

DRAWING LIST: ELECTRICAL SITE PLAN
ELECTRICAL PANEL SCHEDULE
FIRST FLOOR POWER PLAN E-2 E-3 E-4 MEZZANINE FLOOR POWER PLAN ROOF POWER PLAN FIRST FLOOR LIGHTING PLAN SECOND FLOOR LIGHTING PLAN

FIRST FLOOR MISCELLANEOUS SYSTEMS MEZZANINE MISCELLANEOUS SYSTEMS MISCELLANEOUS RISER DIAGRAMS

MISCELLANEOUS RISER DIAGRAMS CONT'D

THIS INSTALLATION SHALL BE IN ACCORDANCE WITH NFPA 70, NYS ENERGY CONSERVATION CODE, NYS BUILDING CODE AND ANY OTHER JURISDICTION HAVING AUTHORITY. ELECTRICIAN SHALL SECURE ALL PERMITS, CERTIFICATES, LICENSES, ETC. AND PROVIDE ALL REQUIRED LABOR, MATERIALS, EQUIPMENT AND SERVICES NECESSARY FOR A COMPLETE AND SAFE INSTALLATION OF ELECTRICAL ITEMS AS

- INDICATED ON THE DRAWINGS, INCLUDING BUT NOT LIMITED TO THE FOLLOWING:

   APPLY FOR AND OBTAIN ELECTRICAL PERMITS AS REQUIRED FOR THE PROJECT.
- RECONNECT ALL EXISTING TO REMAIN FEEDERS AND BRANCH CIRCUITS.

  REPLACE THE EXISTING SERVICE RATED MDP WITH A NEW 200A/3PH 60 CIRCUIT MDP WITH SERVICE RATED MAIN BREAKER.
- PROVIDE AND INSTALL ALL RACEWAYS, PANEL BOARD, WIRING, JUNCTION BOXES, DISCONNECTS, ETC. PROVIDE AND INSTALL ALL FIXTURES, LAMPS, CIRCUITS AND CONDUITS. PROVIDE AND INSTALL WALL SWITCHES, RECEPTACLES, LIGHTING CONTROLS, TIME CLOCKS,
- INTERIOR, EXTERIOR AND SITE LIGHTING. PROVIDE ALL PRIMARY POWER WIRING IN CONDUIT FOR MECHANICAL EQUIPMENT, PLUMBING
- EQUIPMENT, FIRE ALARM, FIRE SPRINKLER AND CONTROLS. COORDINATE WITH TRADE CONTRACTORS.

  PROVIDE CONTROL WIRING CONDUIT FOR MECHANICAL EQUIPMENT, PLUMBING EQUIPMENT AND

  CONTROLS. COORDINATE WITH TRADE CONTRACTORS.

  PROVIDE AND INSTALL ALL INDICATED MISCELLANEOUS SYSTEMS AS SPECIFIED WHICH INCLUDES
- ALL WIRING AND TERMINATION DEVICE OR FIXTURE.

DATE: ISSUE

7.18.22 FOR BID

SEAL:

215 ROANOKE AVENUE RIVERHEAD, NY 11901 (631) 727-5352



TAPPAN FIRE DISTRICT 300 WESTERN HWY S, TAPPAN NY, 10983

PROJECT #: 21-08

DRAWN BY:


CAD FILE: 21-08/P:/BID

Voltage:	JLE FOR:  208 / 120 V	PANE	_		PP2	X Equip. G	round Pus		Poles:	60			Min CB IC	c: 65,000 AIC	
Main Bus:	-		х		200 A Isol. Gro				Mtg:	RECESSED			Min CB IC: <b>65,000 AIC</b> Comments:		
Ckt		Load	+	reaker	Minimum		110 505	Phase	1116	Minimum Branch	Breaker	r	Load		
# Serves		VA	P	Trip	Circuit	, Dranen	Α	В	С	Circuit	Trip	Р	4	Serves	
<del> </del>	1PRESSOR	1296	3	30	4#8,#10	G.1"C	4364		I	4#8,#10G,1-1/4"C	40	2	3068	HEAT PUMP	
3		1296	1		,	-,		4364			"	-	3068	HP-1	
5		1296	1						2496	4#12,#12G,3/4"C	20	1	1200	COMP AIR DRYER	
7 AIR PUR	IFIER	1035	2	15	4#12.#1	2G,3/4"C	3531			4#10,#10G,1"C	25	2	2496	HEAT PUMP	
9		1035	1 -		,			3531	]	20,200,2	-	-	2496	HP-2	
11 APP BAY	EXHAUST	728	2	15	4#12.#1	2G,3/4"C	1 '		1478	2#12,#12G,3/4"C	15	1	750	HOSE REELS	
13 EF-2		728	1		,		1478			2#12,#12G,3/4"C	15	1	750	HOSE REELS	
	ATER UH-1,2	874	1	15	2#12.#1	2G,3/4"C		1624	1	2#12,#12G,3/4"C	15	1	750	HOSE REELS	
	ATER UH-3,4	874	1	15		2G,3/4"C	1 '		1624	2#12,#12G,3/4"C	15	1	750	HOSE REELS	
19 WH-1	· · · · · · · · · · · · · · · · · · ·	1000	1	20		2G,3/4"C	1750			2#12,#12G,3/4"C	15	1	750	HOSE REELS	
21 RED ALE	RT	100	1	15		2G,3/4"C		1300		2#12,#12G,3/4"C	15	1	1200	GEAR DRYER	
	CONTROLLER	500	1	15		2G,3/4"C	1 '		1700	2#12,#12G,3/4"C	15	1	1200	GEAR DRYER	
25 HOSE RE		750	1	15		2G,3/4"C	1711			4#12,#12G,3/4"C	20	3	961	GEAR WASHER	
27 HOSE RE		750	1	15		2G,3/4"C		1711					961	1	
29 GARAGE		750	2	15		2G,3/4"C	1 '		1711	1			961	1	
31		750	1			, ,	1250			2#12,#12G,3/4"C	15	1	500	LOCKER POWER	
33 GARAGE	DOOR	750	2	15	2#12.#1	2G,3/4"C		1250		2#12,#12G,3/4"C	15	1	500	LOCKER POWER	
35		750	1		" ,"	-,-,	·		1110	2#12,#12G,3/4"C	20	1	360	DISPATCH REC	
37 GARAGE	DOOR	750	2	15	2#12,#1	2G,3/4"C	1110			2#12,#12G,3/4"C	20	1	360	DISPATCH REC	
39		750	1		'	, ,		1110		2#12,#12G,3/4"C	20	1	360	APP BAY REC	
41 GARAGE	DOOR	750	2	15	2#12,#1	2G,3/4"C	<b>1</b> '		1650	2#12,#12G,3/4"C	20	1	900	LTG	
43		750	1				1650			2#12,#12G,3/4"C	20	1	900	LTG	
45 REC		360	1	20	2#12,#1	2G,3/4"C		1260		2#12,#12G,3/4"C	20	1	900	EXT LTG	
47 REC		360	1	20	2#12,#1	2G,3/4"C			1360	2#12,#12G,3/4"C	20	1	1000	BAY LTG	
49 REC		180	1	20		2G,3/4"C	180								
51 REC		180	1	20	2#12,#1	2G,3/4"C	] [	180				_			
53							Ļ,		0			_			
55			_				0		1			$\perp$			
57			<u> </u>				<b>]</b> [	0			1	$\vdash$			
59							47000	10000	0			1			
		nected Load (			6483	7	17024 141.9	16330 136.1		VA per phase Amps per phase	129			nnected Load (Amps)	

DATE: ISSUE
7.18.22 FOR BID

SEAL:

SENDLEWSKI ARCHITECTS PC
ARCHITECTS - PLANNERS
215 ROANOKE AVENUE
RIVERHEAD, NY 11901
(631) 727-5352

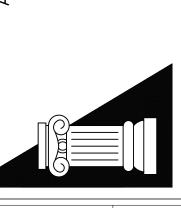

17, 10983


TAPPAN FIRE DISTRICT 300 WESTERN HWY S, TAPPAN NY, 10983

PROJECT #: 21-08

DRAWN BY:

CAD FILE: 21-08/P:/BID



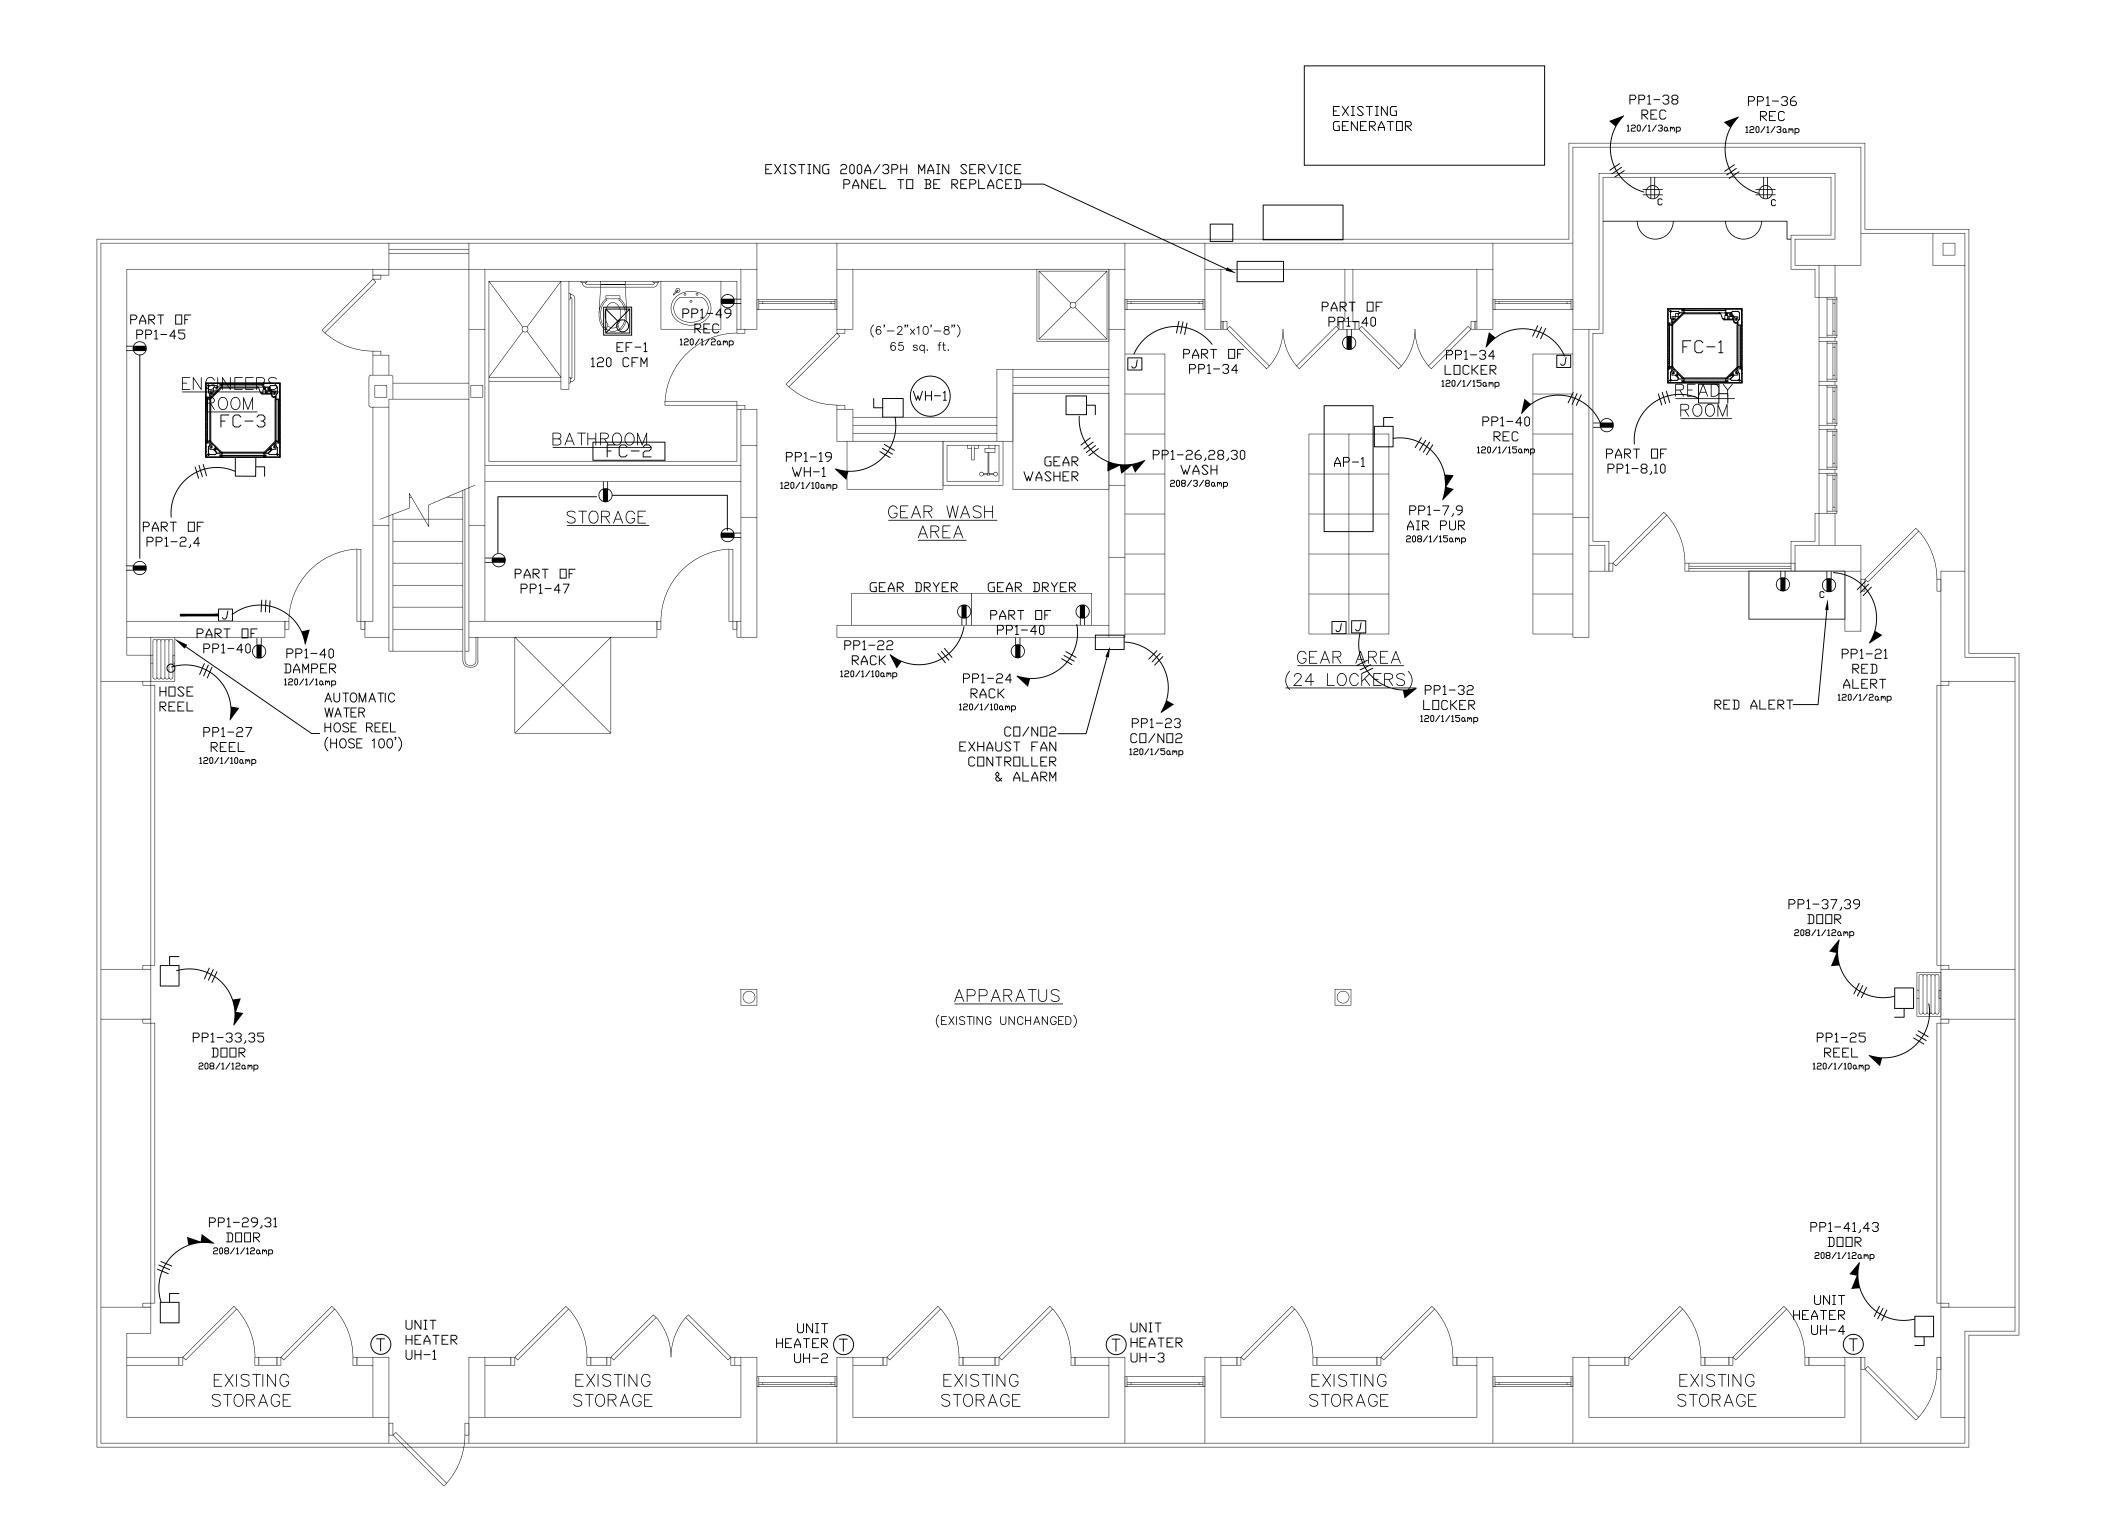

	SYMBOL LIST
SYMBOL	DESCRIPTION
Sa	SINGLE POLE LIGHT SWITCH(LOW VOLTAGE)  a = INDICATES LIGHTS CONTROLLED  (MOUNTED AT 48"TO TOP OF SWITCH UNLESS OTHERWISE NOTED)
• •	DUPLEX RECEPTACLE GROUNDING TYPE,  (MOUNTED AT 24"TO TOP OF RECP. UNLESS OTHERWISE NOTED)  • DUPLEX RECEPTACLE EQUIPTED WITH USB CHARGING PORT,
Ö	DUPLEX RECEPTACLE (ORANGE) ISOLATED GROUNDING TYPE (COMPUTER TYPE)
<b>#</b>	QUAD RECEPTACLE GROUNDING TYPE, (MOUNTED (MOUNTED AT 24"TO TOP OF RECP. UNLESS OTHERWISE NOTED)
<del>-</del>	DUPLEX RECEPTACLE (GROUND FAULT INTERUPTER TYPE) c = DENOTES COUNTER HEIGHT (VERIFY HEIGHT WITH ARCHITECT.)
**	HOMERUN TO DESIGNATED PANEL OR BOARD SLASHES INDICATE NUMBER OF WIRES FOR EACH CIRCUIT. ARROWS INDICATE NUMBER OF CIRCUITS.
	DISCONNECT SWITCH FUSED (SIZE AS INDICATED)
J	JUNCTION BOX (SIZE AS REQUIRED)
HD	ELECTRIC HAND DRYER EXCELERATOR TYPE # H-1927W SUPPLIED AND INSTALLED BY ELECTRICAL CNTR.

PLAN NOTES:

1. REMOVE EXISTING POWER PANELS FROM MAIN SERVICE AND ALL ASSOCIATED WIRING AND CONDUIT. PROVIDE NEW POWER PANEL AND REFEED EXISTING CIRCUITS AND SUB PANELS TO REMAIN.

2. NEW FEEDERS FOR ALL EQUIPMENT SHALL BE IN CONDUIT.

3. ALL RECEPTACLES SHALL BE GFI. ALL WIRING SHALL BE IN CONDUIT.

4. BATHROOM EXHAUST FANS SHALL BE INTERLOCKED WITH THE LIGHTING. FAN SHALL REMAIN ON FOR 15 MINUTES AFTER LIGHTS ARE SHUT OFF.

5. VERIFY RECEPTACLE LOCATIONS, TYPES AND HEIGHTS WITH ARCHITECT PRIOR TO INSTALLATION.
6. ALL PIPING SHALL BE AT CEILING DOWN TO DEVICE OR FIXTURE UNLESS OTHERWISE NOTED.
7. CONNECTIONS TO ALL EQUIPMENT SHALL BE AS PER THE


MANUFACTURER'S INSTALLATION MANUAL.

8. CIRCUIT DESIGNATIONS ARE FOR REFERENCE ONLY. ELECTRICIAN SHALL VERIFY CIRCUIT LOADS OF LIGHTING FIXTURES, POWER AND EQUIPMENT BEFORE CONNECTING NEW CIRCUITS TO NEW PANELS. ELECTRICIAN SHALL BE RESPONSIBLE FOR BALANCING LEGS.

9. ALL EQUIPMENT POWER AND CONTROL WIRING SHALL BE IN METAL CONDUIT.

SEAL:

SENDLEWSKI ARCHITECTS PC
ARCHITECTS - PLANNERS
215 ROANOKE AVENUE
RIVERHEAD, NY 11901
(631) 727-5352

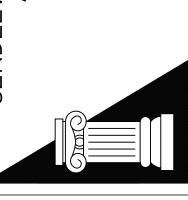

TAPPAN FIRE DISTRICT 300 WESTERN HWY S, TAPPAN NY, 10983


PROJECT #: 21-08

DRAWN BY:

CAD FILE: 21-08/P:/BID

DRAWING#:

FIRST FLOOR POWER PLAN

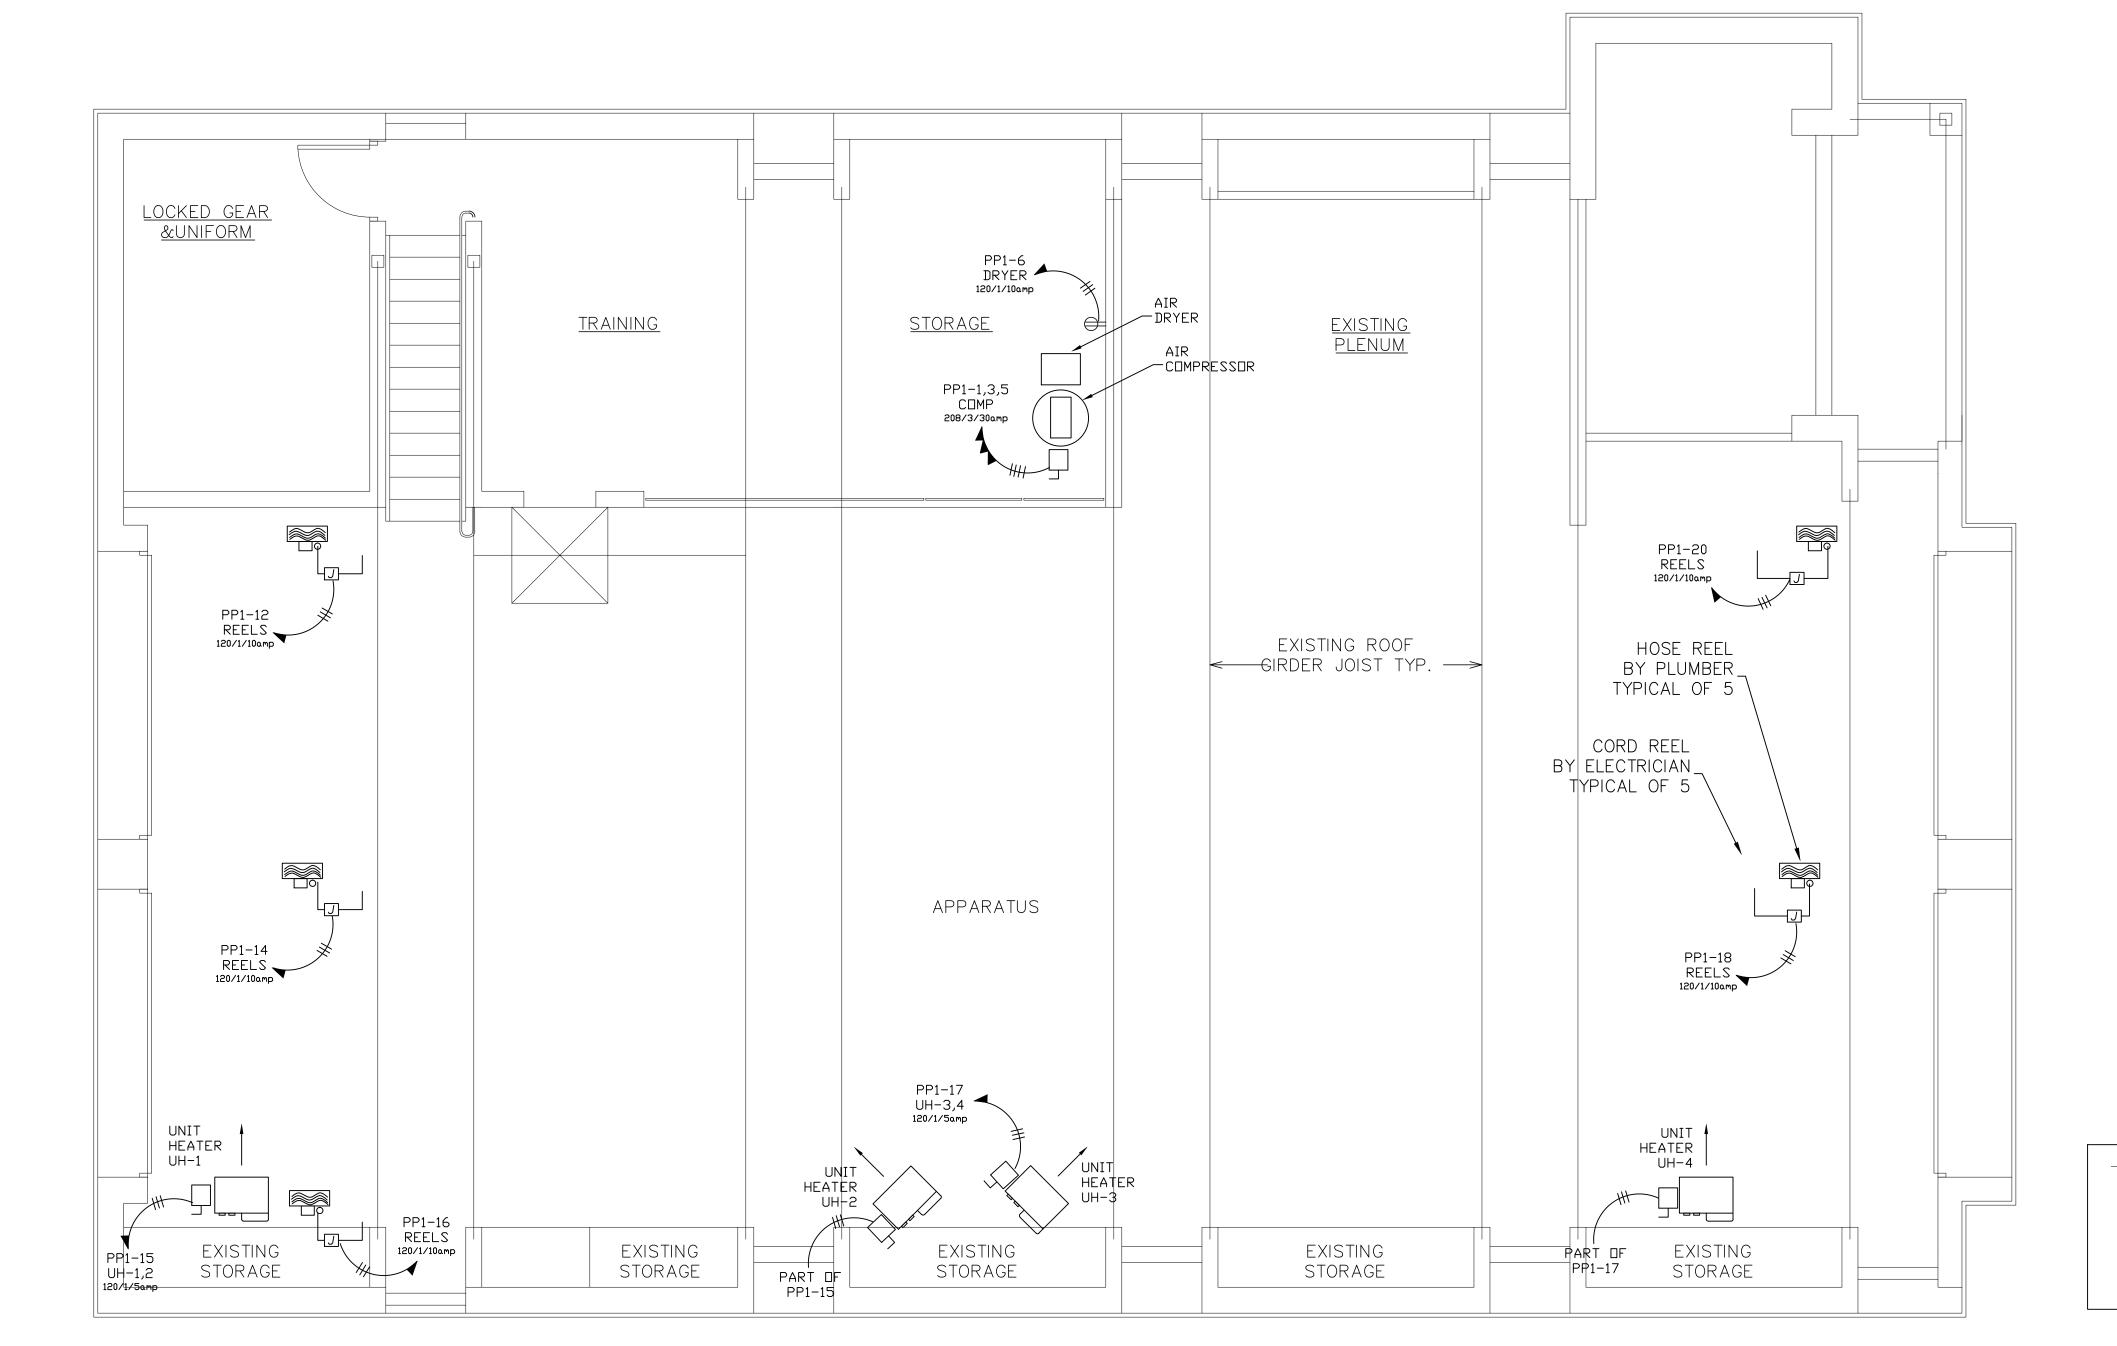

	SYMBOL LIST
SYMBOL	DESCRIPTION
Sa	SINGLE POLE LIGHT SWITCH(LOW VOLTAGE)  a = INDICATES LIGHTS CONTROLLED  (MOUNTED AT 48"TO TOP OF SWITCH UNLESS OTHERWISE NOTED)
• 🕈	DUPLEX RECEPTACLE GROUNDING TYPE,  (MOUNTED AT 24"TO TOP OF RECP. UNLESS OTHERWISE NOTED)  • DUPLEX RECEPTACLE EQUIPTED WITH USB CHARGING PORT,
•	DUPLEX RECEPTACLE (ORANGE) ISOLATED GROUNDING TYPE (COMPUTER TYPE)
<b>#</b>	QUAD RECEPTACLE GROUNDING TYPE, (MOUNTED (MOUNTED AT 24"TO TOP OF RECP. UNLESS OTHERWISE NOTED)
<del>-</del>	DUPLEX RECEPTACLE (GROUND FAULT INTERUPTER TYPE) c = DENOTES COUNTER HEIGHT (VERIFY HEIGHT WITH ARCHITECT.)
***	HOMERUN TO DESIGNATED PANEL OR BOARD SLASHES INDICATE NUMBER OF WIRES FOR EACH CIRCUIT. ARROWS INDICATE NUMBER OF CIRCUITS.
	DISCONNECT SWITCH FUSED (SIZE AS INDICATED)
J	JUNCTION BOX (SIZE AS REQUIRED)
HD	ELECTRIC HAND DRYER EXCELERATOR TYPE # H-1927W SUPPLIED AND INSTALLED BY ELECTRICAL CNTR.

1. REMOVE EXISTING POWER PANELS, MAIN SERVICE, TRANSFER SWITCH AND ALL ASSOCIATED WIRING AND CONDUIT. PROVIDE NEW POWER PANEL

REFEED EXISTING CIRCUITS TO REMAIN. 2. NEW ELECTRIC SERVICE AND FEEDERS FOR ALL EQUIPMENT IN THE ELECTRICAL ROOM, SHALL BE IN CONDUIT AND SHALL BE RUN UNDER

3, ALL CELLAR RECEPTACLES SHALL BE GFI, ALL WIRING SHALL BE IN CONDUIT.

4. BATHROOM EXHAUST FANS SHALL BE INTERLOCKED WITH THE LIGHTING. FAN SHALL REMAIN ON FOR 15 MINUTES AFTER LIGHTS ARE SHUT OFF.

5. VERIFY RECEPTACLE LOCATIONS, TYPES AND HEIGHTS WITH ARCHITECT PRIOR TO INSTALLATION. 6. ALL PIPING SHALL BE AT CEILING DOWN TO DEVICE OR FIXTURE

UNLESS OTHERWISE NOTED. 7. CONNECTIONS TO ALL EQUIPMENT SHALL BE AS PER THE

MANUFACTURER'S INSTALLATION MANUAL. 8. CIRCUIT DESIGNATIONS ARE FOR REFERENCE ONLY, ELECTRICIAN SHALL VERIFY CIRCUIT LOADS OF LIGHTING FIXTURES, POWER AND EQUIPMENT BEFORE CONNECTING NEW CIRCUITS TO NEW PANELS.

ELECTRICIAN SHALL BE RESPONSIBLE FOR BALANCING LEGS. 9. ALL EQUIPMENT POWER AND CONTROL WIRING SHALL BE IN METAL

HR - 1 CEILING MOUNTED CORD REELS

DESCRIPTION: HEAVY DUTY REEL WITH INDUSTRIAL DUTY CHANNEL FRAME CONSTRUCTION. CHAIN AND SPROCKET DRIVE POWERED BY 1/2 HP 115V ELECTRIC MOTOR & OPTIONAL CHAIN CLUTCH REDUCTION UNIT, AND AUXILIARY CRANK REWIND. 1/2" NPT BRONZE INLET & OUTLET. REEL SHALL BE CAPABLE OF HANDLING 100' OF HOSE. HANNAY MODEL NO. ECR1614-17-18 OR EQUAL. CONTROLLER SHALL BE PURCHASED AND INSTALLED BY ELECTRICAL CONTRACTOR. WIRED BY ELECTRICAL CONTRACTOR.

CORD 100' OF 10/3 CORD WITH THREE END TERMINAL SENDLEWSKI ARCHITECTS PC ARCHITECTS - PLANNERS

SEAL:

DATE: ISSUE

7.18.22 FOR BID

FIRE DISTRICT ESTERN HWY S, AN NY, 10983 TAPPAN 300 WES TAPPAN


PROJECT #: 21-08

DRAWN BY:

CAD FILE: 21-08/P:/BID

DRAWING#:

MEZZANINE POWER PLAN

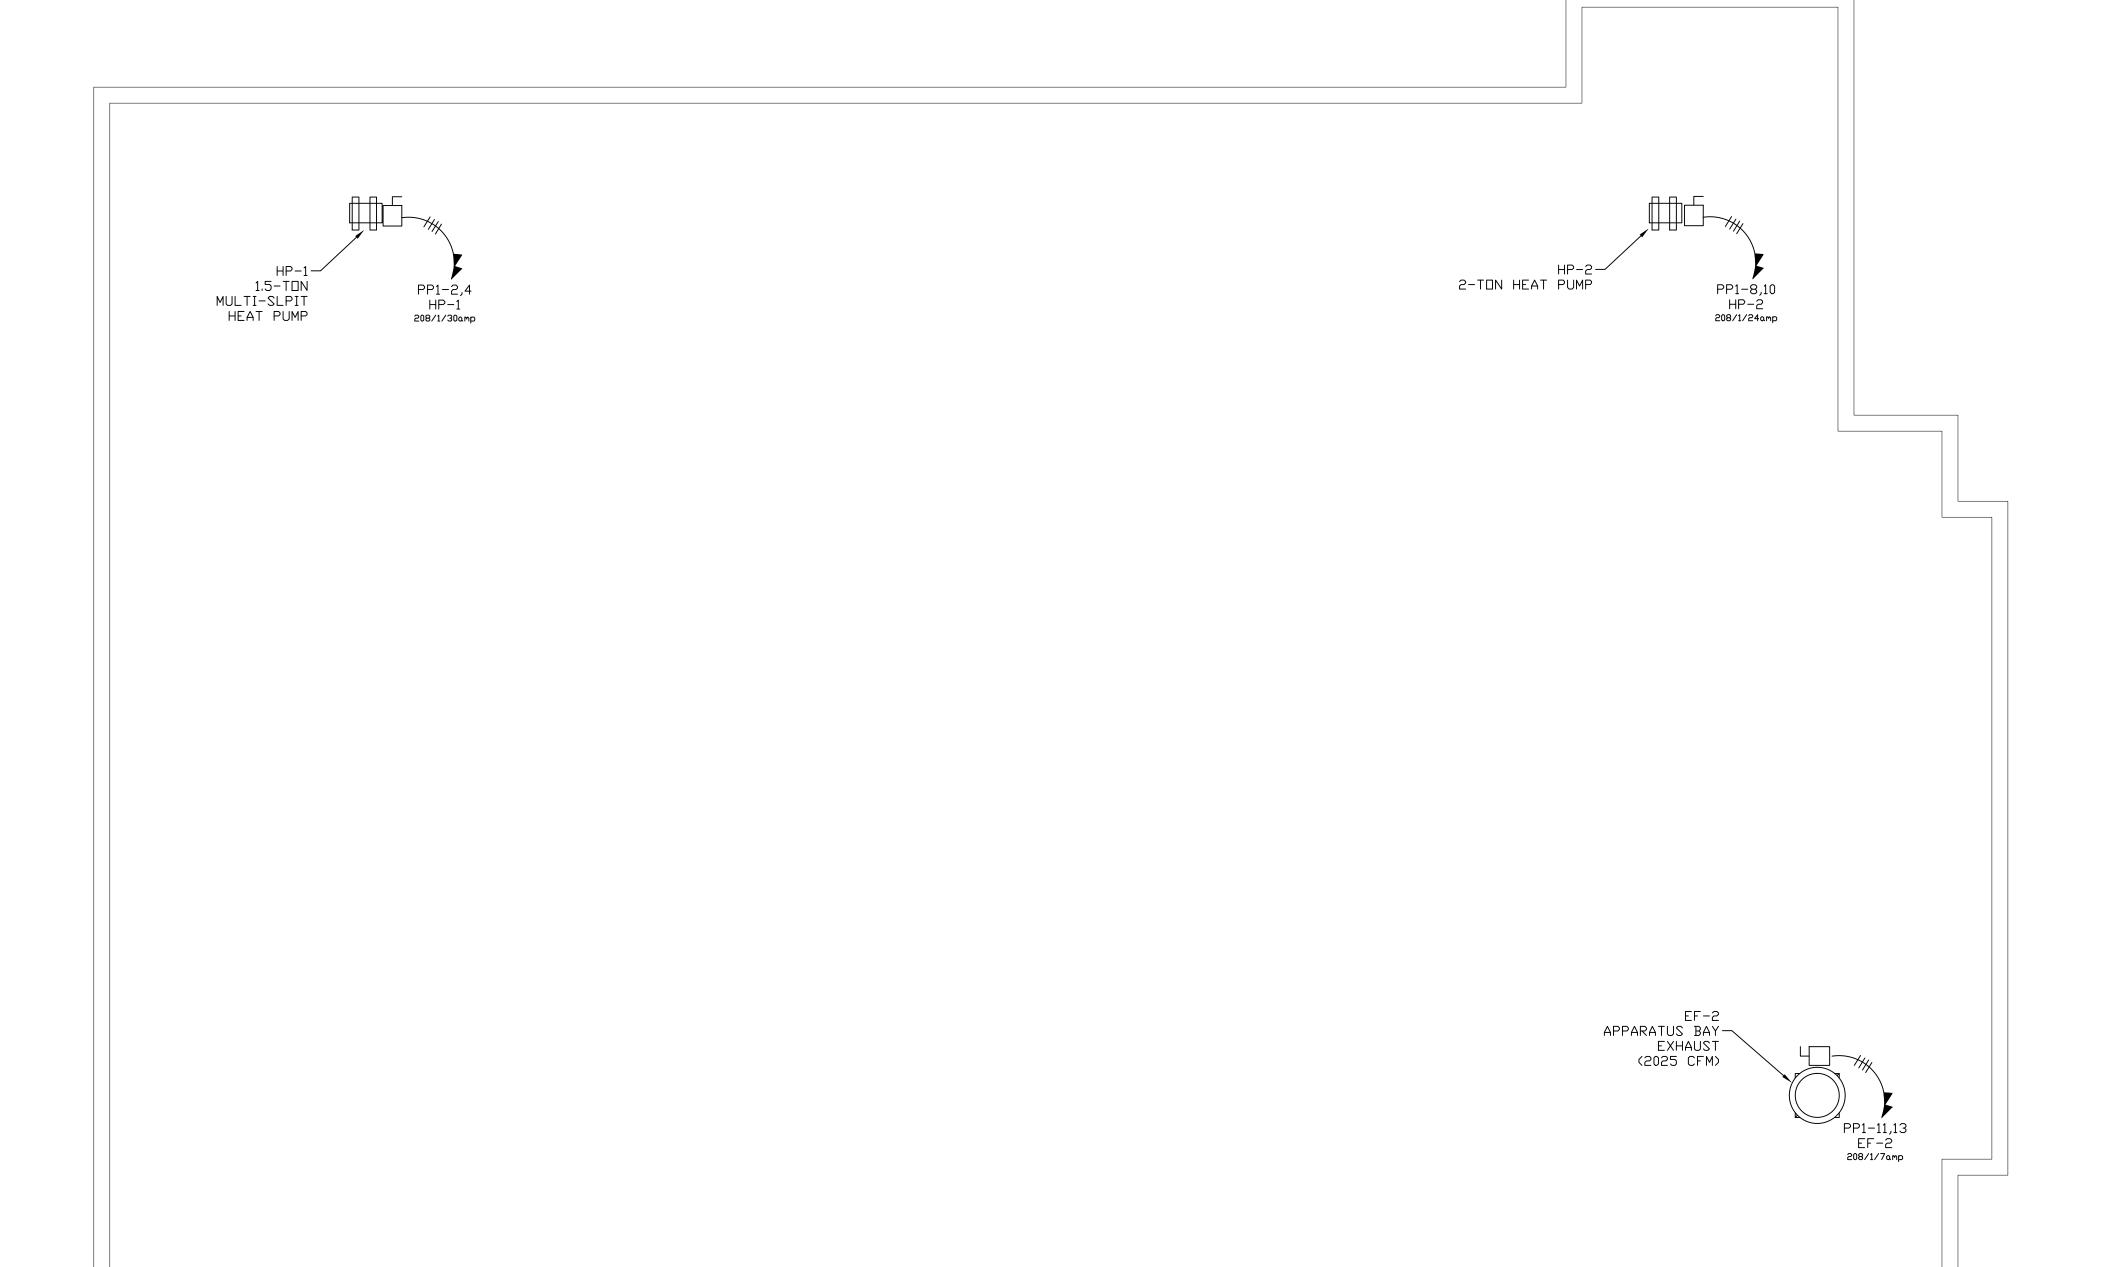

	SYMBOL LIST
SYMBOL	DESCRIPTION
Sa	SINGLE POLE LIGHT SWITCH  a = INDICATES LIGHTS CONTROLLED  (MOUNTED AT 48"TO TOP OF SWITCH UNLESS OTHERWISE NOTED)
S 3	THREE WAY SWITCH  a = INDICATES LIGHTS CONTROLLED  (MOUNTED AT 48"TO TOP OF SWITCH UNLESS OTHERWISE NOTED)
• 🕈	DUPLEX RECEPTACLE GROUNDING TYPE,  (MOUNTED AT 24"TO TOP OF RECP. UNLESS OTHERWISE NOTED)  • DUPLEX RECEPTACLE EQUIPTED WITH USB CHARGING PORT,
Ö	DUPLEX RECEPTACLE (ORANGE) ISOLATED GROUNDING TYPE (COMPUTER TYPE)
<b>#</b>	QUAD RECEPTACLE GROUNDING TYPE, (MOUNTED (MOUNTED AT 24"TO TOP OF RECP. UNLESS OTHERWISE NOTED)
<del>-</del>	DUPLEX RECEPTACLE (GROUND FAULT INTERUPTER TYPE) c = DENOTES COUNTER HEIGHT (VERIFY HEIGHT WITH ARCHITECT.)
**	HOMERUN TO DESIGNATED PANEL OR BOARD SLASHES INDICATE NUMBER OF WIRES FOR EACH CIRCUIT. ARROWS INDICATE NUMBER OF CIRCUITS.
	DISCONNECT SWITCH FUSED (SIZE AS INDICATED)
J	JUNCTION BOX (SIZE AS REQUIRED)
SWT	WIND-UP TIMER SWITCH
	COMBO STARTER DISC SW.
ST	HORSEPOWER RATED SWITCH
HD	ELECTRIC HAND DRYER EXCELERATOR TYPE # H-1927W SUPPLIED AND INSTALLED BY ELECTRICAL CNTR.

PLAN NOTES:

1. REMOVE EXISTING POWER PANELS, MAIN SERVICE, TRANSFER SWITCH AND ALL ASSOCIATED WIRING AND CONDUIT. PROVIDE NEW POWER PANEL AND

REFEED EXISTING CIRCUITS TO REMAIN.

2. NEW ELECTRIC SERVICE AND FEEDERS FOR ALL EQUIPMENT IN THE ELECTRICAL ROOM, SHALL BE IN CONDUIT AND SHALL BE RUN UNDER

ELECTRICAL ROOM, SHALL BE IN CONDUIT AND SHALL BE RUN UNDER THE SLAB.

3. ALL CELLAR RECEPTACLES SHALL BE GFI. ALL WIRING SHALL BE IN

CONDUIT.

4. BATHROOM EXHAUST FANS SHALL BE INTERLOCKED WITH THE LIGHTING.
FAN SHALL REMAIN ON FOR 15 MINUTES AFTER LIGHTS ARE SHUT OFF.

5. VERIFY RECEPTACLE LOCATIONS, TYPES AND HEIGHTS WITH

ARCHITECT PRIOR TO INSTALLATION.

6. ALL PIPING SHALL BE AT CEILING DOWN TO DEVICE OR FIXTURE UNLESS OTHERWISE NOTED.

7. CONNECTIONS TO ALL EQUIPMENT SHALL BE AS PER THE

7. CONNECTIONS TO ALL EQUIPMENT SHALL BE AS PER THE MANUFACTURER'S INSTALLATION MANUAL.

8. CIRCUIT DESIGNATIONS ARE FOR REFERENCE ONLY. ELECTRICI

8. CIRCUIT DESIGNATIONS ARE FOR REFERENCE ONLY, ELECTRICIAN SHALL VERIFY CIRCUIT LOADS OF LIGHTING FIXTURES, POWER AND EQUIPMENT BEFORE CONNECTING NEW CIRCUITS TO NEW PANELS, ELECTRICIAN SHALL BE RESPONSIBLE FOR BALANCING LEGS.

9. ALL EQUIPMENT POWER AND CONTROL WIRING SHALL BE IN METAL CONDUIT.

SENDLEWSKI ARCHITECTS PC
ARCHITECTS - PLANNERS
215 ROANOKE AVENUE
RIVERHEAD, NY 11901
(631) 727-5352

DATE: ISSUE

SEAL:

7.18.22 FOR BID

TAPPAN FIRE DISTRICT 300 WESTERN HWY S, TAPPAN NY, 10983


PROJECT #: 21-08

DRAWN BY:

CAD FILE: 21-08/P:/BID

DRAWING#:

ROOF POWER PLAN

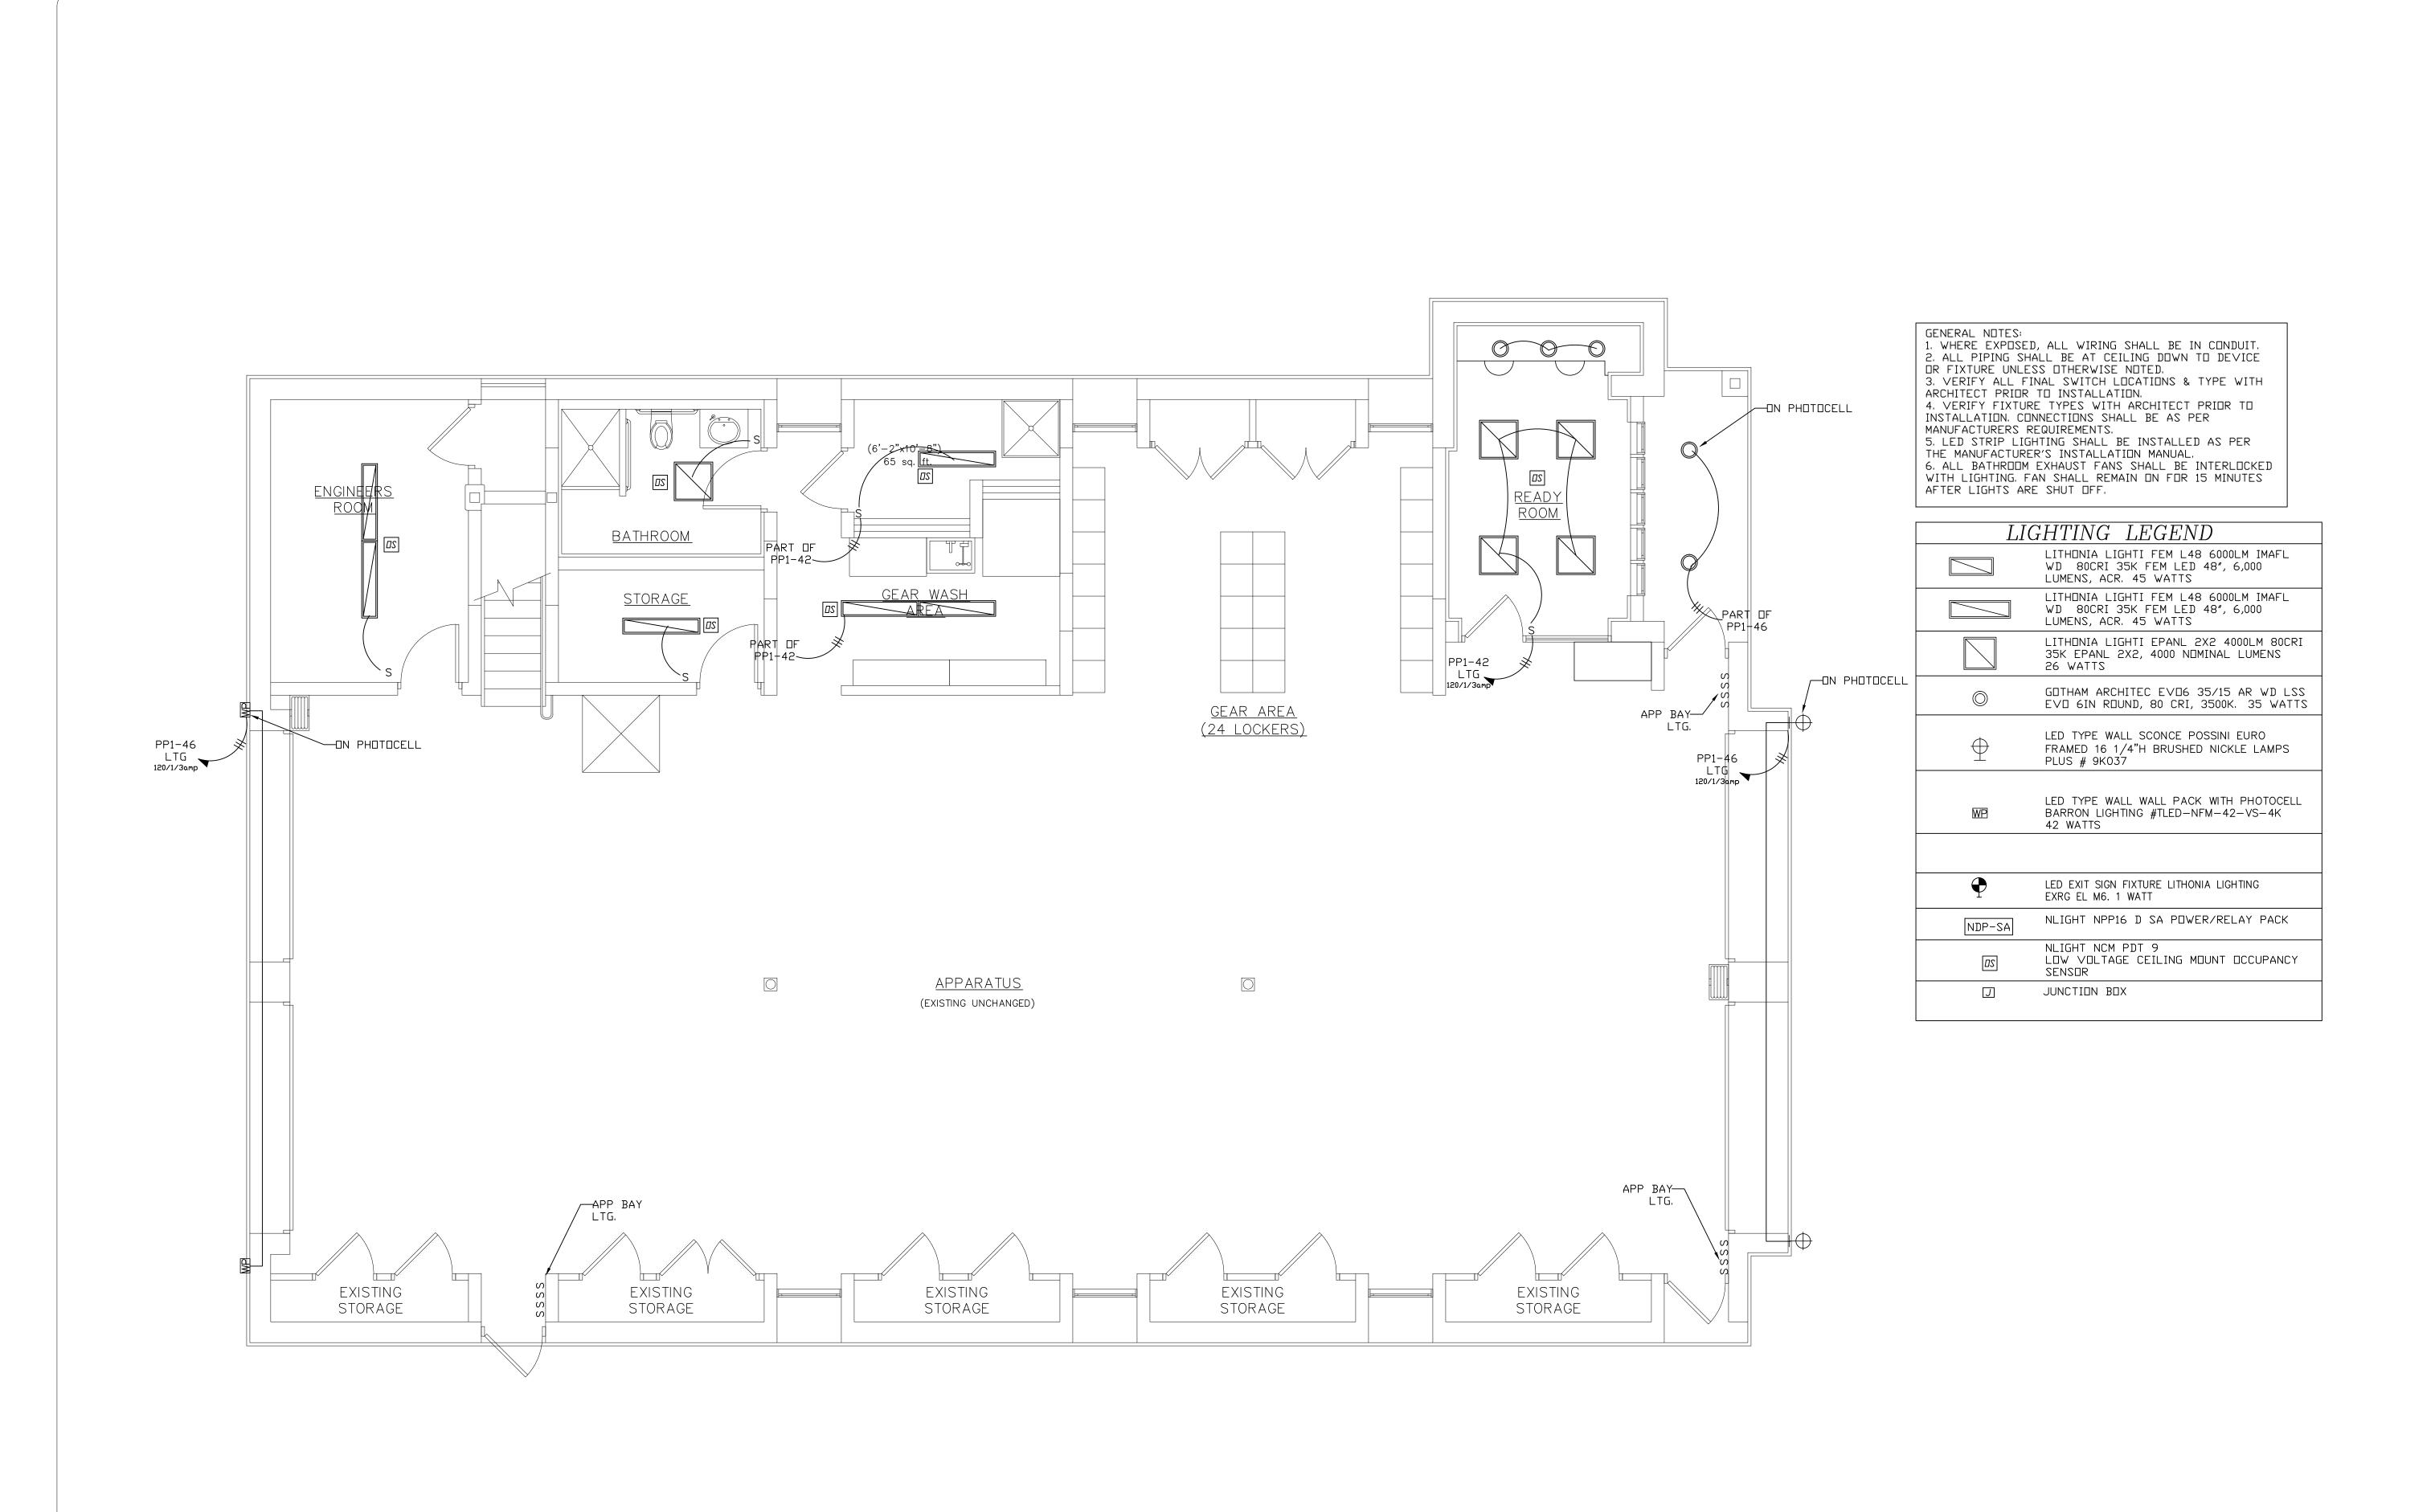


7.18.22 FOR BID

DATE: ISSUE

SEAL:

215 ROANOKE AVENUE RIVERHEAD, NY 11901 (631) 727-5352 NDLEWSKI ARCHITECTS PC ARCHITECTS - PLANNERS

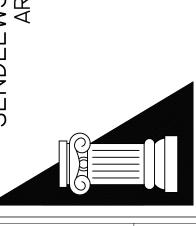

TAPPAN FIRE DISTRICT 300 WESTERN HWY S, TAPPAN NY, 10983


PROJECT #: 21-08

DRAWN BY:

CAD FILE: 21-08/P:/BID

DRAWING#:

FIRST FLOOR LIGHTING PLAN

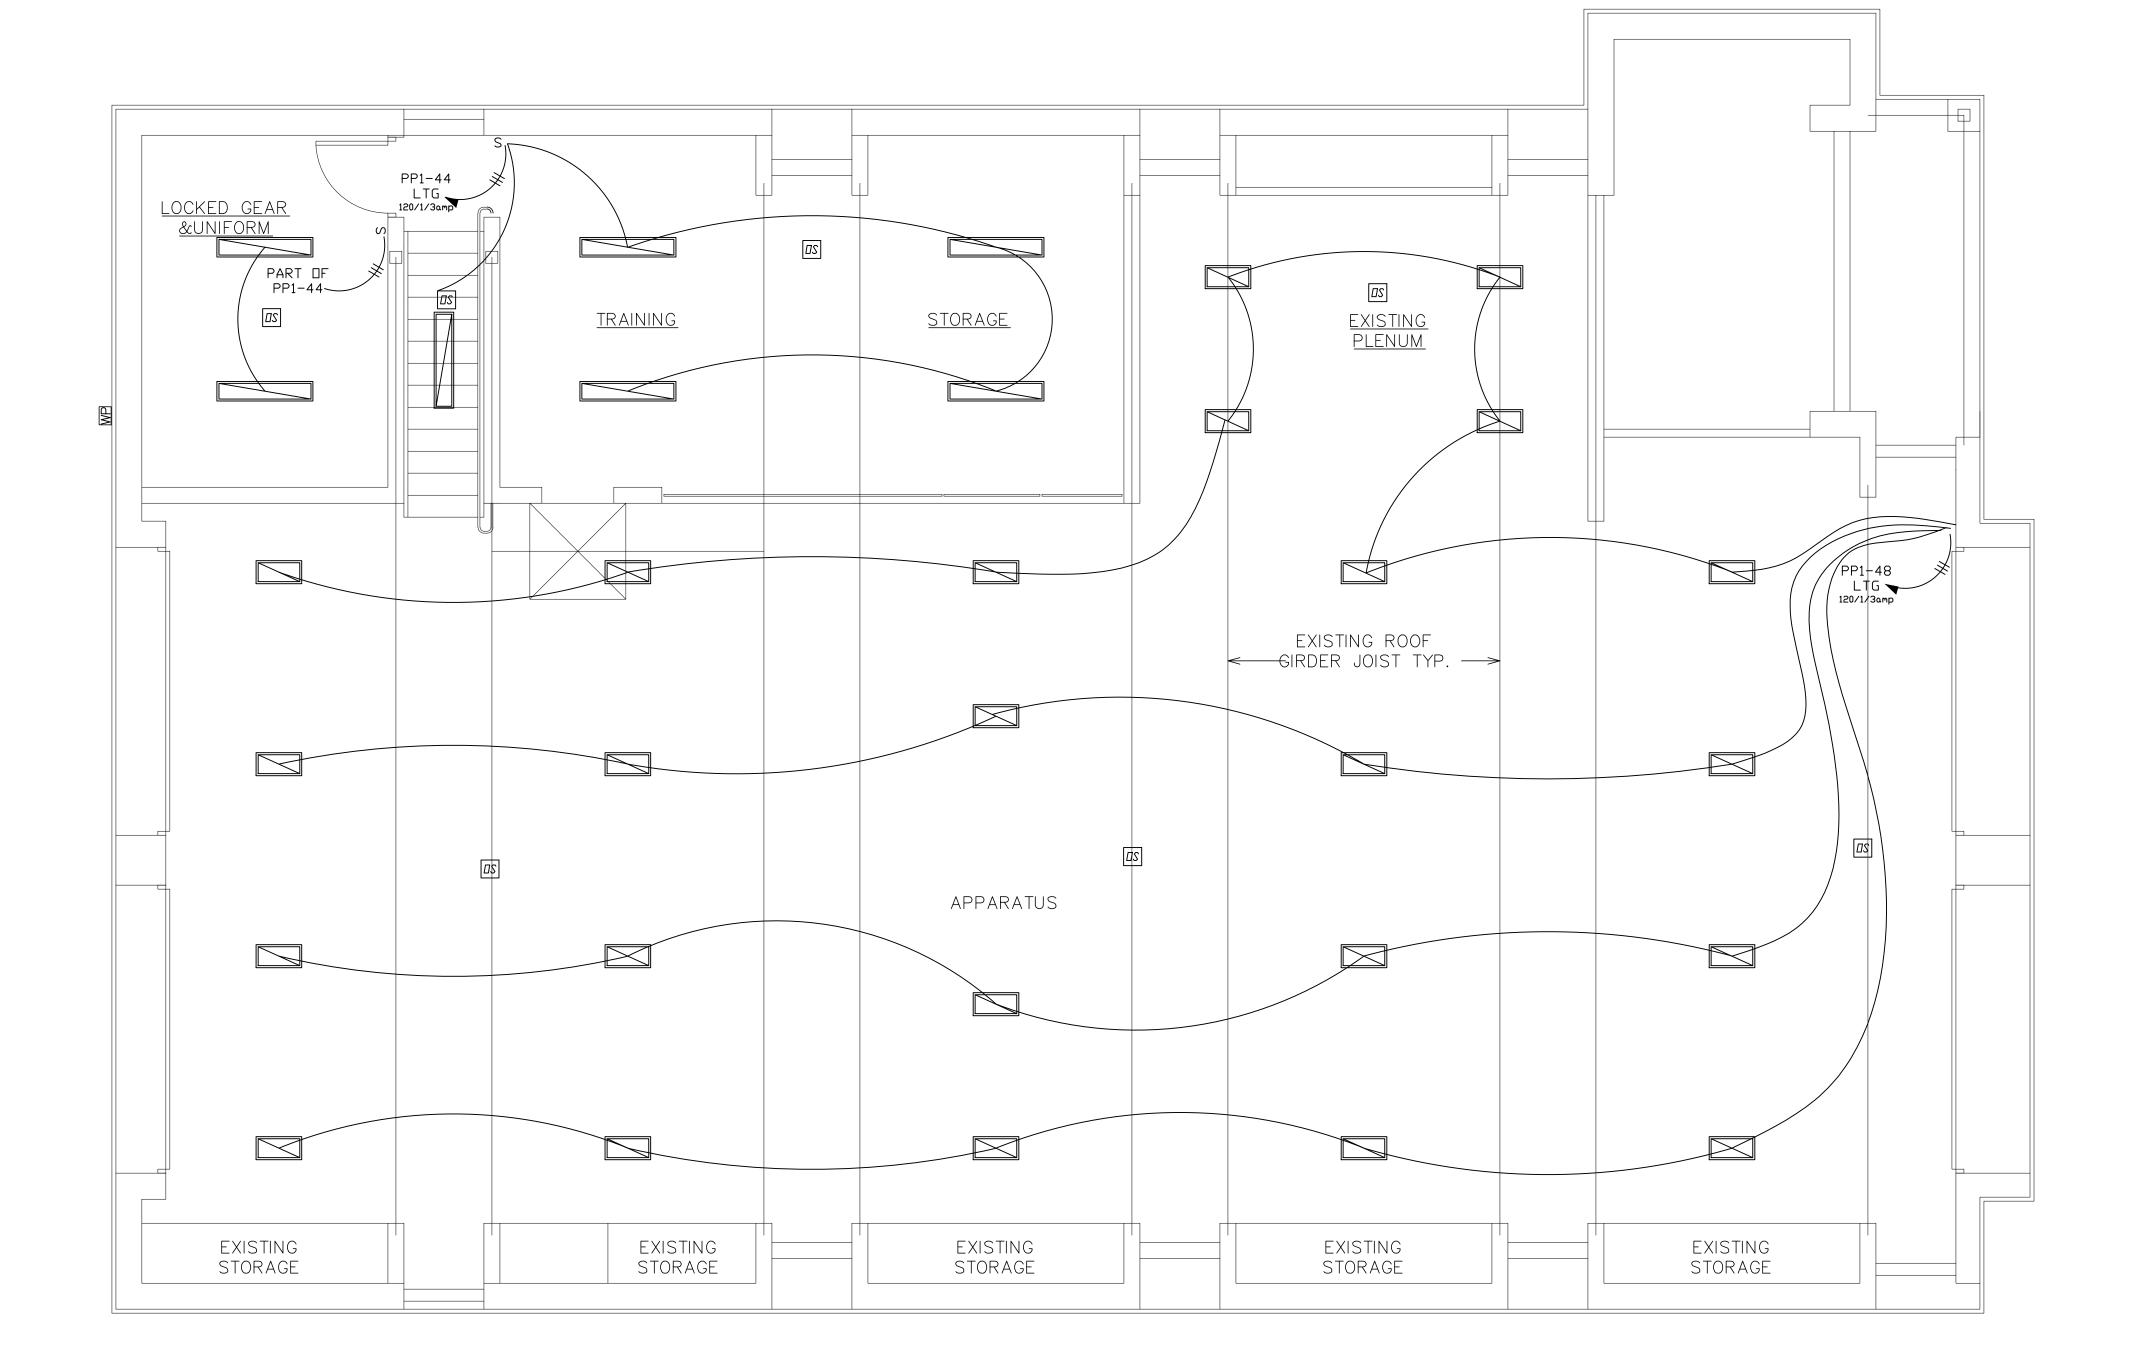

GENERAL NOTES:

1. WHERE EXPOSED, ALL WIRING SHALL BE IN CONDUIT.

2. ALL PIPING SHALL BE AT CEILING DOWN TO DEVICE OR FIXTURE UNLESS OTHERWISE NOTED.

3. VERIFY ALL FINAL SWITCH LOCATIONS & TYPE WITH ARCHITECT PRIOR TO INSTALLATION.

4. VERIFY FIXTURE TYPES WITH ARCHITECT PRIOR TO INSTALLATION. CONNECTIONS SHALL BE AS PER MANUFACTURERS REQUIREMENTS.

5. LED STRIP LIGHTING SHALL BE INSTALLED AS PER THE MANUFACTURER'S INSTALLATION MANUAL.

6. ALL BATHROOM EXHAUST FANS SHALL BE INTERLOCKED WITH LIGHTING. FAN SHALL REMAIN ON FOR 15 MINUTES AFTER LIGHTS ARE SHUT OFF.

LI	GHTING LEGEND
	LITHONIA LIGHTI FEM L48 6000LM IMAFL WD 80CRI 35K FEM LED 48″, 6,000 LUMENS, ACR. 45 WATTS
	LITHONIA LIGHTI FEM L48 6000LM IMAFL WD 80CRI 35K FEM LED 48″, 6,000 LUMENS, ACR. 45 WATTS
	LITHONIA LIGHTI EPANL 2X2 4000LM 80CRI 35K EPANL 2X2, 4000 NOMINAL LUMENS 26 WATTS
0	GOTHAM ARCHITEC EVO6 35/15 AR WD LSS EVO 6IN ROUND, 80 CRI, 3500K. 35 WATTS
<u></u>	LED TYPE WALL SCONCE POSSINI EURO FRAMED 16 1/4"H BRUSHED NICKLE LAMPS PLUS # 9K037
WP	LED TYPE WALL WALL PACK WITH PHOTOCELL BARRON LIGHTING #TLED-NFM-42-VS-4K 42 WATTS
•	LED EXIT SIGN FIXTURE LITHONIA LIGHTING EXRG EL M6. 1 WATT
NDP-SA	NLIGHT NPP16 D SA POWER/RELAY PACK
ΔS	NLIGHT NCM PDT 9 LDW VOLTAGE CEILING MOUNT OCCUPANCY SENSOR
J	JUNCTION BOX

DATE: ISSUE

7.18.22 FOR BID

SEAL:

SENDLEWSKI ARCHITECTS PC
ARCHITECTS - PLANNERS
215 ROANOKE AVENUE
RIVERHEAD, NY 11901
(631) 727-5352

TAPPAN FIRE DISTRICT 300 WESTERN HWY S, TAPPAN NY, 10983

MEZZANINE LIGHTING PLAN

PROJECT #: 21-08

DRAWN BY:

CAD FILE: 21-08/P:/BID

DRAWING#:

\_\_\_\_

MEZZANINE LIGHTING PLAN

## SYMBOL LIST

- CABLE TV DUTLET(MTD, @ 7'-6"AFF)UNLESS NOTED
  WIRE SUPPLIED & INSTALLED BY ELECTRICAL
  CONTRACTOR TO COMPUTER IT ROOM.
  TERMINATE W/2-CAT 6 WIRE WHITE, VERIFY W/CABLE CO
- COMPUTER OUTLET(DUPLEX)(MTD.@2'-0"AFF)
  ELECTRICAL CONTRACTOR SHALL SUPPLY & INSTALL
  CMPTR.. WIRE CAT 6(BLUE) TO COMPUTER RM
  FROM EACH OUTLET. TERMINATE AT PUNCH BLOCK
- TELEPHONE OUTLET(MTD.@2'-0"AFF.)

  W = WALL MTD. (MTD.@64"AFF)

  ELECTRICAL CONTRACTOR WILL SUPPLY

  AND INSTALL 2 CAT 6 WIRE GREY FROM EACH TELEPHONE

  OUTLET TO COMPUTER RM.TERMINATE AT PUNCH BLOCK
- ☐ INTERIOR DOOR ELECTRIC STRIKE
- EXTERIOR DOOR ELECTRIC STRIKE
- ☐ CARD READER(MTD. @ 48"AFF)WHERE APPLICABLE
- ■DB DOOR BELL & SPEAKER(PART OF ACCESS SYSTEM) ELECTRICAL CONTR. SHALL SUPPLY AND INSTALL WIRE,CDT,JBOXES ETC PLUS 18/4 TO TELEPHONE SYSTEM.
- DCD DOOR CONTROL DEVICE
- SECURITY CAMERA

  1 = DENOTES TYPE OF CAMERA(OUTDOOR)

  2 = DENOTES TYPE OF CAMERA(INDOOR)
- RADIO SYSTEM SPEAKER
- W/18/4+CAT 6 ORANGE FROM COMPUTER ROOM TO VOLUME
  VOLUME CONTROL TO SPEAKER
- RADIO SYSTEM VOLUME CONTROLLER
- MONITOR OUTLET(DUPLEX)(MTD.@7'-6"AFF)
  ELECTRICAL CONTRACTOR SHALL SUPPLY & INSTALL
  CMPTR. WIRE CAT 6(BLUE) TO COMPUTER RM
  FROM EACH OUTLET. TERMINATE AT PUNCH BLOCK

### FACP FIRE ALARM CONTROL PANEL

- ANN FIRE ALARM REMOTE ANNUNCIATOR PANEL
- ₩ STROBE
- HORN/STROBE
- MANUAL PULL STATION
- CONTROL MODULE WITH
- RELAY/CONTACTOR FOR HOOD
- SMOKE DETECTOR
- RAL=ABOVE CLG. W/ REMOTE ALARM LAMP
- C CARBON MONOXIDE DETECTOR
- RAL=ABOVE CLG. W/ REMOTE ALARM LAMP

### NOTF:

LOCATIONS SHOWN FOR ALL TELEPHONE, COMPUTER JACKS, CABLE TV, FIRE ALARM, ETC. ARE CONCEPTUAL—EXACT LOCATIONS TO BE COORDINATED WITH OWNER/ARCHITECT.

ALL WIRING FOR ACCESS, SURVEILANCE, TELEPHONE, CABLE TV, COMPUTER, FIRE ALARM, PUBLIC ADDRESS SYSTEMS TO BE SUPPLIED AND INSTALLED BY ELECTRICAL CNTR. ALL CDT, BOXES ETC NEEDED TO FACILITATE INSTALLATION SHALL BE SUPPLIED AND INSTALLED BY ELECT. CNTR. ALL ROUTING TO 2ND FLOOR COMPUTER ROOM.

### NOT

ALL WIRING FOR SPECIALTY SYSTEMS SHOWN ON THESE DRAWINGS SHALL BE VERIFIED WITH SUCCESSFUL SPECIALTY SYSTEMS VENDOR PRIOR TO PURCHASE OR INSTALLATION BY ELECTRICAL CONTRACTOR

### NOTE

ALL WIRING FOR SPECIALTY SYSTEMS SHOWN ON THESE DRAWINGS SHALL BE CERTIFIED BY ELECTRICAL CONTRACTOR.

### NOTE

OUTLETS SHOWN ON MISCELLANEOUS SYSTEMS PLANS ARE ALSO SHOWN ON POWER PLANS AND ARE NOT IN ADDITION TO OUTLETS SHOWN ON POWER PLANS

\_\_\_\_

SEAL:

DATE: ISSUE

7.18.22 FOR BID

215 ROANOKE AVENUE RIVERHEAD, NY 11901 (631) 727-5352 9 SELENA COURT

ENDLEWSKI ARCHITECTS PC ARCHITECTS - PLANNERS

TAPPAN FIRE DISTRICT 300 WESTERN HWY S, TAPPAN NY, 10983

PROJECT #: 21-08


DRAWN BY:

CAD FILE: 21-08/P:/BID

DRAWING#:

\_\_\_\_

FIRST FL MISCELLANEOUS PLAN

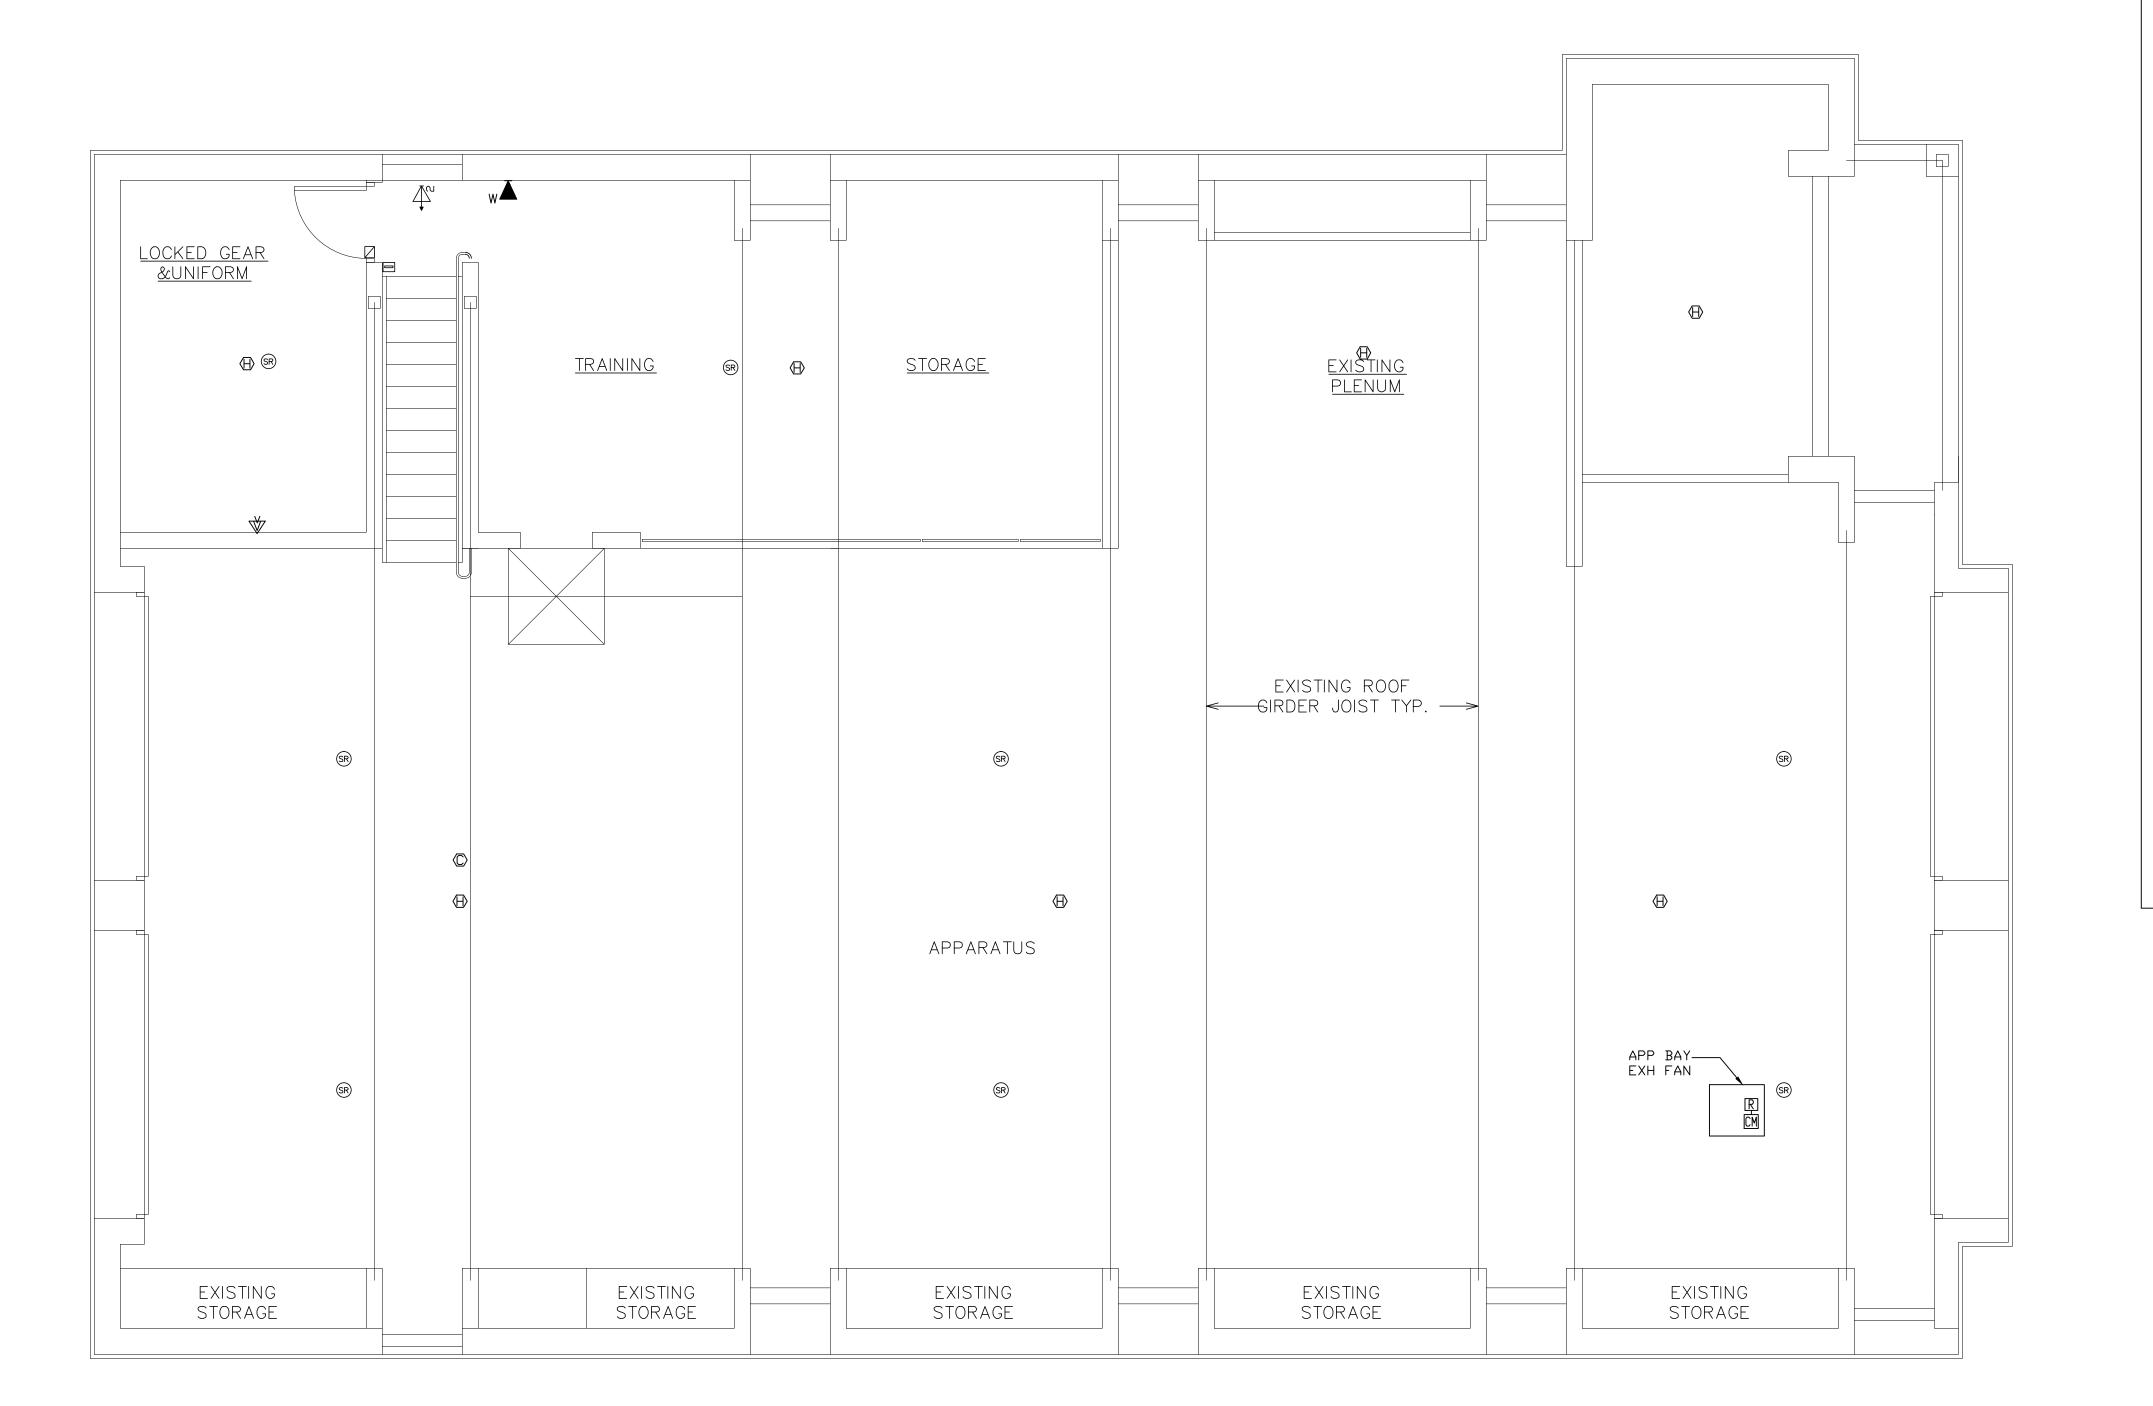

SYMBOL LIST

CABLE TV DUTLET(MTD. @ 7'-6"AFF)UNLESS NOTED WIRE SUPPLIED & INSTALLED BY ELECTRICAL CONTRACTOR TO COMPUTER IT ROOM.

COMPUTER OUTLET(DUPLEX)(MTD.@2'-0"AFF)
ELECTRICAL CONTRACTOR SHALL SUPPLY & INSTALL
CMPTR.. WIRE CAT 6(BLUE) TO COMPUTER RM
FROM EACH OUTLET. TERMINATE AT PUNCH BLOCK

TELEPHONE OUTLET(MTD.@2'-0"AFF.) W = WALL MTD. (MTD.@64"AFF) ELECTRICAL CONTRACTOR WILL SUPPLY
AND INSTALL 2 CAT 6 WIRE GREY FROM EACH TELEPHONE
OUTLET TO COMPUTER RM.TERMINATE AT PUNCH BLOCK

■DB DOOR BELL & SPEAKER(PART OF ACCESS SYSTEM) ELECTRICAL CONTR. SHALL SUPPLY AND INSTALL

1 = DENOTES TYPE OF CAMERA(OUTDOOR)

W/18/4+CAT 6 ORANGE FROM COMPUTER ROOM TO VOLUME

RADIO SYSTEM VOLUME CONTROLLER

ANN FIRE ALARM REMOTE ANNUNCIATOR PANEL

HORN/STROBE

MANUAL PULL STATION

RELAY/CONTACTOR FOR HOOD

RAL=ABOVE CLG. W/ REMOTE ALARM LAMP

CARBON MONOXIDE DETECTOR

LOCATIONS SHOWN FOR ALL TELEPHONE, COMPUTER JACKS, CABLE TV, FIRE ALARM, ETC. ARE CONCEPTUAL-EXACT LOCATIONS TO

ALL WIRING FOR ACCESS, SURVEILANCE, TELEPHONE, CABLE TV, COMPUTER, FIRE ALARM, PUBLIC ADDRESS SYSTEMS TO BE SUPPLIED AND INSTALLED BY ELECTRICAL CNTR. ALL CDT, BOXES ETC NEEDED TO FACILITATE INSTALLATION SHALL BE SUPPLIED AND INSTALLED BY ELECT. CNTR. ALL ROUTING TO 2ND FLOOR COMPUTER ROOM.

ALL WIRING FOR SPECIALTY SYSTEMS SHOWN ON THESE DRAWINGS

ALL WIRING FOR SPECIALTY SYSTEMS SHOWN ON THESE DRAWINGS SHALL BE CERTIFIED BY ELECTRICAL CONTRACTOR.

OUTLETS SHOWN ON MISCELLANEOUS SYSTEMS PLANS ARE ALSO SHOWN ON POWER PLANS AND ARE NOT IN ADDITION TO OUTLETS SHOWN ON POWER PLANS

TERMINATE W/2-CAT 6 WIRE WHITE. VERIFY W/CABLE CO

EXTERIOR DOOR ELECTRIC STRIKE

CARD READER(MTD. @ 48"AFF)WHERE APPLICABLE WIRE, CDT, JBOXES ETC PLUS 18/4 TO TELEPHONE SYSTEM.

DCD DOOR CONTROL DEVICE

2 = DENOTES TYPE OF CAMERA(INDOOR)

RADIO SYSTEM SPEAKER

VOLUME CONTROL TO SPEAKER

MONITOR OUTLET(DUPLEX)(MTD.@7'-6"AFF)
ELECTRICAL CONTRACTOR SHALL SUPPLY & INSTALL
CMPTR. WIRE CAT 6(BLUE) TO COMPUTER RM
FROM EACH OUTLET. TERMINATE AT PUNCH BLOCK

FACP FIRE ALARM CONTROL PANEL

STROBE

CONTROL MODULE WITH

SMOKE DETECTOR

RAL=ABOVE CLG. W/ REMOTE ALARM LAMP

BE COORDINATED WITH OWNER/ARCHITECT

SHALL BE VERIFIED WITH SUCCESSFUL SPECIALTY SYSTEMS VENDOR PRIOR TO PURCHASE OR INSTALLATION BY ELECTRICAL

CAD FILE: 21-08/P:/BID

PROJECT #: 21-08

DRAWN BY:

DRAWING#:

TAPPAN FIRE DISTRICT 300 WESTERN HWY S, TAPPAN NY, 10983

DATE: ISSUE


SEAL:


215 ROANOKE AVENUE RIVERHEAD, NY 11901 (631) 727-5352


EWSKI ARCHITECTS PC ARCHITECTS - PLANNERS

7.18.22 FOR BID

MEZZANINE MISCELLANEOUS PLAN

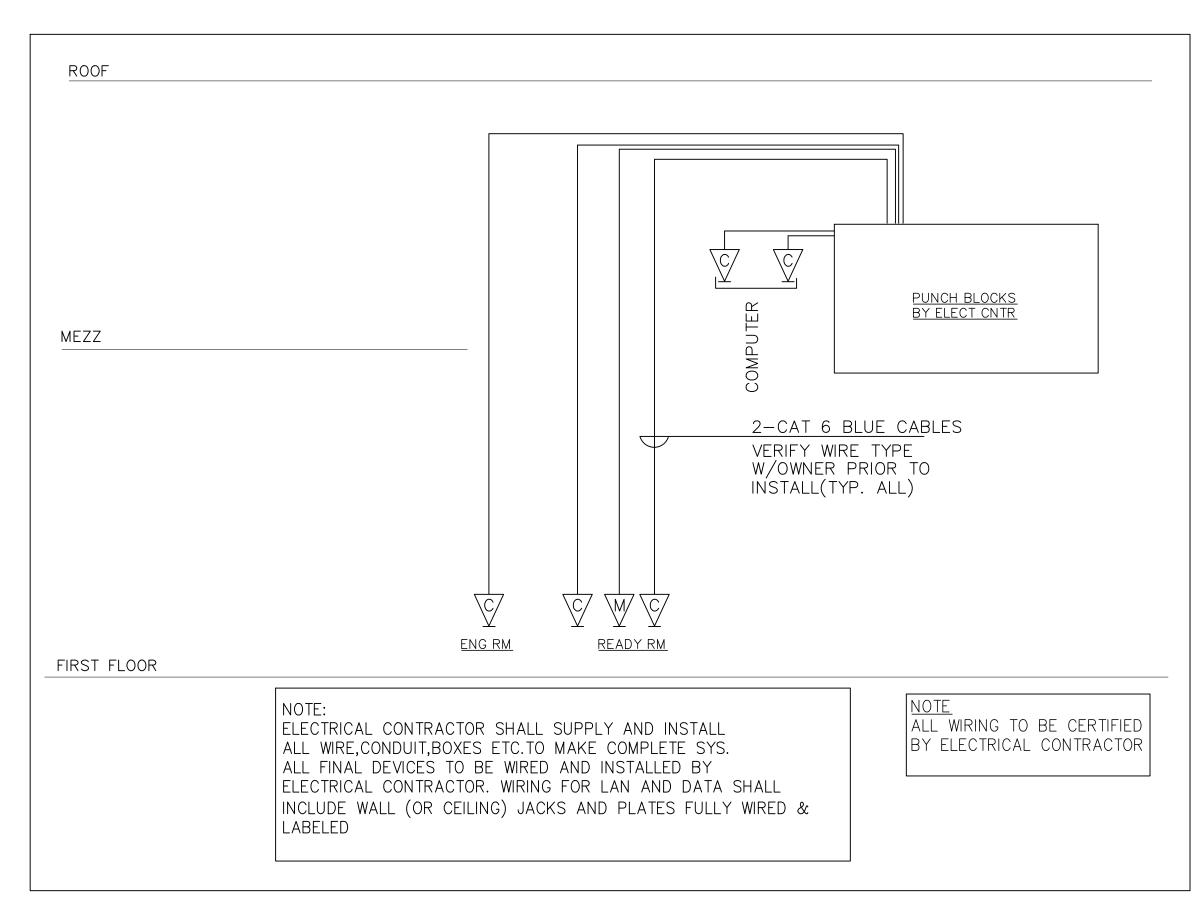


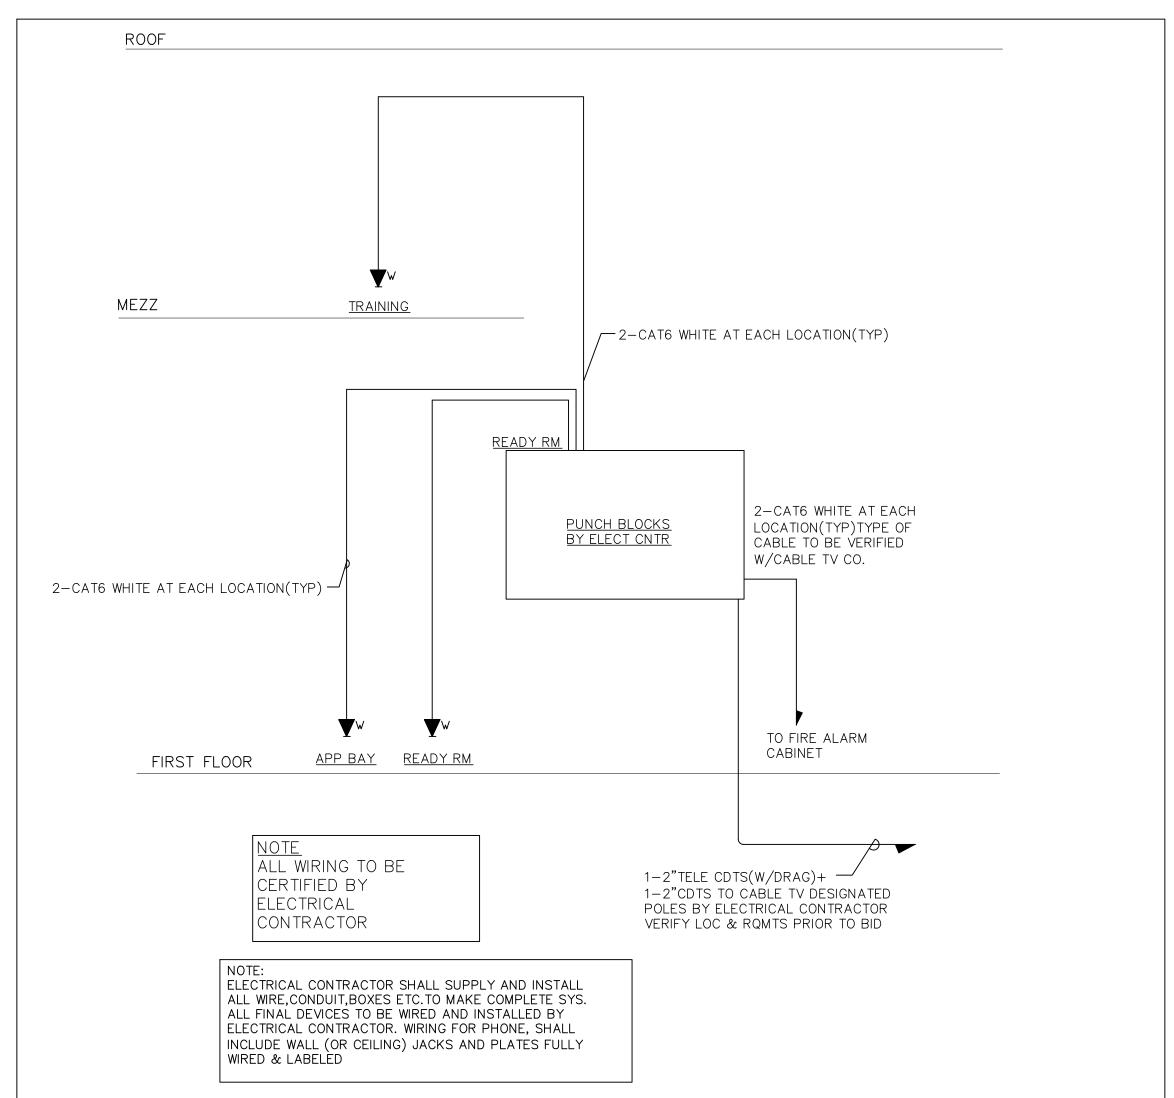


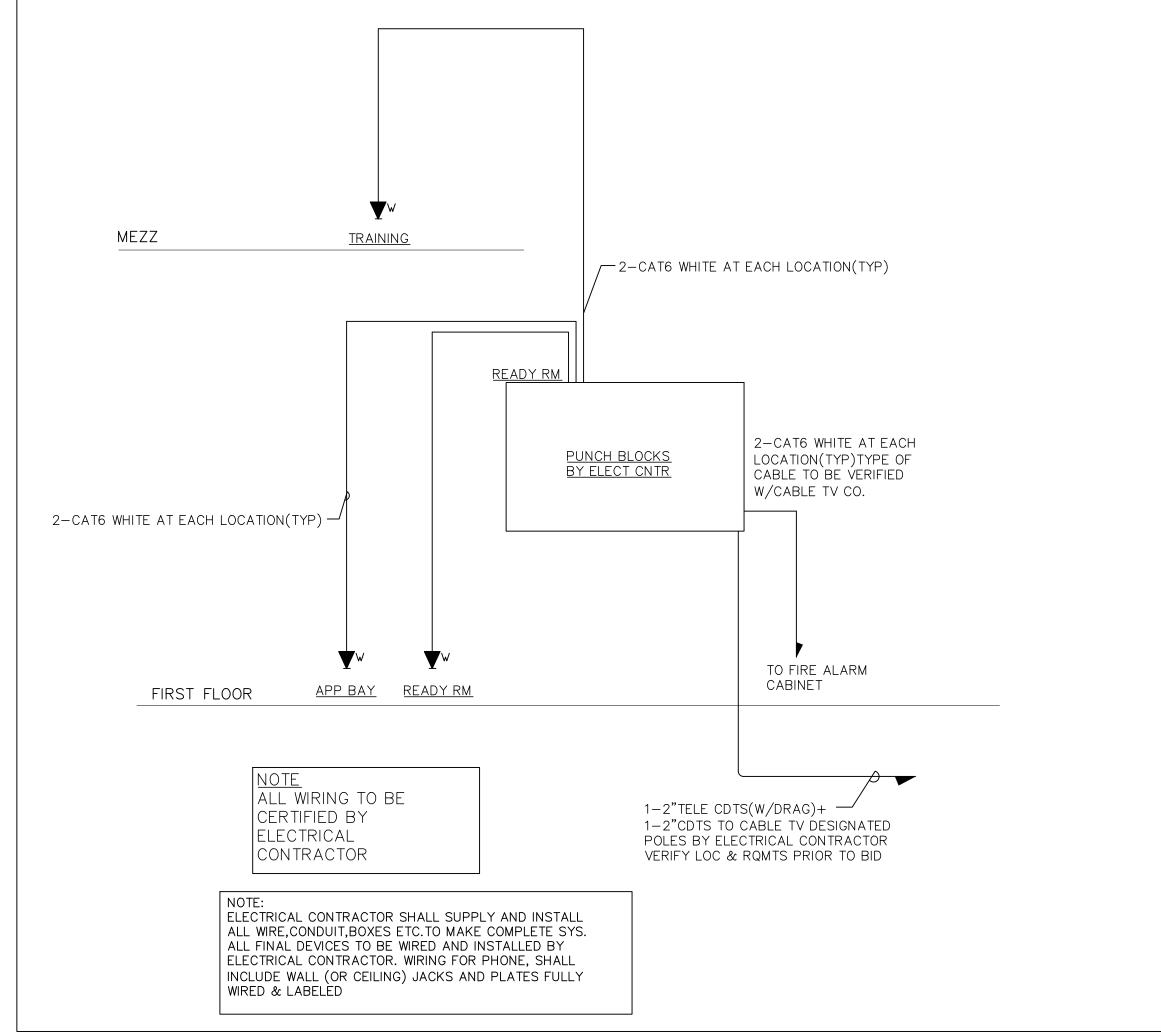

MISCELLANEOUS RISERS

SCALE: 1/4" = 1'-0"

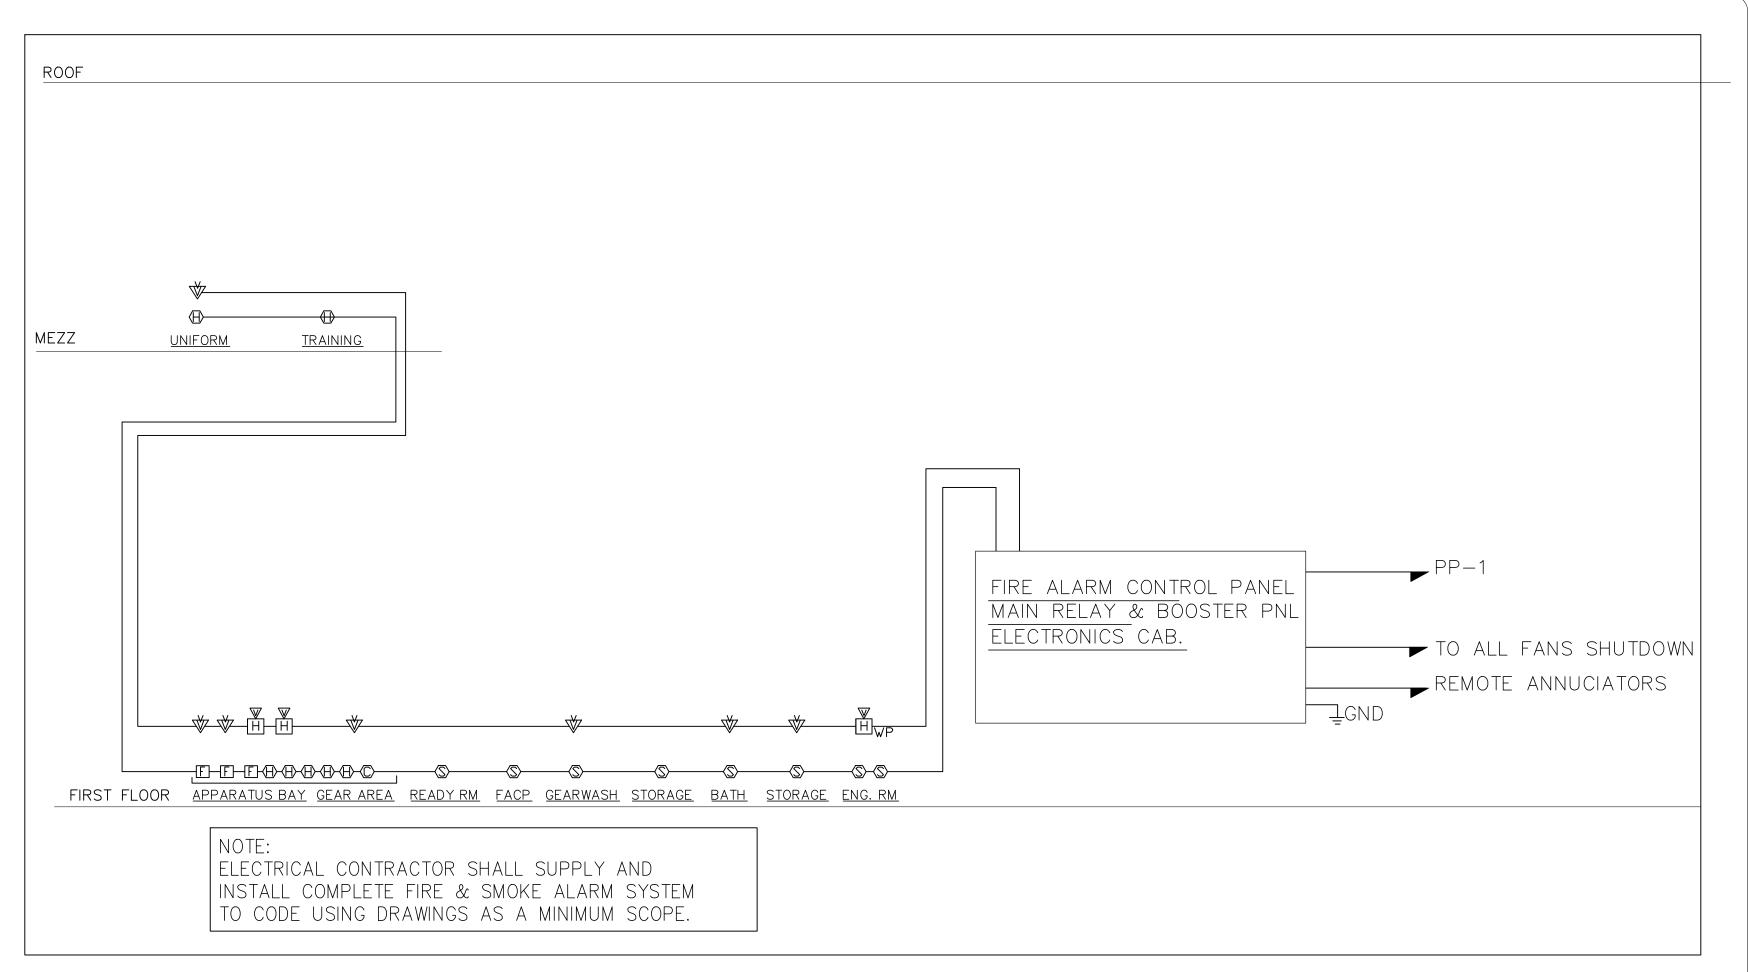

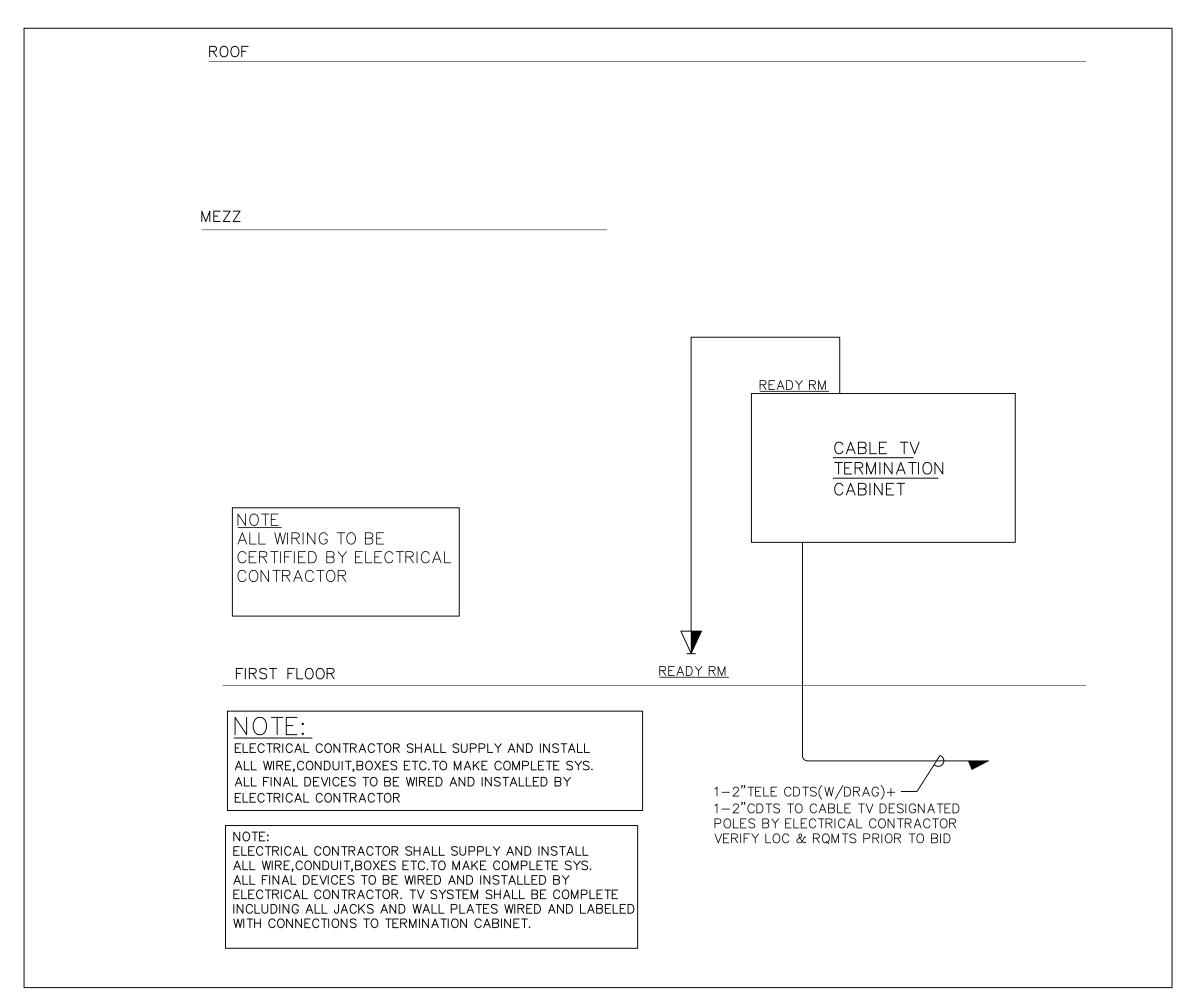

DATE: ISSUE 7.18.22 FOR BID

SEAL:

NDLEWSKI ARCHITECTS PC ARCHITECTS - PLANNERS

TAPPAN FIRE DISTRICT 300 WESTERN HWY S, TAPPAN NY, 10983


PROJECT #: 21-08


DRAWN BY:

CAD FILE: 21-08/P:/BID

# MISCELLANEOUS RISERS CONTINUED

SCALE: 1/4" = 1'-0"

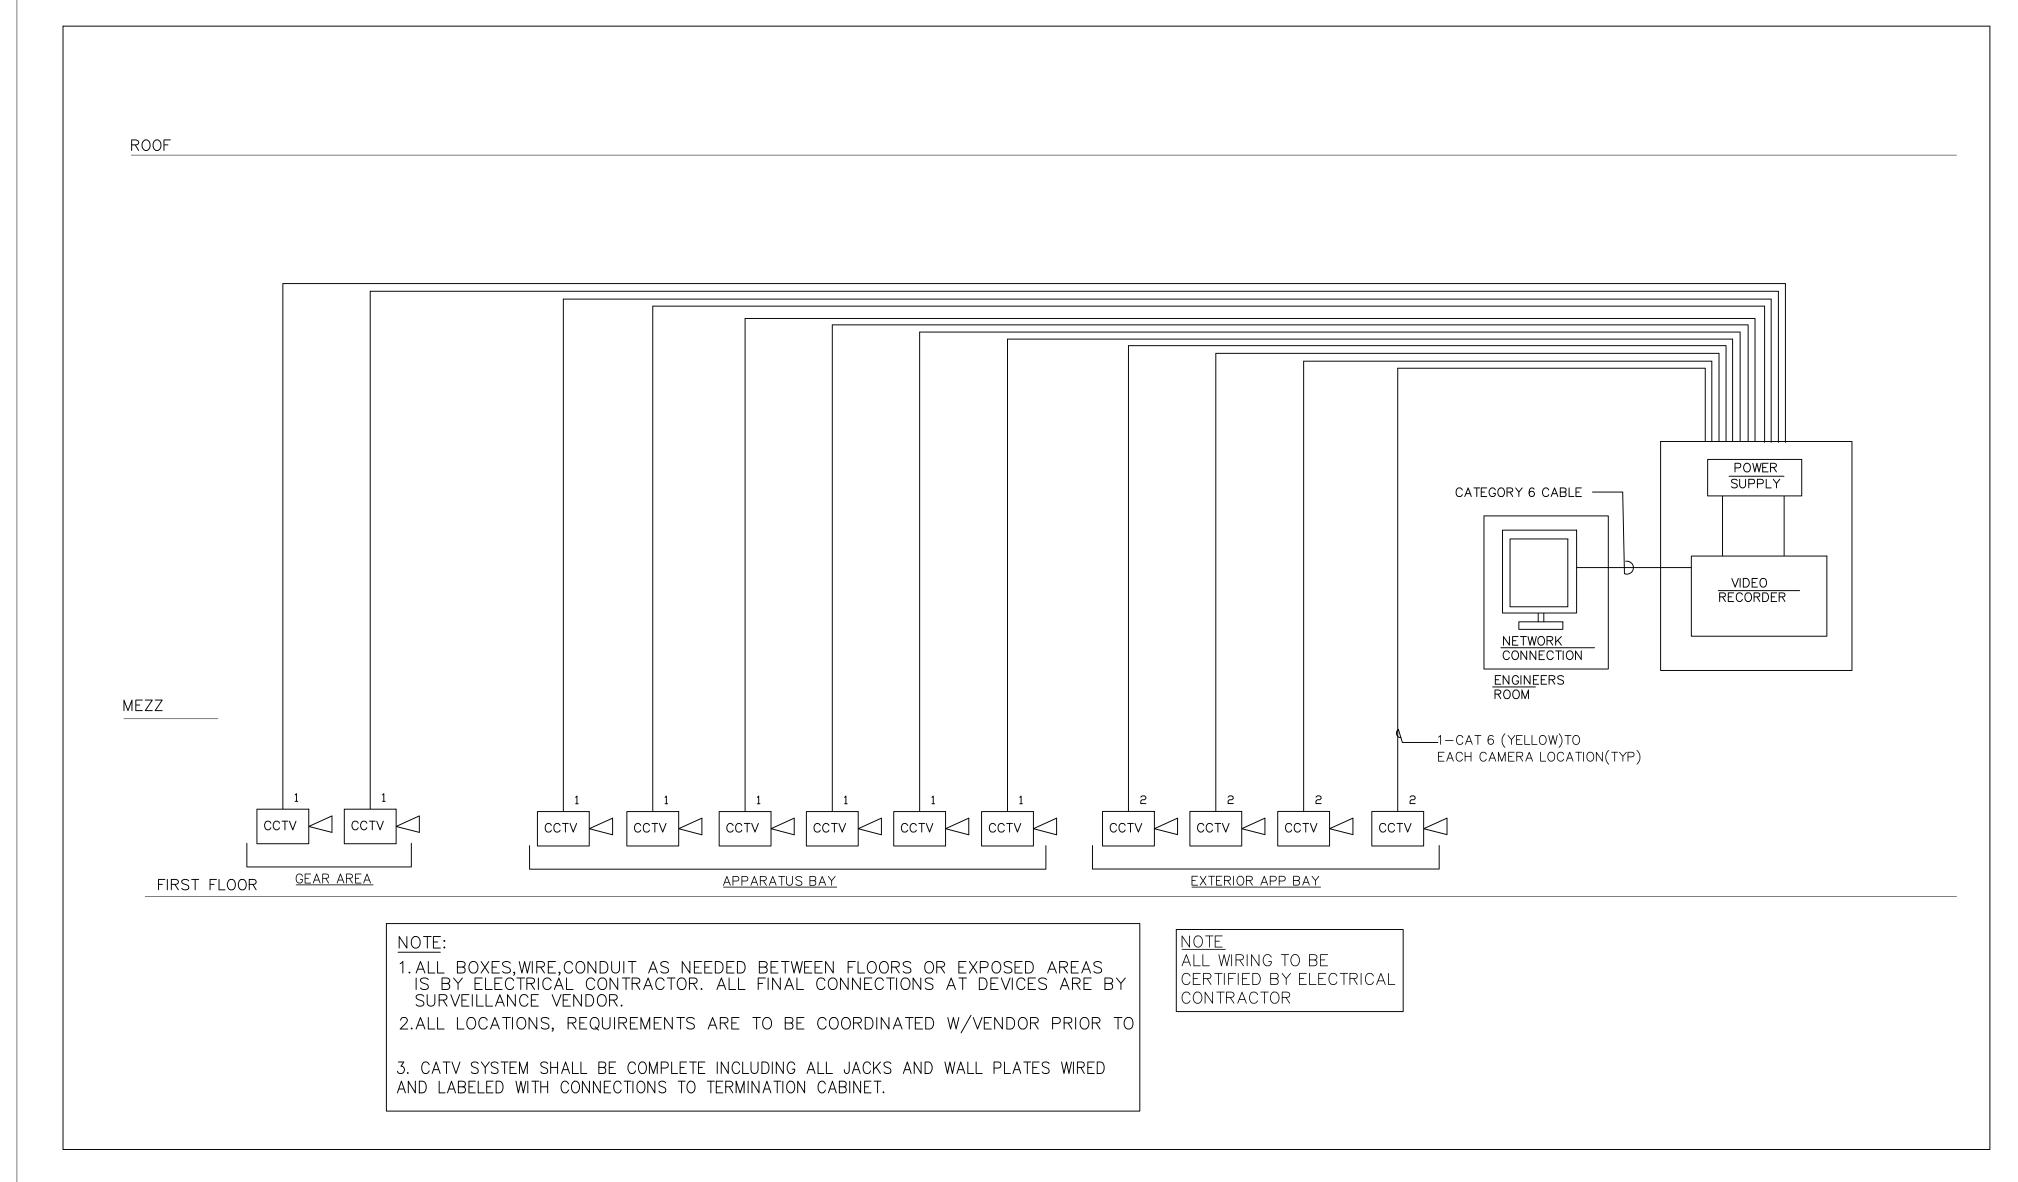

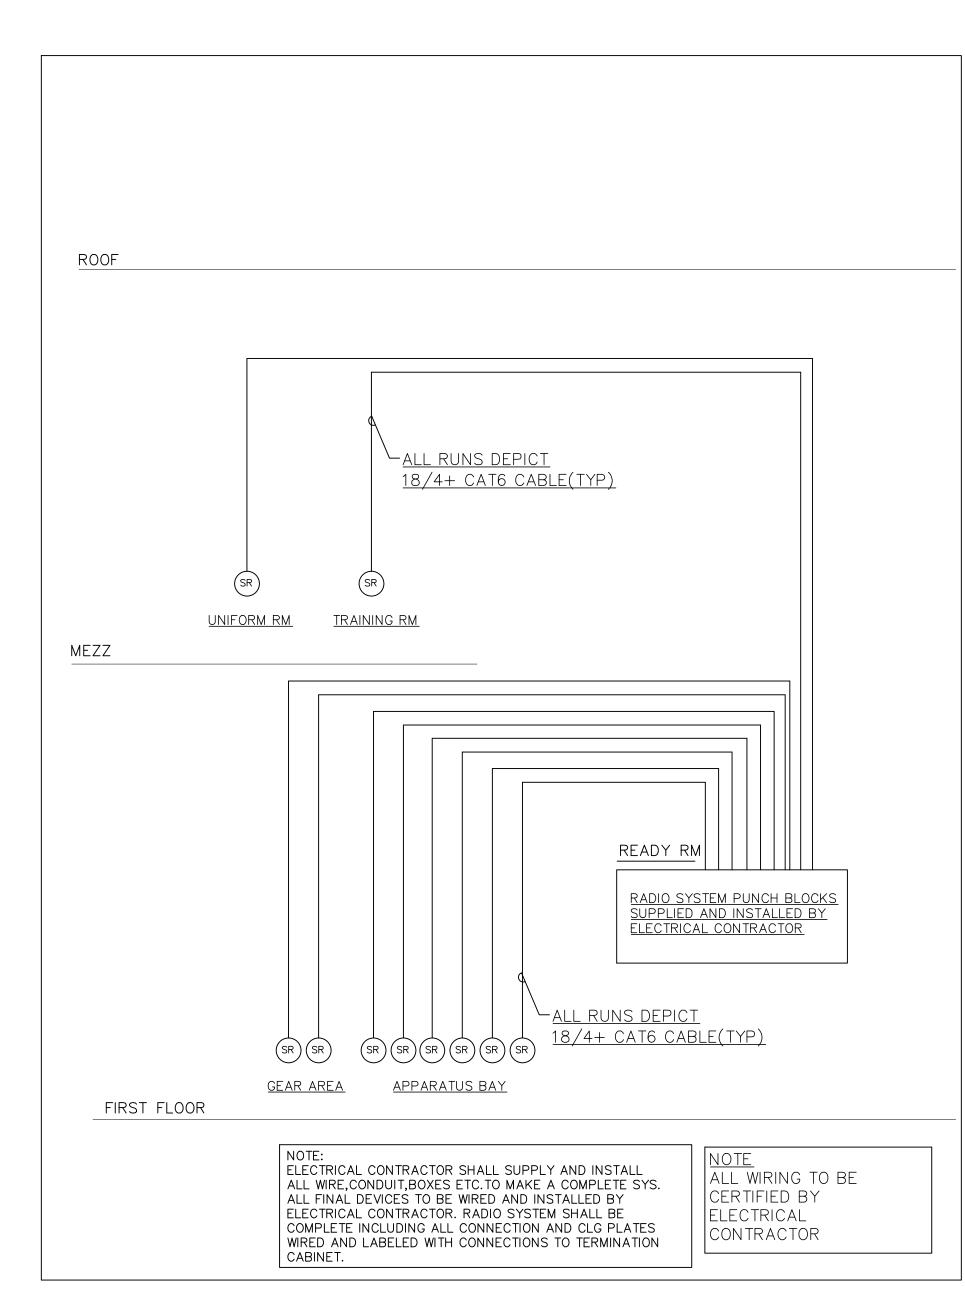

DATE: ISSUE

7.18.22 FOR BID

SEAL:

ENDLEWSKI ARCHITECTS PC ARCHITECTS - PLANNERS

TAPPAN FIRE DISTRICT 300 WESTERN HWY S, TAPPAN NY, 10983

PROJECT #: 21-08

DRAWN BY:

CAD FILE: 21-08/P:/BID