FLOW SWITCH

STAGE 2 BELL.

AUDIBLE /STROBE

PULL STATIONS

COIL SUPERVISORY (F.B.O.).

AIR COMPRESSOR, LOW PRESSURE (F.B.O.).

AIR COMPRESSOR, HIGH PRESSURE (F.B.O.).

TYPICAL DEVICE LOCATIONS

2 Typical Fire Alarm Device Location SCALE: NTS

SMOKE DETECTOR —

	LIST OF DRAWINGS					
NTS	FA2 001.00	FIRE ALARM LEGENDS AND RISER DIAGRAM				
	FA2 101A.00	PARTIAL FIRST FLOOR FIRE ALARM PLAN				
	FA2 101B.00	PARTIAL FIRST FLOOR FIRE ALARM PLAN				
	FA2 102A.00	PARTIAL SECOND/MEZZANINE FLOOR FIRE ALARM PLAN				
	FA2 102B.00	PARTIAL SECOND FLOOR FIRE ALARM PLAN				

NOTES:

- 1. ALL WIRING TO BE INSTALLED ACCORDING TO THE LATEST REVISION OF THE NATIONAL ELECTRIC CODE OR AS DICTATED BY CONTRACT SPECIFICATIONS, AND THE LATEST EDITION OF N.F.P.A 72 OR AS REQUIRED BY LOCAL ORDINANCE.
- 2. ALL CONDUCTORS MUST BE TEST FREE OF OPENS, SHORTS AND GROUNDS.
- 3. GROUNDING MUST COMPLY WITH THE NATIONAL ELECTRIC CODE. GROUNDING MUST BE NO. 12
- 4. ALL PANEL TERMINATIONS TO BE SUPERVISED BY A FACTORY AUTHORIZED TECHNICIAN PRIOR TO POWERING EQUIPMENT.
- 5. FOR COMPONENT WIRING AND INSTALLATION INFORMATION REFER TO MANUFACTURERS REQUIREMENTS.
- 6. REFER TO CONTRACT DRAWINGS FOR APPROXIMATE DEVICE LOCATIONS. DRAWINGS REPRESENT DEVICE QUANTITIES. SHOP DRAWINGS SHALL BE SUBMITTED SHOWING SCALED LOCATIONS. CONTRACTOR TO SUBMIT PLANS STAMPED BY LICENSED NEW YORK PROFESSIONAL ENGINEER ONLY. SHOP DRAWINGS WITHOUT P.E STAMP WILL BE AUTOMATICALLY REJECTED.
- INSTALL DETECTORS A MINIMUM OF 3'-0" FROM ANY SUPPLY OR RETURN AIR REGISTERS. COORDINATE EXACT LOCATIONS OF SUPPLY/RETURNS REGISTERS WITH MECHANICAL CONTRACTOR
- 8. WHEN INSTALLING SHIELDED CABLE THE FOLLOWING MUST BE OBSERVED:
- A. METALLIC CONTINUITY MUST BE MAINTAINED THROUGHOUT THE CABLE RUN.
- B. THE CABLE SHIELD MUST BE ISOLATED FROM GROUND AND TERMINATED ONLY IN THE ASSOCIATED CONTROL PANEL AT THE TERMINAL INDICATED ON THE CONTROL PANEL DRAWINGS. THE REMOTE END OF THE SHIELD (AT LAST DEVICE) MUST BE TAPED AND ISOLATED FROM GROUND.
- 9. ALL STROBE APPLIANCES SHALL BE SYNCHRONIZED. ALL ALARM INDICATING APPLIANCES SHALL SOUND A 'TEMPORAL 3' CODE PATTERN, UNLESS SYSTEM IS VOICE ACTIVATED.
- 10. AFTER ALARM INDICATION, ALL FANS SHALL BE MANUALLY RESET INDEPENDENT FROM F.A.C.P. SYSTEM RESET. PROVIDE ALL REQUIRED HARDWARE ACCESSORIES, MOTOR STARTERS, CONTROLS, POWER AND CONTROL WIRING AND CONDUITS TO PROVIDE INDEPENDENT RESET OF ALL FANS AFTER ALARM INDICATION.

CONTROL UNIT NOTIFICATION SUPPLEMENTARY

- 11. INSTALL ALL DEVICES IN ACCORDANCE WITH A.D.A REQUIREMENTS. ALL DEVICES SHALL BE **MOUNTED AS FOLLOWS:**
- A. MANUAL PULL STATIONS 48" O.C.
- B. ALARM INDICATING APPLIANCE 80" A.F.F.
- C. VERIFY WITH CONTRACT SPECIFICATIONS FOR ANY DEVIATIONS.

MONITOR MODULES AS REQUIRED BY MANUFACTURER.

- 12. STROBES SHALL BE WIRED TO REMAIN ACTIVE AFTER SILENCE FUNCTION IS PERFORMED. 13. PROVIDE AND INSTALL ALL NECESSARY CONTROL MODULES, SYNCHRONIZATION MODULES AND
- 14. COORDINATE INSTALLATION OF WATER FLOW AND TAMPER SWITCHES WITH SPRINKLER
- 15. CONTRACTOR TO INSTALL NECESSARY & REQUIRED POWER SUPPLY UNITS TO ENSURE PROPER OPERATION AT ALL MAGNETIC DOOR HOLDERS AS SHOWN ON DRAWINGS.
- 16. PROVIDE AND INSTALL ALL REQUIRED RELAYS TO RELEASE ELECTRIC DOOR LATCHES.
- 17. COORDINATE EXACT LOCATION OF REMOTE ANNUNCIATOR AND F.A.C.P. WITH LOCAL FIRE MARSHALL AND OWNER.
- 18. PROVIDE ALL REQUIRED DUCT SMOKE DETECTORS. CONTRACTOR TO INSTALL DUCT SMOKE DETECTORS. CONTRACTOR TO INTERFACE ALL DUCT DETECTORS WITH FACP.
- 19. CONTRACTOR TO INSTALL NECESSARY COMPONENTS FOR ELEVATOR RECALL AS PER LOCAL FIRE MARSHALL. EACH LOBBY, MACHINE ROOM AND PIT TO HAVE SMOKE DETECTION. WHERE APPLICABLE CONTRACTOR TO COORDINATE AND INSTALL NECESSARY COMPONENTS TO INTERFACE FIRE ALARM SYSTEM, ELEVATOR, AND SPRINKLER HEAD SOLENOID VALVES LOCATED IN THE ELEVATOR SHAFT.
- 20. CONTRACTOR SHALL PROVIDE TWO TELEPHONE LINES AND TELEPHONE JACKS. PROVIDE ALL REQUIRED WIRING/CONDUIT TO LOCATE NEW TELEPHONE JACKS ADJACENT TO FACP.
- 21. FIRE ALARM RISER DIAGRAM IS SCHEMATIC. REFER TO FLOOR PLANS FOR DEVICE TYPES AND QUANTITIES.

- 22. ALL HVAC EQUIPMENT WITH A CFM RATING OF 1000 CFM OR GREATER SHALL BE INTERCONNECTED TO THE FIRE ALARM SYSTEM AND SHUT DOWN UPON FIRE ALARM SYSTEM ALARM ACTIVATION. CONTRACTOR SHALL ALSO PROVIDE AND INSTALL NEW RETURN DUCT SMOKE DETECTORS WITH REMOTE LED'S FOR ALL HVAC UNITS WITH A CFM RATING OF 2000 CFM
- 23. IN ADDITION TO DEVICES SHOWN ON THE DRAWINGS CONTRACTOR TO PROVIDE FIVE SMOKE DETECTORS, FIVE HEAT DETECTORS, FIVE PULL STATIONS, FIVE HORN STROBES, FIVE STROBES AND FIVE CARBON MONOXIDE DETECTORS. EACH DEVICE SHALL BE INCLUDED WITH 100' OF WIRING AND/OR CONDUIT.
- 24. PROTECTIVE SHIELDS SHALL BE PROVIDED FOR ALL PULL STATIONS. SHIELDS SHALL FIT OVER MANUAL PULL STATIONS AND SHALL INCLUDE A BATTERY OPERATED PIERCING HORN WHEN THE SHIELD IS REMOVED.
- 25. PLENUM WIRING TO BE USED IN ALL AREAS ABOVE DROP CEILINGS. CONDUIT MUST BE USED IN ALL MECHANICAL AND ELECTRICAL ROOMS. CONDUIT MUST ALSO BE USED IN ALL AREAS WITH
- 26. ALL EQUIPMENT TO BE RECESSED MOUNTED AND ALL WIRING AND CONDUIT TO BE RUN CONCEALED
- 27. HEAT DETECTOR MOUNTED IN THE ELEVATOR SHAFT MUST BE WITHIN 2' OF THE SPRINKLER
- 28. ON WATER FLOW, AND IF THE F.A.C.P WAS NOT IN ALARM, THE PRESSURE SWITCH WILL PUT THE SYSTEM IN ALARM TURNING ON AV'S, STAGE 2 BELL AND SEND SIGNALS TO CENTRAL STATION
- 29. TS (TAMPER SWITCH), CH (AIR COMPRESSOR HIGH PRESSURE), CL (AIR COMPRESSOR LOW PRESSURE), SHALL CAUSE A SUPERVISORY TROUBLE AT THE F.A.C.P AND SEND A SIGNAL TO CENTRAL STATION IF SYSTEM IS MONITORED.

MECHANICAL EQUIPMENT

EQUIPMENT NAME

CU-1,2

DOAS-1

GX-1

UH-1,2,3,4

LRS-1

RTU-208

OU-1

TX-1

EU-114,203,212,213,214,215,216

EU-120,211

EU-125A

AIRFLOW CHART (NOTE 22)

AIRFLOW (CFM)

11300

4250

3240

1250


1200

1165

700

265

283

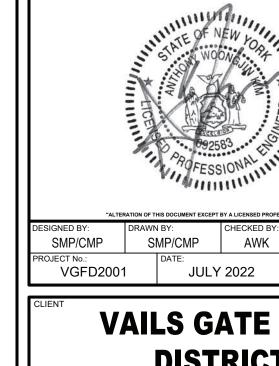

VAILS GATE FIRE DISTRICT

538 Broad Hollow Road, 4th Floor East

Melville, NY 11747

631.756.8000 • www.h2m.com

DESCRIPTION

AWK

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ONSULTANTS:

MARK DATE

New Storage Building (Phase I) New Fire Station (Phase II)



872 Blooming Grove Turnpike New Windsor, NY 12553

CONTRACT G GENERAL CONSTRUCTION

FINAL BID DOCUMENT

FIRE ALARM LEGENDS **AND RISER DIAGRAM** PHASE 2

FA2 001.00

FAN RESET IS INDEPENDENT OF FIRE TWO TELEPHONE LINES (PROVIDE TWO RJ-31X JACKS) AND ALL ASSOCIATED WIRING. Fire Alarm Riser Diagram (Note 21)

SCALE: NTS


NIRE LEGEND						
	WIRE DESCRIPTION	TYPE	NOTES			
Α	1 PAIR TWISTED SHIELDED #18 AWG	FPLP	-			
В	1 PAIR #18 AWG. NON-SHIELDED	FPLP	-			
С	1 PAIR #14 AWG. NON SHIELDED	FPLP	-			
D	#12 AWG. NON SHIELDED	THHN	*			
E	#14 AWG. NON SHIELDED	THHN	-			
F	1 PAIR TWISTED SHIELDED #16 AWG.	FPLP	-			


(2)	Fire Alarm Sequence of Operation	
(3)	SCALE: NOT TO SCALE	_

	ACTUATE COMM	ACTUATE VISUA	ACTUATE COMM	ACTUATE COMM	ACTUATE ZONE	ACTUATE FULL E	DISPLAY CHANG	TRANSMIT FIRE	
MANUAL PULL STATION									
SMOKE DETECTOR									
HEAT DETECTOR									
DUCT DETECTOR									
CARBON MONOXIDE DETECTOR									
FIRE PANEL AC POWER FAILURE									
FA SYSTEM LOW BATTERY									
OPEN CIRCUIT									
GROUND FAULT									
NOTIFICATION APPLIANCE CIRCUIT SHORT									

EU-118,202


PROVIDE ALL 120 VOLT CIRCUITS IN CONDUIT.

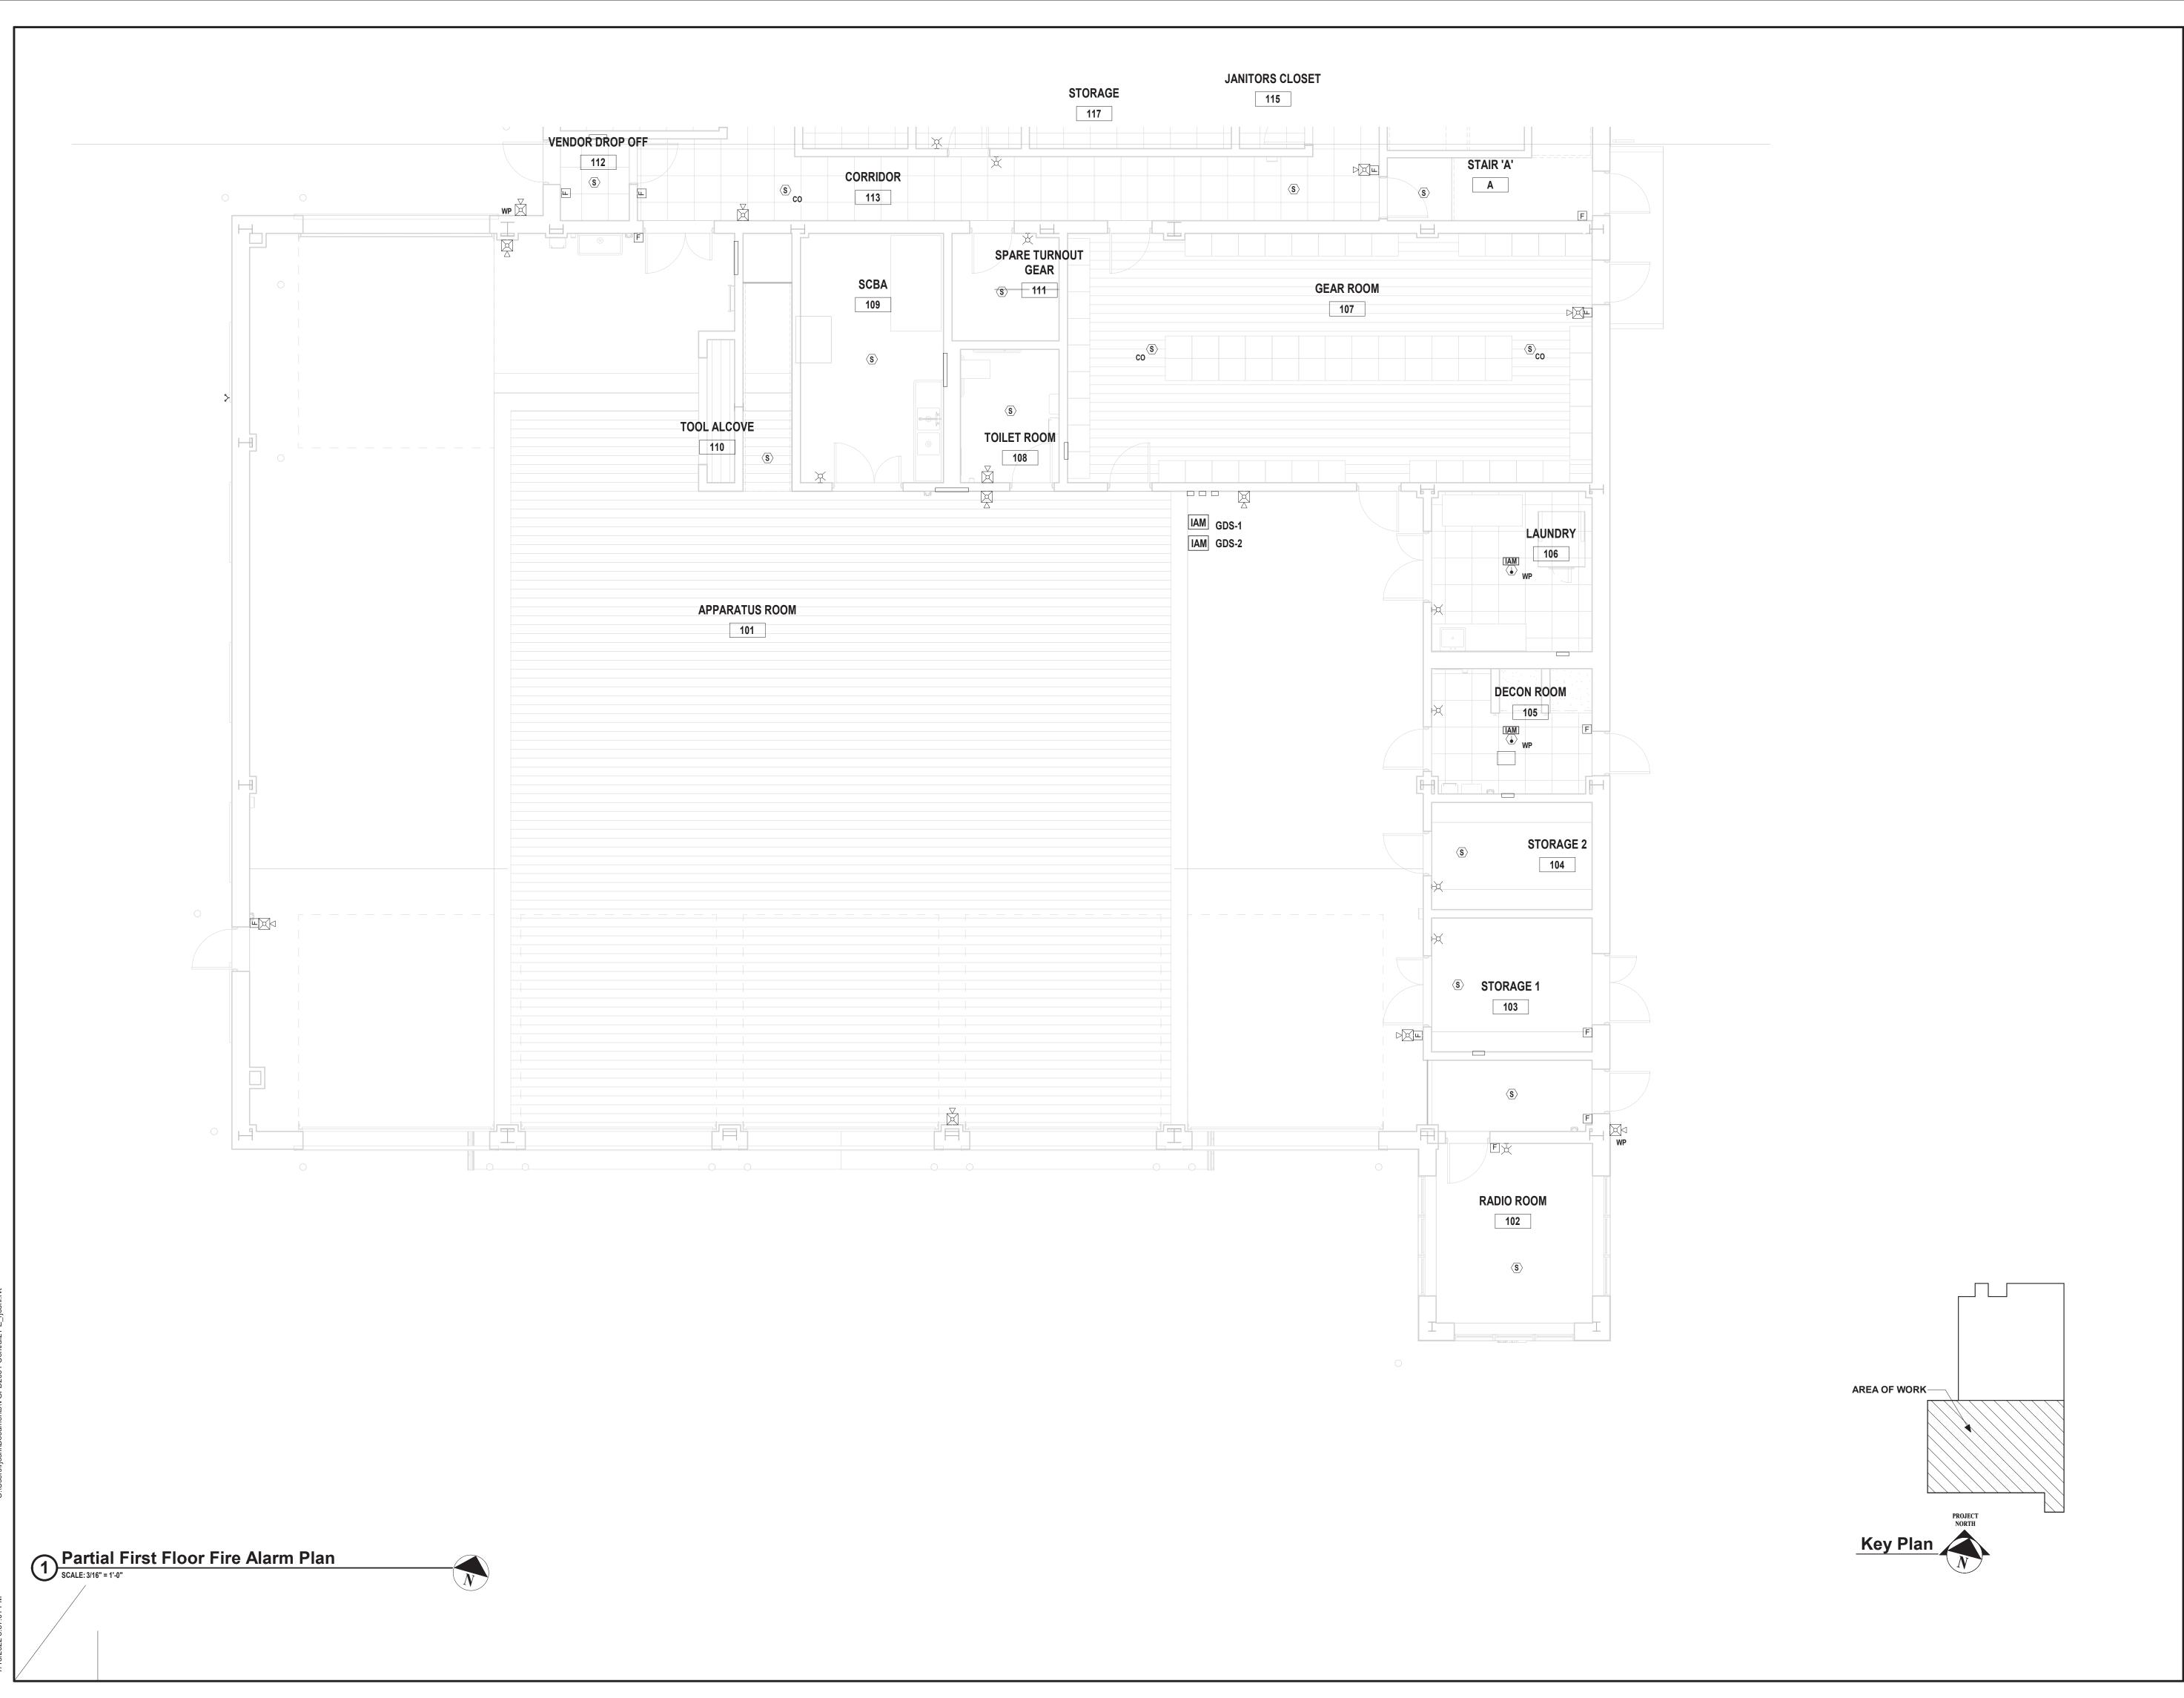

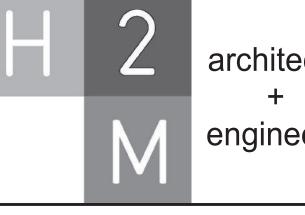

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VGFD2001

VAILS GATE FIRE
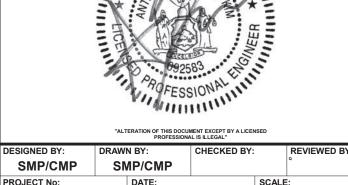
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New Storage Building (Phase I) New Fire Station (Phase II)

DISTRICT



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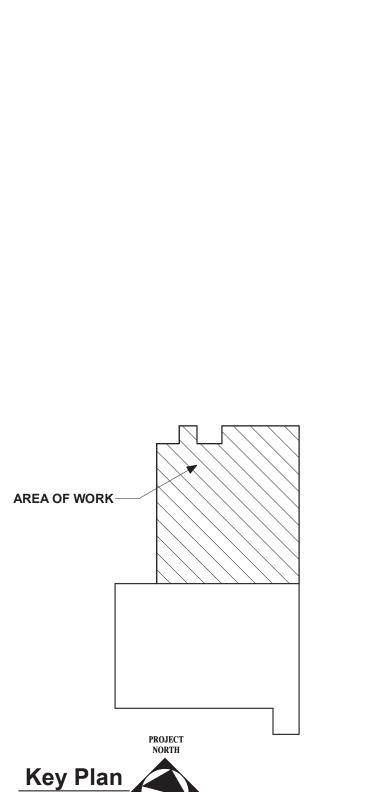
CONTRACT G
GENERAL CONSTRUCTION


REGULATORY REVIEW

SHEET TITLE

PARTIAL FIRST FLOOR FIRE ALARM
PLAN
NEW FIRE STATION
PHASE 2


FA2 101A.00



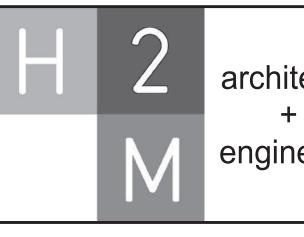

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VAILS GATE FIRE DISTRICT

New Storage Building (Phase I) New Fire Station (Phase II)

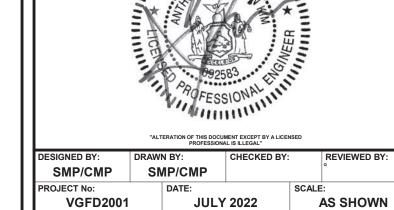

872 Blooming Grove Turnpike New Windsor, NY 12553

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REGULATORY REVIEW

SHEET TITLE

PARTIAL FIRST FLOOR FIRE ALARM
PLAN
NEW FIRE STATION
PHASE 2

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New Storage Building (Phase I) New Fire Station (Phase II)



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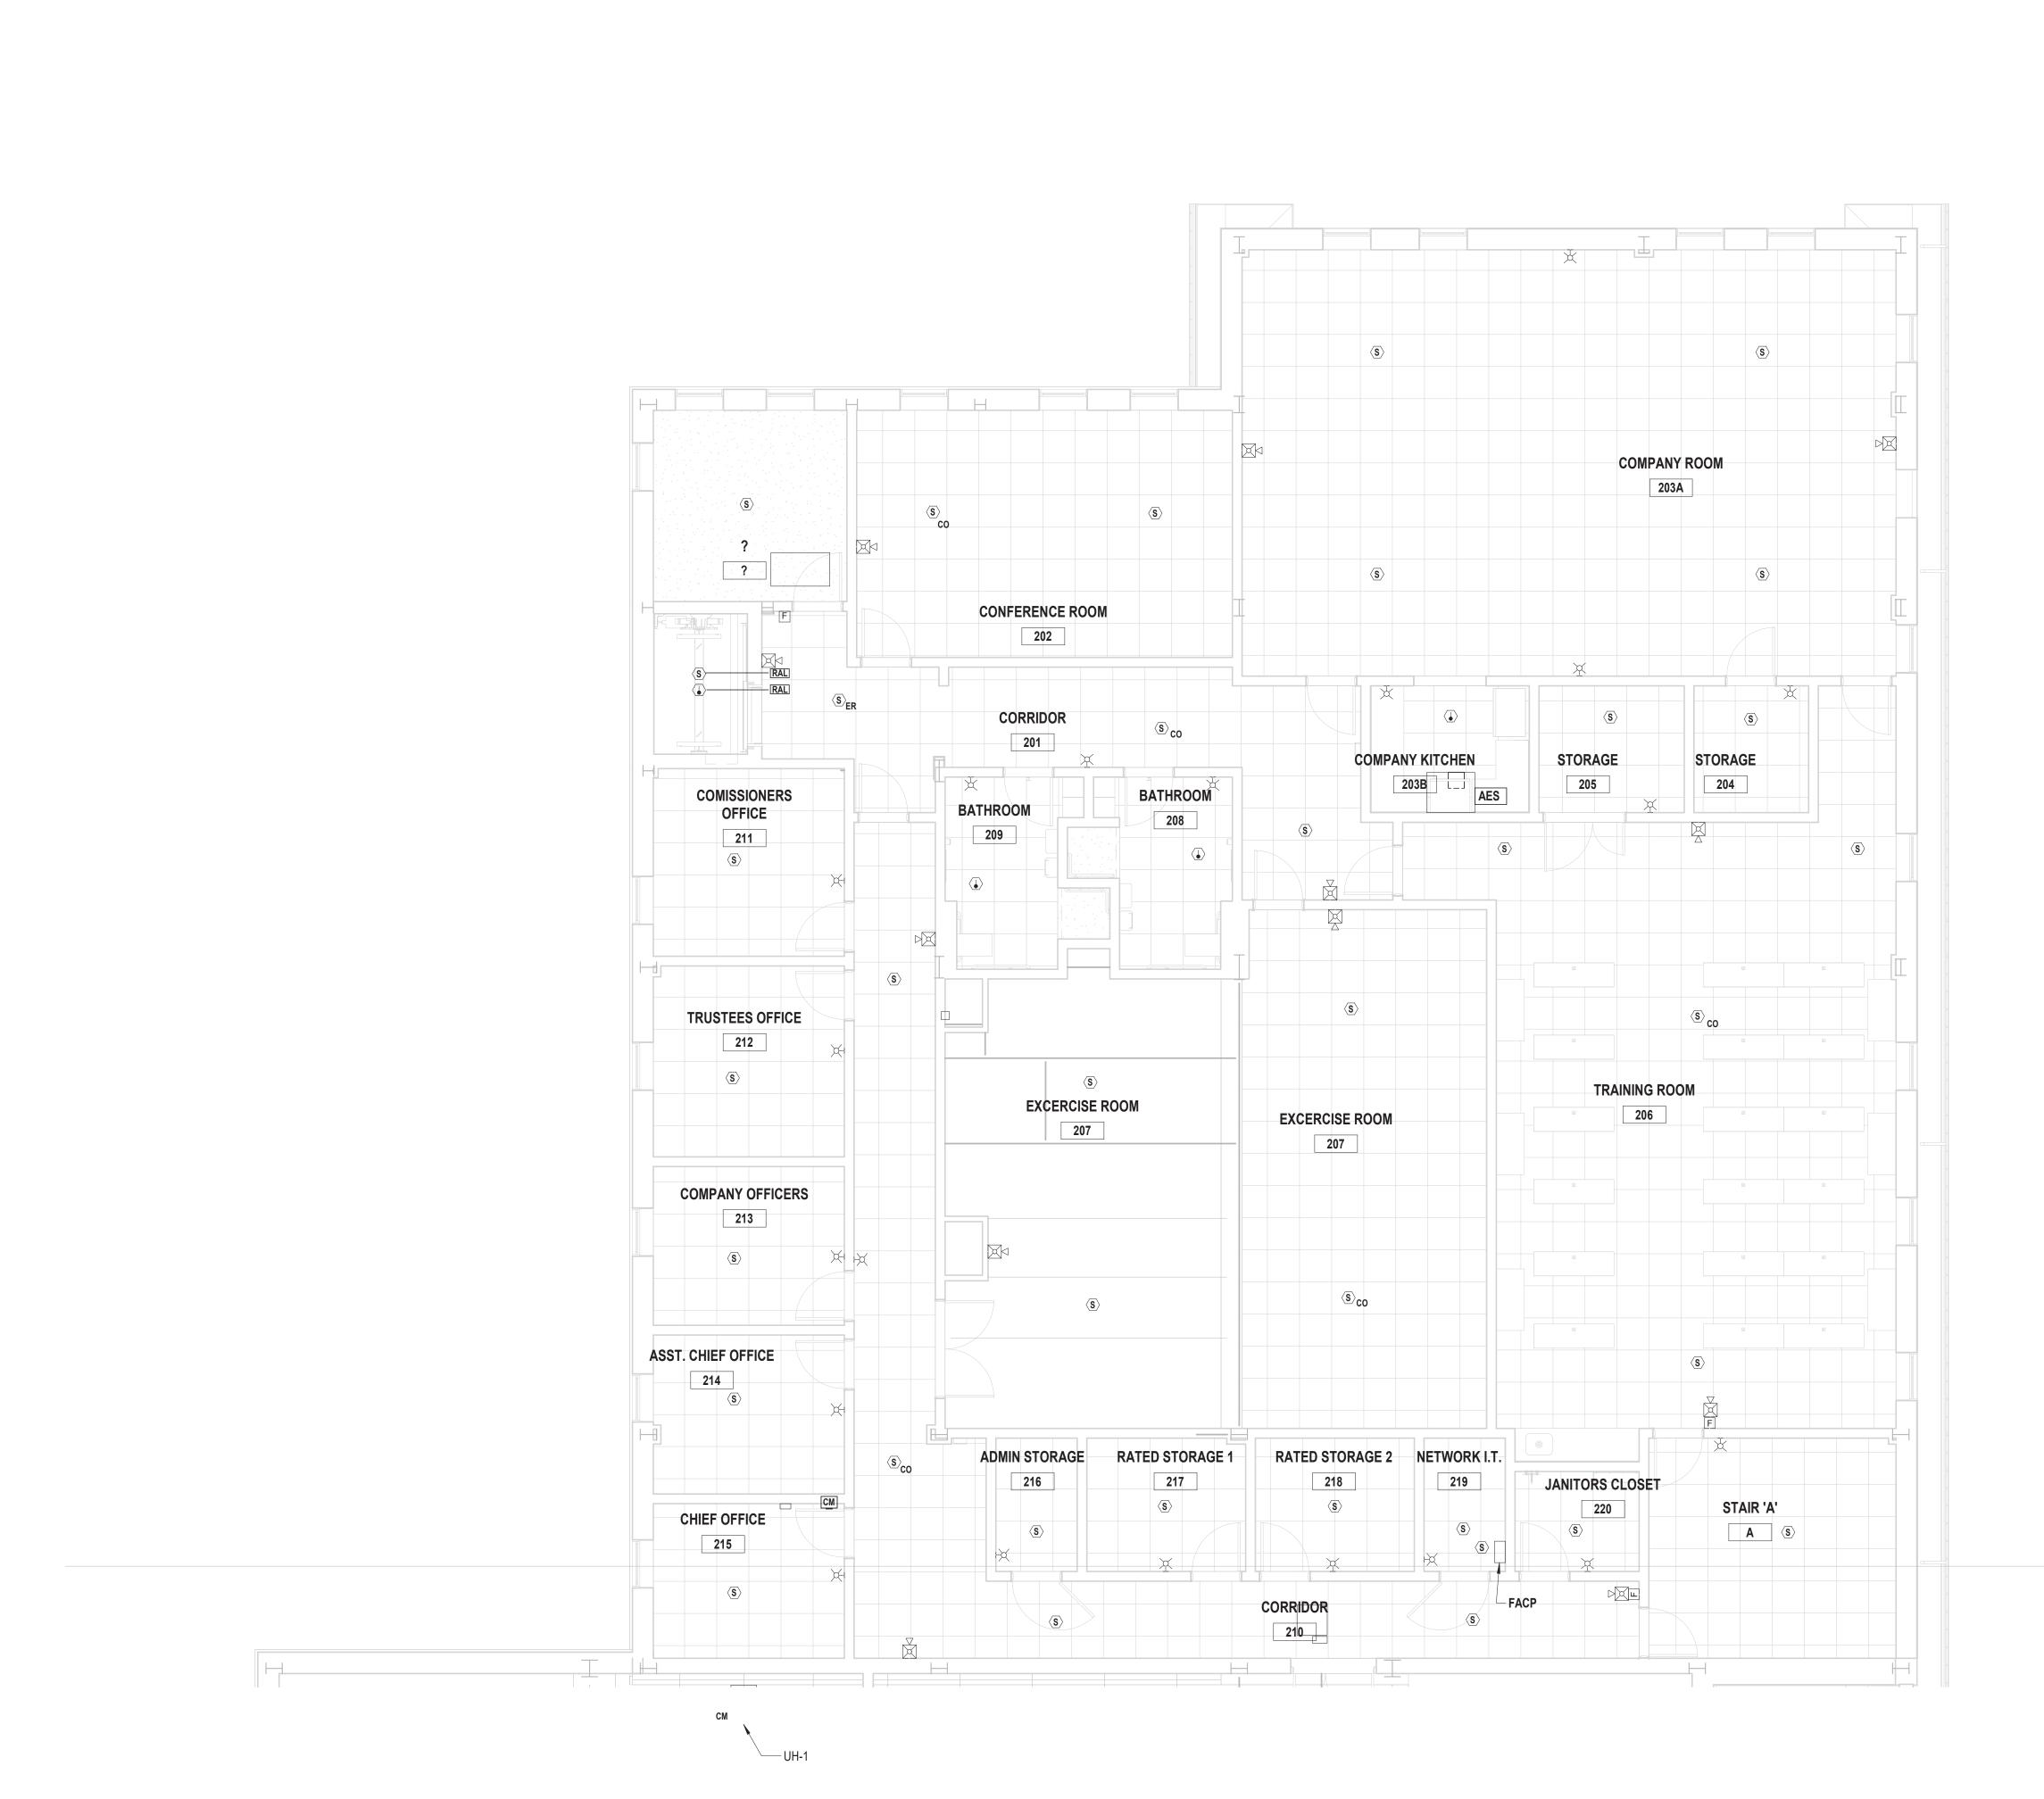
REGULATORY REVIEW


PARTIAL SECOND / MEZZANINE FLOOR FIRE ALARM PLAN
NEW FIRE STATION
PHASE 2

FA2 102A.00


Partial Second / Mezzanine Floor Fire Alarm Plan

SCALE: 3/16" = 1'-0"



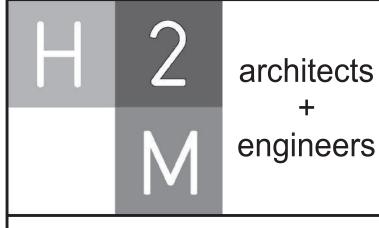

		55000000000
MARK	DATE	DESCRIPTION

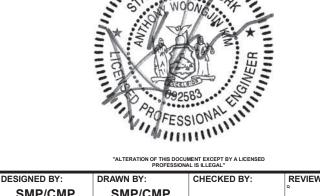

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SMP/CMP	SMP/CMP				Q .		
ROJECT No:		DATE:		SCALE	:		
VGFD2001		JULY	2022	1	AS SHOW		

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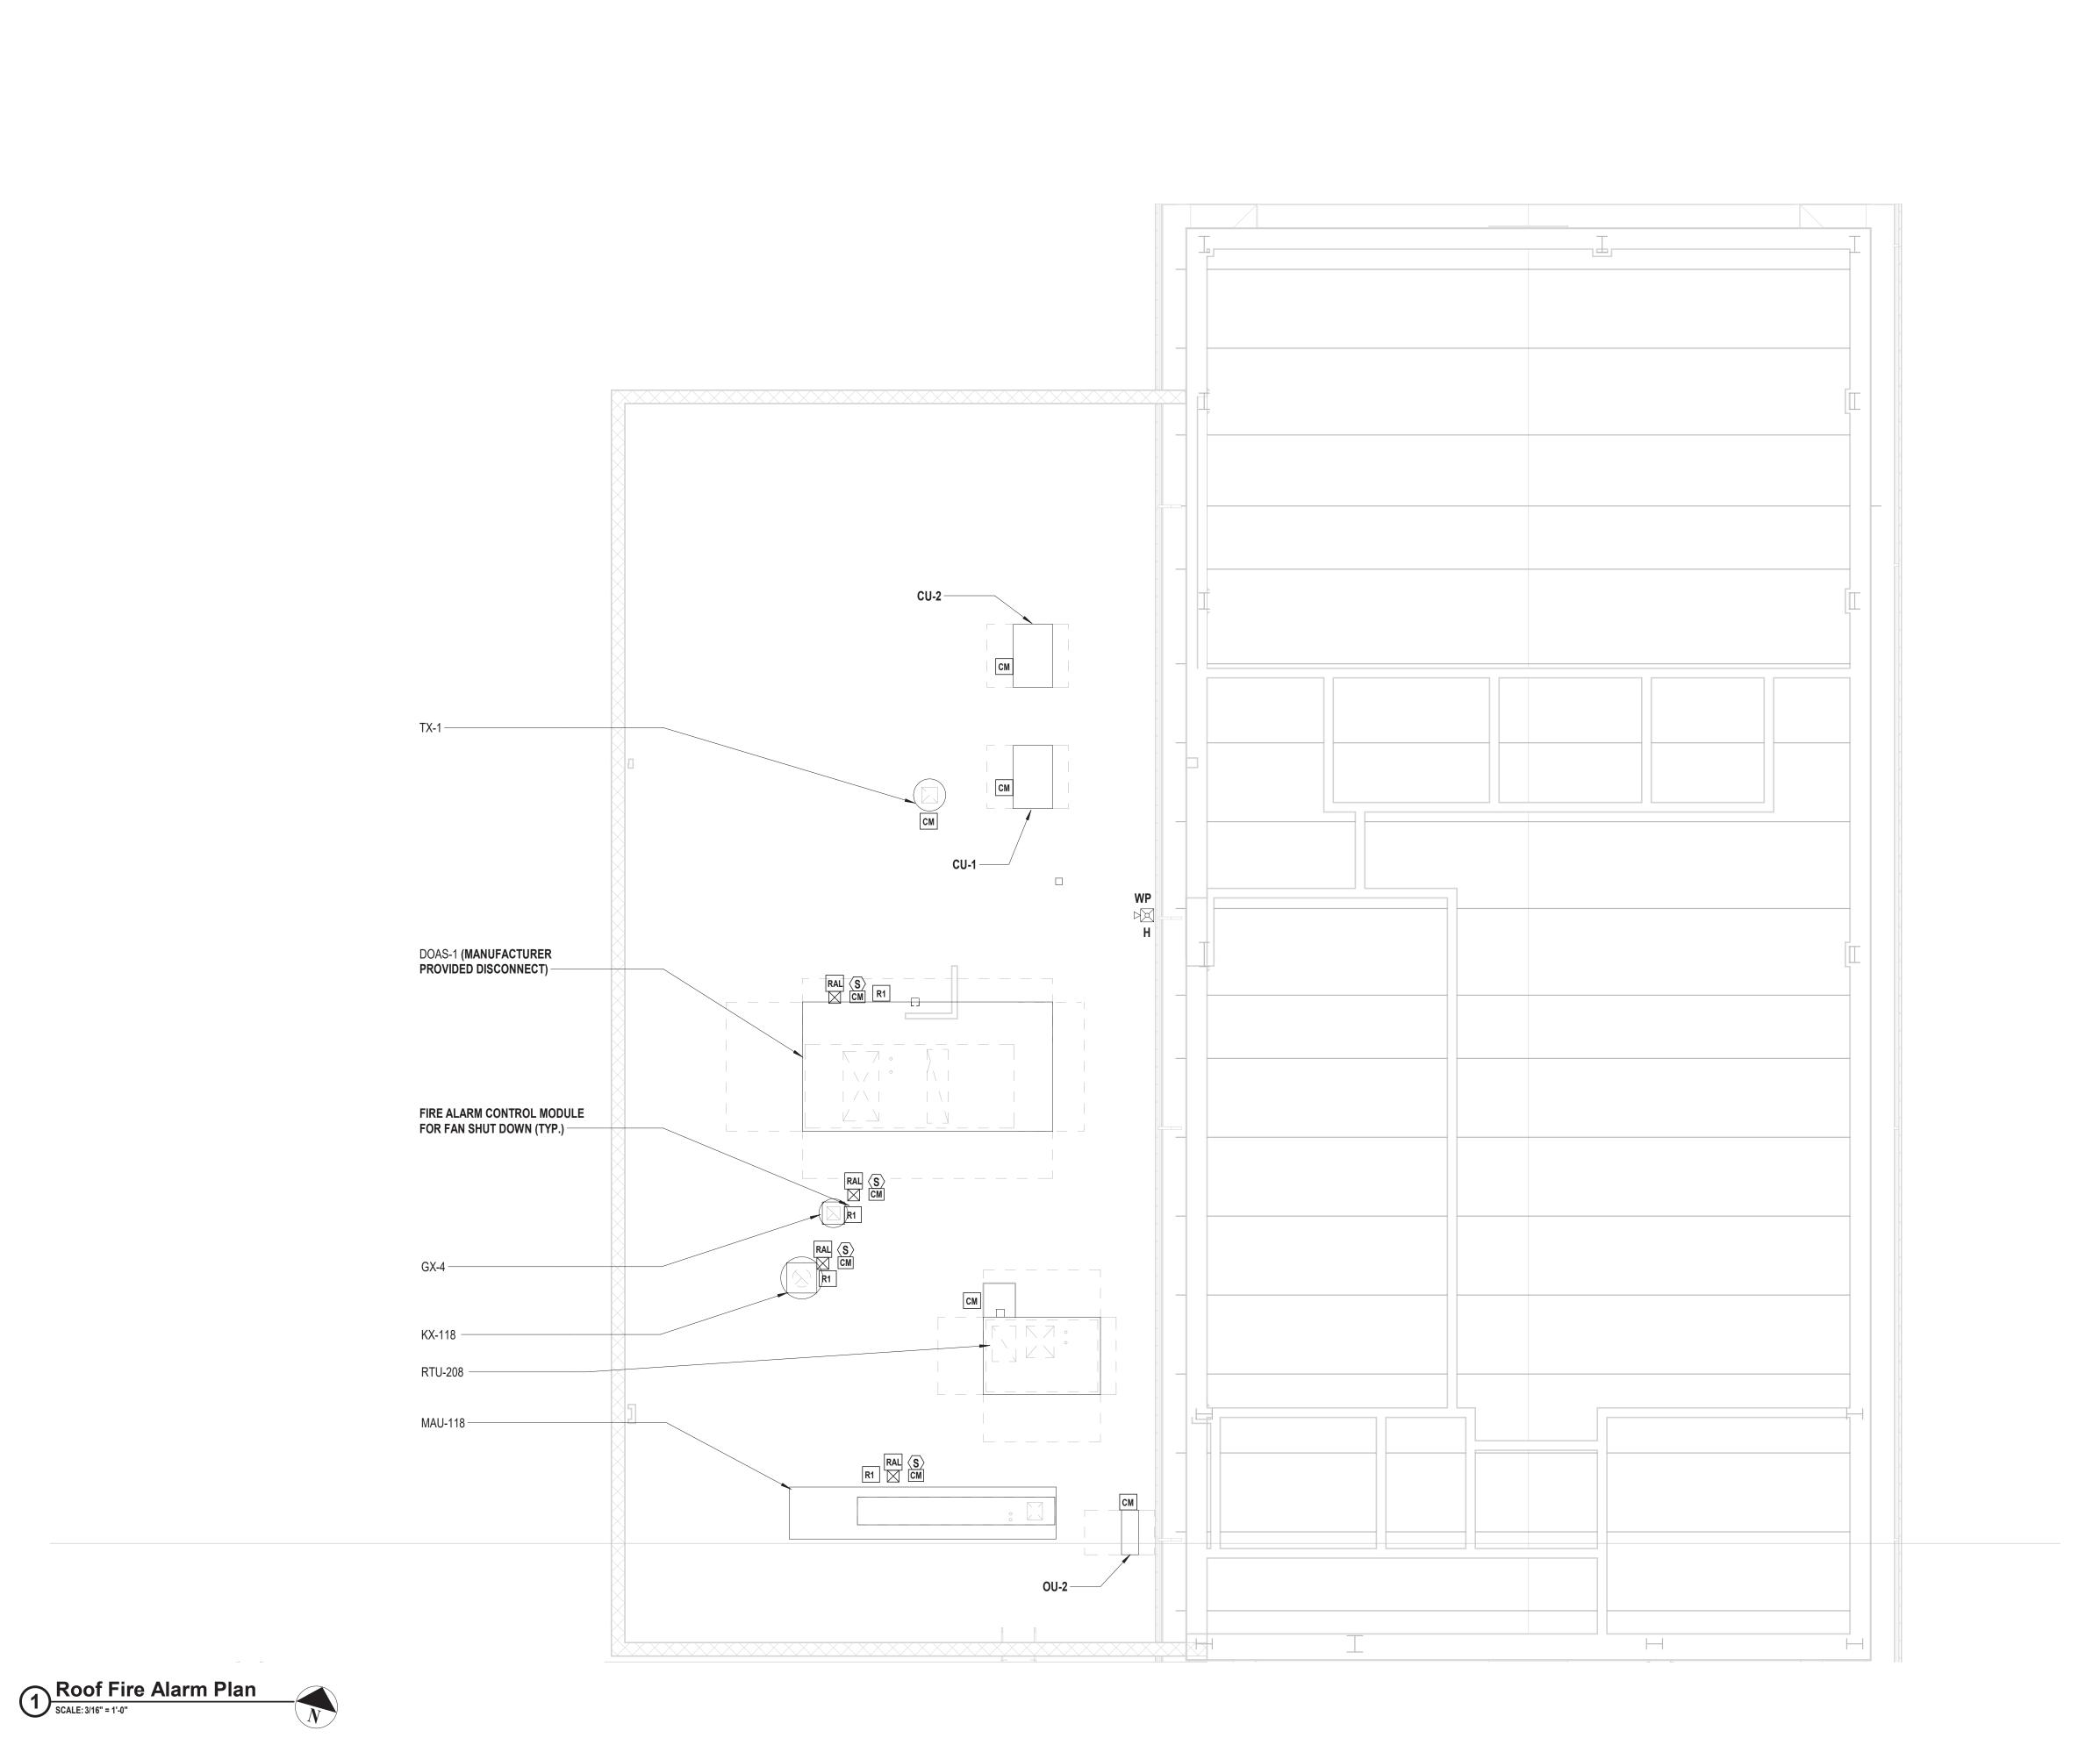
AREA OF WORK-


PARTIAL SECOND FLOOR FIRE
ALARM PLAN
NEW FIRE STATION
PHASE 2

FA2 102B.00

Partial Second Floor Fire Alarm Plan


SCALE: 3/16" = 1'-0"



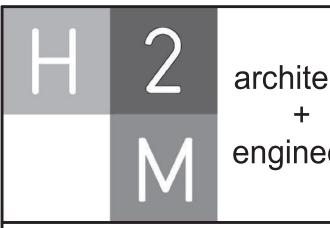

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AREA OF WORK-

ROOF FIRE ALARM PLAN NEW FIRE STATION PHASE 2

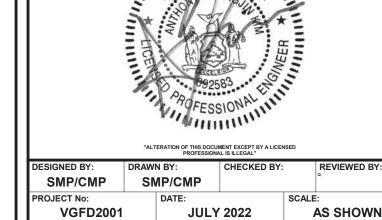FA2 130.00

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