


WESTCHESTER COUNTY



WESTCHESTER COUNTY, NEW YORK
DEPARTMENT OF PUBLIC WORKS AND TRANSPORTATION
DIVISION OF ENGINEERING

CONTRACT No. 23-532-Rev.

TERMINAL BUILDING HVAC-1 AND HVAC-2 UPGRADES
WESTCHESTER COUNTY AIRPORT
TOWNS OF HARRISON AND NORTH CASTLE
AND VILLAGE OF RYE BROOK, NEW YORK

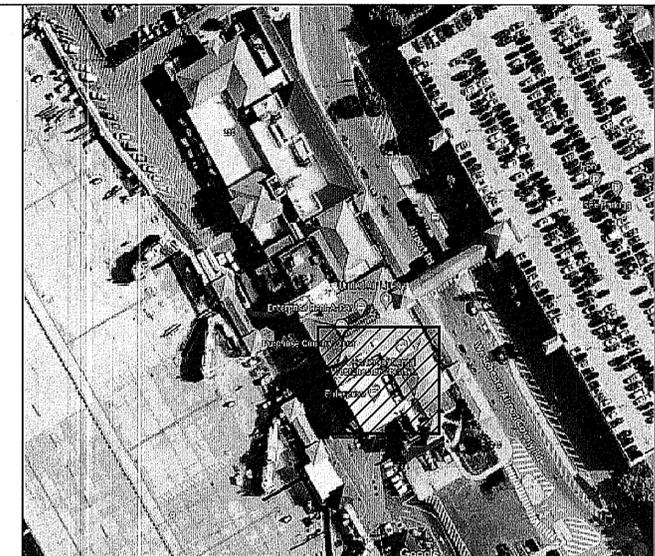

LOCATION MAP
SCALE: N.T.S.

SHEET NO.	SHEET TITLE	DPW FILE NO.
T001	COVER SHEET	48-15-T-874-0
S-201	STRUCTURAL FLOOR PLAN	48-15-S-875-0
S-300	STRUCTURAL DETAILS AND NOTES	48-15-2-876-0
GC-201	GENERAL CONSTRUCTION DEMO AND NEW WORK PLAN	48-15-G-877-0
GC-701	GENERAL CONSTRUCTION DETAILS	48-15-G-878-0
M-001	MECHANICAL SYMBOLS, ABBREVIATIONS, AND GENERAL NOTES	48-15-M-879-0
M-101	MECHANICAL DEMOLITION FIRST FLOOR PART PLAN	48-15-M-880-0
M-201	MECHANICAL NEW WORK FIRST FLOOR PART PLAN	48-15-M-881-0
M-202	MECHANICAL NEW WORK FIRST FLOOR PLAN	48-15-M-882-0
M-601	MECHANICAL SCHEDULES	48-15-M-883-0
M-701	MECHANICAL DETAILS	48-15-M-884-0
M-702	MECHANICAL DETAILS	48-15-M-885-0
E001	ELECTRICAL SYMBOLS, ABBREVIATIONS AND GENERAL NOTES	48-15-E-886-0
E101	ELECTRICAL FIRST FLOOR PART PLAN - DEMOLITION	48-15-E-887-0
E201	ELECTRICAL FIRST FLOOR PLAN - NEW WORK	48-15-E-888-0
E301	ELECTRICAL ONE-LINE DIAGRAM AND PLANS	48-15-M-889-0
SP-001	SPRINKLER SYMBOLS, ABBREVIATIONS, AND GENERAL NOTES	48-15-SP-890-0
SP-201	SPRINKLER SYMBOLS, ABBREVIATIONS, AND GENERAL NOTES	48-15-SP-891-0
SP-701	SPRINKLER SYMBOLS, ABBREVIATIONS, AND GENERAL NOTES	48-15-SP-892-0



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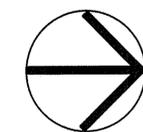
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PROJECT NORTH

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REVISION NUMBER	DATE	MADE BY	APP'D BY	REVISION

RECORD DRAWING CERTIFICATION

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- AS BUILT - NO CHANGES

CONTRACTOR		PROJECT COORDINATOR	
NAME	SIGNATURE	NAME	SIGNATURE
TITLE	DATE	TITLE	DATE

WESTCHESTER COUNTY, NEW YORK
DEPARTMENT OF PUBLIC WORKS AND TRANSPORTATION
DIVISION OF ENGINEERING

CONTRACT NUMBER: 23-532-Rev. SHEET NUMBER: T-001
SHEET NO. 1 OF 19

SCALE: AS SHOWN
DATE: 10/29/24
DPW FILE NO. 48-15-T-874 R.O. 0

TERMINAL BUILDING HVAC-1 & HVAC-2 UPGRADES
WESTCHESTER COUNTY AIRPORT
TOWNS OF HARRISON, NORTH CASTLE & VILLAGE OF RYE BROOK
COVER SHEET

IN CHARGE OF PATRICK LYNCH, P.E.
CHECKED BY ROBERT SPINA, P.E./JOSEPH FIERRO, P.E.
MADE BY JOHN TESSER, P.E./GIOVANNI DEL CID, P.E.

Jeffrey A. Dean 11/29/24
RECOMMENDED FOR DESIGN DATE

JEFFREY A. DEAN, P.E.
ASSOCIATE ENGINEER
DEPARTMENT OF PUBLIC WORKS
AND TRANSPORTATION

Gayle M. Katzman 11-21-2024
RECOMMENDED FOR CONSTRUCTION DATE

GAYLE M. KATZMAN, P.E.
FIRST DEPUTY COMMISSIONER
DEPARTMENT OF PUBLIC WORKS
AND TRANSPORTATION


Hugh J. Greechan, Jr. 11/20/24
APPROVED FOR CONSTRUCTION DATE

HUGH J. GREECHAN, JR., P.E.
COMMISSIONER
DEPARTMENT OF PUBLIC WORKS
AND TRANSPORTATION

BURIED ELEC. CONDUITS TO REMAIN, VERIFY LOCATION IN FIELD. DO NOT DAMAGE CONDUITS

NEW AHU UNIT APPROX. WGT. = 7000 LBS

CONCRETE PAD ON GRADE

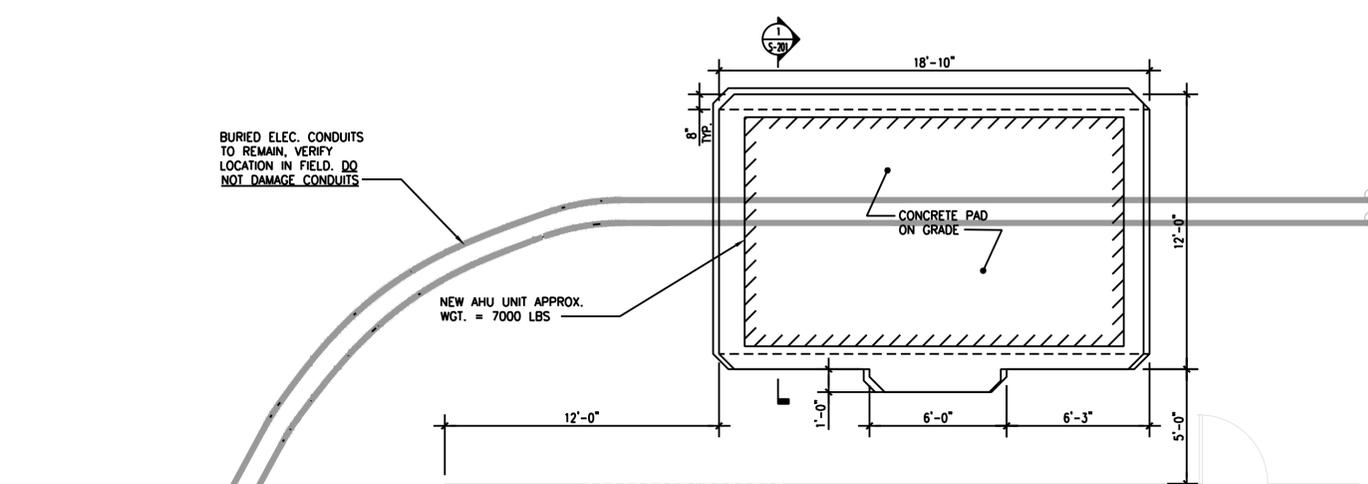


MECHANICAL EQUIP. FOUNDATION PLAN
1/4" = 1'-0"



- DO NOT SCALE THIS DRAWING. ALL DIMENSIONS AND ELEVATIONS SHALL BE V.I.F.
- NEW EQUIPMENT PAD CONSTRUCTION: 8" CONCRETE SLAB REINFORCED WITH #4 AT 18" o.c. EACH WAY.


IN CHARGE OF PATRICK CONLON
CHECKED BY PATRICK CONLON
MADE BY LEANDRO CARVALHO

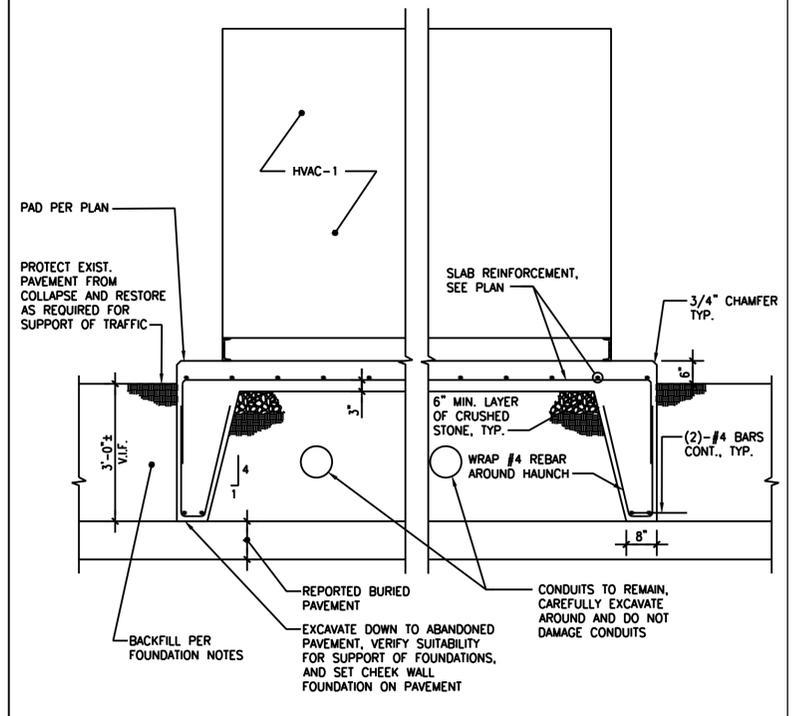

SECTION
1/2" = 1'-0"



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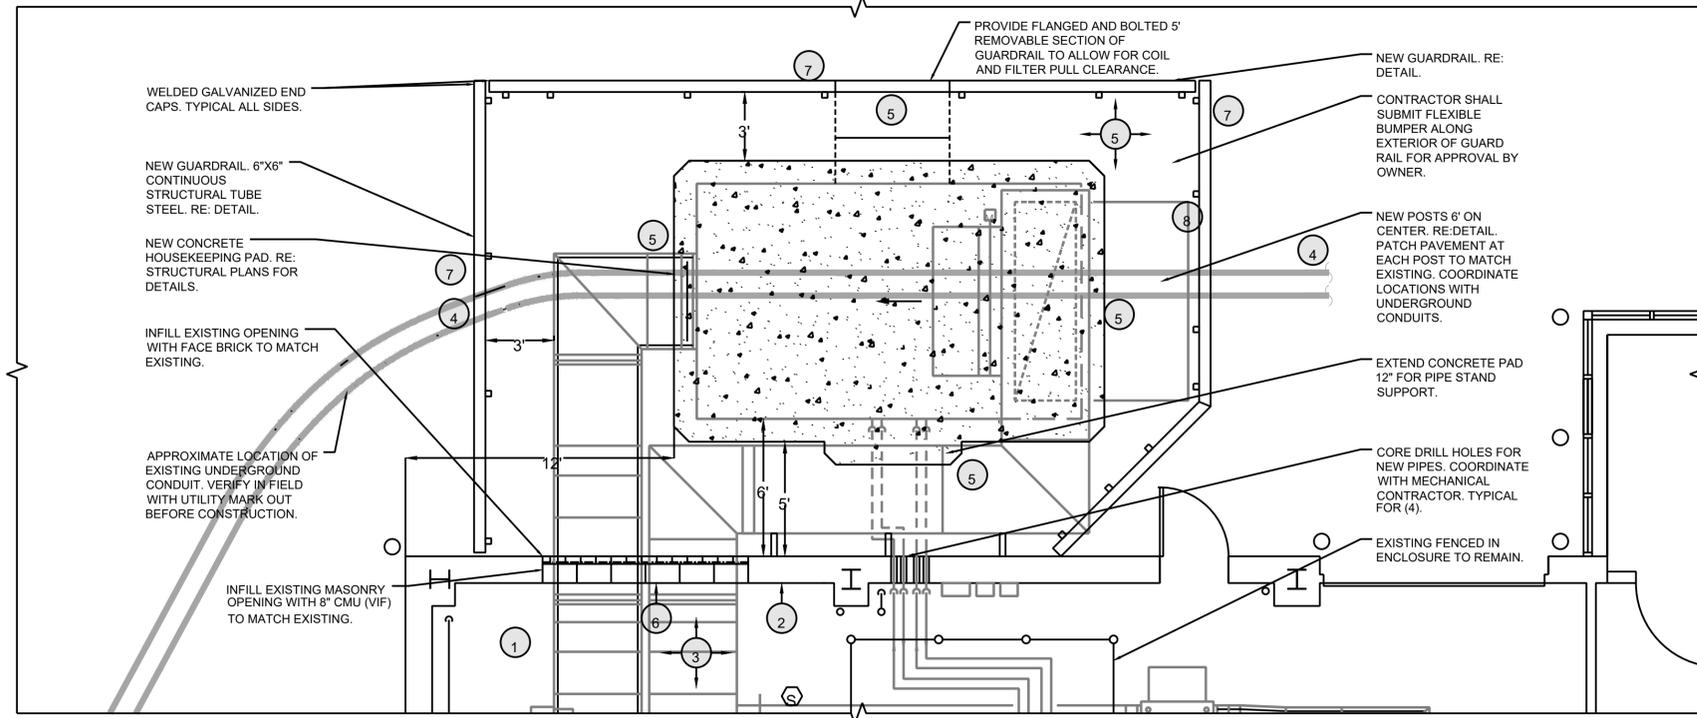
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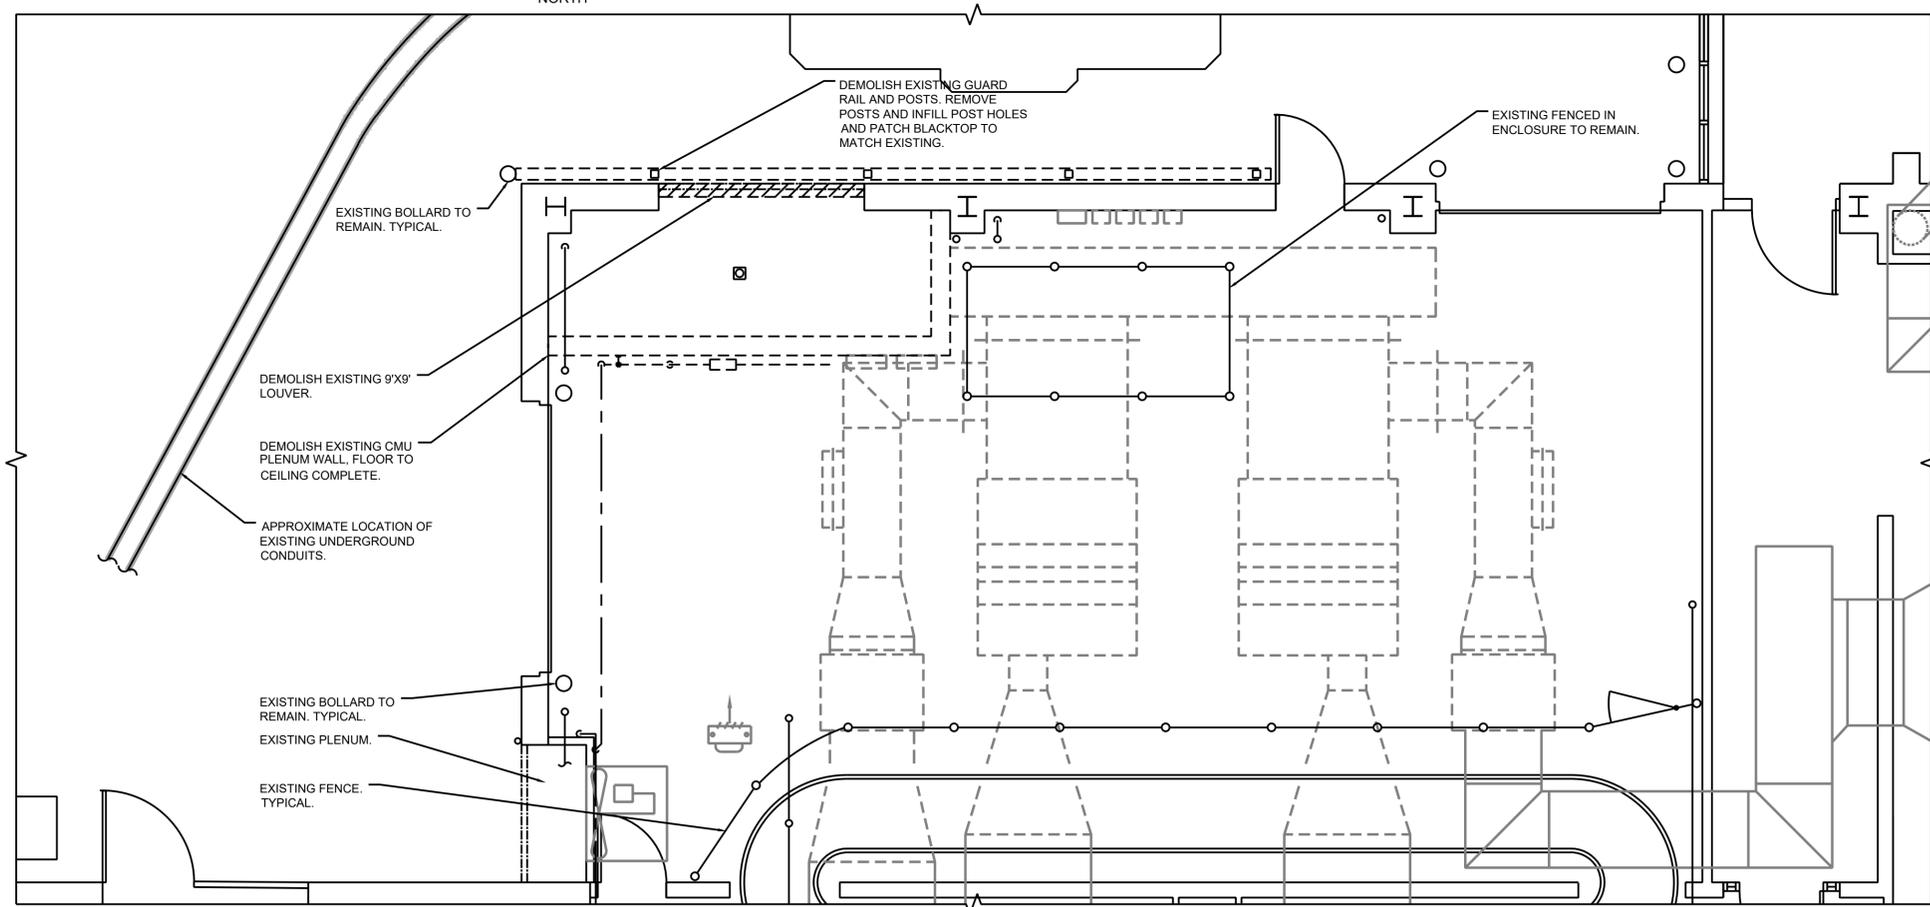
WESTCHESTER COUNTY, NEW YORK
DEPARTMENT OF PUBLIC WORKS AND TRANSPORTATION
DIVISION OF ENGINEERING

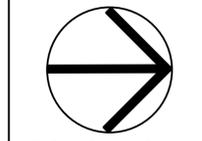CONTRACT NUMBER 23-532-Rev.	SHEET NUMBER S-201
SHEET NO. 2 OF 19	
SCALE: AS SHOWN DATE: 10/29/24	
DPW FILE NO. 48-15-S-875	REV. NO. 0

TERMINAL BUILDING HVAC-1 AND HVAC-2 UPGRADES
WESTCHESTER COUNTY AIRPORT
TOWNS OF HARRISON, NORTH CASTLE & VILLAGE OF RYE BROOK, NEW YORK
STRUCTURAL FLOOR PLAN



2 GENERAL CONSTRUCTION NEW WORK FIRST FLOOR PART PLAN
SCALE: 1/4" = 1'-0"
NORTH



1 GENERAL CONSTRUCTION DEMOLITION FIRST FLOOR PART PLAN
SCALE: 1/4" = 1'-0"
NORTH

IN CHARGE OF PATRICK LYNCH, P.E.
CHECKED BY ROBERT SPINA, P.E. / JOSEPH FIERRO, P.E.
MADE BY JOHN TESSER P.E. / GIOVANNI DEL CID, P.E.

GENERAL CONSTRUCTION NEW WORK NOTES:

- 1 EXISTING CONCRETE FLOOR IN THE AREA OF THE EXISTING OAI PLENUM SHALL BE CLEANED AND PATCHED TO MATCH EXISTING. GRIND AND POLISH FLOOR TO MATCH EXISTING.
- 2 PAINT WALLS IN THE AREA OF THE OAI PLENUM WHITE TO MATCH EXISTING. CLEAN AND PATCH WALLS. PRIME AND PAINT WITH SATIN URETHANE ALKLD ENAMEL. PAINT SHALL BE SHERWIN WILLIAMS OR BENJAMIN MOORE. SUBMIT PRODUCT SPECIFICATIONS FOR REVIEW AND APPROVAL.
- 3 FIRE PROOFING: ALL EXISTING STRUCTURAL STEEL CEILING BEAMS, FRAMING, AND DECKING IN THIS ROOM WHERE UNPROTECTED OR FIRE PROOFING HAS BEEN DAMAGED, SHALL BE FIRE PROOFED. REMOVE ANY LOOSE COVERING AND RUST ON STEEL. APPLY 1-1/2" OF GCPAT MONOKOTE TYPE 2-146 HIGH DENSITY CEMENTITIOUS FIRE PROOFING. USE FIRE BOND BONDING AGENT. PREP EXISTING STEEL AND CONCRETE AS PER THE MANUFACTURERS SPECIFICATIONS.
- 4 THE CONTRACTOR SHALL PERFORM AN UNDERGROUND UTILITY SURVEY PRIOR TO STARTING CONSTRUCTION. COORDINATE THE LOCATION OF THE CONCRETE PAD AND ALL POSTS ACCORDINGLY. DIG BY HAND IF REQUIRED.
- 5 PATCH THE PAVEMENT IN THE AREA OF WORK AROUND THE NEW CONCRETE PAD TO MATCH EXISTING. SAW CUT PAVEMENT IN STRAIGHT PARALLEL LINES AROUND THE AREA OF WORK.
- 6 INFILL THE EXISTING WALL OPENING WITH 8" CMU (VIF) TO MATCH EXISTING. INFILL FACE BRICK TO MATCH. REMOVE EXISTING BRICK AND BLOCK AROUND THE OPENING TO "KEY IN" NEW FACE BRICK AND CMU. SUBMIT MORTAR COLOR SAMPLE FOR REVIEW. PROVIDE TEST SAMPLE AREA OF MORTAR AND BRICK FOR REVIEW AND APPROVAL. CMU SHALL BE NEW. BRICK SHALL BE PROVIDED BY THE AIRPORT. THE CONTRACTOR SHALL BE RESPONSIBLE FOR CLEANING AND TRANSPORTING FROM AIRPORT WAREHOUSE.
- 7 ALL GUARD RAILS, POSTS, ANGLE IRON, END CAPS, NUTS, BOLTS, AND WASHERS SHALL BE GALVANIZED STEEL. ALL MEMBERS THAT ARE CUT IN THE FIELD SHALL BE COLD GALVANIZED WITH ZRC COLD GALVANIZING COMPOUND.
- 8 PROVIDE YELLOW PLASTIC GUARD RAIL COVER ON ALL NEW 6 X 6" GUARD RAILS AND POSTS.
- 9 SOIL STOCK PILING DETAIL PLAN GC-701

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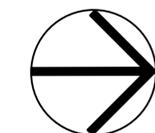


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WESTCHESTER COUNTY, NEW YORK DEPARTMENT OF PUBLIC WORKS AND TRANSPORTATION DIVISION OF ENGINEERING		CONTRACT NUMBER 23-532-Rev.	SHEET NUMBER GC-201
TERMINAL BUILDING HVAC-1 & HVAC-2 UPGRADES WESTCHESTER COUNTY AIRPORT TOWNS OF HARRISON, NORTH CASTLE & VILLAGE OF RYE BROOK		SHEET NO. 4 OF 19	SCALE: AS SHOWN DATE: 10/29/24
GENERAL CONSTRUCTION DEMO AND NEW WORK PLAN		DPW FILE NO. 48-15-G-877-0	REV. NO. 0

SYMBOL & ABBREVIATIONS			SYMBOL & ABBREVIATIONS		
SYMBOL	ABBREVIATION	DESCRIPTION	SYMBOL	ABBREVIATION	DESCRIPTION
-	AD	ACCESS DOOR		-	FLEXIBLE CONNECTION
-	AFF	ABOVE FINISHED FLOOR		-	GATE VALVE
-	AHC	ABOVE HUNG CEILING		-	STRAINER
-	AHU-	AIR HANDLING UNIT		-	FLOW ARROW
-	AP	ACCESS PANEL		-	BALANCING VALVE
-	BDD	BACKDRAFT DAMPER		-	MANUAL AIR VENT
-	BHP	BRAKE HORSEPOWER		-	BALL VALVE
-	BTU	BRITISH THERMAL UNIT		-	PRESSURE GAGE
-	CFM	CUBIC FEET PER MINUTE		-	TERMOMETER
-	CL	CENTERLINE		-	CHECK VALVE
-	CP-	CONDENSATE PUMP		-	UNION
-	DB	DRY BULB TEMPERATURE		-	MOTORIZED DAMPER
-	DIA. OR Ø	DIAMETER		-	CO2 SENSOR
-	DX	DIRECT EXPANSION		-	THERMOSTAT
-	EA	EXHAUST AIR		-	SMOKE DUCT DETECTOR
-	EAT	ENTERING AIR TEMPERATURE		-	DOOR UNDER CUT
-	EF-	EXHAUST FAN		-	AIR INTO REGISTER
-	EL	ELEVATION		-	3-WAY VALVE
-	ER	EXHAUST REGISTER		-	FLEXIBLE CONNECTION
-	ESP	EXTERNAL STATIC PRESSURE		-	2-WAY VALVE
-	EWT	ENTERING WATER TEMPERATURE		-	TEE DOWN
-	FPM	FEET PER MINUTE		-	ELBOW DOWN
-	FPS	FEET PER SECOND		-	TEE UP
-	GPM	GALLONS PER MINUTE		-	ELBOW UP
-	HP	HORSE POWER		-	CONCENTRIC REDUCER
-	HV-	HEATING AND VENTILATING UNIT		CFSD	COMBINATION FIRE SMOKE DAMPER
-	HVAC-	HEATING, VENTILATING AND AIR CONDITIONING UNIT		VD	VOLUME DAMPER
-	LAT	LEAVING AIR TEMPERATURE		-	DUCT SIZE - 1ST FIGURE IS SIDE SHOWN
-	LF	LINEAR FEET		FC	FLEXIBLE CONNECTION
-	LWT	LEAVING WATER TEMPERATURE		FD	FIRE DAMPER
-	MBH	1000 BRITISH THERMAL UNITS PER HOUR		-	EQUIPMENT TAG
-	MER	MECHANICAL EQUIPMENT ROOM		-	AIR OUTLET CFM TAG
-	NC	NORMALLY CLOSED			
-	NIC	NOT IN CONTRACT			
-	NO	NORMALLY OPEN			
-	OAI	OUTSIDE AIR INTAKE			
-	PSI	POUNDS PER SQUARE INCH			
_____	EX.	EXISTING TO REMAIN			
- - - - -	REL.	REMOVE AND RELOCATE			
_____	NEW	NEW WORK			
- - - - -	DEM.	EXISTING TO BE REMOVED			
— CHWS —	-	CHILLED WATER SUPPLY			
— CHWR —	-	CHILLED WATER RETURN			
— HWS —	-	HOT WATER SUPPLY			
— HWR —	-	HOT WATER RETURN			
⊕	-	THERMOSTAT			
⊕	-	HUMIDISTAT			
	-	MOTORIZED DAMPER			
⊙	-	SMOKE DETECTOR			
⊙	-	CO2 SENSOR			

GENERAL NOTES

- CONTRACT DRAWINGS, AS FAR AS THEY RELATE TO THE GENERAL ARRANGEMENT AND LOCATION OF EQUIPMENT, SHEET METAL, AND PIPING, SHALL BE UNDERSTOOD AS DIAGRAMMATIC. ANY CHANGES TO EQUIPMENT, SHEET METAL, AND PIPING LOCATIONS NECESSARY TO AVOID INTERFERENCE WITH OTHER TRADES SHALL BE MADE AT NO EXTRA COST, AND MUST BE APPROVED BY THE ENGINEER.
- THE CONTRACTOR SHALL INSTALL FIRE DAMPERS WITH ACCESS DOORS IN ALL DUCTS PENETRATING FIRE RATED WALLS, WHETHER SPECIFICALLY SHOWN ON THE DRAWINGS OR NOT.
- THE CONTRACTOR SHALL FURNISH AND INSTALL VOLUME DAMPERS IN DUCTWORK AS REQUIRED TO BALANCE THE AIRFLOW AT ALL REGISTERS AND DIFFUSERS TO THE CFM'S INDICATED ON PLAN, WHETHER SPECIFICALLY SHOWN ON THE DRAWINGS OR NOT.
- ALL MOTOR STARTERS AND DISCONNECT SWITCHES FOR HVAC EQUIPMENT SHALL BE FURNISHED BY THE CONTRACTOR AND INSTALLED BY THE ELECTRICIAN, UNLESS OTHERWISE NOTED. DISCONNECT SWITCHES FURNISHED BY THE CONTRACTOR FOR HVAC EQUIPMENT SHALL BE HEAVY DUTY TYPE.
- THE CONTRACTOR SHALL FIELD VERIFY ALL EXISTING CONDITIONS PRIOR TO THE BEGINNING OF WORK, AND SHALL COORDINATE ALL WORK WITH OTHER TRADES.
- DUCT DIMENSIONS SHOWN ON DRAWINGS REFER TO INSIDE CLEAR DUCT DIMENSIONS. WHERE DUCTWORK IS LINED, THE CONTRACTOR SHALL INCREASE THE SIZE OF DUCT TO COMPENSATE FOR LINING.
- ALL HVAC EQUIPMENT SHALL HAVE 3" HIGH BLACK LAMACOID NAME PLATES WITH WHITE ENGRAVED LETTERS PERMANENTLY FASTENED TO EQUIPMENT.
- THE CONTRACTOR SHALL SUBMIT FOR REVIEW A COMPOSITE SHOP DRAWING, FULLY COORDINATED WITH ALL OTHER TRADES, INDICATING DUCTWORK, PLUMBING AND SPRINKLER PIPING, SMOKE DETECTORS, LIGHTS, CONDUITS, DIFFUSERS, GRILLES, ETC.
- ALL WORK SHALL COMPLY WITH STATE BUILDING CODE, LOCAL BUILDING CODE, AND ENERGY CODE REQUIREMENTS. IN CASE OF CONFLICT BETWEEN THE CONTRACT DOCUMENTS AND A GOVERNING CODE OR ORDINANCE, THE MORE STRINGENT STANDARD SHALL APPLY.
- DURING CONSTRUCTION, ALL OPEN OR INCOMPLETE DUCTWORK SHALL BE CAPPED AIRTIGHT WITH HEAVY POLYETHYLENE PLASTIC. AFTER THE INSTALLATION OF DUCTWORK, REGISTERS, GRILLES, AND DIFFUSERS, THE CONTRACTOR SHALL BLANK OFF ALL REGISTERS, GRILLES, AND DIFFUSERS WITH HEAVY POLYETHYLENE PLASTIC AND TAPE AIR TIGHT, IN AREAS THAT ARE UNDER CONSTRUCTION, UNTIL WORK IS COMPLETE IN THOSE AREAS. FLOOR REGISTERS AND GRILLES SHALL ALSO BE COVERED WITH 1/8" MASONITE.
- WHEN GENERAL CONSTRUCTION IS COMPLETE, VACUUM CLEAN & SANITIZE ALL DUCTWORK, DIFFUSERS, REGISTERS, GRILLES, AND HVAC EQUIPMENT CONNECTED TO THE EXISTING HVAC-1 AND HVAC-2 SYSTEMS OR SERVING THE PROJECT AREA. REMOVE ANY CONSTRUCTION DEBRIS. REPLACE ALL AIR FILTERS WITH NEW. REFER TO SPECIFICATIONS FOR ADDITIONAL INFORMATION.**
- THE OWNER'S PERMANENT HVAC EQUIPMENT (NEW AND EXISTING) SHALL NOT BE USED BY CONTRACTOR DURING CONSTRUCTION FOR TEMPORARY HEATING, COOLING, OR VENTILATION. IF TEMPORARY HEATING, COOLING, OR VENTILATION IS REQUIRED AT ANY POINT DURING CONSTRUCTION, THE CONTRACTOR SHALL PROVIDE TEMPORARY HEATING, COOLING, OR VENTILATION EQUIPMENT, DUCTWORK, CONTROLS, AND POWER AT HIS OWN EXPENSE.
- THE CONTRACTOR SHALL BE RESPONSIBLE FOR PROVIDING TEMPORARY VENTILATION AND EXHAUST AIR WHEN WELDING OR SOLDERING OPERATIONS ARE PERFORMED, AS REQUIRED BY OSHA.
- WHERE EXISTING BUILDING STRUCTURAL COMPONENTS HAVE FIREPROOF MATERIAL, ANY AREA THAT IS DISTURBED OR DAMAGED AS A RESULT OF MECHANICAL WORK, INCLUDING THE INSTALLATION OF HANGERS FOR PIPING, DUCTWORK, OR EQUIPMENT, SHALL BE PATCHED WITH UL AND FM APPROVED FIREPROOFING TO MATCH EXISTING.
- THE CONTRACTOR SHALL BE RESPONSIBLE FOR OBTAINING AND PAYING FOR ALL NECESSARY PERMITS AND FOR PAYING RELATED FEES.
- THE CONTRACTOR SHALL PROVIDE ALL CUTTING, PATCHING, CORE DRILLING, ACCESS PANELS, PAINTING, AND FINAL RESTORATION REQUIRED TO FACILITATE THE INSTALLATION OF HVAC DUCTWORK, CONTROL CONDUITS, AND PIPING, INCLUDING ABOVE CEILINGS AND IN SHAFTS THAT WILL NOT BE REPLACED OR OPENED UNDER ANY OTHER SCOPE OF WORK RELATED TO THIS PROJECT. CONTRACTOR TO REMOVE AND REPLACE CEILINGS, AND OPEN AND PATCH SHAFTS AND WALLS, AS REQUIRED TO EXECUTE THE MECHANICAL WORK.
- ALL DUCTWORK SHALL BE PRESSURE TESTED AND INSPECTED PRIOR TO CONCEALMENT IN GENERAL CONSTRUCTION OR INSTALLATION OF HUNG CEILINGS.
- LOCATE THERMOSTATS AND TEMPERATURE SENSORS 5'-6" ABOVE FINISHED FLOOR UNLESS OTHERWISE NOTED. COORDINATE LOCATION WITH FURNITURE, CABINETS, ETC. FURNISH LOCKING TAMPERPROOF COVER FOR ALL NEW THERMOSTATS IN PUBLIC AREAS.
- DUCT-MOUNTED SMOKE DETECTORS AND SAMPLING TUBES SHALL BE FURNISHED BY THE CONTRACTOR. THE CONTRACTOR SHALL INSTALL EACH SAMPLING TUBE IN THE DUCTWORK. THE CONTRACTOR SHALL INSTALL AND WIRE EACH SMOKE DETECTOR. THE CONTRACTOR SHALL NOT BRANCH OFF ANY DUCT REQUIRING A DUCT SMOKE DETECTOR BEFORE THE DUCT SMOKE DETECTOR. LOCATE SMOKE DETECTORS IN SERVICEABLE AREAS, NOT IN SHAFTS.
- THE CONTRACTOR IS RESPONSIBLE FOR DRAINING, DISPOSING OF, AND REFILLING THE CHILLED WATER AND HOT WATER SYSTEMS WITH A 30% GLYCOL SOLUTION AS REQUIRED FOR THE INSTALLATION OF THE NEW AHU.
- THE CONTRACTOR SHALL PERFORM PRE-DEMOLITION WATER BALANCING TESTING AT BOTH OF THE EXISTING AIR HANDLING UNITS HVAC-1 AND HVAC-2. TEST BOTH THE CHILLED WATER AND HOT WATER FLOW RATES AT BOTH UNITS. REPORT FINDINGS TO THE ENGINEER FOR REVIEW.
- THE CONTRACTOR SHALL PERFORM WORK WITHIN THE BAGGAGE DROP AREA DURING OFF HOURS. WHEN THE BAGGAGE DROP AREA IS NOT IN USE. EXACT SCHEDULE AND HOURS TO BE COORDINATED WITH THE AIRPORT ADMINISTRATION. DEMOLITION WORK IS NOT TO BE STARTED UNTIL ALL NECESSARY MATERIALS AND EQUIPMENT ARE IN HAND, TO PREVENT DELAYS DURING THE CONSTRUCTION PROCESS.

GENERAL NOTES

- ALL EXISTING SUPPLY AIR & RETURN AIR DUCTWORK CONNECTED TO THE NEW HVAC-1 SYSTEM SHALL BE TESTED & INJECTED SEPARATELY WITH AEROSOLIZED VINYL POLYMER SEALANT BY DUCT DIAGNOSTICS LLC. ALL OF THE OPENINGS OF THE DUCTWORK SHALL BE SEALED OFF AND THEN THE DUCTWORK IS PRESSURIZED USING A CALIBRATED-FLOW FAN, WHICH KEEPS THE AEROSOL MOVING THROUGH THE DUCTS WITHOUT COLLECTING ON THE SURFACE; THE PARTICLES REMAIN SUSPENDED IN THE AIR FLOW UNTIL THE CHANGE IN PRESSURE AROUND LEAKS AND HOLES FORCES THE AEROSOL ADHESIVE THROUGH THE CRACKS. WHERE IT COLLECTS ON THE EDGE AND BUILDS A SEAL TO EFFECTIVELY BLOCK AIR FLOW. THE TEST & SEALING SHALL BE PERFORMED IN THE FOLLOWING SEQUENCE:
 - EACH DUCT SYSTEM (SUPPLY & RETURN) SHALL BE TESTED TO 3"WC PRIOR TO INJECTING THE AEROSOLIZED SEALANT. A CFM LEAKAGE SHALL BE MEASURED AND RECORDED.
 - EACH DUCT SYSTEM (SUPPLY & RETURN) SHALL BE INJECTED WITH THE SEALANT ACCORDING TO MANUFACTURERS INSTRUCTIONS.
 - THE SYSTEM SHALL BE TESTED AND A LEAKAGE CLASS OF 3 SHALL BE REACHED ACCORDING TO TABLE "LEAKAGE AS A PERCENT OF AIRFLOW IN SYSTEM" IN SMACNA APPENDIX A WITH 3.1% LEAKAGE.

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PROJECT NORTH

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AS BUILT - CHANGES AS NOTED
 AS BUILT - NO CHANGES

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NAME	DATE	NAME	DATE

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 DEPARTMENT OF PUBLIC WORKS
 AND TRANSPORTATION
 DIVISION OF ENGINEERING


CONTRACT NUMBER 23-532-Rev. M-001
 SHEET NO. 6 OF 19

SCALE: AS SHOWN
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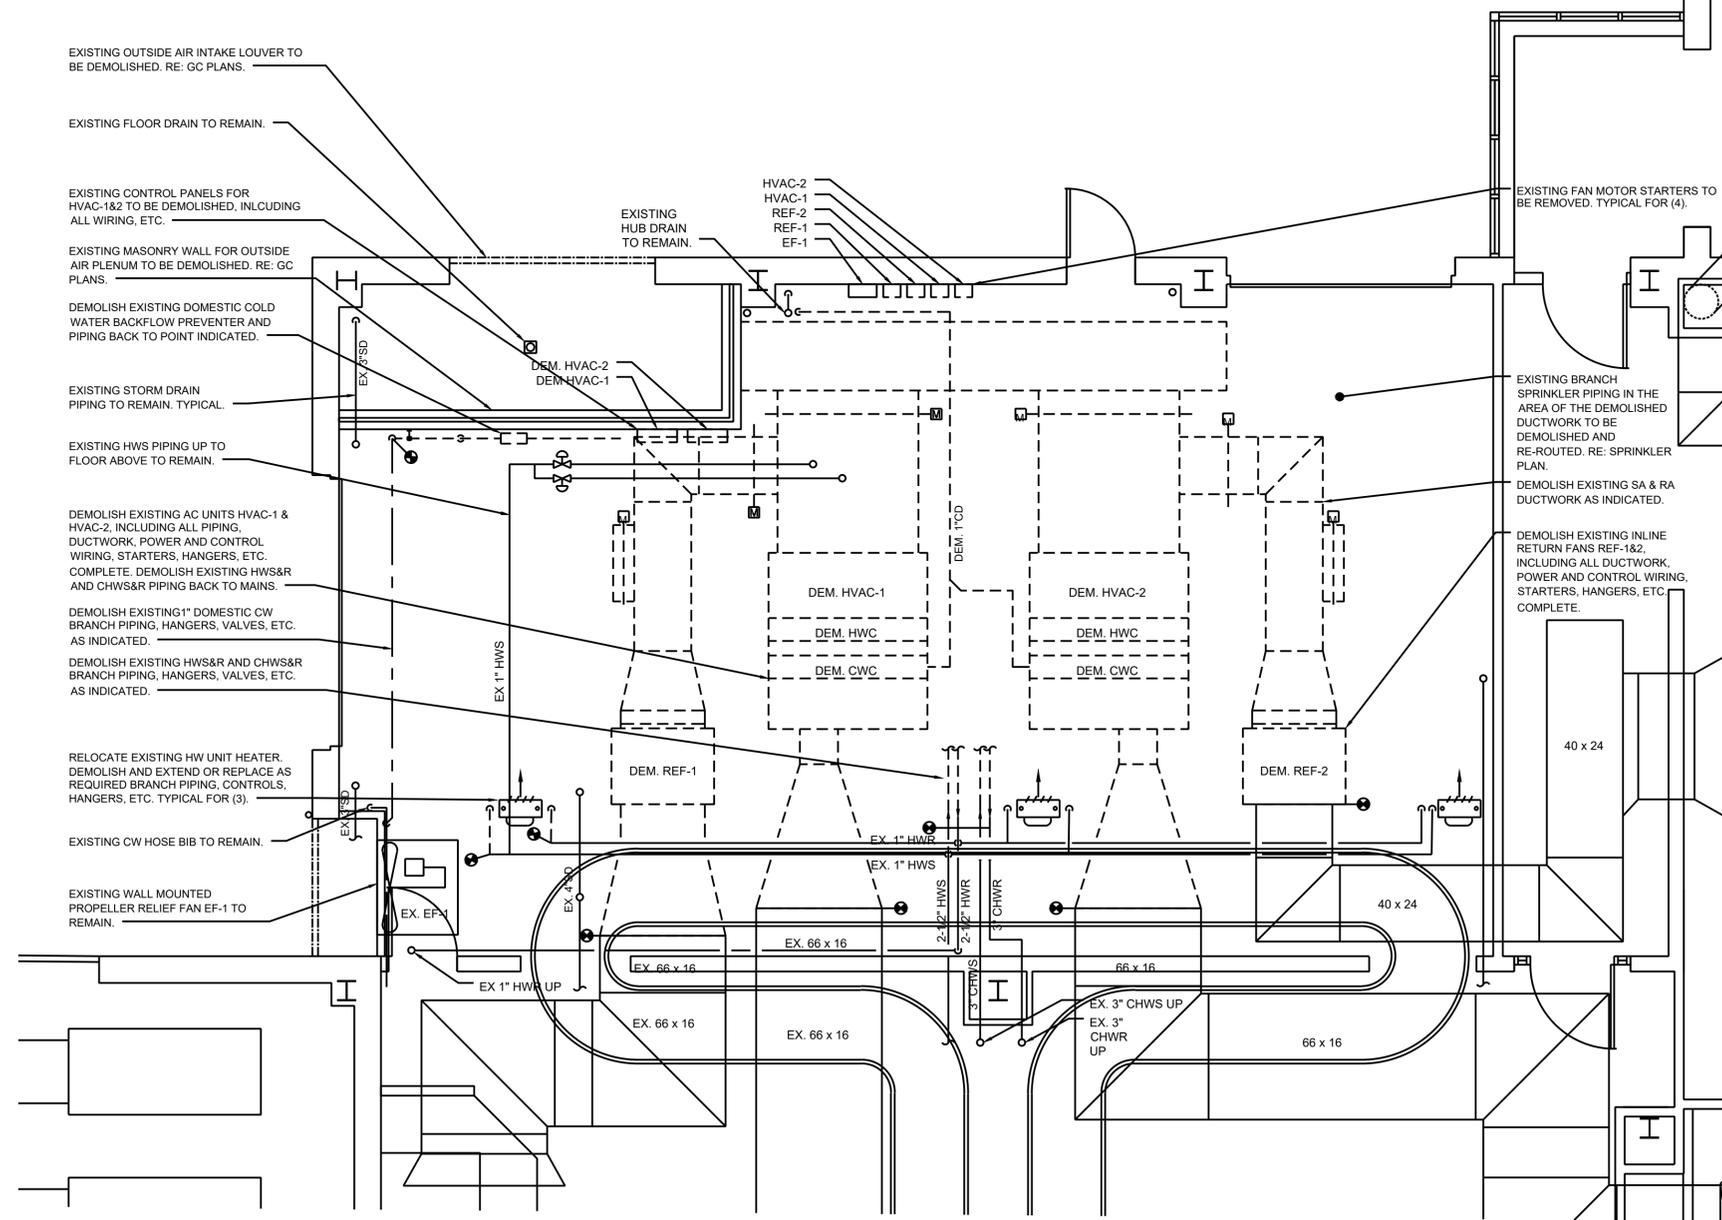
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MECHANICAL SYMBOLS, ABBREVIATIONS, AND GENERAL NOTES

IN CHARGE OF PATRICK LYNCH, P.E.
 CHECKED BY ROBERT SPINA, P.E. / JOSEPH FIERRO, P.E.
 MADE BY JOHN TESSER P.E. / GIOVANNI DEL CID, P.E.



2 FIRST FLOOR KEY PLAN
SCALE: 1/64" = 1'-0"
NORTH

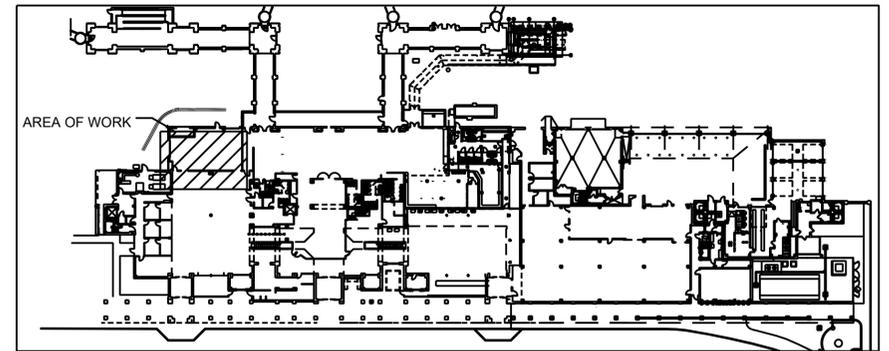

1 MECHANICAL DEMOLITION FIRST FLOOR PART PLAN
SCALE: 1/4" = 1'-0"
NORTH

IN CHARGE OF PATRICK LYNCH, P.E.
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STRUCTURAL ENGINEER

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REVISION NUMBER	DATE	MADE BY	APP'D BY	REVISION

RECORD DRAWING CERTIFICATION

AS BUILT - CHANGES AS NOTED
 AS BUILT - NO CHANGES

CONTRACTOR		PROJECT COORDINATOR	
NAME	NAME	DATE	DATE
SIGNATURE	SIGNATURE		
TITLE	TITLE		
WESTCHESTER COUNTY, NEW YORK DEPARTMENT OF PUBLIC WORKS AND TRANSPORTATION DIVISION OF ENGINEERING		CONTRACT NUMBER	SHEET NUMBER
		23-532-Rev. M-101	7 OF 19
TERMINAL BUILDING HVAC-1 & HVAC-2 UPGRADES WESTCHESTER COUNTY AIRPORT TOWNS OF HARRISON, NORTH CASTLE & VILLAGE OF RYE BROOK		SCALE: AS SHOWN	DATE: 10/29/24
		DPW FILE NO. 48-15-M-880-0	REV. NO. 0
MECHANICAL DEMOLITION FIRST FLOOR PART PLAN			

78x20 SPILL AIR DAMPER AND DISCHARGE HOOD WITH 1/2" WMS.

NEW HVAC-1. MAINTAIN 5' CLEAR TO BUILDING. MOUNT ON NEW CONCRETE PAD.

APPROXIMATE LOCATION OF (2) 4" UNDERGROUND CONDUITS. APPROX. 12"-24" DEEP.

NEW GUARD RAIL. RE: GC PLANS.

NEW SA & RA DUCTWORK AT TOP OF EXISTING OPENING. HOLD AS HIGH AS POSSIBLE. PROVIDE FLASHING AND COUNTER FLASHING. SEAL WATER TIGHT.

SET SA & RA DUCTWORK UP THROUGH WALL.

1/2" ACOUSTIC LINING ON ALL SUPPLY AND RETURN DUCTWORK.

DUCT SMOKE DETECTOR, TYPICAL FOR (2).

NEW 3/4" CW DOWN TO NEW HOSE/BIB AT WALL WITH SHUT-OFF VALVE. CW PIPE SHALL BE COPPER TYPE L TO MATCH EX.


NEW BIPOLAR IONIZATION BPI-1&2 MOUNTED TO SA DUCT.

GALVANIZED 12X12 SHEET METAL ANGLE ON LEADING EDGE OF DUCT IN FRONT OF DOOR.

HOLD ALL DUCTWORK AND PIPING AS HIGH AS POSSIBLE. MINIMUM 8" CLEARANCE REQUIRED BELOW ALL DUCTWORK AND PIPING.

RELOCATE EXISTING HOT WATER UNIT HEATER. EXTEND EXISTING HWS&R PIPING AS REQUIRED. HANG AS HIGH AS POSSIBLE.

84 x 24 POINT RETURN AIR ABOVE HUNG CEILING.

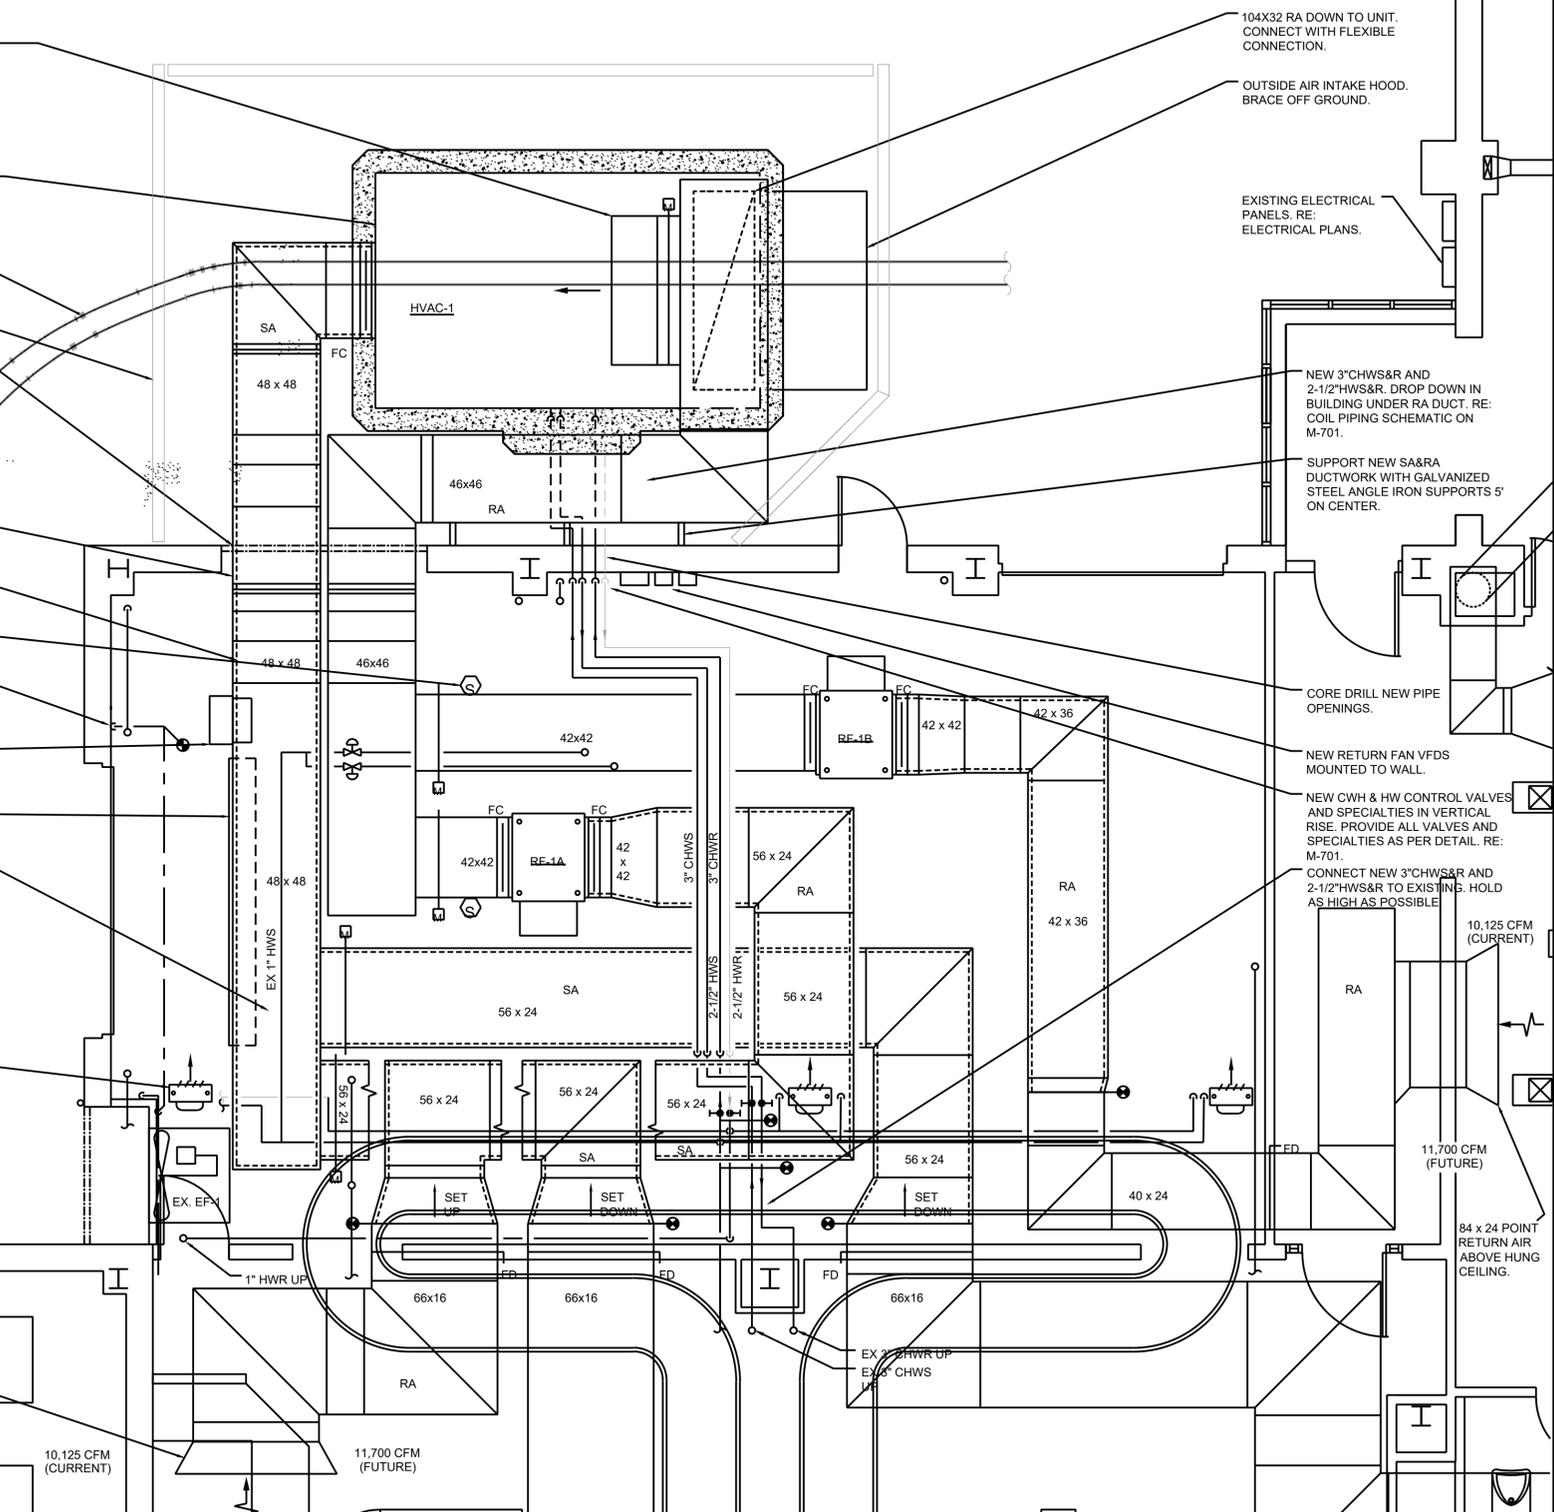

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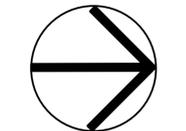
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PROJECT NORTH



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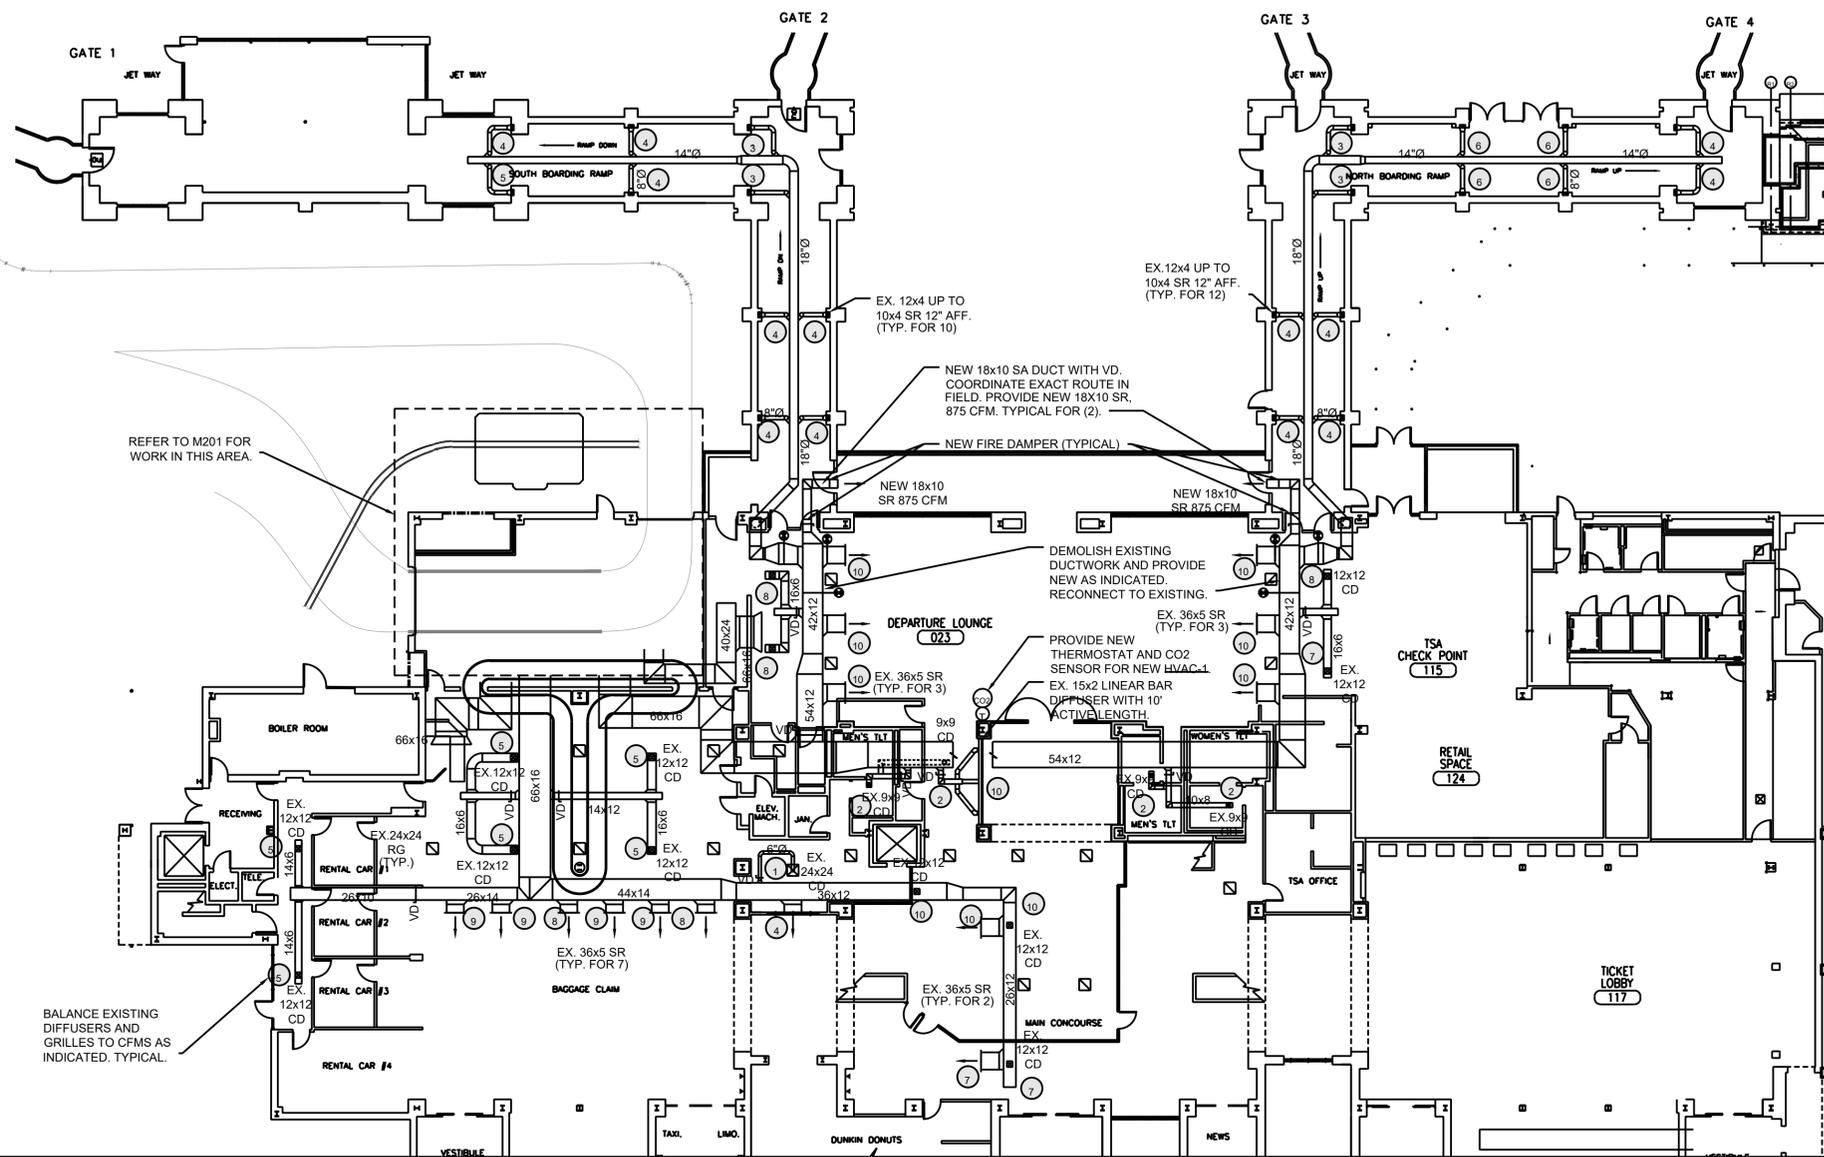
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SIGNATURE		SIGNATURE	
TITLE		TITLE	

WESTCHESTER COUNTY, NEW YORK DEPARTMENT OF PUBLIC WORKS AND TRANSPORTATION DIVISION OF ENGINEERING		CONTRACT NUMBER	SHEET NUMBER
		23-532-Rev.	M-201
SHEET NO. 8 OF 19		SCALE: AS SHOWN	DATE: 10/29/24
TERMINAL BUILDING HVAC-1 & HVAC-2 UPGRADES WESTCHESTER COUNTY AIRPORT TOWNS OF HARRISON, NORTH CASTLE & VILLAGE OF RYE BROOK		DPW FILE NO.	REV. NO.
MECHANICAL NEW WORK FIRST FLOOR PART PLAN		48-15-M-881-0	0

IN CHARGE OF PATRICK LYNCH, P.E.
 CHECKED BY ROBERT SPINA, P.E. / JOSEPH FIERRO, P.E.
 MADE BY JOHN TESSER P.E. / GIOVANNI DEL CID, P.E.

MECHANICAL NEW WORK FIRST FLOOR PART PLAN
 SCALE: 1/4" = 1'-0"
 NORTH



REFER TO M201 FOR WORK IN THIS AREA.

BALANCE EXISTING DIFFUSERS AND GRILLES TO CFMS AS INDICATED. TYPICAL.


NOTES:

1. THE CONTRACTOR SHALL PERFORM PRE-DEMOLITION CFM READINGS AT ALL AIR OUTLETS THROUGHOUT THE AREA OF WORK, WHETHER SHOWN ON PLAN OR NOT. REPORT FINDINGS TO THE ENGINEER FOR REVIEW.

 **1** MECHANICAL NEW WORK FIRST FLOOR PLAN
SCALE: 1/16" = 1'-0"
NORTH

AIR BALANCE SCHEDULE	
TAG	CFM
1	75
2	100
3	125
4	150
5	175
6	200
7	500
8	600
9	800
10	850

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TITLE	DATE	TITLE
WESTCHESTER COUNTY, NEW YORK DEPARTMENT OF PUBLIC WORKS AND TRANSPORTATION DIVISION OF ENGINEERING		CONTRACT NUMBER 23-532-Rev. M-202 SHEET NO. 9 OF 19
TERMINAL BUILDING HVAC-1 & HVAC-2 UPGRADES WESTCHESTER COUNTY AIRPORT TOWNS OF HARRISON, NORTH CASTLE & VILLAGE OF RYE BROOK		SCALE: AS SHOWN DATE: 10/29/24 DPW FILE NO. 48-15-M-882-0
MECHANICAL NEW WORK FIRST FLOOR PLAN		REV. NO. 0

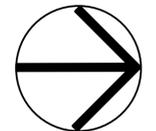AIR HANDLING UNIT SCHEDULE

DESIGNATION	HVAC-1	
LOCATION	GRADE OUTSIDE BAGGAGE DROP	
AREA SERVED	SEE PLANS	
MANUFACTURER-BASIS OF DESIGN	JOHNSON YORK	
MODEL	PAQ-78X102	
WEIGHT OF UNIT (LBS)	6,868	
DESIGN DATA:	CURRENT	FUTURE
SUPPLY AIR (CFM)	22,500	26,000
OUTDOOR AIR (CFM)	4,350	4,350
RETURN AIR (CFM)	20,250	23,400
SPILL AIR (CFM)	2,300	1,750
SUMMER OA TEMP (°F) DB/WB	86.4/71.9	86.4/71.9
SUMMER RA TEMP (°F) DB/WB	75/62.5	75/62.5
WINTER OA TEMP (°F)	10	10
WINTER RA TEMP (°F)	68	68
FILTERS:		
PRE-FILTER: PANEL/50% DIRTY PD	2" MERV-8/0.61	2" MERV-8/0.61
MAIN FILTER: BAG/50% DIRTY PD	4" MERV-13/0.93	4" MERV-13/0.93
HOT WATER COIL:		
FACE AREA (SQ. FT.) VEL. FT/MIN	46.8/475	46.8/555
No. OF ROWS/ FPI MIN	1/8	1/8
E.W.T./L.W.T. (°F)	180/160	180/160
E.A.T./L.A.T. (°F)	58/93.3	58/93.3
AIR P.D. (IN H ₂ O)	0.05	.11
CAPACITY (MBH)	796	1,101
GPM	62	98.7
W.P.D. (FT H ₂ O)	5.7	14.2
CHILLED WATER COIL:		
FACE AREA (SQ. FT.)	46.8	46.8
No. OF ROWS/ FPI MIN	8/8	6/8
E.W.T./L.W.T. (°F)	45/56.7	45/56.7
E.A.T. (°F) DB/WB	80/67	80/67
L.A.T. (°F) DB/WB	55.9/54.7	55.9/54.7
AIR P.D. (IN H ₂ O)	0.81	0.73
CAPACITY (MBH) SENS./TOTAL	579.4/859	689.7/938.2
GPM	146	196.91
W.P.D. (FT H ₂ O)	8.5	13.9
SUPPLY FAN:		
DESIGN AIRFLOW (CFM)	22,250	26,000
BHP/HP	29.58/45	37.1/45
RPM	1,261	1,891
ESP/TSP (IN H ₂ O)	3/5.5	3/5.77
STARTER TYPE	VFD	VFD
ELECTRICAL DATA - SINGLE POINT POWER CONNECTION:		
VOLTS/Ø/Hz	460/3/60	460/3/60
FLA/MCA/MOCP (AMPS)	39/48.75/70	54.3/58.8/70

NOTES:

- PROVIDE THE FOLLOWING MODULES FOR OUTDOOR UNIT (BACK TO FRONT):
 - TOP RETURN SECTION
 - OAI, RA, MIXED AIR, AND SPILL DAMPERS SHALL BE A UL LISTED SMOKE DAMPERS. THE CONTRACTOR SHALL REMOVE THE EXISTING DAMPERS AND FIELD INSTALL NEW UL LISTED 555S RATED DAMPERS.
 - MERV-8 PRE-FILTER
 - MERV-13 MAIN-FILTER
 - HOT WATER COIL MODULE. COIL SIZED FOR 30% PROP GLYCOL SOLUTION.
 - CHILLED WATER COIL MODULE. COIL SIZED FOR 30% PROP GLYCOL SOLUTION.
 - BIPOLAR IONIZATION
 - SUPPLY FAN MODULE
 - DISCHARGE PLENUM MODULE WITH BOTTOM OUTLET.
- PROVIDE THE FOLLOWING OPTIONAL EQUIPMENT FOR EACH UNIT:
 - 100% MODULATING ECONOMIZER WITH DIFFERENTIAL ENTHALPY CONTROL.
 - CHILLED WATER AND HOT WATER PIPING TO UNIT SHALL BE LOCATED IN A FACTORY FABRICATED AND INSULATED PIPE ENCLOSURE.
 - FURNISH A FREEZE STAT ARRANGED TO OVERRIDE THE HOT WATER CONTROL VALVE AND SHUT DOWN UNIT, AS PER THE SEQUENCE OF OPERATIONS.
 - FURNISH (1) EXTRA FILTER SET OF EACH KIND OF FILTER.
 - COORDINATE LEFT/RIGHT COIL CONNECTION AND FAN DRIVE IN FIELD.
 - FURNISH 2-WAY MODULATING CONTROL VALVE FOR EACH COIL, WITH PIPING PACKAGE AS PER DETAIL #6 ON DRAWING M-701. 5 PSI MAX AT CONTROL VALVE.
 - ALL MODULATING DAMPERS SHALL BE OPPOSED-BLADE TYPE.
 - OUTSIDE AIR INTAKE DAMPER SHALL BE ARRANGED MODULATE OAI CFM ACCORDING TO THE DEMAND CONTROL VENTILATION SEQUENCE.
- INDEPENDENT OF VARIABLE SA CFM. PROVIDE AN OUTSIDE AIR INTAKE AIRFLOW MEASURING STATION.
 - POWERED CONVENIENCE OUTLET TO BE POWERED BY CONTRACTOR.
- PROVIDE THE FOLLOWING MOTOR CONTROL OPTIONS FOR EACH UNIT:
 - UNITARY CONTROLLER BY AUTOMATIC TEMPERATURE CONTROLS MANUFACTURER, SHALL BE JOHNSON METASYS BUILDING AUTOMATION SYSTEM.
 - PREMIUM EFFICIENCY FAN MOTOR. ALL MOTORS FURNISHED WITH VARIABLE FREQUENCY DRIVES SHALL BE INVERTER DUTY RATED & APPROVED FOR VARIABLE SPEED AND TORQUE APPLICATIONS.
 - SINGLE POINT EXTERNAL POWER CONNECTION AT UNIT.
 - PROVIDE FACTORY MOUNTED COMBINATION VFD / MOTOR STARTERS AND DISCONNECT SWITCHES IN A WEATHERPROOF ENCLOSURE MOUNTED TO UNIT.
- PROVIDE DIFFERENTIAL AIR PRESSURE GAGES ON EACH SIDE OF THE FILTER BANK. PROVIDE MODULES TO REPORT PRESSURE READINGS TO BMS AND INDICATE DIRTY FILTER ALARM WHEN PRESSURE DROP ACROSS THE FILTER INCREASES ABOVE 0.5" SP (ADJ.).

IN CHARGE OF PATRICK LYNCH, P.E.
 CHECKED BY ROBERT SPINA, P.E. / JOSEPH FIERRO, P.E.
 MADE BY JOHN TESSER P.E. / GIOVANNI DEL CID, P.E.

FAN SCHEDULE

DESIGNATION	RF-1A & RF-1B	
LOCATION	BAGGAGE DROP	
AREA SERVED	SEE PLANS	
MANUFACTURER	GREENHECK	
MODEL	BSQ-300	
WEIGHT (LBS)	523	
FAN TYPE	INLINE CENTRIFUGAL	
DRIVE TYPE	BELT	
CFM	10,250	11,700
BHP	3.7	4.6
HP	5	5
RPM	739	795
SP (IN H ₂ O)	1	1
VOLTS/Ø/Hz	460/3/60	460/3/60
STARTER TYPE	VFD	VFD
STARTER LOCATION	BAGGAGE DROP	BAGGAGE DROP
INTERLOCK	HVAC-1	HVAC-1
NOTES:	1. ALL MOTORS 1 HP OR GREATER SHALL BE PREMIUM EFFICIENCY. 2. ALL MOTORS FURNISHED WITH VARIABLE FREQUENCY DRIVES SHALL BE INVERTER DUTY RATED & APPROVED FOR VARIABLE SPEED AND TORQUE APPLICATIONS. 3. FURNISH RUBBER IN SHEAR OR SPRING VIBRATION ISOLATORS AS PER THE SPECIFICATION. 4. FURNISH MOTOR AND BELT GUARDS FOR ALL EXTERNAL MOTOR DRIVES. 5. MOTOR STARTER AND DISCONNECT SWITCH FOR EACH FAN SHALL BE FURNISHED BY THE CONTRACTOR AND INSTALLED BY THE CONTRACTOR.	

EQUIPMENT NOTES

- VOLUME CONTROL DAMPERS:** FOR ALL ROUND & RECTANGULAR VOLUME CONTROL DAMPERS THAT ARE LOCATED ABOVE INACCESSIBLE CEILINGS, PROVIDE CABLE OPERATED DAMPERS. ROUND DAMPERS SHALL BE YOUNG BOWDEN MODEL 5020-CC. RECTANGULAR DAMPERS SHALL BE MODEL 830-CC2. CABLE CONTROLS SHALL BE MODEL 270-275 FOR CONCEALED LOCATIONS & MODEL 270-896C FOR LOCATIONS WHERE CABLES TERMINATE IN FINISHED SPACES. COORDINATE LOCATIONS IN THE FIELD.
- MOTORIZED DAMPERS:** SHALL BE RUSKIN MODEL SD60-2, 4" DEEP EXTRUDED ALUMINUM AIRFOIL DAMPER. DAMPER SHALL HAVE OPPOSED BLADES, MOTOR AND LINKAGE. DAMPER SHALL BE LISTED TO UL 555S. DAMPERS SHALL BE 120V/1Ø/60Hz, 3 AMPS MAX. FURNISH DISCONNECT SWITCH.
- FIRE DAMPERS:** SHALL BE RUSKIN MODEL DIBD-2, 1-1/2 HOUR UL555 RATED, SUITABLE FOR INSTALLATION IN WALL AND FLOOR PARTITIONS WITH FIRE RATINGS OF LESS THAN 3 HOURS. DAMPER SHALL BE A COMPLETE FACTORY PACKAGE INCLUDING U.L. APPROVED ANGLES, WALL SLEEVE, AND BREAKAWAY CONNECTIONS. DAMPER SHALL BE RATED FOR DYNAMIC AIRFLOW CONDITIONS OF 2,000 FPM AND 4.0" SP.
- DUCT INSULATION (INTERIOR):** SHALL BE OWENS CORNING 2" MIN, 700 SERIES TYPE 705, 6.0 PEF RIGID FIBER GLASS BOARD WITH POLY ENCAPSULATED ASJ MAX FACING WITH K FACTOR OF .25 AT 100 DEG FAHRENHEIT MEAN TEMPERATURE INSULATION SHALL BE NO LESS THEN THE HEIGHT OF DUCT STANDING SEAM.
- DUCT INSULATION (EXTERIOR):** SHALL BE AEROFLEX/AEROCCEL WLP EPDM SHEET OR ROLL. MINIMUM OF 2" BUT NOT LESS THAN THE DUCT STANDING SEAM. INSTALL WITH AEROFLEX ADHESIVES. GLUE ALL BUTT JOINTS AND SEAM AND TAPE WITH EPDM TAPE. PERMEABILITY SHALL BE 0.01 PER INCH. K2.245
- PIPE INSULATION (INTERIOR):** SHALL BE JOHNS MANVILLE MICROLOK FIBERGLASS K FACTOR .24 AT 100 DEGREE FAHRENHEIT MEAN TEMP 2" THICK WITH WHITE ALL SERVICE JACKET (ASJ) WITH FLAME AND SMOKE SPREAD RATING OF LESS THAN 50/25. PROVIDE ZESTOY 2000 PVC JACKETING ON ALL INTERIOR INSULATED PIPES. HW, CHW, CW.
- PIPE INSULATION (EXTERIOR):** SHALL BE AEROFLEX AEROCCELL WLP EPDM TUBE OR SHEET FOR PIPING WITH PREMOLDED PIPE FITTING INSULATION. INSTALL WITH AEROFLEX EPDM TAPE. PERMEABILITY SHALL BE .01 PER INCH. K2.245.
- EXTERIOR PIPE AND DUCT JACKET:** SHALL BE POLYGUARD-ALUMNAGUARD ALL WEATHER JACKET. COMPOSITE MEMBRANE CONSISTING OF MULTIPLE UV RESISTANT ALUMINUM FOIL POLYMER LAMINATE.
- DUCT MOUNTED BIPOLAR IONIZATION (BPI-182):** SHALL BE ATMOSAIR 508FC, CAPABLE OF SERVING AIRFLOWS UP TO 15,000 CFM, 120V/1PH/60HZ POWER SUPPLY, 28 WATTS, 0.25 AMPS. FIELD ELECTRICAL CONNECTION TO BE WIRED TO JUNCTION BOX. PROVIDE MOUNTING BRACKET AND AIR PRESSURE SWITCH TO ACTIVATE THE UNIT ONLY WHEN AIRFLOW IS PRESENT.
- SIDEWALL SUPPLY AIR REGISTERS:** SHALL BE TITUS MODEL 300FS, ALUMINUM CONSTRUCTION, WITH 3/4" SPACING, DOUBLE DEFLECTION AIRFOIL BLADES, OPPOSED BLADE VOLUME DAMPER IN NECK, SIZE AND CFM AS NOTED ON PLANS. FINISH SHALL BE BAKED ON ENAMEL. SUBMIT COLOR CHART FOR APPROVAL. FRAME SHALL BE SUITABLE FOR LAY-IN OR SURFACE MOUNTING AS REQUIRED. COORDINATE WITH ARCH PLANS.

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PROJECT NORTH

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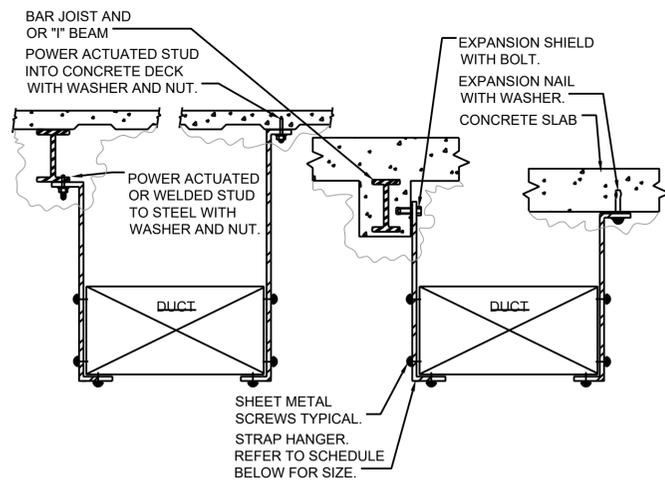
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WESTCHESTER COUNTY, NEW YORK DEPARTMENT OF PUBLIC WORKS AND TRANSPORTATION DIVISION OF ENGINEERING		CONTRACT NUMBER 23-532-Rev. M-601	SHEET NUMBER M-601
TERMINAL BUILDING HVAC-1 & HVAC-2 UPGRADES WESTCHESTER COUNTY AIRPORT TOWNS OF HARRISON, NORTH CASTLE & VILLAGE OF RYE BROOK		SHEET NO. 10 OF 19	SCALE: AS SHOWN DATE: 10/29/24

DPW FILE NO. 48-15-M-883-0	REV. NO. 0
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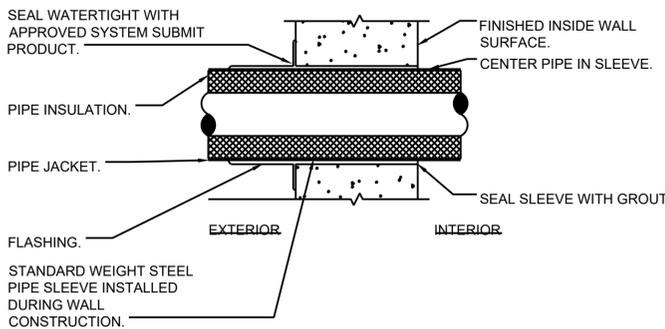
MECHANICAL SCHEDULES



- NOTES:**
- FOR DUCTS OVER 49" WIDE, THE STRAP HANGER SHALL BE TURNED UNDER THE BOTTOM OF THE DUCT.
 - WHERE EXISTING BUILDING STRUCTURAL COMPONENTS HAVE FIREPROOF MATERIAL, ANY AREA THAT IS DISTURBED OR DAMAGED AS A RESULT OF HANGER INSTALLATION SHALL BE PATCHED WITH UL AND FM APPROVED FIREPROOFING TO MATCH EXISTING.
 - ALL ANCHORS AND INSERTS SHALL HAVE NEW YORK CITY BOARD OF STANDARD AND APPEALS, (BSA) APPROVAL.

DUCT STRAP SCHEDULE		
DUCT SIZE	HANGER SIZE	MAXIMUM SPACING
UP TO 2 SQ.FT.	1" X 1/16"	8'-0"
2 SQ.FT. TO 4 SQ.FT.	1" X 1/8"	8'-0"
4 SQ.FT. TO 10 SQ.FT.	1" X 1/8"	6'-0"
OVER 10 SQ.FT.	1" X 1/8"	4'-0"


5 DUCT HANGER DETAIL
SCALE: NONE



- NOTES:**
- PIPE SLEEVE FOR EXTERIOR WALL ABOVE GRADE.

4 PIPE WALL SLEEVE DETAIL FOR EXTERIOR WALLS ABOVE GRADE
SCALE: NONE


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- NOTES:**
- HANG UNIT WITH THREADED RODS CONTAINING SPRING TYPE VIBRATION ISOLATORS FROM BUILDING STRUCTURAL MEMBERS.
 - SUSPEND UNIT HEATERS SECURELY WITH PROVISIONS FOR EASY REMOVAL AND REPAIR. COORDINATE EXACT LOCATIONS IN FIELD.
 - INSTALL UNITS SO THAT THEY HANG LEVEL AND PLUMB.
 - PROVIDE FOR EXPANSION IN SUPPLY PIPING. SWING JOINT IS SUGGESTED PIPING ARRANGEMENT.
 - PROVIDE UNIONS AND ISOLATION VALVES ADJACENT TO UNIT HEATER IN BOTH THE SUPPLY AND RETURN MAINS.
 - USE 45 DEGREE ANGLE RUN OUTS FROM ALL SUPPLY AND RETURN MAINS.
 - PROVIDE A ROOM THERMOSTAT ARRANGED TO OPEN CONTROL VALVE AND CYCLE THE FAN ON A CALL FOR HEAT, FURNISH AN AQUASTAT ARRANGED TO PREVENT FAN START UP IF HW IS NOT ENABLED AND RUNNING.

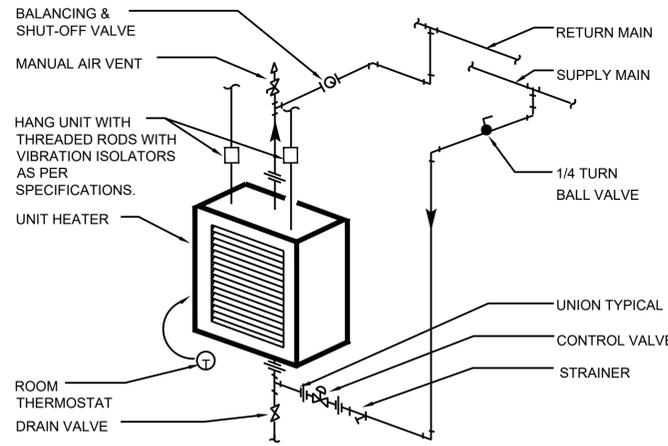
PIPE SIZE SCHEDULE												
PIPE SIZE	1/2	3/4	1	1-1/4	1-1/2	2	2-1/2	3	4	5	6	
MAX. GPM	2		3.5	7	13	22	45	70	130	260	480	750

4 VERTICAL HOT WATER HEATER PIPING SCHEMATIC
SCALE: NONE




- NOTES:**
- DUCT SUPPORT SHALL BE MIFAB MODEL DSAW12-3157. MINIMUM LENGTH SHALL BE 48" OR 12" LONGER THAN DUCT WIDTH.
 - ALL BRACKETS, HANGERS, FASTENERS AND SUPPORTS LOCATED OUTDOORS SHALL BE GALVANIZED OR NICKEL PLATED.
 - CEMENT RUBBER SUPPORT BLOCKS TO ROOF - USE ONLY MATERIALS COMPATIBLE WITH THE ROOFING SYSTEM.

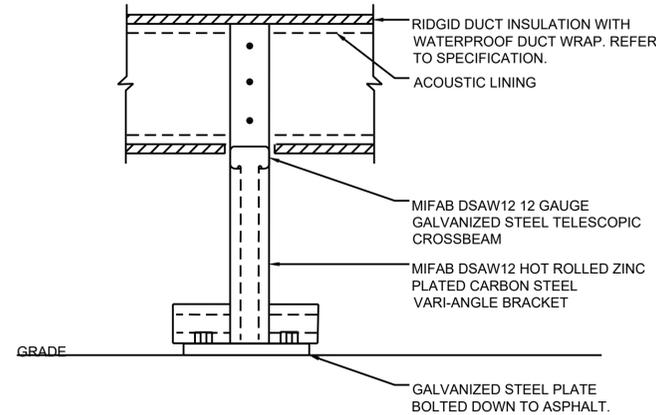3 OUTDOOR ON GRADE DUCT SUPPORT DETAIL
SCALE: NONE

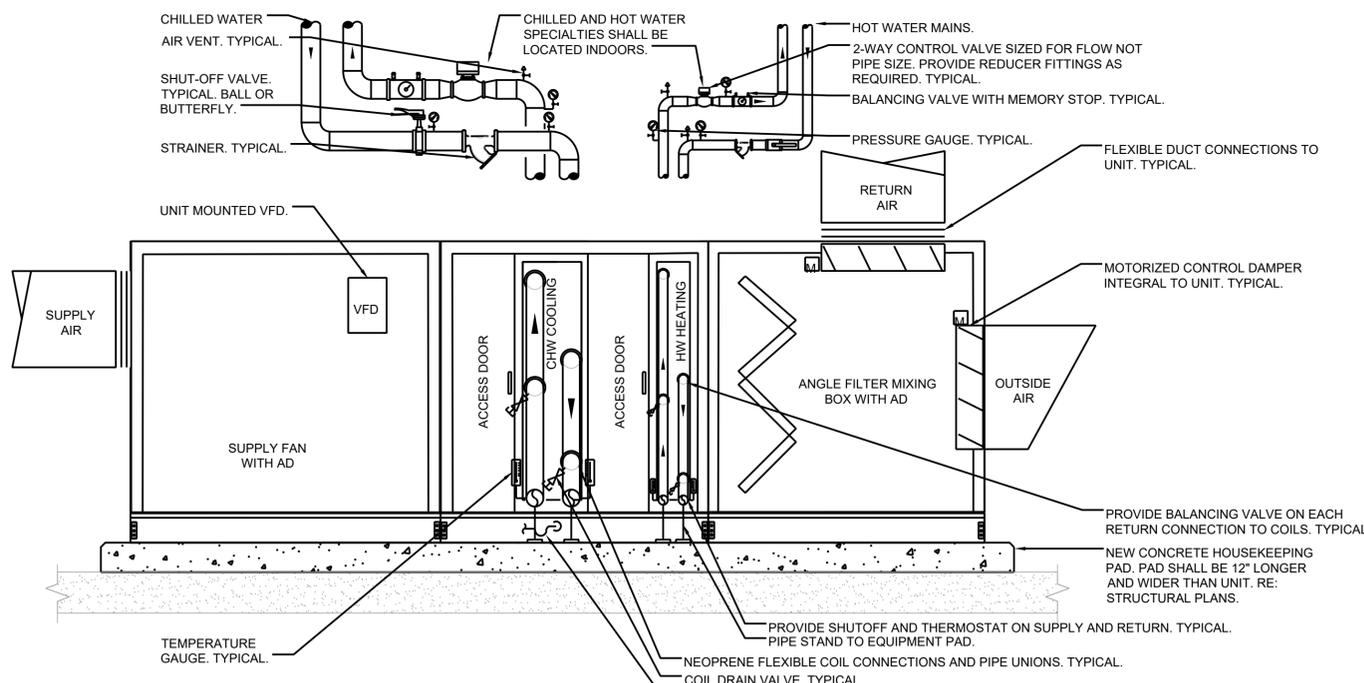

- NOTES:**
- THIS IS A DIAGRAM FOR REFERENCE ONLY. NOTHING IS TO SCALE. COORDINATE ALL REQUIREMENTS WITH SPECIFIC EQUIPMENT INSTALLATION REQUIREMENTS.
 - REFER TO FLOOR PLANS FOR ALL SIZES, PIPING & DUCTWORK ROUTING ETC.
 - REFER TO MANUFACTURERS INSTALLATION REQUIREMENTS TO MEET ALL SERVICE CLEARANCES.
 - PIPING, DUCTWORK AND ACCESSORIES SHALL NOT BE INSTALLED IN FRONT OF ACCESS DOORS.
 - ALL PIPING, DUCTWORK, INSULATION, VALVES & SPECIALTIES SHALL BE AS PER THE SPECIFICATIONS.
 - REVIEW SEQUENCE OF OPERATIONS IN SPECIFICATIONS AND PROVIDE A COMPLETE CONTROL SYSTEM ACCORDINGLY.
 - POWER SHALL BE SINGLE POINT CONNECTION. VFD SHALL BE FACTORY MOUNTED TO THE AHU.
 - PROVIDE FREEZE PROTECTION CONTROLS.
 - COORDINATE FAN ROTATION WITH DUCTWORK CONFIGURATION IN THE FIELD PRIOR TO ORDERING UNIT.
 - STATIC PRESSURE (SP) SENSOR SHALL BE LOCATED 2/3 OF THE WAY DOWNSTREAM FROM THE SUPPLY FAN OR WHERE INDICATED ON PLAN.
 - PROVIDE CONDENSATE PAN OVERFLOW LEVEL SENSOR ARRANGED TO SHUT-DOWN UNIT AND INDICATE A FAULT ON THE DDC.
 - PROVIDE MAGNEHELIC FOR EACH FILTER BANK. INSTALL PRESSURE SENSORS BEFORE AND AFTER EACH FILTER. DIFFERENTIAL PRESSURE SHALL BE MEASURED AT EACH FILTER BANK AND INDICATED ON THE BMS AIR HANDLER UNIT GRAPHIC DISPLAY. THE BMS SHALL BE CONFIGURED TO INDICATE A FILTER CHANGE OUT ALARM ON THE BMS WHEN THE DP REACHES THE SPECIFIED 50 % DIRTY VALUE IN THE THE AHU SCHEDULE.

2 AIR HANDLING UNIT ON FLOOR SCHEMATIC
SCALE: NONE

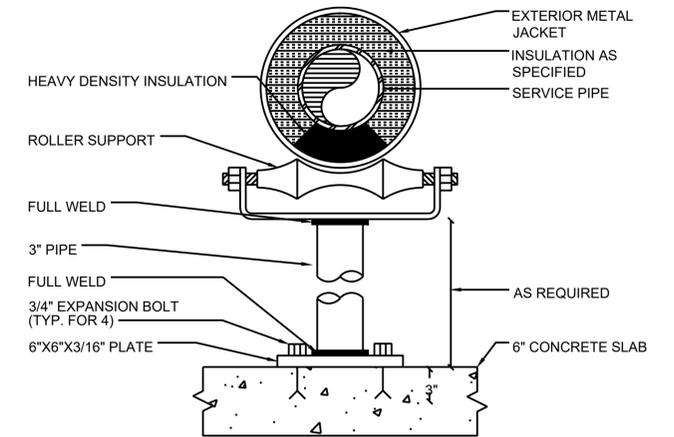

1 EXTERIOR PIPE SUPPORT DETAIL
SCALE: NONE

STRUCTURAL ENGINEER

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 246 FEDERAL ROAD, SUITE B23
 BROOKFIELD, CONNECTICUT 06804
 203-740-0990




MEP ENGINEER

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PROJECT NORTH

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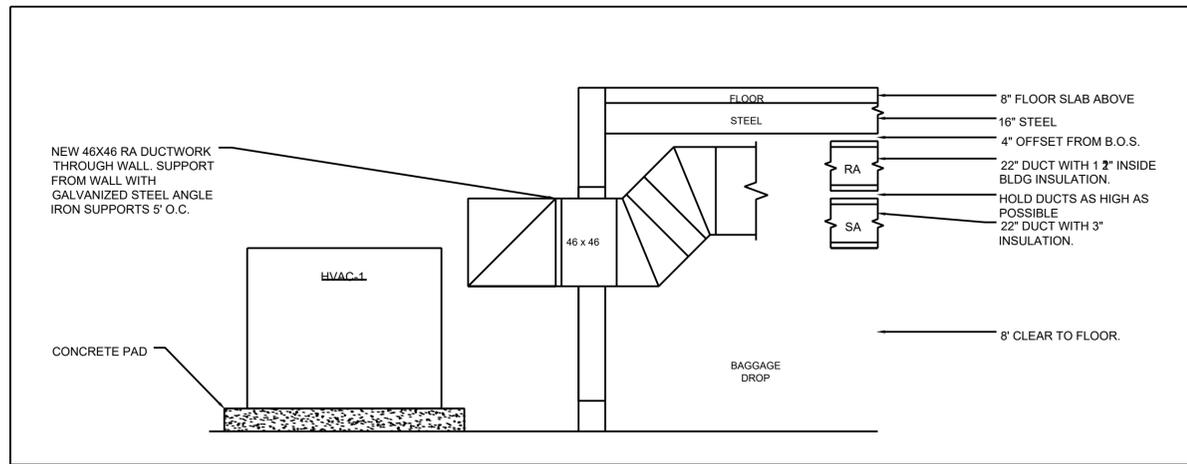
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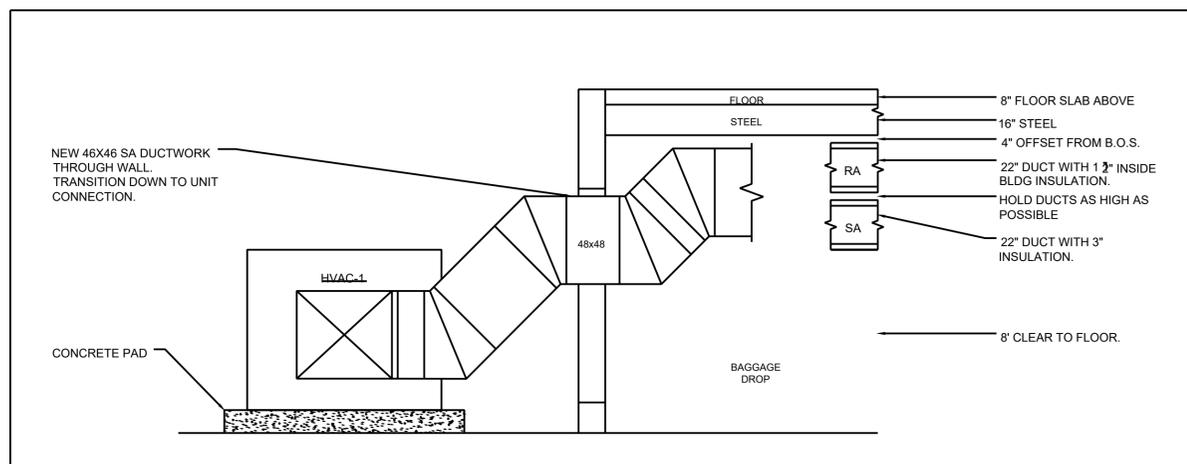
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CONTRACTOR		PROJECT COORDINATOR	
NAME	DATE	NAME	DATE
SIGNATURE		SIGNATURE	
TITLE		TITLE	


WESTCHESTER COUNTY, NEW YORK		CONTRACT NUMBER	SHEET NUMBER
DEPARTMENT OF PUBLIC WORKS		23-532-Rev.	M-701
AND TRANSPORTATION		SHEET NO. 11 OF 19	
DIVISION OF ENGINEERING		SCALE: AS SHOWN	
TERMINAL BUILDING HVAC-1 & HVAC-2 UPGRADES		DATE: 10/29/24	
WESTCHESTER COUNTY AIRPORT		DPW FILE NO.	REV. NO.
TOWNS OF HARRISON, NORTH CASTLE & VILLAGE OF RYE BROOK		48-15-M-884-0	0
MECHANICAL DETAILS			

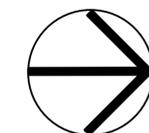

5 RETURN AIR DUCT SECTION THROUGH WALL
SCALE: 1/4" = 1'-0"




4 SUPPLY AIR DUCT SECTION THROUGH WALL
SCALE: 1/4" = 1'-0"

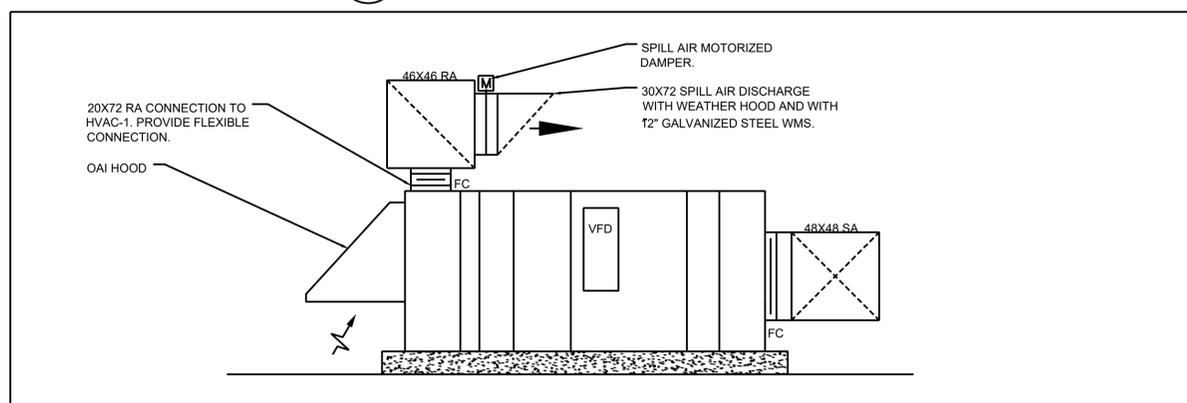

3 HVAC-1 ELEVATION VIEW
SCALE: 1/8" = 1'-0"

IN CHARGE OF PATRICK LYNCH, P.E.
CHECKED BY ROBERT SPINA, P.E. / JOSEPH FIERRO, P.E.
MADE BY JOHN TESSER P.E. / GIOVANNI DEL CID, P.E.

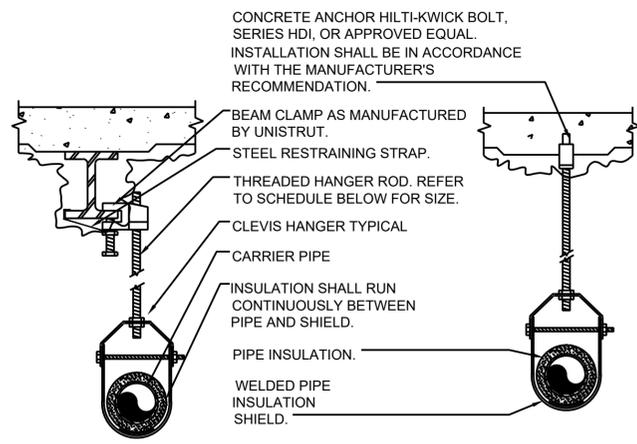


PIPE HANGER SCHEDULE

PIPE DIA.	3/4"-2"	2 1/2"-3"	4"-5"	6"	8"-12"
HANGER DIA.	3/8"	1/2"	5/8"	3/4"	7/8"

- NOTES:**
- 1.) CLEVIS HANGERS WITH WELDED INSULATION SHIELDS SIMILAR TO RAUCH FIG. 100SH ON ALL PIPES LARGER THAN 1".
 - 2.) FOR PIPES 1" OR SMALLER, A BAND HANGER WITH INSULATION SHIELD MAY BE USED SIMILAR TO RAUCH FIG. NO. 1ASH.
 - 3.) FOR NON-INSULATED PIPE, INSULATION SHIELDS MAY BE OMITTED.
 - 4.) ALL PIPE HANGERS SHALL BE GALVANIZED STEEL OR FACTORY PAINTED BLACK WITH ENAMEL.
 - 5.) FOR NON FERROUS PIPING WITHOUT INSULATION, ALL HANGERS SHALL BE COPPER PLATED OR FURNISHED WITH A DIELECTRIC BETWEEN PIPE AND HANGERS.
 - 6.) WHERE EXISTING BUILDING STRUCTURAL COMPONENTS HAVE FIREPROOF MATERIAL, ANY AREA THAT IS DISTURBED OR DAMAGED AS A RESULT OF HANGER INSTALLATION SHALL BE PATCHED WITH UL AND FM APPROVED FIREPROOFING TO MATCH EXISTING.
 - 7.) ANY AREA WITH A CEILING WHICH IS DISTURBED OR DAMAGED AS A RESULT OF HANGER INSTALLATION SHALL BE PATCHED. REPLACE WIRE LATH AND RE-CEMENT IF REQUIRED.

2 PIPE HANGER DETAIL
SCALE: NONE

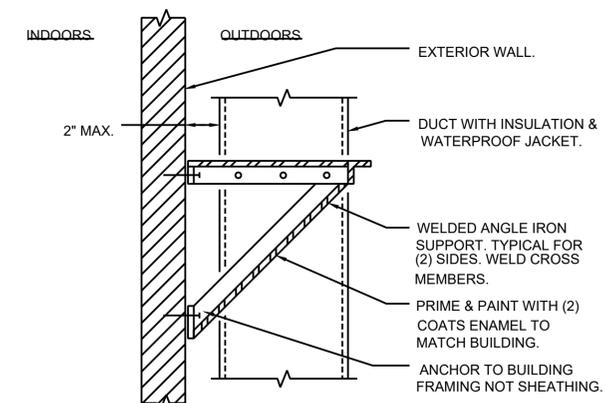


- NOTES:**
- 1.) DUCTS SHALL BE SUPPORTED AS PER "SMACNA HVAC DUCT CONSTRUCTION STANDARDS METAL AND FLEXIBLE" FIGURE 4-8.B.
 - 2.) ALL BOLT, FASTENERS, AND HARDWARE SHALL BE GALVANIZED.
 - 3.) MAXIMUM SPACING BETWEEN BRACKETS SHALL BE 12'.
 - 4.) LOCATE DUCTS AGAINST WALL OR MAXIMUM 2" AWAY FROM THE WALL.
 - 5.) EACH WALL ANCHOR SHALL SATISFY THE FOLLOWING CRITERIA UNLESS OTHER ANALYSIS IS MADE:
A.) TENSILE LOAD = 3/8 x DUCT WEIGHT, SAFETY FACTOR 4.
B.) SHEAR LOAD = 1/2 x DUCT WEIGHT, SAFETY FACTOR 4.
 - 6.) ALL SUPPORT MEMBERS SHALL BE PAINTED WITH (1) COAT OF PRIMER AND (1) COAT OF ENAMEL TO MATCH BUILDING.

ANGLE SIZING

DUCT SIZE	ANGLE SIZE	MAXIMUM SPACING
30"x12"	1" x 1" x 1/8"	12'-0"
36"x18"	1" x 1" x 1/8"	12'-0"
42"x24"	1-1/4" x 1-1/4" x 1/8"	12'-0"
48"x30"	1-1/4" x 1-1/4" x 1/8"	12'-0"

1 DUCT SUPPORT AT EXTERIOR WALL DETAIL
SCALE: NONE

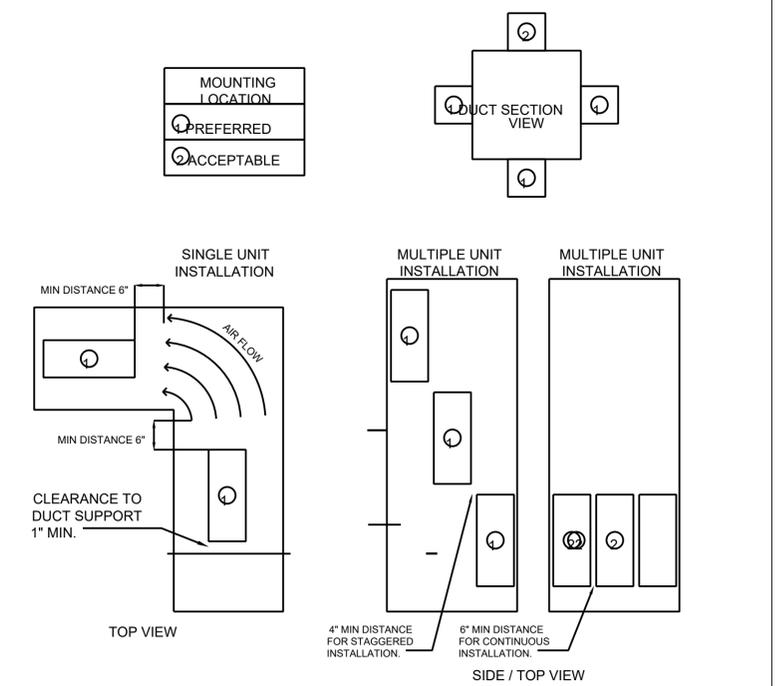

6 BIPOLAR IONIZATION MOUNTING LOCATION DETAIL
SCALE: NONE

STRUCTURAL ENGINEER

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REVISION NUMBER	DATE	MADE BY	APP'D BY	REVISION

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AS BUILT - CHANGES AS NOTED
 AS BUILT - NO CHANGES

CONTRACTOR		PROJECT COORDINATOR	
NAME	DATE	NAME	DATE
SIGNATURE		SIGNATURE	
TITLE		TITLE	

**WESTCHESTER COUNTY, NEW YORK
DEPARTMENT OF PUBLIC WORKS
AND TRANSPORTATION
DIVISION OF ENGINEERING**

TERMINAL BUILDING HVAC-1 & HVAC-2 UPGRADES
WESTCHESTER COUNTY AIRPORT
TOWNS OF HARRISON, NORTH CASTLE & VILLAGE OF RYE BROOK

MECHANICAL DETAILS

CONTRACT NUMBER 23-532-Rev. M-702	SHEET NUMBER 12 OF 19
SCALE: AS SHOWN DATE: 10/29/24	
DPW FILE NO. 48-15-M-885-0	REV. NO. 0


SYMBOLS AND ABBREVIATIONS			SYMBOL			ABBREVIATION			DESCRIPTION		
	-	CONDUIT AND WIRING		AF	AMPERAGE OF FUSE						
	-	CONDUIT & WIRING TO BE REMOVED UON		AHU	AIR HANDLING UNIT						
	-	BURIED CONDUIT		AS	AMPERAGE OF SWITCH						
	-	OVERHEAD CONDUCTORS		AWG	AMERICAN WIRE GAUGE						
	-	HOMERUN TO PANEL, ARROWS INDICATE # 1P		BCW	BARE COPPER WIRE						
	-	MULTI-POLE HOMERUN		BLDG	BUILDING						
	-	ELECTRICAL EQUIPMENT AS INDICATED		BMS	BUILDING MANAGEMENT SYSTEM						
	-	ELECTRICAL EQUIPMENT TO BE REMOVED UON		C	CONDUIT						
	-	ELECTRIC METER		CAT	CATALOG						
	-	JUNCTION BOX		CD	CANDELA						
	-	FUSED DISCONNECT SWITCH		CKT	CIRCUIT						
	-	UNFUSED DISCONNECT SWITCH		CLG	CEILING						
	-	COMBINATION MOTOR STARTER/FUSED DISC.		CU	COPPER						
	-	MOTOR STARTER		DEM.	DEMOLISH AND REMOVE						
	-	MOTOR		DISC	DISCONNECT						
	-	BATTERY PACK EMERGENCY LIGHT FIXTURE		DWG	DRAWING						
	-	SINGLE POLE SWITCH (X - INDICATES FIXTURE BEING CONTROLLED)		EMT	ELECTRICAL METALLIC TUBING						
	-	MOTOR RATED TOGGLE SWITCH		EM	EMERGENCY						
	-	DUPLEX RECEPTACLE		EX.	EXISTING TO REMAIN						
	-	DOUBLE DUPLEX RECEPTACLE		F	FLOOR						
	-	SPECIAL RECEPTACLE		GFI	GROUND FAULT INTERRUPTER						
	-	FIRE ALARM MANUAL PULL STATION		HP	HORSEPOWER						
	-	FIRE ALARM COMBINATION AUDIO/VISUAL DEVICE (15/75 CD - STROBE)		HVAC	HEATING VENTILATION AIR CONDITIONING						
	-	FIRE ALARM STROBE 15/75 CD		IG	ISOLATED GROUND						
	-	SMOKE DETECTOR, EL - ELEVATOR LOBBY; SH - SMOKE HATCH; SC - PLENUM RATED ABOVE CEILING		IMC	INTERMEDIATE METAL CONDUIT						
	-	DUCT MOUNTED SMOKE DETECTOR		KVA	KILO-VOLT-AMPERE						
	-	FIRE ALARM ANNUNCIATOR PANEL		KW	KILO-WATT						
	CM	FIRE ALARM CONTROL MODULE		MAX	MAXIMUM						
	MM	FIRE ALARM MONITORING MODULE		MCB	MAIN CIRCUIT BREAKER						
	FACP	FIRE ALARM CONTROL PANEL		MIN	MINIMUM						
	-	FIRE ALARM RELAY		MLO	MAIN LUG ONLY						
	EOL	END OF LINE RESISTOR		NO	NUMBER						
	-	SECURITY CAMERA PTZ - PAN, TILT, ZOOM		NTS	NOT TO SCALE						
	CB	CIRCUIT BREAKER		P	POLE						
	-	ENCLOSED CIRCUIT BREAKER		PNL	PANEL						
	-	FUSED SWITCH		PVC	POLY VINYL CHLORIDE						
	GND	GROUND AS PER LOCAL CODE		REL.	REMOVE AND RELOCATE						
	XFMR	TRANSFORMER		RGS	RIGID GALVANIZED STEEL						
	CT	CURRENT TRANSFORMER		RTU	ROOF TOP UNIT						
	NC	NORMALLY CLOSED CONTACTS		SCH	SCHEDULE						
	NO	NORMALLY OPEN CONTACTS		SPD	SURGE PROTECTION DEVICE						
	MD	MOTORIZED DAMPER		SW	SWITCH(ES)						
	SD OR CFSD	SMOKE DAMPER		TYP	TYPICAL						
	UH	UNIT HEATER		UG	UNDERGROUND						
	A	AMPERE(S)		UON	UNLESS OTHERWISE NOTED						
	AC	AIR CONDITIONER		V	VOLT(S)						
	ACC	AIR CONDITIONER CONDENSER		WP	WEATHERPROOF						
	AFF	ABOVE FINISHED FLOOR									

IN CHARGE OF PATRICK LYNCH, P.E.
 CHECKED BY ROBERT SPINA, P.E. / JOSEPH FIERRO, P.E.
 MADE BY JOHN TESSER P.E. / GIOVANNI DEL CID, P.E.

NOTES:
 1. ALL SYMBOLS AND ABBREVIATIONS MAY NOT BE APPLICABLE FOR THIS PROJECT.
 2. SEE LIGHTING FIXTURE SCHEDULE FOR LIGHT FIXTURE SYMBOLS.

TYPICAL BRANCH CIRCUIT WIRING LEGEND

- 2-#12 & 1-#12 GND (1-1P-20A OR 1-1P-15A CB)
- 3-#12 & 1-#12 GND (3P-20A OR 3P-15A CB)
- 2-#12 & 1-#12 GND (2P-20A OR 2P-15A CB)

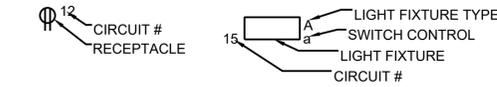

NOTES:

- EACH 120V AND 277V CIRCUIT SHALL HAVE A DEDICATED NEUTRAL CONDUCTOR. SHARED NEUTRAL HOMERUNS ARE NOT PERMITTED.
- CONDUCTORS SHALL BE INCREASED FOR VOLTAGE DROP AND DERATING AS PER APPLICABLE ELECTRICAL CODE. FOR CIRCUITS THAT ARE BETWEEN 100' AND 150' IN LENGTH, PHASE AND NEUTRAL CONDUCTORS SHALL BE #10 AWG. FOR CIRCUITS THAT ARE BETWEEN 150' AND 225' IN LENGTH, PHASE AND NEUTRAL CONDUCTORS SHALL BE #8 AWG. FOR LENGTHS GREATER THAN 225' IN LENGTH, VERIFY CONDUCTOR SIZES WITH ENGINEER.

DEFINITION OF TERMS

- WHEREVER IN THE CONTRACT DOCUMENTS THE WORD "CLIENT" IS USED, IT MUST BE UNDERSTOOD THAT "WESCHESTER COUNTY DEPARTMENT OF PUBLIC WORKS AND TRANSPORTATION" IS INTENDED.
- WHEREVER IN THE CONTRACT DOCUMENTS THE WORD "ENGINEER" IS USED, IT MUST BE UNDERSTOOD THAT "OLA CONSULTING ENGINEERS" IS INTENDED.
- WHEREVER IN THE CONTRACT DOCUMENTS THE WORDS "ELECTRICAL UTILITY" OR "POWER COMPANY" ARE USED, IT MUST BE UNDERSTOOD THAT "CON ED" IS INTENDED.
- WHEREVER IN THE CONTRACT DOCUMENTS THE WORDS "FIRE ALARM SYSTEM" OR "FIRE ALARM VENDOR" ARE USED, IT MUST BE UNDERSTOOD THAT "SIEMENS" IS INTENDED.
- "WORK" MUST BE DEEMED TO CONSIST OF ALL LABOR AND OPERATIONS, TRANSPORTATION, HOISTING, MATERIALS, TOOLS, EQUIPMENT, SERVICES, INSPECTIONS, INVESTIGATIONS, COORDINATION AND SUPERVISION REQUIRED AND / OR REASONABLY NECESSARY TO PRODUCE THE CONSTRUCTION REQUIRED BY THE CONTRACT DOCUMENTS.
- "FURNISH" MEANS THE DESIGN, FABRICATION, PURCHASE AND DELIVERY TO THE JOB SITE.
- "INSTALL OR INSTALLATION" MEANS THE ACT OF PHYSICALLY PLACING, APPLYING, SETTING, ERECTING, ANCHORING, SECURING, ETC., CONSTRUCTION MATERIALS, EQUIPMENT, FURNISHINGS, APPLIANCES, AND SIMILAR ITEMS SPECIFIED AND FURNISHED AT THE JOB SITE. INSTALLATION OF SPECIFIED ITEMS MUST BE COMPLETE IN ALL RESPECTS.
- "PROVIDE" MEANS TO FURNISH AND INSTALL CONSTRUCTION MATERIAL, EQUIPMENT, ETC. AS DEFINED ABOVE.
- THE FOLLOWING ARE DEFINITIONS OF SHOP DRAWING STAMP ACTIONS:
 - A. "NO EXCEPTIONS TAKEN" MEANS THAT THE SHOP DRAWING IS CORRECT AS TO PERFORMANCE, CAPACITY, ETC. AND SUBSTANTIAL CONFORMANCE TO THE CONTRACT DRAWINGS AND SPECIFICATIONS. FABRICATION AND/OR PURCHASE MAY COMMENCE.
 - B. "MAKE CORRECTIONS NOTED" MEANS THAT THE SHOP DRAWING IS CORRECT AS TO PERFORMANCE, CAPACITY, ETC. AND SUBSTANTIAL CONFORMANCE TO THE CONTRACT DRAWINGS AND/OR SPECIFICATIONS, SUBJECT TO AND IN COMPLIANCE WITH THE ANNOTATIONS AND/OR CORRECTIONS INDICATED ON THE SHOP DRAWING. FABRICATION AND/OR PURCHASE MAY COMMENCE.
 - C. "AMEND AND RESUBMIT" MEANS THAT THE COMMENTS AND/OR CORRECTION ARE SO EXTENSIVE AND IMPORTANT THAT THE REVIEWER WANTS TO SEE HOW THE COMMENTS AND/OR CORRECTIONS ARE RESOLVED PRIOR TO RELEASE FOR FABRICATION AND/OR PURCHASE. FABRICATIONS AND/OR PURCHASE MAY NOT COMMENCE.
 - D. "REJECTED" MEANS THAT THE SHOP DRAWING DOES NOT COMPLY OR CONFORM TO THE CONTRACT DRAWINGS AND/OR SPECIFICATIONS. FABRICATION AND/OR PURCHASE MAY NOT COMMENCE.


GENERAL NOTES

- ALL WORK SHOWN IS NEW UNLESS OTHERWISE NOTED (UON) EXISTING TO REMAIN (EX.).
- THE DRAWINGS ARE TO BE CONSIDERED SCHEMATIC ONLY AND DO NOT NECESSARILY SHOW THE EXACT LOCATIONS AND DETAILS OF THE WORK TO BE INSTALLED.
- THE CONTRACTOR SHALL BE RESPONSIBLE FOR OBTAINING ALL NECESSARY PERMITS AND PAYING ALL FEES ASSOCIATED WITH THIS WORK INCLUDING FILING WITH THE UTILITY COMPANY (AS REQUIRED), AND WITH LOCAL AUTHORITY HAVING JURISDICTION.
- CONTRACTOR SHALL BE RESPONSIBLE TO HIRE A THIRD PARTY ELECTRICAL INSPECTION AGENCY TO PROVIDE UL INSPECTIONS AND SUBMIT A CERTIFICATE OF INSPECTION PRIOR TO FINAL REQUEST FOR PAYMENT.
- ALL WORK INVOLVING THE ELECTRIC SERVICE SHALL BE COORDINATED AND APPROVED BY THE UTILITY COMPANY.
- ALL CONDUCTORS SHALL BE COPPER UON "ON DRAWINGS".
- ELECTRONIC FILES OF THE MECHANICAL, ELECTRICAL, PLUMBING AND FIRE PROTECTION DRAWINGS ARE AVAILABLE TO THE CONTRACTOR. THE ENGINEER MAY GRANT THE CONTRACTOR A LIMITED LICENSE TO MAKE A DERIVATIVE WORK OF THE DATABASE FOR THE PURPOSE OF SHOP DRAWINGS, SUBMITTALS AND AS-BUILT DRAWINGS. UPON REQUEST, THE ENGINEER SHALL PROVIDE A RELEASE FORM THAT MUST BE SIGNED AND RETURNED BY THE CONTRACTOR PRIOR TO RELEASE OF THE ELECTRONIC FILES.
- CIRCUIT NUMBERS ARE FOR INFORMATION PURPOSES ONLY. ACTUAL CIRCUIT NUMBERS SHALL BE DETERMINED IN THE FIELD.
- CORE DRILLING OR TRENCHING THROUGH AN EXISTING FLOOR SLAB, WHEN REQUIRED, SHALL BE COORDINATED WITH THE OWNER. FLOOR SLABS SHALL BE RADAR SCANNED PRIOR TO CORE DRILLING OR TRENCHING. ALL WORK, INCLUDING CORE DRILLING, RADAR SCAN, INSTALLATION OF FIRE STOPPING, & CONDUIT/CABLE INSTALLATION SHALL BE PERFORMED DURING NON-BUSINESS HOURS AND INCLUDED IN BASE BID. USE EXTREME CAUTION DURING ANY CUTTING OPERATION TO AVOID DAMAGE TO EXISTING EQUIPMENT/SYSTEMS. ANY ITEMS DAMAGED AS A RESULT OF CORE DRILLING SHALL BE REPAIRED AT NO COST TO THE CLIENT. ALL CORES SHALL BE FIRE SEALED.

- WHERE GFI RECEPTACLES ARE CIRCUITED WITH GENERAL CONVENIENCE RECEPTACLES, THE GFI RECEPTACLE SHALL BE THE LAST DEVICE ON THE CIRCUIT.
- INSTALL CONDUIT EXPANSION FITTINGS AT ALL LOCATIONS WHERE CONDUITS CROSS BUILDING OR STRUCTURE EXPANSION JOINTS.
- UNLESS OTHERWISE NOTED, DISCONNECT SWITCHES, STARTERS, HOAS AND MOTOR RATED TOGGLE SWITCHES FOR MECHANICAL PUMPS, CABINET AND UNIT HEATERS, RETURN FANS, ROOF FANS, VAV BOXES, COMPRESSORS, FAN COIL UNITS, AIR HANDLERS AND CONDENSERS SHALL BE FURNISHED BY THE CONTRACTOR AND INSTALLED BY THE CONTRACTOR. COORDINATE ALL WORK WITH THE CONTRACTOR.
- DISCONNECT SWITCHES FOR MOTORIZED DAMPERS, CFSD/SD AND VAV BOXES SUPPLIED BY CONTRACTOR AND INSTALLED AND WIRED BY CONTRACTOR. SWITCHES NOT SHOWN ON PLANS.
- ALL DUPLEX AND QUAD RECEPTACLE SHALL BE LABELED WITH THE CIRCUIT NUMBER WHICH IT SERVES. ALPHANUMERICS TO BE 1/8" HIGH AND BLACK ON CLEAR BACKGROUND. LABELS SHALL BE SELF ADHESIVE. IDENTIFY ASSOCIATED PANEL AND CIRCUIT NUMBER.
- THE CONTRACTOR SHALL PROVIDE ALL CUTTING, PATCHING, PAINTING, AND FINAL RESTORATION REQUIRED TO FACILITATE THE DEMOLITION AND INSTALLATION OF ALL ELECTRICAL EQUIPMENT, INCLUDING BUT NOT LIMITED TO PANELBOARDS, CONDUITS, WIRING, DEVICES, FIXTURES, ETC. INCLUDING ABOVE CEILINGS. CONTRACTOR TO REMOVE AND REPLACE CEILINGS, AND OPEN AND PATCH WALLS, AS REQUIRED TO EXECUTE THE ELECTRICAL WORK.
- CONTRACTOR SHALL BE RESPONSIBLE TO HIRE AND PAY ALL FEES FOR THE UL FIELD EVALUATION SERVICE TO RE-INSPECT AND RE-CERTIFY THE SWITCHBOARD IN RELATION TO MODIFICATIONS REQUIRED WHEN TAPPING THE BUS. CONTRACTOR SHALL SCHEDULE WITH UL PRIOR TO START OF WORK. UL SHALL BE PRESENT WHILE TAPPING OF THE SWITCHBOARD IS EXECUTED. (TEL: 1-877-ULHELPS)

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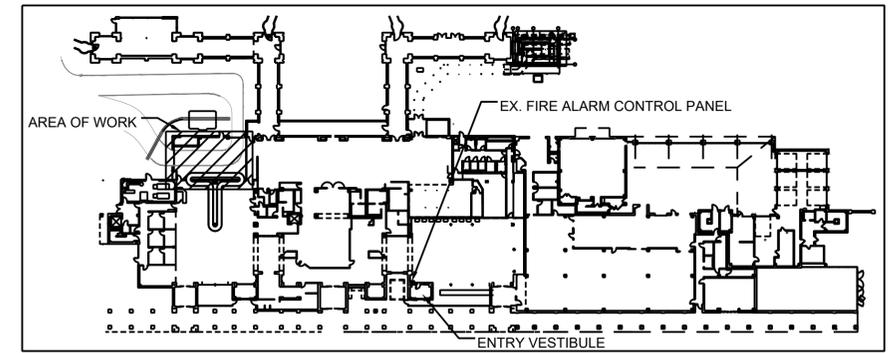
REVISION NUMBER	DATE	MADE BY	APP'D BY	REVISION

RECORD DRAWING CERTIFICATION

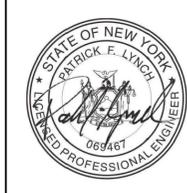
<input type="checkbox"/> AS BUILT - CHANGES AS NOTED <input type="checkbox"/> AS BUILT - NO CHANGES		CONTRACTOR: <u>WESTCHESTER COUNTY, NEW YORK DEPARTMENT OF PUBLIC WORKS AND TRANSPORTATION DIVISION OF ENGINEERING</u>		PROJECT COORDINATOR: _____	
NAME: _____ SIGNATURE: _____ TITLE: _____		NAME: _____ SIGNATURE: _____ TITLE: _____		DATE: _____ SHEET NUMBER: <u>13</u> OF <u>19</u>	
SCALE: AS SHOWN DATE: <u>10/29/24</u>				SHEET NO. <u>13</u> OF <u>19</u>	
DPW FILE NO. <u>48-15-E-886-0</u>				REV. NO. <u>0</u>	

DEMOLITION NOTES:

1. ALL EQUIPMENT SHALL BE DISCONNECTED AND REMOVED BACK TO POWER SOURCE ORIGINATION UNLESS OTHERWISE NOTED (UON) EXISTING TO REMAIN (EX.).
2. CONTRACTOR SHALL VERIFY EXTENT OF DEMOLITION WORK IN THE FIELD PRIOR TO BID AND SHALL INCLUDE ALL LABOR AND MATERIALS IN BASE BID INCLUDING ALL TEMPORARY CONNECTIONS, CONDUIT AND WIRE IN ORDER TO ACCOMMODATE CONSTRUCTION AND PROVIDE CONTINUOUS SERVICE TO DEVICES AND SYSTEMS TO REMAIN, TEMPORARY AND PERMANENTLY. WORK REQUIRING THE SHUT-DOWN OF THE BUILDING POWER SHALL BE PERFORMED DURING OVERTIME AND SHALL BE INCLUDED IN BASE BID.
3. CIRCUIT BREAKER, CONDUIT AND CONDUCTOR SIZES INDICATED SHALL BE FIELD VERIFIED PRIOR TO BID.
4. ALL EXISTING ELECTRICAL EQUIPMENT NO LONGER IN USE, SUCH AS DISCONNECT SWITCHES, MOTOR CONTROLLERS, MOTOR STARTER PANELS, ETC. SHALL BE REMOVED UON.
5. ALL DISCONNECTED & REMOVED EXISTING ELECTRICAL ITEMS THAT ARE NOT BEING REUSED SHALL BE RETURNED TO THE OWNER OR DISPOSED OF AS DIRECTED.
6. THE CONTRACTOR SHALL INCLUDE IN THE BASE BID FOR ALL MATERIAL & LABOR REQUIRED FOR THE EXTENSIONS, REROUTING & RELOCATION OF EXISTING SYSTEM COMPONENTS, EQUIPMENT, WIRING, CONDUITS & CABLING SO AS TO MAINTAIN OPERATION OF ALL SYSTEMS THROUGHOUT THE BUILDING DURING DEMOLITION & CONSTRUCTION PHASES.



2 FIRST FLOOR KEY PLAN
SCALE: 1/84" = 1'-0"
NORTH

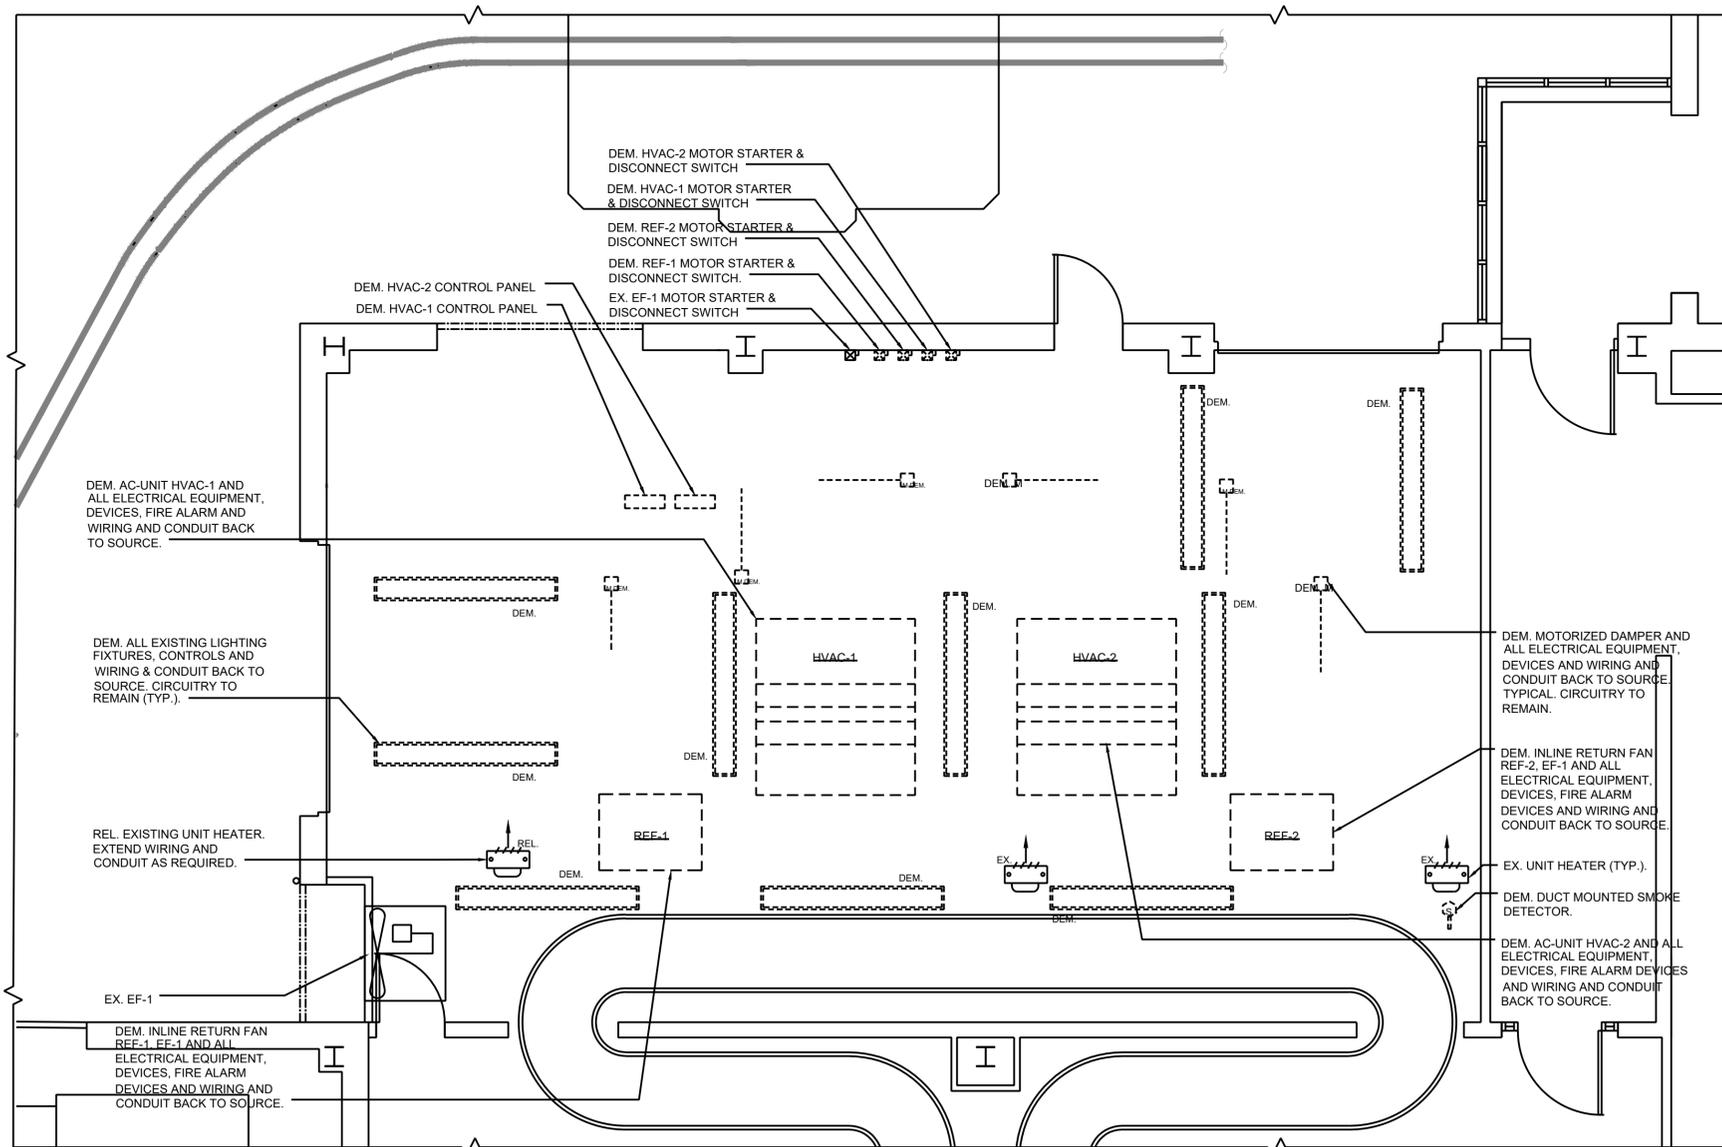

1 ELECTRICAL DEMOLITION FIRST FLOOR PART PLAN
SCALE: 1/4" = 1'-0"
NORTH

NOTES:

1. REFER FOR SYMBOLS, ABBREVIATION AND NOTES ON DWG E-001.00

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RECORD DRAWING CERTIFICATION				
<input type="checkbox"/> AS BUILT - CHANGES AS NOTED <input type="checkbox"/> AS BUILT - NO CHANGES		CONTRACTOR: _____ PROJECT COORDINATOR: _____ NAME: _____ NAME: _____ SIGNATURE: _____ SIGNATURE: _____ TITLE: _____ TITLE: _____		
WESTCHESTER COUNTY, NEW YORK DEPARTMENT OF PUBLIC WORKS AND TRANSPORTATION DIVISION OF ENGINEERING		CONTRACT NUMBER 23-532-Rev.	SHEET NUMBER E-101	
TERMINAL BUILDING HVAC-1 & HVAC-2 UPGRADES WESTCHESTER COUNTY AIRPORT TOWNS OF HARRISON, NORTH CASTLE & VILLAGE OF RYE BROOK		SHEET NO. 14 OF 19	SCALE: AS SHOWN DATE: 10/29/24	
ELECTRICAL FIRST FLOOR PART PLAN - DEMOLITION		DPW FILE NO. 48-15-E-887-0	REV. NO. 0	


IN CHARGE OF PATRICK LYNCH, P.E.
 CHECKED BY ROBERT SPINA, P.E. / JOSEPH FIERRO, P.E.
 MADE BY JOHN TESSER P.E. / GIOVANNI DEL CID, P.E.

LIGHTING FIXTURE SCHEDULE (SITE ONLY)

FIXTURE DESIGNATION	MANUFACTURER	CATALOG NUMBER	LAMPS	VOLTS	INPUT WATTS (W)	MOUNTING	REMARKS
A	LITHONIA LIGHTING	VAP 8000LM PCL MD MVOLT 50K 90CRI	LED 5000K	120-277V	66.9	PENDANT/SURFACE	INDUSTRIAL TYPE LED LIGHTING FIXTURE.

NOTES:

1. VERIFY ALL FIXTURE CATALOG NUMBERS FOR INTENDED APPLICATIONS WITH REQUIRED ACCESSORIES.
2. IN THE EVENT THE CONTRACTOR CHOOSES TO SUBSTITUTE LIGHT FIXTURES FOR THOSE THAT ARE SPECIFIED ON THE LIGHT FIXTURE SCHEDULE, THE CONTRACTOR SHALL SUBMIT POINT-TO-POINT PHOTOMETRIC CALCULATIONS FOR ALL AREAS WHERE THE SUBSTITUTED FIXTURES ARE INDICATED TO BE INSTALLED ON THE DRAWINGS. THESE CALCULATIONS SHALL BE SUBMITTED ALONG WITH THE LIGHT FIXTURE SHOP DRAWINGS.

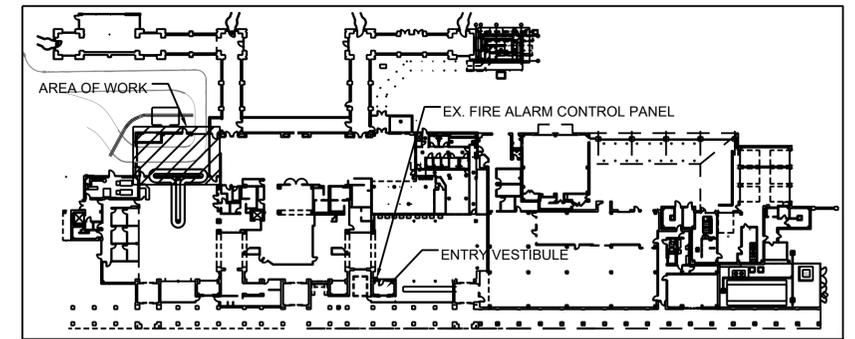


2 FIRST FLOOR KEY PLAN
SCALE: 1/64" = 1'-0"
NORTH

HVAC SEQUENCE OF OPERATION MATRIX FOR FIRE ALARM & SMOKE PURGE

NOTE: FIRE ALARM SYSTEM SHALL BE PROGRAMMED AS FOLLOWS:

UNIT	NORMAL OPERATION	FIRE ALARM	SMOKE PURGE
HVAC-1	ON	OFF	ON
OA DAMPER AT HVAC-1	OPEN	CLOSED	OPEN
RA DAMPER AT HVAC-1	OPEN	CLOSED	CLOSED
SPILL AIR DAMPER	OPEN	CLOSED	CLOSED
SA DAMPERS (2)	OPEN	CLOSED	OPEN
RA DAMPERS (2)	OPEN	CLOSED	CLOSED
RF-1A	ON	OFF	OFF
RF-1B	ON	OFF	OFF

NOTE: EXISTING SMOKE PURGE FANS WILL CONTINUE TO OPERATE AS PROGRAMMED FOR SMOKE PURGE SEQUENCE.

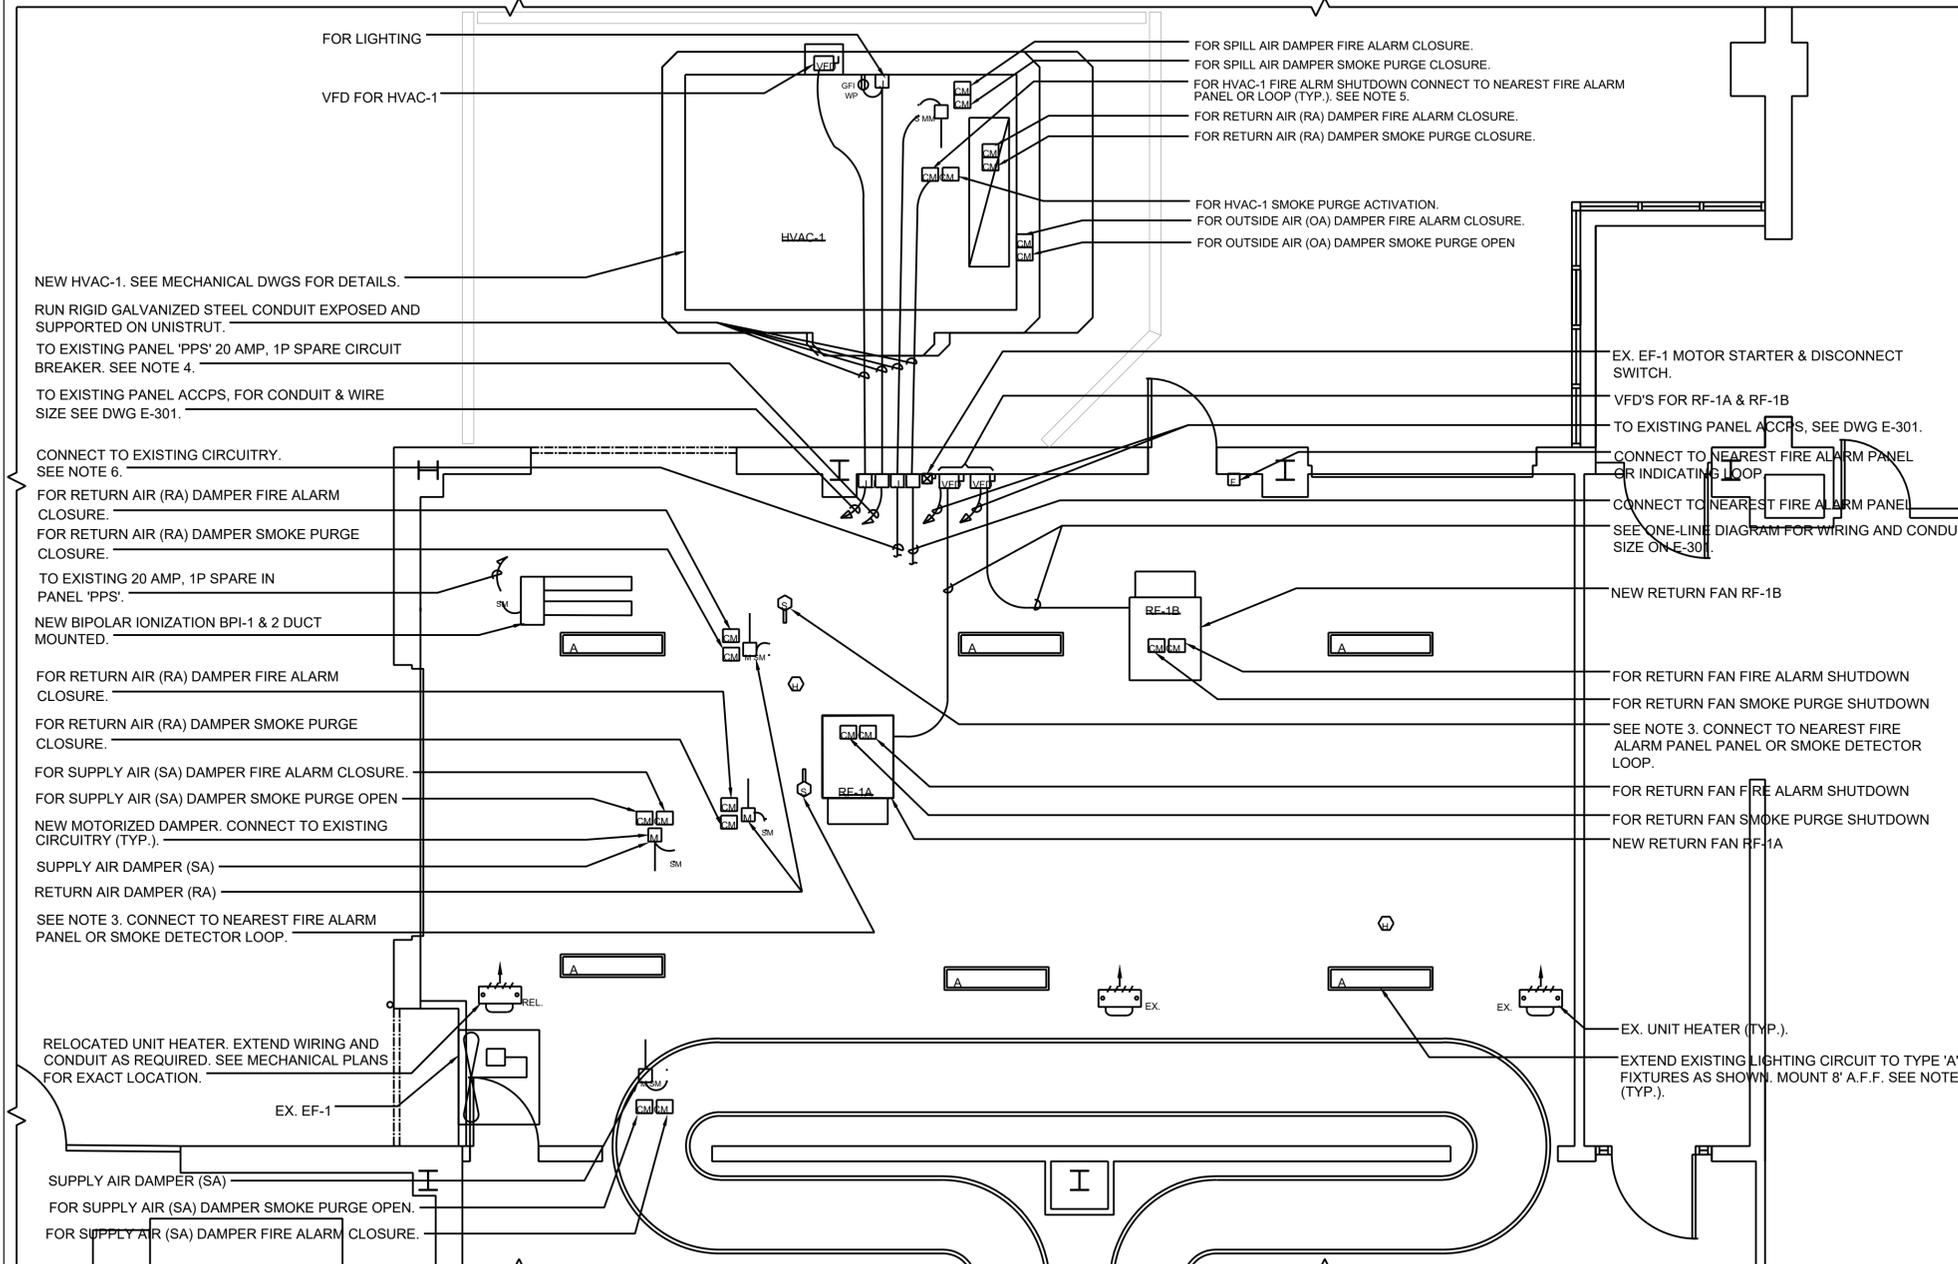

1 ELECTRICAL FIRST FLOOR PART PLAN - POWER & LIGHTING
SCALE: 1/4" = 1'-0"
NORTH

NOTES:

1. REFER FOR SYMBOLS, ABBREVIATION AND NOTES ON DWG E-001.00.
2. COORDINATE FINAL LOCATION OF LIGHTING FIXTURES WITH MECHANICAL EQUIPMENT AND EXISTING FENCE.
3. DETECTION OF SMOKE SHALL SHUTDOWN HVAC-1, RF-1A AND RF-1B. COORDINATE ALL PROGRAMMING WITH AIRPORT'S FIRE ALARM VENDOR.
4. FOR ELECTRICAL PANEL LOCATIONS SEE PART PLANS ON E-301.
5. SEE FIRE ALARM & SMOKE PURGE SEQUENCE OF OPERATION MATRIX FOR HVAC SYSTEM. FOR ADDITIONAL INFORMATION ON SMOKE PURGE SEQUENCE & FIRE ALARM SHUTDOWN SEQUENCE REFER TO SPECIFICATION 237313FL SECTION 3.09. CONTACT JEFF TODELE AT SIEMENS FIRE ALARM AT 973 396-4386. SEE FIRST FLOOR KEY PLAN FOR LOCATION OF FIRE ALARM CONTROL PANEL.
6. EXTEND EXISTING CIRCUITRY FOR MOTORIZED DAMPERS TO ALL LOCATIONS SHOWN ON FLOOR PLAN.

IN CHARGE OF PATRICK LYNCH, P.E.
CHECKED BY ROBERT SPINA, P.E. / JOSEPH FIERRO, P.E.
MADE BY JOHN TESSER P.E. / GIOVANNI DEL CID, P.E.

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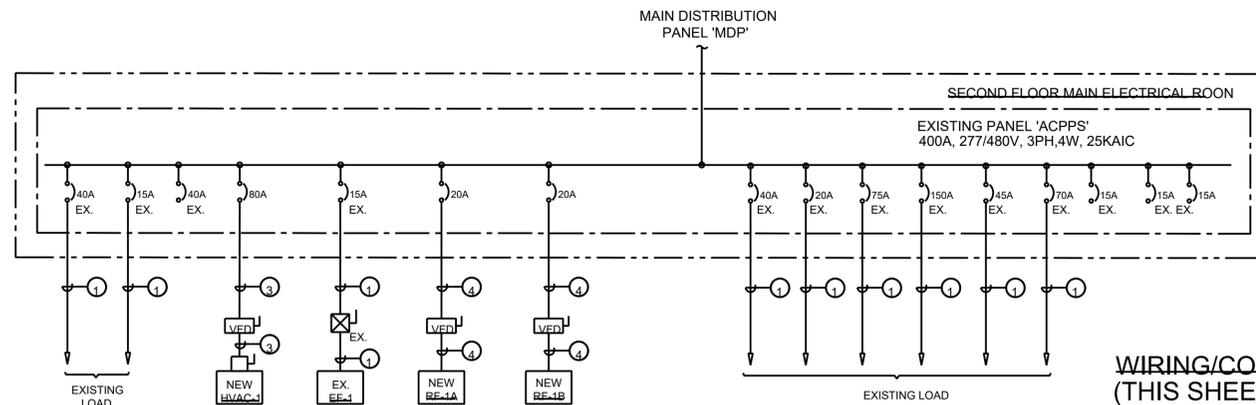
PROJECT NORTH

REVISION NUMBER	DATE	MADE BY	APP'D BY	REVISION

RECORD DRAWING CERTIFICATION

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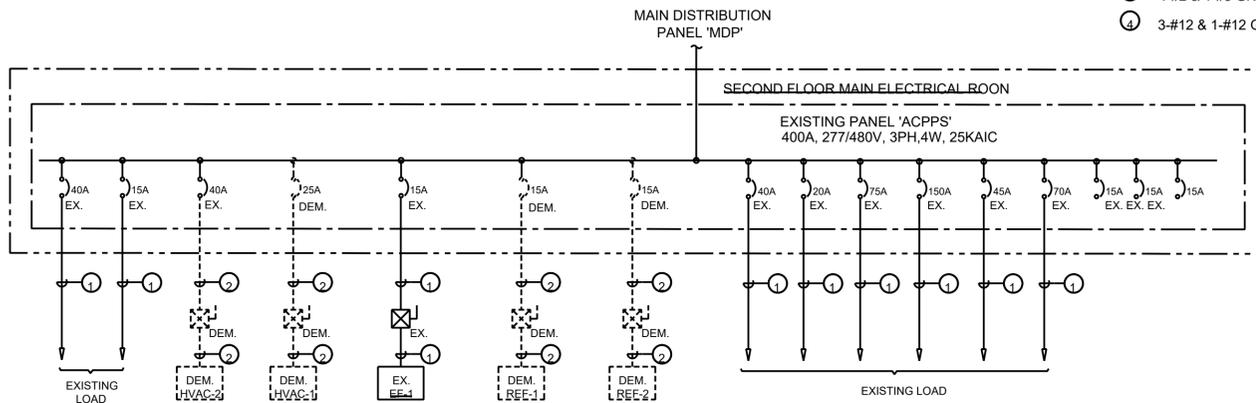
CONTRACTOR		PROJECT COORDINATOR	
NAME	SIGNATURE	NAME	SIGNATURE
TITLE	DATE	TITLE	DATE
WESTCHESTER COUNTY, NEW YORK DEPARTMENT OF PUBLIC WORKS AND TRANSPORTATION DIVISION OF ENGINEERING		CONTRACT NUMBER	SHEET NUMBER
		23-532-Rev.	E-201
TERMINAL BUILDING HVAC-1 & HVAC-2 UPGRADES WESTCHESTER COUNTY AIRPORT TOWNS OF HARRISON, NORTH CASTLE & VILLAGE OF RYE BROOK		SHEET NO. 15 OF 19	SCALE: AS SHOWN DATE: 10/29/24
ELECTRICAL FIRST FLOOR PLAN - NEW WORK		DPW FILE NO. 48-15-E-888-0	REV. NO. 0




3 ELECTRICAL PART ONE-LINE DIAGRAM - NEW WORK
NOT TO SCALE

WIRING/CONDUIT LEGEND:
(THIS SHEET ONLY)

- ① EX. WIRE AND CONDUIT
- ② DEM. WIRE & CONDUIT
- ③ 4-#2 & 1-#8 GND IN 1-1/4" C.
- ④ 3-#12 & 1-#12 GND IN 3/4" C.



2 ELECTRICAL PART ONE-LINE DIAGRAM - DEMOLITION
NOT TO SCALE

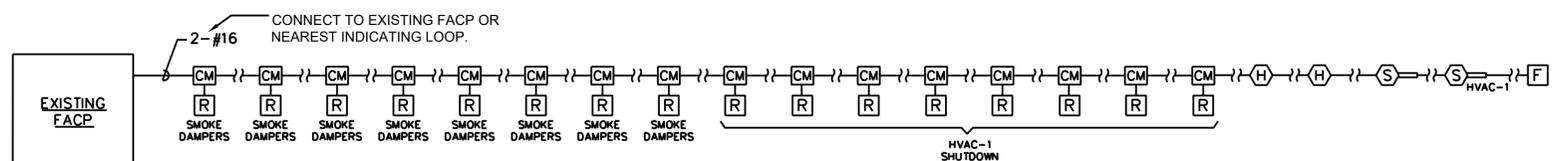


1 FIRE ALARM RISER DIAGRAM
SCALE: NONE


RISER NOTES:

- 1.) THIS IS NOT A POINT-TO-POINT WIRING DIAGRAM. PRIOR TO STARTING ANY WORK, A WORKING POINT-TO-POINT WIRING DIAGRAM SHALL BE OBTAINED FROM FIRE ALARM SYSTEM VENDOR AND PERFORM ALL WORK IN ACCORDANCE WITH THAT DIAGRAM.
- 2.) CONTRACTOR SHALL INCLUDE IN THE BASE BID ALL 120V CIRCUITS THAT ARE REQUIRED TO SUPPORT THE OPERATION OF THE FIRE ALARM SYSTEM. COORDINATE REQUIREMENTS WITH THE FIRE ALARM VENDOR.
- 3.) QUANTITY OF STROBE BOOSTER POWER SUPPLY PANELS AND ASSOCIATED 120V CIRCUITS SHALL BE COORDINATED WITH SELECTED FIRE ALARM SYSTEM MANUFACTURER AND/OR FIRE ALARM VENDOR.
- 4.) PROVIDE ALL NECESSARY WIRING, MODULES, COMPONENTS, EXTENDER CABINET, AND PROGRAMMING REQUIRED TO CONNECT NEW DEVICES TO EXISTING SYSTEM.
- 5.) PROVIDE ALL NECESSARY HARDWARE AND PROGRAMMING TO PROVIDE THE CLIENT WITH 20% SPARE CAPACITY ON ALL INITIATING AND INDICATING CIRCUITS.
- 6.) PROVIDE AS PART OF THE BASE CONTRACT ALL LABOR AND MATERIALS TO INSTALL FOUR (4) ADDITIONAL FIRE ALARM DEVICES DURING CONSTRUCTION. THE ADDITIONAL FIRE ALARM DEVICES CAN BE BUT NOT LIMITED TO SMOKE DETECTOR, HEAT DETECTOR, DOOR HOLDER, DUCT DETECTOR, FAN SHUTDOWN, TAMPER SWITCHES, FLOW SWITCHES, ETC. INCLUDE ALL LABOR AND MATERIALS INCLUDING WIRE, BOXES, CONDUIT, TERMINATIONS, HARDWARE, SOFTWARE, PROGRAMMING AND TESTING.
- 7.) DUCT SMOKE DETECTORS SHALL BE FURNISHED AND WIRED BY CONTRACTOR AND INSTALLED IN DUCT WORK BY CONTRACTOR.
- 8.) PROVIDE ALL FIRE ALARM PROGRAMMING AT EXISTING FIRE ALARM CONTROL PANEL FOR ALL NEW DEVICES. SEE HVAC SEQUENCE OF OPERATION MATRIX FOR FIRE ALARM AND SMOKE PURGE ON DRAWING E-201 FOR PROGRAMMING OF ADDITIONAL DEVICES FOR HVAC SYSTEM. PROVIDE ALL NECESSARY MODULES, AND DEVICES FOR REQUIRED PROGRAMMING.
- 9.) ALL VISUAL ALARM DEVICES SHALL BE ADA COMPLIANT.
- 10.) CONTRACTOR TO PROVIDE A RELAY FOR EACH SMOKE DAMPER/COMBINATION FIRE SMOKE DAMPER. RELAYS ARE NOT SHOWN ON PLANS FOR CLARITY.

- 11.) PROVIDE REMOTE LED INDICATORS FOR ALL CONCEALED FIRE ALARM DEVICES SUCH AS DUCT SMOKE DETECTORS, ABOVE CEILING SMOKE DETECTORS, ELEVATOR SHAFT DETECTORS, MONITORING AND CONTROL MODULES, ETC. LED INDICATORS FOR DEVICES MOUNTED ABOVE DROP CEILINGS SHALL BE MOUNTED BELOW ASSOCIATED DEVICES. LABEL INDICATORS TO INDICATE DEVICE SERVED.
- 12.) CONTRACTOR TO PROVIDE SMOKE DETECTOR(S) IN ALL LOCATIONS CONTAINING FIRE ALARM CONTROL PANELS, DATA GATHERING PANELS, BOOSTER POWER SUPPLIES, OR ANY OTHER FIRE ALARM SYSTEM PANEL, WHETHER SHOWN ON PLANS OR NOT.
- 13.) CONTROL MODULES USED TO INITIATE EMERGENCY CONTROL FUNCTIONS THAT DO NOT FAIL IN A SAFE POSITION SHALL BE LOCATED WITHIN 3 FEET OF THE COMPONENT CONTROLLING THE EMERGENCY CONTROL FUNCTION PER NFPA 72. THIS INCLUDES, BUT IS NOT LIMITED TO, CONTROL MODULES CONNECTED TO FAN MOTOR CONTROLLERS, ELEVATOR CONTROLLERS, ETC.
- 14.) ALL FIRE ALARM PANELS, JUNCTION BOX COVERS, ETC SHALL BE PAINTED "FIRE DEPARTMENT RED".
- 15.) MAKE CONNECTIONS TO SIDES OR BOTTOM OF FACP ONLY.
- 16.) THE CONTRACTOR SHALL BE RESPONSIBLE TO PROVIDE THE ENGINEER WITH AN ACCURATE AS-BUILT FIRE ALARM DRAWING, SHOWING INSTALLED DEVICE LOCATIONS AND A COMPLETE INTERCONNECTION WIRING DIAGRAM OF THE SYSTEM. THE DRAWINGS SHALL BE PROVIDED IN AUTOCAD FORMAT AND HARD COPIES. AS-BUILT DRAWINGS MUST BE PROVIDED TO THE ENGINEER BEFORE PROJECT CAN BE CLOSEOUT.
- 17.) THE CONTRACTOR IS REQUIRED TO SCHEDULE ALL INSPECTIONS WITH AUTHORITY HAVING JURISDICTION IN ORDER TO OBTAIN THE FINAL LETTER OF APPROVAL AND SIGN-OFF. PROVIDE RE-INSPECTIONS AS REQUIRED UNTIL FINAL LETTER OF APPROVAL IS OBTAINED. AT EACH INSPECTION, A MINIMUM OF TWO FIRE ALARM TECHNICIANS WITH S97 OR S98 CERTIFICATIONS AND ONE ELECTRICIAN SHALL BE PRESENT.
- 18.) ANY REPROGRAMMING OF THE SYSTEM REQUIRED PRIOR TO THE INITIAL INSPECTION SHALL BE DONE AT NO CHARGE TO COMPLY WITH ANY CHANGES REQUIRED BY THE OWNER, ENGINEER, INCONSISTENCIES WITH THE PLANS OR CHANGES REQUIRED DUE TO CHANGE IN NOMENCLATURES OF ANY ROOMS, STAIRS, ELEVATOR, ETC.

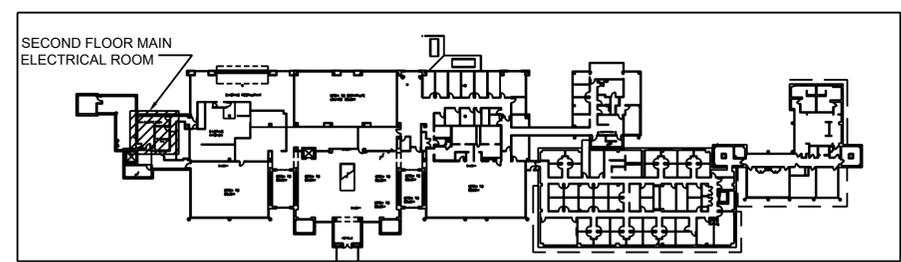

2 SECOND FLOOR KEY PLAN
SCALE: 1/64" = 1'-0"

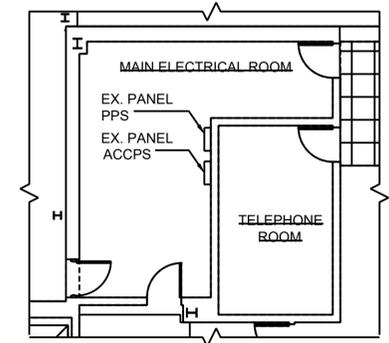

3 ELECTRICAL PART PLAN MAIN ELECTRICAL ROOM
SCALE: 1/8" = 1'-0"

	STRUCTURAL ENGINEER				
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	MEP ENGINEER				
<p>OLA Consulting Engineers 50 Broadway, Hawthorne, NY 10532 914.747.2800 8 West 38th Street, Suite 900 New York, NY 10018 646.849.4110 olace.com</p>					
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<p>PROJECT NORTH</p>					
REVISION NUMBER	DATE	MADE BY	APP'D BY	REVISION	
RECORD DRAWING CERTIFICATION					
<p><input type="checkbox"/> AS BUILT - CHANGES AS NOTED <input type="checkbox"/> AS BUILT - NO CHANGES</p>					
CONTRACTOR			PROJECT COORDINATOR		
NAME _____			NAME _____		
SIGNATURE _____			SIGNATURE _____		
TITLE _____			TITLE _____		
			DATE _____		
<p>WESTCHESTER COUNTY, NEW YORK DEPARTMENT OF PUBLIC WORKS AND TRANSPORTATION DIVISION OF ENGINEERING</p>				<p>CONTRACT NUMBER 23-532-Rev.</p>	<p>SHEET NUMBER E-301</p>
<p>TERMINAL BUILDING HVAC-1 & HVAC-2 UPGRADES WESTCHESTER COUNTY AIRPORT TOWNS OF HARRISON, NORTH CASTLE & VILLAGE OF RYE BROOK</p>				<p>SHEET NO. 16 OF 19</p>	<p>SCALE: AS SHOWN DATE: 10/29/24</p>
ELECTRICAL ONE-LINE DIAGRAM AND PLANS				<p>DPW FILE NO. 48-15-E-889-0</p>	<p>REV. NO. 0</p>

IN CHARGE OF PATRICK LYNCH, P.E.
CHECKED BY ROBERT SPINA, P.E. / JOSEPH FIERRO, P.E.
MADE BY JOHN TESSER P.E. / GIOVANNI DEL CID, P.E.

SYMBOLS AND ABBREVIATIONS

SYMBOL	ABBREVIATION	DESCRIPTION
_____	EX.	EXISTING TO REMAIN
_____	NEW	NEW WORK
- - - - -	DEM.	EXISTING TO BE REMOVED
○	-	ELBOW UP
⏟	-	ELBOW DOWN
⊥	-	TEE DOWN
⊕	-	TEE UP
┌	-	PIPE CAP OR FLUSHING CONNECTION
⊗	-	GATE VALVE
⊗	-	OS&Y GATE VALVE
⊗	-	BUTTERFLY VALVE
↗	-	CHECK VALVE
+	-	UNION
⊡	-	TEMPERATURE GAGE
⊡	-	PRESSURE GAGE
WF	-	WATER FLOW SWITCH
TS	-	TAMPER SWITCH
⊗	-	INSPECTORS TEST CONNECTION
-	-	FLOW ARROW
X	-	SPRINKLER GUARD
○ _F OR ● _F	-	EXISTING SPRINKLER TO REMAIN
⊗ _F OR ⊗ _F	-	EXISTING SPRINKLER TO BE REMOVED
○ _N	-	NEW PENDENT SPRINKLER, CONCEALED OR EXPOSED AS NOTED
○ _N	-	NEW UPRIGHT SPRINKLER
◀	-	SIDEWALL SPRINKLER
⊗	-	POINT OF CONNECTION
⊗	-	POINT OF DISCONNECTION
NI	-	HYDRAULIC REFERENCE NODE
⊗	-	HYDRAULIC REFERENCE SPRINKLER
⊗	FDC	FIRE DEPARTMENT CONNECTION
-	AFF	ABOVE FINISHED FLOOR
-	AHC	ABOVE HUNG CEILING
-	ATC	AT CEILING
-	BFP	BACKFLOW PREVENTOR
-	DN.	DOWN
-	FCA	FLOOR CONTROL ASSEMBLY
-	FD	FLOOR DRAIN
-	FLFD	FUNNEL FLOOR DRAIN
-	GPM	GALLONS PER MINUTE
-	NFPA	NATIONAL FIRE PROTECTION ASSOCIATION
-	(NO)	NORMALLY OPEN
-	(NC)	NORMALLY CLOSED
-	NTS	NOT TO SCALE
-	PRV	PRESSURE REDUCING VALVE
-	PSI	POUNDS PER SQUARE INCH
-	SF	SQUARE FOOT
-	TYP	TYPICAL
-	U.O.N.	UNLESS OTHERWISE NOTED

NOTE: FOR REFERENCE ONLY. NOT ALL SYMBOLS OR ABBREVIATIONS ARE USED IN THIS PROJECT.

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GENERAL NOTES

1. THE REVISED SPRINKLER SYSTEM SHALL BE DESIGNED AND INSTALLED BY AN EXPERIENCED CONTRACTOR IN STRICT ACCORDANCE WITH NFPA-13, THE REQUIREMENTS OF THE OWNER, OWNER'S FIRE INSURANCE UNDERWRITER, AND ALL GOVERNMENTAL AGENCIES AND AUTHORITIES HAVING JURISDICTION OVER THE PREMESIS.
2. COORDINATE ALL WORK WITH OTHER TRADES TO MINIMIZE INTERFERENCES WITH NEW AND EXISTING FACILITIES, TO FACILITATE TIMELY COMPLETION AND AVOID NECESSITY FOR CUTTING AND PATCHING. FURNISH TO OTHER AFFECTED TRADES ALL NECESSARY INFORMATION, WORKING DRAWINGS OR MATERIALS REQUIRED FOR INSTALLATION AND COMPLETION OF ALL WORK. ALL CONFLICTS, OBSTRUCTIONS AND/OR MODIFICATIONS TO THE SPRINKLER DESIGN LAYOUT DUE TO FIELD CONDITIONS SHALL BE BROUGHT TO THE ATTENTION OF THE ENGINEER PRIOR TO FABRICATION AND INSTALLATION.
3. CONTRACTOR SHALL CONDUCT A HYDRANT FLOW TEST ON THE WATER MAIN SERVICING THE BUILDING TO ESTABLISH EXACT FLOW AND PRESSURE AVAILABLE ON THE SITE FOR PREPARATION OF HYDRAULIC CALCULATIONS AS REQUIRED.
4. SPRINKLER SHOP DRAWINGS SHALL BE SUBMITTED FULLY COORDINATED AND RECONCILED WITH SUBMITTED HYDRAULIC CALCULATIONS FOR REVIEW AND APPROVAL BY THE ENGINEER.
5. ALTER PIPING AS REQUIRED TO SUIT NEW AND EXISTING EQUIPMENT, DUCTWORK, AND LIGHTS. PROVIDE AT NO EXTRA COST ALL ADDITIONAL PIPING AND FITTINGS REQUIRED TO OFFSET SYSTEM TO AVOID STRUCTURAL, ARCHITECTURAL, MECHANICAL, AND ELECTRICAL INTERFERENCES, WHETHER INDICATED OR NOT, BEFORE INSTALLING WORK.
6. WHEN INSTALLING SPRINKLER HEADS, THE CONTRACTOR SHALL PROVIDE THE SHORTEST HYDRAULIC PIPE LENGTH BETWEEN THE FINAL SPRINKLER HEAD LOCATION AND THE BRANCH LINE CONNECTION. MINIMUM 1" FOR TWO HEADS, 1-1/4" FOR THREE HEADS AND 1-1/2" FOR FIVE HEADS.
7. EXACT LOCATION OF SPRINKLER HEADS IN FINISHED AREAS SHALL BE COORDINATED WITH ALL OTHER TRADES.
8. INSTALL SPRINKLER HEADS TIGHT TO BOTTOM OF DUCT WORK WITH CARE THAT THE FINISH IS NOT DAMAGED.
9. DRAIN VALVES AT MAIN SHUT-OFF VALVES, LOW POINTS, AND APPARATUS SHALL BE PROVIDED.
10. THE CONTRACTOR SHALL MAKE A PROVISION FOR (5) EXTRA SPRINKLERS INCLUDING IMMEDIATE BRANCH PIPING, FITTINGS AND ARM-OVERS. THE CONTRACTOR SHALL COORDINATE WITH FINAL CONFIGURATION OF OPEN AND HUNG CEILINGS, ALL HVAC DUCTWORK AND PIPING AND STRUCTURAL ELEMENTS THROUGHOUT THE AREA OF WORK.
11. THE CONTRACTOR SHALL PERFORM WORK WITHIN BAGGAGE DROP AREA DURING OFF HOURS, WHEN THE BAGGAGE DROP AREA IS NOT IN USE. EXACT SCHEDULE AND HOURS TO BE COORDINATED WITH THE AIRPORT ADMINISTRATION. DEMOLITION WORK IS NOT TO BE STARTED UNTIL ALL NECESSARY MATERIALS AND EQUIPMENT ARE IN HAND, TO PREVENT DELAYS DURING THE CONSTRUCTION PROCESS.
12. PROVIDE SPRINKLER GUARDS ON ALL EXPOSED SPRINKLER HEADS LOCATED UNDER DUCT WORK IN THE AREA OF WORK.

EQUIPMENT NOTES

1. SPRINKLER PIPING MATERIAL: SHALL BE STANDARD WEIGHT SCHEDULE 40 BLACK STEEL PIPE, SEAMLESS OR WELDED MILD STEEL, CONFORMING TO ASTM A-795/A-53. SCHEDULE 10 PIPING IS NOT PERMITTED FOR PIPING LESS THAN 2".
2. SPRINKLERS: REFER TO DRAWING FP-701 FOR SPRINKLER HEAD SCHEDULE.

DESIGN CRITERIA

HAZARD CLASSIFICATION(1)	DENSITY(2)	PROTECTION AREA PER SPRINKLER(3)
LIGHT HAZARD	0.1 GPM / 1500 SQ. FT.	225 SQ. FT. MAX
ORDINARY HAZARD GROUP 1	0.15 GPM / 1500 SQ. FT.	130 SQ. FT. MAX
ORDINARY HAZARD GROUP 2	0.2 GPM / 1500 SQ. FT.	130 SQ. FT. MAX
EXTRA HAZARD GROUP 1	0.3 GPM / 2500 SQ. FT.	100 SQ. FT. MAX
EXTRA HAZARD GROUP 2	0.4 GPM / 2500 SQ. FT.	100 SQ. FT. MAX

NOTES:
 1.) HAZARD CLASSIFICATION, DENSITY AND MAX. PROTECTION AREA SHALL BE IN ACCORDANCE WITH NFPA 13 - 2016 RECOMMENDATIONS UNLESS OTHERWISE NOTED.
 2.) WHERE REQUIRED BY THE BUILDING DEPARTMENT OR AUTHORITY HAVING JURISDICTION FOR PERMIT, THE ENTIRE SYSTEM SHALL BE HYDRAULICALLY CALCULATED.
 3.) THE MINIMUM PRESSURE AT EACH SPRINKLER HEAD SHALL BE 7 PSI.
 4.) EQUIVALENT FITTING LENGTHS USED IN HYDRAULIC CALCULATIONS SHALL BE IN ACCORDANCE WITH NFPA 13 - 2016.
 5.) DISCHARGE FROM EACH SPRINKLER SHALL NOT BE LESS THAN REQUIRED AREA COVERAGE BY THIS HEAD. AREA COVERAGE PER HEAD SHALL BE DETERMINED IN ACCORDANCE WITH NFPA 13 SECTION 8.6.2.2.1 (2016).
 6.) HYDRAULIC CALCULATIONS SHALL BE BROUGHT BACK TO THE CONNECTION TO THE RISER OR SPRINKLER CONTROL VALVE (F.C.A).
 FLOW VELOCITY IN SPRINKLER PIPING SHALL NOT EXCEED 20 FEET PER SECOND (FPS).

STRUCTURAL ENGINEER

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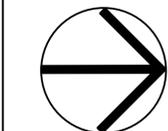
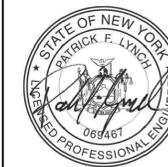
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PROJECT NORTH



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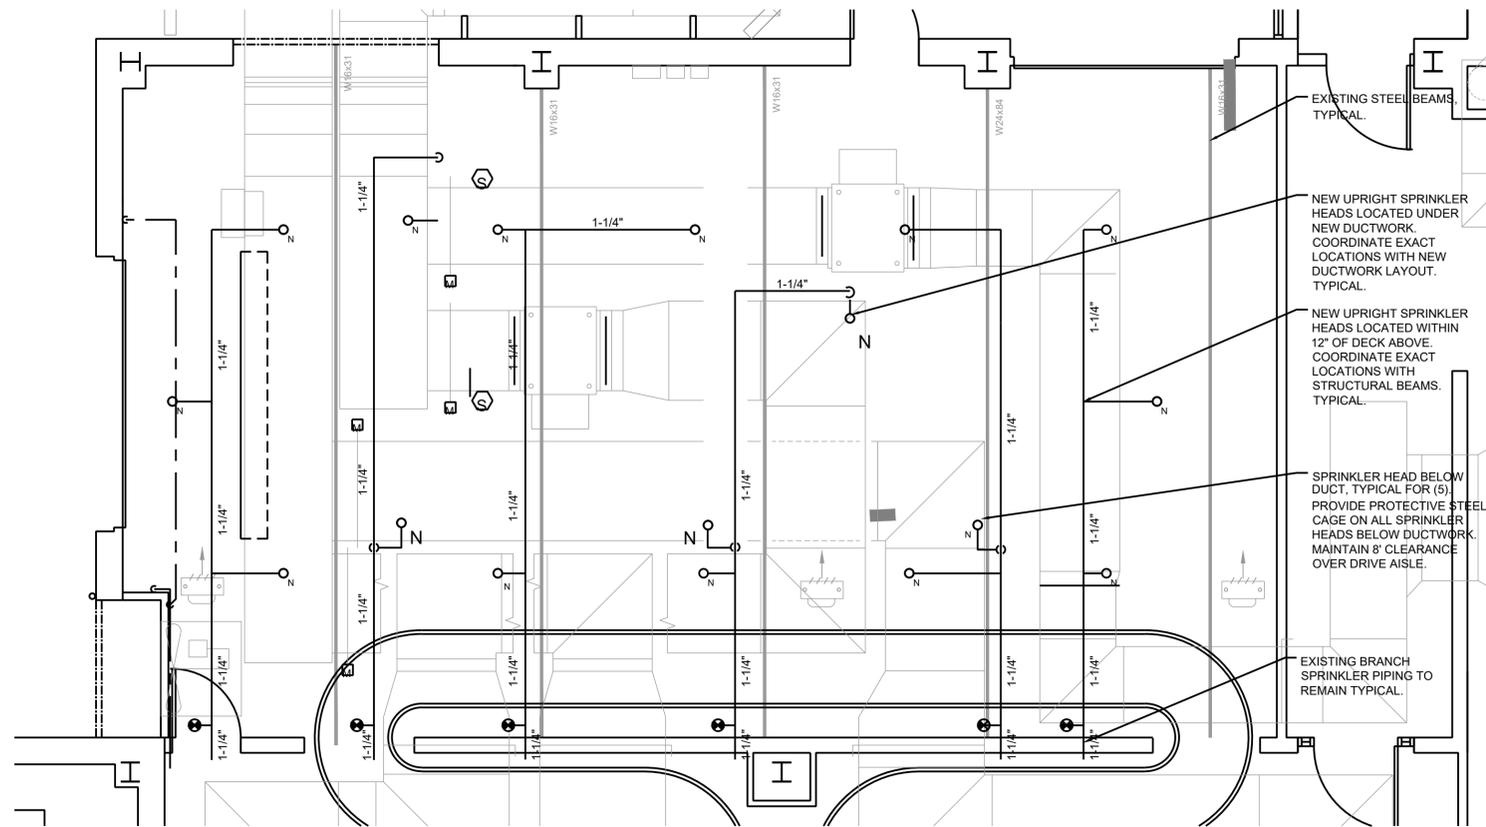
REVISION NUMBER	DATE	MADE BY	APP'D BY	REVISION

RECORD DRAWING CERTIFICATION


- AS BUILT - CHANGES AS NOTED
- AS BUILT - NO CHANGES

CONTRACTOR		PROJECT COORDINATOR	
NAME	SIGNATURE	NAME	SIGNATURE
TITLE	DATE	TITLE	DATE


WESTCHESTER COUNTY, NEW YORK DEPARTMENT OF PUBLIC WORKS AND TRANSPORTATION DIVISION OF ENGINEERING		CONTRACT NUMBER	SHEET NUMBER
		23-532-Rev.	SP-001
SHEET NO. 17 OF 19		SCALE: AS SHOWN DATE: 10/29/24	
TERMINAL BUILDING HVAC-1 & HVAC-2 UPGRADES WESTCHESTER COUNTY AIRPORT TOWNS OF HARRISON, NORTH CASTLE & VILLAGE OF RYE BROOK SPRINKLER SYMBOLS, ABBREVIATIONS, AND GENERAL NOTES		DPW FILE NO. 48-15-SP-890-0	REV. NO. 0



2 SPRINKLER NEW WORK FIRST FLOOR PART PLAN
SCALE: 1/4" = 1'-0"
NORTH

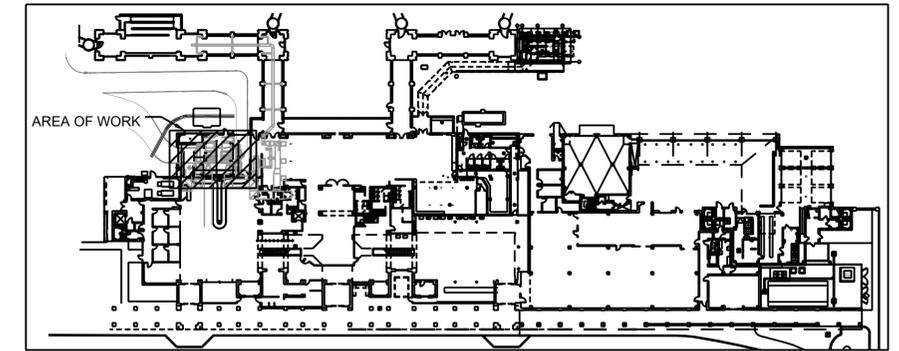


2 FIRST FLOOR KEY PLAN
SCALE: 1/64" = 1'-0"
NORTH

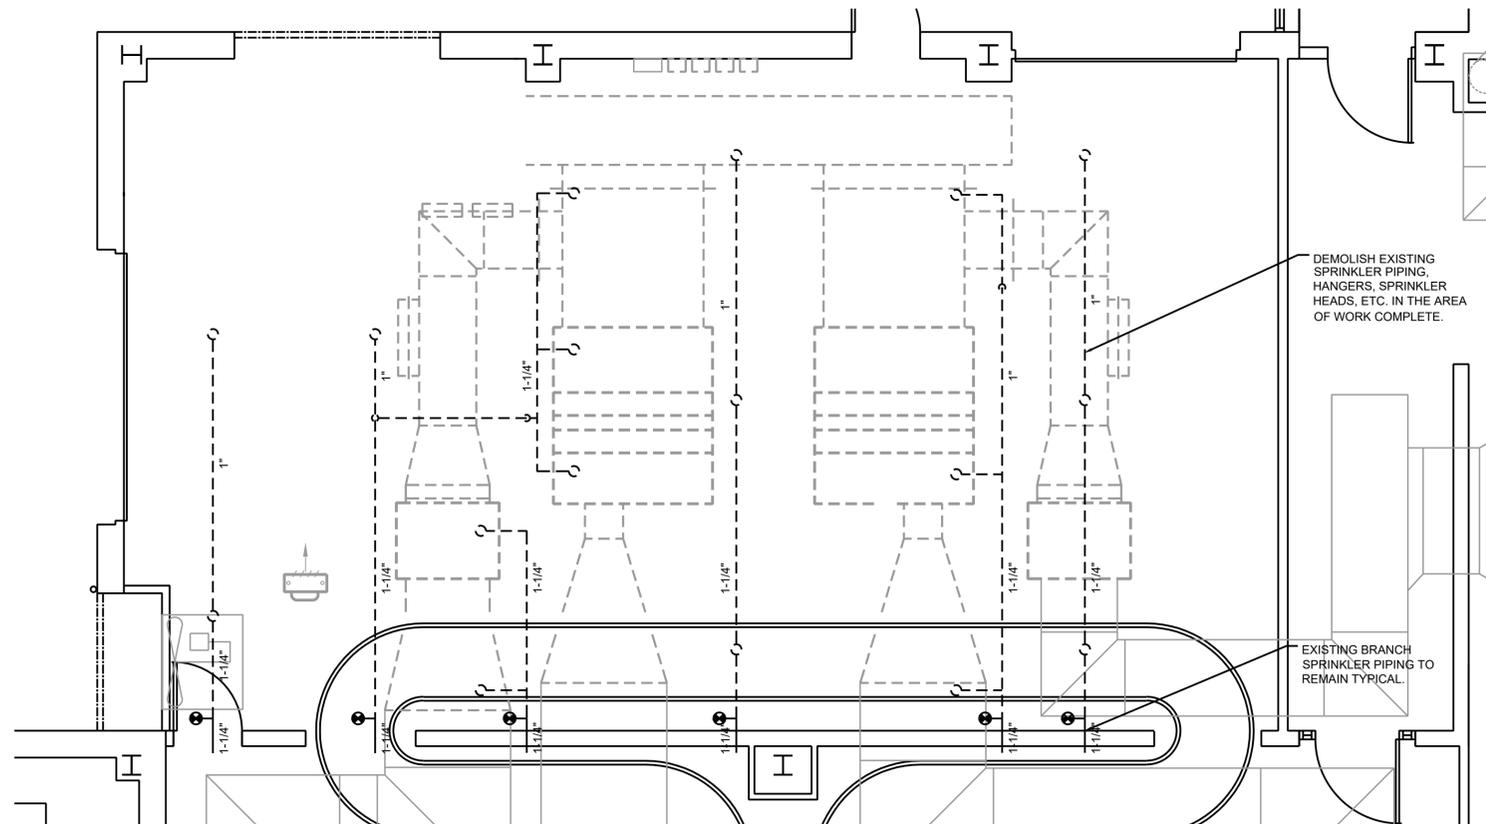


1 SPRINKLER DEMOLITION FIRST FLOOR PART PLAN
SCALE: 1/4" = 1'-0"
NORTH

IN CHARGE OF PATRICK LYNCH, P.E.
CHECKED BY ROBERT SPINA, P.E. / JOSEPH FIERRO, P.E.
MADE BY JOHN TESSER P.E. / GIOVANNI DEL CID, P.E.

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				WARNING: IT IS A VIOLATION OF THE NYS EDUCATION LAW ARTICLE 145 FOR ANY PERSON, UNLESS HE IS ACTING UNDER THE DIRECTION OF A LICENSED ARCHITECT OR PROFESSIONAL ENGINEER, TO ALTER THIS ITEM IN ANY WAY.	
RECORD DRAWING CERTIFICATION					
<input type="checkbox"/> AS BUILT - CHANGES AS NOTED <input type="checkbox"/> AS BUILT - NO CHANGES					
REVISION NUMBER		DATE	MADE BY	APP'D BY	REVISION
CONTRACTOR					
NAME			PROJECT COORDINATOR		
SIGNATURE			SIGNATURE		
TITLE			TITLE		
DATE			DATE		
WESTCHESTER COUNTY, NEW YORK DEPARTMENT OF PUBLIC WORKS AND TRANSPORTATION DIVISION OF ENGINEERING				CONTRACT NUMBER	SHEET NUMBER
				23-532-Rev.	SP-201
				SHEET NO. 18	OF 19
TERMINAL BUILDING HVAC-1 & HVAC-2 UPGRADES WESTCHESTER COUNTY AIRPORT TOWNS OF HARRISON, NORTH CASTLE & VILLAGE OF RYE BROOK				SCALE: AS SHOWN	DATE: 10/29/24
SPRINKLER DEMOLITION AND NEW WORK				DPW FILE NO.	REV. NO.
				48-15-SP-891-0	0

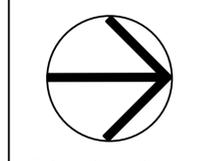


PROJECT NORTH

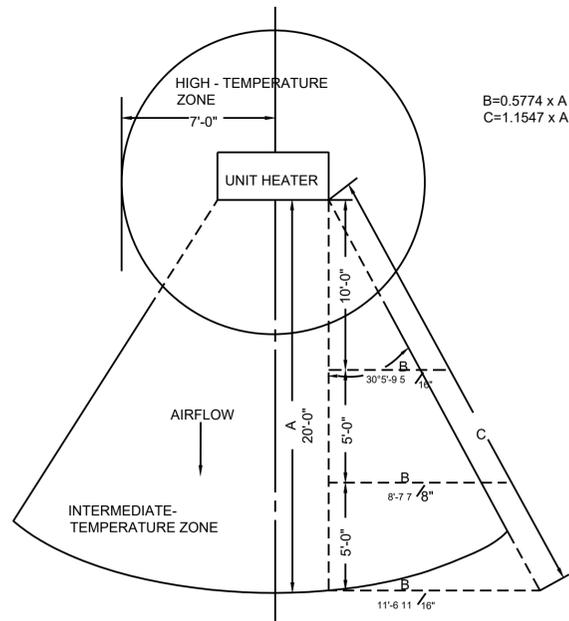


SPRINKLER TEMPERATURE ZONES

7 AT UNIT HEATERS
SCALE: NONE

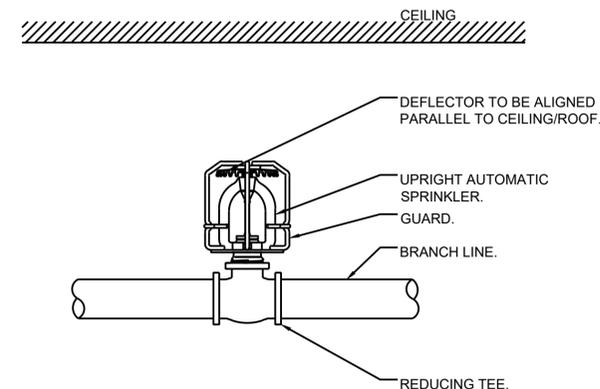

5 TYPICAL UPRIGHT SPRINKLER WITH GUARD
SCALE: NONE

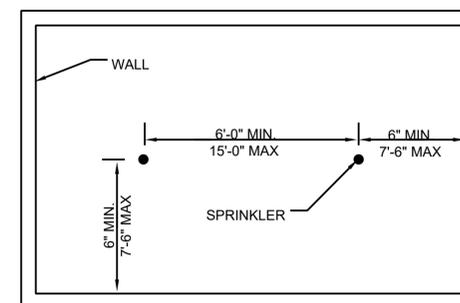

	MAX AREA PER HEAD	DENSITY PER 1500 SQ. FT.
LIGHT HAZARD	225 SQ. FT.	0.10 GPM/SQ. FT.
ORDINARY HAZARD	130 SQ. FT.	0.15 GPM/SQ. FT.

3 SPRINKLER HEAD SPACING CRITERIA
SCALE: NONE

PIPE SIZING SCHEDULE		
SIZE	LIGHT HAZARD	ORDINARY HAZARD
	QTY SPRINKLERS	QTY SPRINKLERS
1"	2	2
1 1/4"	3	3
1 1/2"	5	5
2"	10	10
2 1/2"	30	20
3"	60	40
3 1/2"	100	65
4"	SEE NOTE 3	100


NOTES:
1. IN ACCORDANCE WITH NFPA 13 - 2013 EDITION - TABLE 22.5.2.2.1 AND TABLE 22.5.3.4.
2. ALL PIPING BASED ON SCHEDULE 40 BLACK STEEL.
3. AREAS REQUIRING MORE SPRINKLERS THAN SPECIFIED FOR 3/4" SHALL BE SUPPLIED BY MAINS OR RISERS SIZED FOR ORDINARY HAZARD OCCUPANCIES.

SPRINKLER SCHEDULE

SYM	TYPE	LOCATION	FINISH	MANUF. MODEL	HEAD TEMP.	MAX CEILING TEMP.	ORIFICE	K-FACTOR
o	UPRIGHT	EXPOSED AREAS PER PLANS	CHROME PLATED	RELIABLE F1FR	165°F	100°F	1/2"	5.6
o	UPRIGHT EC	EXTENDED COVERAGE GARAGE	NATURAL BRONZE	RELIABLE JL112	155°F	100°F	3/4"	11.2

NOTES:
1. SPRINKLER HEADS SHALL BE INSTALLED AS PER MANUFACTURER'S RECOMMENDATIONS
2. PROVIDE METAL WIRE GUARDS WHERE SPRINKLERS ARE SUBJECT TO DAMAGE, SUCH AS SPRINKLER HEADS LOCATED UNDER MECHANICAL DUCTS IN MECHANICAL EQUIPMENT ROOMS WHEN LOCATED LOWER THAN 7'-0" AFF
3. ALL SPRINKLER HEADS THROUGHOUT THE PROJECT AREA SHALL BE OF THE ORDINARY TEMPERATURE RATING EXCEPT AS FOLLOWS:
3.1. SPRINKLER HEADS LOCATED CLOSE TO HEATERS, HOT WATER PIPING OR LOW-PRESSURE BLOW-OFF VALVE SHALL BE OF THE TEMPERATURE RATING AS REQUIRED BY NFPA-13.
3.2. ALL HEAT GENERATING EQUIPMENT WHICH CAN AFFECT THE TEMPERATURE RATING OF THE SPRINKLER HEADS SHALL BE CLEARLY IDENTIFIED ON THE SHOP DRAWINGS PRIOR TO SUBMISSION FOR APPROVAL


1 SPRINKLER HEAD SCHEDULE
SCALE: NONE

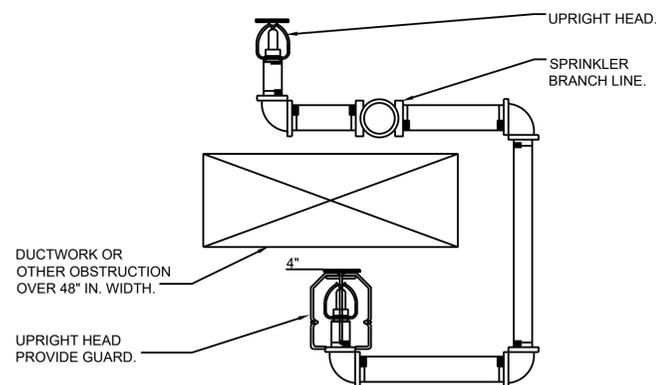

NOTES:
1. CONTRACTOR SHALL SPRINKLER ABOVE AND BELOW DUCT OR OTHER OBSTRUCTION OVER 48" IN WIDTH.
2. SPRINKLERS SHALL BE COORDINATED WITH THE HVAC AND GENERAL CONSTRUCTION.


SPRINKLER DETAIL ABOVE AND BELOW DUCT DETAIL

6 SCALE: NONE

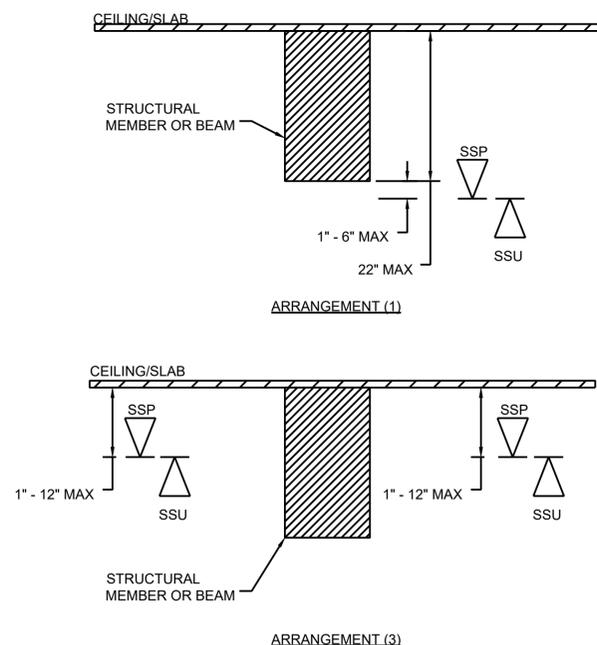

NOTE: SPRINKLERS SHALL BE INSTALLED IN ACCORDANCE WITH NFPA 13 REQUIREMENTS FOR SECTION 8.6.4.1.2 - OBSTRUCTED CONSTRUCTION: UNDER OBSTRUCTED CONSTRUCTION, THE SPRINKLER DEFLECTOR SHALL BE LOCATED IN ACCORDANCE WITH ONE OF THE FOLLOWING ARRANGEMENTS:
1. INSTALLED WITH THE DEFLECTORS WITHIN THE HORIZONTAL PLANES OF 1 IN. TO 6 IN. BELOW THE STRUCTURAL MEMBERS AND A MAXIMUM DISTANCE OF 22 IN. BELOW THE CEILING/ROOF DECK
2. INSTALLED WITH THE DEFLECTORS AT OR ABOVE THE BOTTOM OF THE STRUCTURAL MEMBER TO A MAXIMUM OF 22 IN. BELOW THE CEILING/ROOF DECK WHERE THE SPRINKLER IS INSTALLED IN CONFORMANCE WITH 8.6.5.1.2. REFER TO DETAIL #2.
3. INSTALLED IN EACH BAY OF OBSTRUCTED CONSTRUCTION, WITH THE DEFLECTORS LOCATED A MINIMUM OF 1 IN. AND A MAXIMUM OF 12 IN. BELOW THE CEILING

4 OBSTRUCTED CONSTRUCTION DETAIL
SCALE: NONE

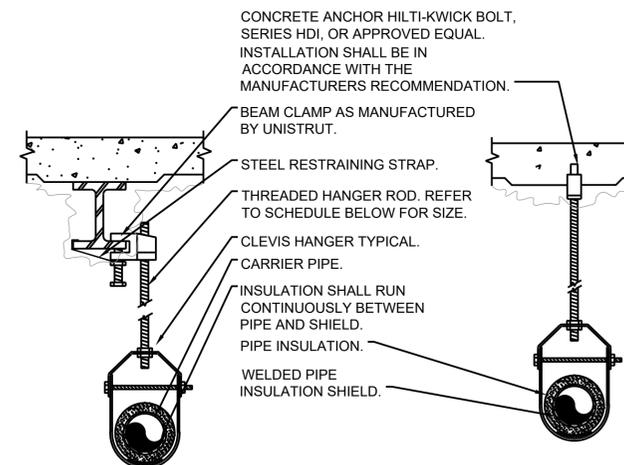

PIPE HANGER SCHEDULE					
PIPE DIA.	3/4"-2"	2-1/2"-3"	4"-5"	6"	8"-12"
HANGER DIA.	3/8"	1/2"	5/8"	3/4"	7/8"


NOTES:
1.) CLEVIS HANGERS WITH WELDED INSULATION SHIELDS SIMILAR TO RAUCH FIG. 100SH ON ALL PIPES LARGER THAN 1".
2.) FOR PIPES 1" OR SMALLER, A BAND HANGER WITH INSULATION SHIELD MAY BE USED SIMILAR TO RAUCH FIG. NO. 1ASH.
3.) FOR NON-INSULATED PIPE, INSULATION SHIELDS MAY BE OMITTED.
4.) ALL PIPE HANGERS SHALL BE GALVANIZED STEEL OR FACTORY PAINTED BLACK WITH ENAMEL.
5.) FOR NON FERROUS PIPING WITHOUT INSULATION, ALL HANGERS SHALL BE COPPER PLATED OR FURNISHED WITH A DI-ELECTRIC BETWEEN PIPE AND HANGERS.
6.) WHERE EXISTING BUILDING STRUCTURAL COMPONENTS HAVE FIREPROOF MATERIAL, ANY AREA THAT IS DISTURBED OR DAMAGED AS A RESULT OF HANGER INSTALLATION SHALL BE PATCHED WITH UL AND FM APPROVED FIREPROOFING TO MATCH EXISTING.

2 PIPE HANGER DETAIL
SCALE: NONE

STRUCTURAL ENGINEER

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PROJECT NORTH

REVISION NUMBER	DATE	MADE BY	APP'D BY	REVISION

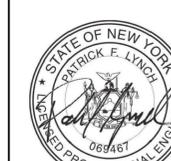RECORD DRAWING CERTIFICATION

AS BUILT - CHANGES AS NOTED
 AS BUILT - NO CHANGES

CONTRACTOR: _____ PROJECT COORDINATOR: _____
SIGNATURE: _____ SIGNATURE: _____
TITLE: _____ TITLE: _____

WESTCHESTER COUNTY, NEW YORK
DEPARTMENT OF PUBLIC WORKS
AND TRANSPORTATION
DIVISION OF ENGINEERING

TERMINAL BUILDING HVAC-1 & HVAC-2 UPGRADES
WESTCHESTER COUNTY AIRPORT
TOWNS OF HARRISON, NORTH CASTLE & VILLAGE OF RYE BROOK

SPRINKLER DETAILS

CONTRACT NUMBER: 23-532-Rev.
SHEET NUMBER: SP-701

SHEET NO. 19 OF 19

SCALE: AS SHOWN
DATE: 10/29/24

DPW FILE NO. 48-15-SP-892-0
REV. No. 0

IN CHARGE OF: PATRICK LYNCH, P.E.
CHECKED BY: ROBERT SPINA, P.E. / JOSEPH FIERRO, P.E.
MADE BY: JOHN TESSER, P.E. / GIOVANNI DEL CID, P.E.