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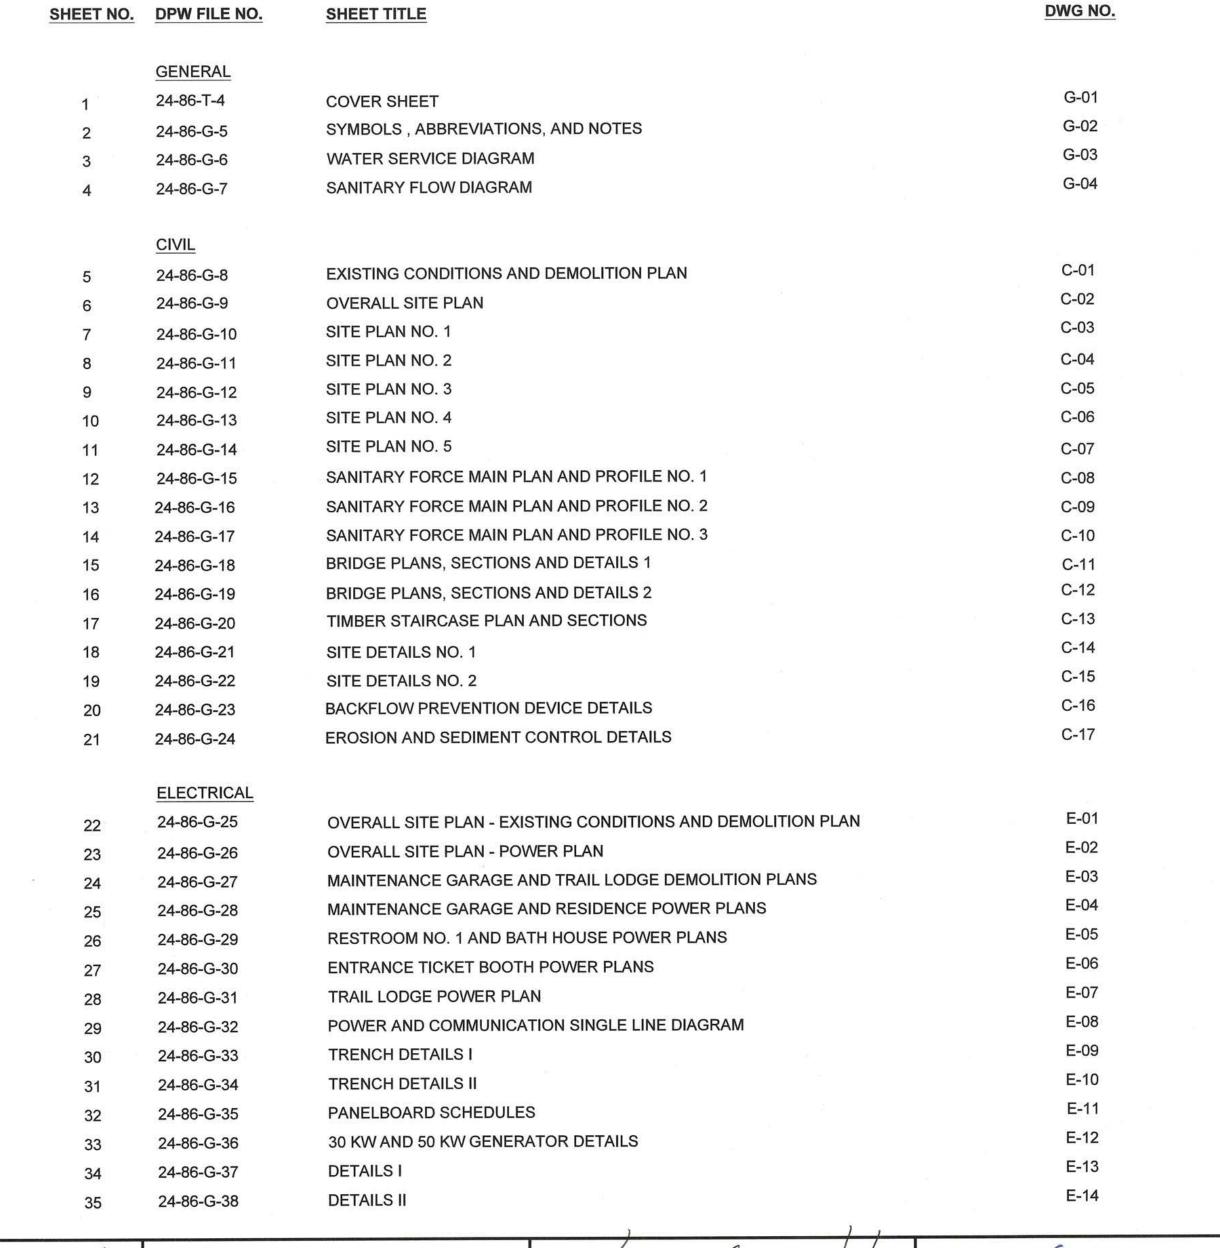
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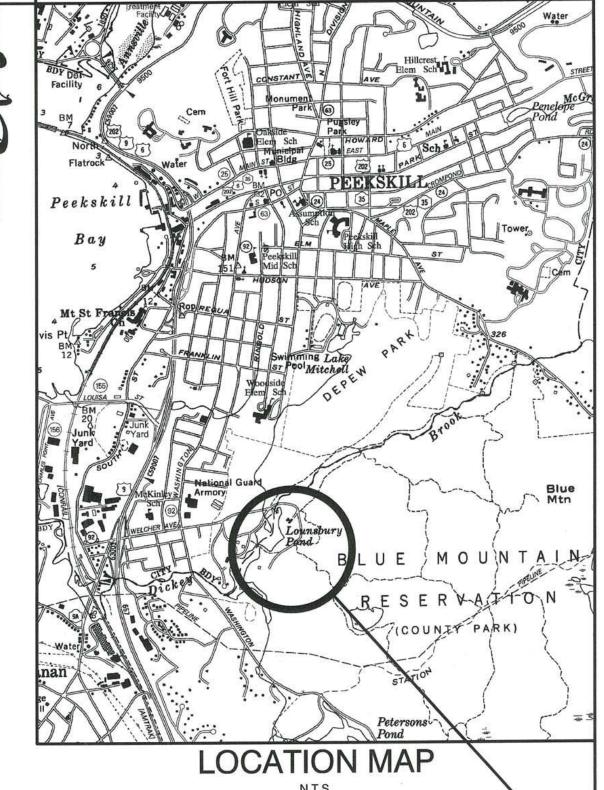
MADE BY



WESTCHESTER COUNTY, NEW YORK DEPARTMENT OF PUBLIC WORKS AND TRANSPORTATION DIVISION OF ENGINEERING

CONTRACT No. 17-519 BLUE MOUNTAIN RESERVATION SITE WORK IMPROVEMENTS TOWN OF CORTLANDT, CITY OF PEEKSKILL, NEW YORK





BLUE -MOUNTAIN **RESERVATION**

INFORMATION D&B ENGINEERS ARCHITECTS, P.C.

TEL: (914) 467-5300 FAX: (914) 467-6103

G - 01

DATE: APRIL 2020

24-86-T-4

DPW FILE NO.

REVISION DATE MADE APP'D REVISION NUMBER

RECORD DRAWING CERTIFICATION AS BUILT - CHANGES AS NOTED

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4 WEST RED OAK LANE #315

WHITE PLAINS, NY 10604

PROJECT COORDINATOR CONTRACTOR NAME NAME SIGNATURE SIGNATURE .

WESTCHESTER COUNTY, NEW YORK 17-519 DEPARTMENT OF PUBLIC WORKS AND TRANSPORTATION SHEET NO. 1 OF 35 DIVISION OF ENGINEERING SCALE: AS SHOWN

BLUE MOUNTAIN RESERVATION SITE WORK IMPROVEMENTS TOWN OF CORTLANDT, CITY OF PEEKSKILL, NY **GENERAL** COVER SHEET

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RECOMMENDED FOR CONSTRUCTION

ROBERT S. DONNELLY, P.E. DIRECTOR OF DESIGN COORDINATION DEPARTMENT OF PUBLIC WORKS AND TRANSPORTATION AND TRANSPORTATION

1882 00/1 48.2021 RECOMMENDED FOR CONSTRUCTION GAYLE M. KATZMAN, P.E. FIRST DEPUTY COMMISSIONER DEPARTMENT OF PUBLIC WORKS

APPROVED FOR CONSTRUCTION KATHLEEN O'CONNOR COMMISSIONER DEPARTMENT OF PARKS, RECREATION AND CONSERVATION

APPROVED FOR CONSTRUCTION HUGH J. GREECHAN, JR., P.E. COMMISSIONER DEPARTMENT OF PUBLIC WORKS AND TRANSPORTATION

- A/6/21

ABBREVIATIONS

SSx

STD

STRUCT

T&B

TOL

TOS

TOW

TYP

U.G.

VERT,V

VTR

WVB

WWF

SOLID SENSOR No.

SEWAGE TREATMENT PLANT

STAINLESS STEEL

STANDARD

STIFFENER

STRUCTURAL

SHORT WAY

TOP OF DUCT

TOP OF STEEL

TOP OF WALL

TRAFFIC LOOP

UNDERGROUND

UTILITY POLE

VACUUM BREAKER

VOLUME DAMPER

WATER CLOSET

WATER MAIN

WATER VALVE

SQUARE FEET

WATER VALVE BOX

WELDED WIRE FABRIC

VERTICAL

VITRIFIED CLAY PIPE

VENT THROUGH ROOF

WATER STOP OR WATER SERVICE

UNLESS NOTED OTHERWISE

TYPICAL

TOP AND BOTTOM

TOP OF LOUVER

A.B.	ANCHOR BOLT	GV	GATE VALVE
A.C.	ASBESTOS CEMENT PIPE	HB	HOSE BIBB
ADD'L	ADDITIONAL	HDPE	HIGH DENSITY POLYETHYLENE PIPE
AFF	ABOVE FINISHED FLOOR	HGR	HANGER
ALUM	ALUMINUM	HORIZ,H	HORIZONTAL
ARCH	ARCHITECTURAL	HR	HANDRAIL
B,BOT	ВОТТОМ	HP	HIGH POINT
B.C.	BRICK COURSE	HW	HOT WATER
BLK	BLOCK	HYD	HYDRANT
ВМ	BEAM	ID	INSIDE DIAMETER
BU	BUTTERFLY VALVE	INSUL.	INSULATION
BV	BALL VALVE	INT	INTERIOR
СВ	CATCH BASIN		.E.INVERT ELEVATION
C.I.	CAST IRON	JT	JOINT
CHK'D	CHECKERED		POUNDS
CJ	CONSTRUCTION JOINT	LF	LINEAR FEET
CL.	CLEARANCE	LG	LONG
CMU	CONCRETE MASONRY UNIT		LEFT HAND
C.O.	CLEAN OUT		LOW POINT
COL	COLUMN	LLV	
CONC	CONCRETE	LLV	LONG WAY
CONN	CONNECTION	MAX	
CONT	CONTINUE, CONTINUOUS		
CTR	CENTER	MFG	MECHANICAL MANUFACTURING
CU.	COPPER	MFTR	MANUFACTURER
CV.	CHECK VALVE	MIN	MINIMUM
CW	COLD WATER	MIIN MH	MANHOLE
DET	DETAIL	МО	MASONRY OPENING
DMH	DRAIN MANHOLE		
D.I.	DUCTILE IRON	NO/#	NUMBER
DIA./ø	DIAMETER	NP	NON-POTABLE WATER
DIM(S)		NTS	NOT TO SCALE
DWG(S)	` '	OC	ON CENTER
DWLS	DOWELS	OF	OVERFLOW
"E"	EXISTING	OH	OVER HEAD ELECTRICAL
EA	EACH	OPNG	OPENING
EC	ELECTRICAL CONTRACTOR	OPP	OPPOSITE
EF	EACH FACE	PC	PRECAST
	ELEVATION	PI	PRESSURE INDICATOR
EMH	ELECTRICAL MANHOLE	P. ATE	PROPERTY LINE
EQ	EQUAL	PLATF	
EQUIP	EQUIPMENT	PSI PSI	POUNDS PER SQUARE FOOT POUNDS PER SQUARE INCH
ES	EACH SIDE	PST	PRIMARY SETTLING TANK
EW	EACH WAY	PV	PLUG VALVE
EXP	EXPANSION	PVB	
EXT	EXTERIOR	PVB	POLYVINYL CHLORIDE PIPE
FD	FLOOR DRAIN	RD RD	
FDN	FOUNDATION	REF	ROOF DRAIN REFERENCE
FIN	FINISH(ED)	REINF	REINFORCE, REINFORCING
FIN. FL.	FINISHED FLOOR	REQ'D	REQUIRED
FL.	FLOOR	RFG	ROOFING
FM	FORCE MAIN	R.H.	RIGHT HAND
FOW	FACE OF WALL	ROW	RIGHT OF WAY
FTG	FOOTING	RPZ	REDUCED PRESSURE
FL	FIRE EXTINGUISHER	SCH	SCHEDULE
GA	GAUGE		
GB	GLOBE VALVE	SECT	SECTION
GALV	GALVANIZED	SAN	SANITARY DRAIN

SYMBOLS

CIVIL EXISTING

- 0-	SIGN
Φ	LIGHT POLE
⊕	UTILITY POLE
> -	GUY WIRE
•	BOLLARD
IIII)	SQUARE CATCH BASIN
	GAS VALVE
	CATCH BASIN CURB INLET
WP	WATER FOUNTAIN
	ELECTRIC MANHOLE
	DRAINAGE MANHOLE
	SEWER MANHOLE
(IP)	UTILITY POLE
\bowtie	WATER VALVE
~	HYDRANT
*	BENCHMARK SET OR FOUND
	CONTOUR
	WETLANDS LINE
xxxxxx	WIRE FENCE
	CHAIN LINK FENCE
	POST AND RAIL FENCE
	WOODEN GUIDE RAIL
	PICKET FENCE
·0000000000000000000000000000000000000	HEDGE OR TREE ROW
	UNDERGROUND DRAINAGE PIPI
	STONE MASONRY WALL
	STONE RETAINING WALL
	STONE WALL REMAINS
***************************************	STONE WALL
G G G	U.G. GAS LINE
— s —— s —— s ——	U.G. SANITARY SEWER LINE
www	U.G. WATER LINE
FM FM	FORCE MAIN
— Е — Е — Е — — Е —	ELECTRIC LINE

CIVIL NEW

0	SIGN
\$	LIGHT POLE
©.	UTILITY POLE
>-	GUY WIRE
•	BOLLARD
⊠	GAS VALVE
W F	WATER FOUNTAIN
E	ELECTRIC MANHOLE
<u> </u>	DRAINAGE MANHOLE
<u>(s)</u>	SEWER MANHOLE
@ © @ @	AIR RELEASE MANHOLE
©	WYE CLEANOUT
(P)	GRINDER PUMP STATION UTILITY POLE
₩	WATER VALVE
~	HYDRANT
♦	BENCHMARK SET OR FOUND
X ©	DOUBLE CHECK VALVE
<u> </u>	NEW WORK
	U.G. GAS LINE
- s s s	U.G. SANITARY SEWER LINE
www	U.G. WATER LINE
FM FM	FORCE MAIN
—E ——E ——E ——	ELECTRIC LINE
	CONTOUR
	SAW CUT
[CS]	PRESERVE AND PROTECT TREES
[CJ]	LIMIT OF DISTURBANCE
	PROPOSED PAVEMENT

GENERAL NOTES:

- 1. ALL DIMENSIONS INDICATED ON THE DRAWINGS ARE APPROXIMATE AND SUBJECT TO REVISIONS AS PER ACTUAL FIELD CONDITIONS.
- 2. CONTRACTOR SHALL COMPLY WITH ALL NYSDEC PERMIT REQUIREMENTS AND ANY OTHER STATE, CITY, COUNTY OR TOWN AGENCY HAVING JURISDICTION. REFER TO THE CONTRACT SPECIFICATIONS, APPENDIX I, FOR PERMIT REQUIREMENTS.
- 3. CONTRACTOR SHALL TAKE ALL PRECAUTIONS TO MAINTAIN SERVICE TO AND PROTECT THE EXISTING MONTROSE IMPROVEMENT DISTRICT 16" WATER MAIN. SHUTDOWNS OF THIS WATER MAIN ARE NOT PERMITTED. EXISTING CORPORATION STOPS AND VALVES SHALL BE THE TIE-IN POINTS FOR NEW SERVICE.
- 4. ANY UTILITIES SHOWN ON THE PLANS ARE FOR INFORMATION ONLY AND HAVE BEEN OBTAINED FROM AVAILABLE SOURCES. THE EXISTENCE AND LOCATION OF ANY UTILITIES INDICATED ON THE PLANS ARE NOT GUARANTEED AND SHALL BE INVESTIGATED AND VERIFIED IN THE FIELD BY THE CONTRACTOR BEFORE STARTING WORK. EXCAVATION IN THE VICINITY OF UNDERGROUND UTILITIES SHALL BE DUG BY HAND. THE CONTRACTOR WILL BE HELD RESPONSIBLE FOR ANY DAMAGE TO EXISTING UTILITIES. NO SEPARATE PAYMENT SHALL BE MADE FOR THIS WORK.
- 5. THE CONTRACTOR WILL BE REQUIRED TO PROVIDE PRIVATE UTILITY MARKOUTS FOR ALL UTILITIES IN THE WORK AREAS. THE CONTRACTOR SHALL SUBMIT THE PROPOSED UTILITY SUB-CONTRACTOR FOR APPROVAL.
- 6. THE CONTRACTOR SHALL OBTAIN AND HAVE ON THE JOB SITE, AT ALL TIMES, ALL PERMITS AS REQUIRED BY THE STATE, COUNTY, TOWN/VILLAGE, OR ANY OTHER PERMITTING AGENCY. THE CONTRACTOR SHALL BEAR ALL COSTS OF OBTAINING THESE PERMITS.
- 7. CONTRACTOR SHALL REMOVE ALL DEBRIS AND EXCESS CONSTRUCTION MATERIALS TO THE SATISFACTION OF THE OWNER AND ENGINEER. THE CONTRACTOR SHALL BE RESPONSIBLE FOR THE REMOVAL AND LEGAL DISPOSAL OF ALL MATERIALS RESULTING FROM THIS CONTRACT.
- 8. CONTRACTOR SHALL COORDINATE ALL CONSTRUCTION ACTIVITIES WITH THE OWNER AND ENGINEER TO MINIMIZE INTERRUPTIONS TO NORMAL PARK OPERATIONS.
- 9. CONTRACTOR SHALL SUBMIT DETAILED WORK PLAN INCLUDING SEQUENCE OF OPERATIONS PRIOR TO COMMENCING WORK AND SHALL BE SUBJECT TO APPROVAL OF THE OWNER.
- 10. THE CONTRACTOR SHALL AT ALL TIMES, PROVIDE CONVENIENT ACCESS WITH SAFE AND PROPER FACILITIES FOR THE INSPECTION OF ALL PARTS OF THE WORK. NO WORK, EXCEPT SUCH SHOP WORK AS MAY BE SO PERMITTED, SHALL BE DONE EXCEPT WITH THE CONSENT OF THE OWNER OR A REPRESENTATIVE THEREOF.
- 11. THE CONTRACTOR SHALL NOTIFY THE OWNER AND THE ENGINEER A MINIMUM OF SEVENTY-TWO (72) HOURS PRIOR TO THE START OF CONSTRUCTION. IN ADDITION, IF WORK SHOULD BE STOPPED AND RESTARTED FOR ANY REASON, THE CONTRACTOR SHALL GIVE THE ENGINEER A MINIMUM OF SEVENTY-TWO (72) HOURS NOTICE.
- 12. ITEMS SUSTAINING DAMAGE DURING CONSTRUCTION AS A RESULT OF THE CONTRACTOR'S OPERATIONS SHALL BE REPAIRED AND/OR REPLACED TO THE SATISFACTION AND APPROVAL OF THE OWNER AT THE CONTRACTOR'S EXPENSE. ANY DAMAGE TO PAVEMENT OR GRASS AREAS SHALL BE REPAIRED AT NO ADDITIONAL COST TO THE OWNER.
- 13. ALL NECESSARY PRECAUTIONS SHALL BE TAKEN TO PRESERVE THE MATERIAL BELOW AND BEYOND THE LINES OF ALL EXCAVATION IN THE SOUNDEST POSSIBLE CONDITION. ANY DAMAGE TO THE WORK DUE TO THE CONTRACTOR'S OPERATIONS SHALL BE REPAIRED AT THE EXPENSE OF AND BY THE CONTRACTOR.
- 14. NO MATERIALS OF ANY KIND SHALL BE USED UNTIL IT HAS BEEN INSPECTED AND ACCEPTED BY THE ENGINEER; ALL MATERIALS REJECTED SHALL BE IMMEDIATELY REMOVED FROM THE WORK SITE AND SHALL NOT BE OFFERED FOR INSPECTION AGAIN.
- 15. ANY MATERIALS OR WORKMANSHIP FOUND AT ANY TIME TO BE DEFECTIVE SHALL BE REMEDIED AT ONCE, REGARDLESS OF PREVIOUS INSPECTION, THE INSPECTION AND OBSERVATION OF WORK BY THE ENGINEER IS INTENDED TO AID THE CONTRACTOR IN APPLYING LABOR AND MATERIAL TO AND IN ACCORDANCE WITH THE SPECIFICATIONS, BUT SUCH INSPECTION SHALL NOT RELEASE THE CONTRACTOR FROM ANY CONTRACT
- 16. THE CONTRACTOR SHALL CONDUCT THE WORK IN A SAFE MANNER SO AS TO POSE NO DANGER OR HAZARDS TO PERSONS OR PROPERTY. WHERE NECESSARY, TEMPORARY SHIELDS OR OTHER PROTECTIVE DEVICES MUST BE UTILIZED. THE CONTRACTOR ASSUMES FULL RESPONSIBILITY AND EXPENSE OF ANY AND ALL SAFETY MEASURES. THE USE OF EXPLOSIVES IS STRICTLY PROHIBITED. THE CONTRACTOR SHALL COMPLY WITH ALL OSHA AND NEW YORK STATE DEPARTMENT OF LABOR REQUIREMENTS.

- 17. RESEED ALL AREAS WHERE WORK HAS OCCURRED AND/OR WHERE CONTRACTOR HAS DAMAGED EXISTING GRASS, IN ACCORDANCE WITH THE SPECIFICATIONS. STAGING AREAS SHALL BE RESTORED TO ORIGINAL CONDITION AND SHALL BE SEEDED FOLLOWING COMPLETION OF ALL WORK.
- 18. THE CONTRACTOR SHALL HAVE A COMPETENT REPRESENTATIVE PRESENT WHO SHALL RESPOND TO ANY QUESTIONS OR REQUESTS OF THE ENGINEER IN THE PROSECUTION AND COMPLETION OF THE WORK IN CONFORMITY WITH THIS CONTRACT, AND SHALL HAVE FULL AUTHORITY TO SUPPLY LABOR AND MATERIAL IMMEDIATELY. THE CONTRACTOR SHALL ALSO HAVE A COMPETENT REPRESENTATIVE AVAILABLE TO RECEIVE TELEPHONE MESSAGES AND PROVIDE A REASONABLE REPLY AS SOON AS POSSIBLE, BUT NO LATER THAN 24 HOURS.
- 19. NEITHER THE OWNER OR ENGINEER SHALL BE RESPONSIBLE FOR THE MEANS AND METHODS CHOSEN BY THE CONTRACTOR TO COMPLETE THE WORK.
- 20. THE CONTRACTOR SHALL HAVE FULL RESPONSIBILITY FOR SITE SAFETY AND THE SAFETY OF THE CONTRACTOR'S WORK FORCE.
- 21. BACKFILL AT ALL EXCAVATIONS SHALL BE PLACED IN 6" LIFTS AND SHALL ACHIEVE A COMPACTION NOT LESS THAN 95 PERCENT OF STANDARD PROCTOR MAXIMUM DENSITY. UNDER THE TERMS OF THE CONTRACT, THE CONTRACTOR SHALL PERFORM FIELD TESTS BY AN APPROVED LABORATORY TO ASSURE THIS COMPACTION RATE AT VARYING DEPTHS. THE CONTRACTOR SHALL HAVE THE APPROVED LABORATORY REPRESENTATIVE ON SITE WHEN DIRECTED BY THE ENGINEER. THE CONTRACTOR SHALL BEAR ALL COSTS FOR TESTING AND ANY DELAYS THAT RESULT FROM SUCH TESTING.
- 22. THE CONTRACTOR SHALL ADJUST ALL MANHOLE FRAMES AND COVERS, VALVE COVERS, WATER VALVE BOXES, DRAINAGE INLETS, ETC. AS NECESSARY TO MEET THE SURFACE OF NEW PAVEMENT OR WALKWAY AS REQUIRED. NO SEPARATE PAYMENT WILL BE MADE FOR THIS WORK UNLESS OTHERWISE NOTED IN THE CONTRACT DOCUMENTS. THE CONTRACTOR SHALL COORDINATE THIS ACTIVITY WITH THE RELATED UTILITY COMPANIES, IF APPLICABLE. WARPING OF THE PAVEMENT SURFACE TO MEET THESE ITEMS SHALL NOT BE PERMITTED.
- 23. ALL EXISTING SIGNS IN THE CONTRACT AREA ARE TO REMAIN INTACT. SIGNS DAMAGED SHALL BE REPLACED AT THE CONTRACTOR'S EXPENSE. ANY SIGNS THAT REQUIRE RESETTING SHALL BE PLACED IN A FINAL POSITION DETERMINED BY THE OWNER. NO SEPARATE PAYMENT SHALL BE MADE FOR THIS WORK. THE CONTRACTOR SHALL BE HELD RESPONSIBLE FOR SIGNS DAMAGED BY HIS OPERATIONS. THE CONTRACTOR SHALL BE RESPONSIBLE FOR ALL DAMAGES TO BURIED AND OVERHEAD UTILITIES LOCATED ON PUBLIC AND PRIVATE PROPERTY. THE CONTRACTOR SHALL BE RESPONSIBLE FOR ALL DAMAGES TO FACILITIES ON PUBLIC AND PRIVATE PROPERTY, SUCH AS, LANDSCAPING, DRIVEWAYS, CURBS, PAVEMENT, SIDEWALK, ETC.
- 24. CONTRACTOR IS RESPONSIBLE TO COORDINATE AND VERIFY THE EXTENT OF ALL DEMOLITION WITH THE ENGINEER PRIOR TO PERFORMING THE WORK.
- 25. CONTRACTOR SHALL RESTORE STAGING AREA BACK TO ITS ORIGINAL CONDITION INCLUDING GRADING, SEEDING, ETC. EXISTING TREES, UTILITIES, LIGHT POLES, STONE, SIDEWALK, CURB, ETC. SHALL BE PROTECTED AND REPLACED IF DAMAGED. PROVIDE ELECTRICAL POWER, WATER, TELEPHONE, ETC. AS SPECIFIED FOR THE ENGINEERS TRAILER WHICH SHALL BE LOCATED IN THE STAGING AREA.
- 26. ALL ELECTRICAL INFORMATION SHOWN WITHIN THE CIVIL PLANS ARE FOR COORDINATION PURPOSES ONLY AND NOT TO BE USED FOR CONSTRUCTION. REFER TO ELECTRICAL SHEETS E-01 THROUGH E-99 FOR ELECTRICAL PLANS AND DETAILS.



(914) 467-5300

GAS MAIN

GAS SERVICE

GENERAL CONTRACTOR

GRINDER PUMP STATION

GALVANIZED STEEL OR

GM

GPS

GS



SIMILAR


SQUARE


SHORT LEG VERTICAL

SPECIFICATIONS

SLAB

SQ.

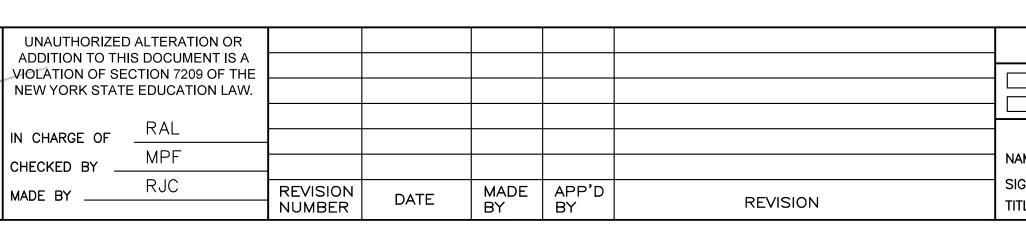

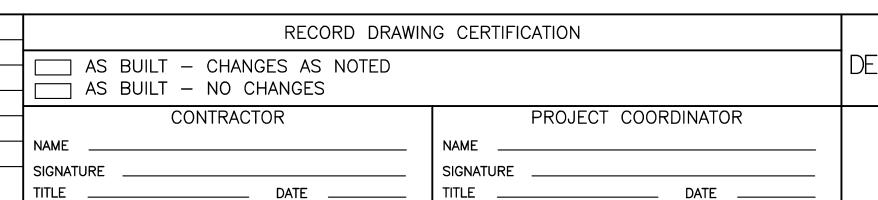

WESTCHESTER COUNTY, NEW YORK DEPARTMENT OF PUBLIC WORKS & TRANSPORTATION DIVISION OF ENGINEERING

SYMBOLS, ABBREVIATIONS, AND NOTES


SHEET NO. 2 OF 35 SCALE: AS NOTED BLUE MOUNTAIN RESERVATION SITE WORK IMPROVEMENTS DATE: APRIL 2021 TOWN OF CORTLANDT, CITY OF PEEKSKILL, NY DPW FILE NO. GENERAL


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17-519





DATE ___

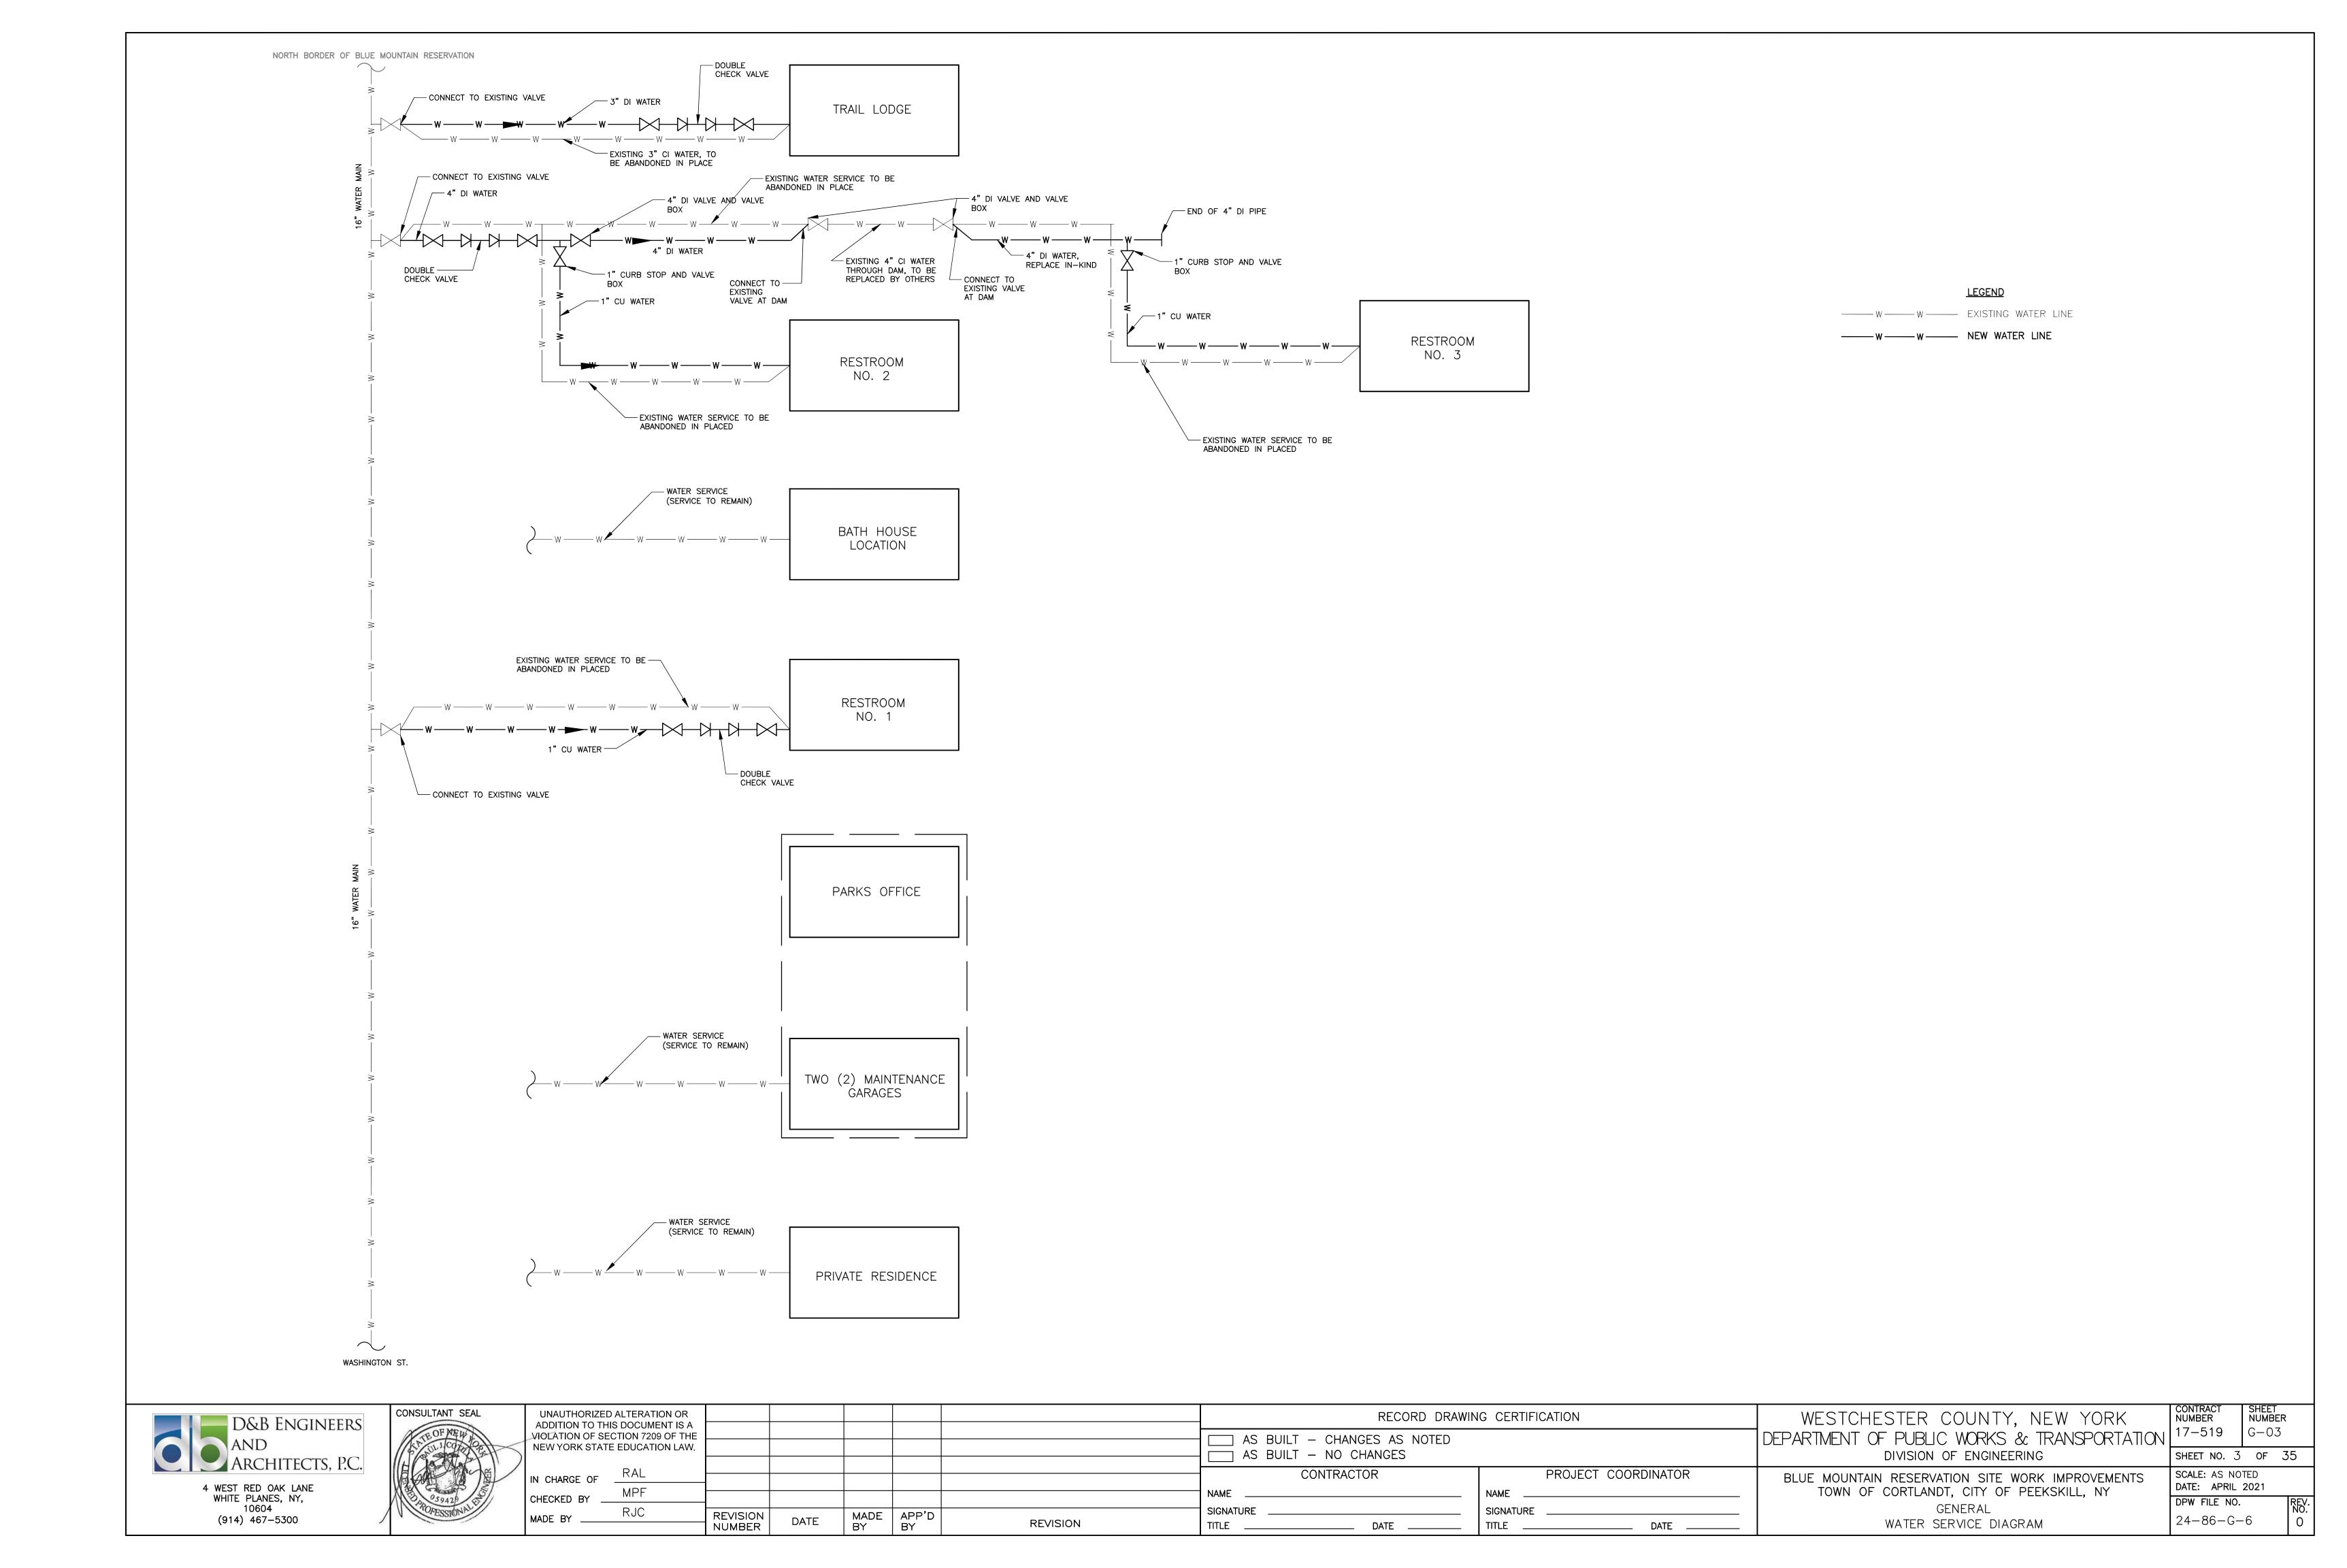
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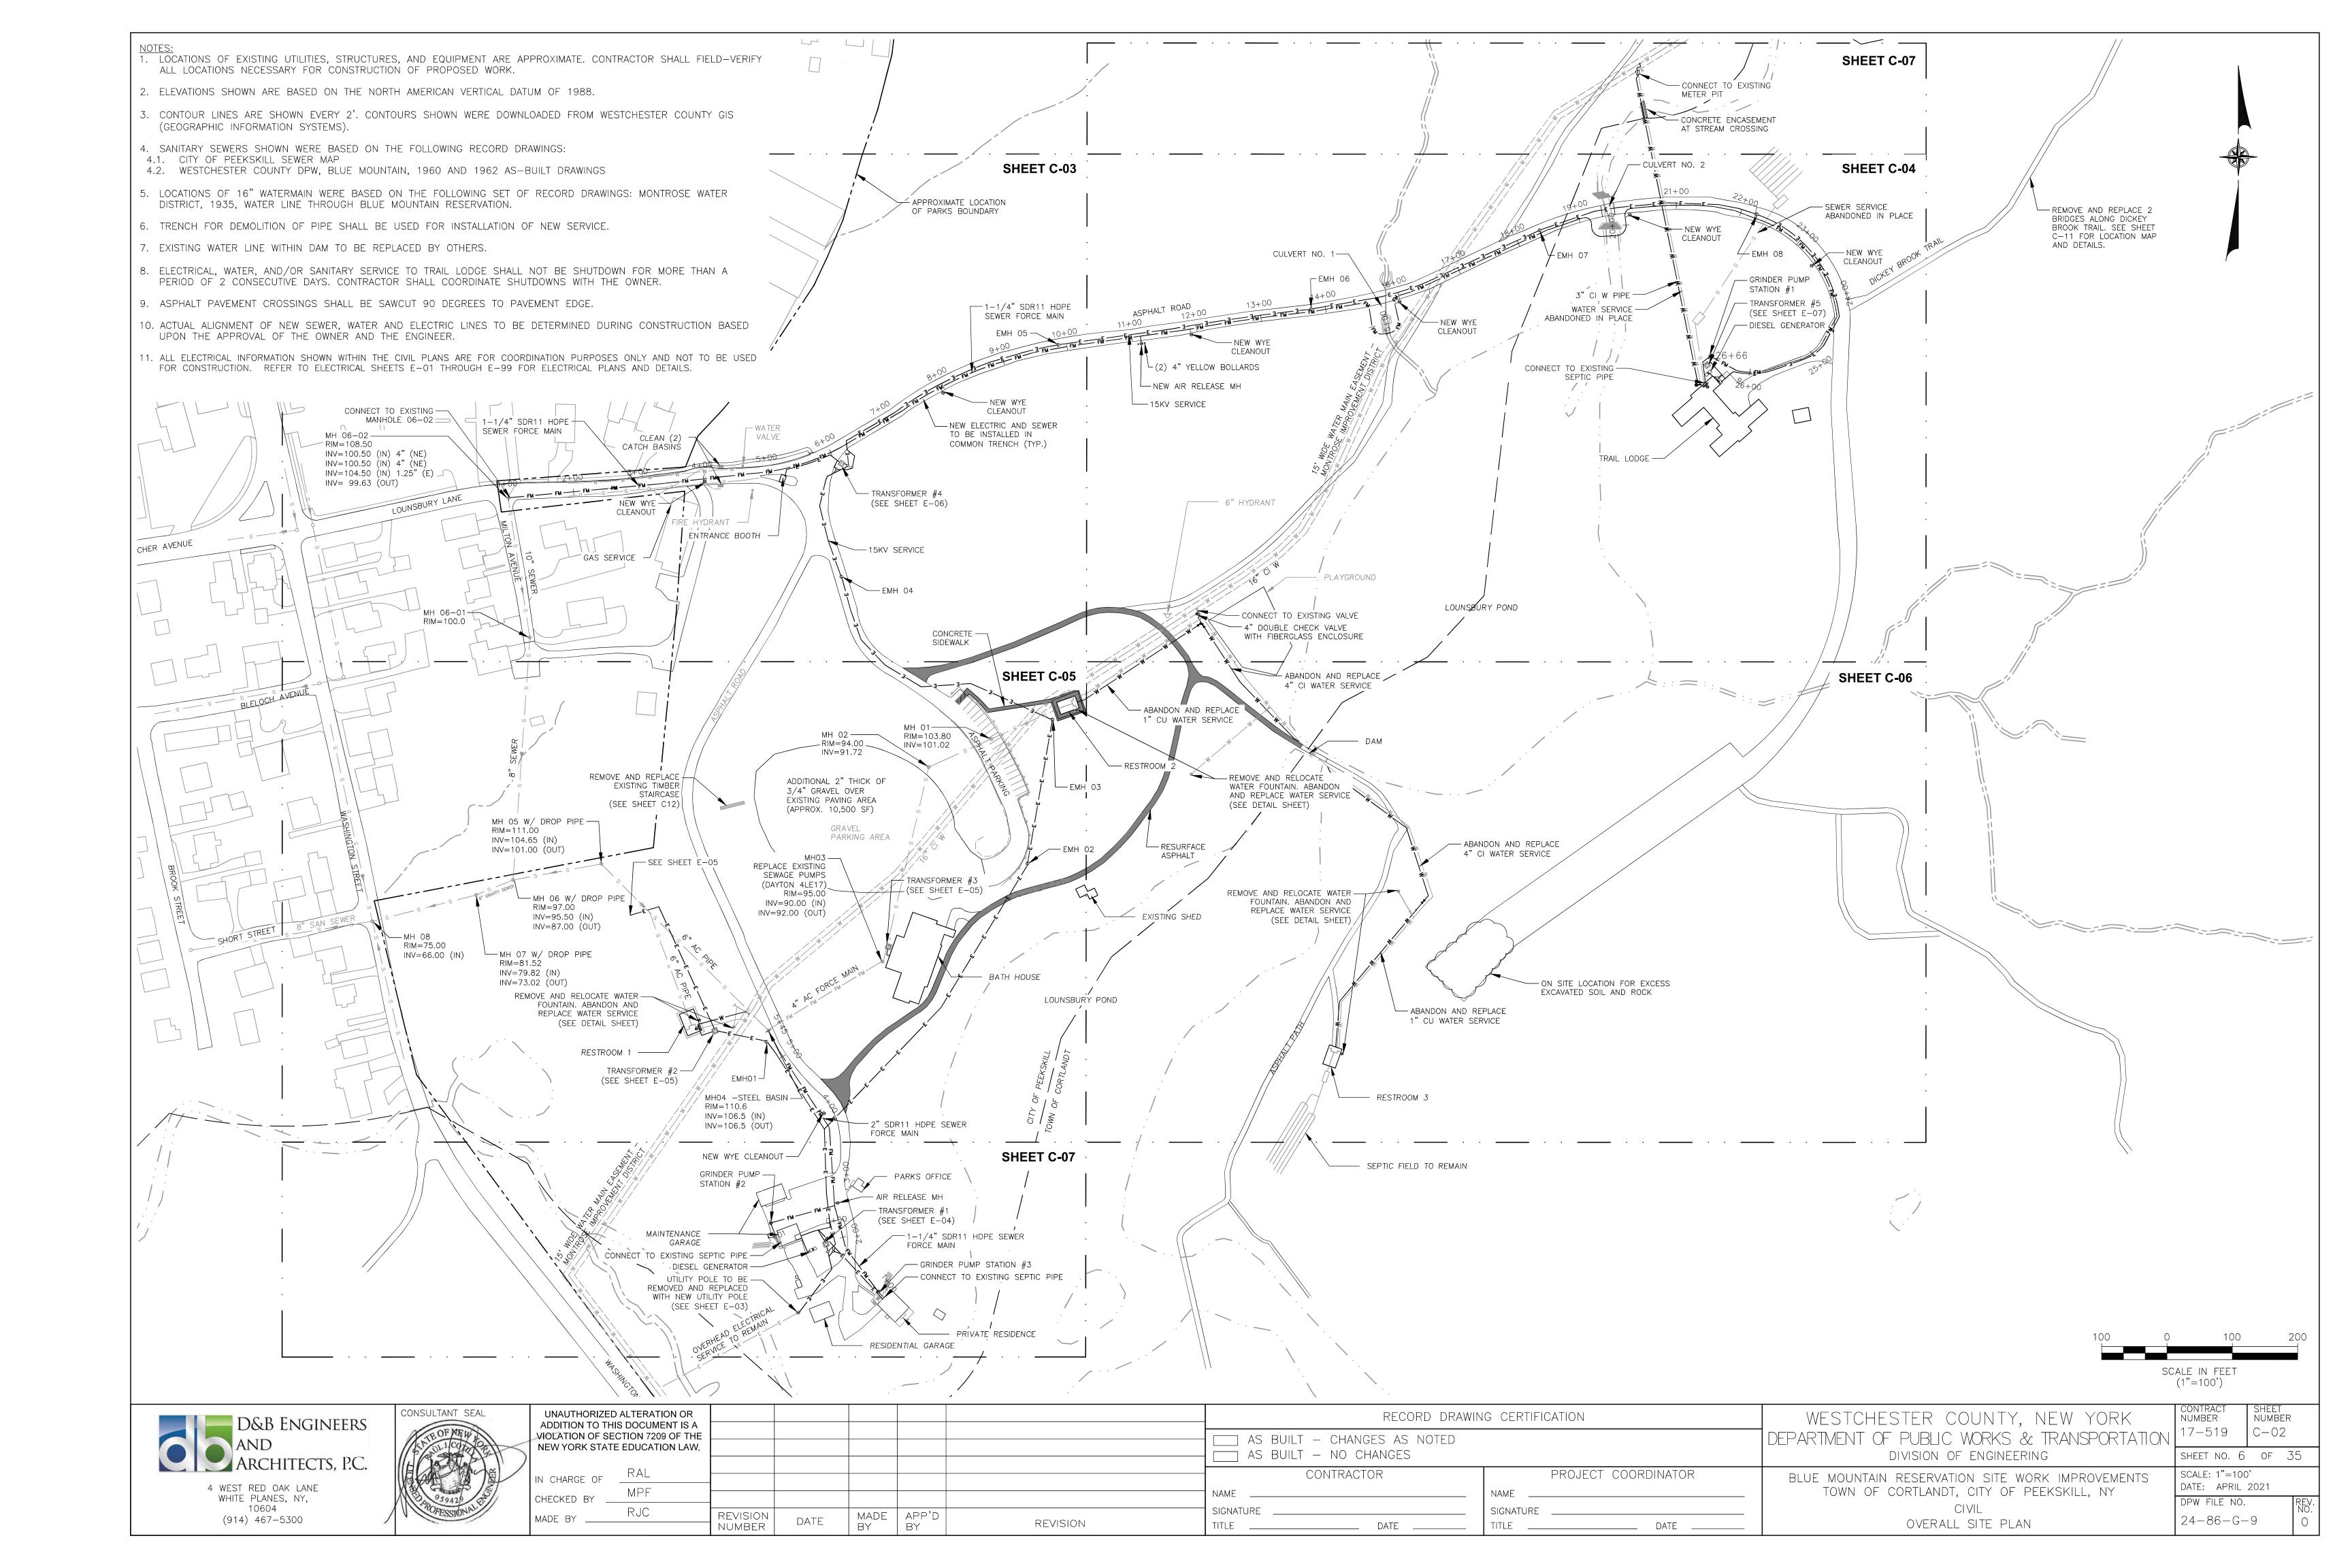
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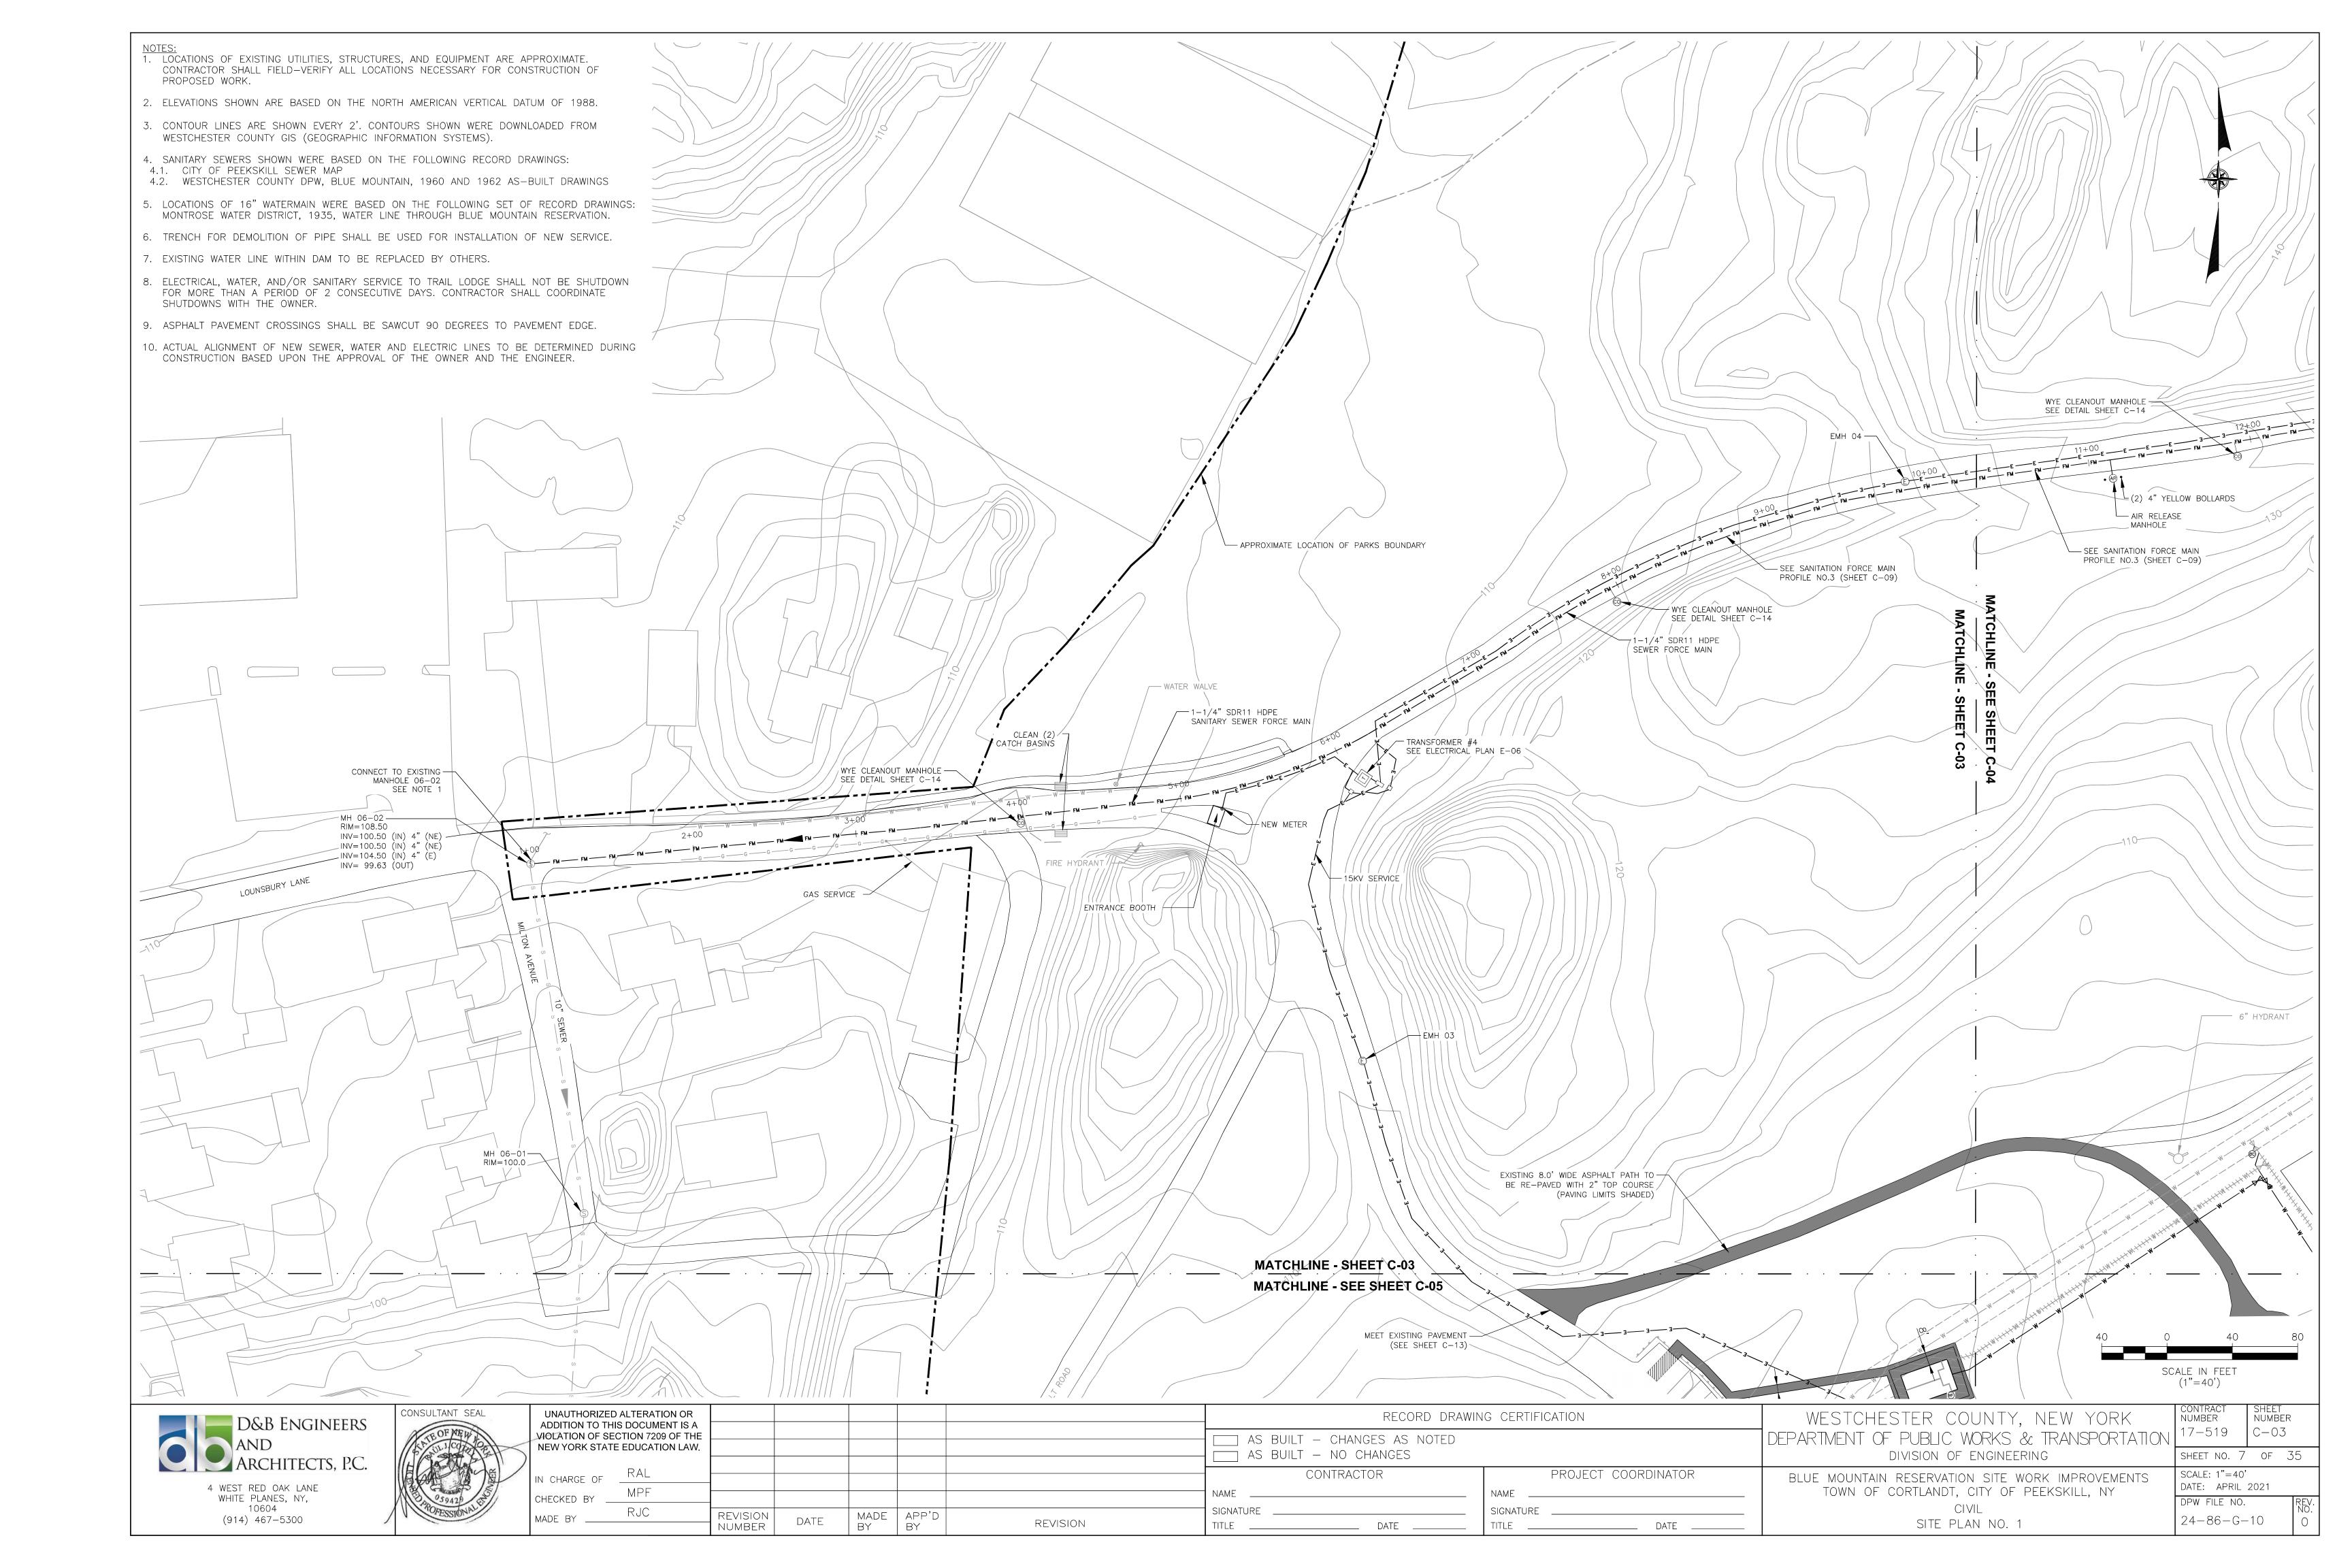


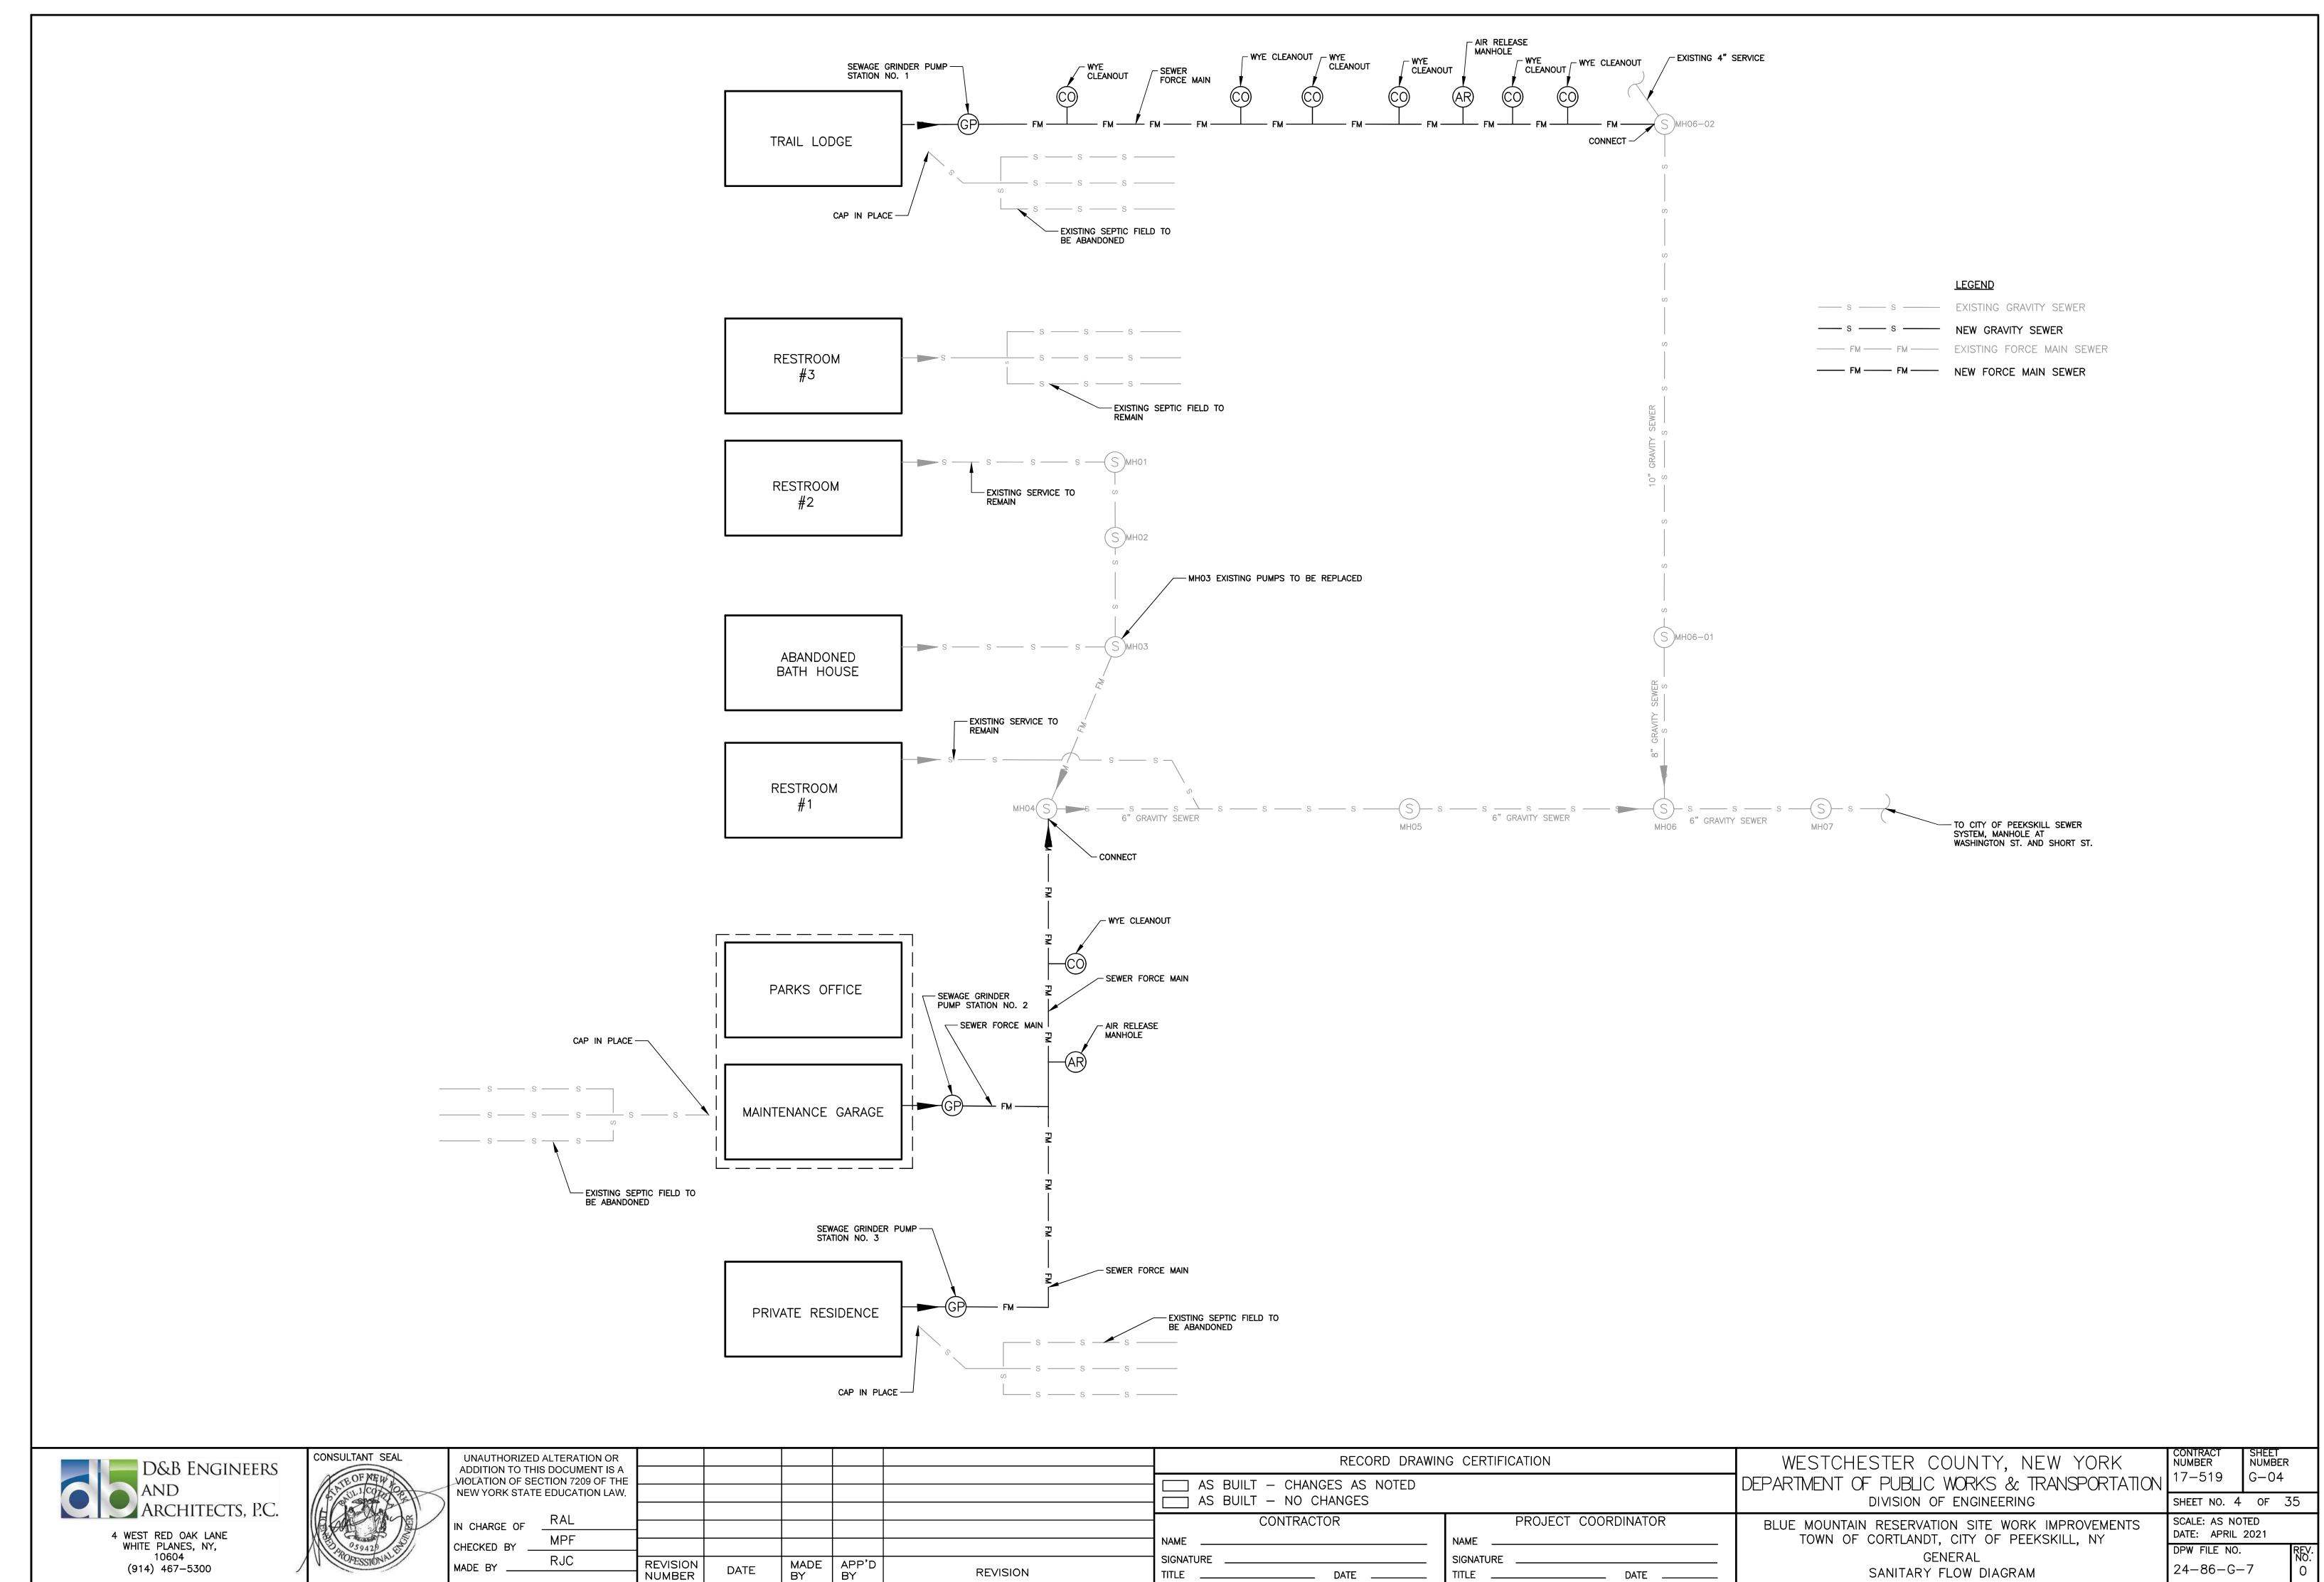
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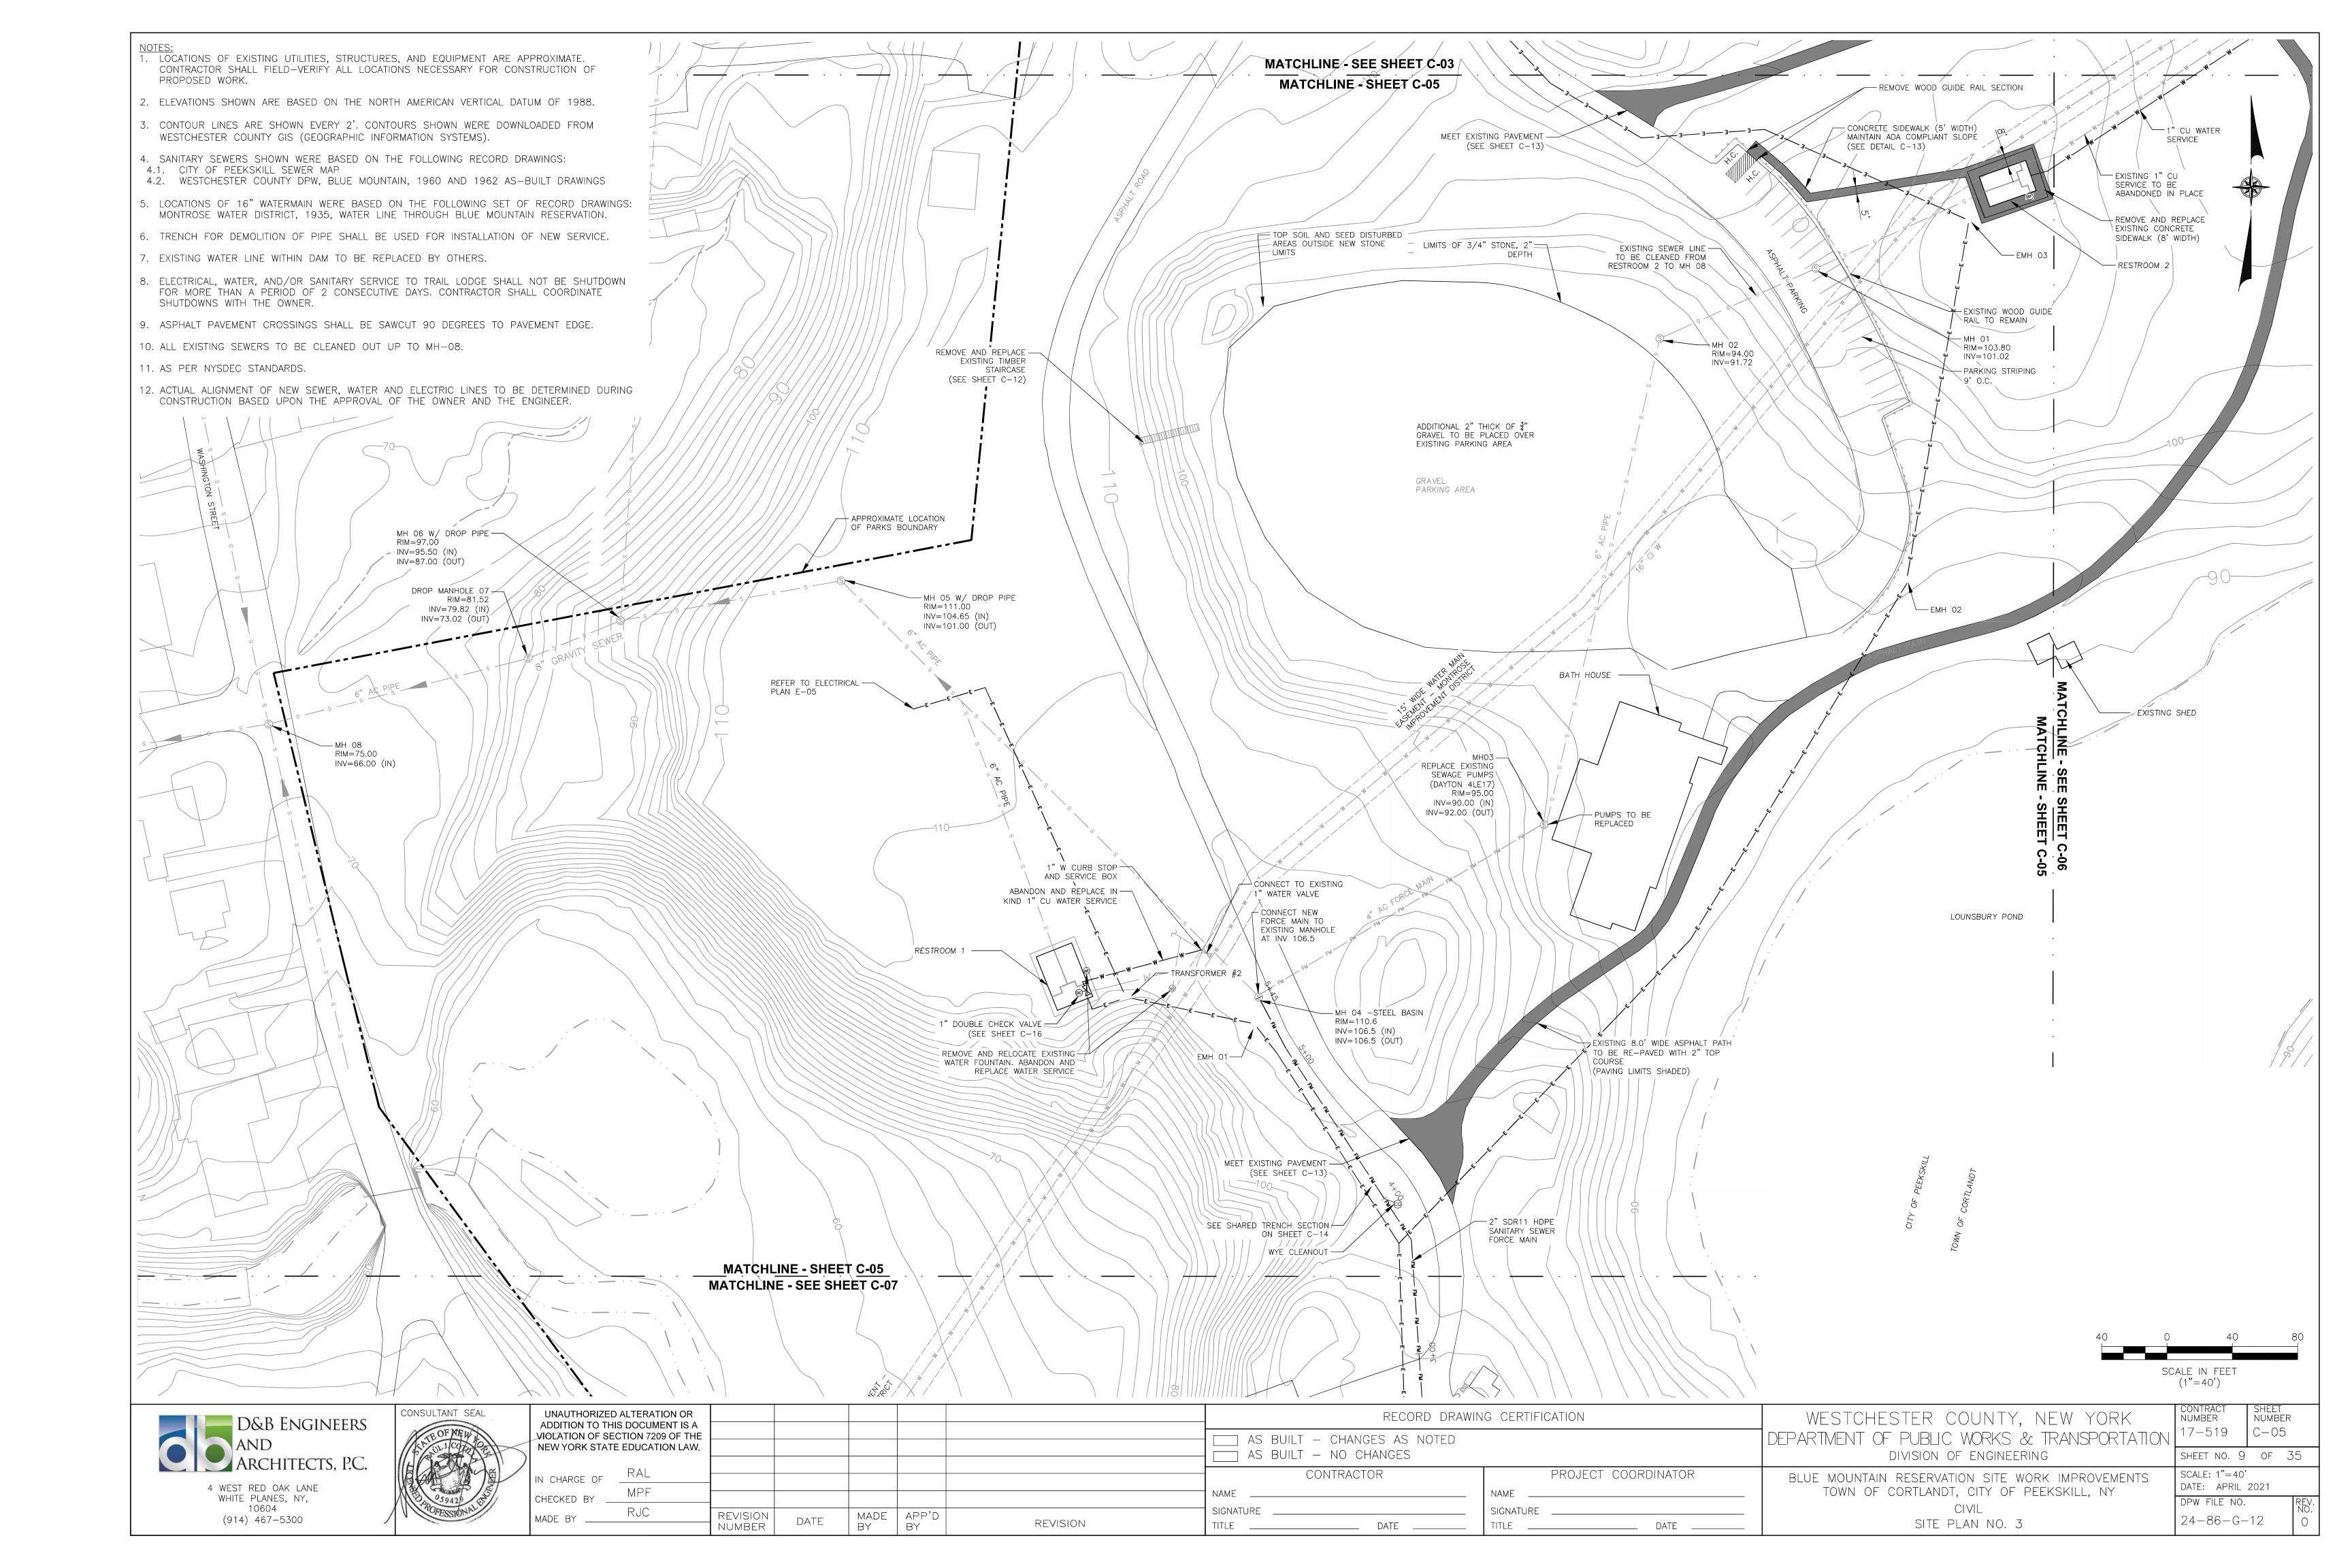
GENERAL SANITARY FLOW DIAGRAM










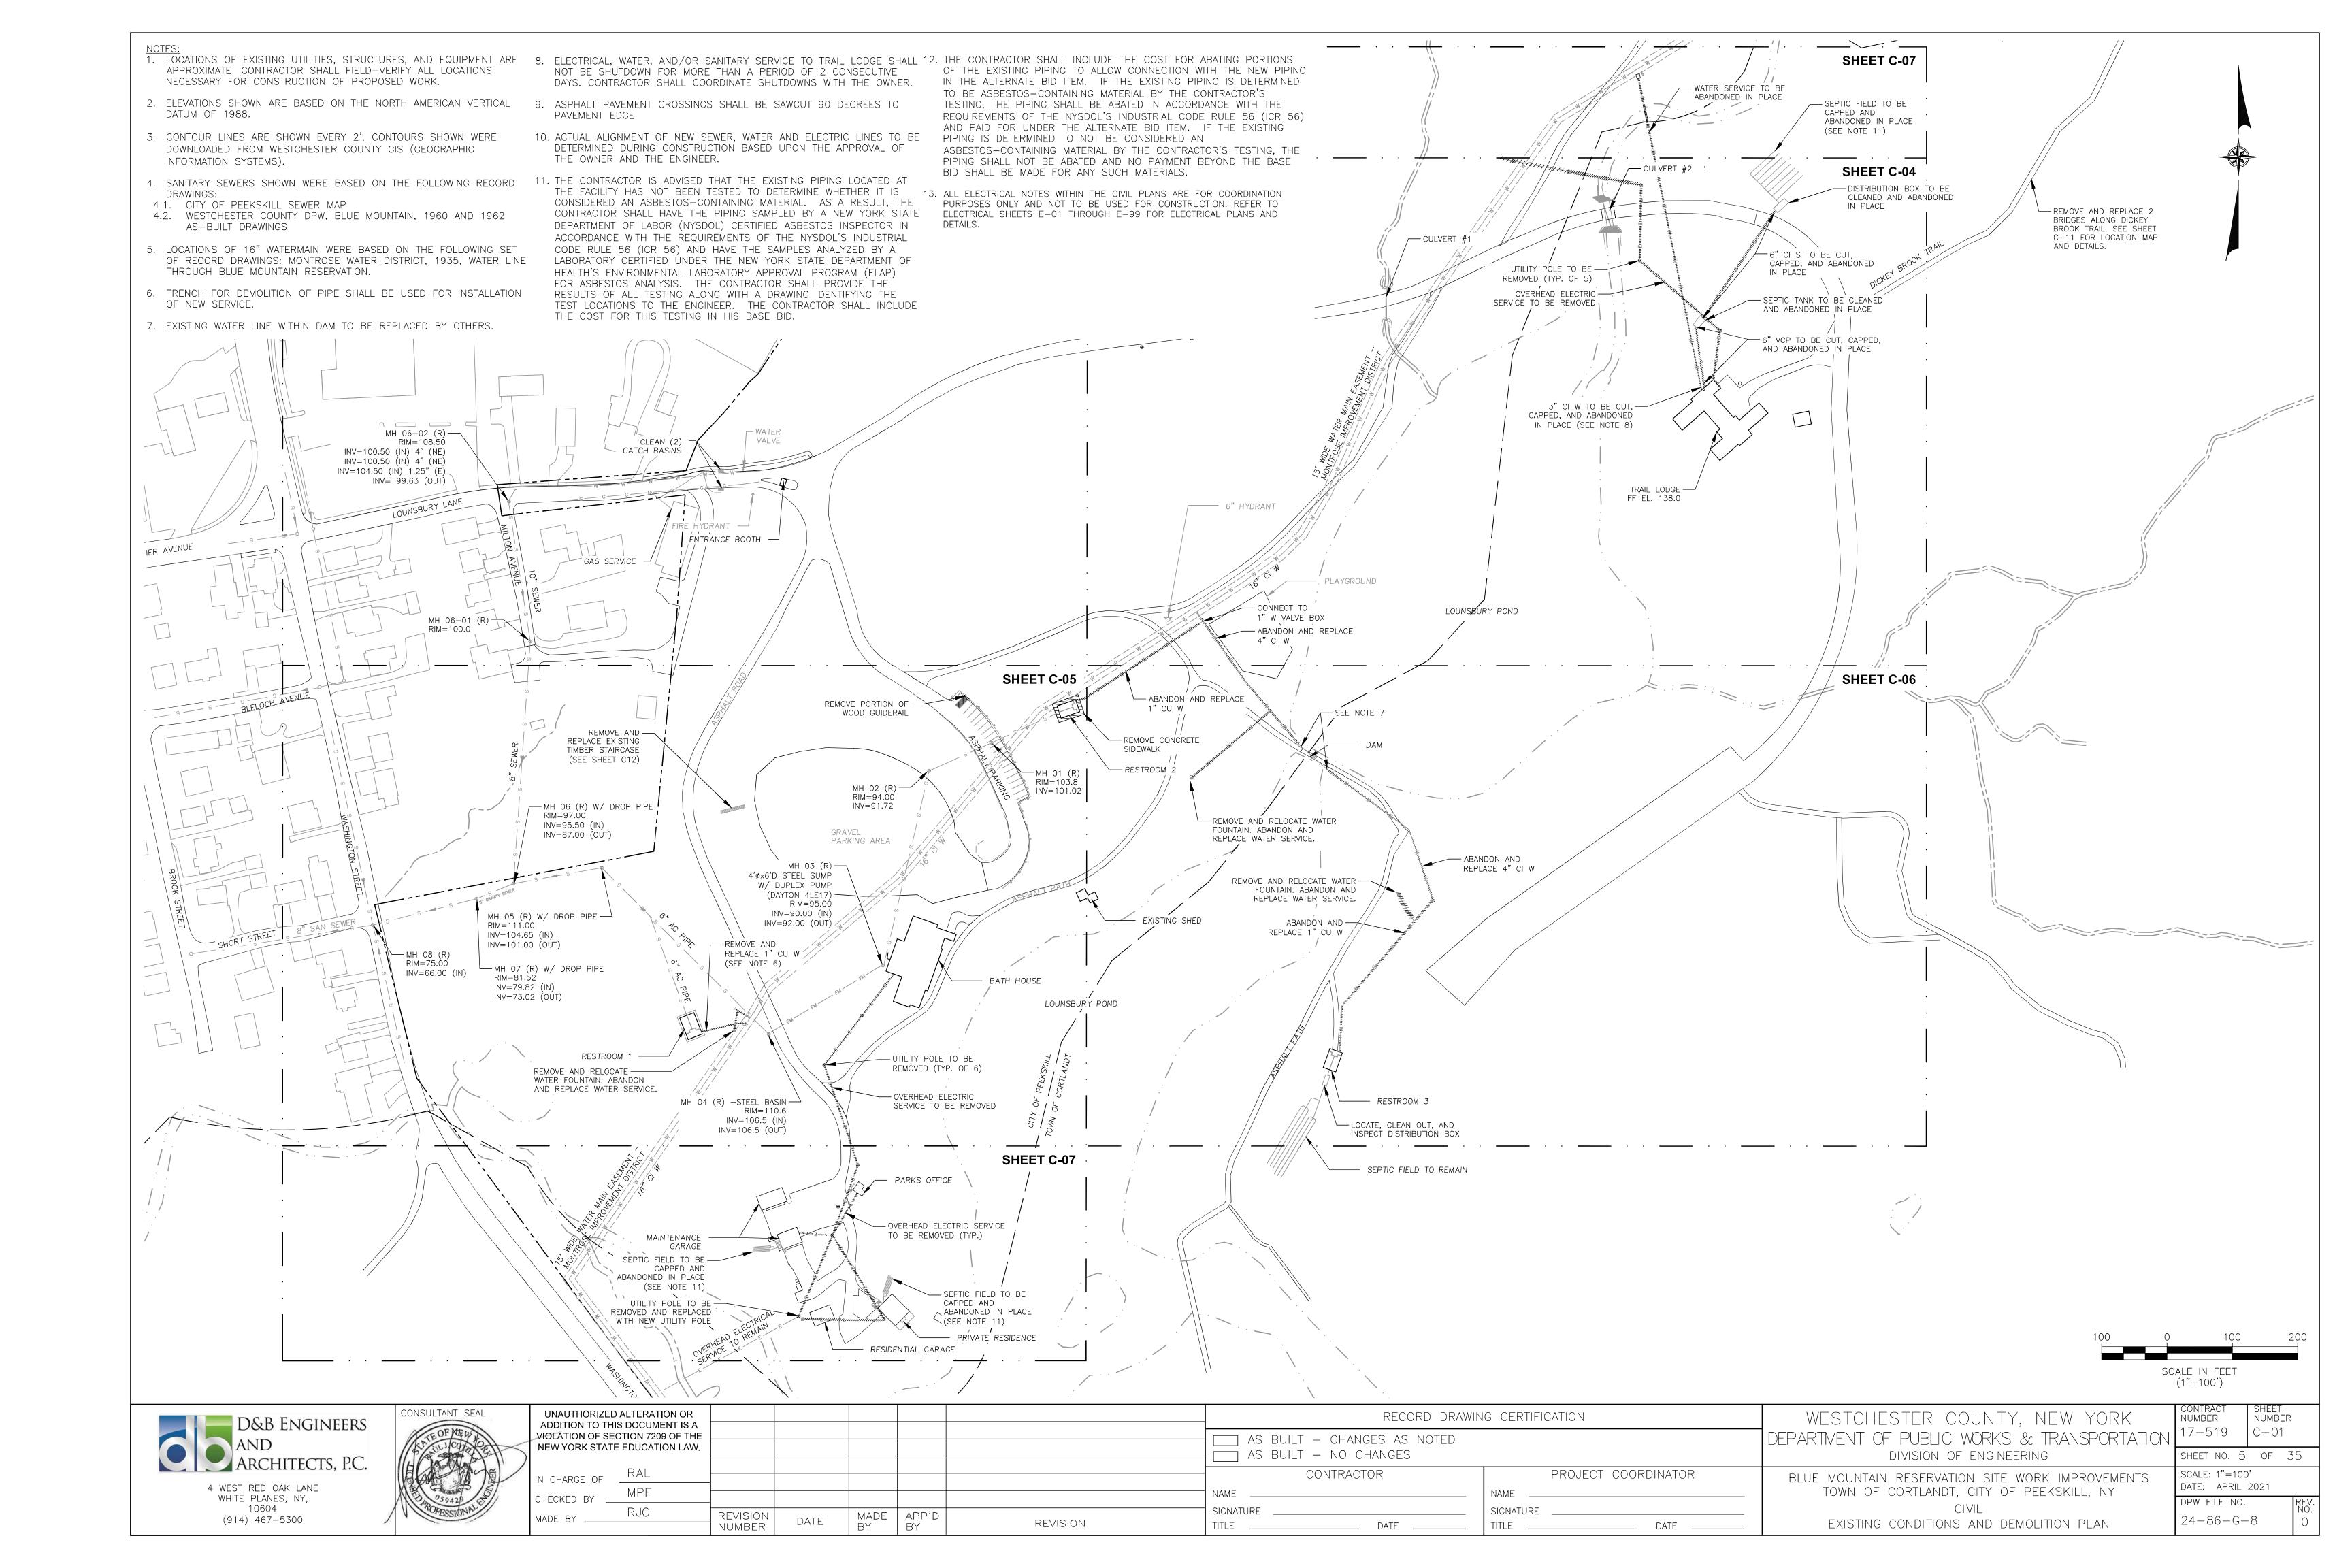


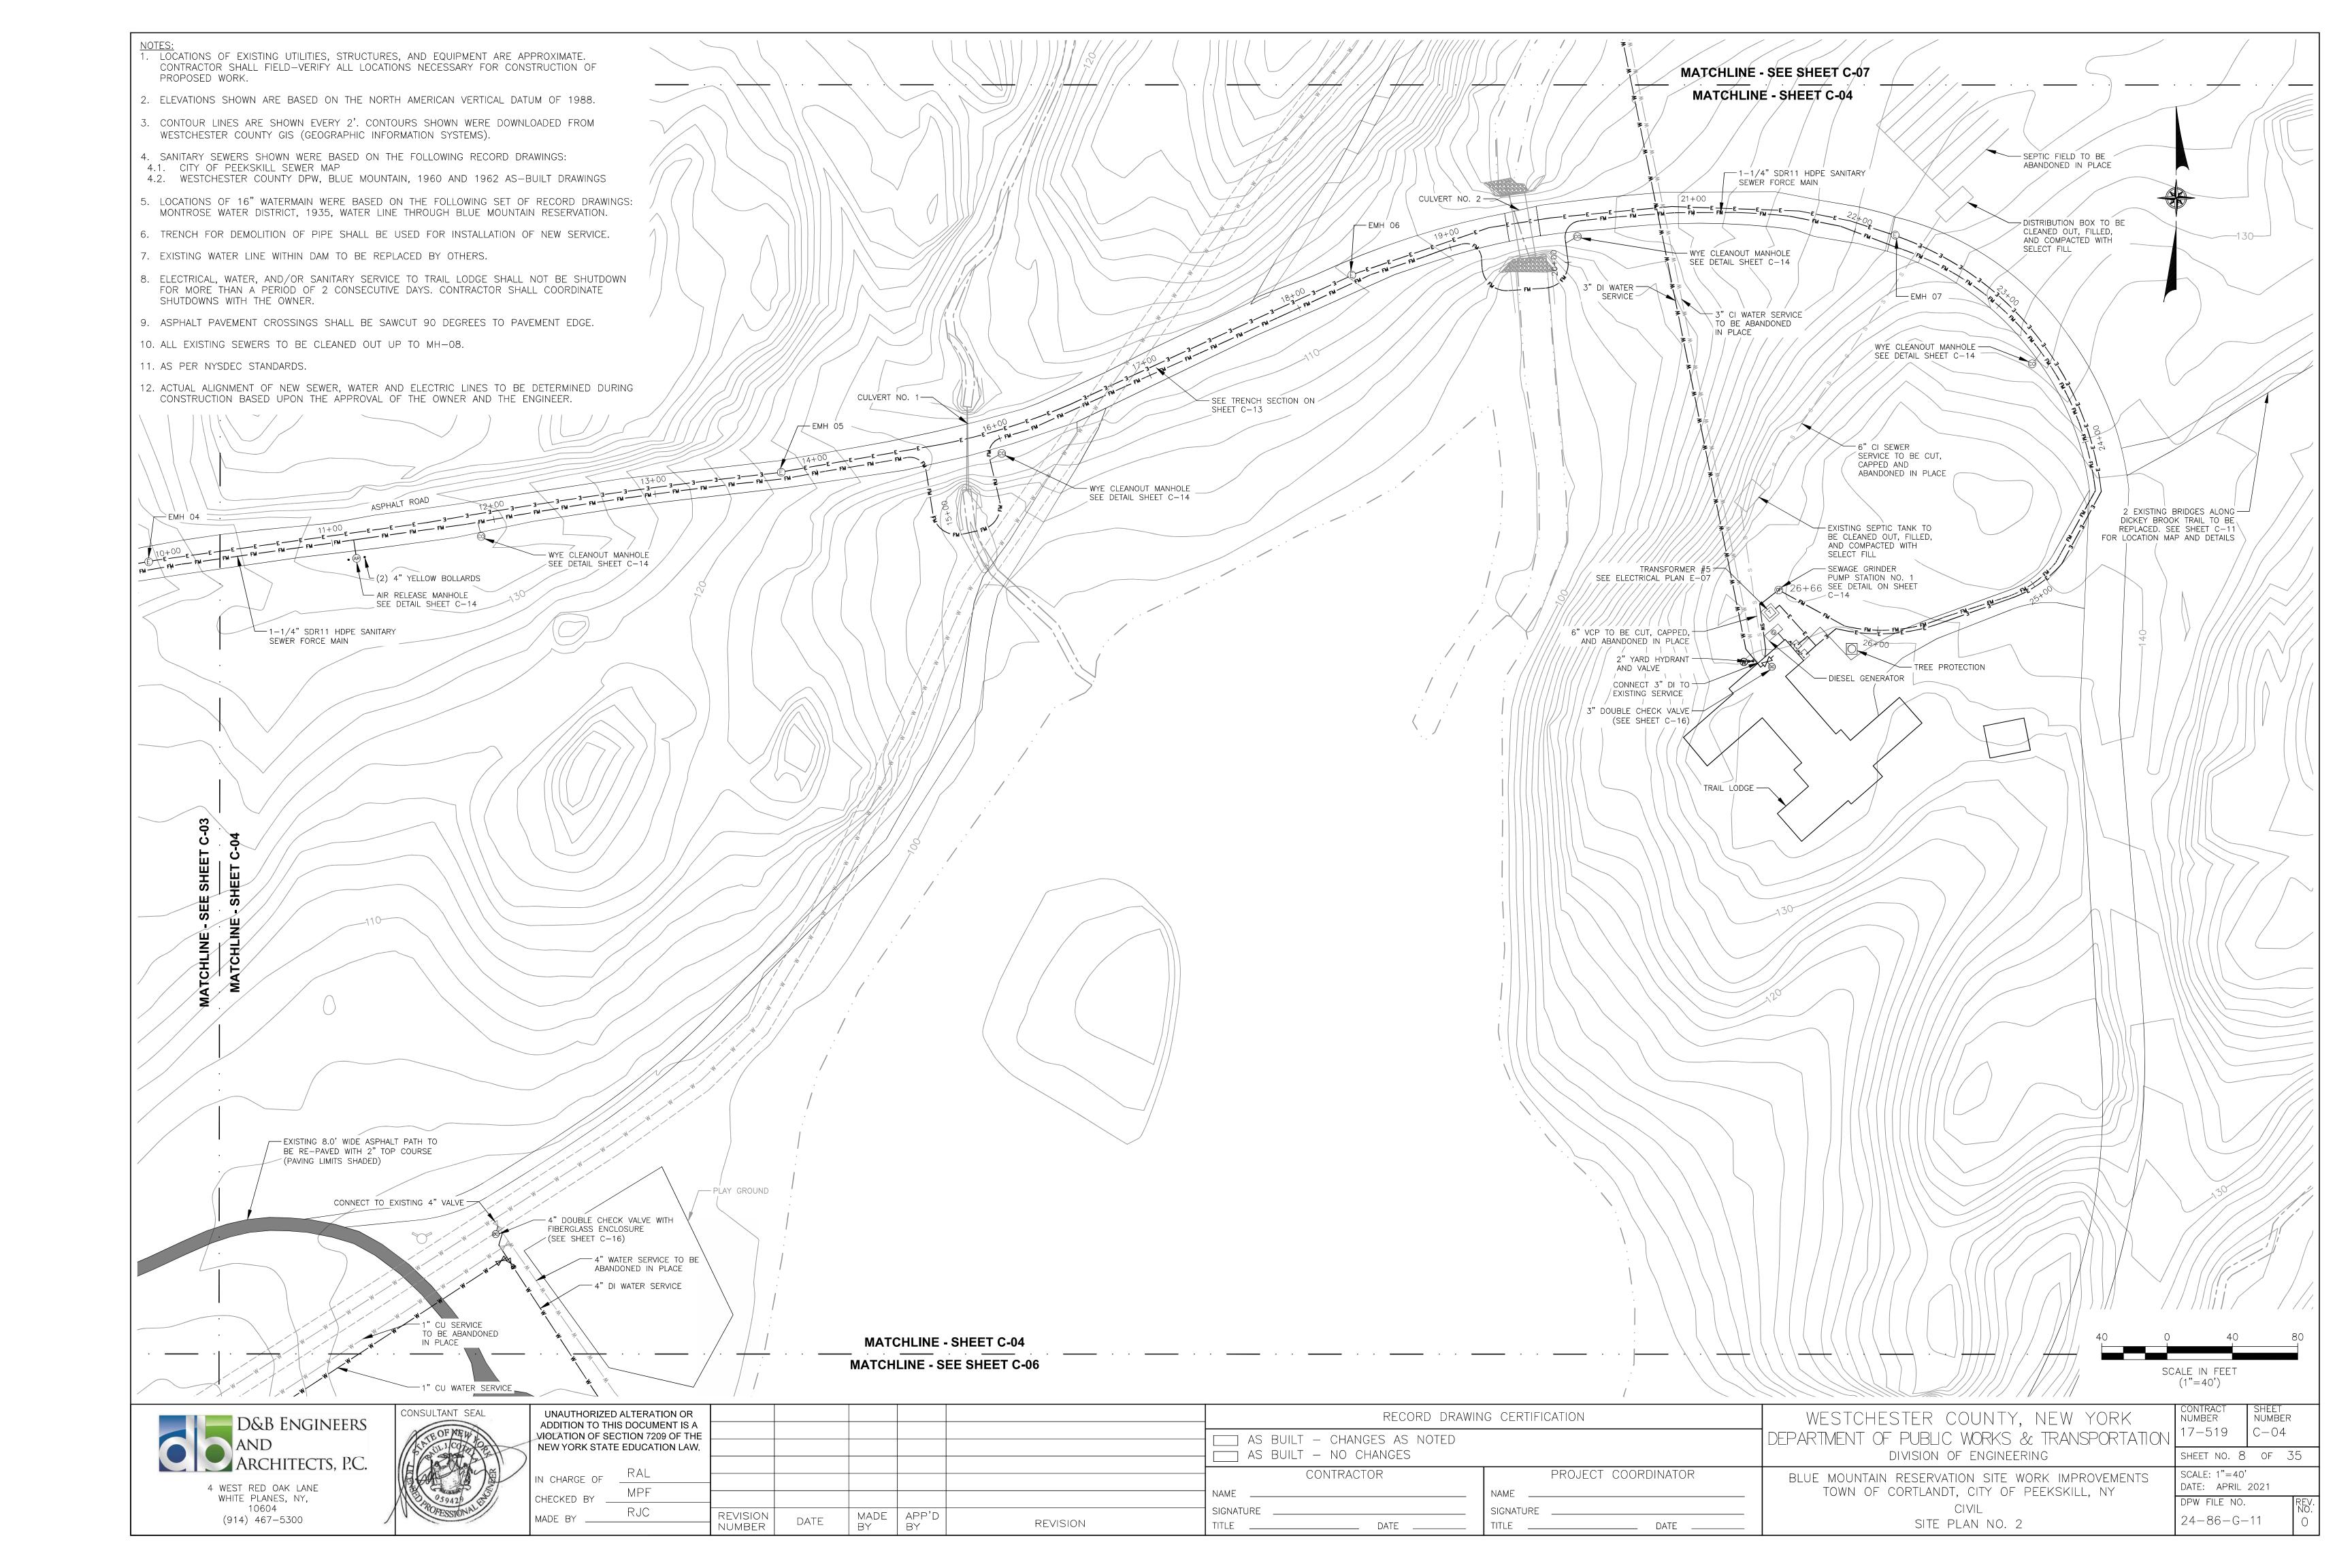

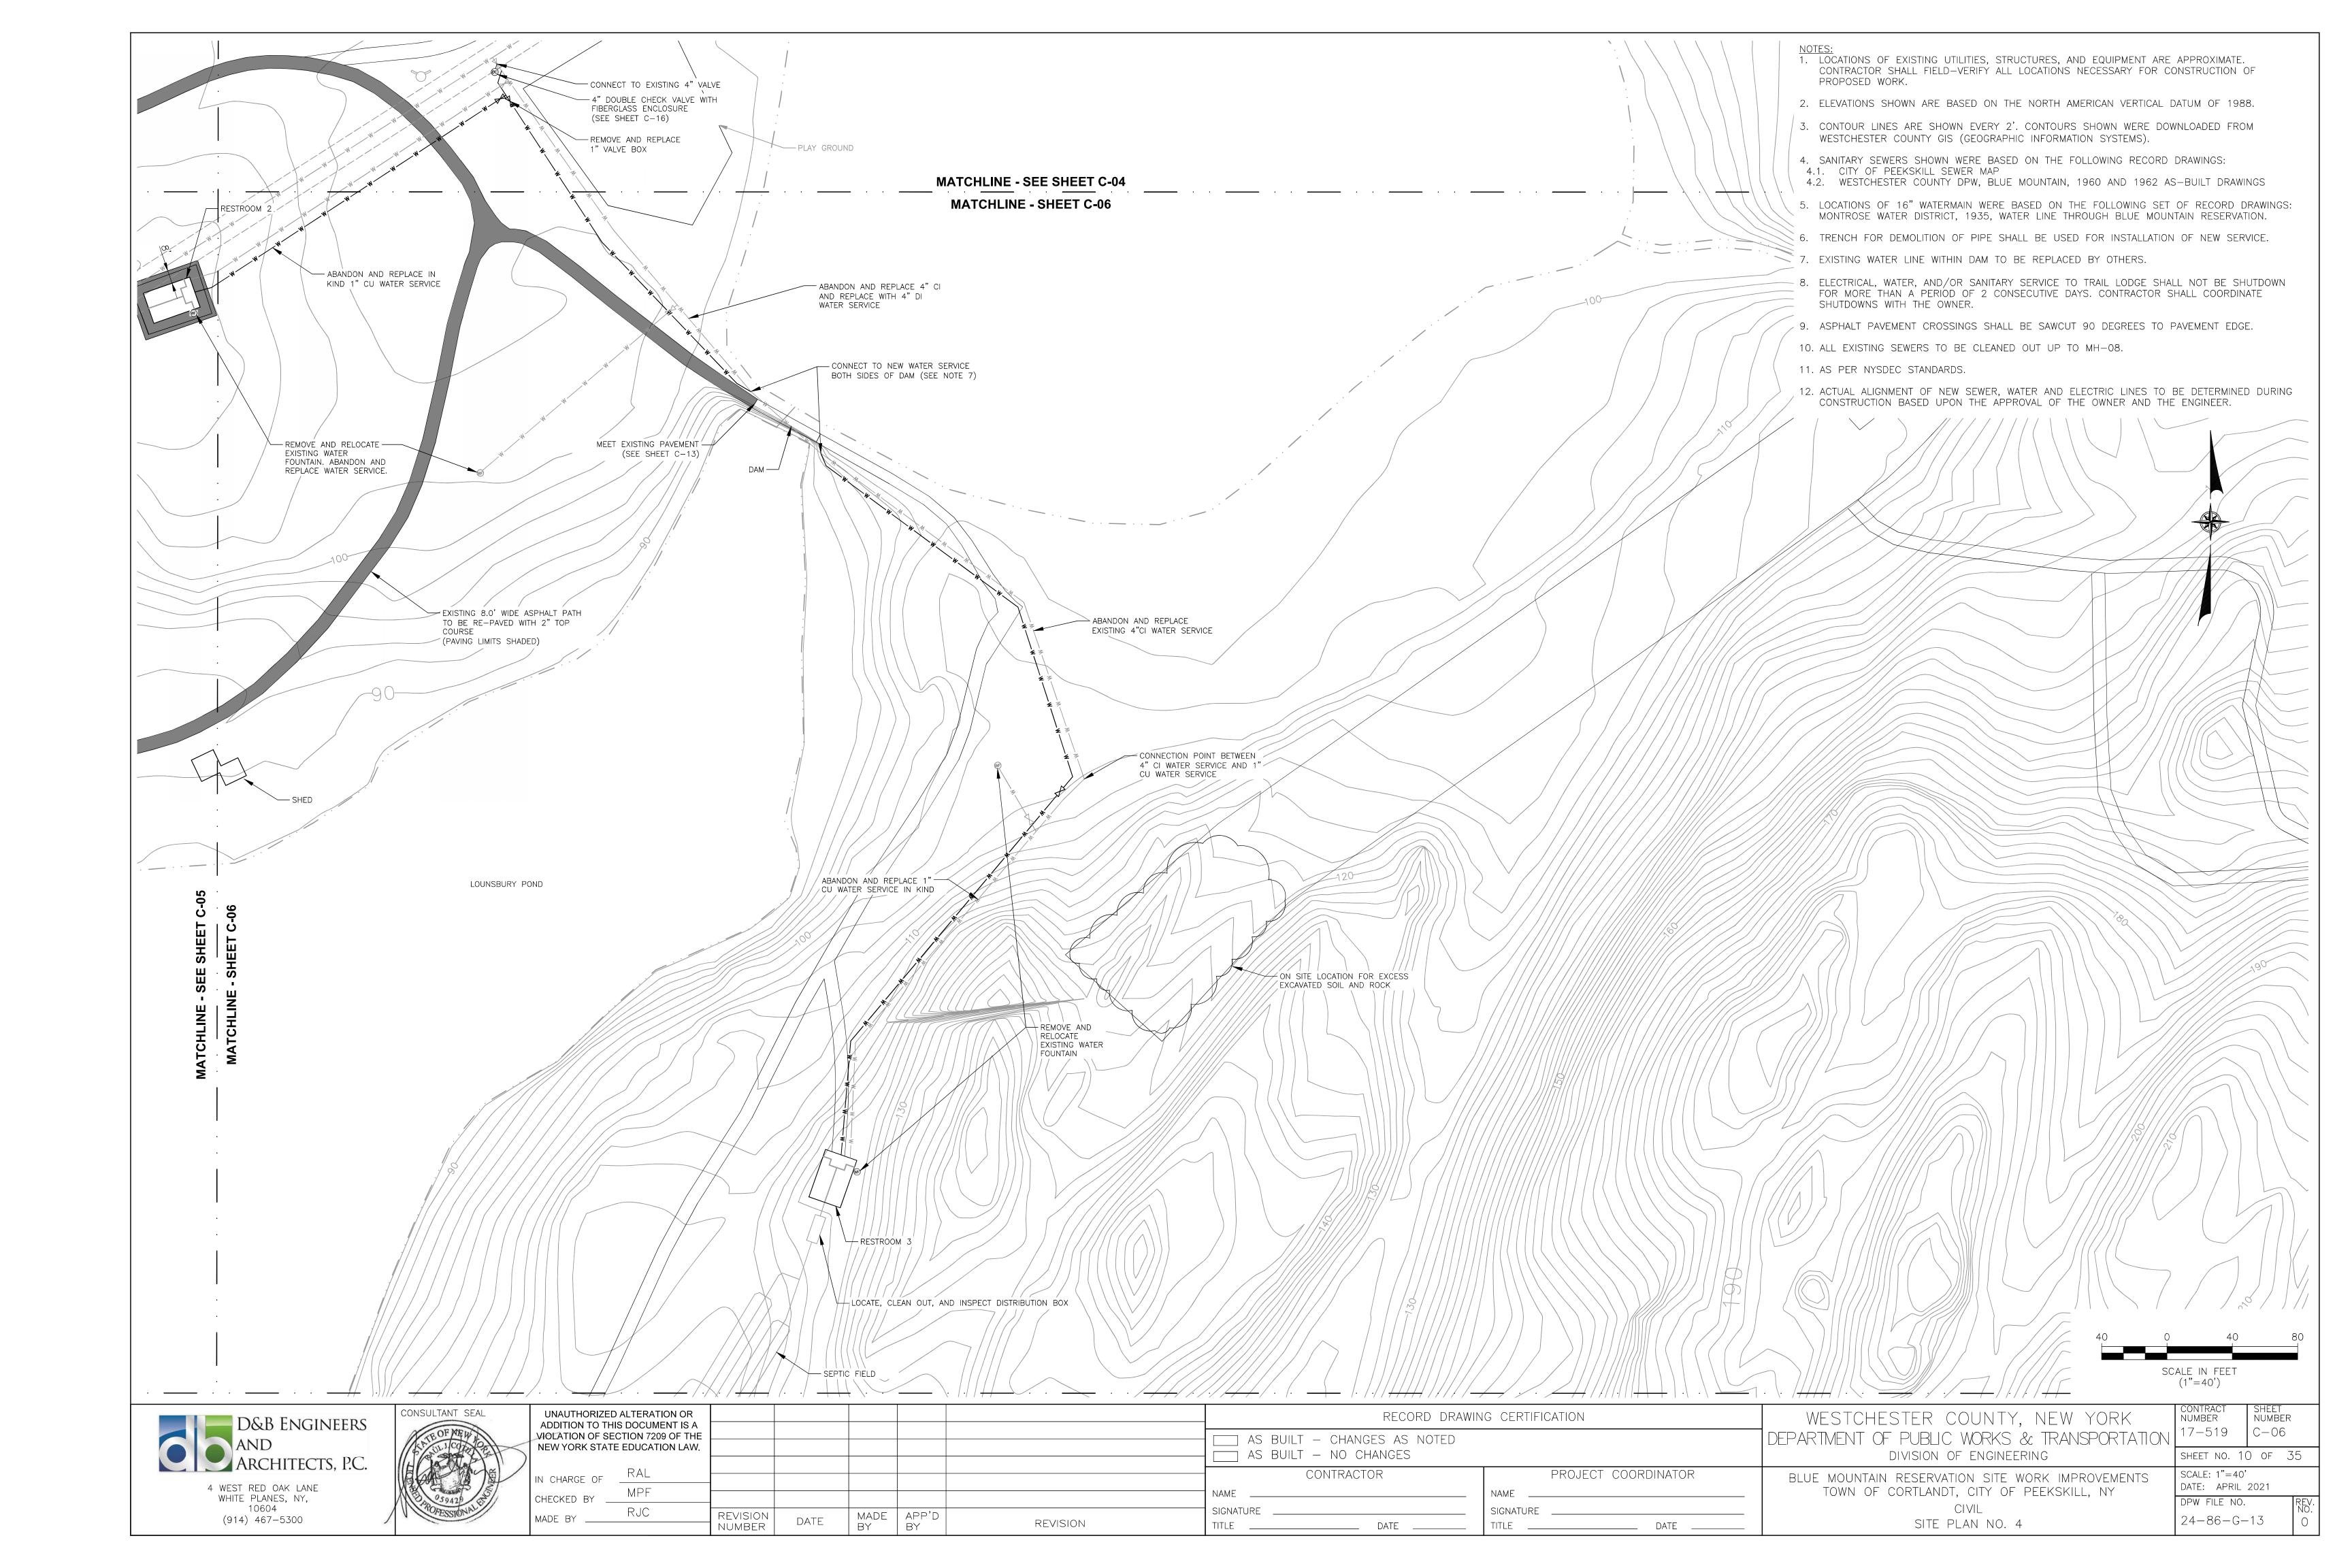

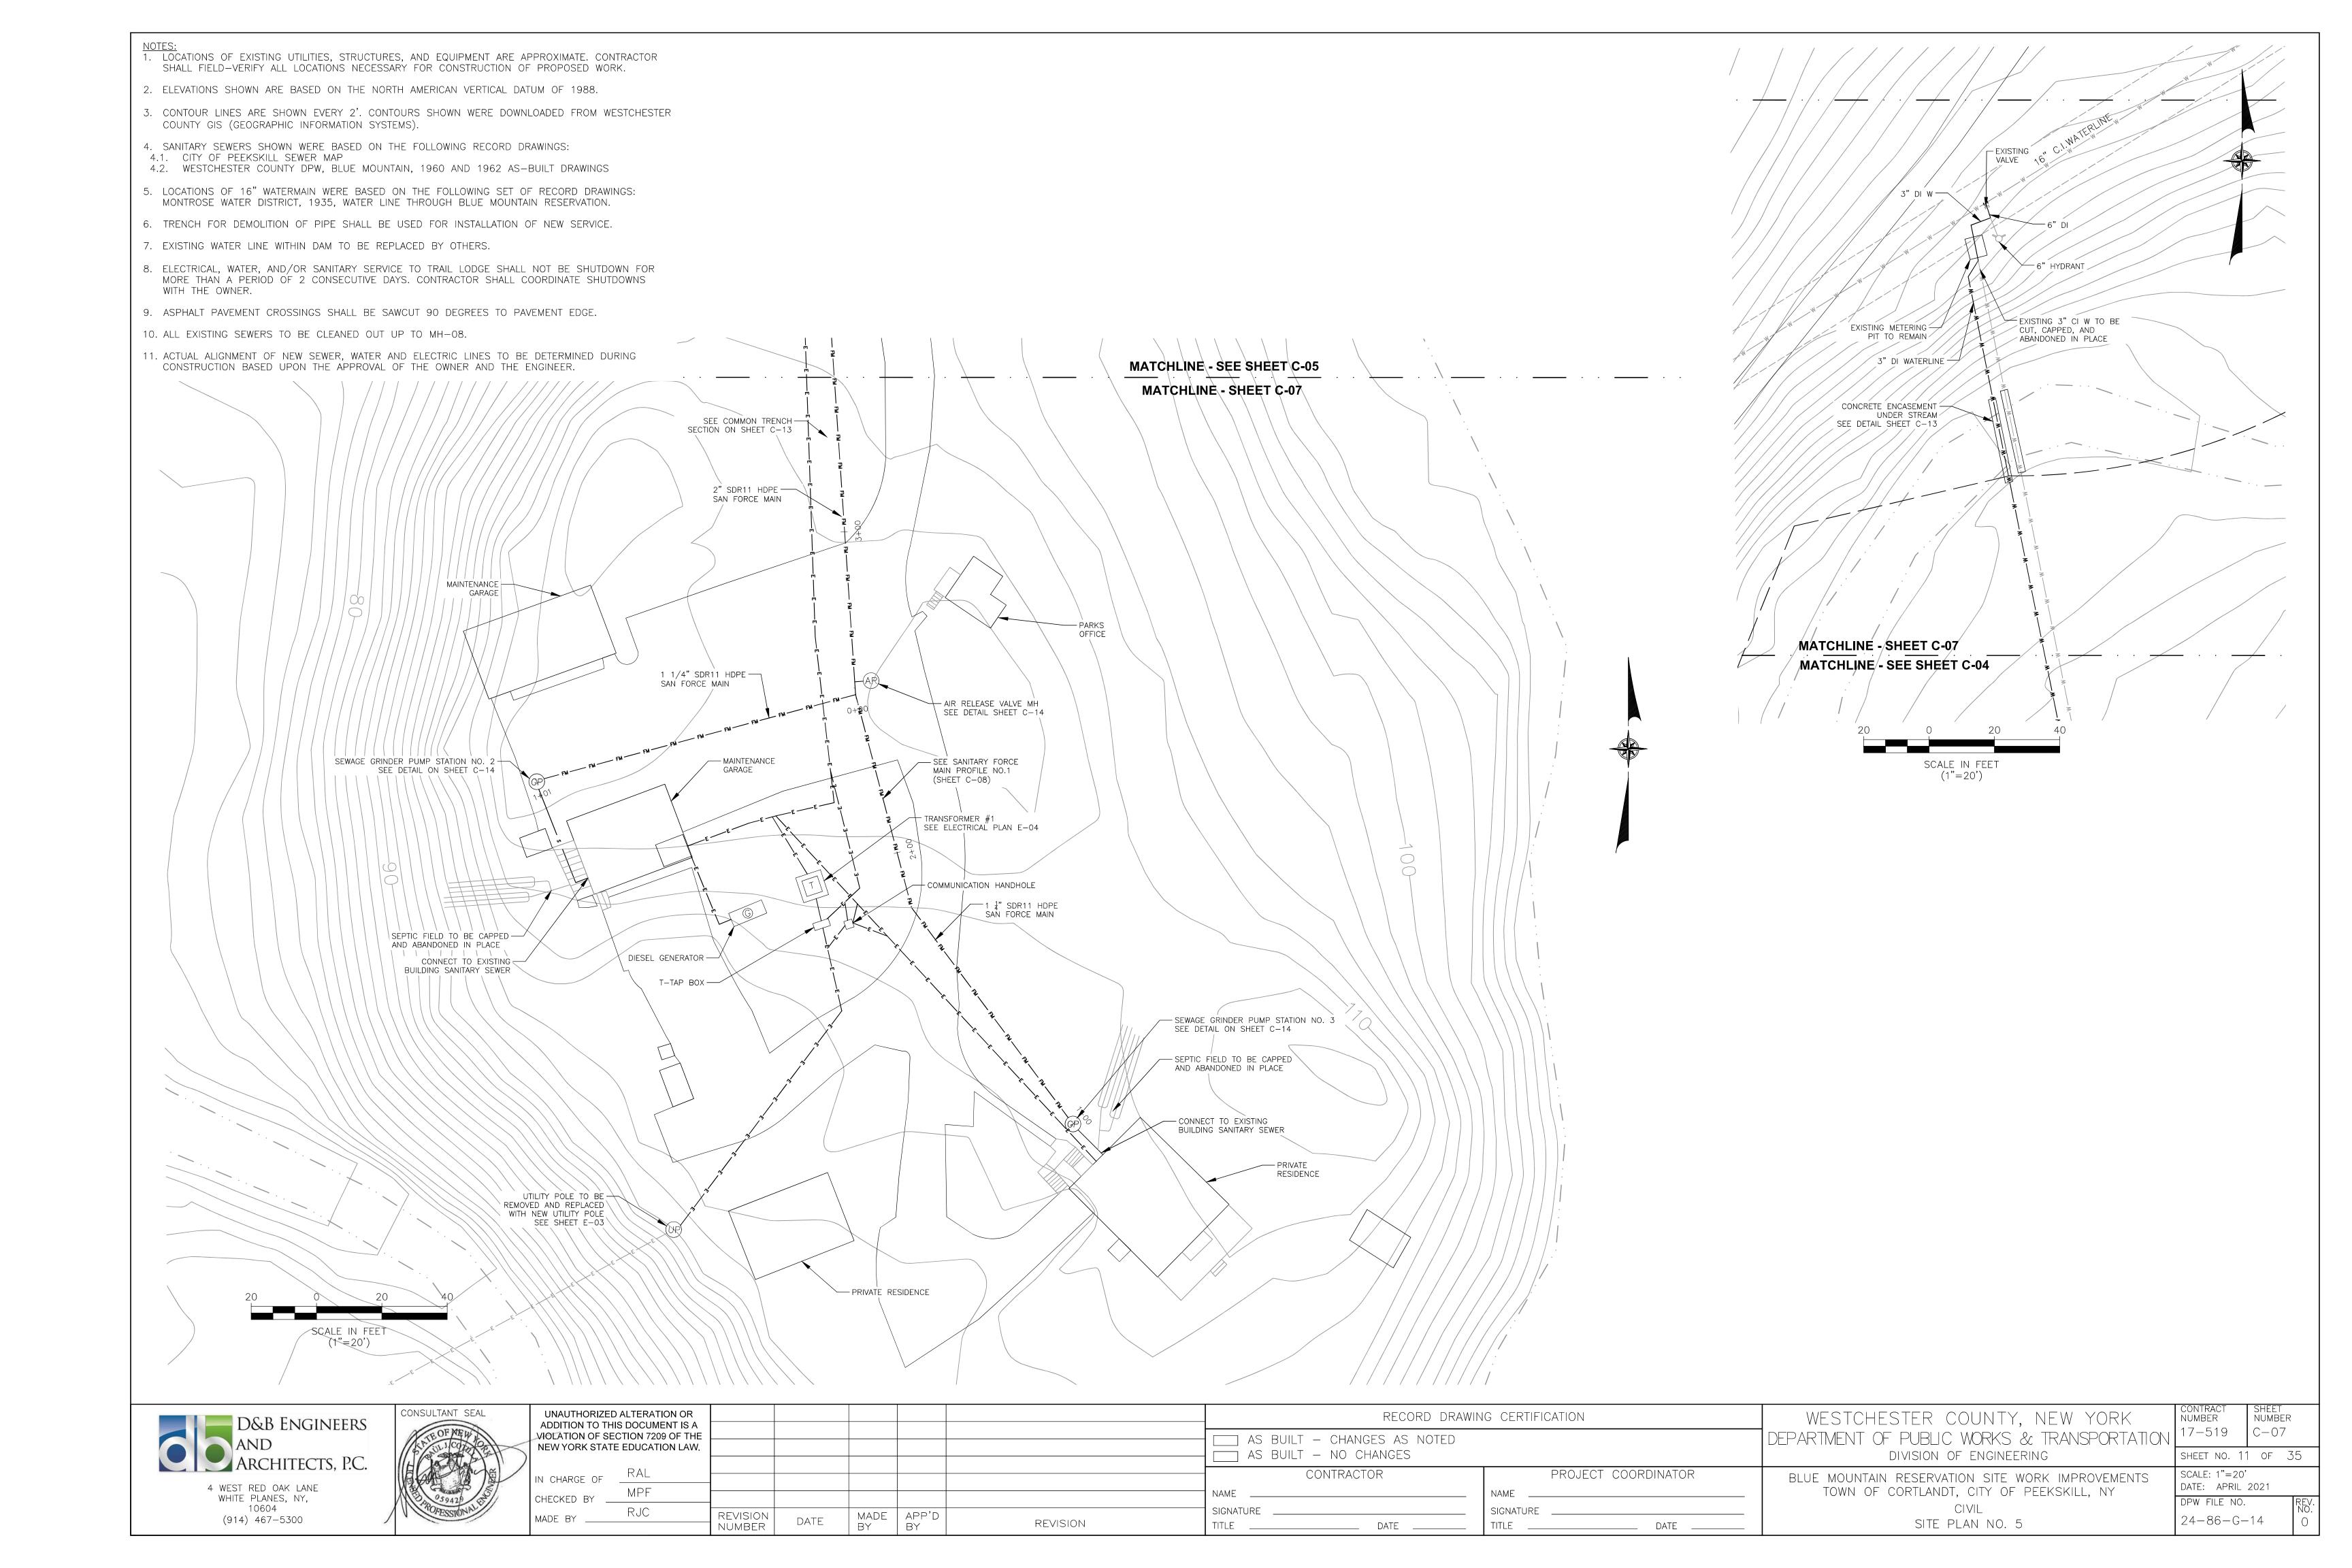

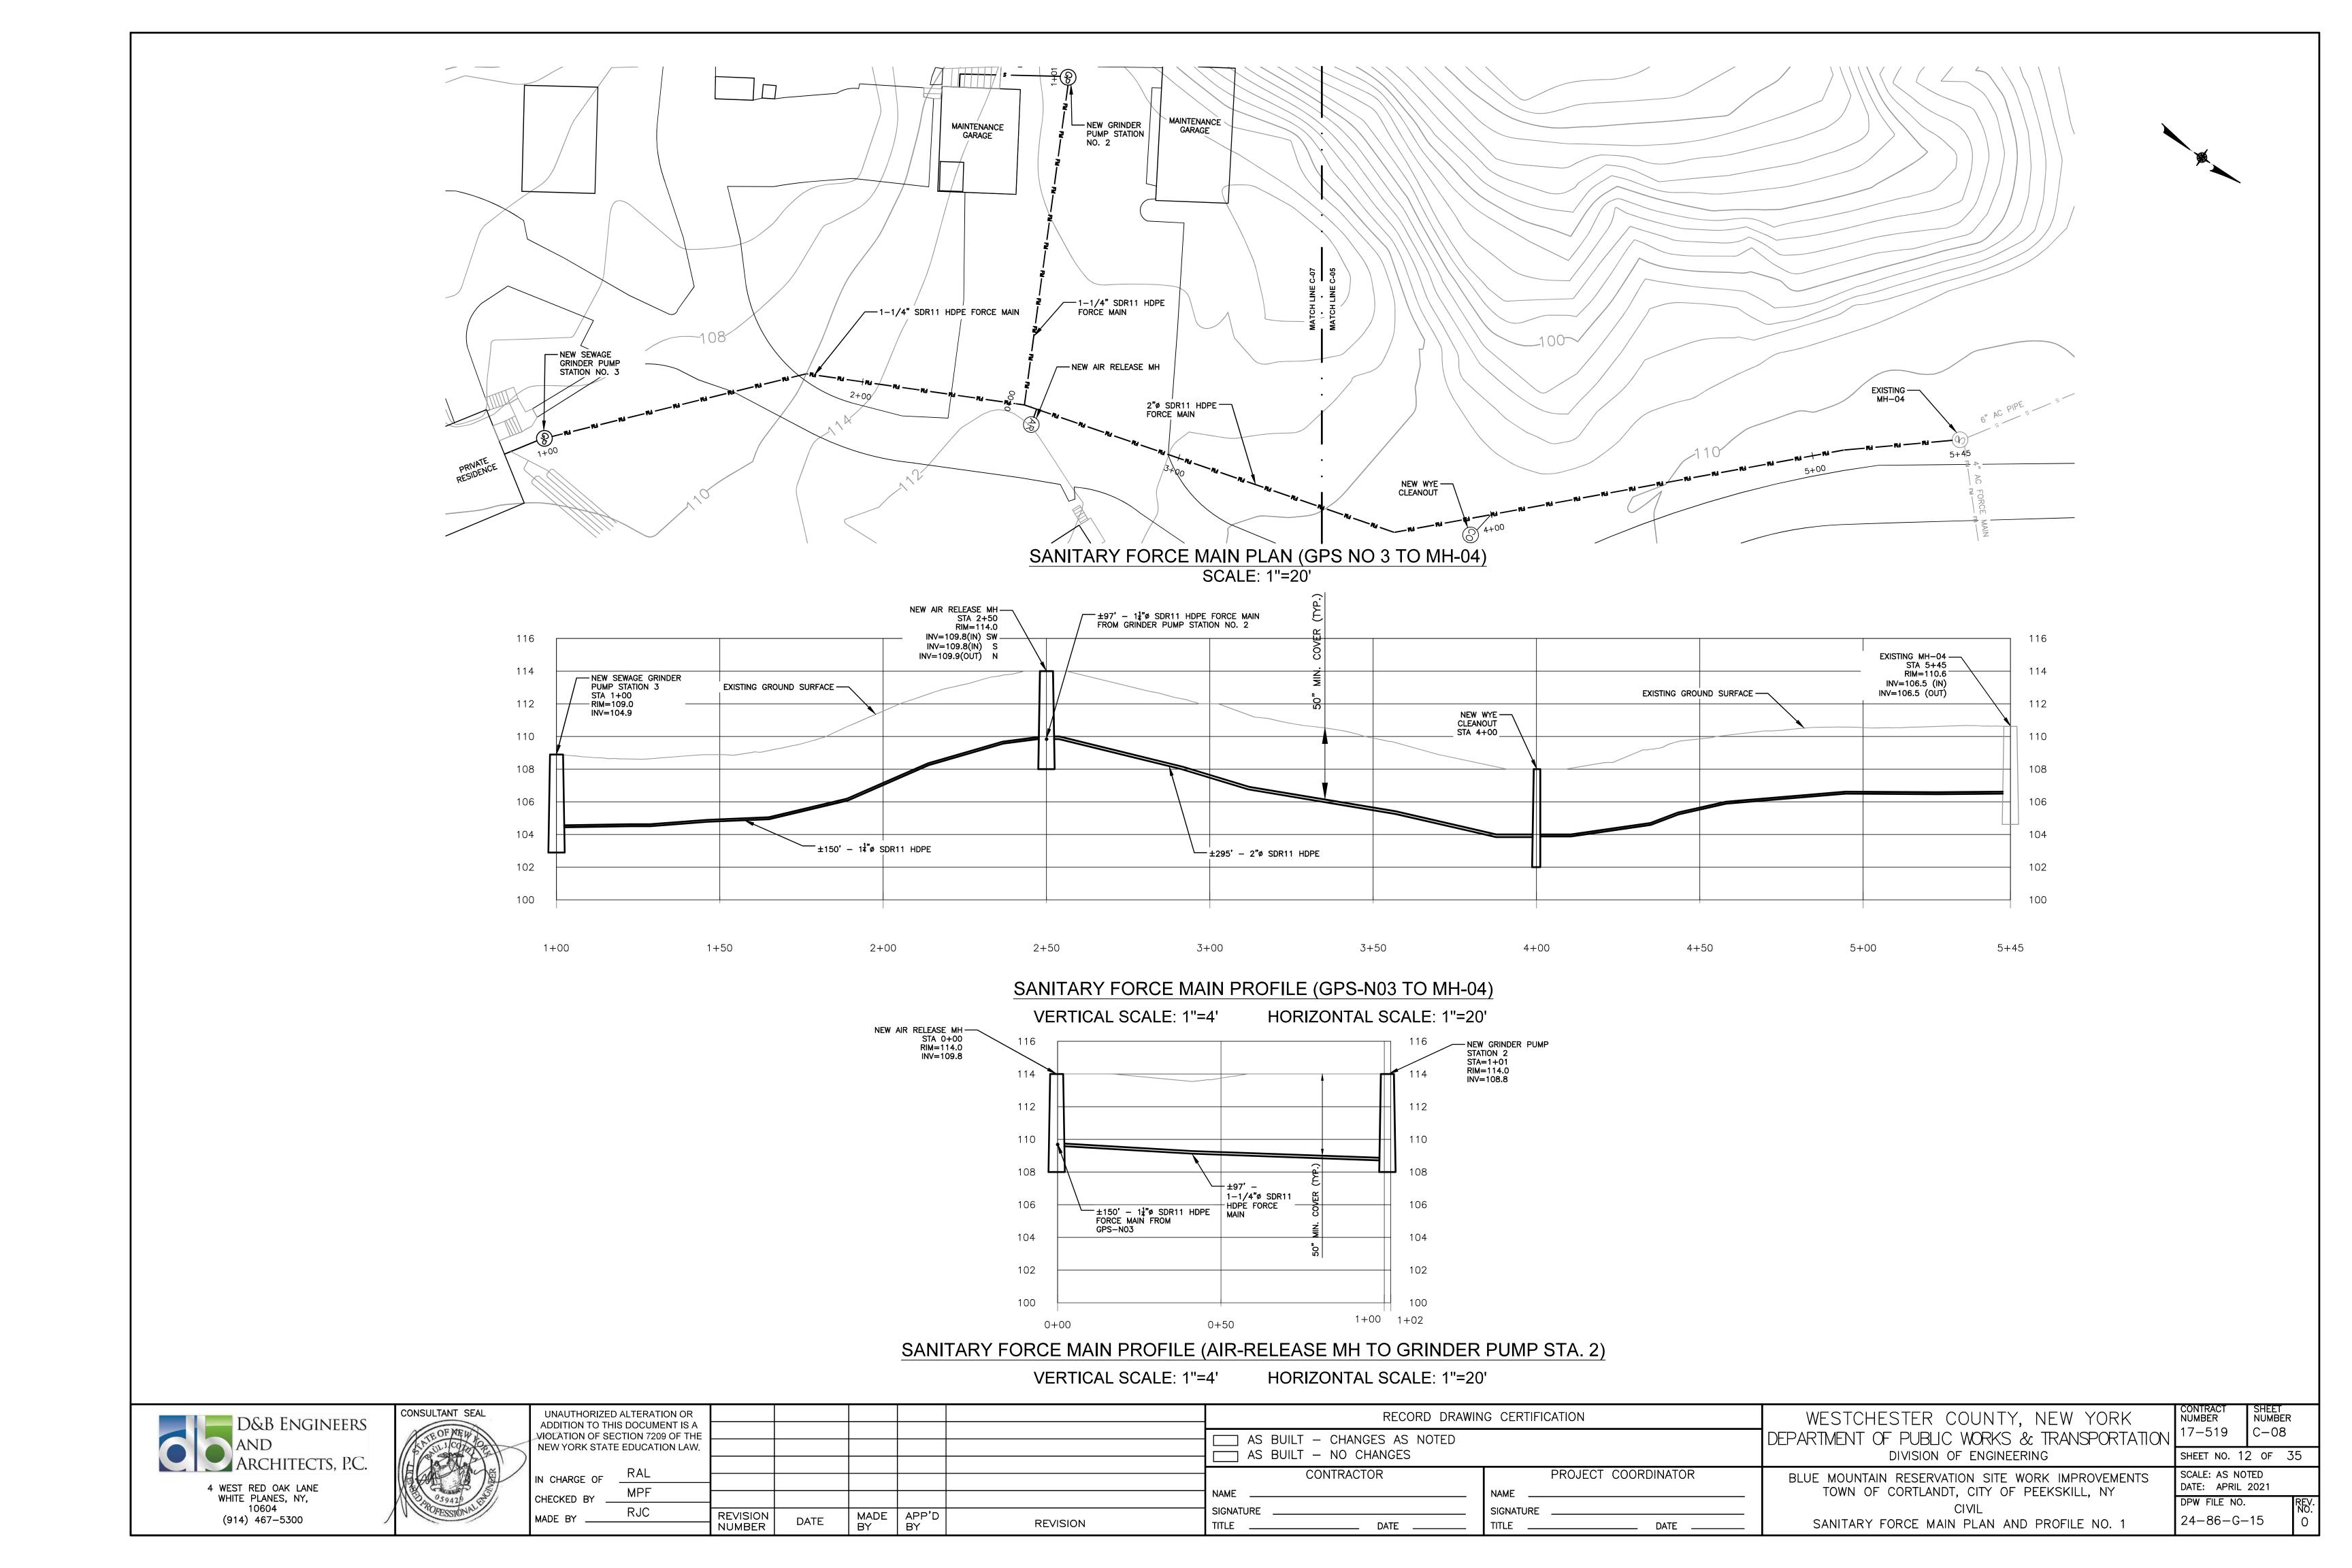

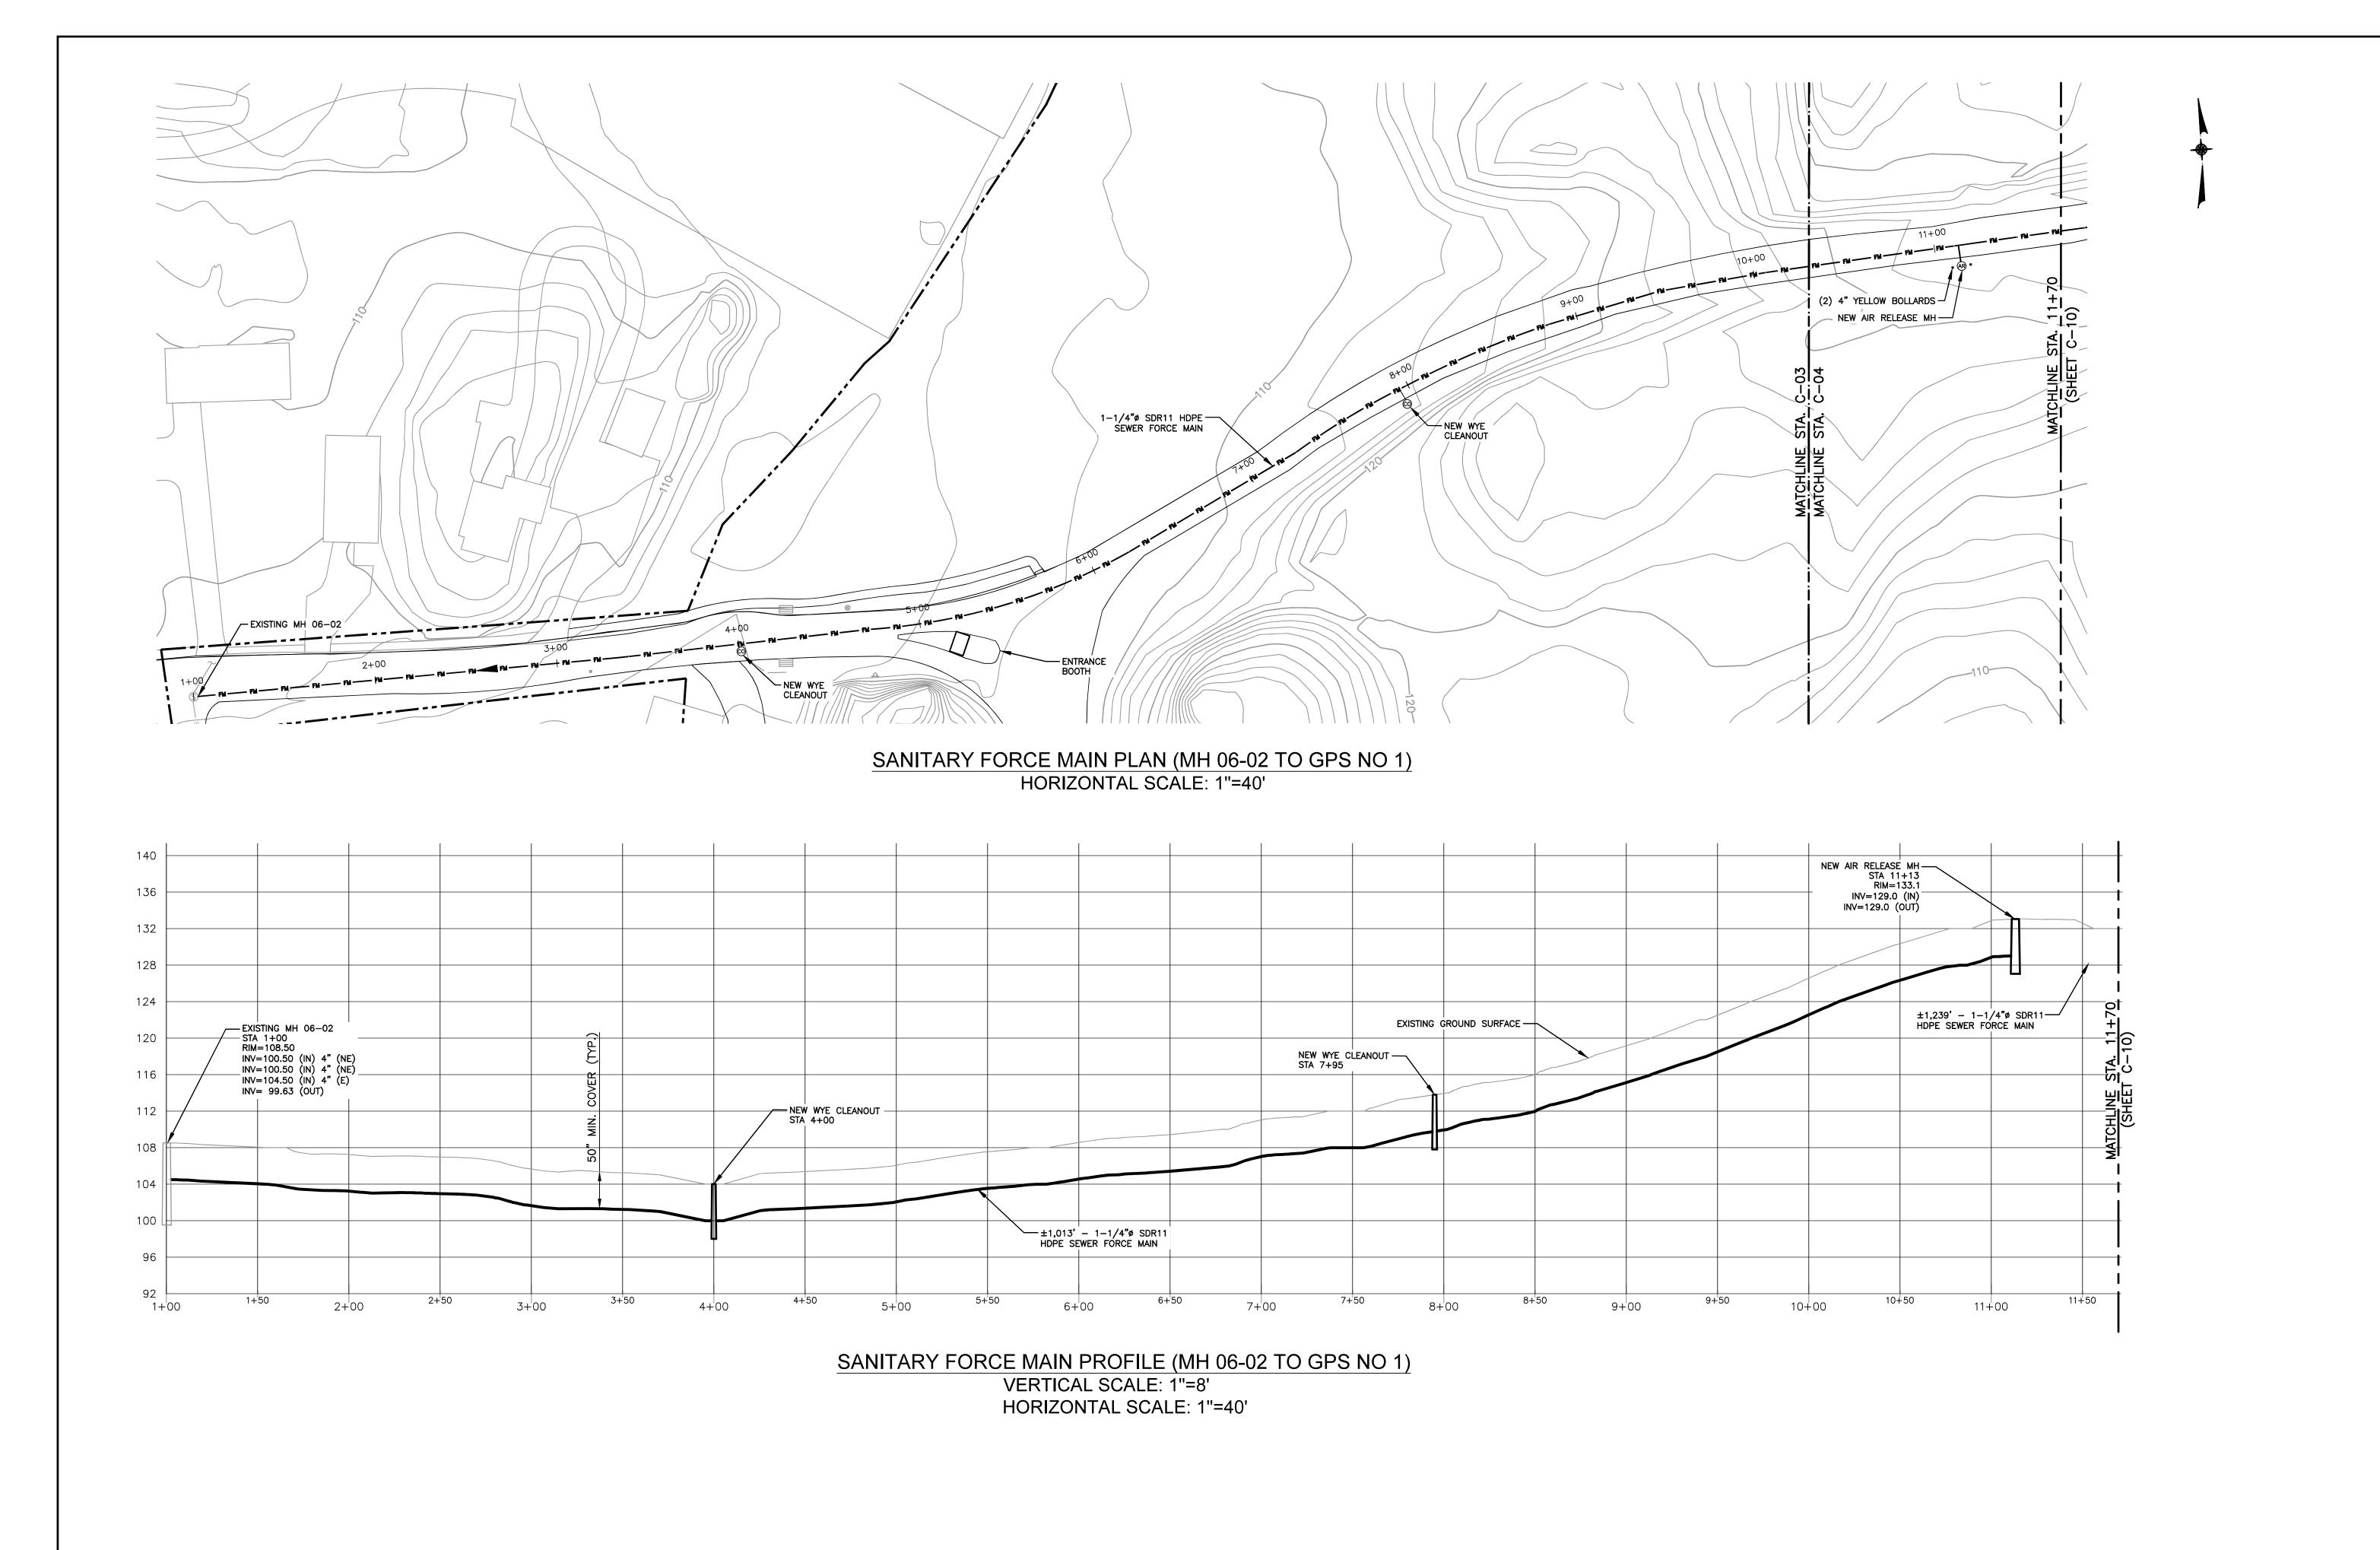



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REVISION

MADE APP'D BY BY

PROJECT COORDINATOR SIGNATURE DATE ____


DEPARTMENT OF PUBLIC WORKS & TRANSPORTATION DIVISION OF ENGINEERING BLUE MOUNTAIN RESERVATION SITE WORK IMPROVEMENTS TOWN OF CORTLANDT, CITY OF PEEKSKILL, NY CIVIL


SANITARY FORCE MAIN PLAN AND PROFILE NO. 2

WESTCHESTER COUNTY, NEW YORK

CONTRACT NUMBER SHEET NUMBER 17-519 C-09 SHEET NO. 13 OF 35 SCALE: AS NOTED DATE: APRIL 2021

DPW FILE NO.

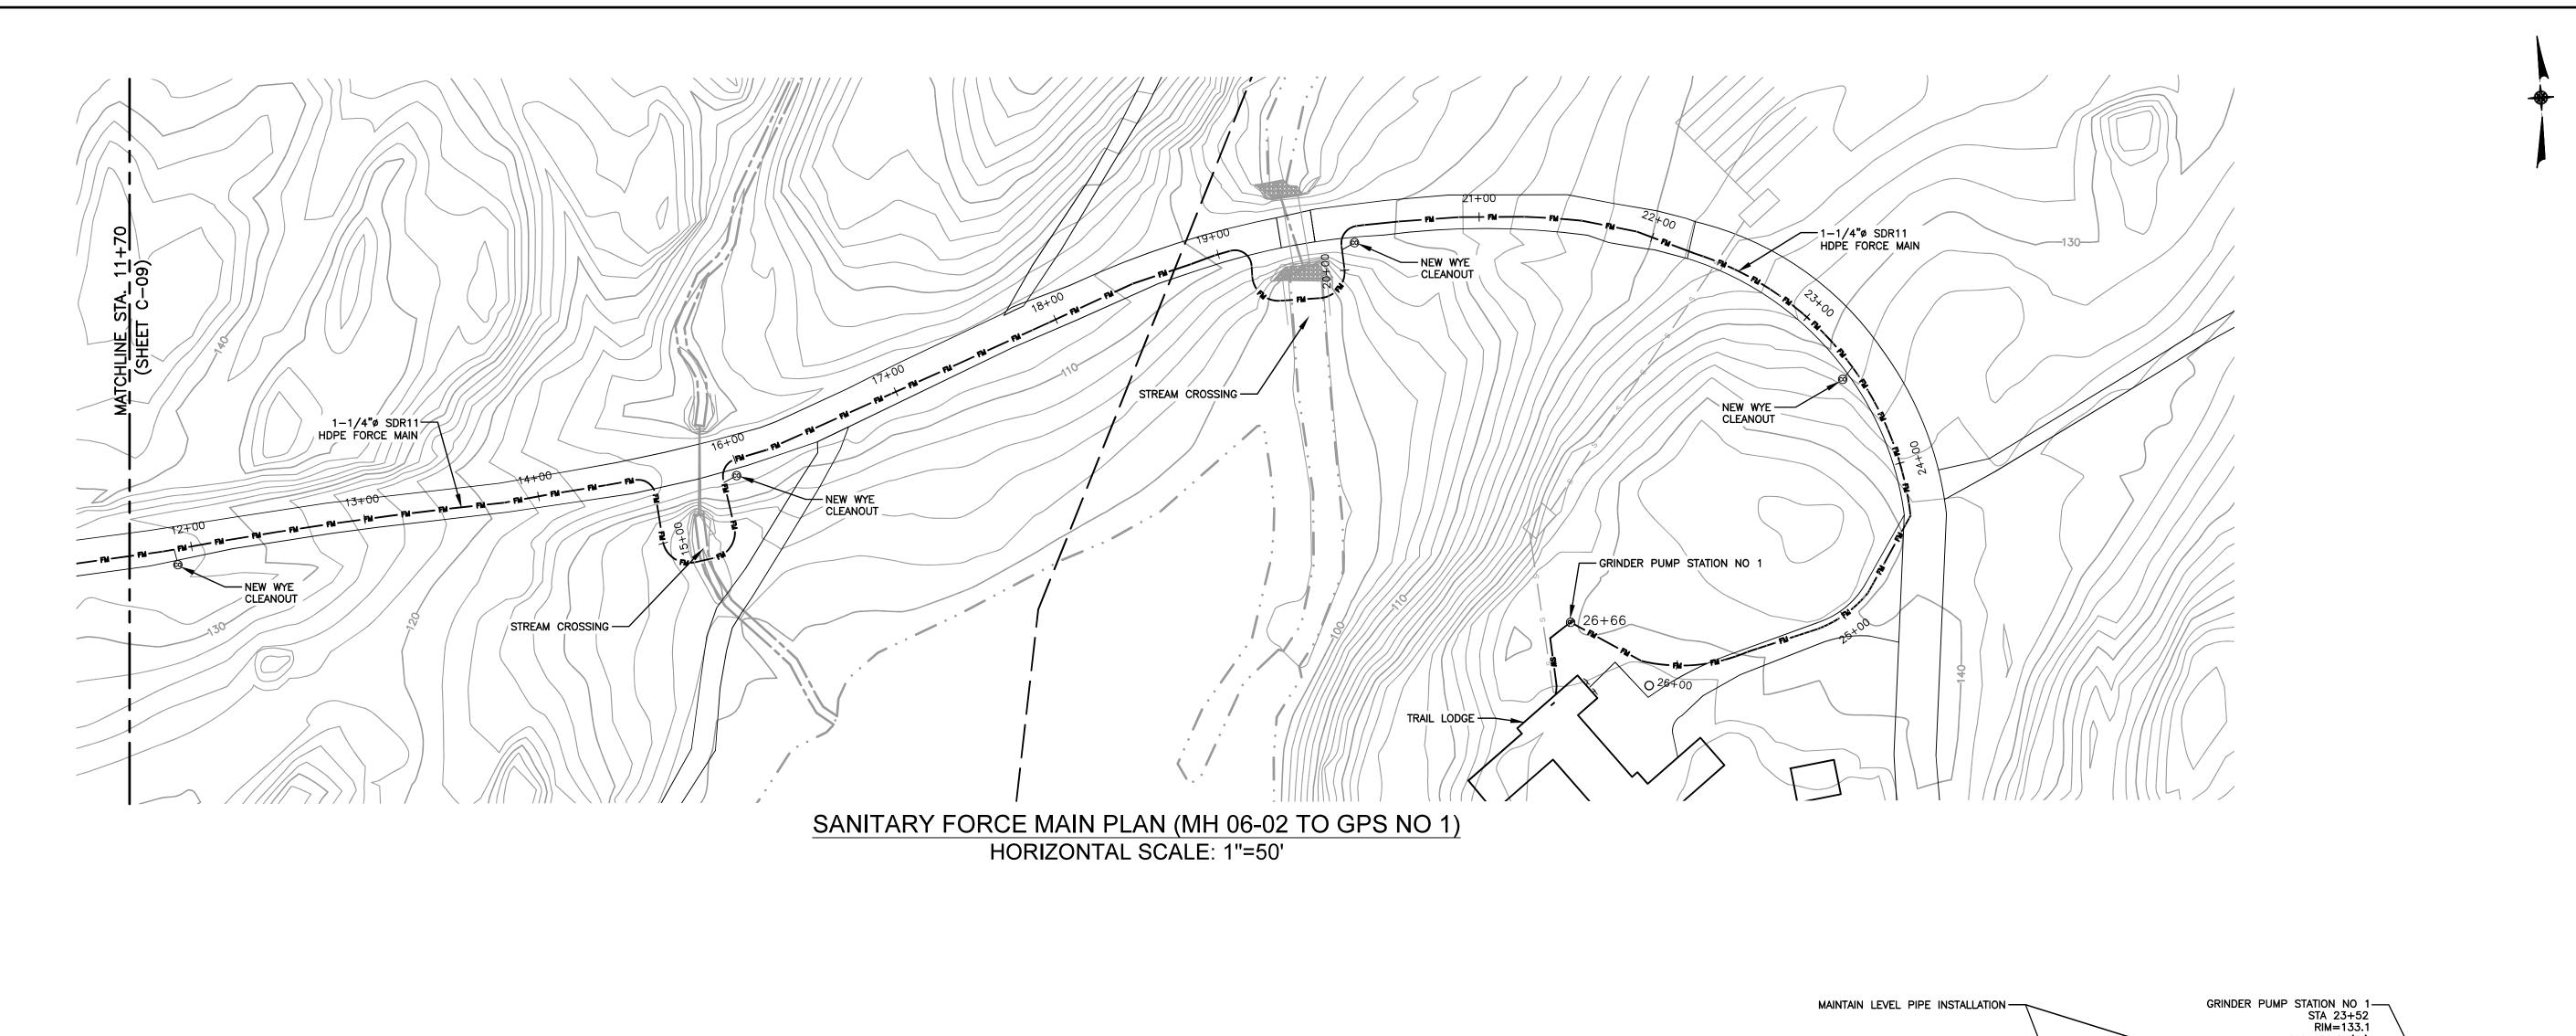

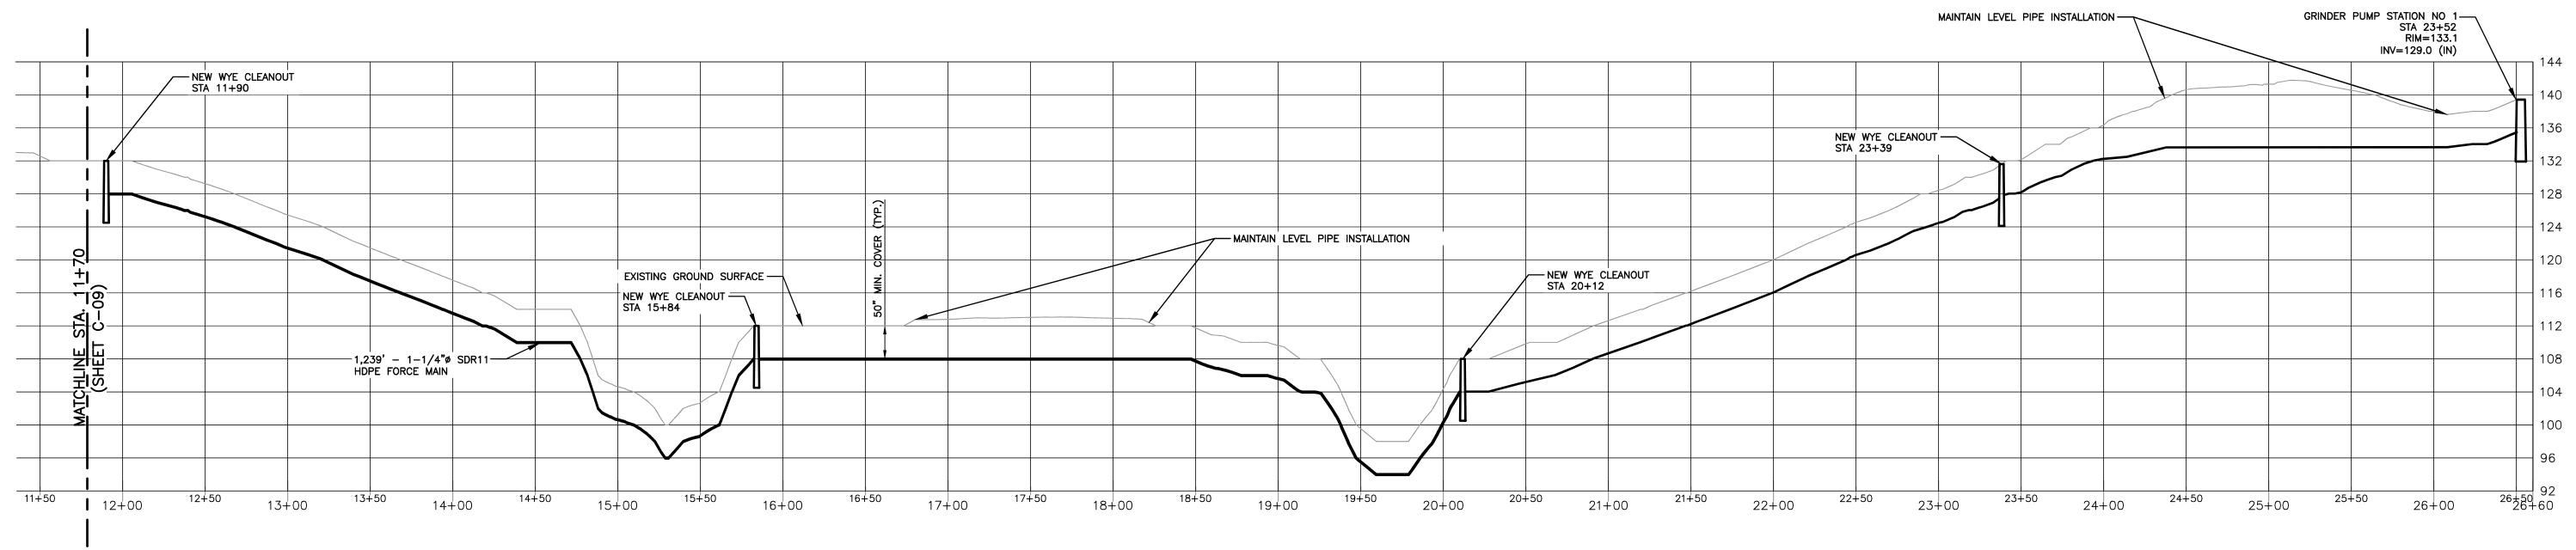

SANITARY FORCE MAIN PROFILE (MH 06-02 TO GPS NO 1) VERTICAL SCALE: 1"=2" HORIZONTAL SCALE: 1"=50"






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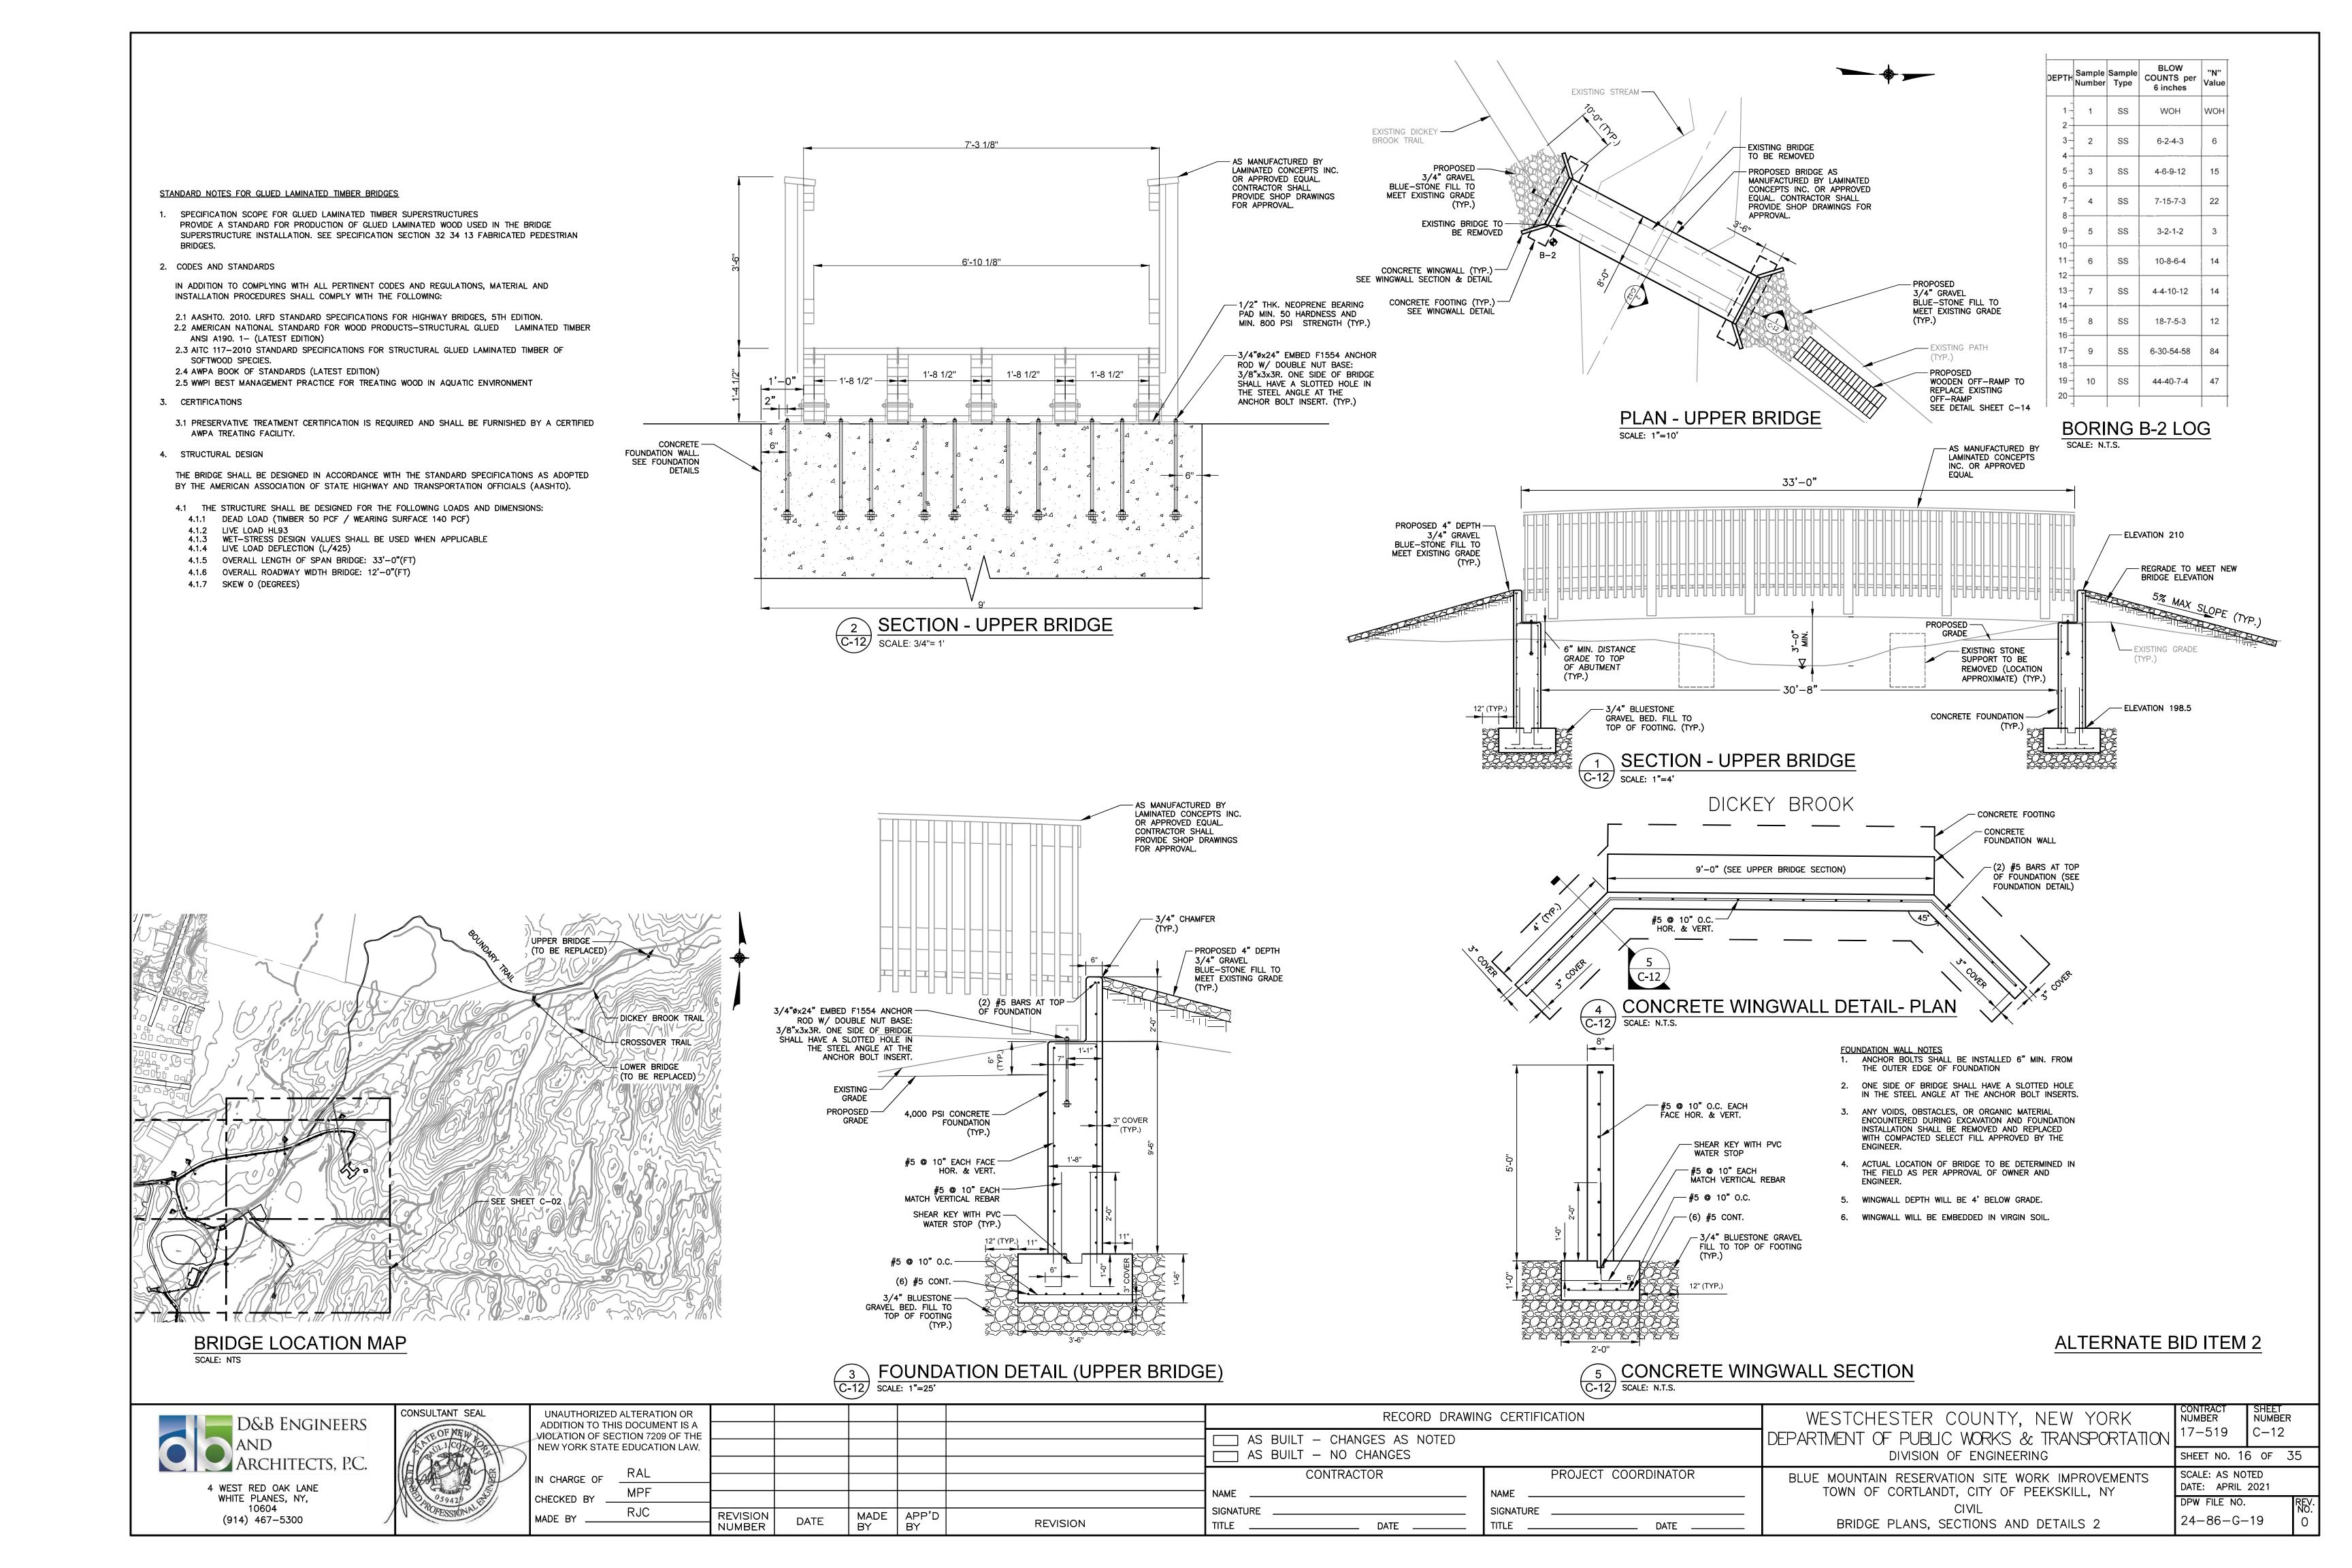
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CONTRACTOR	PROJECT COORDINATOR					
NAME	NAME					
SIGNATURE DATE	SIGNATURE DATE					


DEPARIMENT OF PUBLIC WORKS & TRANSPORTATION OF ENGINEERING
BLUE MOUNTAIN RESERVATION SITE WORK IMPROVEMENTS TOWN OF CORTLANDT, CITY OF PEEKSKILL, NY
CIVIL
SANITARY FORCE MAIN PLAN AND PROFILE NO.3

WESTCHESTER COUNTY, NEW YORK

1	CONTRACT NUMBER 17-519	SHEET NUMBER C-10			
	SHEET NO. 14	4 OF 35			
	SCALE: AS NO DATE: APRIL				
	DPW FILE NO.	REV.			




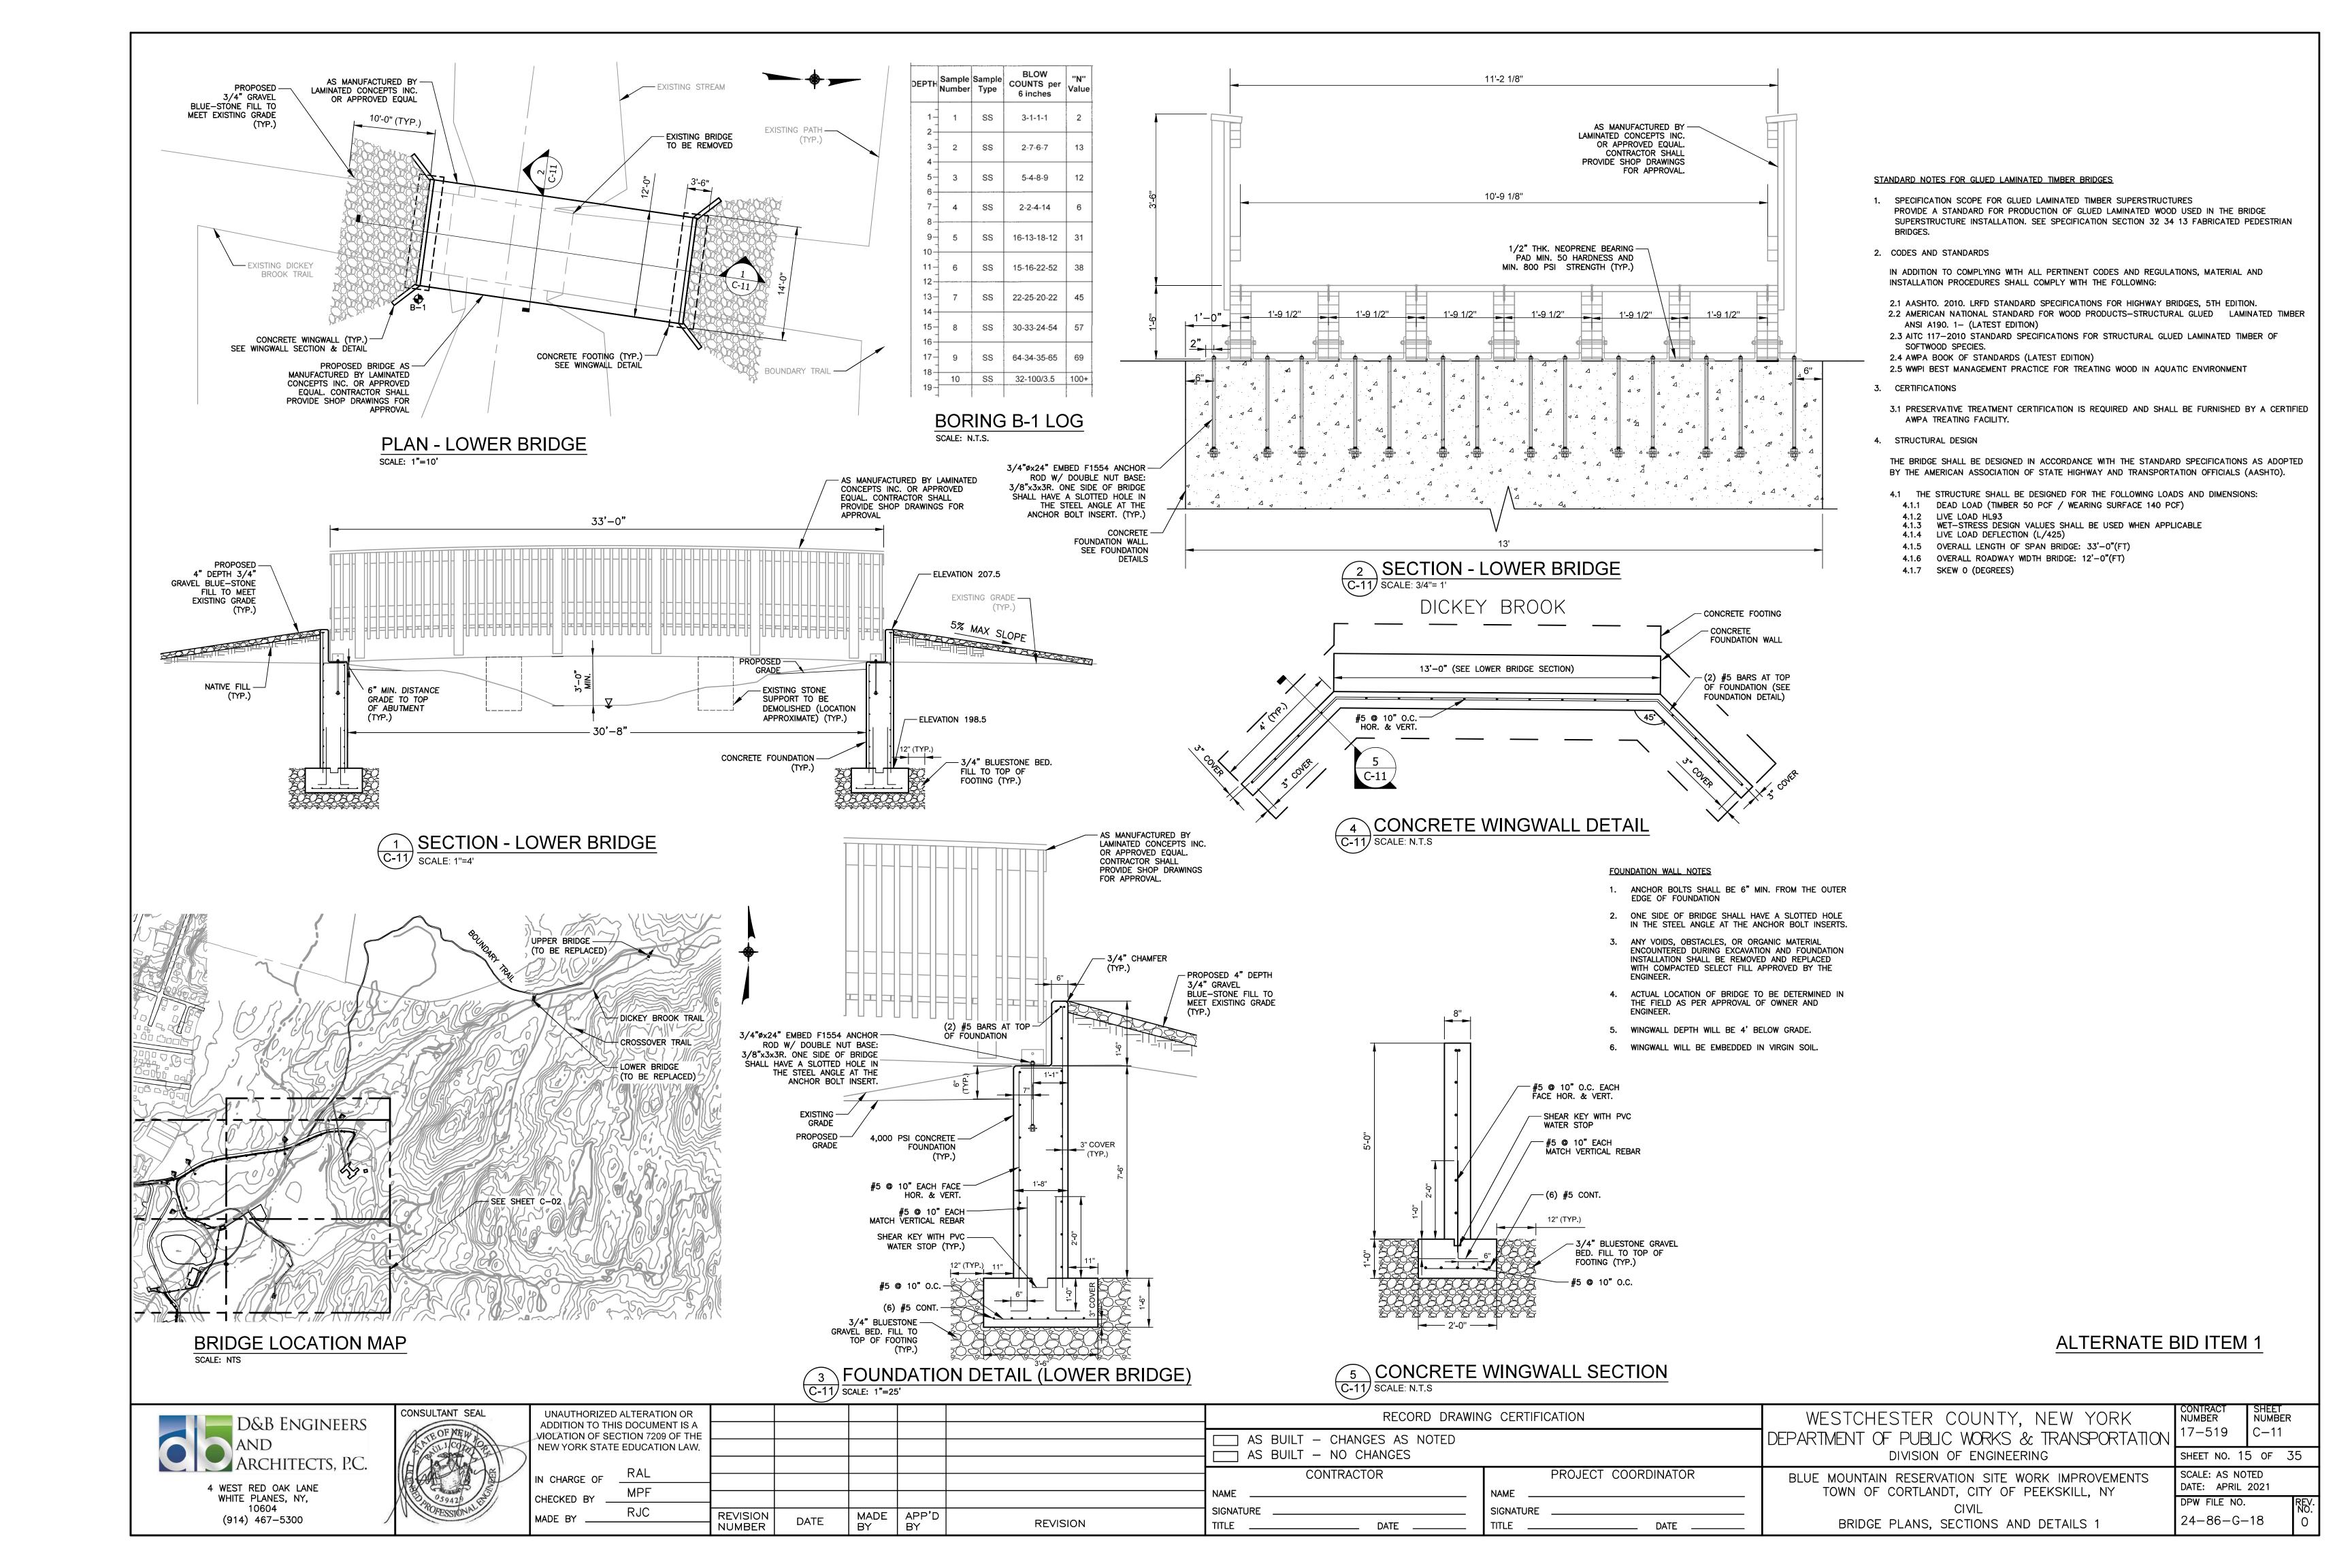


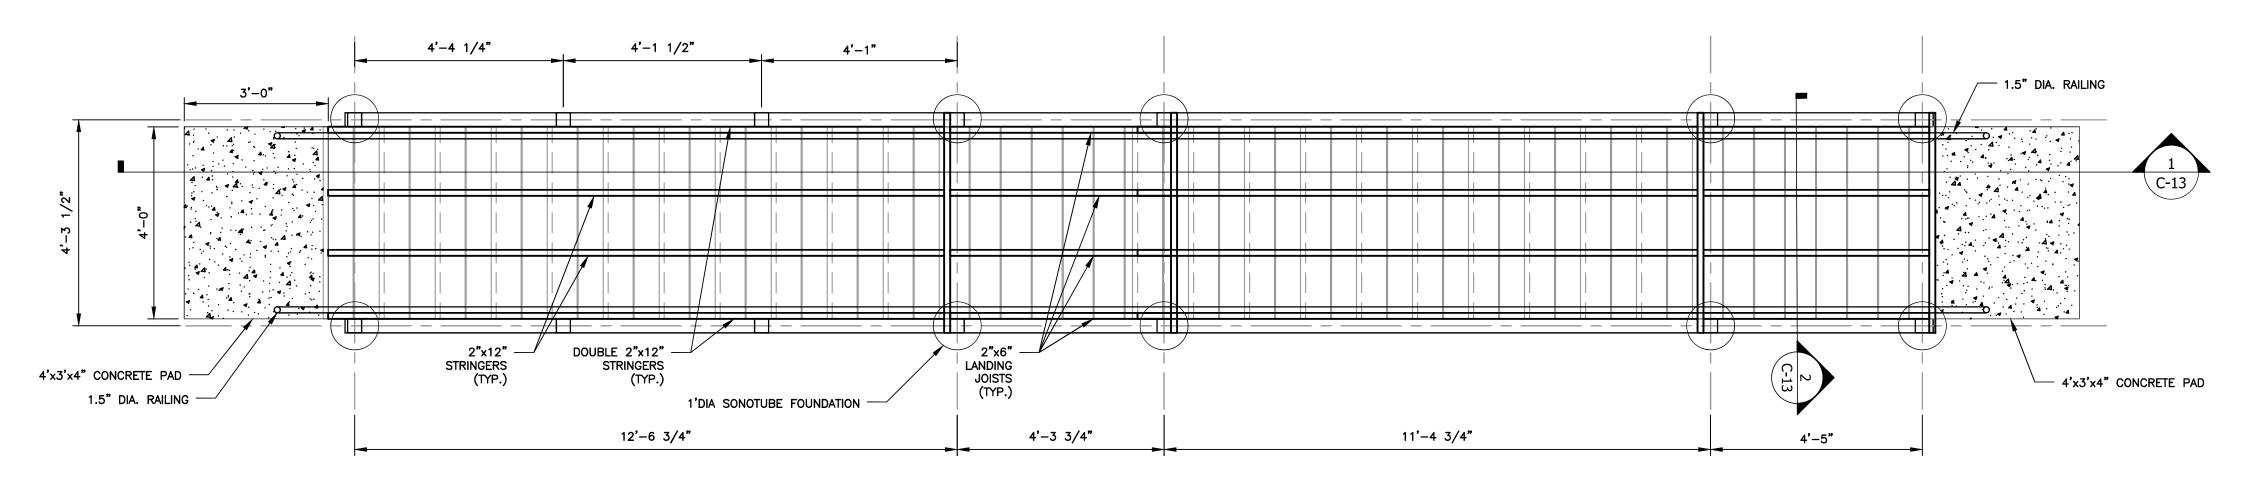

TIMBER STAIRCASE PLAN

SCALE: 1/2" = 1'-0"

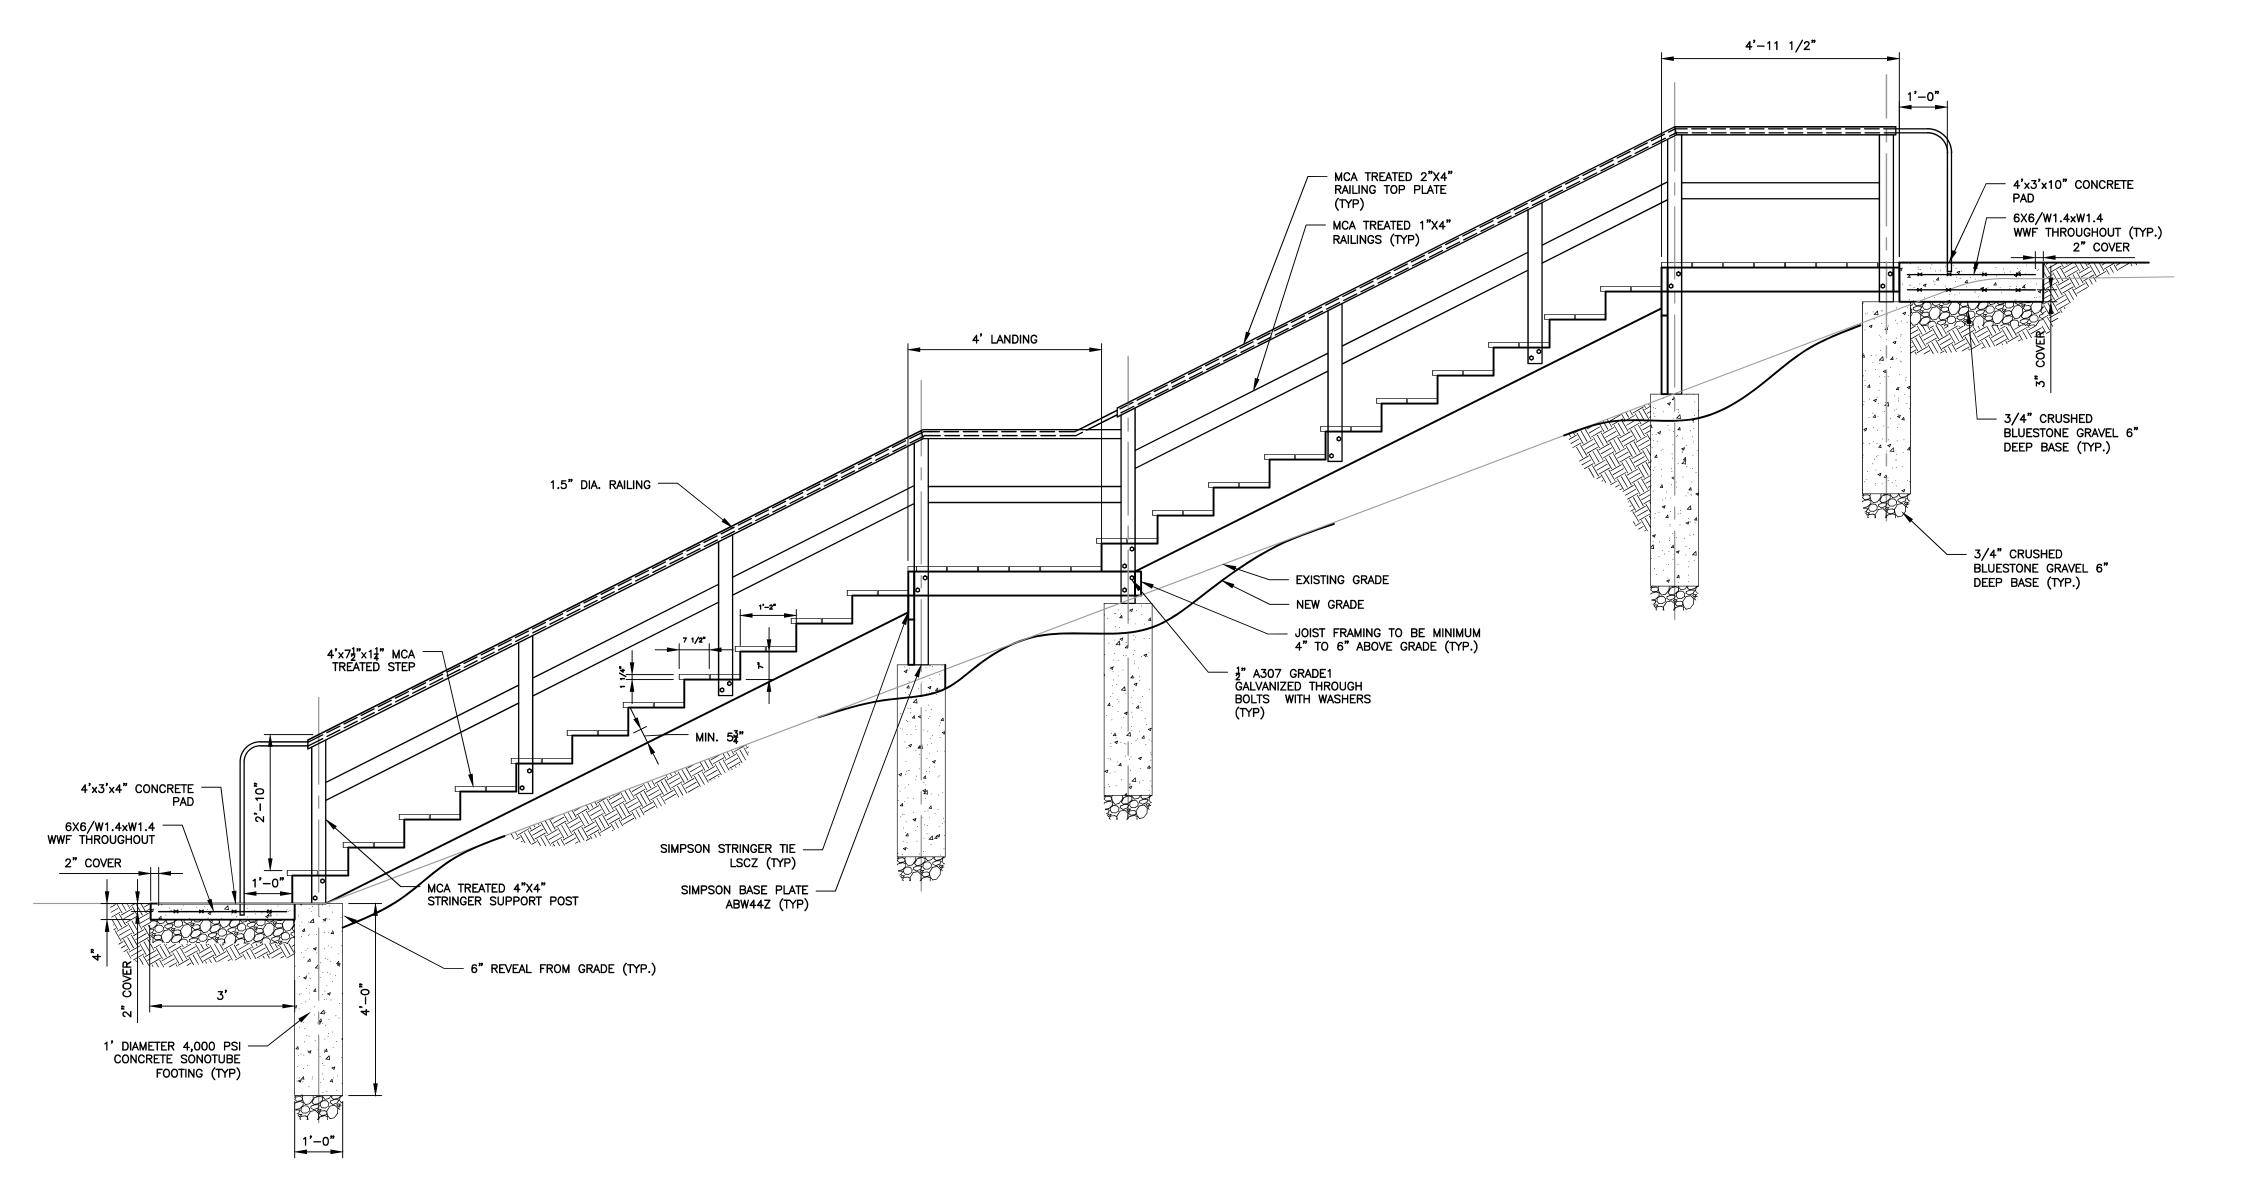

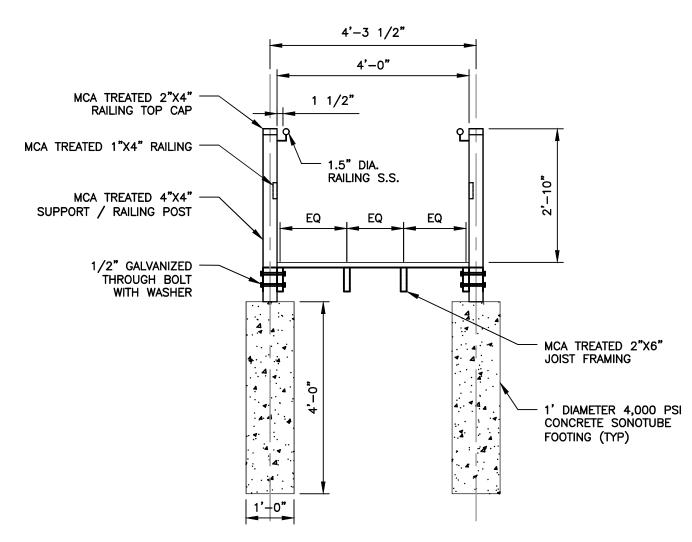

2 TIMBER STAIRCASE SECTION C-13 SCALE: 1/2" = 1'-0"

TIMBER NOTES:

1. ALL TIMBERS SHALL BE SOUTHERN PINE OR COASTAL DOUGLAS FIR. TIMBER SHALL BE PRESSURE TREATED WITH 0.31 POUNDS PER CUBIC FOOT OF MICRONIZED COPPER AZOLE (MCA), 0.60 POUNDS PER CUBIC FOOT OF ALKALINE COPPER QUATERNARY (ACQ), OR APPROVED EQUAL BY THE ENGINEER IN ACCORDANCE WITH AMERICAN WOOD—PRESERVER'S ASSOCIATION (AWPA) STANDARDS FOR GROUND CONTACT USAGE CODE "UC4B".

TIMBER STAIRCASE SECTION C-13 SCALE: 1/2" = 1'-0"

REVISION

ALTERNATE BID ITEM 3





	UNAUTHORIZED A						
	ADDITION TO THIS VIOLATION OF SEC						
1	NEW YORK STATE						
		RAL					
	IN CHARGE OF .						
	CHECKED BY	MPF					
	MADE BY	RJC	REVISION	DATE	MADE	APP'D	<u> </u>
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RECORD DRAWING CERTIFICATION						
AS BUILT — CHANGES AS NOTED AS BUILT — NO CHANGES						
CONTRACTOR	PROJECT COORDINATOR					
NAME	NAME					
SIGNATURE	SIGNATURE					

DEPARTMENT OF PUBLIC WORKS & TRANSPORTATION DIVISION OF ENGINEERING

BLUE MOUNTAIN RESERVATION SITE WORK IMPROVEMENTS TOWN OF CORTLANDT, CITY OF PEEKSKILL, NY

CIVIL

TIMBER STAIRCASE PLAN AND SECTIONS


WESTCHESTER COUNTY, NEW YORK


CONTRACT NUMBER 17-519 C-13

SHEET NO. 17 OF 35

SCALE: 1/2" = 1'-0"
DATE: APRIL 2021


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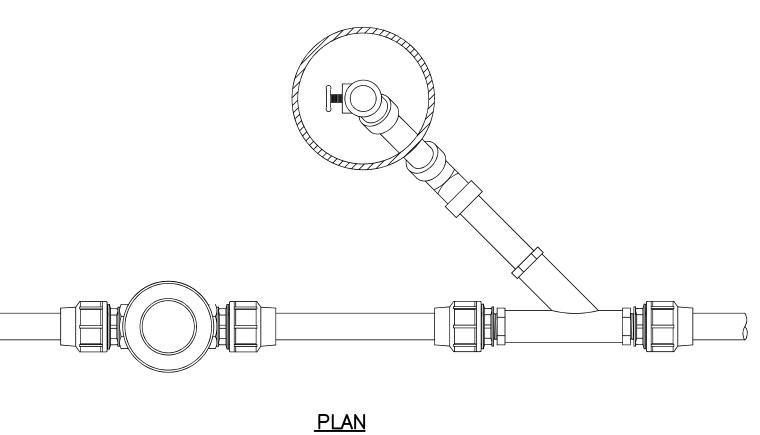


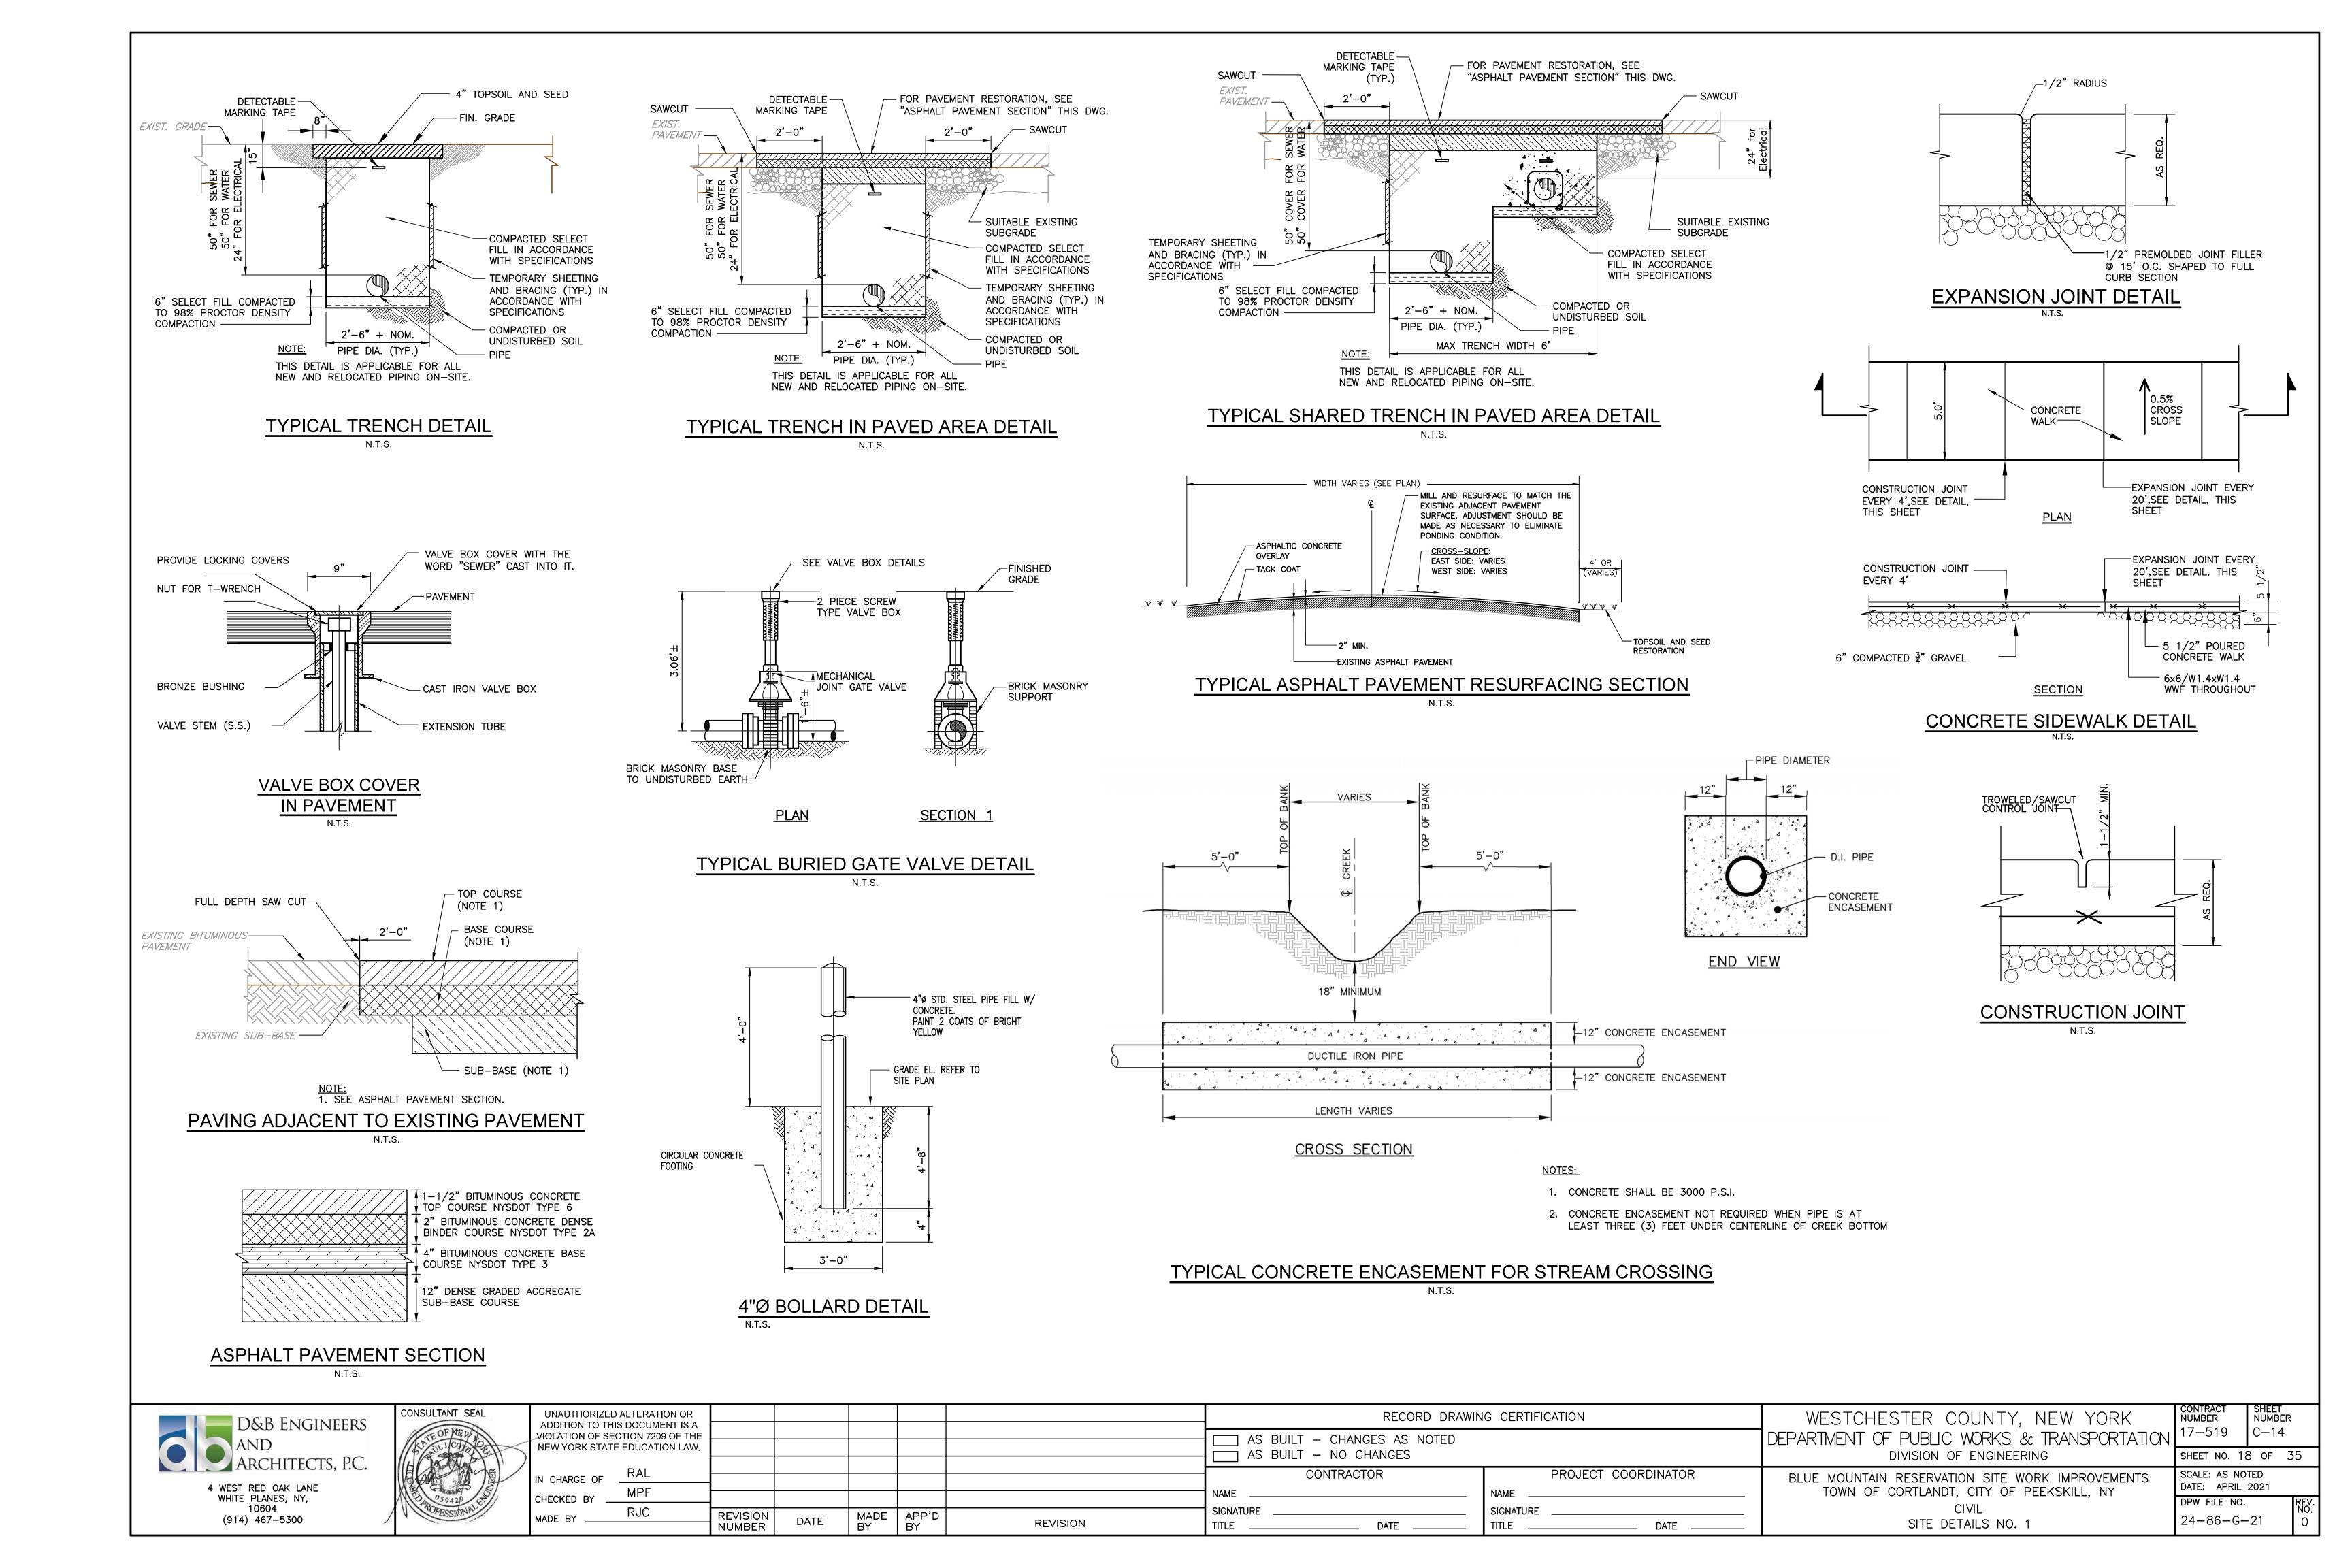
WOODEN RAMP NEAR UPPER BRIDGE DETAIL SCALE: 1"=1"
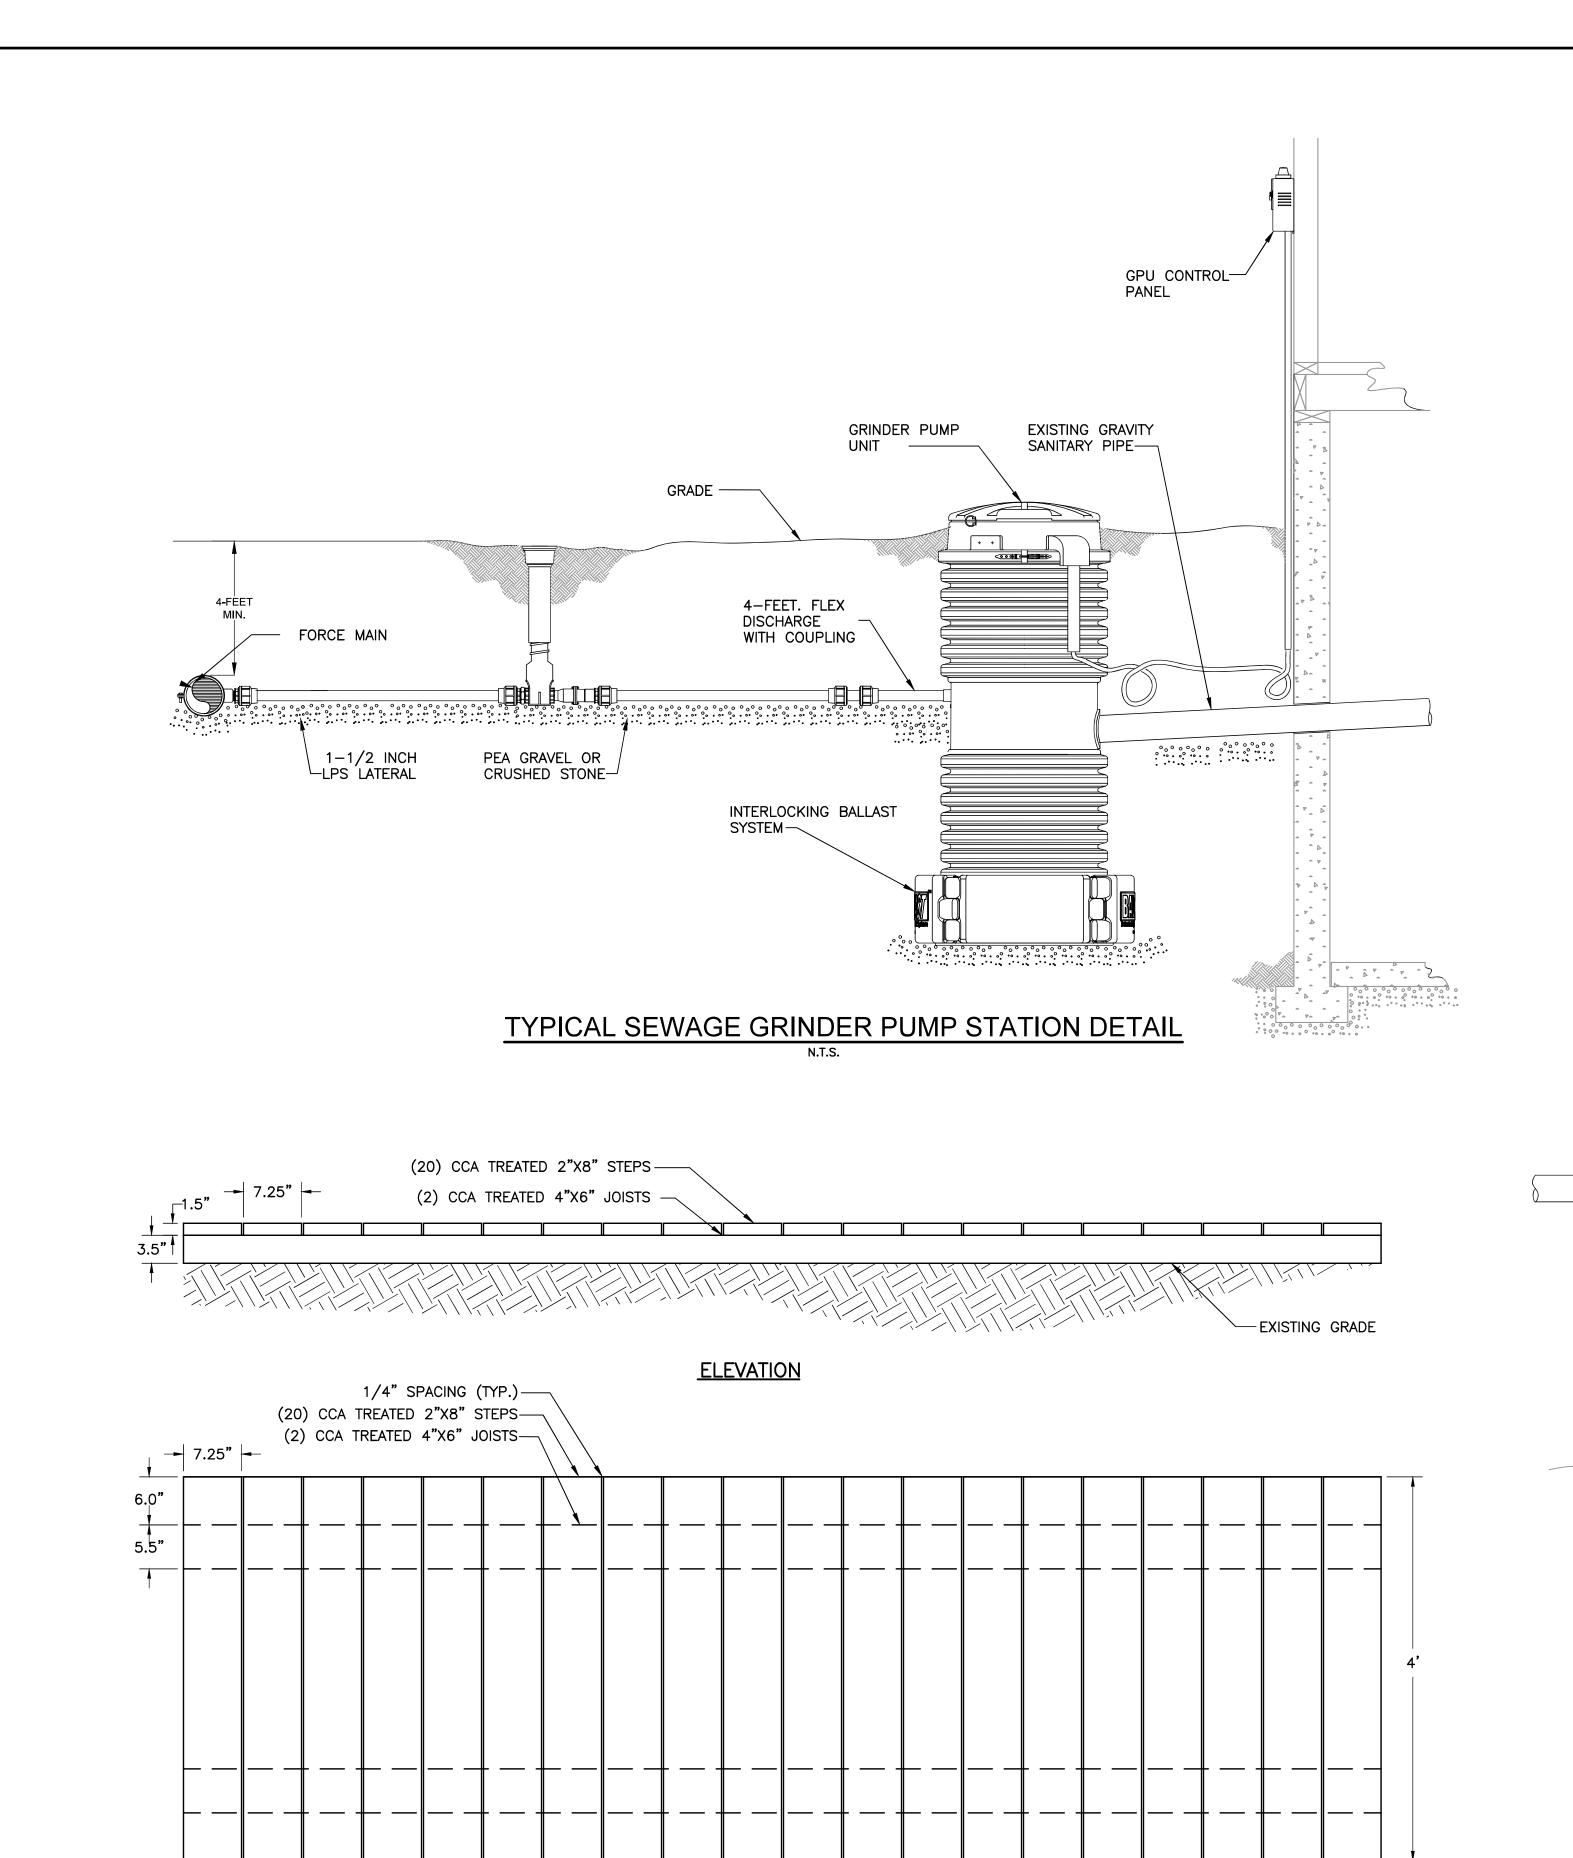
<u>PLAN</u>




TYPICAL AIR RELEASE STATION DETAIL

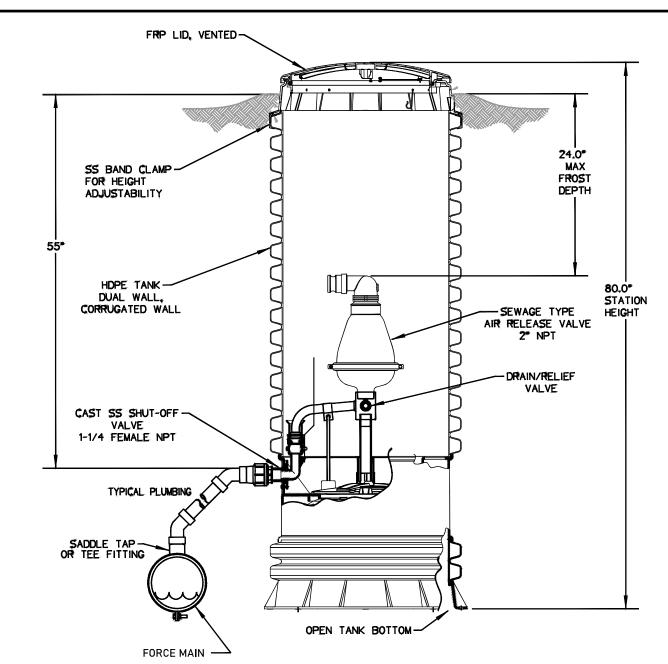

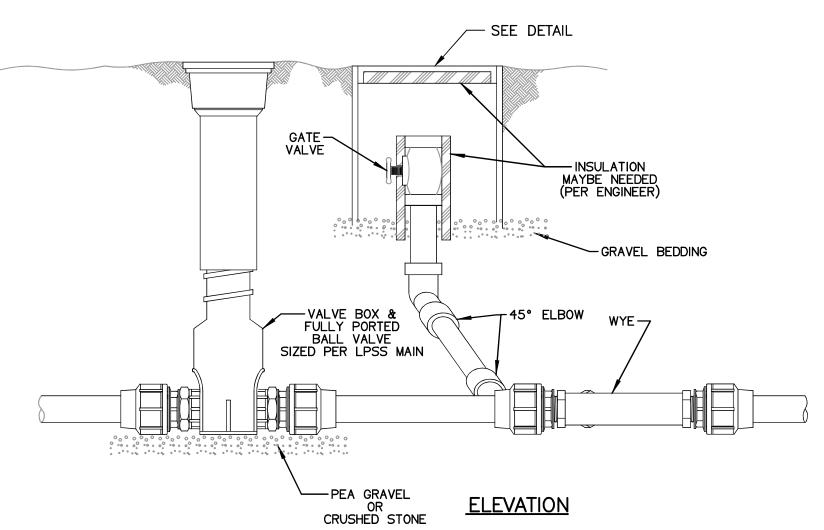

TITLE __

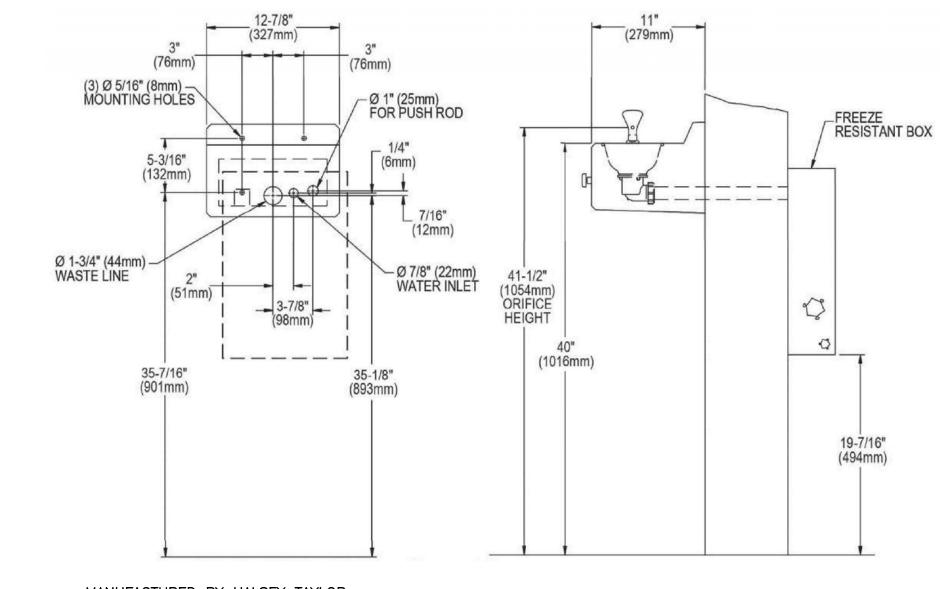

MANUFACTURED BY HALSEY TAYLOR: OUTDOOR SIERRA STONE FOUNTAIN WALL MOUNT NON-FILTERED NON-REFRIGERATED (MODEL 4592FR) OPERATING PRESSURES: SUPPLY WATER-105 PSI MAXIMUM. FREEZE-RESISTANT BOX MUST BE INSTALLED ON INTERIOR NON-FREEZING WALL.

NOTE: A SERVICE SUPPLY STOP (NOT INCLUDED) SHOULD BE INSTALLED AT THE FOUNTAIN INTEL LINE. IMPORTANT: FOR RECOMMENDED WALL SUPPORT SEE INSTALLATION INSTRUCTIONS PROVIDED WITH FOUNTAIN.

A. RECOMMENDED WATER SUPPLY LOCATION, 3/8" O.D. UNPLATED COPPER TUBE CONNECT STUB 1-1/2" (38MM) OUT FROM WALL SHUT OFF VALVE BY OTHERS.


B. RECOMMENDED LOCATION FOR WASTE OUTLET, 1-3/4" O.D. (44MM) DRAIN. C. (4) 5/16" (8MM) DIA. MOUNTING HOLES.

INSTALLATION INSTRUCTIONS.)

IMPORTANT: FOR RECOMMENDED WALL SUPPORT SEE INSTALLATION INSTRUCTIONS PROVIDED WITH PANEL AND FOUNTAINS.

REFER TO DIAGRAMS FOR ROUGH-IN OF FREEZE-RESISTANT SYSTEM AND PLUMBING. FOR WALL SUPPORT REQUIRED LOCATIONS SEE INSTALLATION INSTRUCTIONS PROVIDED WITH FOUNTAIN. BOLT FOUNTAIN SECURELY TO WALL PER INSTALLATION INSTRUCTIONS. WATER SUPPLY AND WASTE LINE ARE TO BE ASSEMBLED AS REQUIRED. FINAL CHECK FOR LEAKS AND CORRECT FUNCTIONS OF FOUNTAIN SHOULD BE MADE. (FOR DETAILS SEE

WALL MOUNTED STONE WATER FOUNTAIN: HALSEY TAYLOR (MODEL 4592FR)

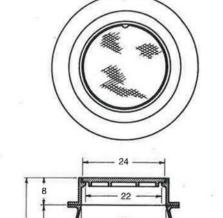

AS MANUFACTURED BY THE CAMPBELL FOUNDRY CO. PATTERN # 4420 FOR SANITARY OR COMBINED SEWER COVER MUST SAY "WCDPWT SEWER" ROUND FLANGE ONLY

> **CLEANOUT ACCESS FRAME** AND COVER

TYPICAL CLEANOUT	DETAII
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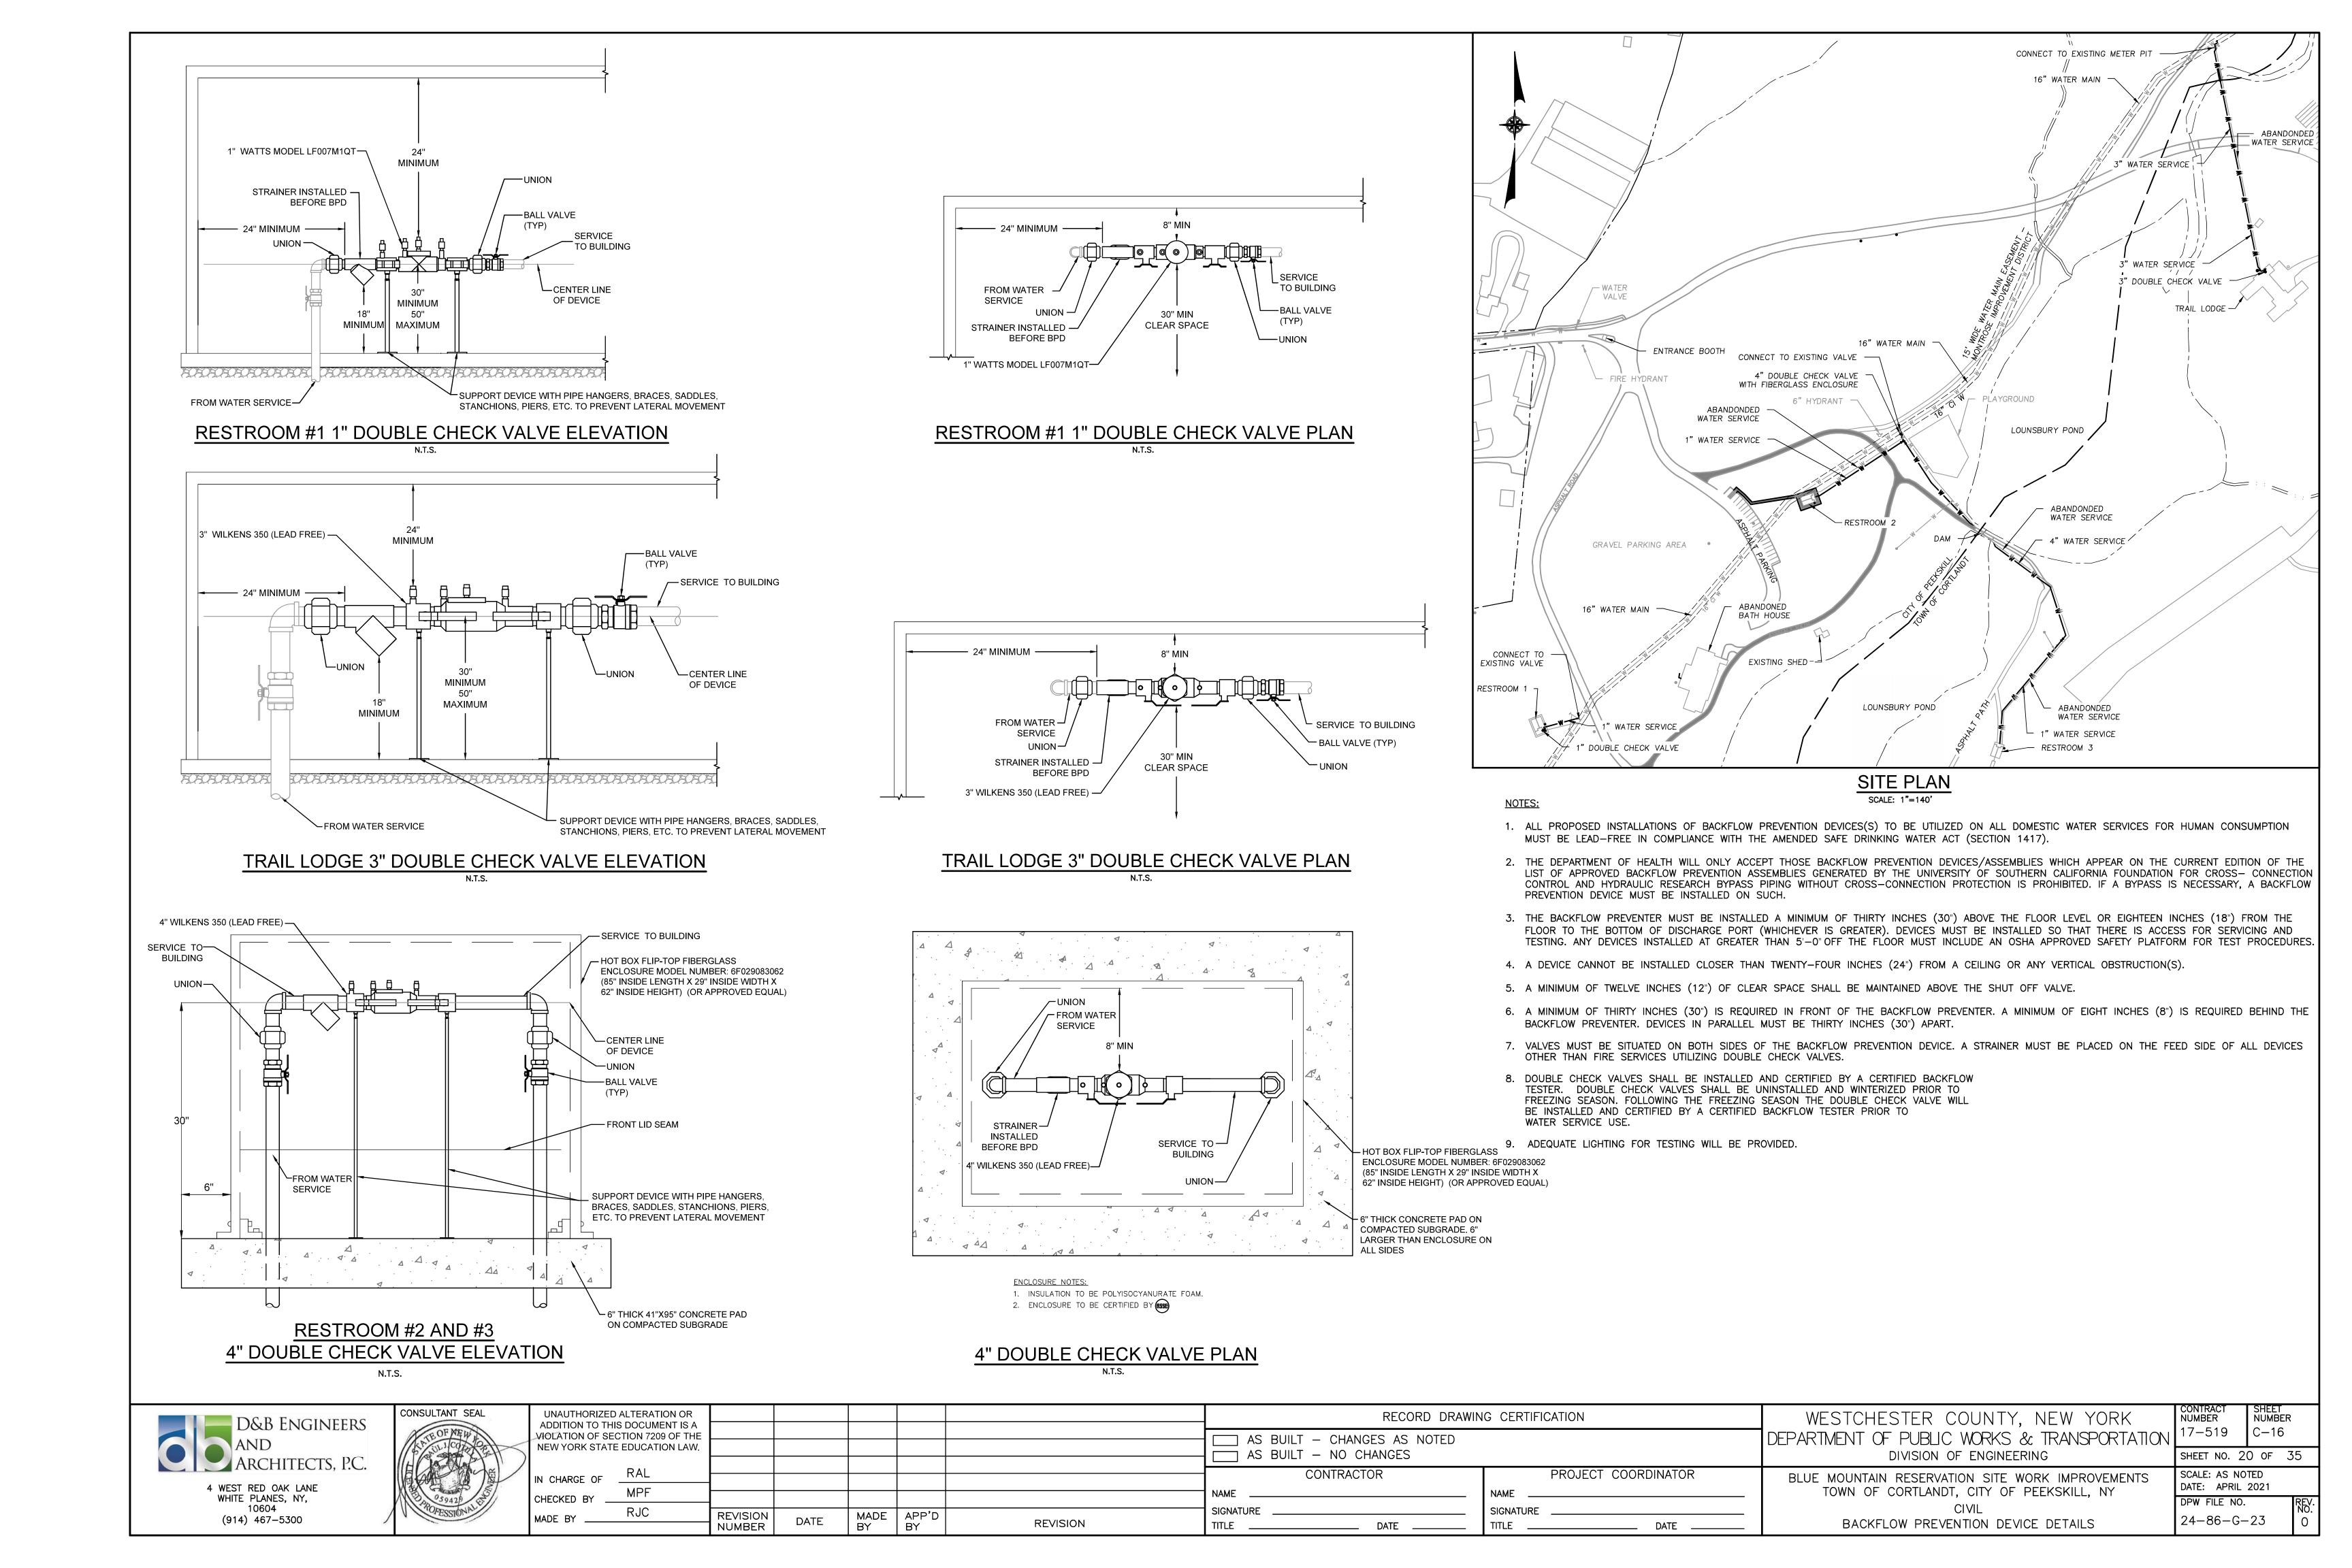
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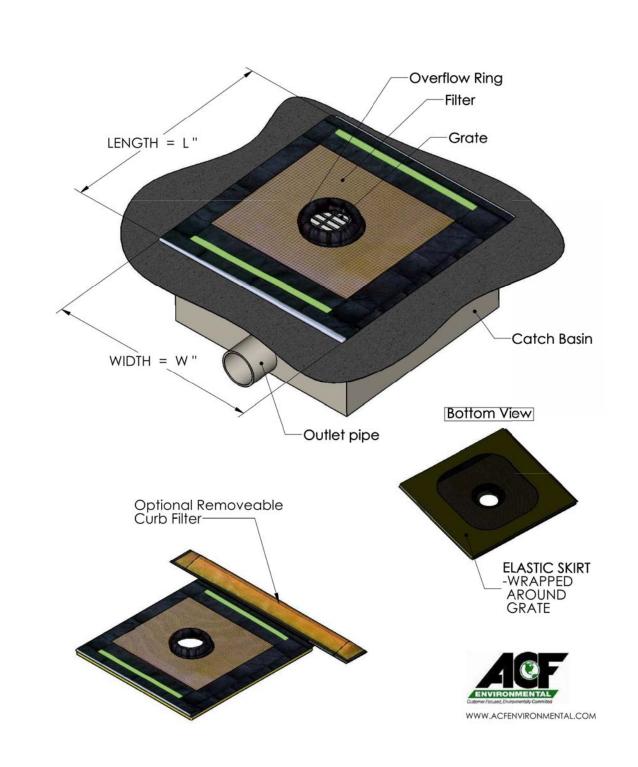
DEPARTMENT OF PUBLIC WORKS & TRANSPORTATION DIVISION OF ENGINEERING BLUE MOUNTAIN RESERVATION SITE WORK IMPROVEMENTS TOWN OF CORTLANDT, CITY OF PEEKSKILL, NY CIVIL

WESTCHESTER COUNTY, NEW YORK

SITE DETAILS NO. 2

CONTRACT NUMBER SHEET NUMBER 17-519 C-15 SHEET NO. 19 OF 35 SCALE: AS NOTED DATE: APRIL 2021 DPW FILE NO.





INLET PROTECTION "GRATE GATOR TYPE A" DETAIL

WOVEN WIRE REINFORCEMENT -MESH INSTALLED TO FULL HEIGHT OF STAKES - POSTS SPACED AT 10'-0 (MAX) SOME AREAS MAY REQUIRE CLOSER SPACING FOR PROPER TOP OF FILTER CLOTH 16" -FROM GRADE (MINIMUM) 1'-8 (MIN) SHOWN BELOW) COMPACTED SOIL-6" MIN. EMBED 1'-4 (MIN) GEOTEXTILE BURIED IN -4" (MIN)

MAXIMUM ALLOWABLE SLOPE LENGTH MAXIMUM ALLOWABLE SLOPE LENGTHS CONTRIBUTING RUNOFF TO A SECTION OF SILT FENCE SHALL BE AS FOLLOWS:

SLOPE STEEPNESS: MAX. SLOPE LENGTH: 25 FT 1: 2 1:3 50 FT 1:4 75 FT 1:5 OR FLATTER 100 FT

NOTE: MAXIMUM DRAINAGE AREA FOR OVERLAND FLOW TO SILT FENCE SECTION SHALL NOT EXCEED 1/4 ACRE PER 100 FT OF FENCE. CONCENTRATED DISCHARGE OF SEDIMENT LADEN WATER SHALL NOT BE ALLOWED TO FLOW DIRECTLY TO THE FENCING.

CONSTRUCTION NOTES FOR FABRICATED SILT FENCE

TYPE OR 2" HARDWOOD

6" MAX. MESH OPENING


MIRAFI 100X, STABILINKA

T140N OR APPROVED EQUAL.

FILTER X,

FILTER CLOTH:

- 1. INSTALL SILT FENCE IN ACCORDANCE WITH THE NEW YORK STANDARDS POSTS: STEEL EITHER "T" OR "U" AND SPECIFICATIONS FOR EROSION AND SEDIMENT CONTROL", SECTION 5A.
- 2. WOVEN WIRE FENCE SHALL BE 12 1/2 GA., 6" MAXIMUM MESH OPENING, FENCE: WOVEN WIRE, 12 1/2 GA. FASTENED SECURELY TO FENCE POŚTS WITH WIRE TIES OR STAPLES.
- 3. FILTER CLOTH TO BE TO BE FASTENED SECURELY TO WOVEN WIRE FENCE WITH TIES SPACED EVERY 24" AT TOP AND MID SECTION.
- 4. WHEN TWO SECTIONS OF FILTER CLOTH ADJOIN EACH OTHER THEY SHALL BE WRAPPED TOGETHER PER DETAIL ON THIS PAGE.
- 5. MAINTENANCE SHALL BE PERFORMED AS NEEDED AND SEDIMENT REMOVED PREFABRICATED UNIT: GEOFAB, WHEN ACCUMULATION REACHES 1/2 OF DESIGN CAPACITY OF FENCE ENVIROFENCE, OR APPROVED (1/2 HEIGHT OF FILTER FABRIC) OR WHEN BULGES DEVELOP IN FENCING. EQUAL.

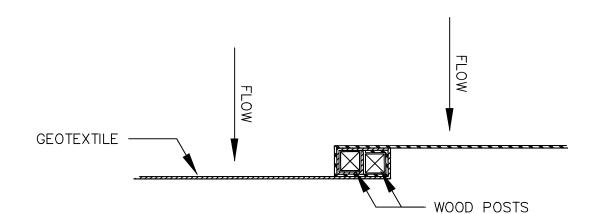

WRAP ENDS OF SILT FENCE SECTIONS TOGETHER TO PREVENT FLOW OF SEDIMENT BETWEEN SECTIONS

SILT FENCE JOINT DETAIL

-SAFETY FENCE: USE HAZARD ORANGE DIAMOND OR SQUARE PLASTIC FENCE MESH 4' HIGH MOUNTED ON HEAVY DUTY STEEL T-POSTS SET AT 8' O.C. MAX.

NOTES:


1. THE PROJECT DEVELOPER SHALL TAKE REASONABLE PRECAUTION

THE PROJECT DEVELOPER SHALL TAKE REASONABLE PRECAUTION

THE PROJECT DEVELOPER SHALL TAKE REASONABLE PRECAUTION TO SAVE SPECIMEN QUALITY TREES IN AREAS NOTED ON THE PLANS FOR CLEARING. WHEN POSSIBLE THE DEVELOPER SHALL PROTECT INDIVIDUAL SPECIMEN TREES THROUGH THE INSTALLATION OF SAFETY FENCING AROUND THE DRIP LINE PERIMETER OF THE TREE. 2. SAFETY FENCING SHALL BE INSTALLED AT THE ON SET OF SITE CONSTRUCTION TO PREVENT VEHICLE TRAFFIC FROM COMPACTING THE SOILS IN THE VICINITY OF THE TREE ROOT STRUCTURE. 3. PROTECT ALL TREES WITHIN AREA OF DISTURBANCE OVER 6" CAL.

TREE PROTECTION DETAIL

SEDIMENT CONTROL FENCE INSTALLATION DETAIL

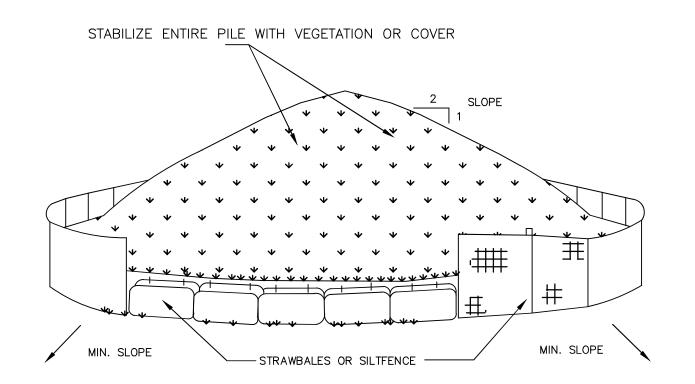


SEE SHEET 6 FOR LOCATION.

INSTALLATION NOTES

- AREA CHOSEN FOR STOCKPILING OPERATIONS SHALL BE DRY AND STABLE.
 MAXIMUM SLOPE OF STOCKPILE SHALL BE 1:2.
 UPON COMPLETION OF SOIL STOCKPILING, EACH PILE SHALL BE SURROUNDED WITH EITHER SILT FENCING OR STRAWBALES, THEN STABILIZED WITH VEGETATION OR COVERED.
 SEE SILT FENCE DETAIL FOR INSTALLATION OF SILTFENCE.

PERIMETER SEDIMENT CONTROLS MUST BE MAINTAINED ACCORDING TO THE STANDARDS DESCRIBED IN THIS MANUAL. STOCKPILES AND FILL AREAS SHALL BE INSPECTED PERIODICALLY (I.E. WEEKLY) FOR SIGNS OF EROSION OR PROBLEMS WITH PLANT ESTABLISHMENT.

MATERIAL STOCKPILING

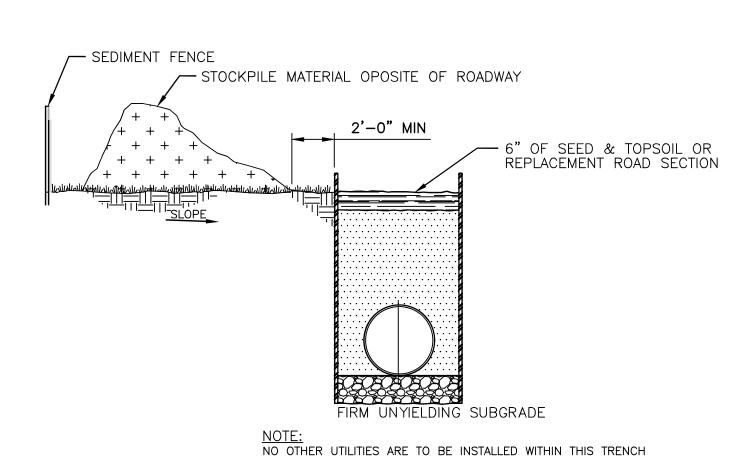

TYPICAL MATERIAL STOCK PILE NEAR TRENCH DETAIL





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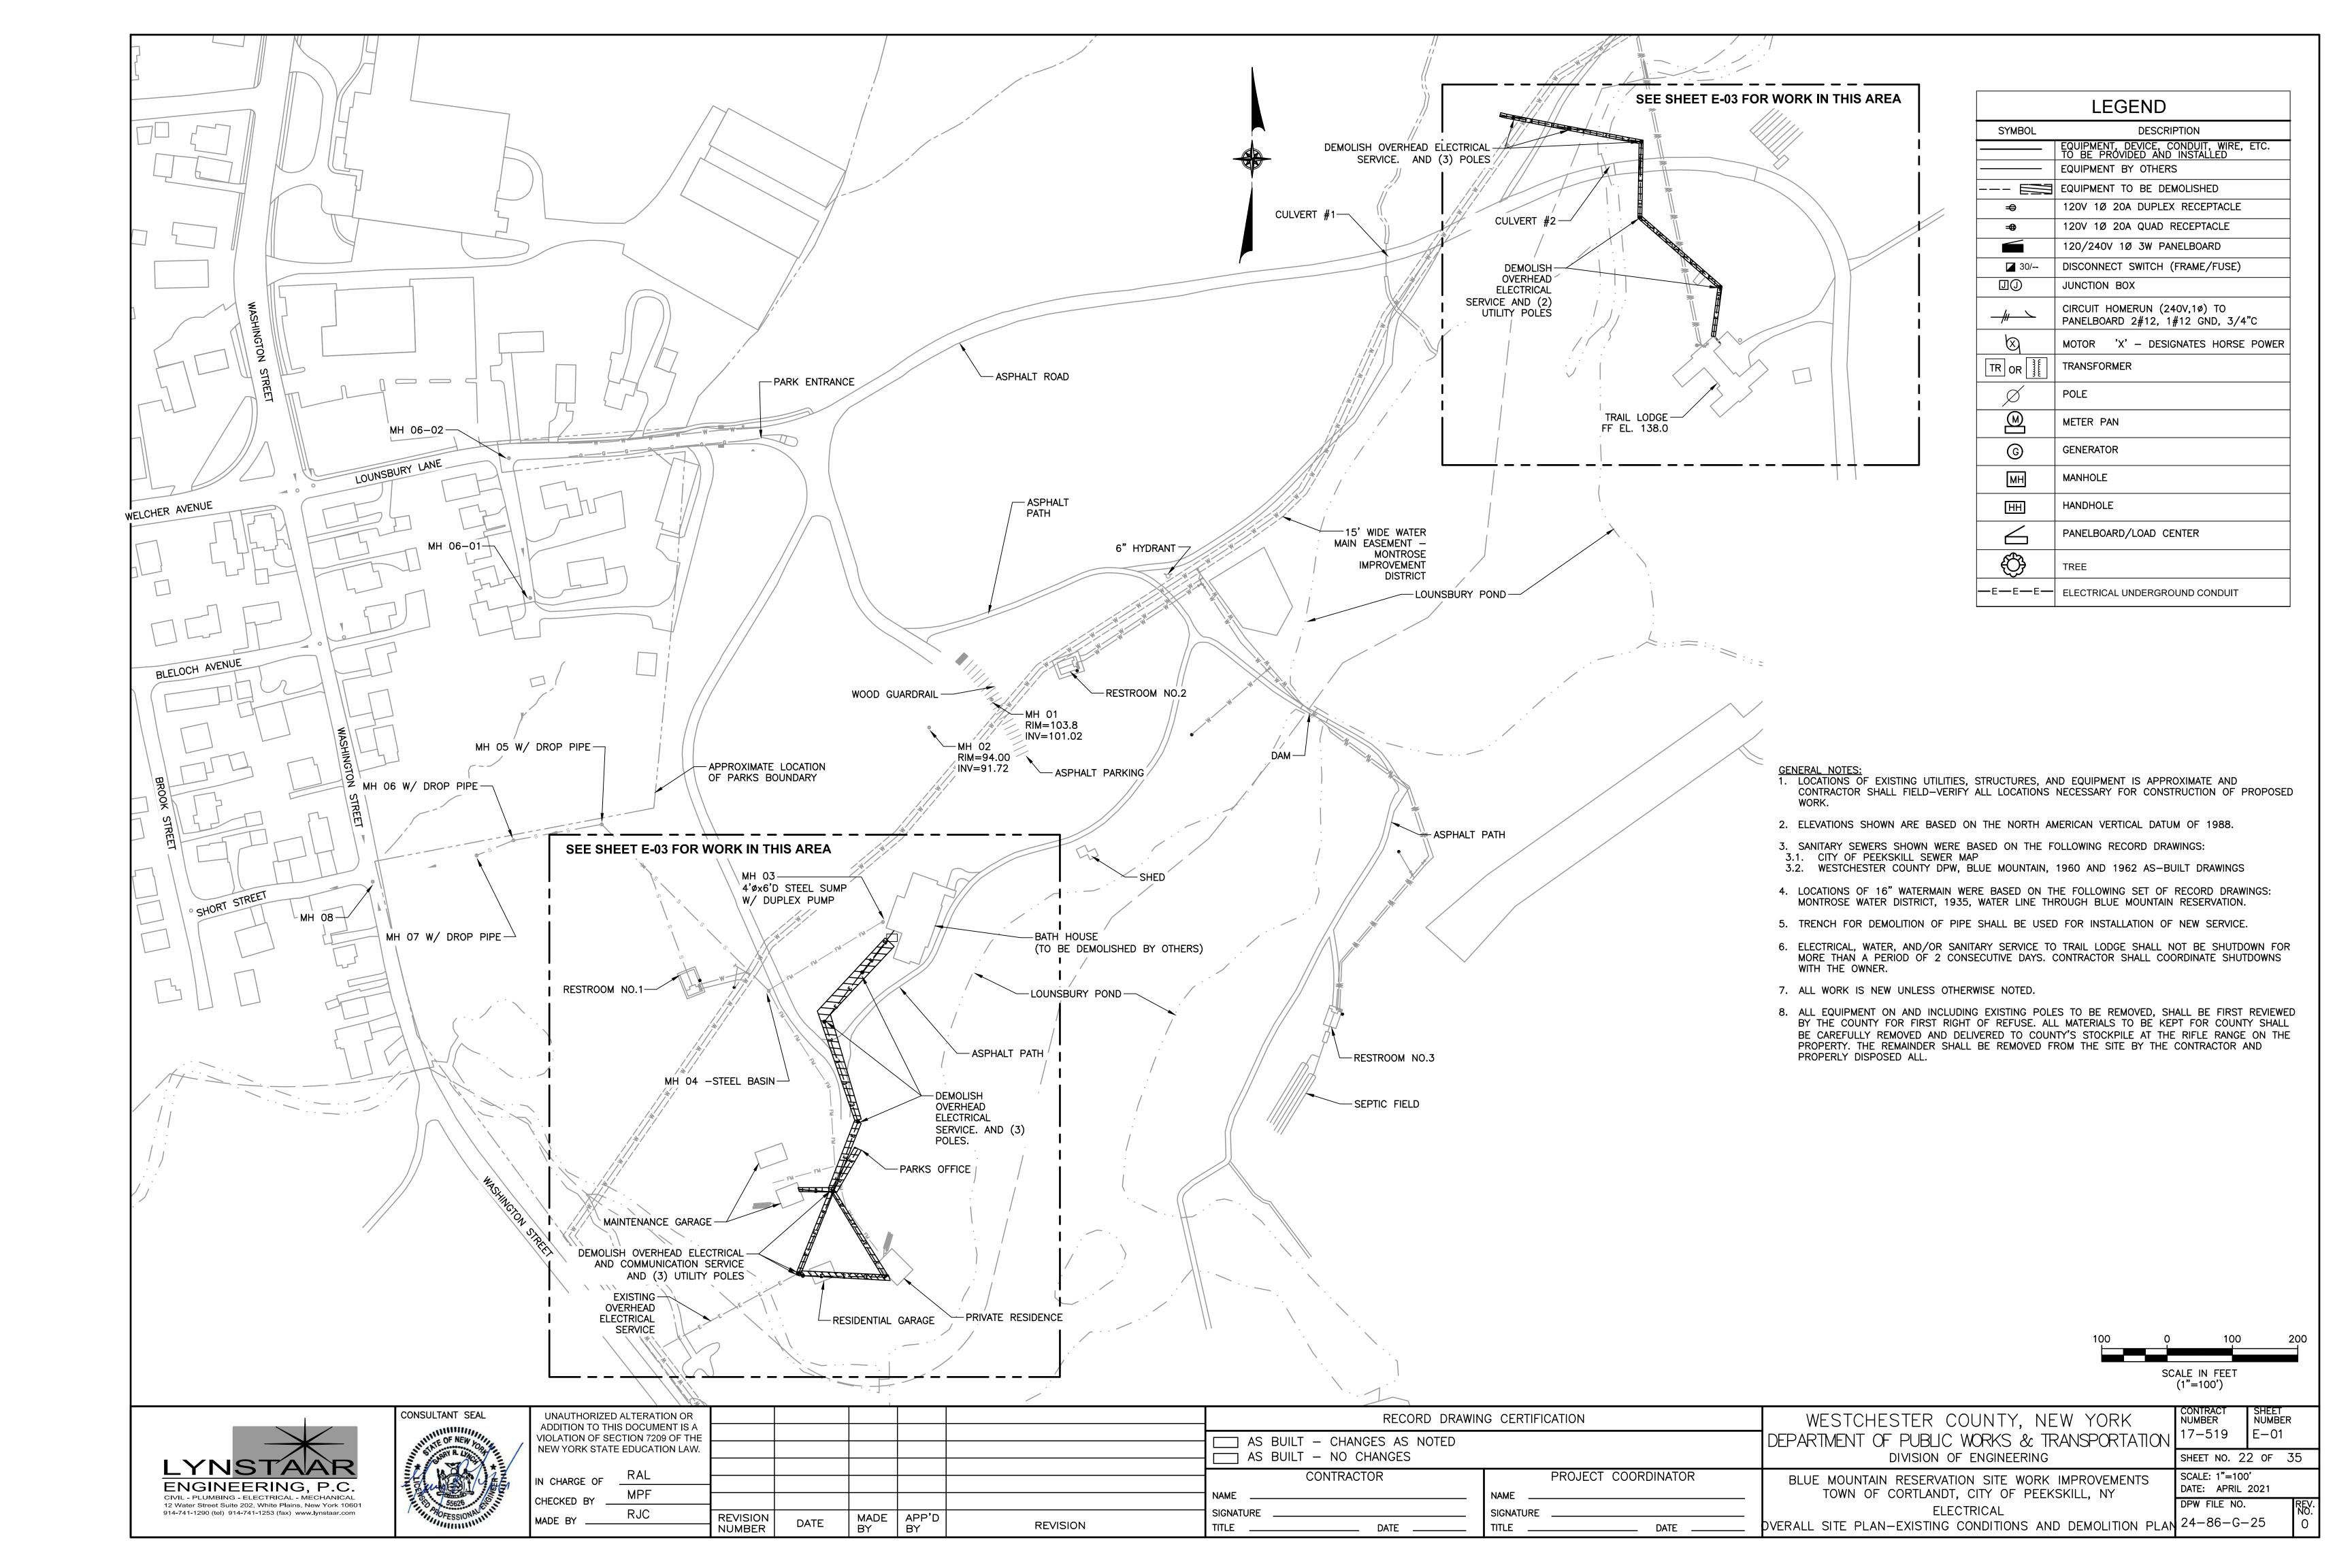
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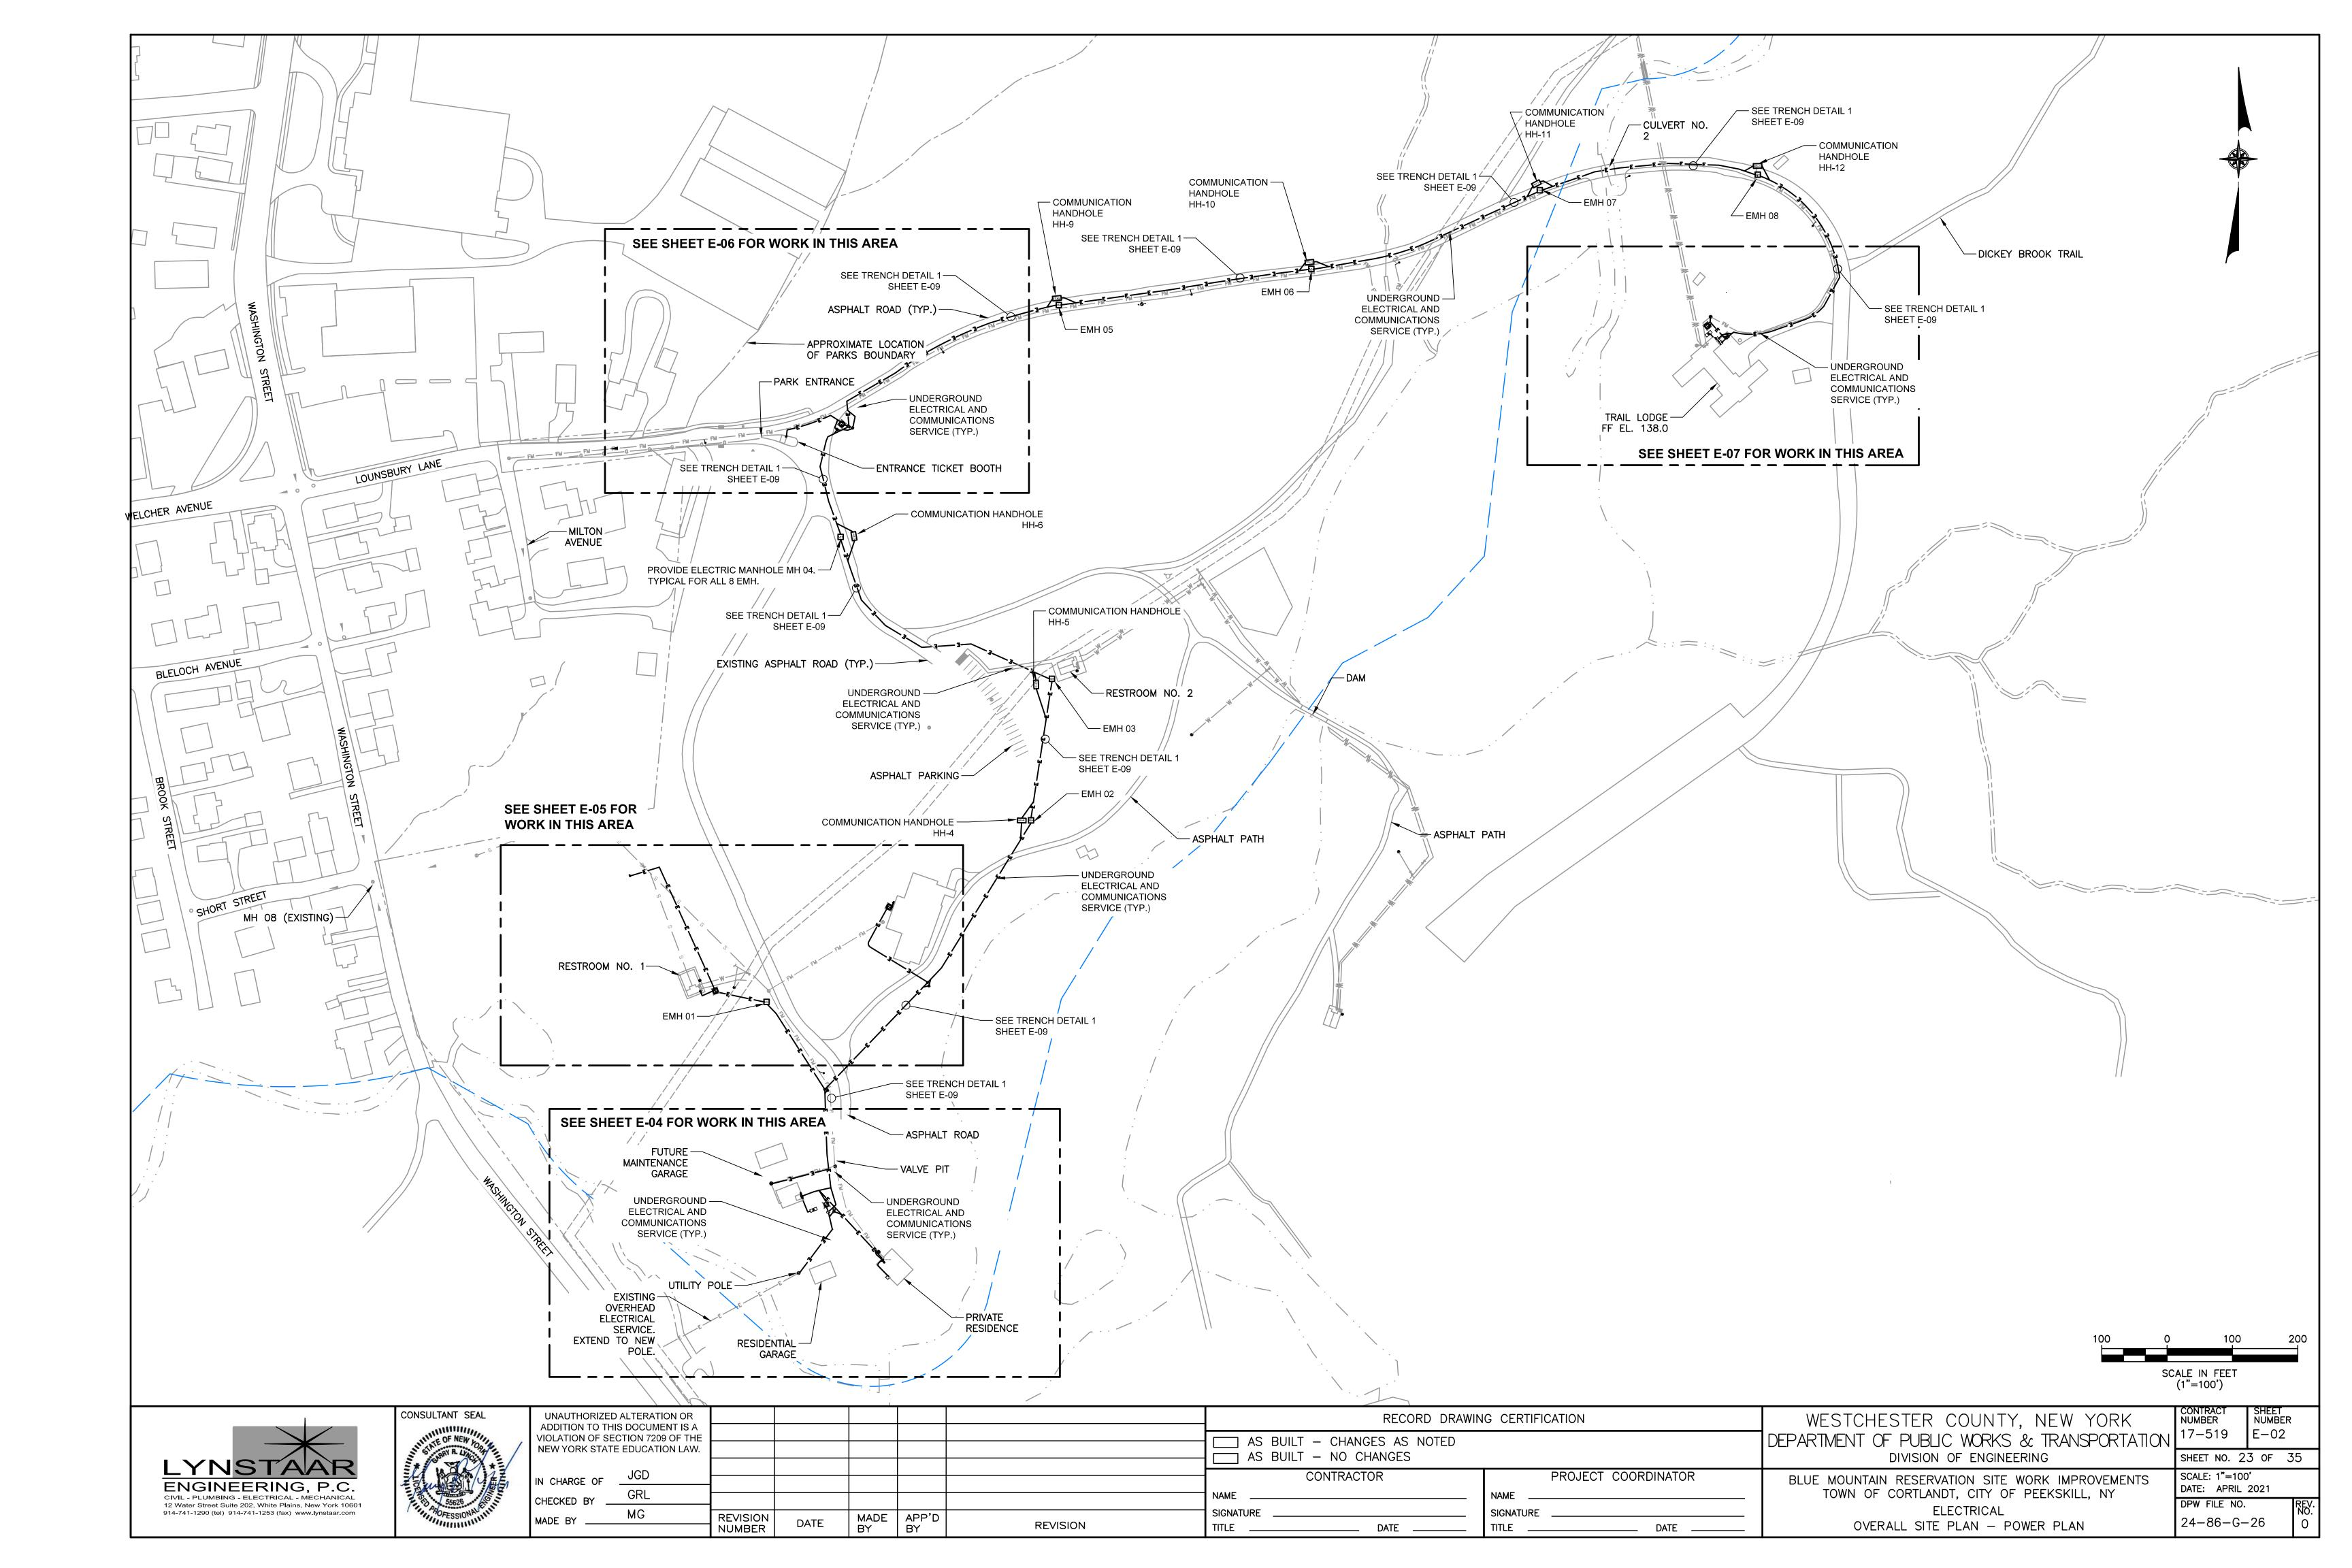
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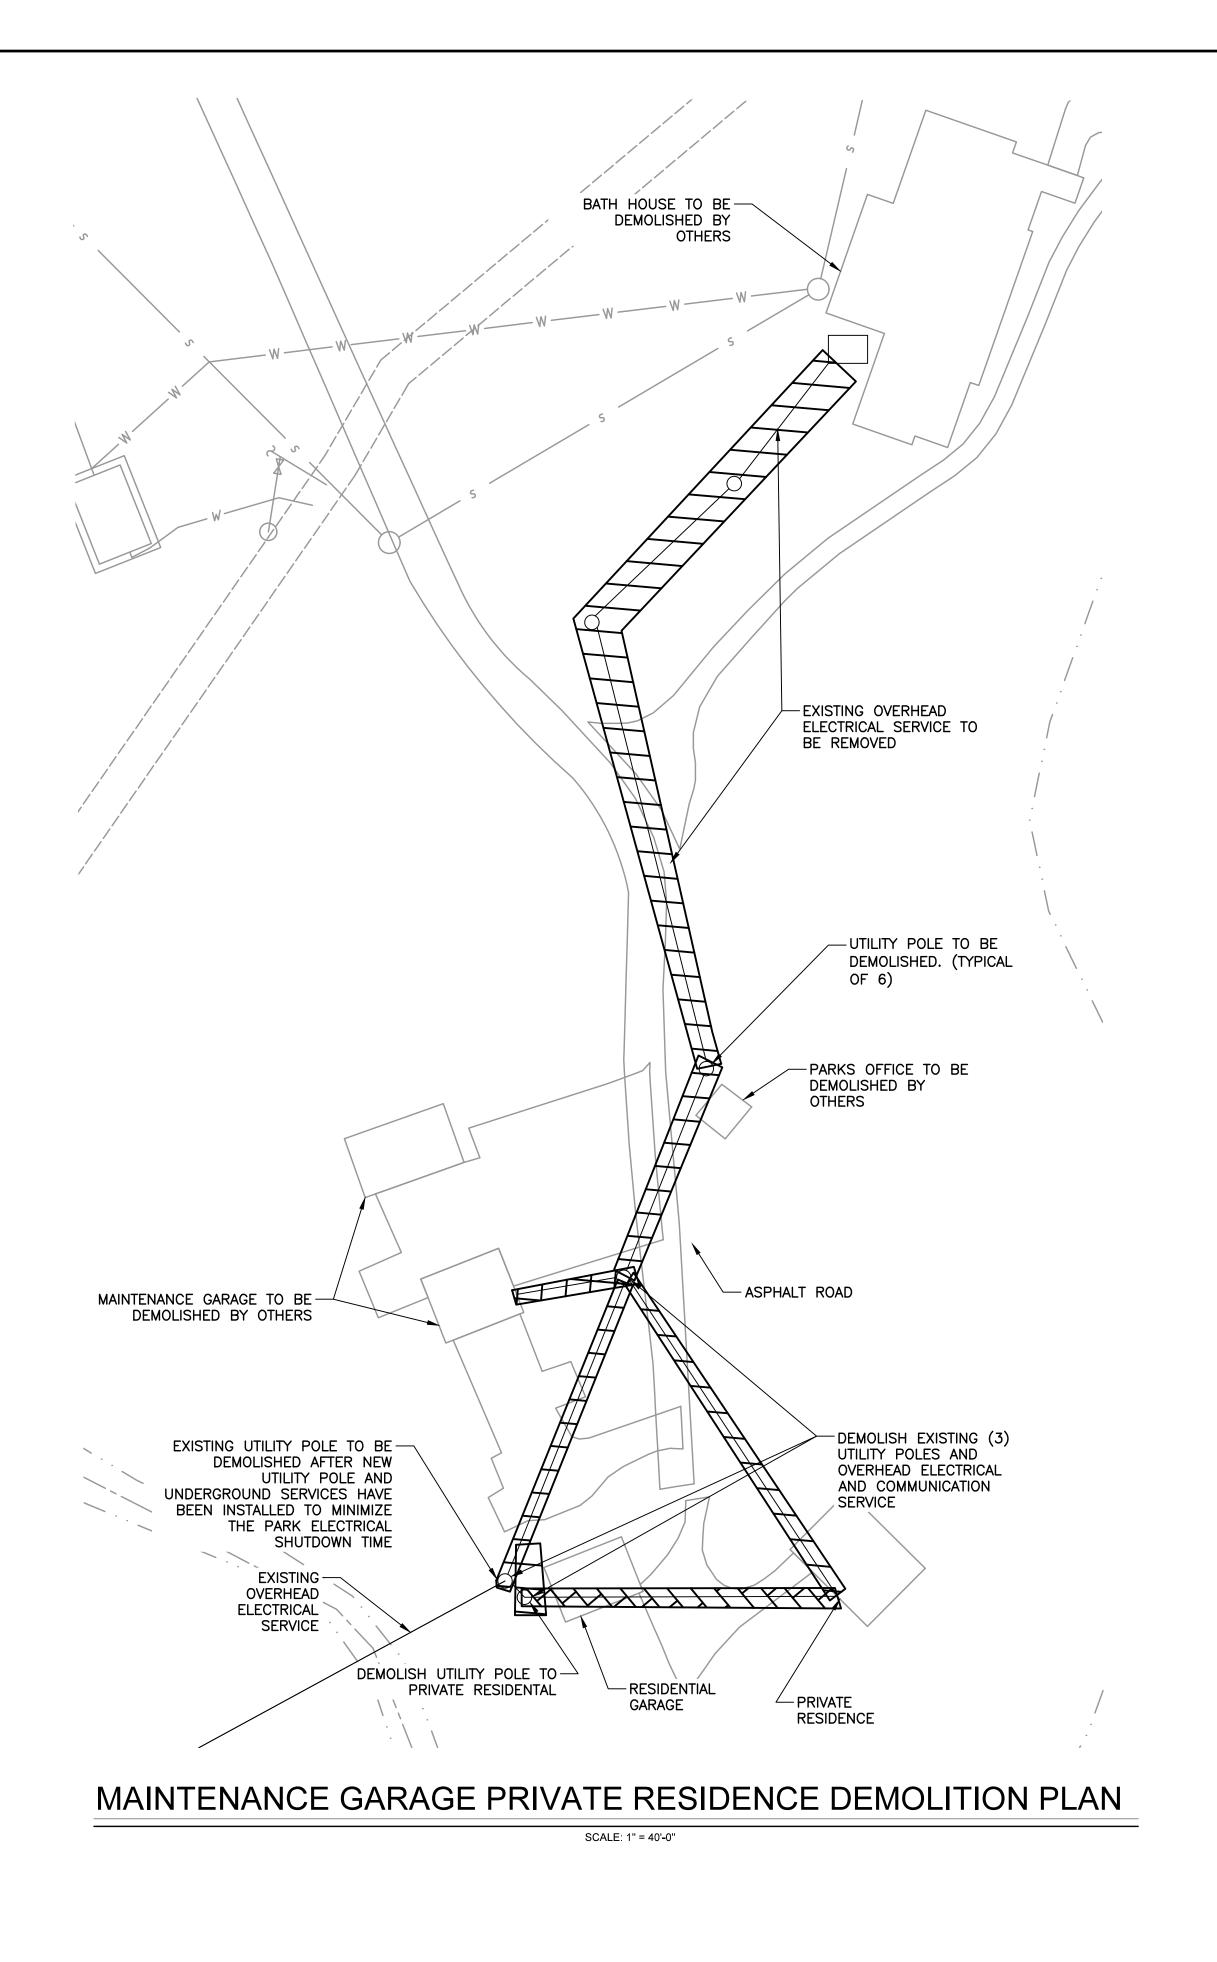
DIVISION OF ENGINEERING BLUE MOUNTAIN RESERVATION SITE WORK IMPROVEMENTS TOWN OF CORTLANDT, CITY OF PEEKSKILL, NY CIVIL EROSION AND SEDIMENT CONTROL DETAILS

WESTCHESTER COUNTY, NEW YORK

CONTRACT NUMBER SHEET NUMBER 17-519 C-17 DEPARTMENT OF PUBLIC WORKS & TRANSPORTATION SHEET NO. 21 OF 35 SCALE: AS NOTED DATE: APRIL 2021 DPW FILE NO. 24-86-G-24








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SCALE IN FEET (1"=40')

CONTRACT NUMBER

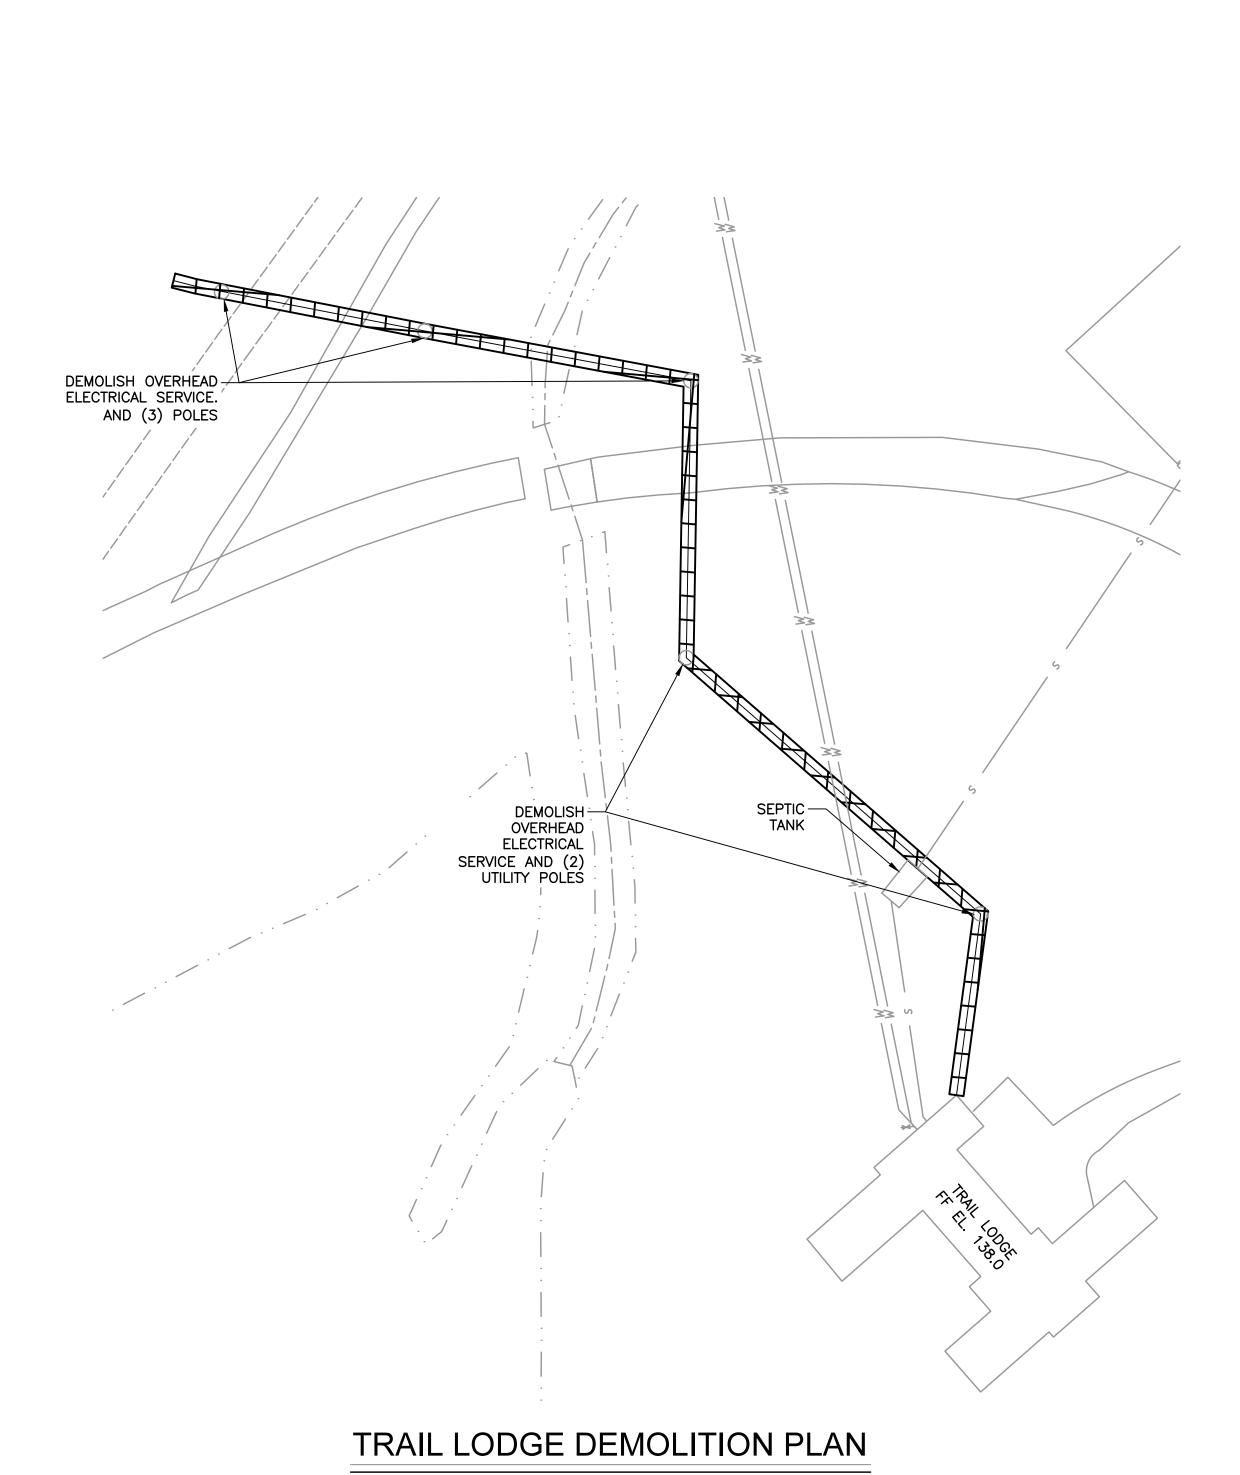17-519

SCALE: 1"=40' DATE: APRIL 2021

DPW FILE NO.

24-86-G-27

ELECTRICAL

MAINTENANCE GARAGE AND TRAIL LODGE DEMOLITION PLANS

SHEET NUMBER

E-03

SHEET NO. 24 OF 35

LYNSTAAR
ENGINEERING, P.C. CIVIL - PLUMBING - ELECTRICAL - MECHANICAL 12 Water Street Suite 202, White Plains, New York 10601 914-741-1290 (tel) 914-741-1253 (fax) www.lynstaar.com

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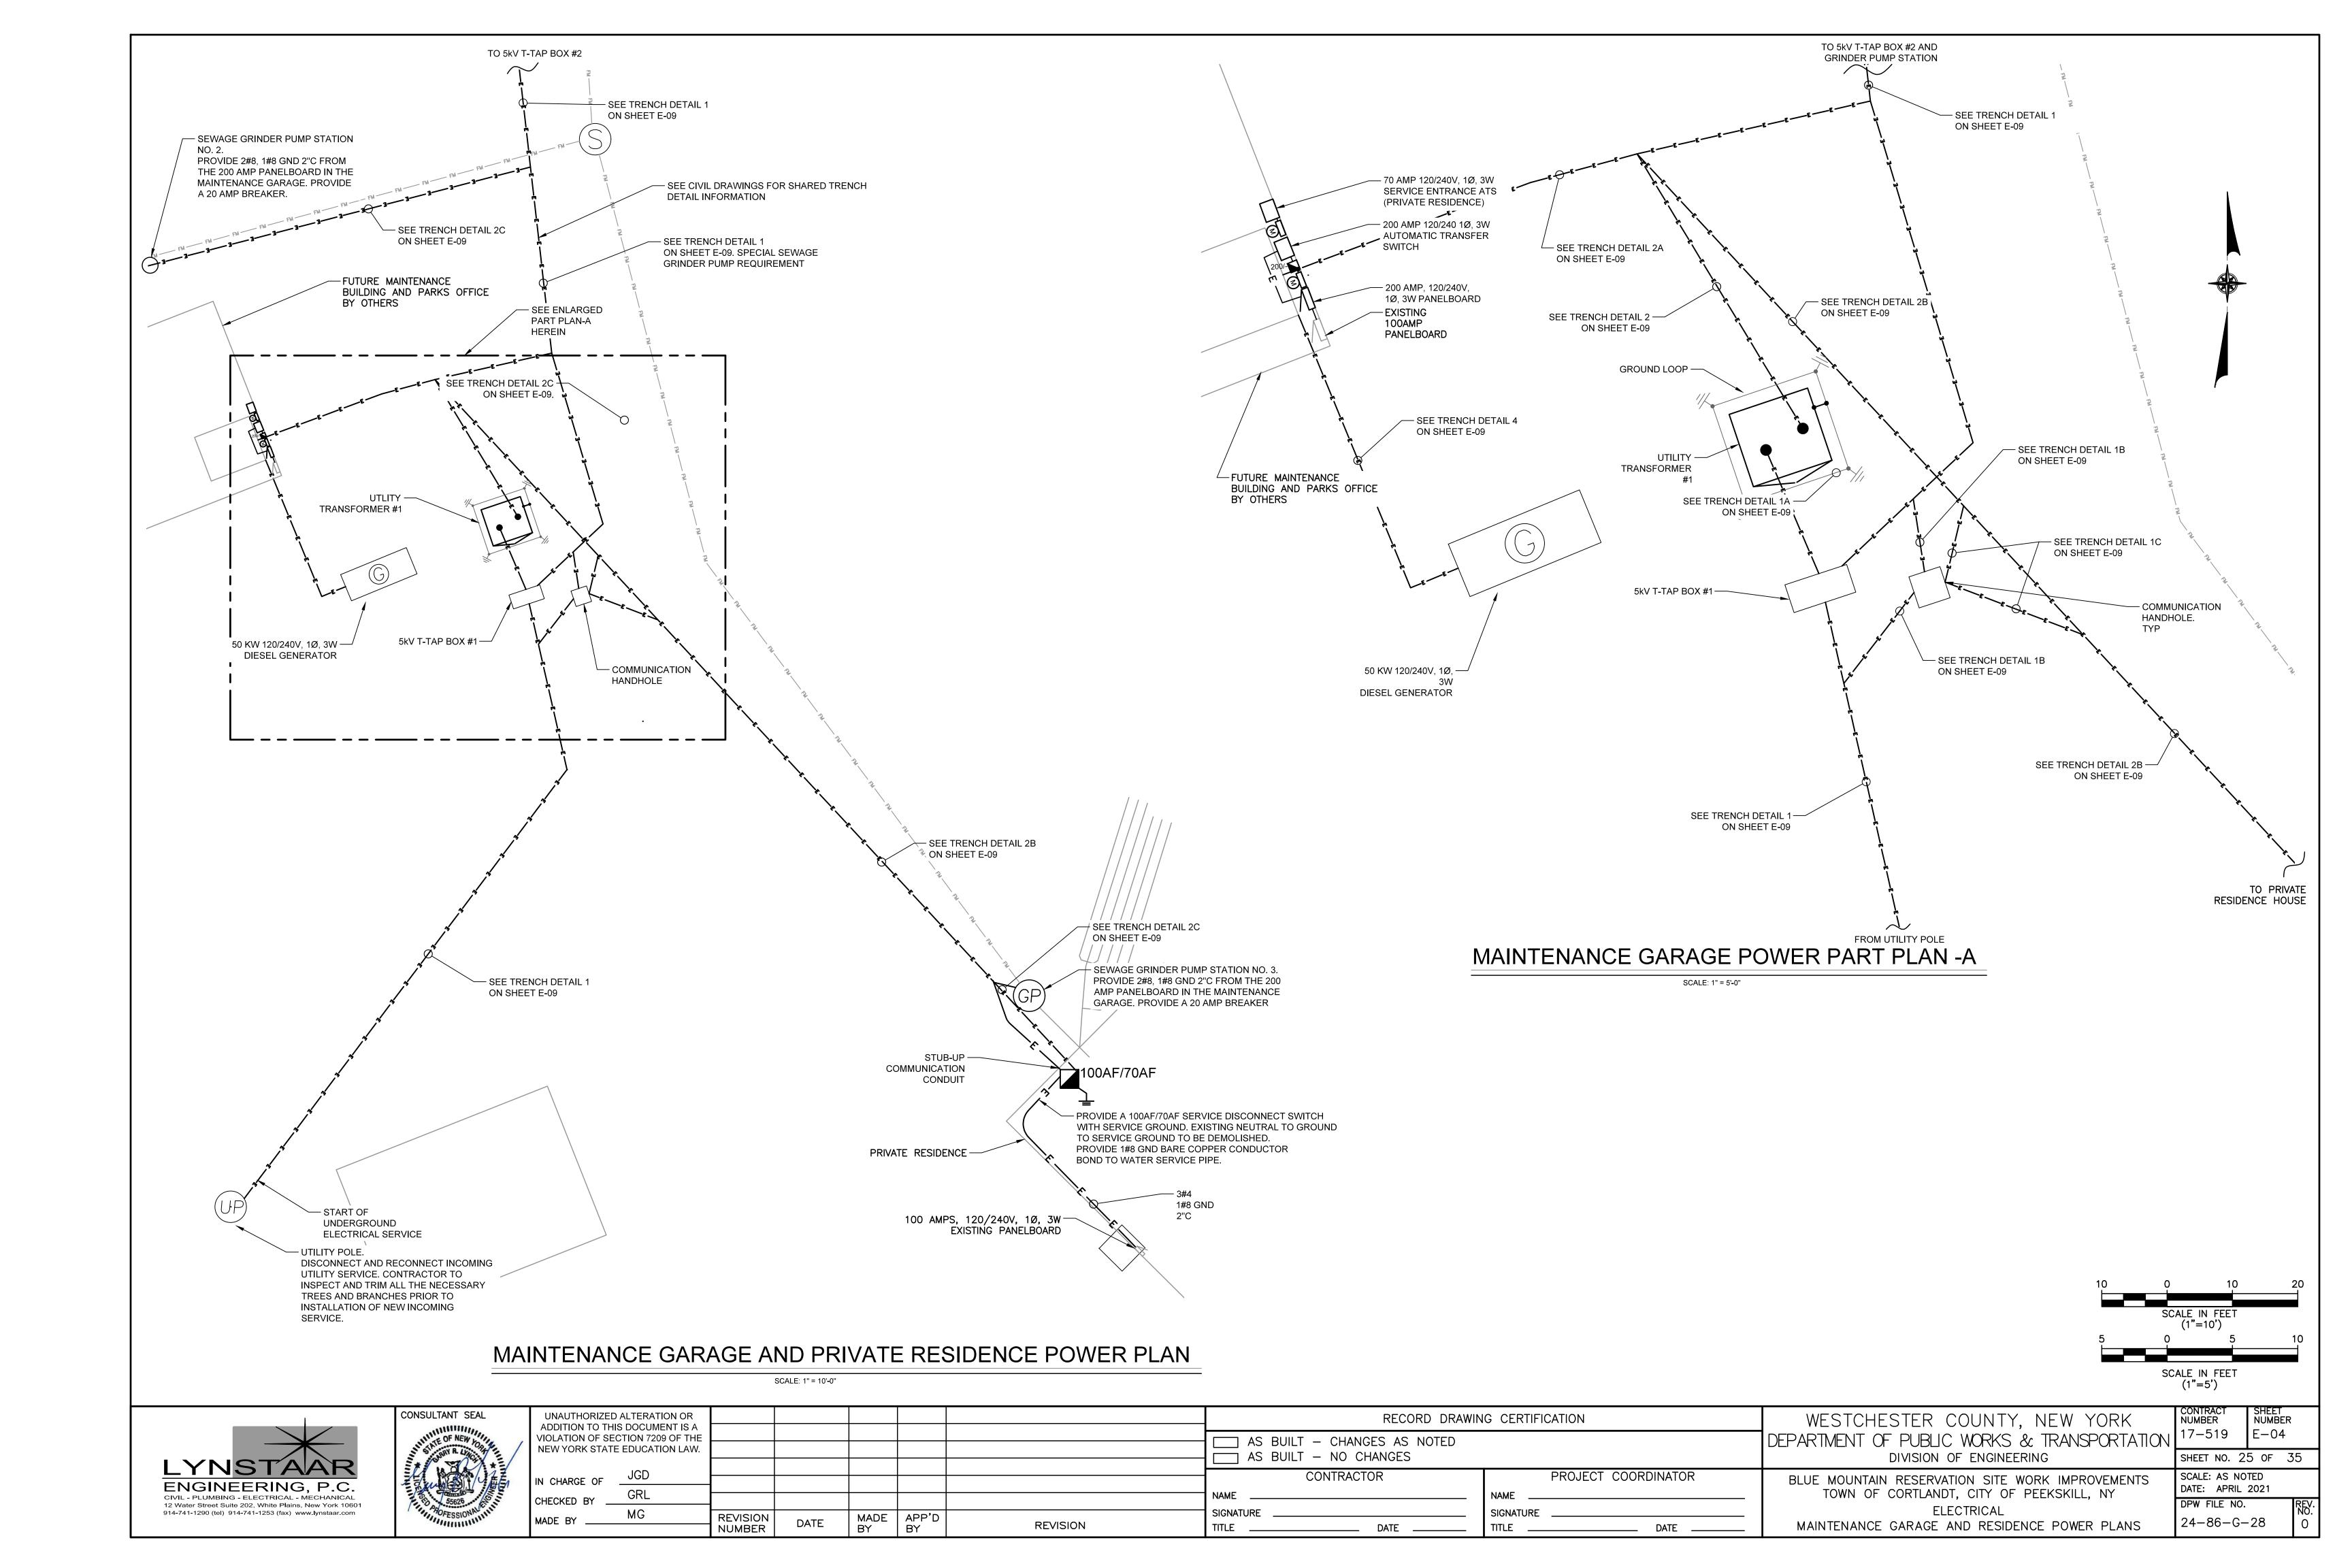
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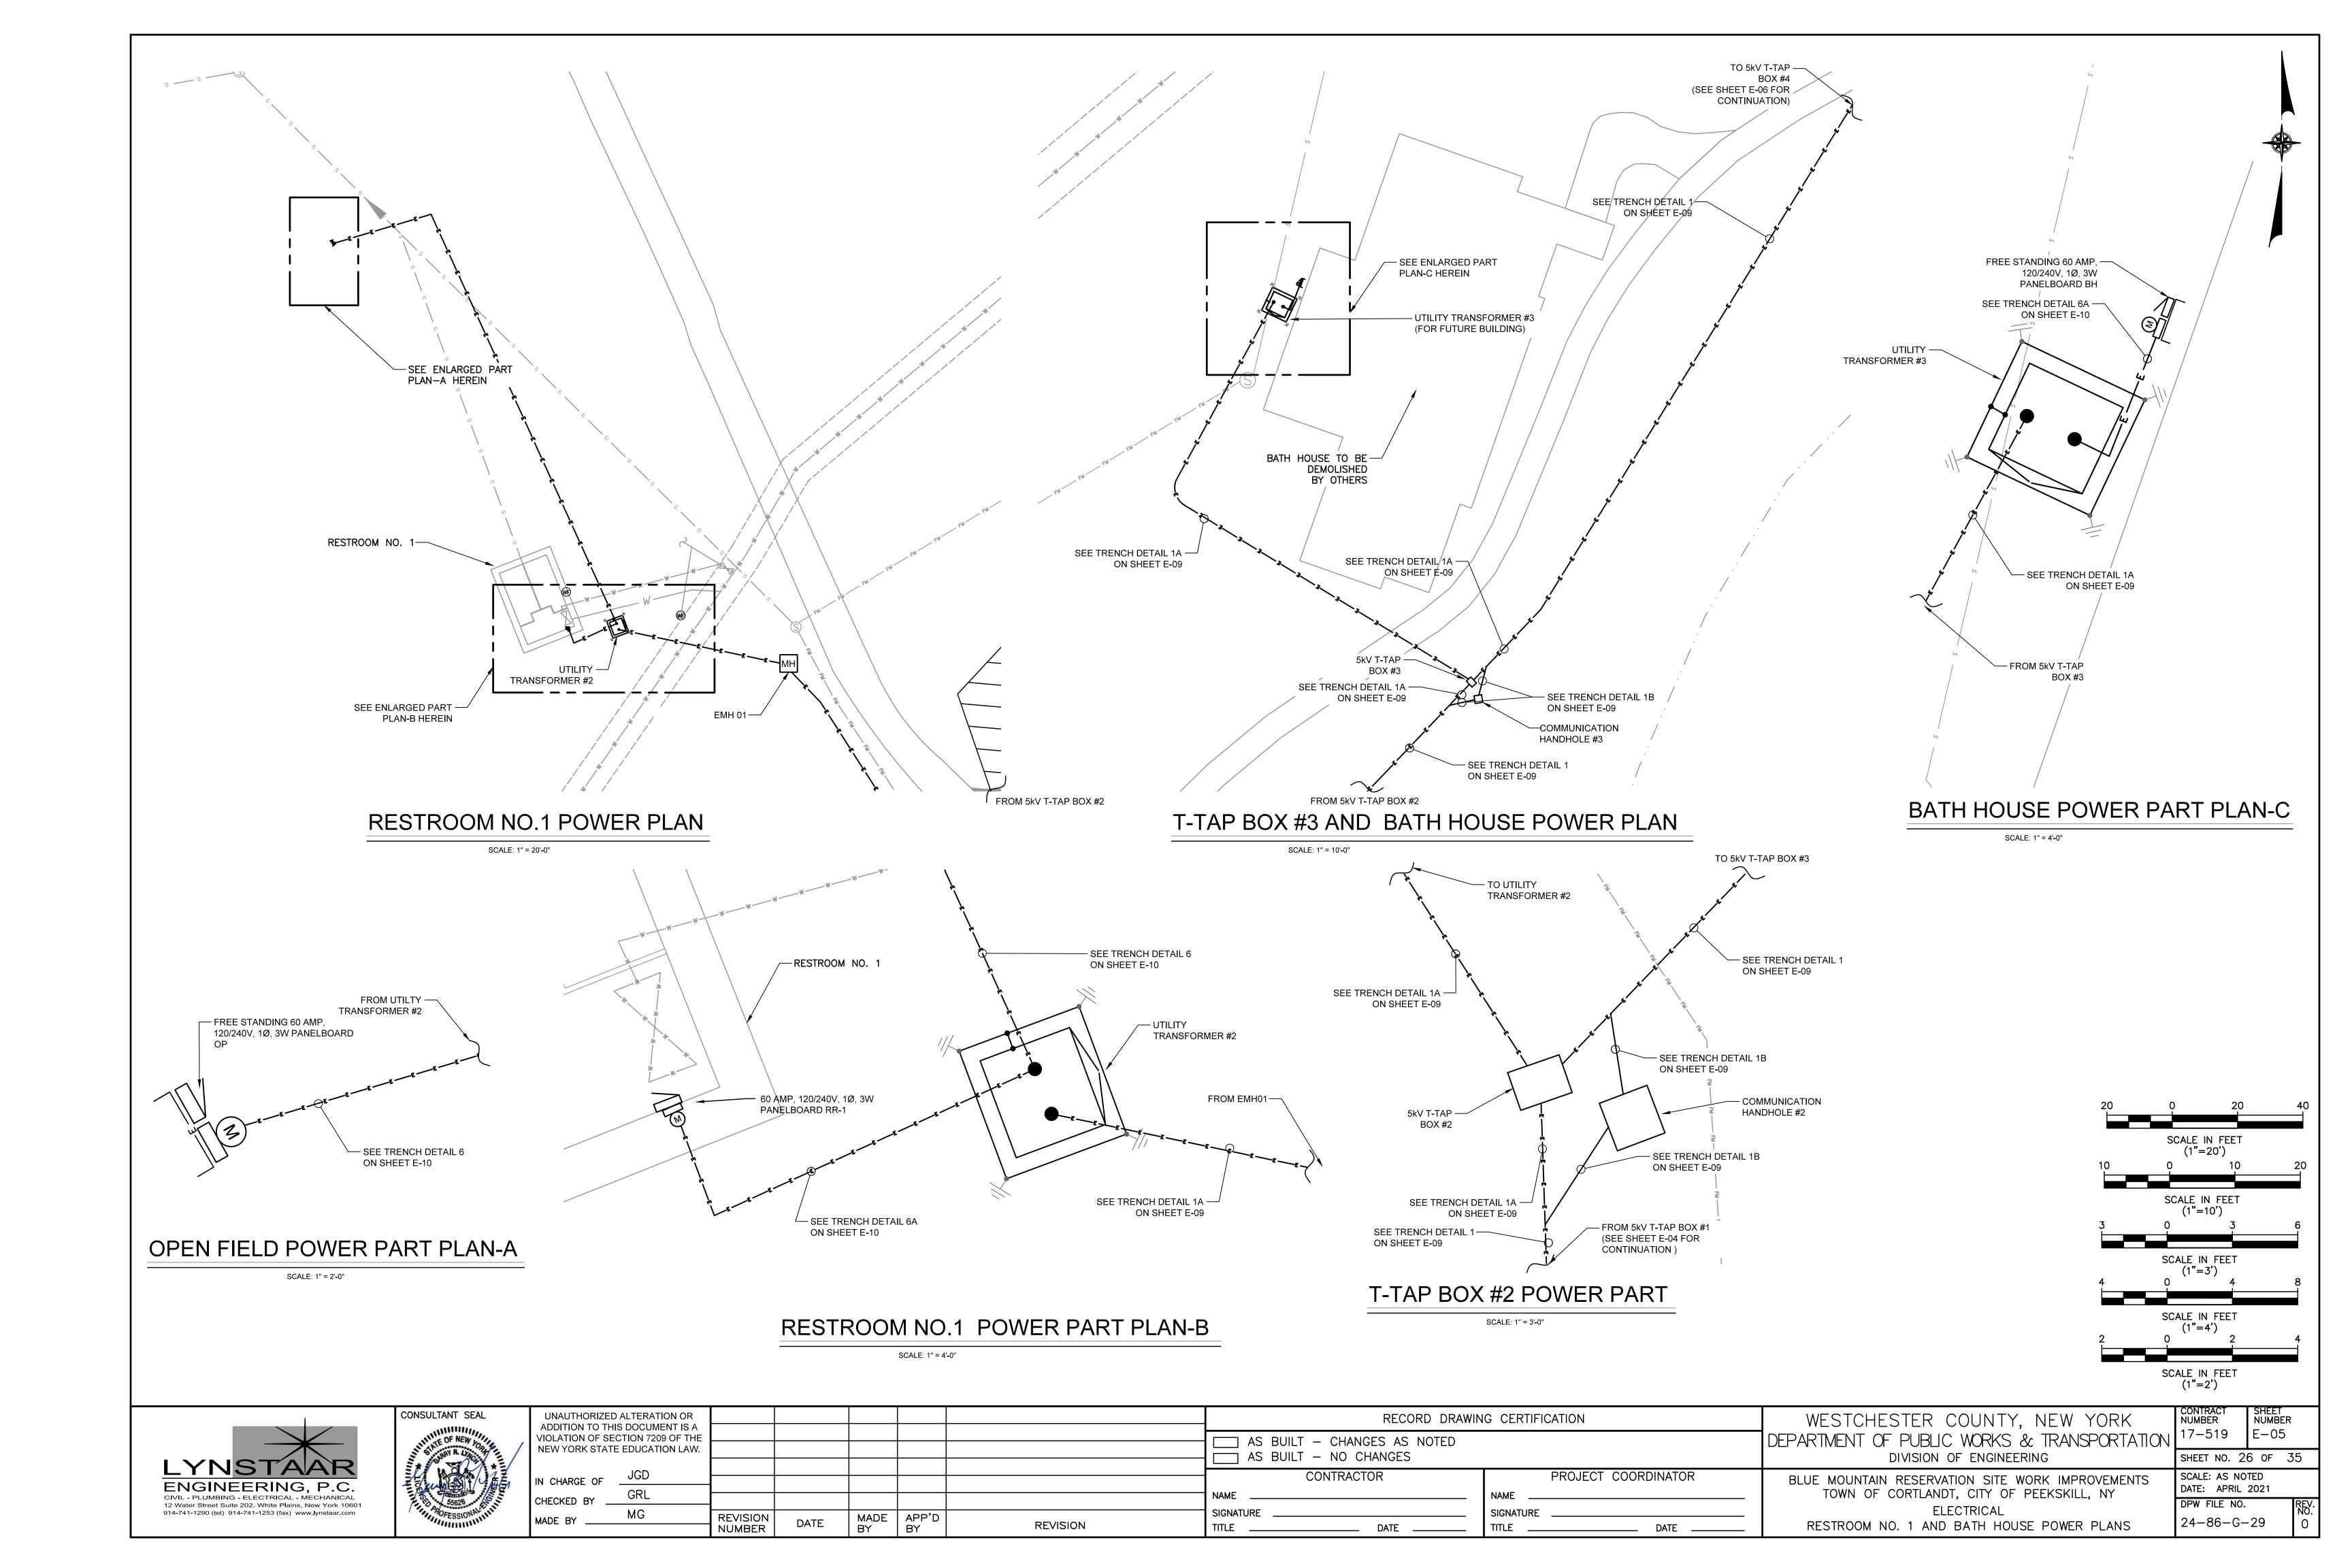
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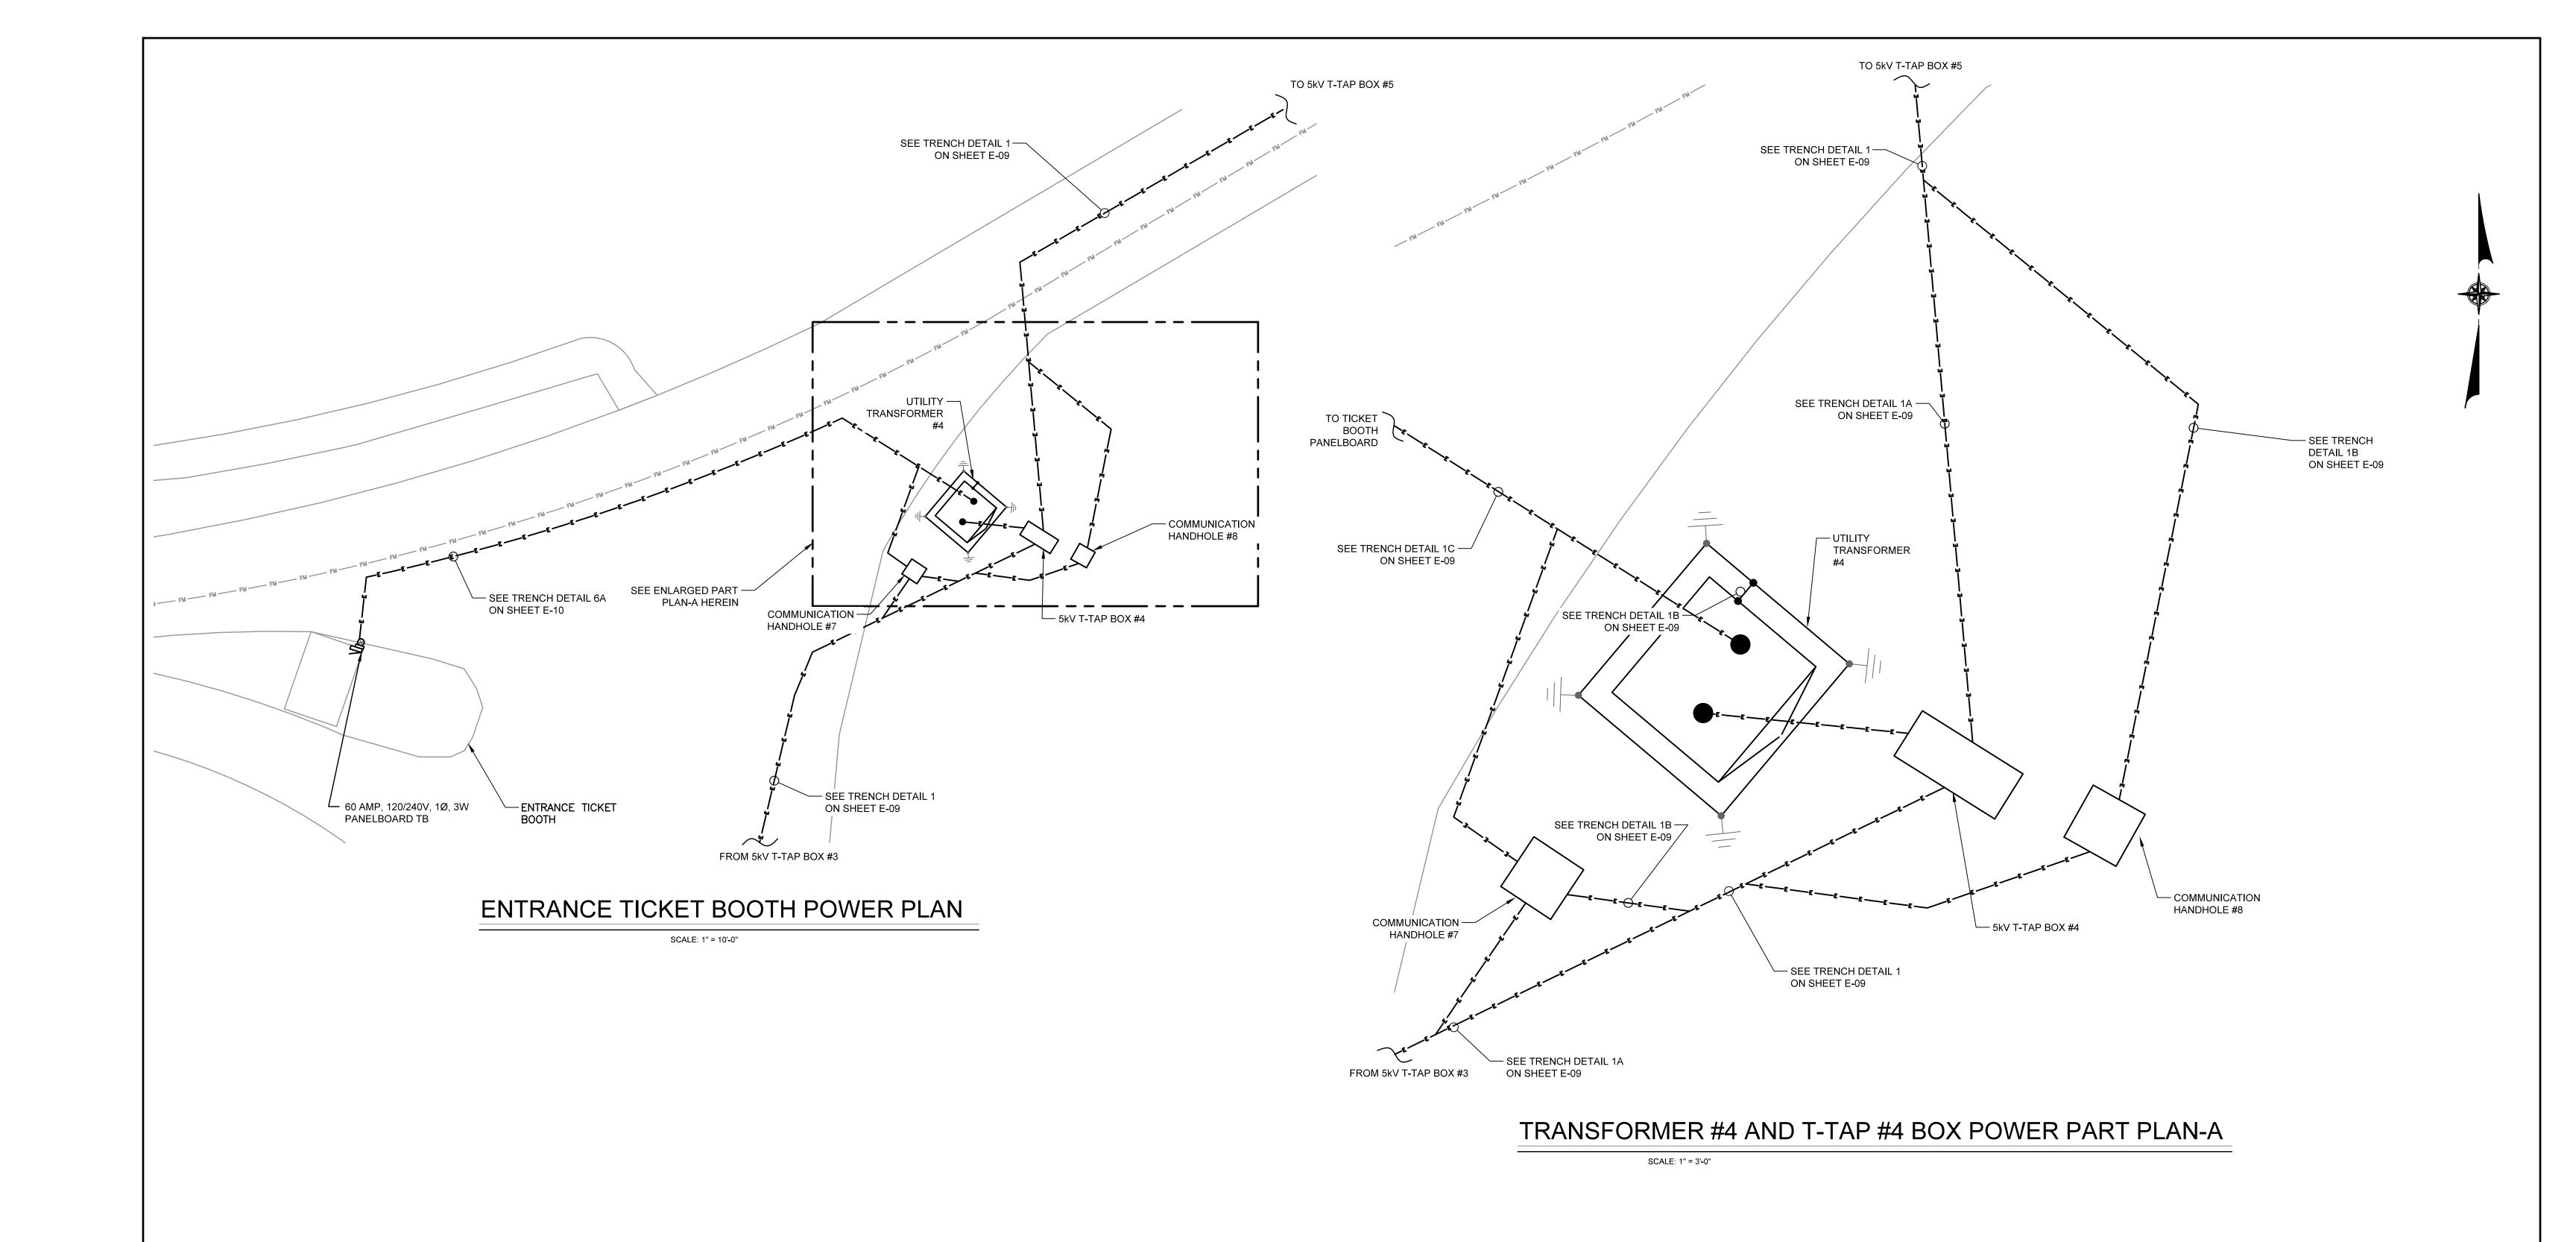
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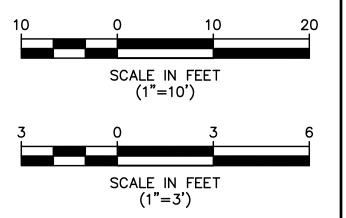
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CONTRACT NUMBER

ENTERANCE TICKET BOOTH POWER PLANS

SHEET NUMBER

SHEET NO. 27 OF 35

SCALE: AS NOTED

DATE: APRIL 2021

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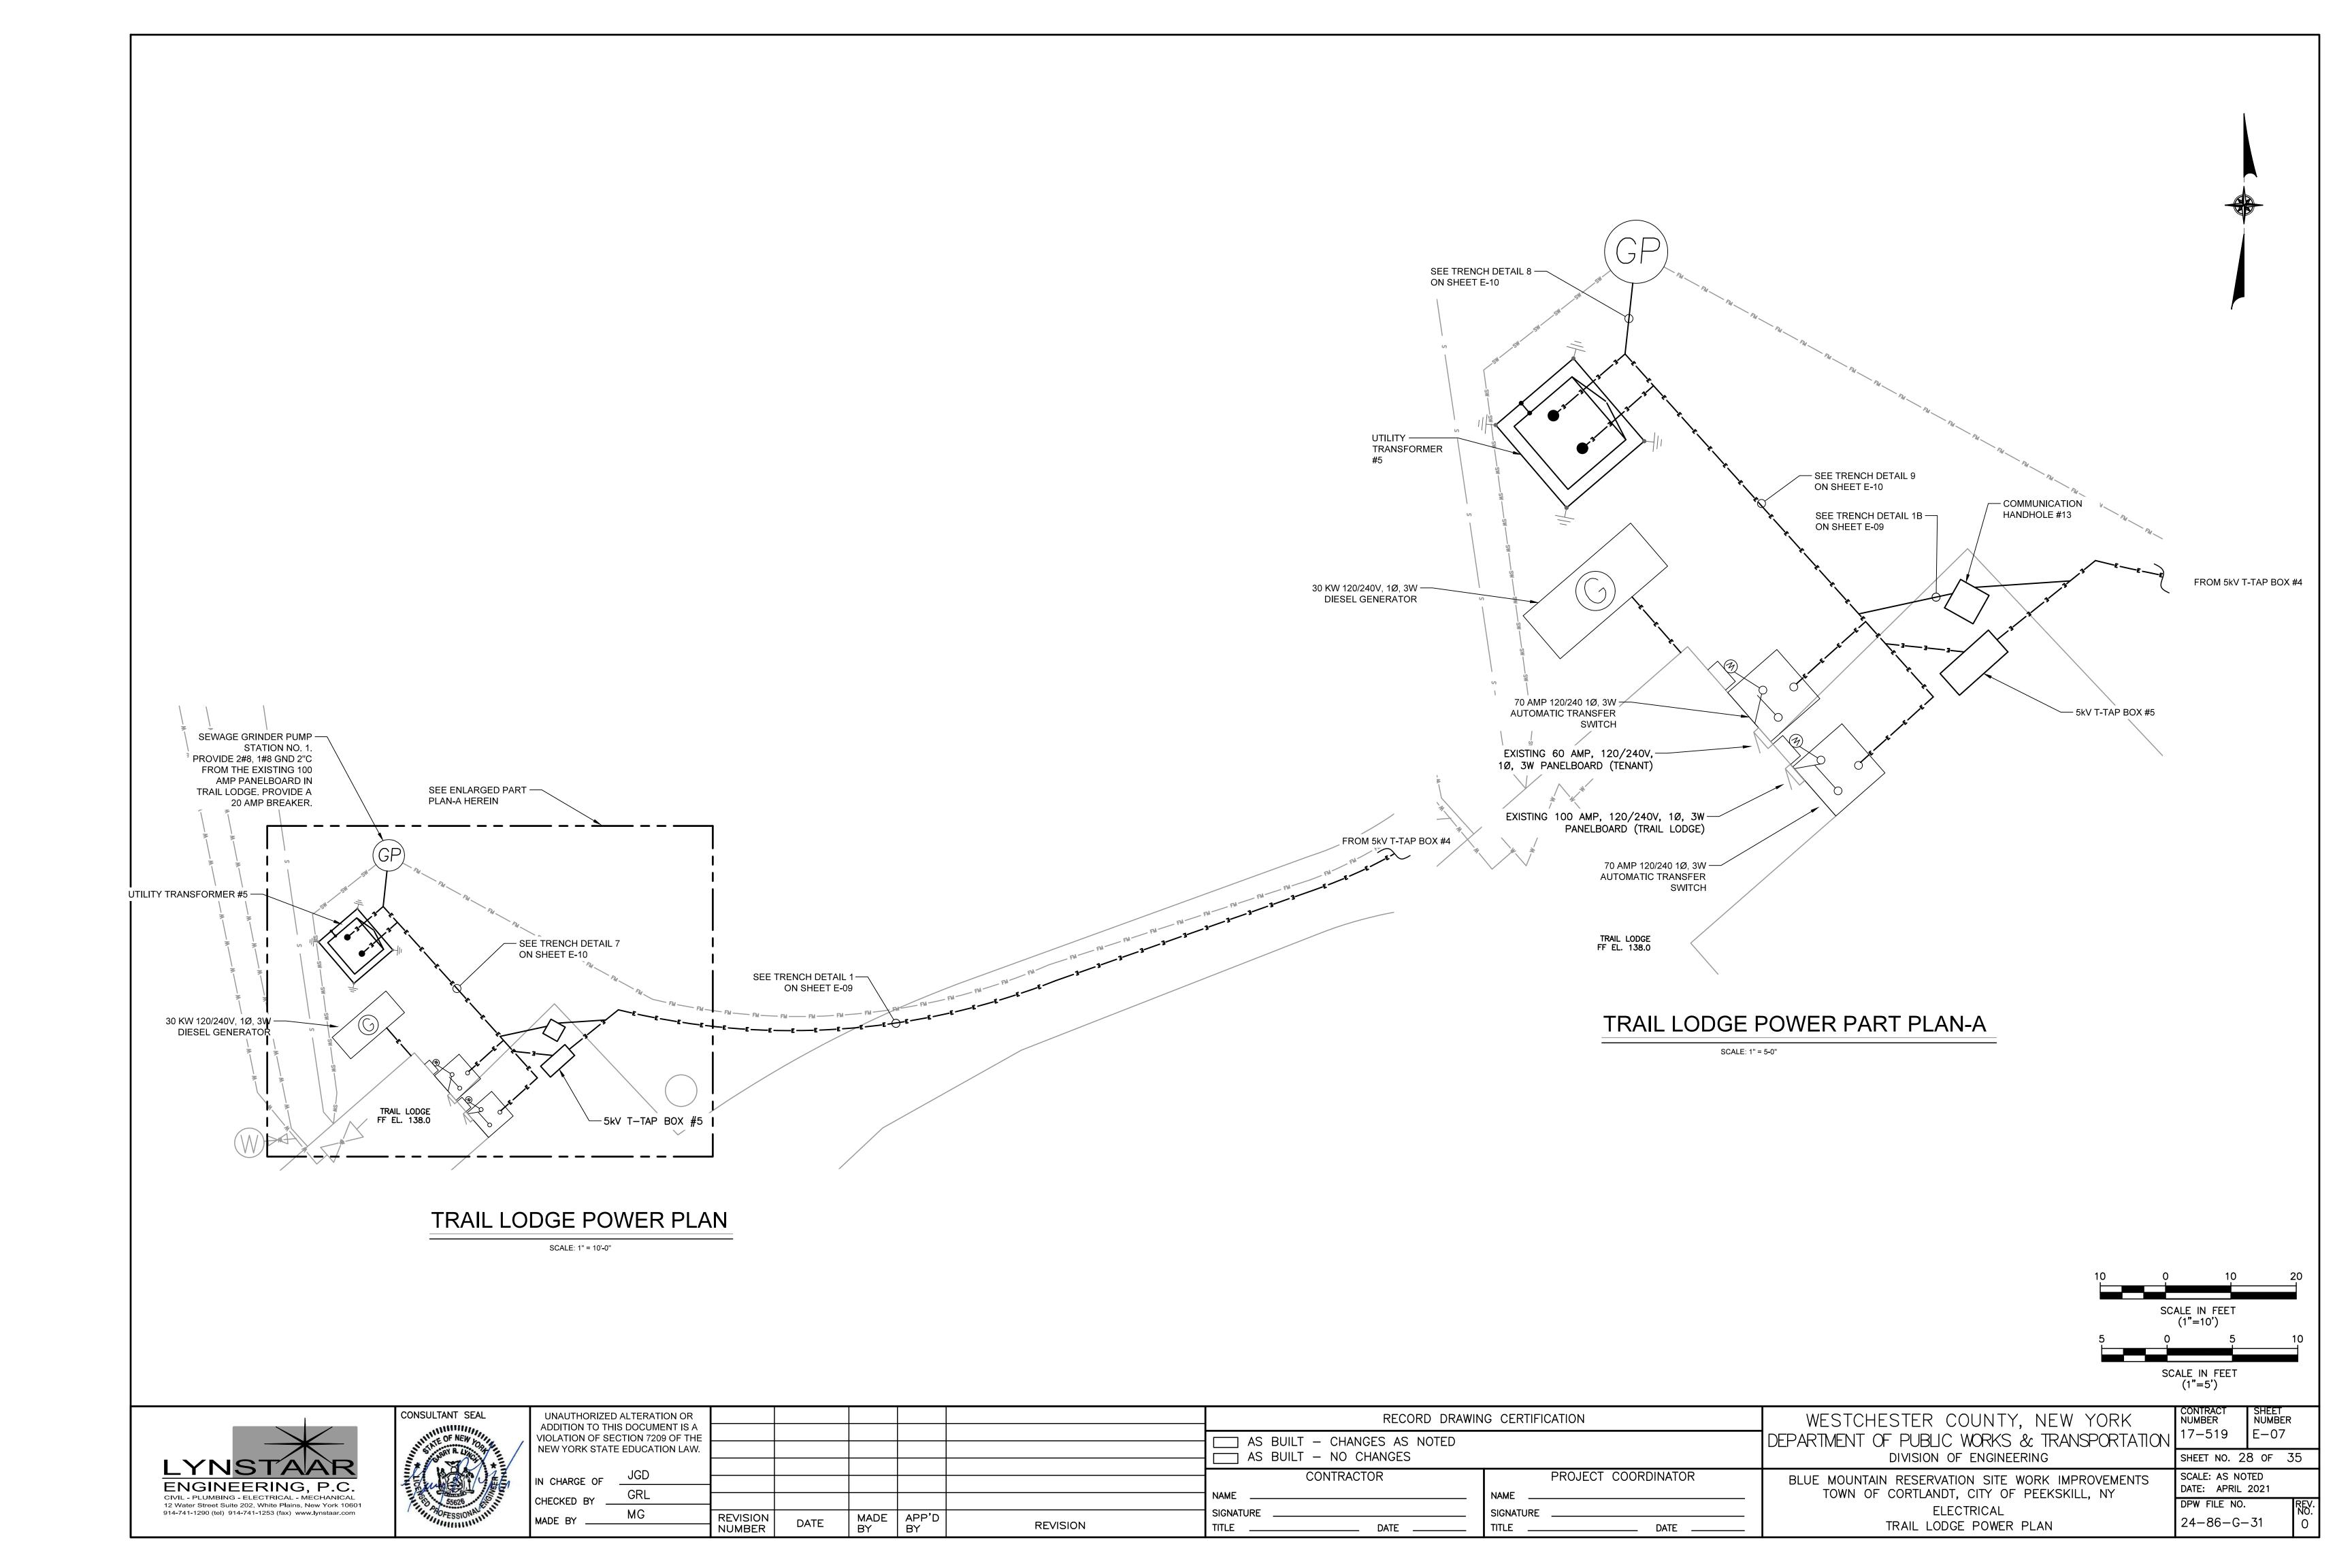
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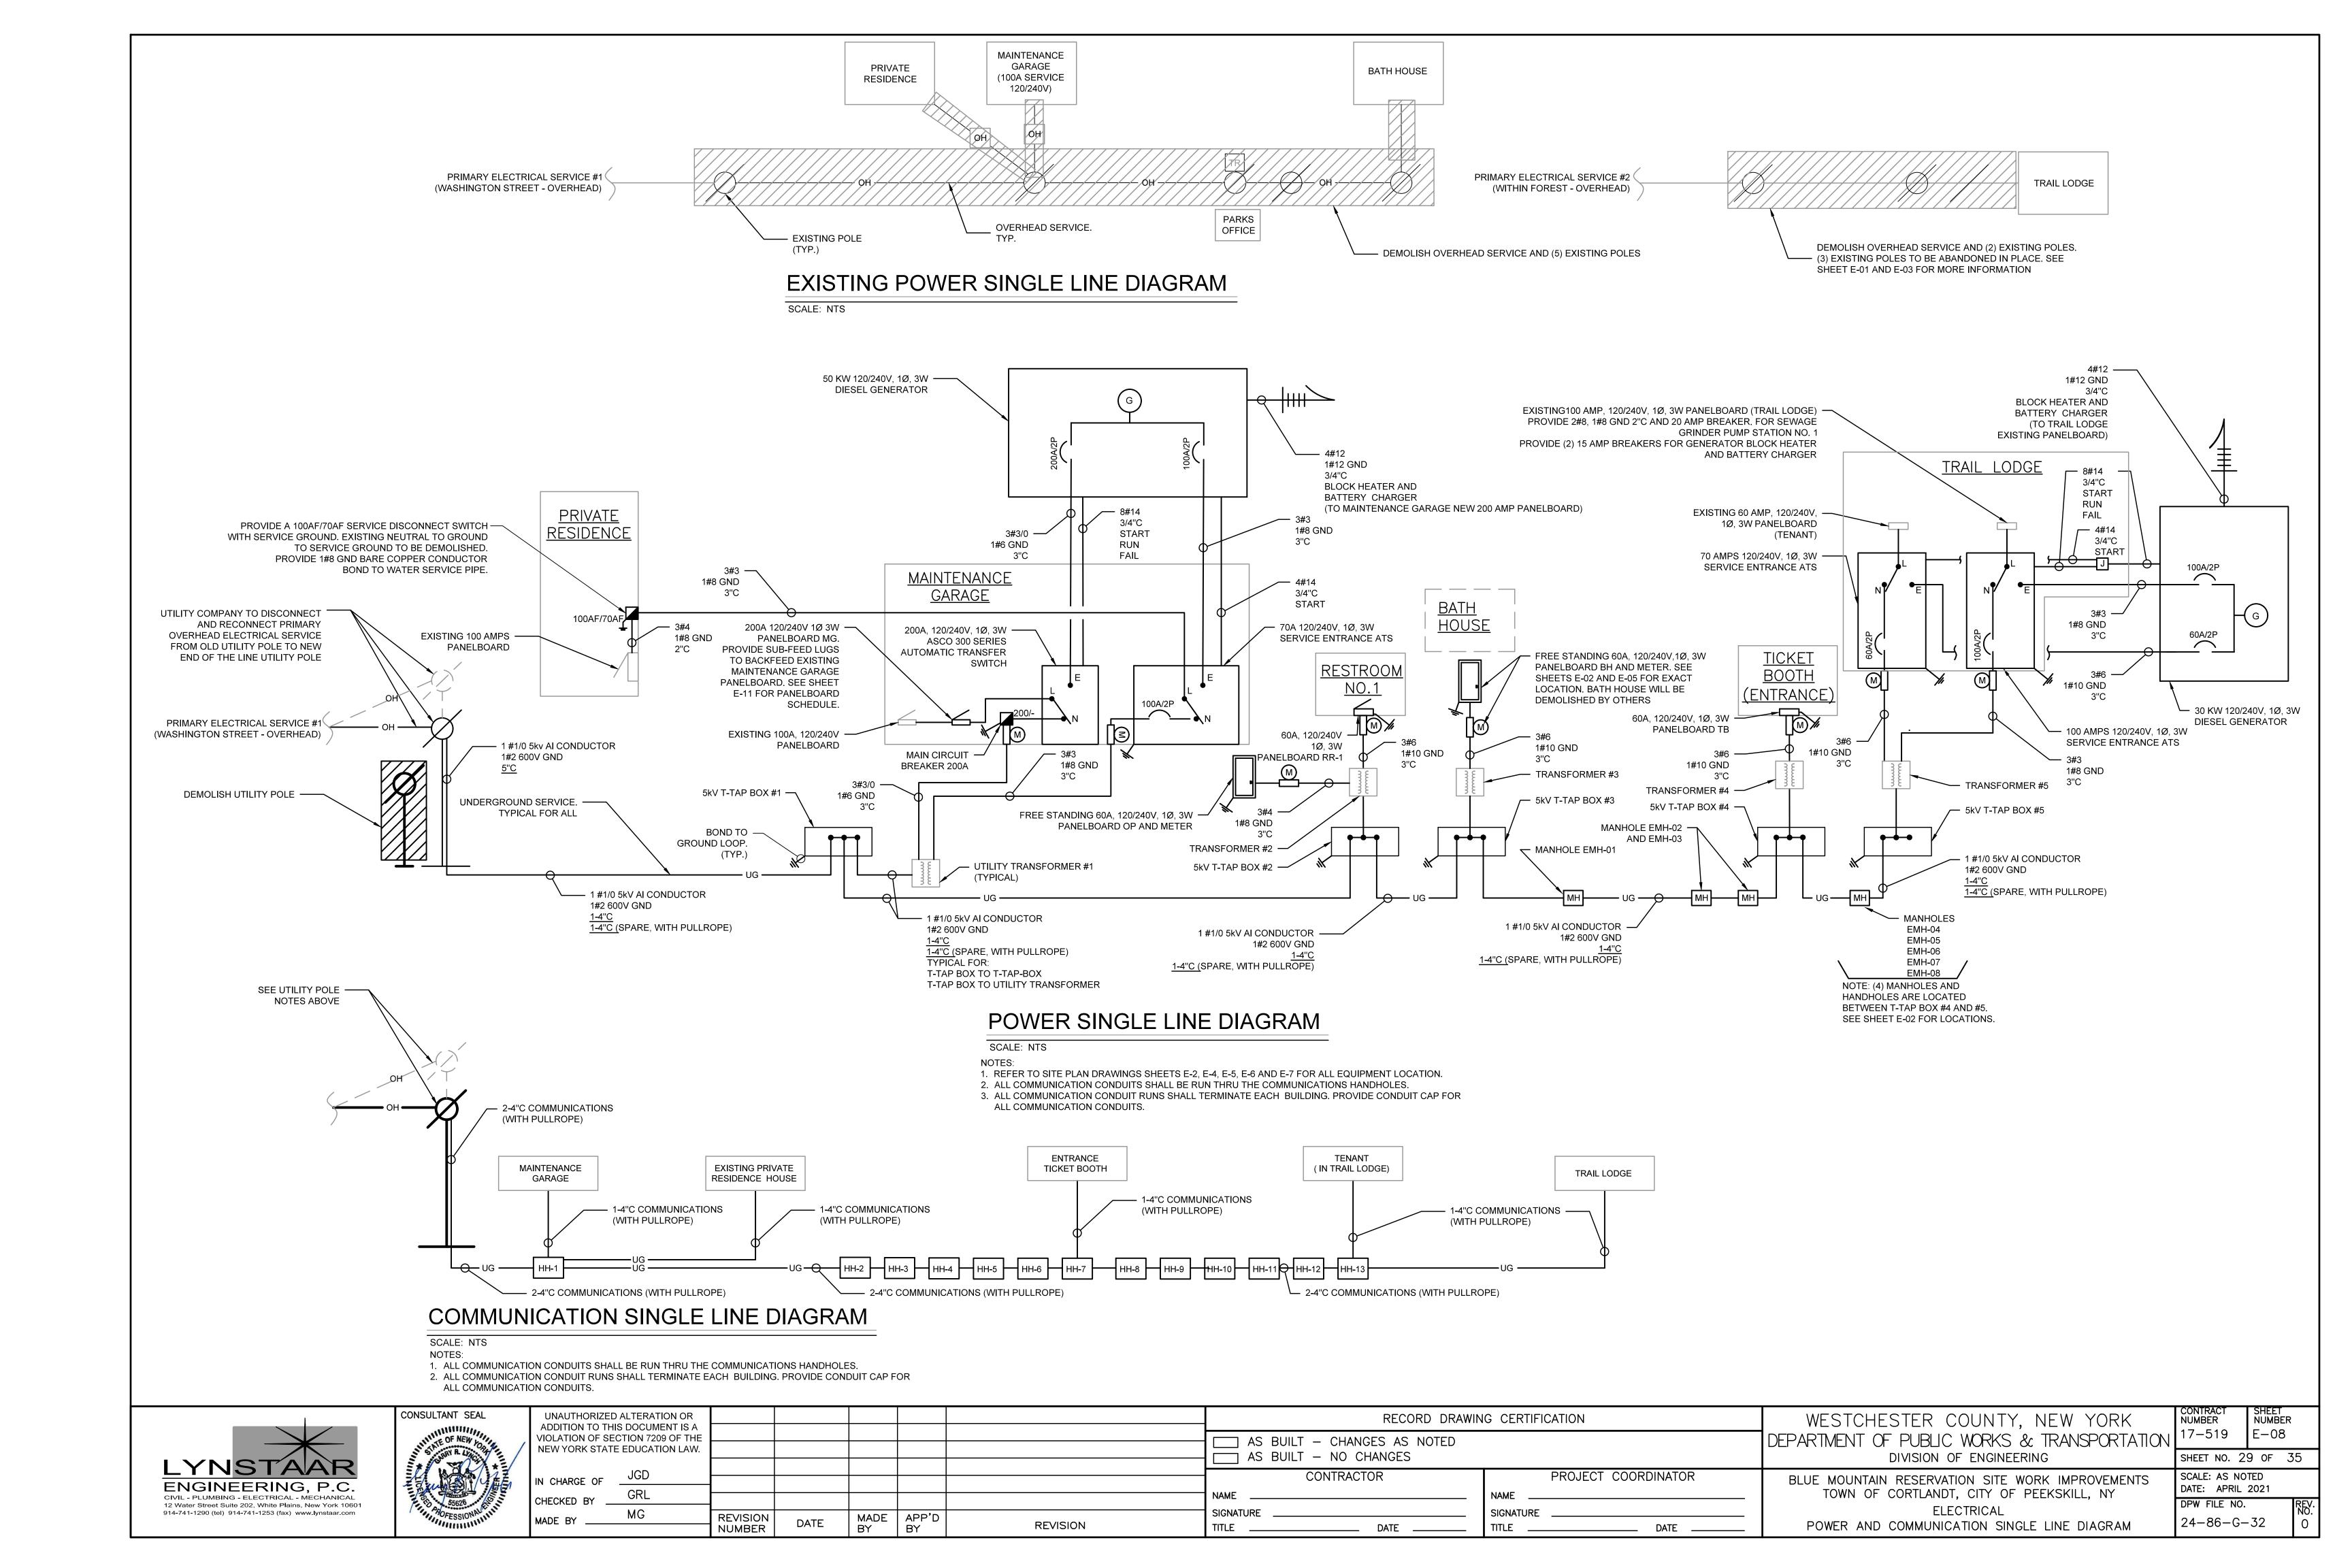
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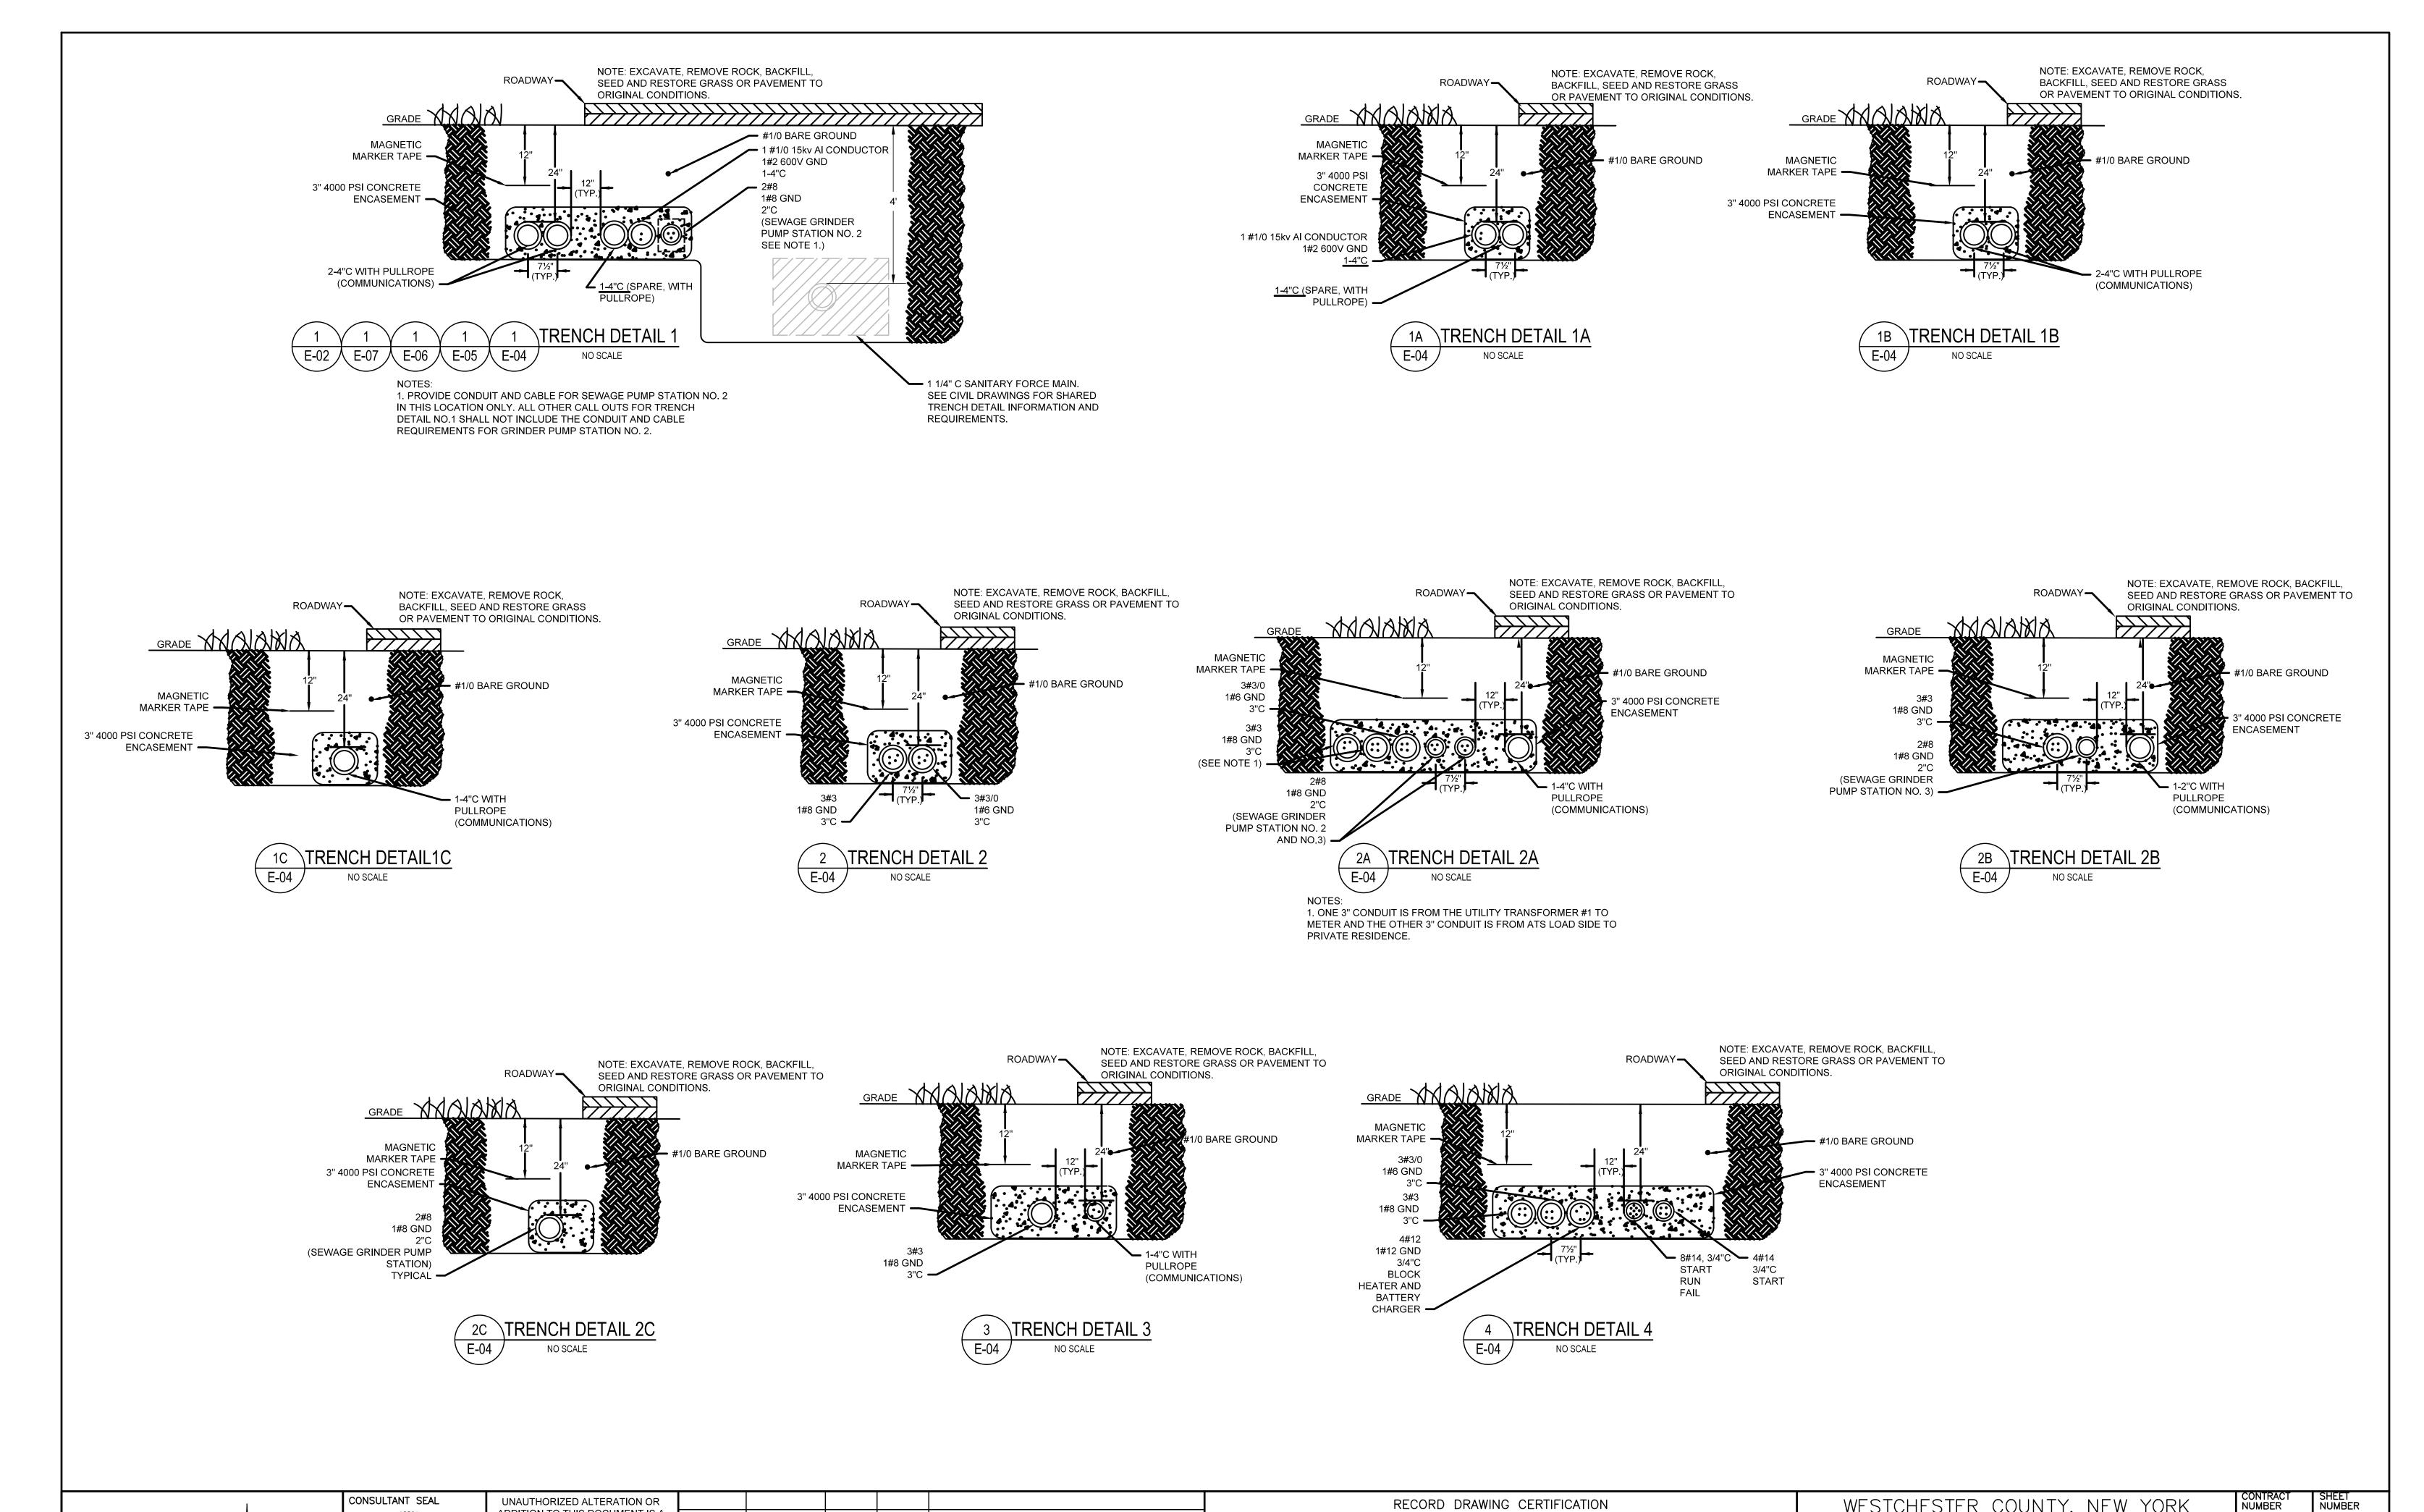
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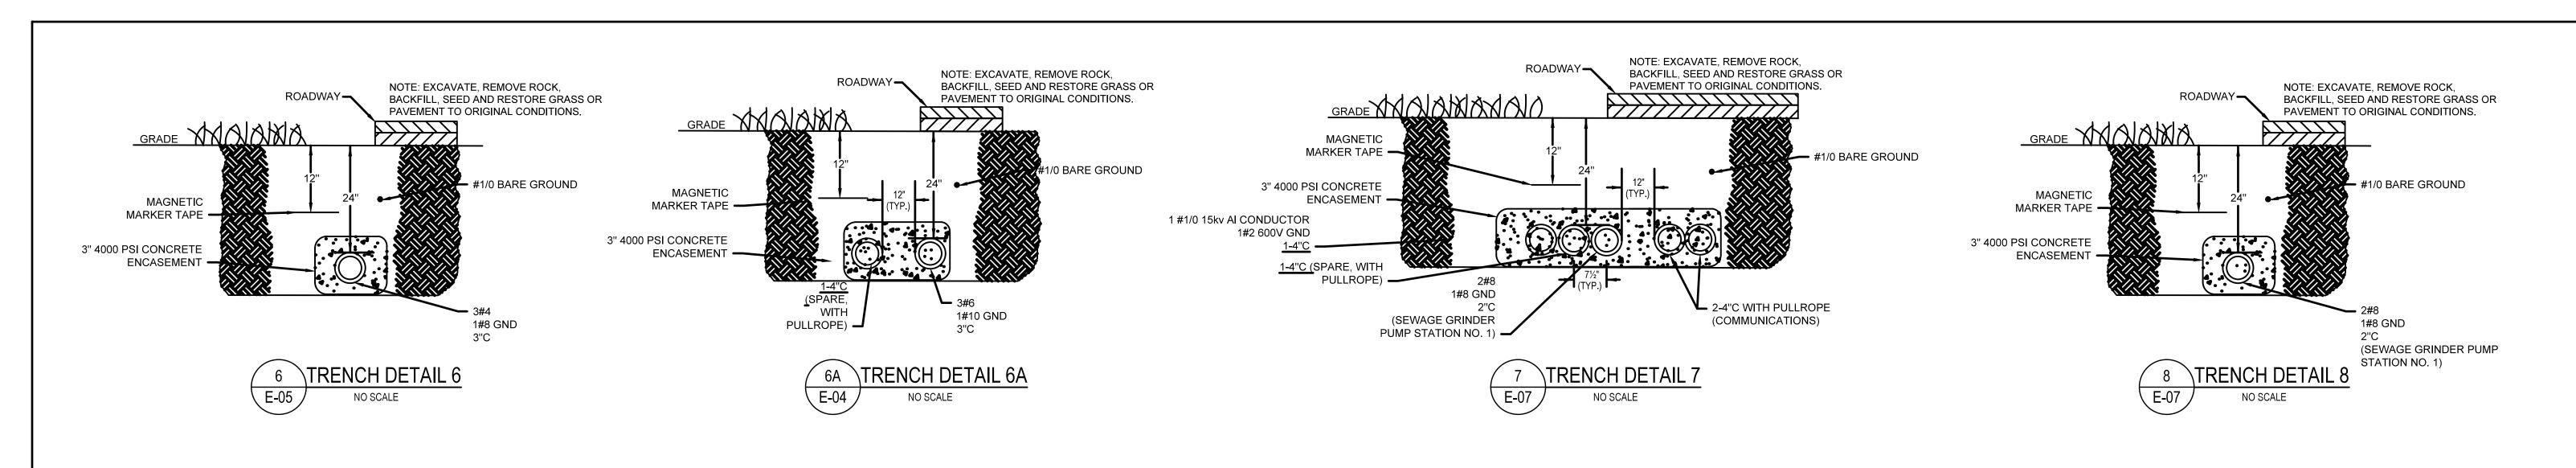
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PROJECT COORDINATOR	BLUE MOUNTAIN RESERVATION SITE WORK IMPROVEMENTS TOWN OF CORTLANDT, CITY OF PERKSKILL, NY


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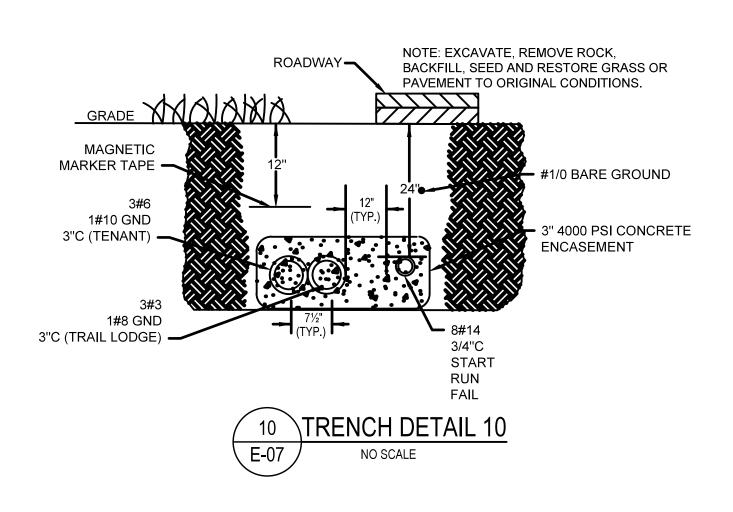
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CONTRACT NUMBER

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SHEET NO. 31 OF 35

SCALE: AS NOTED

DATE: APRIL 2021

24-86-G-34

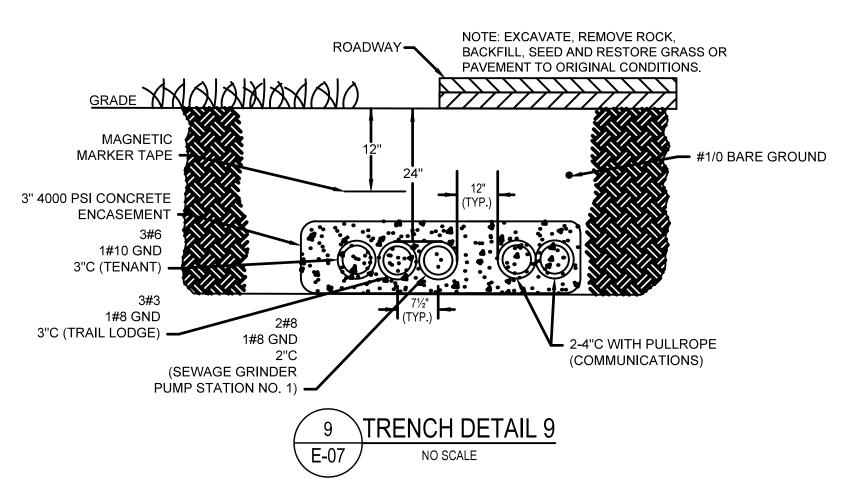DPW FILE NO.

TRENCH DETAILS II

PANELBOARD "MG"													
MAIN BUS RATINGS: 200, 120/240 VOLTS, 1 PHASE, 3 WIRE FED FROM: ATS/TRANSFORMER #1 MINIMUM SHORTCIRCUIT INTERRUPTION RATING: 22,000 AIC INCOMING FEED: 1-3/0 PER PHASE													
MAIN BREAKER TRIP:200A ENCLOSURE: NEMA 1 ESTIMATED CONNECTED LOAD: 30 KW													
DESCRIPTION	LOAD KW	CB TRIP/POLE	CIR. NO			CIR. NO	CB TRIP/POLE	LOAD KW	DESCRIPTION				
SPARE	0.0	20A/1P	1	A	В	2	20A/1P	0.0	SPARE				
SPARE	0.0	20A/1P	3			4	20A/1P	0.0	SPARE				
SPARE SPARE	0.0	20A/1P 20A/1P	5 7			6 8	20A/1P 20A/1P	0.0	SPARE SPARE				
SPARE	0.0	20A/1P	9			10	20A/1P	0.0	SPARE				
SPARE	0.0	20A/1P	11			12	20A/1P	0.0	SPARE				
SPARE SPARE	0.0	20A/1P 20A/1P	13 15			14 16	20A/1P 20A/1P	0.0	SPARE SPARE				
SPARE	0.0	20A/1P	17			18	20A/1P	0.0	SPARE				
SPARE SPARE	0.0	20A/1P 20A/1P	19 21			20 22	20A/1P 20A/1P	0.0	SPARE SPARE				
SPARE	0.0	20A/1P	23			24	20A/1P	0.0	SPARE				
SPARE SPARE	0.0	20A/1P 20A/1P	25 27			26 28	20A/1P 20A/1P	0.0	SPARE SPARE				
SPARE	0.0	20A/1P	29			30	20A/1P	0.0	SPARE				
SPARE	0.0	20A/1P	31			32	20A/1P	0.0	SPARE				
SPARE SPARE	0.0	20A/1P 20A/1P	33 35		, ,	34 36	20A/1P 20A/1P	0.0	SPARE SPARE				
BLOCK HEATER	1	20A/1P	37			38	20A/1P	1	BATTERY CHARGER				
GRINDER PS #2	3	20A/2P	39 41			40 42	20A/2P	3	GRINDER PS #3				

PANELBOARD "BH"															
MAIN BUS RATINGS	AIN BUS RATINGS: 100, 120/240 VOLTS, 1 PHASE, 3 WIRE FED FROM: TRANSFORMER #3														
MINIMUM SHORTCIF	INIMUM SHORTCIRCUIT INTERRUPTION RATING: 22,000 AIC INCOMING FEED: 1-6 PER PHASE														
MAIN BREAKER TRI	MAIN BREAKER TRIP:60A ENCLOSURE: NEMA 4														
ESTIMATED CONNE	STIMATED CONNECTED LOAD: 10 KW														
DESCRIPTION LOAD CB CIR. CB LOAD DESCRIPTION															
	KW	TRIP/POLE	NO			NO	TRIP/POLE	KW							
SPARE	0.0	20A/1P	1			2	20A/1P	0.0	SPARE						
SPARE	0.0	20A/1P	3			4	20A/1P	0.0	SPARE						
SPARE	0.0	20A/1P	5			6	20A/1P	0.0	SPARE						
SPARE	0.0	20A/1P	7			8	20A/1P	0.0	SPARE						
SPARE	0.0	20A/1P	9			10	20A/1P	0.0	SPARE						
SPARE	0.0	20A/1P	11			12	20A/1P	0.0	SPARE						
SPARE	0.0	20A/1P	13			14	20A/1P	0.0	SPARE						
SPARE	0.0	20A/1P	15			16	20A/1P	0.0	SPARE						
SPARE	0.0	20A/1P	17			18	20A/1P	0.0	SPARE						
SPARE	0.0	20A/1P	19			20	20A/1P	0.0	SPARE						
SPARE	0.0	20A/1P	21			22	20A/1P	0.0	SPARE						
SPARE	0.0	20A/1P	23			24	20A/1P	0.0	SPARE						
SPARE	0.0	20A/1P	25			26	20A/1P	0.0	SPARE						
SPARE	0.0	20A/1P	27			28	20A/2P	3	GRINDER PS #1						
SPARE	0.0	20A/1P	29			30	20//21		GININDLIN I O # I						

- 1. PROVIDE SUB-FEED LUGS TO BACKFEED EXISTING PANELBOARD IN MAINTENANCE GARAGE.
- 2. PROVIDE 2#12, 1#12 GND 1"C FROM PANELBOARD TO GRINDER PS #2.
- 3. PROVIDE 2#12, 1#12 GND 2"C FROM PANELBOARD TO GRINDER PS #3.
- 4. PROVIDE 2#12, 1#12 GND 3/4"C FROM PANELBOARD TO GENERATOR BLOCK HEATER.
- 5. PROVIDE 2#12, 1#12 GND 3/4"C FROM PANELNOARD TO GENERATOR BATTERY CHARGER.

PANELBOARD "RR-1"													
MAIN BUS RATINGS: 100, 120/240 VOLTS, 1 PHASE, 3 WIRE MINIMUM SHORTCIRCUIT INTERRUPTION RATING: 22,000 AIC MAIN BREAKER TRIP:60A ENCLOSURE: NEMA 1 ESTIMATED CONNECTED LOAD: 10 KW													
DESCRIPTION LOAD CB CIR. CB LOAD DESCRIPTION KW TRIP/POLE NO NO TRIP/POLE KW													
				Α	В								
SPARE	0.0	20A/1P	1		$\overline{}$	2	20A/1P	0.0	SPARE				
SPARE	0.0	20A/1P	3			4	20A/1P	0.0	SPARE				
SPARE	0.0	20A/1P	5			6	20A/1P	0.0	SPARE				
SPARE	0.0	20A/1P	7			8	20A/1P	0.0	SPARE				
SPARE	0.0	20A/1P	9			10	20A/1P	0.0	SPARE				
SPARE	0.0	20A/1P	11			12	20A/1P	0.0	SPARE				

PANELBOARD "TB"													
MAIN BUS RATINGS: 100, 120/240 VOLTS, 1 PHASE, 3 WIRE FED FROM: TRANSFORMER #4													
MINIMUM SHORTCIRCUIT INTERRUPTION RATING: 22,000 AIC INCOMING FEED: 1-6 PER PHASE													
MAIN BREAKER TRIP:	MAIN BREAKER TRIP:60A ENCLOSURE: NEMA 1												
ESTIMATED CONNEC	ESTIMATED CONNECTED LOAD: 10 KW												
DESCRIPTION	DESCRIPTION LOAD CB CIR. CB LOAD DESCRIPTION												
	KW	TRIP/POLE	NO				NO	TRIP/POLE	KW				
				F	4	В							
SPARE	0.0	20A/1P	1		-	\bigcap	2	20A/1P	0.0	SPARE			
SPARE	0.0	20A/1P	3				4	20A/1P	0.0	SPARE			
SPARE	0.0	20A/1P	5				6	20A/1P	0.0	SPARE			
SPARE 0.0 20A/1P 7 8 20A/1P 0.0 SPARE													
SPARE	0.0	20A/1P	9				10	20A/1P	0.0	SPARE			
SPARE	0.0	20A/1P	11				12	20A/1P	0.0	SPARE			

PANELBOARD "OP"								
MAIN BUS RATINGS:	MAIN BUS RATINGS: 100, 120/240 VOLTS, 1 PHASE, 3 WIRE FED FROM: TRANSFORMER #2							
MINIMUM SHORTCIRC	TNI TIU	ERRUPTIO	N RA	TING: 22,000 AIC	INC	COMING FE	ED: 1-4	PER PHASE
MAIN BREAKER TRIP:	30A				EN	CLOSURE:	NEM	1A 4
ESTIMATED CONNECT	ESTIMATED CONNECTED LOAD: 10 KW							
DESCRIPTION	LOAD	СВ	CIR.		CIR.	СВ	LOAD	DESCRIPTION
	KW	TRIP/POLE	NO		NO	TRIP/POLE	KW	
				A B				
SPARE	0.0	20A/1P	1		2	20A/1P	0.0	SPARE
SPARE	0.0	20A/1P	3		4	20A/1P	0.0	SPARE
SPARE	0.0	20A/1P	5		6	20A/1P	0.0	SPARE
SPARE	0.0	20A/1P	7		8	20A/1P	0.0	SPARE
SPARE	0.0	20A/1P	9		10	20A/1P	0.0	SPARE
SPARE	0.0	20A/1P	11		12	20A/1P	0.0	SPARE





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DATE ___


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ENGINEERING E MOUNTAIN RESERVATION SITE WORK IMPROVEMENTS TOWN OF CORTLANDT, CITY OF PEEKSKILL, NY ELECTRICAL PANELBOARD SCHEDULES


COUNTY, NEW YORK

WORKS & TRANSPORTATION 17-519 CONTRACT NUMBER SHEET NUMBER E-11 SHEET NO. 32 OF 35 SCALE: AS NOTED DATE: APRIL 2021 DPW FILE NO. 24-86-G-35



30 KW AND 50 KW GENERATOR - OUTLET VIEW

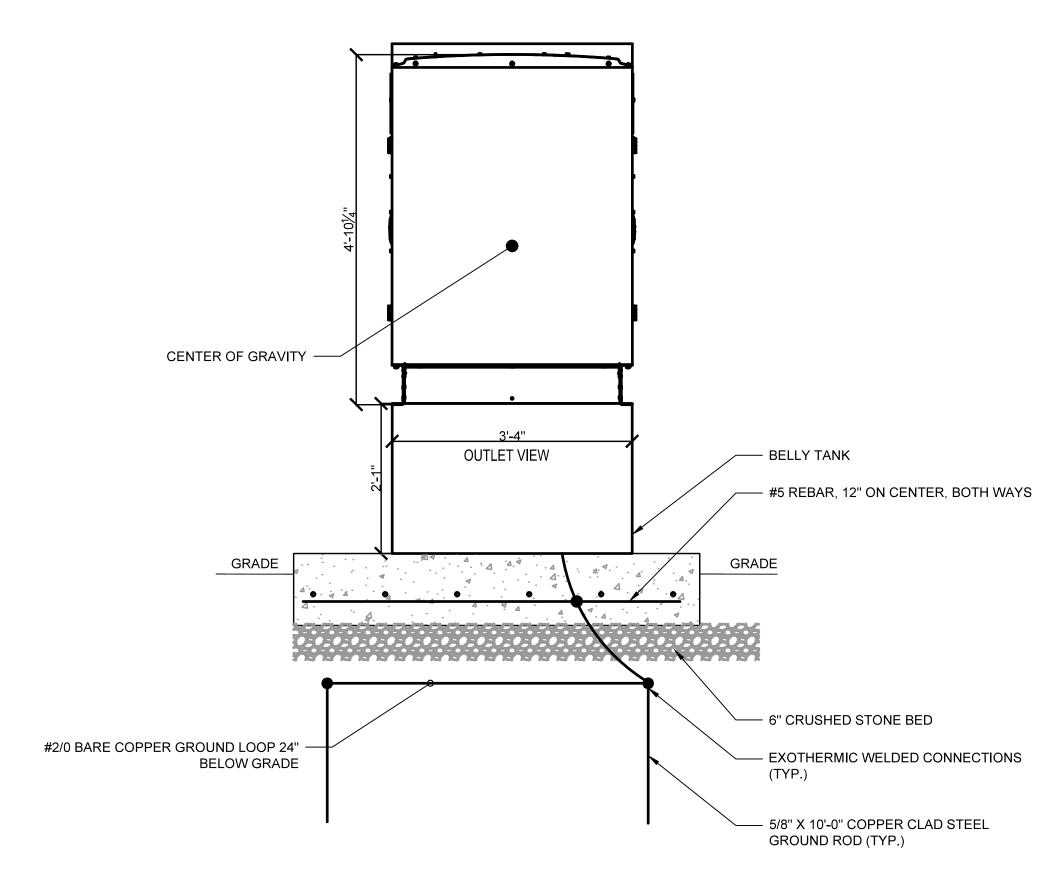SCALE: 3/4" = 1'-0"

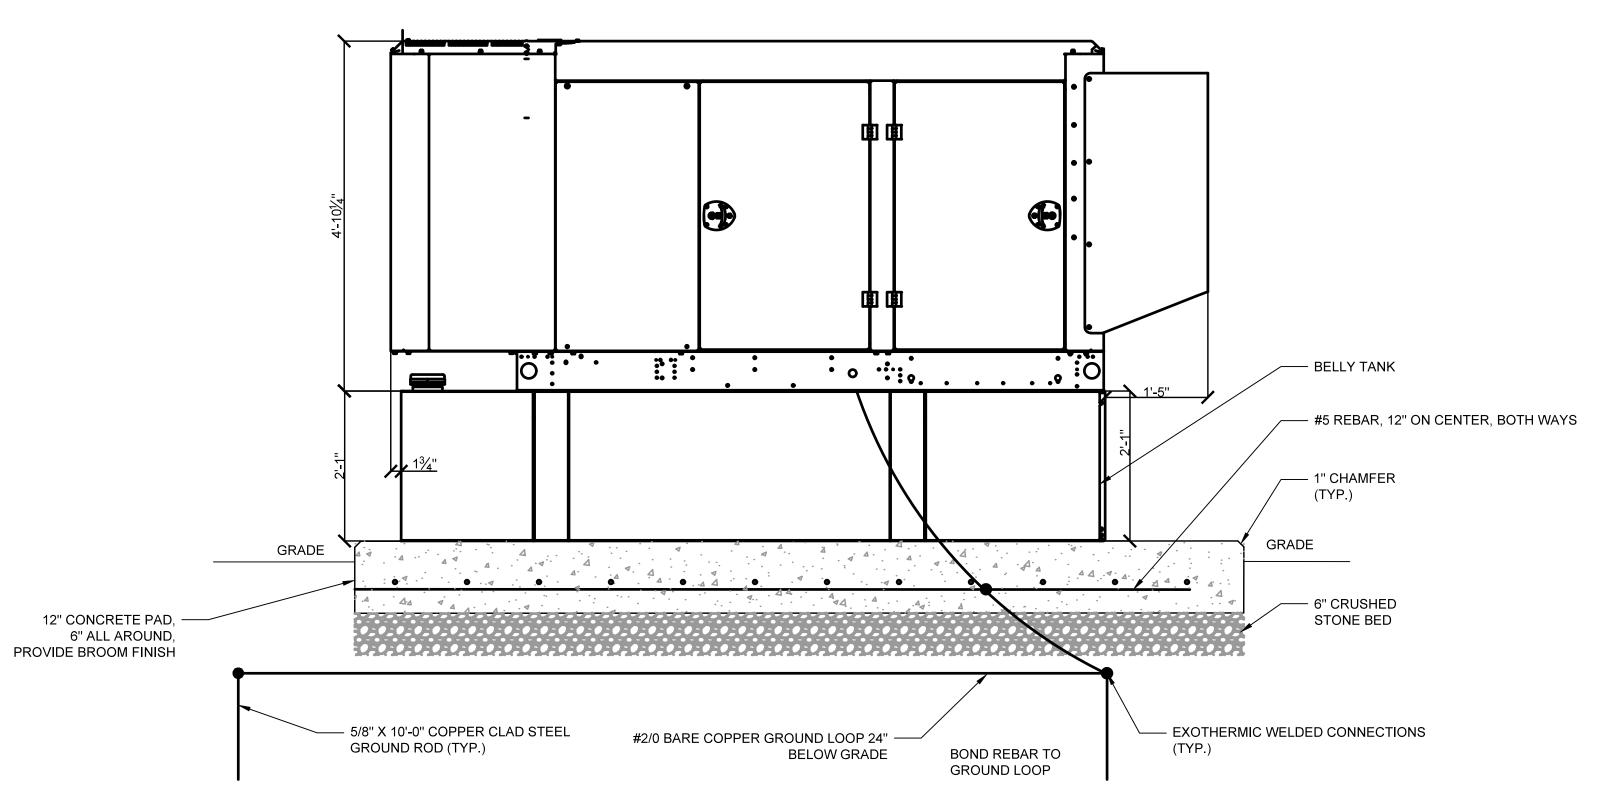


BELLY TANK - #5 REBAR, 12" ON CENTER, BOTH WAYS GRADE - 6" CRUSHED STONE BED #2/0 BARE COPPER GROUND LOOP 24" **BELOW GRADE** - EXOTHERMIC WELDED CONNECTIONS - 5/8" X 10'-0" COPPER CLAD STEEL GROUND ROD (TYP.)


- AIR INTAKE AREAS

30 KW AND 50 KW GENERATOR - INTAKE VIEW

SCALE: 3/4" = 1'-0"

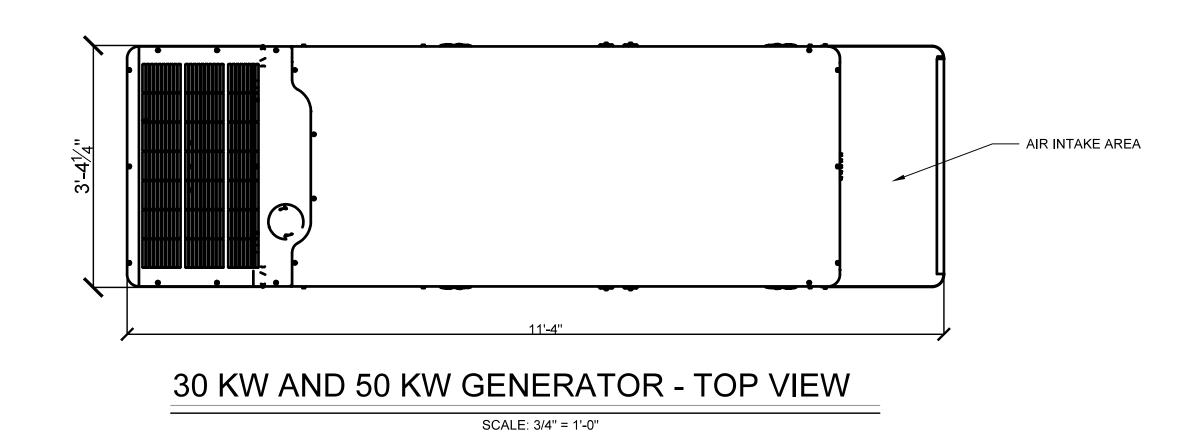

DATE .

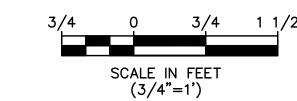

30 KW AND 50 KW GENERATOR - REAR VIEW

SCALE: 3/4" = 1'-0"

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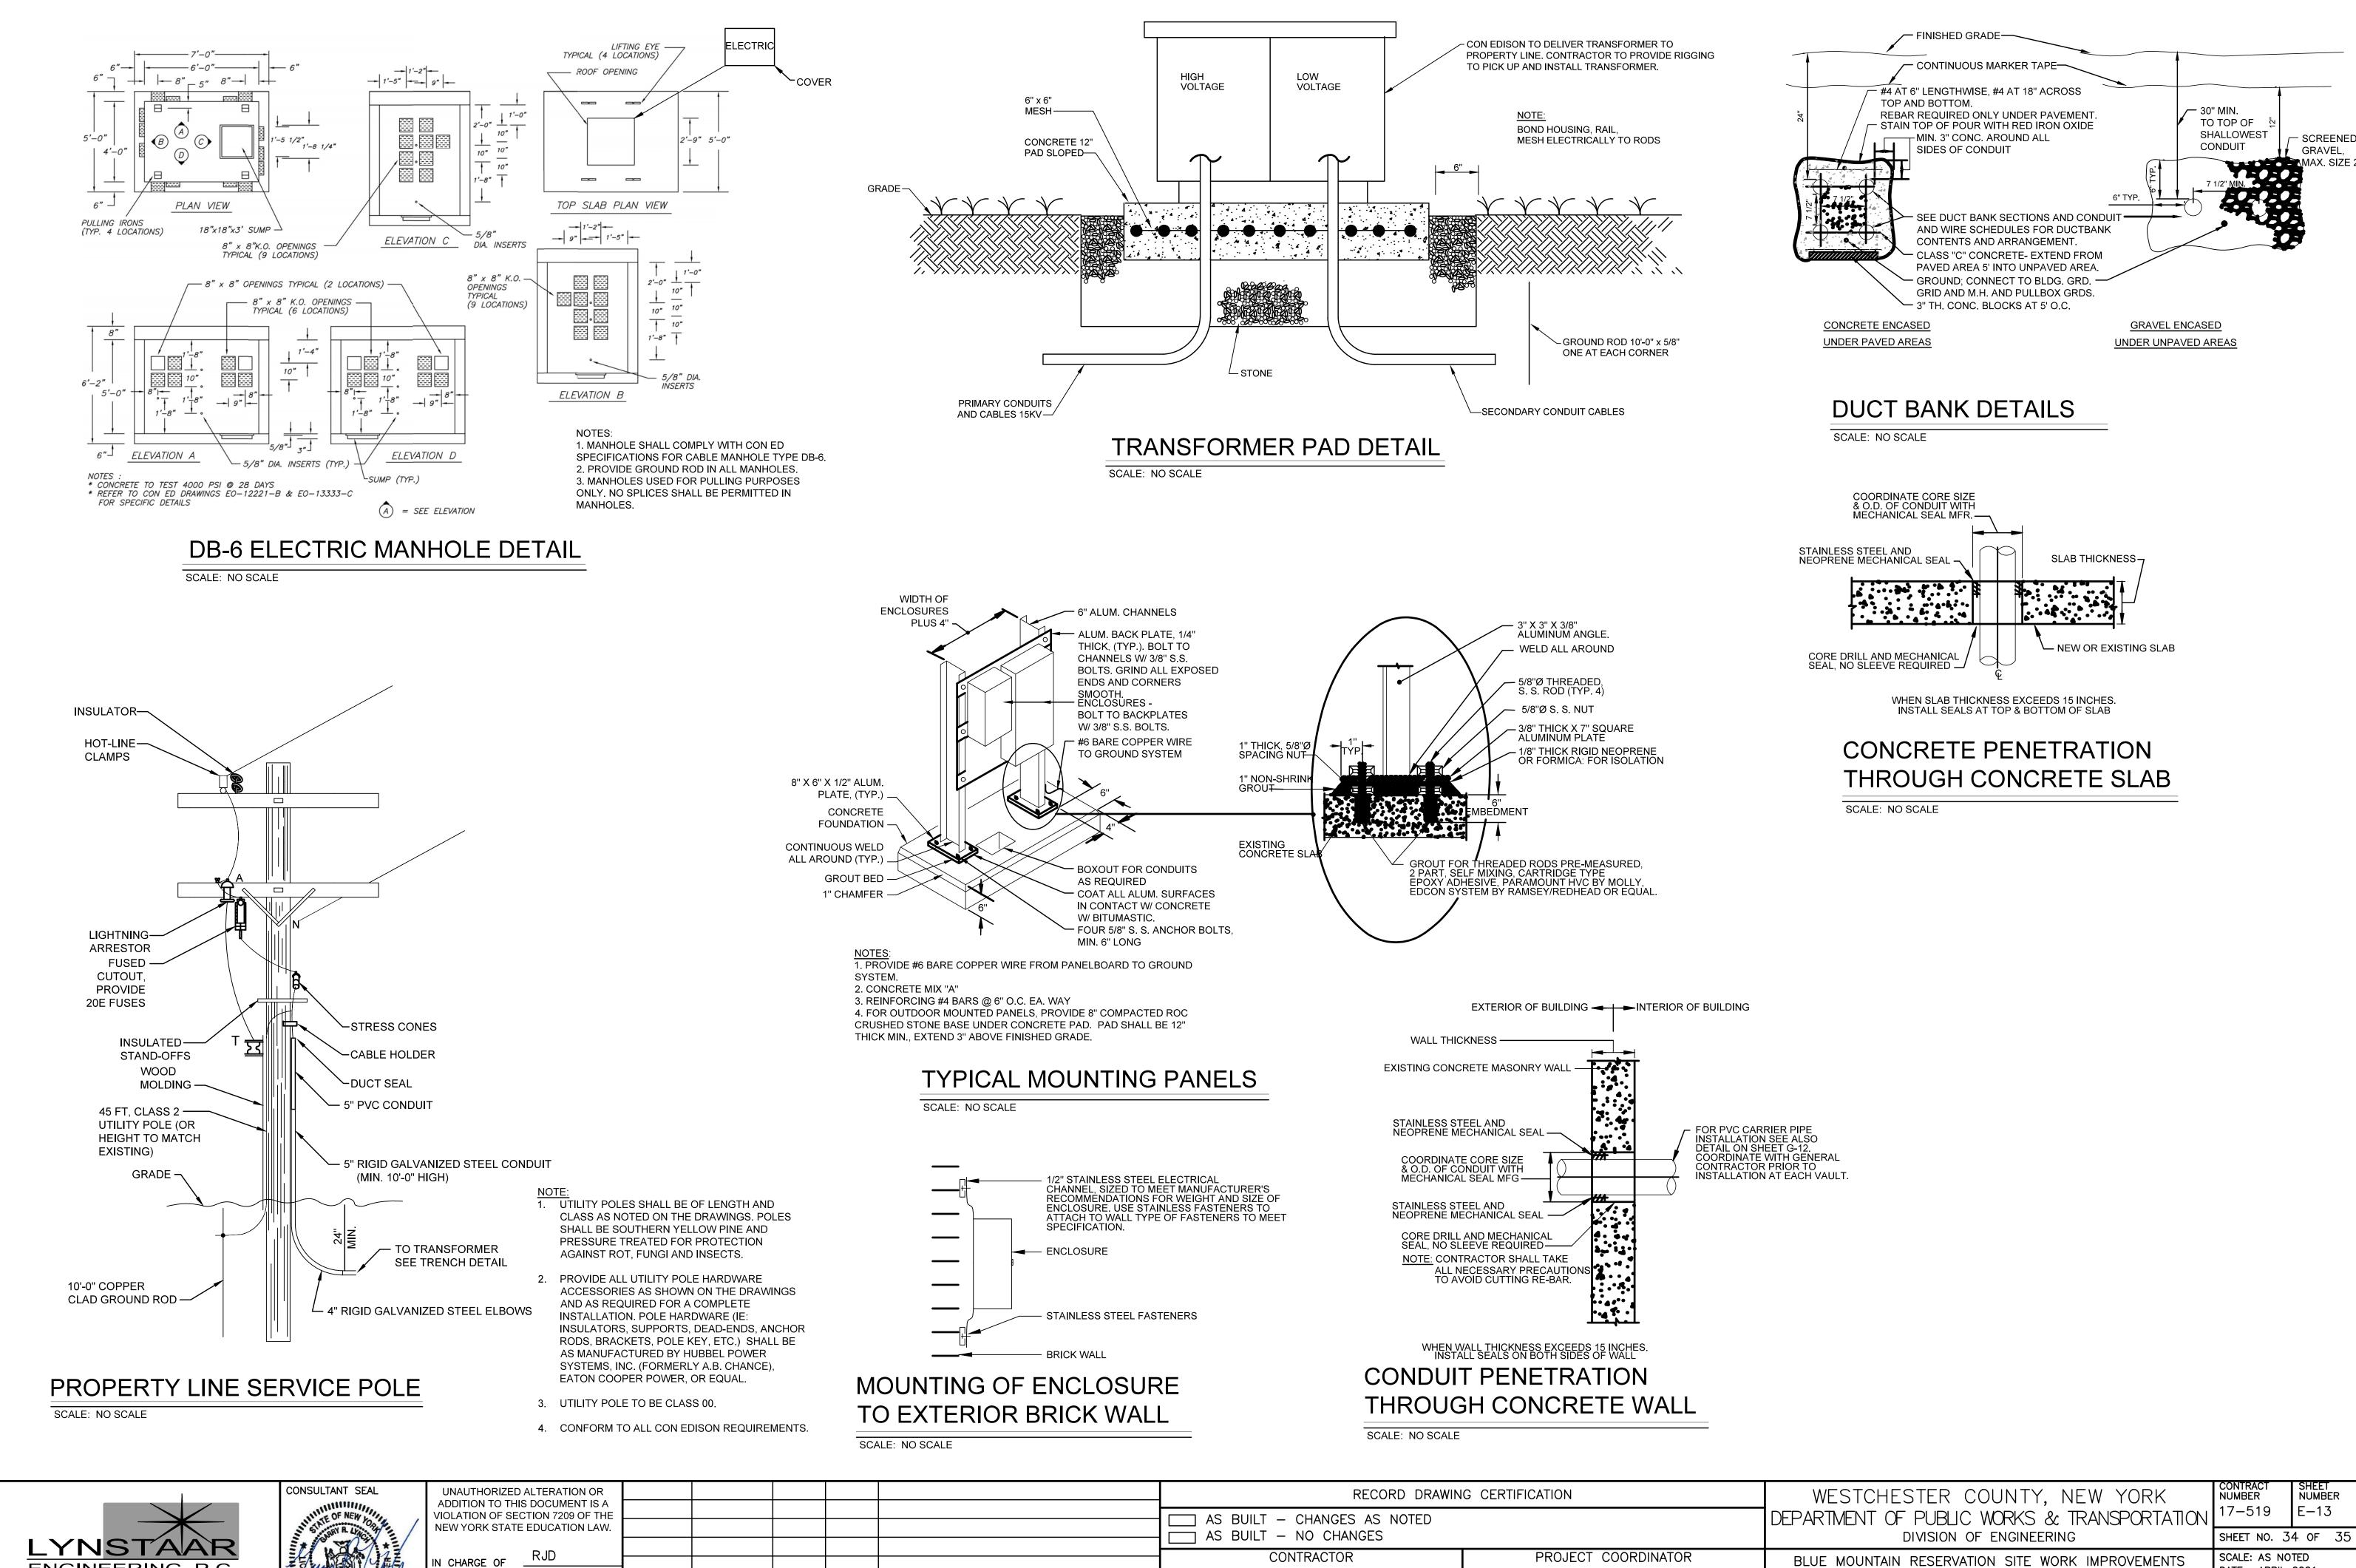
DATE ___

DEPARTMENT OF PUBLIC WORKS & TRANSPORTATION DIVISION OF ENGINEERING BLUE MOUNTAIN RESERVATION SITE WORK IMPROVEMENTS TOWN OF CORTLANDT, CITY OF PEEKSKILL, NY

WESTCHESTER COUNTY, NEW YORK

CONTRACT NUMBER SHEET NUMBER 17-519 E-12 SHEET NO. 33 OF 35 SCALE: AS NOTED DATE: APRIL 2021

ELECTRICAL 30 KW AND 50 KW GENERATOR DETAILS DPW FILE NO. 24-86-G-36



ENGINEERING, P.C. 12 Water Street Suite 202, White Plains, New York 10601 914-741-1290 (tel) 914-741-1253 (fax) www.lynstaar.com




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CONTRACTOR		PROJECT COORDINATOR
NAME	NAME	
SIGNATURE	SIGNATURE	

BLUE MOUNTAIN RESERVATION SITE WORK IMPROVEMENTS TOWN OF CORTLANDT, CITY OF PEEKSKILL, NY ELECTRICAL DETAILS I

DATE: APRIL 2021 DPW FILE NO.

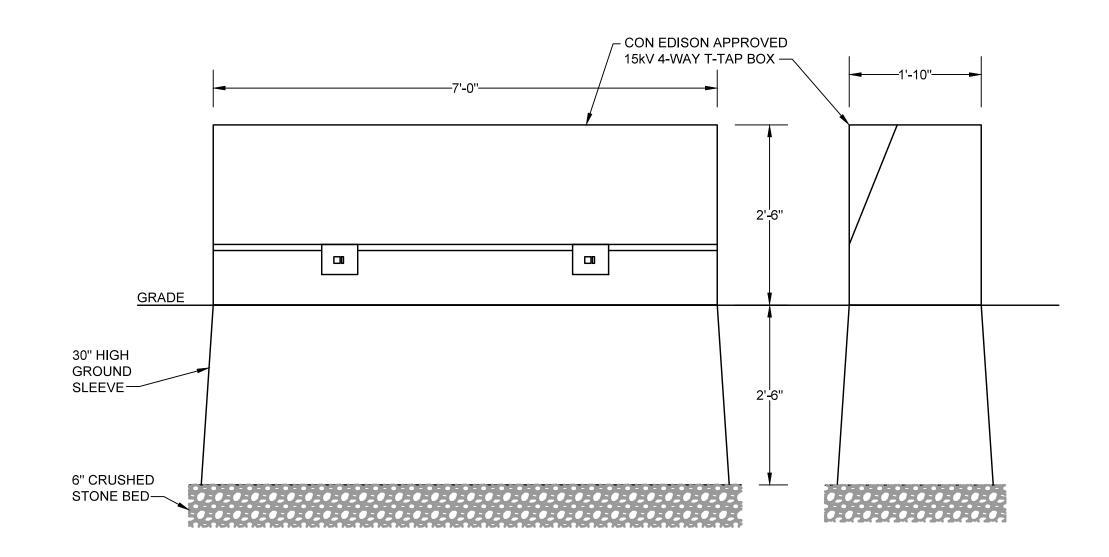

15kV T-TAP BOX DETAILS

SCALE: 3/4" = 1'-0"

1. PROVIDE #1/0 BARE Cu GROUND LOOP 24" BELOW GRADE WITH TWO (2) 5/8"x10'-0" Cu CLAD STEEL GROUND

RODS, ONE (1) AT EACH CORNER TYPICAL. 2. ALL UNDERGROUND CONDUIT SHALL BE SCHEDULE 40 PVC CONCRETE ENCASED, ALL ELBOWS UP TO T-TAP BOX SHALL BE RIGID STEEL.

15KV T-TAP BOX SPECIFICATIONS

1. MANUFACTURER: COOPER POWER SYSTEMS SECTER CABINET. 2. PRODUCT DESCRIPTION:

A. 15KV, 200A, 4-WAY, T-TAP BOX AS APPROVED FOR USE BY THE UTILITY COMPANY.

B. PROVIDE 200A, 15KV CLASS 4-WAY LOADBREAK JUNCTIONS. COOPER POWER SYSTEMS ELECTRICAL APPARATUS 500-15.

C. PROVIDE COMPATIBLE 200A, 15KV CLASS LOADBREAK ELBOWS. COOPER POWER SYSTEMS, ELECTRICAL APPARATUS 500-10, SIZED FOR #1/0 CONDUCTORS.


D. PROVIDE 15KV RATED INSULATED CAPS FOR ALL BUSHINGS NOT IN USE.

3. OPTIONS: PROVIDE OPTIONAL 30" GROUND SLEEVE. 4. LOCAL SALES REPRESENTATIVE: HOWARD SCHECTER, TECHNICAL GROUP SERVICES, INC.,

271 RT. 46W, SUITE H207, FAIRFIELD, NJ 07004. PHONE: 862-210-8127, FAX: 862-210-8129,


EMAIL: HOWARD@TGS-INC.COM.

5. CONFIRM TO ALL CON EDISON REQUIREMENTS.

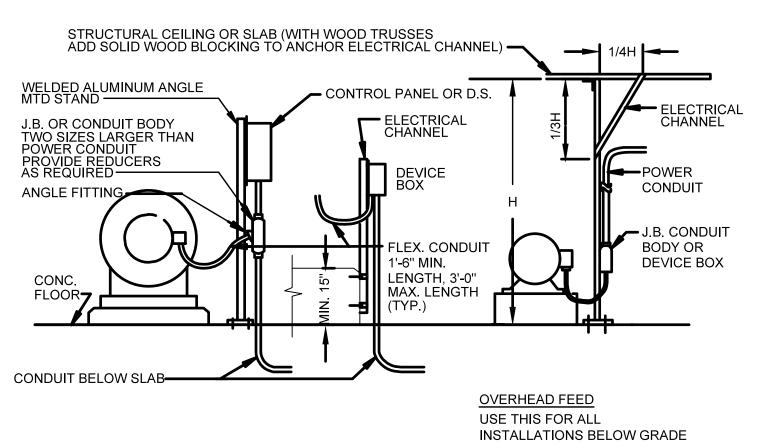

TYPICAL ELECTRICAL FEED

SCALE: NO SCALE

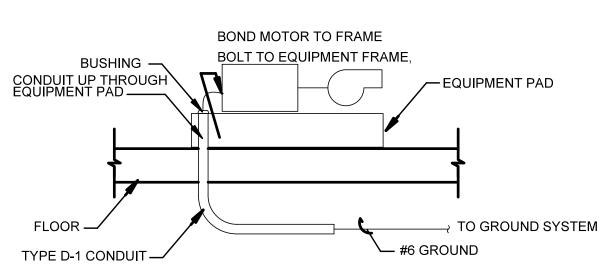



SCALE: NO SCALE

ENGINEERING, P.C.

12 Water Street Suite 202, White Plains, New York 10601

914-741-1290 (tel) 914-741-1253 (fax) www.lynstaar.com

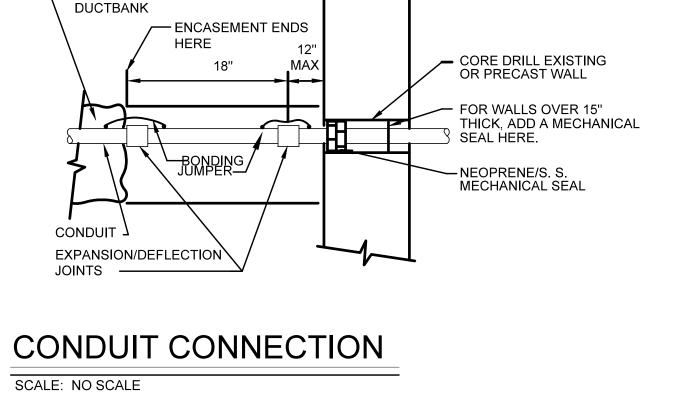

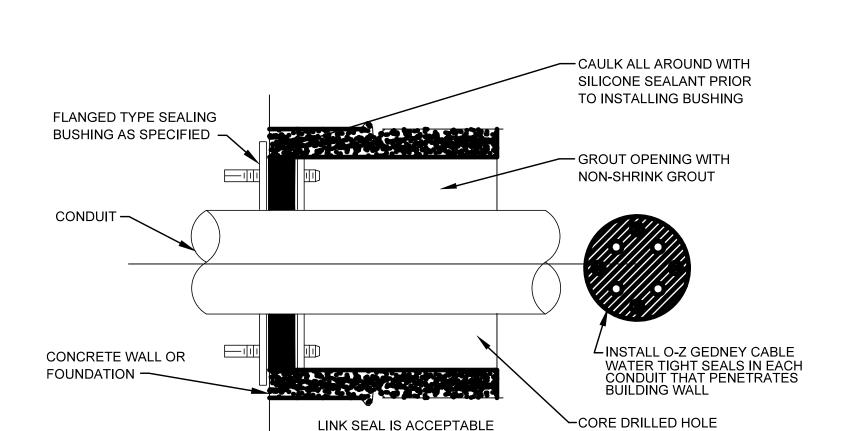


TYPICAL SLEEVE DETAIL FOR **EXISTING WALL PENETRATION**

SCALE: NO SCALE

REVISION


— GRAVEL ENCASED

THIS DETAIL IS DESIGNED FOR CONCRETE ENCASED DUCTBANK ABUTTING NEW OR EXISTING CONCRETE WALL. GRAVEL DUCTBANK WOULD NOT REQUIRE WALL RECESS AND WOULD NEED THE DEFLECTION JOINTS AS

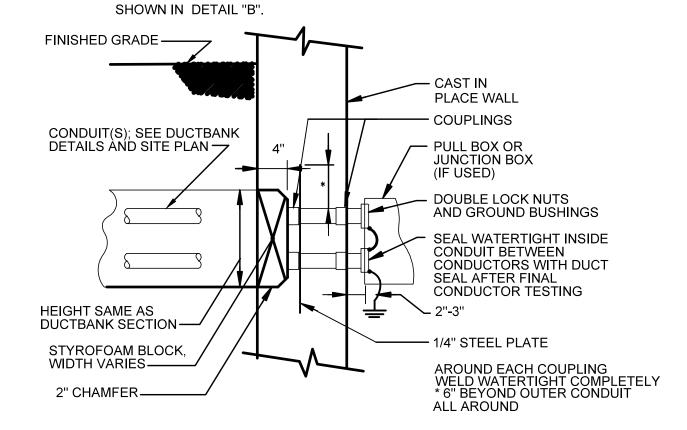

CONDUIT CONNECTION - DETAIL "A"

SCALE: NO SCALE

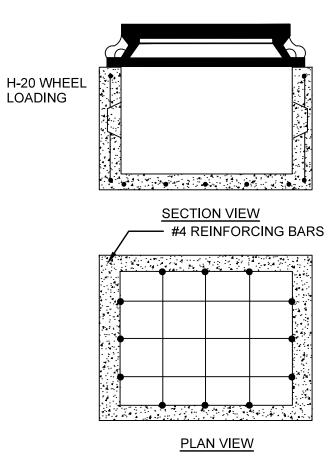

1. HANDHOLE COVERS SHALL BE NOTED EITHER AS "ELECTRIC" OR "COMMUNICATION" (REFER TO SITE PLAN). 2. HANDHOLES SHALL BE RATED FOR H-20 WHEEL LOADING.


3. HANDHOLE SHALL HAVE A CAST IRON COVER. 4. CONCRETE AND STEEL HANDHOLE SHALL BE PROVIDED IN DRIVEWAYS AND ROADWAYS. 5. HANDHOLE SHALL BE 18"x24"x24" MINIMUM, OR AS SHOWN

ON DRAWINGS.

CONCRETE AND STEEL HANDHOLE DETAIL

SCALE: NO SCALE

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GROUNDING ELECTRIC MOTOR
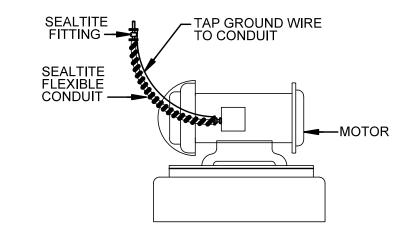
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SCALE: NO SCALE

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EQUIPMENT GROUNDING DETAIL

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WESTCHESTER COUNTY, NEW YORK DEPARTMENT OF PUBLIC WORKS & TRANSPORTATION DIVISION OF ENGINEERING

BLUE MOUNTAIN RESERVATION SITE WORK IMPROVEMENTS TOWN OF CORTLANDT, CITY OF PEEKSKILL, NY ELECTRICAL

DETAILS II

CONTRACT NUMBER SHEET NUMBER 17-519 E-14 SHEET NO. 35 OF 35 SCALE: AS NOTED DATE: APRIL 2021 DPW FILE NO.