DUCT SECTION - RETURN/EXHAUST AHU AIR HANDLING UNIT BBD BOILER BLOW DOWN

BD BACKDRAFT DAMPER

CFM CUBIC FEET PER MINUTE

CR CONDENSER WATER RETURN

CS CONDENSER WATER SUPPLY

CW DOMESTIC COLD WATER Ouct section - round duct in inches AXB FO DUCT SECTION - FLAT OVAL DUCT IN INCHES 1 ACOUSTIC THERMAL LINING FLEXIBLE DUCTWORK (E) EXISTING

EA EXHAUST AIR

EC ELECTRICAL CONTRACTOR

EF EXHAUST FAN

ETR EXISTING TO REMAIN FLEXIBLE CONNECTION FIRE DAMPER ETR EXISTING TO REMAIN

GC GENERAL CONTRACTOR

HC HVAC CONTRACTOR

LPC LOW PRESSURE CONDENSATE

LPS LOW PRESSURE STEAM

MBH 1,000 BTU/HR

MC MECHANICAL CONTRACTOR

NC NORMALLY CLOSED SMOKE DAMPER COMBINATION FIRE AND SMOKE DAMPER NO NORMALLY CLOSED

NO NORMALLY OPEN

NTS NOT TO SCALE

OA OUTSIDE AIR

PC PLUMBING CONTRACTOR

RA RETURN AIR VOLUME DAMPER RETURN AIR
RTU ROOFTOP UNIT
RV ROOF VENT
SA SUPPLY AIR
TC TEMPERATURE CONTROLS
CONTRACTOR
UH UNIVERSE AIR DUCT (FIRST FIGURE IS DUCT WIDTH/TOP, SECOND FIGURE IS DUCT DEPTH) 10/20 7 UH UNIT HEATER MULTI-BLADE AIR EXTRACTOR UV UNIT VENTILATOR
V VENT TURNING VANES EXISTING WORK TO BE REMOVED (HATCHED) POINT OF CONNECTION \bigcirc R POINT OF DISCONNECTION TRANSITION SQUARE TO ROUND HUMIDIFIER DISPERSION TUBE SQUARE CEILING DIFFUSER (4 WAY) ROUND CEILING DIFFUSER SQUARE OR RECTANGULAR CEILING GRILLE SUPPLY REGISTER, RETURN OR EXHAUST GRILLE SUPPLY DIFFUSER, 1-WAY, 2-WAY, 3-WAY ©CEILING DIFFUSER WITH NECK SIZE, TYPE, & CFM CEILING RETURN OR EXHAUST GRILLE WITH SIZE, TYPE, & CFM 10"x8", R-2
300 CFM

SUPPLY REGISTER
WITH SIZE, TYPE, & CFM 10"x8", G-2 300 CFM RETURN OR EXHAUST GRILLE WITH SIZE, TYPE, & CFM → → AIR FLOW ACOUSTIC/THERMAL DUCTWORK LINING -1 INCH THICK L2 ACOUSTIC/THERMAL DUCTWORK LINING 2 INCH THICK

PL1 ACOUSTIC/THERMAL DUCTWORK PLENUM
LINING - 1 INCH THICK SPACE TEMPERATURE SENSOR MARK APPLICATION MATERIAL TYPE D1 SUPPLY STEEL DUCT GRILLE D2 FACE MNTD SUPPLY D3 SUPPLY STEEL FACE MNTD R1 RETURN/EA STEEL FACE MNTD R2 RETURN/EA STEEL FACE MNTD RETURN/EA REMARKS: 1. PROVIDE AIR SCOOPS **DUCT BOOT DETAIL**

HVAC SYMBOLS LIST DESCRIPTION SYMBOL DESCRIPTION SYMBOL (DBL) DOUBLE WALL LINED DUCT AAD AUTOMATIC AIR DAMPER ACC AIR-COOLED CONDENSING UNIT
AD ACCESS DOOR
AFF ABOVE FINISHED FLOOR 20/10 DUCT SECTION - SUPPLY ALL OTHER HVAC DRAWINGS.

SYMBOLS GENERAL NOTES:

VALVE AND DAMPER ACTUATOR TYPES (ELECTRIC OR PNEUMATIC) WHICH ARE INDICATED IN HVAC TEMPERATURE CONTROL DRAWINGS SHALL SUPERSEDE TYPE INDICATED ON

HVAC CONTRACTOR GENERAL NOTES:

. IT IS THE RESPONSIBILITY OF THE CONTRACTOR TO FIELD

VERIFY EXISTING CONDITIONS WITHIN THE BUILDING PRIOR TO COMMENCEMENT OF ALL DEMOLITION AND NEW WORK. IT IS THE RESPONSIBILITY OF THE CONTRACTOR TO REMOVE

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AND REPLACE EXISTING CEILINGS, UNLESS OTHERWISE NOTED ON THE ARCHITECTURAL DRAWINGS, FOR PERFORMING DEMOLITION OR NEW WORK WITHIN THE BUILDING. THE EXISTING CEILINGS SHALL BE REMOVED IN A MANNER TO AVOID DAMAGE TO THE CEILING SYSTEMS, STORAGE OF CEILING SYSTEM COMPONENTS FOR REINSTALLATION IS THE RESPONSIBILITY OF THE CONTRACTOR. THE STORAGE OF ALL MATERIAL SHALL BE IN AREAS OR LOCATIONS APPROVED BY THE OWNER. THE OWNER WILL NOT COMPENSATE FOR ANY DAMAGED OR LOST MATERIAL WHILE IN STORAGE. AFTER COMPLETION OF ALL DEMOLITION OR NEW WORK, THE CONTRACTOR SHALL REINSTALL THE CEILING SYSTEMS TO MATCH THE ORIGINAL INSTALLATION.

DEMOLITION DRAWINGS SHOW MAJOR EQUIPMENT, PIPING, AND DUCTWORK REMOVALS. THE INTENT IS NOT TO IDENTIFY ALL MISCELLANEOUS PIPING, PIPING ACCESSORIES, DUCTWORK, DUCTWORK ACCESSORIES, SUPPORTS, CONTROLS, CONTROL ACCESSORIES, CONTROL WIRING, CONDUIT, AND PNEUMATIC CONTROL TUBING TO BE DISCONNECTED AND REMOVED, BUT IS THE REQUIREMENT UNDER THIS CONTRACT. NO EQUIPMENT, PIPING, OR DUCTWORK SHALL BE ABANDONED IN PLACE, UNLESS OTHERWISE NOTED ON THE DRAWINGS.

ALL EQUIPMENT INDICATED TO BE TURNED OVER TO THE OWNER SHALL BE DISCONNECTED AND REMOVED FROM THE EXISTING SYSTEMS AND DELIVERED (INCLUDING LOADING AND UNLOADING) TO A STORAGE AREA WITHIN THE BUILDING AS SELECTED BY THE OWNER. IT WILL BE THE RESPONSIBILITY OF THE CONTRACTOR TO REPAIR ANY EQUIPMENT DAMAGED DURING REMOVAL AND DELIVERY, ANY DAMAGE TO EQUIPMENT PRIOR TO DISCONNECTING SHOULD BE REPORTED TO THE OWNER'S REPRESENTATIVE. IF NOT REPORTED, THE CONTRACTOR TAKES FULL RESPONSIBILITY FOR REPAIRS TO THE

EQUIPMENT. E. BEFORE DISCONNECTING, REMOVING, OR SERVICING ANY AIR CONDITIONING EQUIPMENT OR SYSTEMS CONTAINING REFRIGERANTS, THE EQUIPMENT OR SYSTEMS SHALL BE EVACUATED OF ALL REFRIGERANT PER THE LATEST ADOPTED RULES AND REGULATIONS BY THE UNITED STATES ENVIRONMENTAL PROTECTION AGENCY (EPA). THE CONTRACTOR OR TECHNICIAN PERFORMING THE WORK SHALL BE CERTIFIED BY AN EPA APPROVED CERTIFYING AGENCY OR ORGANIZATION.


F. ALL DUCTWORK, PIPING, AND CONDUIT PENETRATIONS THROUGH RATED WALLS OR FLOORS SHALL BE PROVIDED WITH FIRE/SMOKE STOPPINGS PER SPECIFICATION. REFER TO CODE ANALYSIS DRAWING FOR ALL RATED WALL LOCATIONS. ALL FLOORS SHALL BE CONSIDERED RATED.


G. UNLESS SHOWN ON THE ARCHITECTURAL DRAWINGS, IT IS THE RESPONSIBILITY OF THIS CONTRACT TO PATCH AND FINISH ALL EXISTING DUCTWORK OR PIPE PENETRATIONS THROUGH FLOORS, ROOFS, INTERIOR WALLS, AND EXTERIOR WALLS AFTER DEMOLITION WORK, IN ADDITION, ALL NEW PENETRATIONS SHALL BE PROVIDED FOR INSTALLATION OF MECHANICAL SYSTEMS INCLUDING, BUT NOT LIMITED TO, EQUIPMENT, CURBING, DUCTWORK, PIPING, CONTROLS, ETC. PATCHING AND FINISHING SHALL MATCH EXISTING CONSTRUCTION INCLUDING FIRE RATINGS. PROVIDE LINTELS PER LINTEL SCHEDULE.

H. IT IS NOT THE INTENT OF THE DRAWINGS TO SHOW ALL AIR VENTS AND DRAINS IN THE PIPING SYSTEMS. IT IS THE RESPONSIBILITY OF THE CONTRACTOR TO PROVIDE AIR VENTS AT ALL SYSTEM HIGH POINTS AND AT AREAS WITHIN THE PIPING SYSTEMS THAT COULD ACCUMULATE OR TRAP AIR WHICH WOULD PREVENT PROPER VENTING OR OPERATION OF THE SYSTEMS. DRAINS SHALL BE PROVIDED AT ALL LOW POINTS WITHIN THE PIPING SYSTEM TO FACILITATE COMPLETE DRAINING OF THE SYSTEM . I. PROVIDE THERMAL EXPANSION COMPENSATORS AND


THERMAL EXPANSION LOOPS IN PIPING SYSTEM PER INDUSTRY STANDARDS.


GEORGE FISHER LIBRARY RENOVATION											
		TOTAL									
		OCCUPANCY	O.A. PER	O.A. PER							
	TOTAL	FOR	PERSON	SQ. FT.	Vbz		Voz=Vot				
ROOM NAME	SQ. FT.	VENTILATION	(CFM)	(CFM)	(CFM)	Ez	(CFM)				
IBRARY	4725	48	5	0.12	807	0.8	1009				
BREAKOUT 1	520	20	10	0.12	262	0.8	328				
BREAKOUT 2	520	20	10	0.12	262	0.8	328				
BREAKOUT 3	280	10	10	0.12	134	0.8	167				

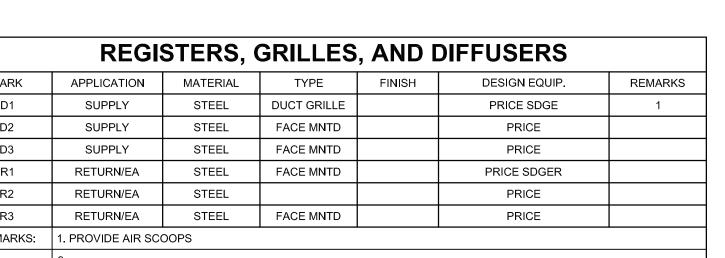

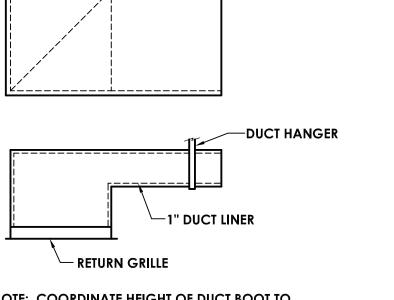


NOTE: COORDINATE HEIGHT OF DUCT BOOT TO AVOID INTERFERENCE WITH LIGHTS AND JOISTS.

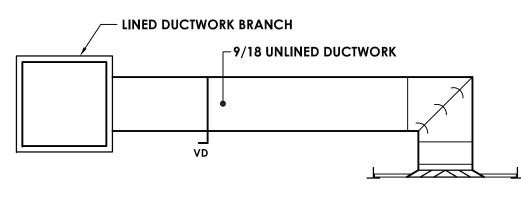

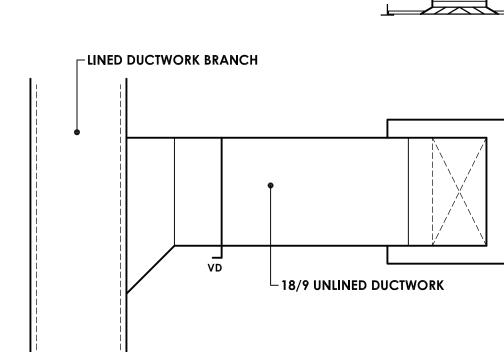



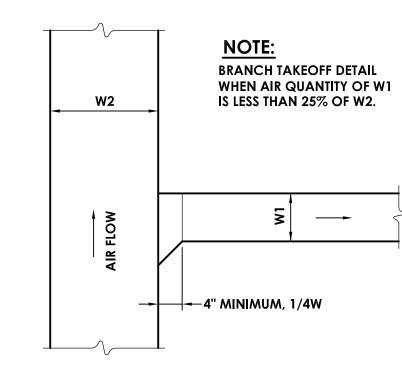


BRANCH TAKE-OFF DETAIL


70019.00 GF H000 DRAWING NUMBER

DISTRIC

11/30/2020 NRH scale AS NOTED HVAC SCHEDULES, DETAILS, LEGEND AND ABREVIATIONS

1 TOILET ROOM DEMOLITION PLAN
H200 SCALE: 1/4" = 1'-0"

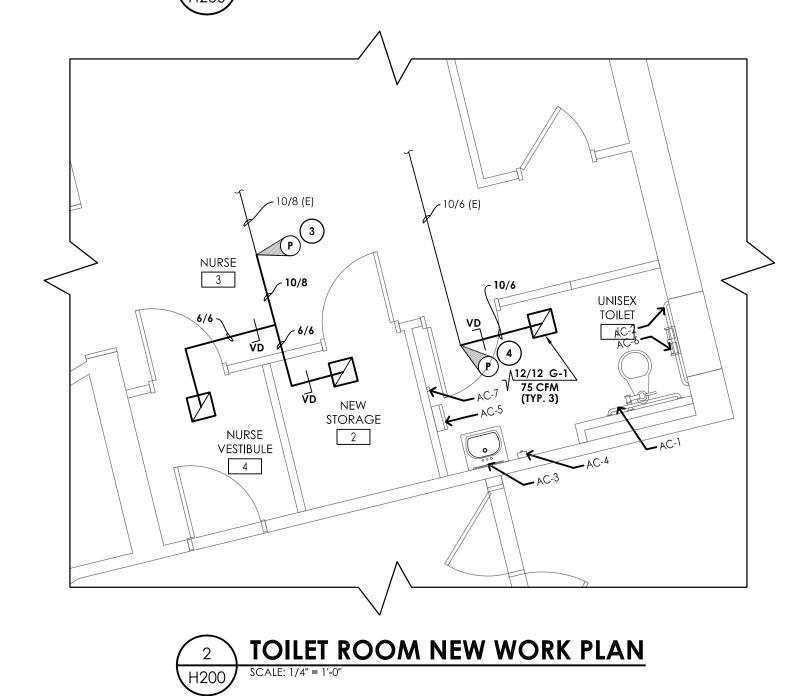

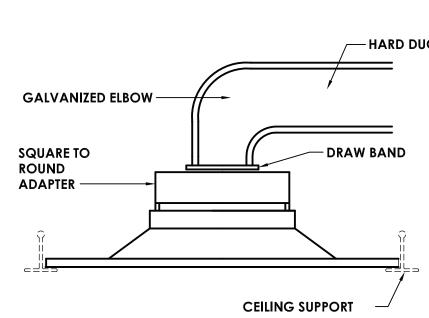



	REGISTERS, GRILLES, AND DIFFUSERS								
ſ	MARK	APPLICATION	MATERIAL	TYPE	FINISH	DESIGN EQUIP.	REMARKS		
	G-1	RETURN/EA	STEEL	LAY-IN	WHITE	PRICE 530	-		

- KEY NOTES:


 REMOVE EXISTING GRILLE AND DUCTWORK TO POINT INDICATED. PREPARE DUCTWORK FOR CONNECTION TO NEW.
- 2 REMOVE EXISTING EXHAUST GRILLE. PREPARE DUCTWORK FOR NEW GRILLE.
- 3) PROVIDE NEW GRILLE AND DUCTWORK. JOG DUCTWORK TO MISS WALL RELOCATION.
- PROVIDE NEW GRILLE AS SCHEDULED. CONNECT TO EXISTING DUCTWORK.

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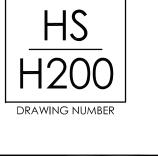
ENVIRONMENTAL CONSULTANT ADELAIDE ENVIRONMENTAL HEALTH ASSOCIATES INC. 1511 ROUTE 22, SUITE C24 BREWSTER, NY 10509 TEL. 845. 278. 7710 FAX. 845.278.7750




DATE DRAWN CHECKED 32 SALE AS NOTED SHEET TITLE


HVAC DEMOLITION, NEW WORK, DETAILS, AND SCHEDULES

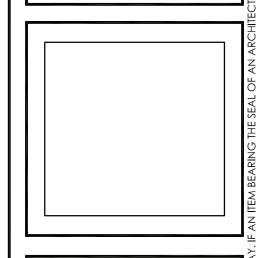PROJECT NUMBER 70019.00




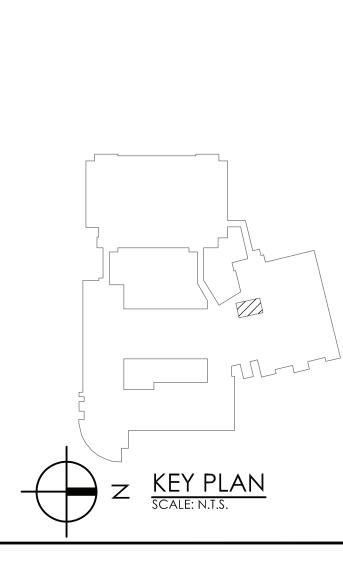





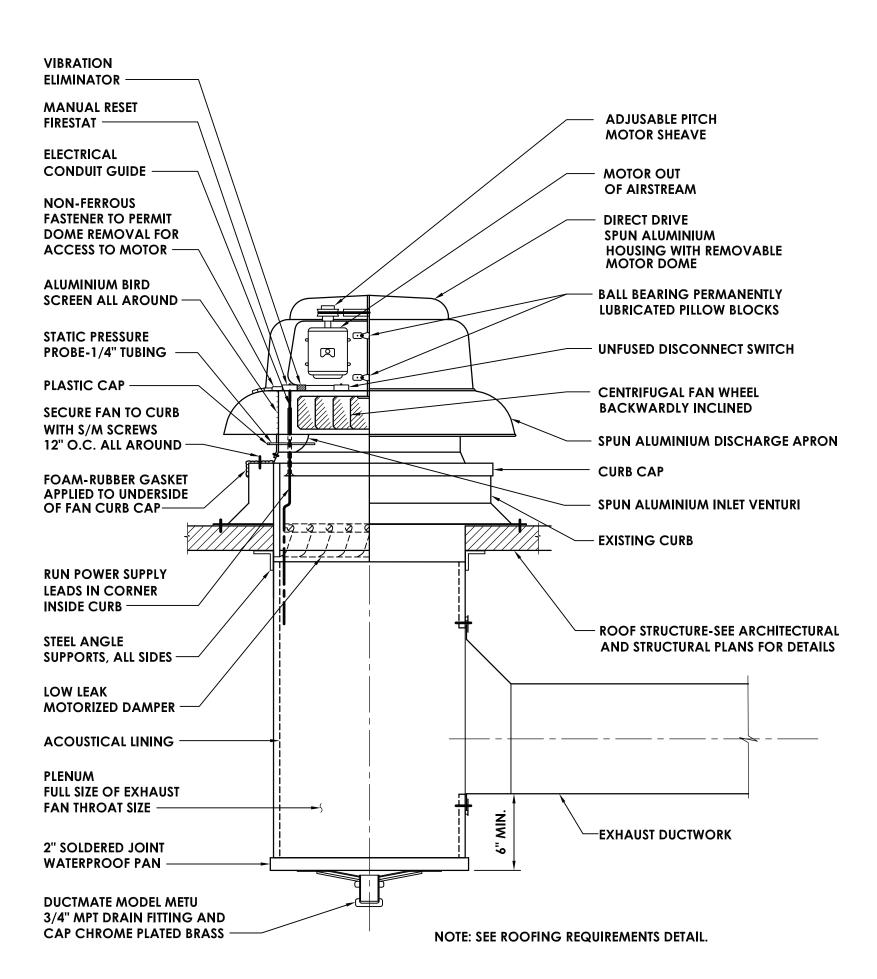




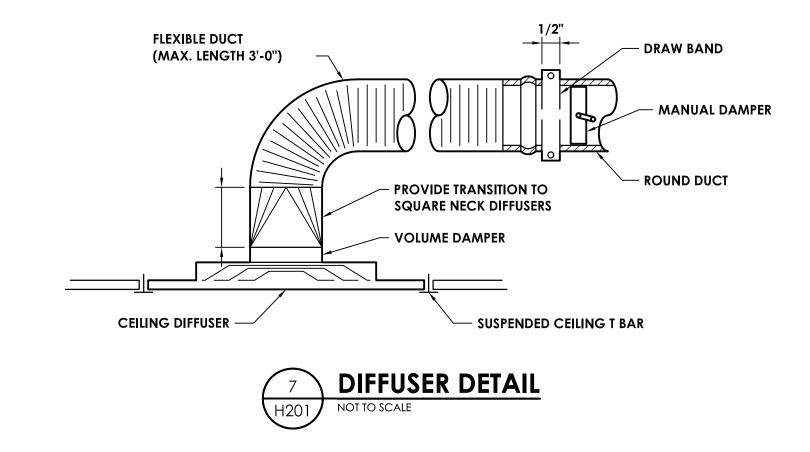

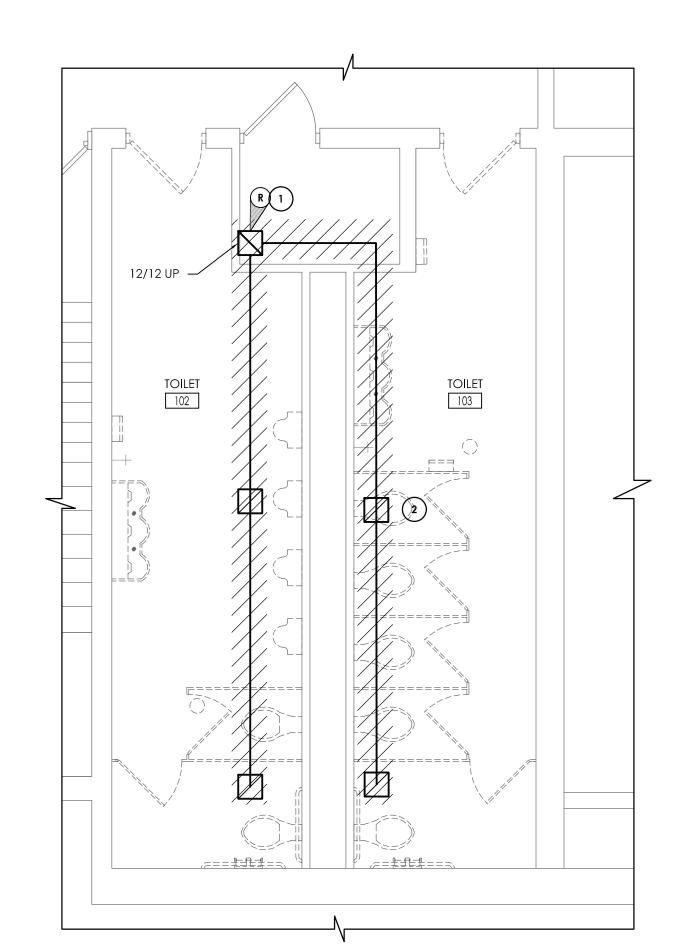

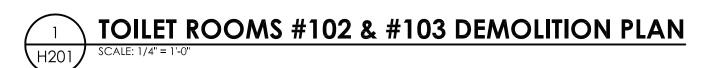


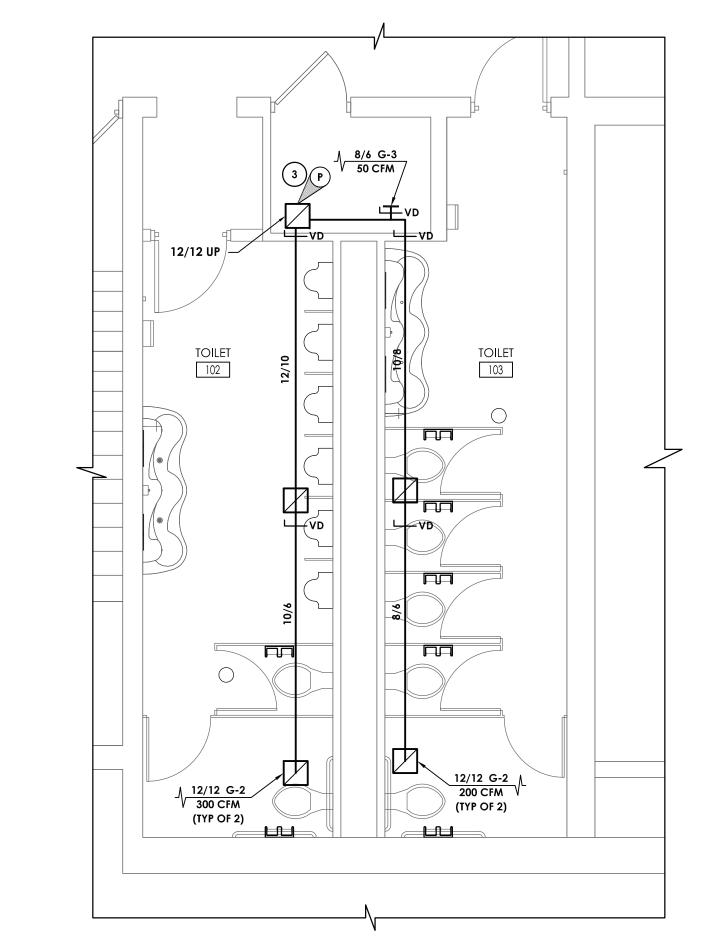


		TOILET ROOMS #102 & #103 NEW WORK PLAN
abla	H201	SCALE: 1/4" = 1'-0"

REGISTERS, GRILLES, AND DIFFUSERS									
MARK	APPLICATION	MATERIAL	TYPE	FINISH	DESIGN EQUIP.	REMARKS			
G-2	RETURN/EA	STEEL	SURFACE MOUNT	WHITE	PRICE 530	ī			
G-3	RETURN/EA	STEEL	DUCT GRILLE	WHITE	PRICE 530	-			

	FAN SCHEDULE											
MARK	LOCATION	SERVICE	TYPE	ROOF	CFM	SP	RPM	ELECTRICAL DATA			TYPICAL UNIT MFG	REMARKS:
IVIARK	LOCATION	SERVICE	ITPE	OPENING (IN.)	CLINI	IN W.G.	KPIVI	BHP / HP	VOLTS	PHASE	& MODEL NO.	REWARKS.
EF-GF-18	ROOF	TOILETS	DOWN BLAST	20.5x20.5	3,000	0.7	833	0.48 / 0.75	208	3	GREENHECK GB-200	1,2,3
REMARKS:	REMARKS: 1. PROVIDE DISCONNECT.											
	2. ALUMINUM BIRD SCREE	N.										
	3 HINGED BASE											

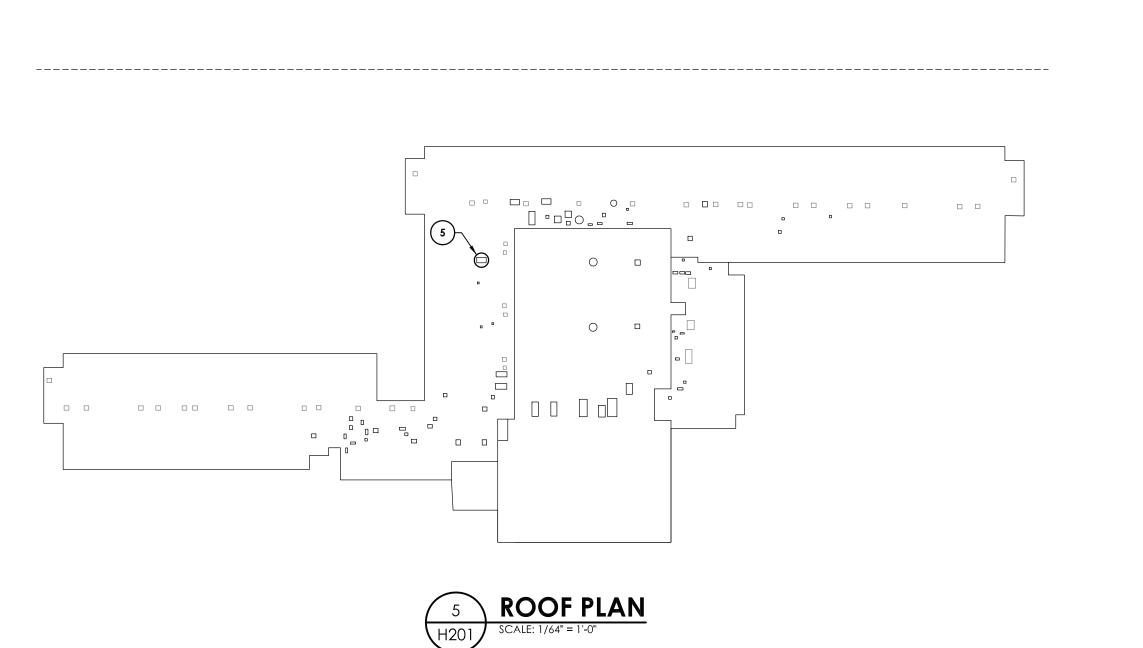

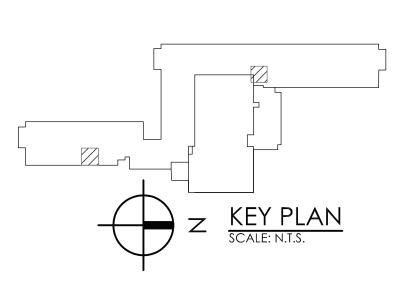



1 REMOVE DUCTWORK TO EXHAUST RISER. PREPARE DUCTWORK FOR NEW CONSTRUCTION.

2 REMOVE EXISTING RETURN GRILLES.

3 CONNECT NEW DUCTWORK TO EXISTING RISER. FIELD VERIFY RISER SIZE.

RISER SIZE.

4 EXISTING EXHAUST GRILLE TO REMAIN.

5 REMOVE AND REPLACE EF-GF-18. MAINTAIN EXISTING CONTROLS MODIFY EXISTING CURB FOR NEW FAN.

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DATE BY CHKED DESCRIPTION	11/30/2020 LJ CG SED 100% CONSTRUCTION DOCUMENTS SUBMISSION	01/07/2021 - ADDENDUM #1	03/29/2021 JG JP ISSUED FOR BID	IERING PARTY SHALL AFFIX TO THE ITEM THEIR SEAL AND THE NOTATION "ALTERED BY" FOLLOWED BY THEIR SIGNATURE
DATE	11/30/20:	01/07/20:	03/29/20:	RTY SHALL A
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ENVIRONMENTAL CONSULTANT


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DISTRICT

YORK 12563

303.022
3.06.0.008.018
5.0.010.013
0.001.017

SOUTH STREET, P.O. BOX 296, PATTERSON, NEW YORK

CARMEL HIGH SCHOOL SED#: 48.01.02.06.0.003.022

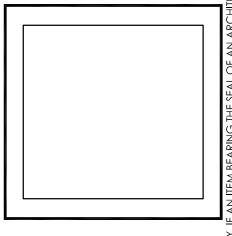DRGE FISCHER MIDDLE SCHOOL SED#: 48.01.02.06.0.00

KENT ELEMENTARY SCHOOL SED#: 48.01.02.06.0.001.0

KENT PRIMARY SCHOOL SED#: 48.01.02.06.0.001.0

DATE DRAWN CHECKED 30/2020 ZBH JJM

SCALE AS NOTED


SHEET TITLE


HVAC DEMOLITION,

NEW WORK, DETAILS,

AND SCHEDULES

PLAN

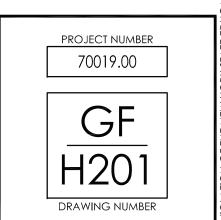

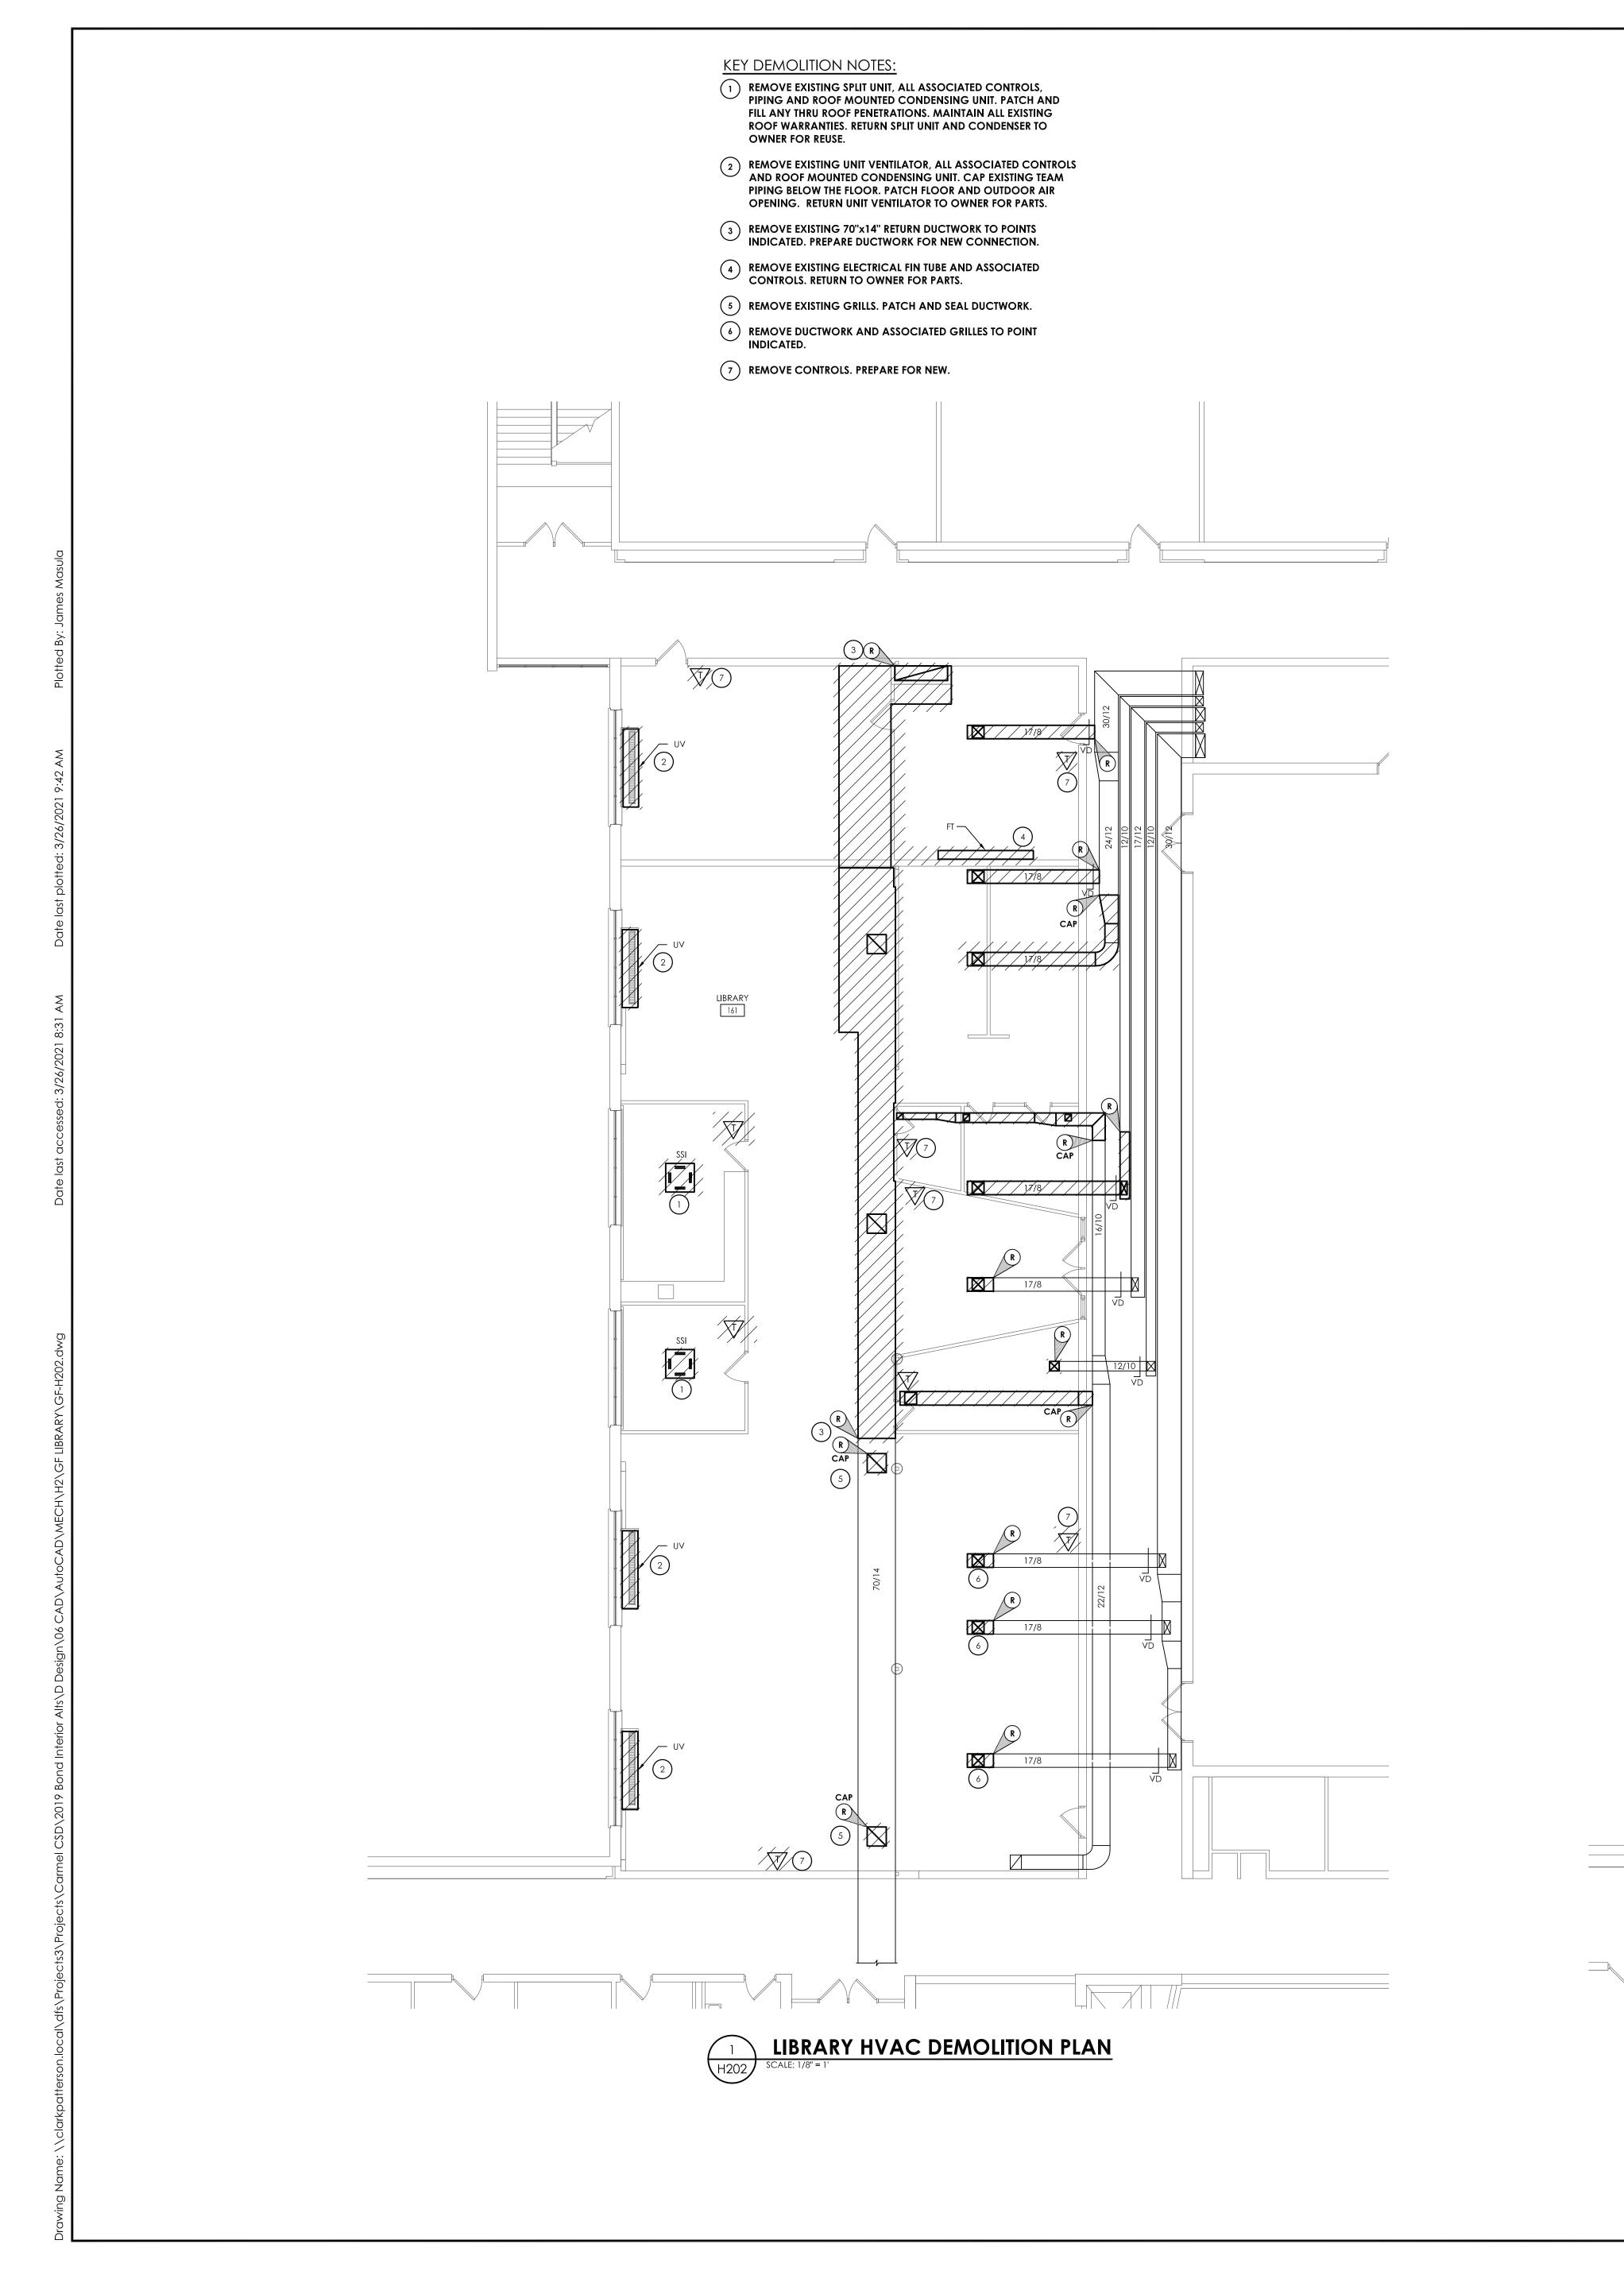

KEY NEW WORK NOTES:

EXISTING JOISTS.

PIPING SLEEVED AND DOWN TO OUTER WALL FOUNDATION

- OONNECT TO EXISTING RETURN DUCTWORK RISER AT THE TOP OF THE CHASE. RUN DUCT TIGHT TO STEEL. COORDINATE LOCATION
- WITH EXISTING STEEL.

 2 CONNECT TO EXISTING SUPPLY DUCTWORK. RUN DUCT IN JOIST SPACE, TIGHT TO DECK. COORDINATE DUCT BRANCHING WITH
- PROVIDE NEW SPLIT SYSTEM INDOOR UNIT AND OUTDOOR CONDENSING UNIT. ROUTE REFRIGERANT PIPING TO ROOF THROUGH EXISTING PITCH POCKETS.
- ROUTE DUCT AS HIGH AS POSSIBLE IN JOIST SPACE. MOUNT SUPPLY GRILLE FLUSH WITH THE BOTTOM OF THE CEILING LIGHTS.
- 5 CONNECT NEW 3/4" INCH FT-1 PIPE TO EXISTING MAIN BELOW FLOOR.


GENERAL NOTES:

- 1. PROVIDE A PRE-BALANCE REPORT OF ALL SUPPLY AND RETURN GRILLS IN PROJECT AREA.
- 2. CLEAN ALL REMAINING DUCTWORK IN PROJECT AREA.
- 3. RE-BALANCE EXISTING AHU TO THE REQUIRED LIBRARY 6000 CFM TOTAL SUPPLY AIR AND 1500 CFM TOTAL OA AIR.

ARCHITECTURE = BN

√ 24/8, G-3 600 CFM 10"Ø D-2 400 CFM /



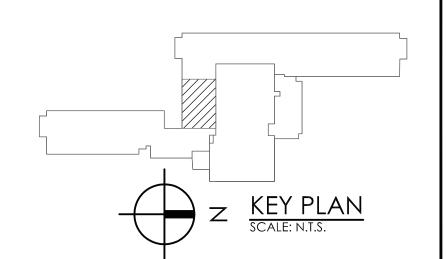

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ISCHER MIDDLE SCHOOL SED#: 48.01.02.06.0.008.018

IR PATERSON SCHOOL SED#: 48.01.02.06.0.010.013

LEMENTARY SCHOOL SED#: 48.01.02.06.0.001.017

PRIMARY SCHOOL SED#: 48.01.02.06.0.004.016

DATE DRAWN CHECKED 11/30/2020 ZBH JJM

SCALE AS NOTED

SHEET TITLE


HVAC DEMOLITION,

AND NEW WORK

70019.00

GF
H202

DRAWING NUMBER

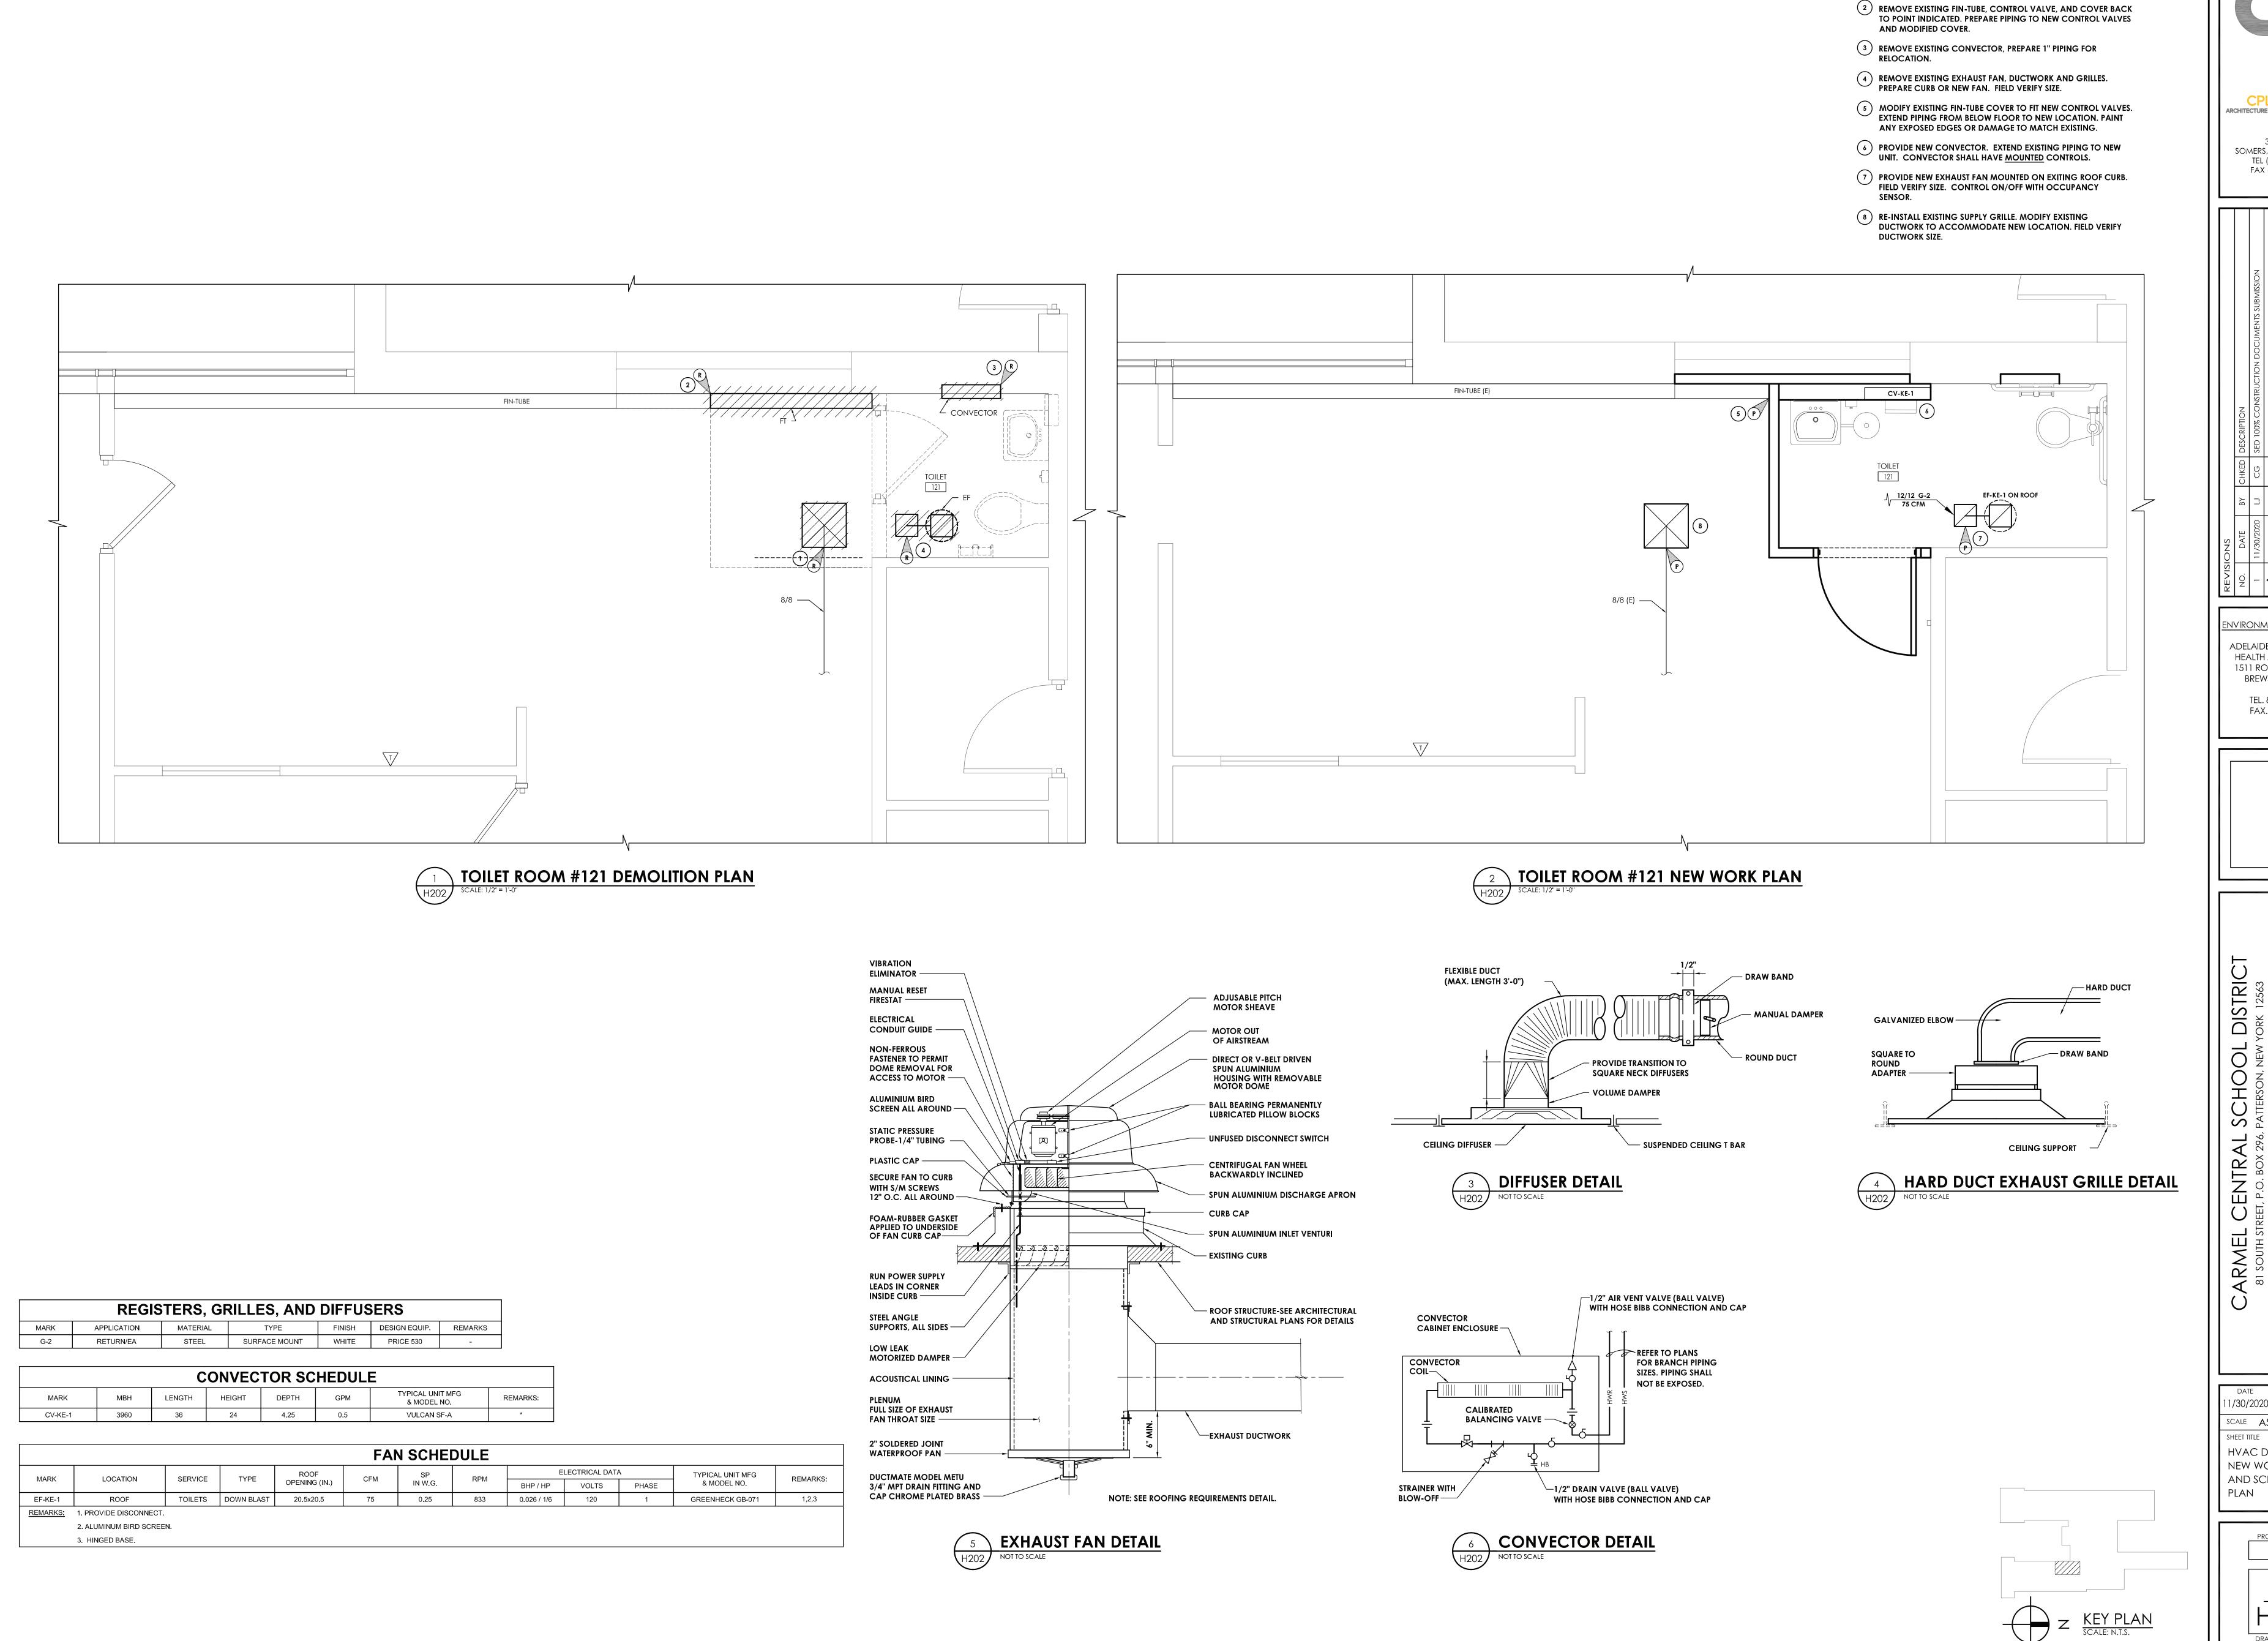

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KEY NOTES:

1 REMOVE EXISTING 18X18 GRILLE. SAVE FOR REINSTALLATION.

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 REVISIONS

 NO.
 DATE
 BY
 CHKED
 DESCRIPTION

 1
 11/30/2020
 LJ
 CG
 SED 100% CONSTRUCTION DOCUMENTS SUBMISSION

 △
 01/07/2021
 ADDENDUM #1

 2
 03/29/2021
 JG
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CARMEL HIGH SCHOOL SED#: 48.01.02.06.0.003.022

GE FISCHER MIDDLE SCHOOL SED#: 48.01.02.06.0.008.018

NT ELEMENTARY SCHOOL SED#: 48.01.02.06.0.01.017

DATE DRAWN CHECKED
11/30/2020 ZBH JJM

SCALE AS NOTED

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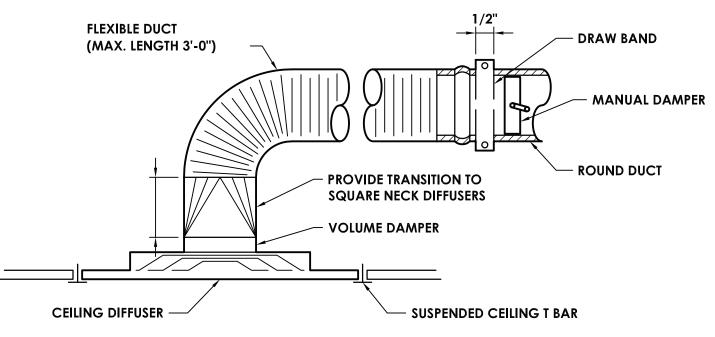
HVAC DEMOLITION,
NEW WORK, DETAILS,
AND SCHEDULES
PLAN

70019.00


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H202

DRAWING NUMBER

5 EXHAUST FAN DETAIL H203 NOT TO SCALE



6 DIFFUSER DETAIL NOT TO SCALE

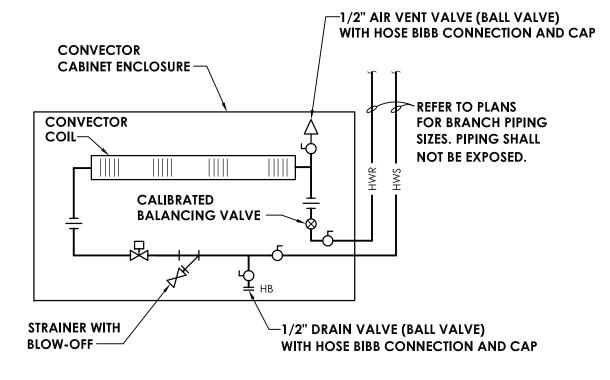

7 CONVECTOR DETAIL H203 NOT TO SCALE


REGISTERS, GRILLES, AND DIFFUSERS									
MARK	APPLICATION	MATERIAL	TYPE	FINISH	DESIGN EQUIP.	REMARKS			
G-2	RETURN/EA	STEEL	SURFACE MOUNT	WHITE	PRICE 530	-			

	CONVECTOR SCHEDULE										
MARK	МВН	LENGTH	HEIGHT	DEPTH	GPM	TYPICAL UNIT MFG & MODEL NO.	REMARKS:				
CV-KP-1	3960	36	24	4.25	0.5	VULCAN SF-A	*				
CV-KP-2	3960	36	24	4.25	0.5	VULCAN SF-A	*				
	ı										


					FAN S	SCHEDU	JLE					
MARK	LOCATION	SERVICE	TYPE	ROOF	CFM	SP	RPM	E	LECTRICAL DATA	A	TYPICAL UNIT MFG	REMARKS
IVIARK	LOCATION	SERVICE	ITPL	OPENING (IN.)	CLIN	IN W.G.	KFIVI	BHP / HP	VOLTS	PHASE	& MODEL NO.	KEWAKKS
EF-KP-1	ROOF	TOILETS	DOWN BLAST	14.5x14.5	375	0.5	1144	0.07 / 0.25	120	1	GREENHECK GB-101	1,2,3
EF-KP-2	ROOF	TOILETS	DOWN BLAST	14.5x14.5	150	0.35	1127	0.06 / 1/6	120	1	GREENHECK GB-071	1,2,3
REMARKS:	1. PROVIDE DISCONNECT.											
	2. ALUMINUM BIRD SCREE	N.										
	3. HINGED BASE.											

KEY NOTES:

- 1 REMOVE EXISTING ROOF-MOUNTED EXHAUST FAN AND ASSOCIATED DUCTWORK AND GRILLES. FIELD VERIFY CURB SIZE FOR NEW FAN.
- 2 REMOVE EXISTING CONVECTOR. PREPARE PIPING AND CONTROLS FOR NEW UNIT.
- 3 PROVIDE NEW EXHAUST FAN. MOUNT TO EXISTING CURB. BALANCE FAN FOR NEW AIRFLOW.
- 4 EXTEND PIPING AND CONTROLS TO NEW CONVECTOR.
 COORDINATE WITH GENERAL CONTRACTOR FOR FLOOR/WALL
 CUTS.
- 5 REMOVE EXISTING TEMPERATURE CONTROLS. SAVE FOR RE-INSTALLATION.
- 6 RE-INSTALL SALVAGED TEMPERATURE CONTROLS.

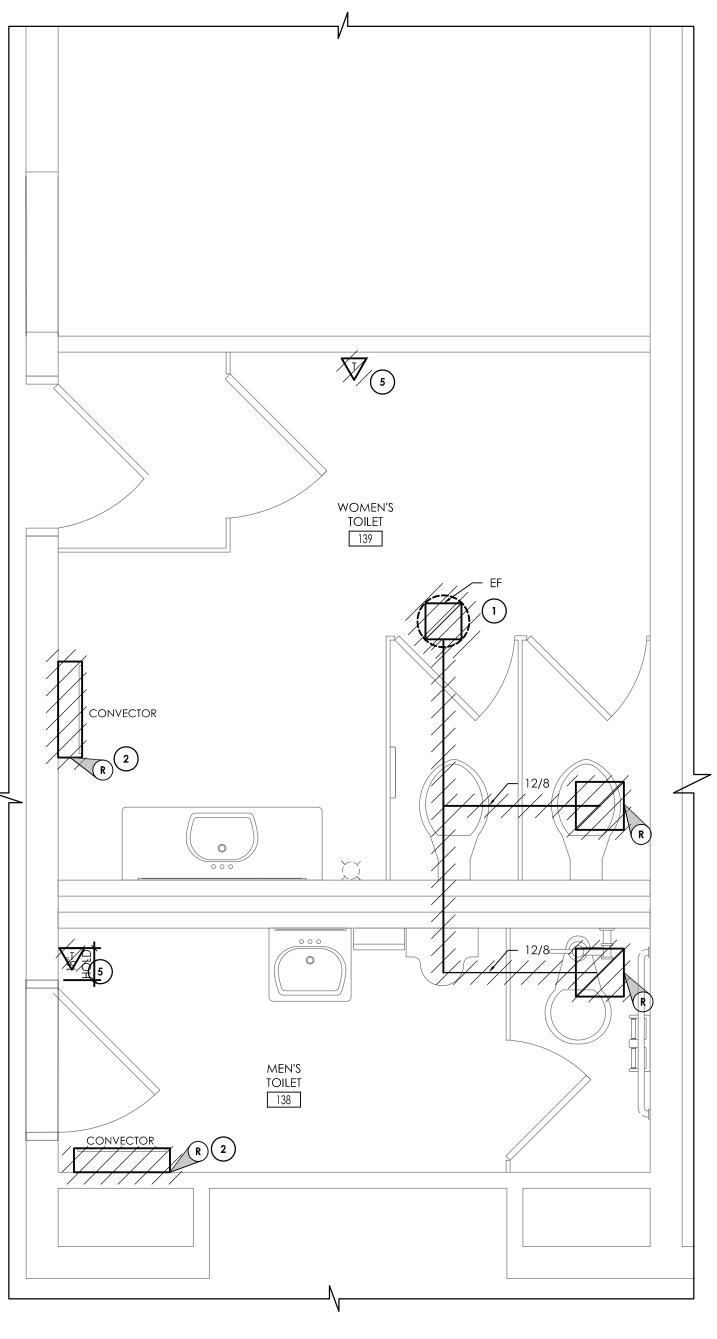



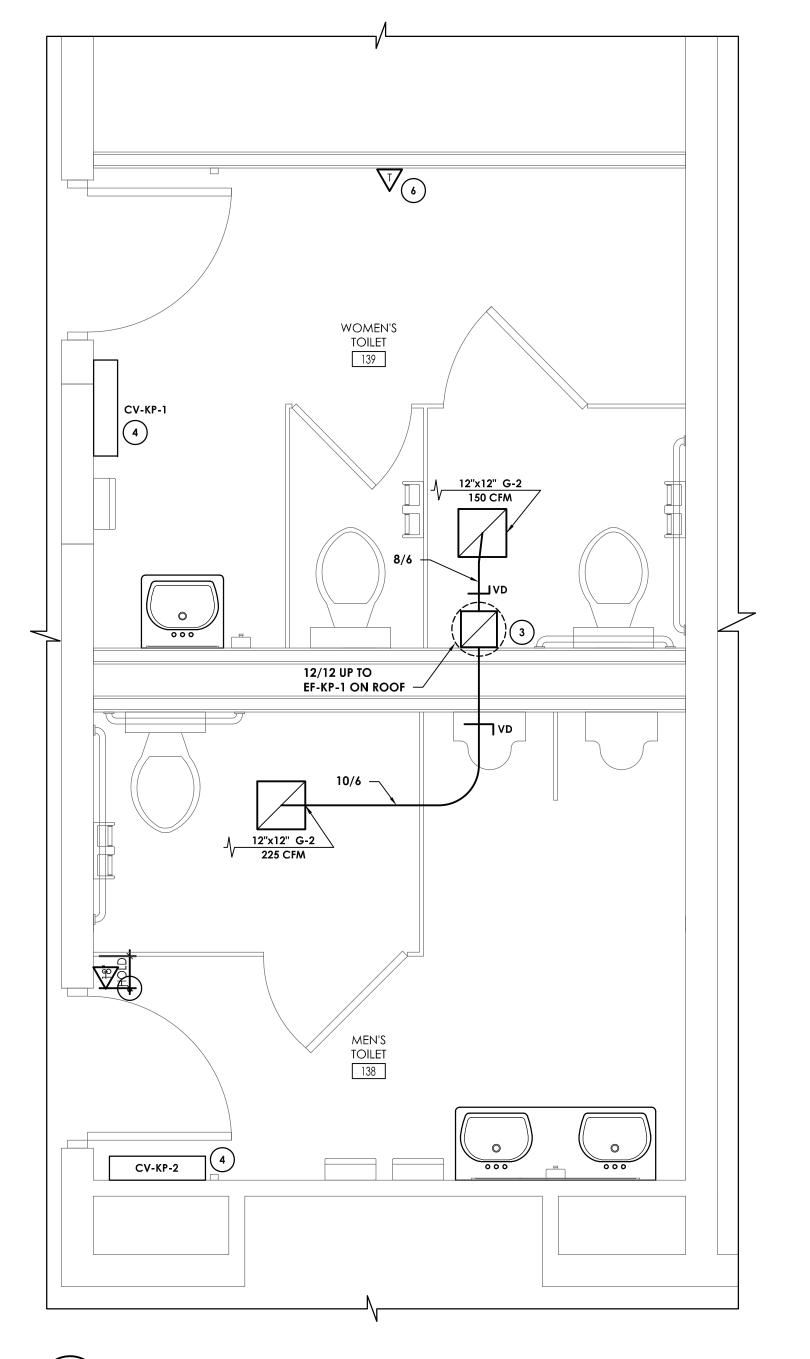

TOILET ROOMS #138 & #139 CONSTRUCTION PLAN

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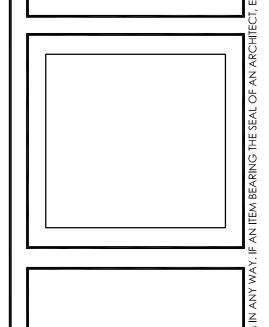
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	BY CHKED DESCRIPTION	CG SED 100% CONSTRUCTION DOCUMENTS SUBMISSION	ADDENDUM #1	JP ISSUED FOR BID	
	CHKED	90	-	dſ	
	ВҮ	П	-	JG	
SNO	DATE	L1/30/2020	01/07/2021	03/29/2021 JG	
REVISIONS	NO.	1	∇	2	

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MEL HIGH SCHOOL SED#: 48.01.02.06.0.003.022

ISCHER MIDDLE SCHOOL SED#: 48.01.02.06.0.008.018

R PATERSON SCHOOL SED#: 48.01.02.06.0.010.013

LEMENTARY SCHOOL SED#: 48.01.02.06.0.001.017

DATE DRAWN CHECKED SS STATE AS NOTED

HVAC DEMOLITION,
NEW WORK, DETAILS,
AND SCHEDULES
PLAN

Z KEY PLAN
SCALE: N.T.S.

70019.00



