


CITY OF POUGHKEEPSIE ENGINEERING DEPARTMENT

ADMINISTRATION BUILDING RTU REPLACEMENT

MARCH 25, 2020

WATER POLLUTION CONTROL PLANT

CITY OF POUGHKEEPSIE, DUTCHESS COUNTY, NEW YORK STATE

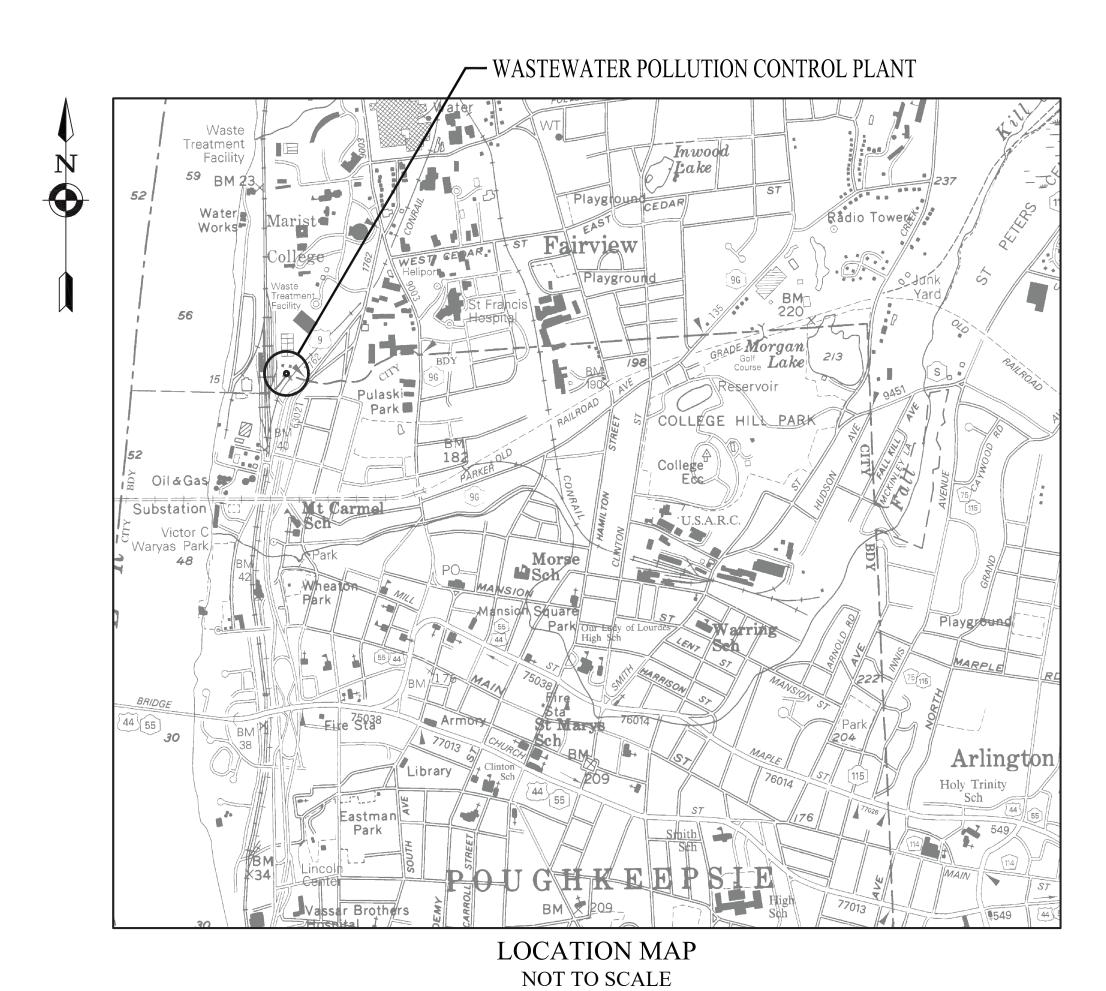


DRAWING INDEX:

GENERAL:
WPCP G001 TITLE SHEET


HVAC:
WPCP H-200 HVAC ROOF PLAN - DEMOLITION, NEW WORK, DETAILS, & SCHEDULES WPCP H-201 HVAC FIRST FLOOR PLAN - DEMOLITION, NEW WORK, & SCHEDULES


www.clarkpatterson.com

	DESCRIPTION	ISSUED FOR EFC REVIEW ISSUED FOR BID
	ВУ	RT
SNC	DATE	03/06/2019
REVISIONS	NO.	7 - 2

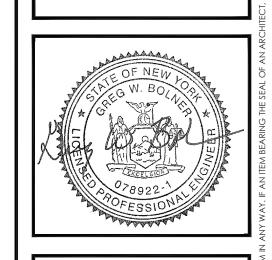

DATE	DRAWN	CHECKED								
3/01/2019	MD	RJT								
scale NTS										
SHEET TITLE										
TITLE SHE	ET									

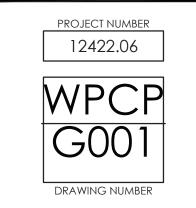

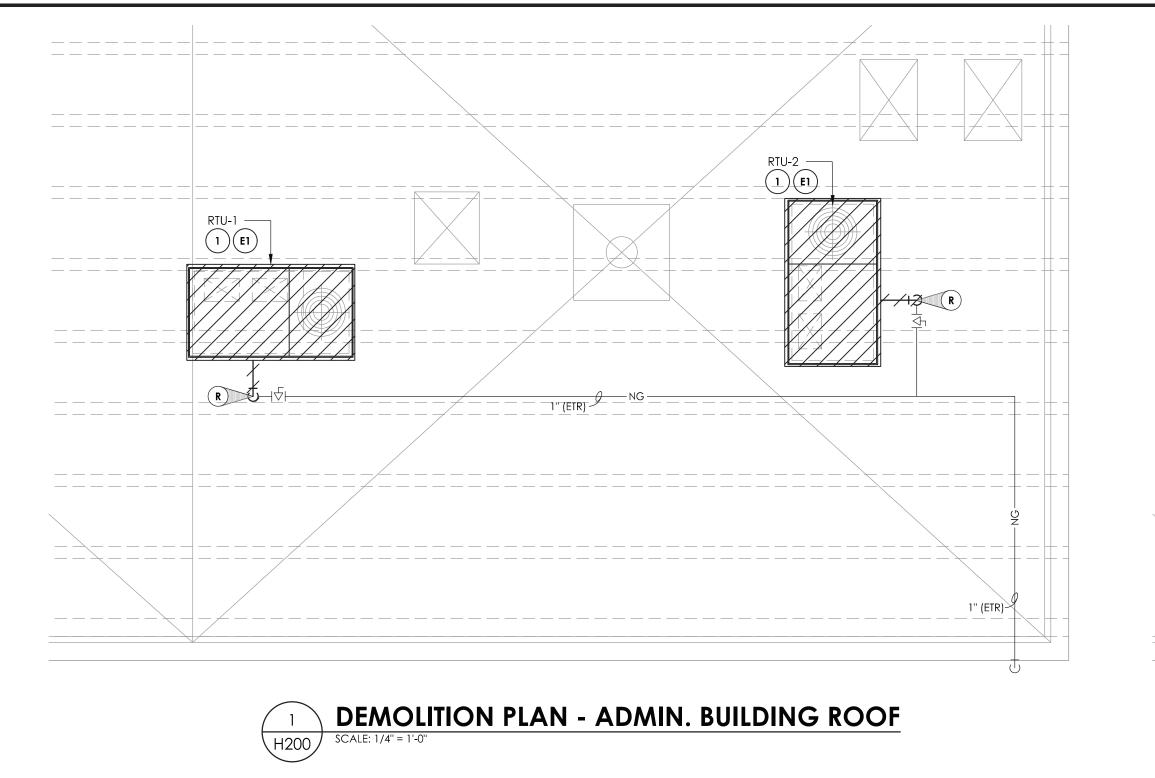

- CURB ADAPTER


INTERNAL BAFFLING

SUPPLY AIR PLENUM

- ROOF CURB ADAPTER

- 1-1/2" X 1-1/2" X 3/16" WELDED

STEEL ANGLE SUPPORT

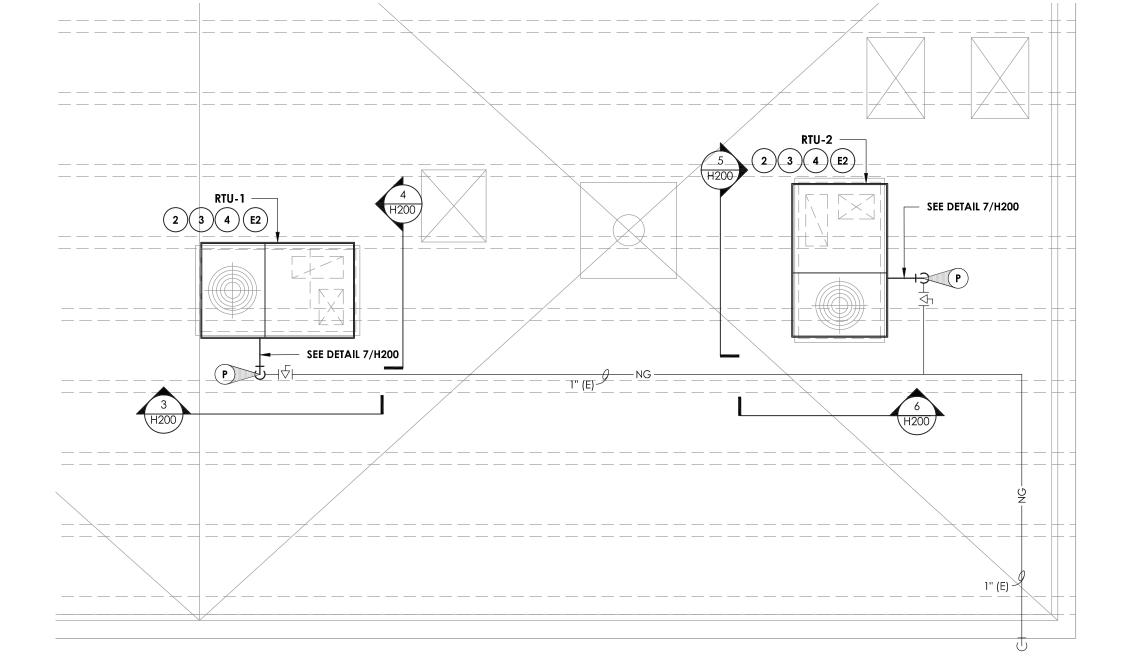

KEY NOTES:

- 1 REMOVE EXISTING ROOF TOP UNIT, DISCONNECT GAS PIPING, CONTROLS, AND ASSOCIATED ROOM THERMOSTAT. PREPARE ROOF CURB AND DUCTWORK FOR CONNECTION TO NEW RTU.
- INSTALL RTU ON EXISTING ROOF CURB USING MANUFACTURES CURB ADAPTER KIT, MODIFY EXISTING DUCTWORK FOR CONNECTION TO RTU, CONNECT RTU TO EXISTING GAS PIPING. PROVIDE CONDENSATE TRAP AT UNIT DRAIN CONNECTION. PATCH AND FLASH ROOF CURB AS NEEDED. PROVIDE ROOFING WORK BY A QUALIFIED CONTRACTOR, MAINTAIN ALL WARRANTIES.
- 3 CLEAN EXISTING SUPPLY AIR DUCTWORK.
- 4 PROVIDE PROTECTION FOR EXISTING ROOFING MEMBRANE DURING ENTIRE CONSTRUCTION PROJECT. PROTECTION METHODS SHALL NOT VOID THE ROOFING MANUFACTURER WARRANTEE.


KEY NOTES: ELECTRICAL


- DISCONNECT EXISTING ROOF TOP UNIT FOR REMOVAL. PULL BACK WIRING AND CONDUIT AND TAG FOR REUSE.
- RECONNECT NEW RTU DISCONNECT SWITCH TO EXISTING CONDUIT AND WIRING TAGGED FOR REUSE. REWORK/EXTEND CONDUIT AND WIRING AS NECESSARY. WIRE RTU TO DISCONNECT SWITCH.

P POINT OF CONNECTION

SPACE THERMOSTAT



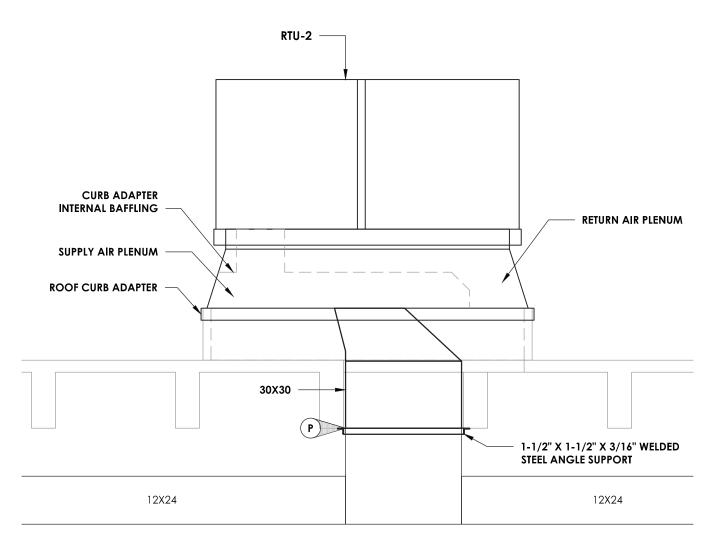

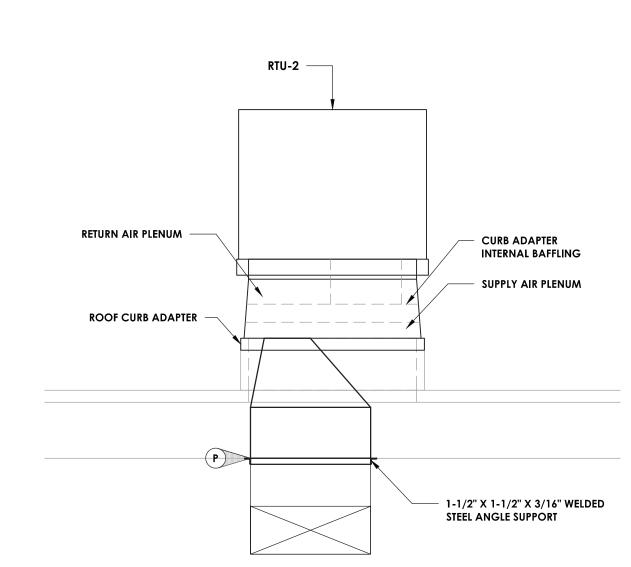



30X30

30X30

RTU-1 -

RETURN AIR PLENUM

12X24



RETURN AIR PLENUM

1-1/2" X 1-1/2" X 3/16"

WELDED STEEL ANGLE

SUPPORT

CURB ADAPTER


INTERNAL BAFFLING

SUPPLY AIR PLENUM

ROOF CURB ADAPTER

12X30



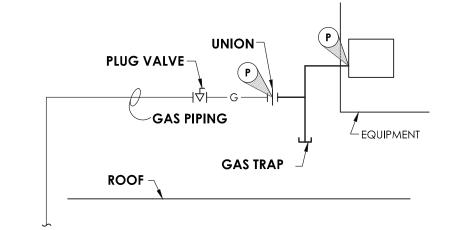



6 FRONT ELEVATION - RTU-2 SCALE: 1/2" = 1'-0"



CONFERENCE & LUNCH ROOM	
CORRIDOR OFFICE NO.1	
LOCKER OFFICE NO.2	
MEN CLOSET CLOSET	В
WOMEN LABORATORY ELECTRICAL EQUIPMENT VESTIBLE VESTIBLE	
	(A

8	THERMOSTAT LOCATIONS
H200	SCALE: NO SCALE

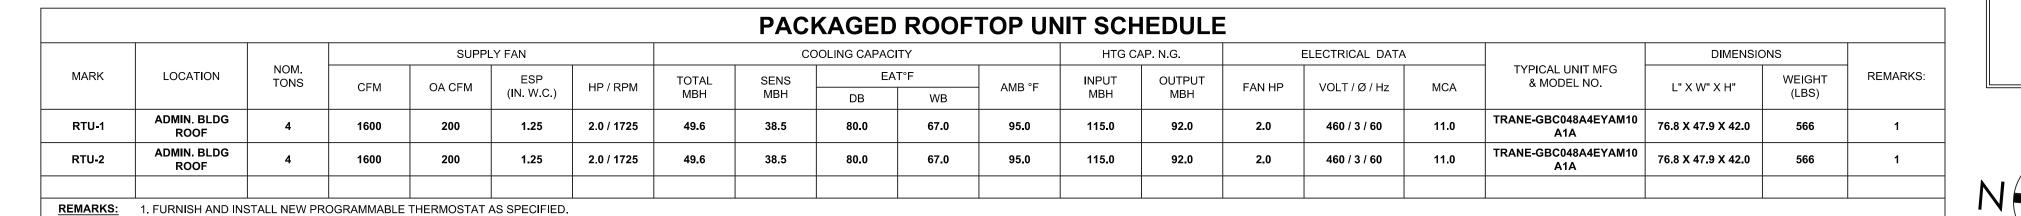

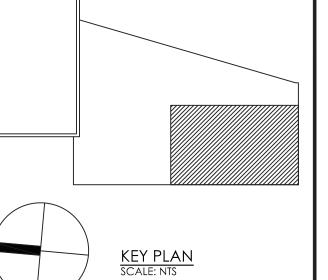

Clark Patterson Lee


NEWBURGH, NEW YORK 12550 TEL (845) 567-6700 FAX (845) 567-9614 www.clarkpatterson.com

50 FRONT STREET, SUITE 202

NO. DATE BY DESCRIPTION

1 03/06/2019 RT ISSUED FOR EFC REVIEW

2 03/25/2020 RT ISSUED FOR BID

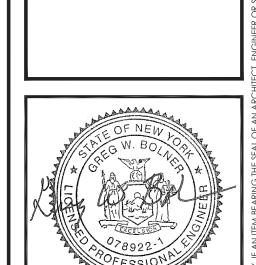

CITY OF POUGHKEEPSIE
ENGINEERING DEPARTMENT
WATER POLLUTION CONTROL PLANT
IMPROVEMENTS

DATE DRAWN CHECKED
3/01/2019 MD RJT

SCALE AS NOTED

SHEET TITLE


HVAC ROOF PLAN -

HVAC ROOF PLAN DEMOLITION, NEW WORK
DETAILS, & SCHEDULES.

PROJECT NUMBER
12422.06

WPCP
H200

DRAWING NUMBER

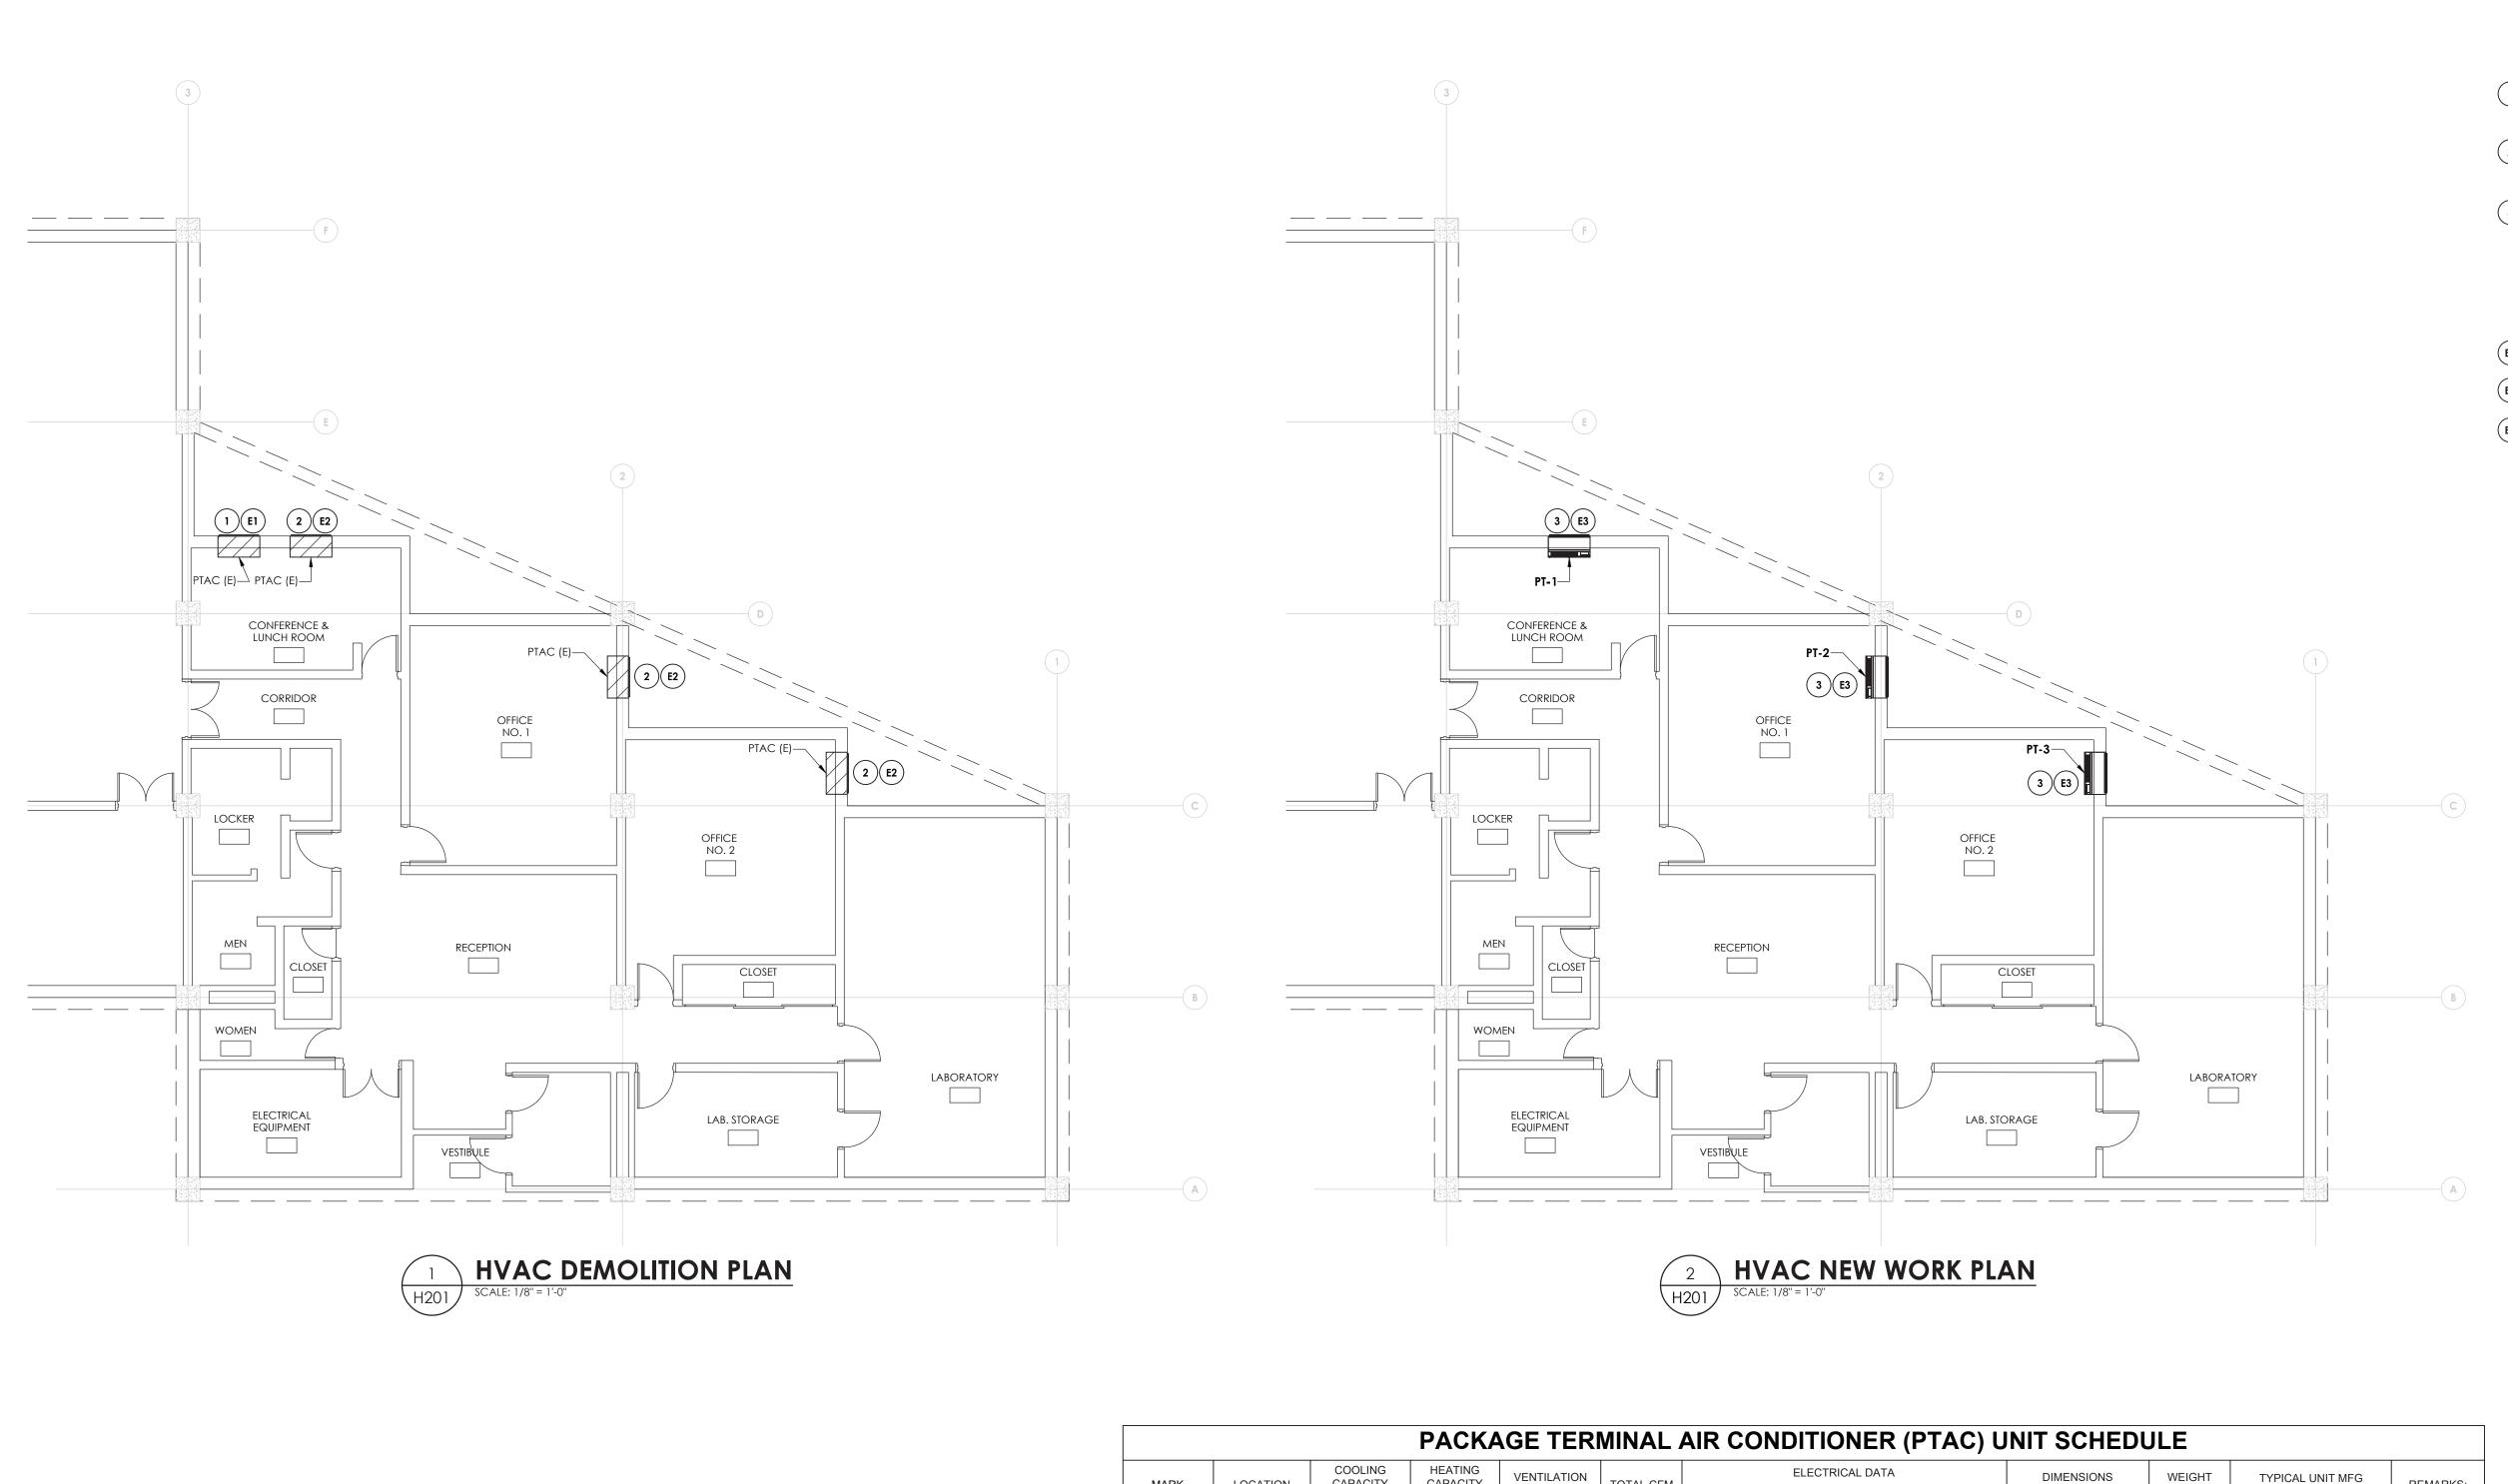

	PACKAGE TERMINAL AIR CONDITIONER (PTAC) UNIT SCHEDULE												
MARK	LOCATION	COOLING CAPACITY (BTU/h)	HEATING CAPACITY (MBH/KW)	VENTILATION AIR (CFM)	TOTAL CFM	ELECTRICAL DATA			DIMENSIONS	WEIGHT	TYPICAL UNIT MFG	REMARKS:	
						VOLTS	PHASE	MCA	EER	(L" X W" X H")	(LBS)	& MODEL NO.	TALIMATANO.
PT-1	CONFERENCE/ LUNCH ROOM	14,800	12.6 / 3.8	65	340	277	1	17.9	10.0	42 X 21-1/2 X 16-1/16	113	AMANA - PTC154G35A	1, 2
PT-2	OFFICE # 1	14,800	17.1 / 5.0	65	340	277	1	23.9	10.0	42 X 21-1/2 X 16-1/16	113	AMANA - PTC154G35A	1, 2
PT-3	OFFICE # 2	14,800	17.1 / 5.0	65	340	277	1	23.9	10.0	42 X 21-1/2 X 16-1/16	113	AMANA - PTC154G35A	1, 2
REMARKS:	1 PROVIDE WALL	SLEEVE TO MATO	CH WALL-DEPTH										

1. PROVIDE WALL SLEEVE TO MATCH WALL-DEPTH.

2. PROVIDE ANODIZED ALUMINUM ARCHITECTURAL OUTDOOR GRILLE.



- REMOVE PACKAGE TERMINAL AIR CONDITIONER (PTAC) IN IT'S ENTIRETY, WALL SLEEVE, AND OUTDOOR GRILLE. PATCH AND REPAIR WALL OPENING WEATHER TIGHT WITH LIKE MATERIALS.
- REMOVE PACKAGE TERMINAL AIR CONDITIONER (PTAC) IN IT'S ENTIRETY, WALL SLEEVE, AND OUTDOOR GRILLE. PREPARE WALL OPENING FOR NEW EQUIPMENT.
- 3 INSTALL NEW PACKAGE TERMINAL AIR CONDITIONER (PTAC), NEW WALL SLEEVE TO MATCH WALL DEPTH, AND ANODIZED ALUMINUM OUTDOOR

KEY NOTES: ELECTRICAL


- DISCONNECT PTAC FOR REMOVAL. REMOVE ALL WIRING AND COUDUIT BACK TO SOURCE. LABEL BREAKER AS SPARE.
- DISCONNECT PTAC FOR REMOVAL. PULL BACK WIRING AND CONDUIT, TAG FOR RE-USE.

CONNECT NEW PTAC UNIT TO EXISTING TAGGED CIRCUITRY. REWORK/EXTEND CONDUIT AND WIRING AS NECESSARY.

Clark Patterson Lee

50 FRONT STREET, SUITE 202 NEWBURGH, NEW YORK 12550 TEL (845) 567-6700 FAX (845) 567-9614 www.clarkpatterson.com

		DESCRIPTION	ISSUED FOR EFC REVIEW ISSUED FOR BID		
		ВҮ	RT RT		
	SNC	DATE	03/06/2019		
	REVISIONS	NO.	1 2		

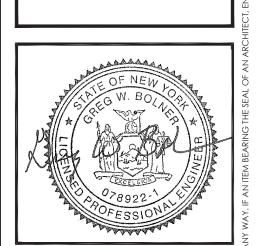

CITY OF POUGHKEEPSIE ENGINEERING DEPARTMENT water pollution control pl improvements

3/01/2019 MD SCALE 1/8'' = 1'-0''hvac first floor plan DEMOLITION, NEW WORK, & SCHEDULES.

12422.06

H201 DRAWING NUMBER