

DRAWING LIST: ELECTRICAL SITE PLAN PANEL SCHEDULES AND RISER DIAGRAM ELECTRICAL PANEL SCHEDULES E-2E - 2.1ELECTRICAL PANEL SCHEDULES ELECTRICAL RISER DIAGRAM E-3BASEMENT POWER PLAN E-4E-5FIRST FLOOR POWER PLAN MEZZANINE FLOOR POWER PLAN E-6SECOND FLOOR POWER PLAN E-7E-8 ROOF POWER PLAN BASEMENT LIGHTING PLAN E-9FIRST FLOOR LIGHTING PLAN E-11 MEZZANINE LIGHTING PLAN E-12 SECOND FLOOR LIGHTING PLAN E - 13ROOF LIGHTING PLAN E-14 BASEMENT MISCELLANEOUS SYSTEMS E-15 FIRST FLOOR MISCELLANEOUS SYSTEMS E-16 MEZZANINE MISCELLANEOUS SYSTEMS E-17 SECOND FLOOR MISCELLANEOUS SYSTEMS E-18 COMPUTER SYSTEM RISER DIAGRAM E-19 TELEPHONE & TV RISER DIAGRAMS ACCESS SYSTEM RISER DIAGRAM E-20 E-21 SURVEILLANCE SYSTEM RISER DIAGRAM PA RISER DIAGRAM E-22 E - 23RADIO & WIFI RISER DIAGRAM IT ROOM PLAN & DETAILS

ELECTRICAL

- ALL WORK SHALL BE PERFORMED AND INSTALLED IN ACCORDANCE WITH THE LATEST EDITION OF THE NATIONAL ELECTRIC CODE AND ANY OTHER GOVERNING CODES OR STANDARDS HAVING JURISDICTION.
- ALL ELECTRICAL EQUIPMENT SHALL BE GROUNDED IN ACCORDANCE WITH ARTICLE 250 OF THE NATIONAL ELECTRIC CODE.
- CONTRACTOR SHALL PAY FOR AND SECURE ALL UNDERWRITERS CERTIFICATES.
- ALL WIRE CABLE SHALL BE COPPER UNLESS OTHERWISE INDICATED. ALL CIRCUIT RUNS TO CONTAIN 3 WIRES UNLESS NOTED OTHERWISE.
- COORDINATE LOCATION OF RECEPTACLES WITH ARCHITECT.
- ALL SWITCHES AND RECEPTACLES ARE TO BE RECESSED UNLESS NOTED OTHERWISE.
- ALL EXPOSED WIRING TO BE IN CONDUIT UNLESS OTHERWISE INDICATED SEE SPECS.
- ELECTRICAL CONTRACTOR SHALL COORDINATE HIS WORK WITH OTHER TRADES AND COORDINATE THE SCHEDULING OF HIS WORK WITH THE OTHER CONTRACTORS.
- THE ELECTRICAL CONTRACTOR SHALL SUPPLY & INSTALL ALL POWER FOR HVAC EQUIPMENT, PLMB, FA, SP AND COORDINATE INSTALLATION WITH CONTRACTOR.
- 10. PROVIDE ALL TEMPORARY LIGHT AND POWER REQUIRED FOR THE DURATION OF THE PROJECT.
- 11. ELECTRICAL CONTRACTOR SHALL MAKE ARRANGEMENTS WITH UTILITY FOR NEW SERVICE AND CO-ORDINATE WITH UTILITY. OWNER TO PAY FOR ALL FEES ASSOCIATED WITH SAME.
- 12. ELECTRICAL CONTRACTOR SHALL MAKE ARRANGEMENTS WITH UTILITY FOR DISCONNECT AND REMOVAL OF ALL THE EXISTING ELECTRICAL SERVICE .
- ALL MASONRY & FOUNDATION SLEEVES REQUIRED BY EACH TRADE SHALL BE PROVIDED AND INSTALLED BY THAT TRADE IN COORDINATION WITH THE GC SCHEDULE OF MASONRY/CONCRETE EACH PRIME CONTRACTOR IS RESPONSIBLE FOR THEIR OWN EXCAVATIONS AND BACKFILLING IN LIFTS TO 95% COMPACTION. SITEWORK TRENCHING REQUIRED FOR THE INSTALLATION OF ANY SUBSURFACE WORK SHALL FULLY COORDINATED BY EACH TRADE IN ASSOCIATION WITH THEIR OWN SCOPE OF WORK. TRENCHING SHALL
- ELECTRICAL CONTRACTOR TO PROVIDE A CONTINGENCY ALLOWANCE OF OF \$20,000.00.

BE FULLY COMPACTED AND SIZED AS NEEDED BY EACH TRADES

- ELECTRICAL CONTRACTOR IS RESPONSIBLE FOR PREPARATION OF ALL PERMIT APPLICATIONS, DRAWINGS AND REPORTS AND FILING OF ANY AND ALL APPROVALS FOR FIRE DETECTION SYSTEM INSTALLATION.
- EC TO PROVIDE TEMPORARY SERVICE FOR SITE TEMPORARY HOT BOX
- GENERAL SUMMARY OF TEMPORARY & PERMANENT ELECTRICAL SERVICE SCOPE OF WORK REQUIRED TO BE PROVIDED/INSTALLED/COORDINATED BY ELECTRICIAN SHALL BE AS FOLLOWS: * NEW TEMPORARY SERVICE TO BE USED TO RUN THE EXISTING FIREHOUSE DURING CONSTRUCTION EXISTING POLE MOUNTED SERVICE WILL BE REQUIRED TO BE REMOVED TO ALLOW FOR THE NEW FACILITY SERVICE (EC TO COORDINATE WITH LOCAL UTILITY COMPANY).
- * ADDITIONAL TEMPORARY SERVICE #2 IS REQUIRED TO THE GC PROVIDED SITE TRAILER AND SITE. THIS INCLUDES REPLACEMENT OF THE EXISTING TEMPORARY SERVICE METER & PANEL AND INCLUDE A NEW FEED TO THE TRAILER & A FEED/PANEL TO THE PROPOSED NEW BUILDING WHEN REQUIRED DURING TRANSITION. LOCATE FOR ALL TRADES USE.
- TIMECLOCKS FOR ALL REQUIRED SITE LIGHTING FIXTURES TO BE "INTERMATIC" MODEL: ET8015C", WIRED OFF-OF CIRCUIT INDICATED
- ACCESS & CONTROL SYSTEM INSTALLATION BY OWNER PRIVATE VENDOR (TBD). ELECTRICIAN PROVIDES/INSTALLS ALL WIRING TO THESE LOCATIONS AS CALLED FOR IN THE CONTRACT DOCUMENTS. WIRING TO BE RUN, TESTED, CERTIFIED & LABELED TO PUNCH DOWN BLOCKS AT IT ROOM. GC PROVIDES & INSTALLS ELECTRIC STRIKE HARDWARE.

DATE: ISSUE

04-21-21 ISSUED FOR BIDDING

SEAL:

, ROANOKE VERHEAD, N (631) 7



206 HARRISON AVE HARRISON, NY 10528 FIRE MODI

HARRIS(

PROJECT #: 2020-04

DRAWN BY: SEND. ARCH.

CAD FILE: P/2020/HFD 2020-04

DRAWING#:

oltage:	208 / 120 V				СВ	Х	Equip. G	round Bus		Poles:	42			Min CB IC	65,000 AIC	
/lain Bus	800A		Х	MCB	800A		Isol. Gro			Mtg:	SURFACE			Comment	through feed	
Ckt		Load	В	reaker	Minimum	n Brai	nch		Phase		Minimum Branch	Breaker		Load		Ck
# Serv	/es	VA	Р	Trip	Circuit			Α	В	С	Circuit	Trip	Р	VA	Serves	#
1 ELE	VATOR	8454	3	130				18877		_		200	3	10423	BASEMENT PNL (BPP2)	2
3		8454							18877					10423		4
5		8454								18877				10423		6
7 RTU	J-1	5572	3	70				10471		_		60	3	4899	RTU-2	8
9		5572							10471					4899		10
11		5572								10471				4899		13
13 RTU	J-3	2594	3	40				5092		_		40	3	2498	RTU-4	1
15		2594							5092					2498		1
17		2594								5092				2498		18
19 CU-	1	16223	1	30				17804		_		25		1581	CU-2/FC-1&2	20
21		16223							17804					1581		2
23 CU-	3/FC-3	915	1	30					•	1830		30		915	CU-4/FC-4	2
25		915						1830		_				915		20
27 AHI	J-1	520	1	15					3328			30	1	2808	AIR COMPRESSOR	28
29		520								3328				2808		30
31 ALT	AHU-2	2522	3	35				8526		_		60	3	6004	ALT APP BAY CU-7	32
33		2522							8526					6004		34
35		2522							•	8526				6004		30
37								0		-						38
39									0							40
41										0						4:
						_		62600	64098	48124	VA per phase					
	Total Conne	ected Load (VA)	17	74822	1		521.7	534.2	401.0	Amps per phase	485		Total Cor	nnected Load (Amps)	

oltage:	208 / 120 V		,		СВ		uip. Ground Bu	ıs		Poles:	42			Min CB IC	•	
lain Bus:	800A		Х		800A		ol. Ground Bus			Mtg:	SURFACE	1		Comment	5	1
ckt		Load	\vdash	reaker	Minimum	n Branch		Pr	nase		Minimum Branch	Breaker		Load		Ckt
# Serve		VA	Р	Trip	Circuit		A	_	В	С	Circuit	Trip	P	VA	Serves	#
	BASEMENT PNL (BPP1)	803	3	100			2290			Ì		100	3	1487	MEZZ PNL (MPP1)	2
3		803						2:	290			4		1487		4
5		803								2290				1487		6
_	FL PNL (2PP1)	6004	3	125			960			1		100	3	3602	2ND FL PNL (2LP1)	8
9		6004						9	606			4		3602		10
11		6004								9606				3602		12
13 IT RO	OM PNL (IT1)	3600	3	100			1533	4		•		40	3	11734	EXISTING PNL (LP-1)	14
L5		3600						15	5334					11734		16
17		3600								15334				11734		18
19 CU-6,	/FC-6	915	1	30			915					25				20
21		915						9	915							22
23 CU-5,	/FC-5	915	1	30						915		30				24
25		915					915									26
27			3						0				3			28
29										0						30
31							0									32
33			1	20					0			20	1			34
35			1	20						0		20	1			36
37			1	20			0					20	1			38
39			1	20					0			20	1			40
41			1	20						0		1				42
			•		•		2906	0 28	3145	28145	VA per phase	_	_		1	
	Total Connec	ted Load ((VA)	8	5350	7	242.		34.5		Amps per phase	237	,	Total Cor	nnected Load (Amps)	

oltage:	208 / 120 V				СВ	XE	quip. Gr	round Bus		Poles:	42			Min CB IC:	22,000 AIC	
/lain Bus:	100 A		Х	MCB	100 A	ls	sol. Grou	und Bus		Mtg:	SURFACE			Comment	s:	
Ckt		Load	Br	eaker	Minimum	Branc	:h		Phase	_	Minimum Branch	Breaker		Load		
# Serves		VA	Р	Trip	Circuit			Α	В	С	Circuit	Trip	Р	VA	Serves	╧
1 DH-1		1010	1	20	2#12,#12	2G 3/4	1"C.	1190		-	2#12,#12G 3/4"C.	20	1	180	ELEV MACH RM REC*	\perp
3 CONV	REC*	540	1	20					740			20	1	200	ELEV LIGHTING	
5 BASEN	MENT LIGHTING	480	1	20						1080		20	1	600	TV REC DAY RM	
7 CONV	REC DAY RM	720	1	20				900		_		20	1	180	REST RM REC	
9 COUN	TER REC DAY RM	360	1	20					540			20	1	180	REST RM REC	
11 COUN	TER REC DAY RM	360	1	20						1760		20	1	1400	HAND DRYER	
13 STOVE		180	1	15				1580				20	1	1400	HAND DRYER	
15 FRIDG	E	350	1	20					1250			20	1	900	APP/DAY RM CORR REC	
17 ELEVA	TOR VENTILATION	1144	1	30						1528		20	1	384	DAY RM / CORR LTG	
19		1144						1294	1			15	1	150	UNIT HEATERS BASEMENT	
21 GEN B	LOCK HTRS	750	1	20					1100			15	1	350	KIT HOOD	
23		750								1100		15	1	350	CUH-4 VESTIBULE	1
25 GENER	RATOR	150	1	20				500]			15	1	350	CUH-5 BASEMENT STAIR	T
27			1	20					0	1		20	1			T
29			1	20						0		20	1			1
31			1	20				0				20	1			1
33			1	20					0			20	1			1
35			1	20						0		20	1			
37			1	20				0]			20	1			T
39			1	20				-	0			20	1			1
41			1	20						0		 	_			1
		ı						5464	3630	5468	VA per phase	1				<u> </u>
	Total Conne	cted Load (VA)	14	4562	7		45.5	30.3	45.6	Amps per phase	40		Total Cor	nnected Load (Amps)	

/oltage:	208 / 120 V				MLO	X Equip. G	round Bus		Poles:	42			Min CB IC	: 22,000 AIC	
∕lain Bus:	225 A			MCB	150 A	Isol. Gro	und Bus		Mtg:	SURFACE			Comment	s:	
Ckt		Load	В	reaker	Minimun	n Branch		Phase		Minimum Branch	Breaker	-	Load		Ck
# Serves		VA	Р	Trip	Circuit		Α	В	С	Circuit	Trip	Р	VA	Serves	#
1					2#12,#1	.2G 3/4"C.	0		_						2
3					2#12,#1	.2G 3/4"C.		961			15	3	961	GEAR WASHER (1ST FL)	
5 EXIST	KIT. PNL (KP-1)	3587	3	100				_	4548				961		6
7		3587					4548		_				961		
9		3587						3767			30	3	180	EXIST FOYER PNL (1ST FL)	_ 1
11 PANE	L (BPP2A)	5295	3	100					7215				1920		1
13		5295					5545		_		15	1	250	CUH-3 LOBBY	1
15		5295						5295							1
17									0						1
19							0		_						2
21								0							2
23								_	0						2
25							0		_						2
27								0							2
29								_	0						3
31							0		_						3
33								0							3
35								_	0						3
37							0		_						3
39								0	<u> </u>						4
41									0						4
						_	10093	10023	11763	VA per phase					
	Total Conf	nected Load	(VA)	1 3	1879		84.1	83.5	98.0	Amps per phase	88		Total Cor	nnected Load (Amps)	

oltag/	e: 208 / 120 V			1	MLO	X Equip. 0	Fround Bus		Poles:	42			Min CB IC	: 22,000 AIC	
√lain E	Bus: 100 A			MCB	100 A	Isol. Gro	ound Bus		Mtg:	SURFACE			Comment	s:	
Ckt		Load	В	reaker	Minimum	Branch		Phase	_	Minimum Branch	Breaker		Load		Ck
# S	Serves	VA	Р	Trip	Circuit		Α	В	С	Circuit	Trip	Р	VA	Serves	#
1 (CONVIENANCE REC	540	1	20	2#12,#12	2G 3/4"C.	1090		-	2#12,#12G 3/4"C.	20	1	550	WATER HTR (WH-1)	1
3 E	BOILER (B-1)	750	1	20	2#12,#12	2G 3/4"C.		1000			20	1	250	N. APP BAY UNIT HTRS	4
5 E	BOILER PUMPS P1&2	1165	1	20				_	1415		20	1	250	GEAR AREA UNIT HTRS	6
7		1168	1	20			1348		_		15	1	180	GEAR AREA FAN EF-4	8
9 5	SPARE		1	20				250			20	1	250	TOWER CUH-2	1
11 S	SUMP PUMPS	750	1	20				_	750		20	1		SPARE	1
13 (GARAGE DOOR 1	1920	1	20			2100		_		15	1	180	EF-3 GEAR SHOWER	1
15 (GARAGE DOOR 2	1920	1	20				2100			20	1	180	VIF CII XR	1
17 (GARAGE DOOR 3	1920	1	20					2100		20	1	180	VIF CIRCUIT	1
19 S	SPARE		1	20			500]			20	1	500	N. APP BAY VIF CIRCUIT	2
21 \	/IF CIRCUIT	500	1	20				1000			20	1	500	N. APP BAY VIF CIRCUIT	2
23 <i>A</i>	ALARM ROOM CNTR REC	360	1	20					860		20	1	500	N. APP BAY VIF CIRCUIT	2
25 <i>A</i>	ALARM ROOM CNTR REC	180	1	20			360]			20	1	180	EXT. GFCI ENTRANCE REC	2
27 <i>A</i>	ALARM ROOM CONV REC*	360	1	20				540	1		20	1	180	STAIR TOWER (1ST FL)	2
29 V	WASHER/DRYER	1200	1	15			1		1536		15	1	336	NEW NORTH APP BAY LTG	3
31 E	XIST NORTH APP BAY LTG	720	1	15			900				20	1	180	GEAR AREA SHOWER REC	3
33 V	WASH & ALARM RM LTG	288	1	15				468	1		20	1	180	TRAFFIC LIGHT/RESPONDER	3
35 L	OBBY LTG (1ST FL)	150	1	15			1		650		20	1	500	FUEL PUMP	3
37 (GEAR AREA REC	360	1	20			360]						BLANK	3
39 E	BLANK							0			30	1		VIF CIRCUIT	4
41 E	BLANK								0					BLANK	4
							6658	5358	7311	VA per phase					_
	Total Connec	ted Load (VA)	1	9327		55.5	44.7	60.9	Amps per phase	54		Total Cor	nnected Load (Amps)	

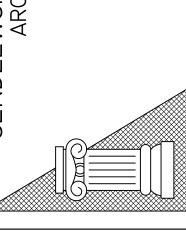
oltage: 208 / 120 V		Т		CB X Equip. 6	Fround Bus		Poles:	42			Min CB IC	: 22,000 AIC	
ain Bus: 200A		х			ound Bus		Mtg:	SURFACE			Comment	-	
kt	Load	+	reaker	Minimum Branch	1	Phase		Minimum Branch	Breaker		Load		Ck
# Serves	VA	Р	Trip	Circuit	Α	В	С	Circuit	Trip	Р	VA	Serves	#
1 BAUER COMP	1921	3	20	2#12,#12G 3/4"C.	4803		•	2#12,#12G 3/4"C.	30	3	2882	NEDERMAN EXH	2
3	1921					4803		· ·			2882		4
5	1921						4803	1			2882		6
7 EXIST SUB PANEL (LP1A)	4300	3	100		6931				60	3	2631	EXIST SUB PNL (LP2A)	8
9	4300					6931					2631		10
.1	4300						6931	1			2631		12
3 AIR PURIFIER AP-1	936	1	15		936				20	1		CHIEF FAN COIL FC-2	14
.5	936					1116	1		20	1	180	CHIEF BATH EXH	16
7 AIR PURIFIER AP-2	936	1	15				936		20	1			18
9	936				936								20
1						0							22
3							0						24
5					0		<u></u>						26
7						0			20	1			28
9							0		20	1			30
1					0		_		20	1			32
3						0			20	1			34
55							0		20	1			36
37					0				20	1			38
9						0			20	1			40
1							0						42
					13606	12850	12670	VA per phase					

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SEAL:

SENDLEWSKI ARCHITECTS PC
ARCHITECTS - PLANNERS

215 ROANOKE AVENUE
RIVERHEAD, NY 11901
(631) 727-5352



HARRISON FIRE DEPT.
PROPOSED ADDITION
206 HARRISON AVE
HARRISON, NY 10528

PROJECT #: 2020-04

DRAWN BY: SEND. ARCH.

CAD FILE: P/2020/HFD 2020-04

DRAWING#:

olta/	ge: 208 / 120 V				СВ	X Equip. 6	Fround Bus		Poles:	42			Min CB IC:	: 22,000 AIC	
/lain	Bus: 100A		Х	MCB	100A	Isol. Gro	ound Bus		Mtg:	SURFACE			Comment	s:	
Ckt		Load	Ві	reaker	Minimum	Branch		Phase		Minimum Branch	Breaker		Load		Ck
#	Serves	VA	Р	Trip	Circuit		Α	В	С	Circuit	Trip	Р	VA	Serves	#
1	EXIST REC	1080	1	20	2#12,#12	2G 3/4"C.	1355		_	2#12,#12G 3/4"C.	20	1	275	LIGHTING	2
3	EXIST REC	1080	1	20				1580			20	1	500	GAS BOILER	4
5	EXIST REC	1080	1	20			1		1355		20	1	275	LIGHTING	6
7	EXIST REC	1080	1	20			1355				20	1	275	LIGHTING	8
9	EXIST FREEZER	500	1	20				1580	1		20	1	1080	EXIST REC	1
11	EXIST BAR LIGHTING	168	1	20			1 '		668		20	1	500	BOILER CONTROLS	1
13			1	20			1165				15	1	1165	BOI.ER PUMPS P-3,4	1
15			1	20				0			1	1			1
17			1	20			1 '		1165		15	1	1165	BOILER PUMPS P-5,6	1
19							0				7				2
21								1165	1		15		1165	BOILER PUMPS P-7,8	2
23			П				1		0		7				2
25			1	20			0								2
27			1	20				0	1		20	1			2
29			1	20			1 '		0		20	1			3
31			1	20			0				20	1			32
33			1	20				0	1		20	1			3
35			1	20			1 '		0		20	1			3
37			1	20			0				20	1			3
39			1	20				0	1		20	1			4
41			1	20			1 '		0						4
							3875	4325	3188	VA per phase	•			•	
	Total Connec	cted Load (VA)	1	1388	1	32.3	36.0	26.6	Amps per phase	32		Total Cor	nnected Load (Amps)	

oltage:	208 / 120 V				СВ	X Equip. G	round Bus		Poles:	42			Min CB IC	: 22,000 AIC	
/lain Bus:	100A		Х	MCB	MLO	Isol. Gro	und Bus		Mtg:	SURFACE			Comment	:s:	
Ckt		Load	В	reaker	Minimum	Branch		Phase	_	Minimum Branch	Breaker	-	Load		С
# Serve	s	VA	Р	Trip	Circuit		Α	В	С	Circuit	Trip	Р	VA	Serves	
1 ICE N	1ACHINE	1600	1	20	2#12,#12	2G 3/4"C.	3100		_	2#12,#12G 3/4"C.	30	2	1500	STEAM TABLE	
3 HOOI	D LIGHTS	180	1	15				1680					1500		
5 RECE	PTACLES	1500	1	20				_	1700		15	1	200	LIGHTING	
7 COUN	NTER RECEPTACLES	360	1	20			1960		_		20	1	1600	HOOD FAN #1	
9 REFR	IGERATOR	540	1	20				2140			20	1	1600	HOOD FAN# 2	1
11 RECE	PTACLES	180	1	20				_	180						1
13							0		_						1
15								0							1
17									0						1
19							0								2
21								0							2
23									0						2
25							0]							- 2
27								0							2
29									0						3
31							0]							3
33								0							3
35							1		0						3
37							0]	_						3
39								0							
41									0						4
		•			•		5060	3820	1880	VA per phase	•	_	•	•	•
	Total Conne	cted Load (VA)	1	0760	1	42.2	31.8	15.7	Amps per phase	30		Total Co	nnected Load (Amps)	

oltage:	208 / 120 V				СВ		. Ground Bus		Poles:	42			Min CB IC	· · · · · · · · · · · · · · · · · · ·	
lain Bus:	100A		Х		100A		Ground Bus	51	Mtg:	SURFACE	1		Comment	S:	_
Ckt		Load	-	reaker	Minimum	n Branch		Phase	T 6	Minimum Branch	Breaker	_	Load		
# Serv		VA	Р	Trip	Circuit		Α	В	С	Circuit	Trip	P	VA	Serves	+
	t unit heater so. Bay	250	1	15	2#12,#1	2G 3/4"C.	750		7	2#12,#12G 3/4"C.	20	1	500	OUTSIDE SIGN LTG	4
	t unit heater so. Bay	250	1	15				666			20	1	416	EXIST SO. APP BAY LTG	4
_	v unit heater so. Bay	375	1	15				1	775		20	1	400	EXIST SO. APP BAY LTG	4
_	ST SO. BAY REC	540	1	20			740		_		20	1	200	EXIST EXH FAN APP ROOM	4
9 EXIS	ST SO. BAY REC	540	1	20			_	1356			20	1	816	NEW SO. APP BAY LTG	4
_	ST FRONT REC	540	1	20				1	1540		20	1	1000	OUTSIDE FRONT LIGHTS	
13 NEV	V GARAGE DOOR	2000	1	30			2336		_		20	1	336	CHIEFS LTG	
15 NEV	V BAY CONV REC	1080	1	20				2580			20	1	1500	CHIEFS BATH DRYER	
17 CHI	EFS OFF CONV/TV	360	1	20				_	540		20	1	180	CHIEFS BATH REC	
19 CHI	EFS QUADS	1080	1	20			1580		_		20	1	500	EXIST VIF	
21 MO	NITOR REC SO BAY EAST	720	1	15				1220			20	1	500	EXIST VIF	
23 MO	NITOR REC SO BAY WEST	360	1	15					610		15	1	250	CUH-1 SO STAIR	
25			1	20			0								
27			1	20				0	1		20	1			
29			1	20					0		20	1			
31			1	20			0				20	1			
33			1	20				0	7		20	1			
35			1	20					0		20	1			
37			1	20			0				20	1			
39			1	20				0	7		20	1			
41			1	20					0						
			•				5406	5822	3465	VA per phase		•			
	Total Connect	ted Load (VA)	14	4693	7	45.1	48.5	28.9	Amps per phase	41		Total Cor	nnected Load (Amps)	

/oltage:	208 / 120 V				СВ	X Equip. G			Poles:	42		_	Min CB IC	_	
Main Bus:	100 A	1	Х		100 A	Isol. Gro	und Bus		Mtg:	SURFACE	_		Comment	:S:	
Ckt		Load	-	reaker	Minimum	Branch		Phase		Minimum Branch	Breaker		Load		Cl
# Serves		VA	Р		Circuit		Α	В	С	Circuit	Trip	Р	VA	Serves	#
1 CONV		900	1		2#12,#12	2G 3/4"C.	1180		٦	2#12,#12G 3/4"C.	20	1	280	LIGHTING	2
3 CONV		900	1				4	1200			20	1	300	LIGHTING	
5 CONV		720	1					I	1080		20	1	360	TV/ENTERT QUAD	- 6
7 CONV		720	1				1230		7		15	1	510	PTAC1	8
9 BATH		180	1				1	690				1	510		1
11 BATH	REC	180	1	20				ı	690	4	15	1	510	PTAC 2	1
13			1	20			510		7			Ш	510		1
15			1	20			1	510		4	15	1	510	PTAC 3	1
17			1	20				ı	510				510		1
19							510		7		15	1	510	PTAC 4	2
21							_	510				Ш	510		2
23								ı	510	_	15	1	510	PTAC 5	2
25			1				510		7			Ш	510		2
27			1	20				180			15	1	180	EF-5 MEZZ BATH	2
29			1	20				Ī	0		20	1			3
31			1	20			0		_		20	1			3
33			1	20			4	0			20	1			3
35			1	20					0		20	1			3
37			1	20			0		_		20	1			3
39			1	20			1	0			20	1			4
41			1	20					0						4

oltage:	208 / 120 V				СВ	X E	quip. Gr	ound Bus		Poles:	42			Min CB IC:	22,000 AIC	
1ain Bus:	225 A		X	MCB	125 A	Is	ol. Grou	und Bus		Mtg:	SURFACE			Comment	s:	
Ckt		Load	В	reaker	Minimum	n Brancl	h		Phase	_	Minimum Branch	Breaker		Load		0
# Serves	5	VA	Р	Trip	Circuit			Α	В	С	Circuit	Trip	Р	VA	Serves	
1 OFF 2	10 REC	1260	1	20	2#12,#1	2G 3/4	."C.	2160		_	2#12,#12G 3/4"C.	20	1	900	CORRIDOR	L
3 OFFIC	E 211/211A REC	1080	1	20					2480			20	1	1400	HAND DRYER MENS RM	L
5 OFF 2	12 REC	1080	1	20					-	2480		20	1	1400	HAND DRYER WOMENS RM	
7 BUNK	(216	720	1	20				1220		_		20	1	500	WATER HEATER	
9 BUNK	BATH REC	180	1	20					860			20	1	680	QUIET ROOM REC	
11 BUNK	217 REC/TV	860	1	20						1940		20	1	1080	CONFERENCE RM REC	
13 MEET	ING RM SCREEN	360	1	20				720				20	1	360	CONF RM FLOOR REC	
15 MEET	ING RM PROJECTOR	1200	1	20					1380			20	1	180	MEETING RM REC	
17 STOR	AGE CONV REC	180	1	20						680		20	1	500	FITNESS REC	
19 OFF/0	CORR/BATH LIGHTING	681	1	20				1321				20	1	640	FITNESS REC	
21 FITNE	SS/STORAGE LTG	450	1	20					1000	1		15	1	550	EF-6,7,8	
23 QUIE	T/BUNK LIGHTING	821	1	20						1001		15	1	180	BUNK BATH	
25 ROOF	LIGHTING	50	1	15				50								
27 EF-2 1	IST FL BATHS	180	1	15					180]						
29										0						
31								0								
33									0]						
35										0						
37								0								
39									0]						
41										0						
		•			•			5471	5900	6101	VA per phase	•		•	•	
	Total Connec	cted Load (VA۱	1	7472	7		45.6	49.2	50.8	Amps per phase	48		Total Cor	nnected Load (Amps)	

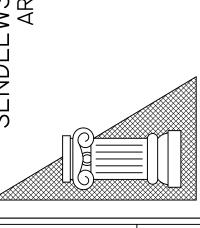
/olta		208 / 120 V				СВ		round Bus		Poles:	42			Min CB IC	: 22,000 AIC	
/lain	Bus:	100 A		X	MCB	100 A	X Isol. Gro	und Bus		Mtg:	SURFACE			Comment	s:	
Ckt			Load	Bı	reaker	Minimum	Branch		Phase		Minimum Branch	Breaker		Load		Ck
#	Serves		VA	Р	Trip	Circuit		Α	В	С	Circuit	Trip	Р	VA	Serves	#
1	LIGHTIN	IG	75	1	20			795		_	2#12,#12G 3/4"C.	20	1	720	DESK QUADS	2
3	SPARE				20				0			20	1		SPARE	4
5	SPARE				20					0		20	1		SPARE	6
7	SPARE				20			0		<u></u>		20	1		SPARE	8
9	SPARE				20				0			15	1		SPARE	10
11	SPARE				15					0		15	1		SPARE	12
13	SPARE				15			0				15	1		SPARE	14
15									0							16
17										0						18
19								0								20
21									0	1						22
23]		0						24
25								0								26
27									0	7						28
29								1		0						30
31								0								32
33									0	7						34
35								1		0						36
37								0								38
39									0	7						40
41								1		0						42
_	•		•			•		795	0	0	VA per phase	•			•	•
		Total Conne	cted Load (VA)		795		6.6	0.0	0.0	Amps per phase	2		Total Cor	nnected Load (Amps)	

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206 HARRISON AVE
HARRISON, NY 10528

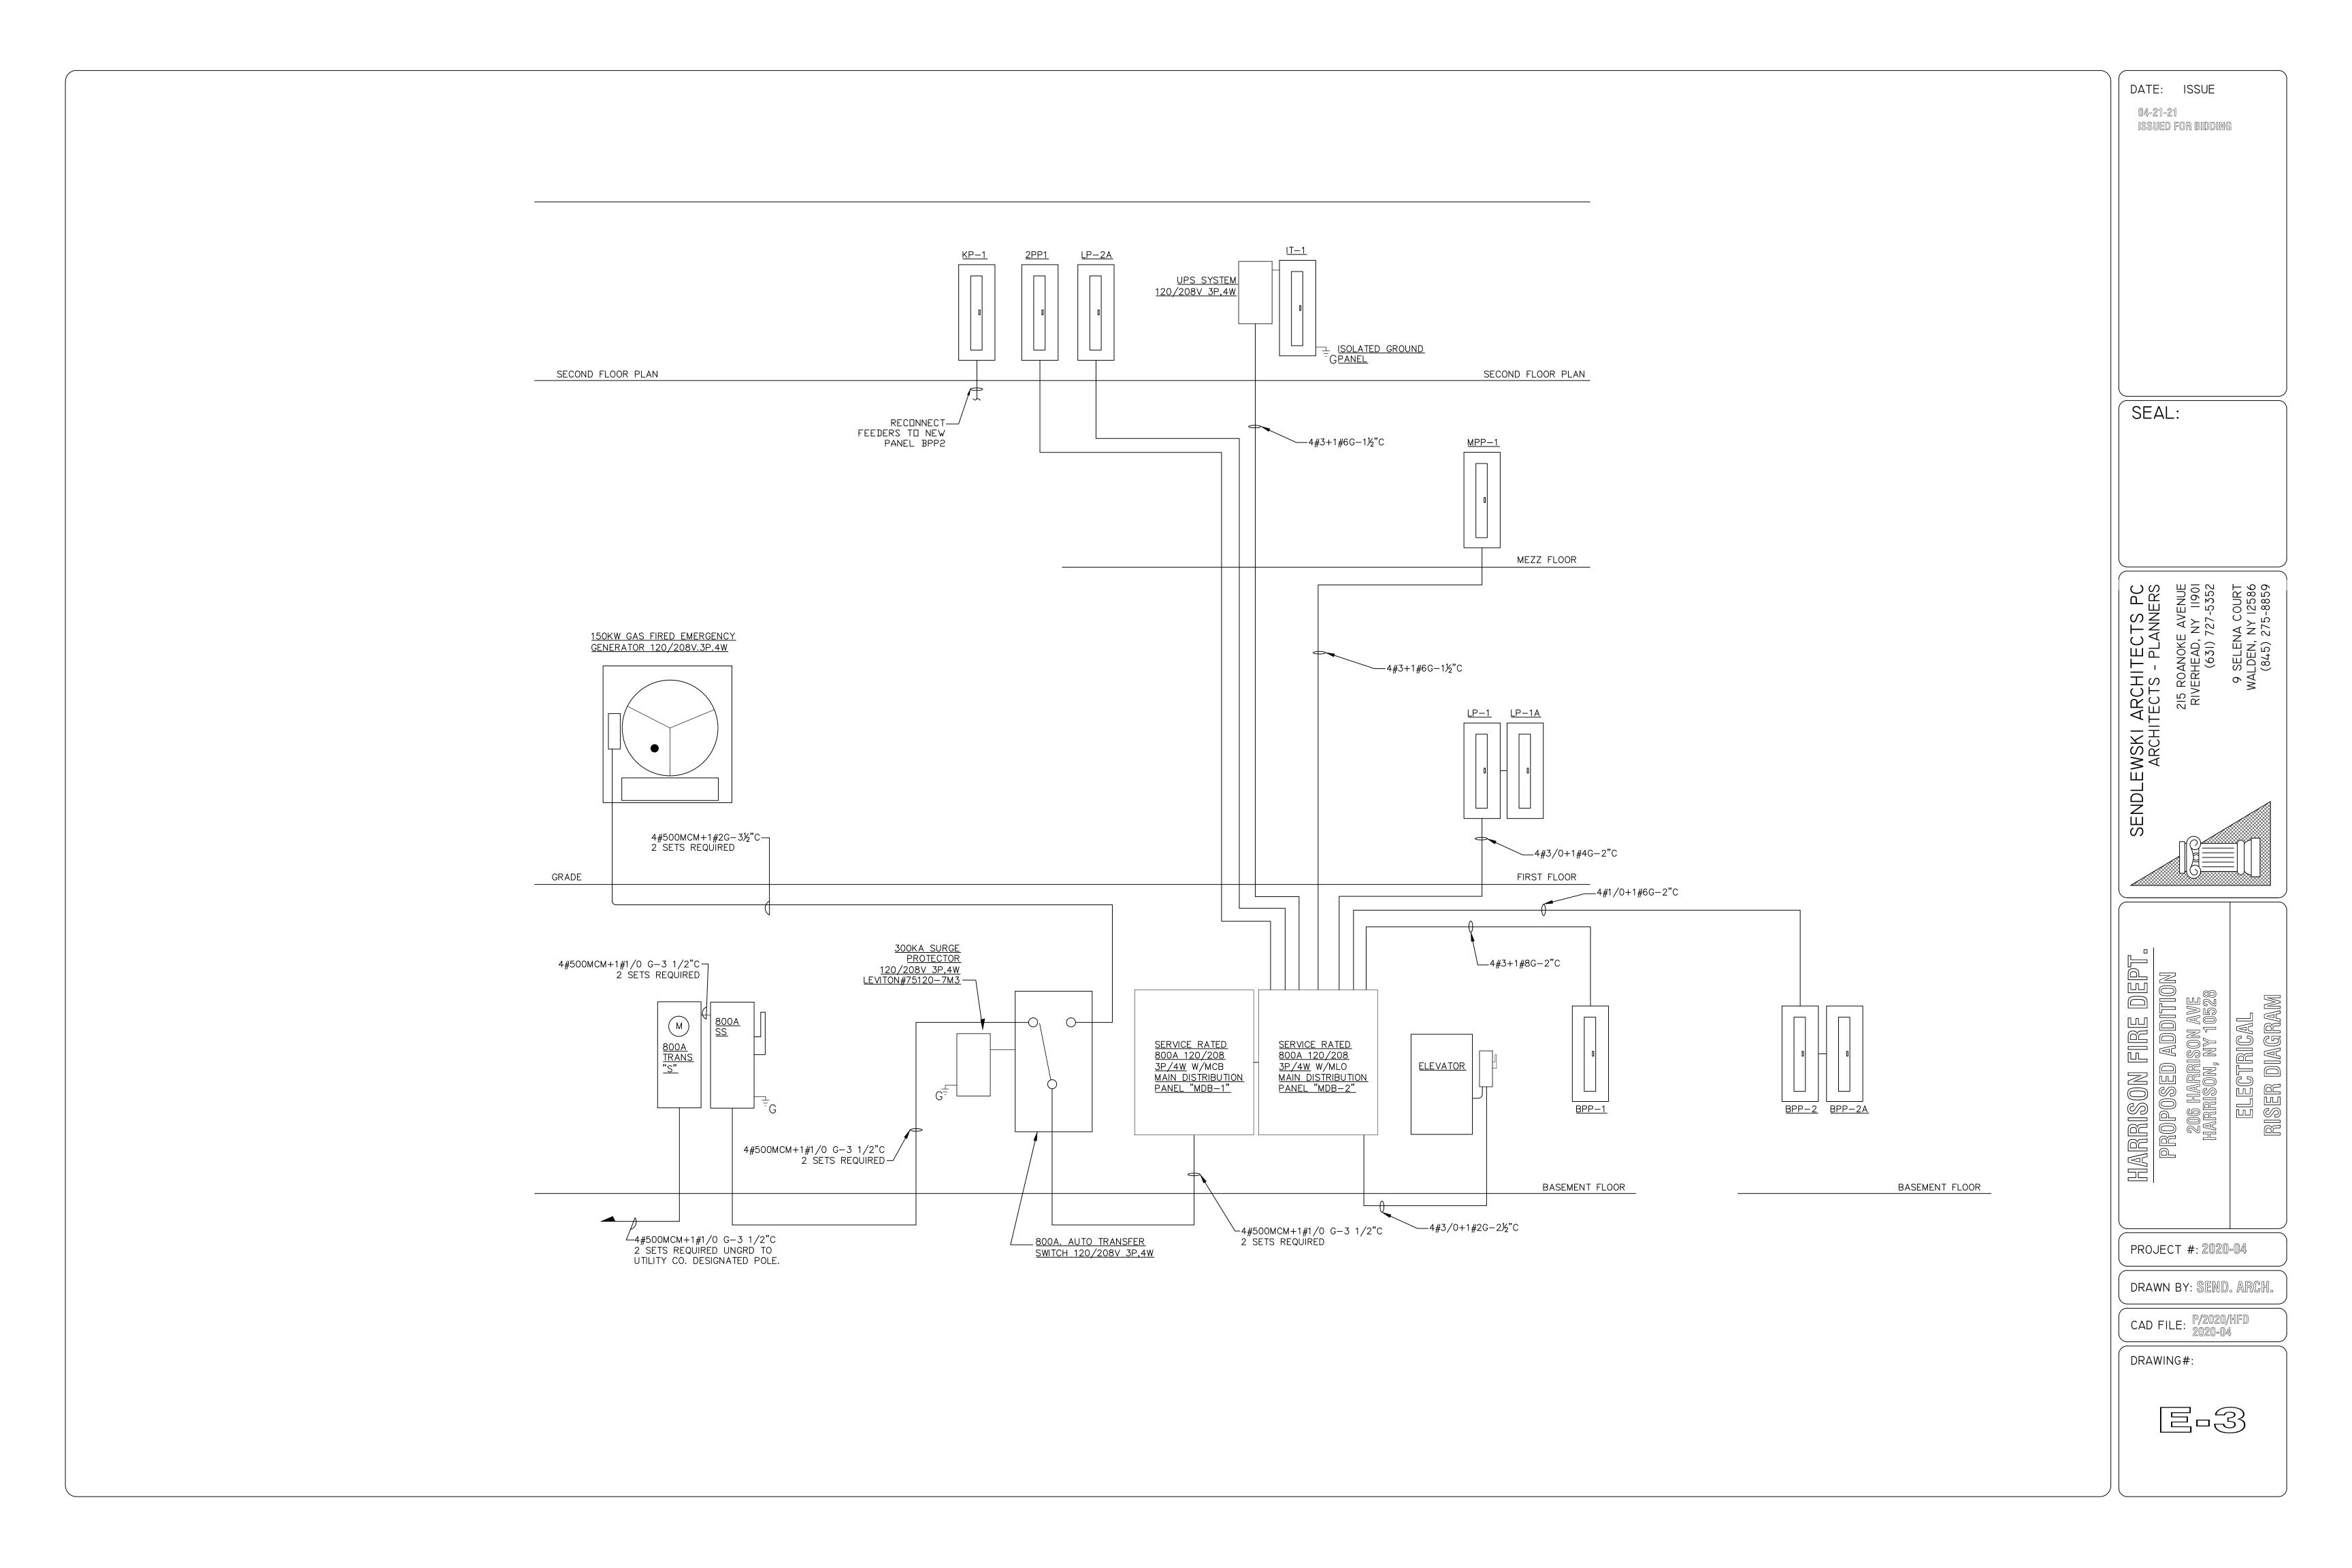
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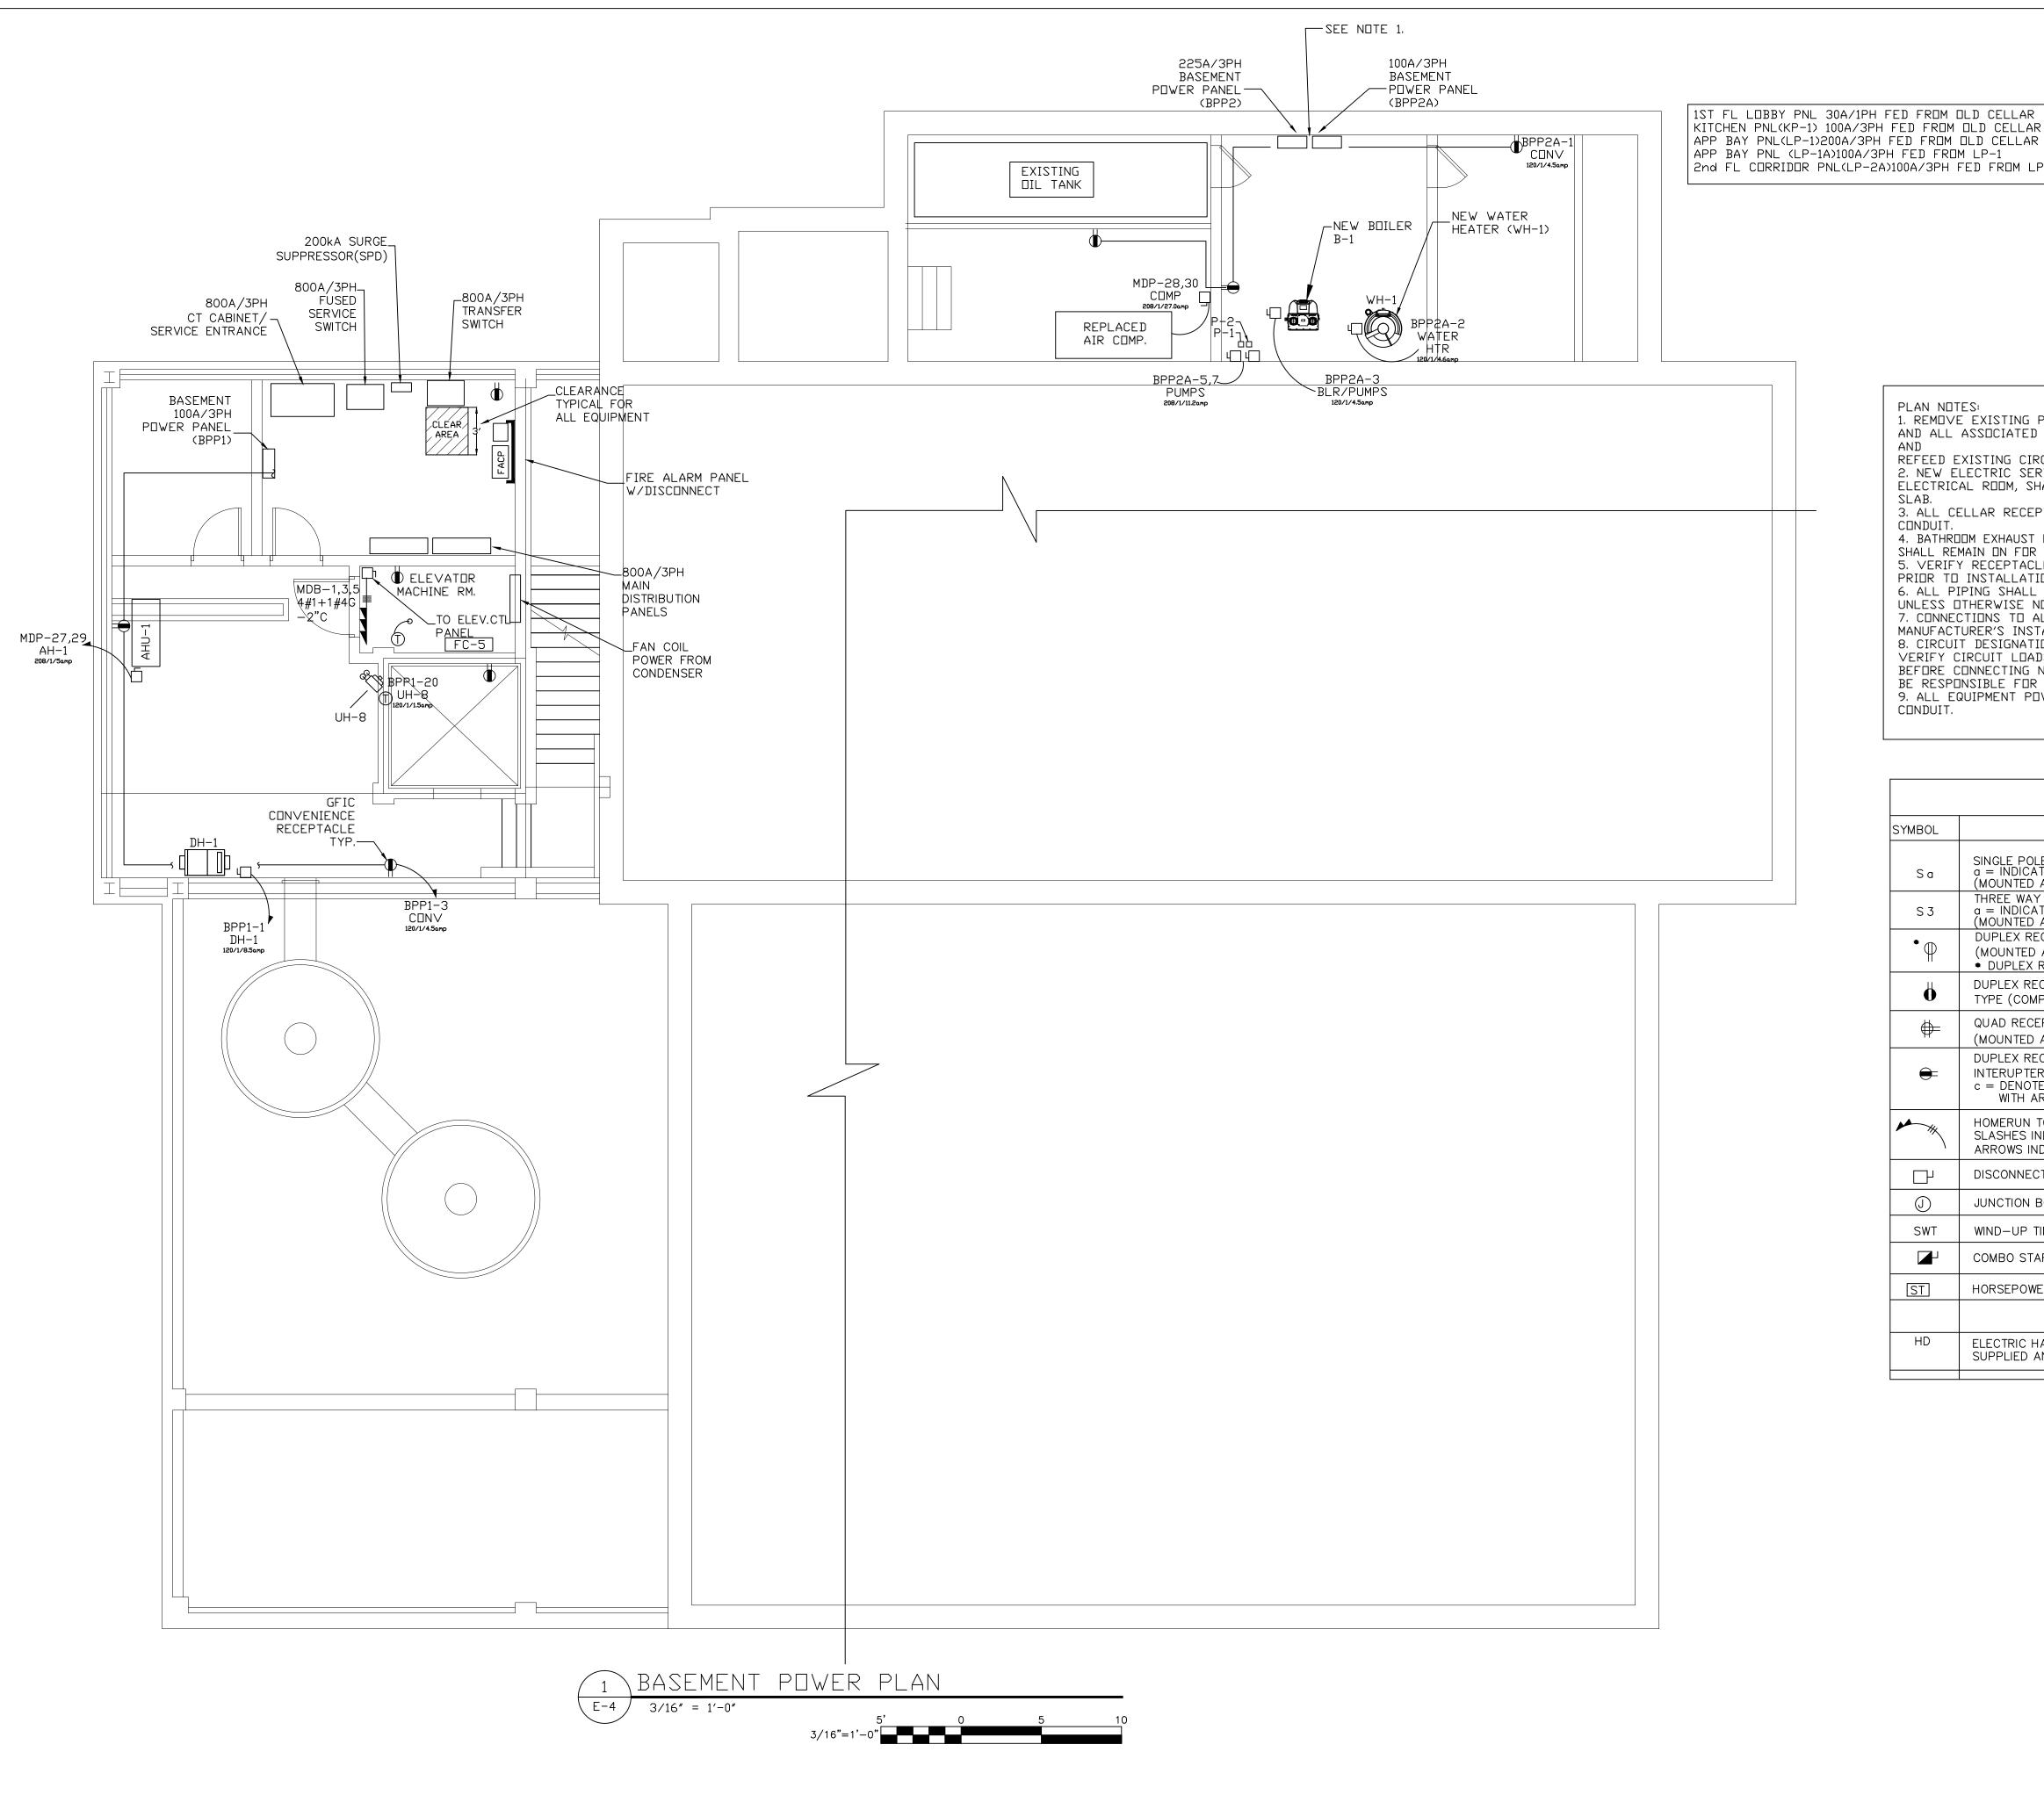
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KITCHEN PNL(KP-1) 100A/3PH FED FROM OLD CELLAR APP BAY PNL(LP-1)200A/3PH FED FROM OLD CELLAR APP BAY PNL (LP-1A)100A/3PH FED FROM LP-1 2nd FL CORRIDOR PNL(LP-2A)100A/3PH FED FROM LP-1

1. REMOVE EXISTING POWER PANELS, MAIN SERVICE, TRANSFER SWITCH AND ALL ASSOCIATED WIRING AND CONDUIT. PROVIDE NEW POWER PANEL

REFEED EXISTING CIRCUITS TO REMAIN.

2. NEW ELECTRIC SERVICE AND FEEDERS FOR ALL EQUIPMENT IN THE ELECTRICAL ROOM, SHALL BE IN CONDUIT AND SHALL BE RUN UNDER THE

3. ALL CELLAR RECEPTACLES SHALL BE GFI. ALL WIRING SHALL BE IN CONDUIT. 4. BATHROOM EXHAUST FANS SHALL BE INTERLOCKED WITH THE LIGHTING, FAN SHALL REMAIN ON FOR 15 MINUTES AFTER LIGHTS ARE SHUT OFF.

5. VERIFY RECEPTACLE LOCATIONS, TYPES AND HEIGHTS WITH ARCHITECT PRIOR TO INSTALLATION. 6. ALL PIPING SHALL BE AT CEILING DOWN TO DEVICE OR FIXTURE

UNLESS OTHERWISE NOTED. 7. CONNECTIONS TO ALL EQUIPMENT SHALL BE AS PER THE MANUFACTURER'S INSTALLATION MANUAL.

8. CIRCUIT DESIGNATIONS ARE FOR REFERENCE ONLY, ELECTRICIAN SHALL VERIFY CIRCUIT LOADS OF LIGHTING FIXTURES, POWER AND EQUIPMENT BEFORE CONNECTING NEW CIRCUITS TO NEW PANELS, ELECTRICIAN SHALL BE RESPONSIBLE FOR BALANCING LEGS. 9. ALL EQUIPMENT POWER AND CONTROL WIRING SHALL BE IN METAL

CVMDOLLICT

SYMBOL	DESCRIPTION
Sa	SINGLE POLE LIGHT SWITCH a = INDICATES LIGHTS CONTROLLED (MOUNTED AT 48"TO TOP OF SWITCH UNLESS OTHERWISE NOTED)
S 3	THREE WAY SWITCH a = INDICATES LIGHTS CONTROLLED (MOUNTED AT 48"TO TOP OF SWITCH UNLESS OTHERWISE NOTED)
• •	DUPLEX RECEPTACLE GROUNDING TYPE, (MOUNTED AT 24"TO TOP OF RECP. UNLESS OTHERWISE NOTED) • DUPLEX RECEPTACLE EQUIPTED WITH USB CHARGING PORT,
ø	DUPLEX RECEPTACLE (ORANGE) ISOLATED GROUNDING TYPE (COMPUTER TYPE)
+	QUAD RECEPTACLE GROUNDING TYPE, (MOUNTED (MOUNTED AT 24"TO TOP OF RECP. UNLESS OTHERWISE NOTED)
-	DUPLEX RECEPTACLE (GROUND FAULT INTERUPTER TYPE) c = DENOTES COUNTER HEIGHT (VERIFY HEIGHT WITH ARCHITECT.)
***	HOMERUN TO DESIGNATED PANEL OR BOARD SLASHES INDICATE NUMBER OF WIRES FOR EACH CIRCUIT. ARROWS INDICATE NUMBER OF CIRCUITS.
	DISCONNECT SWITCH FUSED (SIZE AS INDICATED)
(J)	JUNCTION BOX (SIZE AS REQUIRED)
SWT	WIND-UP TIMER SWITCH
	COMBO STARTER DISC SW.
ST	HORSEPOWER RATED SWITCH
HD	ELECTRIC HAND DRYER EXCELERATOR TYPE # H-1927W SUPPLIED AND INSTALLED BY ELECTRICAL CNTR.

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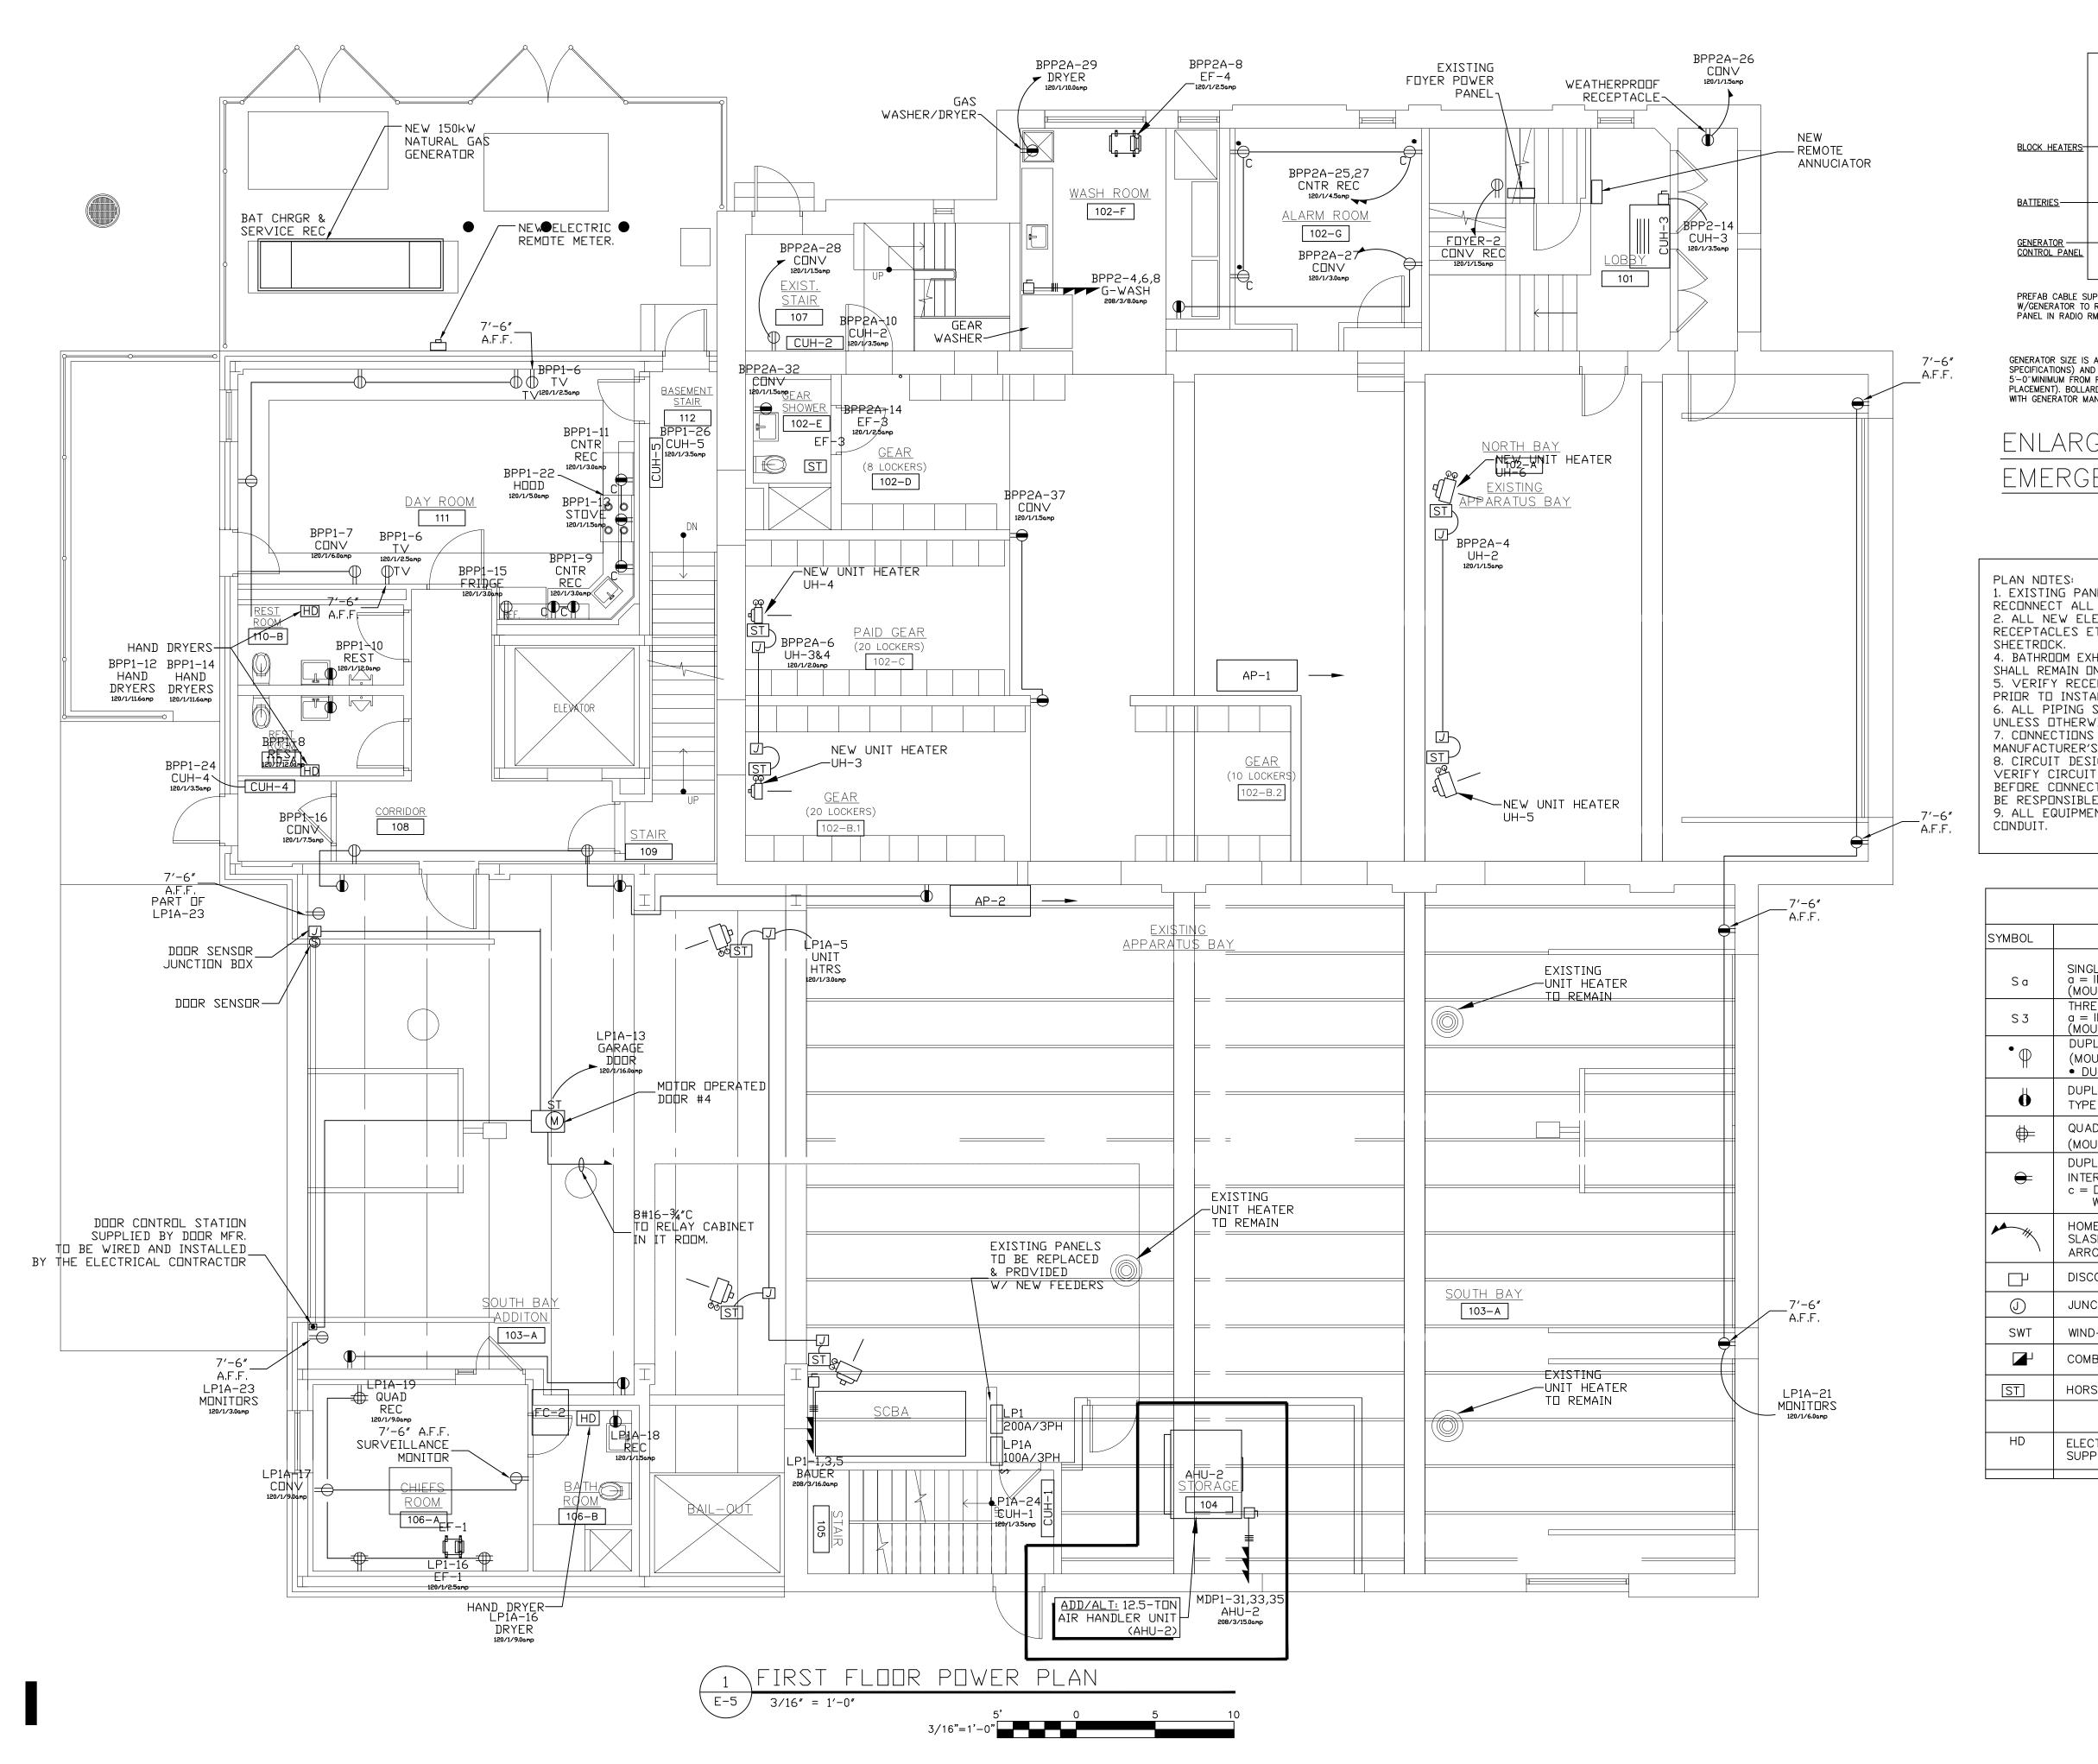
215 ROANOKE AVENUE RIVERHEAD, NY 11901 (631) 727-5352 NDLEWSKI ARCHITECTS PC ARCHITECTS - PLANNERS

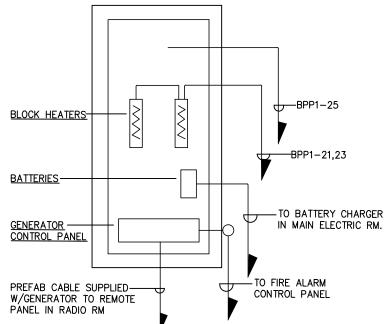
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GENERATOR SIZE IS APPROXIMATELY 5'-9"X 17'-5"(EC TO VERIFY PER SPECIFICATIONS) AND SHOULD BE SET WITH CLOSEST END AT 5'-0"MINIMUM FROM REAR BUILDING FACE (VERIFY PRIOR TO PLACEMENT). BOLLARDS & CLEAR ACCESS SHALL BE COORDINATED WITH GENERATOR MANUFACTURER REQUIREMENTS.

ENLARGED PLAN EMERGENCY GENERATOR

1. EXISTING PANELS TO BE REPLACED DURING DEMOLITION.
RECONNECT ALL EXISTING CIRCUITS TO REMAIN.
2. ALL NEW ELECTRICAL IN APPARATUS BAY INCLUDING CDT, BOXES,
RECEPTACLES ETC SHALL BE RECESSED WITHIN THE BLOCK AND
SHEETROCK.
4. BATHROOM EXHAUST FANS SHALL BE INTERLOCKED WITH THE LIGHTING. FAN
SHALL REMAIN ON FOR 15 MINUTES AFTER LIGHTS ARE SHUT OFF.
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HD	ELECTRIC HAND DRYER EXCELERATOR TYPE # H-1927W SUPPLIED AND INSTALLED BY ELECTRICAL CNTR.	

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WALDEN, NY 12586
(84.5) 275-8859

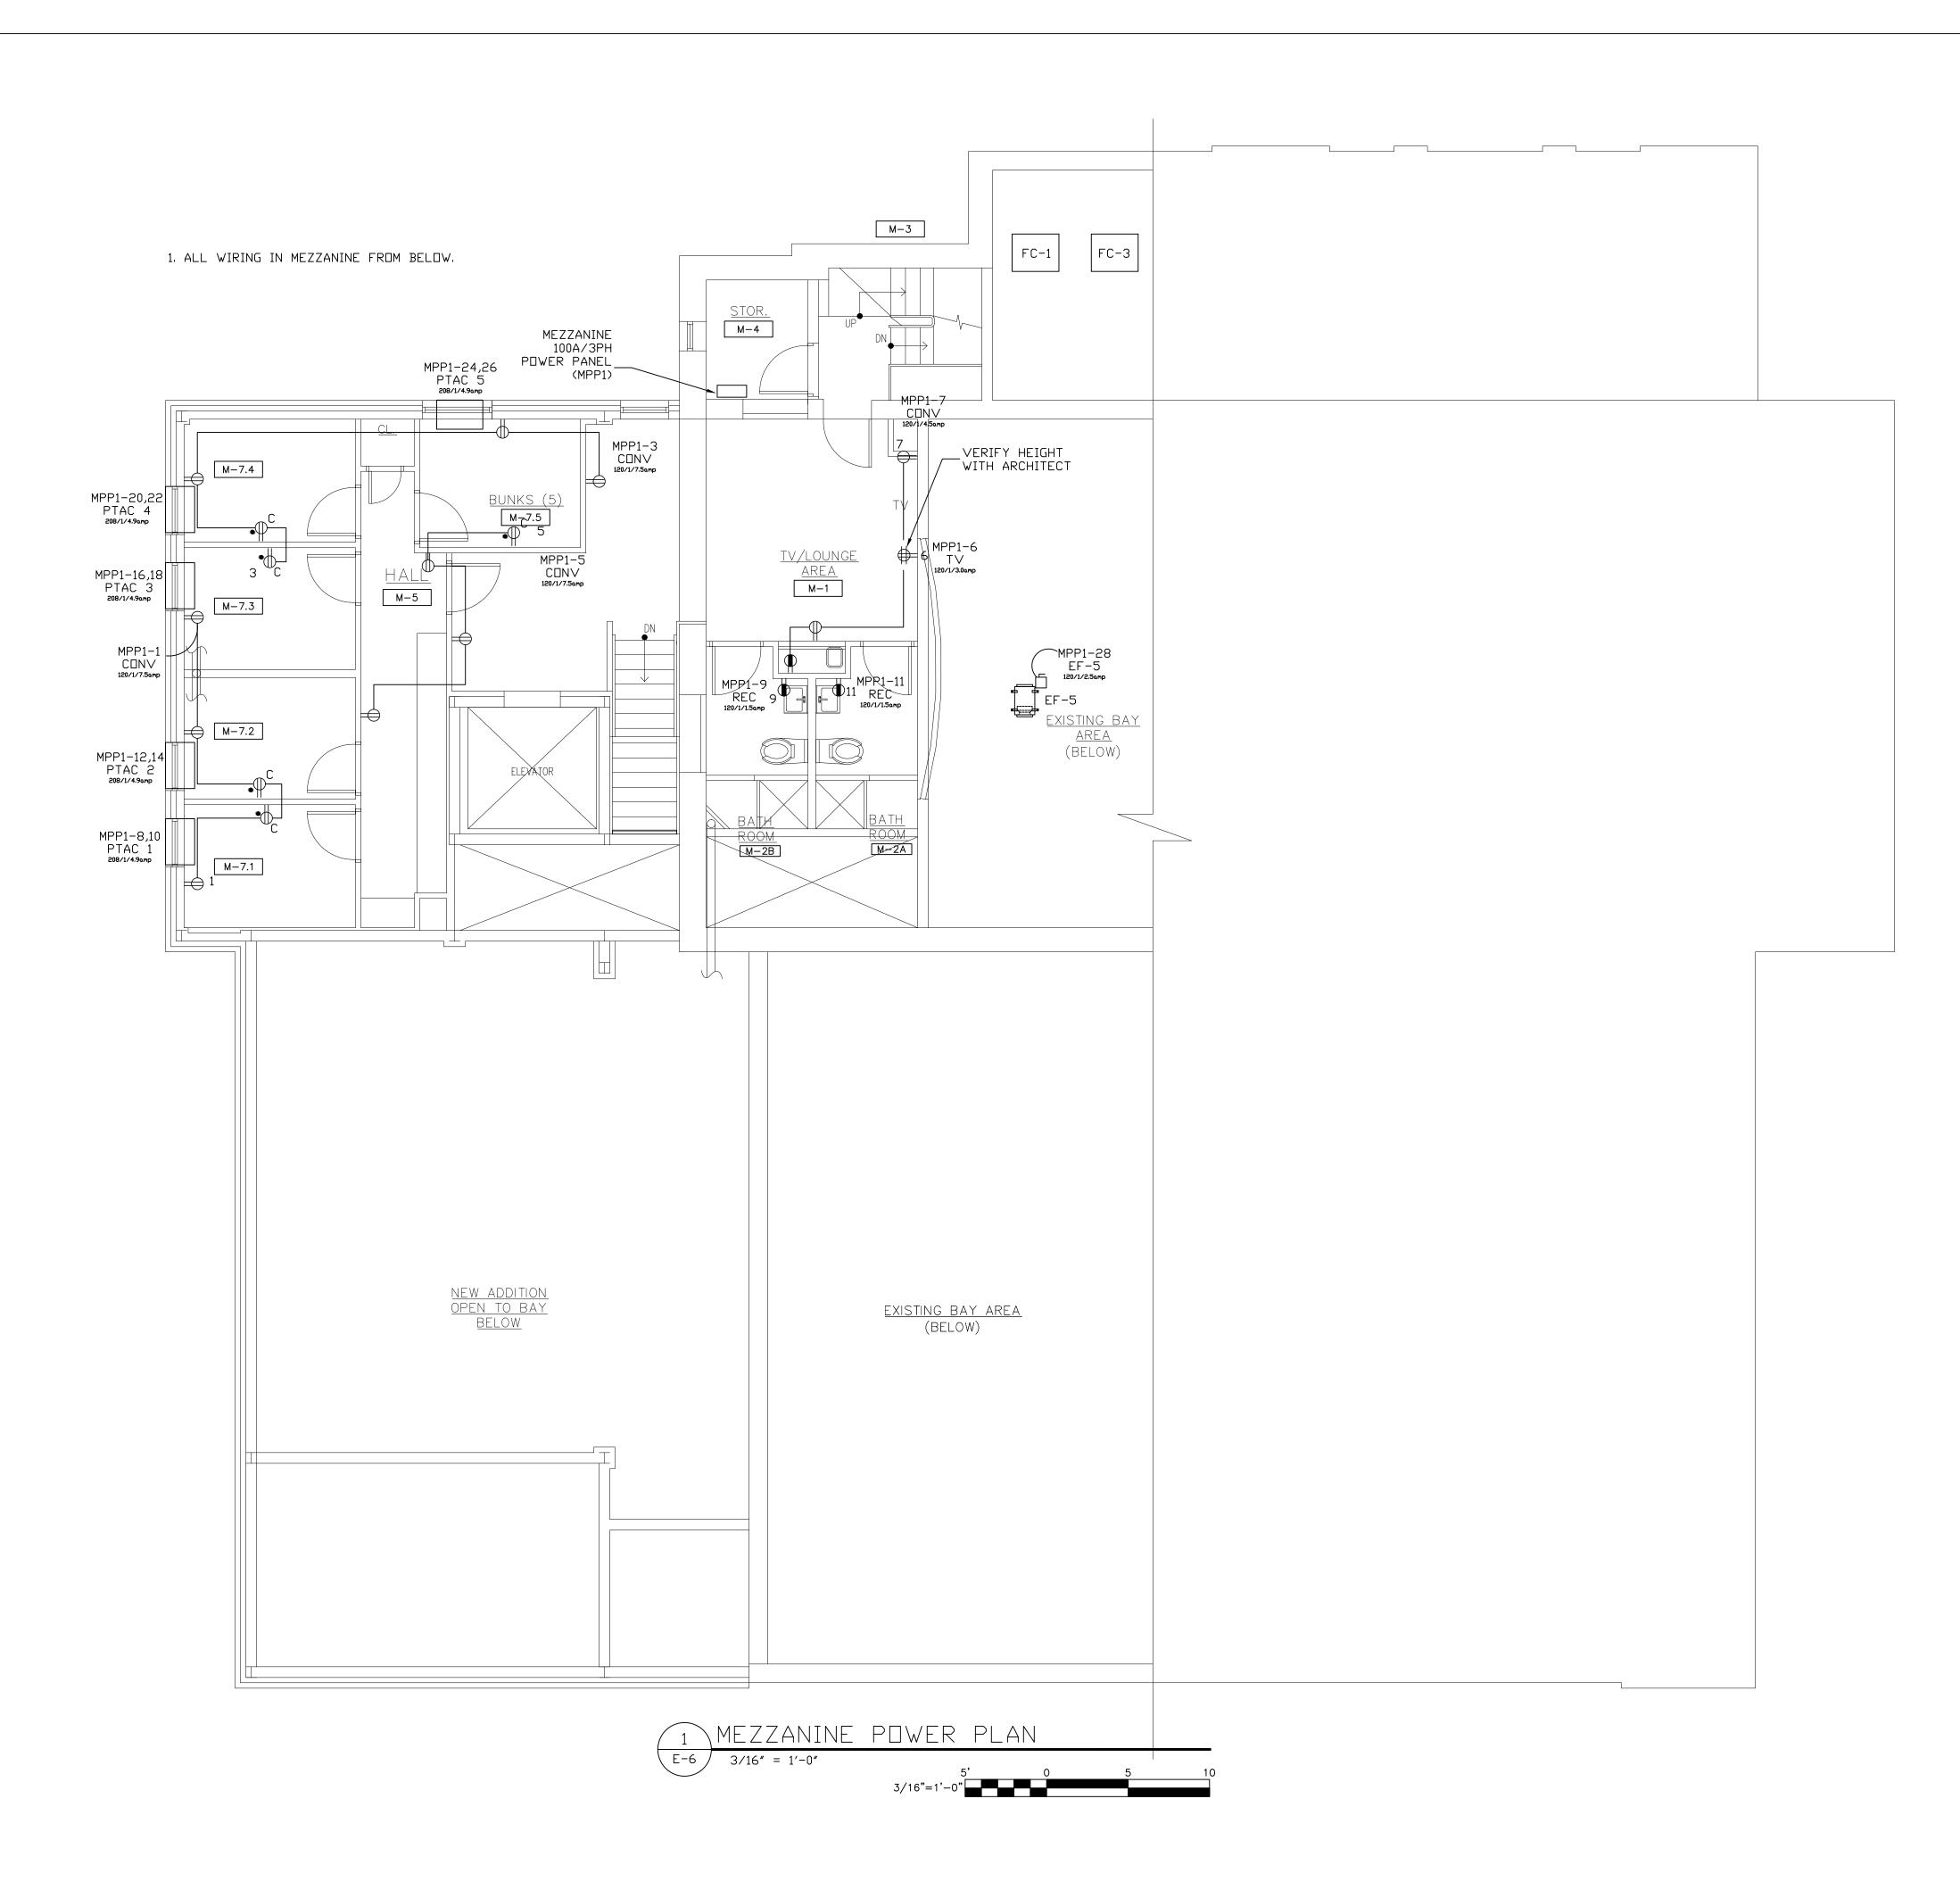
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RECONNECT ALL EXISTING CIRCUITS TO REMAIN.
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PLAN NOTES:

8. CIRCUIT DESIGNATIONS ARE FOR REFERENCE ONLY. ELECTRICIAN SHALL VERIFY CIRCUIT LOADS OF LIGHTING FIXTURES, POWER AND EQUIPMENT BEFORE CONNECTING NEW CIRCUITS TO NEW PANELS. ELECTRICIAN SHALL BE RESPONSIBLE FOR BALANCING LEGS.

9. ALL EQUIPMENT POWER AND CONTROL WIRING SHALL BE IN METAL CONDUIT.

SYMBOL LIST

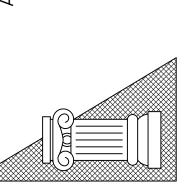
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WALDEN, NY 12586



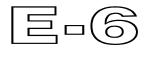
HARRISON FIRE DEPT.
PROPOSED ADDITION
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HARRISON, NY 10528

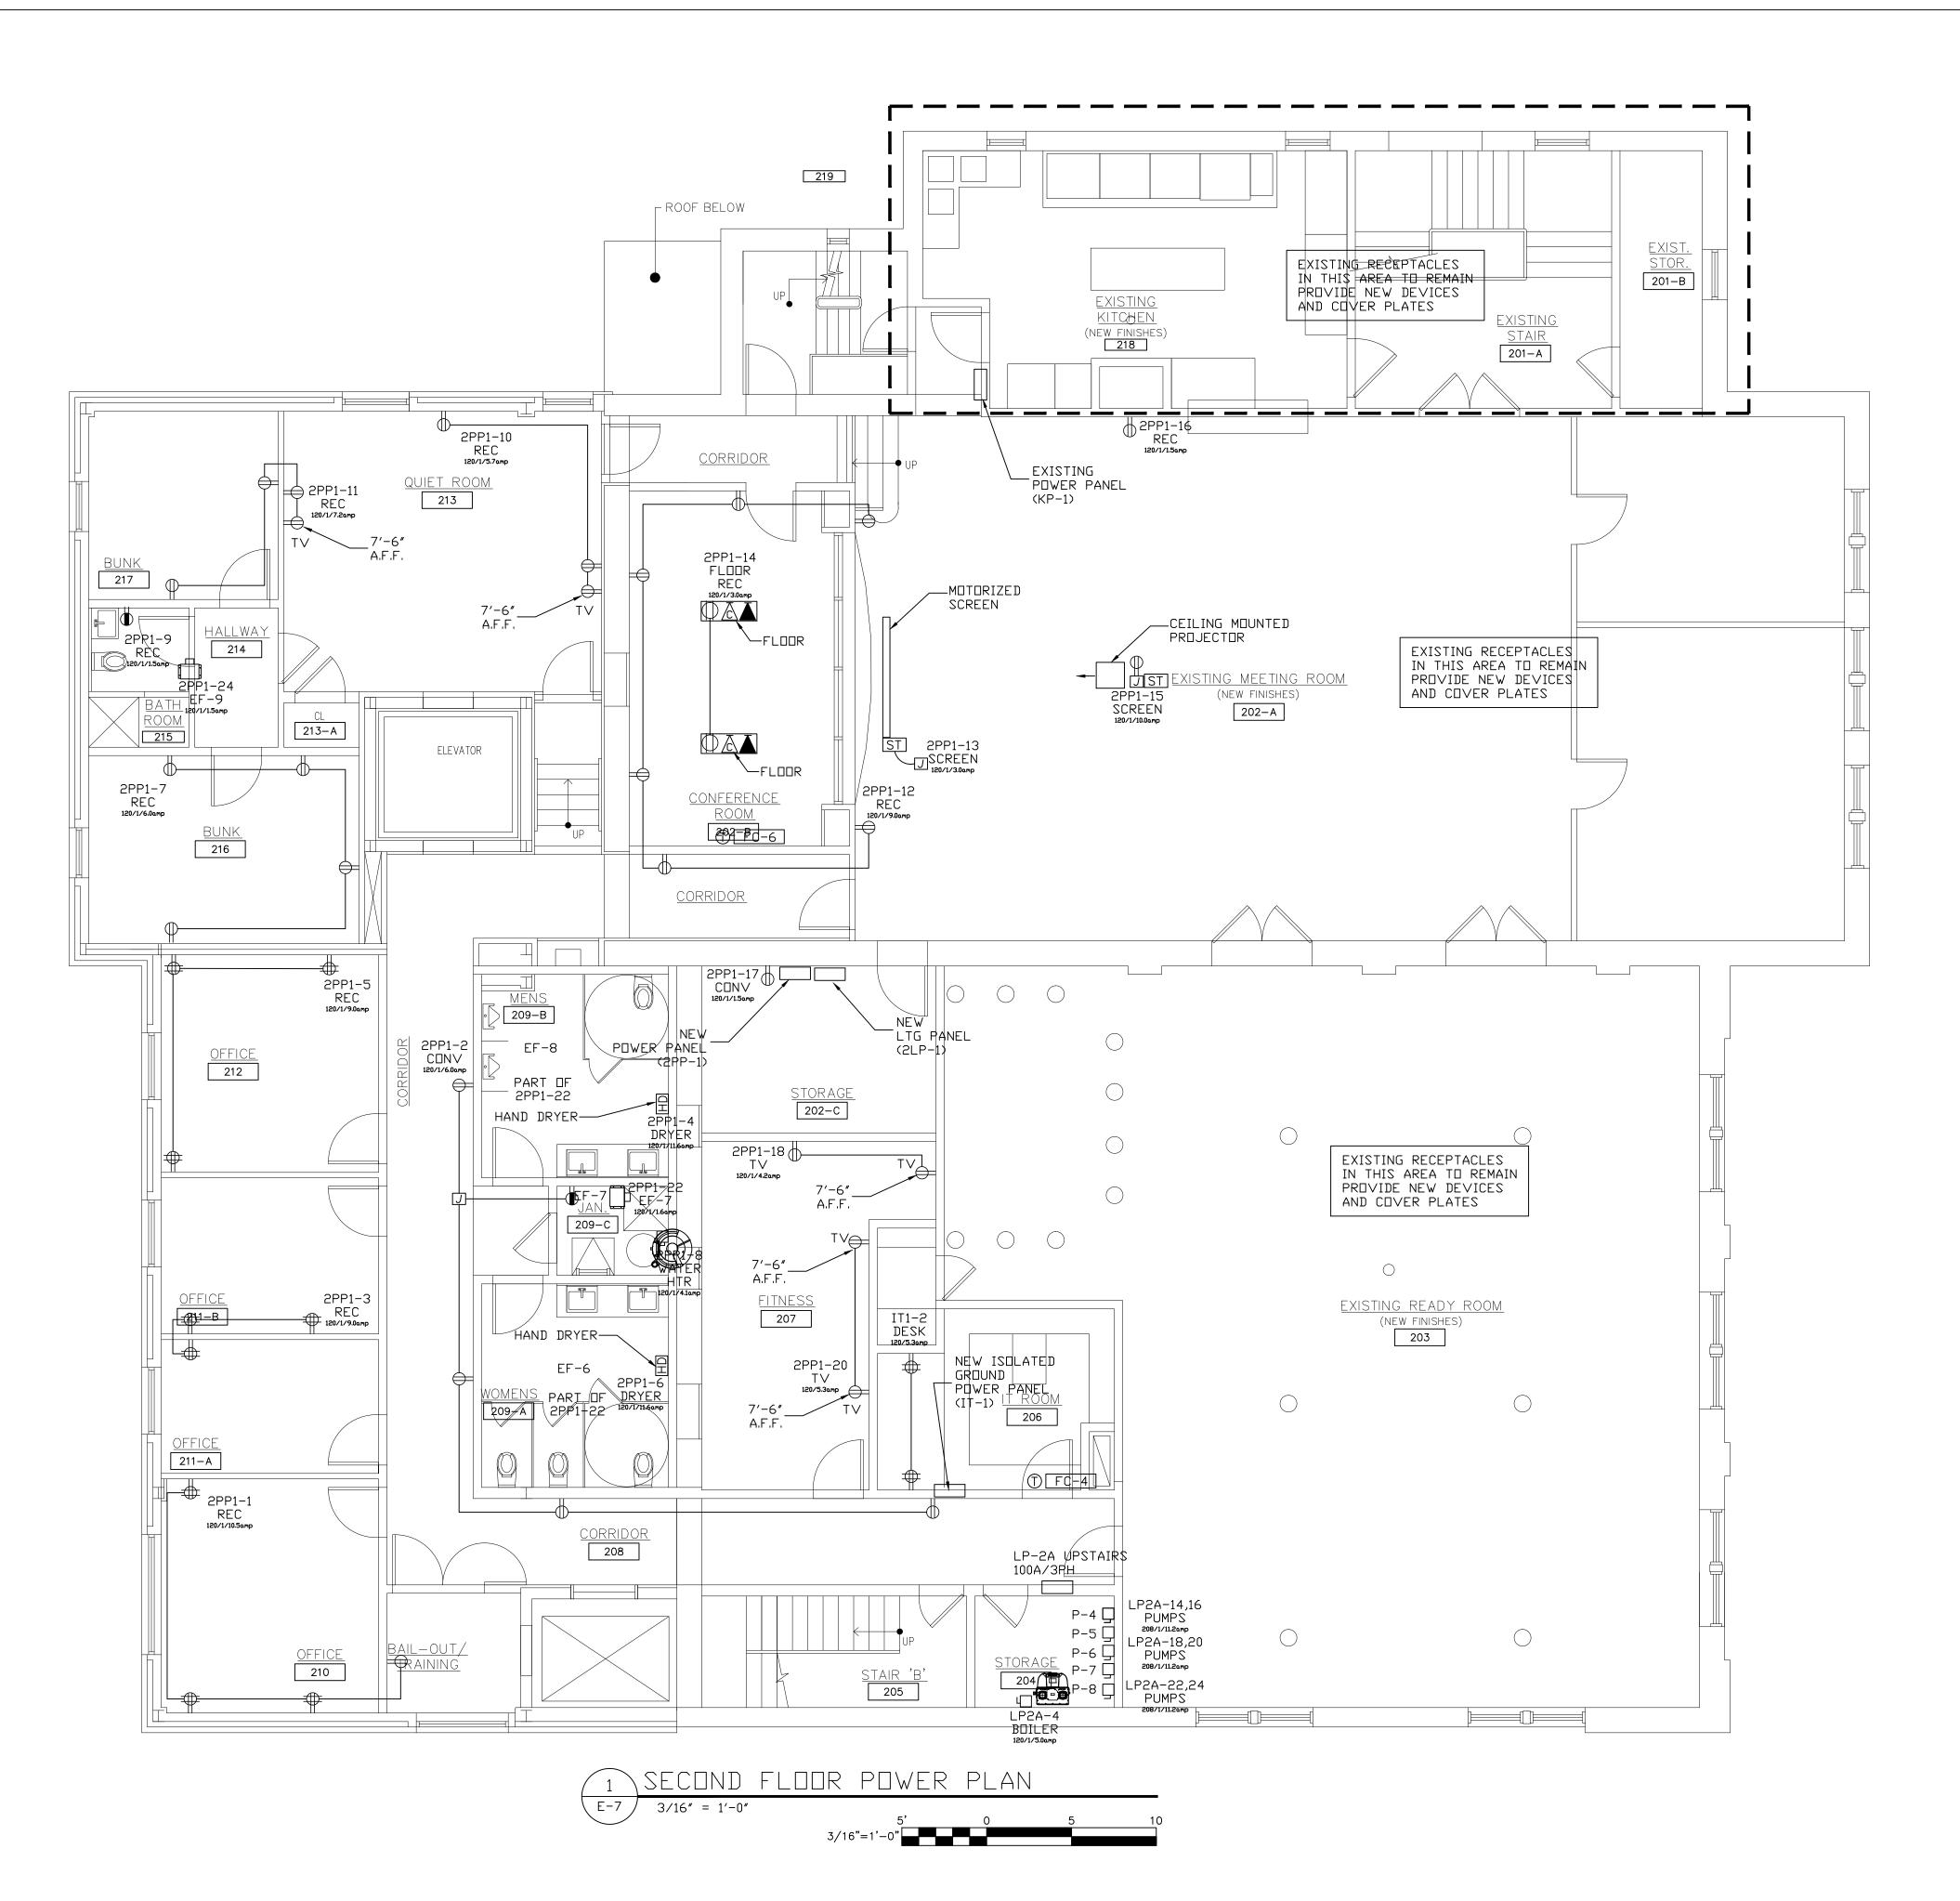
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PLAN NOTES:

1. EXISTING PANEL LP-2A TO BE REPLACED DURING DEMOLITION.
RECONNECT ALL EXISTING CIRCUITS TO REMAIN.

2. ALL NEW ELECTRICAL BOXES, RECEPTACLES ETC SHALL BE RECESSED WITHIN THE BLOCK AND SHEETROCK.

3. BATHROOM EXHAUST FANS SHALL BE INTERLOCKED WITH THE LIGHTING. FAN SHALL REMAIN ON FOR 15 MINUTES AFTER LIGHTS ARE SHUT OFF.

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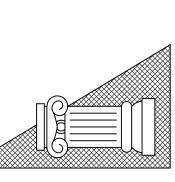
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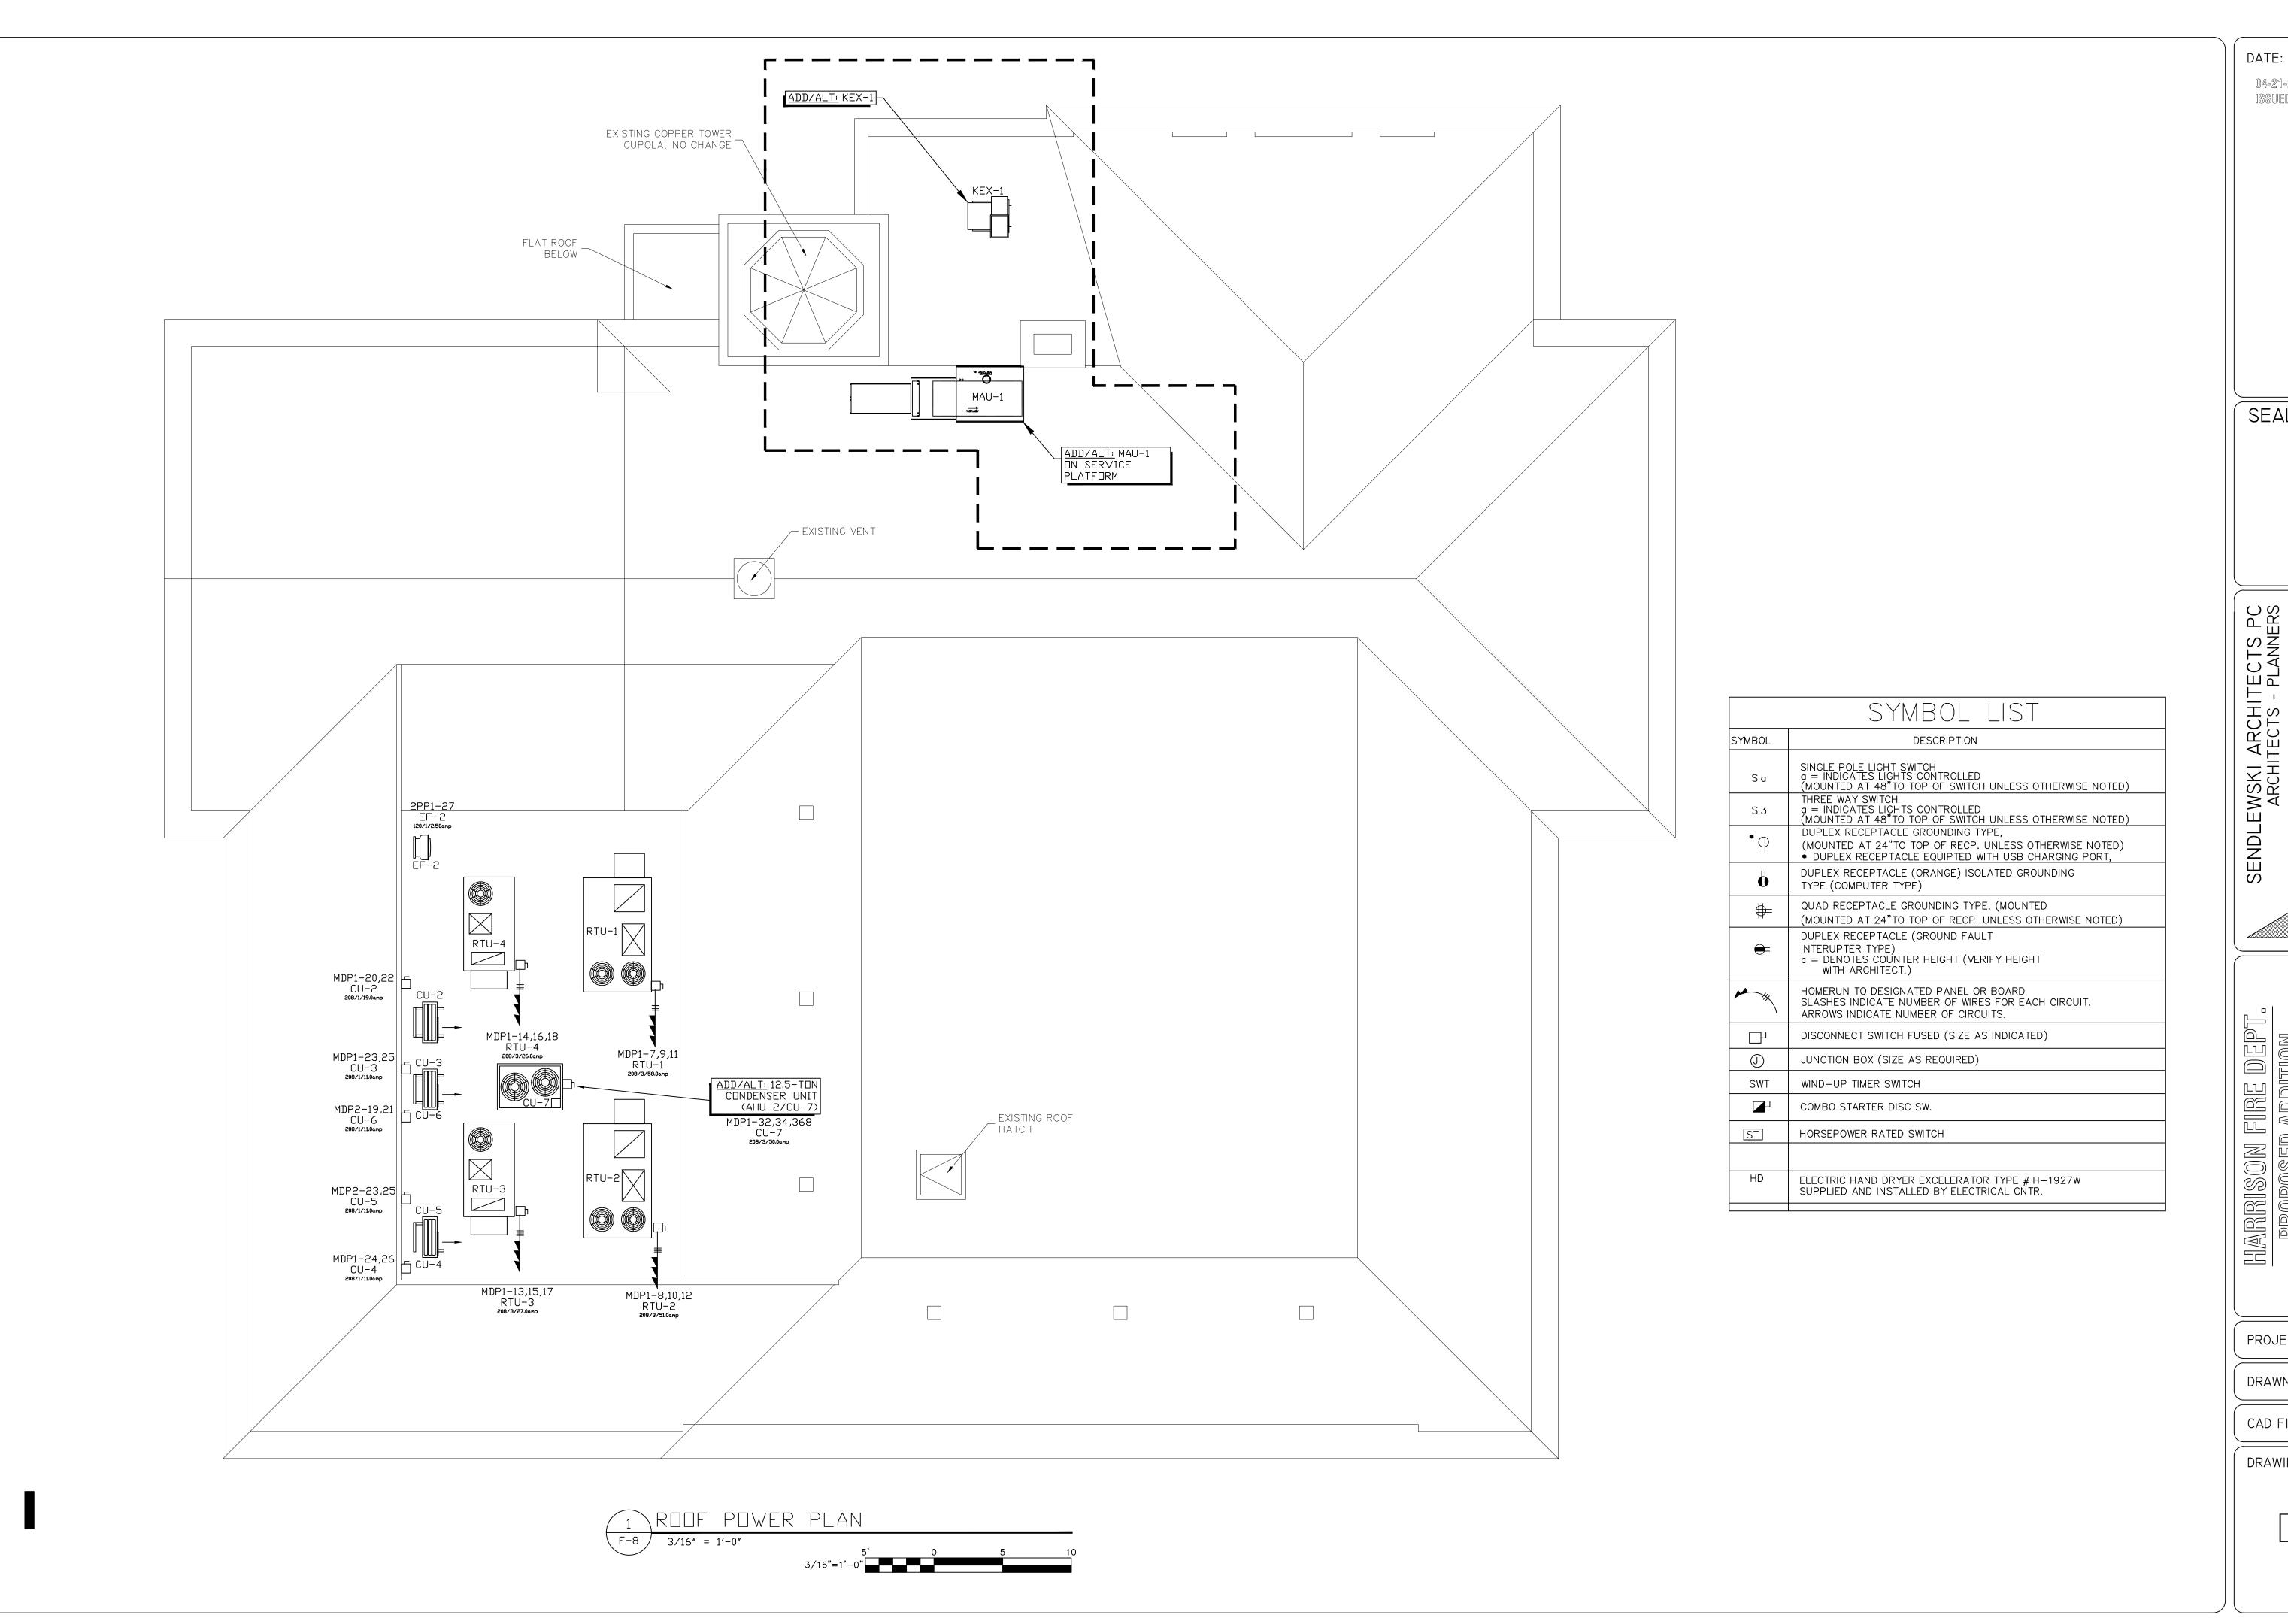
HARRISON FIRE DEPT.
PROPOSED ADDITION
206 HARRISON AVE
HARRISON, NY 10528
SECOND FLOOR

PROJECT #: 2020-04

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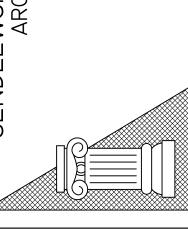
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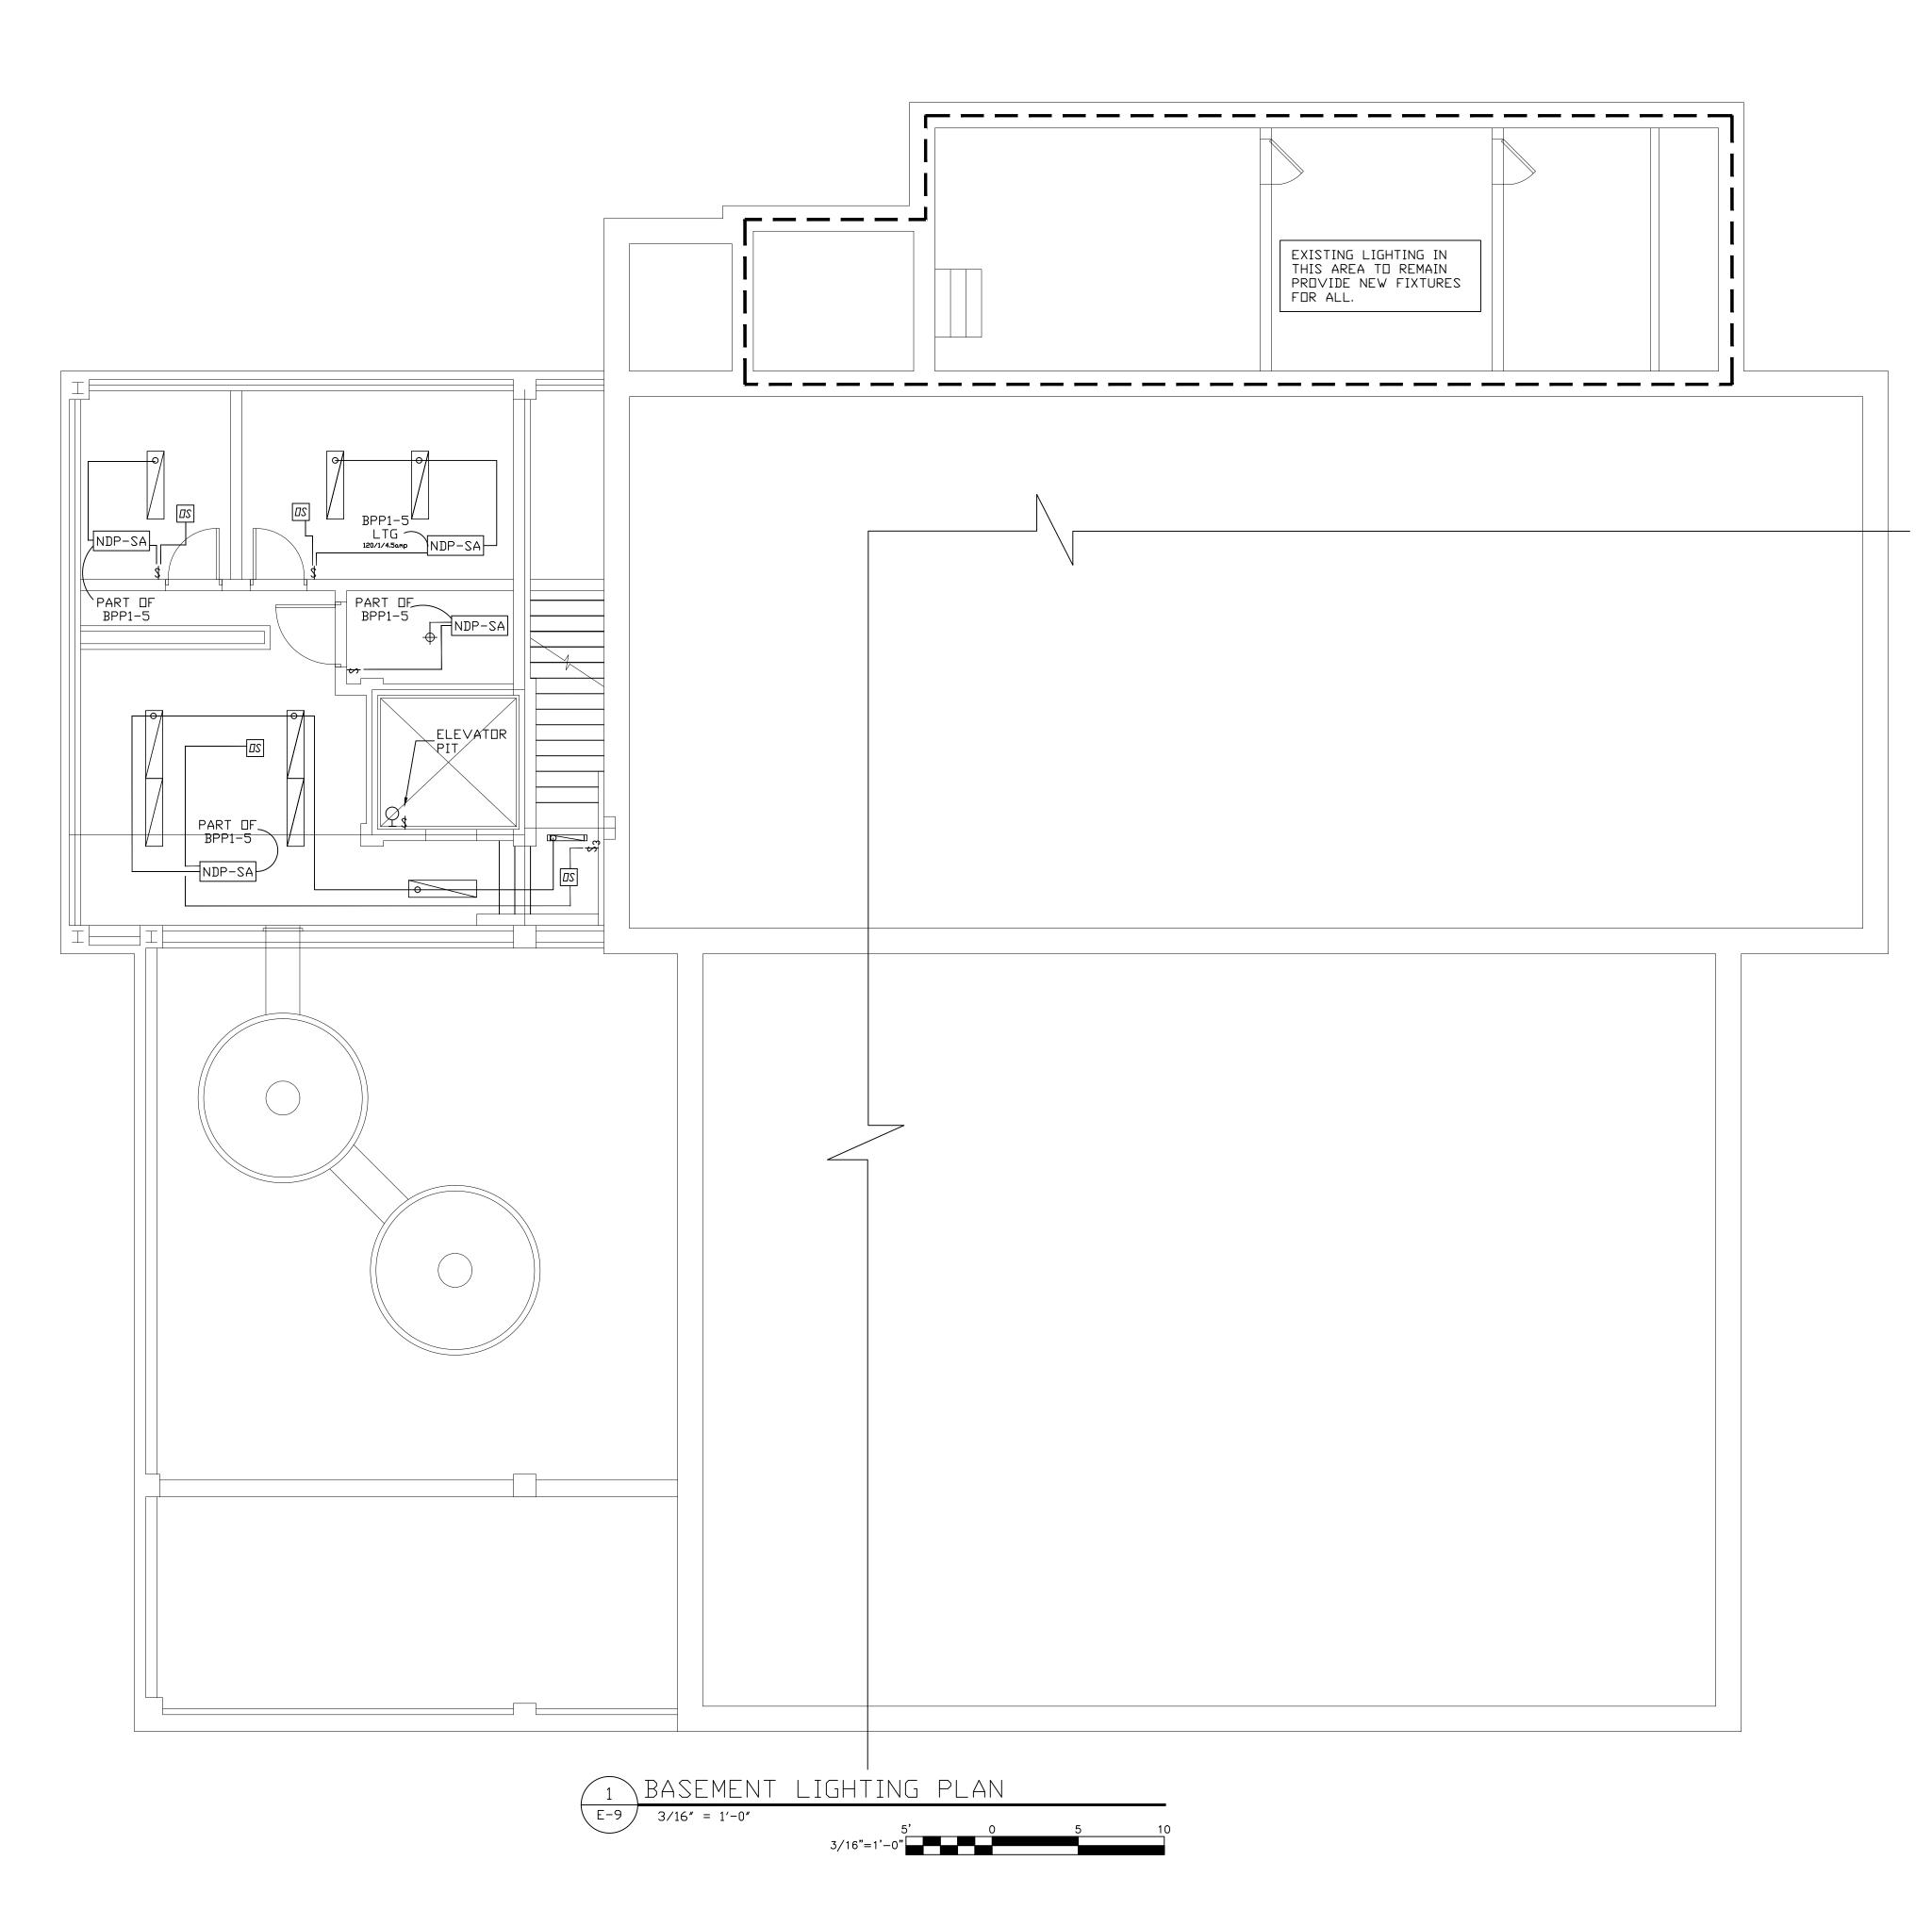
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GENERAL NOTES: 1. WHERE EXPOSED, ALL WIRING SHALL BE IN CONDUIT.
2. ALL PIPING SHALL BE AT CEILING DOWN TO DEVICE OR FIXTURE UNLESS OTHERWISE NOTED. 3. VERIFY ALL FINAL SWITCH LOCATIONS & TYPE WITH ARCHITECT PRIOR TO INSTALLATION. 4. VERIFY FIXTURE TYPES WITH ARCHITECT PRIOR TO INSTALLATION, CONNECTIONS SHALL BE AS PER MANUFACTURERS REQUIREMENTS. 5. LED STRIP LIGHTING SHALL BE INSTALLED AS PER THE MANUFACTURER'S INSTALLATION MANUAL. 6. ALL BATHROOM EXHAUST FANS SHALL BE INTERLOCKED WITH LIGHTING. FAN SHALL REMAIN ON FOR 15 MINUTES AFTER LIGHTS ARE SHUT OFF. 7. ALL EXTERIOR LIGHTING CIRCUITS SHALL BE PROVIDED WITH AN ASTRONOMICAL TIME SWITCH IN ACCORDANCE WITH IECC C405.2.5. 8. ALL EMERGENCY LIGHTING & EXIT SIGNS SHALL HAVE BATTERY BACKUP, CONNECTIONS SHALL BE ON LOCAL LIGHTING CIRCUIT AHEAD OF ALL SWITCH LEGS. EXIT SIGNS SHALL NOT EXCEED 5 WATTS PER SIDE. 9. EXTERIOR TIME SWITCH TESTING SHALL COMPLY WITH THE FOLLOWING: 9.1. CONFIRM THAT THE TIME-SWITCH CONTROL IS PROGRAMMED WITH ACCURATE WEEKDAY, WEEKEND AND HOLIDAY SCHEDULES. 9.2. PROVIDE DOCUMENTATION TO THE OWNER OF TIME-SWITCH CONTROLS PROGRAMMING INCLUDING WEEKDAY, WEEKEND, HOLIDAY SCHEDULES, AND SET-UP AND PREFERENCE PROGRAM SETTINGS. 9.3. VERIFY THE CORRECT TIME AND DATE IN THE TIME SWITCH. 9.4. VERIFY THAT ANY BATTERY BACK-UP IS INSTALLED AND ENERGIZED. 9.5. VERIFY THAT THE OVERRIDE TIME LIMIT IS SET TO NOT MORE THAN 2 HOURS. 9.6. SIMULATE OCCUPIED CONDITION, VERIFY AND DOCUMENT THE FOLLOWING: 9.7. ALL LIGHTS CAN BE TURNED ON AND OFF BY THEIR RESPECTIVE AREA CONTROL SWITCH. 9.8. THE SWITCH ONLY OPERATES LIGHTING IN THE ENCLOSED SPACE IN WHICH THE SWITCH IS 9.9. SIMULATE UNDCCUPIED CONDITION. VERIFY AND

DOCUMENT THE FOLLOWING: 9.9.1. NONEXEMPT LIGHTING TURNS OFF. 9,9.2. MANUAL OVERRIDE SWITCH ALLOWS ONLY THE LIGHTS IN THE ENCLOSED SPACE WHERE THE OVERRIDE SWITCH IS LOCATED TO TURN ON OR REMAIN ON UNTIL THE NEXT SCHEDULED SHUTOFF OCCURS.

10.0. ADDITIONAL TESTING AS SPECIFIED BY THE REGISTERED DESIGN PROFESSIONAL.

10. EXISTING LIGHTING SHALL BE REPLACED WITH NEW WHERE INDICATED. 11. REPLACE ALL EXISTING SWITCHES AND COVER PLATES.

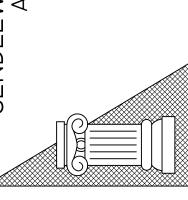
LIc	GHTING LEGEND
	LITHONIA LIGHTI FEM L48 6000LM IMAFL WD 80CRI 35K FEM LED 48″, 6,000 LUMENS, ACR. 45 WATTS
E	LITHONIA LIGHTI FEM L48 6000LM IMAFL WD 80CRI 35K FEM LED 48″, 6,000 LUMENS, ACR. 45 WATTS
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	LITHONIA LIGHTI EPANL 2X4 4000LM 80CRI 35K EPANL 2X4, 4000 NOMINAL LUMENS 39 WATTS
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NDP-SA	NLIGHT NPP16 D SA POWER/RELAY PACK
<u>as</u>	NLIGHT NCM PDT 9 LOW VOLTAGE CEILING MOUNT OCCUPANCY SENSOR
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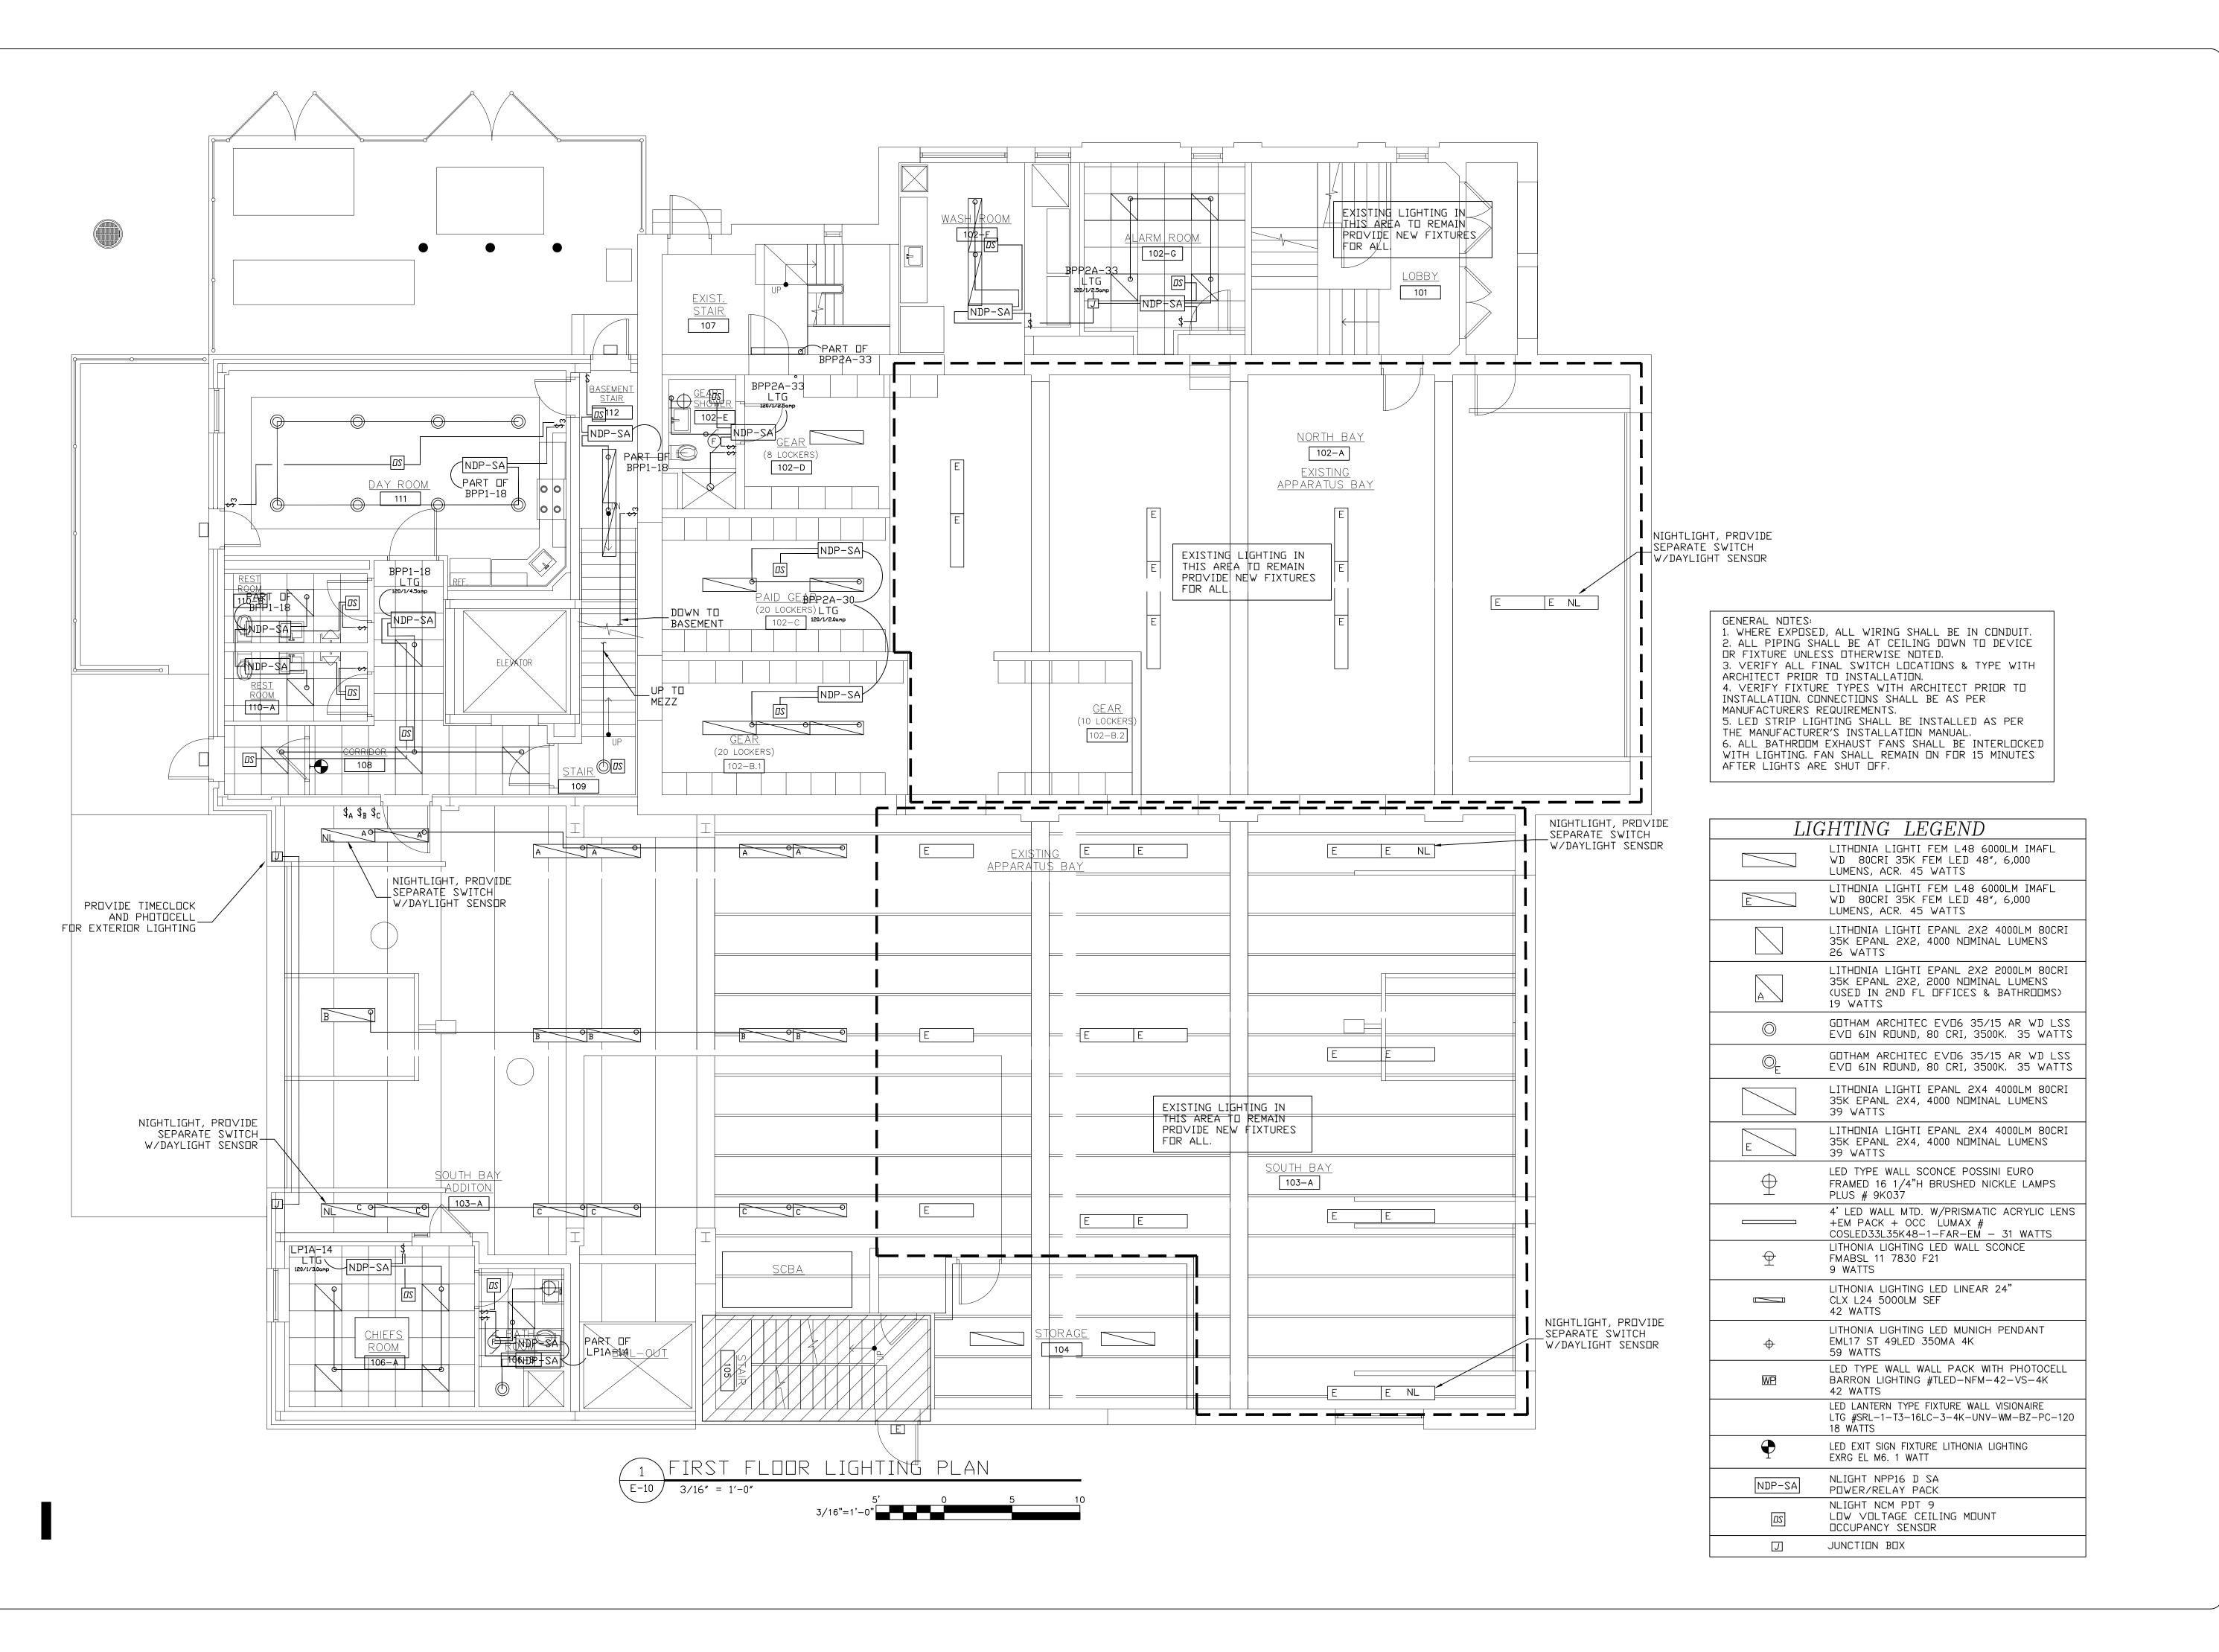


PROJECT #: 2020-04

DRAWN BY: SEND. ARCH

CAD FILE: P/2020/HFD 2020-04

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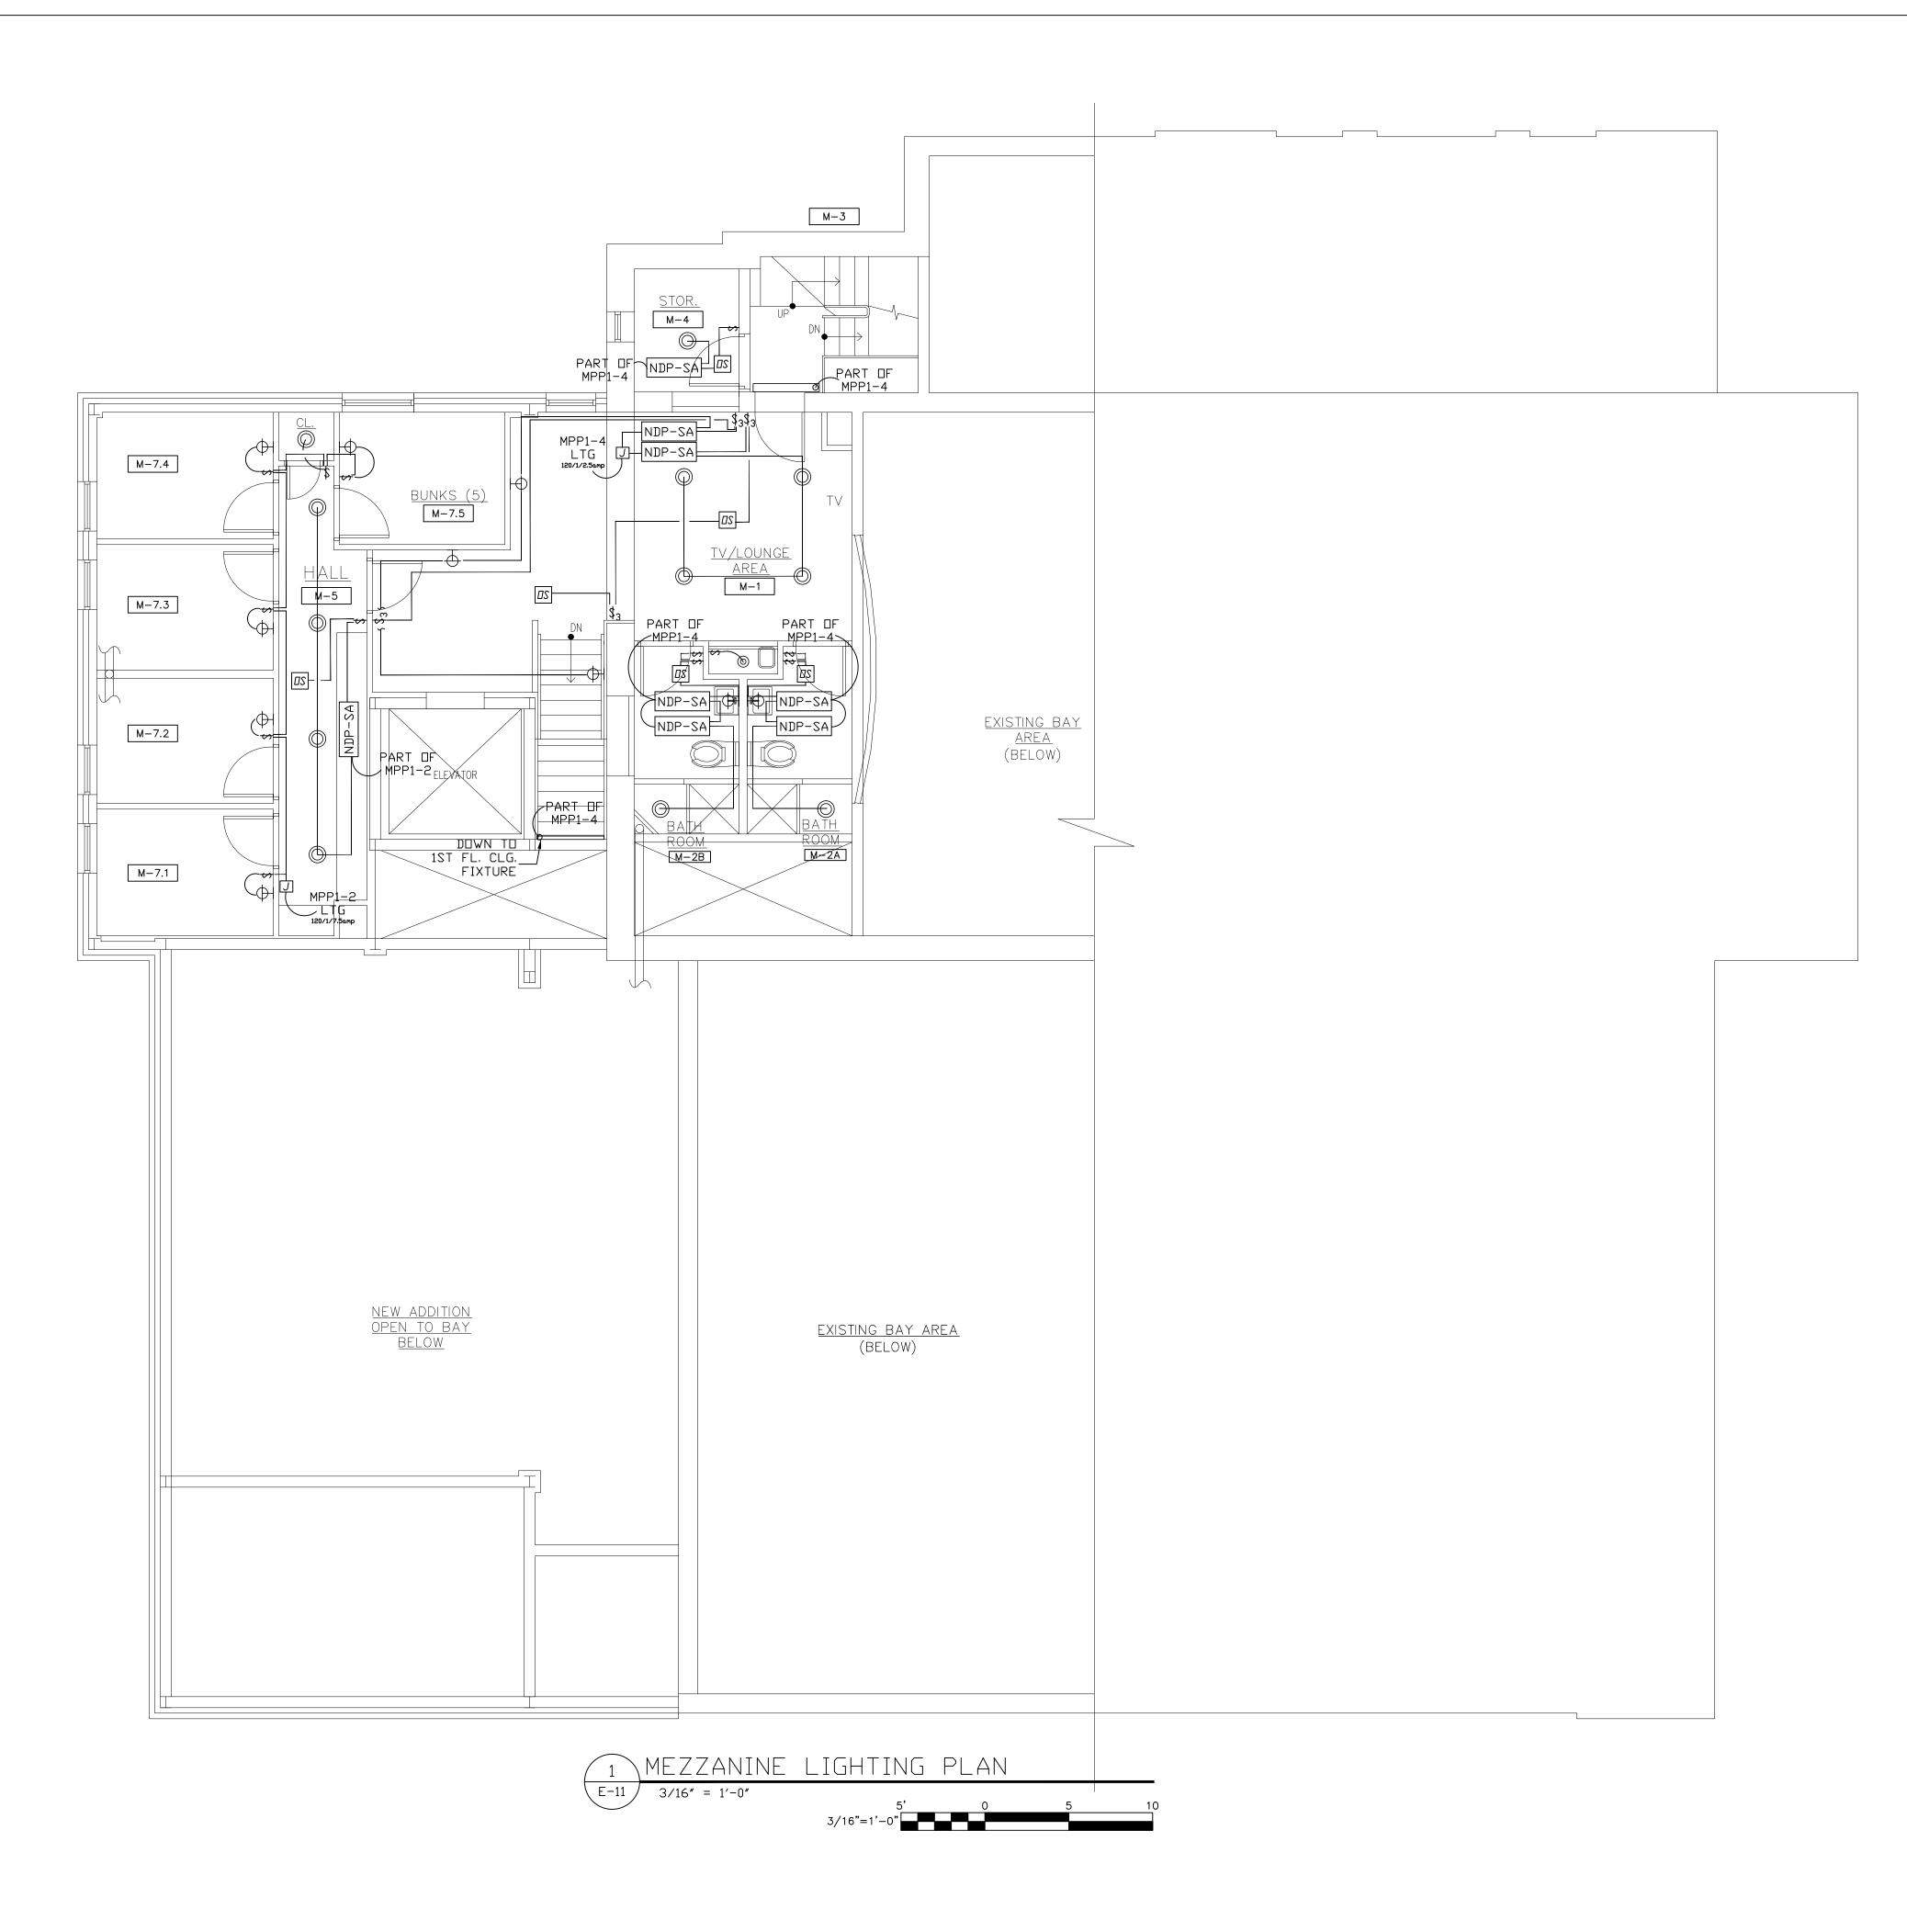
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PROPOSED ADDITION
206 HARRISON AVE
HARRISON, NY 10528

PROJECT #: 2020-04

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LIGHTING LEGEND LITHONIA LIGHTI FEM L48 6000LM IMAFL WD 80CRI 35K FEM LED 48", 6,000 LUMENS, ACR. 45 WATTS LITHONIA LIGHTI FEM L48 6000LM IMAFL WD 80CRI 35K FEM LED 48", 6,000 LUMENS, ACR. 45 WATTS LITHONIA LIGHTI EPANL 2X2 4000LM 80CRI 35K EPANL 2X2, 4000 NOMINAL LUMENS 26 WATTS LITHONIA LIGHTI EPANL 2X2 2000LM 80CRI 35K EPANL 2X2, 2000 NOMINAL LUMENS (USED IN 2ND FL DFFICES & BATHROOMS) GOTHAM ARCHITEC EVO6 35/15 AR WD LSS EVO 6IN ROUND, 80 CRI, 3500K. 35 WATTS GOTHAM ARCHITEC EVO6 35/15 AR WD LSS EVO 6IN ROUND, 80 CRI, 3500K. 35 WATTS LITHONIA LIGHTI EPANL 2X4 4000LM 80CRI 35K EPANL 2X4, 4000 NOMINAL LUMENS 39 WATTS LITHONIA LIGHTI EPANL 2X4 4000LM 80CRI 35K EPANL 2X4, 4000 NDMINAL LUMENS 39 WATTS LED TYPE WALL SCONCE POSSINI EURO FRAMED 16 1/4"H BRUSHED NICKLE LAMPS PLUS # 9K037 4' LED WALL MTD. W/PRISMATIC ACRYLIC LENS +EM PACK + OCC LUMAX # COSLED33L35K48-1-FAR-EM - 31 WATTS LITHONIA LIGHTING LED WALL SCONCE FMABSL 11 7830 F21 9 WATTS LITHONIA LIGHTING LED LINEAR 24" CLX L24 5000LM SEF 42 WATTS LITHONIA LIGHTING LED MUNICH PENDANT EML17 ST 49LED 350MA 4K 59 WATTS LED TYPE WALL WALL PACK WITH PHOTOCELL BARRON LIGHTING #TLED-NFM-42-VS-4K 42 WATTS LED LANTERN TYPE FIXTURE WALL VISIONAIRE LTG #SRL-1-T3-16LC-3-4K-UNV-WM-BZ-PC-120 LED EXIT SIGN FIXTURE LITHONIA LIGHTING EXRG EL M6. 1 WATT

NLIGHT NPP16 D SA

LOW VOLTAGE CEILING MOUNT

POWER/RELAY PACK NLIGHT NCM PDT 9

OCCUPANCY SENSOR

JUNCTION BOX

NDP-SA

J

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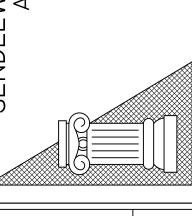
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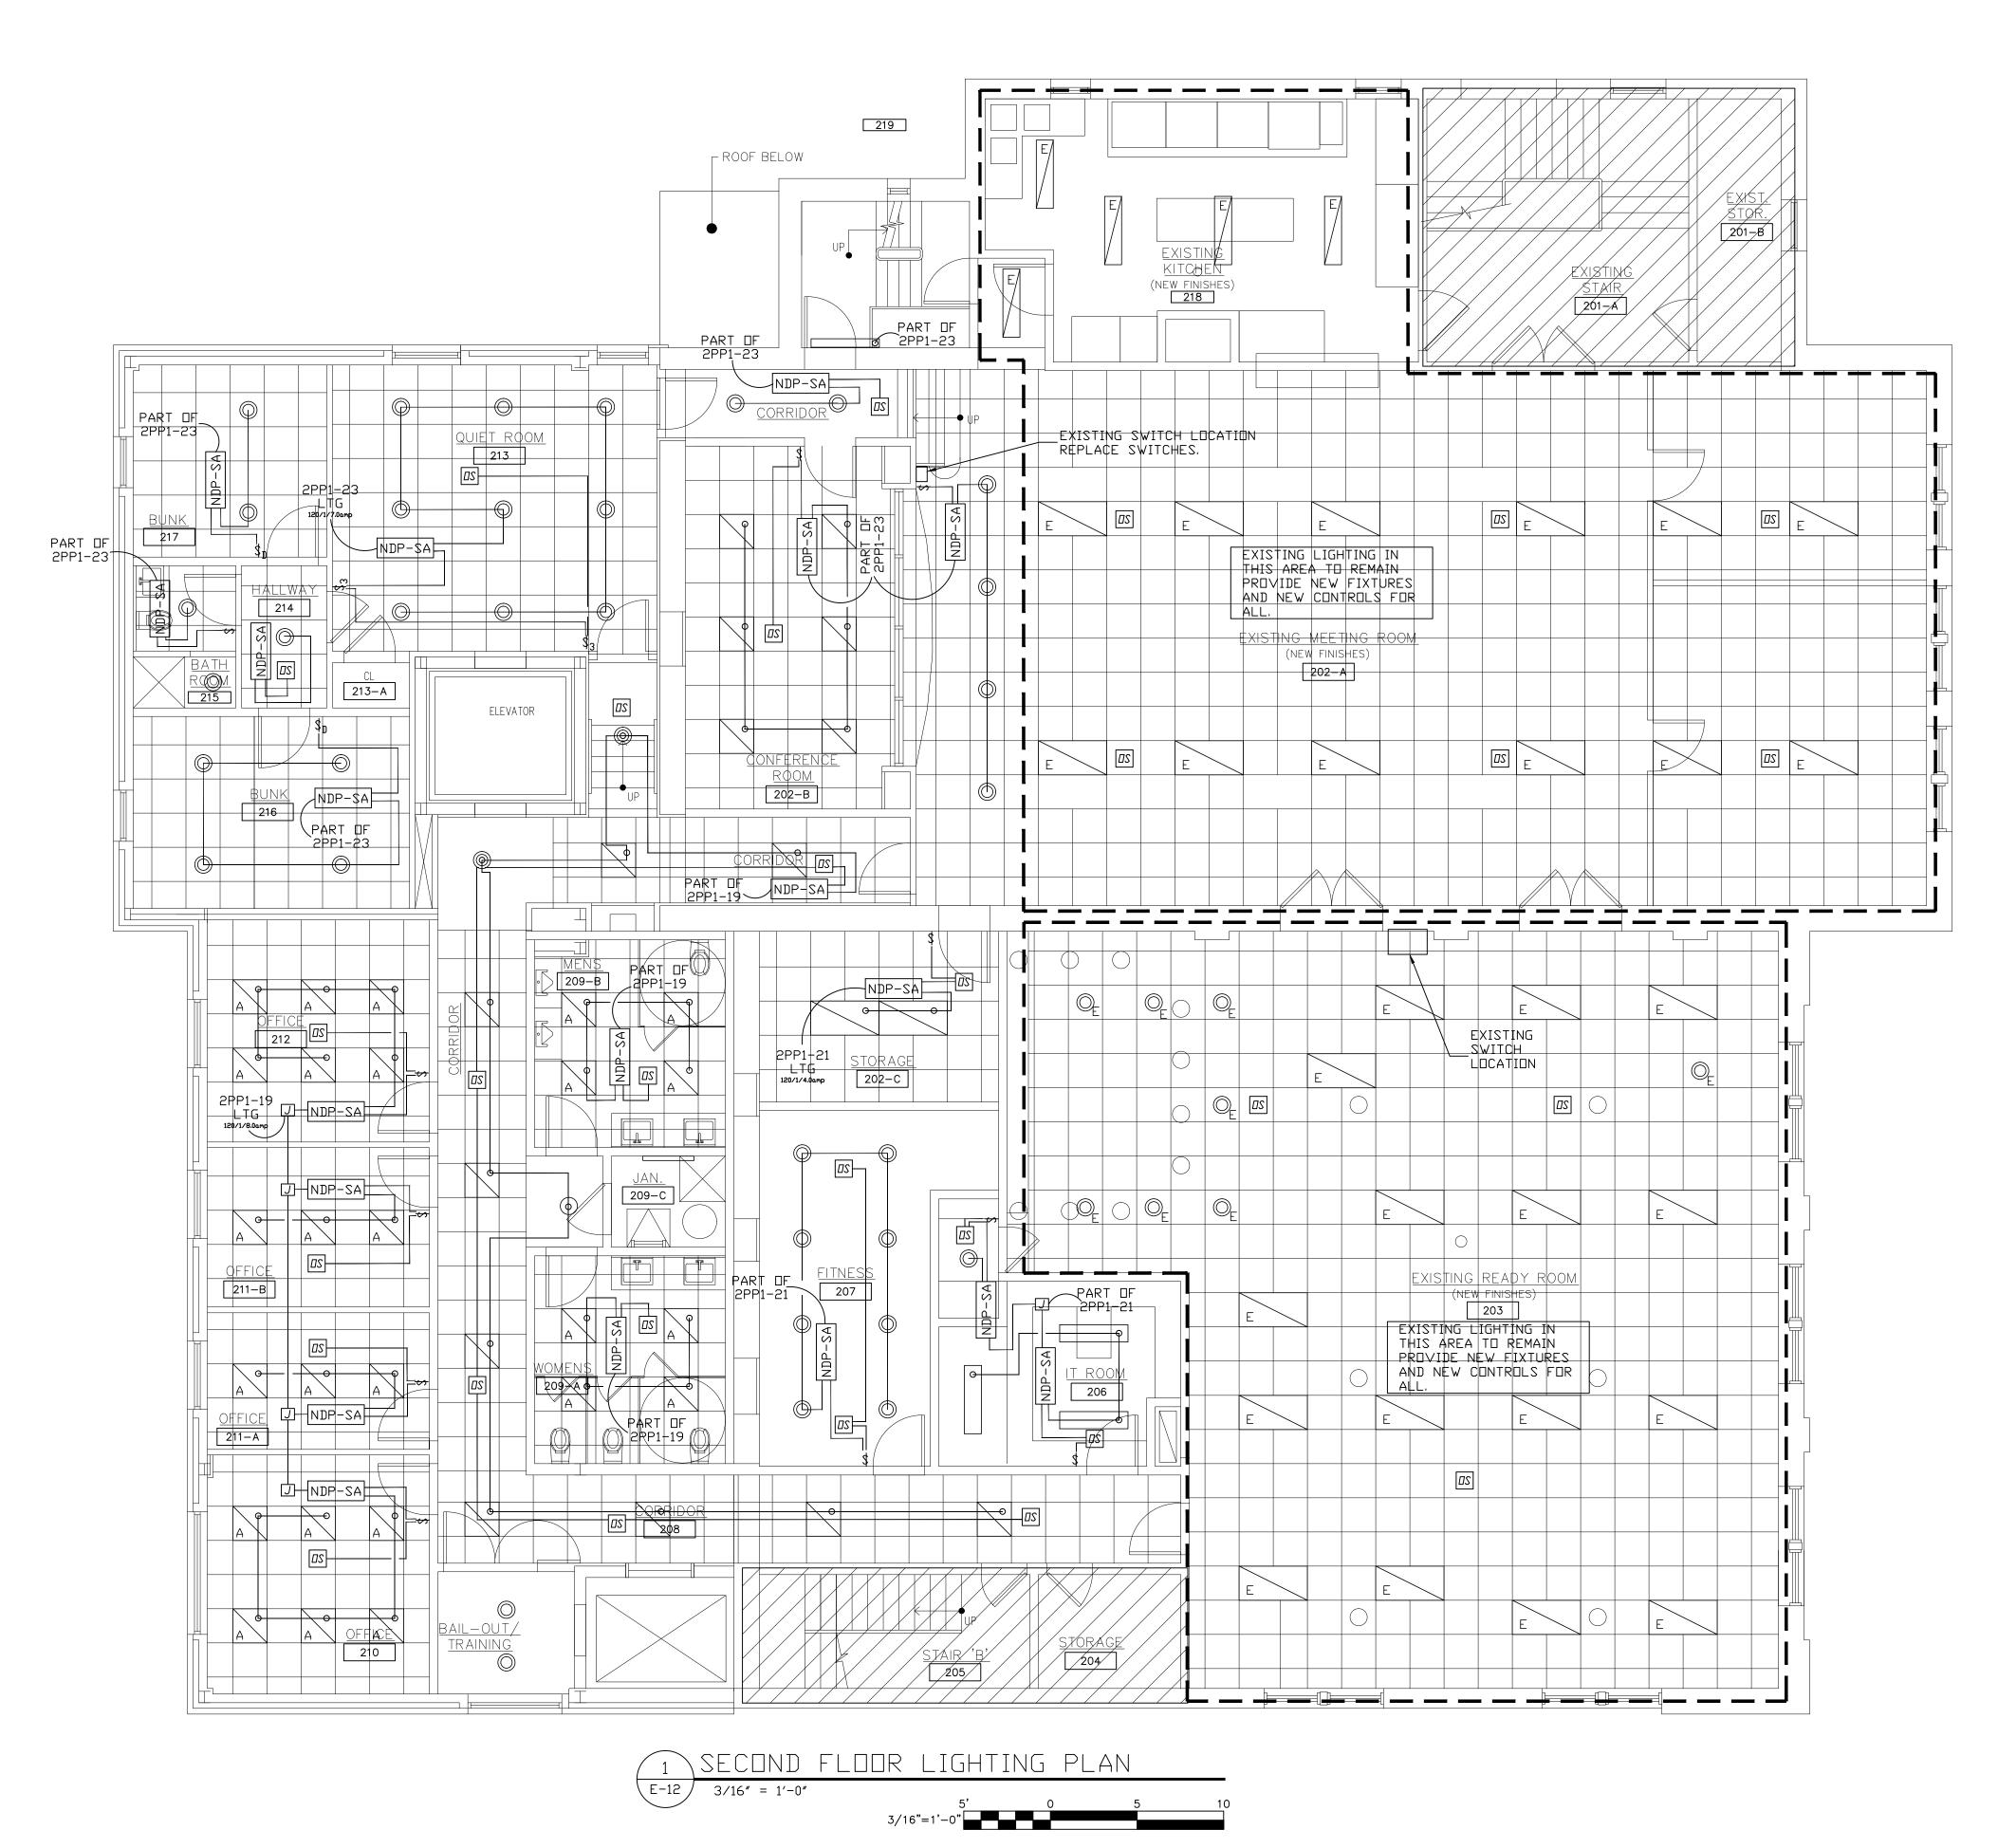
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CAD FILE: P/2020/HFD 2020-04

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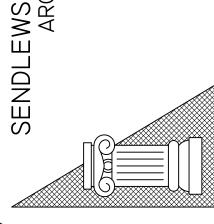
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HARRISON, NY 10528
SECOND FLOOR

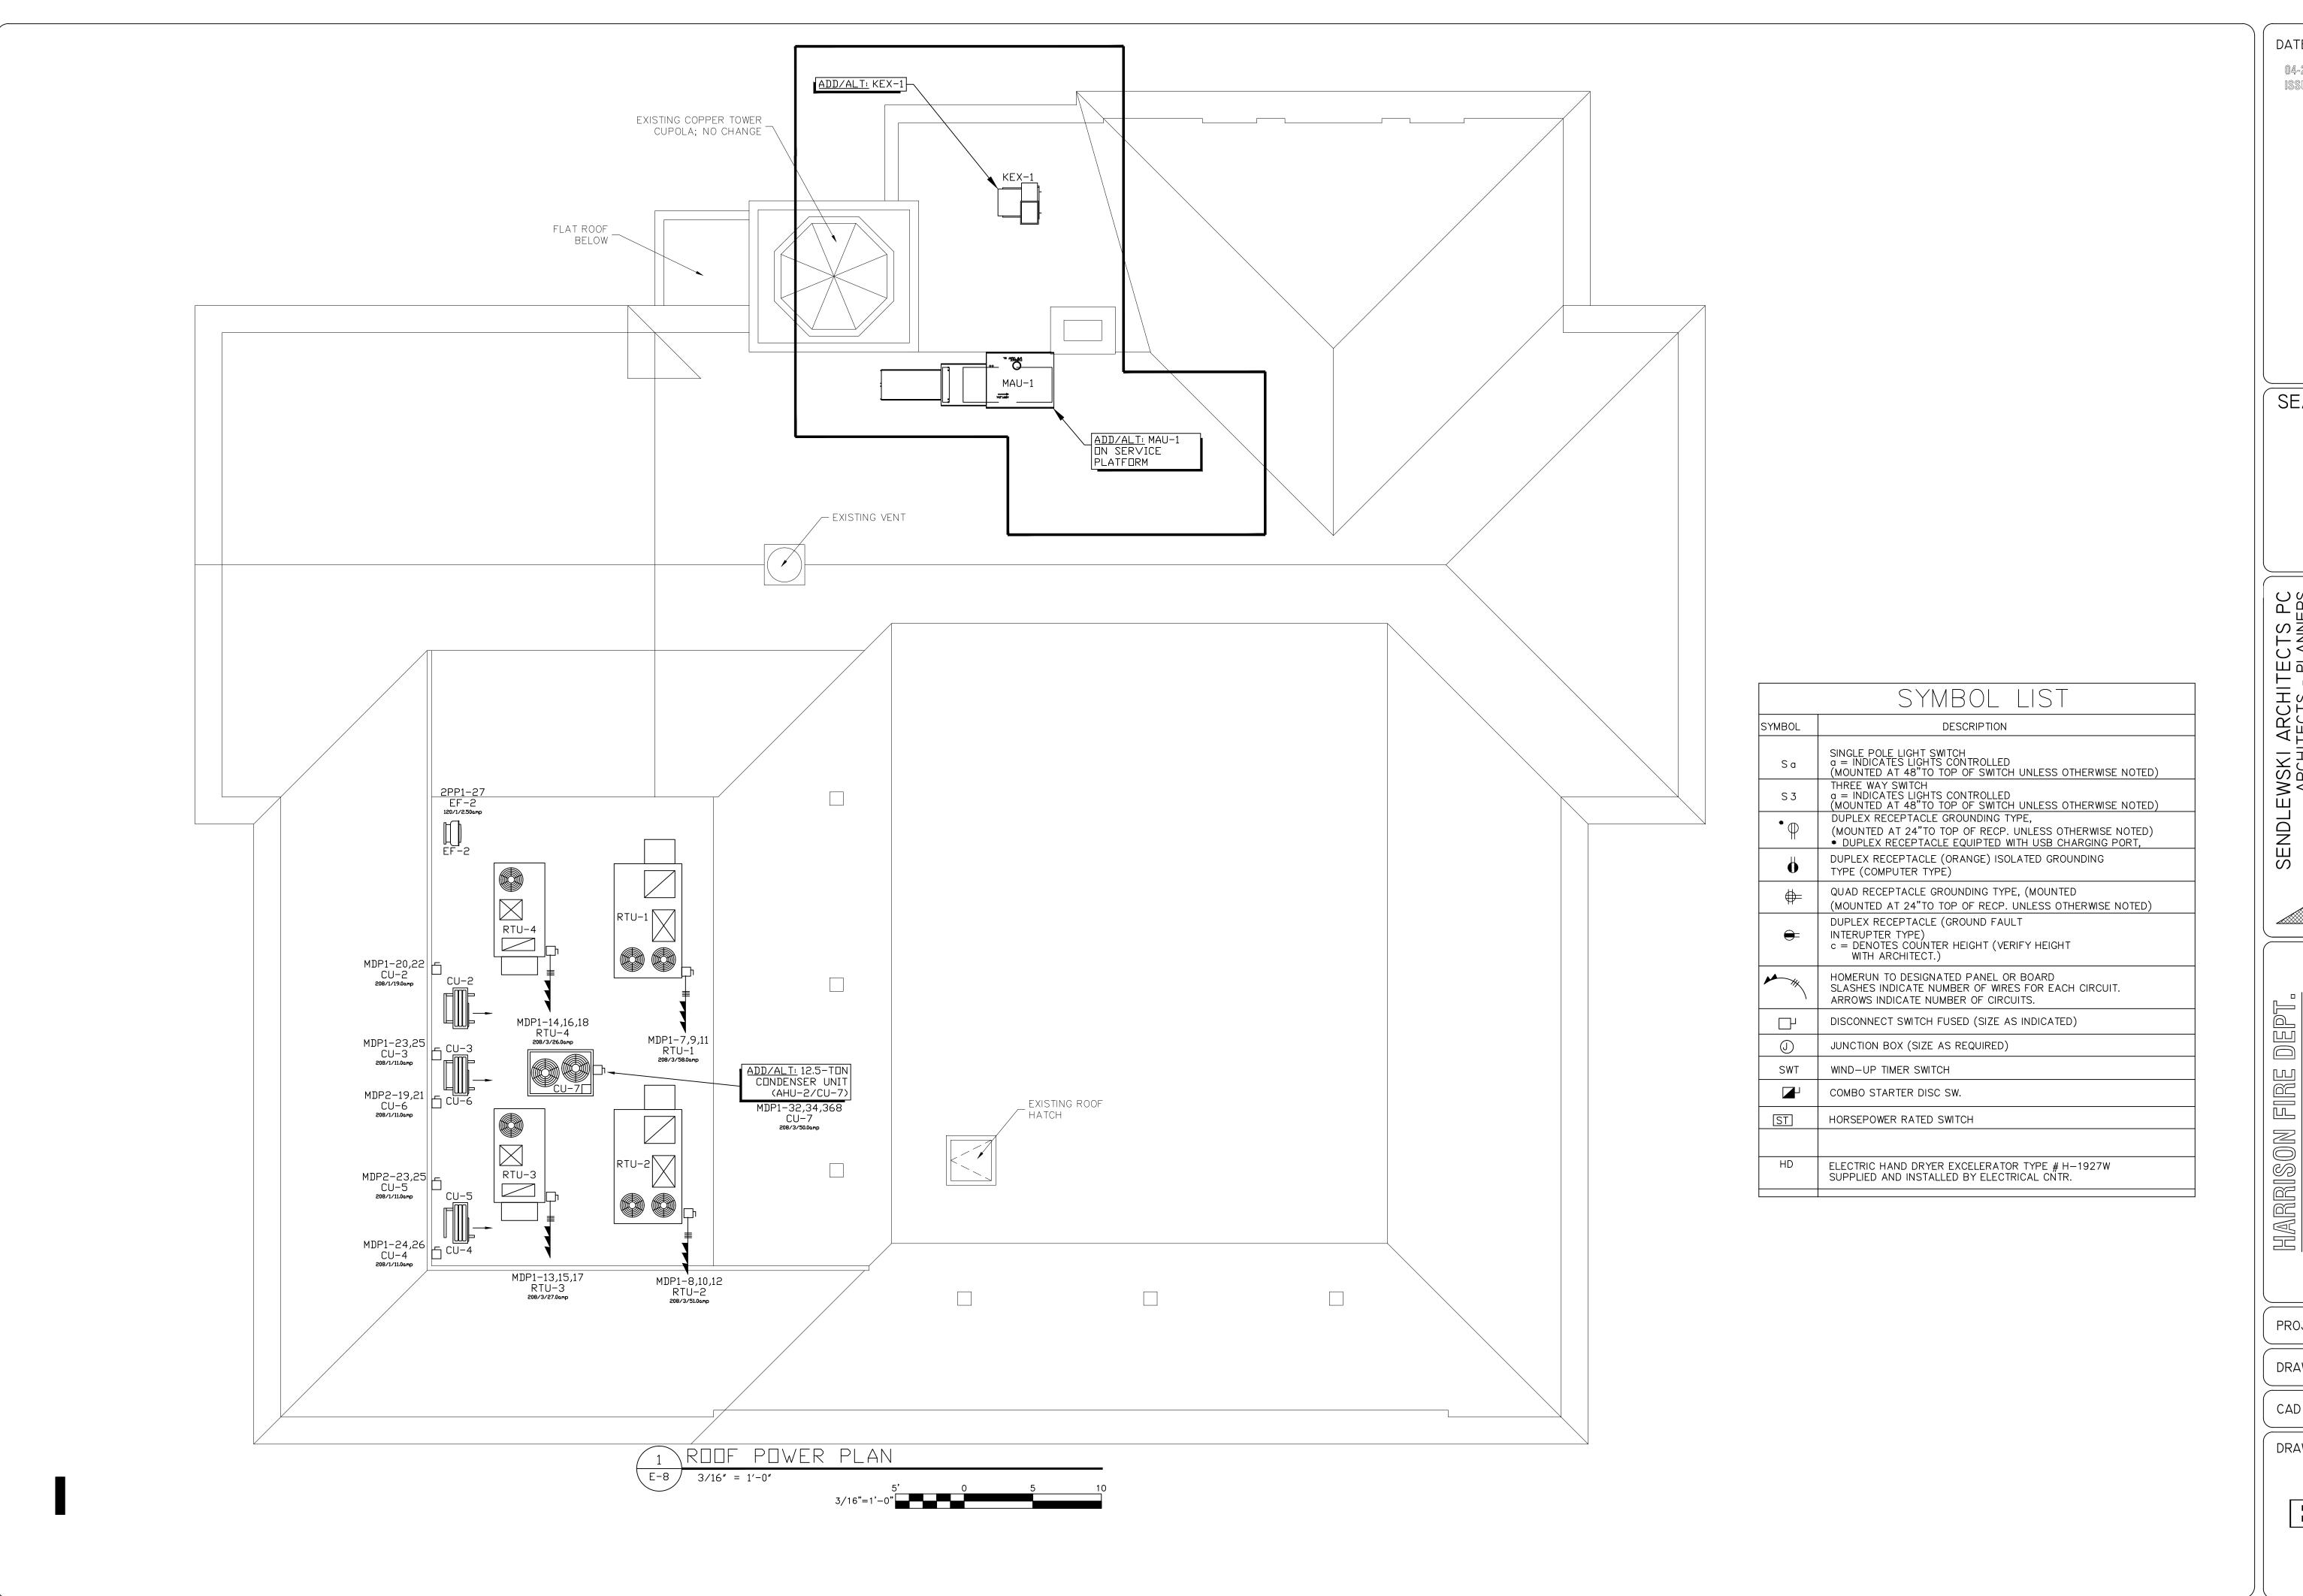
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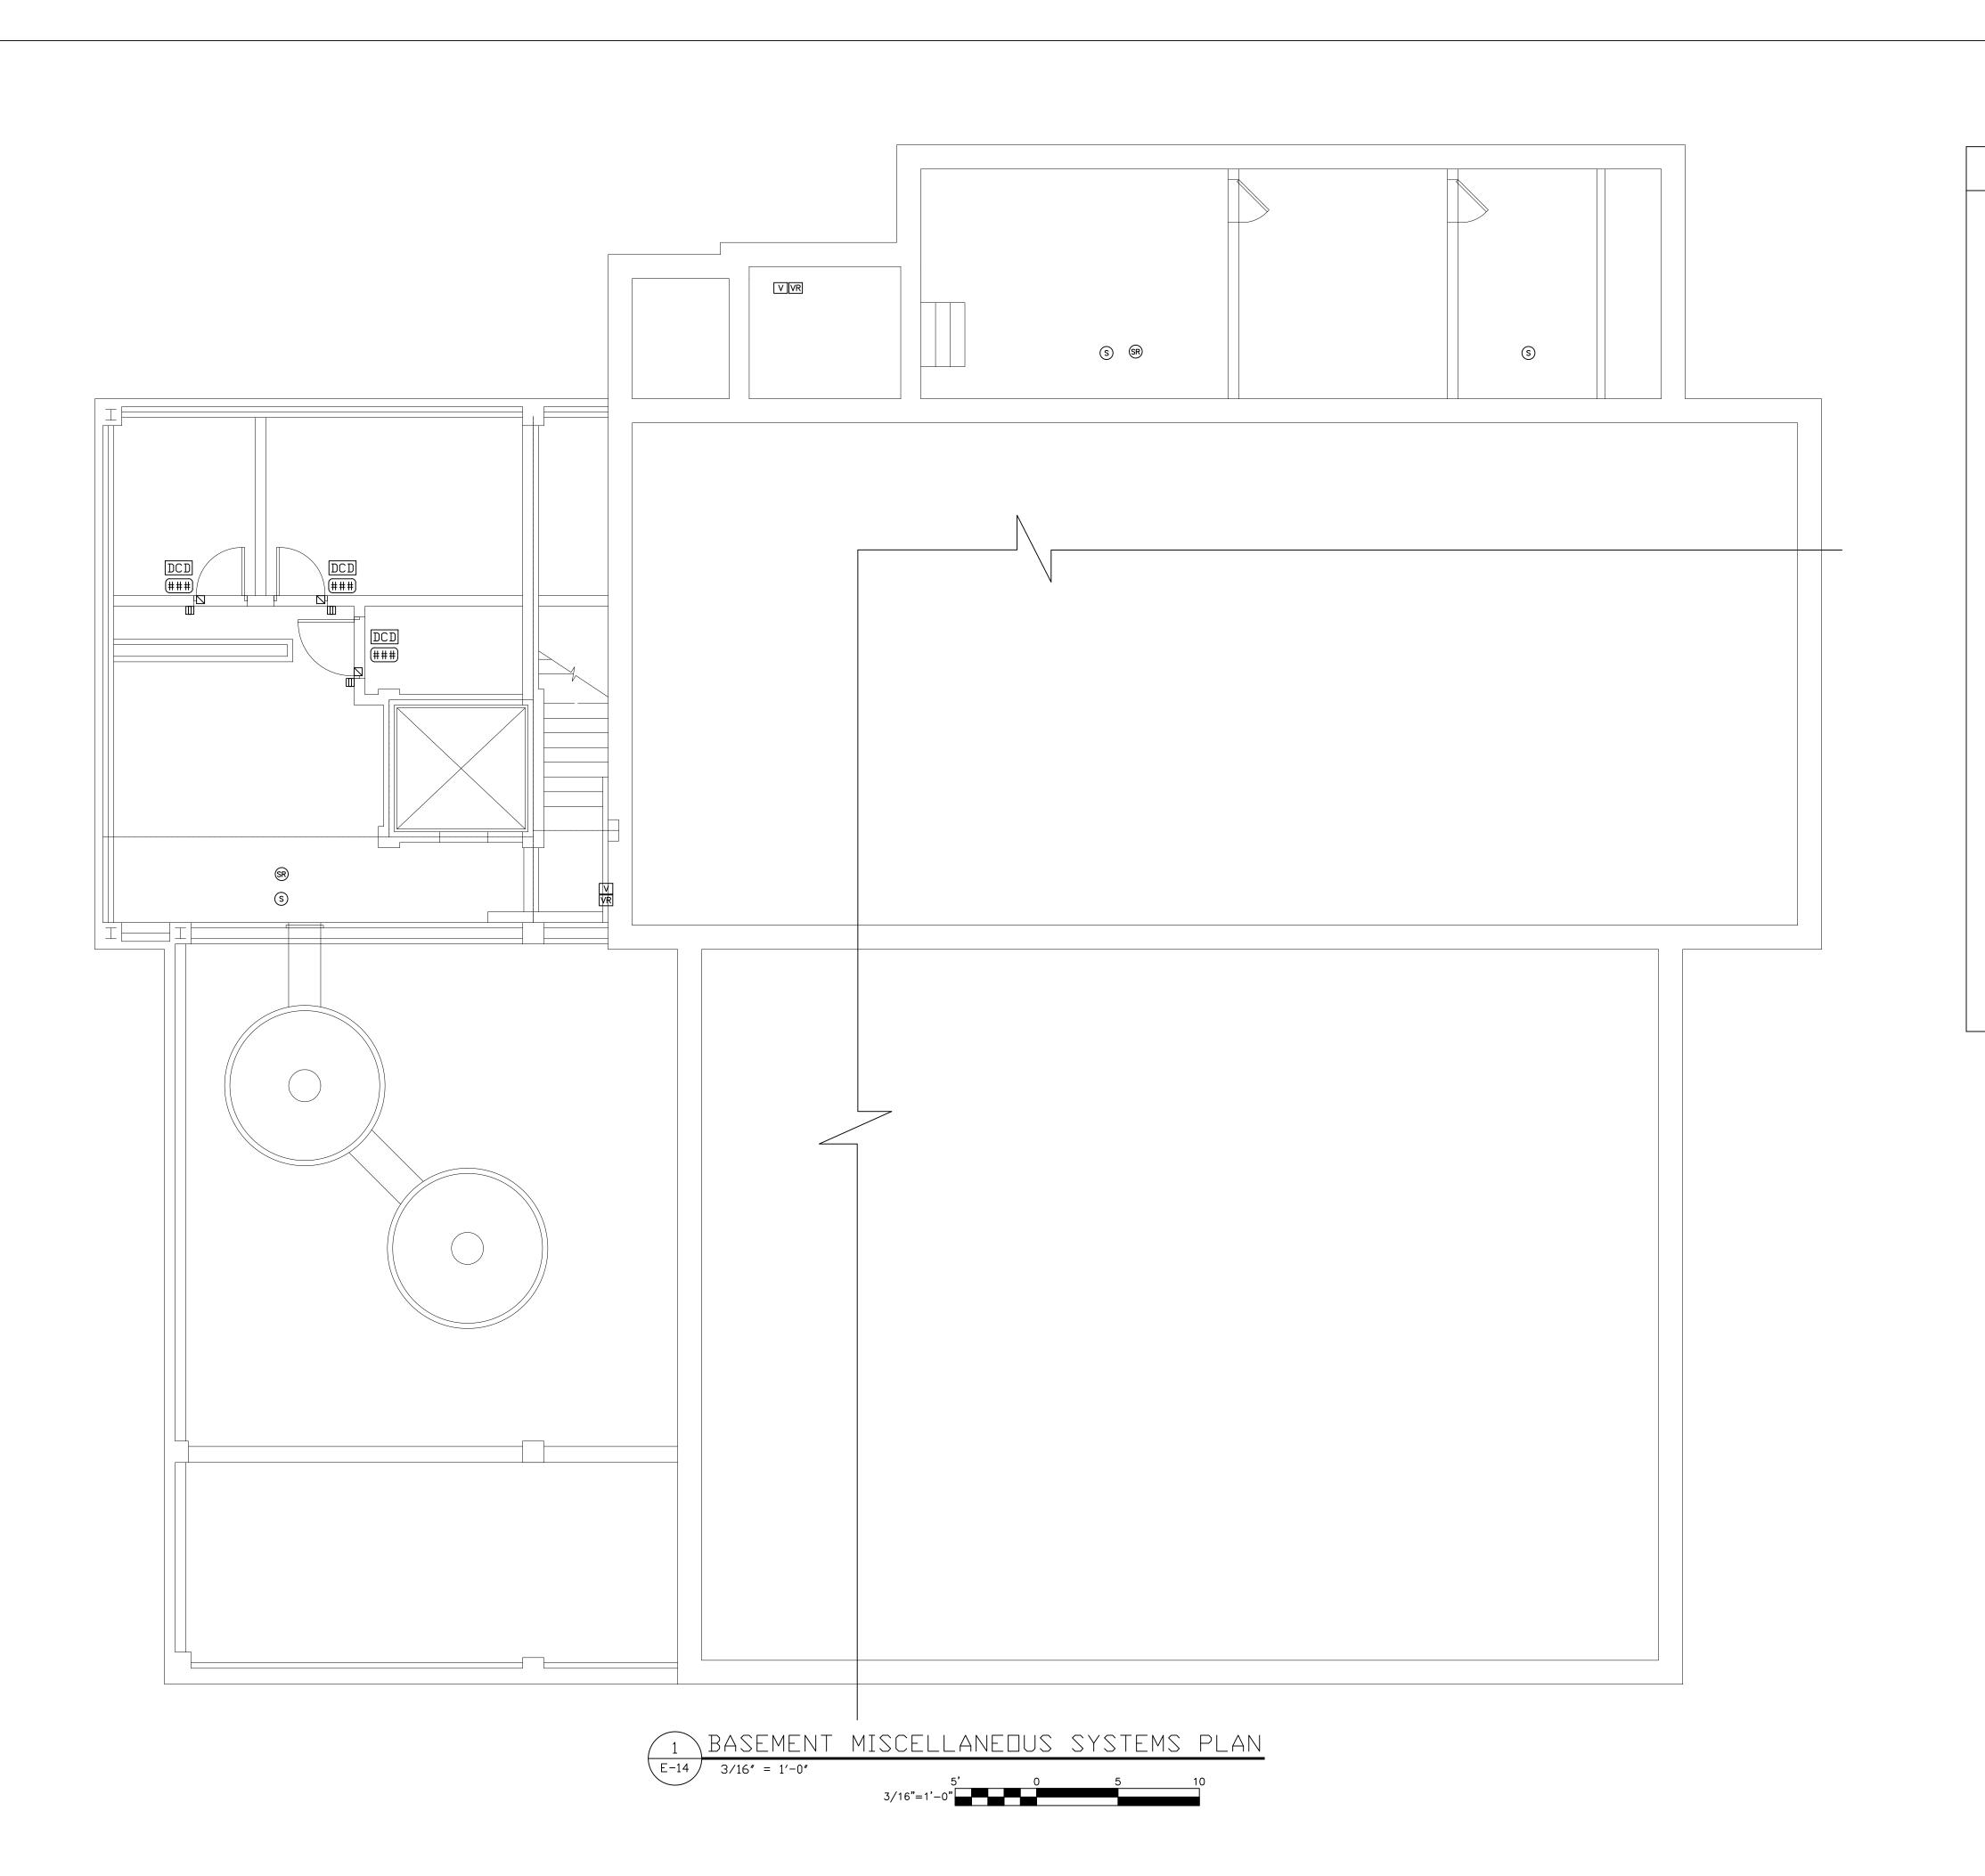
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PROJECT #: 2020-04

DRAWN BY: SEND. ARCH.

CAD FILE: P/2020/HFD 2020-04

DRAWING#:



- CABLE TV DUTLET(MTD. @ 2'-0"AFF)UNLESS NOTED WIRE SUPPLIED & INSTALLED BY ELECTRICAL CNTR. TO MEZZANINE COMPUTER ROOM CABLE TV. TERMIN BOX W/2-CAT 6 WIRE BLUE VERIFY W/CABLE CO.
- COMPUTER OUTLET(DUPLEX)(MTD.@2'-0"AFF)
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 - INTERIOR DOOR ELECTRIC STRIKE
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- DCD DOOR CONTROL DEVICE
- DENOTES DOOR NUMBER AS SHOWN ON RISER DIAGRAM AND PLAN
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- RECEPTACLE/WITH MONITOR JACK SINGLE COVER PLATE CAT 6 WIRE BACK TO MEZZANINE FLOOR COMPUTER RM
- MUSIC/PUBLIC ADDRESS SYSTEM SPEAKER W/18/4 FROM COMPUTER ROOM TO VOLUME
- CONTROL TO SPEAKER MUSIC/PUBLIC ADDRESS SYSTEM VOLUME CONTROLLER
- RADIO SYSTEM SPEAKER
- W/18/4+CAT 6 ORANGE FROM COMPUTER ROOM TO VOLUME CONTROL TO SPEAKER
- RADIO SYSTEM VOLUME CONTROLLER MONITOR OUTLET(DUPLEX)(MTD.@'-0"AFF)
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 FROM EACH OUTLET TERMINATE AT PUNCH BLOCK

LOCATIONS SHOWN FOR ALL TELEPHONE, COMPUTER JACKS, CABLE TV ETC. ARE CONCEPTUAL-EXACT LOCATIONS TO BE COORDINATED WITH OWNER/ARCHITECT .

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ALL WIRING FOR SPECIALTY SYSTEMS SHOWN ON THESE DRAWINGS SHALL BE VERIFIED WITH SUCCESSFUL SPECIALTY SYSTEMS VENDOR PRIOR TO PURCHASE OR INSTALLATION BY ELECTRICAL CONTRACTOR

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NOTE:

OUTLETS SHOWN ON MISCELLANEOUS SYSTEMS PLANS ARE ALSO SHOWN ON POWER PLANS AND ARE NOT IN ADDITION TO OUTLETS SHOWN ON POWER PLANS

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 ELECTRICAL CONTRACTOR WILL SUPPLY

 AND INSTALL 2CAT 6 WIRE GREY FROM EACH TELEPHONE

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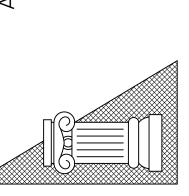
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EWSKI ARCHITECTS PC ARCHITECTS - PLANNERS 215 ROANOKE AVENUE RIVERHEAD, NY 11901 (631) 727-5352



HARRISON FIRE DEPT.
PROPOSED ADDITION
206 HARRISON AVE
HARRISON, NY 10528
MEZZANINE MISCELLANEOL

PROJECT #: 2020-04

DRAWN BY: SEND. ARCH.

CAD FILE: P/2020/HFD 2020-04

DRAWING#:



- CABLE TV DUTLET(MTD. @ 2'-0"AFF)UNLESS NOTED WIRE SUPPLIED & INSTALLED BY ELECTRICAL CNTR. TO MEZZANINE COMPUTER ROOM CABLE TV. TERMIN BOX W/2-CAT 6 WIRE BLUE VERIFY W/CABLE CO.
- COMPUTER OUTLET(DUPLEX)(MTD.@2'-0"AFF)
 ELECTRICAL CONTRACTOR SHALL SUPPLY & INSTALL CMPTR.. WIRE CAT 6(BLUE) TO MEZZANINE FLR COMPTR RM FROM EACH OUTLET TERMINATE AT PUNCH BLOCK
- TELEPHONE OUTLET(MTD.@2'-0"AFF.) W = WALL MTD. (MTD.@64"AFF)ELECTRICAL CONTRACTOR WILL SUPPLY AND INSTALL 2CAT 6 WIRE GREY FROM EACH TELEPHONE OUTLET TO MEZZANINE FLOOR COMPUTER RM TERMINATE AT PUNCH BLOCK
 - INTERIOR DOOR ELECTRIC STRIKE
- EXTERIOR DOOR ELECTRIC STRIKE
- CARD READER(MTD. @ 48"AFF)WHERE APPLICABLE
- DDB DOOR BELL & SPEAKER(PART OF ACCESS SYSTEM) ELECTRICAL CONTR. SHALL SUPPLY AND INSTALL WIRE, CDT, JBOXES ETC PLUS 18/4 TO TELEPHONE SYSTEM. SECURITY CAMERA
- 1 = DENOTES TYPE OF CAMERA(OUTDOOR) 2 = DENOTES TYPE OF CAMERA(INDOOR)
- LAN SYSYTEM ANTENNA ELECTRICAL CONTRACTOR WILL SUPPLY AND INSTALL 2CAT 6 WIRE GREY FROM EACH OUTLET TO MEZZANINE FLOOR COMPUTER RM TERMINATE AT PUNCH BLOCK
- DCD DOOR CONTROL DEVICE
- DENOTES DOOR NUMBER AS SHOWN ON RISER DIAGRAM AND PLAN
- PHONE/DATA/ POWER ALL DUPLEX JACKS ONE COVER PLATE W/DIVIDER
- DATA/ POWER ALL DUPLEX JACKS ONE COVER PLATE W/DIVIDER CAT 5E WIRE BACK TO
- MEZZANINE FLOÓR COMPUTER ROOM RECEPTACLE/WITH MONITOR JACK SINGLE COVER PLATE
- CAT 6 WIRE BACK TO MEZZANINE FLOOR COMPUTER RM
- MUSIC/PUBLIC ADDRESS SYSTEM SPEAKER W/18/4 FROM COMPUTER ROOM TO VOLUME
- CONTROL TO SPEAKER MUSIC/PUBLIC ADDRESS SYSTEM VOLUME CONTROLLER
- RADIO SYSTEM SPEAKER
- W/18/4+CAT 6 ORANGE FROM COMPUTER ROOM TO VOLUME CONTROL TO SPEAKER
- RADIO SYSTEM VOLUME CONTROLLER
- MONITOR OUTLET(DUPLEX)(MTD.@'-0"AFF)
 ELECTRICAL CONTRACTOR SHALL SUPPLY & INSTALL
 CMPTR. WIRE CAT 6(BLUE) TO MEZZANINE FLR COMPTR RM
 FROM EACH OUTLET TERMINATE AT PUNCH BLOCK

LOCATIONS SHOWN FOR ALL TELEPHONE, COMPUTER JACKS, CABLE TV ETC. ARE CONCEPTUAL-EXACT LOCATIONS TO BE COORDINATED WITH OWNER/ARCHITECT .

ALL WIRING FOR ACCESS, SURVEILANCE, TELEPHONE, CABLE TV, COMPUTER, FIRE ALARM, PUBLIC ADDRESS SYSTEMS TO BE SUPPLIED AND INSTALLED BY ELECTRICAL CNTR. ALL CDT, BOXES ETC NEEDED TO FACILITATE INSTALLATION SHALL BE SUPPLIED AND INSTALLED BY ELECT. CNTR. ALL ROUTING TO 2ND FLOOR COMPUTER ROOM.

ALL WIRING FOR SPECIALTY SYSTEMS SHOWN ON THESE DRAWINGS SHALL BE VERIFIED WITH SUCCESSFUL SPECIALTY SYSTEMS VENDOR PRIOR TO PURCHASE OR INSTALLATION BY ELECTRICAL CONTRACTOR

ALL WIRING FOR SPECIALTY SYSTEMS SHOWN ON THESE DRAWINGS SHALL BE CERTIFIED BY ELECTRICAL CONTRACTOR.

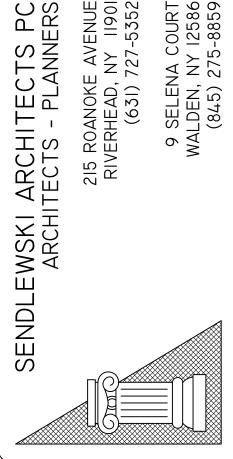
OUTLETS SHOWN ON MISCELLANEOUS SYSTEMS PLANS ARE ALSO SHOWN ON POWER PLANS AND ARE NOT IN ADDITION TO OUTLETS SHOWN ON POWER PLANS

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206 Harrison ave Harrison, ny 10528

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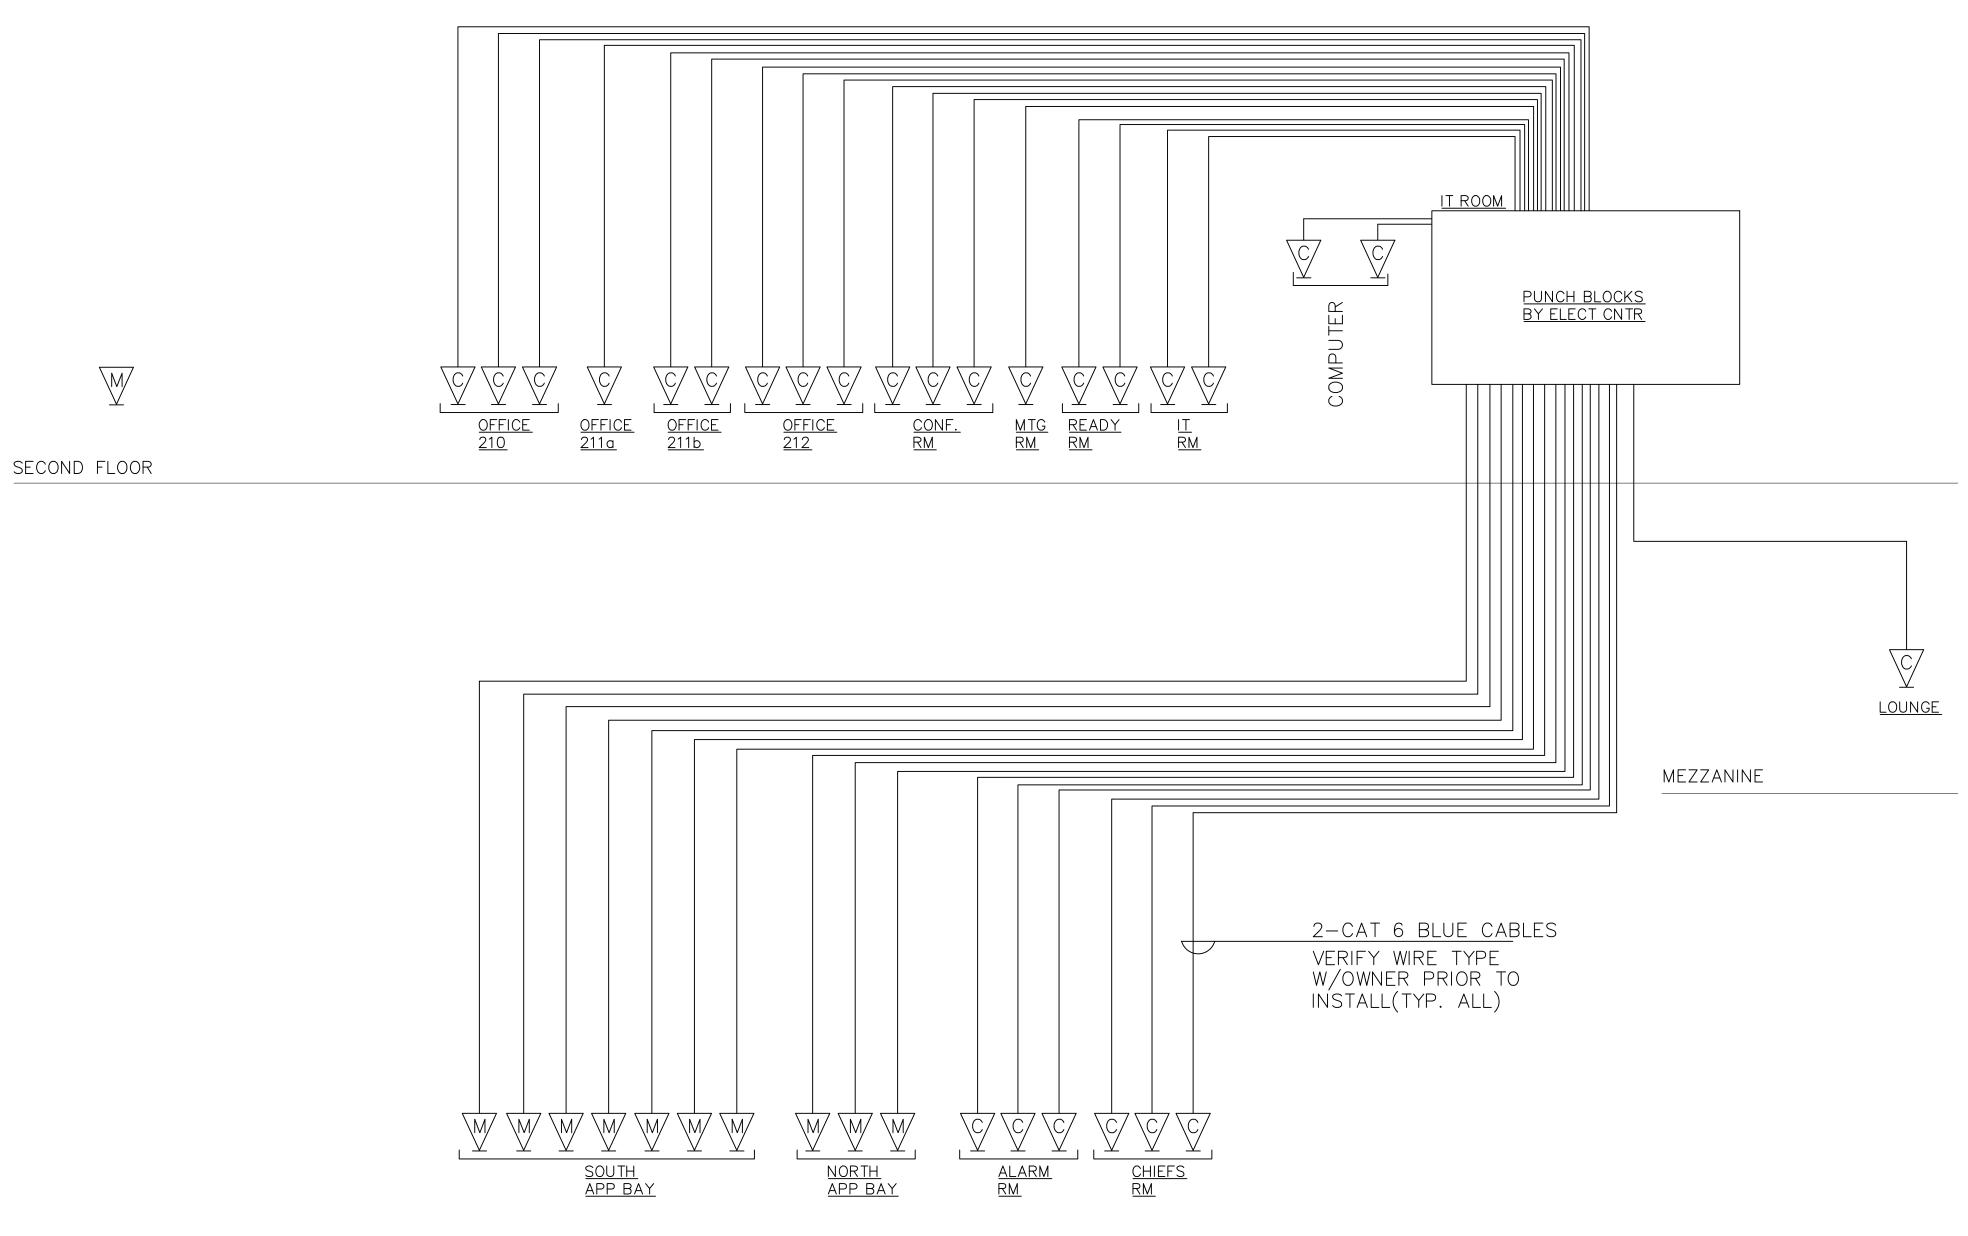
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HARRISON

ATTIC



FIRST FLOOR

NOTE:

ELECTRICAL CONTRACTOR SHALL SUPPLY AND INSTALL ALL WIRE, CONDUIT, BOXES ETC. TO MAKE COMPLETE SYS.
ALL FINAL DEVICES TO BE WIRED AND INSTALLED BY
ELECTRICAL CONTRACTOR. WIRING FOR LAN AND DATA SHALL INCLUDE WALL (OR CEILING) JACKS AND PLATES FULLY WIRED & LABELED

NOTE
ALL WIRING TO BE
CERTIFIED BY ELECTRICAL
CONTRACTOR

BASEMENT

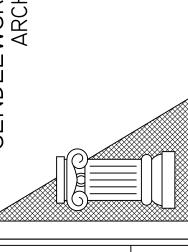
COMPUTER SYSTEM RISER DIAGRAM E-18 3/16" = 1'-0"

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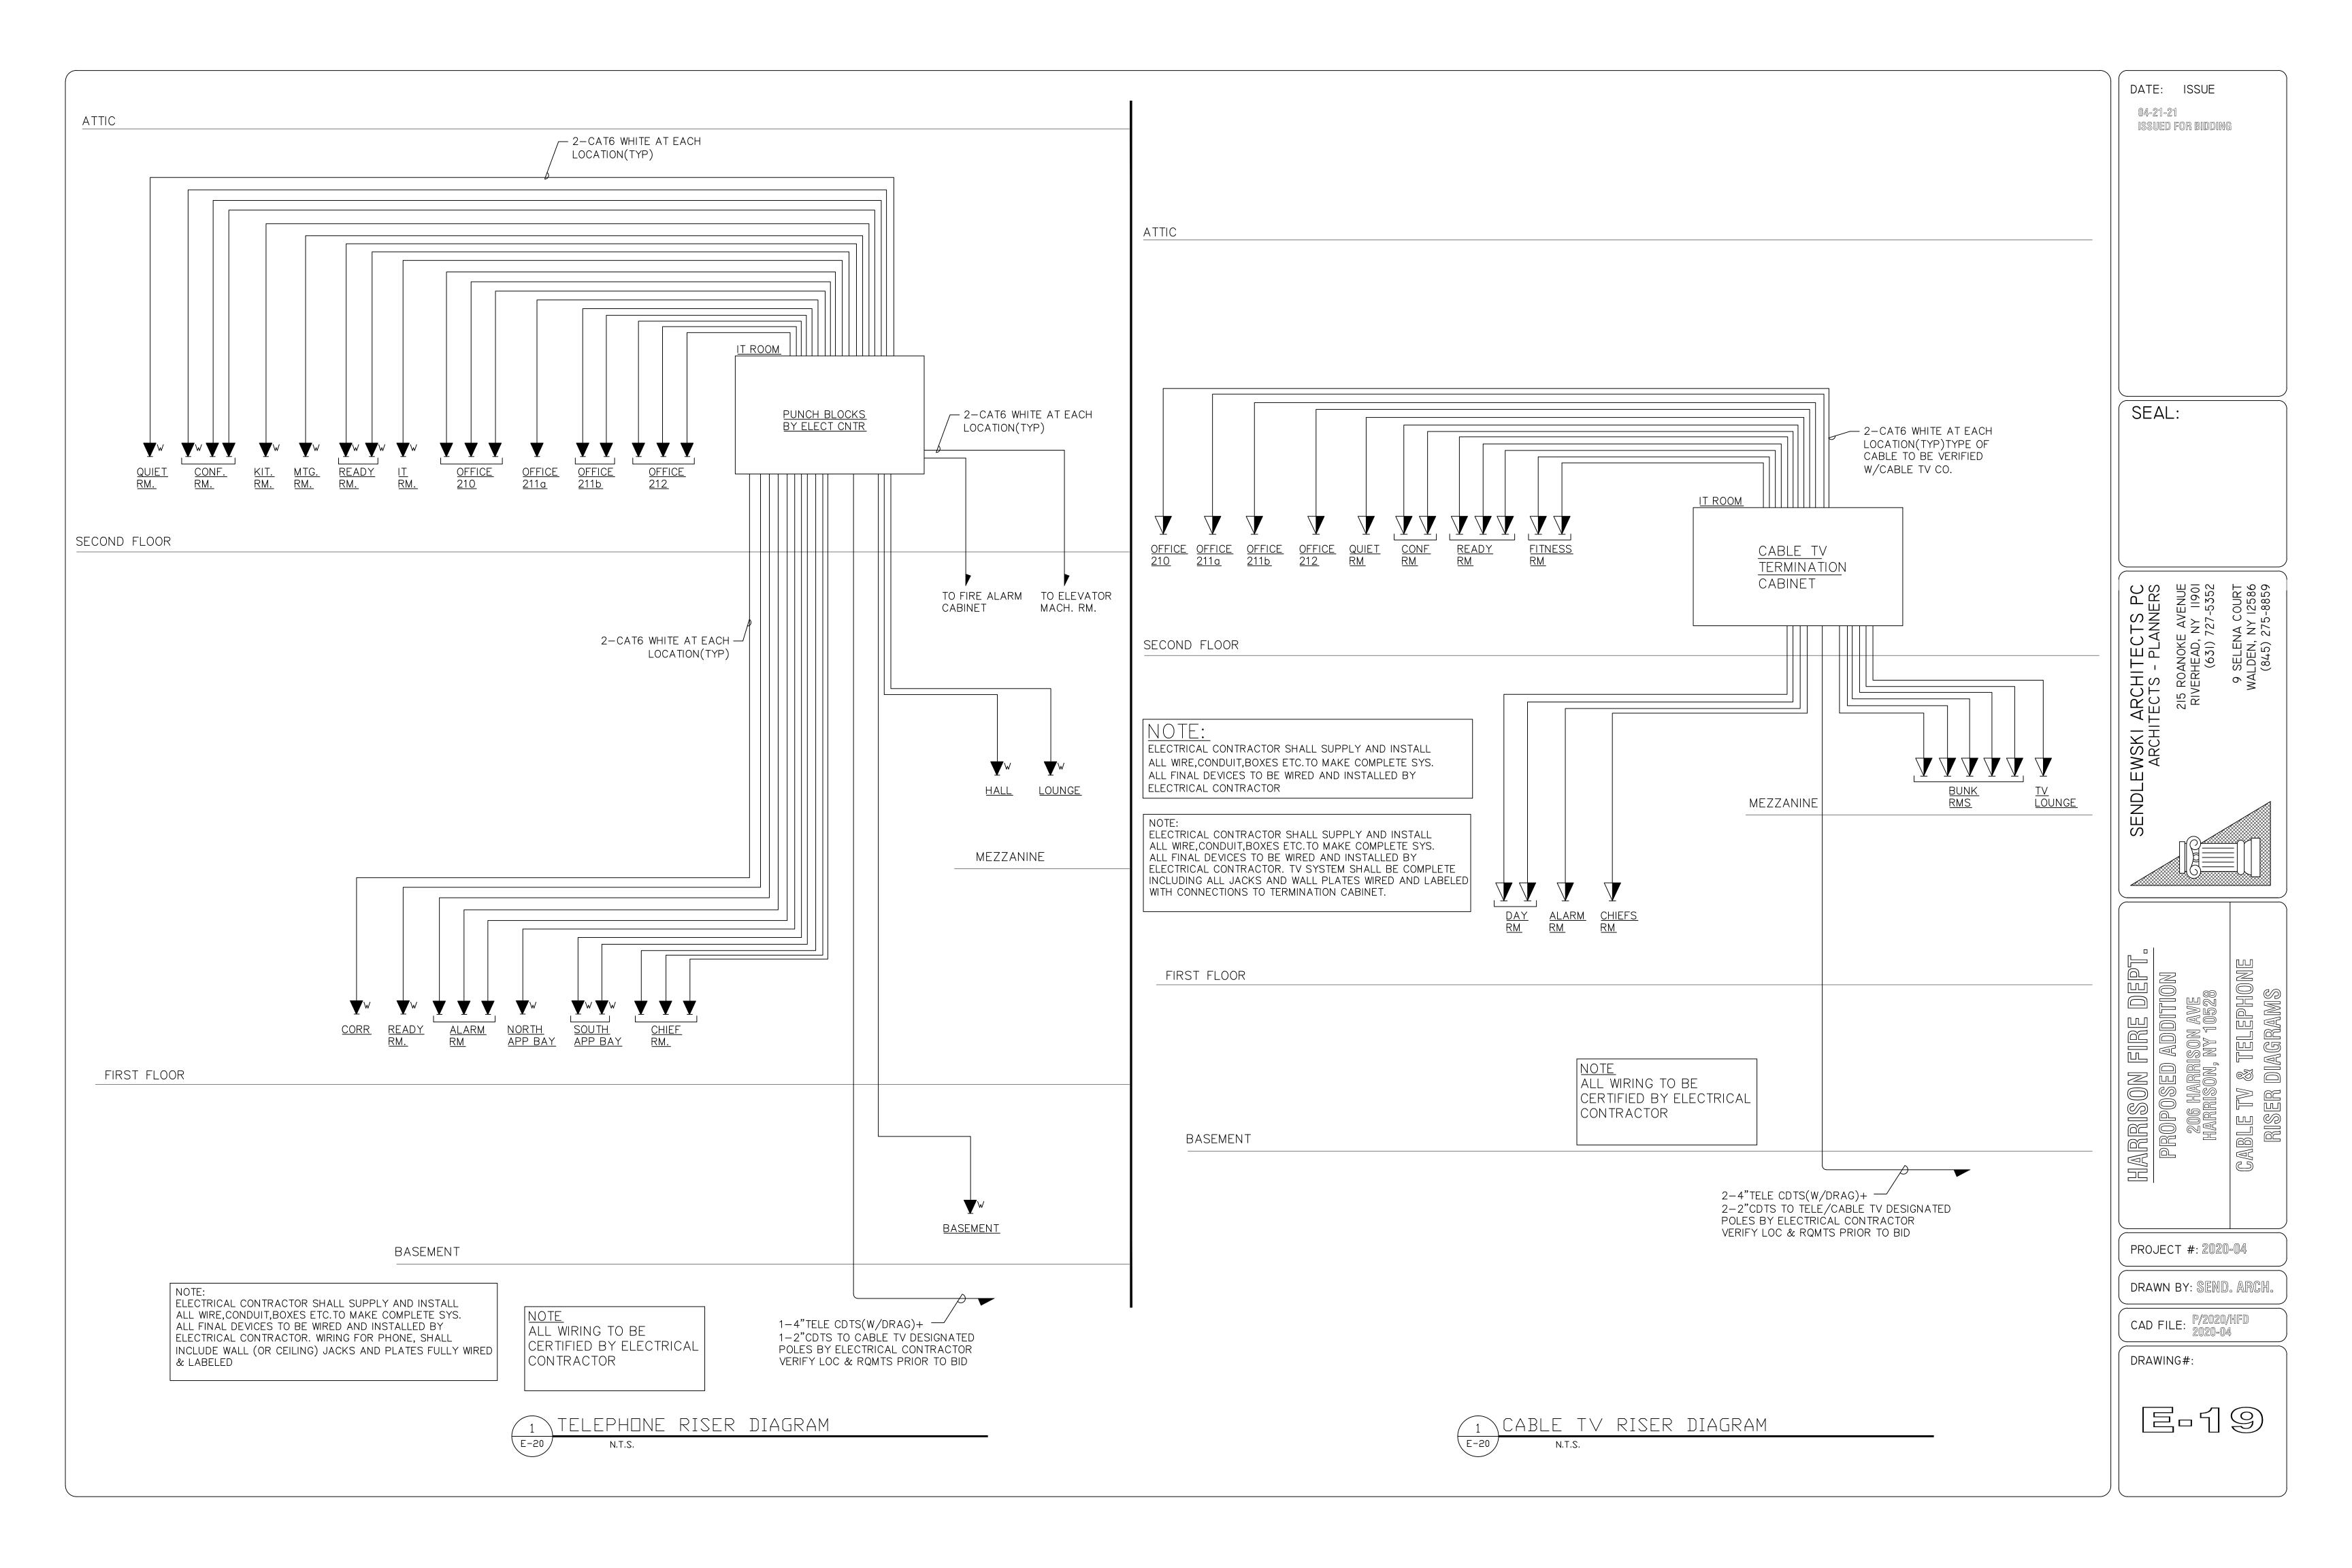
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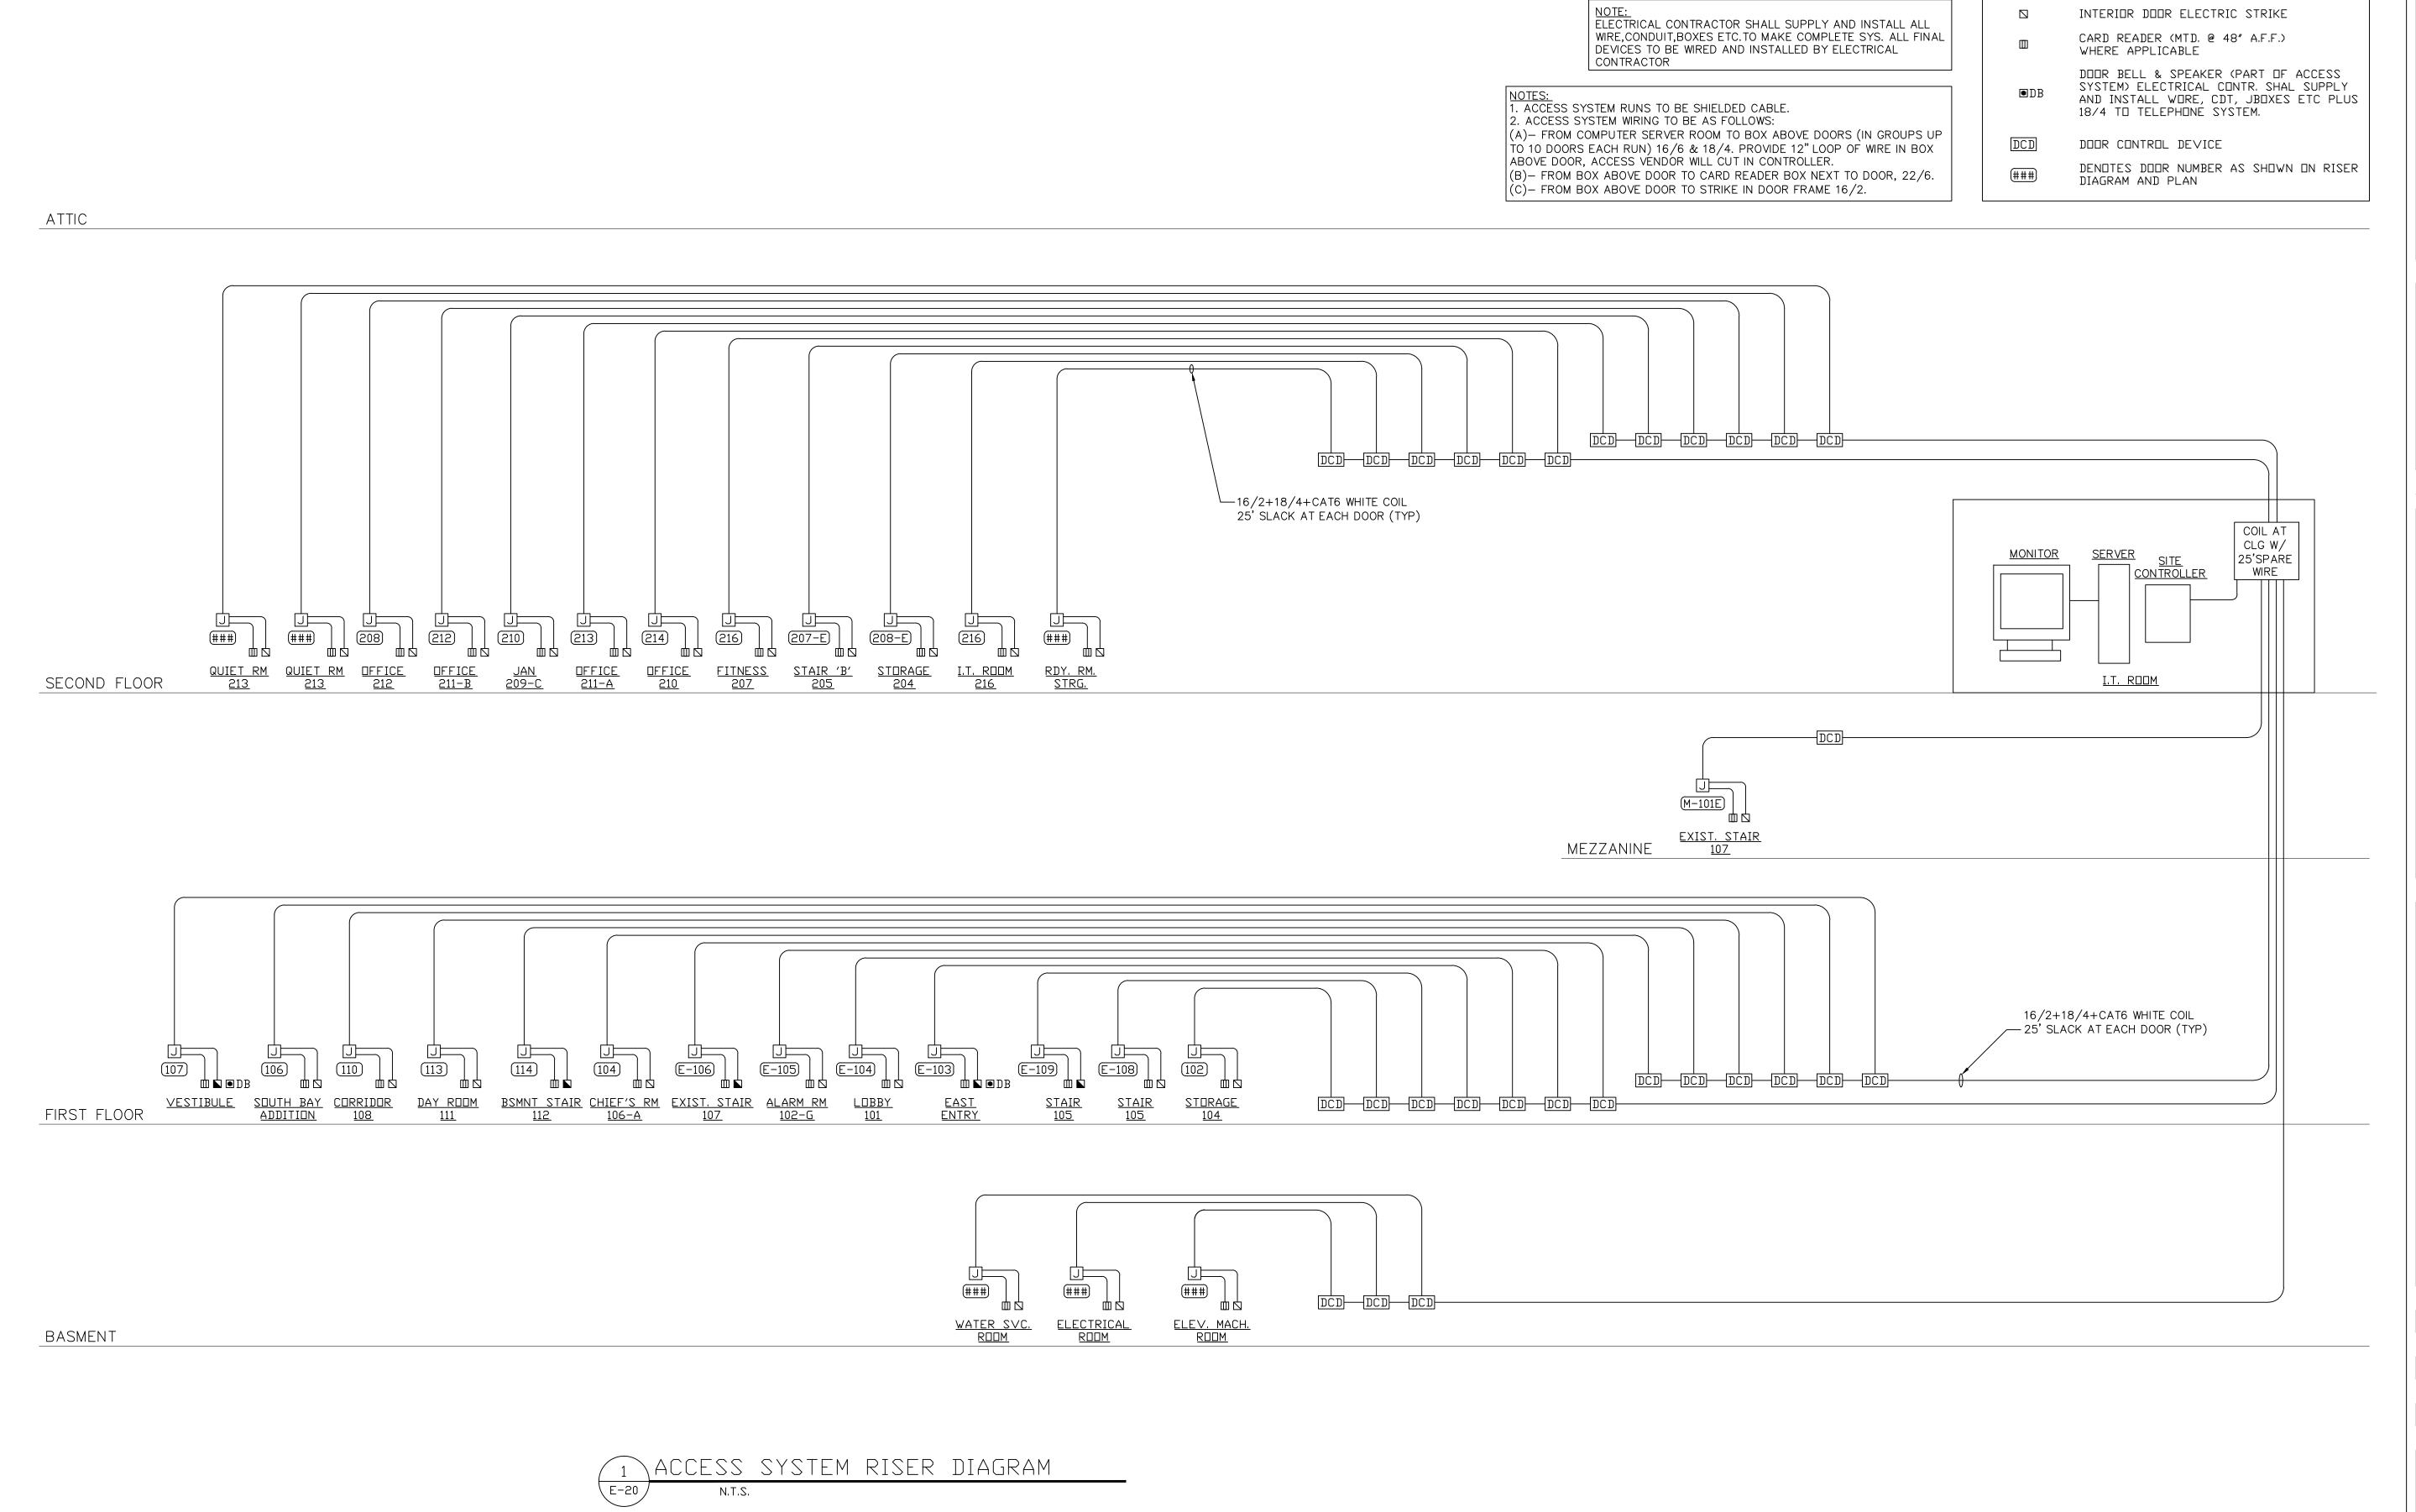
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屋-18





ACCESS LEGEND

EXTERIOR DOOR ELECTRIC STRIKE

INTERIOR DOOR ELECTRIC STRIKE

NOTE: ALL WIRING TO BE CERTIFIED BY

ELECTRICAL CONTRACTOR

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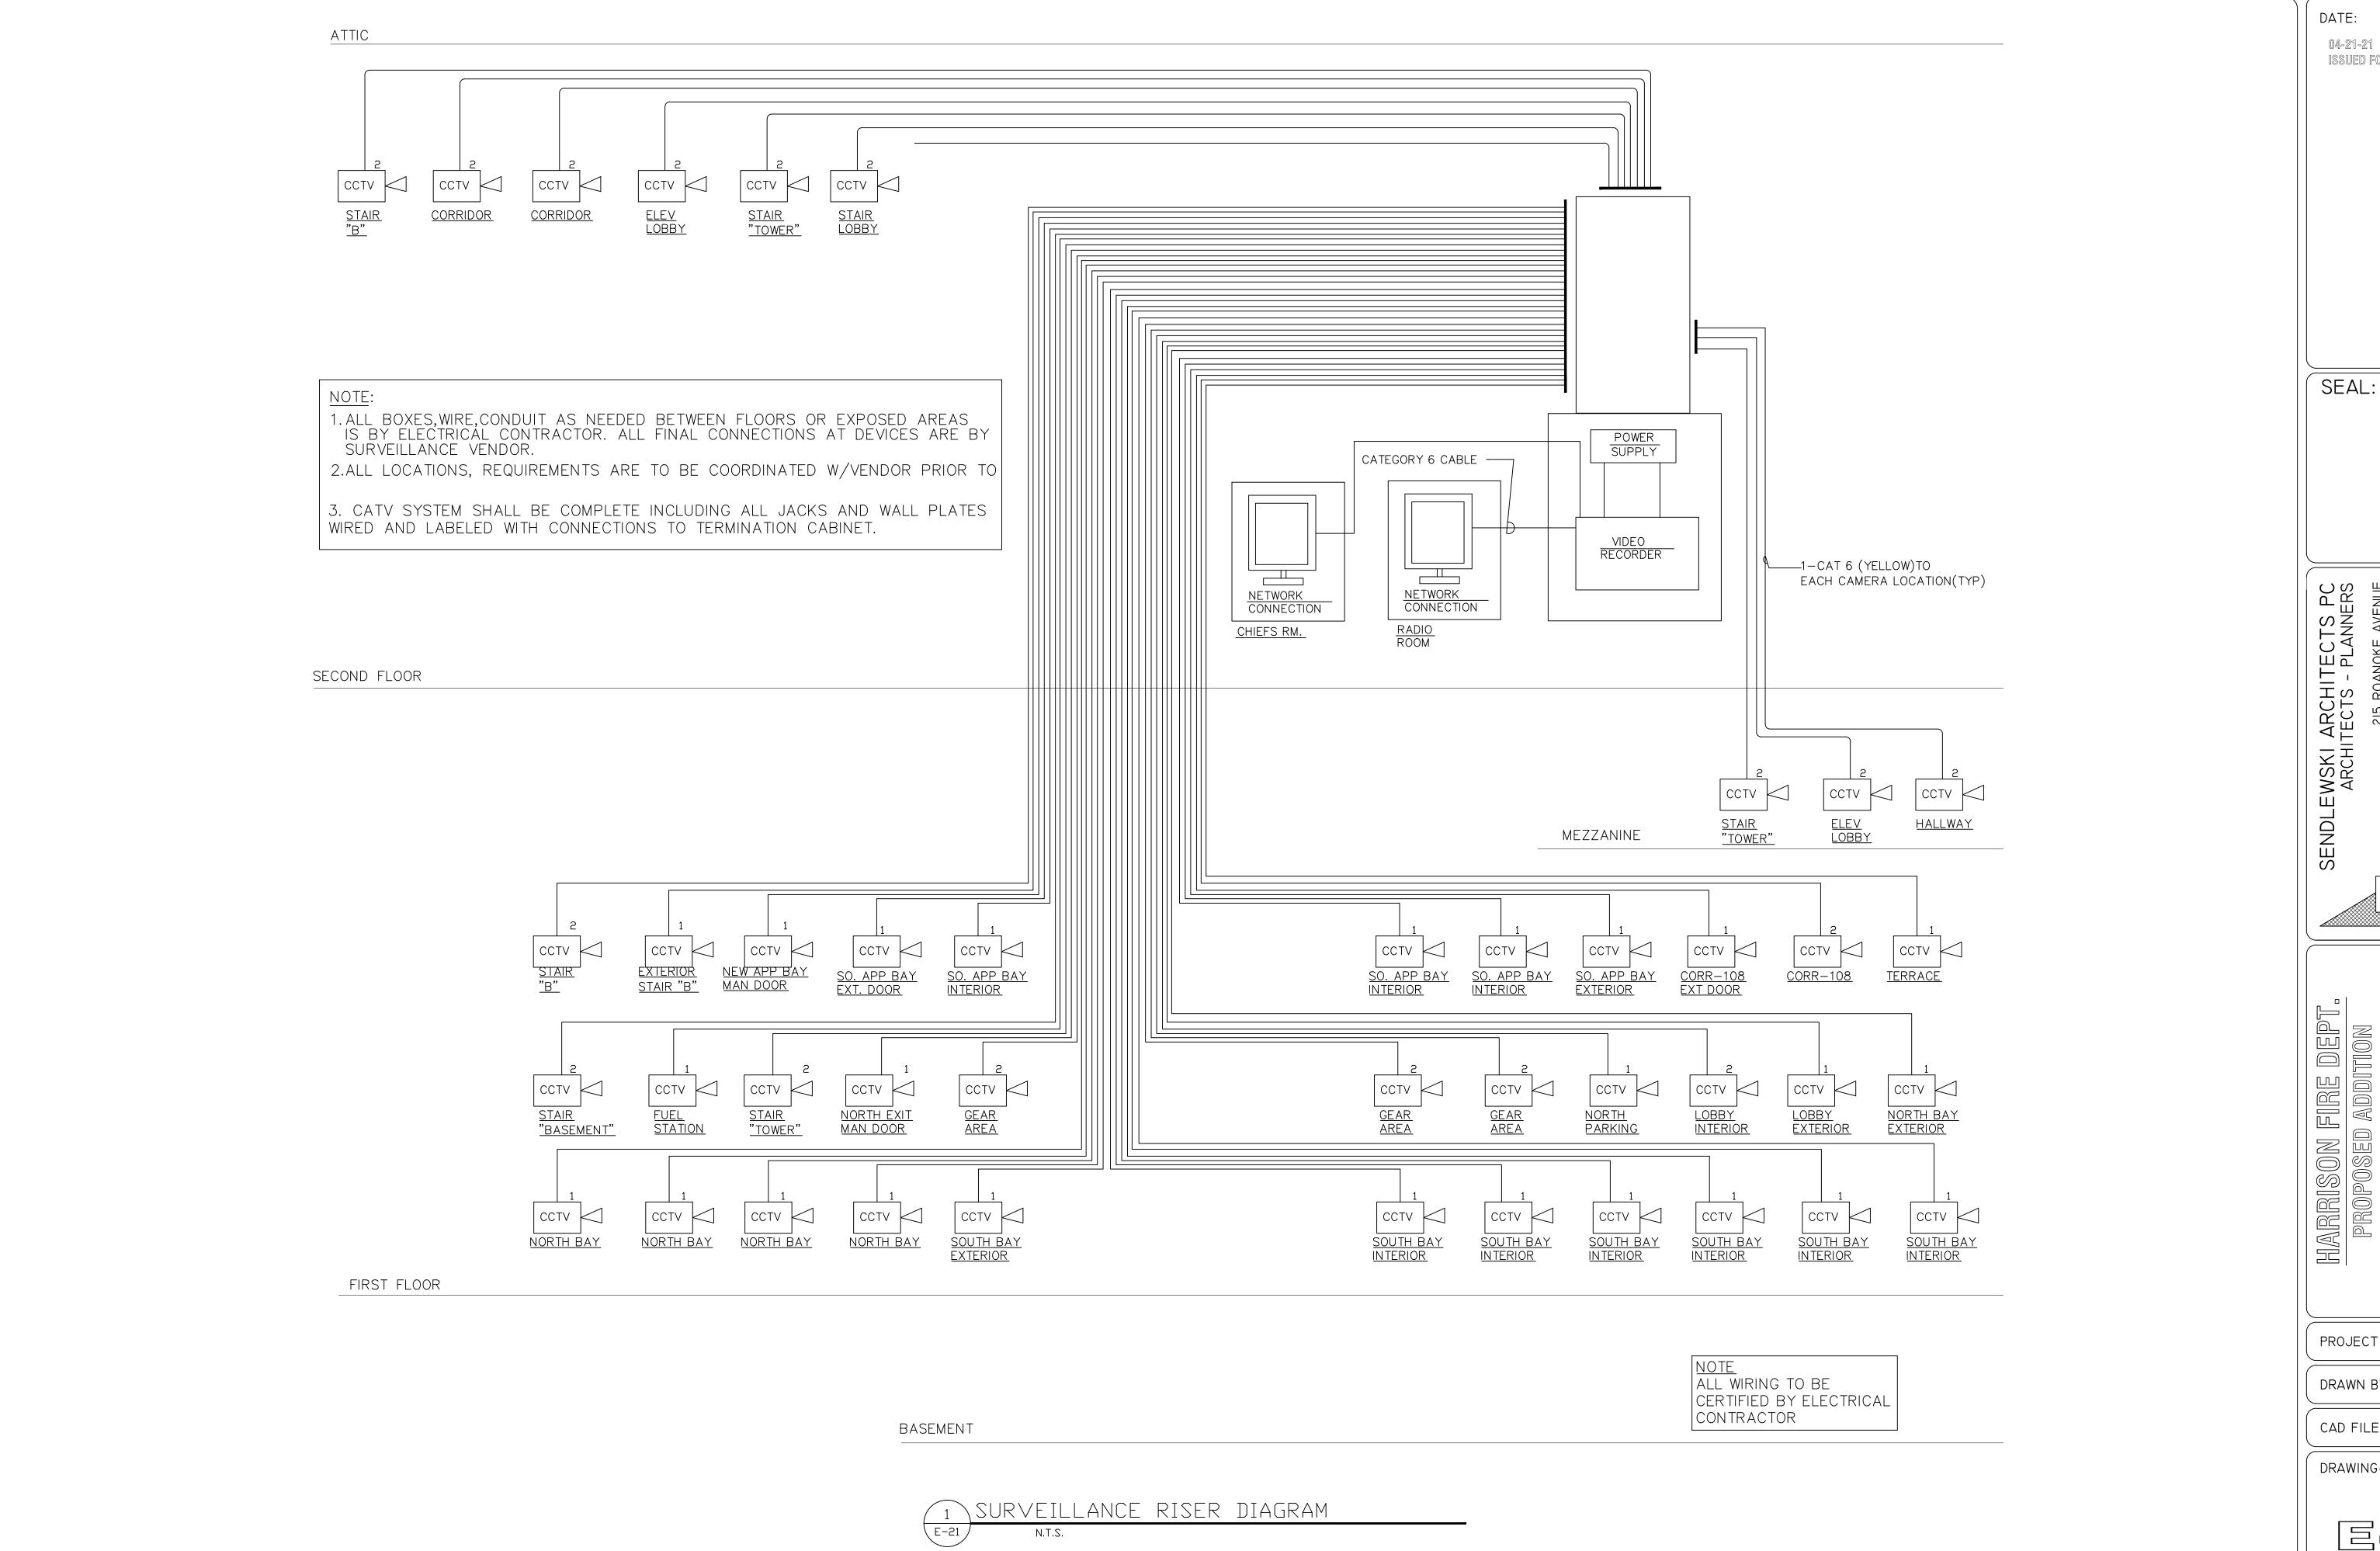
HARRISON FIRE DEPT PROPOSED ADDITION 206 HARRISON AVE HARRISON, NY 10528

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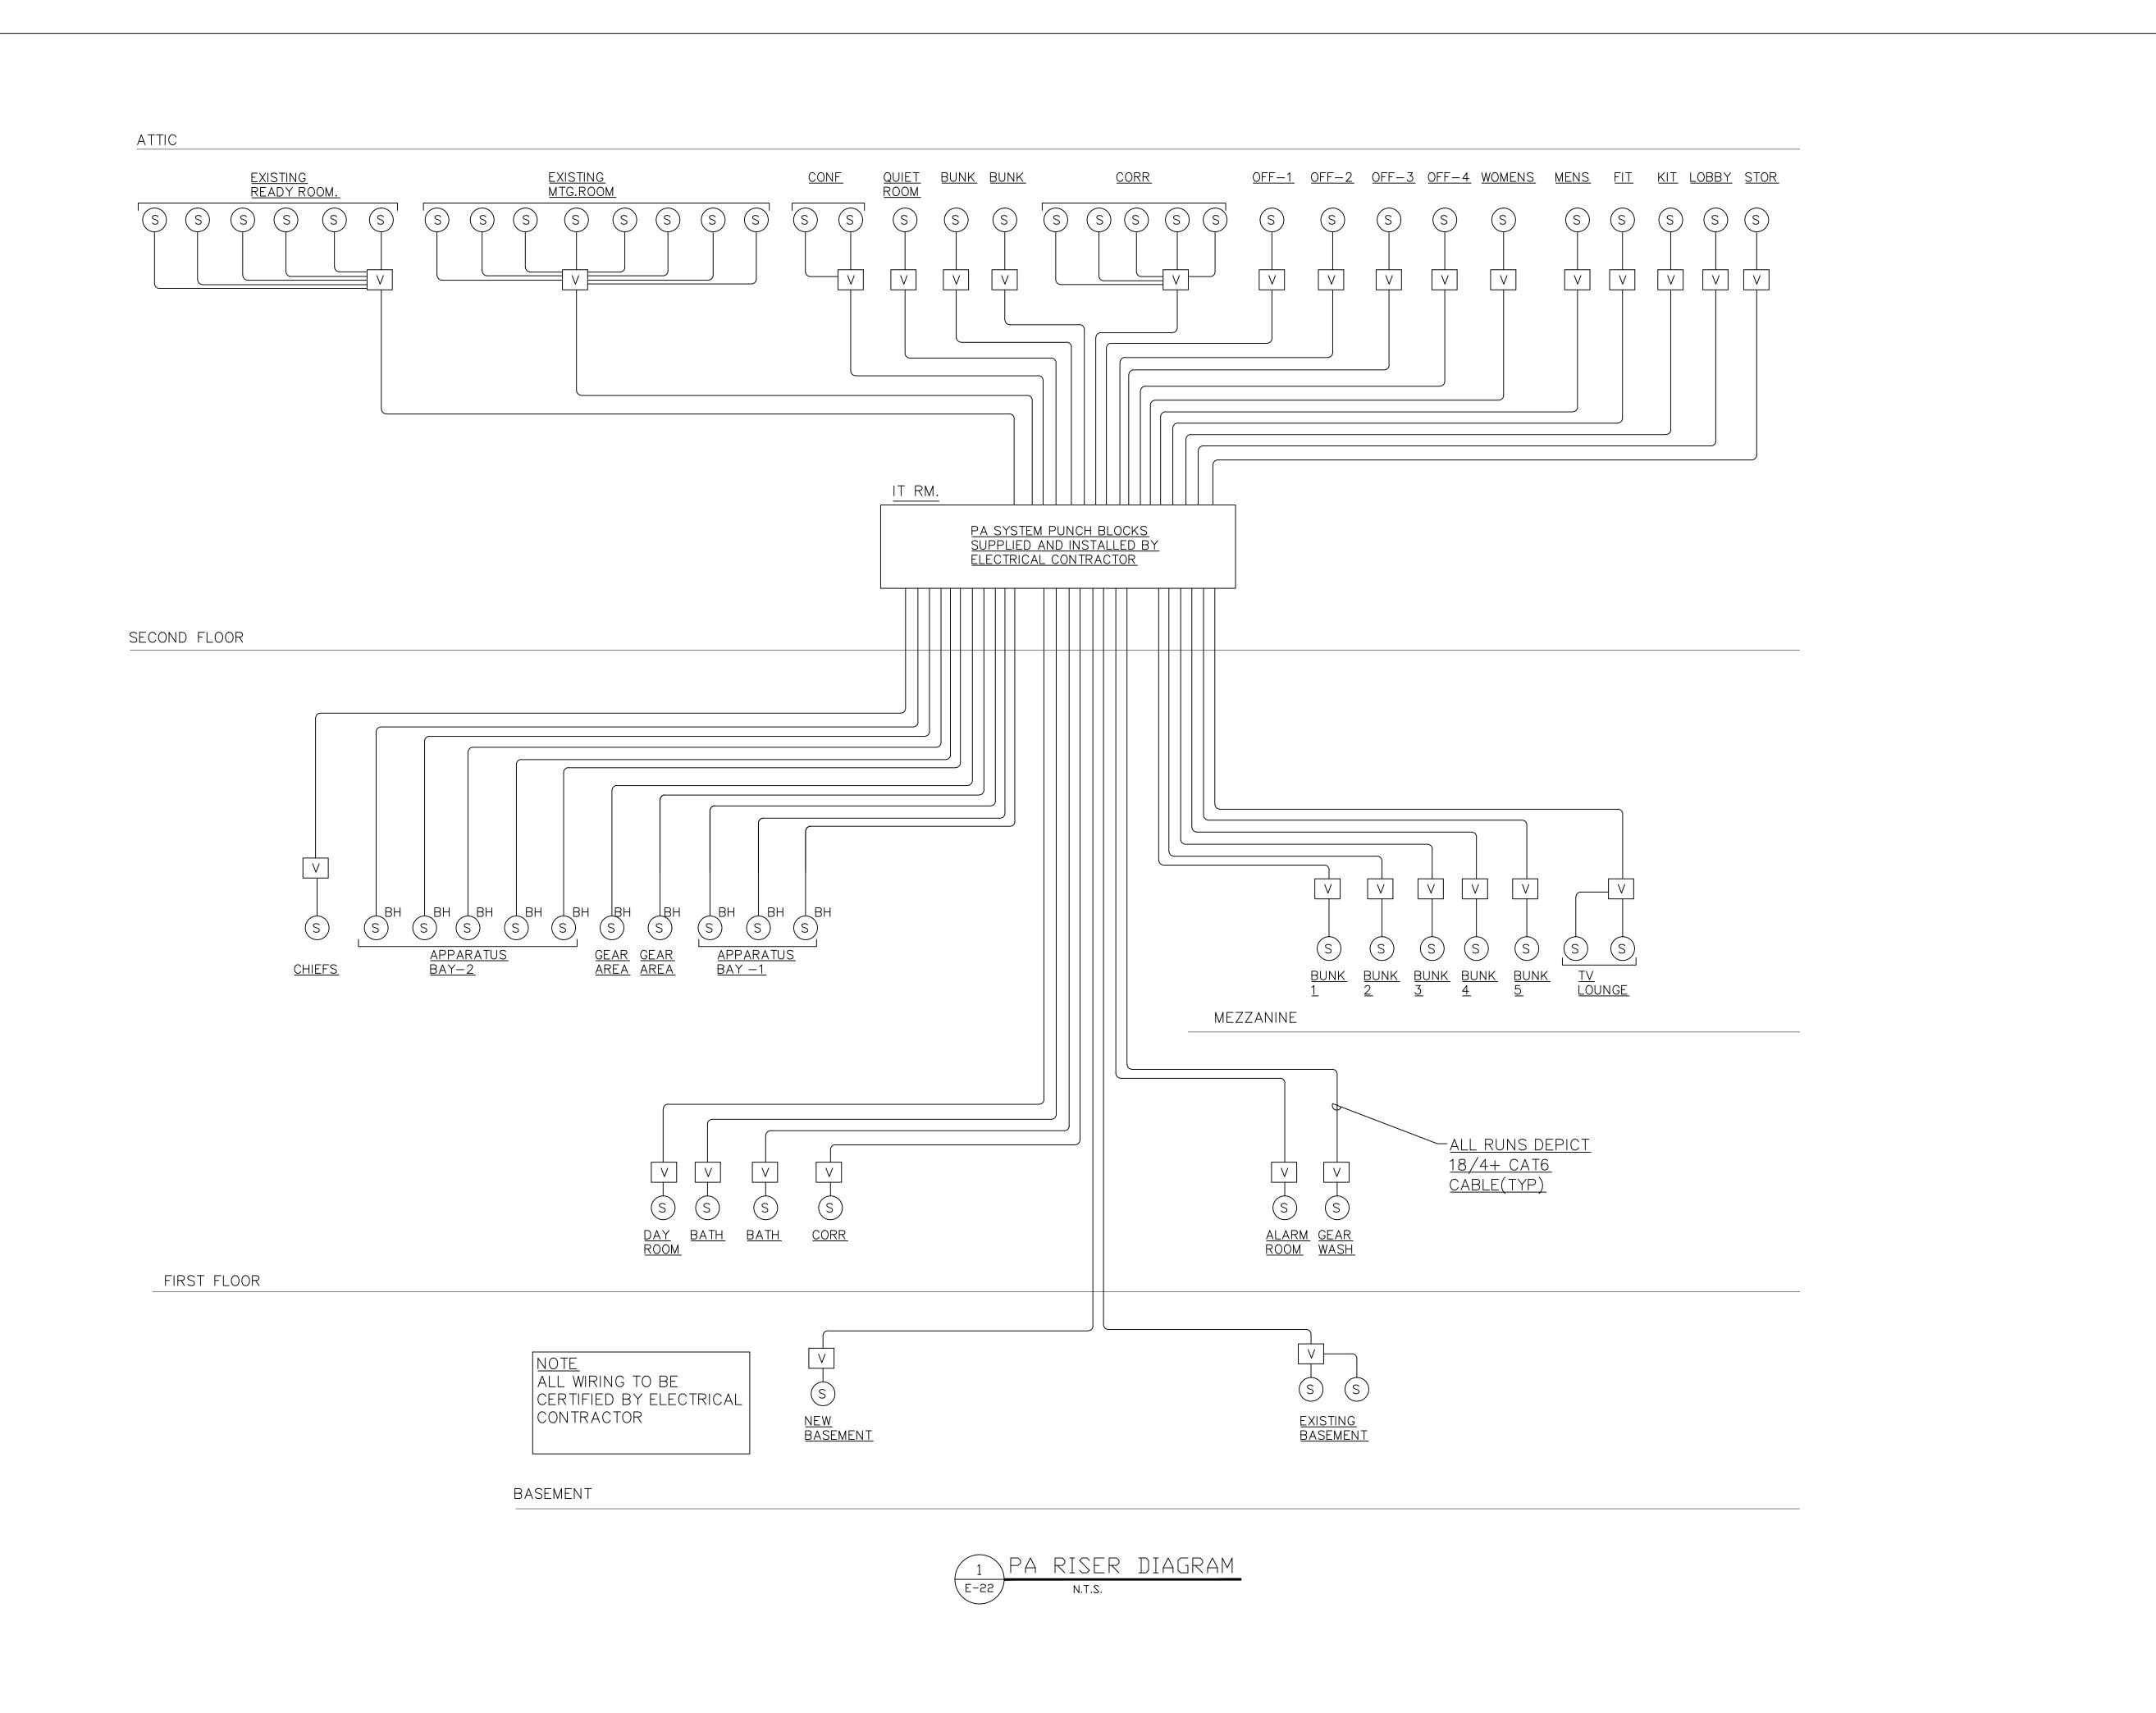
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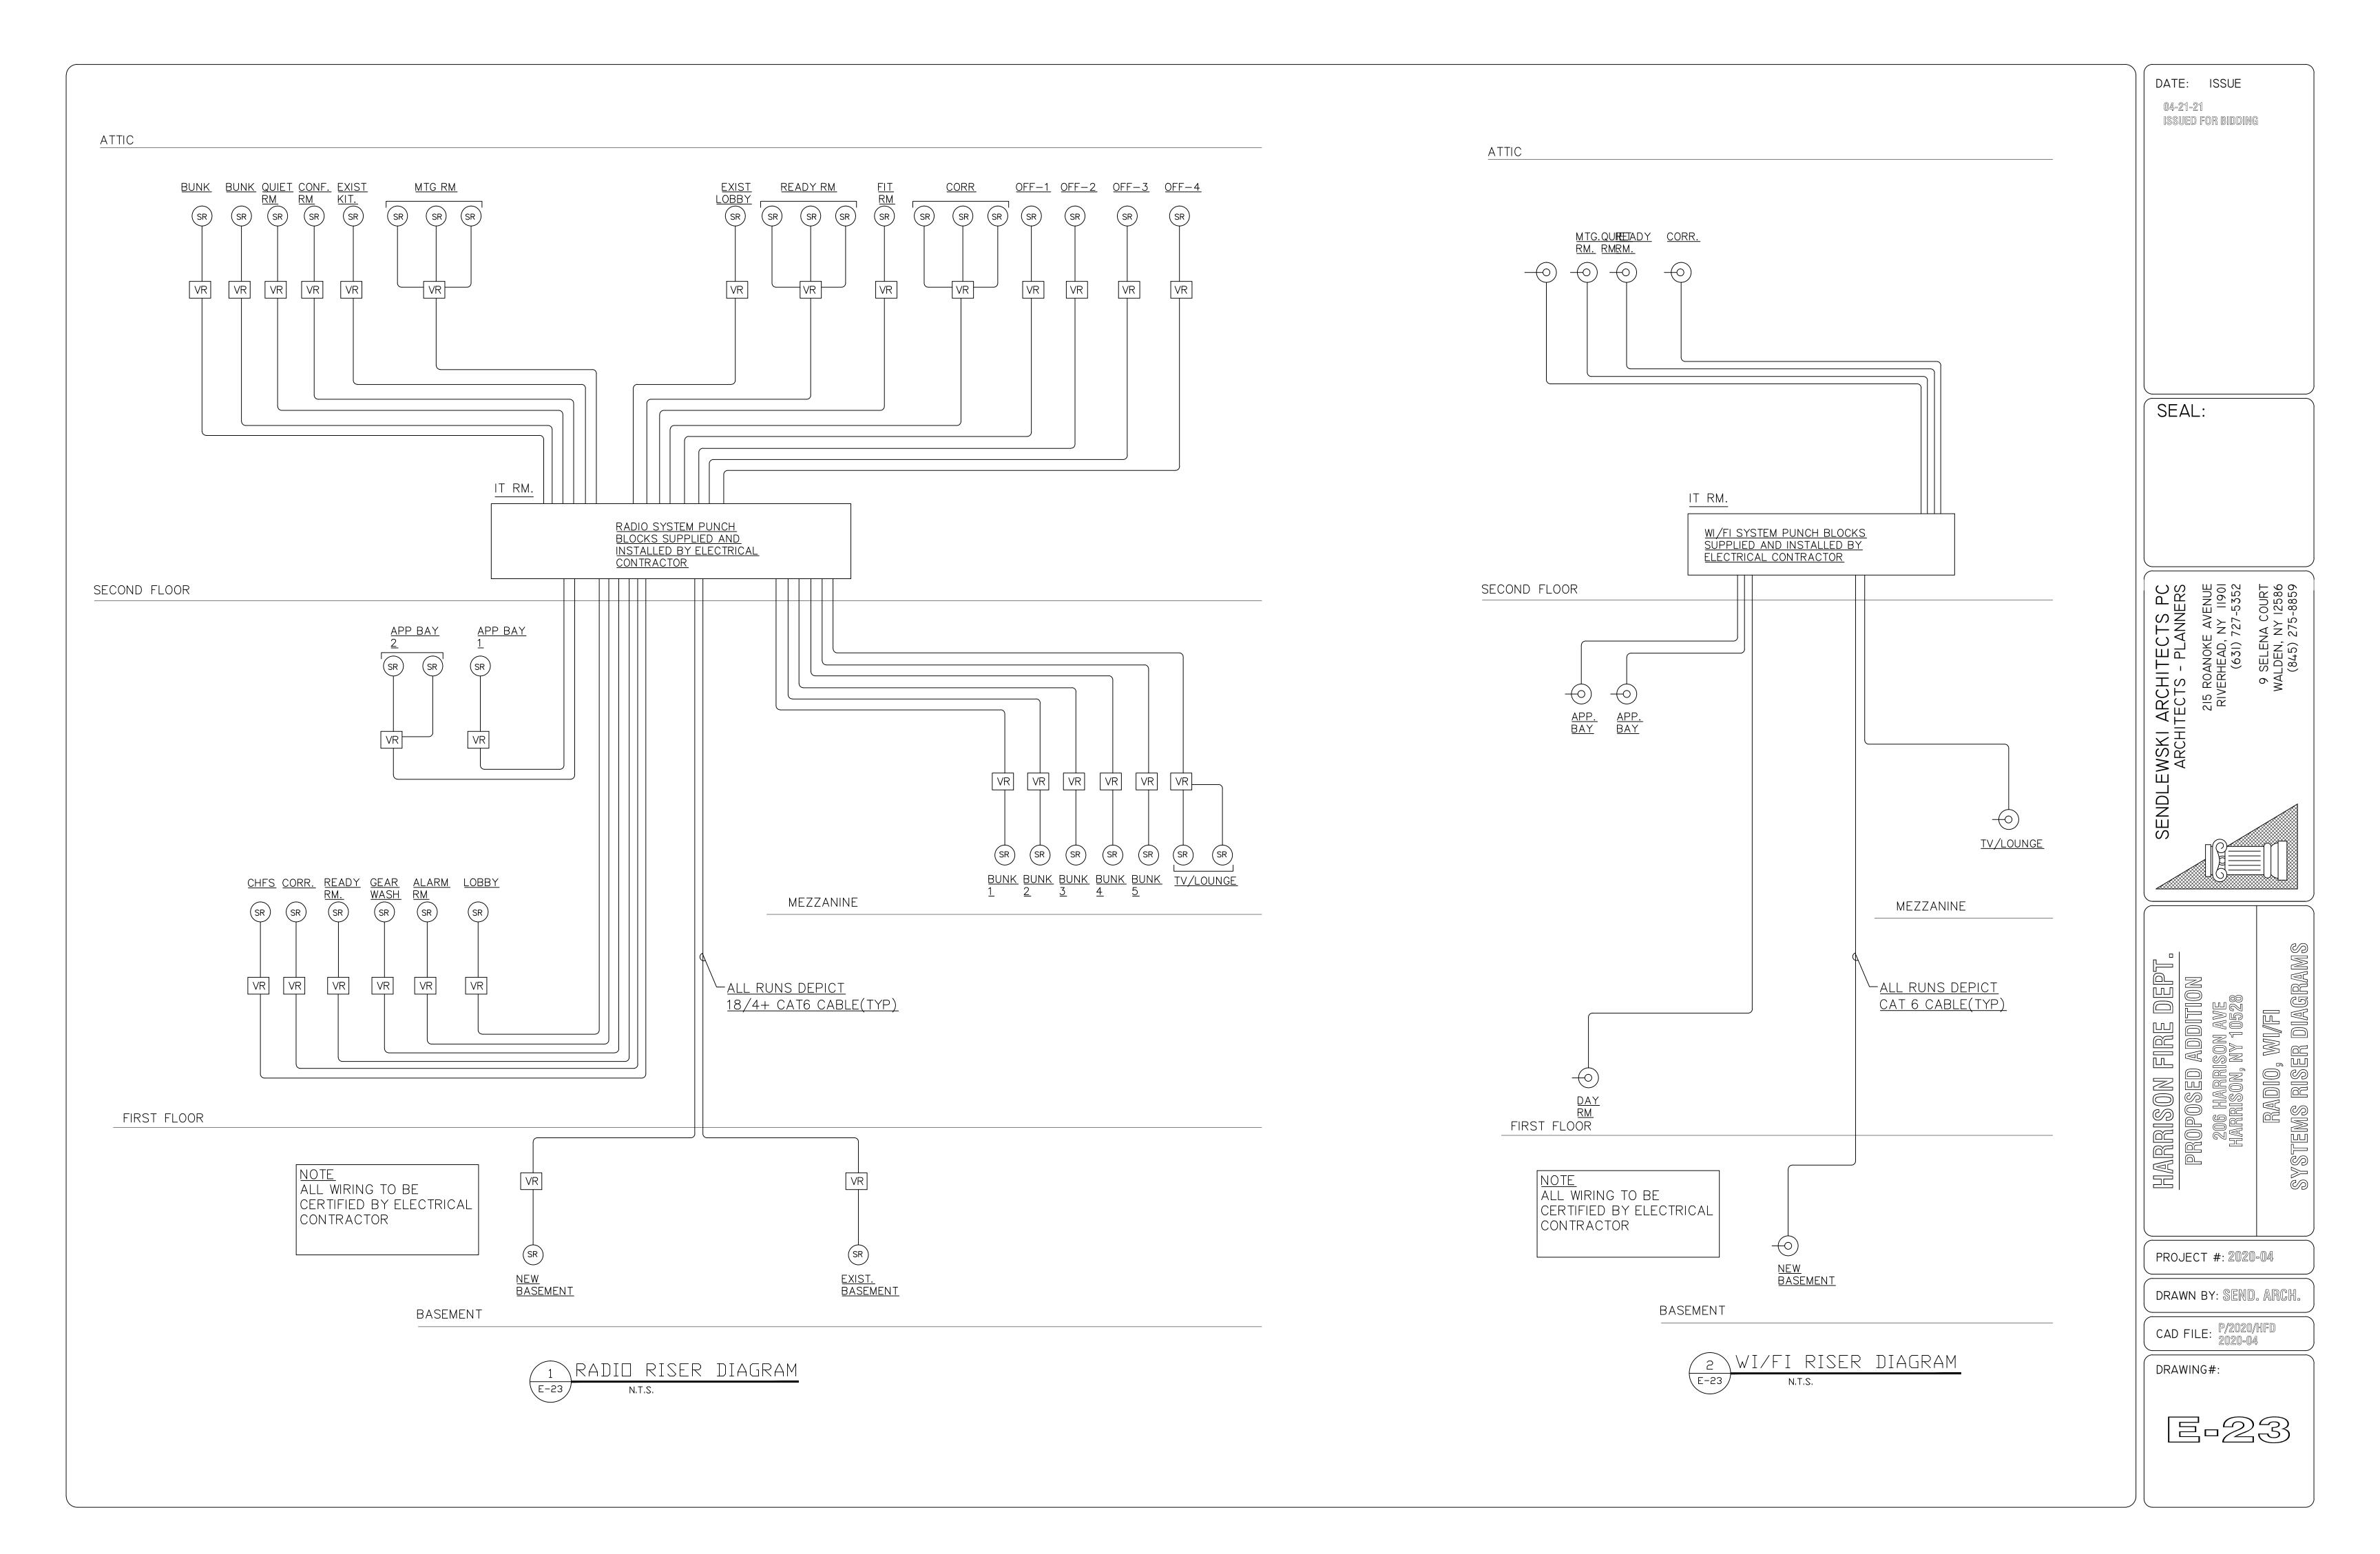
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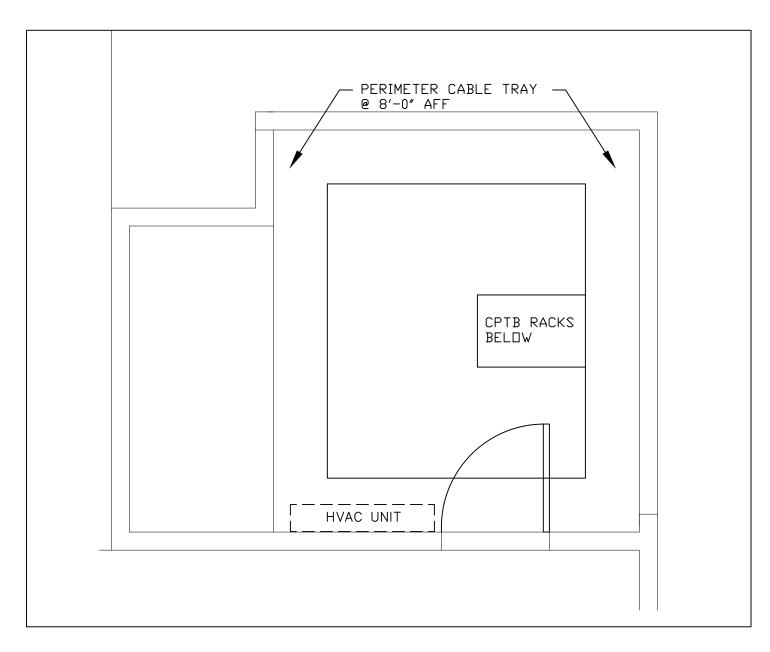
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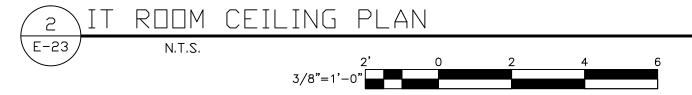
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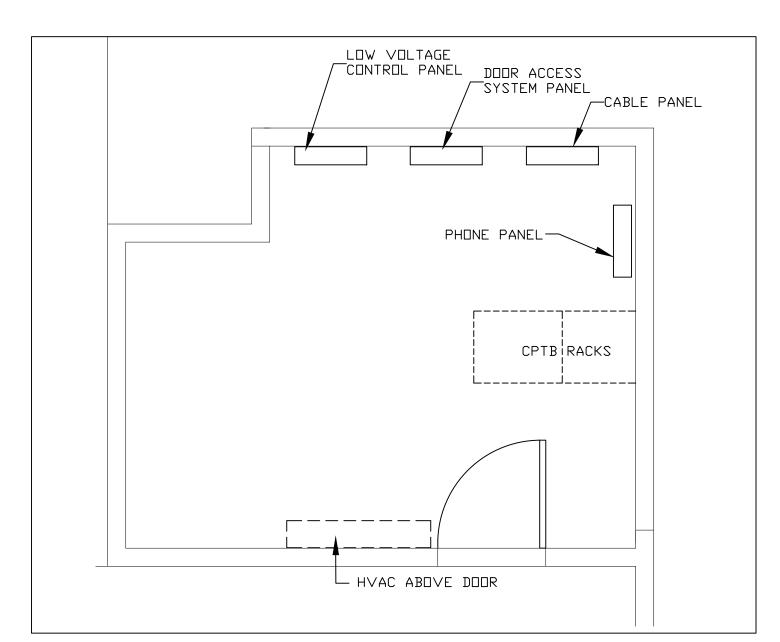
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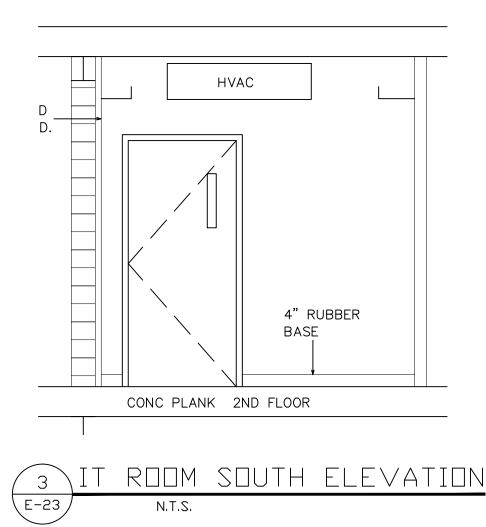


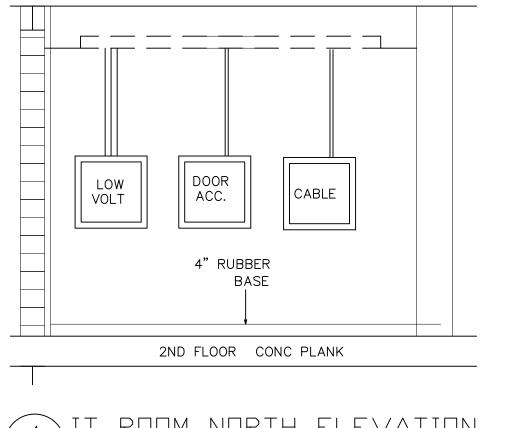




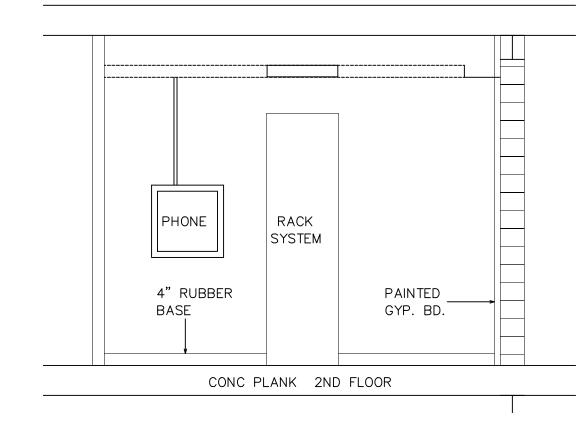




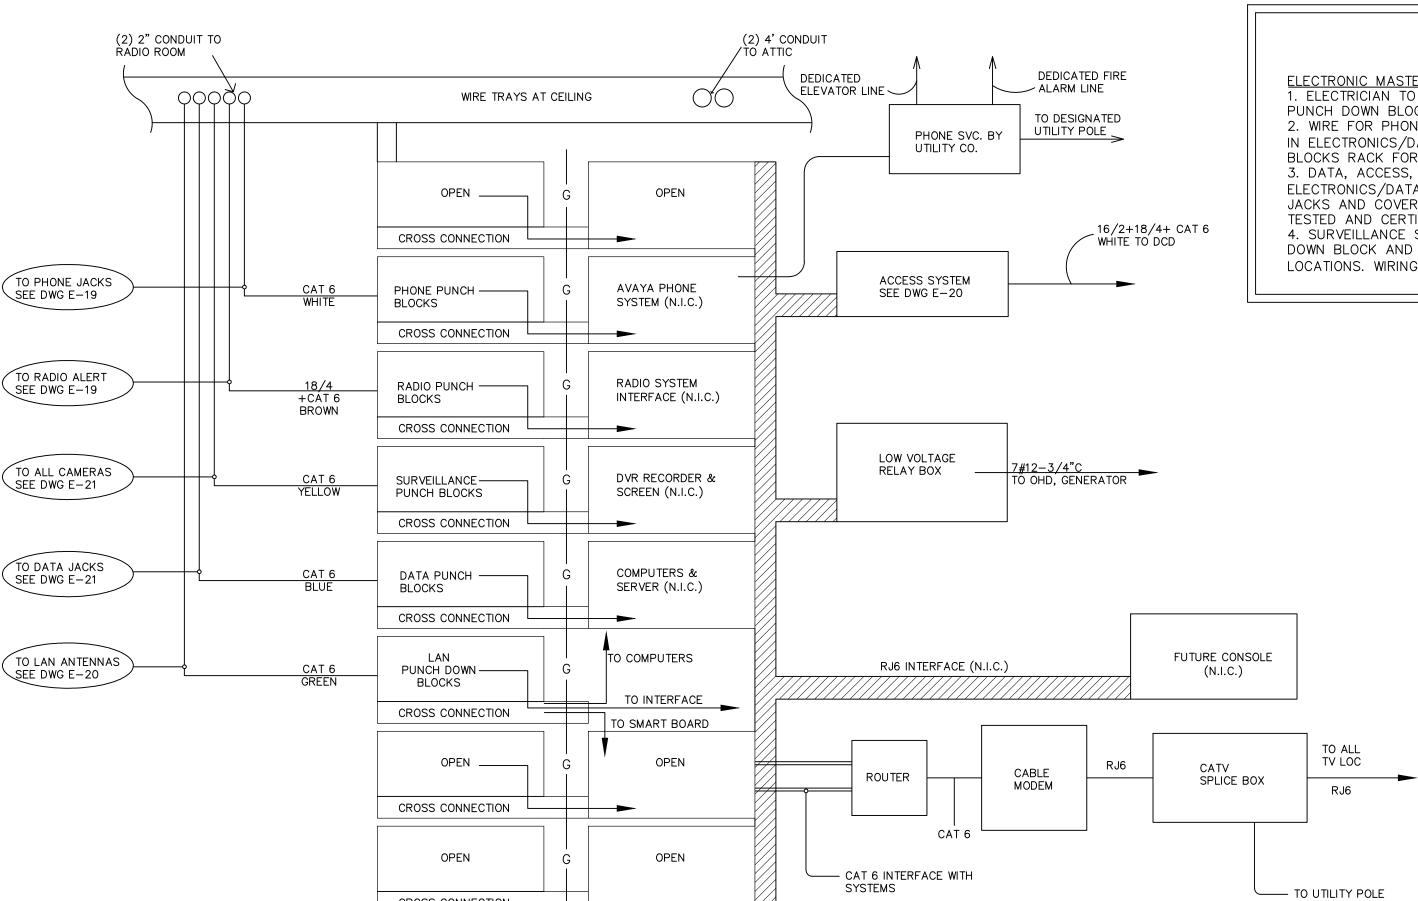








∖E-23 *∫* N.T.S.



GROUND BAR
ALL RACKS TO
BUILDING STEEL

ROOM RISER DIAGRAM 、E−23 */*

CROSS CONNECTION

ELECTRONIC MASTER DIAGRAM NOTES

1. ELECTRICIAN TO PROVIDE TWO RACKS INTERCONNECTED AS SHOWN WITH PUNCH DOWN BLOCKS. PUNCH DOWN, TEST AND CERTIFY ALL WIRING. 2. WIRE FOR PHONE, SURVEILLANCE, LAN AND DATA SHALL BE TERMINATED IN ELECTRONICS/DATA ROOM ON EC PROVIDED RACK SYSTEM WITH PUNCH BLOCKS RACK FOR EACH SYSTEM.

3. DATA, ACCESS, PHONE & SURVEILLANCE SYSTEMS SHALL BE RUN TO THE ELECTRONICS/DATA ROOM. PHONE AND DATA SYSTEMS SHALL INCLUDE WALL JACKS AND COVERS AND SHALL BE CONNECTED TO A PUNCH DOWN BLOCK TESTED AND CERTIFIED.

4. SURVEILLANCE SHALL BE TERMINATED IN ELECTRONICS ROOM TO A PUNCH DOWN BLOCK AND COILED WITH 36"SLACK AT DESIGNATED CAMERA LOCATIONS. WIRING TO BE AS FOLLOWS (ALL TO BE TAGGED/LABELED)

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