

ELEVATION  
SCALE: 3/4" = 1'-0"

SENDELWSKI ARCHITECTS, P.C.  
ARCHITECTS - PLANNER  
(631) 727-5352



215 ROANOKE AVENUE  
RIVERHEAD, NEW YORK 11901

TYPICAL DOOR VISION  
PANEL ELEVATION


HARRISON FD

PROJECT#: 20-04

DRAWING#:

SK-1

DATE#: 04-23-21

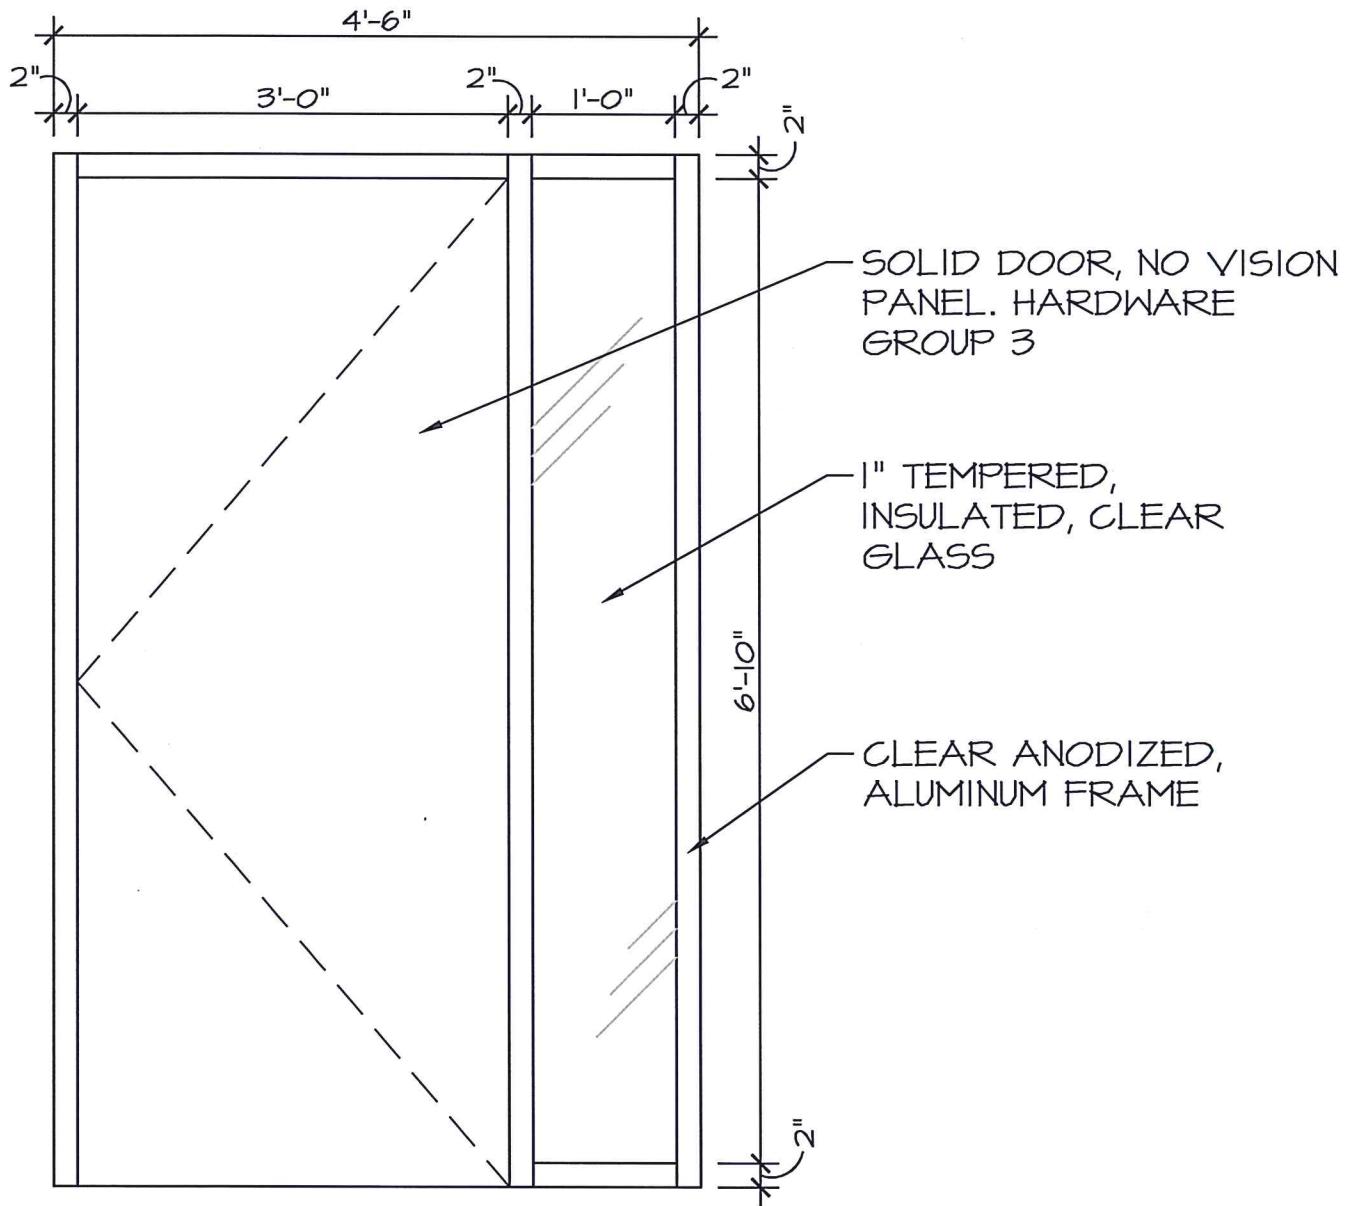

## ELEVATION

SCALE: 3/4" = 1'-0"




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215 ROANOKE AVENUE  
RIVERHEAD, NEW YORK 11901

DOOR 105 ELEVATION  
SKETCH

HARRISON FD

PROJECT#:	20-04
DRAWING#:	SK-2
DATE#:	04-23-21

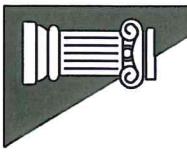

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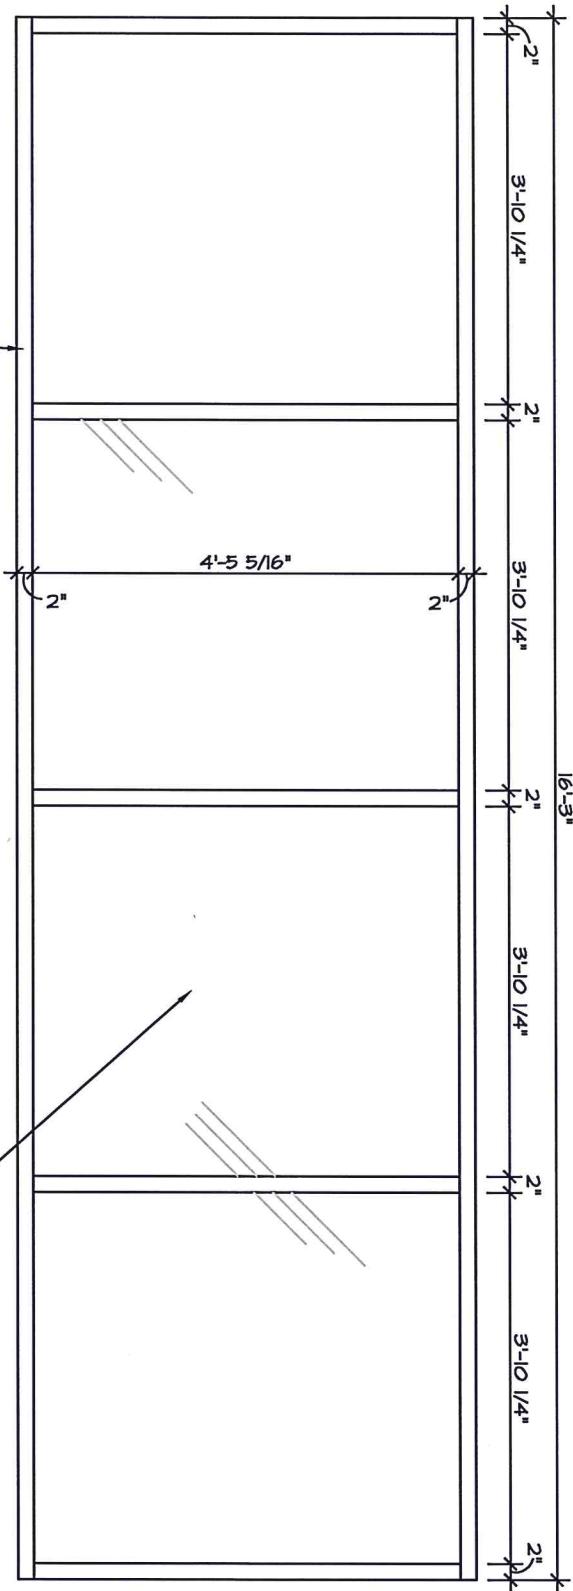
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215 ROANOKE AVENUE  
RIVERHEAD, NEW YORK 11901

ELEVATION  
SCALE: 1/2" = 1'-0"

CLEAR ANODIZED,  
ALUMINUM FRAME


1" TEMPERED,  
INSULATED, CLEAR  
GLASS



ROOM 202-B WINDOW DETAIL

PROJECT#: 20-04  
DRAWING#: SK-3

DATE#: 04-23-2021

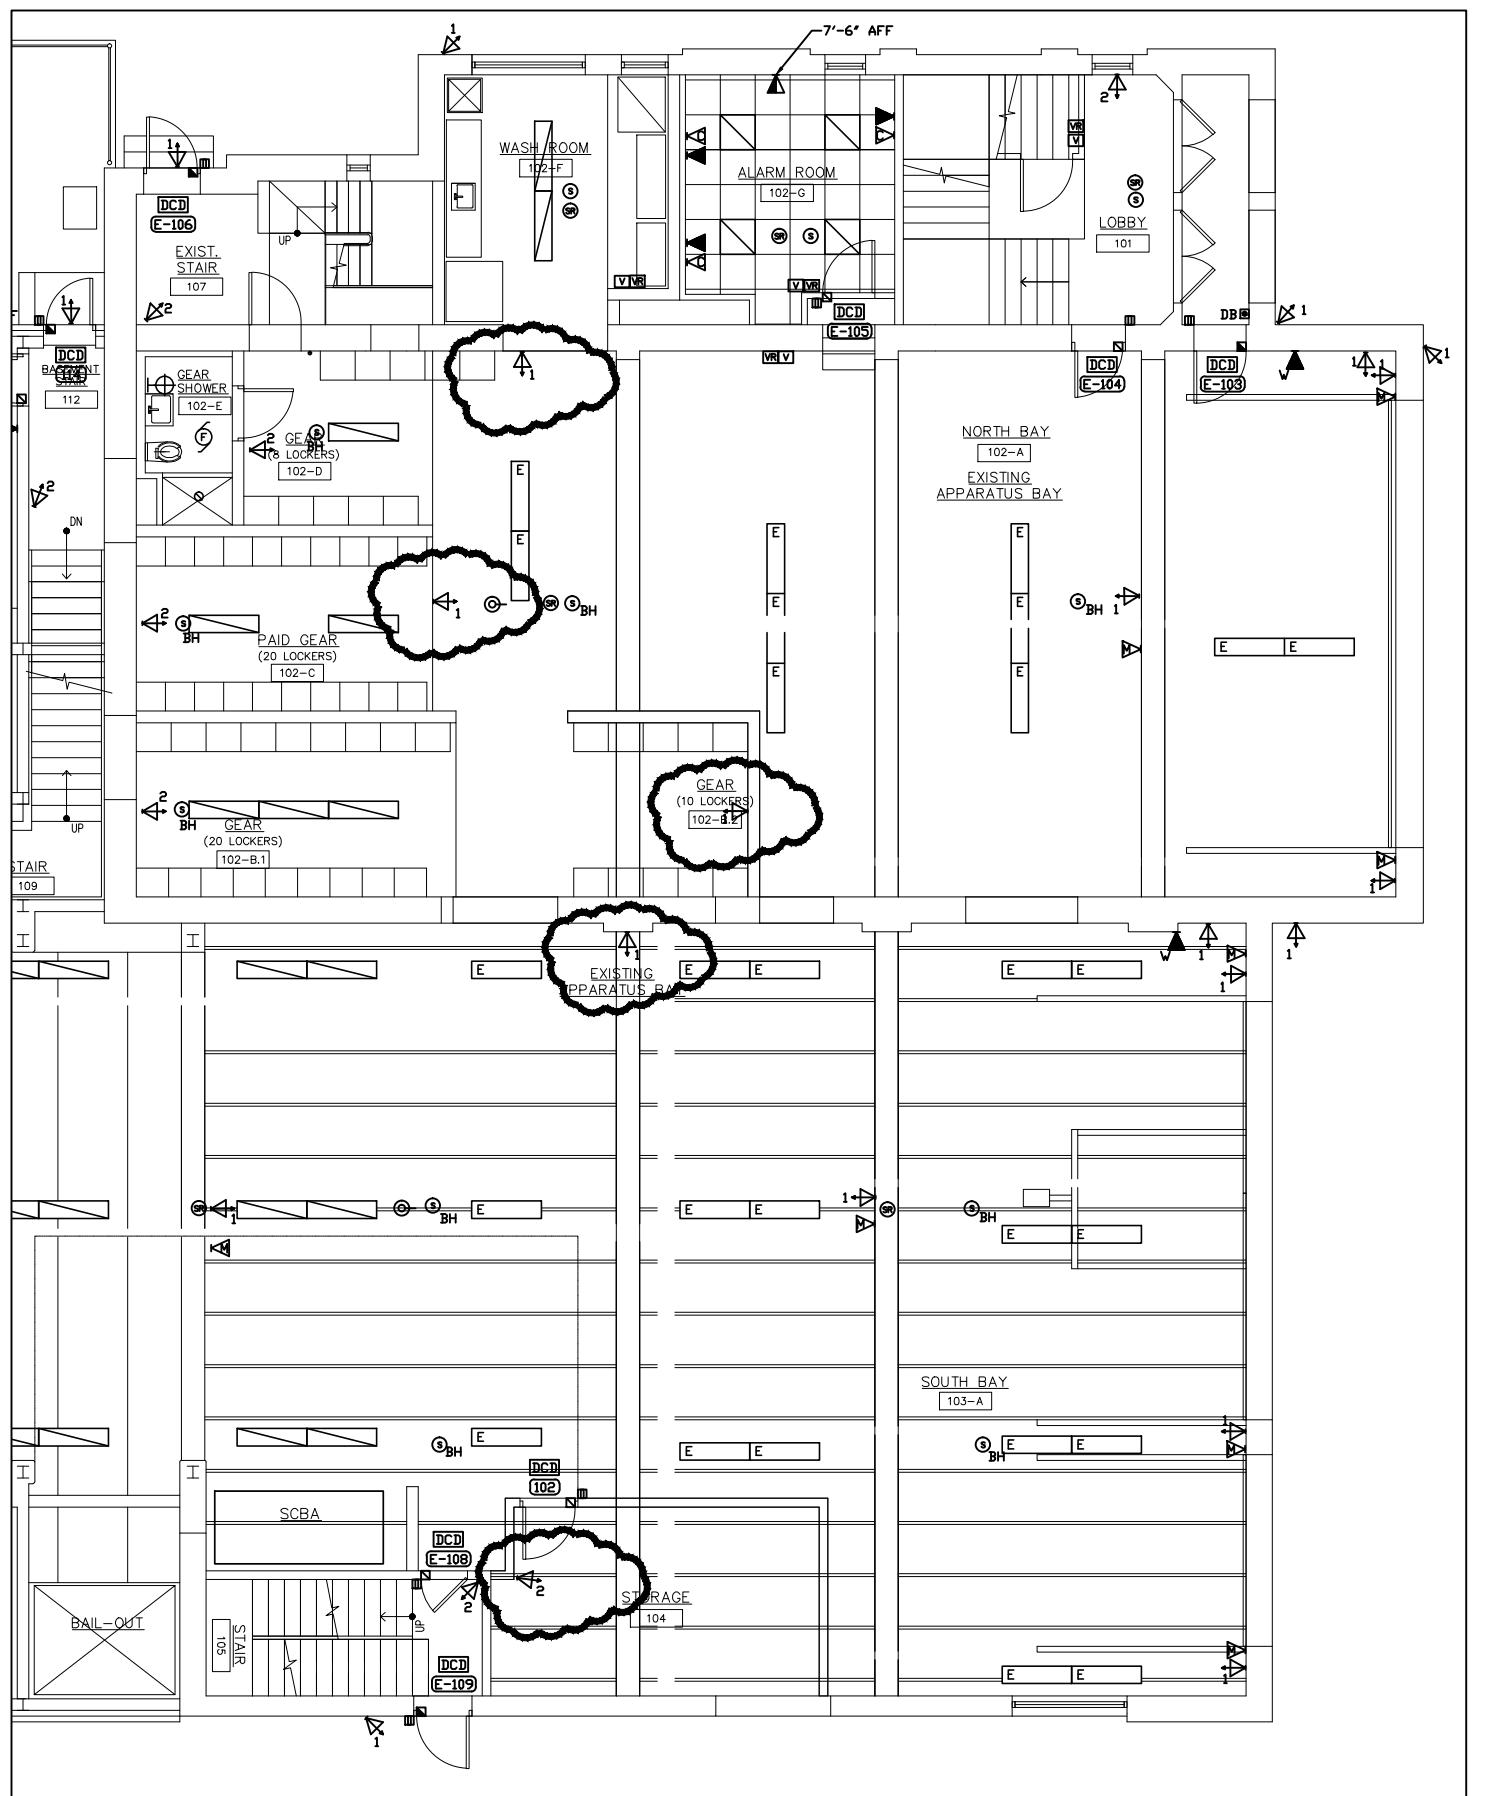

1 APP. BAY ADDITIONAL CAMERAS  
ESK-1 N.T.S.

1/8"=1'-0"



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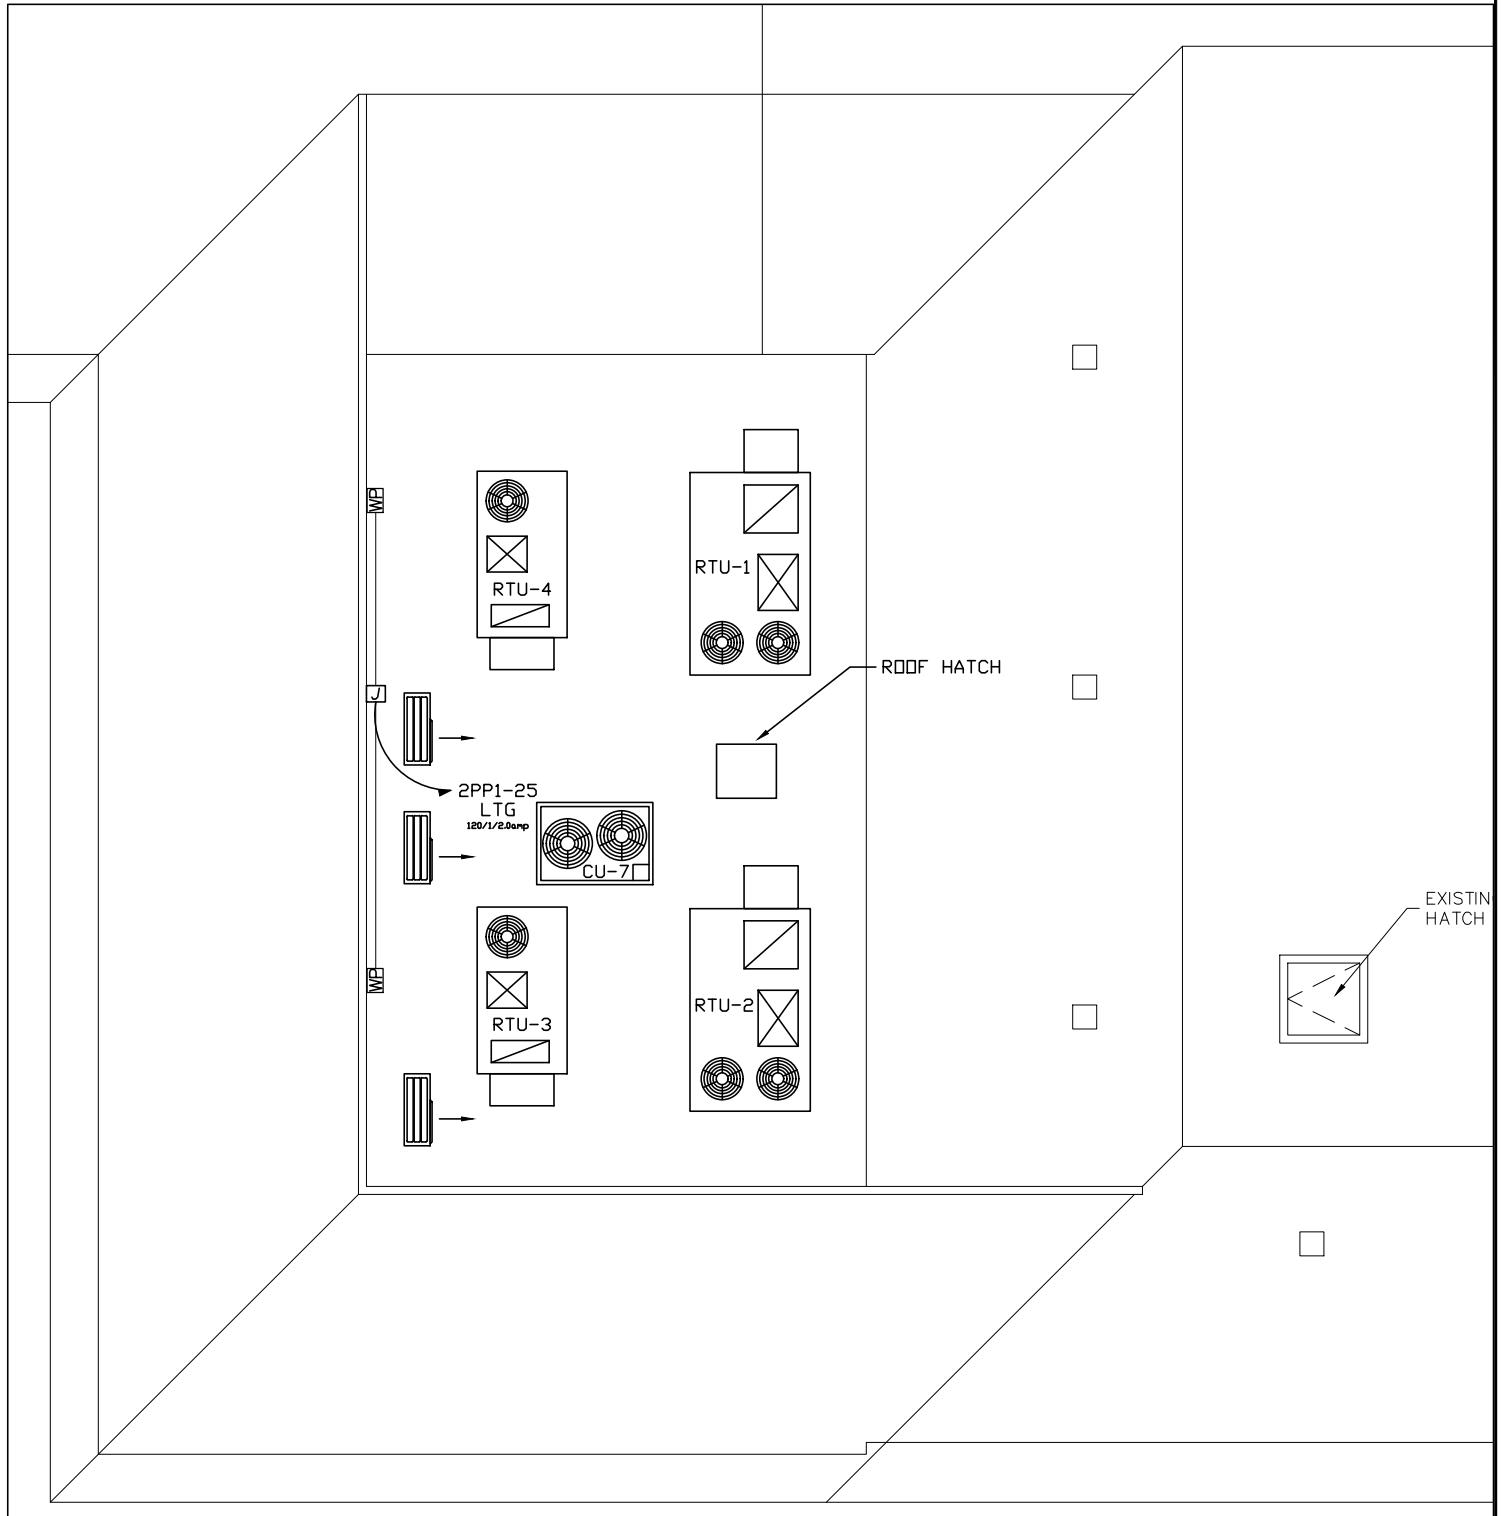
9 SELENA COURT  
WALDEN, NY 12586  
(845) 275-8859

HARRISON FIRE DEPT.  
206 HARRISON AVE  
HARRISON, NY 10528

ESK-1

LED LANTERN TYPE FIXTURE WALL VISIONAIRE  
LTG #SRL-1-T3-16LC-3-4K-UNV-WM-BZ-PC-120  
18 WATTS

2 EXTERIOR LIGHTING SCHEDULE  
ESK-2 N.T.S.



1 ROOF LIGHTING PLAN  
ESK-2

1/8" = 1'-0"

8' 0 8 16  
1/8" = 1'-0"

SENDELEWSKI ARCHITECTS PC  
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ESK-2

**SCHEDULE FOR: PANEL BPP2**

Voltage:	208 / 120 V		MLO	X	Equip. Ground Bus	Poles:	42	Min CB IC:	22,000 AIC						
Main Bus:	225 A		MCB	200 A	Isol. Ground Bus	Mtg:	SURFACE	Comments:							
Ckt #	Serves	Load VA	Breaker P	Minimum Branch Trip Circuit	Phase A	Phase B	Phase C	Minimum Branch Circuit	Breaker Trip P	Load VA	Serves	Ckt #			
1				2#12,#12G 3/4"C.	0							2			
3				2#12,#12G 3/4"C.		961						4			
5	EXIST KIT. PNL (KP-1)	4441	3	100			5402					6			
7		4441			5402							8			
9		4441			4621							10			
11	PANEL (BPP2A)	6213	3	100		8133						12			
13		6213			6463							14			
15		6213			6213							16			
17					0							18			
19					0							20			
21					0							22			
23					0							24			
25					0							26			
27					0							28			
29					0							30			
31					0							32			
33					0							34			
35					0							36			
37					0							38			
39					0							40			
41					0							42			
Total Connected Load (VA)				37195	11865	11795	13535	VA per phase		103	Total Connected Load (Amps)	98.9	98.3	112.8	Amps per phase

**SCHEDULE FOR: PANEL EXIST LP-2A**

Voltage:	208 / 120 V		CB X	Equip. Ground Bus	Poles:	42	Min CB IC:	22,000 AIC							
Main Bus:	100A		MCB	100A	Isol. Ground Bus	Mtg:	SURFACE	Comments:							
Ckt #	Serves	Load VA	Breaker P	Minimum Branch Trip Circuit	Phase A	Phase B	Phase C	Minimum Branch Circuit	Breaker Trip P	Load VA	Serves	Ckt #			
1	EXIST REC	1080	1	20	2#12,#12G 3/4"C.	1355		2#12,#12G 3/4"C.	20	1	275	LIGHTING	2		
3	EXIST REC	1080	1	20		1580			20	1	500	GAS BOILER	4		
5	EXIST REC	1080	1	20			1355		20	1	275	LIGHTING	6		
7	EXIST REC	1080	1	20		1355			20	1	275	LIGHTING	8		
9	EXIST FREEZER	500	1	20		1580			20	1	1080	EXIST REC	10		
11	EXIST BAR LIGHTING	168	1	20			668		20	1	500	BOILER CONTROLS	12		
13		1	20		0				15	1		SPARE	14		
15		1	20			240			15	1	240	BOILER PUMP P-5	16		
17		1	20				240		15	1	240	BOILER PUMP P-6	18		
19					240				15	1	240	BOILER PUMP P-7	20		
21						583			15	1	583	BOILER PUMP P-8	22		
23						583			583				24		
25		1	20		0								26		
27		1	20			0			20	1			28		
29		1	20				0		20	1			30		
31		1	20		0				20	1			32		
33		1	20			0			20	1			34		
35		1	20				0		20	1			36		
37		1	20		0				20	1			38		
39		1	20			0			20	1			40		
41		1	20			0							42		
Total Connected Load (VA)				9779	2950	3983	2846	VA per phase		27	Total Connected Load (Amps)	24.6	33.2	23.7	Amps per phase

1 BOILER PUMP POWER  
ESK-3 3/16" = 1'-0"

5' 0 5 10  
3/16"=1'-0"



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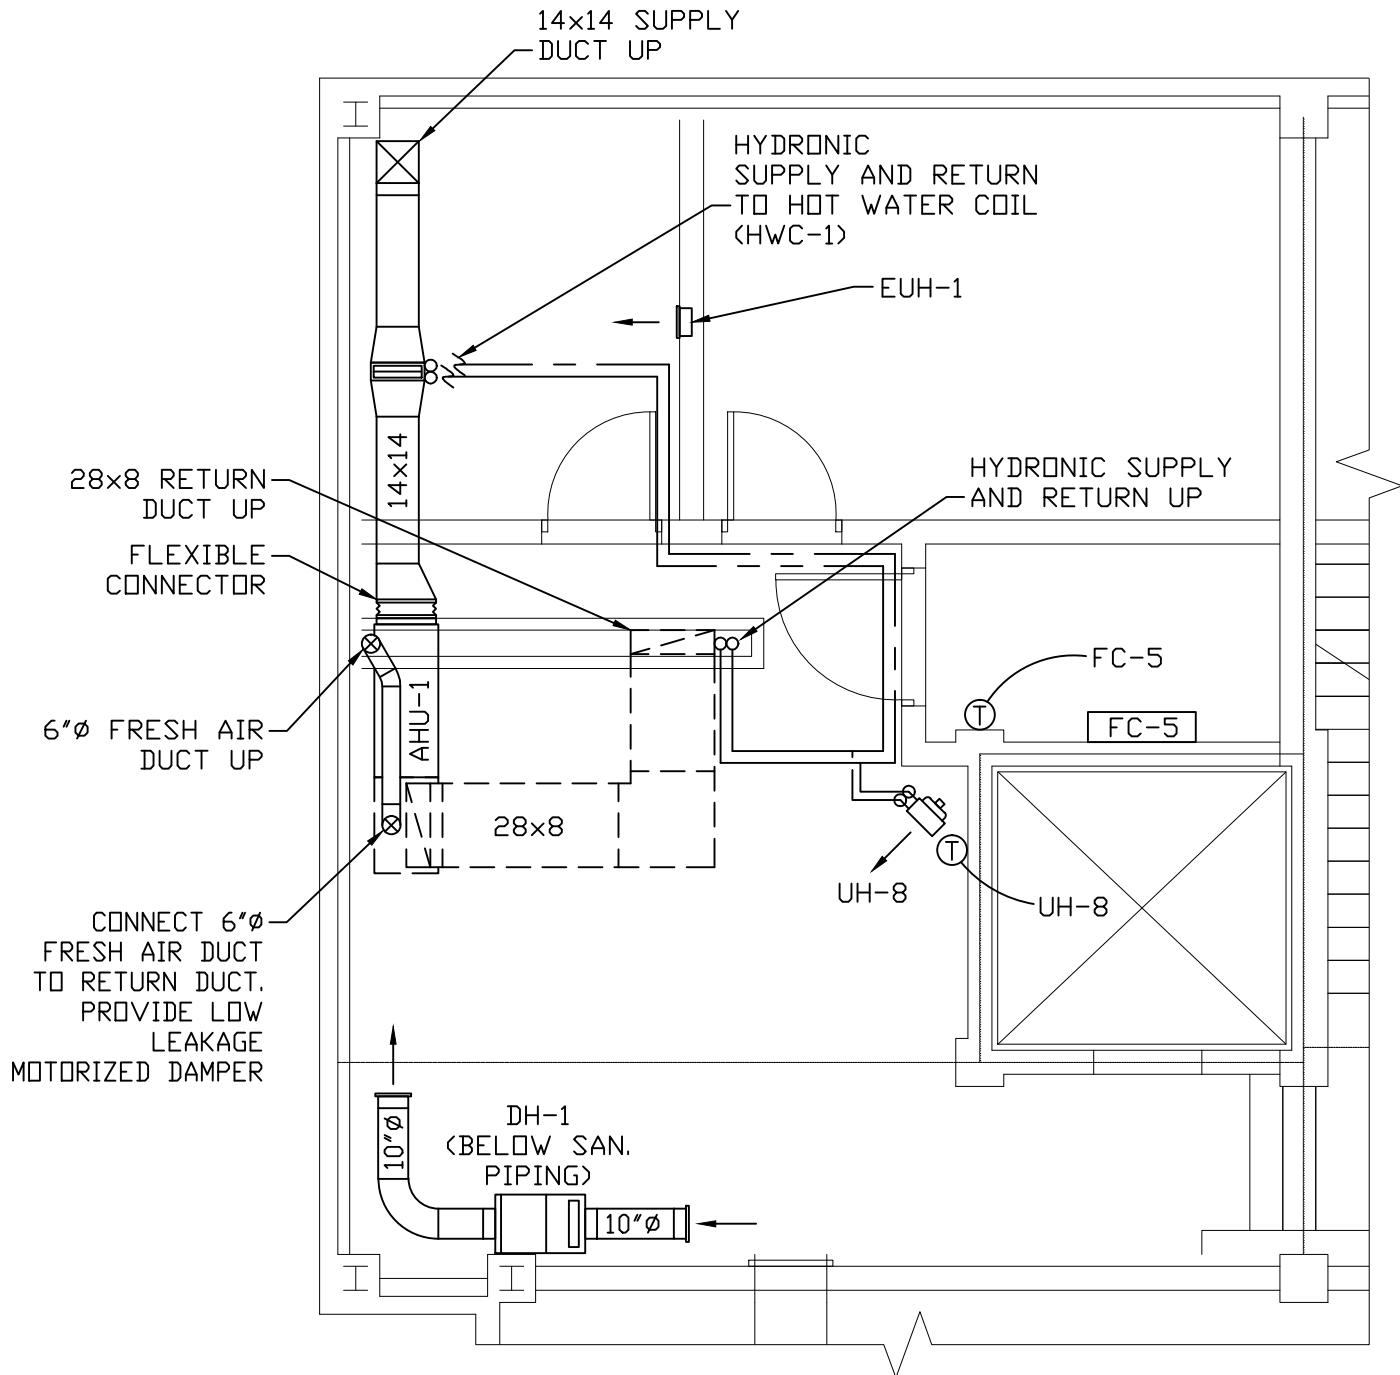
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RIVERHEAD, NY 11901  
(631) 727-5352

9 SELENA COURT  
WALDEN, NY 12586  
(845) 275-8859

HARRISON FIRE DEPT.

206 HARRISON AVE  
HARRISON, NY 10528


ESK-3



1 BASEMENT HYDRONIC SKETCH

MSK-1 3/16" = 1'-0"


3/16"=1'-0"

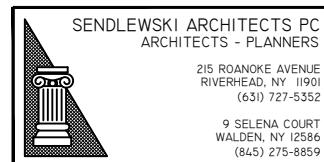

HARRISON FIRE DEPT.


206 HARRISON AVE  
HARRISON, NY 10528

MSK-1

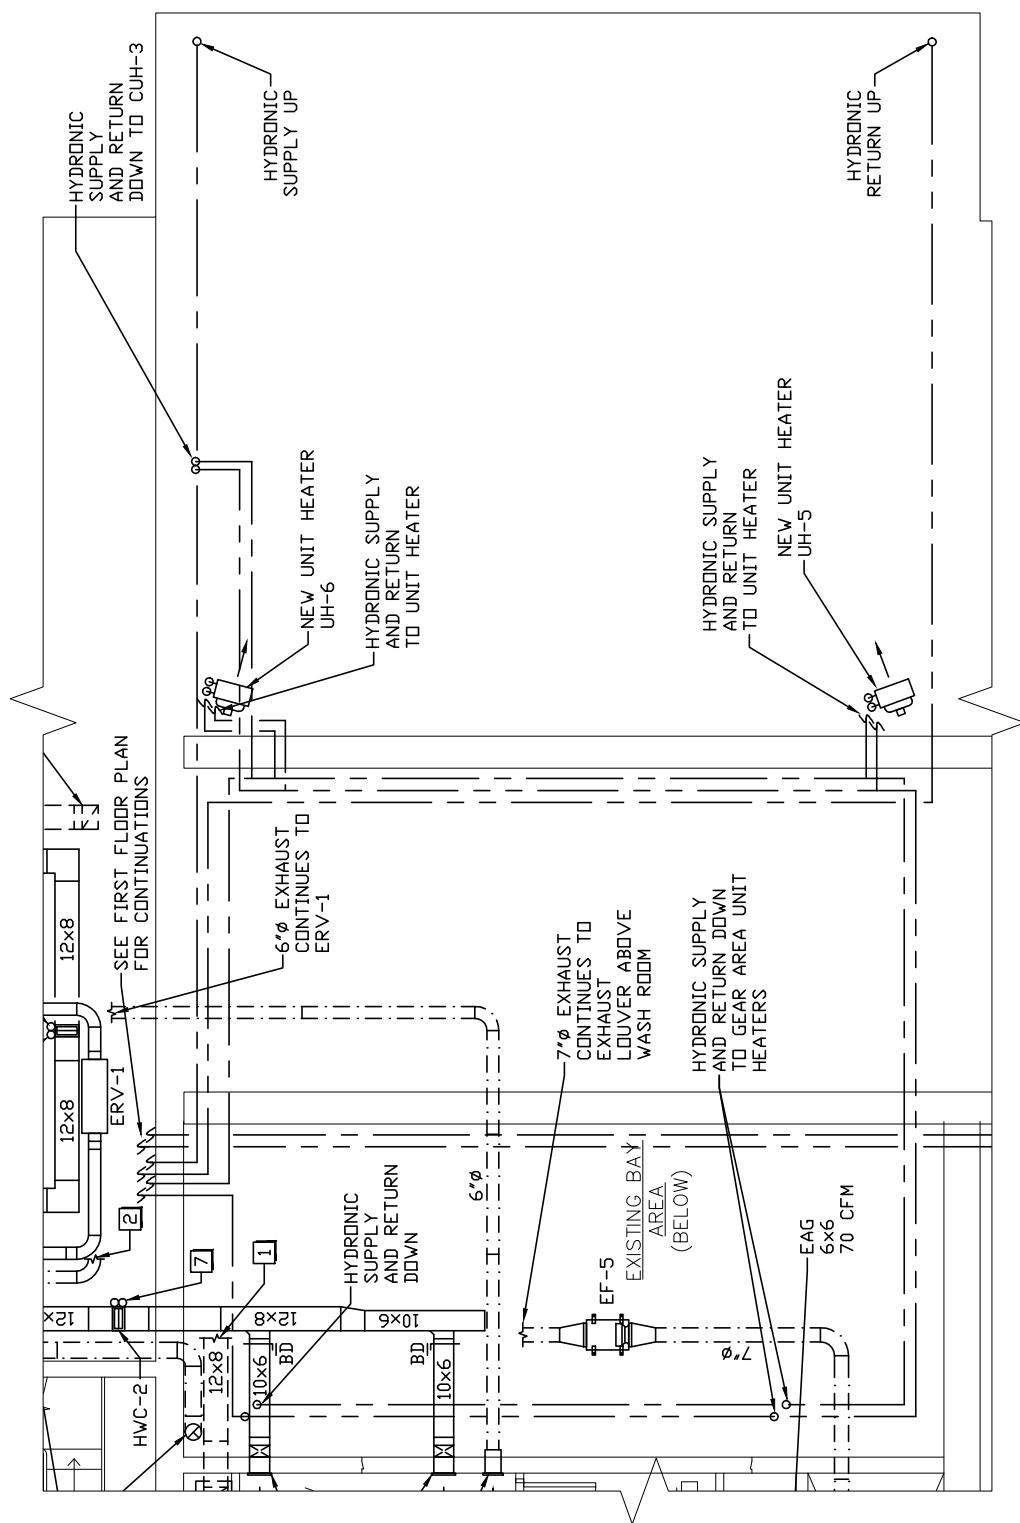

1  
MSK-2 NORTHERN APP. BAY HYDRONIC SKETCH  
1/8" = 1'-0"


8' 0" 8' 16'

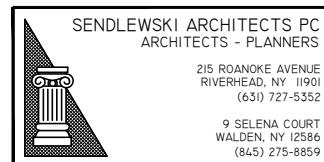

HARRISON FIRE DEPT.

206 HARRISON AVE  
HARRISON, NY 10528

MSK-2

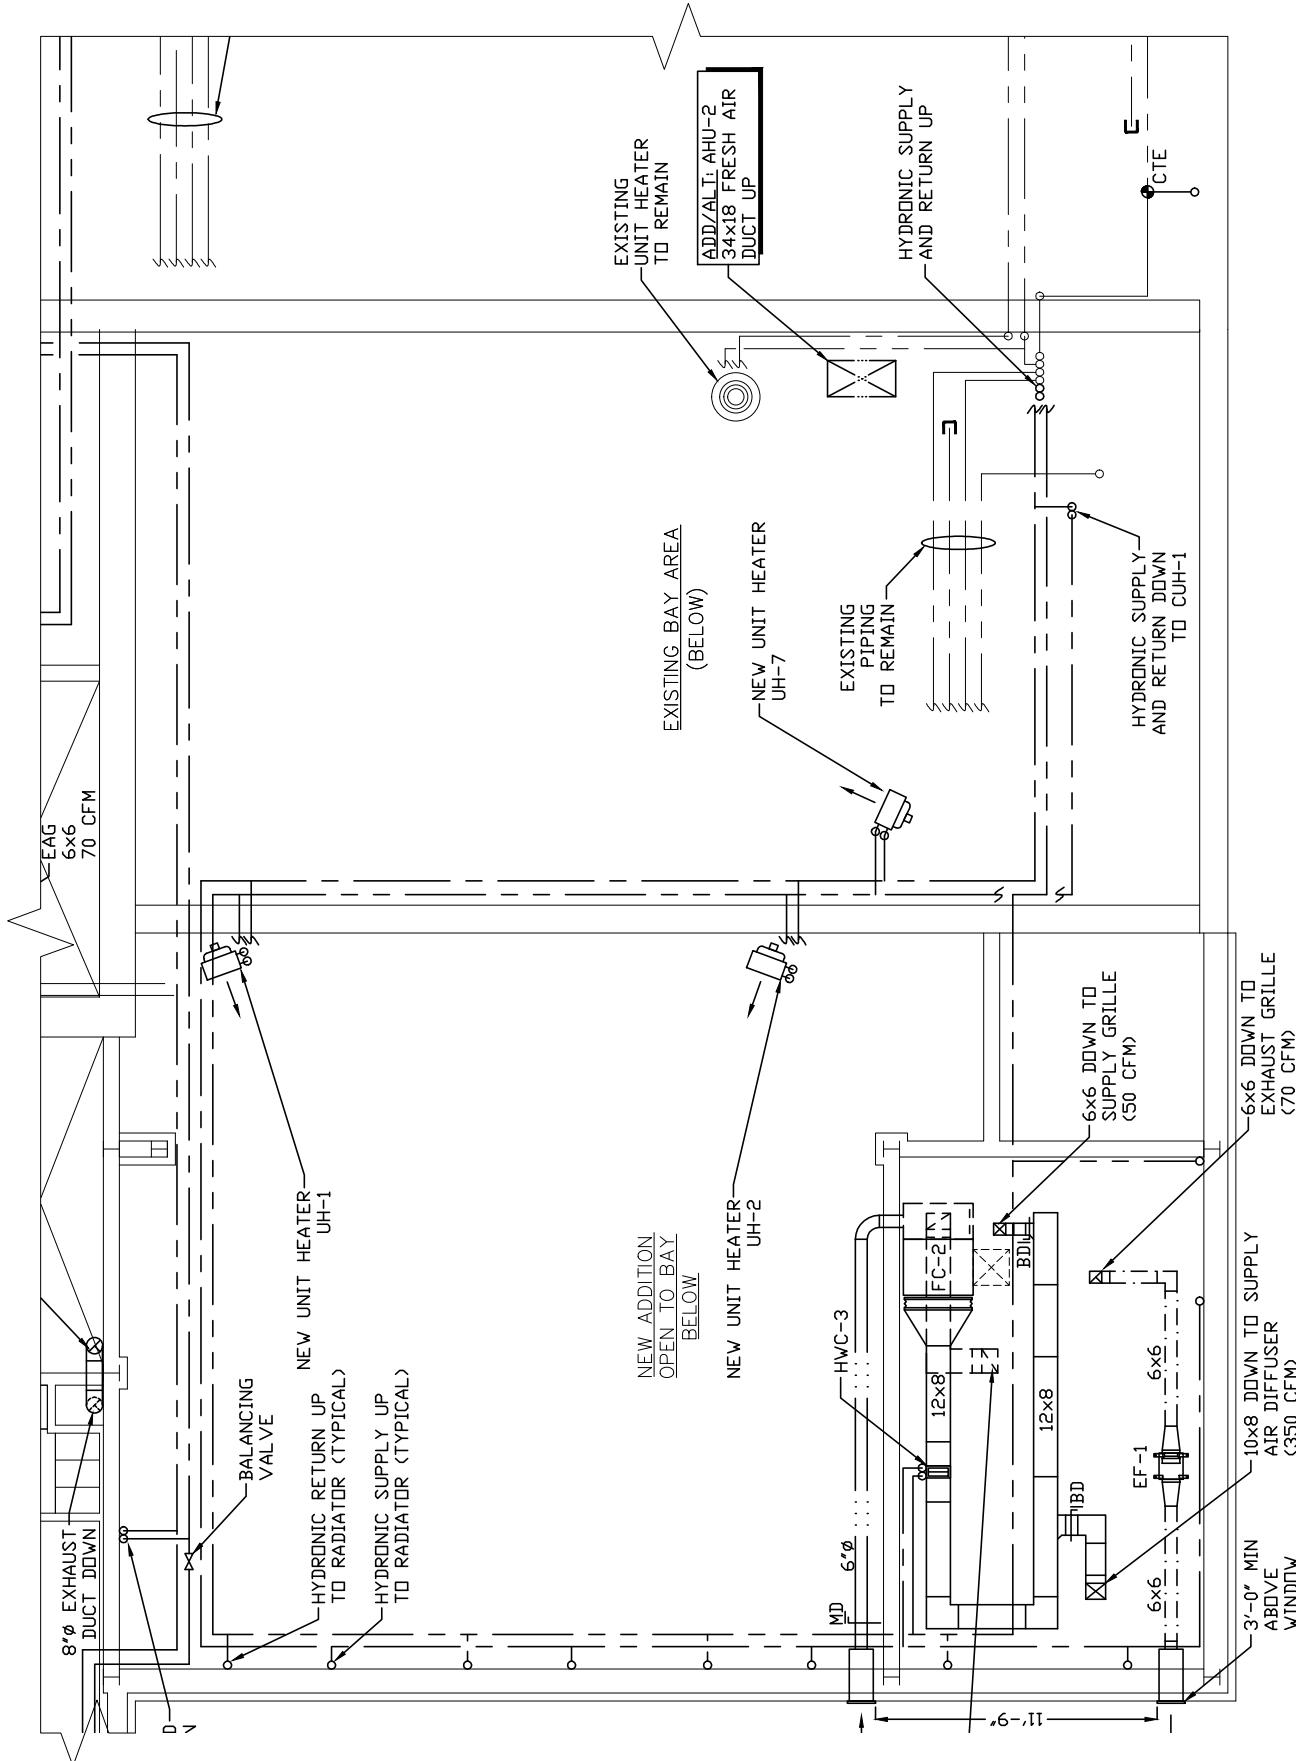

1  
MSK-3 1/8" = 1'-0"  
SOUTH APP. BAY HYDROLOGIC SKETCH

1/8" = 1'-0" 8' 0 8 16



SENDELEWSKI ARCHITECTS PC  
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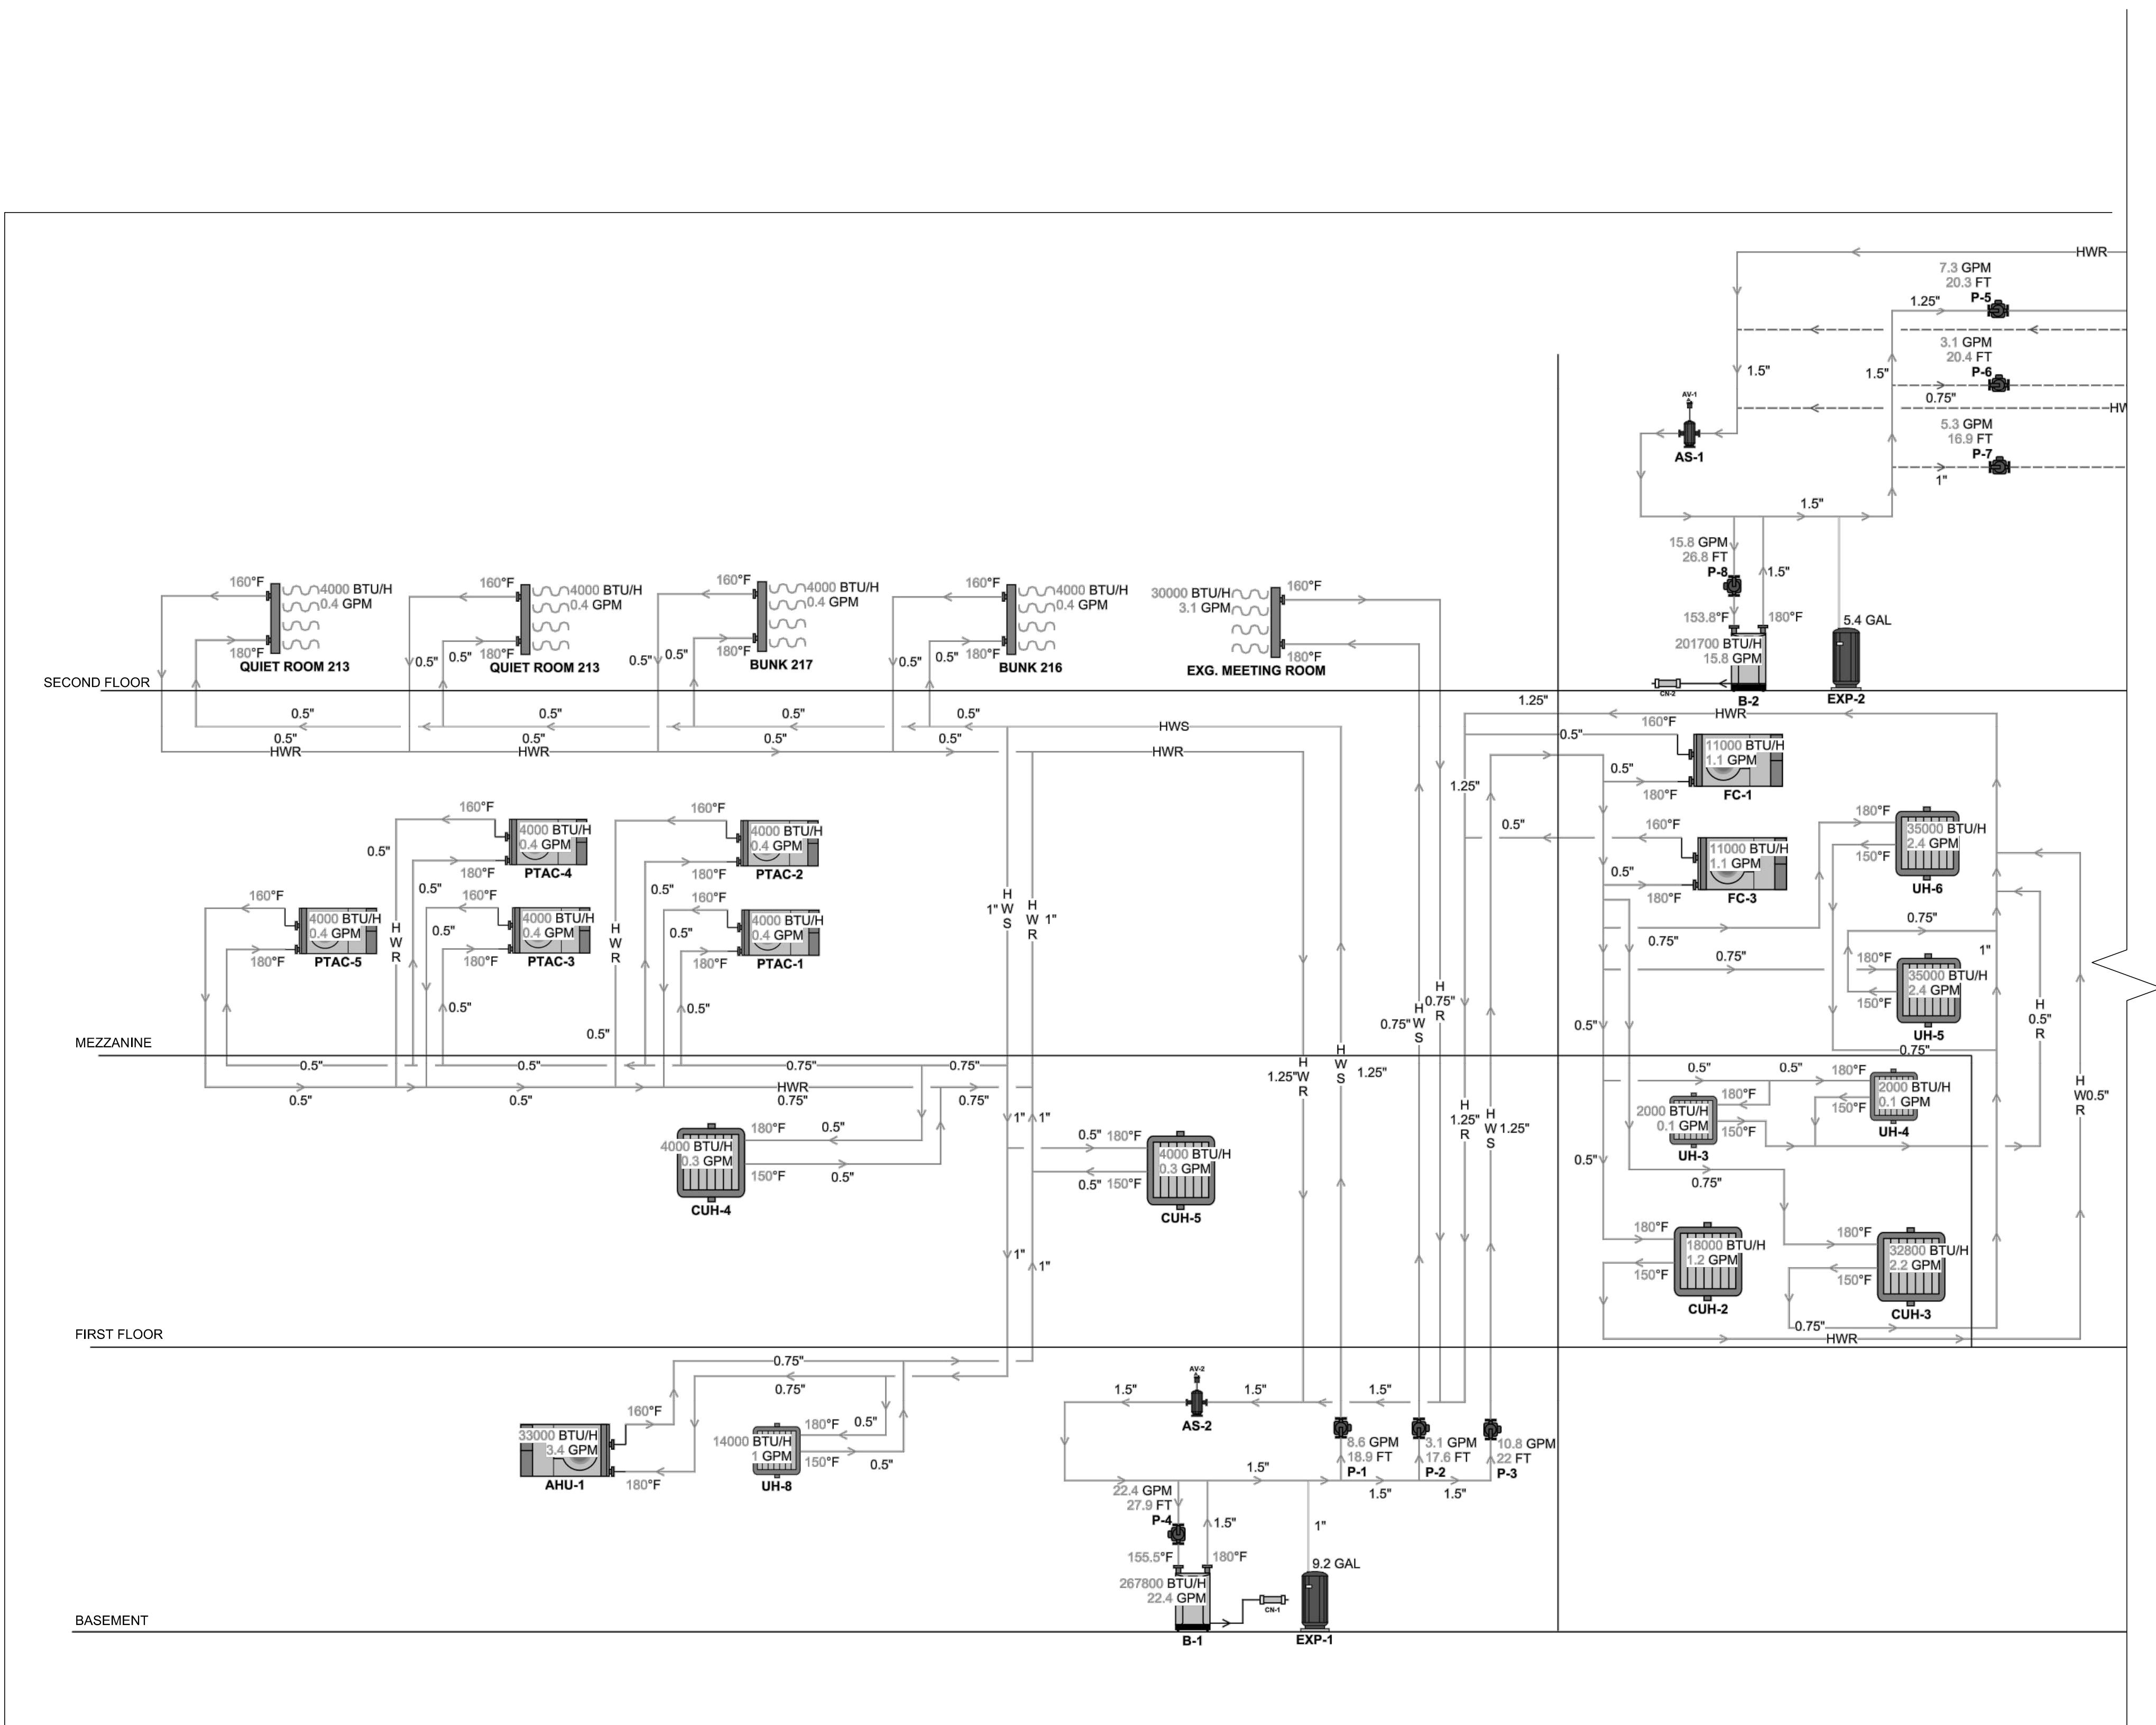
HARRISON FIRE DEPT.  
206 HARRISON AVE  
HARRISON, NY 10528

MSK-3

SEAL:

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WALDEN, NY 12586  
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HARRISON FIRE DEPT.  
PROPOSED ADDITION  
206 HARRISON AVE  
HARRISON, NY 10528  
HYDRONIC  
RISER DIAGRAM



PROJECT #: 2020-04

DRAWN BY: SEND. ARCH.

CAD FILE: P/2020/HFD  
2020-04

DRAWING #:

M-16

SEAL:

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ARCHITECTS - PLANNERS  
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(631) 727-5352  
9 SELENA COURT  
WALDEN, NY 12386  
(845) 275-8559

HARRISON FIRE DEPT.  
PROPOSED ADDITION  
206 HARRISON AVE  
HARRISON, NY 10528  
HYDRONIC  
RISER DIAGRAM


PROJECT #: 2020-04

DRAWN BY: SEND. ARCH.

CAD FILE: P/2020/HFD  
2020-04

DRAWING #:

M-17

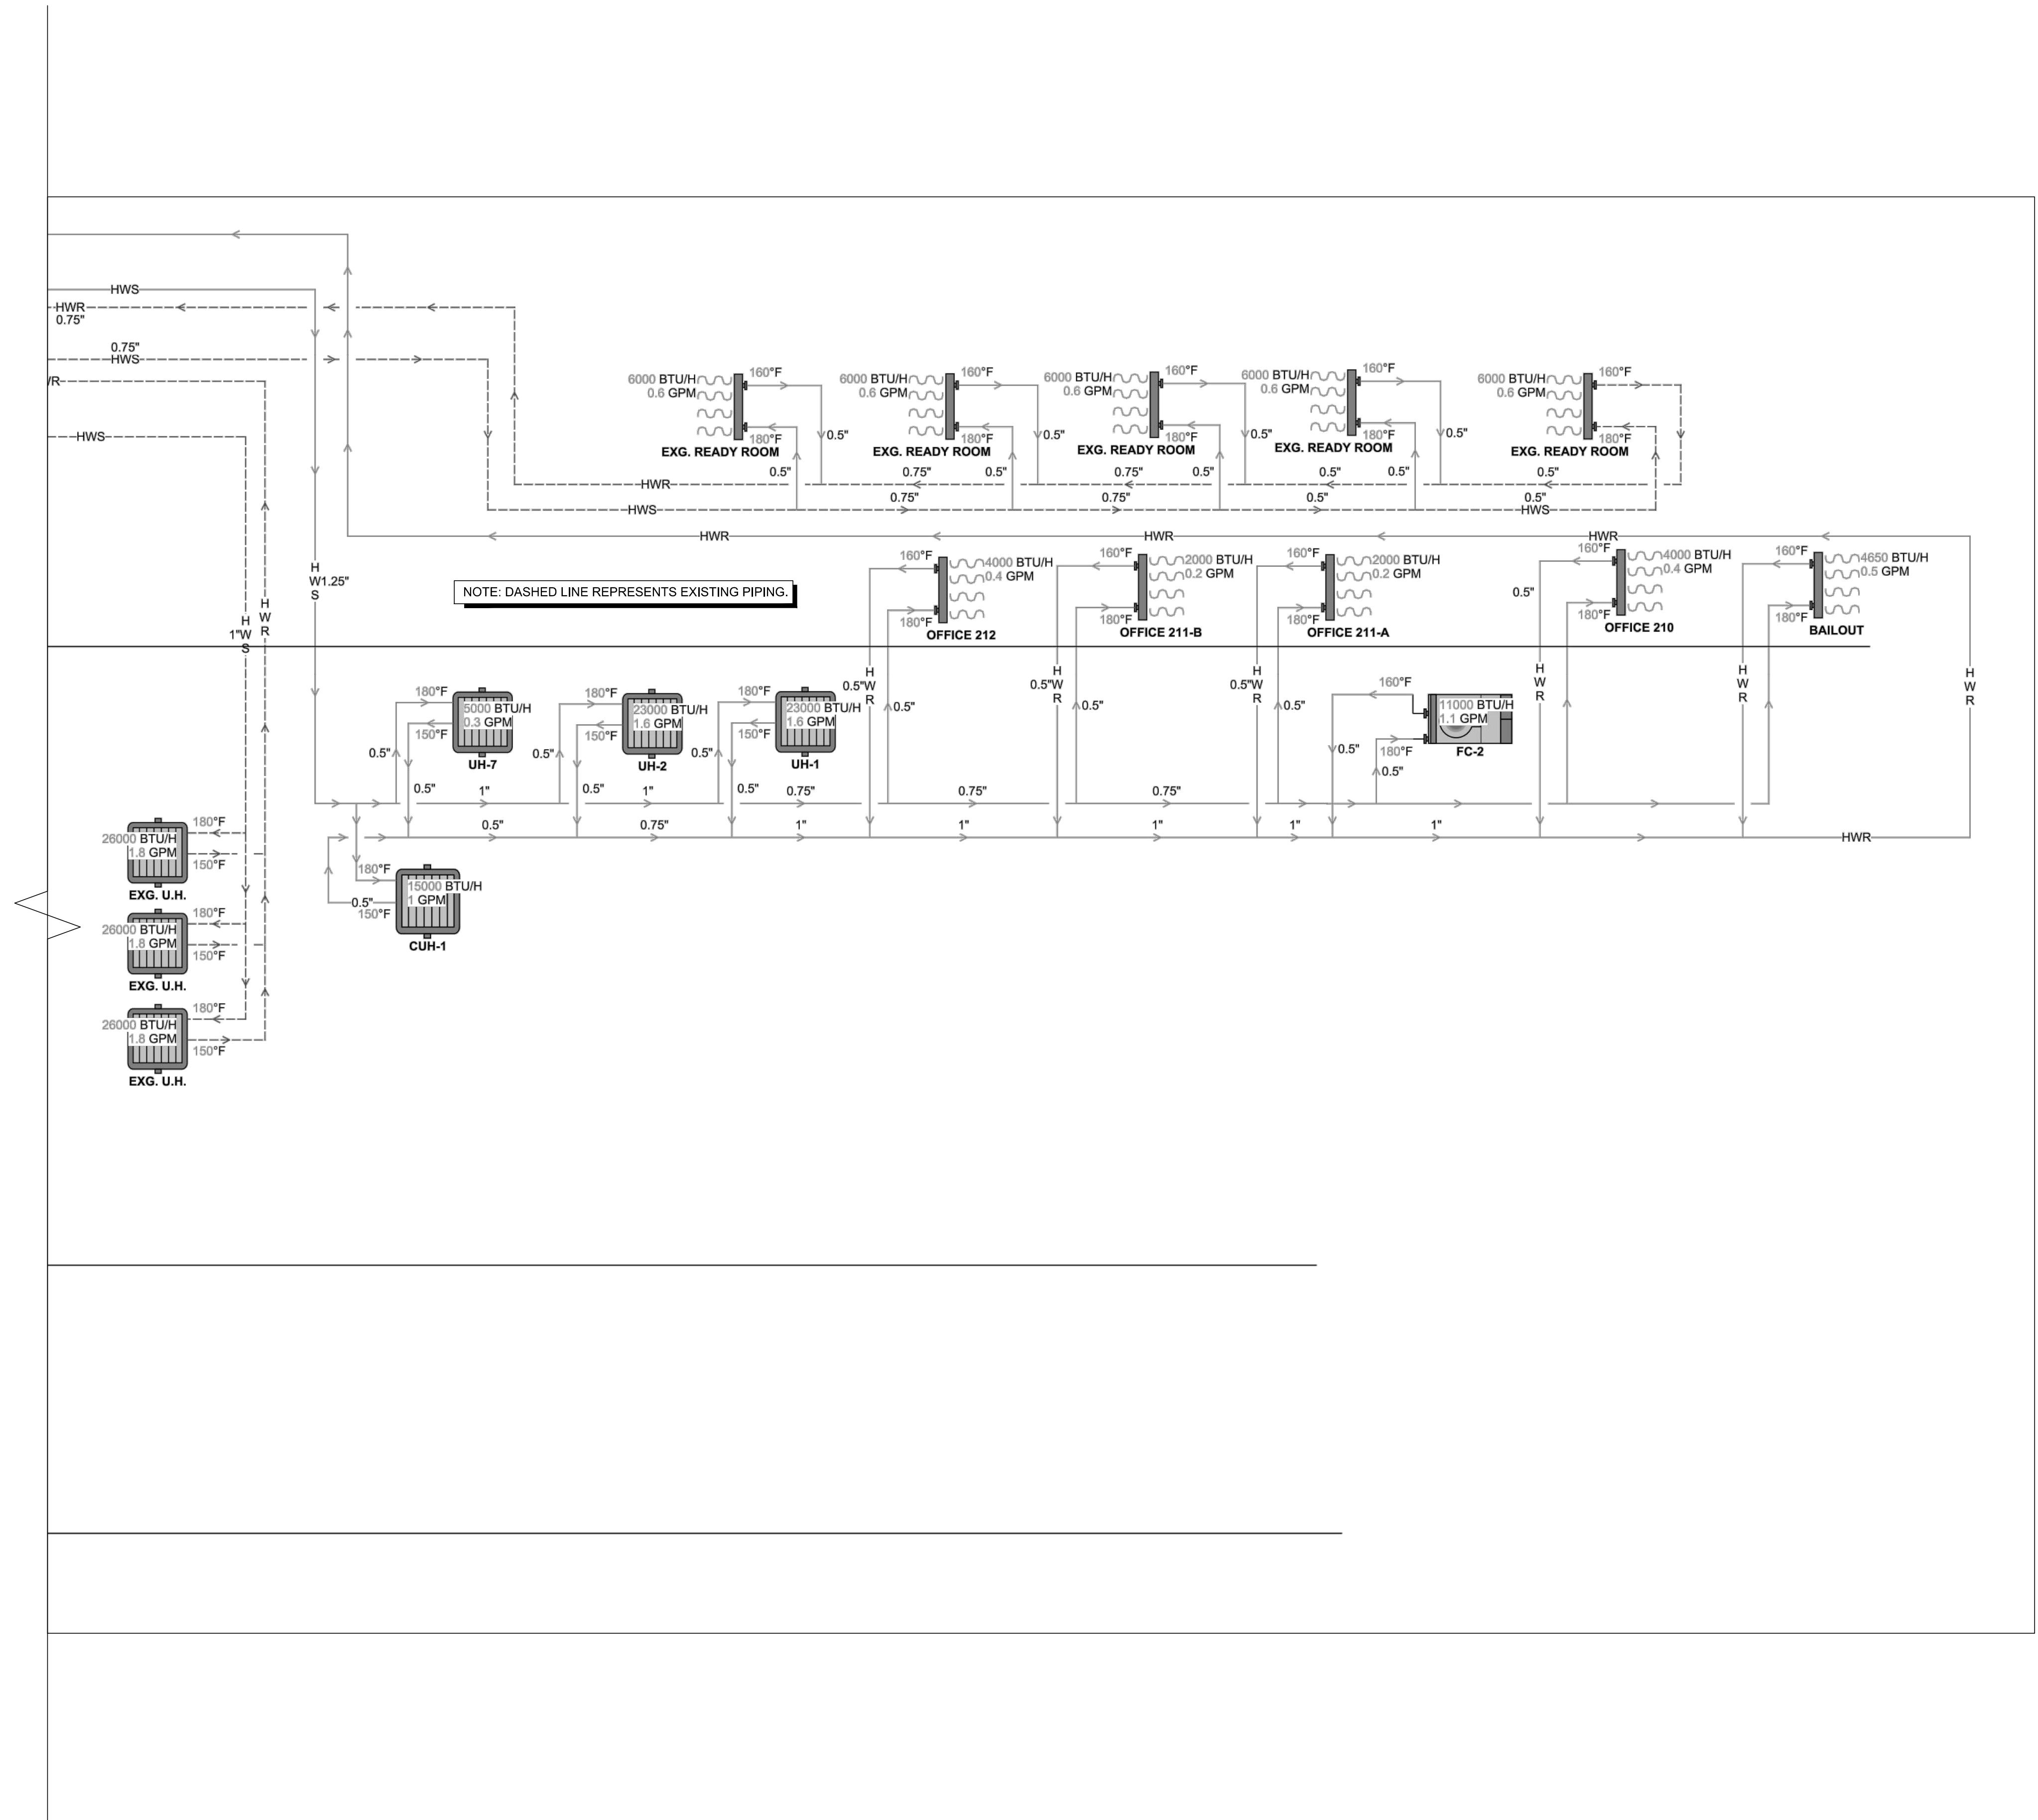

SEAL:


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(845) 275-8359

HARRISON FIRE DEPT.  
PROPOSED ADDITION  
206 HARRISON AVE  
HARRISON, NY 10528  
(ADD/ALTERNATE) ATTIC  
FIRE SPRINKLER PLAN

PROJECT #: 2020-04  
DRAWN BY: SEND. ARCH.  
CAD FILE: P/2020/HFD  
2020-04

DRAWING #:

FS-6

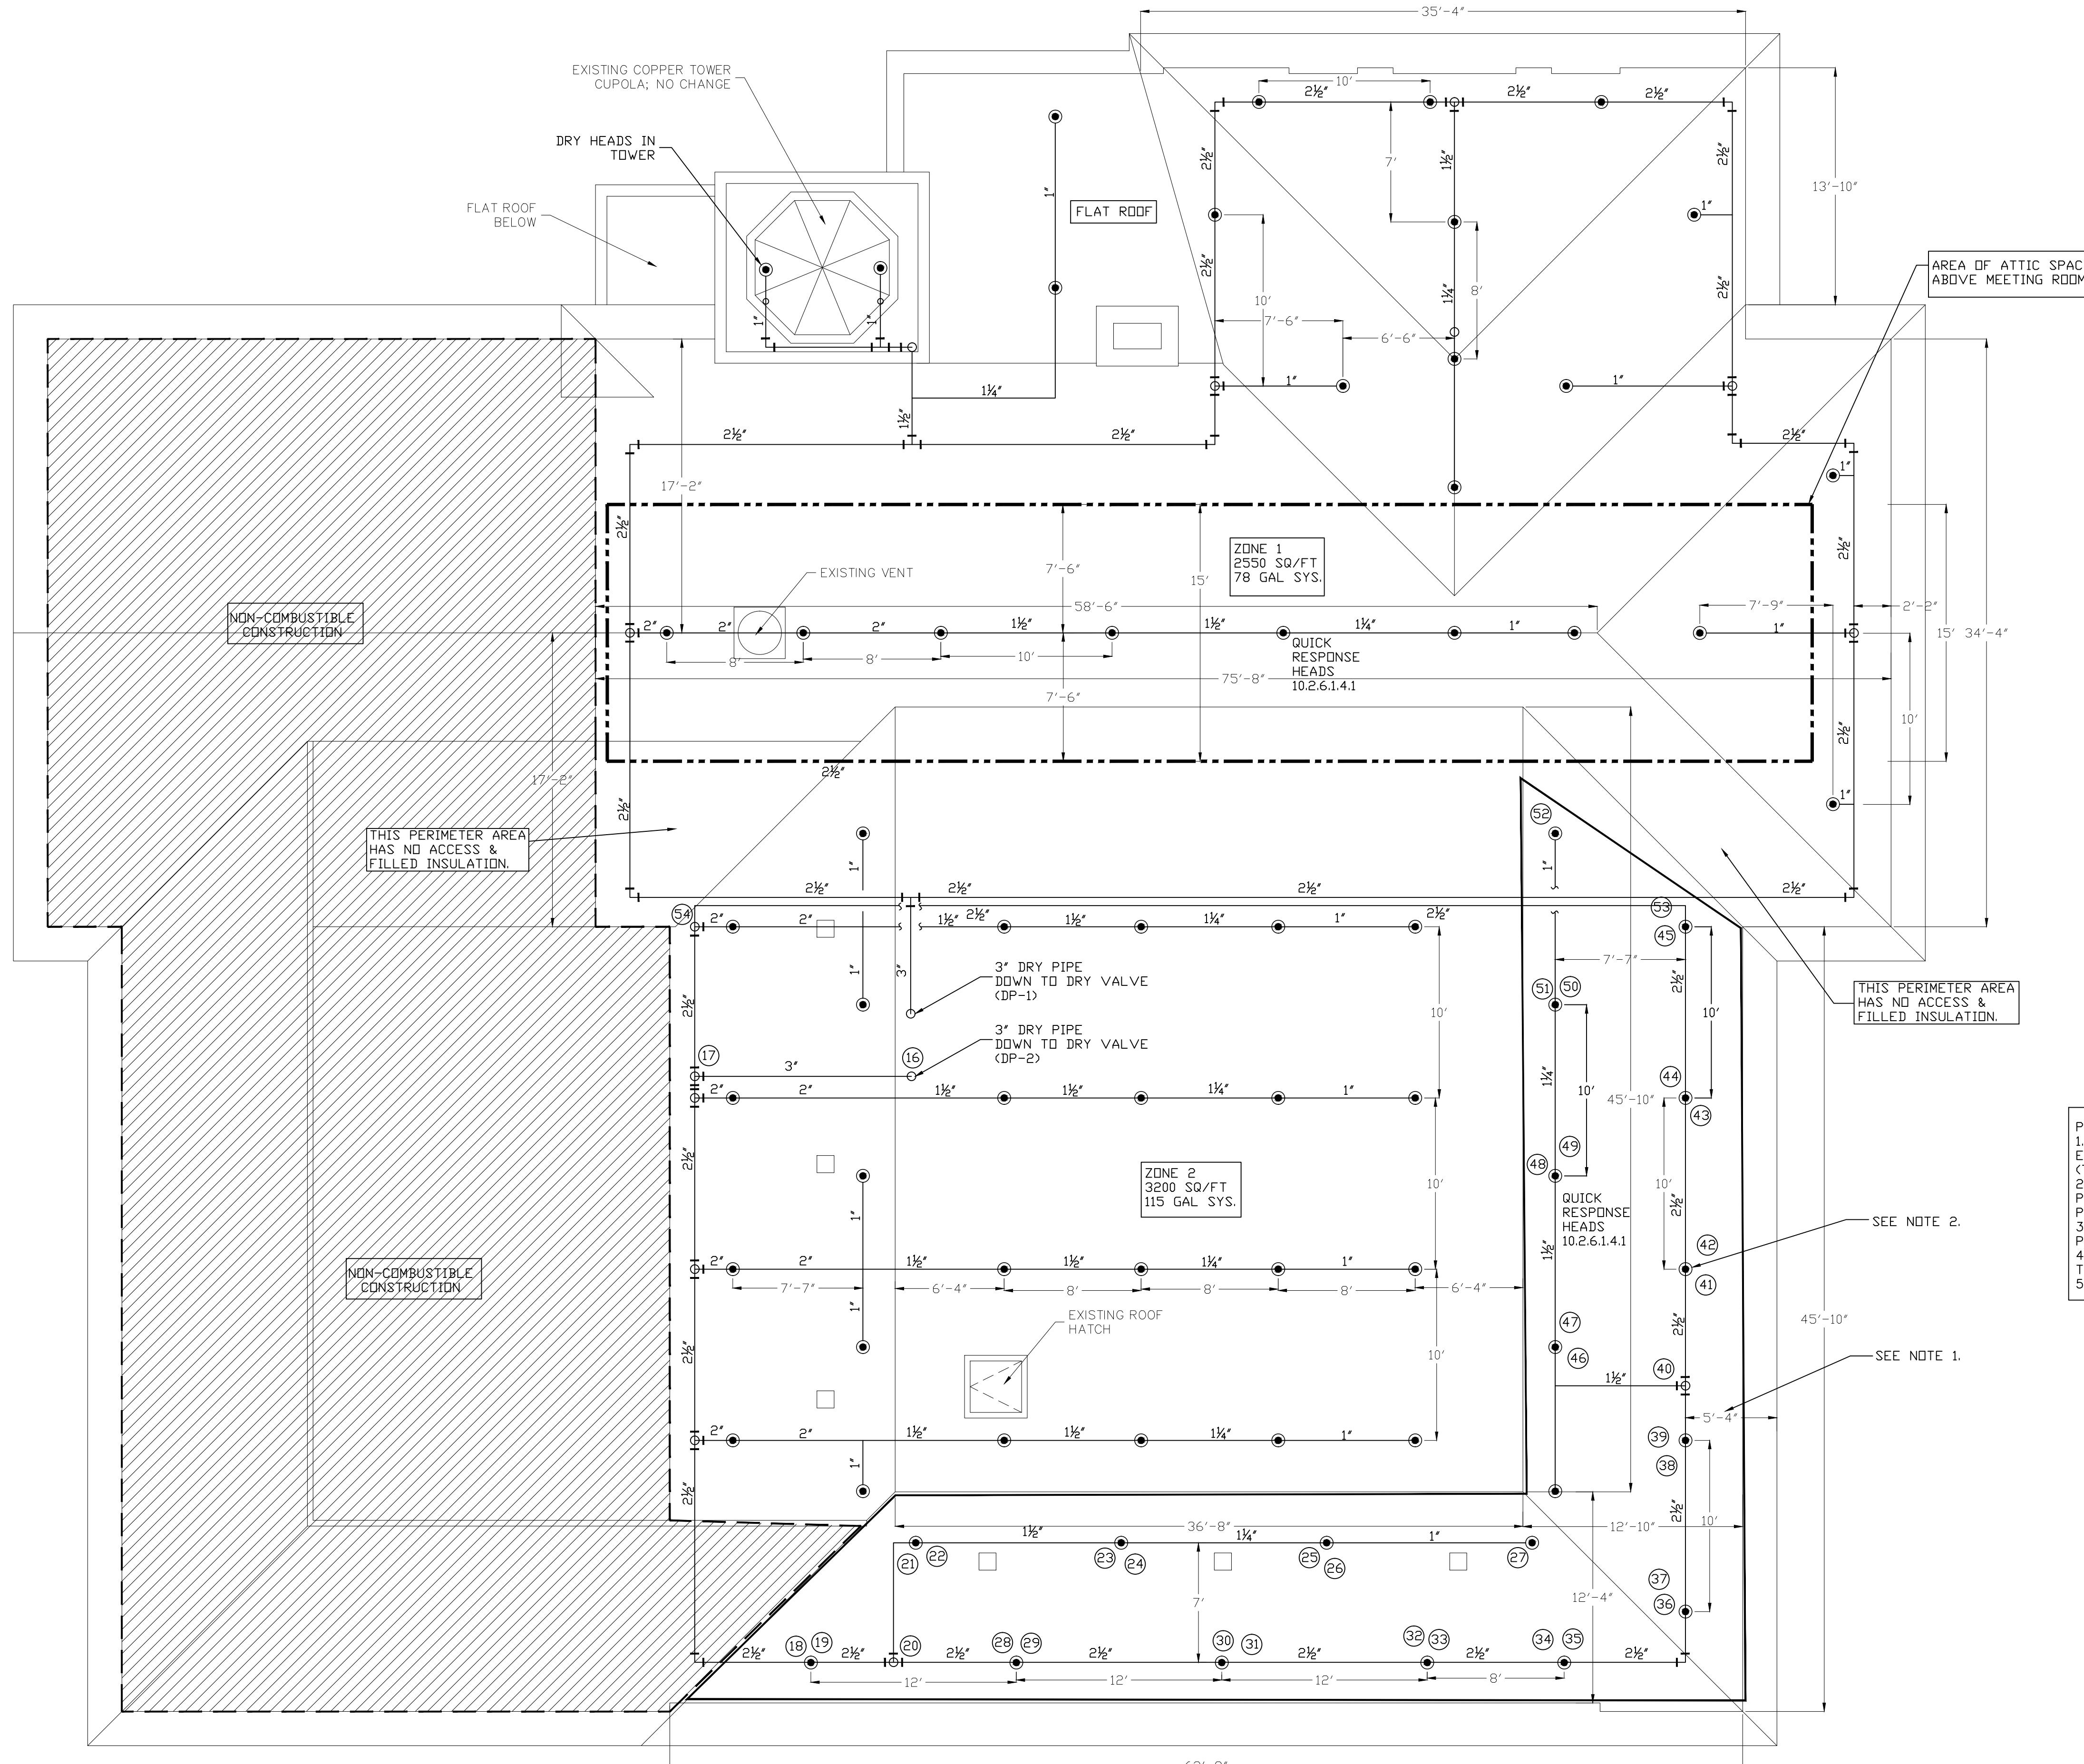

61 SPRINKLER HEADS  
5,750 SQ/FT TOTAL ATTIC AREA  
DESIGN AREA  
1500 SQ/FT ATTIC FL. AREA  
+450 SQ/FT 30% DRY SYS.  
+450 SQ/FT 30% SLOPED CLG. 19.3.3.2.4  
TOTAL CALCULATED AREA OF=2400 SQ/FT

LIGHT HAZARD OCCUPANCY  
DESIGN DENSITY 0.10 GPM/SQ. FT.


LEGEND	
●	UPRIGHT SPRINKLER (DRY SYS)
☒	CONCEALED PENDANT SPRINKLERS
◊	CONCEALED SPACE SPRINKLER
▽	SIDEWALL SPRINKLER
○	UPRIGHT SPRINKLER ON SPRIG
EC	EXTENDED COVERAGE SPRINKLER
INT	INTERMEDIATE TEMPERATURE
⊕	NODE
—	SPRINKLER PIPING
- - -	SPRINKLER DRAIN
— — —	FIRE DEPT CONNECTION PIPING

PLAN NOTES:  
1. DRY HEADS SHALL BE LOCATED A MIN. OF 5'-0" FROM EAVE AND JOIST INTERSECTION AS PER SECTION 8.6.4.1.4.3 (TYPICAL).  
2. WHERE SPRINKLER SPACING DOES NOT EXCEED 8 FEET PERPENDICULAR TO THE SLOPE SPRINKLER DISCHARGE PRESS SHALL BE 7 PSI. NFPA 13 19.4.3.4.1  
3. ALL DRY SYSTEM PIPING SHALL BE CAPABLE OF BEING DRAINED. PITCHED TO PROVIDE SLOPE BACK TO DRY VALVE.  
4. INCLUDE DRUM DRIP AUXILIARY DRAINS AS INDICATED WITHIN THE DRY SYSTEM.  
5. ALL PIPING IN ATTIC SHALL BE SCHEDULE 40 STEEL.

1 (ADD/ALTERNATE) ATTIC FIRE SPRINKLER/STANDPIPE PLAN  
FS-6 3/16" = 1'-0"

3/16" = 1'-0" 5' 0 5 10

N

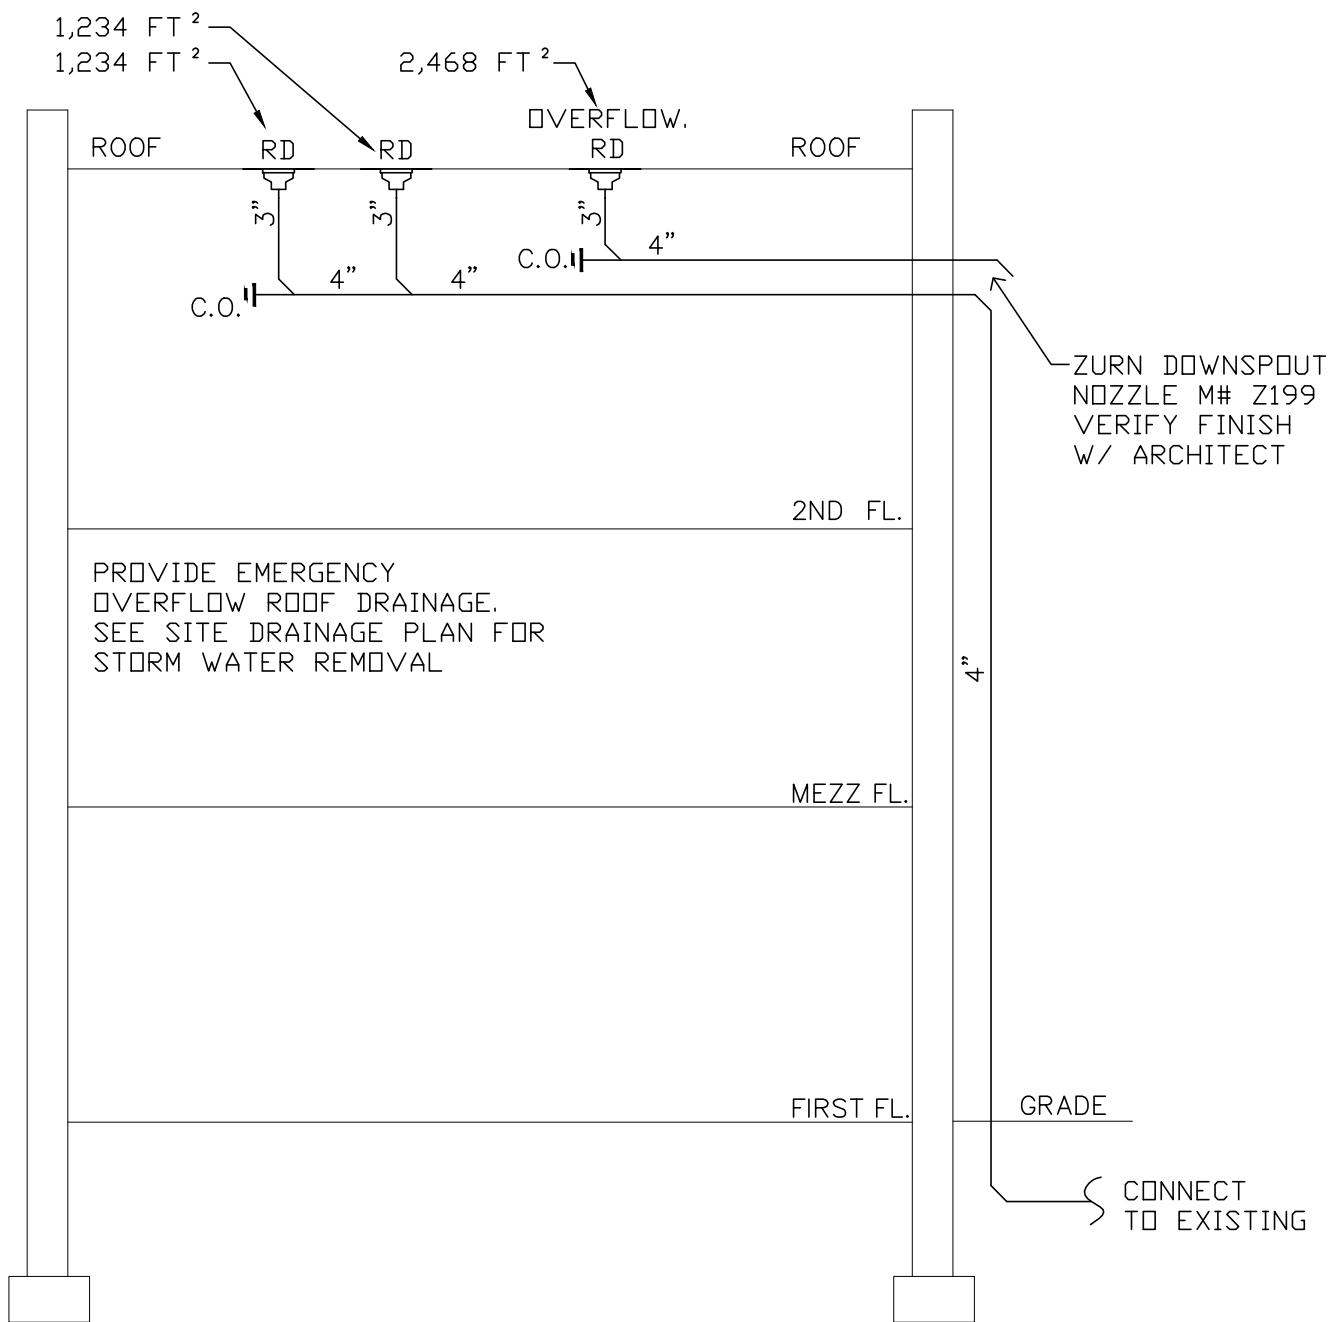


NOTE: PIPE SIZING BASED UPON  $\frac{1}{8}$ " /FT SLOPE.



STORM PIPING SKETCH

$1/8" = 1'-0"$

8' 0 8 16

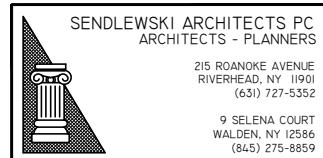

HARRISON FIRE DEPT.

206 HARRISON AVE  
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PSK-1