BID Addendum No. Four (4)

PROJECT:

Iona Preparatory School

Addition and Alterations to the Pail Verni Fine Arts Center

255 Wilmot Road

New Rochelle, NY 10804

ADDENDUM NO. Four (4) Initiation Date: June 22, 2021

Architect's Project No.: 1618
PGA Contact: Danny Lam
dlam@petergisolfiassociates.com

914-478-3677 x 340

TO ALL BIDDERS:

You are directed to make the following changes in this Contract:

B. Architectural

- 1. Sheet L-200 this sheet is being re-issued with location of three (3) condenser units at Verni Center.
- 2. Sheet A-101 see sketch SKA-01 for clarification to window tags at room 125.
- 3. Sheet A-105a note the exterior light fixtures on the Verni building are part of the base bid and not to be excluded in Deduct Alternate #1.
- 4. Sheet A-353 this sheet is being re-issued with clarification on the exterior façade finish at stair B.
- 5. Sheet A-372 note this sheet does not exist. All details referencing A-372 shall refer to sheet A-370.
- 6. Sheet A-601 the wood species for detail 2 at the proscenium opening shall be white oak.
- 7. Specification section 10 50 30 Canopies shall be added to the project.
- 8. Specification section 10 90 00 Miscellaneous Specialties remove reference to glass marker boards from specifications.
- 9. The 1" insulated panels referenced on the exterior wall sections shall be Endurex 525 by Nudo or equal.
- 10. All interior railings are painted steel finish and all site railings are galvanized and powder coated.

C. Structural

- 1. The GC shall include design for roof trusses and exterior wall framing. Refer to specification section 05 40 00 Formed Metal Framing and sheet S-002 for guidance.
- D. Mechanical

No change.

E. Plumbing

No change.

F. Sprinkler

No change.

- G. Electrical
 - 1. Sheet E-302 note symbols L-1, L-2, L-3, R-1, R-2, and R-3 in the theater are wall speakers by others.

PETER GISOLFI ASSOC	IATES	
566 Warburton Avenue	Architects	
Hastings-on-Hudson NY 10706	Landscape Architects	
914 478-3677 914 478-1600 fax	Interior Architects	

BID Addendum No. Four (4)

- 2. Sheet E-501 The new 208V, 3-phase electric service shall terminate in a pullbox in the storage room and safe-off wires. The new distribution related to the renovation work at Parent's Hall is a future/separate project at a later date.
- 3. Lighting in corridors, vestibules and open floor areas at the non-theater locations will be controlled via time clock, contactor and override switches for each floor. Offices, storage rooms, classrooms, etc. are provided with stand-alone control and dimming switches including vacancy/occupancy sensors type switches. These are separate from the theater lighting control systems.

H. Fire Alarm


1. Sheet FA-301 – note 16 – the campus fire alarm vendor is Open Systems Metro, not AFA Protection Systems.

Attachments:


- AIA Document A201-2017 General Conditions and Exhibit A Article 11 Insurance
- Revised sheet L-200: Location of condenser units.
- Sketch SKA-01: Clarification to window tags.
- Revised sheet A-353: Clarification to exterior finish
- Specification Section 10 50 30 Canopies

End of Addendum No. 4

PETER GISOLFI ASSOC	1ATES	
566 Warburton Avenue	Architects	
Hastings-on-Hudson NY 10706	Landscape Architects	
914 478-3677 914 478-1600 fax	Interior Architects	

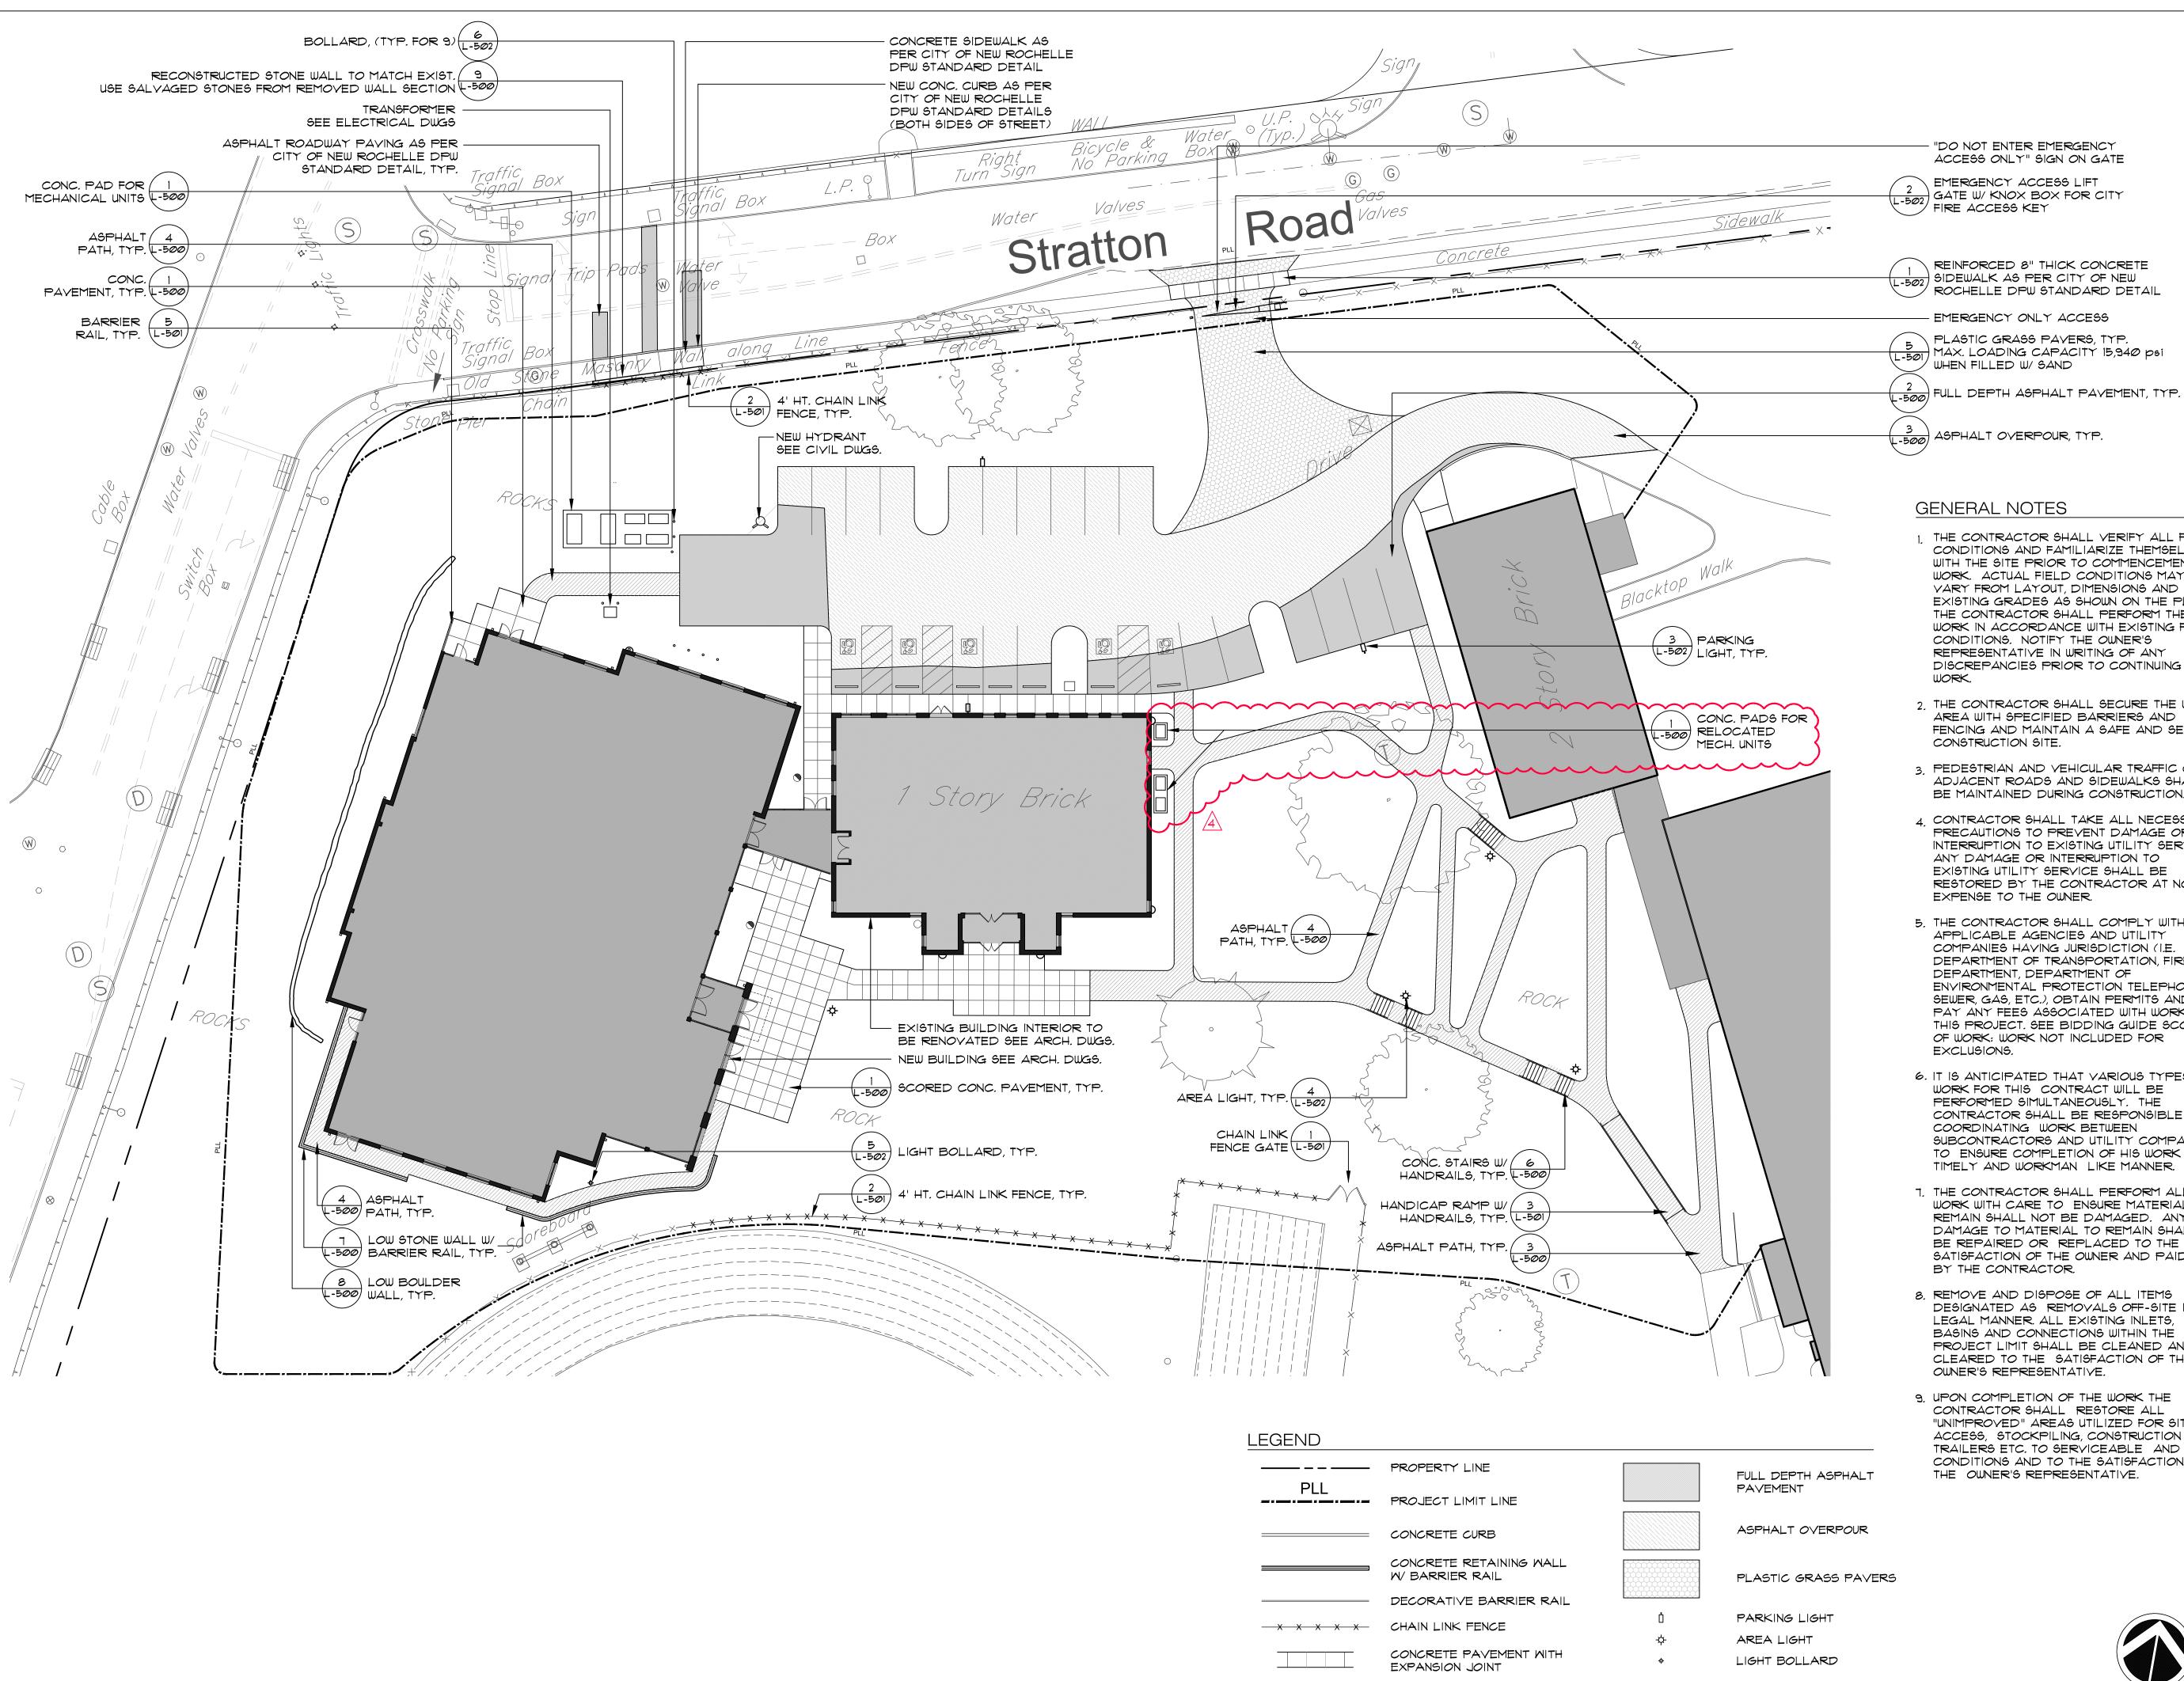


ASPHALT PATH

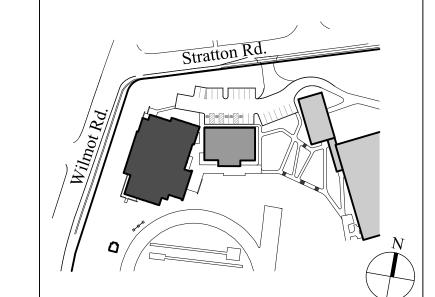

Key Plan Not to Scale

1 THE CONTRACTOR SHALL VERIFY ALL FIELD CONDITIONS AND FAMILIARIZE THEMSELVES WITH THE SITE PRIOR TO COMMENCEMENT OF WORK. ACTUAL FIELD CONDITIONS MAY YARY FROM LAYOUT, DIMENSIONS AND EXISTING GRADES AS SHOWN ON THE PLANS. THE CONTRACTOR SHALL PERFORM THE WORK IN ACCORDANCE WITH EXISTING FIELD CONDITIONS. NOTIFY THE OWNER'S REPRESENTATIVE IN WRITING OF ANY DISCREPANCIES PRIOR TO CONTINUING

- 2. THE CONTRACTOR SHALL SECURE THE WORK AREA WITH SPECIFIED BARRIERS AND FENCING AND MAINTAIN A SAFE AND SECURE CONSTRUCTION SITE.
- 3. PEDESTRIAN AND VEHICULAR TRAFFIC ON ADJACENT ROADS AND SIDEWALKS SHALL BE MAINTAINED DURING CONSTRUCTION.
- 4. CONTRACTOR SHALL TAKE ALL NECESSARY PRECAUTIONS TO PREVENT DAMAGE OR INTERRUPTION TO EXISTING UTILITY SERVICE. ANY DAMAGE OR INTERRUPTION TO EXISTING UTILITY SERVICE SHALL BE RESTORED BY THE CONTRACTOR AT NO EXPENSE TO THE OWNER.
- 5. THE CONTRACTOR SHALL COMPLY WITH ALL APPLICABLE AGENCIES AND UTILITY COMPANIES HAVING JURISDICTION (I.E. DEPARTMENT OF TRANSPORTATION, FIRE DEPARTMENT, DEPARTMENT OF ENVIRONMENTAL PROTECTION TELEPHONE, SEWER, GAS, ETC.), OBTAIN PERMITS AND PAY ANY FEES ASSOCIATED WITH WORK OF THIS PROJECT. SEE BIDDING GUIDE SCOPE OF WORK: WORK NOT INCLUDED FOR
- 6. IT IS ANTICIPATED THAT VARIOUS TYPES OF WORK FOR THIS CONTRACT WILL BE PERFORMED SIMULTANEOUSLY. THE CONTRACTOR SHALL BE RESPONSIBLE FOR COORDINATING WORK BETWEEN SUBCONTRACTORS AND UTILITY COMPANIES TO ENSURE COMPLETION OF HIS WORK IN A TIMELY AND WORKMAN LIKE MANNER.
- 7. THE CONTRACTOR SHALL PERFORM ALL WORK WITH CARE TO ENSURE MATERIALS TO REMAIN SHALL NOT BE DAMAGED. ANY DAMAGE TO MATERIAL TO REMAIN SHALL BE REPAIRED OR REPLACED TO THE SATISFACTION OF THE OWNER AND PAID FOR BY THE CONTRACTOR.
- 8. REMOVE AND DISPOSE OF ALL ITEMS DESIGNATED AS REMOVALS OFF-SITE IN A LEGAL MANNER, ALL EXISTING INLETS, BASING AND CONNECTIONS WITHIN THE PROJECT LIMIT SHALL BE CLEANED AND CLEARED TO THE SATISFACTION OF THE OWNER'S REPRESENTATIVE.
- 9. UPON COMPLETION OF THE WORK THE CONTRACTOR SHALL RESTORE ALL "UNIMPROVED" AREAS UTILIZED FOR SITE ACCESS, STOCKPILING, CONSTRUCTION TRAILERS ETC. TO SERVICEABLE AND SAFE CONDITIONS AND TO THE SATISFACTION OF THE OWNER'S REPRESENTATIVE.

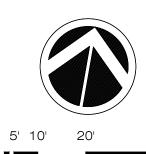

845-727-7793 MEP ENGINEER ROOFING CONSULTANT JMV CONSULTING WATSKY ASSOCIATES ENGINEERING, P.C. 20 MADISON AVENUE 37 W. 39 STREET, STE 703 VALHALLA, NY 10595 NEW YORK, NY 10018 212-852-9855

BID ADDENDUM 4

BID ADDENDUM 1

RE-ISSUED FOR BUILDING PERMIT REVIEW

ISSUED FOR BUILDING PERMIT REVIEW

ISSUED FOR PLANNING BOARD REVIEW

ISSUED FOR PRELIMINARY DOB REVIEW

ISSUED FOR PRELIMINARY DOB REVIEW

RESUBMITTED FOR ZONING REVIEW

ISSUED FOR BID

Revision/Submission

6/22/2021

6/09/2021

6/01/2021

9/23/2020 8/28/2020

1/10/2020

Date

DOMINICK R PILLA ASSOCIATES, P.C.

143 MAIN STREET

NYACK, NY 10960

STRUCTURAL & CIVIL ENGINEER

IONA PREPARATORY SCHOOL VERNI CENTER FOR PERFORMING ARTS

Project Address

IONA PREPARATORY SCHOOL 255 Wilmot Road New Rochelle, NY 10804

Drawing Title

MATERIALS PLAN


Drawing No.


1" = 20'-0'	1618	04/03/2019	
Drawn	Checked	Approved	1 -200
RW	RW	MT	L-200
Peter Gisolfi	Associates, L	LP	

Architects, Landscape Architects

566 Warburton Avenue Hastings on Hudson, NY 10706 914 478 3677

PETER GISOLFI ASSOCIATES

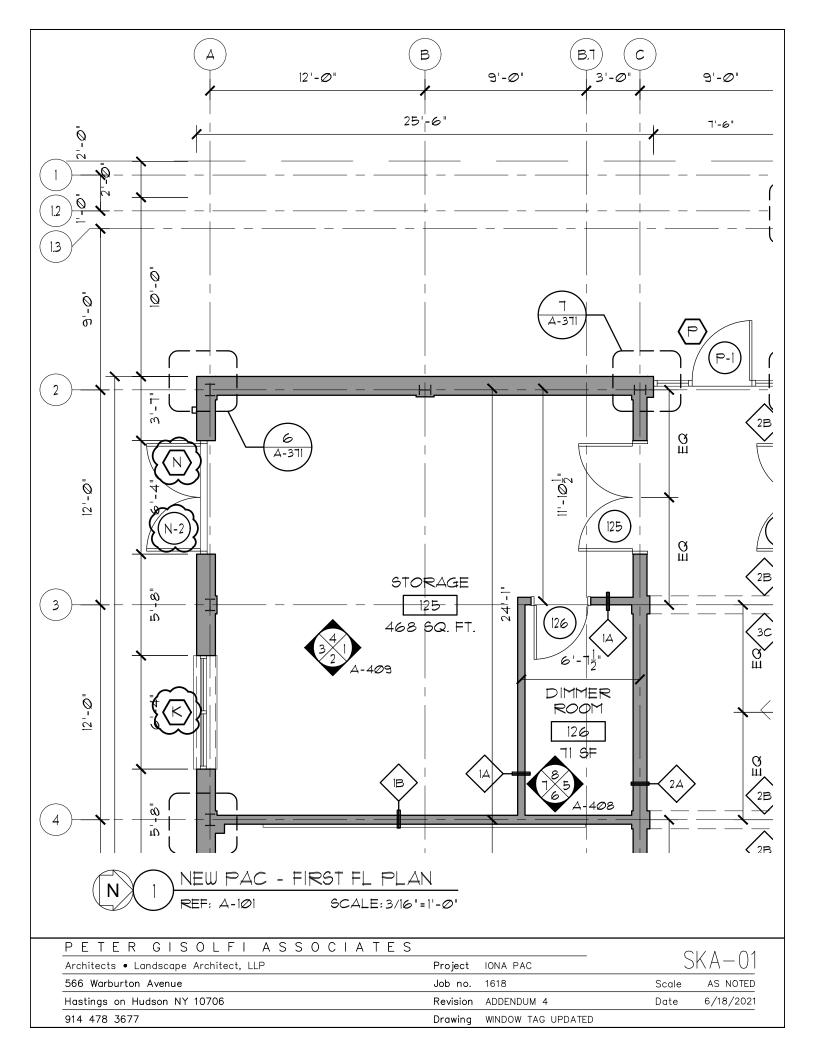

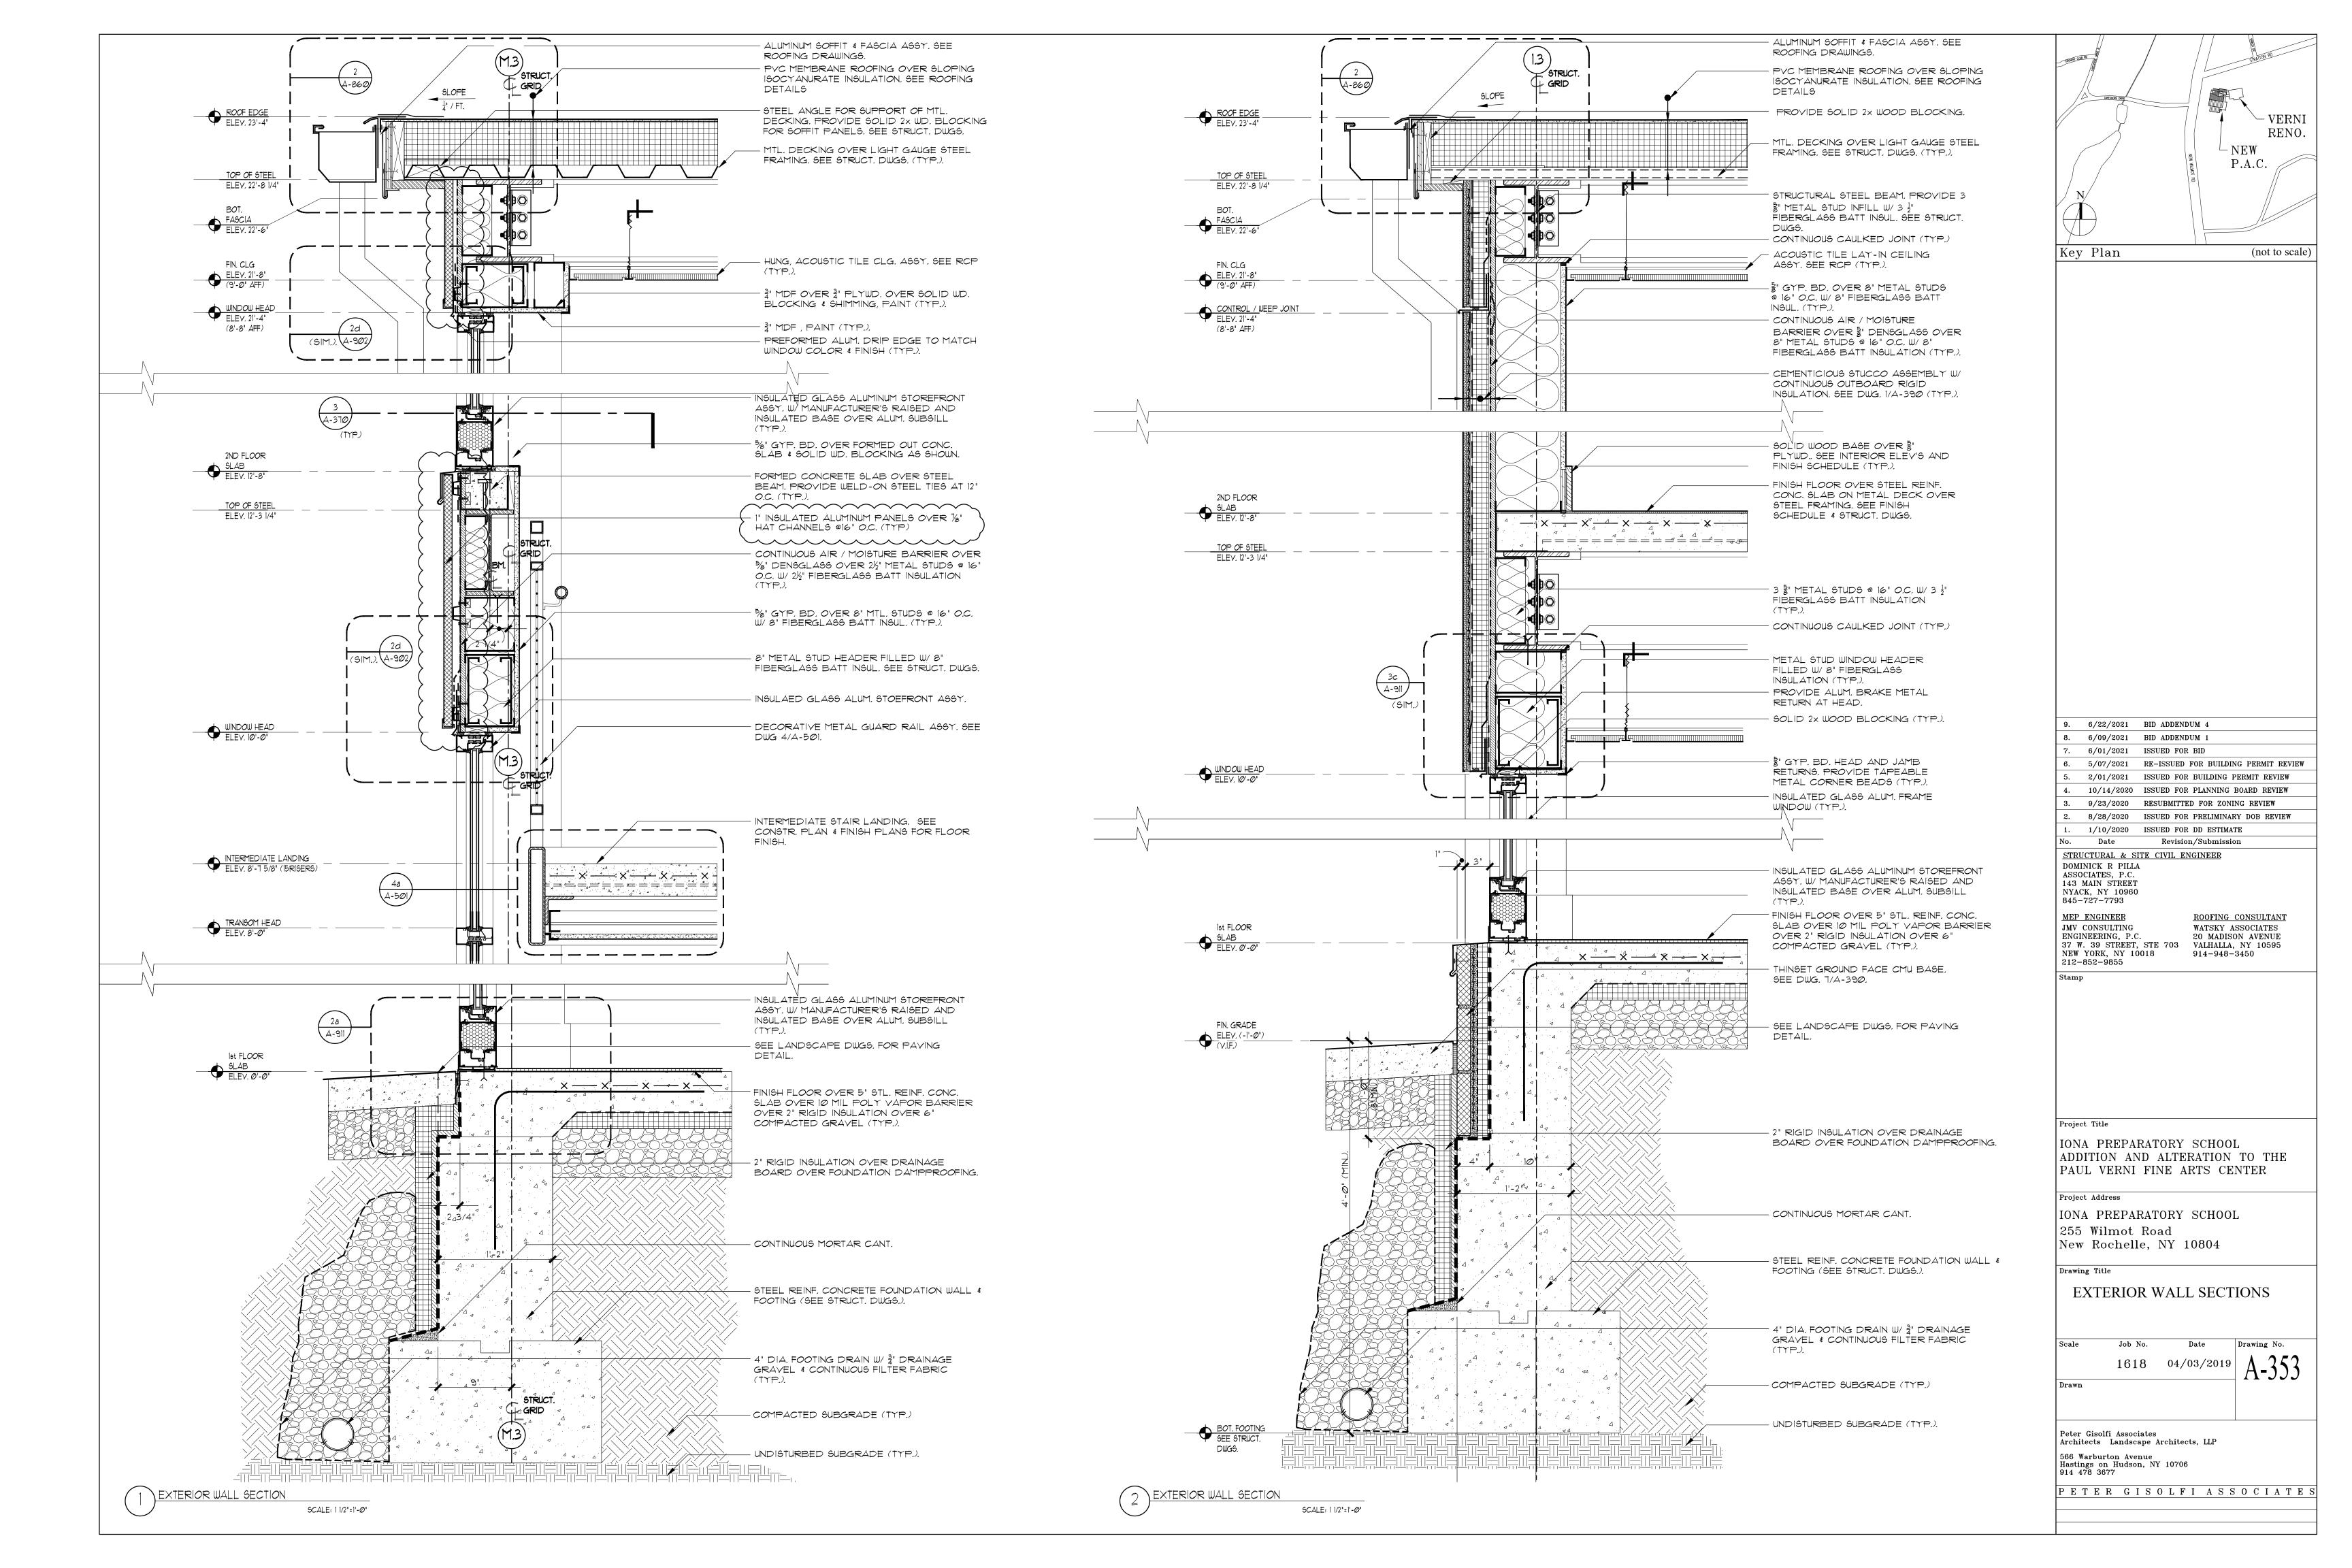

Iona Preparatory School
Addition and Alteration to the
Paul Verni Fine Arts Center
New Rochelle, NY
Page 10 50 30-1

SECTION 10 50 30

CANOPIES

PART 1-GENERAL

1.1 SUMMARY

- A. Section Includes:
 - 1. Building supported metal awnings including framing, enclosure, and attachment hardware.
- B. Related Sections:
 - 1. Division 1: Administrative, procedural, and temporary work requirements.
 - 2. Division 5: Metal Fabrication
 - 3. Division 6: Rough Carpentry

1.2 REFERENCES

- A. Aluminum Association (AA)DAF 45 Designation System for Aluminum Finishes
- B. American Architectural Manufacturers Association (AAMA)
 - 1. 2603 Voluntary Specification, Performance Requirements and Test Procedures for Pigmented Organic Coatings on Architectural Extrusions and Panels.
- C. American Society of Civil Engineers (ASCE) 7 -Minimum Design Loads for Buildings and Other Structures.
- D. ASTM International (ASTM)
 - 1. B221 -Standard Specification for Aluminum and Aluminum-Alloy Extruded Bars, Rods, Wire, Profiles, and Tubes.
 - 2. B429-Standard Specification for Aluminum-Alloy Extruded Pipe and Tube.

1.3 SYSTEM DESCRIPTION

- A. Design Requirements: Design awning system to withstand:
 - 1. Standards for wind pressure, snow load, and drifting snow load in accordance with current adopted form of the Uniform Construction code or accepted requirements of local municipality.

1.4 SUBMITTALS

- A. Submittals for Review:
 - 1. Shop Drawings: Indicate system components, dimensions, attachments, and accessories.

- 2. Samples:
 - a. 3 x 3inch coating samples in specified color.
 - b. 6inch decking/ siding samples showing profile and finish.

1.5 QUALITY ASSURANCE

- A. Installer Qualifications: Minimum 5 years experience in installation of MASA products.
- B. Mockup:
 - 1. Provide mockup of awning system including all framing members, enclosure materials, and attachments at location selected by architect.)

PART 2-PRODUCTS

2.1 MANUFACTURER

A. Contract Documents are based on:
 MASA Architectural Canopies - Extrudeck Series
 250 Shelton Road, Piscataway, NJ 08854
 800-761-7446
 www.architecturalcanopies.com.

2.2 MATERIALS

- A. Aluminum Extrusions:
 - 1. ASTM B221& ASTM B429 6063-T5 alloy and temper.
- B. Hardware:
 - 1. All fasteners shall be stainless steel or hot dip galvanized for corrosion resistance.

2.3 COMPONENTS

- A. Framing:
 - 1. Type: Extruded aluminum "J" channel fascia
 - 2. Size: 8" x .125"
- B. Canopy Supports: Extruded Aluminum Canopy Support "I" Beam
- C. Decking: 3" x 6" x .090" Interlocking Extruded aluminum flat soffit decking (as selected from MASA decking options)
- D. Attachment; 1.050" diameter steel hanger rod, finished to match canopy color
- E. Custom Fascia Profiles: As shown on drawings
- F. Other Components: other components as indicated or as required for system attachment and performance.

2.4 ACCESSORIES

A. Anchors and Fasteners: Stainless steel or hot dip galvanized and corrosion resistant

2.5 FABRICATION

A. Fabricate canopy system in accordance with approved Shop Drawings.

2.6 FINISHES

A. Aluminum:

- A.1 Pre-Treatment: Pre-treat to ASTM D1730 type B, Method 5 using a multi stage chromate process or an approved chrome- free pretreatment process approved by powder coat manufacturer for optimized weather resistance.
- 1. Type AAMA 2603 Thermosetting Polyester Resin-based Powder
- 2. Source: Tiger Drylac powder coating or equivalent.
- 3. Color: (color) to be selected by architect from MASA's standard 5 colors

Aluminum or Steel

- 1. AAMA 2605, Fluoropolymer coating containing minimum 70% PVDF resins
- 2. Source: Duranar by PPG Industries, Inc.
- 3. Color: (color) to be selected by architect from MASA's full color range

PART 3-EXECUTION

3.1 FIELD DIMENSIONS

A. Field verify dimensions of supporting structure and any openings at site of installation prior to fabrication.

3.2 INSTALLATION

- A. Install in accordance with manufacturer's instructions and approved Shop Drawings.
- B. Install components plumb and level, in proper plane, free from warp and twist.
- C. Anchor system to building components; provide adequate clearance for movement caused by thermal expansion and contraction and wind loads.

3.3 ADJUSTING

A. Touch up minor scratches and abrasions on finished surfaces to match original finish.

END OF SECTION