


EXISTING UPRIGHT SPRINKLER HEAD; REMOVE & INSTALL NEW PENDANT HEAD IN LOCATION SHOWN SPRINKLER PIPING — EXISTING UPRIGHT SPRINKLER HEAD; REMOVE & INSTALL NEW PENDANT HEAD IN LOCATION SHOWN


SECOND FLOOR TOILET ROOM FIRE SPRINKLER PLAN (ROOM 209)

3 SCALE: 1/2" = 1'-0" — EXISTING UPRIGHT __SPRINKLER HEAD; REMOVE & INSTALL NEW PENDANT HEAD IN LOCATION SHOWN - EXISTING SPRINKLER PIPING EXISTING UPRIGHT SPRINKLER HEAD; REMOVE & INSTALL NEW PENDANT HEAD IN LOCATION SHOWN

> → THIRD FLOOR SHOWER ROOM FIRE SPRINKLER PLAN (ROOM 303) $\sqrt{\text{SCALE: } 1/2" = 1'-0"}$

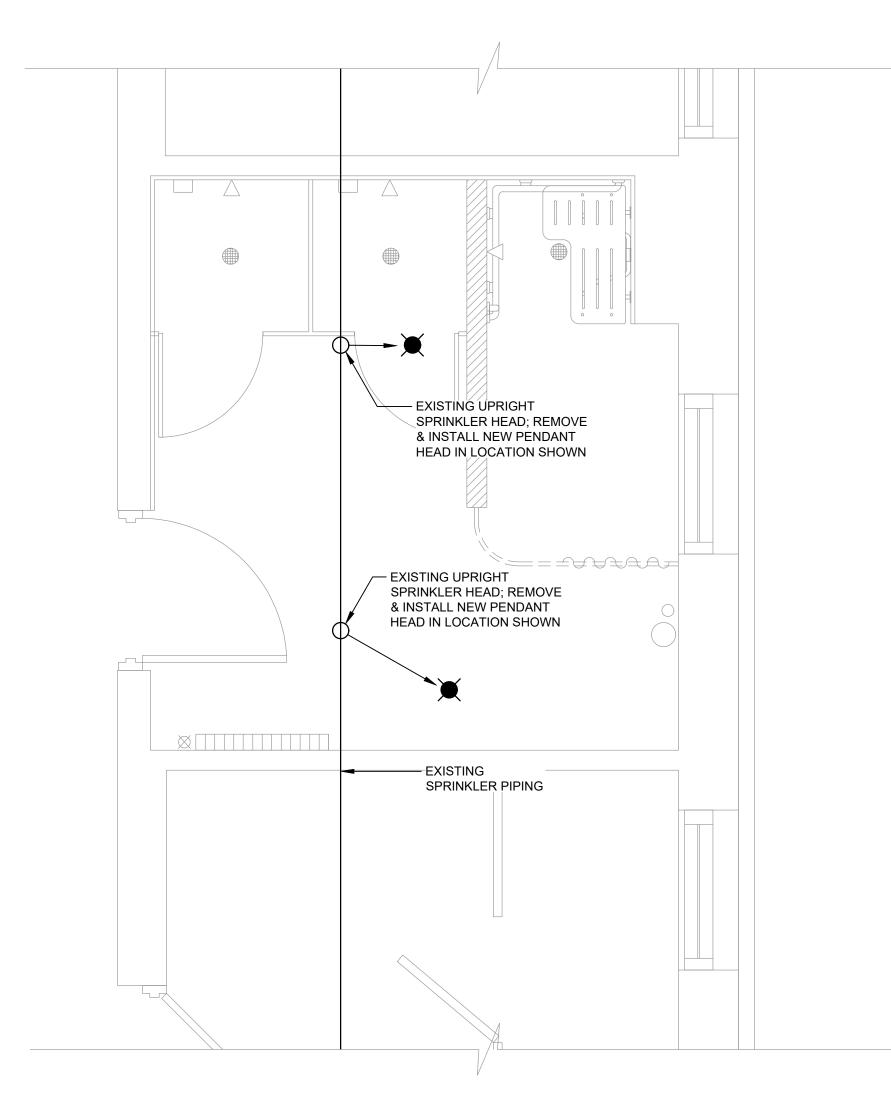

SECOND FLOOR SHOWER ROOM FIRE SPRINKLER PLAN (ROOM 207) SCALE: 1/2" = 1'-0"

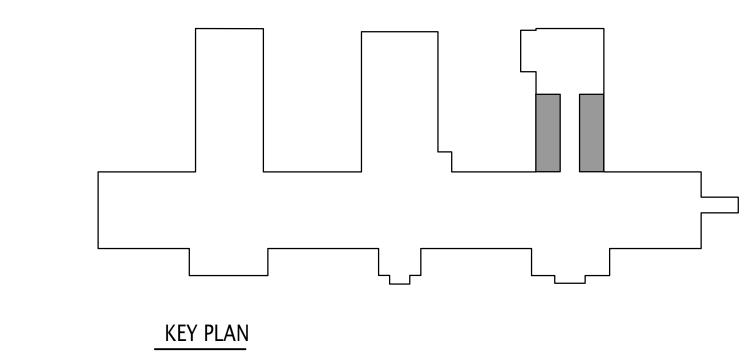

G. No Victaulic "hooker" fittings or Victaulic Style 921 or 925 fittings shall be used.

LEGEND NEW RECESSED CONCEALED QUICK RESPONSE SPRINKLER HEAD INSTALLED IN NEW GYPSUM

1. SEE ARCHITECTURAL REFLECTED CEILING PLANS FOR EXACT HEAD LOCATIONS 2. NO ISOLATION VALVES WERE OBSERVED IN THE FIRE SPRINKLER SYSTEM; THEREFORE THE ENTIRE SYSTEM MAY NEED TO BE DRAINED TO PERFORM THE MODIFICATIONS

MATERIAL SPECIFICATIONS:

- A. All pipe used for fire protection sprinkler systems shall comply with NFPA 13, NFPA 24, and FM requirements. B. All aboveground pipe shall be Schedule 40 and shall meet the requirements of the ANSI/ASTM standards listed in NFPA 13 and NFPA 14. C. Schedule 10 pipe may be used for pipes 2 1/2 inches, 3 inches and larger if joined by welding or by roll-grooved pipe and fittings, in accordance with
- 1.2 Pipe Fittings:
- A. Fittings for Schedule 40 piping 1 inch through 2 inches shall be screwed fittings. Fittings for 2 1/2 inch and larger pipe shall be screwed, flanged or grooved couplings. All fittings shall be cast iron, ductile iron, malleable iron, or steel and shall comply with ANSI/ASTM standards as listed in NFPA 13. B. Grooved mechanical couplings shall be of ductile iron or malleable iron housing with a synthetic rubber gasket of a central cavity pressure- responsive design and nuts, bolts, locking pins, or lugs to secure roll-grooved pipe and fittings. Gaskets shall be nonasbestos.

 C. Welding and joining of pipe and fittings shall conform to NFPA 13 requirements. Only shop welding with appropriate welding fittings shall be used.
- D. Mechanical sleeve seals shall consist of interlocking synthetic rubber links shaped to continuously fill annular space between pipe and sleeve connected with bolts and pressure plates that cause rubber sealing elements to expand when tightened, providing a watertight seal. E. Fittings for underground piping shall be ductile iron and shall meet the requirements of ASTM A 395.

1.3 Pipe Supports and Hangers:

- A. All types of hangers, attachments, and methods of installation shall be in accordance with NFPA 13 and NFPA 14 and FM requirements. All components of hanger assemblies shall be UL-listed and FM approved for use in sprinkler systems. B. If used, all C-clamps shall utilize both locknuts and retaining devices furnished by the manufacturer. C-clamp bodies shall not be constructed from bent
- plates. Only top beam C-clamps shall be used. C. Special hangers and methods of installation shall be certified by a registered professional engineer in accordance with the requirements of NFPA 13. Hanger rods shall be threaded on both ends.

1.4 Sprinklers:


A. All sprinklers shall be UL-listed and FM-approved fusible ink glass bulb type. Sprinkler orifice size shall not be smaller than 1/2 inch. Orifice size, K-factor, temperature rating, and model identification of installed sprinkler shall be identical to system hydraulic calculation data. B. Chrome pendent recessed quick response sprinklers shall be used on all areas with suspended ceilings and concealed piping unless otherwise noted. Upright or pendent sprinklers shall be used in all areas with exposed piping unless otherwise noted.



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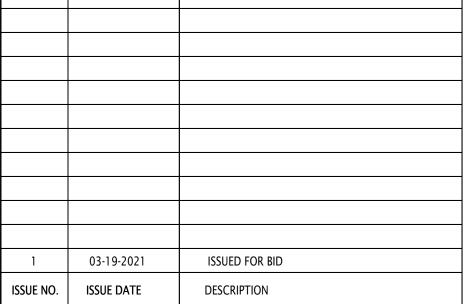
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MECH'L/ELEC'L/PLUMBING ENGINEERS



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ALTERATIONS TO
BUILDING # 51,
EMERGENCY HOUSING
GROUP
38 SEWARD AVENUE

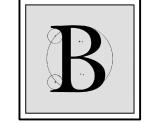MIDDLETOWN, NY 10940

SECOND AND THIRD FLOORS SHOWER AND TOILET ROOMS FIRE SPRINKLER PLANS

PROJECT NO.: 1802-01

DRAWING NO.:

FP-200