



MECHANICAL DEMOLITION PLAN NOTES

- ① EXISTING RETURN GRILL TO BE DEMOLISHED. DEMOLISH DUCTWORK BACK TO ROOF PENETRATION.
- ② EXISTING HOT WATER UNIT HEATER TO BE DEMOLISHED. DEMOLISH EXISTING HOT WATER SUPPLY AND RETURN PIPES BACK TO MAINS AND CAP.
- ③ EXISTING 10" EXHAUST FROM BELOW ROUTED TO ROOF TO REMAIN.
- ④ EXISTING KITCHEN HOOD TO BE DEMOLISHED. DEMOLISH ALL ASSOCIATED DUCTWORK, EXHAUST FANS, MAKE-UP AIR UNITS, CONTROLS, AND SERVICES.
- ⑤ EXISTING SUPPLY AND RETURN DUCTWORK FROM EXISTING RTU TO BE DEMOLISHED.
- ⑥ EXISTING WINDOW AIR CONDITIONER TO BE DEMOLISHED.
- ⑦ EXISTING WALL MOUNTED UV LIGHT UNIT TO BE REMOVED AND REINSTALLED AFTER NEW WORK.
- ⑧ EXISTING WALK-IN COOLER/FREEZER COMPRESSORS TO BE DEMOLISHED. DEMOLISH ASSOCIATED REFRIGERANT PIPING, CONTROLS, AND SERVICES.
- ⑨ EXISTING EXHAUST DUCTWORK FROM EXISTING DISHWASHER TO BE DEMOLISHED.
- ⑩ SECTION OF EXISTING CHILLED WATER SUPPLY AND RETURN PIPES TO BE DEMOLISHED AND REPLACED WITH NEW BURIED PIPES.
- ⑪ EXISTING THROUGH THE WALL AIR CONDITIONER TO BE RELOCATED. REMOVE UNIT AND REINSTALL AFTER NEW WORK HAS BEEN PERFORMED.

1 MECHANICAL TERRACE DEMOLITION PART PLAN
SCALE: 1/4" = 1'-0"

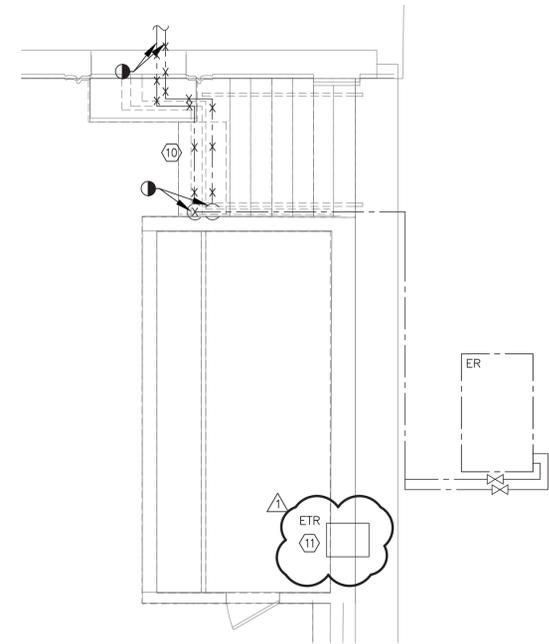


2 MECHANICAL DEMOLITION PLAN
SCALE: 1/4" = 1'-0"

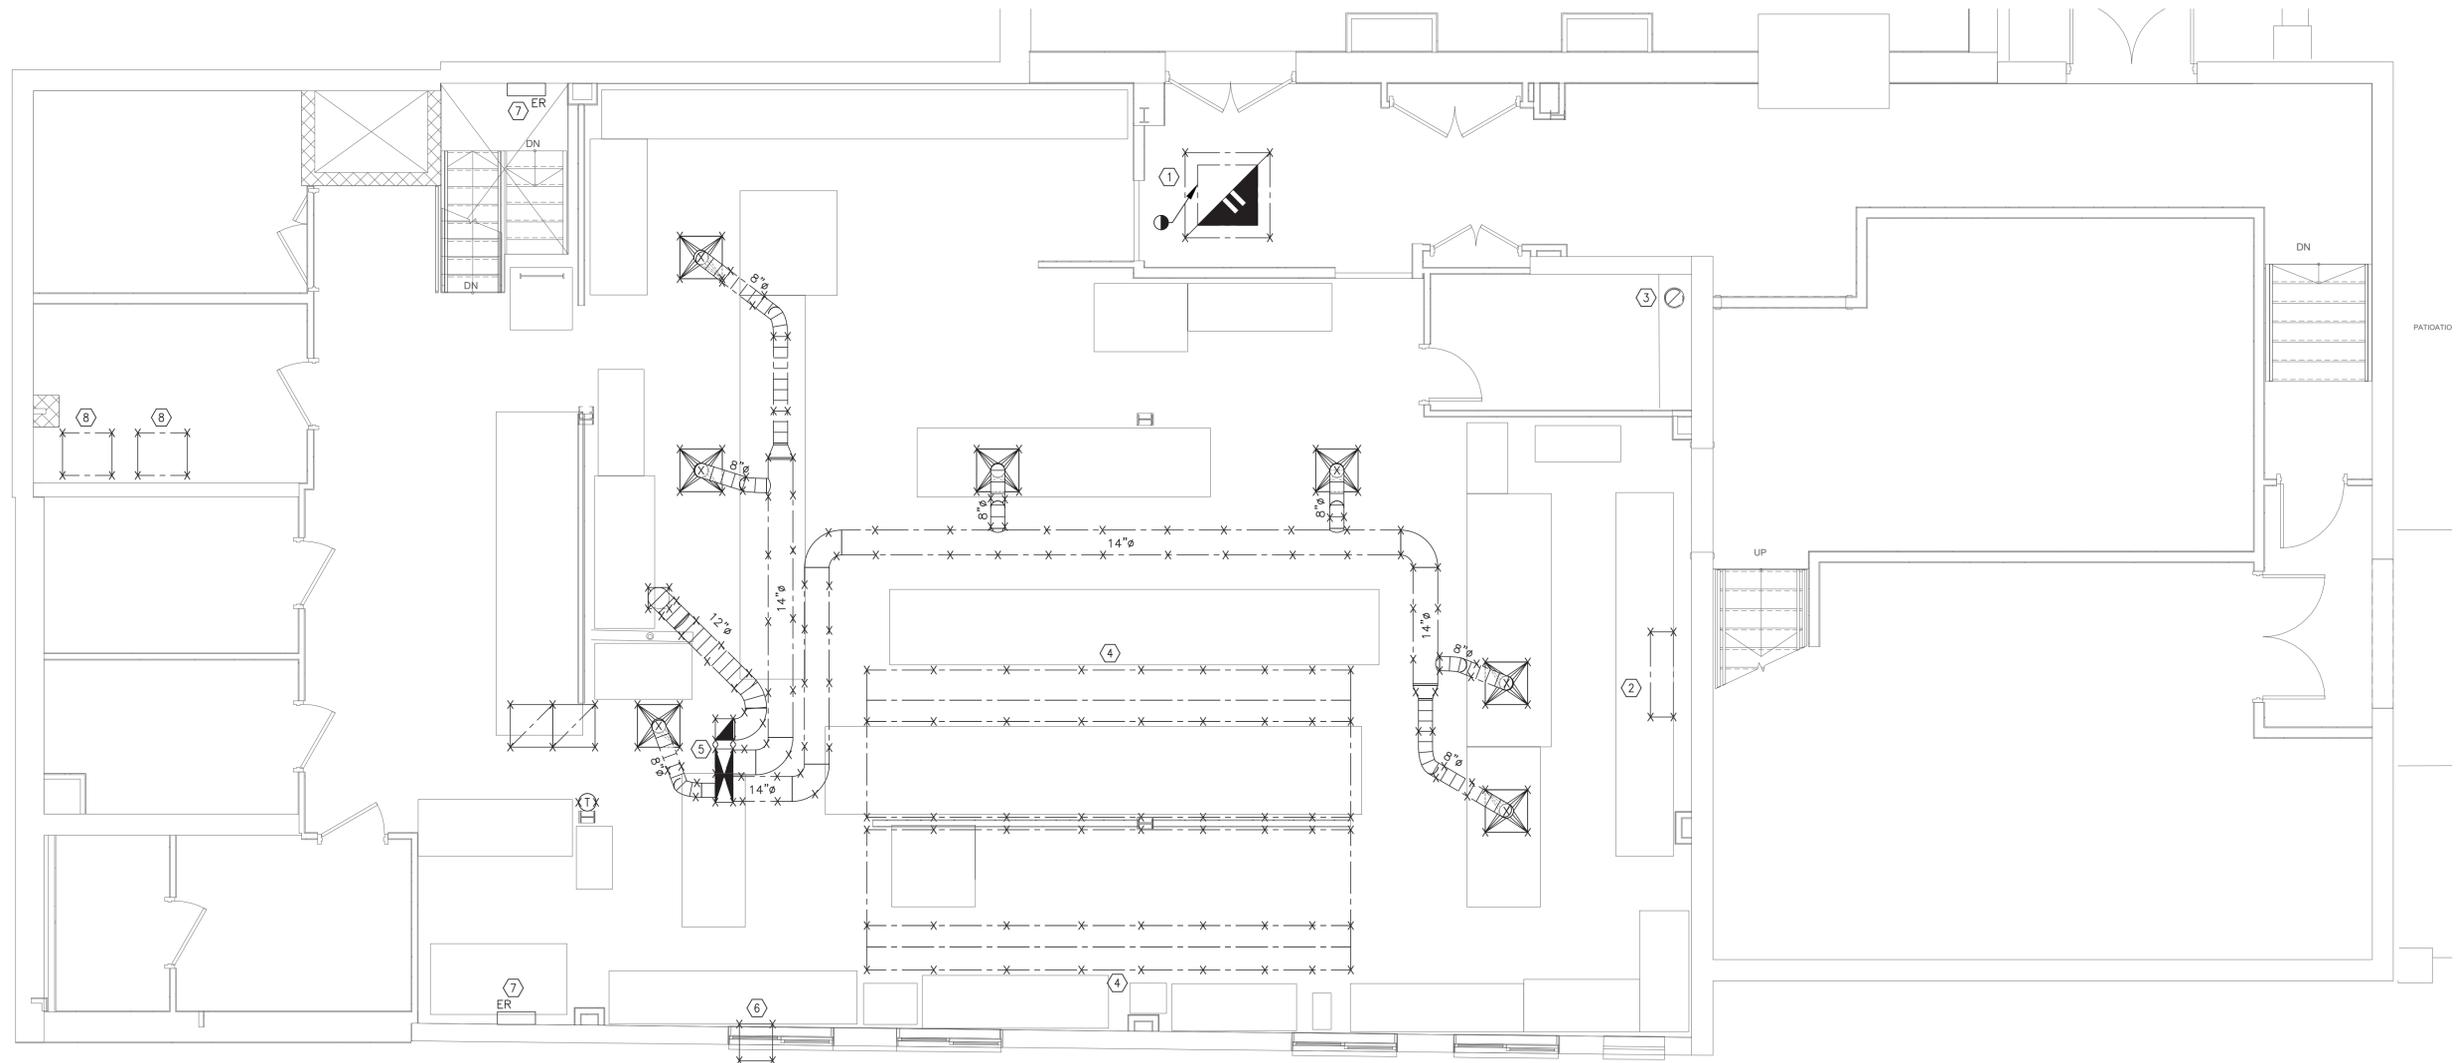

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1	09.17.21		

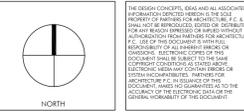

OLD OAKS COUNTRY CLUB

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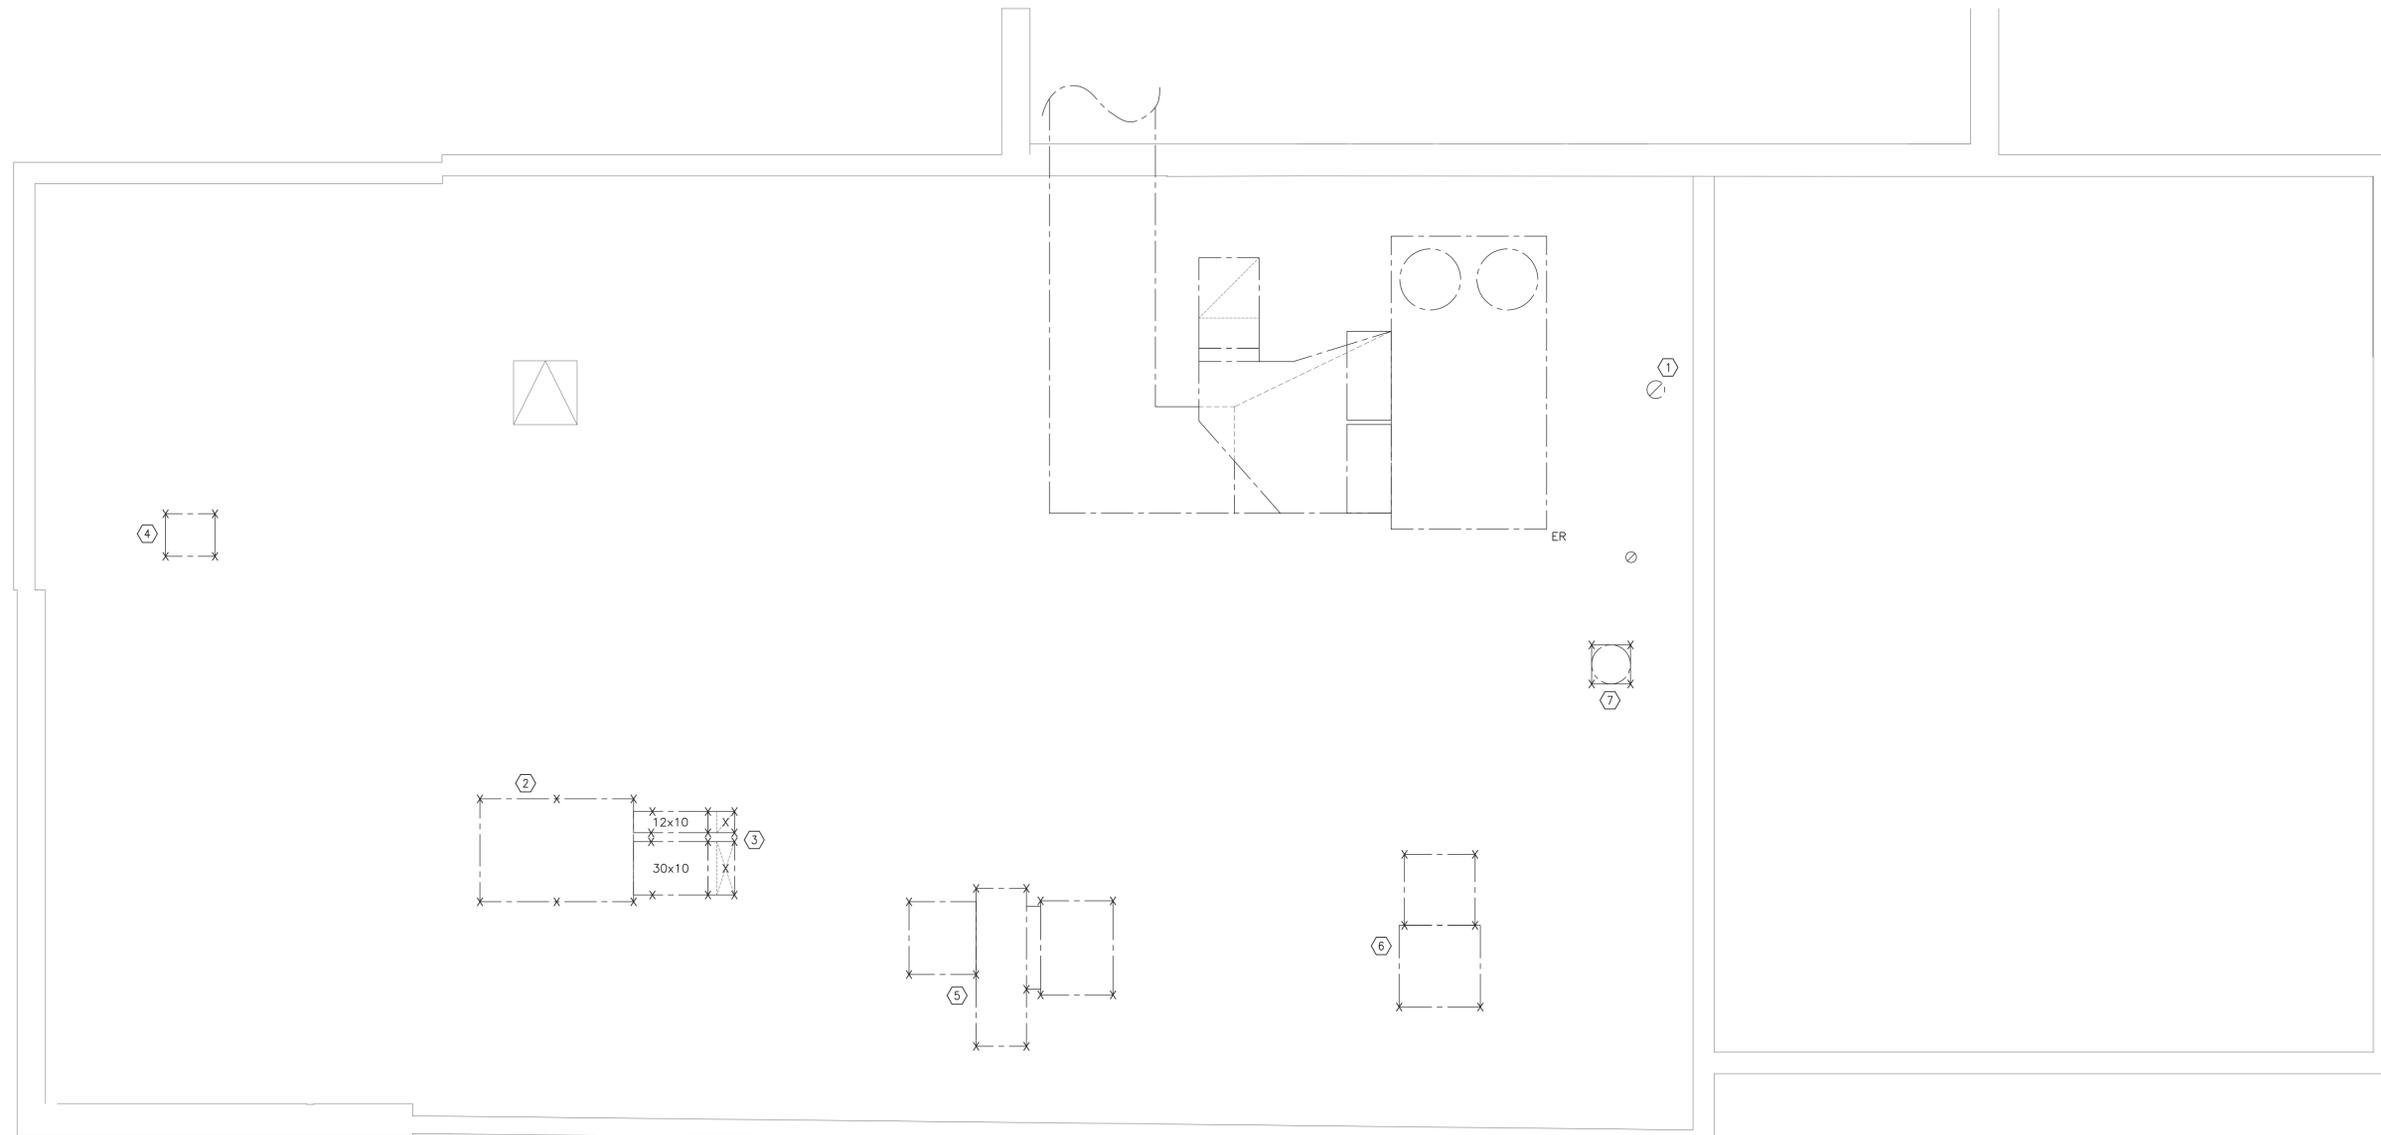
**MECHANICAL
DEMOLITION PLAN**

SEAL & SIGNATURE	DATE: 08-13-21
	PROJECT NO.: 21-826
	DRAWN BY: CH
	CHECKED BY: TL
	DRAWING NO.: M100.00
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MECHANICAL DEMOLITION PLAN NOTES

- ① EXISTING 10"Ø EXHAUST TO REMAIN.
- ② EXISTING RTU TO BE DEMOLISHED. DEMOLISH ASSOCIATED DUCTWORK AND CONTROLS. EXISTING ROOF CURB TO REMAIN AND BE REUSED.
- ③ EXISTING RETURN DUCTWORK ROOF PENETRATION TO BE CAPPED AND SEALED. EXISTING SUPPLY DUCTWORK ROOF PENETRATION TO REMAIN AND BE REUSED.
- ④ EXISTING WALK-IN COOLER/FREEZER COMPRESSOR TO BE DEMOLISHED. DEMOLISH ASSOCIATED REFRIGERANT PIPING, CONTROLS, AND SERVICES.
- ⑤ EXISTING EXHAUST FAN SERVING KITCHEN HOODS TO BE DEMOLISHED. DEMOLISH ASSOCIATED DUCTWORK, CONTROLS, AND SERVICES. EXISTING ROOF PENETRATION TO BE CAPPED AND SEALED.
- ⑥ EXISTING MAKE-UP AIR UNIT SERVING KITCHEN HOODS TO BE DEMOLISHED. DEMOLISH ASSOCIATED DUCTWORK, CONTROLS, AND SERVICES. EXISTING ROOF PENETRATION TO REMAIN AND BE REUSED.
- ⑦ EXISTING EXHAUST FAN SERVING DISHWASHER TO BE DEMOLISHED. DEMOLISH ASSOCIATED DUCTWORK, CONTROLS, AND SERVICES. ROOF PENETRATION TO BE CAPPED AND SEALED.



1 MECHANICAL ROOF DEMOLITION PLAN
SCALE: 1/4" = 1'-0"

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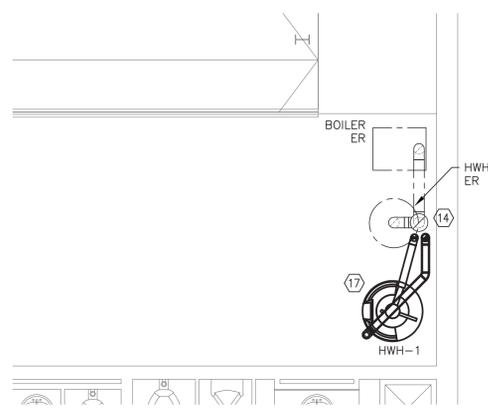
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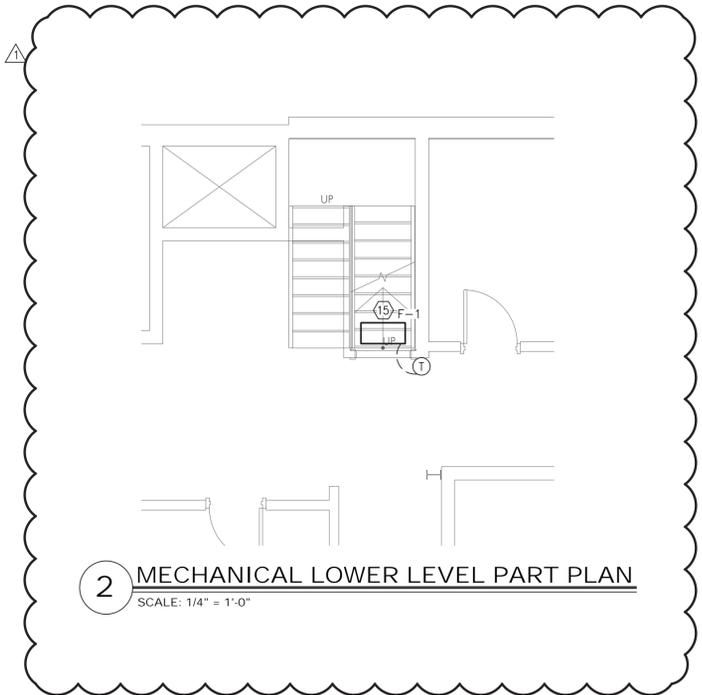
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MECHANICAL ROOF DEMOLITION PLAN

SEAL & SIGNATURE	DATE: 08-13-21
	PROJECT NO.: 21-826
	DRAWN BY: CH
	CHECKED BY: TL
	DRAWING NO.: M101.00
	CAD FILE NO.: 21/Proj2016/694 BASIS



1 MECHANICAL LOWER LEVEL PART PLAN
SCALE: 1/4" = 1'-0"




2 MECHANICAL LOWER LEVEL PART PLAN
SCALE: 1/4" = 1'-0"

MECHANICAL PLAN NOTES

- 1 PROVIDE NEW RETURN DUCTWORK TO EXISTING SIDEWALL RETURN GRILL. VERIFY IN FIELD EXACT CONNECTION SIZE OF EXISTING SIDEWALL RETURN GRILL.
- 2 EXISTING WALL MOUNTED UV LIGHT UNITS TO BE REINSTALLED. COORDINATE EXACT LOCATIONS IN FIELD.
- 3 SUPPLY DUCTWORK FROM NEW RTU-1. ROUTE DUCTWORK BETWEEN JOISTS TO CLEAR BEAM CROSSOVERS.
- 4 PROVIDE NEW WALL MOUNTED 7-DAY PROGRAMMABLE THERMOSTAT WITH HUMIDITY SENSOR TO SERVE NEW RTU-1.
- 5 24x24 EXHAUST DUCT FROM EF-1 ON ROOF TO SERVE KITCHEN HOOD. ALL EXHAUST DUCTWORK SHALL BE BLACK IRON FOR GREASE DUCT APPLICATION. PROVIDE FIRE WRAP AROUND DUCTWORK FOR 0" CLEARANCE TO COMBUSTIBLE MATERIAL. BALANCE EXHAUST TO EACH HOOD SECTION PER HOOD SCHEDULE. EF-1 SHALL BE CONTROLLED BY HOOD AUTO FAN CONTROLLER WITH DEMAND CONTROL VENTILATION.
- 6 30x18 SUPPLY DUCT FROM MUA-1 ON ROOF TO SERVE KITCHEN HOOD. BALANCE SUPPLY TO EACH SUPPLY PLENUM PER HOOD SCHEDULE. MUA-1 SHALL BE CONTROLLED BY HOOD AUTO FAN CONTROLLER WITH DEMAND CONTROL VENTILATION.
- 7 PROVIDE NEW REMOTE ANSUL R-102 FIRE SUPPRESSION SYSTEM TO SERVE HOODS H-1S1 AND H-1S2. MOUNT CABINET HIGH ON WALL.
- 8 PROVIDE REMOTE AUTO FAN CONTROLLER WITH DEMAND CONTROL VENTILATION TO SERVE HOODS H-1S1 AND H-1S2. CONTROLLER SHALL CONTROL EF-1 AND MUA-1.
- 9 22x22 EXHAUST DUCT FROM EF-2 ON ROOF TO SERVE KITCHEN HOOD. ALL EXHAUST DUCTWORK SHALL BE BLACK IRON FOR GREASE DUCT APPLICATION. PROVIDE FIRE WRAP AROUND DUCTWORK FOR 0" CLEARANCE TO COMBUSTIBLE MATERIAL. BALANCE EXHAUST TO EACH HOOD SECTION PER HOOD SCHEDULE. EF-2 SHALL BE CONTROLLED BY HOOD AUTO FAN CONTROLLER WITH DEMAND CONTROL VENTILATION.
- 10 22x16 SUPPLY DUCT FROM MUA-2 ON ROOF TO SERVE KITCHEN HOOD. BALANCE SUPPLY TO EACH SUPPLY PLENUM PER HOOD SCHEDULE. MUA-2 SHALL BE CONTROLLED BY HOOD AUTO FAN CONTROLLER WITH DEMAND CONTROL VENTILATION.
- 11 PROVIDE NEW REMOTE ANSUL R-102 FIRE SUPPRESSION SYSTEM TO SERVE HOODS H-2S1 AND H-2S2. MOUNT CABINET HIGH ON WALL.

MECHANICAL PLAN NOTES


- 12 PROVIDE REMOTE AUTO FAN CONTROLLER WITH DEMAND CONTROL VENTILATION TO SERVE HOODS H-2S1 AND H-2S2. CONTROLLER SHALL CONTROL EF-2 AND MUA-2.
- 13 10x10 EXHAUST DUCT FROM EF-3 ON ROOF TO SERVE DISH WASHER. CONNECT EXHAUST DUCTWORK TO EXHAUST COLLARS ON DISHWASHER. BALANCE EXHAUST TO 175 CFM ON ENTRANCE END AND 375 CFM ON DISCHARGE END OF DISHWASHER. EF-3 SHALL BE CONTROLLED BY DISHWASHER EXHAUST FAN CONTROLLER.
- 14 EXISTING 10" EXHAUST FROM EXISTING BOILER AND HOT WATER HEATER ROUTED TO ROOF TO REMAIN.
- 15 PROVIDE NEW AIR CURTAIN F-1 WITH ELECTRIC HEAT AT STAIRWELL ENTRANCE. PROVIDE WITH MANUFACTURER CONTROL SWITCH TO CONTROL FAN AND HEAT SEPARATELY. PROVIDE WALL MOUNTED THERMOSTAT FOR HEAT CONTROL. INSTALL PER MANUFACTURER'S INSTALLATION INSTRUCTIONS.
- 16 NOT USED.
- 17 PROVIDE NEW 4" INTAKE AND 4" VENT TO SERVE NEW HOT WATER HEATER HWH-1. ROUTE INTAKE AND VENT UP TO ROOF NEXT TO EXISTING 10" VENT. AT ROOF TERMINATE PER MANUFACTURER'S INSTALLATION INSTRUCTIONS.
- 18 NEW 4" INTAKE AND 4" VENT FROM NEW HOT WATER HEATER ON FLOOR BELOW. ROUTE INTAKE AND VENT TO ROOF AND TERMINATE PER MANUFACTURER'S INSTALLATION INSTRUCTIONS.

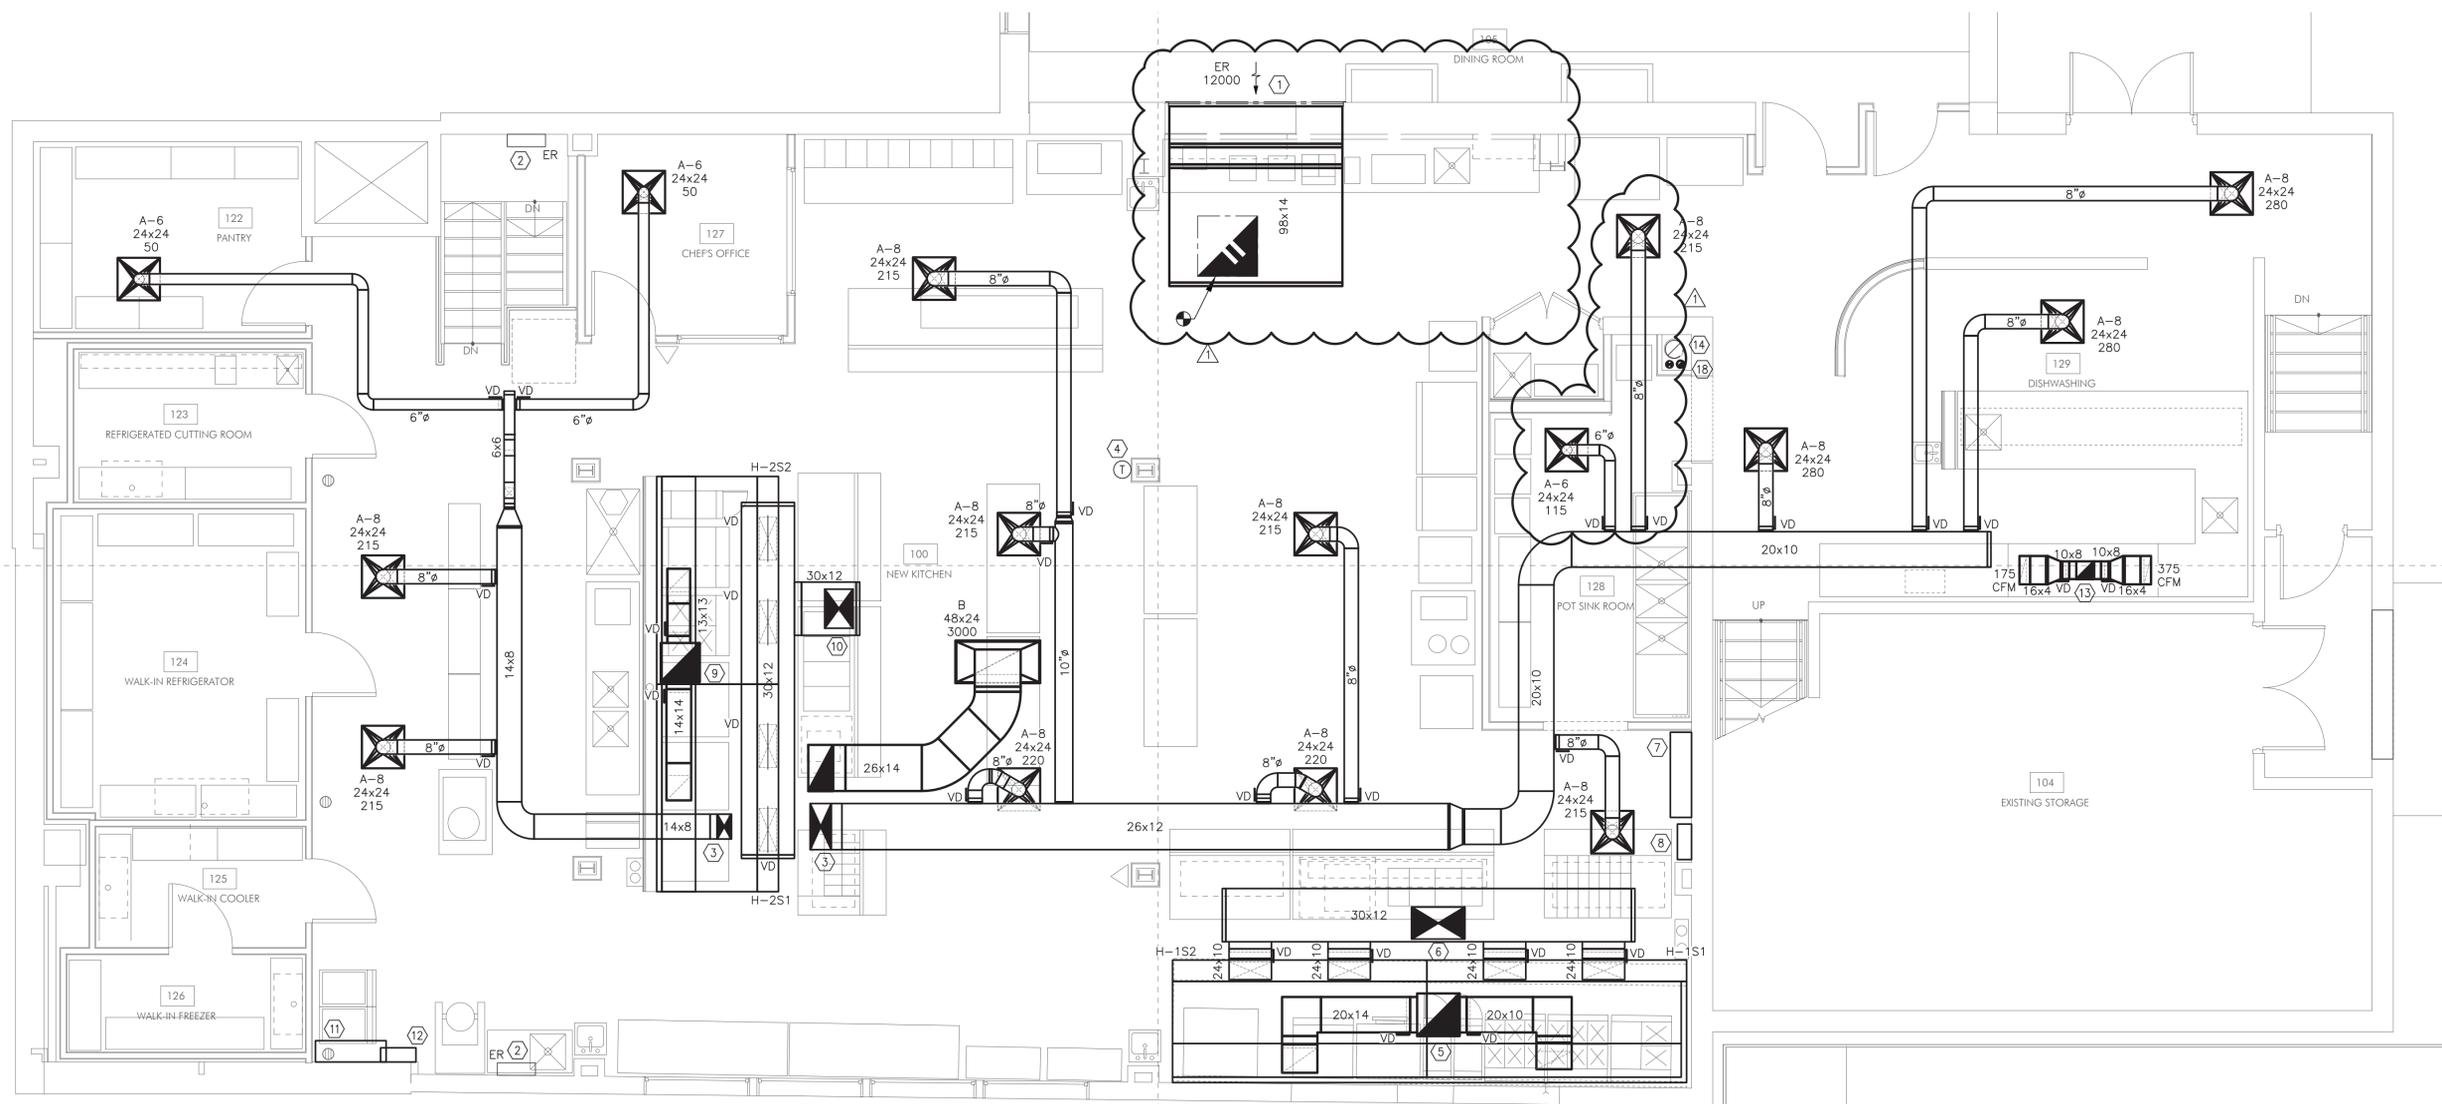

3 MECHANICAL FLOOR PLAN
SCALE: 1/4" = 1'-0"

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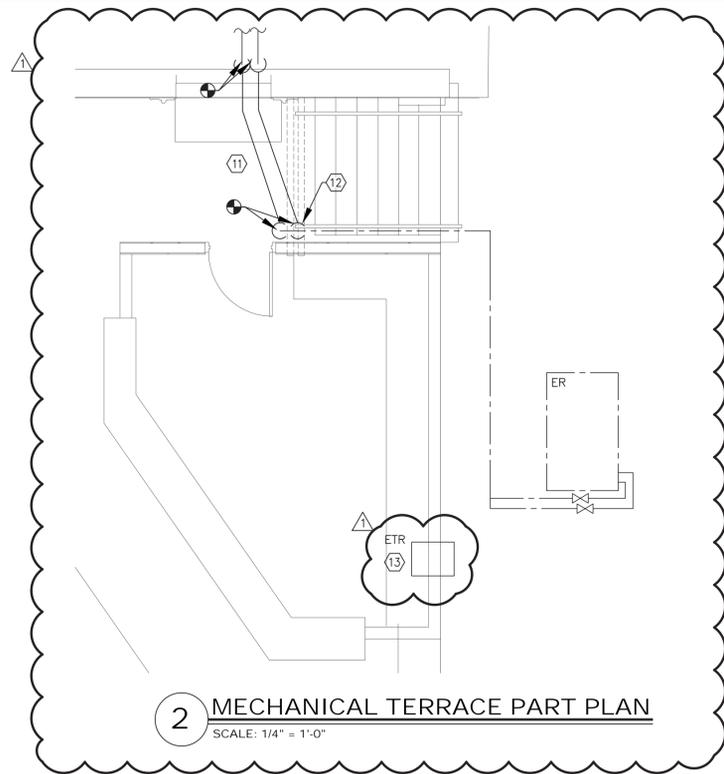


OLD OAKS COUNTRY CLUB
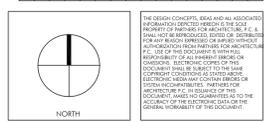
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MECHANICAL FLOOR PLAN


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	PROJECT NO.: 21-826
	DRAWN BY: CH
	CHECKED BY: TL
	DRAWING NO.: M200.00
	CAD FILE NO. J:\Proj\2016\194 BASH



MECHANICAL PLAN NOTES

- 1 EXISTING 10"Ø EXHAUST TO REMAIN.
- 2 PROVIDE NEW RTU-1 TO SERVE KITCHEN. MOUNT UNIT ON EXISTING ROOF CURB. UNIT SHALL BE CONTROLLED BY NEW 7-DAY PROGRAMMABLE THERMOSTAT WITH HUMIDITY SENSOR.
- 3 ROUTE 14x8 SUPPLY DUCT DOWN IN EXISTING ROOF PENETRATION. SEAL REMAINING AREA AROUND DUCT.
- 4 PROVIDE NEW EXHAUST FAN EF-1 TO SERVE HOODS H-1S1 AND H-1S2. MOUNT EXHAUST FAN ON EQUIPMENT SUPPORTS WITH VIBRATION ISOLATORS. EF-1 SHALL BE CONTROLLED BY ASSOCIATED HOOD AUTO FAN CONTROLLER WITH DEMAND CONTROL VENTILATION. COORDINATE EXACT LOCATION IN FIELD TO MAINTAIN MINIMUM 10'-0" CLEARANCE FROM ROOF EDGE AND MINIMUM 10'-0" BETWEEN EXHAUST OUTLET AND MECHANICAL OUTSIDE AIR INTAKES.
- 5 PROVIDE NEW MAKE-UP AIR UNIT MUA-1 TO SERVE HOODS H-1S1 AND H-1S2. MOUNT UNIT ON ROOF CURB WITH VIBRATION ISOLATORS. MUA-1 SHALL BE CONTROLLED BY ASSOCIATED HOOD AUTO FAN CONTROLLER WITH DEMAND CONTROL VENTILATION. COORDINATE EXACT LOCATION IN FIELD TO MAINTAIN MINIMUM 10'-0" CLEARANCE FROM ROOF EDGE.
- 6 PROVIDE NEW EXHAUST FAN EF-2 TO SERVE HOODS H-2S1 AND H-2S2. MOUNT EXHAUST FAN ON EQUIPMENT SUPPORTS WITH VIBRATION ISOLATORS. EF-2 SHALL BE CONTROLLED BY ASSOCIATED HOOD AUTO FAN CONTROLLER WITH DEMAND CONTROL VENTILATION. COORDINATE EXACT LOCATION IN FIELD TO MAINTAIN MINIMUM 10'-0" CLEARANCE FROM ROOF EDGE AND MINIMUM 10'-0" BETWEEN EXHAUST OUTLET AND MECHANICAL OUTSIDE AIR INTAKES.
- 7 PROVIDE NEW MAKE-UP AIR UNIT MUA-2 TO SERVE HOODS H-2S1 AND H-2S2. MOUNT UNIT ON ROOF CURB WITH VIBRATION ISOLATORS. MUA-2 SHALL BE CONTROLLED BY ASSOCIATED HOOD AUTO FAN CONTROLLER WITH DEMAND CONTROL VENTILATION.
- 8 PROVIDE NEW EXHAUST FAN EF-3 TO SERVE DISHWASHER. MOUNT UNIT ON NEW ROOF CURB. EF-3 SHALL BE CONTROLLED BY DISHWASHER EXHAUST FAN CONTROLLER.
- 9 PROVIDE NEW COMPRESSOR TO SERVE WALK-IN COOL/FREEZER. COORDINATE EXACT LOCATION IN FIELD TO MAINTAIN MINIMUM 10'-0" CLEARANCE FROM ROOF EDGE.
- 10 4"Ø INTAKE AND 4"Ø VENT FROM HOT WATER HEATER HWH-1. TERMINATE INTAKE AND VENT PER MANUFACTURER'S INSTALLATION INSTRUCTIONS.
- 11 PROVIDE NEW CHILLED WATER SUPPLY AND RETURN PIPES FULL SIZE OF EXISTING. NEW BURIED PIPES TO BE INSTALLED MINIMUM 12" BELOW GRADE. NEW BURIED PIPES TO BE PRE-INSULATED PIPING SYSTEM SIMILAR TO INSUL-TEK OR APPROVED EQUAL.
- 12 PROVIDE NEW DRAIN VALVE LOW IN CHILLED WATER SUPPLY PIPE TO CHILLER.
- 13 EXISTING THROUGH THE WALL AIR CONDITIONER TO RELOCATED. REINSTALL AFTER NEW WORK HAS BEEN PERFORMED.


2 MECHANICAL TERRACE PART PLAN
SCALE: 1/4" = 1'-0"

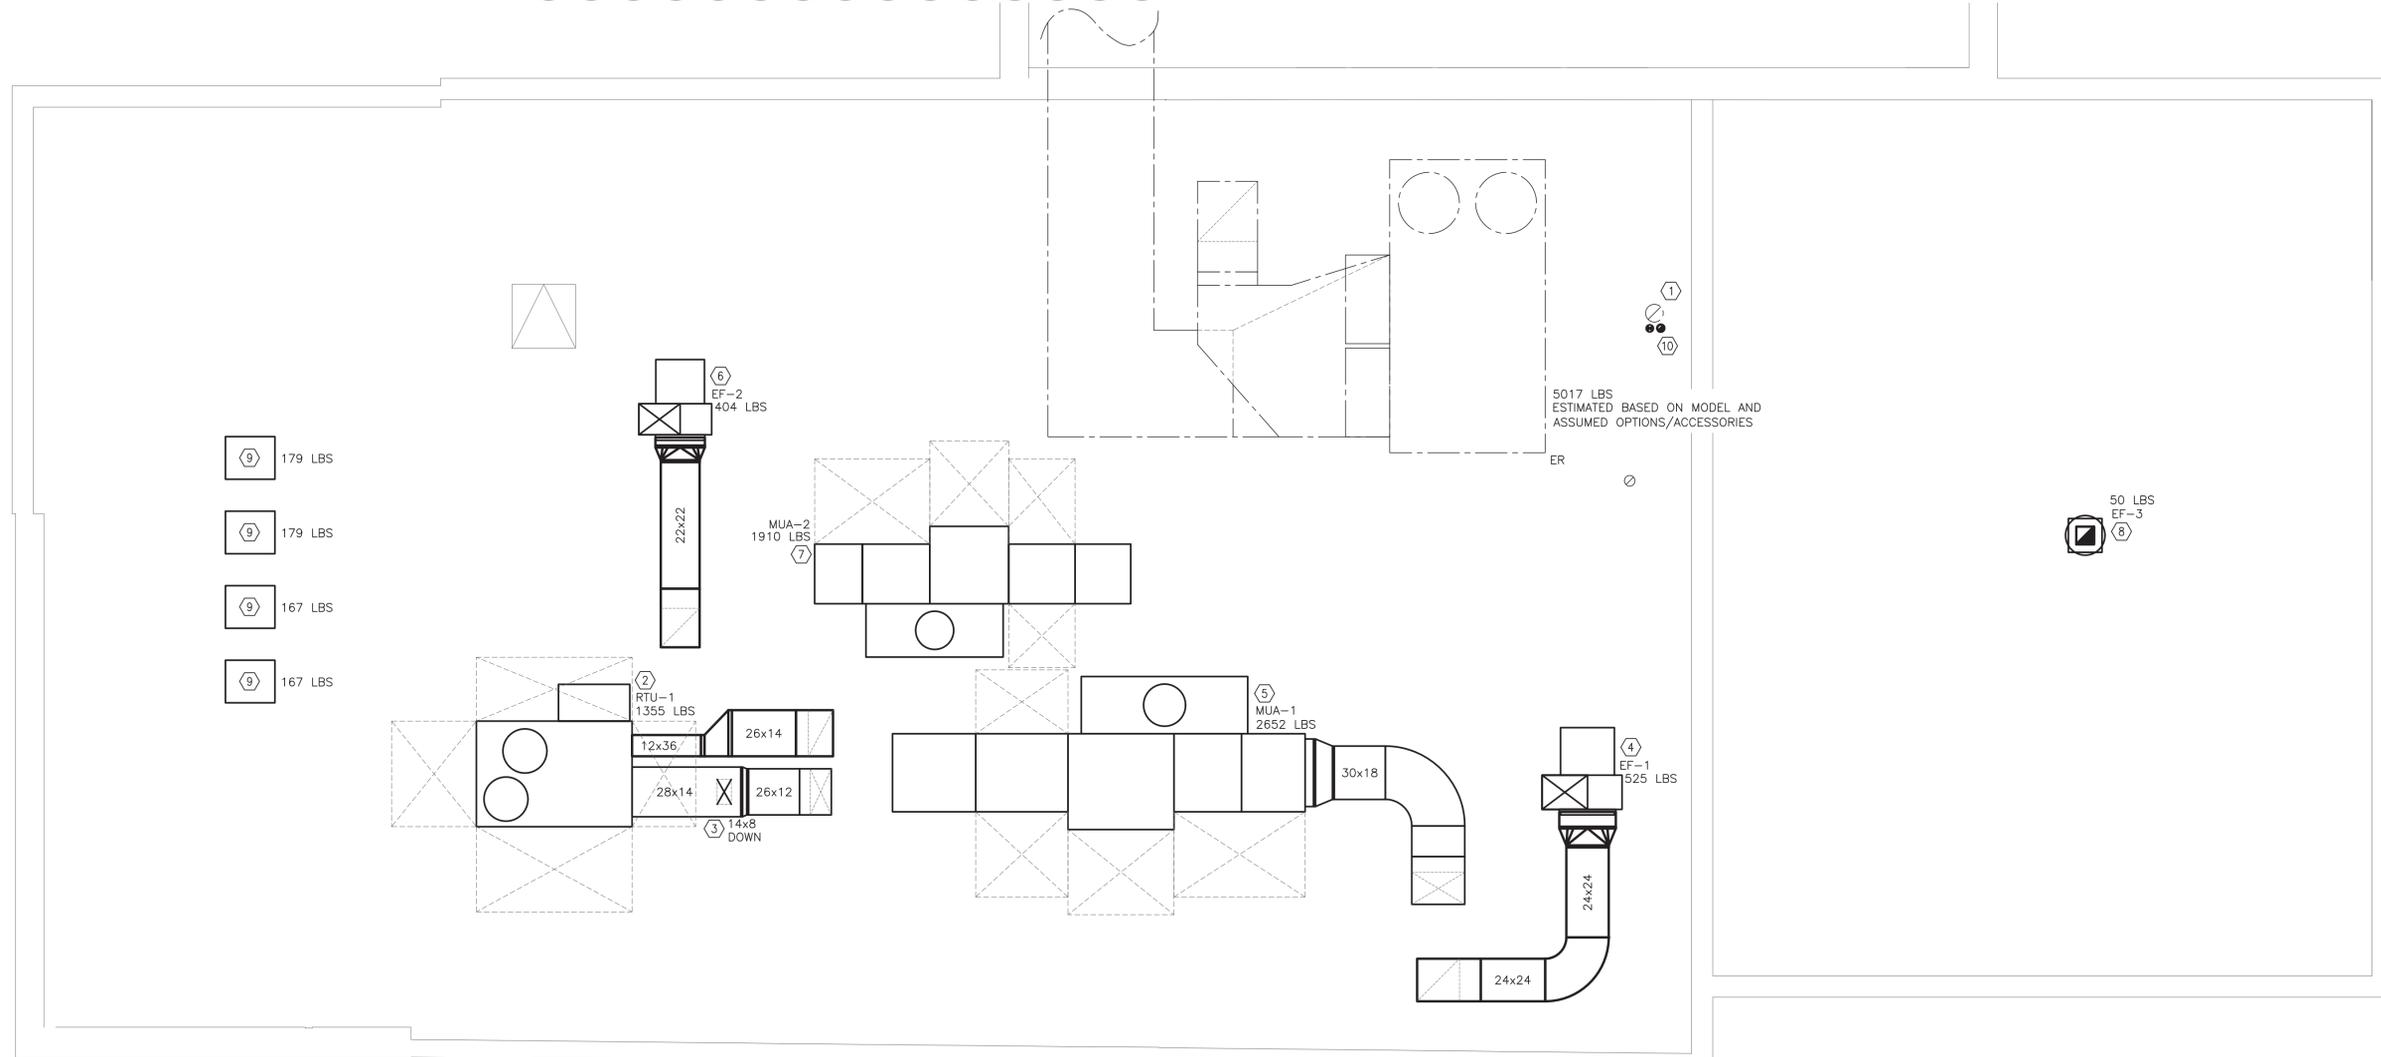

1 MECHANICAL ROOF PLAN
SCALE: 1/4" = 1'-0"

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MECHANICAL ROOF PLAN

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	DRAWN BY: CH
	CHECKED BY: TL
	DRAWING NO.: M201.00
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ROOFTOP UNIT SCHEDULE																								
UNIT TAG	SUPPLY FAN				MIN OUTSIDE AIR (CFM)	COOLING				ELECTRICAL			HEATING			MIN EER	FILTER	MANUFACTURER	MODEL	REFRIGERANT	OPERATING WEIGHT (LBS)	QTY	REMARKS	
	TOTAL CFM	ESP	HP	DRIVE		NOM. CAPACITY TOTAL (MBH)	SENS. (MBH)	EAT DB/WB	AMBIENT (°F)	STAGES (MIN)	MCA	VOLTS	PHASE	INPUT MBH	OUTPUT MBH									STAGES
RTU-1	3000	1.0	-	BELT	90	91.7	54.5	80/67	95	-	47.0	208	3	125	103	1	11.0	MERV 8	CARRIER	48TCD09C2A5	R-410A	1355	1	NOTES 1-13

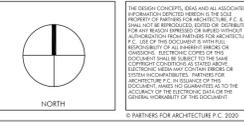NOTES:

- PROVIDE WITH SINGLE POINT POWER CONNECTION.
- PROVIDE WITH MANUFACTURER SUPPLIED UNIT MOUNTED DISCONNECT SWITCH, AND CONVENIENCE OUTLET.
- PROVIDE 2 SPEED FAN CONTROLLER.
- PROVIDE WITH MANUFACTURER INSTALLED SUPPLY AIR SMOKE DETECTORS.
- PROVIDE HINGED ACCESS PANELS.
- PROVIDE CLOGGED FILTER SWITCH.
- PROVIDE 100% ENTHALPY ECONOMIZER AND BAROMETRIC RELIEF DAMPER.
- PROVIDE FAULT DETECTION AND DIAGNOSTICS
- PROVIDE MOTORIZED OUTSIDE AIR INTAKE DAMPER.
- MOUNT UNIT ON NEW TRANSITION CURB TO UTILIZE EXISTING ROOF CURB.
- PROVIDE LP AND HI ALTITUDE CONVERSION KIT.
- PROVIDE MANUFACTURER HUMID-MIZER ADAPTIVE DEHUMIDIFICATION SYSTEM.
- UNIT SHALL BE CONTROLLED BY NEW 7-DAY PROGRAMMABLE THERMOSTAT.

MAKE-UP AIR UNIT SCHEDULE																							
UNIT TAG	SUPPLY FAN				MIN OUTSIDE AIR (CFM)	COOLING				ELECTRICAL			HEATING			MIN EER	MANUFACTURER	MODEL	REFRIGERANT	OPERATING WEIGHT (LBS)	QTY	REMARKS	
	TOTAL CFM	ESP	HP	DRIVE		NOM. CAPACITY TOTAL (MBH)	SENS. (MBH)	AMBIENT (°F)	STAGES (MIN)	MCA	VOLTS	PHASE	INPUT MBH	OUTPUT MBH	STAGES								
MUA-1	4800	0.5	3.0	DIRECT	140.9	78.8	95	-	-	UNIT SUPPLY FAN	48.2	208	3	360	330	-	13.4	LARKIN	XDCX-P116-H22-MF-10	R-410A	2652	1	NOTES 1-14
MUA-2	3488	0.5	2.0	DIRECT	102.4	55.8	95	-	-	UNIT SUPPLY FAN	38.6	208	3	235	215	-	12.9	LARKIN	XDCX-P115-H12-MF-8	R-410A	1910	1	NOTES 1-13, 15

NOTES:

- SUPPLY FAN SHALL BE PROVIDED POWER THROUGH VFD IN AUTOMATIC FAN CONTROLLER SERVING ASSOCIATED HOOD.
- UNIT SHALL BE CONTROLLED BY AUTOMATIC FAN CONTROLLER SERVING ASSOCIATED HOOD. UNIT SHALL PROVIDE CONSTANT DISCHARGE AIR TEMPERATURE.
- PROVIDE WITH MANUFACTURER SUPPLIED UNIT MOUNTED DISCONNECT SWITCH, AND CONVENIENCE OUTLET.
- PROVIDE VARIABLE AIR VOLUME SYSTEM.
- PROVIDE FIELD INSTALLED SUPPLY AIR SMOKE DETECTOR IN DUCTWORK.
- PROVIDE DOUBLE WALL CONSTRUCTION AND 1" FIBERGLASS INSULATION IN COOLING SECTION.
- PROVIDE HINGED ACCESS PANELS.
- PROVIDE SUPPLY FAN AND MOTOR NEOPRENE VIBRATION ISOLATORS.
- PROVIDE DIRTY FILTER SWITCH, HEATING INLET AIR SENSOR, COOLING INLET AIR SENSOR, FREEZE PROTECTION, AND AUXILIARY SUPPLY STARTER CONTACT.
- PROVIDE LOW LEAK OUTDOOR AIR INLET DAMPER.
- PROVIDE ALUMINUM MESH FILTERED WEATHERHOOD.
- PROVIDE FLAME ROD FOR FLAME SENSING AND FM COMPLIANT HEATING SECTION.
- MOUNT UNIT ON NEW ROOF CURB.
- PROVIDE WITH HORIZONTAL SUPPLY DISCHARGE.
- PROVIDE WITH BOTTOM SUPPLY DISCHARGE.

KITCHEN HOOD SCHEDULE											
UNIT TAG	L x W x H	WEIGHT (LBS)	EXHAUST			SUPPLY			MANUFACTURER MODEL	REMARKS	
			COLLAR	CFM	SP	COLLAR	CFM	SP			
H-1S1	12'0"x54"x24"	603	10"x20"	2400	0.375"	24"x10" 24"x10"	960 960	0.125" 0.125"	LARKIN EO-FPSP	NOTES 1-13	
H-1S2	12'0"x54"x24"	603	14"x20"	3600	0.5"	24"x10" 24"x10"	1440 1440	0.125" 0.125"	LARKIN EO-FPSP	NOTES 1-11	
H-2S1	9'9"x54"x24"	511	14x14	2400	0.625"	24"x10" 24"x10"	960 960	0.15" 0.15"	LARKIN EO-FPSP	NOTES 1-11	
H-2S2	9'9"x54"x24"	511	13x13	1960	0.625"	24"x10" 24"x10"	784 784	0.125" 0.125"	LARKIN EO-FPSP	NOTES 1-11	

NOTES:

- PROVIDE WITH PREWIRED INCANDESCENT LIGHTS.
- PROVIDE WITH ALUMINUM BAFFLE FILTERS.
- PROVIDE 12" DEEP FRONT PERFORATED SUPPLY PLENUM.
- PROVIDE 3" BACK STAND-OFF MOUNT.
- PROVIDE 78" TALL S/S BACK WALL SPLASH PANEL.
- PROVIDE ANSUL PIPING IN HOOD AND ANSUL R-102 FIRE SUPPRESSION SYSTEM.
- PROVIDE REMOTE ANSUL AUTOMAN CABINET.
- PROVIDE AUTOMATIC GAS VALVE SERVING EQUIPMENT UNDER HOOD. VALVE SHALL BE INCORPORATED INTO FIRE SUPPRESSION SYSTEM CONTROLS AND CLOSE UPON ACTIVATION OF FIRE SUPPRESSION SYSTEM.
- PROVIDE HEAT SENSOR MOUNTED IN HOOD.
- PROVIDE SEISMIC WALL ANCHOR.
- PROVIDE 7" S/S CEILING ENCLOSURE.
- PROVIDE AUTOMATIC FAN CONTROLLER WITH DEMAND CONTROL VENTILATION. PROVIDE ONE CONTROLLER TO SERVE H-1S1 AND H-1S2 AND ONE CONTROLLER TO SERVE H-2S1 AND H-2S2. PROVIDE EACH CONTROLLER WITH OPTIONAL SHUNT TRIP BREAKER.
- PROVIDE 3" LEFT END STAND-OFF MOUNT.
- PROVIDE 78" TALL S/S LEFT END WALL SPLASH PANEL.

EXHAUST FAN SCHEDULE															
FAN TAG	SERVICE LOCATION	QTY.	CFM	E.S.P.	FAN TYPE	FAN RPM	DRIVE	WEIGHT	MOTOR DATA				MANUFACTURER MODEL	REMARKS	
									HP	VOLTS	PH	FLA			
EF-1	KITCHEN HOOD H-1 ROOF	1	6000	1.5	CENTRIFUGAL	973	BELT	525	3.0	208	3	10.6	LARKIN XUEF-24-3-B1-00-01-01	NOTE 1	
EF-2	KITCHEN HOOD H-2 ROOF	1	4360	1.5	CENTRIFUGAL	983	BELT	404	2.0	208	3	7.5	GREENHECK XUEF-22-3-B1-00-01-01	NOTE 1	
EF-3	BATHROOMS/JC ROOF	1	550	0.75	CENTRIFUGAL	1695	DIRECT	50	1/6	115	1	2.2	GREENHECK CUE-095-VG	NOTE 2	

NOTES:

- EXHAUST FAN SHALL BE CONTROLLED BY AUTOMATIC FAN CONTROL PACKAGE FOR ASSOCIATED HOOD.
- EXHAUST FAN SHALL BE CONTROLLED BY DISHWASHER EXHAUST FAN CONTROLLER.

DIFFUSERS, REGISTERS, GRILLES									
UNIT TAG	SERVICE	MATERIAL FINISH	MANUFACTURER MODEL	REMARKS	UNIT TAG	SERVICE	MATERIAL FINISH	MANUFACTURER MODEL	REMARKS
C	SUPPLY	STEEL WHITE	PRICE 90	NOTE 1	D	-	-	-	-

NOTES:

- SIZE PER MECHANICAL PLAN DRAWINGS.


AIR CURTAIN SCHEDULE												
FAN TAG	SERVICE LOCATION	CFM	NOZZLE WIDTH	NUM. MOTOR	WEIGHT	KW	MOTOR DATA				MANUFACTURER MODEL	REMARKS
							HP	VOLTS	PH	AMPS		
F-1	STAIRWELL WALL	625	25 IN.	1	25	6.1	1/6	208	1	31.2	MARS AIR LPV225-1EBC-OB	NOTES 1-3

NOTES:

- PROVIDE WITH NEMA-1 TOGGLE DISCONNECT SWITCH.
- PROVIDE WITH MANUFACTURER CONTROL SWITCH TO CONTROL FAN AND HEAT SEPARATELY.
- PROVIDE WALL MOUNTED THERMOSTAT TO CONTROL UNIT.

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NO.	DATE	ISS/REV	OWNER/CC	ISSUED TO	DESCRIPTION
1	09/17/21				

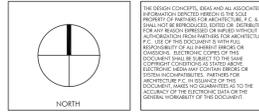

OLD OAKS COUNTRY CLUB

PROJECT ADDRESS

MECHANICAL SCHEDULES

SEAL & SIGNATURE	DATE: 08-13-21
	PROJECT NO.: 21-826
	DRAWN BY: CH
	CHECKED BY: TL
	DRAWING NO.: M300.00
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