

1 2 3 4 5 6 7 8 9 10 11 12 13 14 15 16 17 18 19 20



- NOTES:
- SEE DWG M-001 FOR SYMBOLS, LEGEND, AND ABBREVIATIONS.
  - SEE DWGS MD101 AND MD102 FOR DEMOLITION WORK.
  - SEE DWGS MH101 TO MH107 FOR CONTINUATION.
  - SEE DWG MH108 FOR ROOF PLAN.
  - SEE DWGS MP202 TO MP207 FOR CONTINUATION.
  - SEE DWGS M101 TO M102 FOR CONTROL DIAGRAMS.
  - SEE DWGS M-501 TO M-503 FOR DETAILS.
  - SEE DWGS M-601 TO M-603 FOR EQUIPMENT SCHEDULES.
  - PROVIDE SHUTOFF VALVES AT ALL WATER SUPPLY AND RETURN PIPE BRANCHES. THE SHUTOFF VALVES ARE NOT SHOWN ON THE FLOOR PLAN FOR CLARITY.
  - THE CONTROL VALVE, SHUTOFF VALVES, STRAINER, DRAIN VALVE FOR EACH ROOF MOUNTED DOAS UNIT SHALL BE LOCATED BELOW THE ROOF IN A CLOSE PROXIMITY OF THE CORRESPONDING UNIT.
  - ALL CONDENSER WATER PIPES SHALL BE INSULATED AND JACKETED. FOR ALL CONDENSATE DRAIN PIPES, PROVIDE CLEANOUTS AT EACH 90 DEGREE ELBOWS. PROVIDE CLEANOUTS EVERY 30 FEET ON THE STRAIGHT RUNS.
  - PROVIDE 1/4" PER FOOT SLOPE FOR THE CONDENSATE DRAIN PIPES. PITCH PIPE DOWN IN DIRECTION OF FLOW AS SHOWN ON THE DRAWING.



MARK	DESCRIPTION	DATE

ISSUE DATE: 06 MAY 2021  
 SOLICITATION NO.: W912Q2R0038  
 CONTRACT NO.: W912Q2R0038

DESIGNED BY: DGL  
 DRAWN BY: DGL  
 CHECKED BY: MLP  
 SUBMITTED BY: ANSID

US ARMY CORPS OF ENGINEERS  
 LOUISVILLE DISTRICT  
 LOUISVILLE, KY


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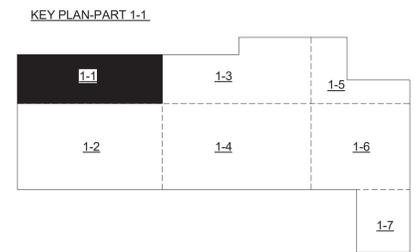
UNITED STATES ARMY RESERVE CENTER  
 ORANGEBURG, NEW YORK

MECHANICAL PIPING FLOOR PART PLAN 1-1

SHEET ID  
**MP101**



**1 MECHANICAL PIPING FLOOR PART PLAN 1-1**  
 1/4" = 1'-0"

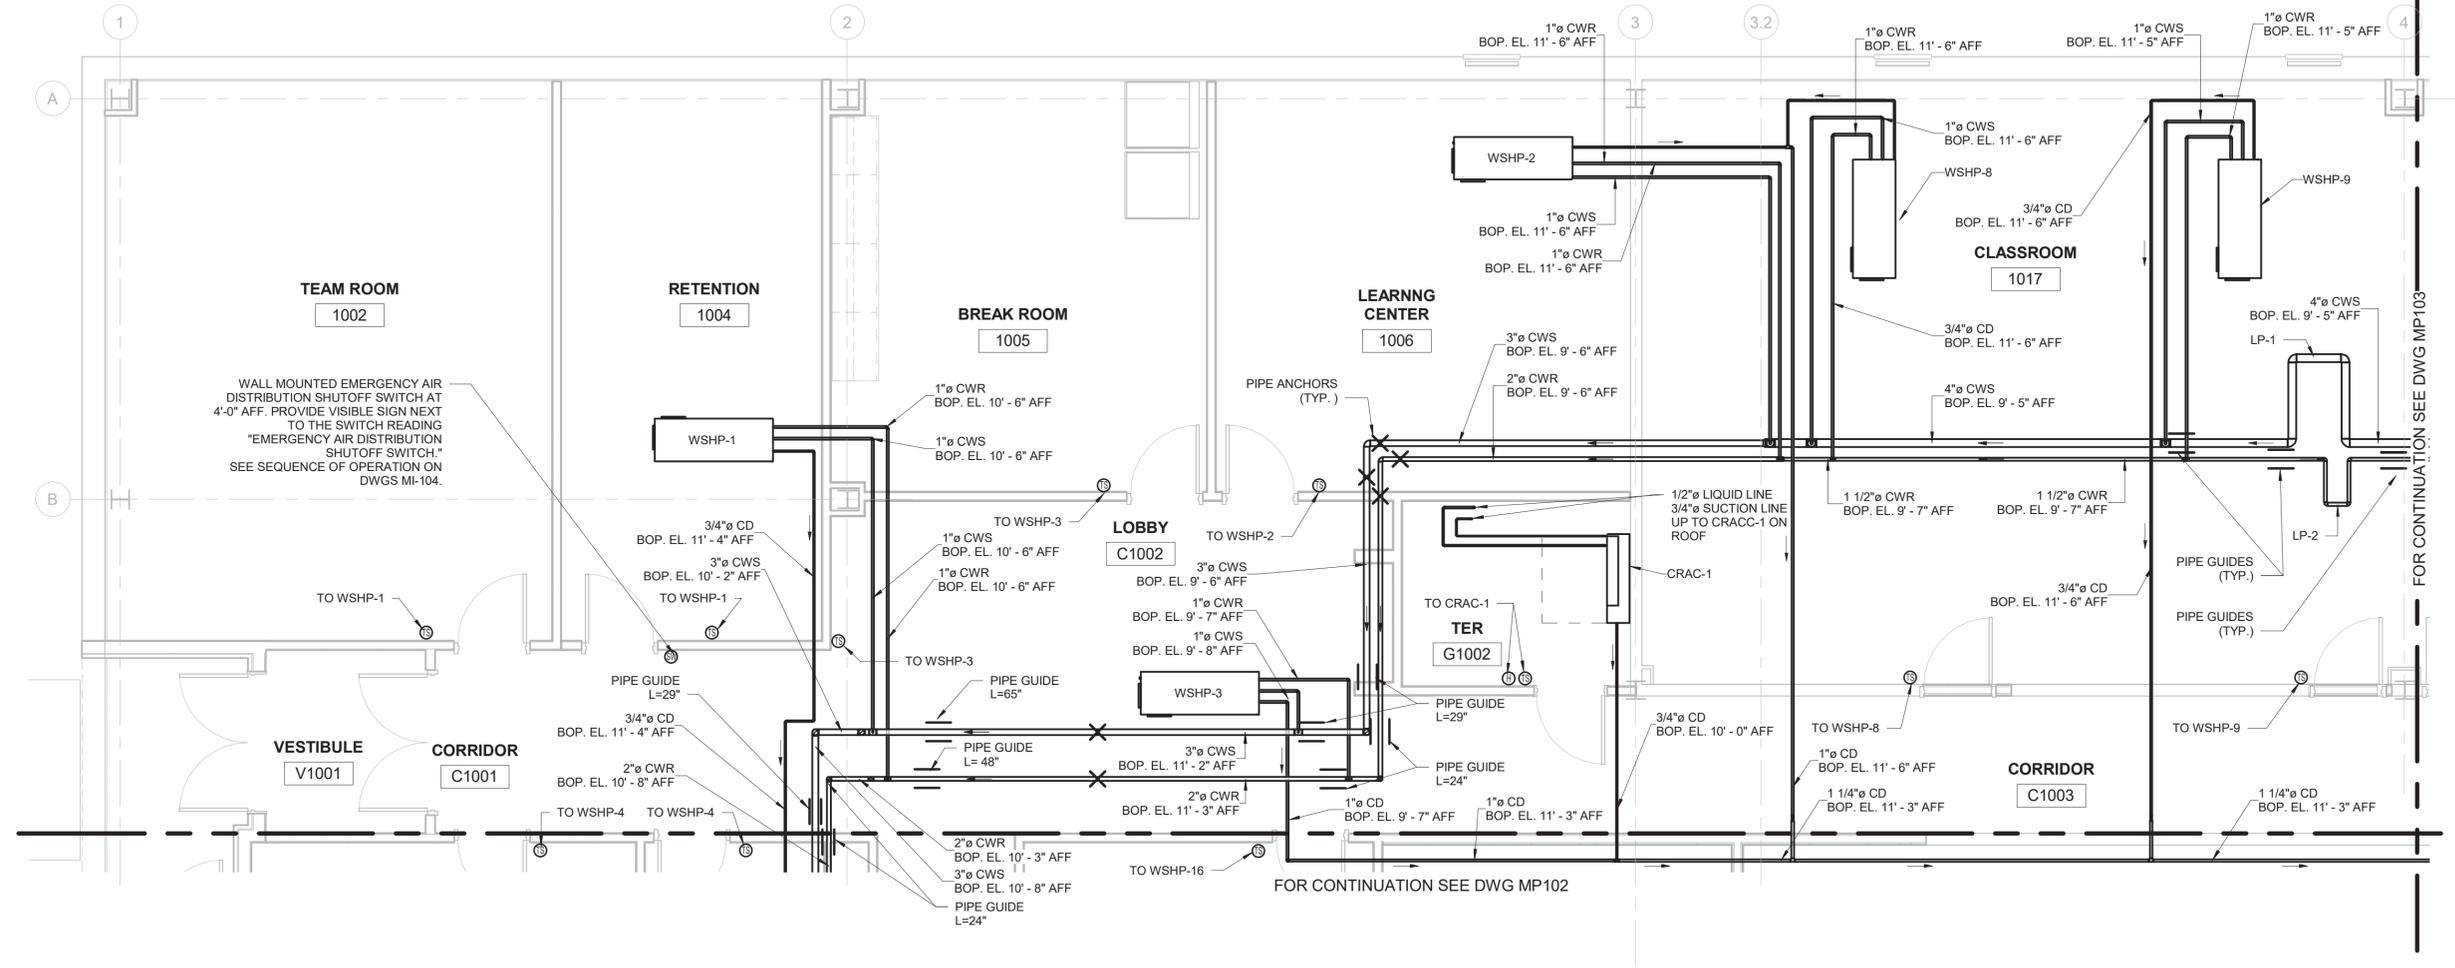


CORRECTED FINAL SUBMISSION - JULY 29, 2021

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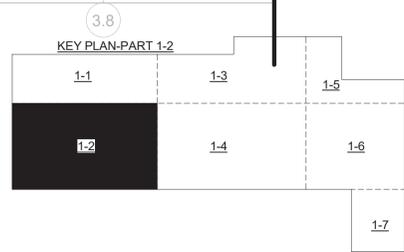


- NOTES:
- SEE DWG M-001 FOR SYMBOLS, LEGEND, AND ABBREVIATIONS.
  - SEE DWGS MD101 AND MD102 FOR DEMOLITION WORK.
  - SEE DWGS MH101 TO MH107 FOR CONTINUATION.
  - SEE DWG MH108 FOR ROOF PLAN.
  - SEE DWGS MP201, MP203 TO MP207 FOR CONTINUATION.
  - SEE DWGS MI101 TO MI102 FOR CONTROL DIAGRAMS.
  - SEE DWGS M-501 TO M-503 FOR DETAILS.
  - SEE DWGS M-601 TO M-603 FOR EQUIPMENT SCHEDULES.
  - PROVIDE SHUTOFF VALVES AT ALL WATER SUPPLY AND RETURN PIPE BRANCHES. THE SHUTOFF VALVES ARE NOT SHOWN ON THE FLOOR PLAN FOR CLARITY.
  - THE CONTROL VALVE, SHUTOFF VALVES, STRAINER, DRAIN VALVE FOR EACH ROOF MOUNTED DOAS UNIT SHALL BE LOCATED BELOW THE ROOF IN A CLOSE PROXIMITY OF THE CORRESPONDING UNIT.
  - ALL CONDENSER WATER PIPES SHALL BE INSULATED AND JACKETED.
  - FOR ALL CONDENSATE DRAIN PIPES, PROVIDE CLEANOUTS AT EACH 90 DEGREE ELBOWS. PROVIDE CLEANOUTS EVERY 30 FEET ON THE STRAIGHT RUNS.
  - PROVIDE 1/4" PER FOOT SLOPE FOR THE CONDENSATE DRAIN PIPES. PITCH PIPE DOWN IN DIRECTION OF FLOW AS SHOWN ON THE DRAWING

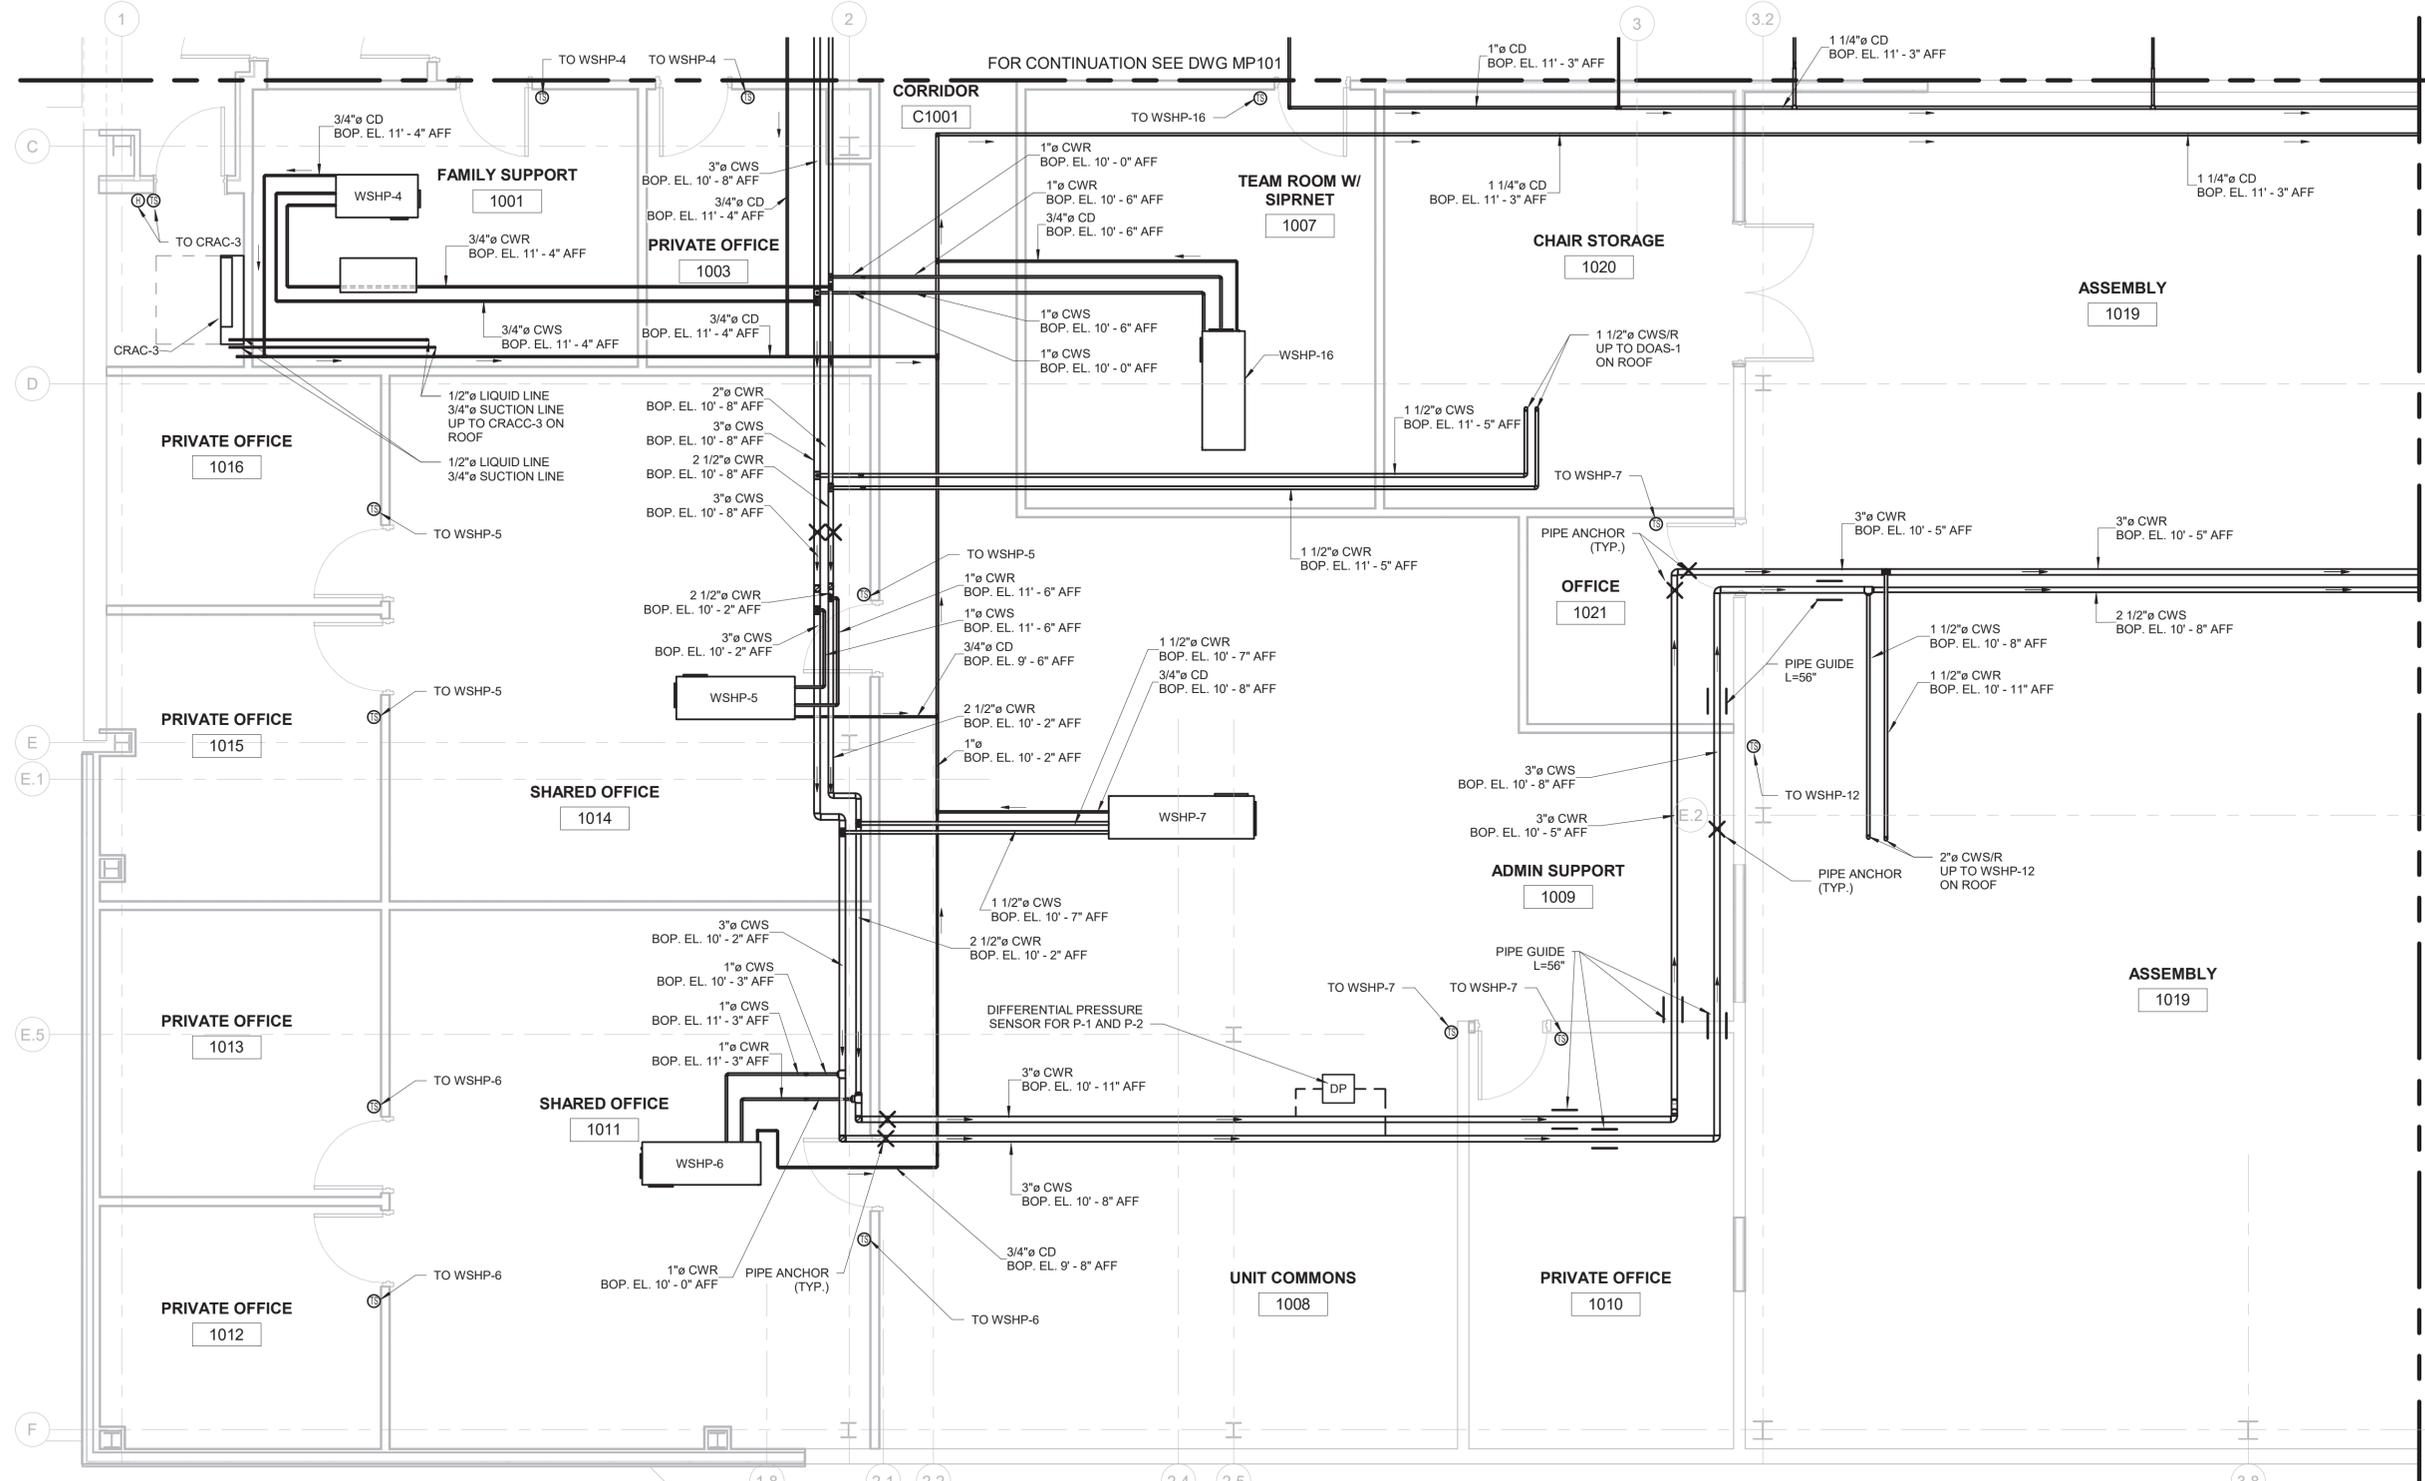

**1 MECHANICAL PIPING FLOOR PART PLAN 1-2**

1/4" = 1'-0"  
 0 2' 4' 8'  
 SCALE: 1/4"=1'-0"



NOT FOR CONSTRUCTION

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 CONTRACT NO.: W812Q2R0038

DESIGNED BY: DGL  
 DRAWN BY: DGL  
 CHECKED BY: MLP  
 SUBMITTED BY: ANSID

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 LOUISVILLE, KY

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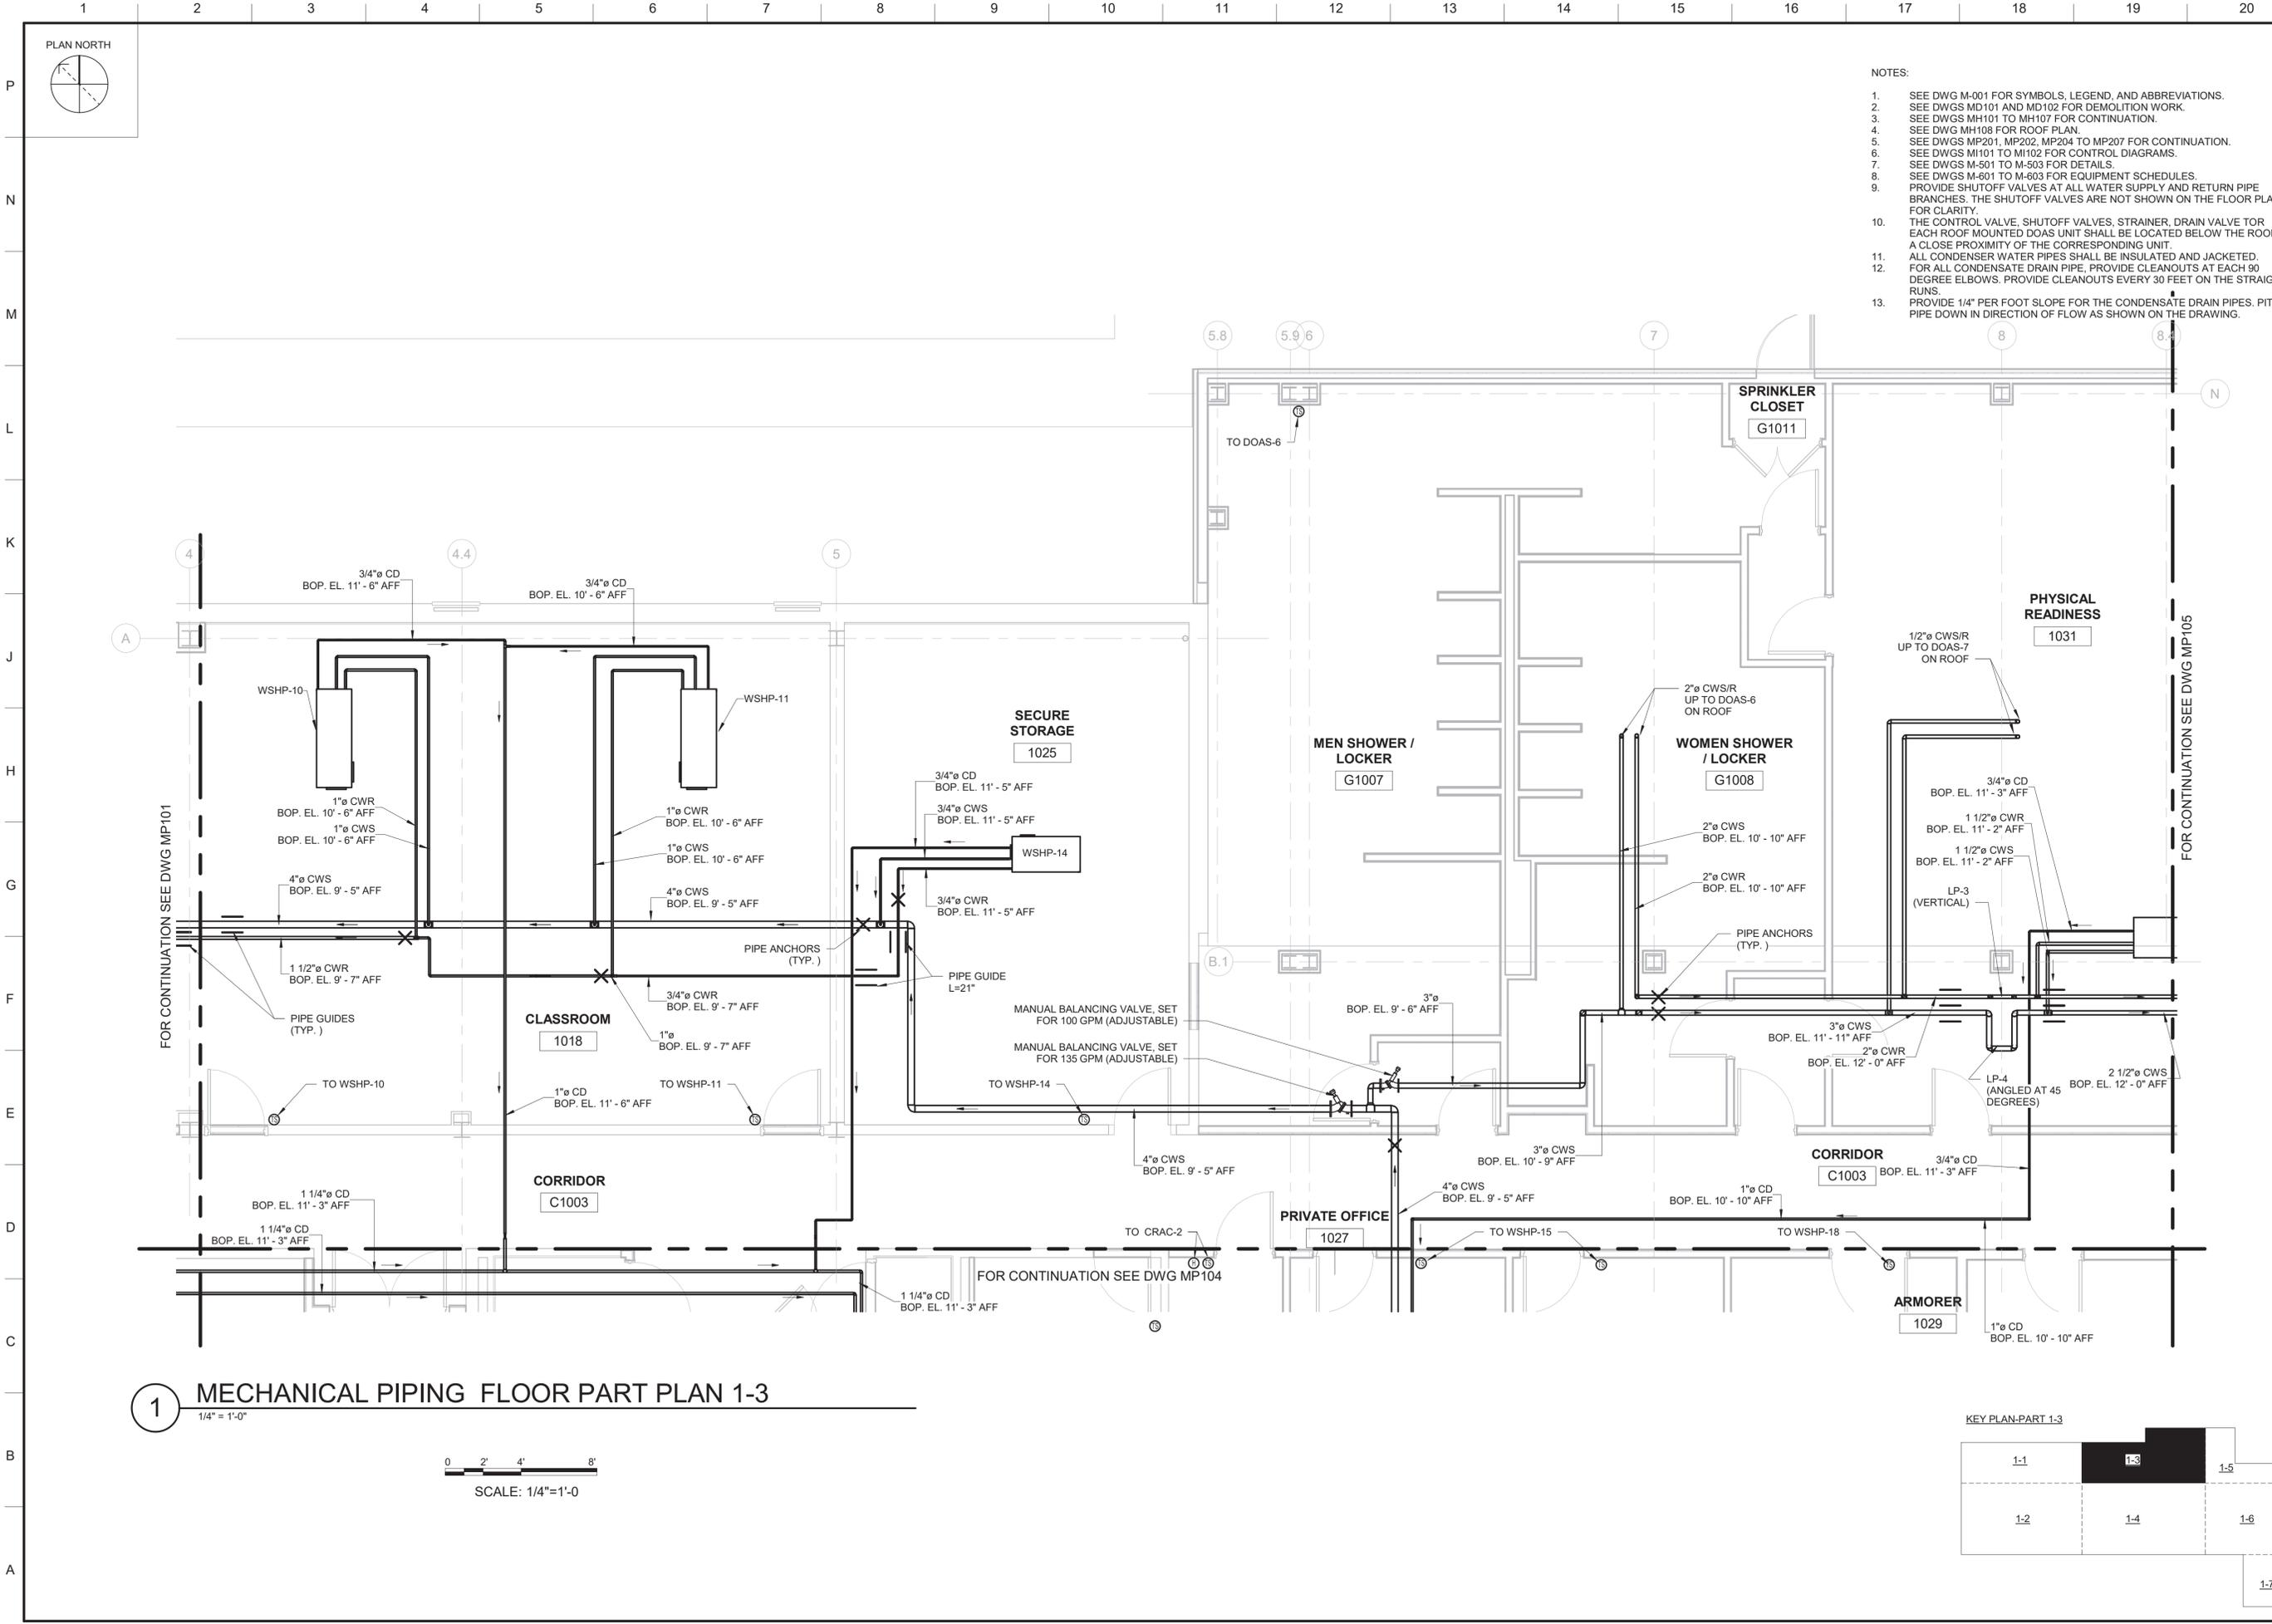
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MECHANICAL PIPING FLOOR PART PLAN 1-2

SHEET ID  
**MP102**

CORRECTED FINAL SUBMISSION - JULY 29, 2021



- NOTES:
- SEE DWG M-001 FOR SYMBOLS, LEGEND, AND ABBREVIATIONS.
  - SEE DWGS MD101 AND MD102 FOR DEMOLITION WORK.
  - SEE DWGS MH101 TO MH107 FOR CONTINUATION.
  - SEE DWG MH108 FOR ROOF PLAN.
  - SEE DWGS MP201, MP202, MP204 TO MP207 FOR CONTINUATION.
  - SEE DWGS MI101 TO MI102 FOR CONTROL DIAGRAMS.
  - SEE DWGS M-501 TO M-503 FOR DETAILS.
  - SEE DWGS M-601 TO M-603 FOR EQUIPMENT SCHEDULES.
  - PROVIDE SHUTOFF VALVES AT ALL WATER SUPPLY AND RETURN PIPE BRANCHES. THE SHUTOFF VALVES ARE NOT SHOWN ON THE FLOOR PLAN FOR CLARITY.
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  - ALL CONDENSER WATER PIPES SHALL BE INSULATED AND JACKETED.
  - FOR ALL CONDENSATE DRAIN PIPE, PROVIDE CLEANOUTS AT EACH 90 DEGREE ELBOWS. PROVIDE CLEANOUTS EVERY 30 FEET ON THE STRAIGHT RUNS.
  - PROVIDE 1/4" PER FOOT SLOPE FOR THE CONDENSATE DRAIN PIPES. PITCH PIPE DOWN IN DIRECTION OF FLOW AS SHOWN ON THE DRAWING.



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ISSUE DATE: 06 MAY 2021  
 SOLICITATION NO.: W912Q2R0038  
 CONTRACT NO.: W912Q2R0038

DESIGNED BY: DGL  
 DRAWN BY: DGL  
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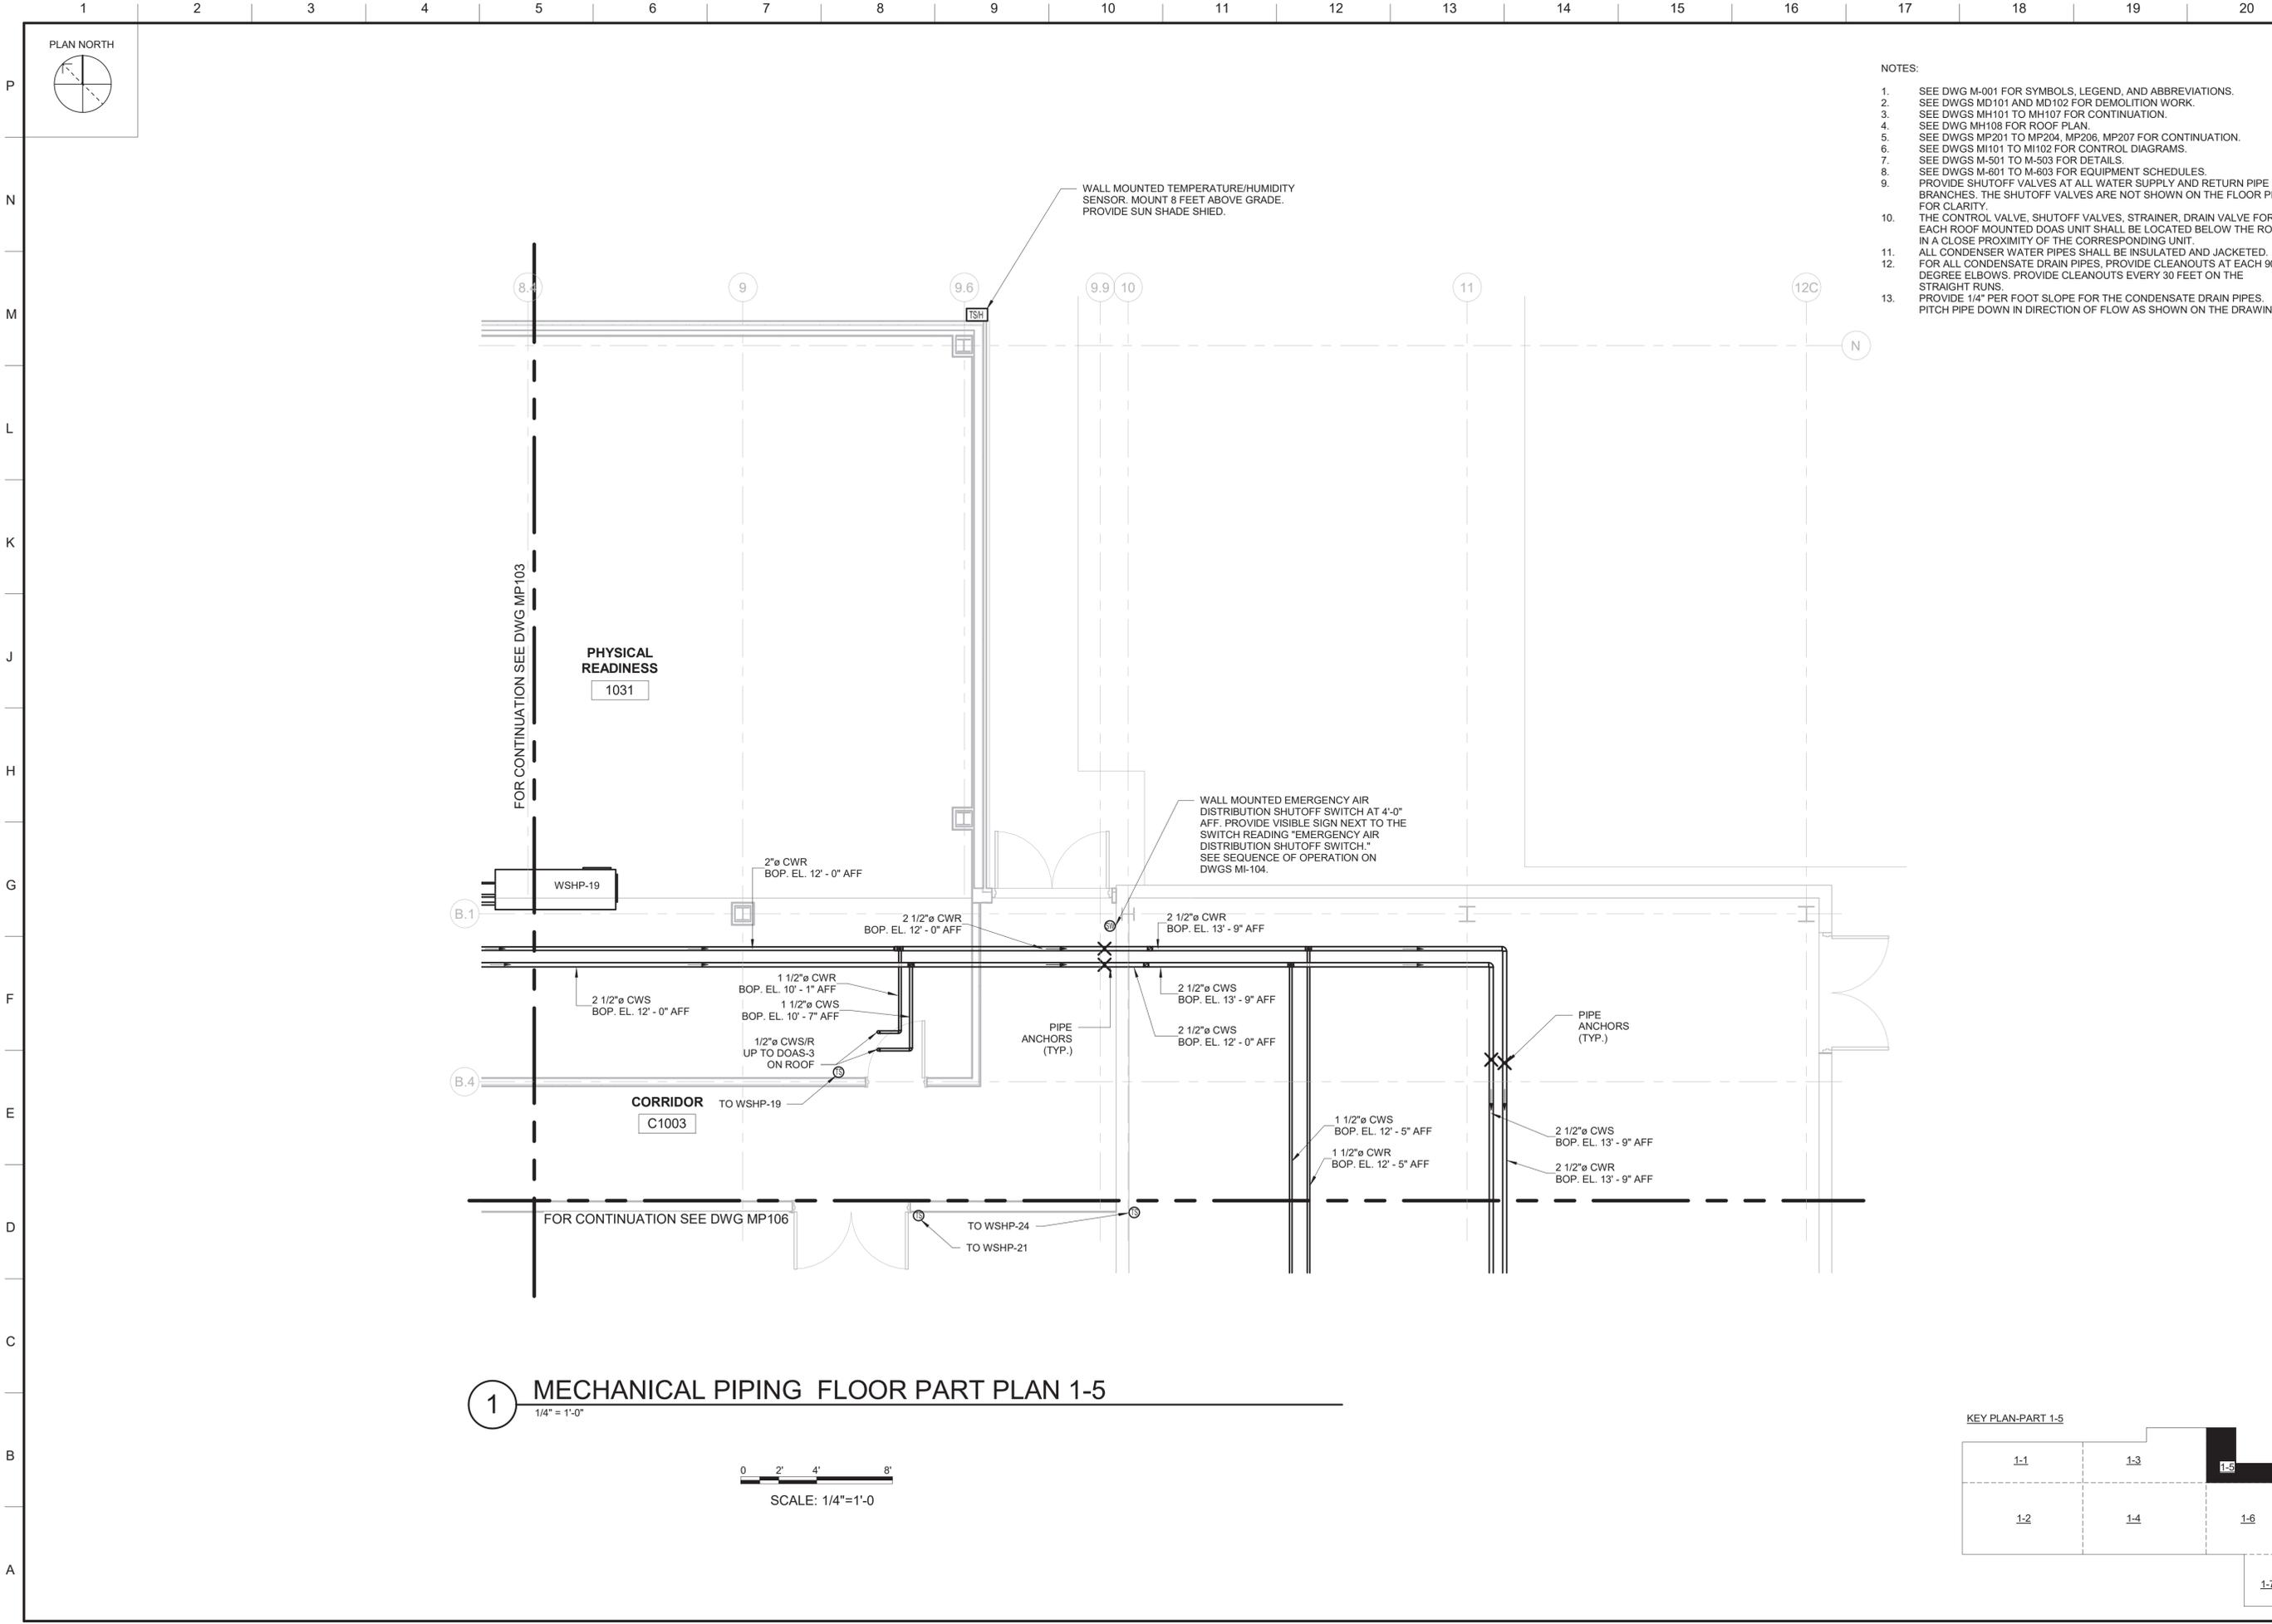
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MECHANICAL PIPING FLOOR PART PLAN 1-3

SHEET ID  
**MP103**

CORRECTED FINAL SUBMISSION - JULY 29, 2021






**1 MECHANICAL PIPING FLOOR PART PLAN 1-5**  
 1/4" = 1'-0"



**NOTES:**

1. SEE DWG M-001 FOR SYMBOLS, LEGEND, AND ABBREVIATIONS.
2. SEE DWGS MD101 AND MD102 FOR DEMOLITION WORK.
3. SEE DWGS MH101 TO MH107 FOR CONTINUATION.
4. SEE DWG MH108 FOR ROOF PLAN.
5. SEE DWGS MP201 TO MP204, MP206, MP207 FOR CONTINUATION.
6. SEE DWGS MI101 TO MI102 FOR CONTROL DIAGRAMS.
7. SEE DWGS M-501 TO M-503 FOR DETAILS.
8. SEE DWGS M-601 TO M-603 FOR EQUIPMENT SCHEDULES.
9. PROVIDE SHUTOFF VALVES AT ALL WATER SUPPLY AND RETURN PIPE BRANCHES. THE SHUTOFF VALVES ARE NOT SHOWN ON THE FLOOR PLAN FOR CLARITY.
10. THE CONTROL VALVE, SHUTOFF VALVES, STRAINER, DRAIN VALVE FOR EACH ROOF MOUNTED DOAS UNIT SHALL BE LOCATED BELOW THE ROOF IN A CLOSE PROXIMITY OF THE CORRESPONDING UNIT.
11. ALL CONDENSATE WATER PIPES SHALL BE INSULATED AND JACKETED. FOR ALL CONDENSATE DRAIN PIPES, PROVIDE CLEANOUTS AT EACH 90 DEGREE ELBOWS. PROVIDE CLEANOUTS EVERY 30 FEET ON THE STRAIGHT RUNS.
13. PROVIDE 1/4" PER FOOT SLOPE FOR THE CONDENSATE DRAIN PIPES. PITCH PIPE DOWN IN DIRECTION OF FLOW AS SHOWN ON THE DRAWING.

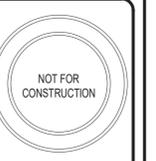

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DESIGNED BY: DGL  
 DRAWN BY: DGL  
 CHECKED BY: MLP  
 SUBMITTED BY: ANSID

ISSUE DATE: 06 MAY 2021  
 SOLICITATION NO.: W912Q2R0038  
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US ARMY CORPS OF ENGINEERS  
 LOUISVILLE DISTRICT  
 LOUISVILLE, KY


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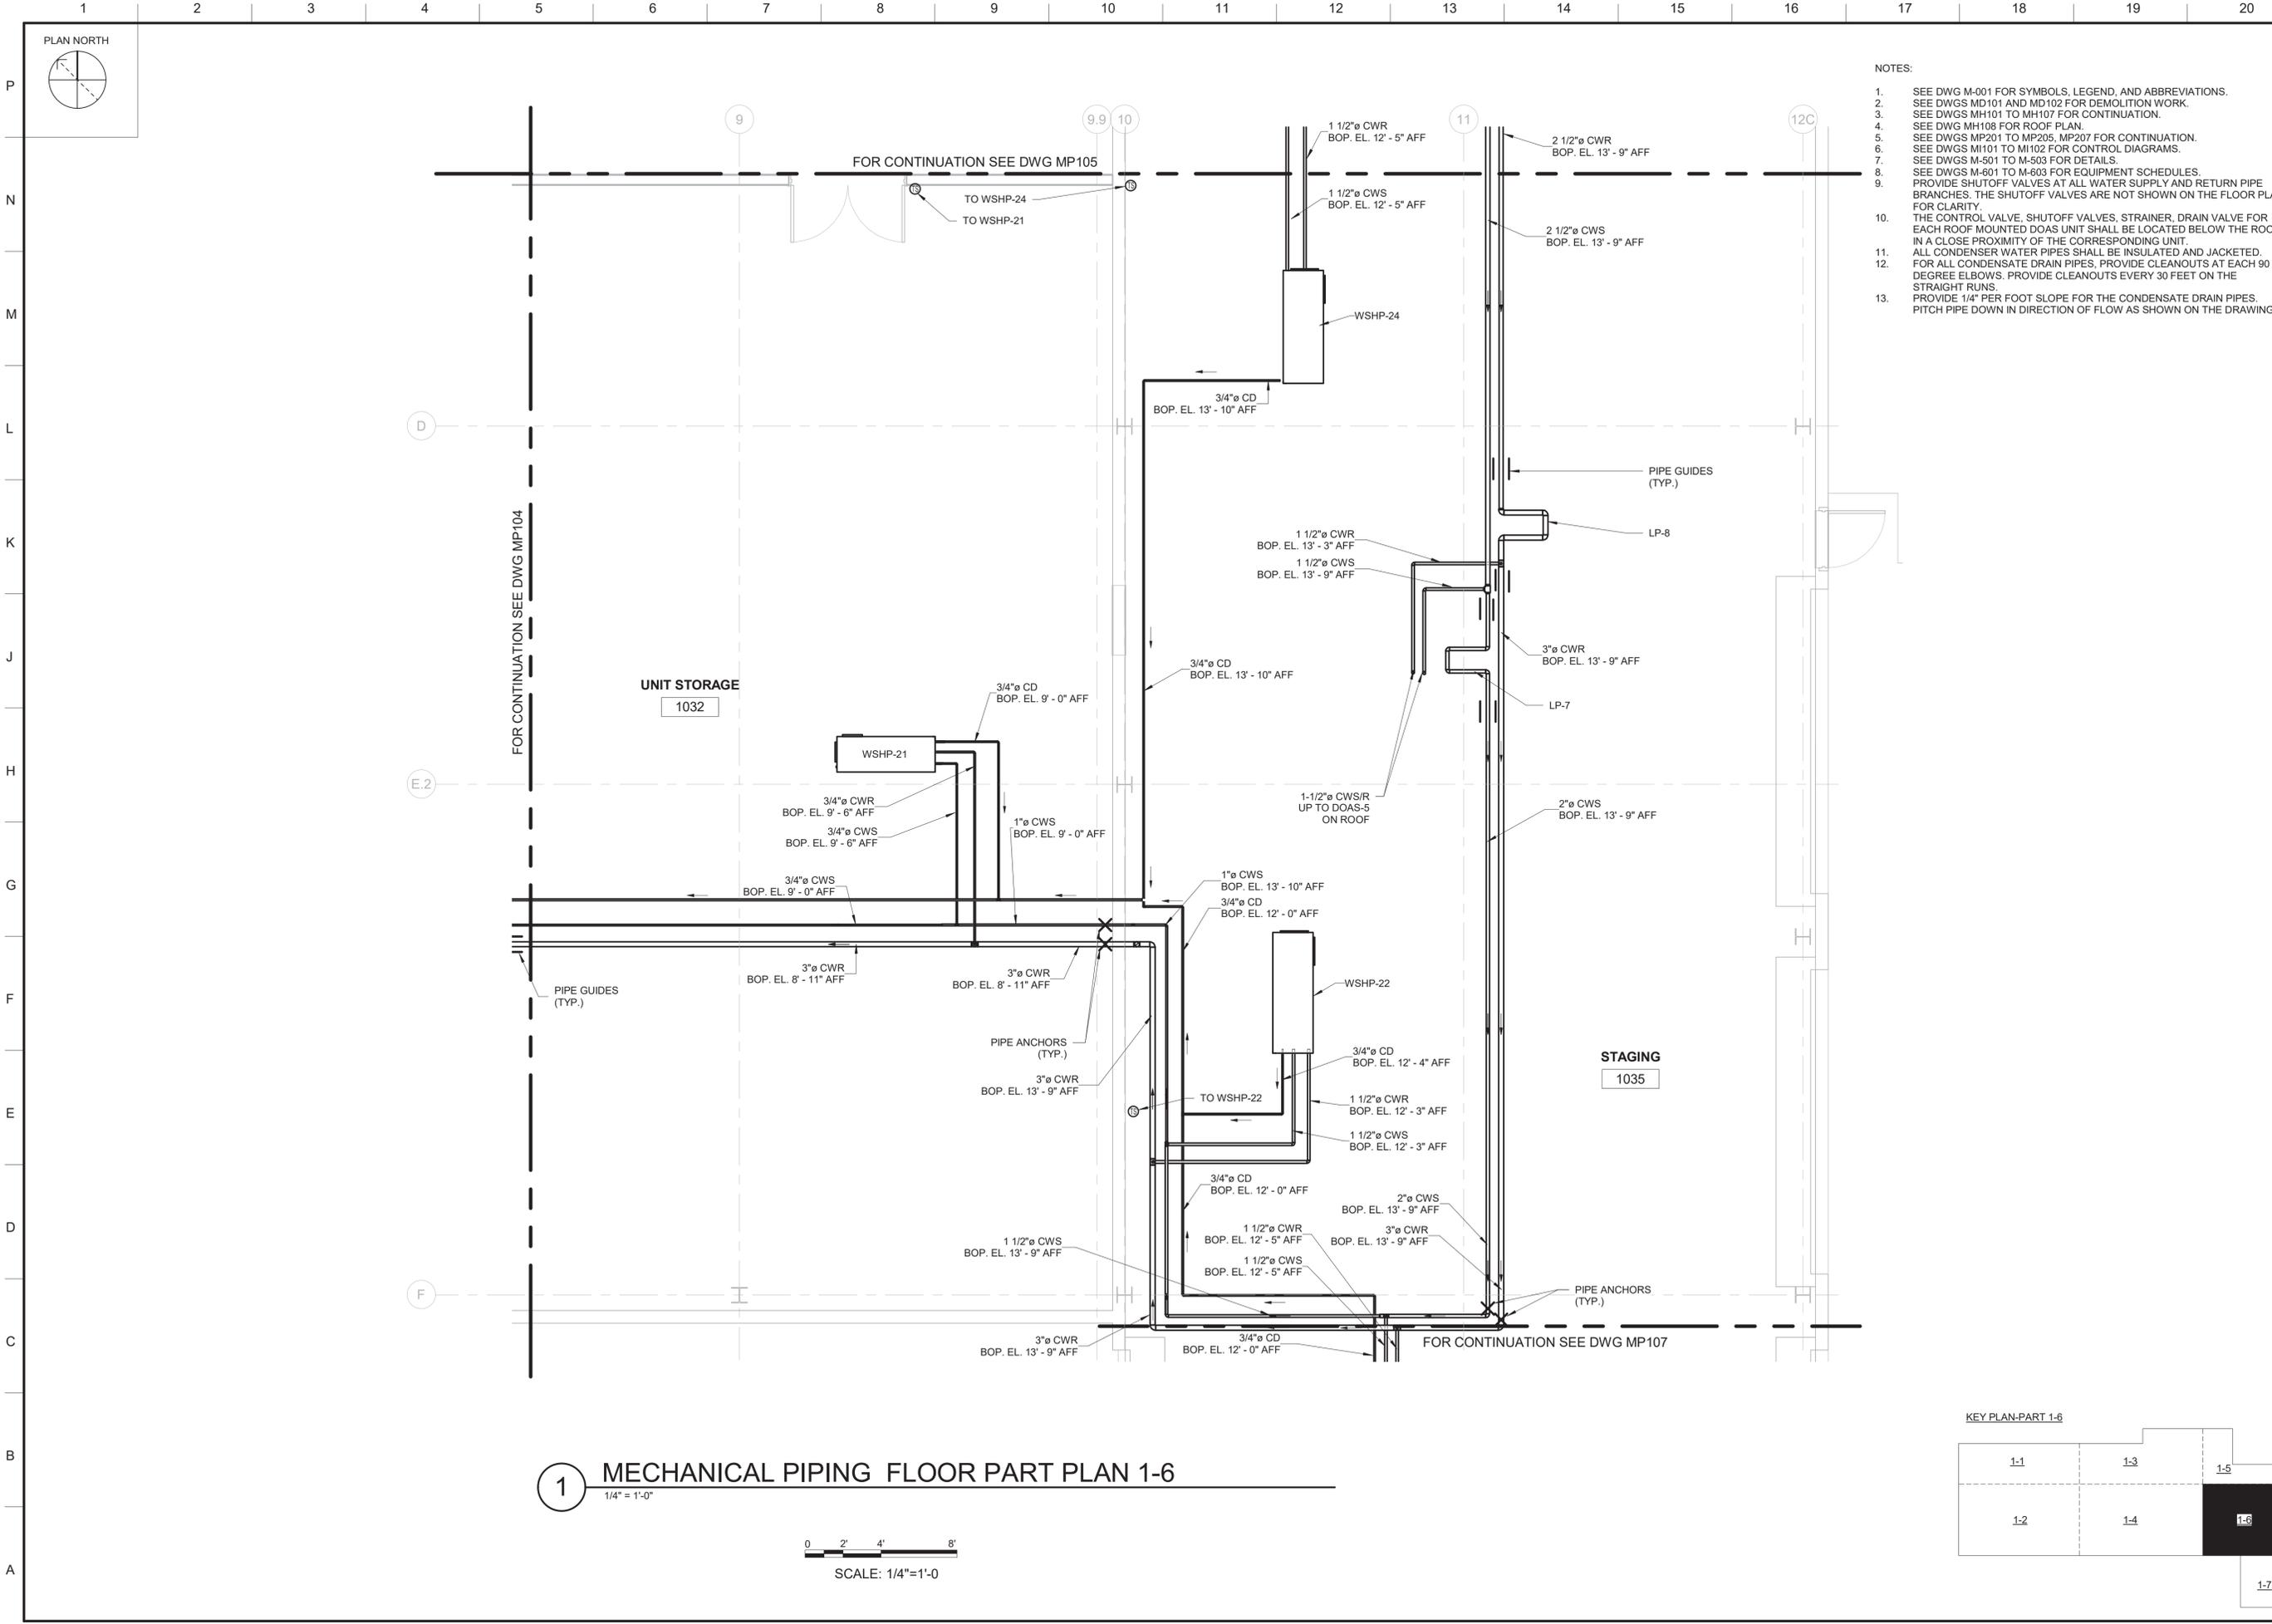
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MECHANICAL PIPING FLOOR PART PLAN 1-5

SHEET ID  
**MP105**





CORRECTED FINAL SUBMISSION - JULY 29, 2021

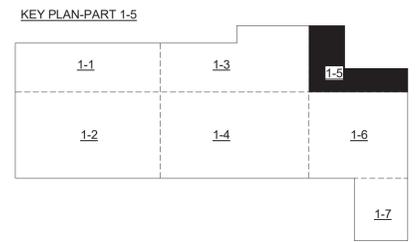

- NOTES:
- SEE DWG M-001 FOR SYMBOLS, LEGEND, AND ABBREVIATIONS.
  - SEE DWGS MD101 AND MD102 FOR DEMOLITION WORK.
  - SEE DWGS MH101 TO MH107 FOR CONTINUATION.
  - SEE DWG MH108 FOR ROOF PLAN.
  - SEE DWGS MP201 TO MP205, MP207 FOR CONTINUATION.
  - SEE DWGS MH101 TO MH102 FOR CONTROL DIAGRAMS.
  - SEE DWGS M-501 TO M-503 FOR DETAILS.
  - SEE DWGS M-601 TO M-603 FOR EQUIPMENT SCHEDULES.
  - PROVIDE SHUTOFF VALVES AT ALL WATER SUPPLY AND RETURN PIPE BRANCHES. THE SHUTOFF VALVES ARE NOT SHOWN ON THE FLOOR PLAN FOR CLARITY.
  - THE CONTROL VALVE, SHUTOFF VALVES, STRAINER, DRAIN VALVE FOR EACH ROOF MOUNTED DOAS UNIT SHALL BE LOCATED BELOW THE ROOF IN A CLOSE PROXIMITY OF THE CORRESPONDING UNIT.
  - ALL CONDENSER WATER PIPES SHALL BE INSULATED AND JACKETED.
  - FOR ALL CONDENSATE DRAIN PIPES, PROVIDE CLEANOUTS AT EACH 90 DEGREE ELBOWS. PROVIDE CLEANOUTS EVERY 30 FEET ON THE STRAIGHT RUNS.
  - PROVIDE 1/4" PER FOOT SLOPE FOR THE CONDENSATE DRAIN PIPES. PITCH PIPE DOWN IN DIRECTION OF FLOW AS SHOWN ON THE DRAWING.

**1 MECHANICAL PIPING FLOOR PART PLAN 1-6**  
1/4" = 1'-0"

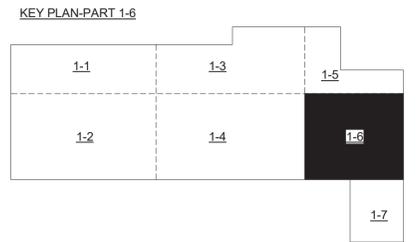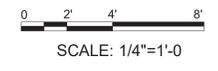

**US Army Corps of Engineers**

NOT FOR CONSTRUCTION

MARK	DESCRIPTION	DATE

DESIGNED BY: DGL	ISSUE DATE: 06 MAY 2021	CHECKED BY: MLP	SUBMITTED BY: ANSID
DRAWN BY: DGL	SOLICITATION NO.: W912QR2R0038	CONTRACT NO.: W912QR2R0038	SIZE: ANSI D

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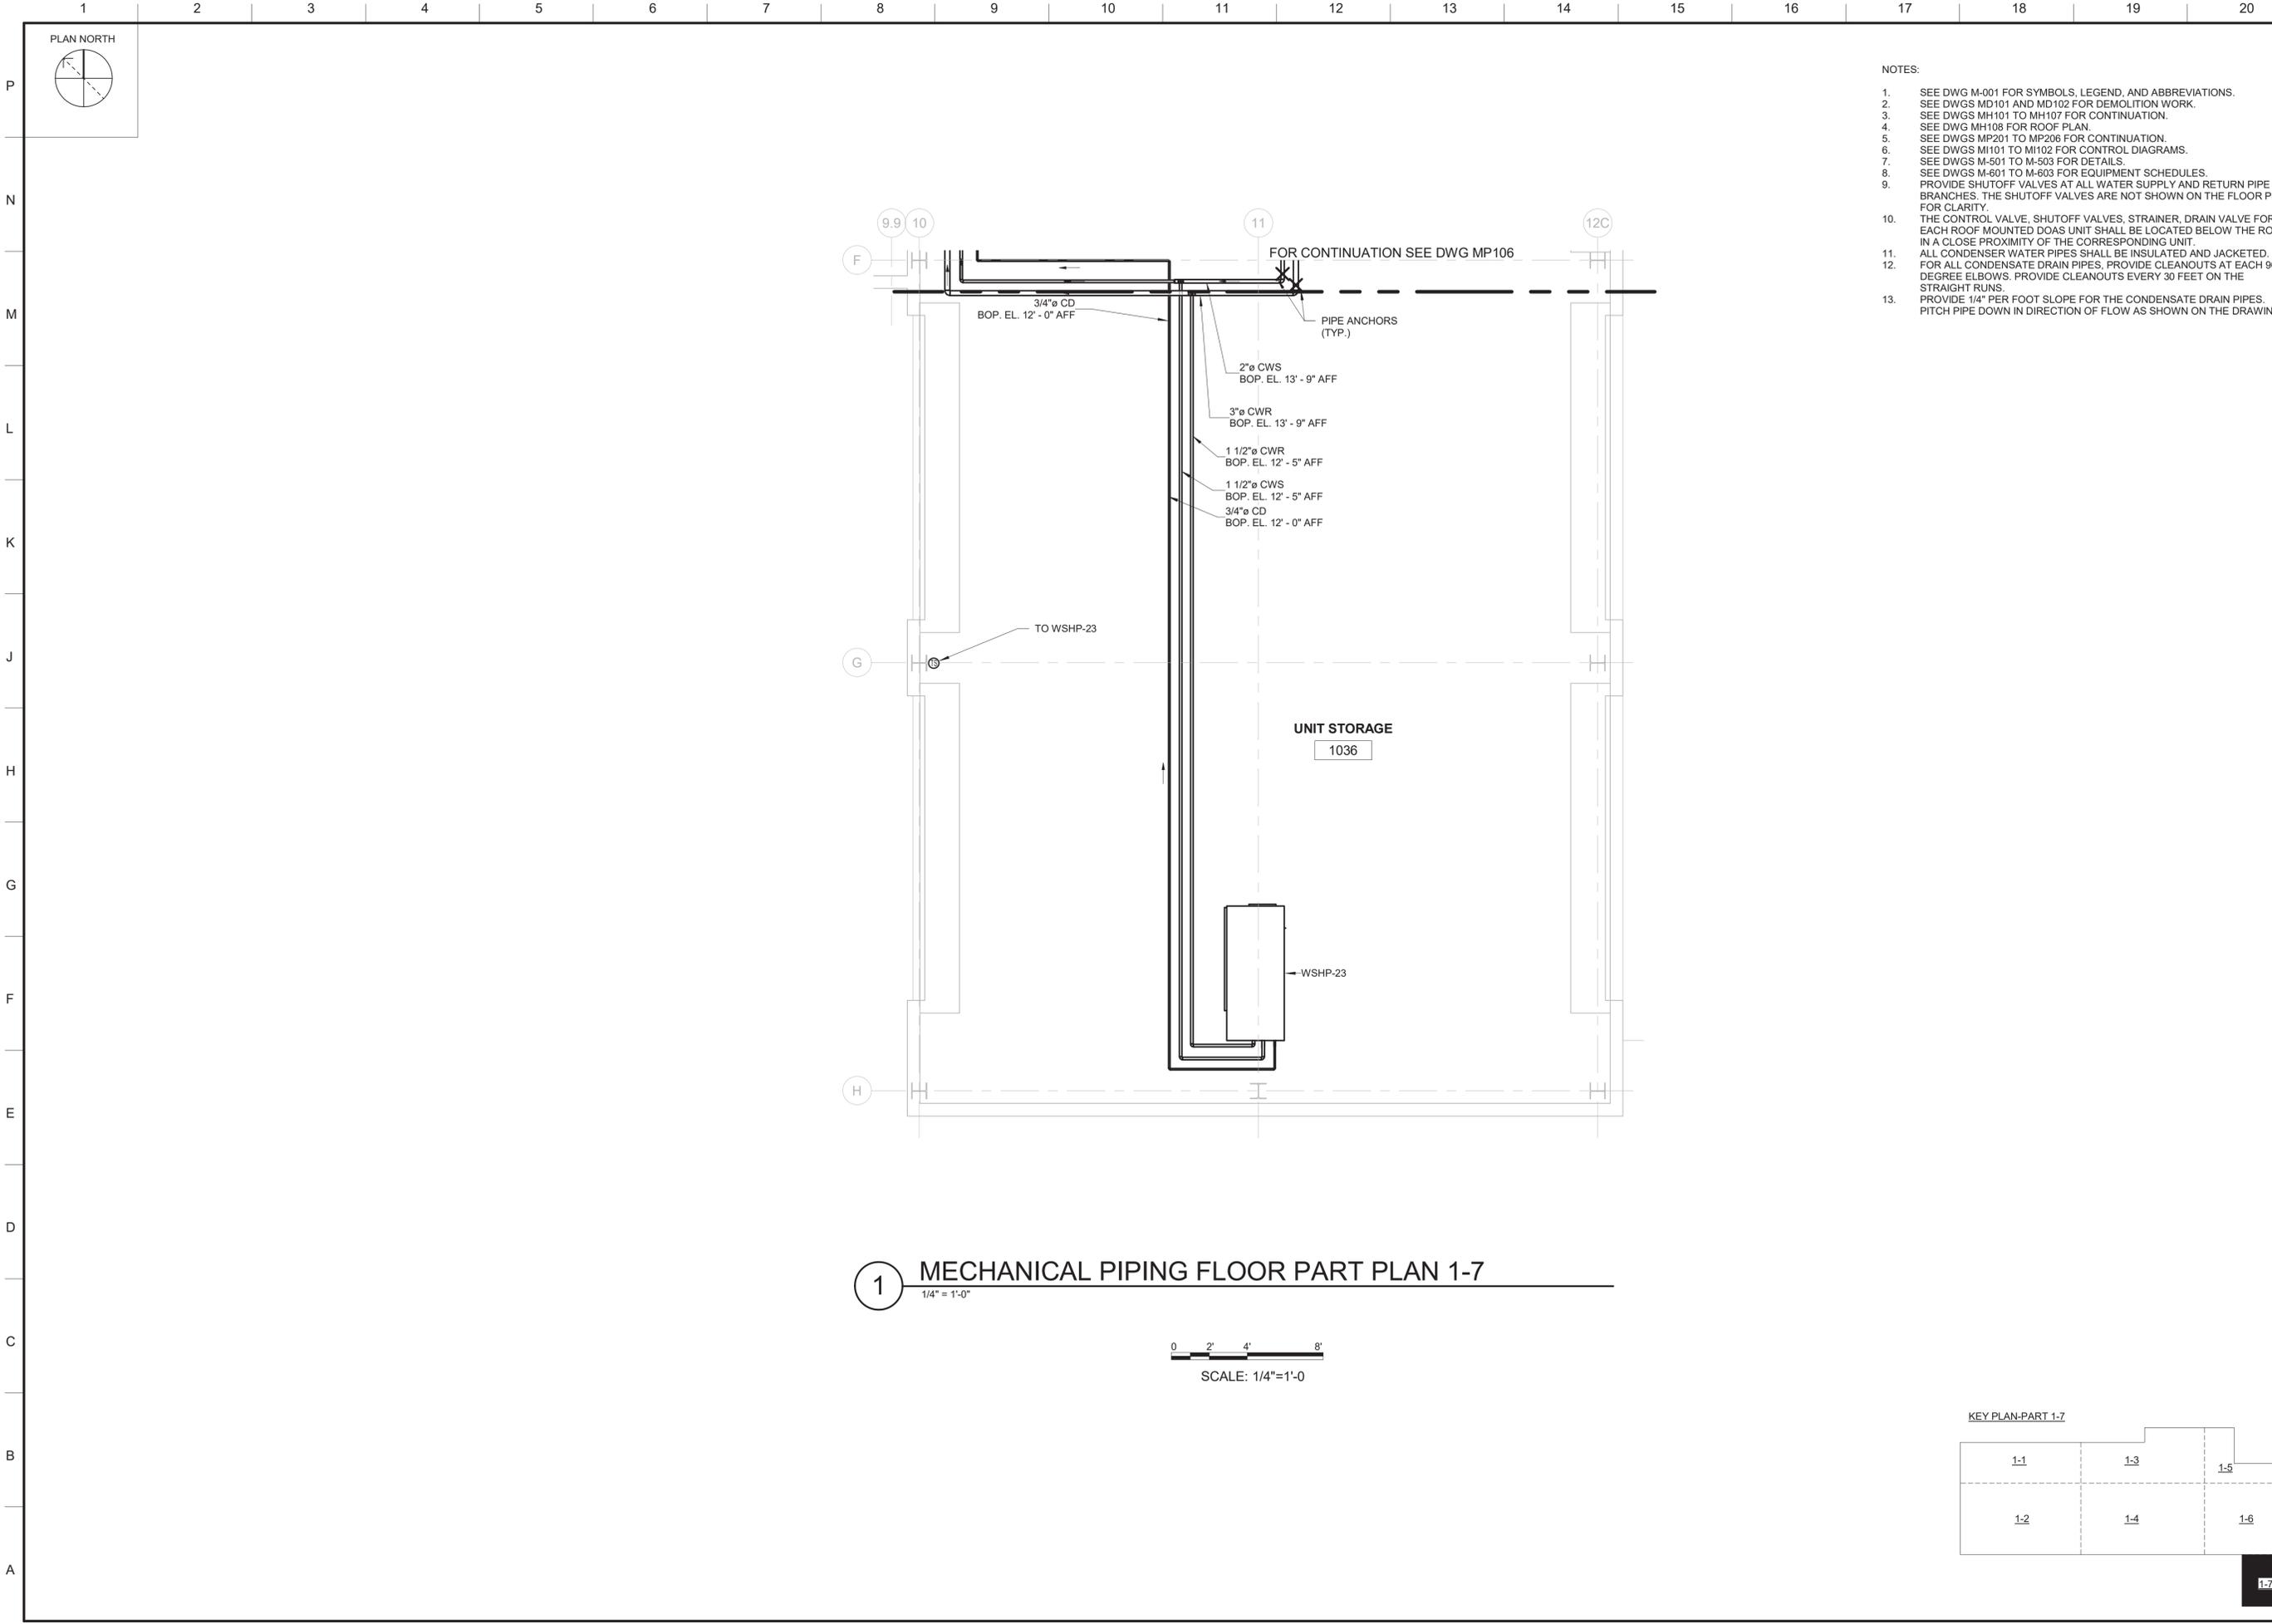
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ORANGEBURG, NEW YORK

MECHANICAL PIPING FLOOR PART PLAN 1-6

SHEET ID	DATE
<b>MP106</b>	

CORRECTED FINAL SUBMISSION - JULY 29, 2021



- NOTES:
- SEE DWG M-001 FOR SYMBOLS, LEGEND, AND ABBREVIATIONS.
  - SEE DWGS MD101 AND MD102 FOR DEMOLITION WORK.
  - SEE DWGS MH101 TO MH107 FOR CONTINUATION.
  - SEE DWG MH108 FOR ROOF PLAN.
  - SEE DWGS MP201 TO MP206 FOR CONTINUATION.
  - SEE DWGS MI101 TO MI102 FOR CONTROL DIAGRAMS.
  - SEE DWGS M-501 TO M-503 FOR DETAILS.
  - SEE DWGS M-601 TO M-603 FOR EQUIPMENT SCHEDULES.
  - PROVIDE SHUTOFF VALVES AT ALL WATER SUPPLY AND RETURN PIPE BRANCHES. THE SHUTOFF VALVES ARE NOT SHOWN ON THE FLOOR PLAN FOR CLARITY.
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 DRAWN BY: DGL  
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 SUBMITTED BY: ANSID


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 LOUISVILLE, KY

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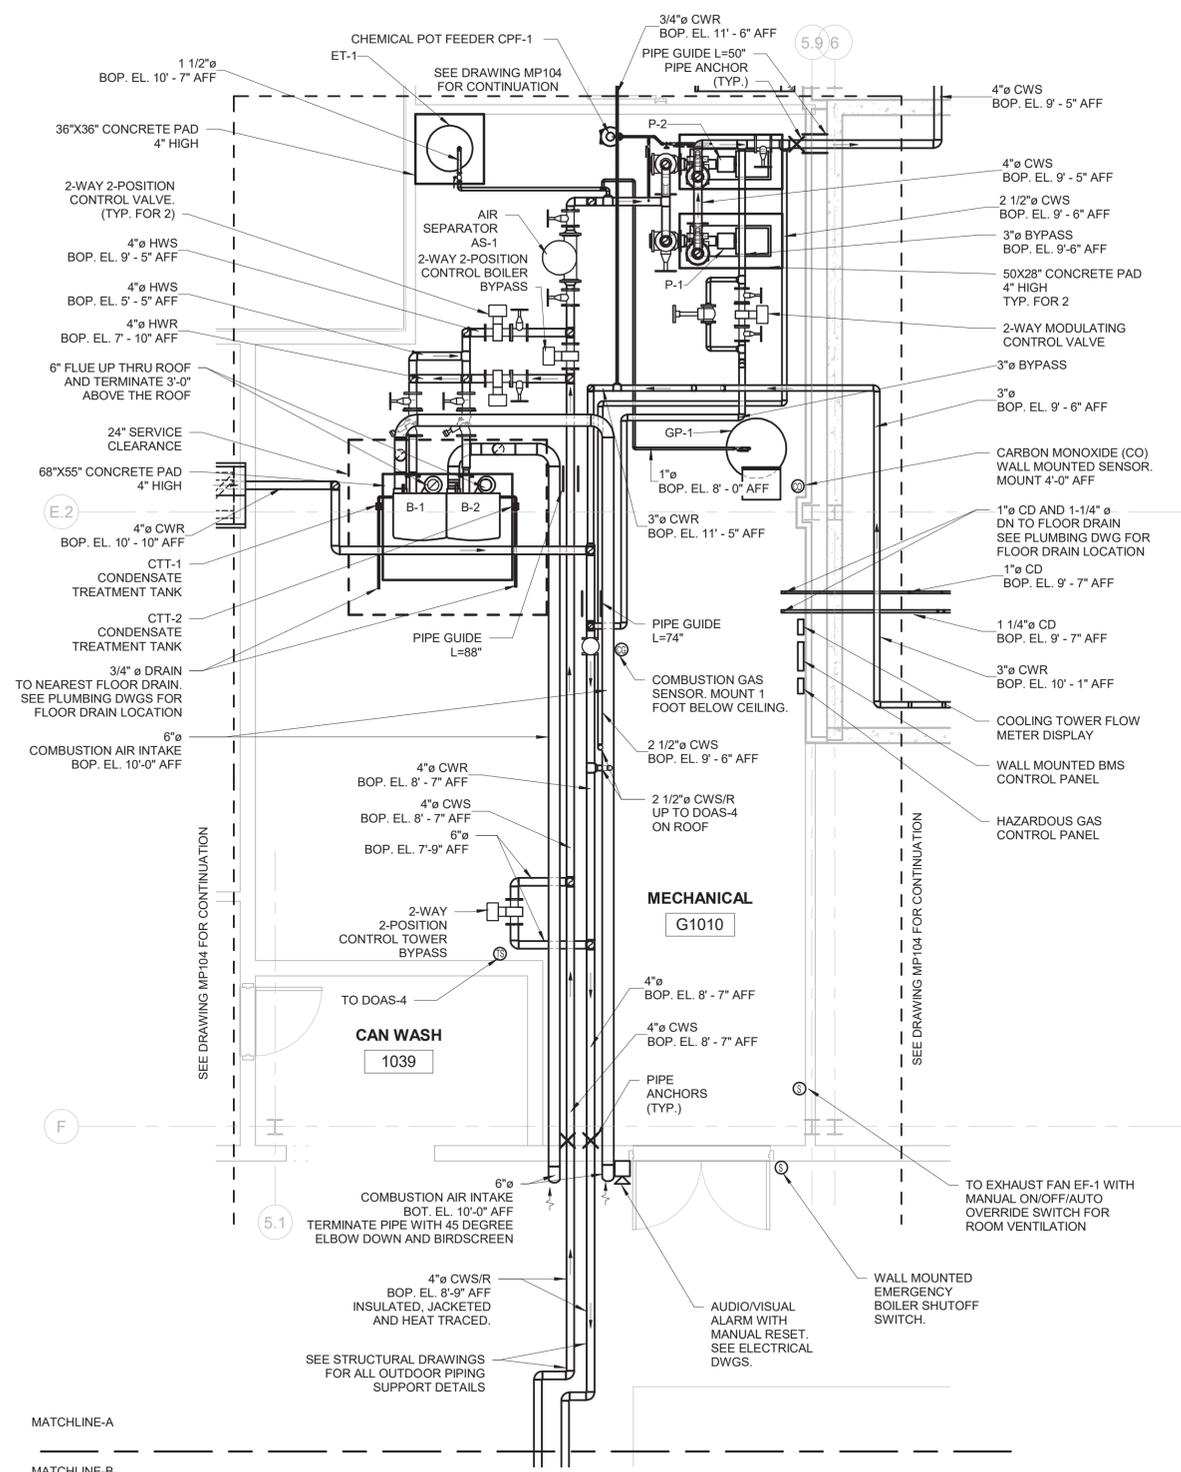
**1** MECHANICAL PIPING FLOOR PART PLAN 1-7  
 1/4" = 1'-0"




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MECHANICAL PIPING FLOOR PART PLAN 1-7

SHEET ID  
**MP107**

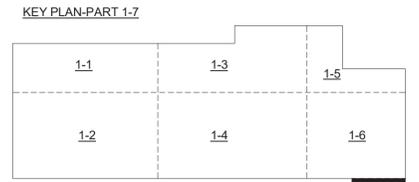

**1** MECHANICAL PIPING-MECHANICAL ROOM G1010 PLAN  
1/4" = 1'-0"

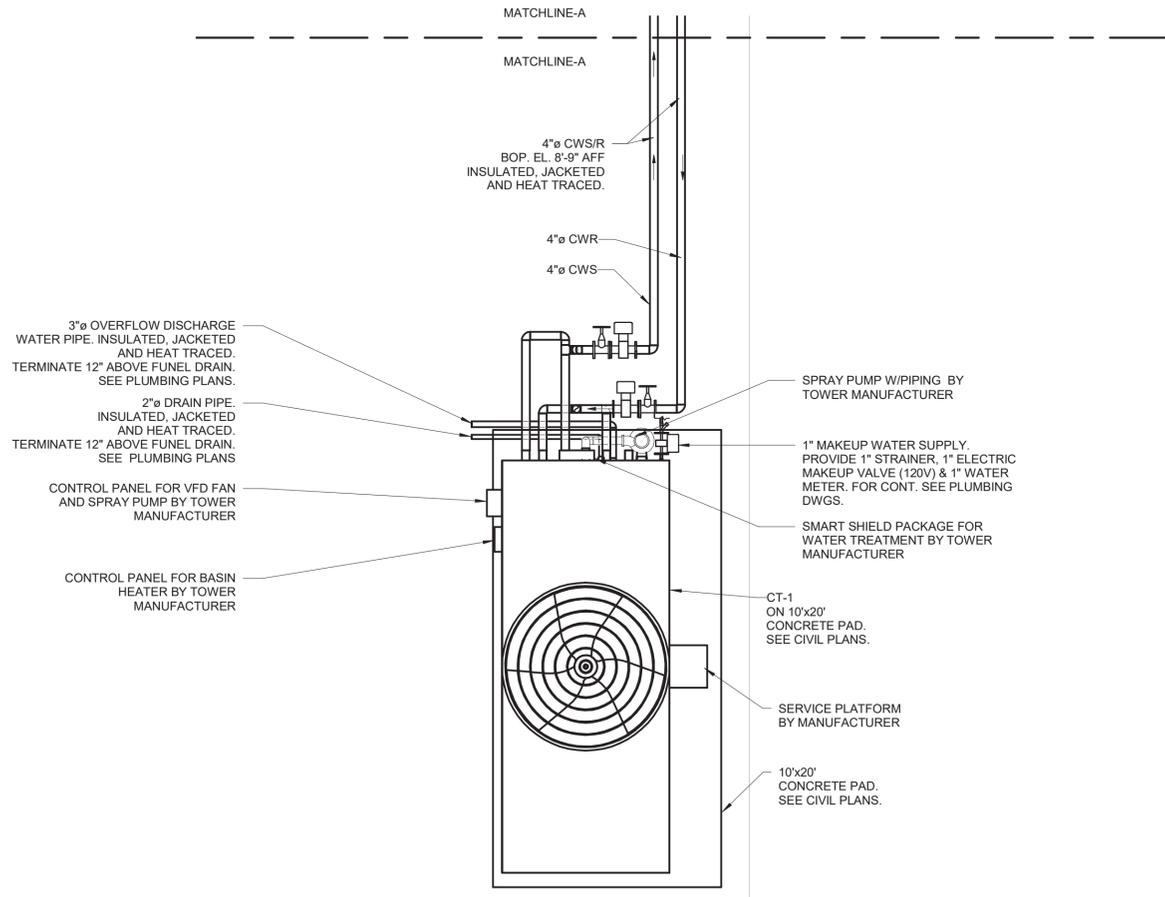

**2** MECHANICAL PIPING-COOLING TOWER PLAN  
1/4" = 1'-0"



- NOTES:
- SEE DWG M-001 FOR LEGEND, ABBREVIATIONS & GENERAL NOTES.
  - SEE DWGS MD101 AND MD102 FOR DEMOLITION FLOOR PLANS.
  - SEE DWG MH104 FOR DUCTWORK FLOOR PLAN.
  - SEE DWGS M101 TO M104 FOR CONTROL SCHEMATICS & SEQUENCE OF OPERATION.
  - SEE DWGS M-501 TO M-503 FOR DETAILS.
  - SEE DWGS M-601 TO M-603 FOR EQUIPMENT SCHEDULES.
  - ALL CONDENSER WATER AND CONDENSATE DRAIN PIPES SHALL BE INSULATED.
  - PROVIDE HEAT TRACING, THERMAL INSULATION AND JACKETING FOR THE COOLING TOWER MOUNTED SPRAY PUMP AND SPRAY PIPING, STANDPIPE ASSEMBLY, MAKEUP PIPING AND SOLENOID VALVE, OVERFLOW AND DRAIN LINES, ANY OTHER CONNECTIONS TO ACCESSORIES AT OR BELOW THE WATER LEVEL SUCH AS ELECTRONIC WATER LEVEL CONTROLLERS. THE CONTRACTOR SHALL PROVIDE, FIELD INSTALL, AND WIRE THE HEAT TRACING SYSTEM WHICH SHALL OPERATE UNDER BUILT IN CONTROLS (BY HEAT TRACING MANUFACTURER). INTEGRATE OPERATION OF THE HEAT TRACING SYSTEM TO THE BMS FOR MONITORING AND ALARMS. SEE ELECTRICAL DWGS FOR THE HEAT TRACING SYSTEM.
  - FOR ALL CONDENSATE DRAIN PIPES, PROVIDE CLEANOUTS AT EACH 90 DEGREE ELBOWS. PROVIDE CLEANOUTS EVERY 30 FEET ON THE STRAIGHT RUNS.
  - PROVIDE 1/4" PER FOOT SLOPE FOR THE CONDENSATE DRAIN PIPES. PITCH PIPE DOWN IN DIRECTION OF FLOW AS SHOWN ON THE DRAWING.



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MECHANICAL PIPING-MECHANICAL ROOM G1010  
 PLAN

SHEET ID  
**MP108**

CORRECTED FINAL SUBMISSION - JULY 29, 2021