

Drawing Name: S:\Projects\Ossining\JFS\Brookside 2 CR Add'l Design\JFS\Brookside 2 CR Add'l Design\06 CAD\AutoCAD\MECH\HV\H000.dwg Date last plotted: 1/4/2021 9:57 AM Plotted By: Brendon Mazza

**HVAC SYMBOLS LIST**


| SYMBOL | DESCRIPTION                   | SYMBOL | DESCRIPTION  | SYMBOL | DESCRIPTION   | SYMBOL | DESCRIPTION                                      | SYMBOL | DESCRIPTION                                     |
|--------|-------------------------------|--------|--|--------|---|--------|--|--------|---|
| AAD    | AUTOMATIC AIR DAMPER          |        | CONNECTION - TOP   |        | DOUBLE WALL LINED DUCT                                  |        | SUPPLY / RETURN / EXHAUST AIR TAKEOFFS           |        | ELECTRIC/PNEUMATIC SWITCH OR RELAY              |
| ACC    | AIR-COOLED CONDENSING UNIT    |        | CONNECTION - BOTTOM  |        | DUCT SECTION - SUPPLY                                   |        | SUPPLY / RETURN / EXHAUST AIR TAKEOFFS           |        | PNEUMATIC/ELECTRIC SWITCH OR RELAY              |
| AD     | ACCESS DOOR                   |        | DIRECTION OF FLOW  |        | DUCT SECTION - RETURN/EXHAUST                           |        | SUPPLY / RETURN / EXHAUST AIR TAKEOFFS           |        | CURRENT TRANSDUCER                              |
| AFF    | ABOVE FINISHED FLOOR          |        | REDUCER  |        | DUCT SECTION - ROUND DUCT IN INCHES                     |        | SUPPLY / RETURN / EXHAUST AIR TAKEOFFS           |        | OPEN/CLOSED                                     |
| AHU    | AIR HANDLING UNIT             |        | CAP OR PLUG  |        | DUCT SECTION - FLAT OVAL DUCT IN INCHES                 |        | SUPPLY / RETURN / EXHAUST AIR TAKEOFFS           |        | START/STOP                                      |
| BBD    | BOILER BLOW DOWN              |        | ELBOW DOWN   |        | ACOUSTIC THERMAL LINING                                 |        | SUPPLY / RETURN / EXHAUST AIR TAKEOFFS           |        | ENABLE/DISABLE                                  |
| BD     | BACKDRAFT DAMPER              |        | ELBOW UP   |        | FLEXIBLE DUCTWORK                                       |        | SUPPLY / RETURN / EXHAUST AIR TAKEOFFS           |        | TEMPERATURE SENSOR (DUCT OR PIPE MOUNTED)       |
| CA     | COMPRESSED AIR                |        | TEE OUTLET - UP  |        | FLEXIBLE CONNECTION                                     |        | SUPPLY AIR TAKEOFFS                              |        | HUMIDITY SENSOR (DUCT MOUNTED)                  |
| CD     | COOLING COIL CONDENSATE DRAIN |        | TEE OUTLET - DOWN  |        | UNION   |        | SUPPLY AIR TAKEOFFS                              |        | FLOW TRANSMITTER                                |
| CFM    | CUBIC FEET PER MINUTE         |        | GATE VALVE   |        | FIRE DAMPER   |        | SUPPLY AIR TAKEOFFS                              |        | PRESSURE TRANSMITTER                            |
| CHWR   | CHILLED WATER RETURN          |        | BALL VALVE   |        | SMOKE DAMPER  |        | SUPPLY AIR TAKEOFFS                              |        | DIFFERENTIAL PRESSURE TRANSMITTER               |
| CHWS   | CHILLED WATER SUPPLY          |        | BALANCING VALVE  |        | COMBINATION FIRE AND SMOKE DAMPER                       |        | SUPPLY AIR TAKEOFFS                              |        | ELECTRIC/PNEUMATIC TRANSDUCER                   |
| CR     | CONDENSER WATER RETURN        |        | STRAINER   |        | VOLUME DAMPER   |        | SUPPLY AIR TAKEOFFS                              |        | ELECTRIC/ELECTRONIC TRANSDUCER                  |
| CS     | CONDENSER WATER SUPPLY        |        | STRAINER WITH BLOW-DOWN  |        | DAMPER CONTROL, PARALLEL BLADE                          |        | SUPPLY AIR TAKEOFFS                              |        | DUCT SMOKE DETECTOR                             |
| CW     | DOMESTIC COLD WATER           |        | BUTTERFLY VALVE  |        | DAMPER CONTROL, OPPOSED BLADE                           |        | SPACE THERMOSTAT                                 |        | SPACE TEMPERATURE SENSOR                        |
| D      | DRAIN                         |        | BUTTERFLY CONTROL VALVE, PNEUMATIC 2-WAY                               |        | AUTOMATIC AIR DAMPER                                    |        | SPACE CARBON DIOXIDE SENSOR                      |        | SPACE CARBON MONOXIDE SENSOR                    |
| (E)    | EXISTING                      |        | BUTTERFLY CONTROL VALVE, ELECTRIC ACTUATOR                             |        | BACK DRAFT DAMPER                                       |        | SPACE NATURAL GAS SENSOR                         |        | SPACE SENSOR WITH GUARD                         |
| EA     | EXHAUST AIR                   |        | GLOBE VALVE  |        | BLAST GATE  |        | WATER FLOW SENSOR                                |        | PNEUMATIC ACTUATOR                              |
| EC     | ELECTRICAL CONTRACTOR         |        | CHECK VALVE  |        | AIR VENT - MANUAL                                       |        | ELECTRIC ACTUATOR                                |        | VARIABLE SPEED / FREQUENCY DRIVE                |
| EF     | EXHAUST FAN                   |        | TRIPLE DUTY VALVE  |        | AIR VENT - AUTOMATIC                                    |        | COOLING COIL                                     |        | HEATING COIL                                    |
| EHF    | ELECTRIC REHEAT COIL          |        | GAS COCK, PLUG VALVE   |        | FLANGE  |        | GAS FURNACE                                      |        | HUMIDIFIER                                      |
| ER     | EXISTING TO REMAIN            |        | UNDERCUT DOOR 1"   |        | CONTROL/SOLENOID VALVE, ELECTRIC 2-WAY                  |        | ALARM  |        | STATUS  |
| EA     | EXHAUST AIR                   |        | LOUVERED DOOR W/ SQ. FT. OF FREE AREA                                  |        | CONTROL VALVE, ELECTRIC 3-WAY                           |        | FLOW SWITCH                                      |        | DIFFERENTIAL STATIC PRESSURE SWITCH             |
| EC     | ELECTRICAL CONTRACTOR         |        | AIR DUCT (FIRST FIGURE IS DUCT WIDTH/TOP, SECOND FIGURE IS DUCT DEPTH) |        | CONTROL VALVE, PNEUMATIC 2-WAY                          |        | RELAY  |        | PRESSURE GAUGE                                  |
| EHF    | ELECTRIC REHEAT COIL          |        | MULTI-BLADE AIR EXTRACTOR  |        | CONTROL VALVE, PNEUMATIC 3-WAY                          |        | FREEZE-STAT                                      |        | DIGITAL INPUT (TO BUILDING MANAGEMENT SYSTEM)   |
| ER     | EXISTING TO REMAIN            |        | TURNING VANES  |        | RELIEF / SAFETY VALVE                                   |        | DIGITAL OUTPUT (FROM BUILDING MANAGEMENT SYSTEM) |        | ANALOG OUTPUT (FROM BUILDING MANAGEMENT SYSTEM) |
| EA     | EXHAUST AIR                   |        | EXISTING WORK TO BE REMOVED (HATCHED)                                  |        | PRESSURE REDUCING VALVE                                 |        | ANALOG INPUT (TO BUILDING MANAGEMENT SYSTEM)     |        | ELECTRICAL INTERFACE                            |
| EC     | ELECTRICAL CONTRACTOR         |        | POINT OF CONNECTION  |        | VACUUM BREAKER  |        | SPEED FEEDBACK                                   |        | END SWITCH                                      |
| EHF    | ELECTRIC REHEAT COIL          |        | POINT OF DISCONNECTION   |        | FLEXIBLE PIPE CONNECTOR                                 |        | POSITION FEEDBACK                                |        | TRAVERSE AVERAGING SENSOR                       |
| ER     | EXISTING TO REMAIN            |        | AIR FLOW SENSOR  |        | EXPANSION COMPENSATOR W/ GUIDES                         |        | PROBE SENSOR                                     |        | FREEZE STAT SENSOR                              |
| EA     | EXHAUST AIR                   |        | FILTER   |        | EXPANSION JOINT   |        | LONG RADIUS 90° ELBOW R/W=1.5                    |        | DUCT TURNING UP OR DOWN                         |
| EC     | ELECTRICAL CONTRACTOR         |        | TRANSITION SQUARE TO ROUND   |        | PIPE ANCHOR   |        | LONG RADIUS 45° ELBOW R/W=1.5                    |        | AIR TERMINAL UNIT-DUCTWORK U - UNIT TYPE        |
| EHF    | ELECTRIC REHEAT COIL          |        | HUMIDIFIER DISPERSION TUBE   |        | PIPE GUIDE  |        | 90° ELBOW WITH TURNING VANES                     |        | AIR TERMINAL UNIT-DUCTWORK U - UNIT TYPE        |
| ER     | EXISTING TO REMAIN            |        | RISE IN DUCT   |        | THERMOSTATIC TRAP                                       |        | 90° VERTICAL SPLIT OFF (PLAN VIEW)               |        | AIR TERMINAL UNIT-DUCTWORK U - UNIT TYPE        |
| EA     | EXHAUST AIR                   |        | DROP IN DUCT   |        | FLOAT & THERMOSTATIC TRAP                               |        | SQUARE CEILING DIFFUSER (4 WAY)                  |        | FAN POWERED AIR TERMINAL UNIT                   |
| EC     | ELECTRICAL CONTRACTOR         |        | ROUND CEILING DIFFUSER   |        | BUCKET TRAP   |        | ROUND CEILING DIFFUSER                           |        | AIR TERMINAL UNIT-DUCTWORK U - UNIT TYPE        |
| EHF    | ELECTRIC REHEAT COIL          |        | SQUARE OR RECTANGULAR CEILING GRILLE                                   |        | THERMODYNAMIC TRAP                                      |        | SQUARE CEILING DIFFUSER (4 WAY)                  |        | AIR TERMINAL UNIT-DUCTWORK U - UNIT TYPE        |
| ER     | EXISTING TO REMAIN            |        | SUPPLY REGISTER, RETURN OR EXHAUST GRILLE                              |        | THERMOMETER   |        | SQUARE OR RECTANGULAR CEILING GRILLE             |        | AIR TERMINAL UNIT-DUCTWORK U - UNIT TYPE        |
| EA     | EXHAUST AIR                   |        | SUPPLY DIFFUSER, 1-WAY, 2-WAY, 3-WAY                                   |        | WELL  |        | SUPPLY REGISTER, RETURN OR EXHAUST GRILLE        |        | AIR TERMINAL UNIT-DUCTWORK U - UNIT TYPE        |
| EC     | ELECTRICAL CONTRACTOR         |        | CEILING DIFFUSER WITH NECK SIZE, TYPE, & CFM                           |        | PRESSURE GAUGE  |        | SUPPLY REGISTER, RETURN OR EXHAUST GRILLE        |        | AIR TERMINAL UNIT-DUCTWORK U - UNIT TYPE        |
| EHF    | ELECTRIC REHEAT COIL          |        | CEILING RETURN OR EXHAUST GRILLE WITH SIZE, TYPE, & CFM                |        | STEAM PRESSURE GAUGE WITH 1/4" NEEDLE VALVE             |        | SUPPLY REGISTER, RETURN OR EXHAUST GRILLE        |        | AIR TERMINAL UNIT-DUCTWORK U - UNIT TYPE        |
| ER     | EXISTING TO REMAIN            |        | FAN POWERED AIR TERMINAL UNIT U - UNIT TYPE                            |        | REFRIGERANT LIQUID PIPE                                 |        | SUPPLY REGISTER, RETURN OR EXHAUST GRILLE        |        | AIR TERMINAL UNIT-DUCTWORK U - UNIT TYPE        |
| EA     | EXHAUST AIR                   |        | AIR TERMINAL UNIT-DUCTWORK U - UNIT TYPE                               |        | REFRIGERANT SUCTION PIPE                                |        | SUPPLY REGISTER, RETURN OR EXHAUST GRILLE        |        | AIR TERMINAL UNIT-DUCTWORK U - UNIT TYPE        |
| EC     | ELECTRICAL CONTRACTOR         |        | AIR TERMINAL UNIT-DUCTWORK U - UNIT TYPE                               |        | ROOFTOP UNIT  |        | SUPPLY REGISTER, RETURN OR EXHAUST GRILLE        |        | AIR TERMINAL UNIT-DUCTWORK U - UNIT TYPE        |
| EHF    | ELECTRIC REHEAT COIL          |        | AIR TERMINAL UNIT-DUCTWORK U - UNIT TYPE                               |        | ROOF VENT   |        | SUPPLY REGISTER, RETURN OR EXHAUST GRILLE        |        | AIR TERMINAL UNIT-DUCTWORK U - UNIT TYPE        |
| ER     | EXISTING TO REMAIN            |        | AIR TERMINAL UNIT-DUCTWORK U - UNIT TYPE                               |        | PIPING  |        | SUPPLY REGISTER, RETURN OR EXHAUST GRILLE        |        | AIR TERMINAL UNIT-DUCTWORK U - UNIT TYPE        |
| EA     | EXHAUST AIR                   |        | AIR TERMINAL UNIT-DUCTWORK U - UNIT TYPE                               |        | PIPING BELOW GRADE                                      |        | SUPPLY REGISTER, RETURN OR EXHAUST GRILLE        |        | AIR TERMINAL UNIT-DUCTWORK U - UNIT TYPE        |
| EC     | ELECTRICAL CONTRACTOR         |        | AIR TERMINAL UNIT-DUCTWORK U - UNIT TYPE                               |        | BASE MOUNTED PUMP                                       |        | SUPPLY REGISTER, RETURN OR EXHAUST GRILLE        |        | AIR TERMINAL UNIT-DUCTWORK U - UNIT TYPE        |
| EHF    | ELECTRIC REHEAT COIL          |        | AIR TERMINAL UNIT-DUCTWORK U - UNIT TYPE                               |        | IN-LINE PUMP  |        | SUPPLY REGISTER, RETURN OR EXHAUST GRILLE        |        | AIR TERMINAL UNIT-DUCTWORK U - UNIT TYPE        |
| ER     | EXISTING TO REMAIN            |        | AIR TERMINAL UNIT-DUCTWORK U - UNIT TYPE                               |        | AIR TERMINAL UNIT WITH REHEAT COIL AND SOUND ATTENUATOR |        | SUPPLY REGISTER, RETURN OR EXHAUST GRILLE        |        | AIR TERMINAL UNIT-DUCTWORK U - UNIT TYPE        |
| EA     | EXHAUST AIR                   |        | AIR TERMINAL UNIT-DUCTWORK U - UNIT TYPE                               |        | AIR TERMINAL UNIT WITH SOUND ATTENUATOR                 |        | SUPPLY REGISTER, RETURN OR EXHAUST GRILLE        |        | AIR TERMINAL UNIT-DUCTWORK U - UNIT TYPE        |
| EC     | ELECTRICAL CONTRACTOR         |        | AIR TERMINAL UNIT-DUCTWORK U - UNIT TYPE                               |        | AIR TERMINAL UNIT WITH REHEAT COIL                      |        | SUPPLY REGISTER, RETURN OR EXHAUST GRILLE        |        | AIR TERMINAL UNIT-DUCTWORK U - UNIT TYPE        |
| EHF    | ELECTRIC REHEAT COIL          |        | AIR TERMINAL UNIT-DUCTWORK U - UNIT TYPE                               |        | AIR TERMINAL UNIT                                       |        | SUPPLY REGISTER, RETURN OR EXHAUST GRILLE        |        | AIR TERMINAL UNIT-DUCTWORK U - UNIT TYPE        |
| ER     | EXISTING TO REMAIN            |        | AIR TERMINAL UNIT-DUCTWORK U - UNIT TYPE                               |        | W/W ENCL. WALL TO WALL FIN TUBE ENCLOSURE               |        | SUPPLY REGISTER, RETURN OR EXHAUST GRILLE        |        | AIR TERMINAL UNIT-DUCTWORK U - UNIT TYPE        |
| EA     | EXHAUST AIR                   |        | AIR TERMINAL UNIT-DUCTWORK U - UNIT TYPE                               |        | ACOUSTIC/THERMAL DUCTWORK LINING - 1 INCH THICK         |        | SUPPLY REGISTER, RETURN OR EXHAUST GRILLE        |        | AIR TERMINAL UNIT-DUCTWORK U - UNIT TYPE        |
| EC     | ELECTRICAL CONTRACTOR         |        | AIR TERMINAL UNIT-DUCTWORK U - UNIT TYPE                               |        | ACOUSTIC/THERMAL DUCTWORK LINING - 2 INCH THICK         |        | SUPPLY REGISTER, RETURN OR EXHAUST GRILLE        |        | AIR TERMINAL UNIT-DUCTWORK U - UNIT TYPE        |
| EHF    | ELECTRIC REHEAT COIL          |        | AIR TERMINAL UNIT-DUCTWORK U - UNIT TYPE                               |        | ACOUSTIC/THERMAL DUCTWORK PLENUM LINING - 1 INCH THICK  |        | SUPPLY REGISTER, RETURN OR EXHAUST GRILLE        |        | AIR TERMINAL UNIT-DUCTWORK U - UNIT TYPE        |
| ER     | EXISTING TO REMAIN            |        | AIR TERMINAL UNIT-DUCTWORK U - UNIT TYPE                               |        | ACOUSTIC/THERMAL DUCTWORK PLENUM LINING - 2 INCH THICK  |        | SUPPLY REGISTER, RETURN OR EXHAUST GRILLE        |        | AIR TERMINAL UNIT-DUCTWORK U - UNIT TYPE        |
| EA     | EXHAUST AIR                   |        | AIR TERMINAL UNIT-DUCTWORK U - UNIT TYPE                               |        | AIR FLOW  |        | SUPPLY REGISTER, RETURN OR EXHAUST GRILLE        |        | AIR TERMINAL UNIT-DUCTWORK U - UNIT TYPE        |
| EC     | ELECTRICAL CONTRACTOR         |        | AIR TERMINAL UNIT-DUCTWORK U - UNIT TYPE                               |        | ACOUSTIC/THERMAL DUCTWORK LINING - 1 INCH THICK         |        | SUPPLY REGISTER, RETURN OR EXHAUST GRILLE        |        | AIR TERMINAL UNIT-DUCTWORK U - UNIT TYPE        |
| EHF    | ELECTRIC REHEAT COIL          |        | AIR TERMINAL UNIT-DUCTWORK U - UNIT TYPE                               |        | ACOUSTIC/THERMAL DUCTWORK LINING - 2 INCH THICK         |        | SUPPLY REGISTER, RETURN OR EXHAUST GRILLE        |        | AIR TERMINAL UNIT-DUCTWORK U - UNIT TYPE        |
| ER     | EXISTING TO REMAIN            |        | AIR TERMINAL UNIT-DUCTWORK U - UNIT TYPE                               |        | ACOUSTIC/THERMAL DUCTWORK PLENUM LINING - 1 INCH THICK  |        | SUPPLY REGISTER, RETURN OR EXHAUST GRILLE        |        | AIR TERMINAL UNIT-DUCTWORK U - UNIT TYPE        |
| EA     | EXHAUST AIR                   |        | AIR TERMINAL UNIT-DUCTWORK U - UNIT TYPE                               |        | ACOUSTIC/THERMAL DUCTWORK PLENUM LINING - 2 INCH THICK  |        | SUPPLY REGISTER, RETURN OR EXHAUST GRILLE        |        | AIR TERMINAL UNIT-DUCTWORK U - UNIT TYPE        |

**SYMBOLS GENERAL NOTES:**

1) VALVE AND DAMPER ACTUATOR TYPES (ELECTRIC OR PNEUMATIC) WHICH ARE INDICATED IN HVAC TEMPERATURE CONTROL DRAWINGS SHALL SUPERSEDE TYPE INDICATED ON ALL OTHER HVAC DRAWINGS.

**HVAC CONTRACTOR GENERAL NOTES:**

- A. IT IS THE RESPONSIBILITY OF THE CONTRACTOR TO FIELD VERIFY EXISTING CONDITIONS WITHIN THE BUILDING PRIOR TO COMMENCEMENT OF ALL DEMOLITION AND NEW WORK.
- B. IT IS THE RESPONSIBILITY OF THE CONTRACTOR TO REMOVE AND REPLACE EXISTING CEILING, UNLESS OTHERWISE NOTED ON THE ARCHITECTURAL DRAWINGS, FOR PERFORMING DEMOLITION OR NEW WORK WITHIN THE BUILDING. THE EXISTING CEILING SHALL BE REMOVED IN A MANNER TO AVOID DAMAGE TO THE CEILING SYSTEMS. STORAGE OF CEILING SYSTEM COMPONENTS FOR REINSTALLATION IS THE RESPONSIBILITY OF THE CONTRACTOR. THE STORAGE OF ALL MATERIAL SHALL BE IN AREAS OR LOCATIONS APPROVED BY THE OWNER. THE OWNER WILL NOT COMPENSATE FOR ANY DAMAGED OR LOST MATERIAL WHILE IN STORAGE. AFTER COMPLETION OF ALL DEMOLITION OR NEW WORK, THE CONTRACTOR SHALL REINSTALL THE CEILING SYSTEMS TO MATCH THE ORIGINAL INSTALLATION.
- C. DEMOLITION DRAWINGS SHOW MAJOR EQUIPMENT, PIPING, AND DUCTWORK REMOVALS. THE INTENT IS NOT TO IDENTIFY ALL MISCELLANEOUS PIPING, PIPING ACCESSORIES, DUCTWORK, DUCTWORK ACCESSORIES, SUPPORTS, CONTROLS, CONTROL ACCESSORIES, CONTROL WIRING, CONDUIT, AND PNEUMATIC CONTROL TUBING TO BE DISCONNECTED AND REMOVED, BUT IS THE REQUIREMENT UNDER THIS CONTRACT. NO EQUIPMENT, PIPING, OR DUCTWORK SHALL BE ABANDONED IN PLACE, UNLESS OTHERWISE NOTED ON THE DRAWINGS.
- D. ALL EQUIPMENT INDICATED TO BE TURNED OVER TO THE OWNER SHALL BE DISCONNECTED AND REMOVED FROM THE EXISTING SYSTEMS AND DELIVERED (INCLUDING LOADING AND UNLOADING) TO A STORAGE AREA WITHIN THE BUILDING AS SELECTED BY THE OWNER. IT WILL BE THE RESPONSIBILITY OF THE CONTRACTOR TO REPAIR ANY EQUIPMENT DAMAGED DURING REMOVAL AND DELIVERY. ANY DAMAGE TO EQUIPMENT PRIOR TO DISCONNECTING SHOULD BE REPORTED TO THE OWNER'S REPRESENTATIVE. IF NOT REPORTED, THE CONTRACTOR TAKES FULL RESPONSIBILITY FOR REPAIRS TO THE EQUIPMENT.
- E. BEFORE DISCONNECTING, REMOVING, OR SERVICING ANY AIR CONDITIONING EQUIPMENT OR SYSTEMS CONTAINING REFRIGERANTS, THE EQUIPMENT OR SYSTEMS SHALL BE EVACUATED OF ALL REFRIGERANT PER THE LATEST ADOPTED RULES AND REGULATIONS BY THE UNITED STATES ENVIRONMENTAL PROTECTION AGENCY (EPA). THE CONTRACTOR OR TECHNICIAN PERFORMING THE WORK SHALL BE CERTIFIED BY AN EPA APPROVED CERTIFYING AGENCY OR ORGANIZATION.
- F. ALL DUCTWORK, PIPING, AND CONDUIT PENETRATIONS THROUGH RATED WALLS OR FLOORS SHALL BE PROVIDED WITH FIRE/SMOKE STOPPINGS PER SPECIFICATION. REFER TO CODE ANALYSIS DRAWING FOR ALL RATED WALL LOCATIONS. ALL FLOORS SHALL BE CONSIDERED RATED.
- G. UNLESS SHOWN ON THE ARCHITECTURAL DRAWINGS, IT IS THE RESPONSIBILITY OF THIS CONTRACTOR TO PATCH AND FINISH ALL EXISTING DUCTWORK OR PIPE PENETRATIONS THROUGH FLOORS, ROOFS, INTERIOR WALLS, AND EXTERIOR WALLS AFTER DEMOLITION WORK. IN ADDITION, ALL NEW PENETRATIONS SHALL BE PROVIDED FOR INSTALLATION OF MECHANICAL SYSTEMS INCLUDING, BUT NOT LIMITED TO, EQUIPMENT, CURBING, DUCTWORK, PIPING, CONTROLS, ETC. PATCHING AND FINISHING SHALL MATCH EXISTING CONSTRUCTION INCLUDING FIRE RATINGS. PROVIDE LINTELS PER LINTEL SCHEDULE.
- H. IT IS NOT THE INTENT OF THE DRAWINGS TO SHOW ALL AIR VENTS AND DRAINS IN THE PIPING SYSTEMS. IT IS THE RESPONSIBILITY OF THE CONTRACTOR TO PROVIDE AIR VENTS AT ALL SYSTEM HIGH POINTS AND AT AREAS WITHIN THE PIPING SYSTEMS THAT COULD ACCUMULATE OR TRAP AIR WHICH WOULD PREVENT PROPER VENTING OR OPERATION OF THE SYSTEMS. DRAINS SHALL BE PROVIDED AT ALL LOW POINTS WITHIN THE PIPING SYSTEM TO FACILITATE COMPLETE DRAINING OF THE SYSTEM.
- I. PROVIDE THERMAL EXPANSION COMPENSATORS AND THERMAL EXPANSION LOOPS IN PIPING SYSTEM PER INDUSTRY STANDARDS.

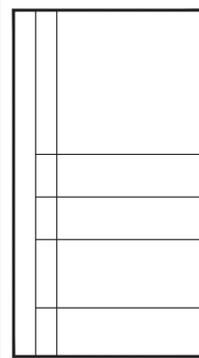


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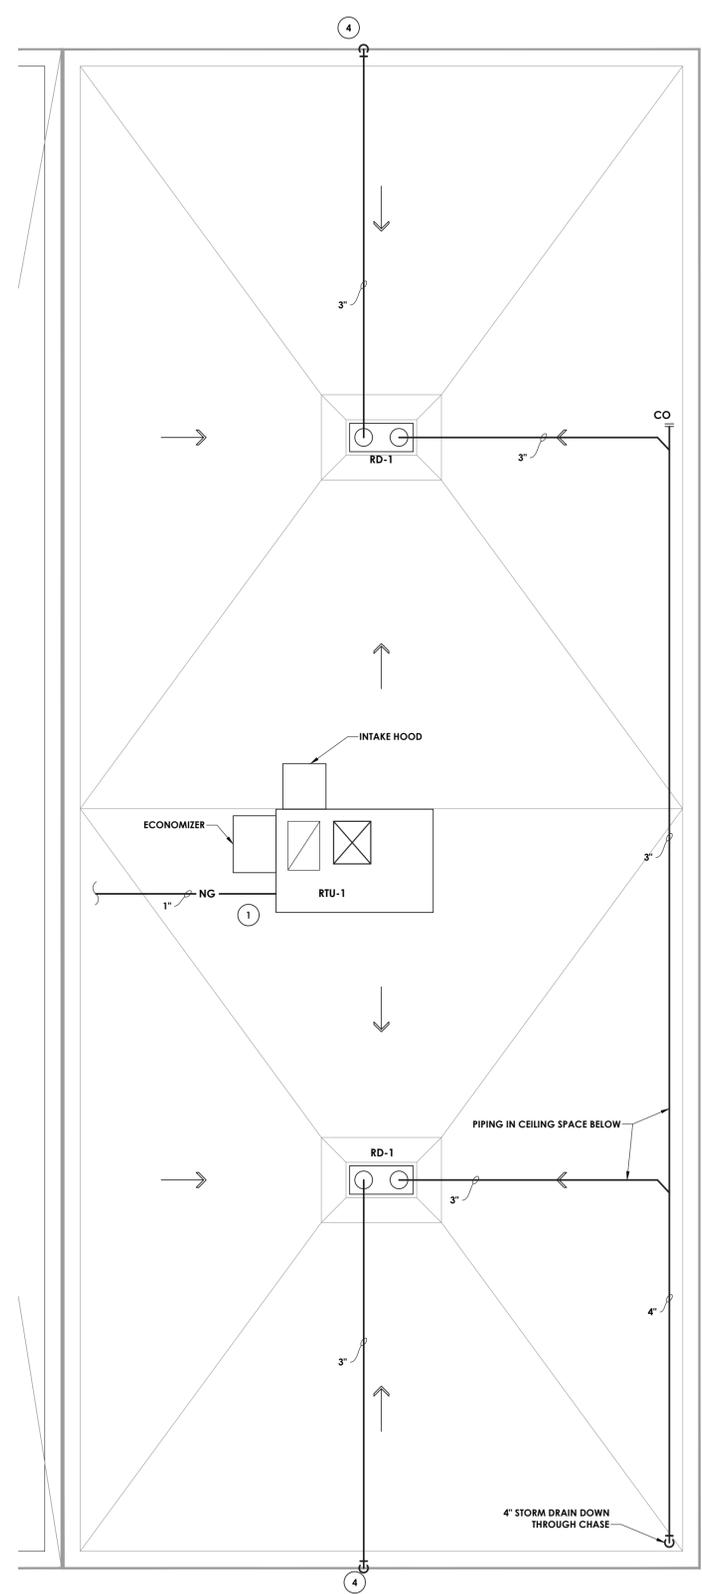
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| SCALE NTS         |       |         |
| SHEET TITLE       |       |         |
| HVAC SYMBOLS LIST |       |         |

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| BES H000       | DRAWING NUMBER |


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 Plotted By: Brendan Mazza

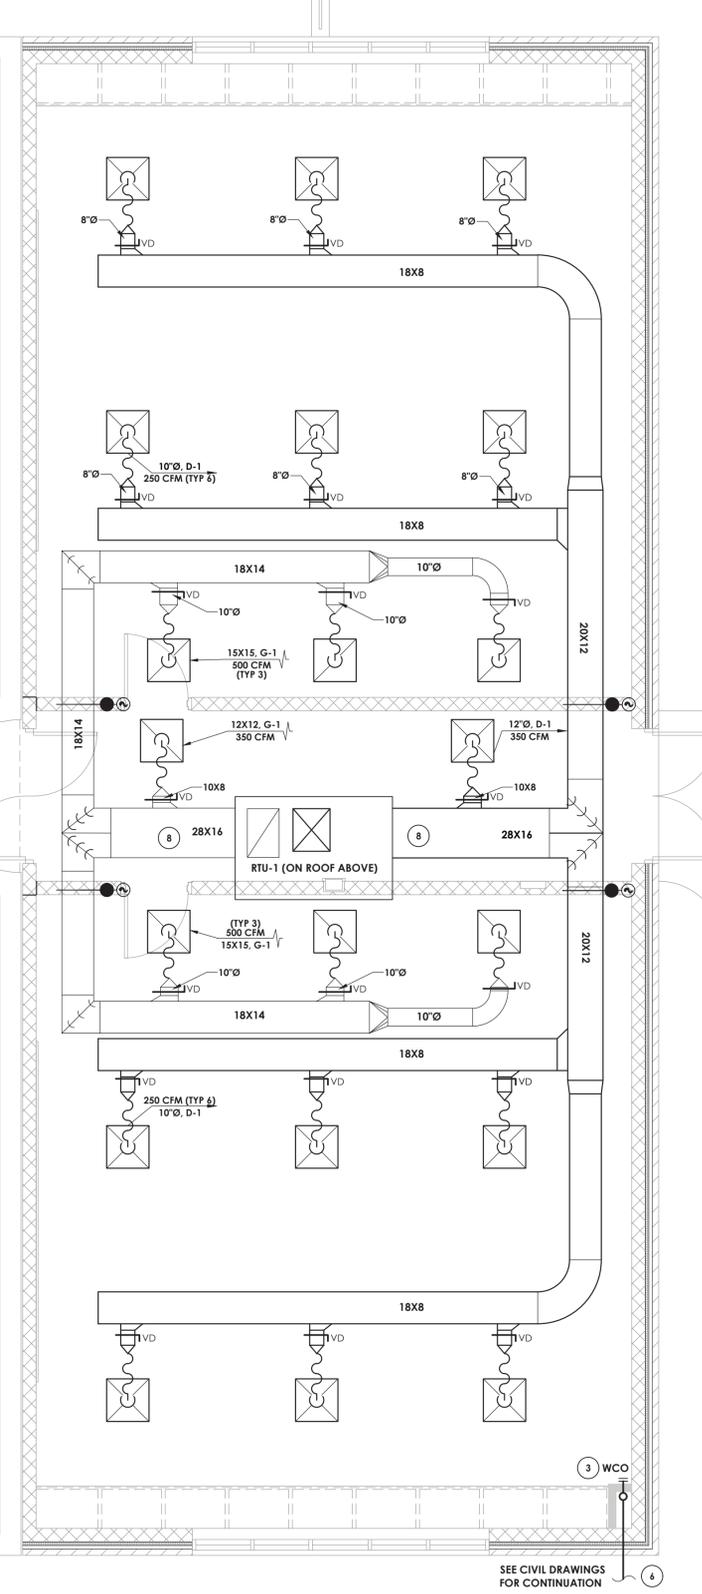


**1 FIRST FLOOR NEW WORK PLAN**  
SCALE: 1/4" = 1'-0"




**2 ROOF NEW WORK PLAN**  
SCALE: 1/4" = 1'-0"

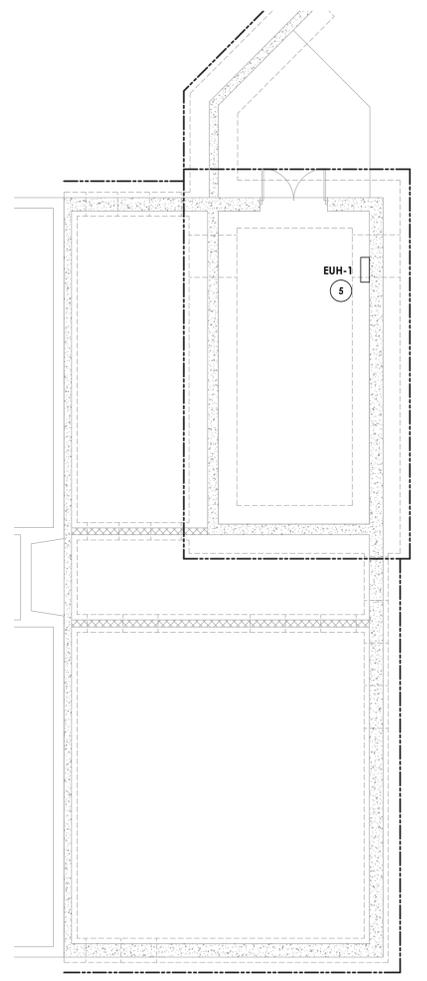

**3 STORAGE ROOM NEW WORK PLAN**  
SCALE: 1/8" = 1'-0"

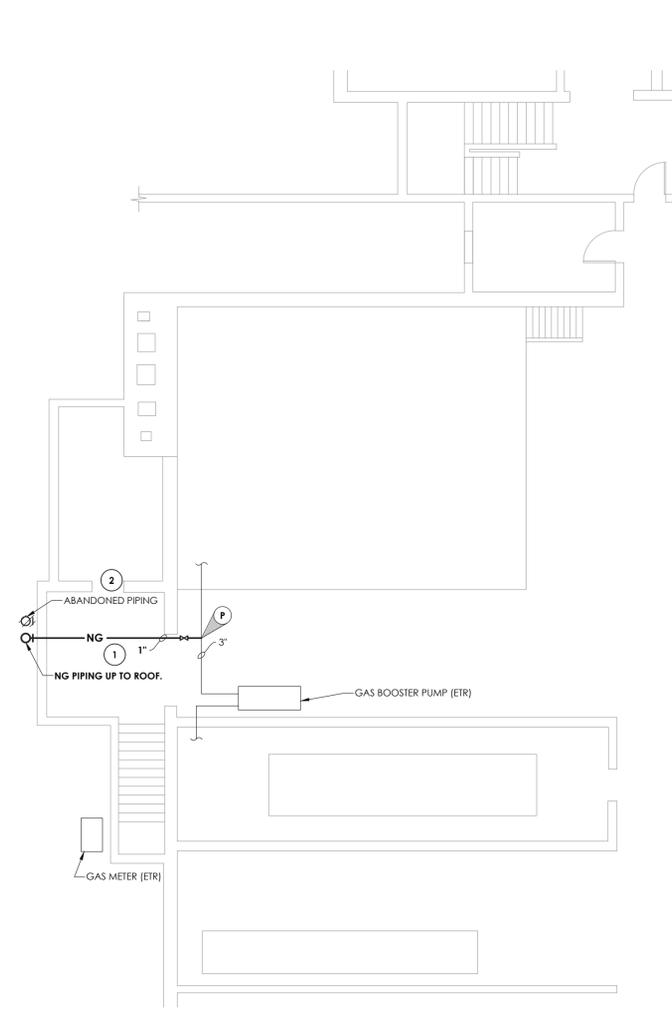

**4 BOILER ROOM NEW WORK PLAN**  
SCALE: 1/8" = 1'-0"

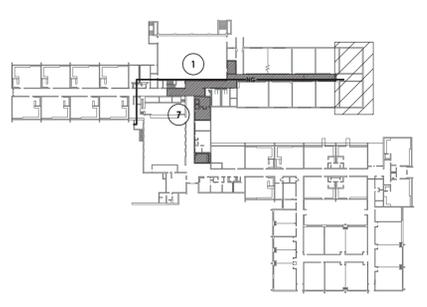

**KEY PLAN**  
SCALE: N.T.S.

- KEY NOTES:**
- 1 RUN 300 FEET OF NATURAL GAS PIPING ALONG ROOF TO NEW RTU-1.
  - 2 REMOVE EXISTING ABANDONED 1" PIPE ALONG SIDE OF BUILDING UP TO ROOF.
  - 3 ROUTE STORM DRAIN THROUGH PIPE CHASE BELOW. COORDINATE FINAL LOCATION WITH GENERAL CONTRACTOR.
  - 4 SECONDARY DRAIN TO DOWNSPOUT NOZZLE. SEE DETAIL 3/H800.
  - 5 MOUNT 2 FEET ABOVE FINISHED FLOOR.
  - 6 COORDINATE CONNECTION WITH SITE CONTRACTOR TO DISCHARGE TO EXISTING STORM DRAIN SYSTEM. PLUMBING CONTRACTOR TO PROVIDE FIRST 5' OUTSIDE OF BUILDING.
  - 7 REMOVE AND REINSTALL ALL EXISTING MECHANICAL EQUIPMENT IN CEILINGS TO BE REMOVED BY ASBESTOS ABATEMENT CONTRACTOR INCLUDING DIFFUSERS, GRILLES, AND EQUIPMENT. REINSULATE PIPING THAT HAS ASBESTOS REMOVED. (60 LF - VERIFY).
  - 8 PROVIDE INTERNAL DUCT INSULATION FOR THE FIRST 10' OF DUCTWORK FROM RTU-1 ON BOTH THE SUPPLY AND RETURN SIDES.

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SED# 66-14-01-03-0-001-022

|                |       |         |
|----------------|-------|---------|
| DATE           | DRAWN | CHECKED |
| 12/18/20       | BKM   | JJM     |
| SCALE AS SHOWN |       |         |
| SHEET TITLE    |       |         |
| HVAC NEW WORK  |       |         |


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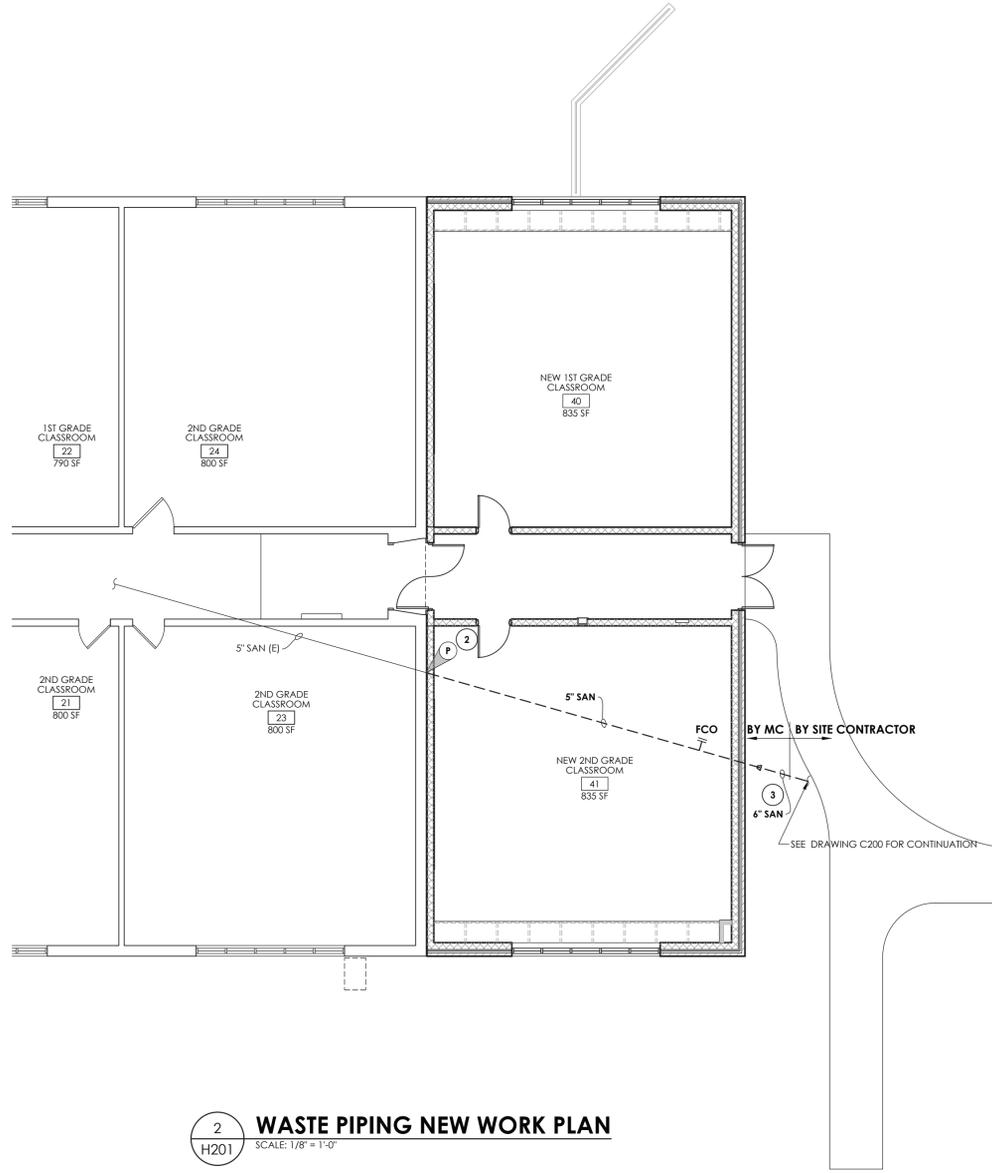
DRAWING NUMBER

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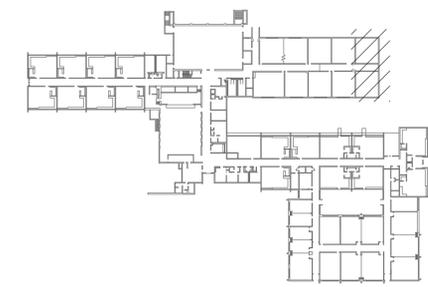


**1 WASTE PIPING DEMOLITION PLAN**  
SCALE: 1/8" = 1'-0"



**2 WASTE PIPING NEW WORK PLAN**  
SCALE: 1/8" = 1'-0"

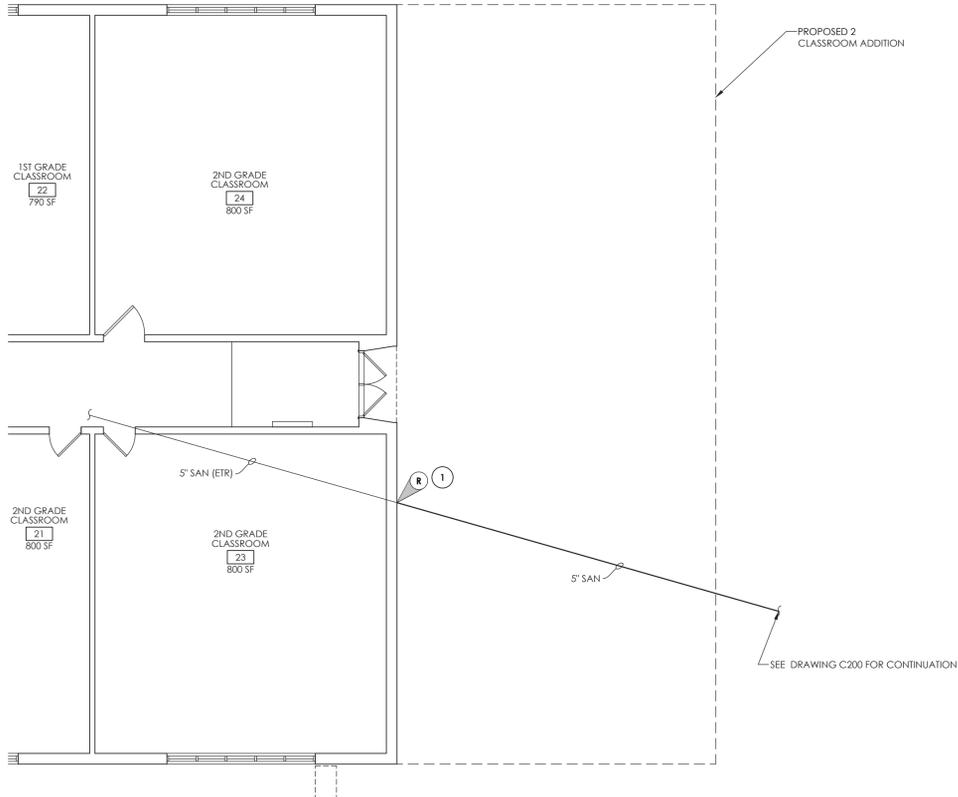- KEY NOTES:**
- 1 SITE CONTRACTOR TO REMOVE EXISTING PIPE TO POINT INDICATED. SEE C200 FOR CONTINUATION.
  - 2 INSTALL NEW 5" SANITARY DRAIN FROM EXISTING BUILDING BELOW SLAB OF NEW ADDITION. SEE CIVIL DRAWINGS FOR CONTINUATION.
  - 3 MECHANICAL CONTRACTOR TO PROVIDE PIPING INSIDE THE BUILDING TO 5' OUTSIDE THE BUILDING.



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ARCHITECTURE • ENGINEERING • PLANNING

50 FRONT STREET, SUITE 202  
NEWBURGH, NEW YORK 12550  
TEL (800) 274-9000  
FAX (845) 567-9614



**OSSINING UNION FREE SCHOOL DISTRICT**  
**BROOKSIDE ELEMENTARY SCHOOL**  
**CLASSROOM ADDITION PROJECT**

SED# 66-14-01-03-0-001-022

|                                     |       |         |
|-------------------------------------|-------|---------|
| DATE                                | DRAWN | CHECKED |
| 12/18/20                            | BKM   | JJM     |
| SCALE AS SHOWN                      |       |         |
| SHEET TITLE                         |       |         |
| WASTE DEMOLITION AND NEW WORK PLANS |       |         |

PROJECT NUMBER  
14428.11

**BES H201**  
DRAWING NUMBER

I, A PROFESSIONAL ENGINEER LICENSED UNDER THE EMBROIDERED ARCHITECT, ENGINEER AND SURVEYOR LAW OF THE STATE OF NEW YORK, DO HEREBY CERTIFY THAT I AM THE DESIGNER OF THESE PLANS AND I AM NOT PROVIDING THESE PLANS TO ANY OTHER PARTY WITHOUT MY WRITTEN PERMISSION. I AM NOT PROVIDING THESE PLANS TO ANY OTHER PARTY WITHOUT MY WRITTEN PERMISSION. I AM NOT PROVIDING THESE PLANS TO ANY OTHER PARTY WITHOUT MY WRITTEN PERMISSION.







Plotted By: Brendan Mazza

Date last plotted: 1/11/2021 1:13 PM

Date last acRPPced: 1/11/2021 1:09 PM

Drawing Name: S:\Projects\Ossining\IFSD\Brookside 2 CR Add\VD Design\06 CAD\AutoCAD\MECH\H801.dwg

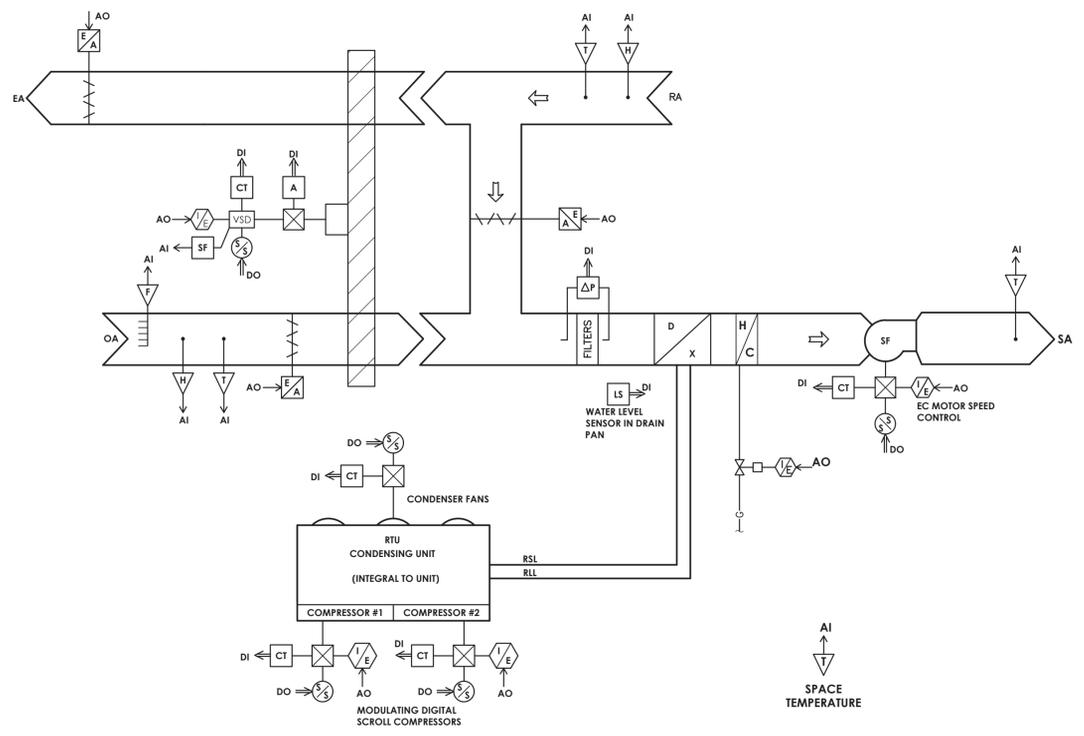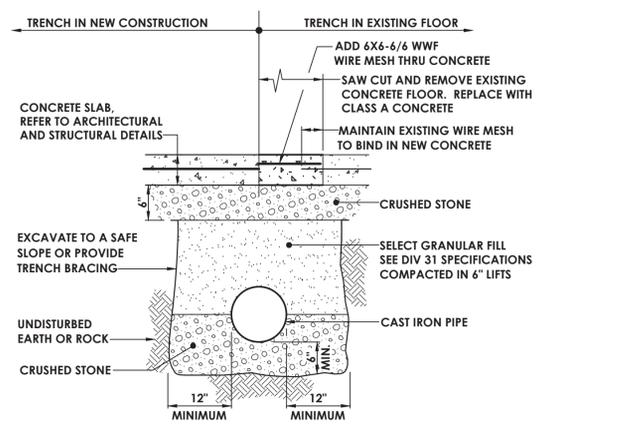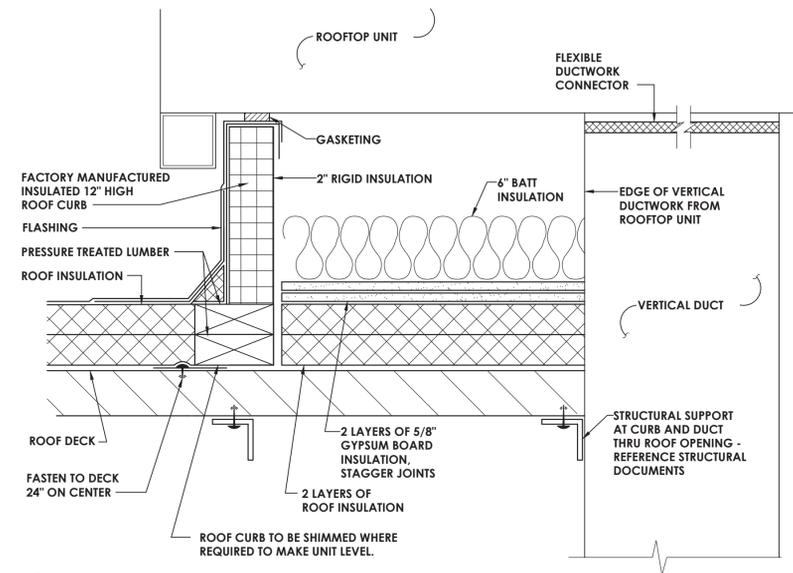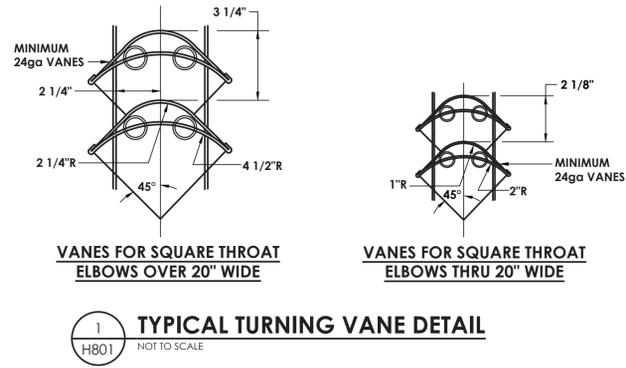

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|----------|-------|---------|
| DATE     | DRAWN | CHECKED |
| 12/18/20 | BKM   | AJS     |

SCALE: NTS  
SHEET TITLE: HVAC DETAILS AND CONTROLS DIAGRAM

PROJECT NUMBER: 14428.11

**BES**  
**H801**  
DRAWING NUMBER