


PORT CHESTER - RYE UNION FREE SCHOOL DISTRICT

- PARK AVENUE ELEMENTARY SCHOOL - CLASSROOM ALTERATIONS
PARK AVE., PORT CHESTER, NY 10573
- JOHN F. KENNEDY PRIMARY SCHOOL - CLASSROOM ALTERATIONS
40 OLIVIA ST., PORT CHESTER, NY 10573
- PORT CHESTER MIDDLE SCHOOL - CLASSROOM ALTERATIONS
113 BOWMAN AVENUE, RYE BROOK, N.Y. 10573



PORT CHESTER MIDDLE SCHOOL

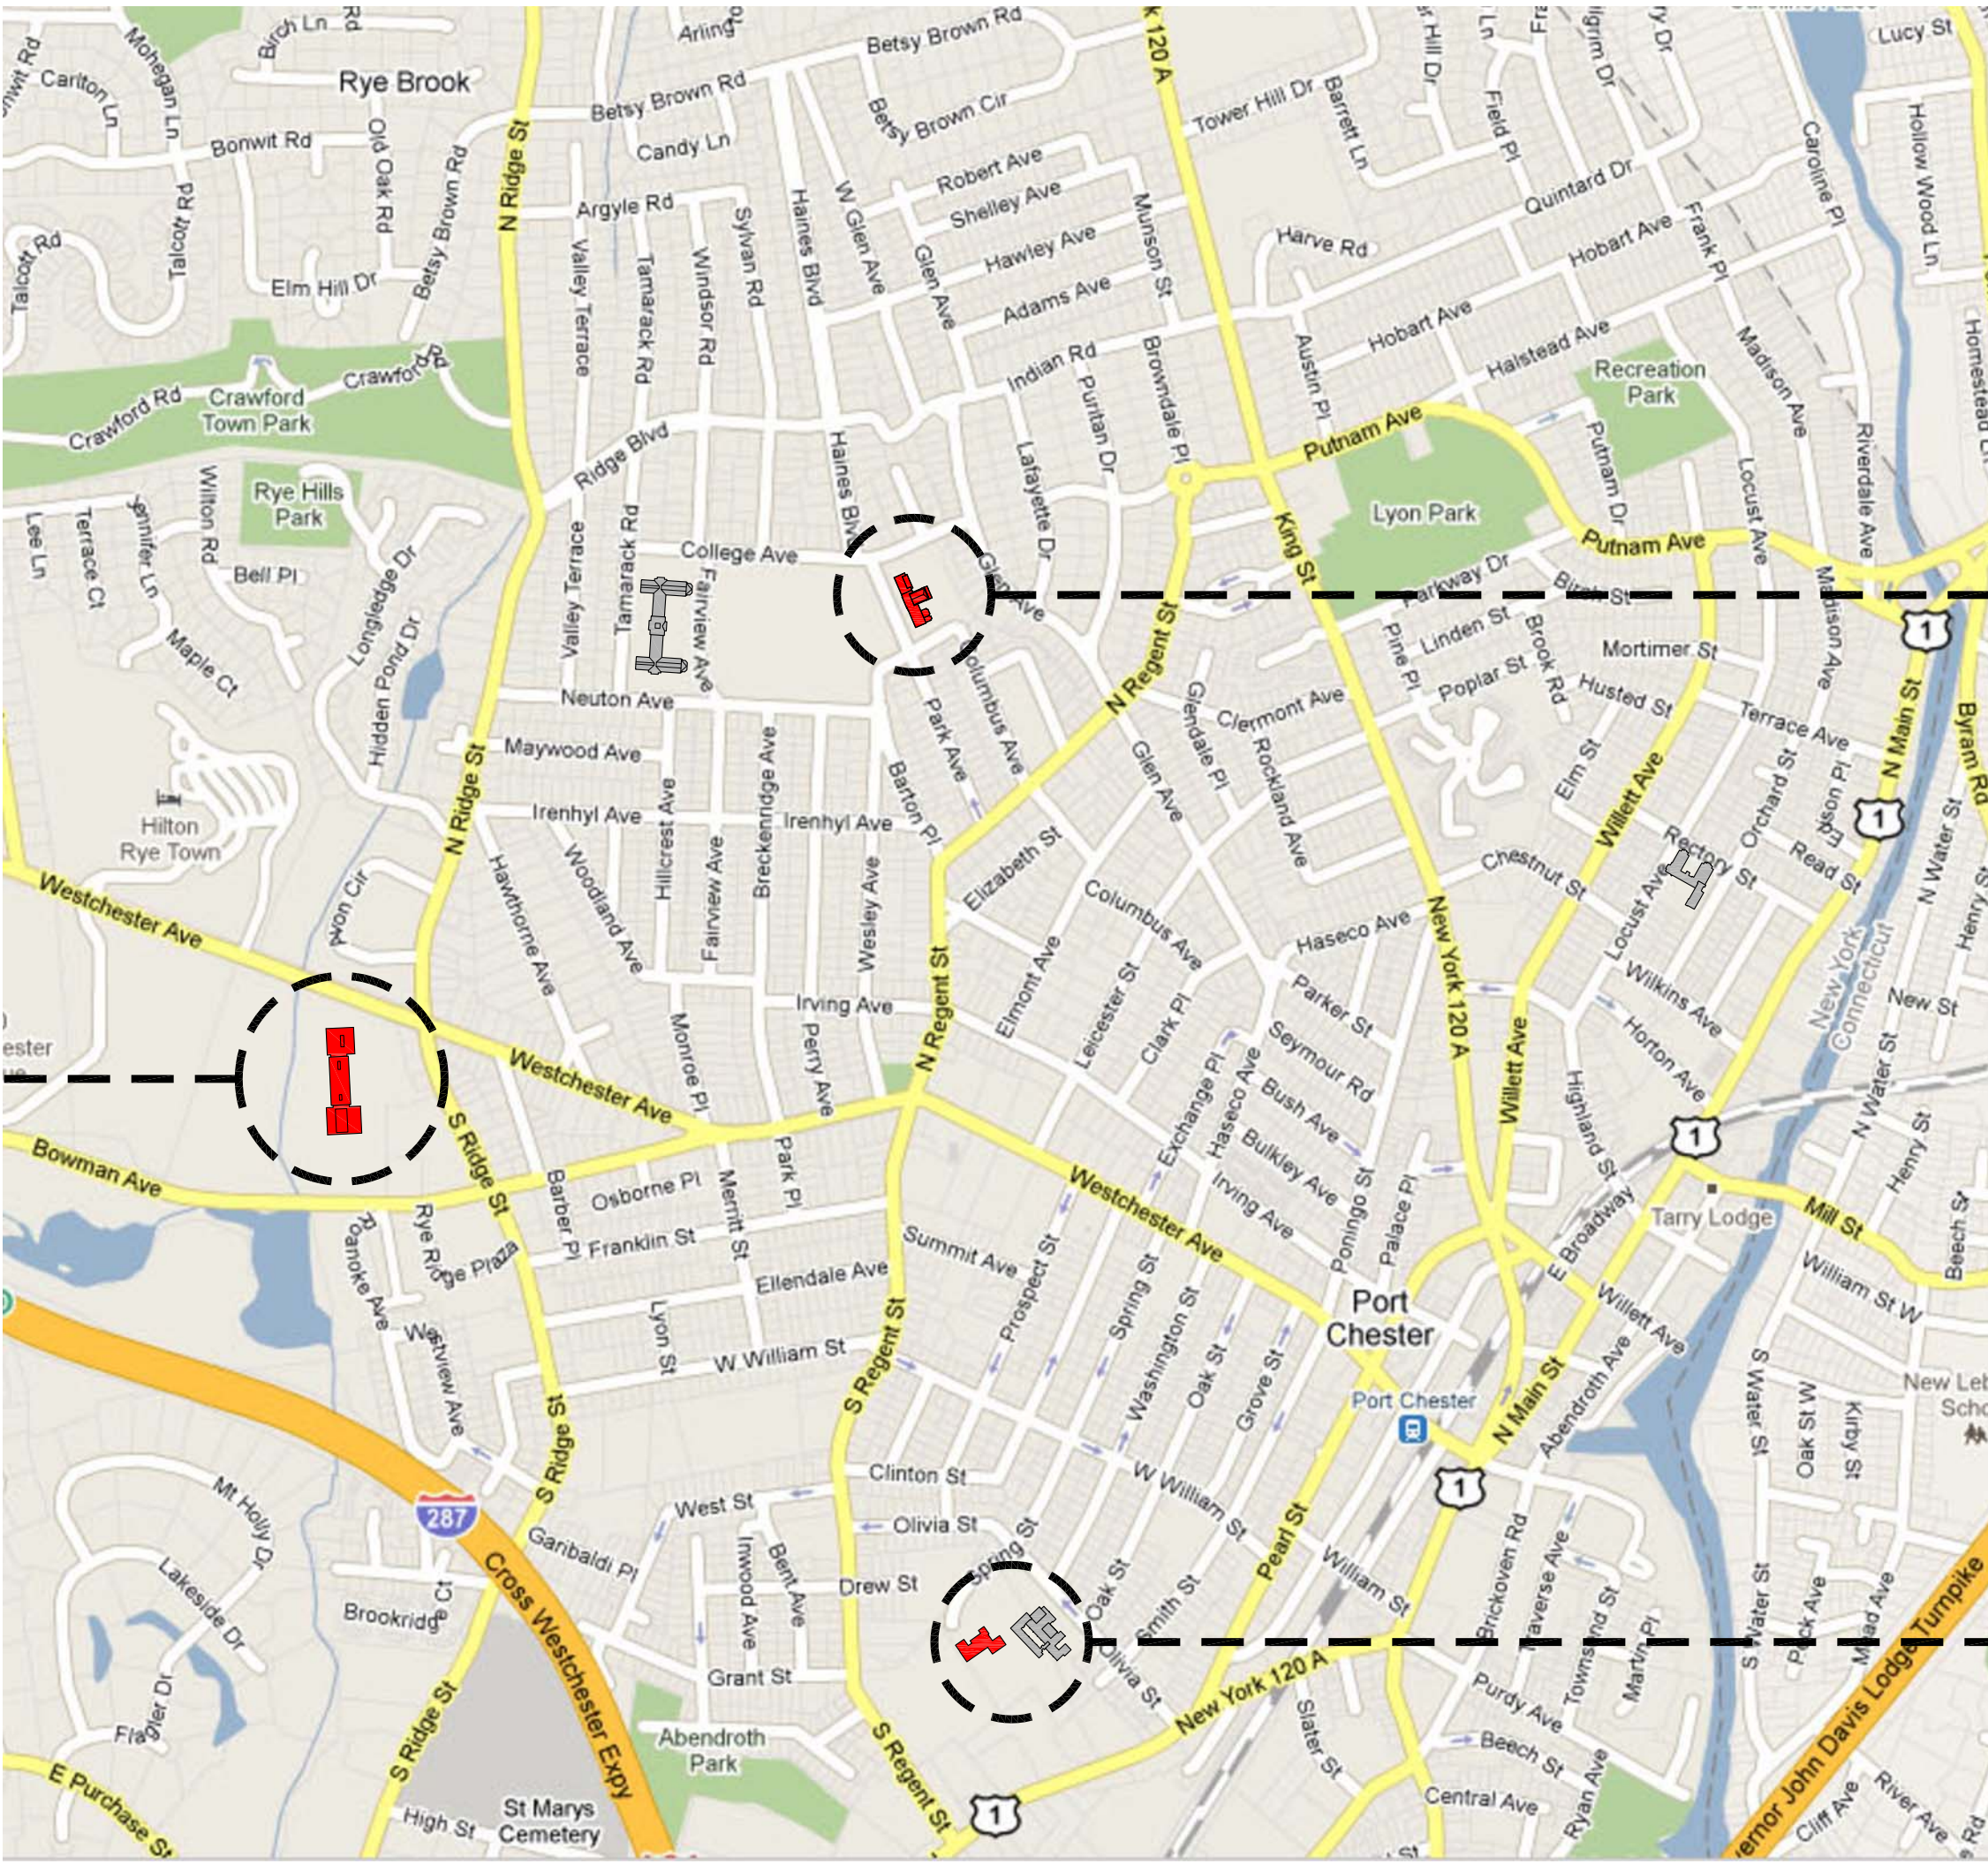

PARK AVENUE ELEMENTARY SCHOOL



JOHN F. KENNEDY PRIMARY SCHOOL

**FULLER
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P.C.**

**ARCHITECTS
PLANNERS**

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TEL 914.592.4444 FAX 914.592.1717
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TOTAL QUALITY
ENVIRONMENTAL INC.,

116 BAY 19th STREET
BROOKLYN, NY 11214
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06-08-2021	B 10
DATE	ISSUED TO
SHEET SIZE 30"x42"	DRAWING NO. T-1
DRAWN BY F & D	FILE NO. 21430.00
CHECKED BY F & D	

ABBREVIATIONS

&	- AND	EAT	- ENTERING AIR TEMPERATURE	HX	- HEAT EXCHANGER -	REF	- ROOF EXHAUST FAN
A/G	- ALUMINUM & GLAZING	E-CONTR	- ELECTRICAL CONTRADICTION	HZ	- FREQUENCY(CYCLES PER MINUTE)	REIN	- REINFORCED
ACU	- AIR CONDITIONING UNIT (S)	EDB	- ENTERING DRY BULB	ID	- INSIDE DIAMETER -	REIN'D	- REINFORCED
ACM	- ASBESTOS CONTAINING MATERIAL	EDR	- EQUIVALENT DIRECT RADIATION	IEF	- IN-LINE EXHAUST FAN	RH	- RELATIVE HUMIDITY
ACT	- ACOUSTICAL CEILING TILE	EER	- EMERGENCY ESCAPE AND RESCUE	INT	- INTERIOR	RO	- ROUGH OPENING
ACW	- ASBESTOS CONTAINING WASTE	E.F	- EXHAUST FAN	INSUL	- INSULATION	RM	- ROOM
AD	- ACCESS DOOR	EFF	- EFFICIENCY	INV	- INVERT	RMF	- REVOLUTIONS PER MINUTE
ADJ	- ADJACENT	EJ	- EXPANSION JOINT	IN	- INCH	RTU	- ROOF TOP UNIT
AFF	- ABOVE FINISH FLOOR	E.Q	- EQUAL	J.C	- JANITOR'S CLOSET	S	- SINK
AHU	- AIR HANDLER UNIT	ELEC	- ELECTRICAL	JT	- JOINT	SA	- SUPPLY AIR
ALUM	- ALUMINUM	EL/ELEV	- ELEVATION	J/B	- JUNCTION BOX	SAN	- SANITARY
ALT	- ALTERNATE	E.M.H	- ELEMENTARY SCHOOL MOUNTING HEIGHT	KIT	- KITCHEN	SCHED	- SCHEDULE
AMB	- AMBIENT	ENCL.	- ENCLOSURE - ENTRANCE	KW	- KILOWATT	SD	- SMOKE DETECTOR
AMP	- AMPERE	EQU	- EQUIPMENT	K.M.H.	- KILOGRAM MOUNTING HEIGHT	S.DMCR	- SMOKE DAMPER
APD	- AIR PRESSURE DROP	ESP	- EXTERNAL STATIC PRESSURE	L	- LENGTH	SECT	- SECTION
APPROX	- APPROXIMATE	ETC	- AND SO FORTH	LAT	- LEAVING AIR TEMPERATURE	SF	- SQUARE FOOT
ARCH	- ARCHITECTURAL	EVP	- EVAPORATOR	LAM	- LAMINATE	SHT	- SHEET
AVG	- AVERAGE	EWB	- ENTERING WET BULB	LAV	- LAVATORY	SIM	- SIMILAR
BDD	- BACK DRAFT DAMPER	EWT	- ENTERING WATER TEMPERATURE	LBS/#	- POUNDS	SP	- STATIC PRESSURE
BDW	- BOILER FEED WATER	EX	- EXPOSED	L.C.C	- LEAD COATED COPPER	SPEC(S)	- SPECIFICATION (S)
BHP	- BRAKE HORSE POWER	EXH	- EXHAUST	LQ	- LIQUID	SQ	- SQUARE
BTUM	- BITUMINOUS	EXHA	- EXHAUST AIR	LF	- LINEAR FEET	SQ FT	- SQUARE FEET
BTUD	- BUILDING	EXIST	- EXISTING	LIVE	- LIVE LOAD	STD	- STANDARD
BULK	- BLOCK	EXP	- EXPOSED CONSTRUCTION.	LL	- LOW POINT	STL	- STEEL
B.O.P.	- BOTTOM OF PLANK	EXT	- EXTERIOR	LPS	- LOW PRESSURE STEAM	STM	- STEAM
B.O.S.	- BOTTOM OF SLAB	F.A.I	- FRESH AIR INTAKE	LRS	- LINEAR RETURN GRILLE	STOR	- STORAGE
BTUH	- BRITISH THERMAL UNITS/HOUR	FCU	- FIRE BLANKET	LSD	- LINEAR SUPPLY DIFFUSER	STRUCT	- STRUCTURAL
BU	- BUILT UP	FB	- FAN COIL UNIT	LWT	- LEAVING WATER TEMPERATURE	SUCT	- SUCTION
BUR	- BUILT UP ROOFING	F.D.	- FLOOR DRAIN	M	- MIRROR	SUSP	- SUSPENDED
C	- COMMON	F.DAMP.	- FIRE DAMPER	MAX	- MAXIMUM	T	- TREAD/TOILET
CV	- COEFFICIENT, VALVE FLOW	F.E.	- FIRE EXTINGUISHER	MAT	- MATERIAL	TOP	- TEMPERATURE CONTROL PANEL
CB	- CATCH BASIN	F.E.-1	- FIRE EXTINGUISHER - SURF. MT.	MBH	- BTU PER HOUR (THOUSAND)	T.D.	- TRENCH DRAIN
C.C	- COOLING COIL	F.E.-2	- FIRE EXTINGUISHER - RECESSED	MD	- MOTORIZED DAMPER	T.DIFF.	- TEMPERATURE DIFFERENCE
CEIL/CLG	- CEILING	F.G.	- FIBER GLASS	MECH	- MECHANICAL	TEL	- TELEPHONE
CER/CEG	- CEILING EXHAUST REGISTER/ GRILLE	FIN	- FINISH	MFR	- MANUFACTURER	TEMP	- TEMPERED
CFM	- CUBIC FEET PER MINUTE	FKT	- FIXTURE	MKB	- MARKER BOARD	THK	- THICK
C.H	- CHILLED WATER RETURN	FHC	- FIRE HOSE CABINET	MISC	- MISCELLANEOUS	TKBD	- TACK BOARD
CHWR	- CHILLED WATER RETURN	FL/FLR	- FLOOR	MO	- MASONRY OPENING	T.O.	- TOP OF CURB
CHWS	- CHILLED WATER SUPPLY	FTC	- FOOTING	FOS	- FUEL OIL GAUGE	T.O.D.	- TOP OF METAL DECK
C.I.	- CENTER LINE	FOB	- FLAT ON BOTTOM	FOF	- FUEL OIL RETURN	T.O.P.	- TOP OF PARAPET
CLG WTR	- COOLING WATER	FOS	- FUEL OIL SUPPLY	FOV	- FUEL OIL VALVE	T.O.S.	- TOP OF STEEL
CLOS	- CLOSET	FOR	- FUEL OIL RETURN	FOT	- FLAT ON TOP	TSP	- TOTAL STATIC PRESSURE
CMU	- CONCRETE MASONRY UNIT	F.P	- FIRE PROOF	FP	- FEET PER MINUTE	T'STAT	- THERMOSTAT
CMP	- CORRUGATED METAL PIPE	FP	- FEET PER MINUTE	FPM	- FEET PER MINUTE	TYP.	- TYPICAL
C.O	- CLEAN OUT	COMP	- COMPRESSOR	FT	- FEET PER SECOND	U	- URINAL
COL	- COLUMN	CONC	- CONCRETE	FT	- FEET PER SECOND	UH	- UNIT HEATER
COMPR	- COMPRESSOR	COND	- CONDENSER	FT	- FEET PER SECOND	UL	- UNDERWRITERS LABORATORY
CONC	- CONCRETE	CONST	- CONSTRUCTION	GA	- GAUGE	UNFN	- UNFINISHED
CON	- CONTINUOUS	CAL	- GALLONS	GAL	- GALLONS	UNFV	- UNIT VENTILATOR
CONTR	- CONTRACTOR	GALV	- GALVANIZED	GA	- GENERAL CONSTRUCTION	V	- VOLT
CONV	- CONVECTOR	G.C	- GENERAL CONSTRUCTION	GEN	- GENERAL	VAV	- VARIABLE AIR VOLUME
CP	- CONDENSATE PUMP	GL	- GLASS	GL	- GALLONS PER HOUR	V.C.T	- VINYL COMPOSITION TILE
CRP/CRG	- CEILING RETURN REGISTER/ GRILLE	OPH	- GALLONS PER HOUR	OPH	- GALLONS PER MINUTE	VO	- VOLUME
CRP	- CARPET	GR	- GRASS	G.T.	- GLAZED WALL TILE	VEL	- VELOCITY
CRU	- COMPUTER ROOM UNIT	G.T.	- GLAZED WALL TILE	G.V.	- GAS VALVE	VEST	- VESTIBULE
CSD	- CEILING SUPPLY DIFFUSER	G.V.	- GYPSUM BOARD	GYP. FB.	- GYPSUM FIBERBOARD	V.F	- VENTILATION
CT	- CERAMIC TILE	H.B	- HOSE BIB	H.C	- HEATING, VENTING, AND AIR	VLV	- VALVE
CTB	- CERAMIC TILE BASE	H.C	- HEATING, VENTING, AND AIR	H.C	- HEATING, VENTING, AND AIR	VOL	- VOLUME
CTW	- C.T.W.R.	H.C	- HEATING, VENTING, AND AIR	H.C	- HEATING, VENTING, AND AIR	V.P.	- VISION PANEL
CU	- CUBIC FEET	H.C	- HEATING, VENTING, AND AIR	H.C	- HEATING, VENTING, AND AIR	V.W.C.	- VENTILATION COVERING
CUH	- CUBIC FEET	H.C	- HEATING, VENTING, AND AIR	H.C	- HEATING, VENTING, AND AIR	W	- WITH
CWR	- CONDENSER WATER RETURN	H.C	- HEATING, VENTING, AND AIR	H.C	- HEATING, VENTING, AND AIR	WB	- WET BULB
CWS	- CONDENSER WATER SUPPLY	H.C	- HEATING, VENTING, AND AIR	H.C	- HEATING, VENTING, AND AIR	W.C.	- WATER CLOSET
D/DA	- DIAMETER	H.C	- HEATING, VENTING, AND AIR	H.C	- HEATING, VENTING, AND AIR	WD	- WOOD
DB	- DRY BULB TEMPERATURE	H.C	- HEATING, VENTING, AND AIR	H.C	- HEATING, VENTING, AND AIR	WEF	- WALL EXHAUST FAN
dB	- DECIBEL	H.C	- HEATING, VENTING, AND AIR	H.C	- HEATING, VENTING, AND AIR	WEG/WRG	- WALL EXHAUST REGISTER/GRILLE
D.C	- DUST COLLECTOR	H.C	- HEATING, VENTING, AND AIR	H.C	- HEATING, VENTING, AND AIR	WG	- INCHES OF WATER, GAGE (PRESSURE)
DEC	- DEGREE	H.C	- HEATING, VENTING, AND AIR	H.C	- HEATING, VENTING, AND AIR	W.G.	- WIRE GLASS
DEMO	- DEMOLITION	H.C	- HEATING, VENTING, AND AIR	H.C	- HEATING, VENTING, AND AIR	WK	- WORK
D.F.A	- DRINKING FOUNTAIN	H.C	- HEATING, VENTING, AND AIR	H.C	- HEATING, VENTING, AND AIR	W.I.	- WROUGHT IRON
D.H	- DOUBLE HUNG	H.C	- HEATING, VENTING, AND AIR	H.C	- HEATING, VENTING, AND AIR	W.P.	- WATER PROOF
DM	- DIMENSION	H.C	- HEATING, VENTING, AND AIR	H.C	- HEATING, VENTING, AND AIR	WPD	- WATER PRESSURE DROP
D.N	- DOWN	H.C	- HEATING, VENTING, AND AIR	H.C	- HEATING, VENTING, AND AIR	W.R.	- WATER RESISTANT
D.O	- DOWN	H.C	- HEATING, VENTING, AND AIR	H.C	- HEATING, VENTING, AND AIR	WRR/WRG	- WALL RETURN REGISTER/GRILLE
D.O	- DOWN	H.C	- HEATING, VENTING, AND AIR	H.C	- HEATING, VENTING, AND AIR	WSR/WSG	- WALL SUPPLY REGISTER/GRILLE
DP	- DEEP	H.C	- HEATING, VENTING, AND AIR	H.C	- HEATING, VENTING, AND AIR	WTC	- WALL TRANSFER GRILLE
DR	- DOOR	H.C	- HEATING, VENTING, AND AIR	H.C	- HEATING, VENTING, AND AIR	WTR	- WATER
DWG	- DRAWING	H.C	- HEATING, VENTING, AND AIR	H.C	- HEATING, VENTING, AND AIR	W.W.F.	- WELDED WIRE FABRIC
DX	- DIRECT EXPANSION	H.C	- HEATING, VENTING, AND AIR	H.C	- HEATING, VENTING, AND AIR	W.W.M.	- WELDED WIRE MESH
E	- EAST	H.C	- HEATING, VENTING, AND AIR	H.C	- HEATING, VENTING, AND AIR	YD	- YARD DRAIN
EA	- EACH	H.C	- HEATING, VENTING, AND AIR	H.C	- HEATING, VENTING, AND AIR		

GRAPHIC LEGEND

CLASSROOM 100	ROOM NAME & NUMBER	-----	REMOVE EXISTING CONSTRUCTION
100	DOOR NUMBER	-----	EXISTING CONSTRUCTION
100	ELEVATION KEY	-----	NEW WALL CONSTRUCTION
100	INTERIOR WALL INDICATIONS	-----	COLUMN GRID LINES
100	WINDOW TYPE	-----	EXISTING COLUMN DESIGNATION
100	REMOVAL/WORKSCOPE NOTE	-----	BUILDING/WALL SECTION/DETAIL
100	REVISION MARK	-----	REFERENCE POINT
100	DETAIL NO.	-----	HIDDEN LINE ABOVE OR BEYOND
100	DWG. NO.	-----	HIDDEN LINE ABOVE OR BEYOND
100	WALL TYPE	-----	CENTERLINE OR N.I.C. LINE
100	EXTERIOR ELEVATION KEY	-----	EXISTING DOOR INDICATES DOOR NUMBER (SEE DOOR SCHEDULE)
100	FLUSH THRESHOLD	-----	NEW DOOR INDICATES DOOR NUMBER (SEE DOOR SCHEDULE)
100	5'-0" 6" HANDICAPPED TURNING RADIUS	-----	

MATERIALS LEGEND

CONCRETE	PARTICLE BOARD
CONCRETE MASONRY UNITS	PLYWOOD
BRICK	ACOUSTICAL TILE
STONE	CONTINUOUS WOOD FRAMING THROUGH MEMBER
METALS	WOOD FRAMING THROUGH INTERRUPTED MEMBER
COMPACTED GRAVEL	FINISHED WOOD
EARTH/UNDISTURBED SOIL	BATT INSULATION
DRAINAGE BOARD	RIGID INSULATION

GENERAL REMOVAL NOTES:

- DRAWINGS INDICATE ONLY MAJOR SCOPE OF REMOVALS. CONTRACTOR IS REQUIRED TO REMOVE ANY AND ALL ITEMS NOT SHOWN AS REQUIRED TO SUIT ALL NEW WORK. CONTRACTOR IS REQUIRED TO REMOVE, PROTECT AND STORE ANY AND ALL ITEMS SHOWN AS REQUIRED TO SUIT ALL NEW WORK, COORDINATE W/ OWNER FOR STORING LOCATIONS.
- EXISTING MECHANICAL AND ELECTRICAL EQUIPMENT, ETC. SHOWN ON DRAWINGS ARE APPROXIMATELY LOCATED. CONTRACTOR IS TO DETERMINE EXACT LOCATIONS OF ALL ITEMS IN THE FIELD.
- CONTRACTOR SHALL BE ADVISED THAT EXISTING ABOVE CEILING CABLING MAY BE PRESENT. CARE SHALL BE TAKEN WHEN REMOVING CEILINGS IN ORDER TO NOT DAMAGE EXISTING CABLING TO REMAIN. REFER TO SPECIFICATIONS FOR CABLE BUNDLING AND SUPPORT.
- CONTRACTOR IS TO VERIFY ANY MAJOR DIMENSIONAL DEVIATIONS FROM DRAWINGS OR STRUCTURAL OBSTRUCTIONS. THESE SHALL BE BROUGHT TO THE OWNER'S REPRESENTATIVE'S ATTENTION. ALL CONTRACT DRAWINGS INDICATE APPROXIMATE DIMENSIONS AND EXISTING CONDITIONS BASED ON FIELD SURVEY AND DRAWINGS FURNISHED BY THE OWNER. VARIATIONS MAY EXIST AS TO FIELD CONDITIONS. THE COST FOR ANY SUCH SURFACES SHALL BE INCLUDED WITHIN THE CONTRACT BID.
- ALL SURFACES DISTURBED BY REMOVALS SHALL BE PATCHED/REPAIRED TO MATCH EXISTING ADJACENT FINISHES. COORDINATE AND PREPARE SURFACES TO ACCOMMODATE WITH NEW FINISH ACCORDING TO SPECS AND MANUFACTURER'S RECOMMENDATIONS.
- CONTRACTOR SHALL FIRE STOP ALL TRADE RELATED EXISTING OR NEW PENETRATIONS THROUGH FLOORS, PARTITIONS AND WALLS AT ALL LOCATIONS WITH APPROVED MATERIALS AND SYSTEMS.
- ALWAYS WORK IN A MANNER WHICH PROVIDES CONTINUOUS SUPPORT TO STRUCTURE ABOVE. PROVIDE APPROPRIATE LINTEL FOR ALL OPENINGS UNLESS SPECIFIED OTHERWISE.
- COORDINATE REMOVALS WITH NEW WORK.
- IF AT ANY TIME DURING SELECTIVE REMOVAL PROCEDURES, SHOULD THE CONTRACTOR SUSPECT HAZARDOUS MATERIALS, WORK SHALL STOP IMMEDIATELY AND THE OWNER SHALL BE NOTIFIED IN WRITING. OWNER SHALL TAKE STEPS TO HAVE AFFECTED WORK AREAS DECONTAMINATED BY A STATE OF NEW YORK LICENSED ABATEMENT CONTRACTOR. OBTAIN APPROVALS FROM GOVERNING AGENCIES PRIOR TO COMMENCEMENT OF ABATEMENT. WORK IN AFFECTED AREAS SHALL RESUME IN THE ABSENCE OF CONTAMINANTS AND WHEN IT HAS BEEN RENDERED HARMLESS BY LABORATORY ANALYSIS AND WRITTEN AGREEMENT BY OWNER AND CONTRACTOR.
- THE OWNER SHALL HAVE FIRST REFUSAL RIGHT TO ALL ITEMS TO BE REMOVED, WHERE ITEMS ARE CHOSEN TO BE SALVAGED, THE CONTRACTOR SHALL DELIVER TO THE OWNER. WHERE THE OWNER REFUSES POSSESSION OF ITEMS, THEY BECOME THE PROPERTY OF THE CONTRACTOR AND SHALL BE DISPOSED OF LEGALLY.
- CUTTING AND PATCHING:
PERFORM WHATEVER CUTTING AND PATCHING IS NECESSARY TO COMPLETE THE WORK. FINISH PATCHED SURFACES TO MATCH FINISH THAT EXISTED PRIOR TO PATCHING. PATCH WORK TO MATCH ADJACENT WORK IN TEXTURE AND APPEARANCE.
- ABATEMENT OF HAZARDOUS MATERIAL SHALL BE COORDINATED WITH REMOVAL WORK.
- FOR ALL ASBESTOS REMOVAL AND DISPOSAL REFER TO ABATEMENT DRAWINGS AND SECTION 02080 OF SPECIFICATIONS.
- FOR ALL LEAD BASED PAINT REMOVAL AND DISPOSAL REFER TO ABATEMENT DRAWINGS AND SECTION 02090 OF SPECIFICATIONS.
- IF AT ANY TIME DURING SELECTIVE REMOVAL PROCEDURES, SHOULD THE CONTRACTOR SUSPECT HAZARDOUS MATERIALS, WORK SHALL STOP IMMEDIATELY AND THE OWNER SHALL BE NOTIFIED IN WRITING. OWNER SHALL TAKE STEPS TO HAVE AFFECTED WORK AREAS DECONTAMINATED BY A STATE OF NEW YORK LICENSED ABATEMENT CONTRACTOR. OBTAIN APPROVALS FROM GOVERNING AGENCIES PRIOR TO COMMENCEMENT OF ABATEMENT. WORK IN AFFECTED AREAS SHALL RESUME IN THE ABSENCE OF CONTAMINANTS AND WHEN IT HAS BEEN RENDERED HARMLESS BY LABORATORY ANALYSIS AND WRITTEN AGREEMENT BY OWNER AND CONTRACTOR.
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LIST OF DRAWINGS

GENERAL:	TITLE SHEET ABBREVIATIONS, MATERIALS, GRAPHIC LEGEND, GENERAL NOTES, MOUNTING HEIGHTS & LIST OF DRAWINGS.
ARCHITECTURAL:	A100 PARK AVE. ELEMENTARY SCHOOL BASEMENT PLAN A101 JOHN F. KENNEDY ELEMENTARY SCHOOL FIRST FLOOR PLAN A102 PORT CHESTER MIDDLE SCHOOL FIRST FLOOR PLAN A103 PARK AVE. ELEMENTARY SCHOOL PLANS & NOTES A104 JOHN F. KENNEDY ELEMENTARY SCHOOL PLANS & NOTES A105 JOHN F. KENNEDY ELEMENTARY SCHOOL PLANS & NOTES A106 PORT CHESTER MIDDLE SCHOOL PLANS & NOTES A-500 PARTITION TYPES & MISCELLANEOUS DETAILS A-700 DOOR SCHEDULE, TYPES AND DETAILS, FINISH SCHEDULE LEGEND, FINISH SCHEDULE & DETAILS
MECHANICAL:	M-100 MECHANICAL LEGENDS, NOTES AND ABBREVIATIONS, PLANS AND SCHEDULES M-101 PARK AVENUE ELEMENTARY SCHOOL, JOHN F. KENNEDY PRIMARY SCHOOL ELECTRICAL PLANS AND NOTES
ELECTRICAL:	E-100 ELECTRICAL SYMBOL LIST, NOTES, DETAILS AND RISER DIAGRAMS E-101 PARK AVE. ELEMENTARY SCHOOL, PORT CHESTER MIDDLE SCHOOL ELECTRICAL PLANS AND NOTES E-102 JOHN F. KENNEDY ELEMENTARY SCHOOL ELECTRICAL PLANS AND NOTES E-103 JOHN F. KENNEDY ELEMENTARY SCHOOL ELECTRICAL PLANS AND NOTES
FURNITURE (FOR REFERENCE ONLY):	FF-100 FOR REFERENCE ONLY - FF&E PLANS

SIGNAGE MOUNTING LOCATIONS:

SIGN LOCATION AT DOOR (TYP.)

SIGN LOCATION

SIGN TYPES:

NOT TO SCALE

EMERGENCY EVACUATION PLAN

EMERGENCY EVACUATION PLAN

EMERGENCY PHONE NO.- 911

EMERGENCY PHONE NO.- 911

PARK AVENUE ELEMENTARY SCHOOL

JOHN F. KENNEDY ELEMENTARY SCHOOL

NOTES:

NOTES:

GENERAL NOTES

GENERAL NOTES

MOUNTING HEIGHTS FOR ACCESSIBLE ITEMS

MOUNTING HEIGHTS FOR ACCESSIBLE ITEMS

FILE: I:\21430.00 Port Chester PAES JKPCS KSES PCMS Alterations\DRAWINGS\CURRENT\1-F&D\21430.00-G-1.dwg

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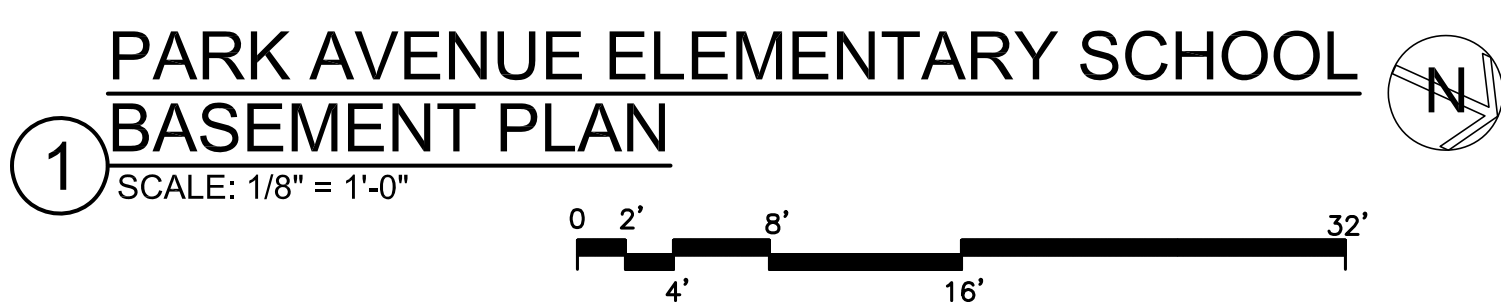
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PORT CHESTER, NY
JOHN F. KENNEDY ELEMENTARY SCHOOL
PORT CHESTER MIDDLE SCHOOL
PORT CHESTER MIDDLE SCHOOL CLASSROOM ALTERATIONS

ABBREVIATIONS, LEGENDS, NOTES, SIGNAGE, & LIST OF DRAWINGS.


06-08-2021
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SHEET SIZE
30"x42"
SCALE
AS NOTED
DRAWN BY
F & D

B I O
ISSUED TO
DRAWING NO.
G-1
FILE NO.
21430.00



PLOT DATE: June 08, 2021 -- 9:24am

FILE: I:\21430.00 Port Chester PAES JFKPS KSES PCMS Alterations\DRAWINGS\CURRENT\1-F&D\21430.00-A101 A104 A105 JFKPS.dwg

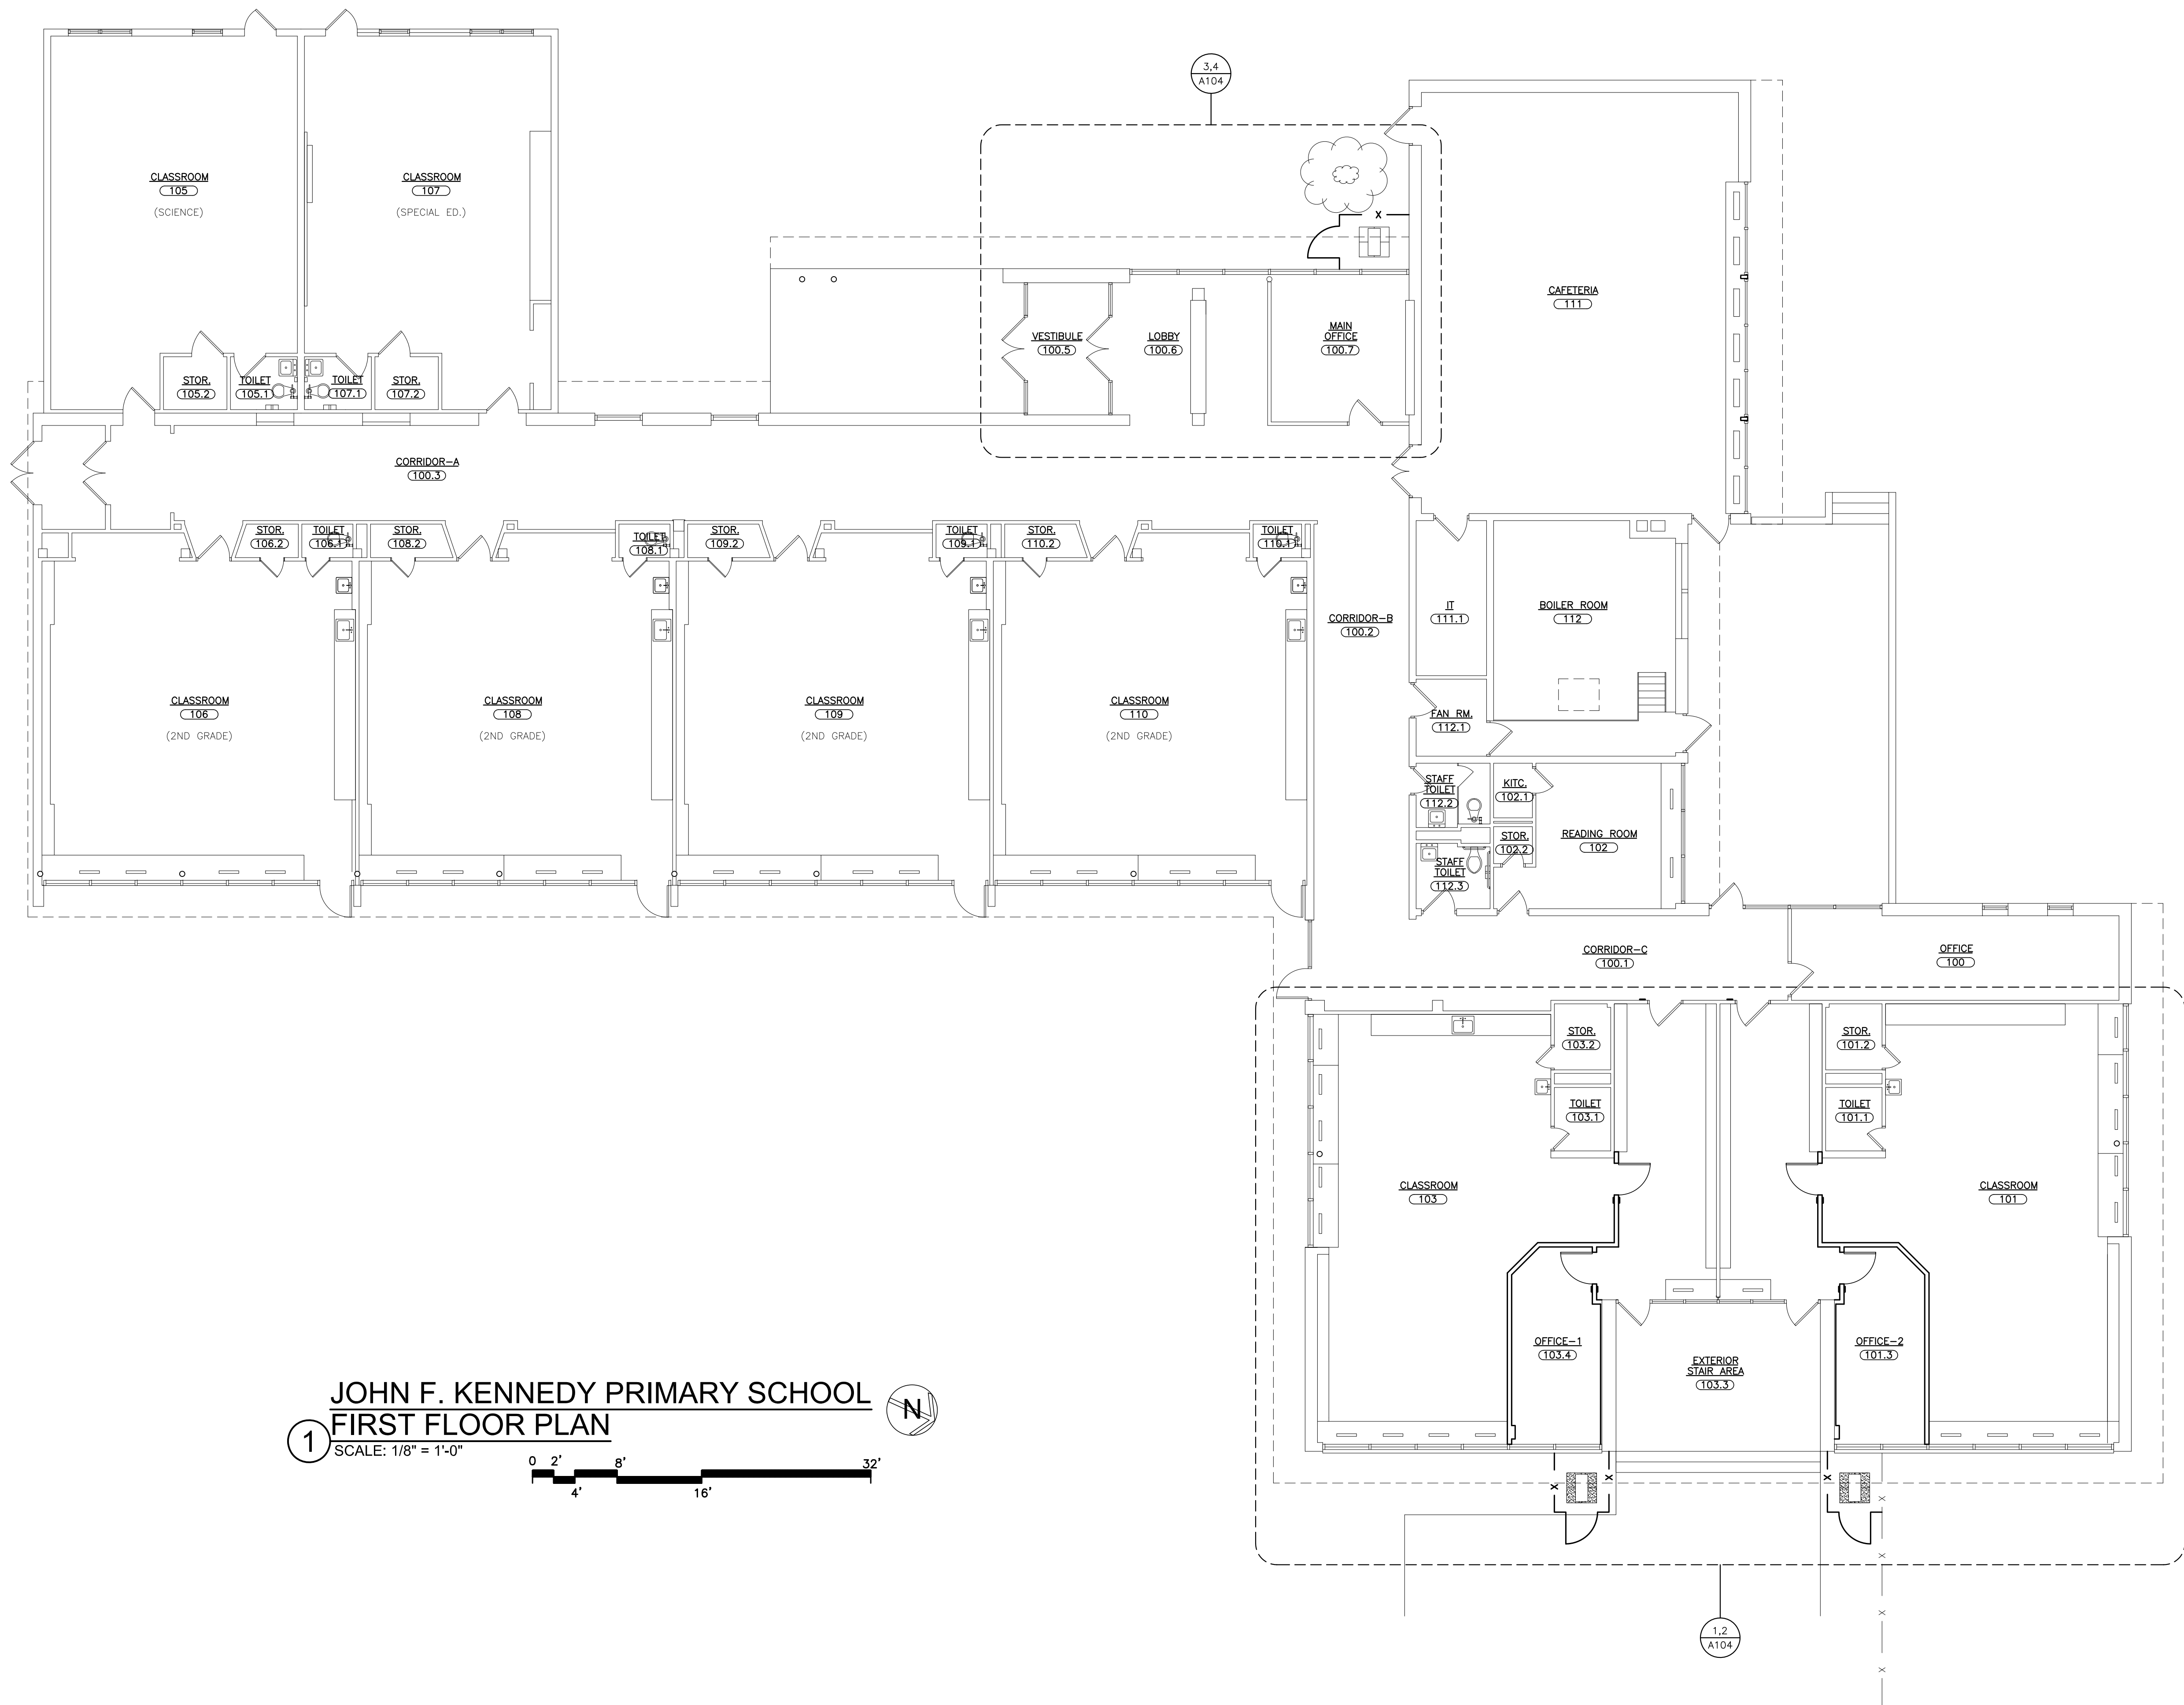

JOHN F. KENNEDY PRIMARY SCHOOL
FIRST FLOOR PLAN
SCALE: 1/8" = 1'-0"


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PROJECT: RYE UNION FREE SCHOOL DISTRICT
PORT CHESTER, RYE UNION FREE SCHOOL DISTRICT
JOHN F. KENNEDY PRIMARY SCHOOL
JOHN F. KENNEDY PRIMARY SCHOOL LIBRARY ALTERATIONS
JOHN F. KENNEDY PRIMARY SCHOOL OFFICE ALTERATIONS
PORT CHESTER MIDDLE SCHOOL CLASSROOM ALTERATIONS
DRAWING TITLE
JOHN F. KENNEDY PRIMARY SCHOOL
FIRST FLOOR PLAN

06-08-2021	B I O
DATE	ISSUED TO
SHEET SIZE 30"x42"	DRAWING NO. A-101
SCALE AS NOTED	FILE NO. 21430.00
DRAWN BY F & D	



PORT CHESTER MIDDLE SCHOOL
1 FIRST FLOOR PLAN
SCALE: 1/16" = 1'-0"

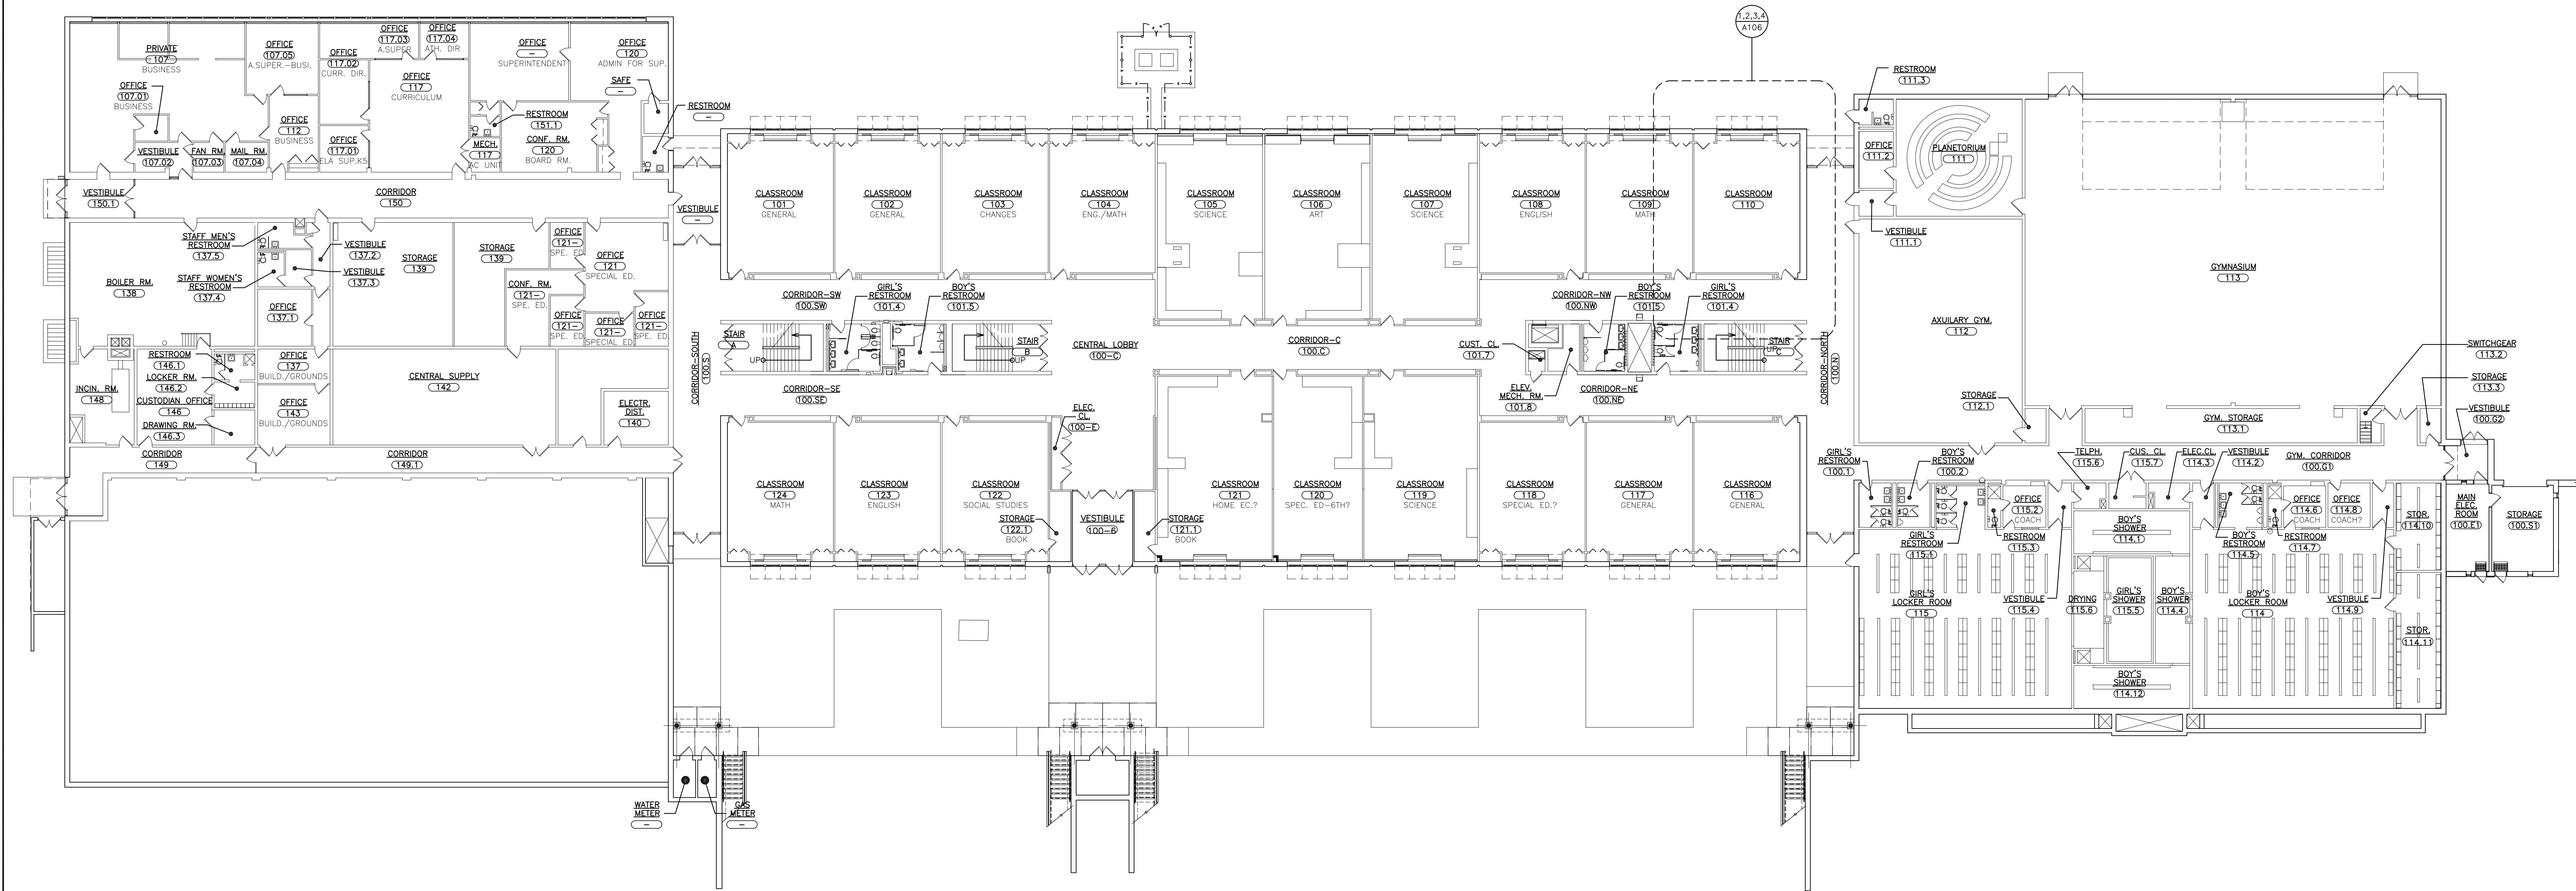

PLOT DATE: June 08, 2021 -- 9:25am

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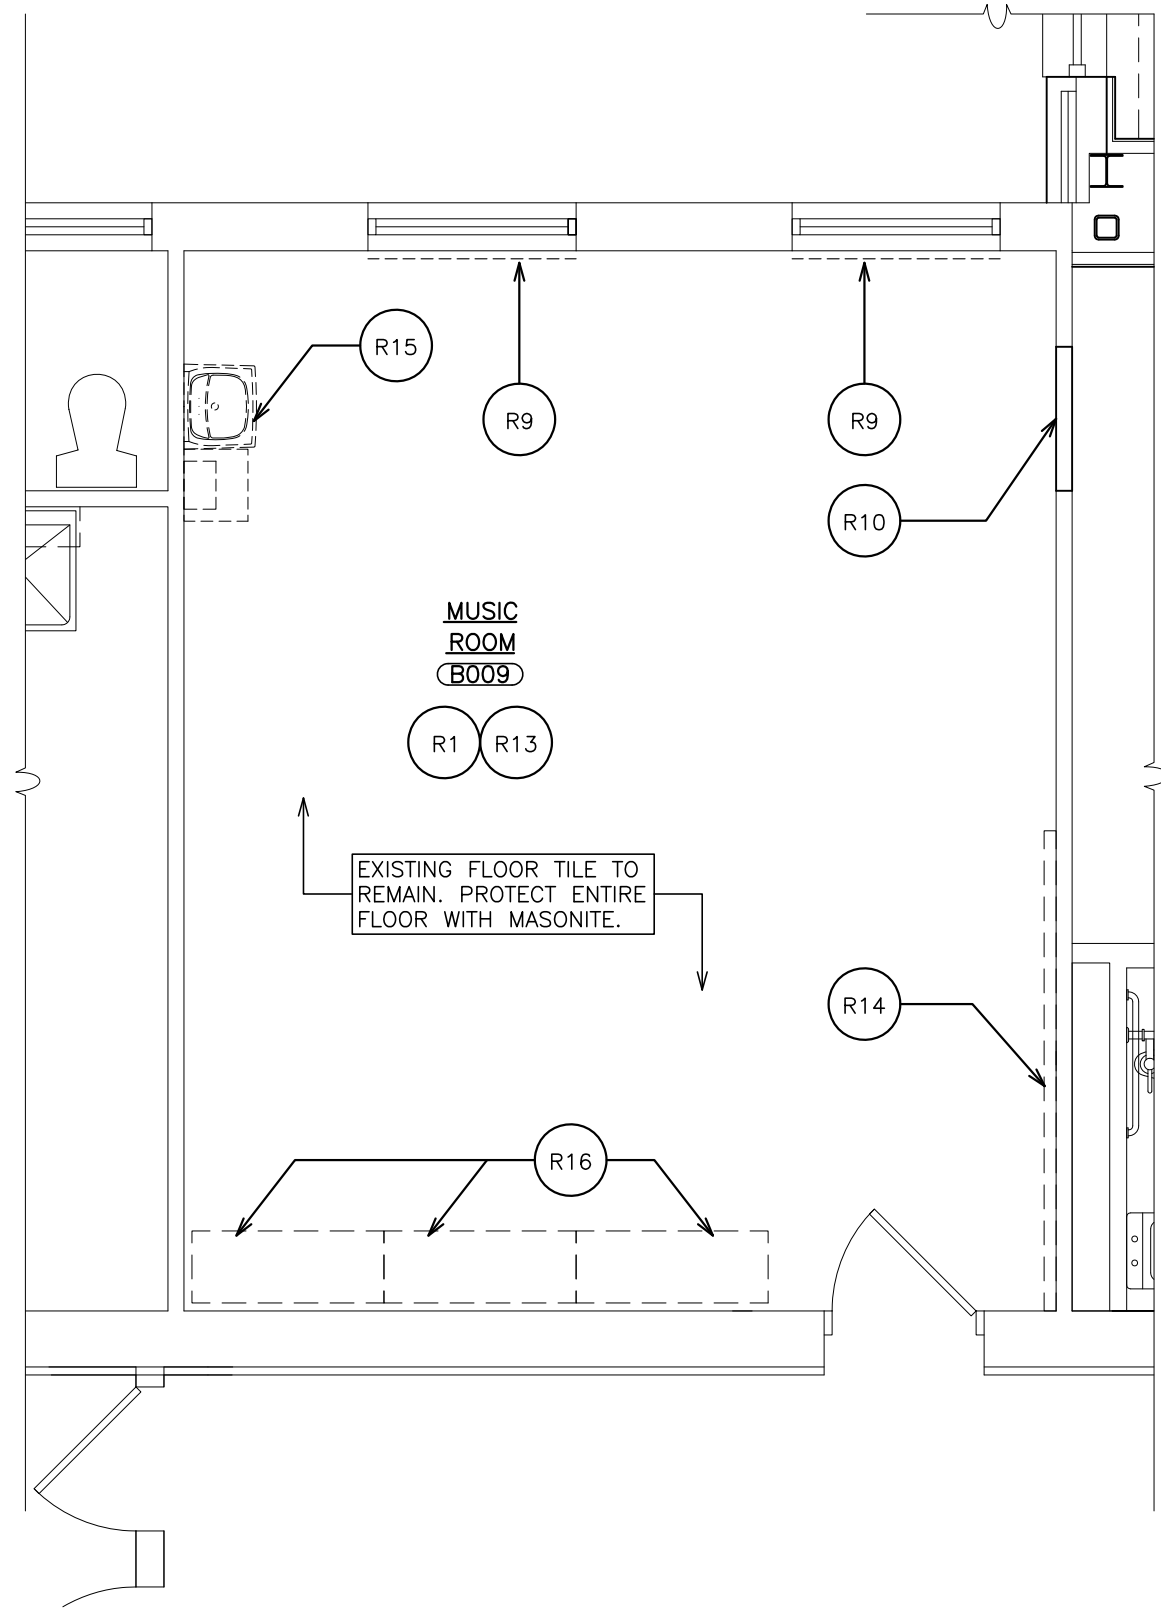
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PLANNERS

PROJECT: PORT CHESTER - RYE UNION FREE SCHOOL DISTRICT
1000 STREET ELEMENTARY SCHOOL LIBRARY ALTERATIONS
JOHN KENNEDY ELEMENTARY SCHOOL OFFICE ALTERATIONS
PORT CHESTER MIDDLE SCHOOL CLASSROOM ALTERATIONS
DRAWING TITLE: PORT CHESTER MIDDLE SCHOOL
FIRST FLOOR PLAN


06-08-2021	B I O
DATE	ISSUED TO
SHEET SIZE 30"x42"	DRAWING NO.
SCALE AS NOTED	A-102
DRAWN BY F & D	FILE NO. 21430.00



1 **PARK AVE. ELEMENTARY SCHOOL**
EXISTING/ REMOVAL PLAN
SCALE: 1/4" = 1'-0"

REMOVAL NOTES:	
COORDINATE REMOVALS WITH ABATEMENT CONTRACTOR	
R1	COORDINATE REMOVALS WITH OWNER. OWNER SHALL REMOVE ALL LOOSE FURNITURE AND BOOKS.
R2	REMOVE EXISTING ACOUSTIC TILE AND SUSPENSION SYSTEM AS REQUIRED TO INSTALL MECHANICAL EQUIPMENT. REFER TO ABATEMENT DOCUMENTS FOR ADDITIONAL INFORMATION.
R3	REMOVE EXISTING RESILIENT TILE FLOOR AND ADHESIVE WITHIN NEW ROOM. PREPARE EXISTING CONCRETE SLAB AS SPECIFIED TO RECEIVE NEW FLOOR FINISH. SEE FINISH SCHEDULE FOR ADDITIONAL INFORMATION.
R4	SAVAGE EXISTING BLINDS FOR REINSTALLATION.
R5	EXISTING WAP TO BE REMOVED AND REINSTALLED BY OWNER.
R6	REMOVE EXISTING MASONRY PLANTER AND COMPONENTS IN IT'S ENTIRETY. PREPARE FLOOR SLAB TO RECEIVE NEW FLOOR FINISH. PATCH ENTIRE AREA WITH 3" CONCRETE IF REQUIRED.
R7	REMOVE EXISTING GYPSUM BOARD PARTITION AND DOOR. REFER TO ABATEMENT DOCUMENTS FOR REMOVAL OF FLOOR TILE.
R8	REMOVE EXISTING 24" X 48" CEILING TILE AND REPLACE WITH NEW.
R9	SAVAGE AND REMOVE EXISTING WINDOW SHADES FOR REINSTALLATION.
R10	REMOVE EXISTING WALL GRILLE PATCH OPENING EACH SIDE OF WALL.
R11	REMOVE EXISTING ACOUSTIC TILE AND SUSPENSION SYSTEM.
R12	REMOVE EXISTING SHELVING, CABINETRY AND RELATED ITEMS IN THEIR ENTIRETY. PATCH DISTURBED SURFACE TO MATCH EXISTING ADJACENT SURFACES.
R13	DISCONNECT AND REMOVE EXISTING FLUORESCENT LIGHT FIXTURES AND ELECTRIC OUTLETS AND SWITCHES. REFER TO ELECTRICAL DRAWINGS. PROVIDE NEW FIXTURES AS INDICATED.
R14	REMOVE EXISTING CHALK BOARDS AND RELATED TRIM GLUE AND ANCHORS IN THEIR ENTIRETY. CLEAN PATCH AND PREPARE SURFACES TO RECEIVE NEW FINISHES AS PER MANUFACTURER'S REQUIREMENTS. SEE FINISH SCHEDULE REFER TO ABATEMENT DRAWINGS FOR ADDITIONAL INFORMATION.
R15	REMOVE EXISTING SINK BY MC. REFER TO MECHANICAL DRAWINGS.
R16	SALVAGE (1) SECTION OF EXISTING FREESTANDING SHELVING AND CABINETRY. RELOCATE TO ROOM 200A. CONFIRM WITH OWNER IF (2) REMAINING CABINET SECTIONS SHALL BE SALVAGED.
R17	REFER TO ASBESTOS DOCUMENTS FOR ADDITIONAL INFORMATION.
R18	SALVAGE EXISTING HAND SANITIZERS AND REINSTALL PER OWNER'S DIRECTION.
R19	REMOVE ACT SOFFIT. FULL WIDTH OF NEW ROOM. RE-SUPPORT AS REQUIRED.
R20	OWNER TO RELOCATE EXISTING PLANTER.

REMOVAL LEGEND	
SYMBOL	DESCRIPTION
---	EXISTING BEAM TO REMAIN
----	INDICATES REMOVAL OF EXISTING FULL HEIGHT PARTITION.
----	INDICATES SELECTIVE REMOVAL OF EXISTING CONSTRUCTION
(R1)	REMOVAL NOTE (KEYED)

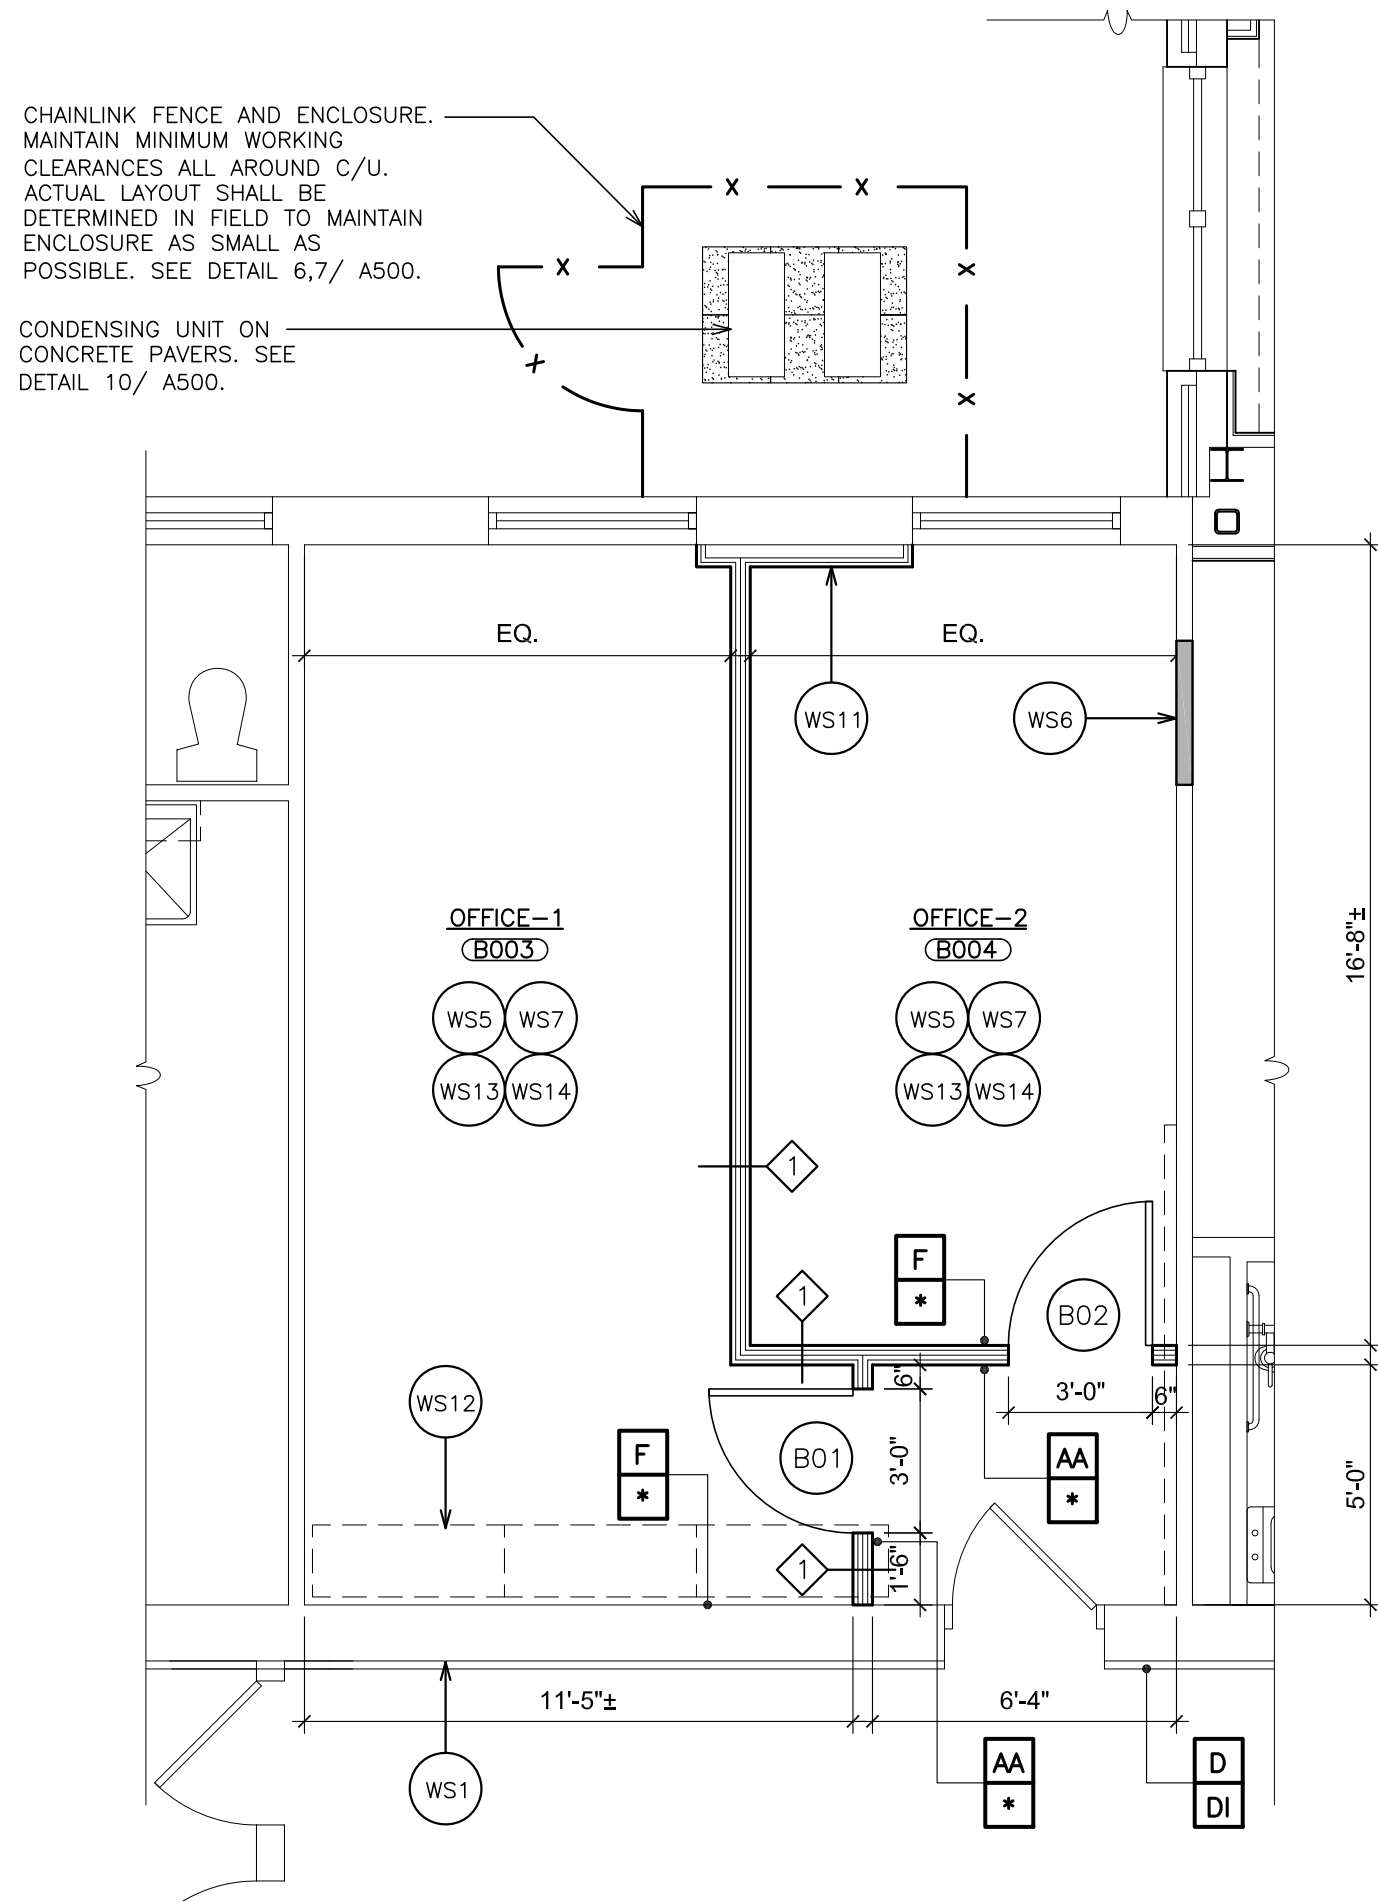


2 **PARK AVE ELEMENTARY SCHOOL**
PROPOSED PLAN
SCALE: 1/4" = 1'-0"

WORKSCOPE NOTES	
WS1	FIRE STOP ALL PENETRATIONS THROUGH CORRIDOR WALL.
WS2	NEW FLOORING. REFER TO FINISH SCHEDULE.
WS3	NEW CEILING PANELS IN EXISTING GRID. REFER TO FINISH SCHEDULE.
WS4	COVER WINDOW PANEL WITH FINISH GRADE PLYWOOD AND PAINT. (FIELD VERIFY CONDITION AFTER REMOVAL OF PLANTER.)
WS5	PAINT WINDOW POCKETS.
WS6	INFILL OPENING IN WALL AFTER REMOVAL OF GRILLE WITH METAL STUDS AND (2) LAYERS OF 5/8" TYPE-X GYPSUM BOARD ON EACH SIDE. SKIM COAT ENTIRE OPENING TO MATCH EXISTING ADJACENT SURFACES.
WS7	SCRAPE, PATCH, CLEAN, PRIME AND PAINT ALL WALLS IN AREA OF WORK, NEW AND EXISTING.
WS8	PROVIDE NEW VCT TO REPLACE ABATED FLOOR TILE. MATCH EXISTING COLOR AND PATTERN. PROVIDE APPROXIMATELY A 24" WIDE STRIP.
WS9	CONSTRUCT WINDOW POCKET OUT OF PRE-FINISHED METAL. ATTACH TO CEILING GRID. SEE DETAIL AT 9/ AS00.
WS10	LINE OF EXISTING DUCTWORK AND FAN TO REMAIN. COORDINATE WITH NEW WORK. PROVIDE GYPSUM BOARD SOFFIT TIGHT TO UNDERSIDE OF FAN SUPPORT.
WS11	FURR EXISTING WALL WITH METAL STUDS AND GYPSUM BOARD TO ACCOMMODATE UTILITY LINES. MAINTAIN SUFFICIENT CLEARANCE FROM WINDOW HARDWARE FOR PROPER OPERATION.
WS12	PATCH/ REPLACE EXISTING VCT AT REMOVED WALL CABINETS.
WS13	PAINT EXISTING QUARTER ROUND AT FLOOR TO MATCH WALLS.
WS14	SCRAPE, PATCH, SKIM COAT EXISTING EXPOSED PLASTER WALLS.
WS15	TRIM/PRUNE TREE FOR INSTALLATION OF FENCE ENCLOSURE.
WS16	REPOSITION EACH WINDOW BLIND TO ALLOW INSTALLATION OF NEW PARTITION AT EXISTING WINDOW MULLION.
WS17	RE-GRADE SOIL LEVEL TO INSTALL CONDENSING UNIT AND CONCRETE PAVERS.
WS18	INSTALL NEW CEILING SUSPENSION SYSTEM AND CEILING TILE TO MATCH EXISTING. SUPPORT FROM STRUCTURE.
WS19	PAINT ENTIRE WALL MATCH EXISTING.

SIGNAGE LEGEND	
AA	INDICATES SIGN TYPE AA
*	INDICATES LOCATION OF SIGN
ROOM FUNCTION SIGN (AA)	SIGN DESCRIPTION
F	INDICATES SIGN TYPE F
*	INDICATES LOCATION OF SIGN
EMERGENCY EVACUATION PLAN (F)	SIGN DESCRIPTION
D	INDICATES SIGN TYPE D
*	INDICATES LOCATION OF SIGN
DIRECTORY SIGN (D)	SIGN DESCRIPTION

- NOTES:**
- REFER TO SPECIFICATIONS FOR SIGNAGE ALLOWANCE.
 - REFER TO DRAWING 'G-1' FOR ADDITIONAL SIGNAGE INFORMATION.

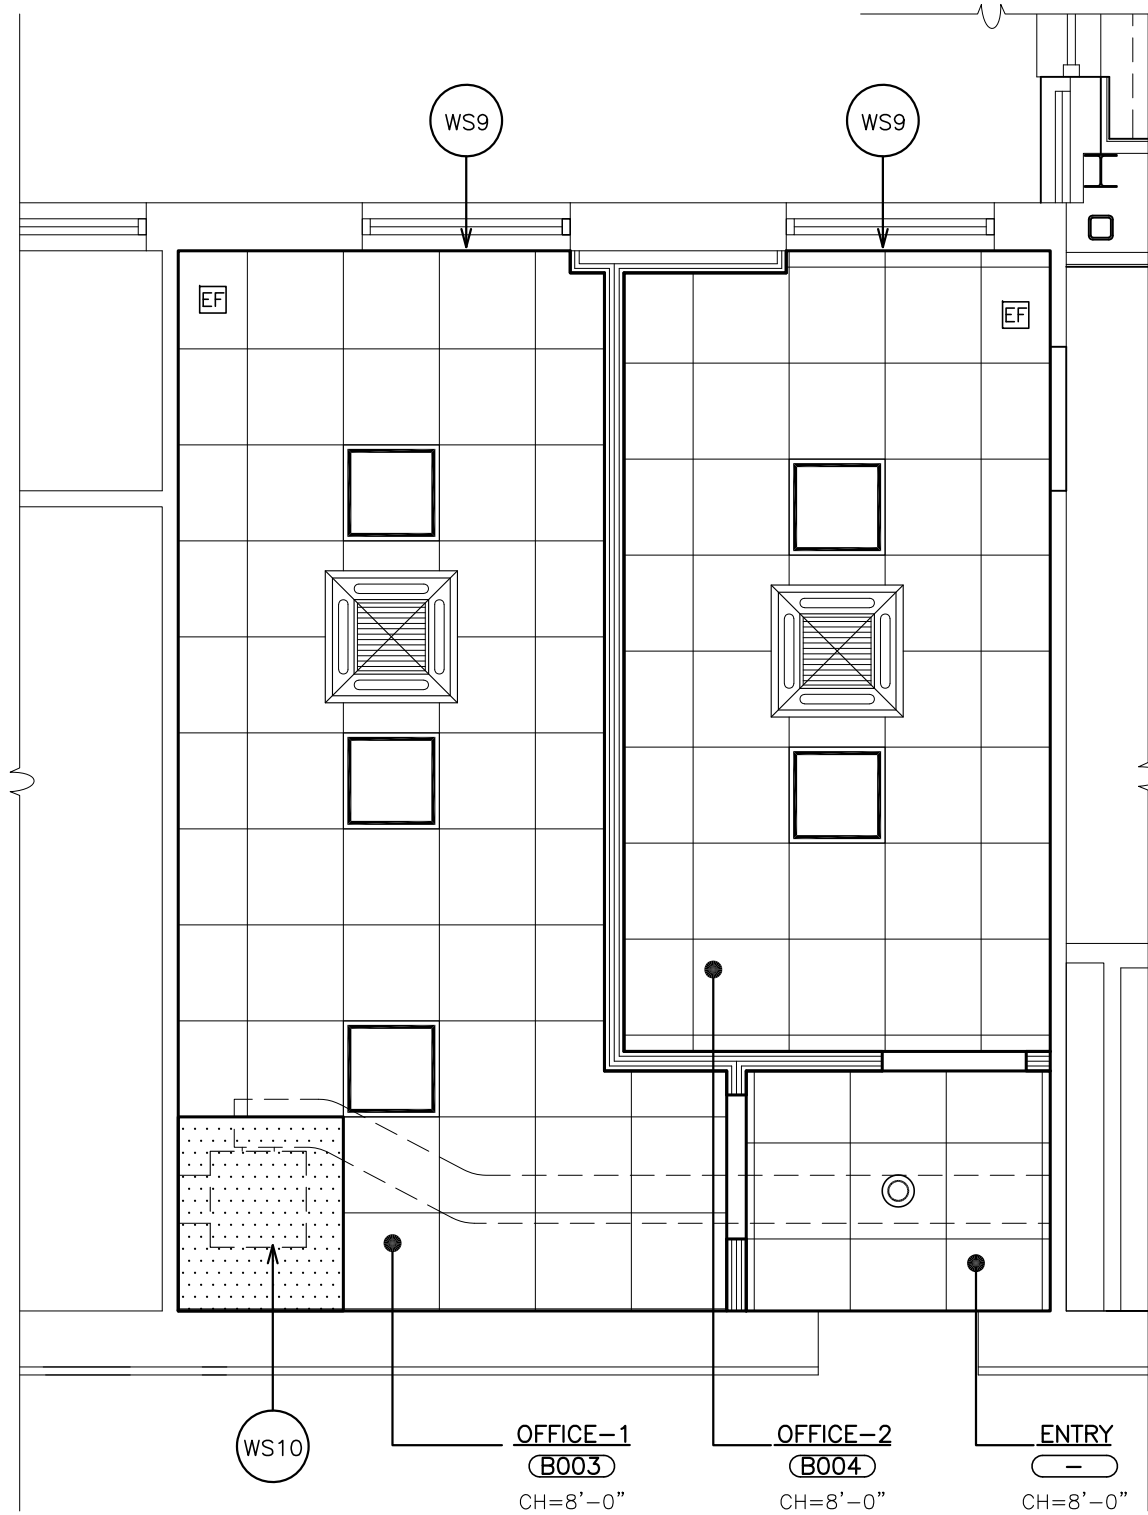

3 **PARK AVE. ELEMENTARY SCHOOL**
REFLECTED CEILING PLAN
SCALE: 1/4" = 1'-0"

GENERAL CEILING NOTES	
1.	ALL CEILING MOUNTED ITEMS (DETECTORS, GRILLS, ETC.) AND INDICATED ON THE MECHANICAL AND ELECTRICAL DRAWINGS. ALL ITEMS ARE TO BE CENTERED WITHIN THE CEILING TILES AND GRIDS. WHERE ITEMS ARE SHOWN ON ARCHITECTURAL DRAWINGS THEY DENOTE LOCATION AND LAYOUT WHERE PLACEMENT IS CRITICAL. THE ARCHITECTURAL DRAWINGS DO NOT REPRESENT COMPLETE SYSTEMS THAT ARE SHOWN ON OTHER DRAWINGS. REFER TO MECHANICAL AND ELECTRICAL DRAWINGS FOR ACCESS DOORS REQUIRED FOR ANY DEVICES WHICH MAY BE COVERED OVER DUE TO NEW CEILING AND SOFFIT WORK.
2.	THE CEILING GRID IS TO BE CENTERED IN ROOMS-TYPICAL UNLESS NOTED OTHERWISE.
3.	PAINT ALL NEW GYPSUM WALLBOARD SOFFITS AND CEILINGS.
4.	REFER TO FINISH SCHEDULE FOR ADDITIONAL INFORMATION.
5.	FIT CEILING TILES AND GRIDS AROUND VERTICAL PIPES THAT PASS THROUGH THE NEW CEILING.
6.	OWNER SHALL REMOVE AND RE-INSTALL WIFI RECEIVERS. COORDINATE
7.	NOT USED
8.	CEILING HEIGHTS INDICATED ARE EXISTING AND ARE TO BE FIELD VERIFIED BY CONTRACTOR. ALL NEW CEILING HEIGHTS ARE TO MATCH EXISTING UNLESS NOTED OTHERWISE.
9.	DIMENSIONS AND CONDITIONS OF EXISTING ITEMS ARE APPROXIMATE (NOT AS-BUILTS). CONTRACTOR SHALL FIELD VERIFY.

CEILING LEGEND	
2'x2' RECESSED MOUNTED LIGHT FIXTURE	
2'x4' RECESSED MOUNTED LIGHT FIXTURE	
RECESSED CAN LIGHT FIXTURE	
GYPSUM BOARD OR SOFFIT	
CEILING GRID STARTING POINT	
FIRE ALARM SMOKE DETECTOR	
CEILING SPEAKER	
EXHAUST FAN, SEE MECHANICAL DWGS.	
CEILING REGISTER. SIZE VARIES. SEE MECHANICAL DRAWINGS.	
CEILING DIFFUSER. SIZE VARIES. SEE MECHANICAL DRAWINGS.	
HEAT PUMP DIFFUSER	
CEILING MOUNTED EXIT SIGN W/ DIRECTIONAL ARROW	
WALL MOUNTED EXIT SIGN W/ DIRECTIONAL ARROW	
WIRELESS ACCESS POINT	
OCCUPANCY SENSOR	
CEILING MOUNTED PROJECTOR	
RECESSED PROJECTOR SCREEN	
2'x2' OR 2'x4' ACOUSTICAL CEILING TILE AND SUSPENSION SYSTEM	


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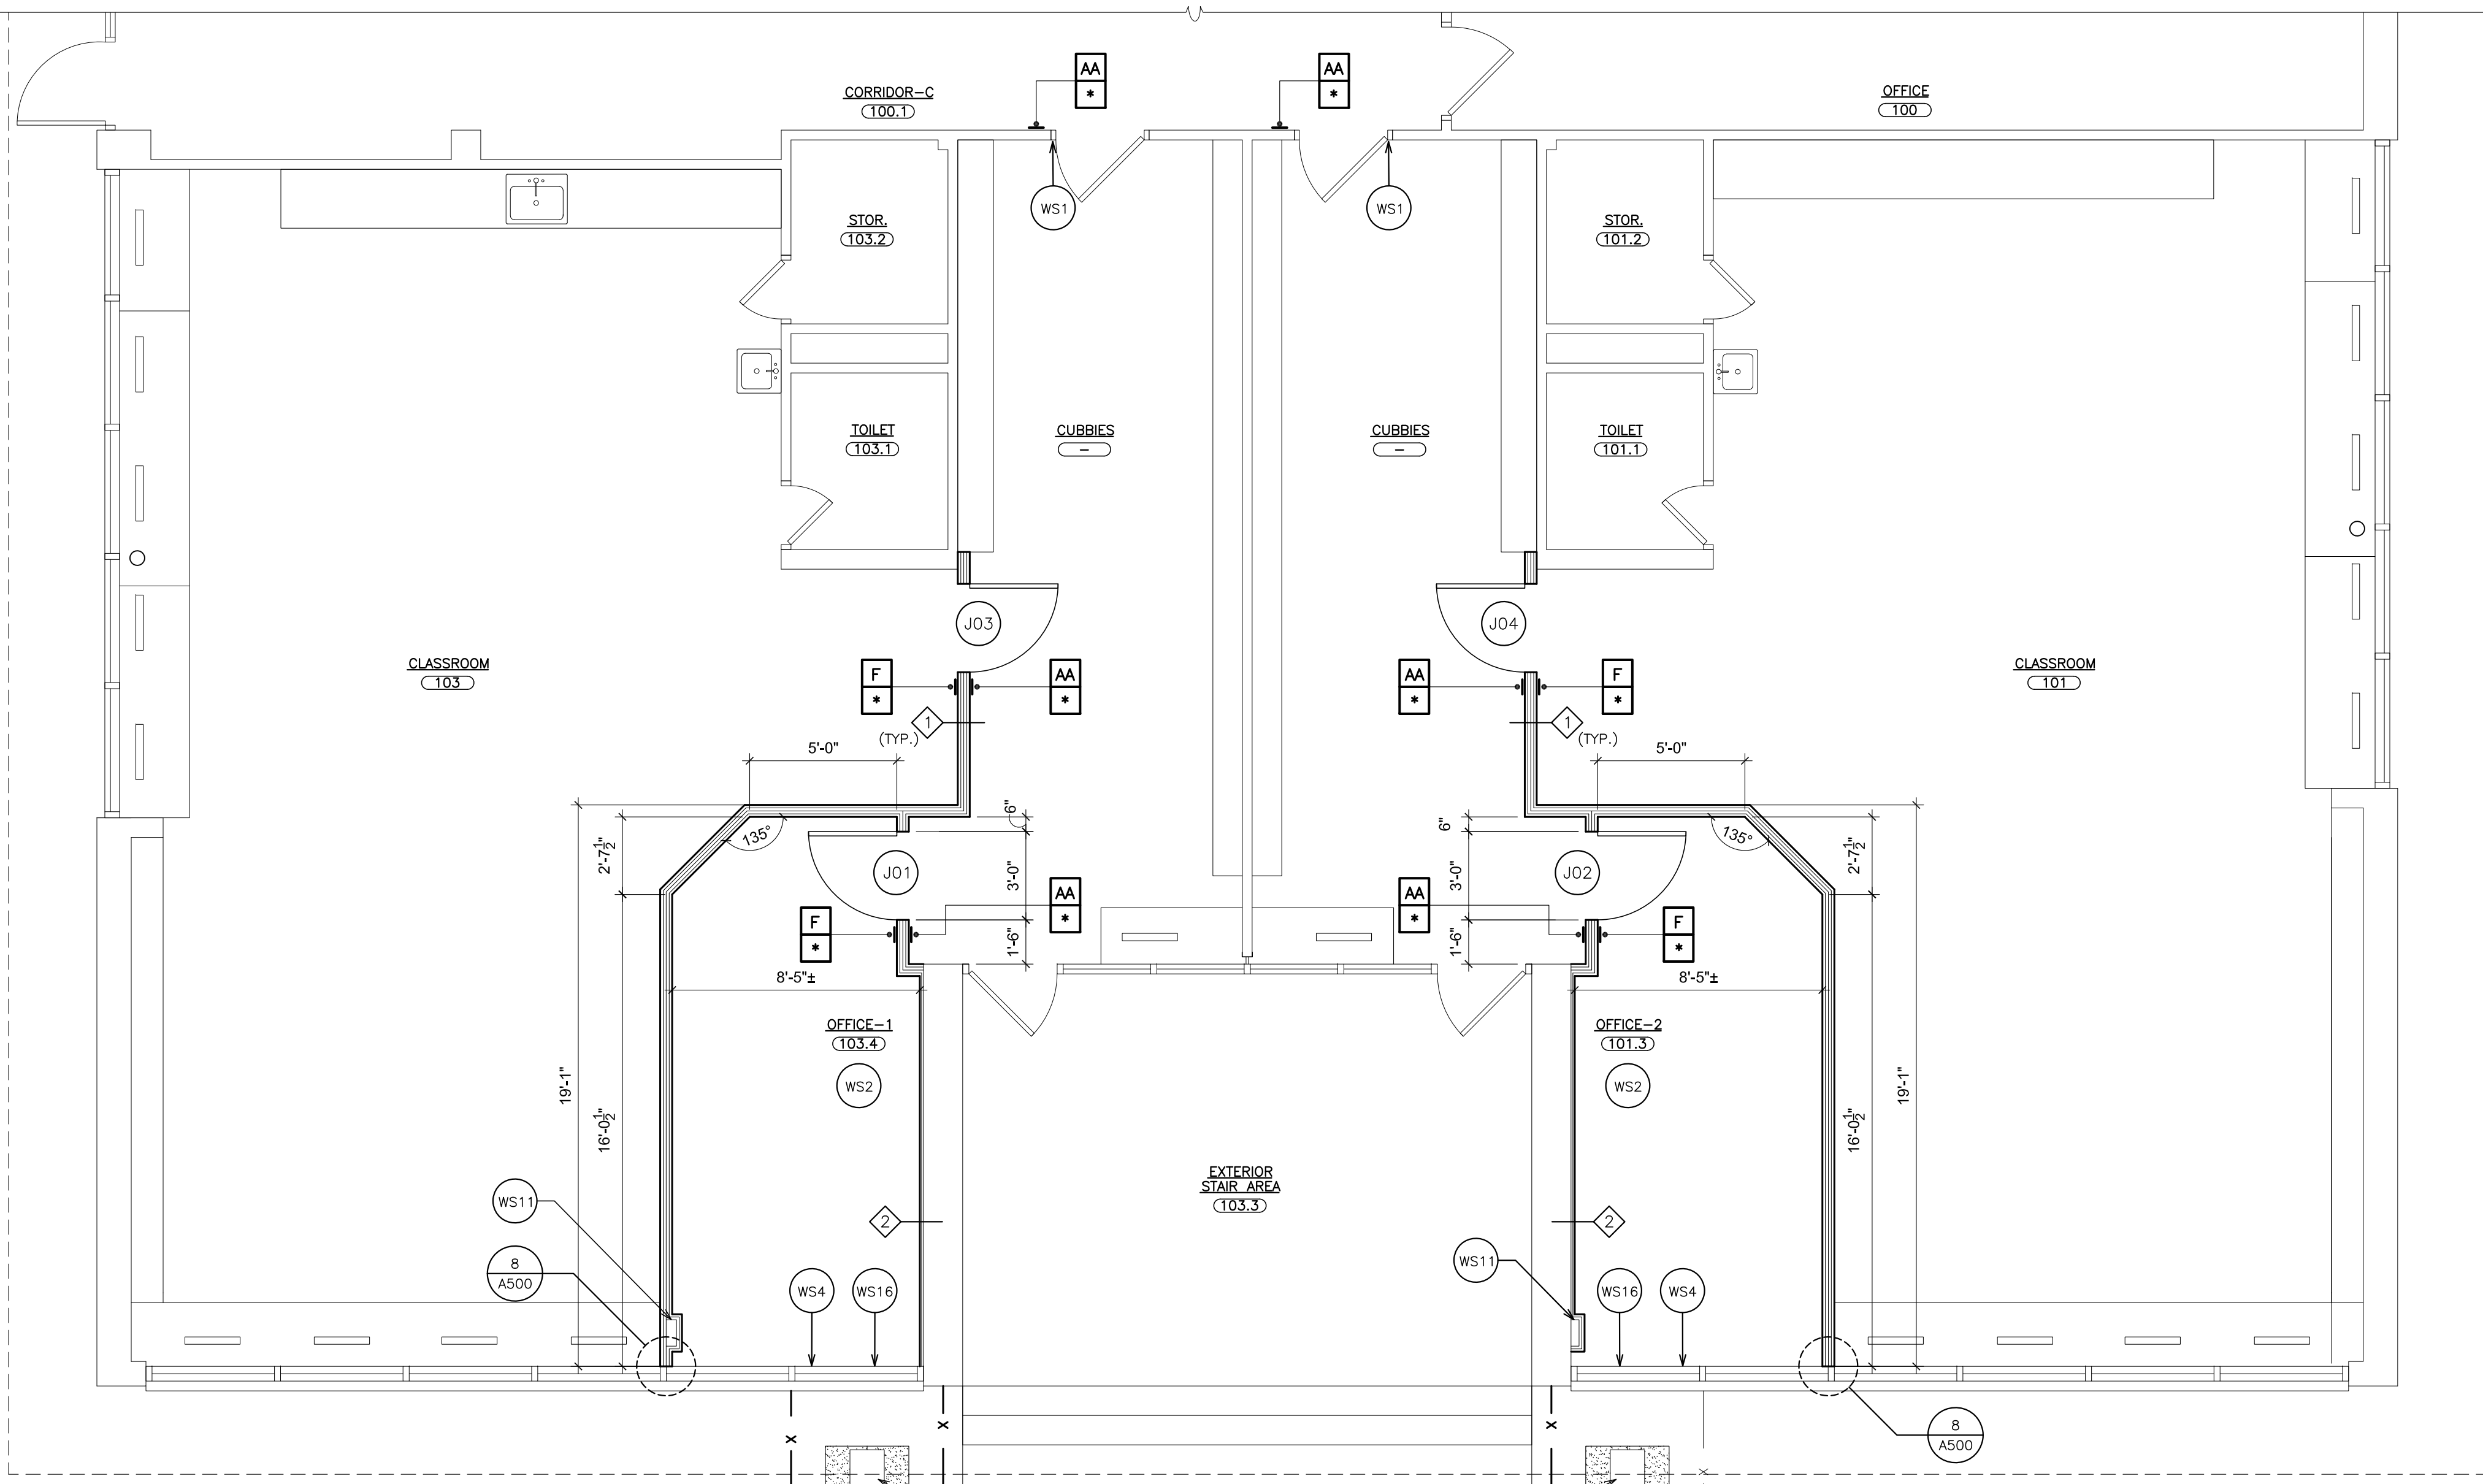
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ARCHITECTS
PLANNERS

PROJECT: PARK AVE. ELEMENTARY SCHOOL DISTRICT
PORT CHESTER, NY
DRAWING TITLE: PARK AVENUE ELEMENTARY SCHOOL
BASEMENT PLAN AND NOTES


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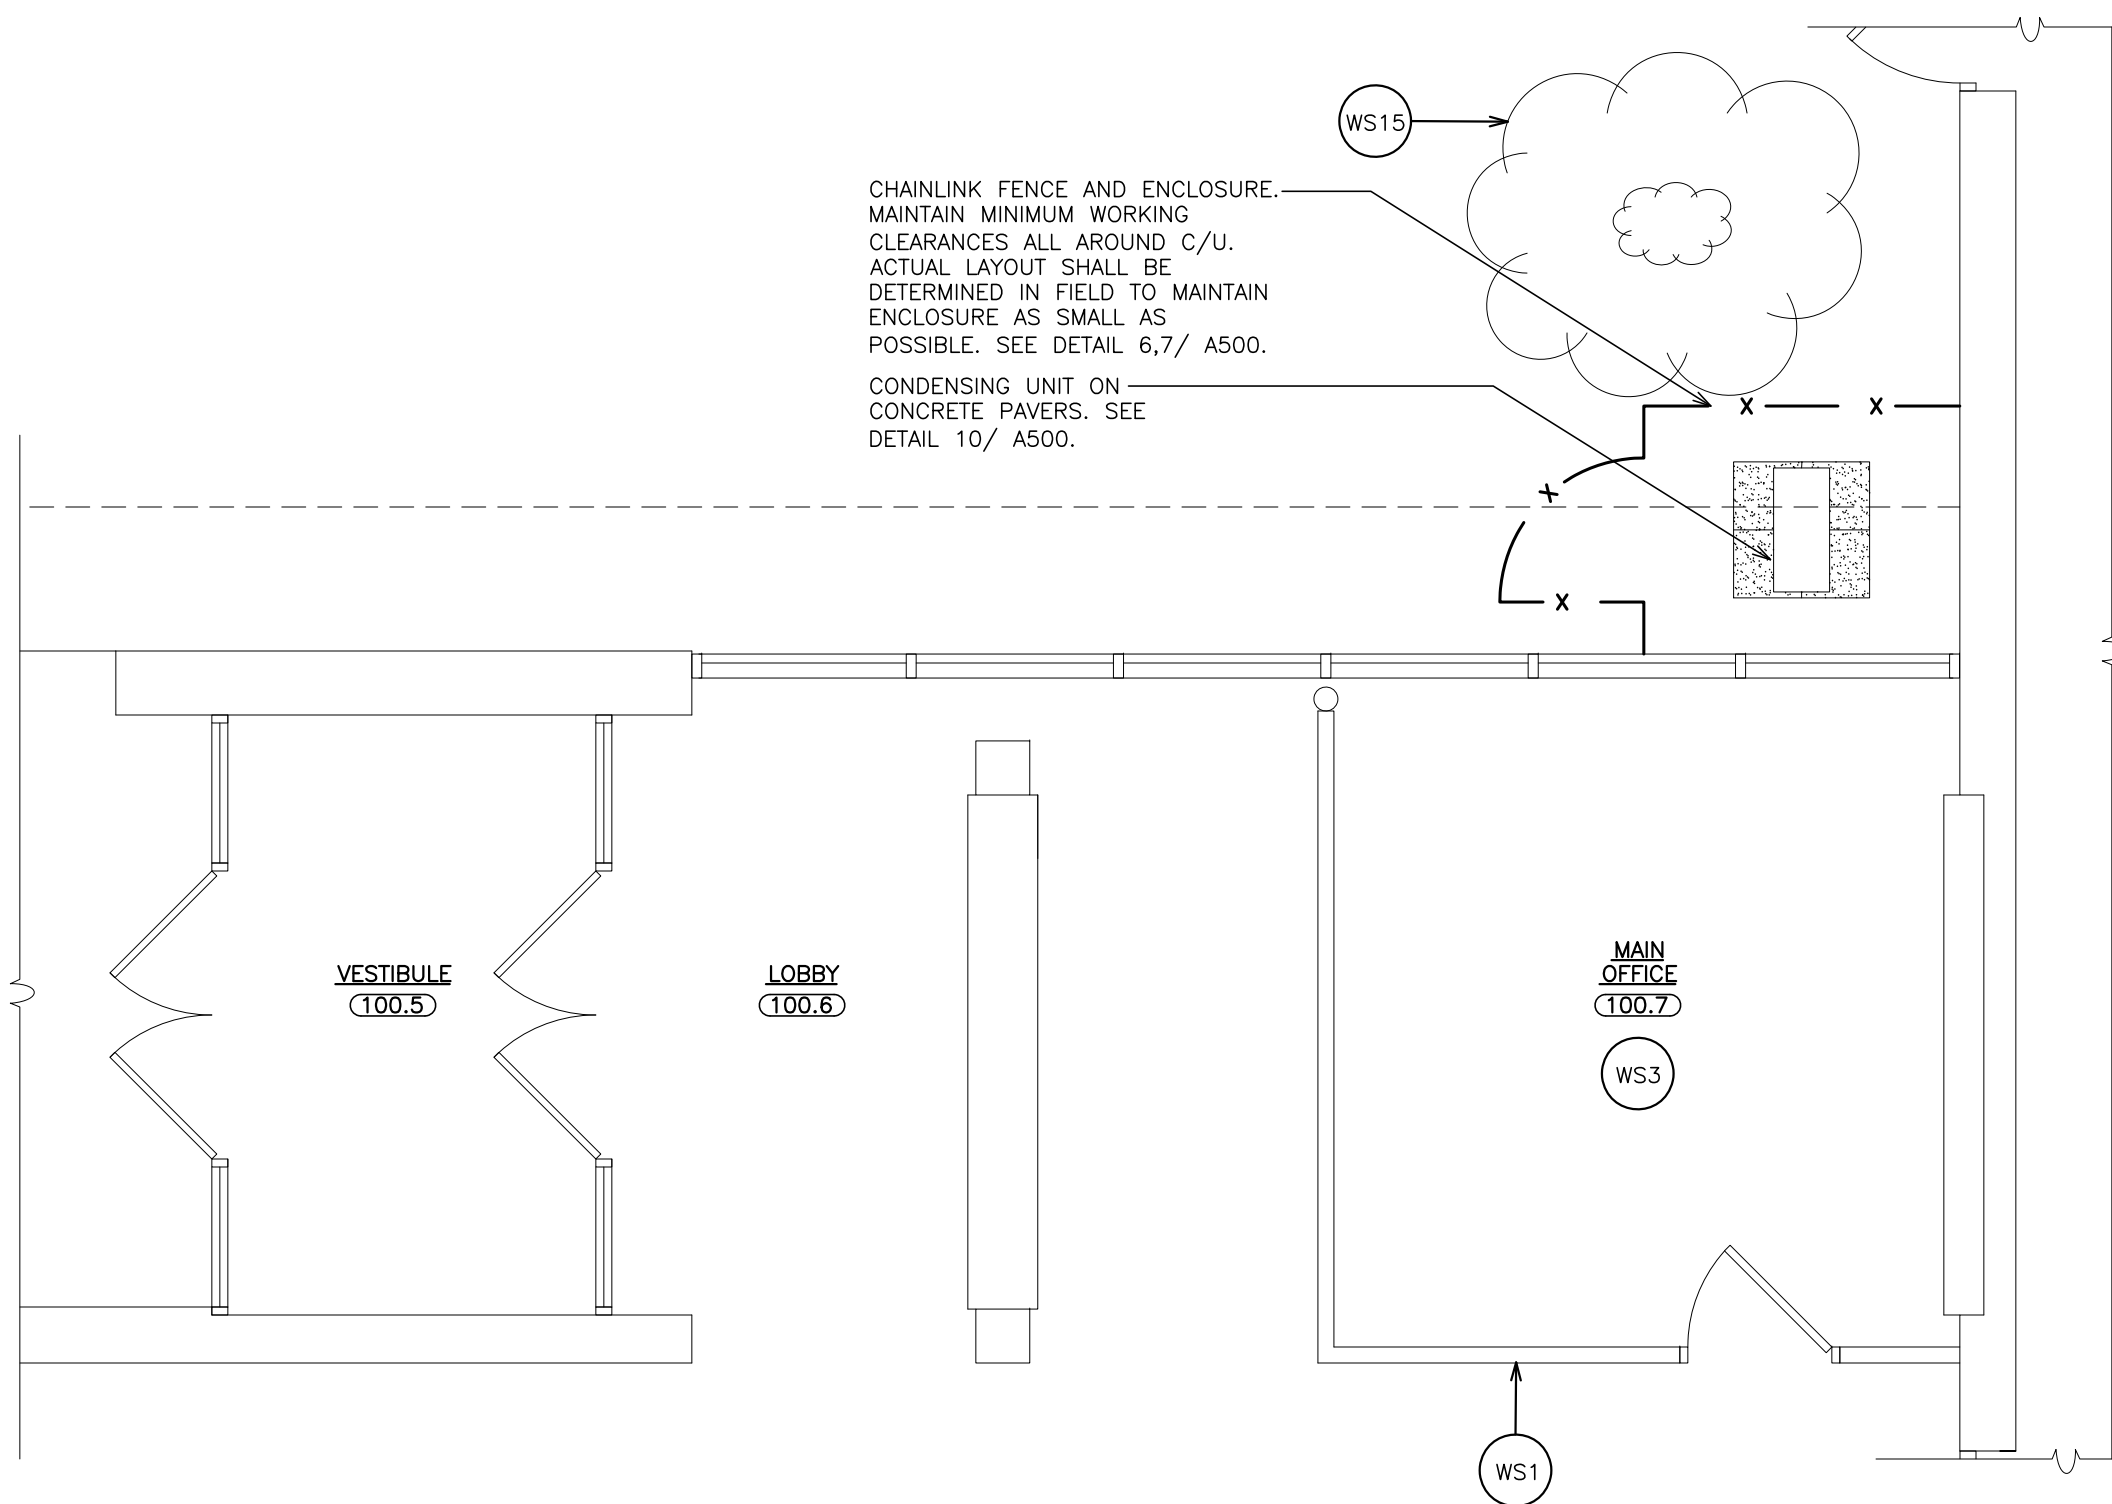
JOHN F. KENNEDY PRIMARY SCHOOL
EXISTING/ REMOVAL PLAN
1 SCALE: 1/4" = 1'-0"



JOHN F. KENNEDY PRI. SCHOOL
PROPOSED PLAN
2 SCALE: 1/4" = 1'-0"

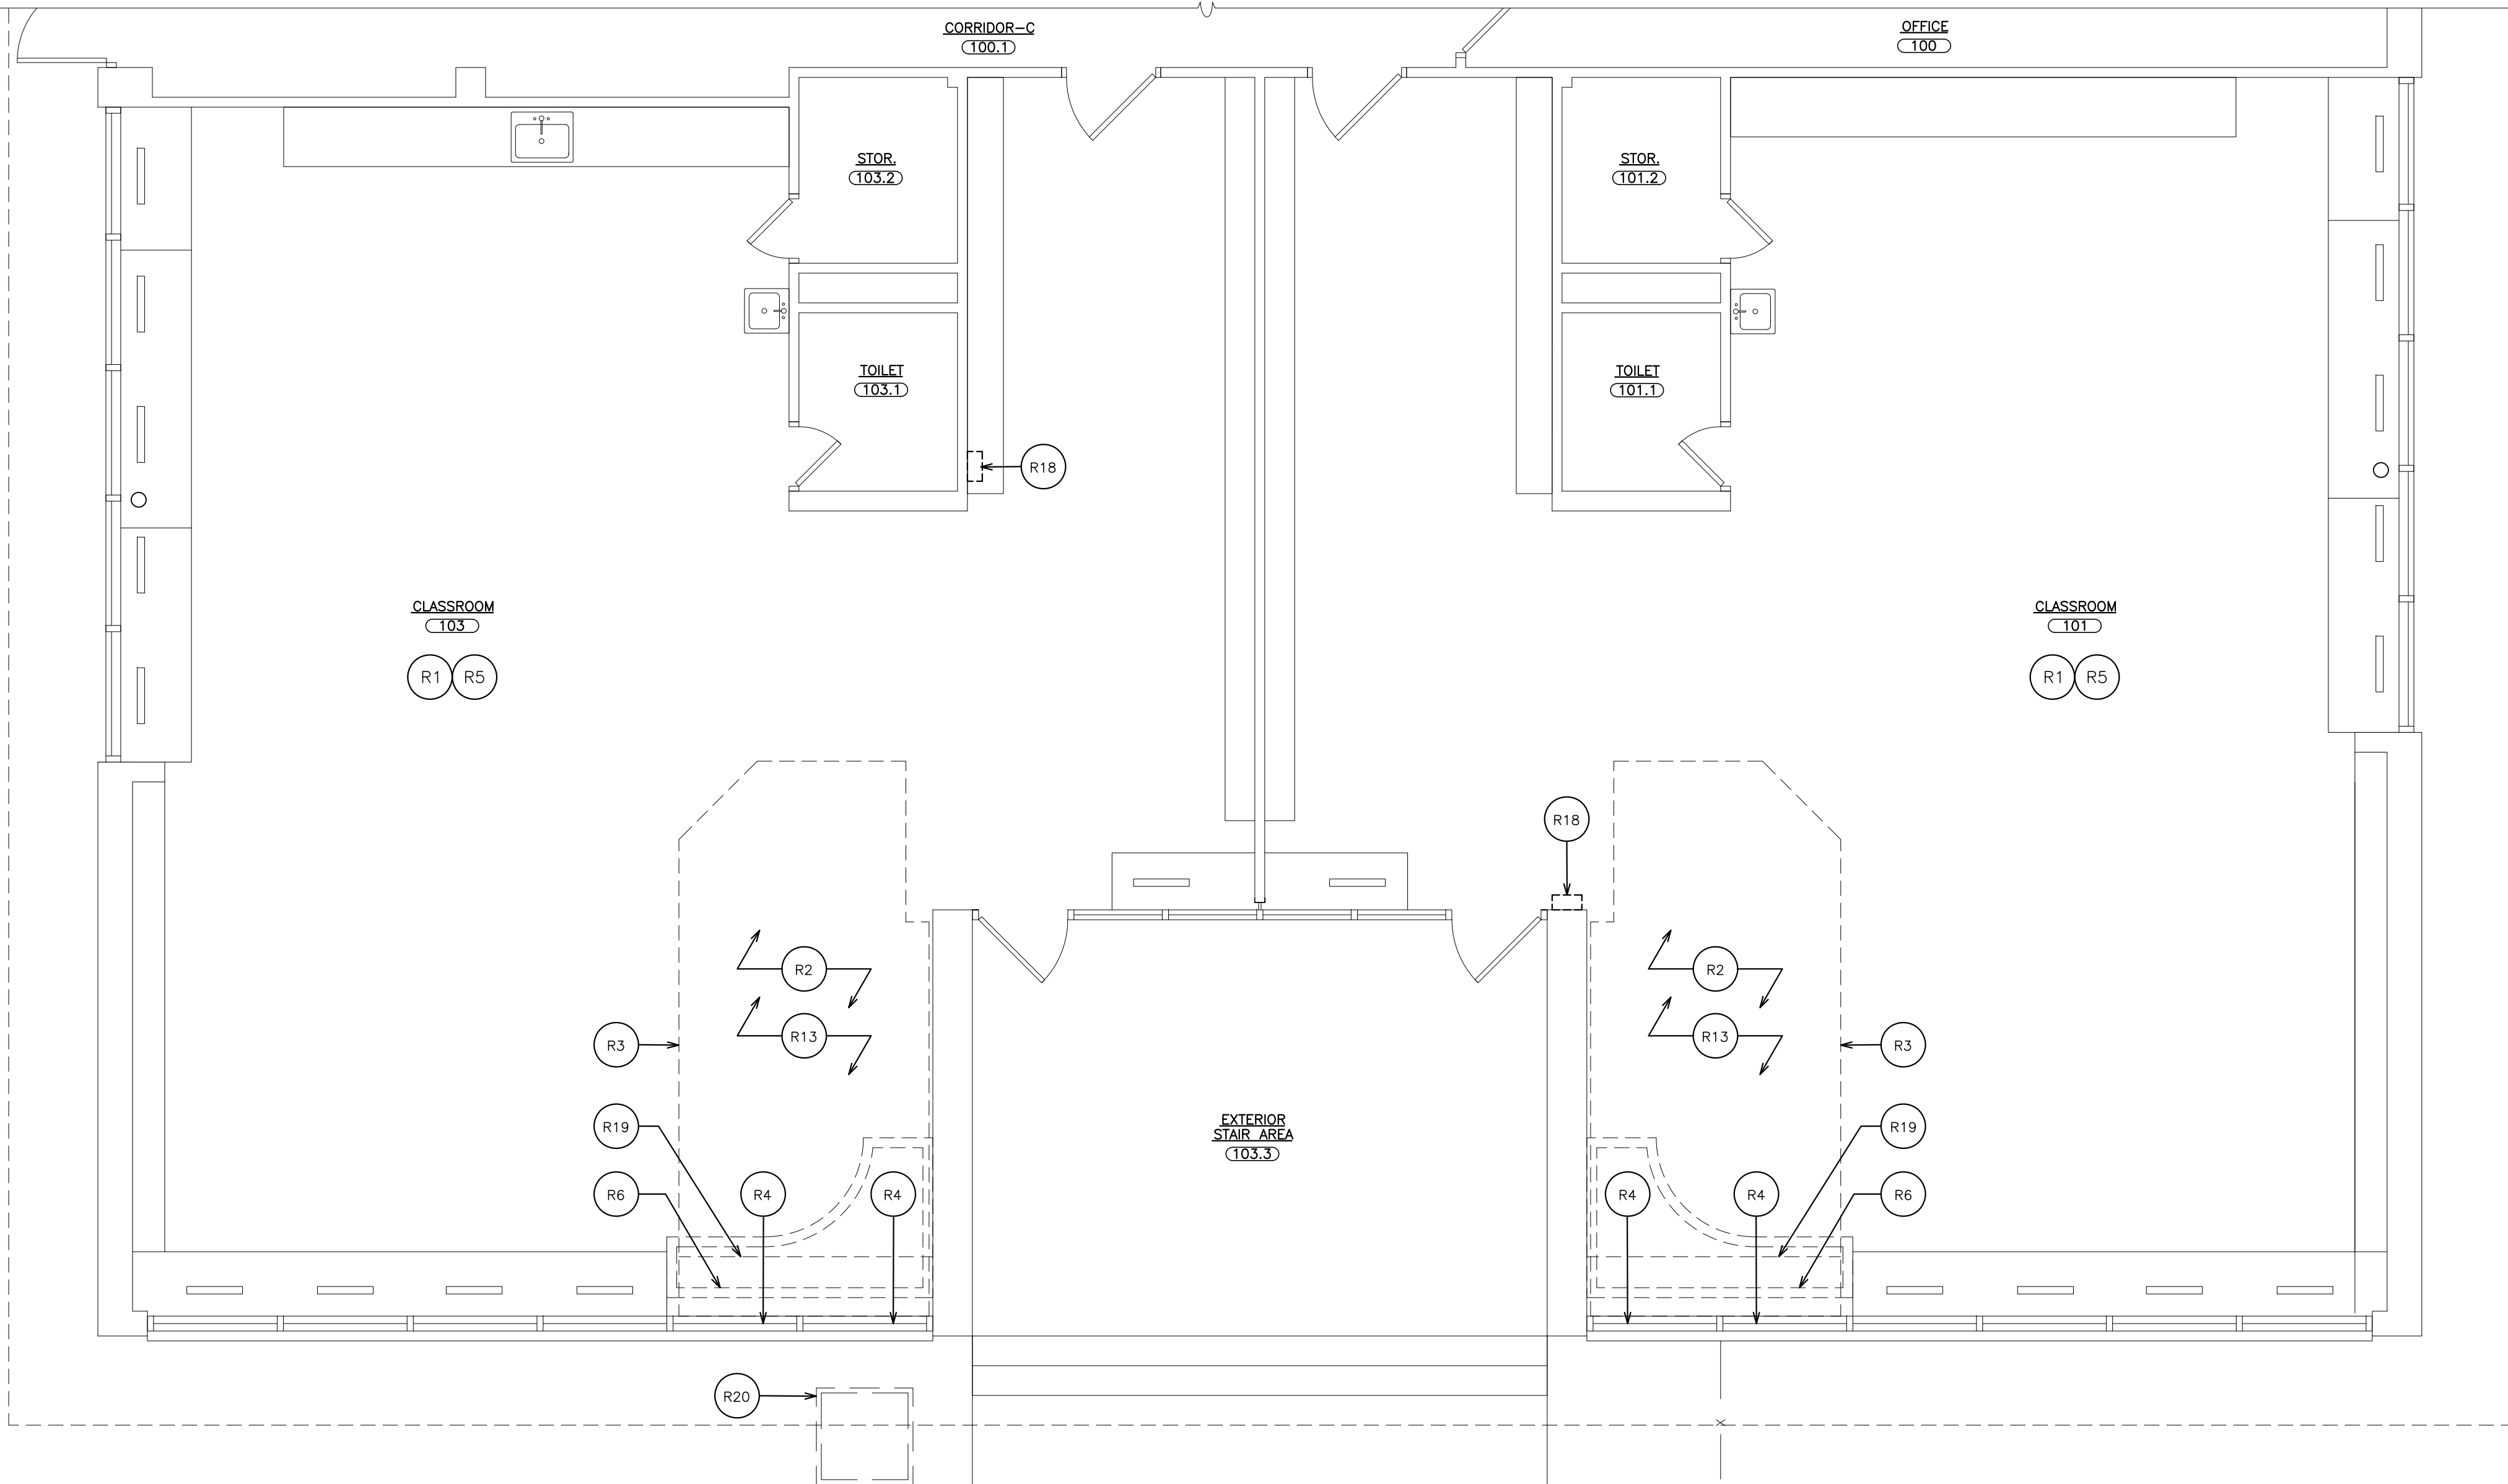

JOHN F. KENNEDY PRIMARY SCHOOL
EXISTING/ REMOVAL PLAN
3 SCALE: 1/4" = 1'-0"

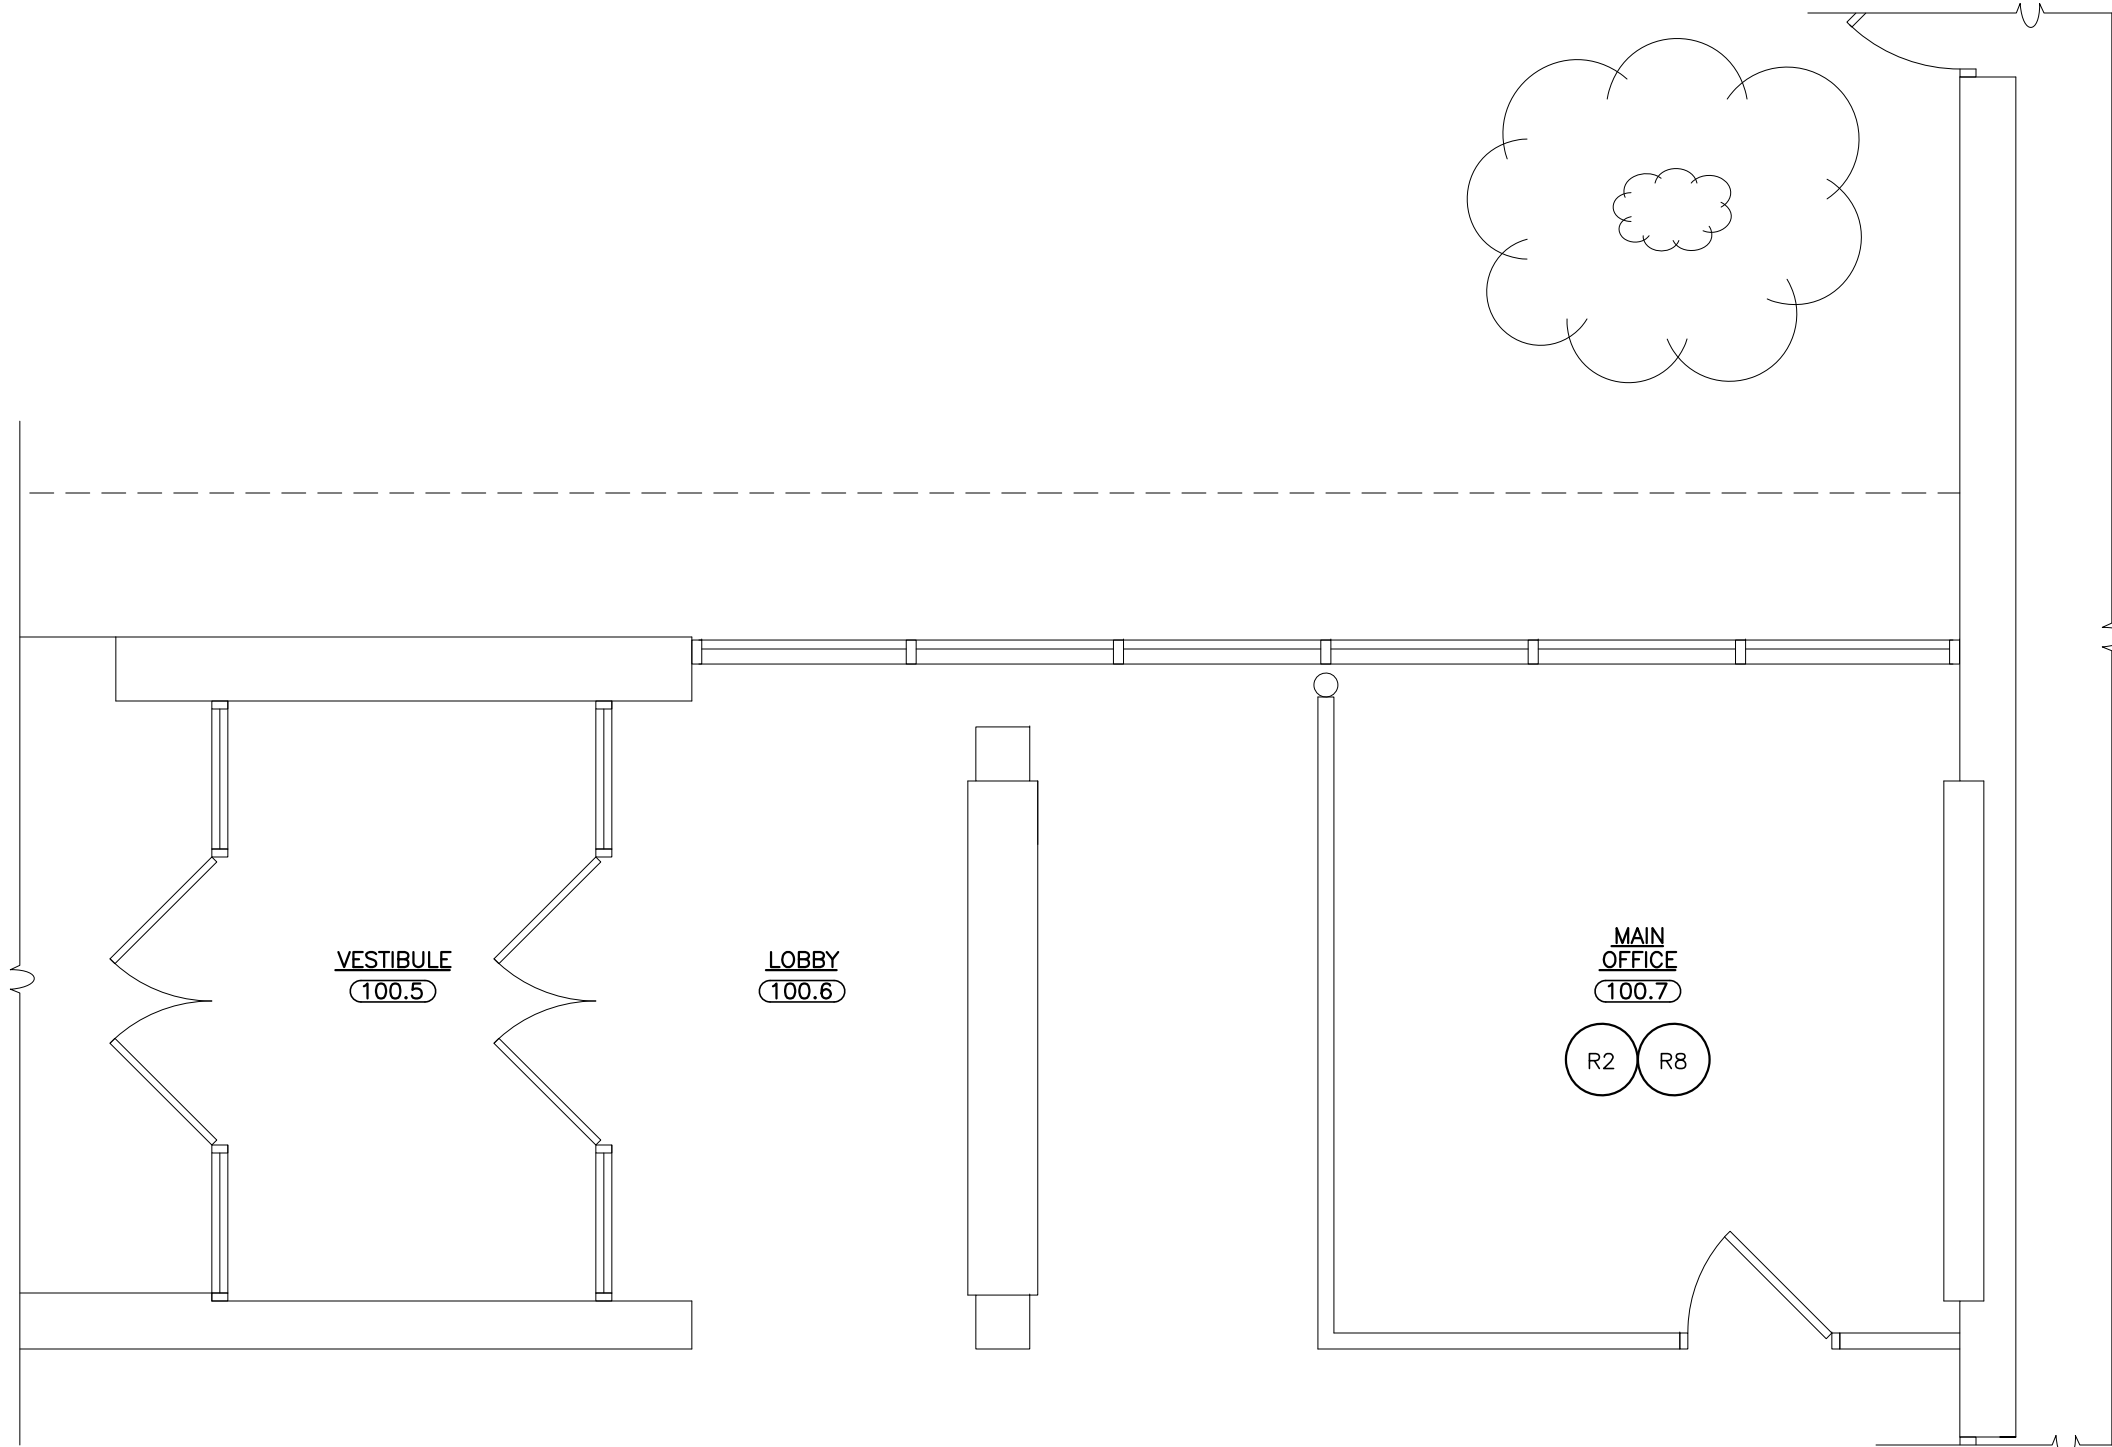

JOHN F. KENNEDY PRIMARY SCHOOL
PROPOSED PLAN
4 SCALE: 1/4" = 1'-0"

SIGNAGE LEGEND	WORKSCOPE NOTES	REMOVAL NOTES:
<p>INDICATES SIGN TYPE AA INDICATES LOCATION OF SIGN SIGN DESCRIPTION</p> <p>INDICATES SIGN TYPE F INDICATES LOCATION OF SIGN EMERGENCY EVACUATION PLAN (F) SIGN DESCRIPTION</p> <p>INDICATES SIGN TYPE D INDICATES LOCATION OF SIGN DIRECTORY SIGN (D) SIGN DESCRIPTION</p>	<p>WS1 FIRE STOP ALL PENETRATIONS THROUGH CORRIDOR WALL.</p> <p>WS2 NEW FLOORING. REFER TO FINISH SCHEDULE.</p> <p>WS3 NEW CEILING PANELS IN EXISTING GRID. REFER TO FINISH SCHEDULE.</p> <p>WS4 COVER WINDOW PANEL WITH FINISH GRADE PLYWOOD AND PAINT. (FIELD VERIFY CONDITION AFTER REMOVAL OF PLANTER.)</p> <p>WS5 PAINT WINDOW POCKETS.</p> <p>WS6 INFILL OPENING IN WALL AFTER REMOVAL OF GRILLE WITH METAL STUDS AND (2) LAYERS OF 5/8" TYPE-X GYPSUM BOARD ON EACH SIDE. SKIM COAT ENTIRE OPENING TO MATCH EXISTING ADJACENT SURFACES.</p> <p>WS7 SCRAPE, PATCH, CLEAN, PRIME AND PAINT ALL WALLS IN AREA OF WORK, NEW AND EXISTING.</p> <p>WS8 PROVIDE NEW VCT TO REPLACE ABATED FLOOR TILE. MATCH EXISTING COLOR AND PATTERN. PROVIDE APPROXIMATELY A 24" WIDE STRIP.</p> <p>WS9 CONSTRUCT WINDOW POCKET OUT OF PRE-FINISHED METAL. ATTACH TO CEILING GRID. SEE DETAIL AT 9/ ASO.</p> <p>WS10 LINE OF EXISTING DUCTWORK AND FAN TO REMAIN. COORDINATE WITH NEW WORK. PROVIDE GYPSUM BOARD SOFFIT TIGHT TO UNDERSIDE OF FAN SUPPORT.</p> <p>WS11 FURR EXISTING WALL WITH METAL STUDS AND GYPSUM BOARD TO ACCOMMODATE UTILITY LINES. MAINTAIN SUFFICIENT CLEARANCE FROM WINDOW HARDWARE FOR PROPER OPERATION.</p> <p>WS12 PATCH/ REPLACE EXISTING VCT AT REMOVED WALL CABINETS.</p> <p>WS13 PAINT EXISTING QUARTER ROUND AT FLOOR TO MATCH WALLS.</p> <p>WS14 SCRAPE, PATCH, SKIM COAT EXISTING EXPOSED PLASTER WALLS.</p> <p>WS15 TRIM/PRUNE TREE FOR INSTALLATION OF FENCE ENCLOSURE.</p> <p>WS16 REPOSITION EACH WINDOW BLIND TO ALLOW INSTALLATION OF NEW PARTITION AT EXISTING WINDOW MULLION.</p> <p>WS17 RE-GRADE SOIL LEVEL TO INSTALL CONDENSING UNIT AND CONCRETE PAVERS.</p> <p>WS18 INSTALL NEW CEILING SUSPENSION SYSTEM AND CEILING TILE TO MATCH EXISTING. SUPPORT FROM STRUCTURE.</p> <p>WS19 PAINT ENTIRE WALL MATCH EXISTING.</p>	<p>R1 COORDINATE REMOVALS WITH OWNER. OWNER SHALL REMOVE ALL LOOSE FURNITURE AND BOOKS.</p> <p>R2 REMOVE EXISTING ACOUSTIC TILE AND SUSPENSION SYSTEM AS REQUIRED TO INSTALL MECHANICAL EQUIPMENT. REFER TO ABATEMENT DOCUMENTS FOR ADDITIONAL INFORMATION.</p> <p>R3 REMOVE EXISTING RESILIENT TILE FLOOR AND ADHESIVE WITHIN NEW ROOM. PREPARE EXISTING CONCRETE SLAB AS SPECIFIED TO RECEIVE NEW FLOOR FINISH. SEE FINISH SCHEDULE FOR ADDITIONAL INFORMATION.</p> <p>R4 SAVAGE EXISTING BLINDS FOR REINSTALLATION.</p> <p>R5 EXISTING WAP TO BE REMOVED AND REINSTALLED BY OWNER.</p> <p>R6 REMOVE EXISTING MASONRY PLANTER AND COMPONENTS IN IT'S ENTIRETY. PREPARE FLOOR SLAB TO RECEIVE NEW FLOOR FINISH. PATCH ENTIRE AREA WITH 3" CONCRETE IF REQUIRED.</p> <p>R7 REMOVE EXISTING GYPSUM BOARD PARTITION AND DOOR. REFER TO ABATEMENT DOCUMENTS FOR REMOVAL OF TILE FLOOR.</p> <p>R8 REMOVE EXISTING 24" X 48" CEILING TILE AND REPLACE WITH NEW.</p> <p>R9 SAVAGE AND REMOVE EXISTING WINDOW SHADES FOR REINSTALLATION.</p> <p>R10 REMOVE EXISTING WALL GRILLE PATCH OPENING EACH SIDE OF WALL.</p> <p>R11 REMOVE EXISTING ACOUSTIC TILE AND SUSPENSION SYSTEM.</p> <p>R12 REMOVE EXISTING SHELVING, CABINETS AND RELATED ITEMS IN THEIR ENTIRETY. PATCH DISTURBED SURFACE TO MATCH EXISTING ADJACENT SURFACES.</p> <p>R13 DISCONNECT AND REMOVE EXISTING FLUORESCENT LIGHT FIXTURES AND ELECTRIC OUTLETS AND SWITCHES. REFER TO ELECTRICAL DRAWINGS. PROVIDE NEW FIXTURES AS INDICATED.</p> <p>R14 REMOVE EXISTING CHALK BOARDS AND RELATED TRIM GLUE AND ANCHORS IN THEIR ENTIRETY. CLEAN PATCH AND PREPARE SURFACES TO RECEIVE NEW FINISHES AS PER MANUFACTURER'S REQUIREMENTS. SEE FINISH SCHEDULE. REFER TO ABATEMENT DRAWINGS FOR ADDITIONAL INFORMATION.</p> <p>R15 REMOVE EXISTING SINK BY MC. REFER TO MECHANICAL DRAWINGS.</p> <p>R16 SALVAGE (1) SECTION OF EXISTING FREESTANDING SHELVING AND CABINETS. RELOCATE TO ROOM 200A. CONFIRM WITH OWNER IF (2) REMAINING CABINET SECTIONS SHALL BE SALVAGED.</p> <p>R17 REFER TO ASBESTOS DOCUMENTS FOR ADDITIONAL INFORMATION.</p> <p>R18 SALVAGE EXISTING HAND SANITIZERS AND REINSTALL PER OWNER'S DIRECTION.</p> <p>R19 REMOVE ACCT SOFFIT. FULL WIDTH OF NEW ROOM. RE-SUPPORT AS REQUIRED.</p> <p>R20 OWNER TO RELOCATE EXISTING PLANTER.</p>


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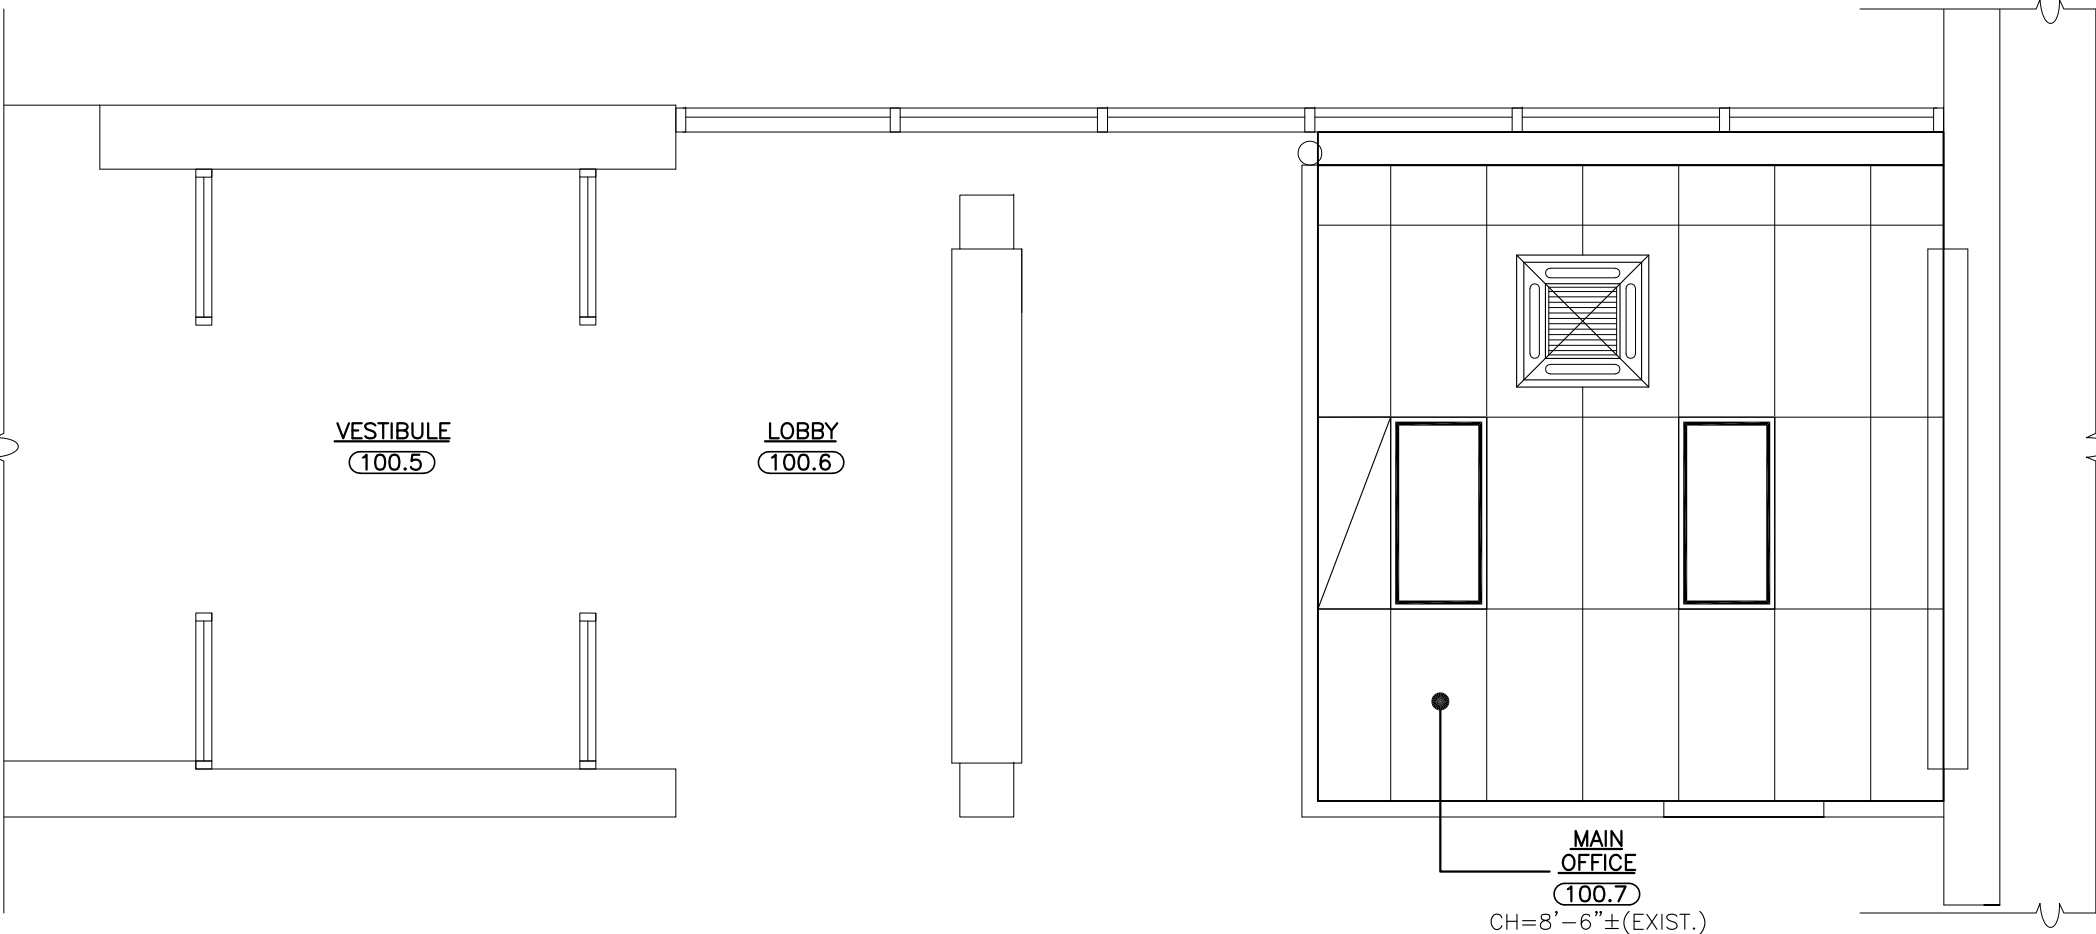
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PORT CHESTER MIDDLE SCHOOL CLASSROOM ALTERATIONS
DRAWING TITLE: JOHN F. KENNEDY PRIMARY SCHOOL
FIRST FLOOR PLAN

06-08-2021 B I O
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JOHN F. KENNEDY PRIMARY SCHOOL
REFLECTED CEILING PLAN
SCALE: 1/4" = 1'-0"



JOHN F. KENNEDY PRIMARY SCHOOL
REFLECTED CEILING PLAN
SCALE: 1/4" = 1'-0"

WORKSCOPE NOTES

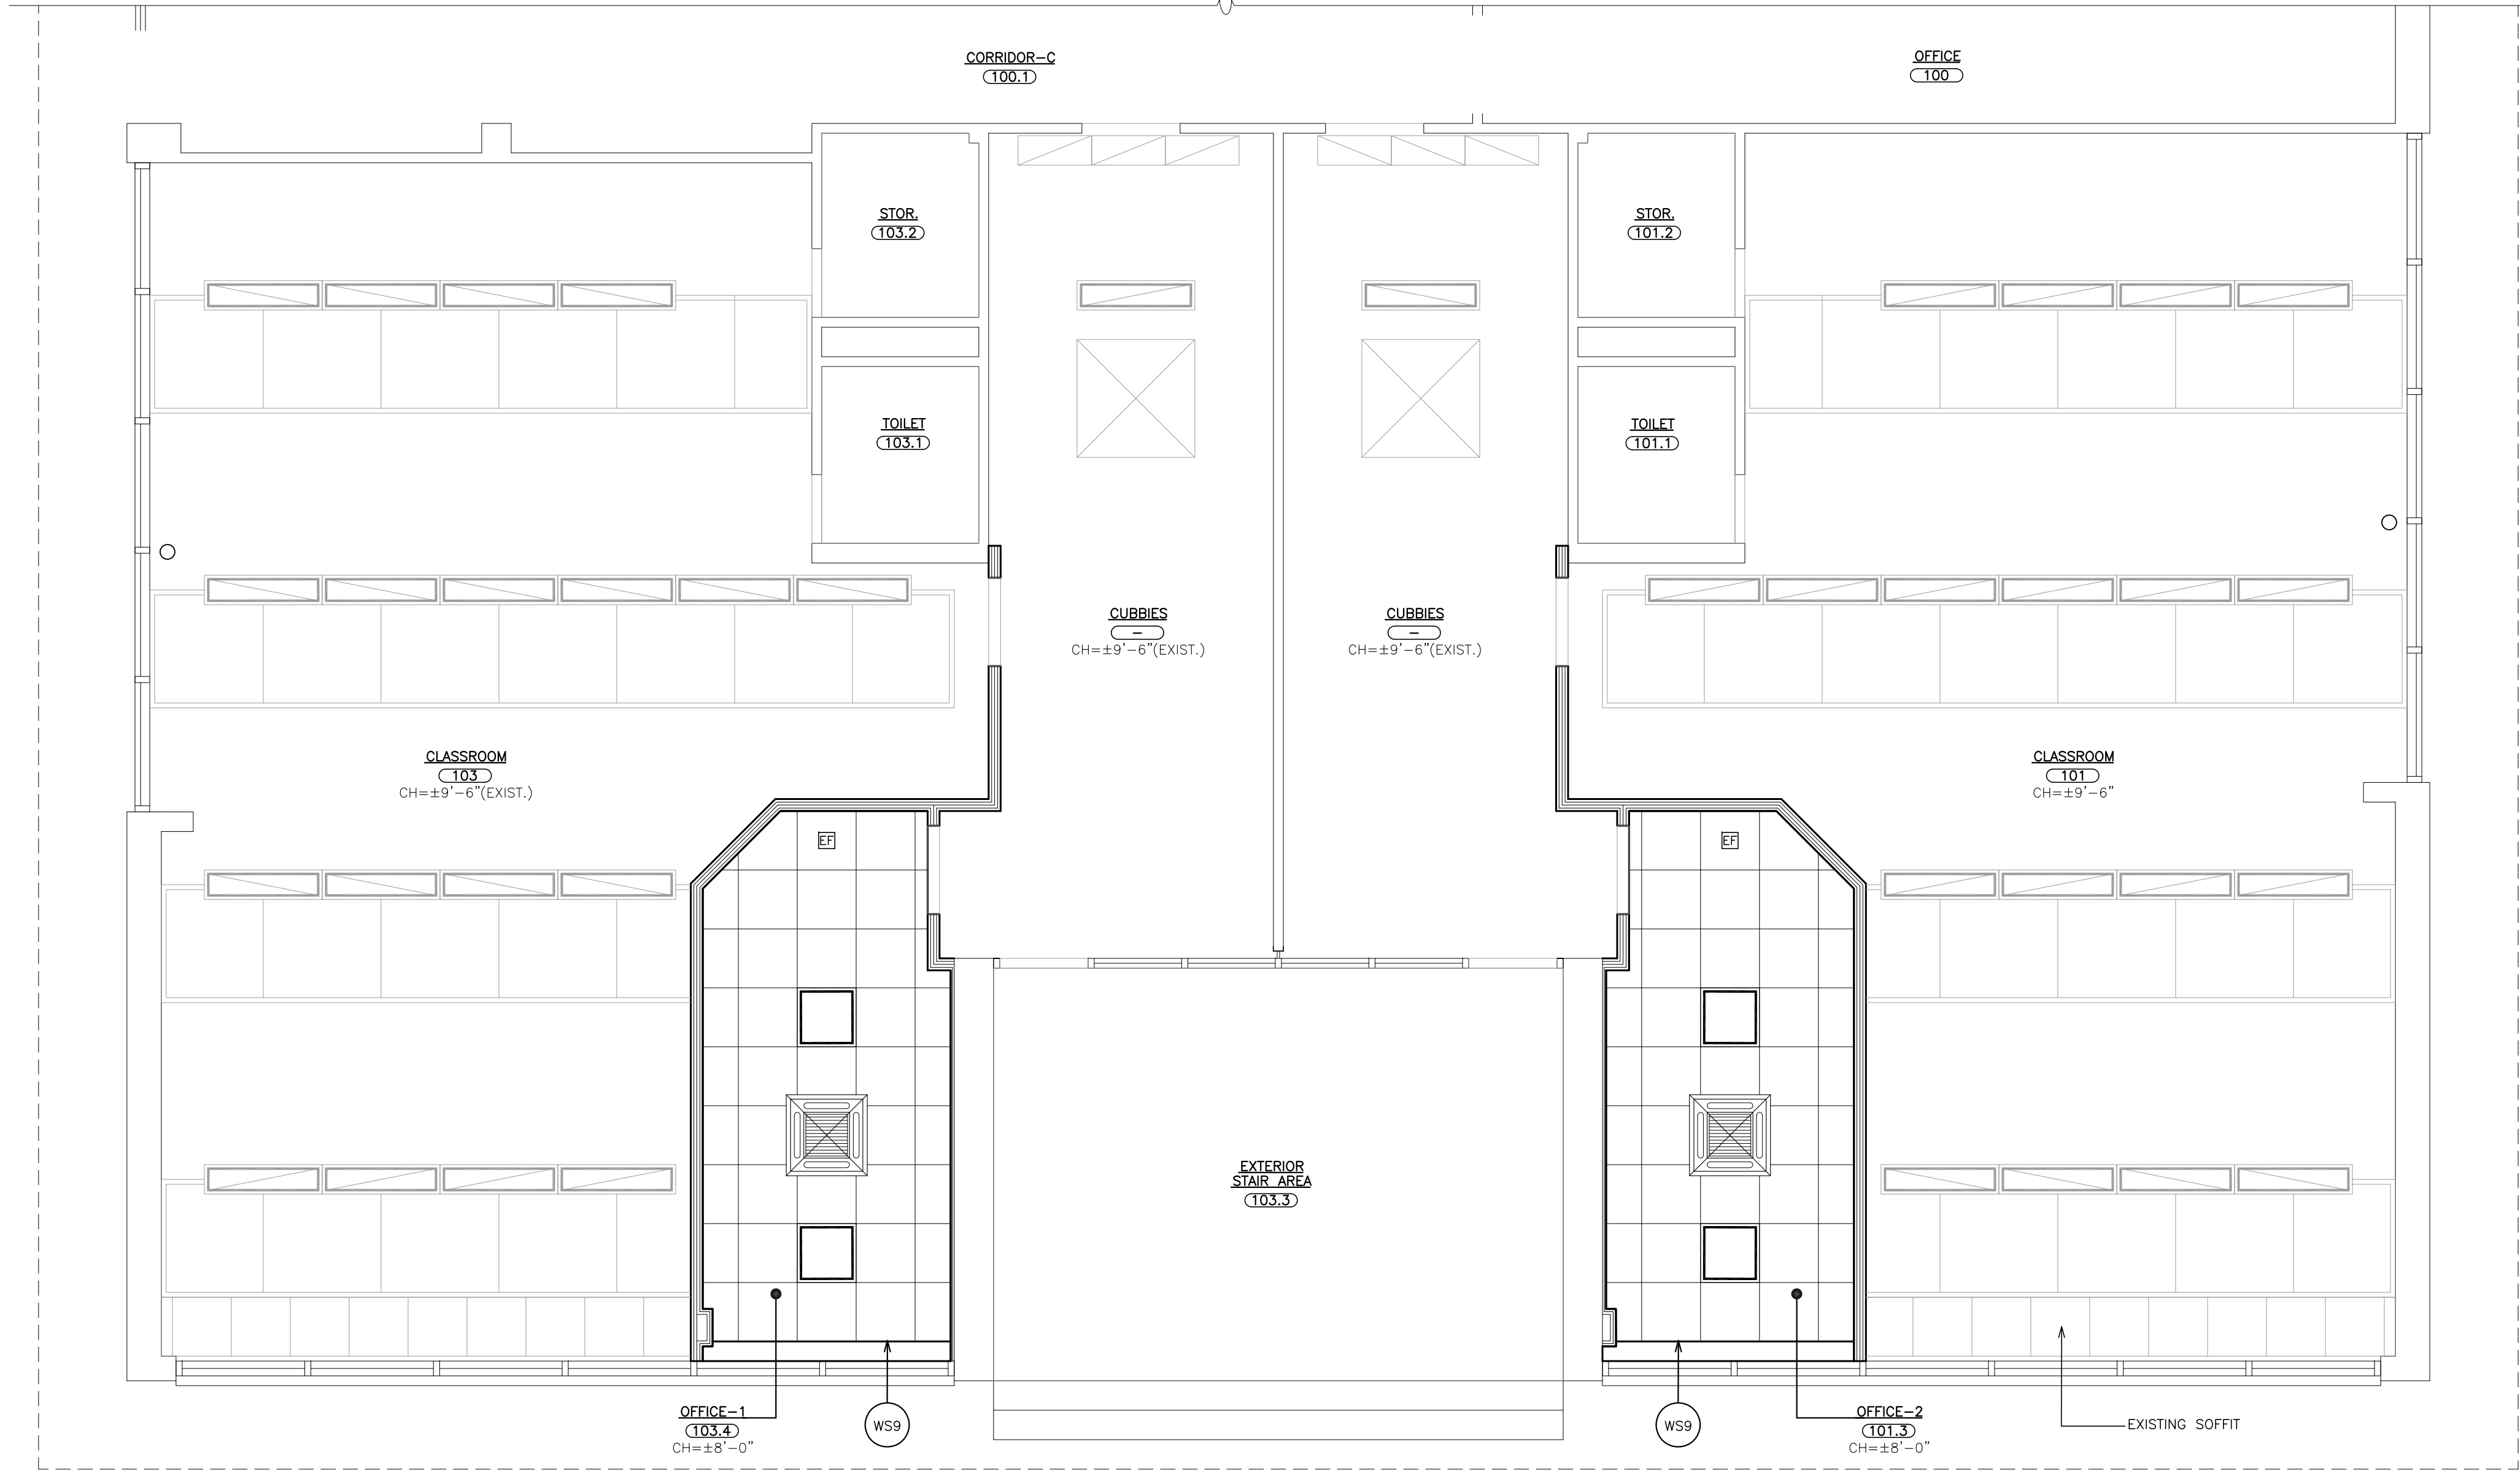- WS1 FIRE STOP ALL PENETRATIONS THROUGH CORRIDOR WALL.
- WS2 NEW FLOORING. REFER TO FINISH SCHEDULE.
- WS3 NEW CEILING PANELS IN EXISTING GRID. REFER TO FINISH SCHEDULE.
- WS4 COVER WINDOW PANEL WITH FINISH GRADE PLYWOOD AND PAINT. (FIELD VERIFY CONDITION AFTER REMOVAL OF PLANTER.)
- WS5 PAINT WINDOW POCKETS.
- WS6 INFILL OPENING IN WALL AFTER REMOVAL OF GRILLE WITH METAL STUDS AND (2) LAYERS OF 3/4" TYPE-X GYPSUM BOARD ON EACH SIDE. SKIM COAT ENTIRE OPENING TO MATCH EXISTING ADJACENT SURFACES.
- WS7 SCRAPE, PATCH, CLEAN, PRIME AND PAINT ALL WALLS IN AREA OF WORK, NEW AND EXISTING.
- WS8 PROVIDE NEW VOT TO REPLACE ABATED FLOOR TILE. MATCH EXISTING COLOR AND PATTERN. PROVIDE APPROXIMATELY A 24" WIDE STRIP.
- WS9 CONSTRUCT WINDOW POCKET OUT OF PRE-FINISHED METAL. ATTACH TO CEILING GRID. SEE DETAIL AT 9/ ASDO.
- WS10 LINE OF EXISTING DUCTWORK AND FAN TO REMAIN. COORDINATE WITH NEW WORK. PROVIDE GYPSUM BOARD SOFFIT TIGHT TO UNDERSIDE OF FAN SUPPORT.
- WS11 FURR EXISTING WALL WITH METAL STUDS AND GYPSUM BOARD TO ACCOMMODATE UTILITY LINES. MAINTAIN SUFFICIENT CLEARANCE FROM WINDOW HARDWARE FOR PROPER OPERATION.
- WS12 PATCH/ REPLACE EXISTING VOT AT REMOVED WALL CABINETS.
- WS13 PAINT EXISTING QUARTER ROUND AT FLOOR TO MATCH WALLS.
- WS14 SCRAPE, PATCH, SKIM COAT EXISTING EXPOSED PLASTER WALLS.
- WS15 TRIM/PRUNE TREE FOR INSTALLATION OF FENCE ENCLOSURE.
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- WS17 RE-GRADE SOIL LEVEL TO INSTALL CONDENSING UNIT AND CONCRETE PAVERS.
- WS18 INSTALL NEW CEILING SUSPENSION SYSTEM AND CEILING TILE TO MATCH EXISTING. SUPPORT FROM STRUCTURE.
- WS19 PAINT ENTIRE WALL MATCH EXISTING.

GENERAL CEILING NOTES

- ALL CEILING MOUNTED ITEMS (DETECTORS, GRILLS, ETC.) AND INDICATED ON THE MECHANICAL AND ELECTRICAL DRAWINGS. ALL ITEMS ARE TO BE CENTERED WITHIN THE CEILING TILES AND GRIDS. WHERE ITEMS ARE SHOWN ON ARCHITECTURAL DRAWINGS THEY DENOTE LOCATION AND LAYOUT WHERE PLACEMENT IS CRITICAL. THE ARCHITECTURAL DRAWINGS DO NOT REPRESENT COMPLETE SYSTEMS THAT ARE SHOWN ON OTHER DRAWINGS. REFER TO MECHANICAL AND ELECTRICAL DRAWINGS FOR ACCESS DOORS REQUIRED FOR ANY DEVICES WHICH MAY BE COVERED OVER DUE TO NEW CEILING AND SOFFIT WORK.
- THE CEILING GRID IS TO BE CENTERED IN ROOMS—TYPICAL UNLESS NOTED OTHERWISE.
- PAINT ALL NEW GYPSUM WALLBOARD SOFFITS AND CEILINGS.
- REFER TO FINISH SCHEDULE FOR ADDITIONAL INFORMATION.
- FIT CEILING TILES AND GRIDS AROUND VERTICAL PIPES THAT PASS THROUGH THE NEW CEILING.
- OWNER SHALL REMOVE AND RE-INSTALL WIFI RECEIVERS. COORDINATE
- NOT USED
- CEILING HEIGHTS INDICATED ARE EXISTING AND ARE TO BE FIELD VERIFIED BY CONTRACTOR. ALL NEW CEILING HEIGHTS ARE TO MATCH EXISTING UNLESS NOTED OTHERWISE.
- DIMENSIONS AND CONDITIONS OF EXISTING ITEMS ARE APPROXIMATE (NOT AS-BUILTS). CONTRACTOR SHALL FIELD VERIFY.

CEILING LEGEND

- 2'x2" RECESSED MOUNTED LIGHT FIXTURE
- 2'x4" RECESSED MOUNTED LIGHT FIXTURE
- RECESSED CAN LIGHT FIXTURE
- GYPSUM BOARD OR SOFFIT
- CEILING GRID STARTING POINT
- FIRE ALARM SMOKE DETECTOR
- CEILING SPEAKER
- EXHAUST FAN, SEE MECHANICAL DWGS.
- CEILING REGISTER. SIZE VARIES. SEE MECHANICAL DRAWINGS.
- HEAT PUMP DIFFUSER
- CEILING MOUNTED EXIT SIGN W/ DIRECTIONAL ARROW
- WALL MOUNTED EXIT SIGN W/ DIRECTIONAL ARROW
- WIRELESS ACCESS POINT
- OCCUPANCY SENSOR
- CEILING MOUNTED PROJECTOR
- RECESSED PROJECTOR SCREEN
- 2'x2" OR 2'x4" ACOUSTICAL CEILING TILE AND SUSPENSION SYSTEM

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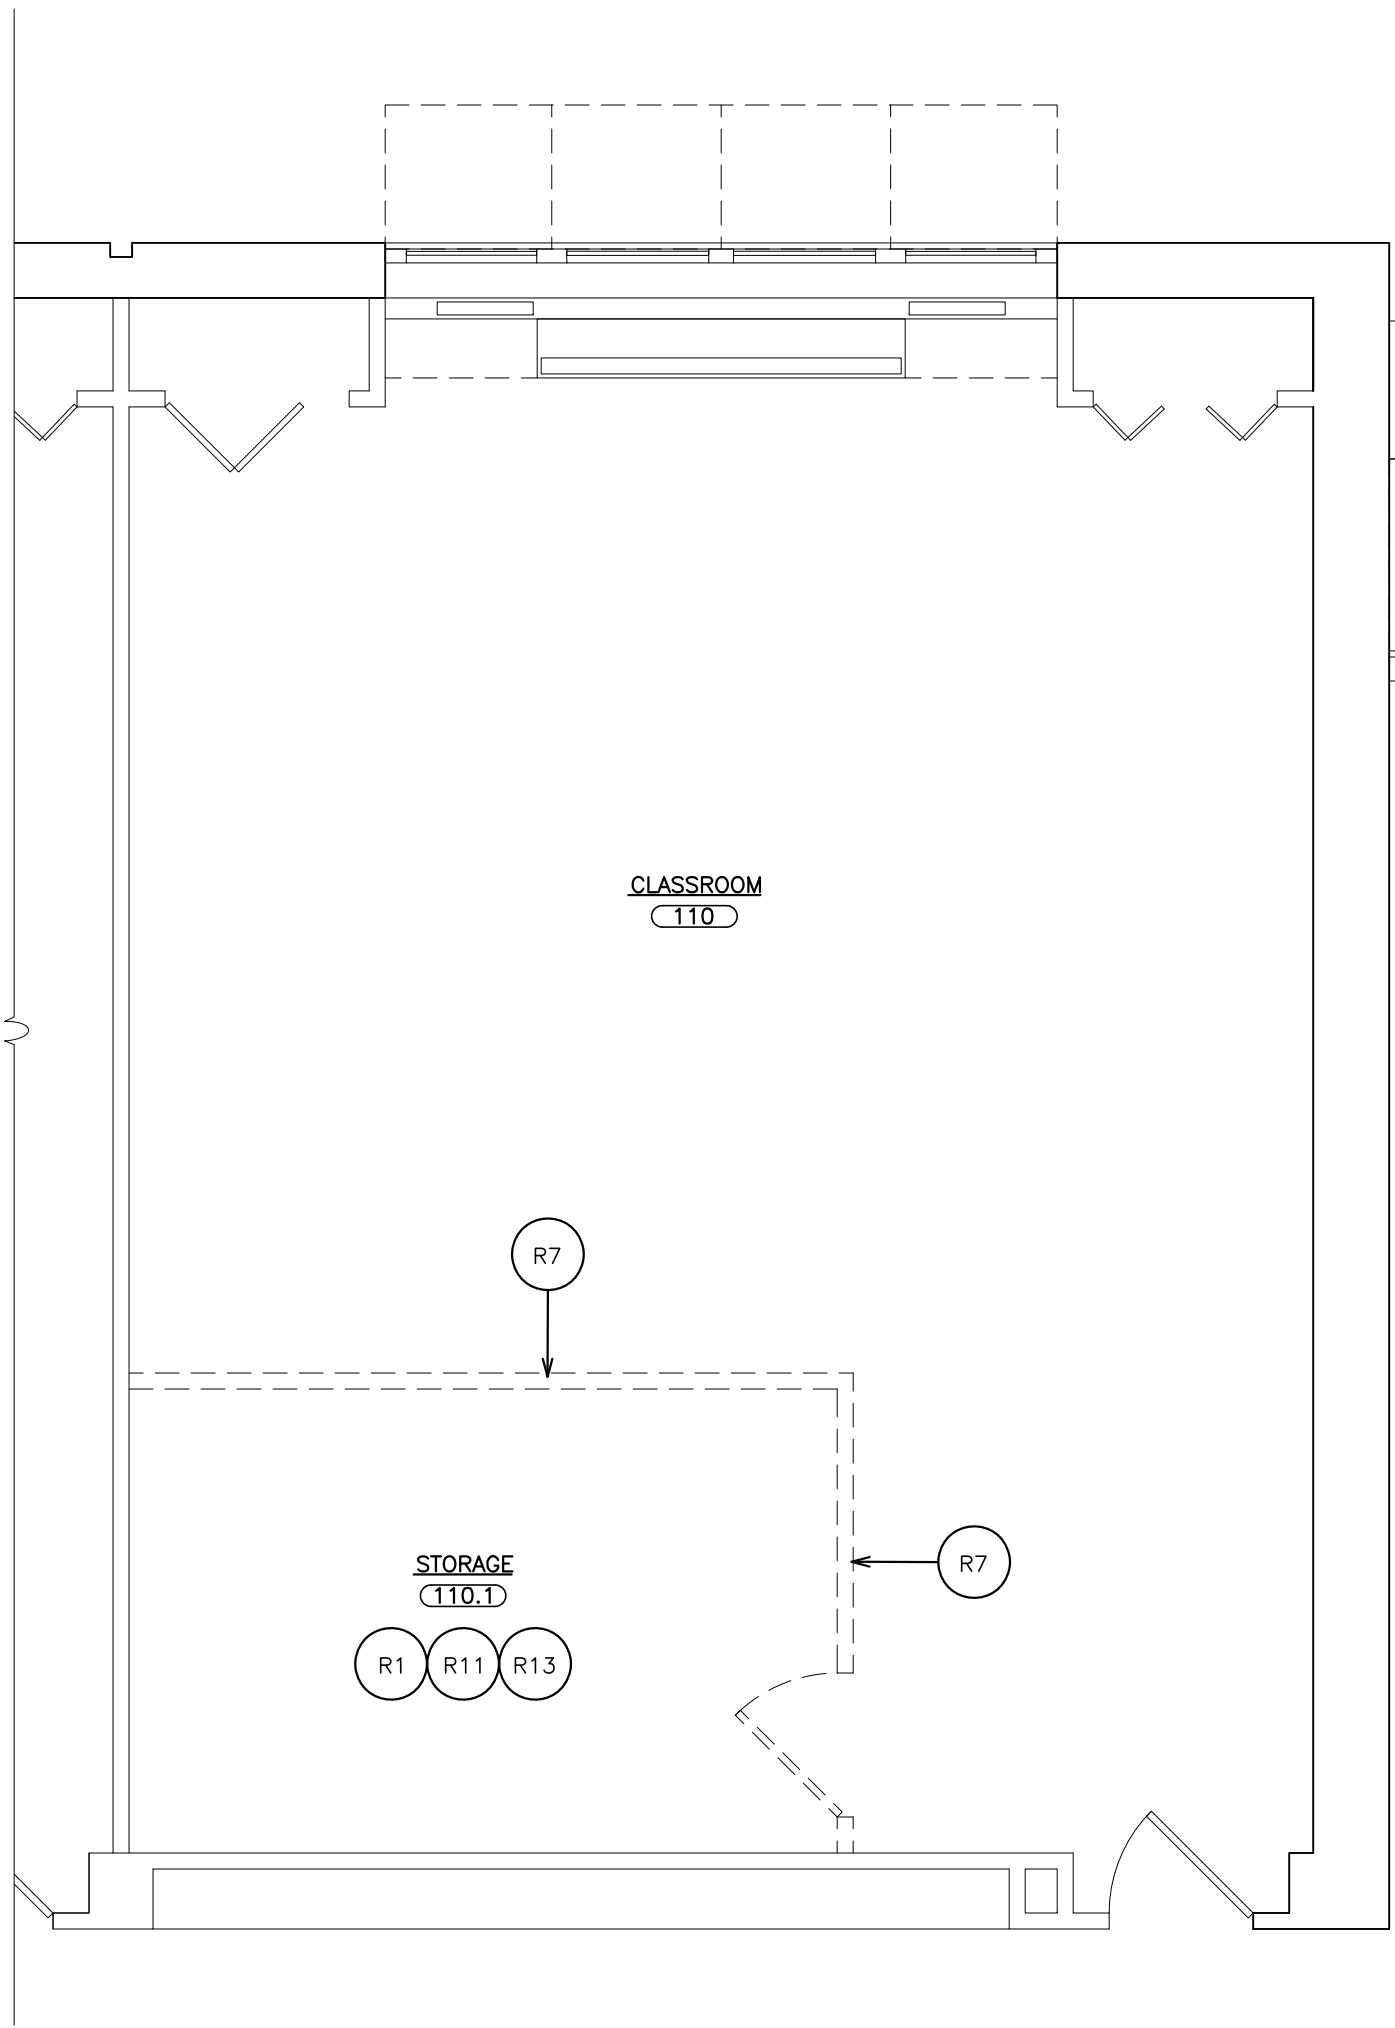
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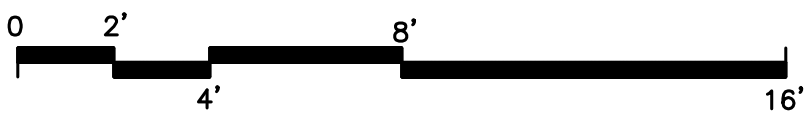
PROJECT
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KING STREET ELEMENTARY SCHOOL LIBRARY ALTERATIONS
JOHN F. KENNEDY ELEMENTARY SCHOOL OFFICE ALTERATIONS
PORT CHESTER MIDDLE SCHOOL CLASSROOM ALTERATIONS

DRAWING TITLE
JOHN F. KENNEDY PRIMARY SCHOOL
FIRST FLOOR PLAN


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EXISTING/ REMOVAL PLAN
1 SCALE: 1/4" = 1'-0"




REMOVAL NOTES:	
COORDINATE REMOVALS WITH ABATEMENT CONTRACTOR	
R1	COORDINATE REMOVALS WITH OWNER. OWNER SHALL REMOVE ALL LOOSE FURNITURE AND BOOKS.
R2	REMOVE EXISTING ACOUSTIC TILE AND SUSPENSION SYSTEM AS REQUIRED TO INSTALL MECHANICAL EQUIPMENT. REFER TO ABATEMENT DOCUMENTS FOR ADDITIONAL INFORMATION.
R3	REMOVE EXISTING RESILIENT TILE FLOOR AND ADHESIVE WITHIN NEW ROOM. PREPARE EXISTING CONCRETE SLAB AS SPECIFIED TO RECEIVE NEW FLOOR FINISH. SEE FINISH SCHEDULE FOR ADDITIONAL INFORMATION.
R4	SAVE EXISTING BLINDS FOR REINSTALLATION.
R5	EXISTING WAP TO BE REMOVED AND REINSTALLED BY OWNER.
R6	REMOVE EXISTING MASONRY PLANTER AND COMPONENTS IN IT'S ENTIRETY. PREPARE FLOOR SLAB TO RECEIVE NEW FLOOR FINISH. PATCH ENTIRE AREA WITH 3" CONCRETE IF REQUIRED.
R7	REMOVE EXISTING GYPSUM BOARD PARTITION AND DOOR. REFER TO ABATEMENT DOCUMENTS FOR REMOVAL OF FLOOR TILE.
R8	REMOVE EXISTING 24" X 48" CEILING TILE AND REPLACE WITH NEW.
R9	SAVE AND REMOVE EXISTING WINDOW SHADES FOR REINSTALLATION.
R10	REMOVE EXISTING WALL GRILLE PATCH OPENING EACH SIDE OF WALL.
R11	REMOVE EXISTING ACOUSTIC TILE AND SUSPENSION SYSTEM.
R12	REMOVE EXISTING SHELVING, CABINETRY AND RELATED ITEMS IN THEIR ENTIRETY. PATCH DISTURBED SURFACE TO MATCH EXISTING ADJACENT SURFACES.
R13	DISCONNECT AND REMOVE EXISTING FLUORESCENT LIGHT FIXTURES AND ELECTRIC OUTLETS AND SWITCHES. REFER TO ELECTRICAL DRAWINGS. PROVIDE NEW FIXTURES AS INDICATED.
R14	REMOVE EXISTING CHALK BOARDS AND RELATED TRIM GLUE AND ANCHORS IN THEIR ENTIRETY. CLEAN PATCH AND PREPARE SURFACES TO RECEIVE NEW FINISHES AS PER MANUFACTURER'S REQUIREMENTS. SEE FINISH SCHEDULE REFER TO ABATEMENT DRAWINGS FOR ADDITIONAL INFORMATION.
R15	REMOVE EXISTING SINK BY MC. REFER TO MECHANICAL DRAWINGS.
R16	SALVAGE (1) SECTION OF EXISTING FREESTANDING SHELVING AND CABINETRY. RELOCATE TO ROOM 200A. CONFIRM WITH OWNER IF (2) REMAINING CABINET SECTIONS SHALL BE SALVAGED.
R17	REFER TO ASBESTOS DOCUMENTS FOR ADDITIONAL INFORMATION.
R18	SALVAGE EXISTING HAND SANITIZERS AND REINSTALL PER OWNER'S DIRECTION.
R19	REMOVE ACT SOFFIT. FULL WIDTH OF NEW ROOM. RE-SUPPORT AS REQUIRED.
R20	OWNER TO RELOCATE EXISTING PLANTER.



PORT CHESTER MIDDLE SCHOOL
PROPOSED PLAN
2 SCALE: 1/4" = 1'-0"

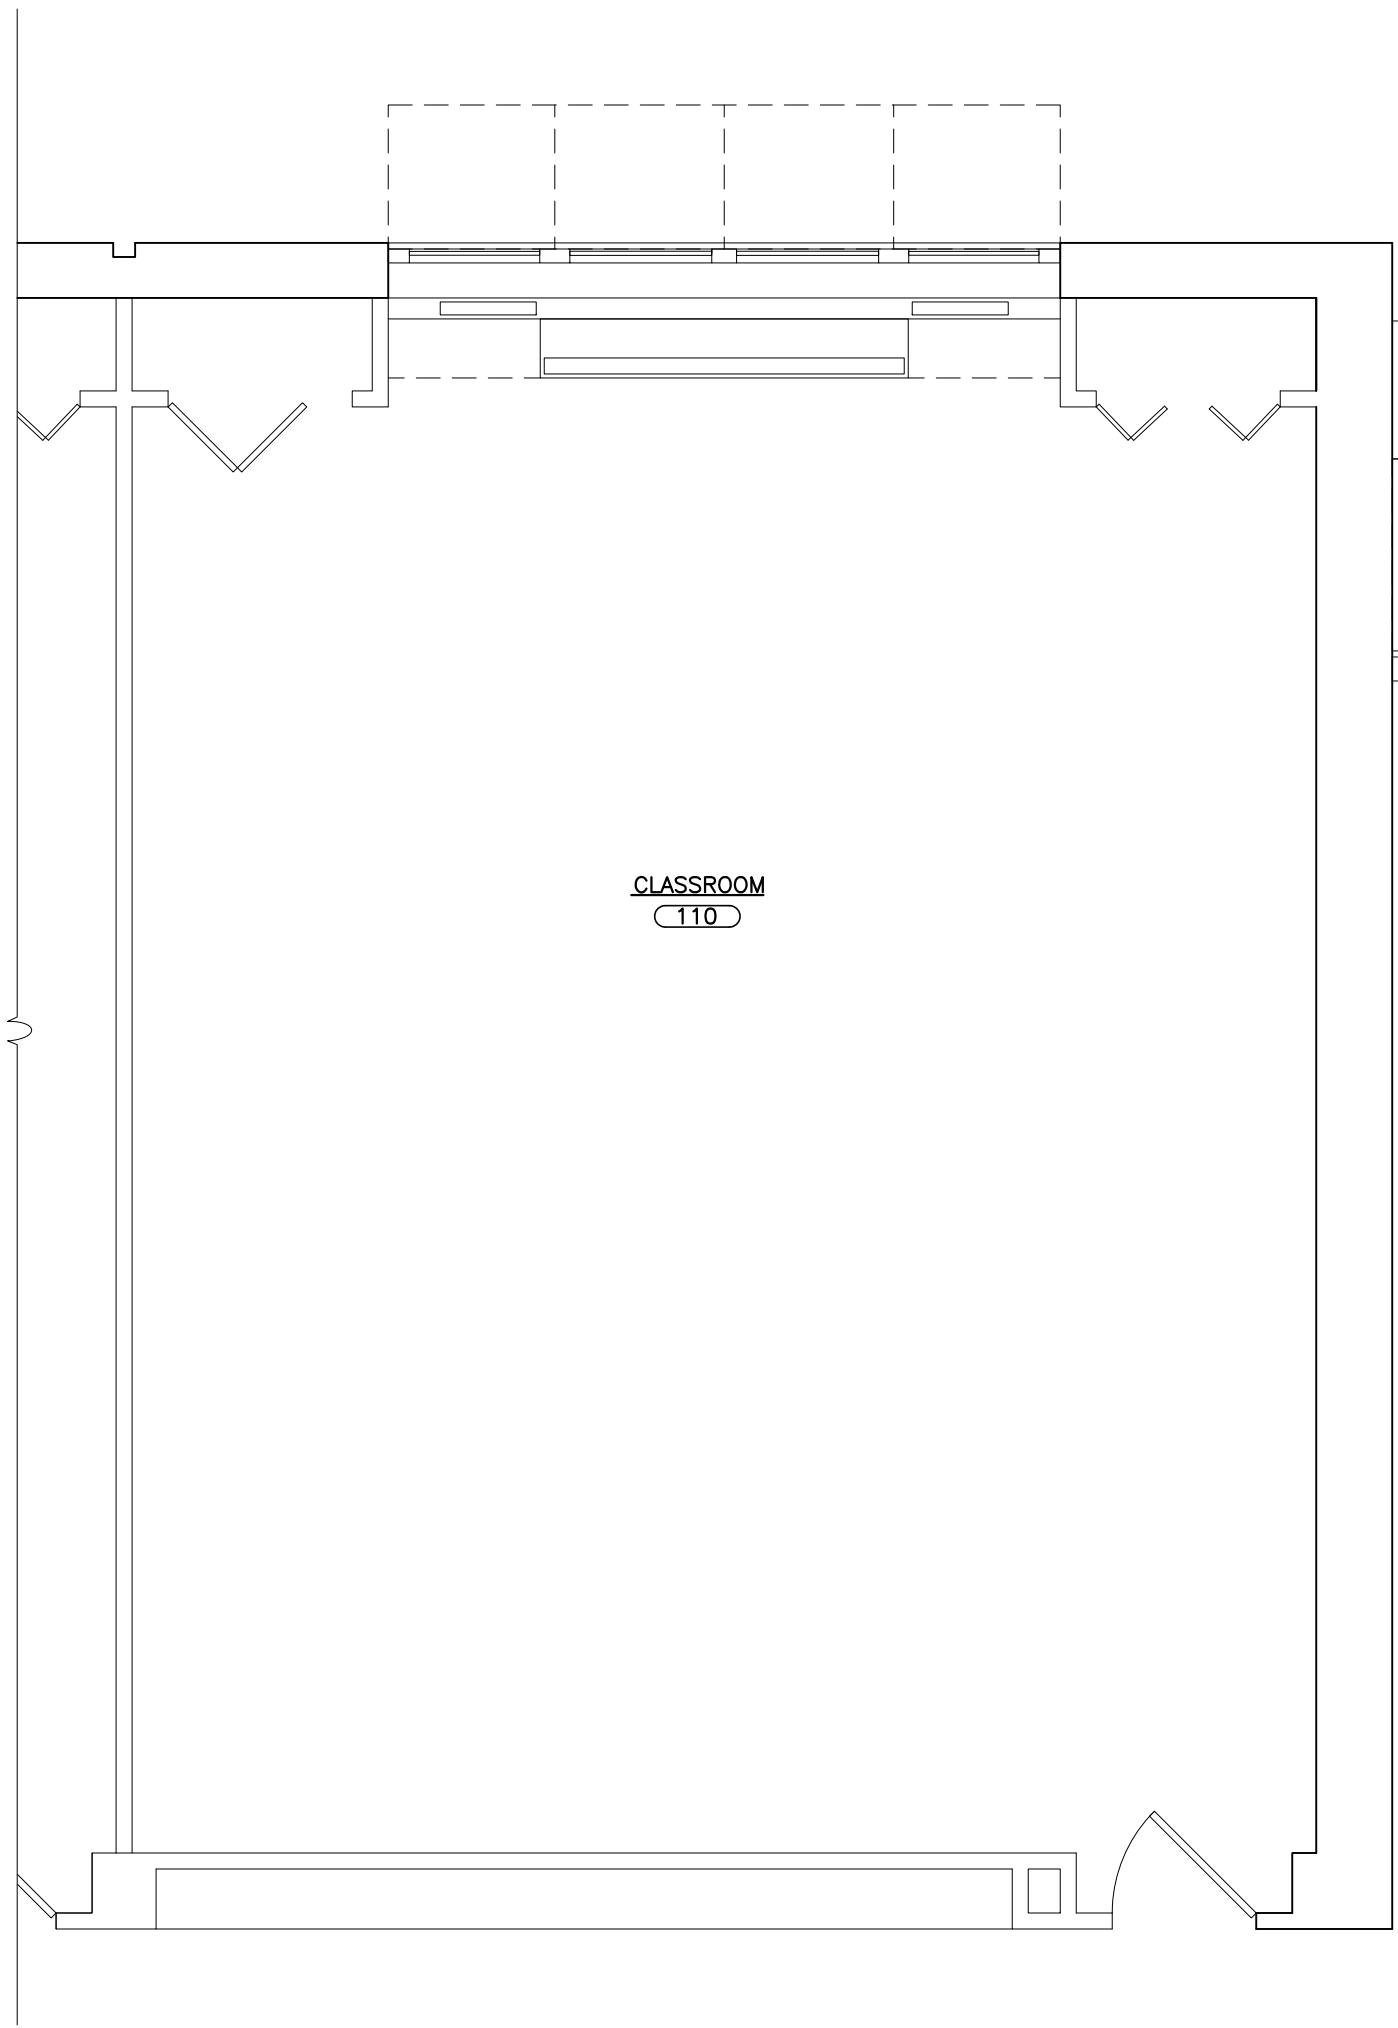
WORKSCOPE NOTES	
WS1	FIRE STOP ALL PENETRATIONS THROUGH CORRIDOR WALL.
WS2	NEW FLOORING. REFER TO FINISH SCHEDULE.
WS3	NEW CEILING PANELS IN EXISTING GRID. REFER TO FINISH SCHEDULE.
WS4	COVER WINDOW PANEL WITH FINISH GRADE PLYWOOD AND PAINT. (FIELD VERIFY CONDITION AFTER REMOVAL OF PLANTER.)
WS5	PAINT WINDOW POCKETS.
WS6	INFILL OPENING IN WALL AFTER REMOVAL OF GRILLE WITH METAL STUDS AND (2) LAYERS OF 5/8" TYPE-X GYPSUM BOARD ON EACH SIDE. SKIM COAT ENTIRE OPENING TO MATCH EXISTING ADJACENT SURFACES.
WS7	SCRAPE, PATCH, CLEAN, PRIME AND PAINT ALL WALLS IN AREA OF WORK, NEW AND EXISTING.
WS8	PROVIDE NEW VCT TO REPLACE ABATED FLOOR TILE. MATCH EXISTING COLOR AND PATTERN. PROVIDE APPROXIMATELY A 24" WIDE STRIP.
WS9	CONSTRUCT WINDOW POCKET OUT OF PRE-FINISHED METAL. ATTACH TO CEILING GRID. SEE DETAIL AT 9/ A500.
WS10	LINE OF EXISTING DUCTWORK AND FAN TO REMAIN. COORDINATE WITH NEW WORK. PROVIDE GYPSUM BOARD SOFFIT TIGHT TO UNDERSIDE OF FAN SUPPORT.
WS11	FURR EXISTING WALL WITH METAL STUDS AND GYPSUM BOARD TO ACCOMMODATE UTILITY LINES. MAINTAIN SUFFICIENT CLEARANCE FROM WINDOW HARDWARE FOR PROPER OPERATION.
WS12	PATCH/ REPLACE EXISTING VCT AT REMOVED WALL CABINETS.
WS13	PAINT EXISTING QUARTER ROUND AT FLOOR TO MATCH WALLS.
WS14	SCRAPE, PATCH, SKIM COAT EXISTING EXPOSED PLASTER WALLS.
WS15	TRIM/PRUNE TREE FOR INSTALLATION OF FENCE ENCLOSURE.
WS16	REPOSITION EACH WINDOW BLIND TO ALLOW INSTALLATION OF NEW PARTITION AT EXISTING WINDOW MULLION.
WS17	RE-GRADE SOIL LEVEL TO INSTALL CONDENSING UNIT AND CONCRETE PAVERS.
WS18	INSTALL NEW CEILING SUSPENSION SYSTEM AND CEILING TILE TO MATCH EXISTING. SUPPORT FROM STRUCTURE.
WS19	PAINT ENTIRE WALL MATCH EXISTING.

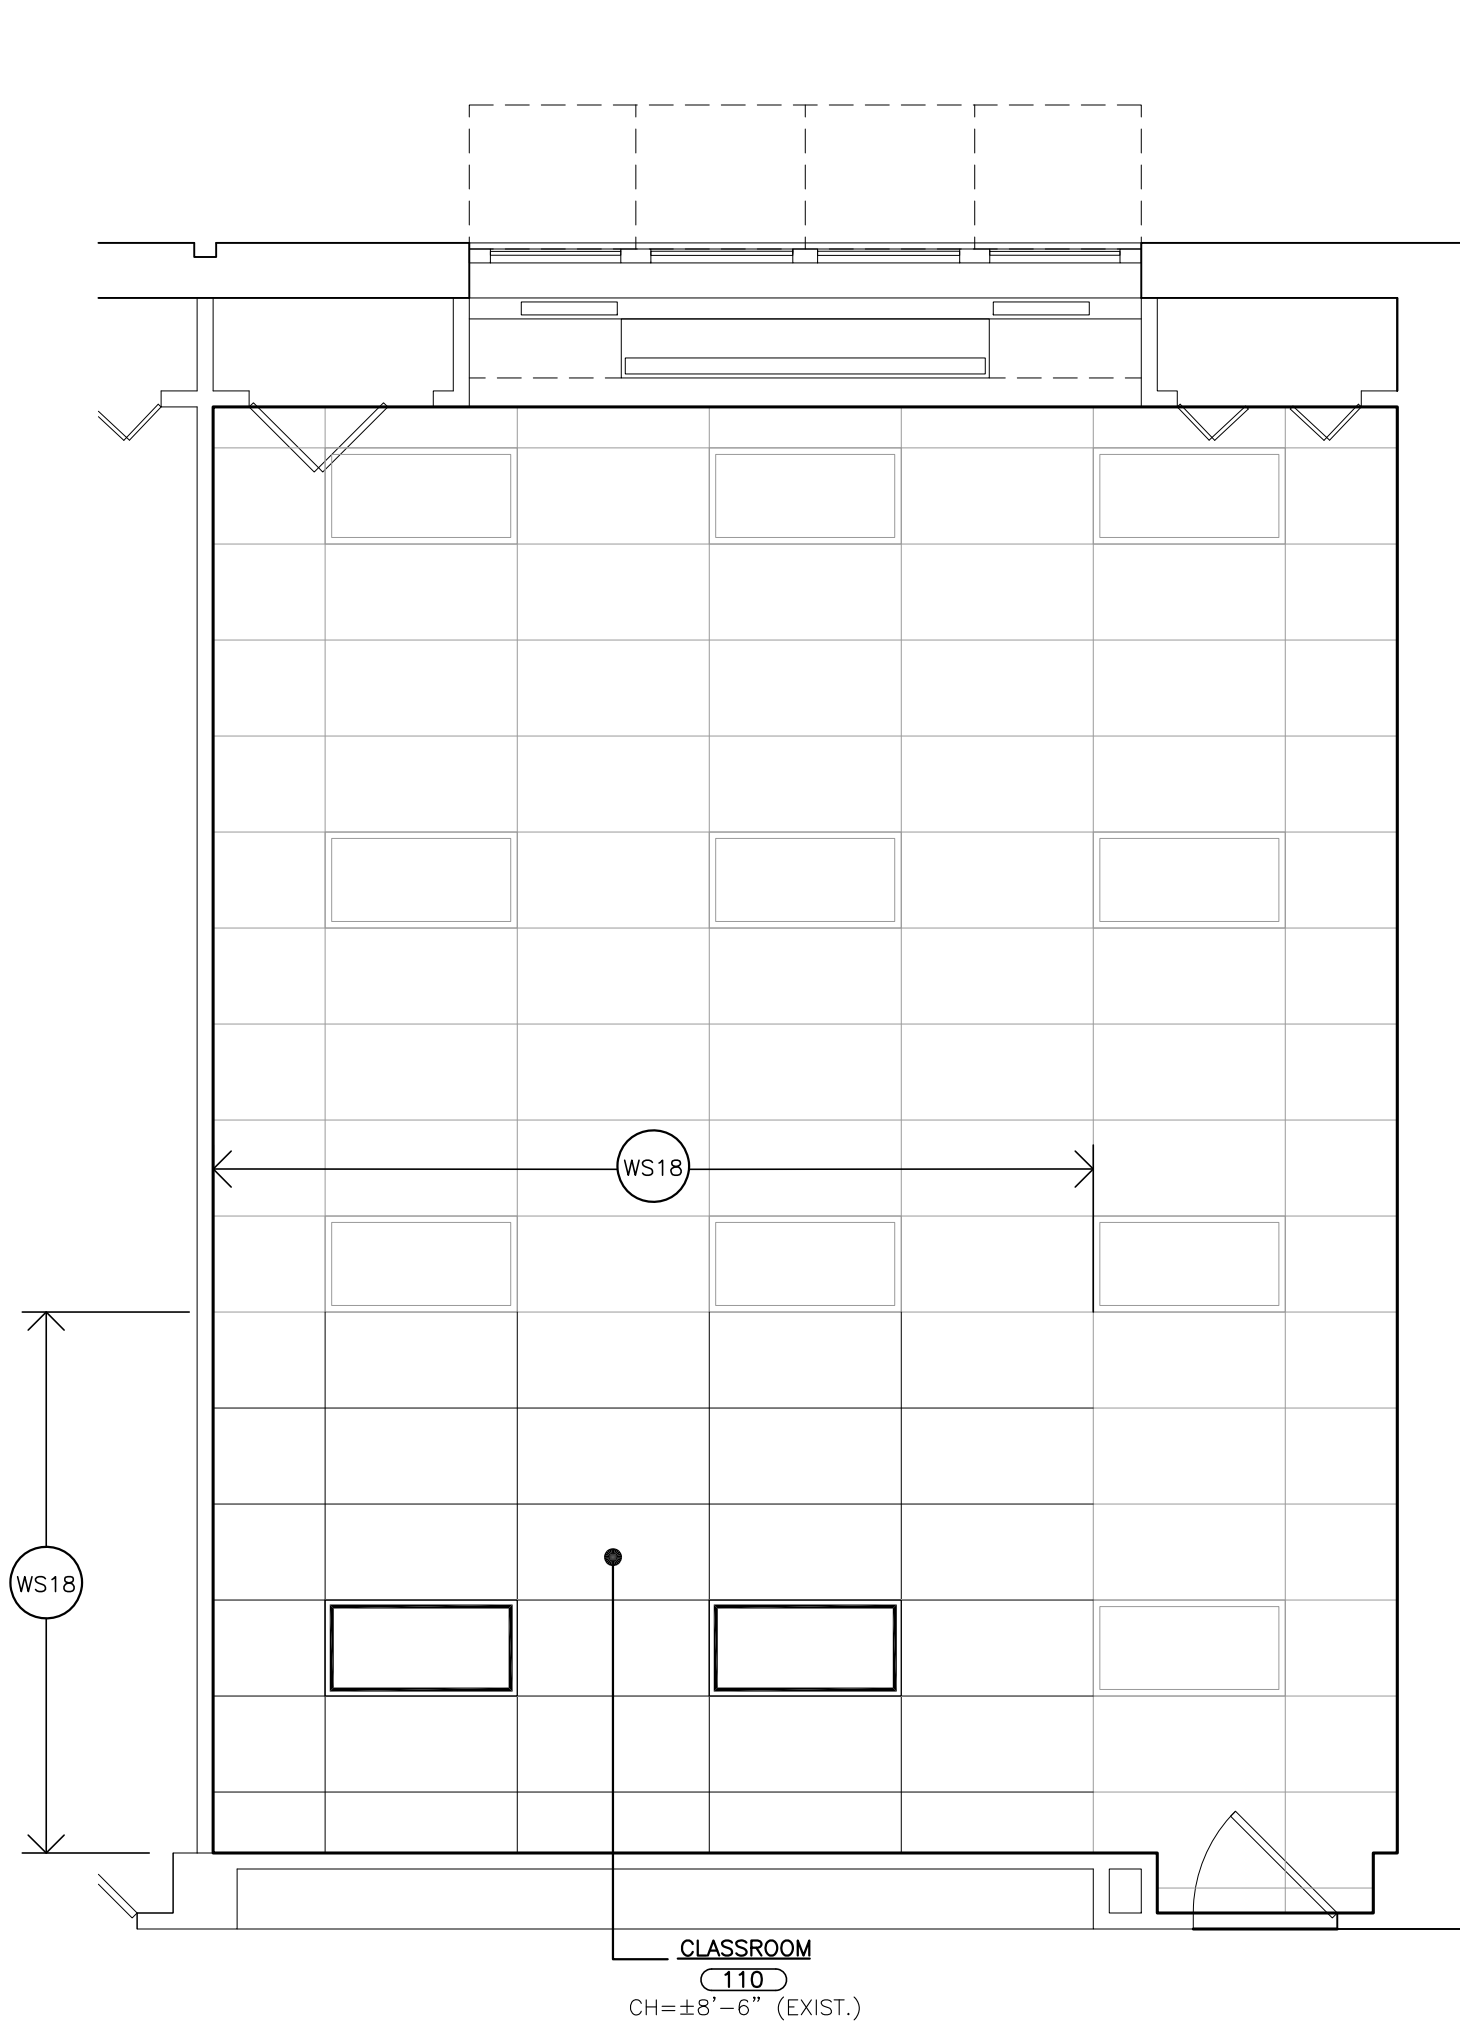

PORT CHESTER MIDDLE SCHOOL
REFLECTED CEILING PLAN
3 SCALE: 1/4" = 1'-0"

GENERAL CEILING NOTES	
1.	ALL CEILING MOUNTED ITEMS (DETECTORS, GRILLS, ETC.) AND INDICATED ON THE MECHANICAL AND ELECTRICAL DRAWINGS. ALL ITEMS ARE TO BE CENTERED WITHIN THE CEILING TILES AND GRIDS. WHERE ITEMS ARE SHOWN ON ARCHITECTURAL DRAWINGS THEY DENOTE LOCATION AND LAYOUT WHERE PLACEMENT IS CRITICAL. THE ARCHITECTURAL DRAWINGS DO NOT REPRESENT COMPLETE SYSTEMS THAT ARE SHOWN ON OTHER DRAWINGS. REFER TO MECHANICAL AND ELECTRICAL DRAWINGS FOR ACCESS DOORS REQUIRED FOR ANY DEVICES WHICH MAY BE COVERED OVER DUE TO NEW CEILING AND SOFFIT WORK.
2.	THE CEILING GRID IS TO BE CENTERED IN ROOMS-TYPICAL UNLESS NOTED OTHERWISE.
3.	PAINT ALL NEW GYPSUM WALLBOARD SOFFITS AND CEILINGS.
4.	REFER TO FINISH SCHEDULE FOR ADDITIONAL INFORMATION.
5.	FIT CEILING TILES AND GRIDS AROUND VERTICAL PIPES THAT PASS THROUGH THE NEW CEILING.
6.	OWNER SHALL REMOVE AND RE-INSTALL WIFI RECEIVERS. COORDINATE
7.	NOT USED
8.	CEILING HEIGHTS INDICATED ARE EXISTING AND ARE TO BE FIELD VERIFIED BY CONTRACTOR. ALL NEW CEILING HEIGHTS ARE TO MATCH EXISTING UNLESS NOTED OTHERWISE.
9.	DIMENSIONS AND CONDITIONS OF EXISTING ITEMS ARE APPROXIMATE. (NOT AS-BUILTS). CONTRACTOR SHALL FIELD VERIFY.

CEILING LEGEND	
	2'x2' RECESSED MOUNTED LIGHT FIXTURE
	2'x4' RECESSED MOUNTED LIGHT FIXTURE
	RECESSED CAN LIGHT FIXTURE
	GYPSUM BOARD OR SOFFIT
	CEILING GRID STARTING POINT
	FIRE ALARM SMOKE DETECTOR
	CEILING SPEAKER
	EXHAUST FAN, SEE MECHANICAL DWGS.
	CEILING REGISTER. SIZE VARIES. SEE MECHANICAL DRAWINGS.
	CEILING DIFFUSER. SIZE VARIES. SEE MECHANICAL DRAWINGS.
	HEAT PUMP DIFFUSER
	CEILING MOUNTED EXIT SIGN W/ DIRECTIONAL ARROW
	WALL MOUNTED EXIT SIGN W/ DIRECTIONAL ARROW
	WIRELESS ACCESS POINT
	OCCUPANCY SENSOR
	CEILING MOUNTED PROJECTOR
	RECESSED PROJECTOR SCREEN
	2'x2' OR 2'x4' ACOUSTICAL CEILING TILE AND SUSPENSION SYSTEM

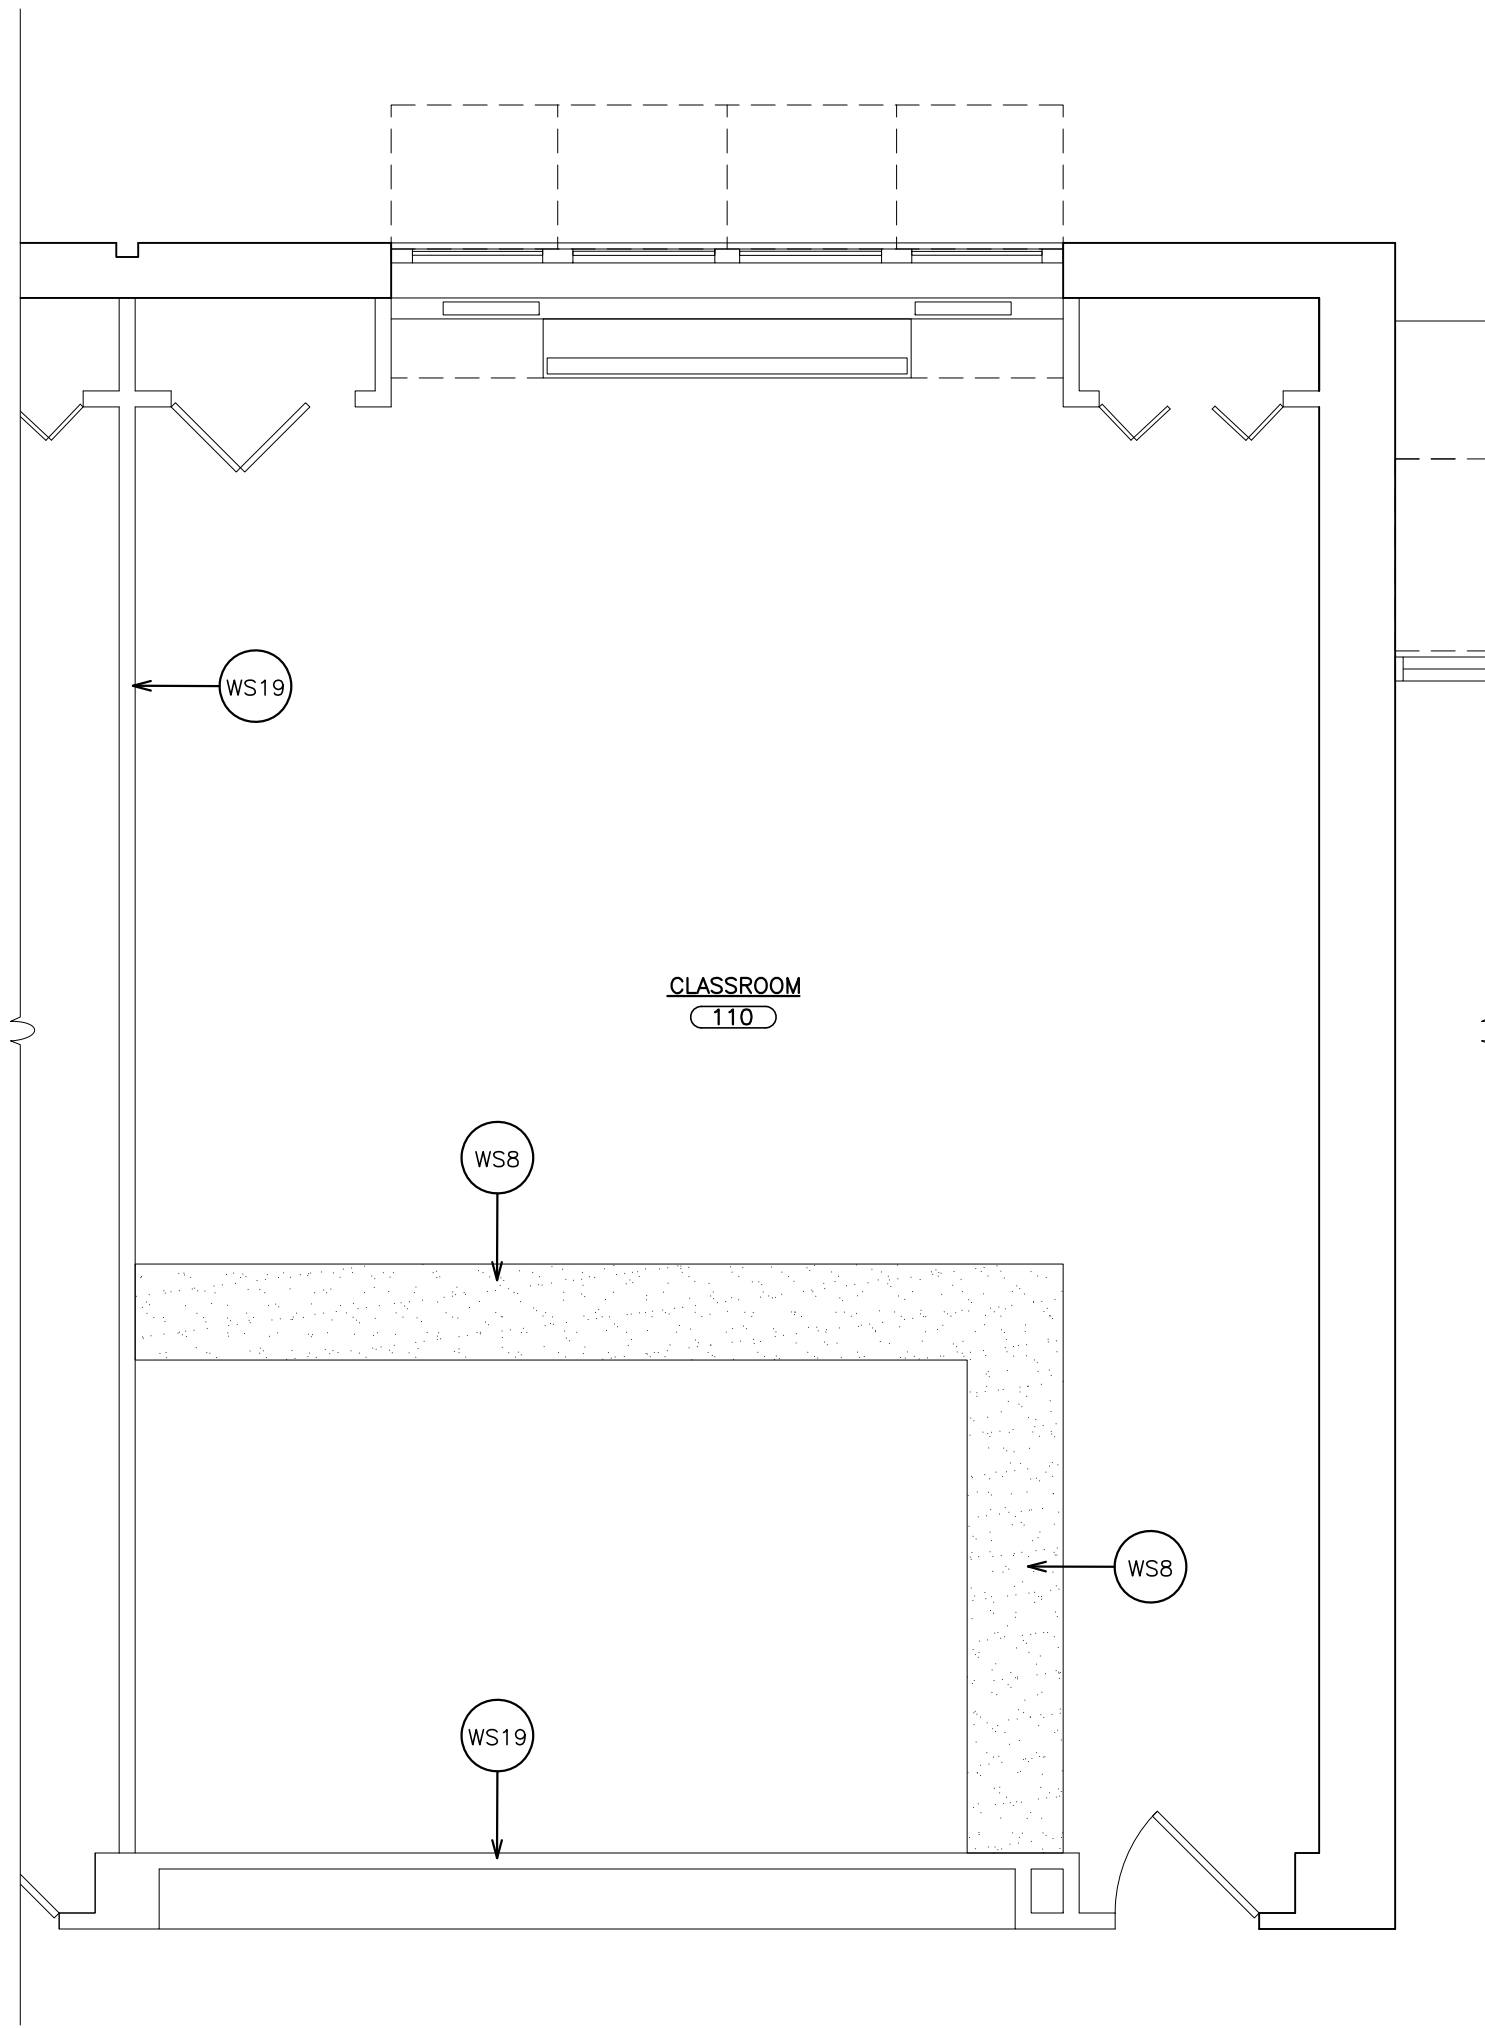

PORT CHESTER MIDDLE SCHOOL
FINISH FLOOR PLAN
4 SCALE: 1/4" = 1'-0"

PROJECT: PORT CHESTER - RYE UNION FREE SCHOOL DISTRICT
1000 STREET ELEMENTARY SCHOOL LIBRARY ALTERATIONS
JOHN KENNEDY ELEMENTARY SCHOOL OFFICE ALTERATIONS
PORT CHESTER MIDDLE SCHOOL CLASSROOM ALTERATIONS

DRAWING TITLE
PORT CHESTER MIDDLE SCHOOL
FIRST FLOOR PLAN

06-08-2021
DATE

B I O
ISSUED TO

SHEET SIZE
30"x42"

DRAWING NO.
A-106

SCALE
AS NOTED

FILE NO.
21430.00

DRAWN BY
F & D

FILE NO.
21430.00


FULLER
D'ANGELO
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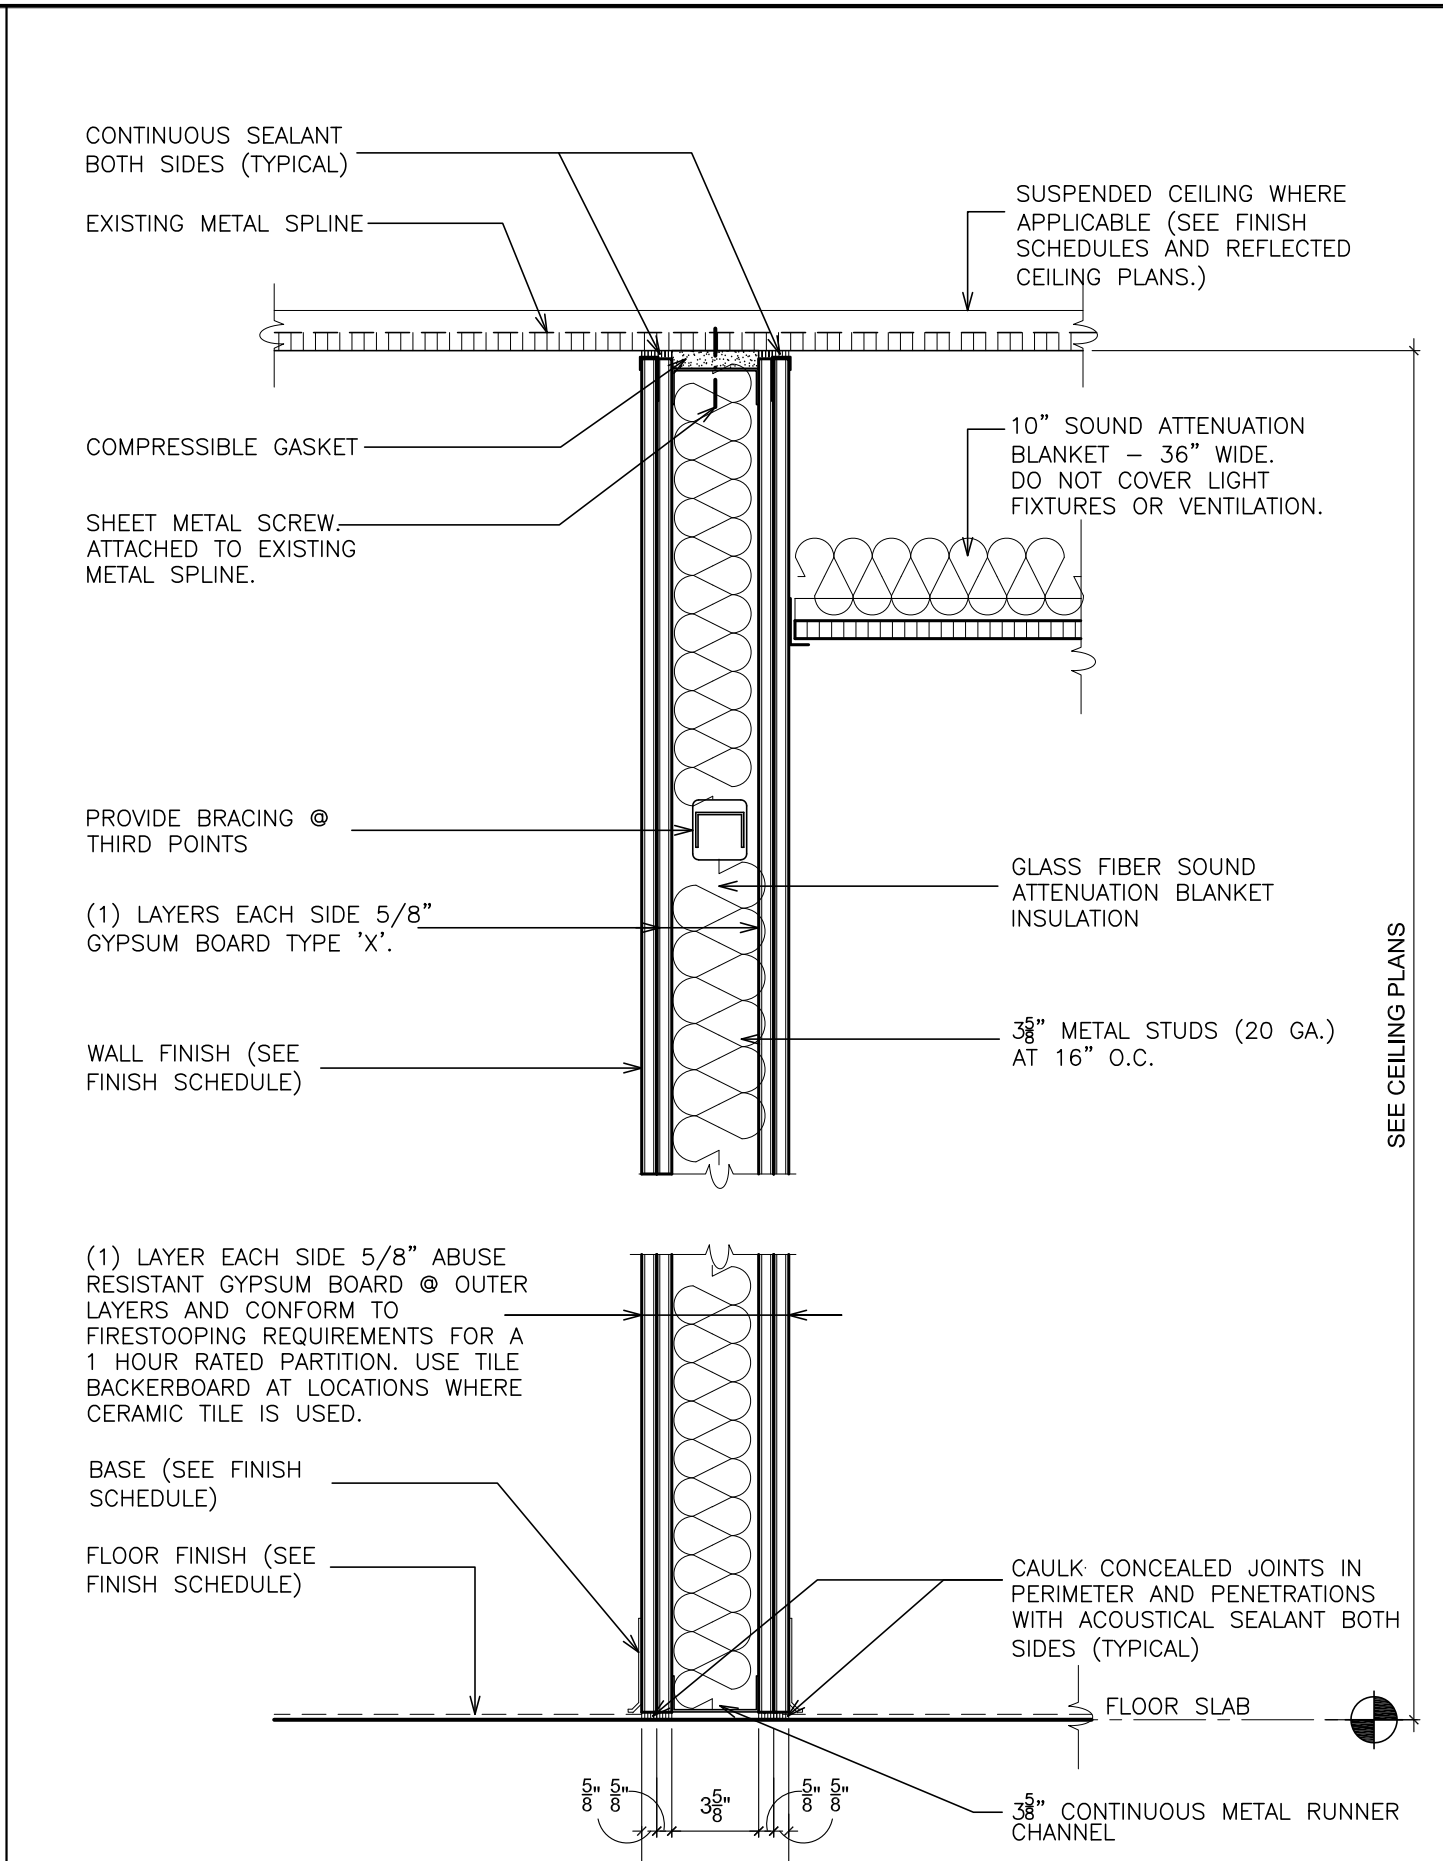
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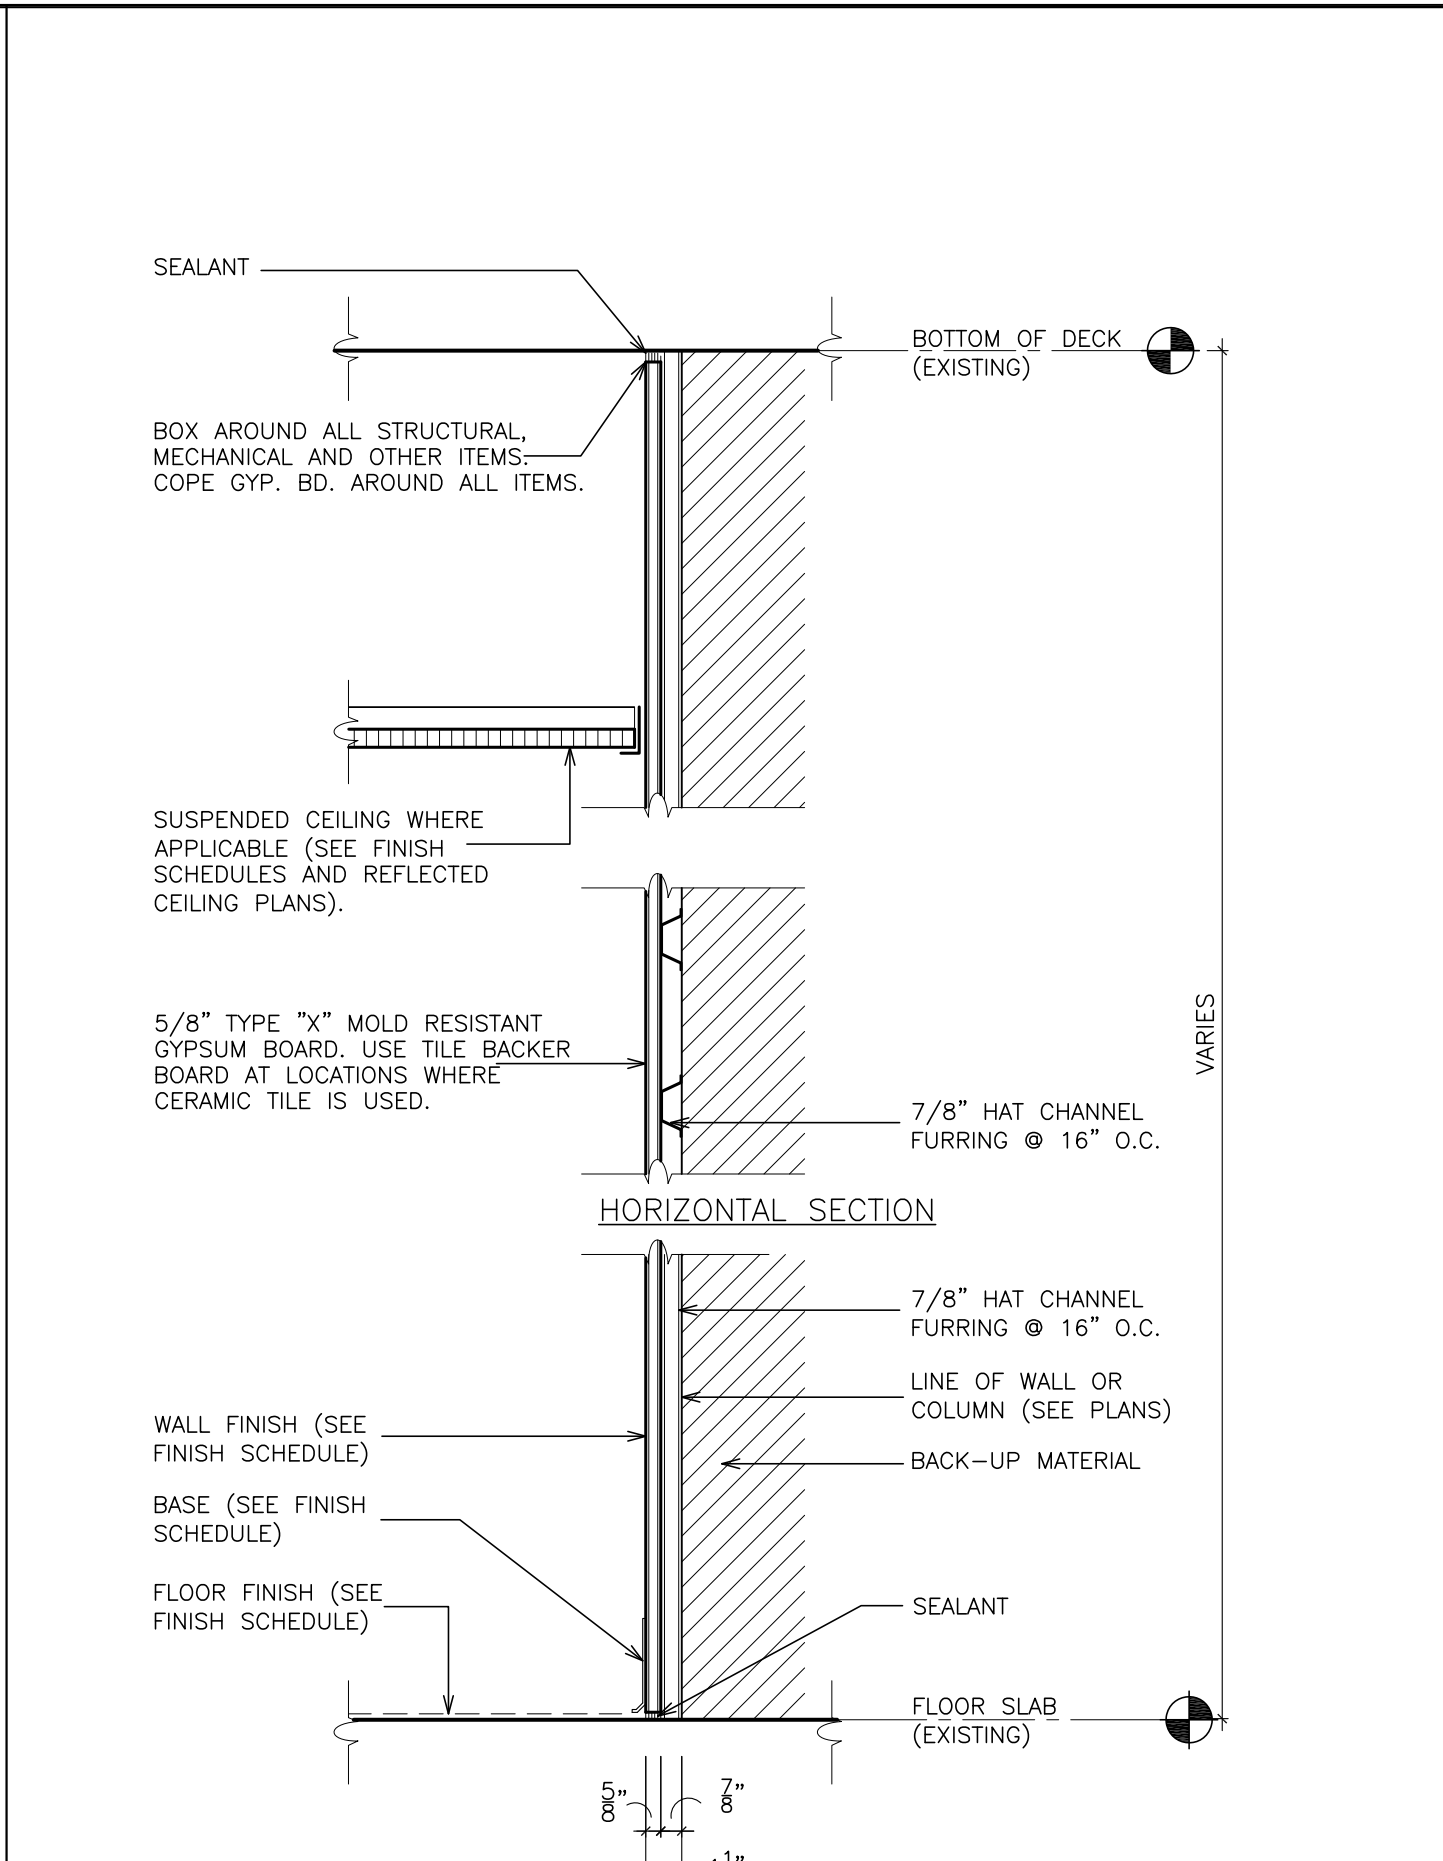


1 METAL STUD WALL
FIRE RATING - 1 HOUR (UL 411)

1A METAL STUD WALL
FIRE RATING - 0 HOUR




2 METAL STUD WALL
FIRE RATING - 1 HOUR (UL 411)

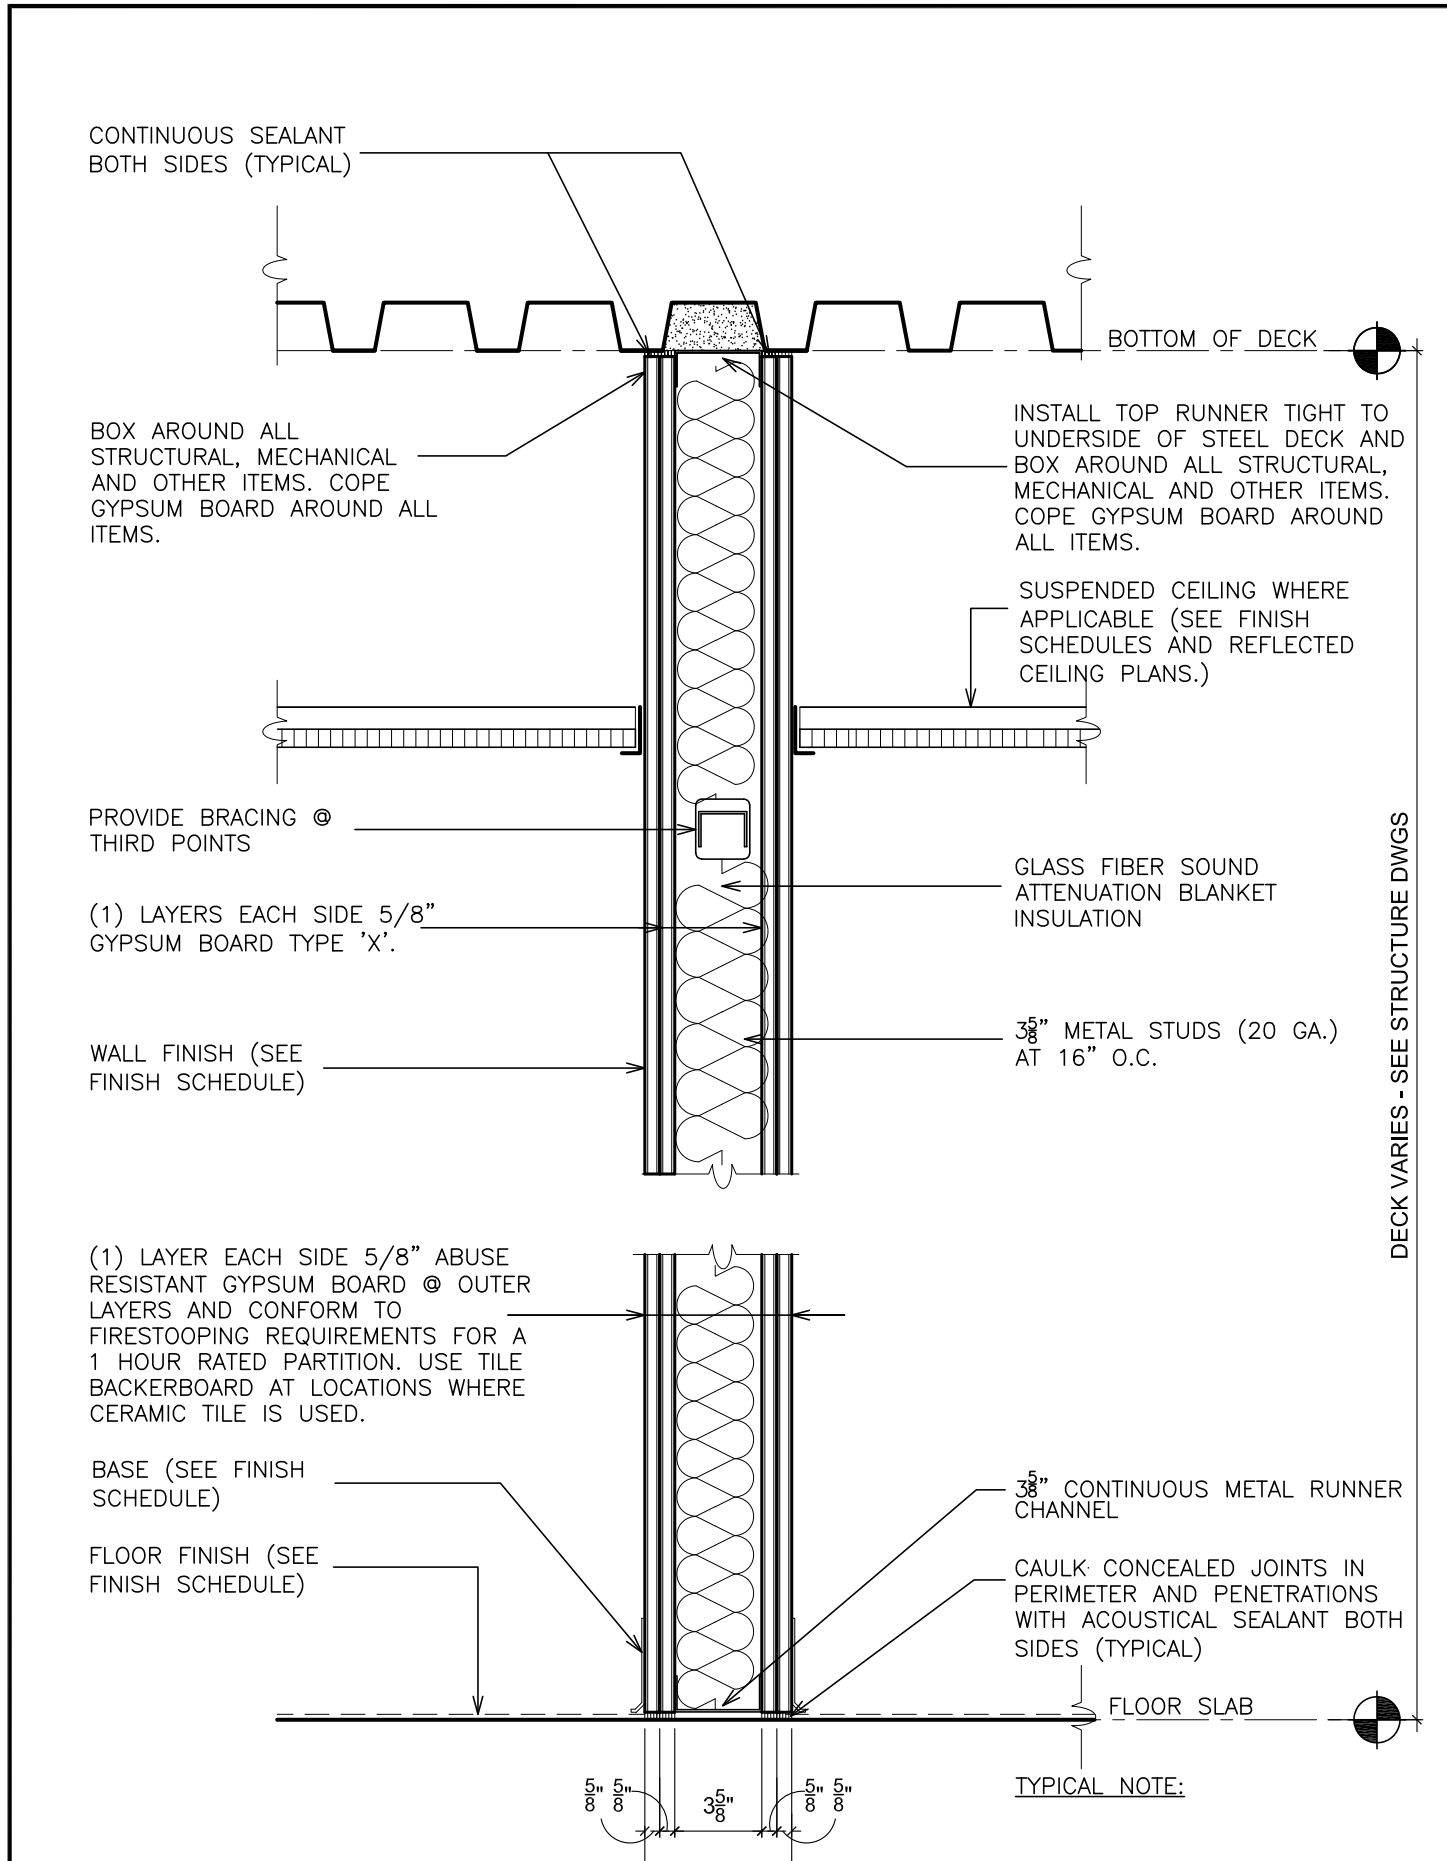


3 METAL STUD FURRING
FIRE RATING - 0 HOUR


- GENERAL NOTES:** (ALL PARTITION TYPES)
- PARTITION TYPES ARE SHOWN ON FLOOR PLANS. REFER TO DRAWING A-510 FOR TYPICAL DETAILS.
 - REFER TO FINISH SCHEDULE FOR ALL FINISHES.
 - PARTITIONS SHALL BE CONSTRUCTED FULL HEIGHT, EXTEND TO BOTTOM ON CONCRETE OR METAL DECK ABOVE AND SHALL BE SEALED AIRTIGHT TO RESIST THE PASSAGE OF SMOKE (UNLESS OTHERWISE NOTED)
 - PARTITIONS SHALL BE CONSTRUCTED USING TYPE "X" GYPSUM BOARD.
 - INTERIOR GYPSUM BOARD PARTITIONS SHALL HAVE SOUND ATTENUATION INSULATION EQUAL TO METAL STUD THICKNESS FOR FULL HEIGHT (UNLESS OTHERWISE NOTED)
 - FIRE RATED WALL ASSEMBLIES SHALL BE IN ACCORDANCE WITH DESIGNATED FIRE TEST AND MANUFACTURER'S DIRECTIONS TO ACHIEVE FIRE RESISTANCE RATING INDICATED.
 - ALL PERIMETER JOINTS AND PENETRATIONS IN FIRE-RATED PARTITIONS TO BE FIRE STOPPED WITH SPECIFIED FIRE RESISTANT RATED MATERIALS.
 - GYPSUM WALL ASSEMBLIES SHALL LIMIT DEFLECTION TO L/360 UNDER AN LOADS.
 - MASONRY PARTITIONS SHALL EXTEND FROM FLOOR SLAB TO UNDERSIDE OF STRUCTURE ABOVE (UNLESS OTHERWISE INDICATED). PROVIDE LATERAL BRACING AS DETAILED.
 - SEE DOOR AND FRAME DETAILS FOR TYPICAL NOTES AND DETAILS ON FRAMING AND ANCHORING REQUIREMENTS.
 - PROVIDE CONTROL JOINTS IN ALL PARTITIONS 30'-0" O.C. MAX. FOR GNB PARTITIONS, 20'-0" O.C. MAX FOR CMU PARTITIONS.
 - PROVIDE 5/8" THICK IMPACT RATED GYPSUM WALL BOARDS FOR FACE LAYERS OF ALL WALLS, UNLESS NOTED OTHERWISE.**
 - ALL PARTITIONS SHALL BE "SMOKE RESISTANT BARRIERS" AT ALL FIRE RATED OR SMOKE RESISTANT PARTITIONS PROVIDE FIRE SAFING INSULATION AND SEALANT AS DETAILED.

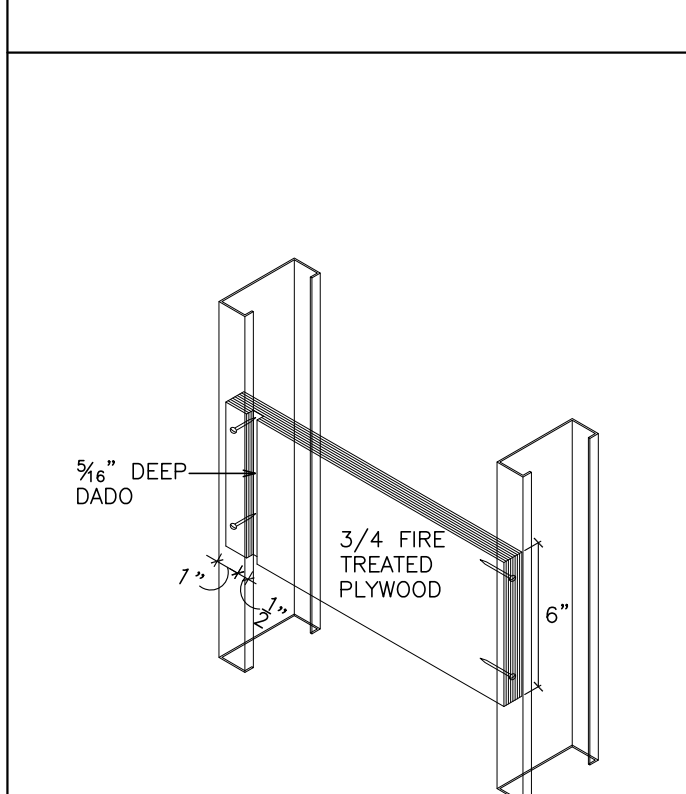


1 TYP. BLOCKING
SCALE: N.T.S.

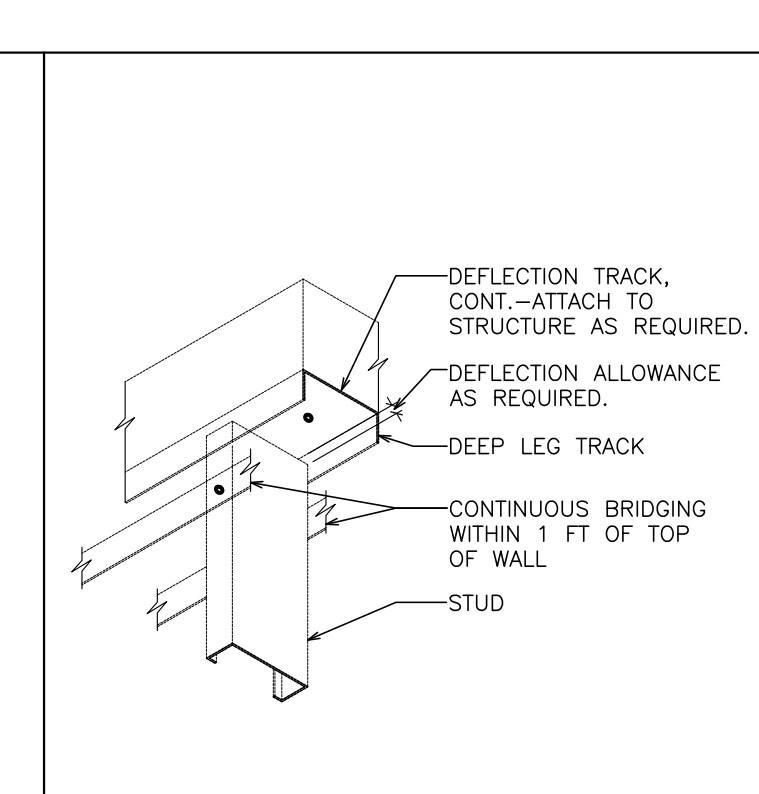


2 TYP. WALL INTERSECTION
SCALE: N.T.S.

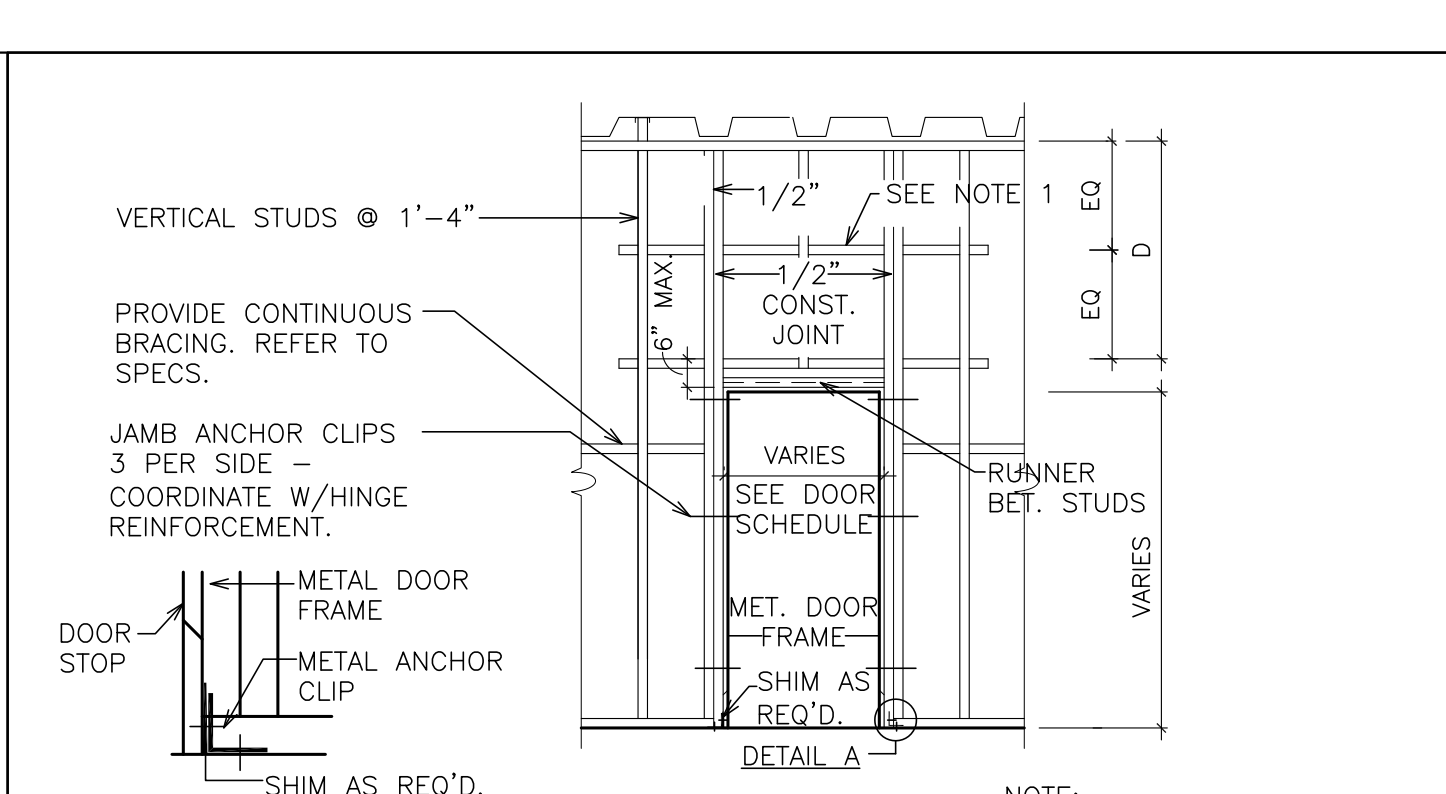


3 DETAIL PARTITION FRAMING FOR DOORS
SCALE: 1/4" = 1'-0"

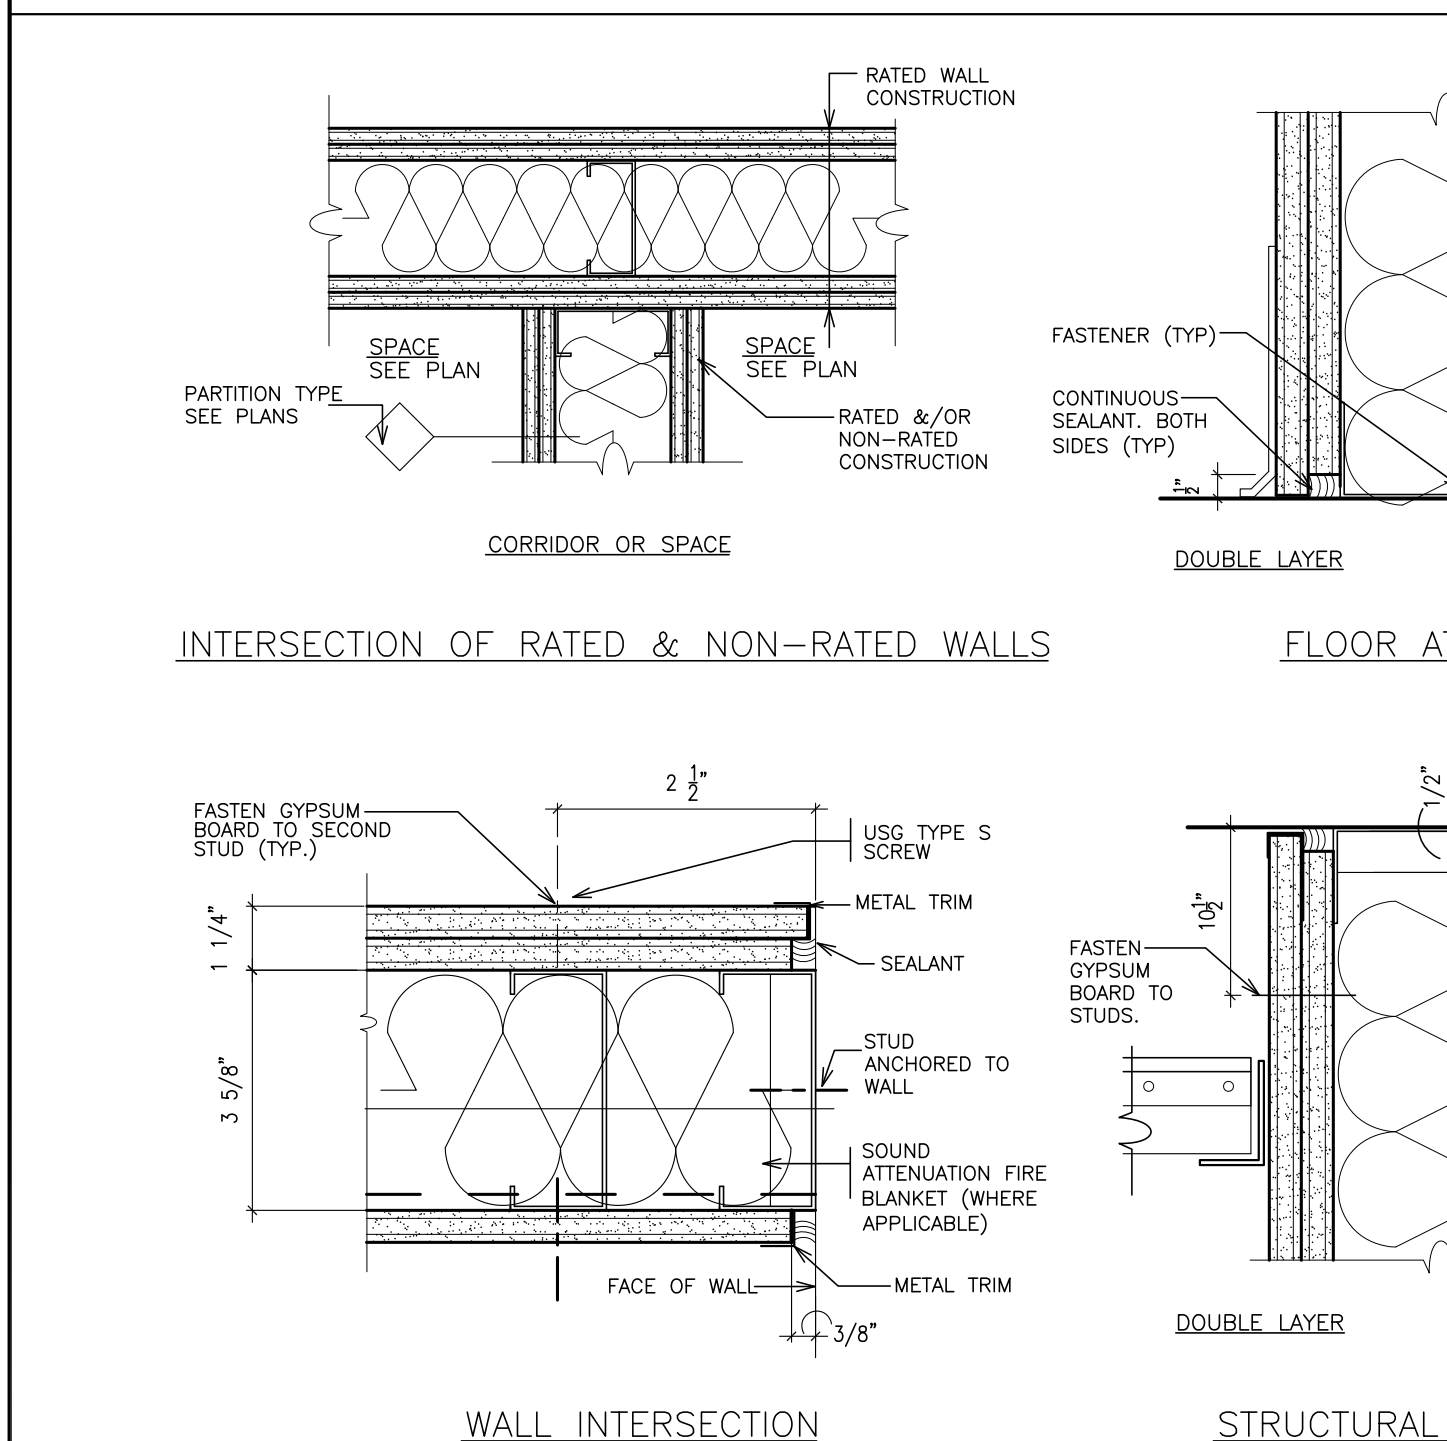



4 TYPICAL PARTITION DETAILS
NOT TO SCALE

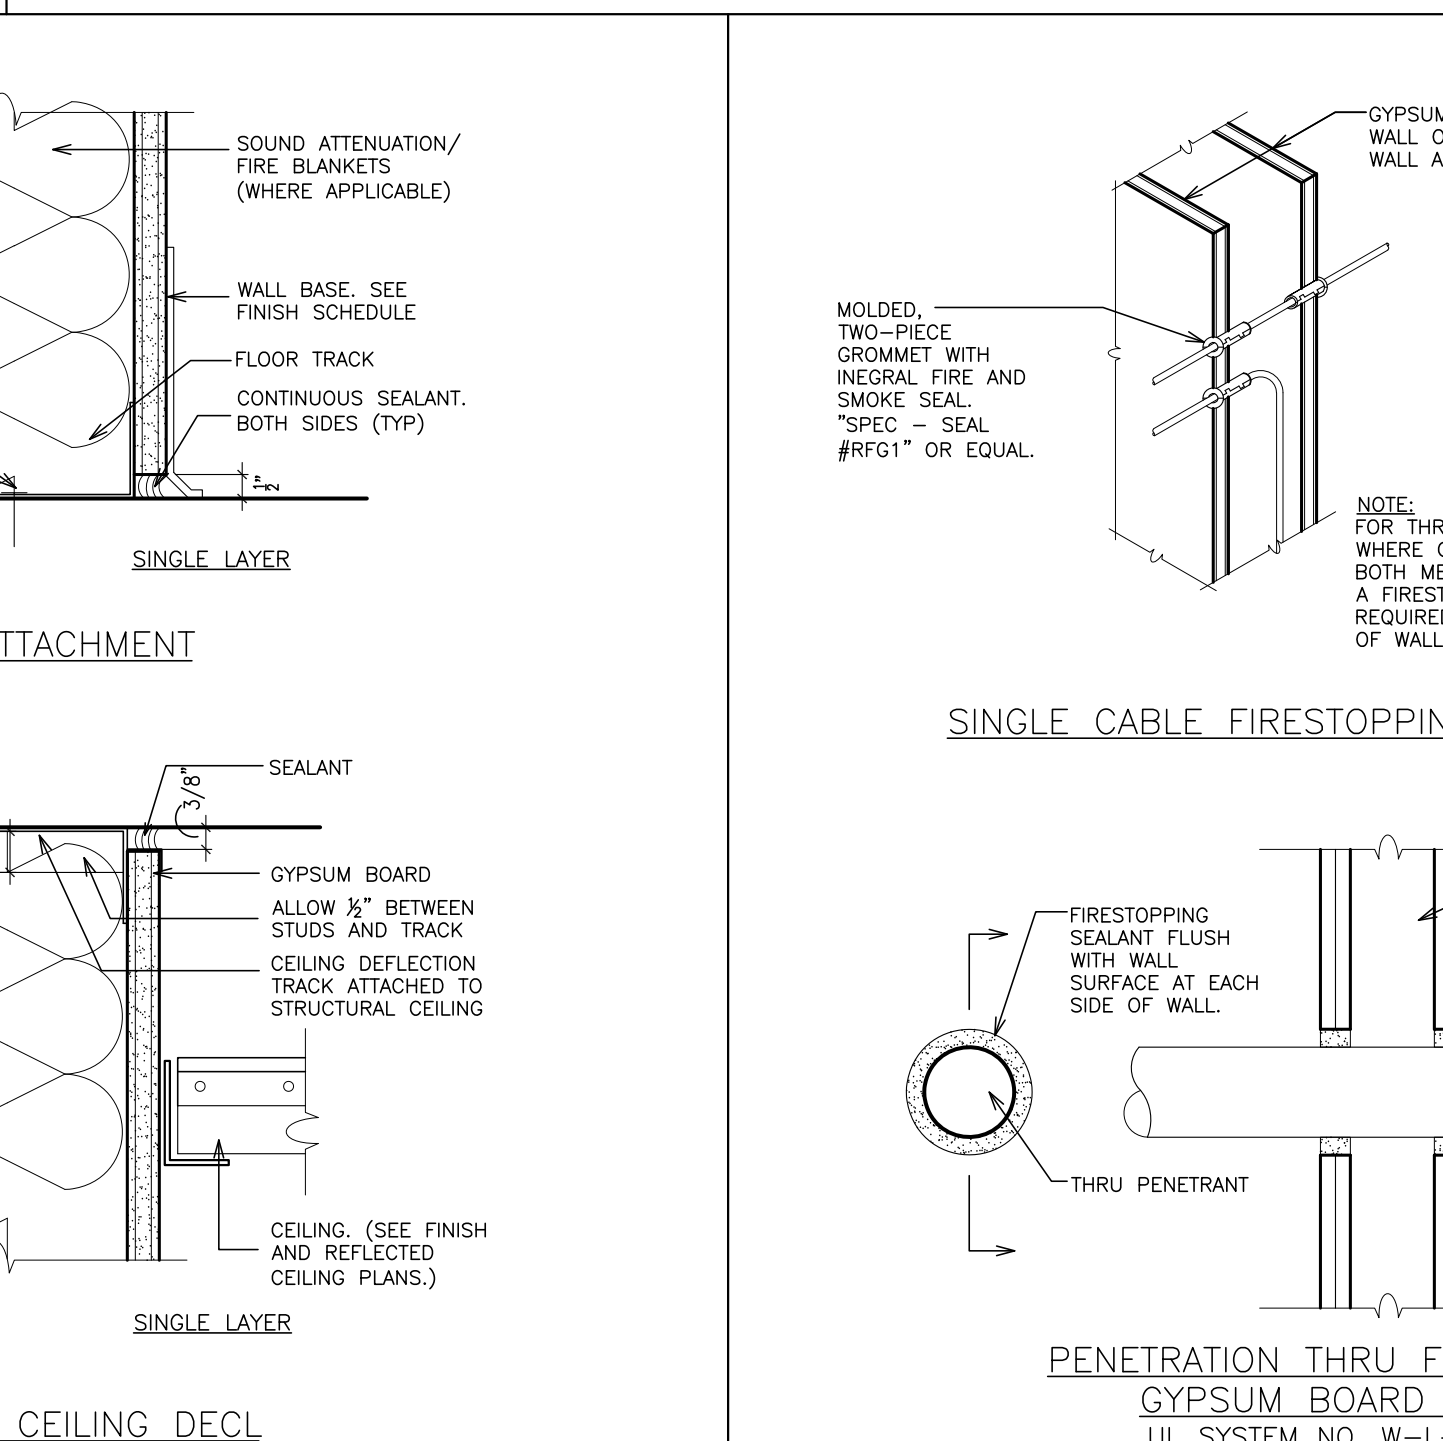





5 TYPICAL FIRESTOPPING DETAILS
NOT TO SCALE

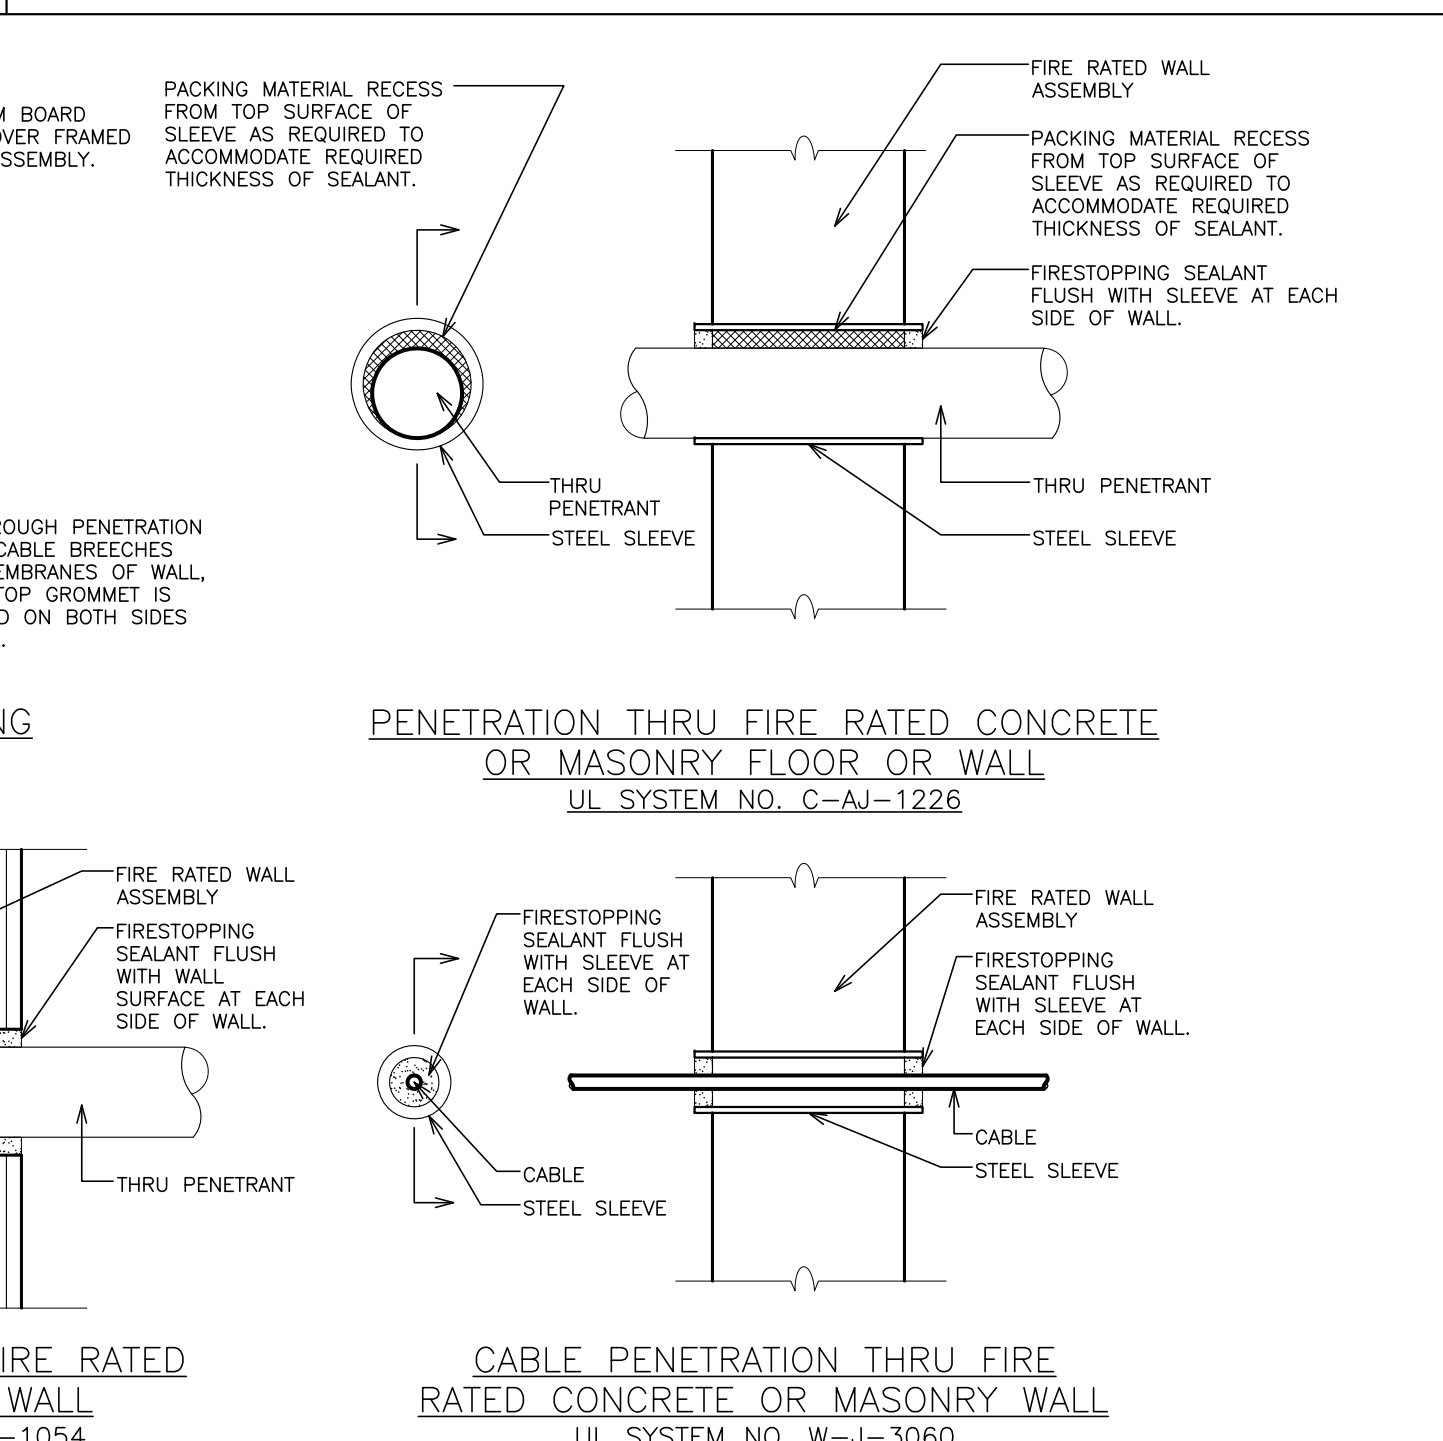

6 TYPICAL FIRESTOPPING DETAILS
NOT TO SCALE

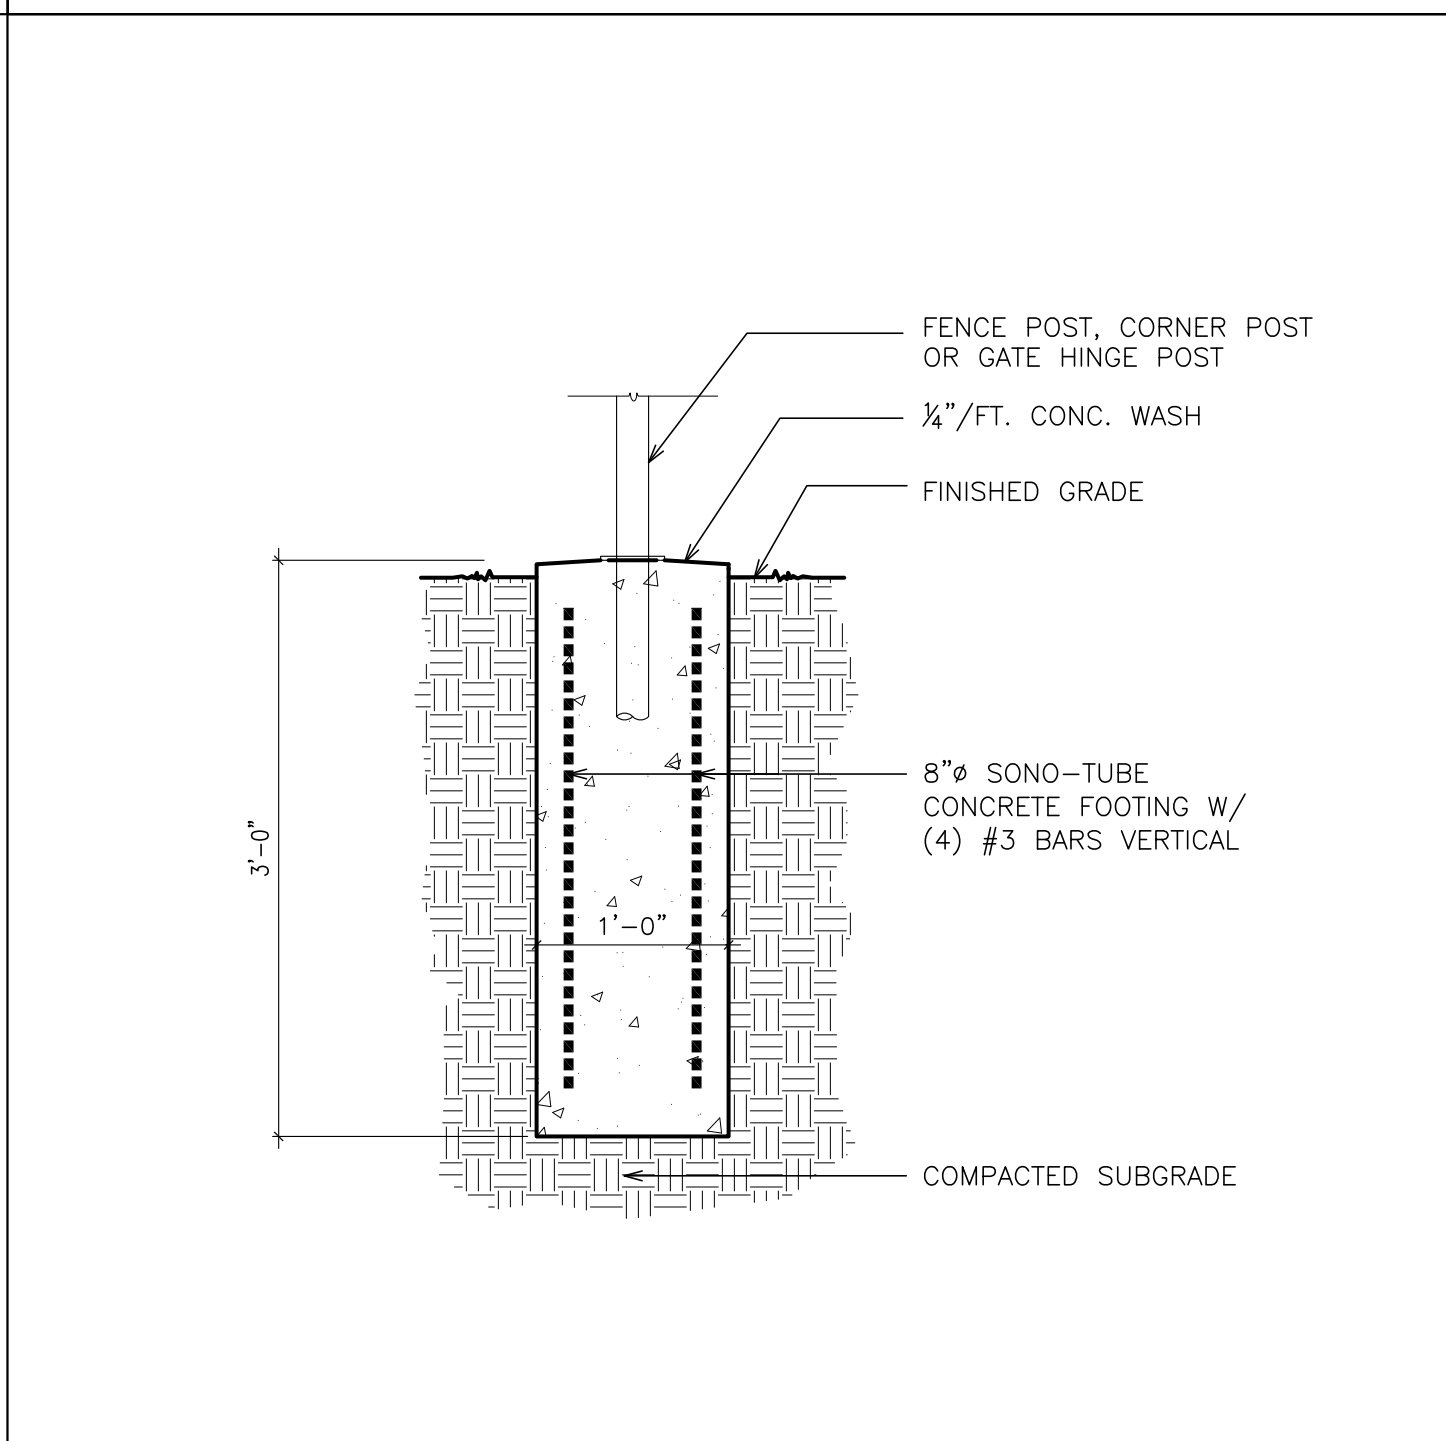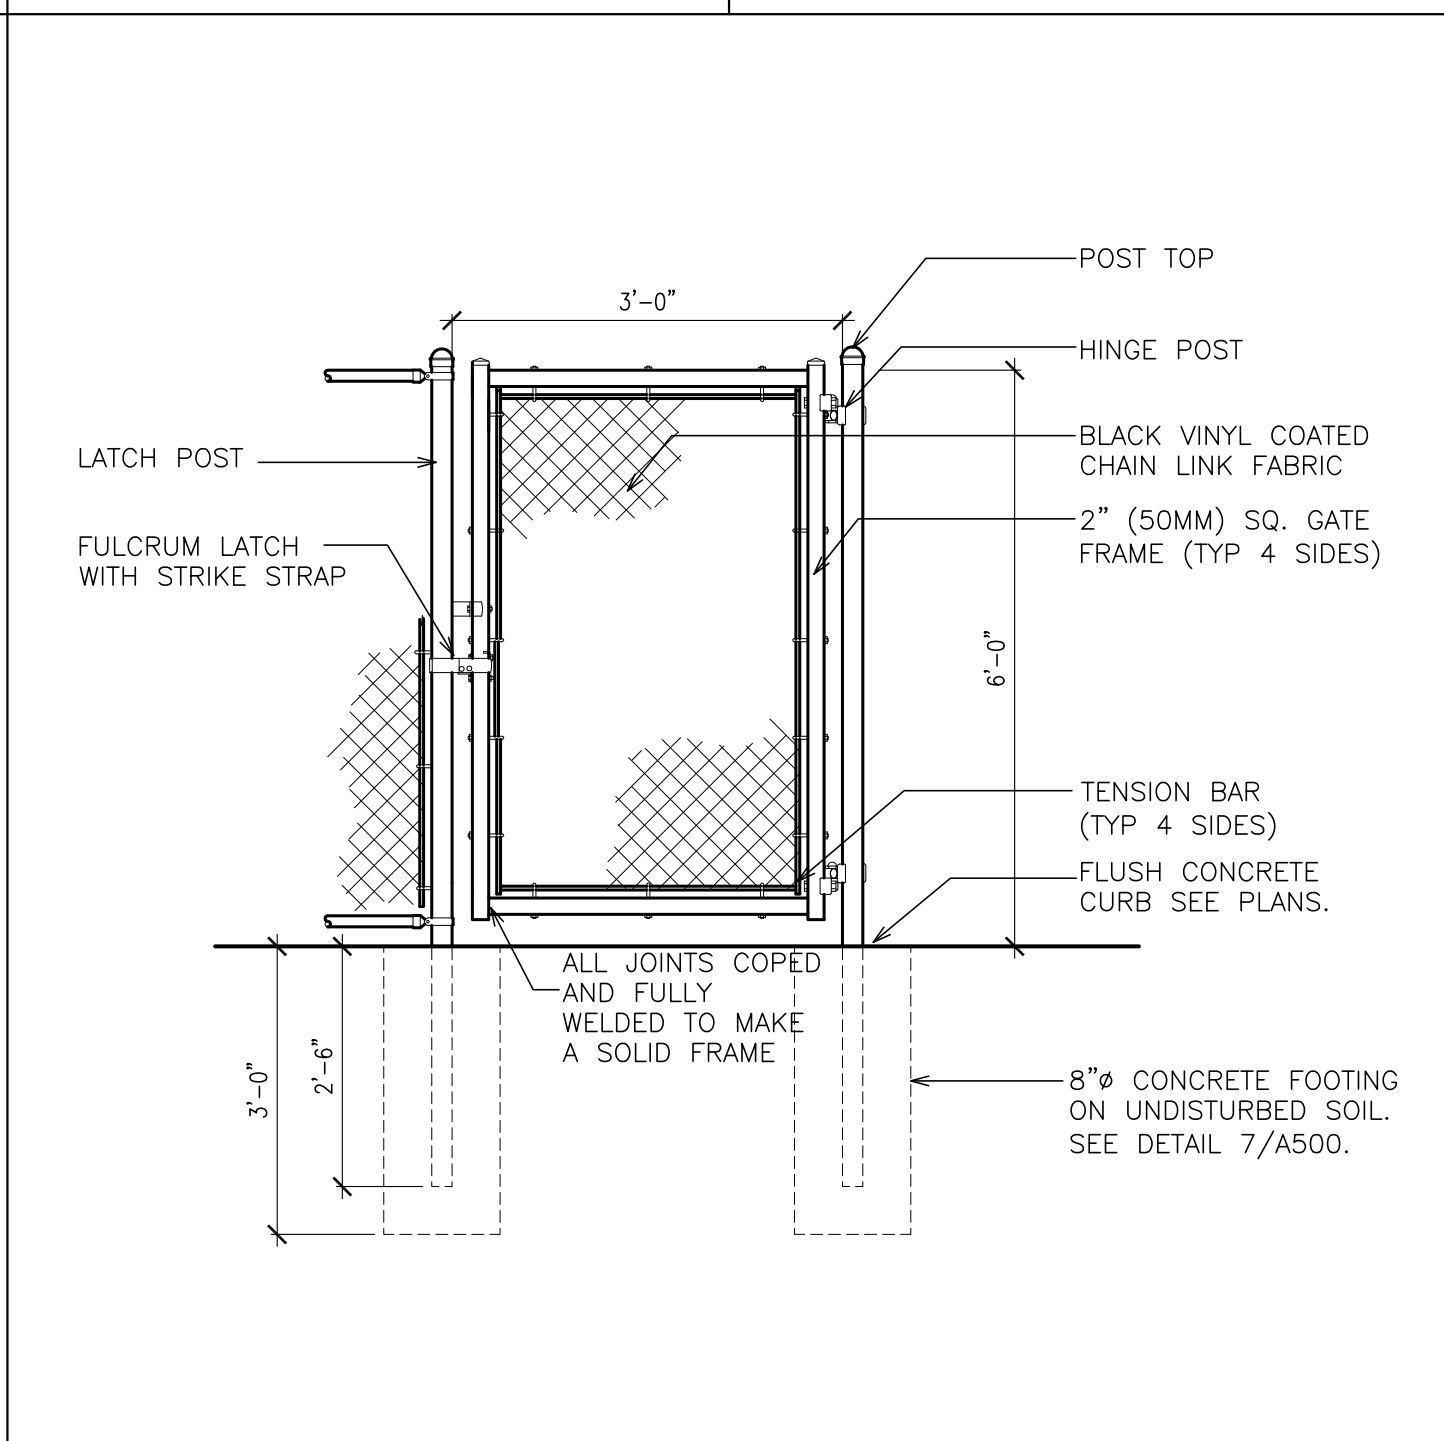

8 PROPOSED VERTICAL IMPOST (TYP.)
SCALE: 6" = 1'-0"

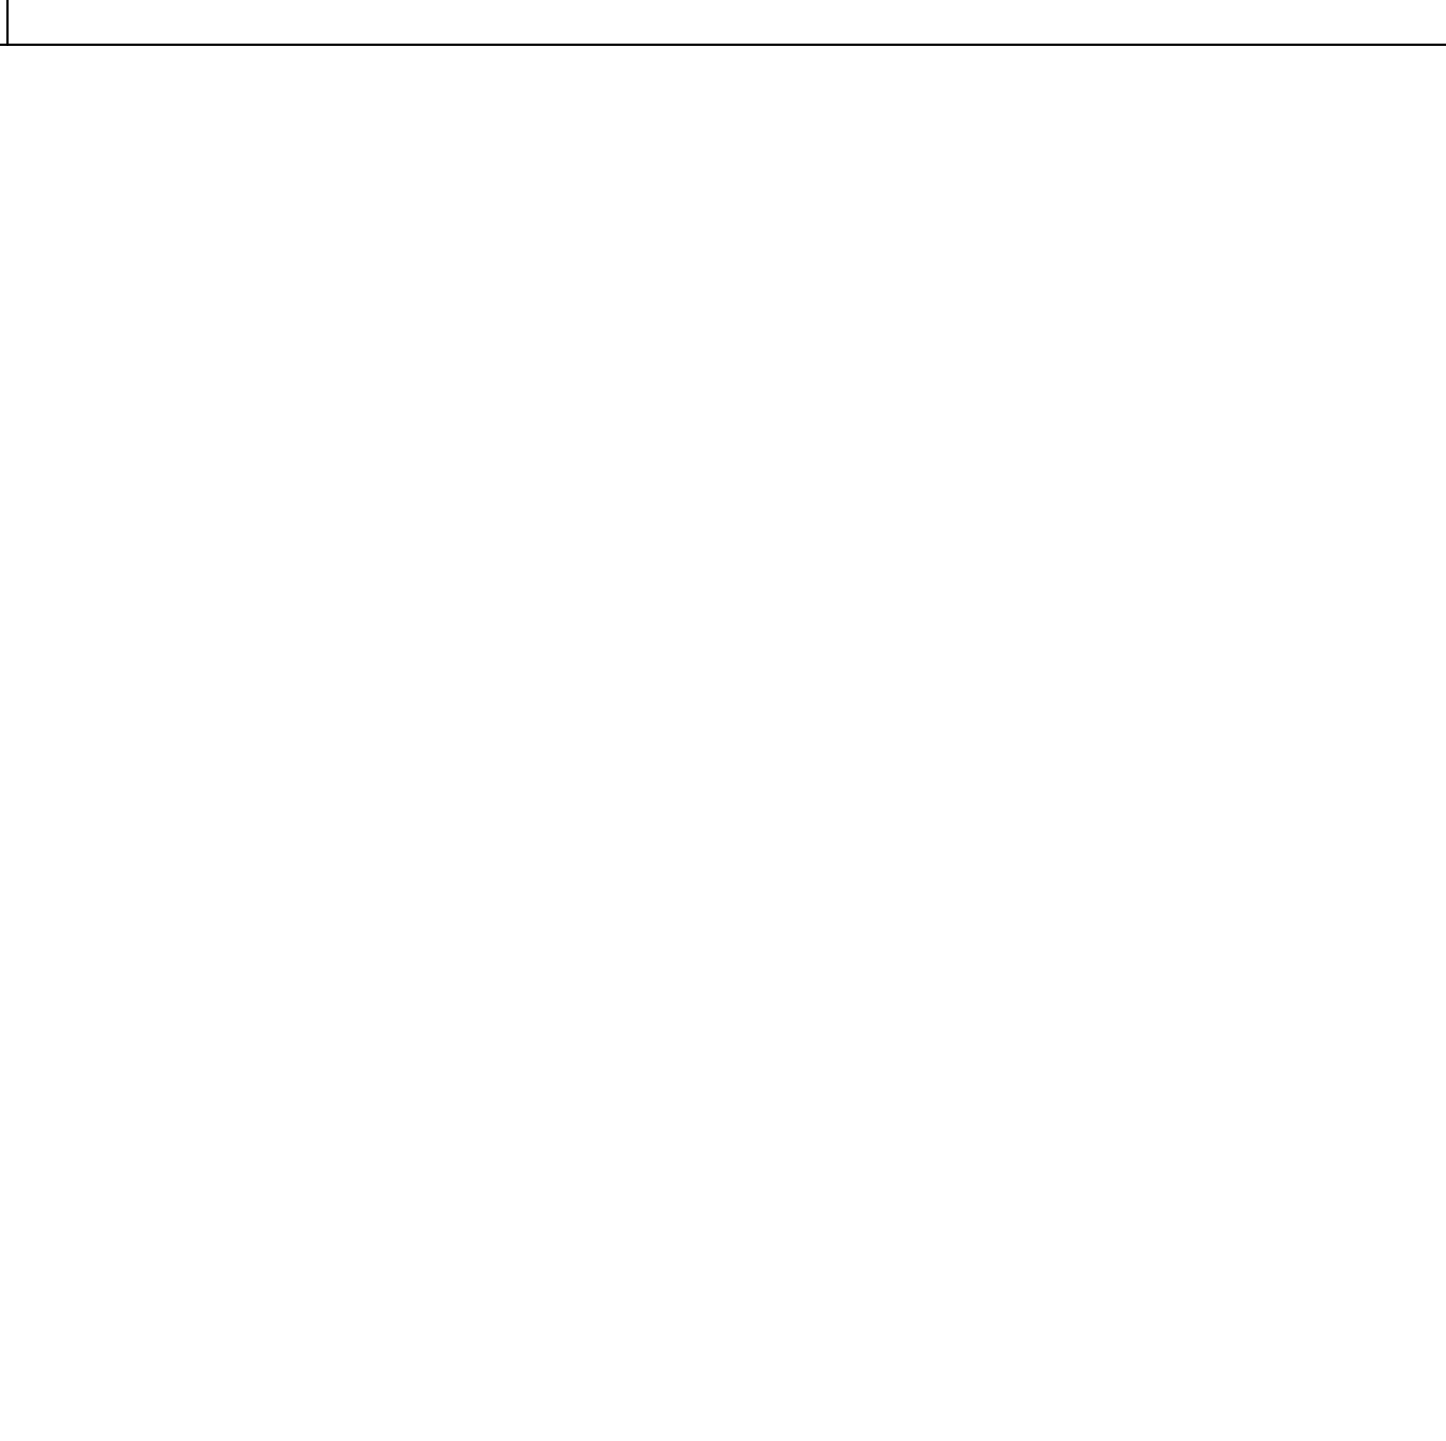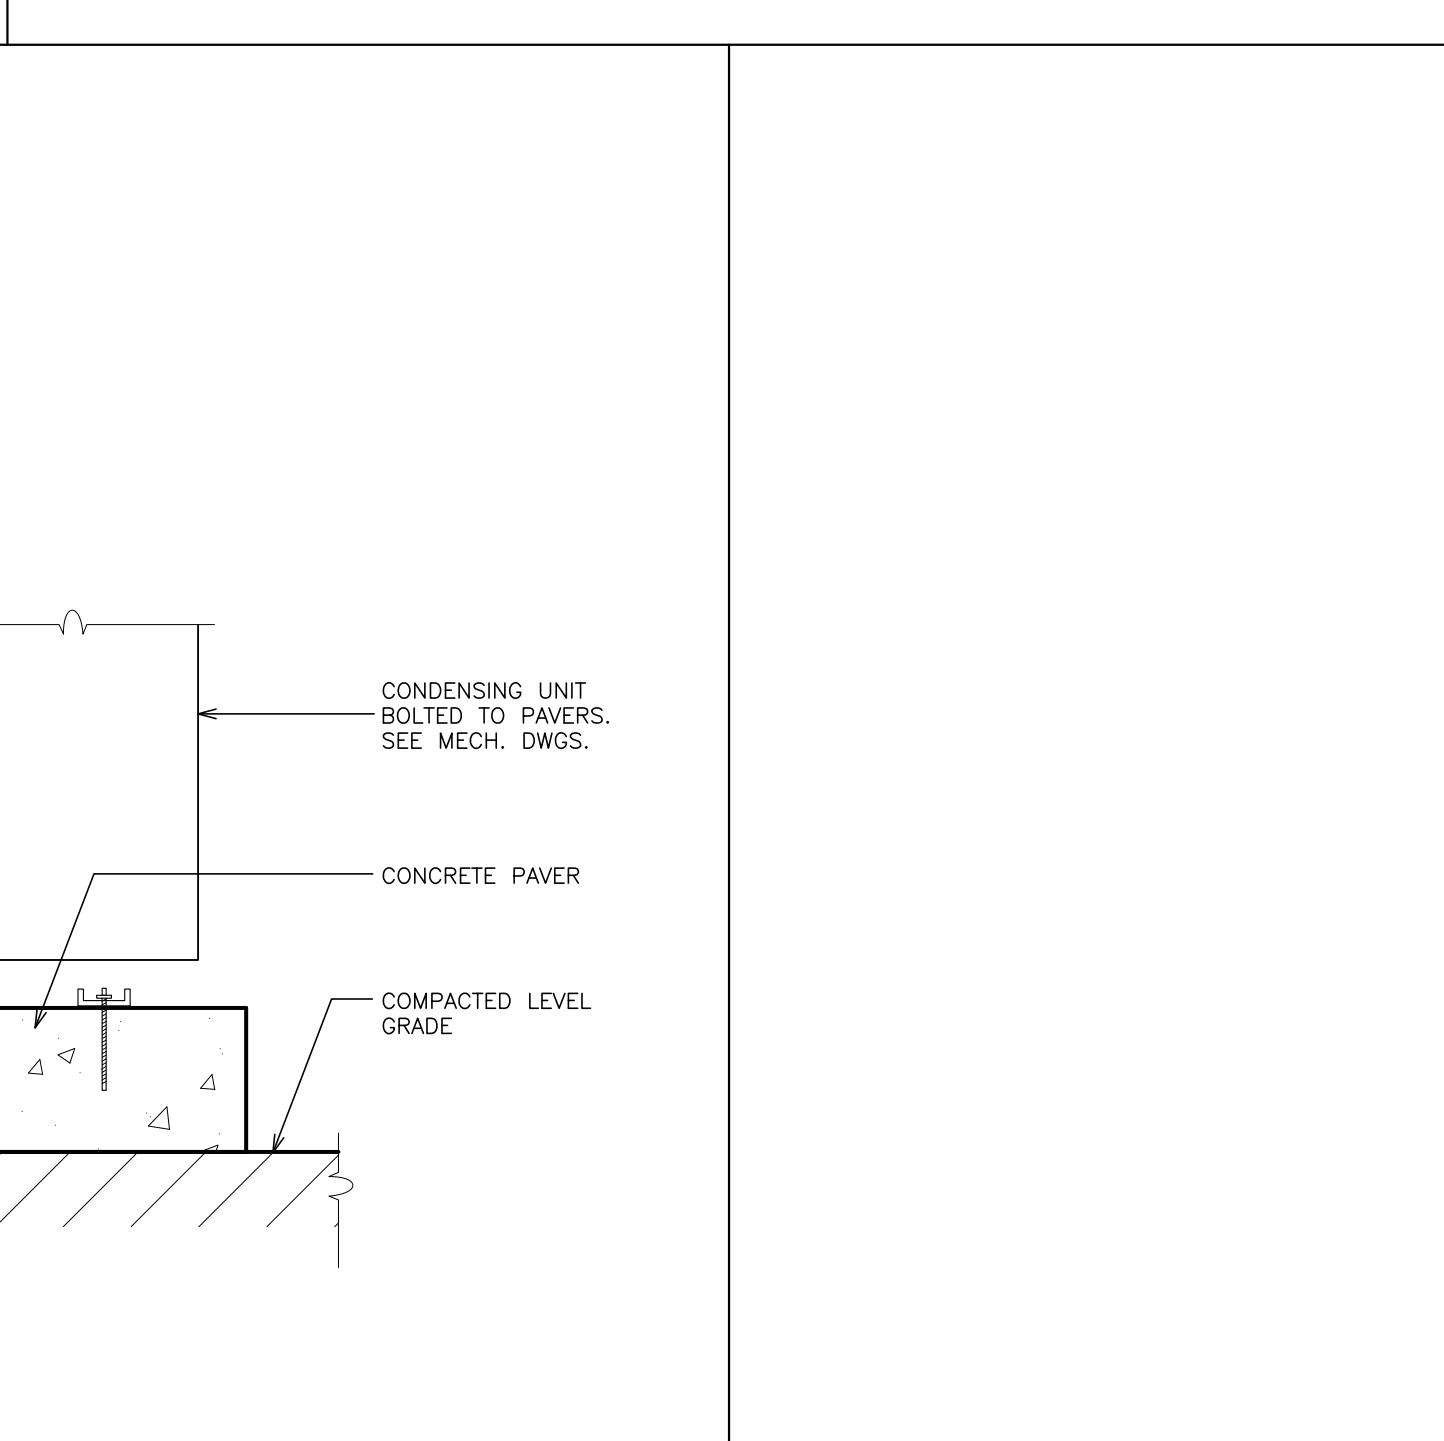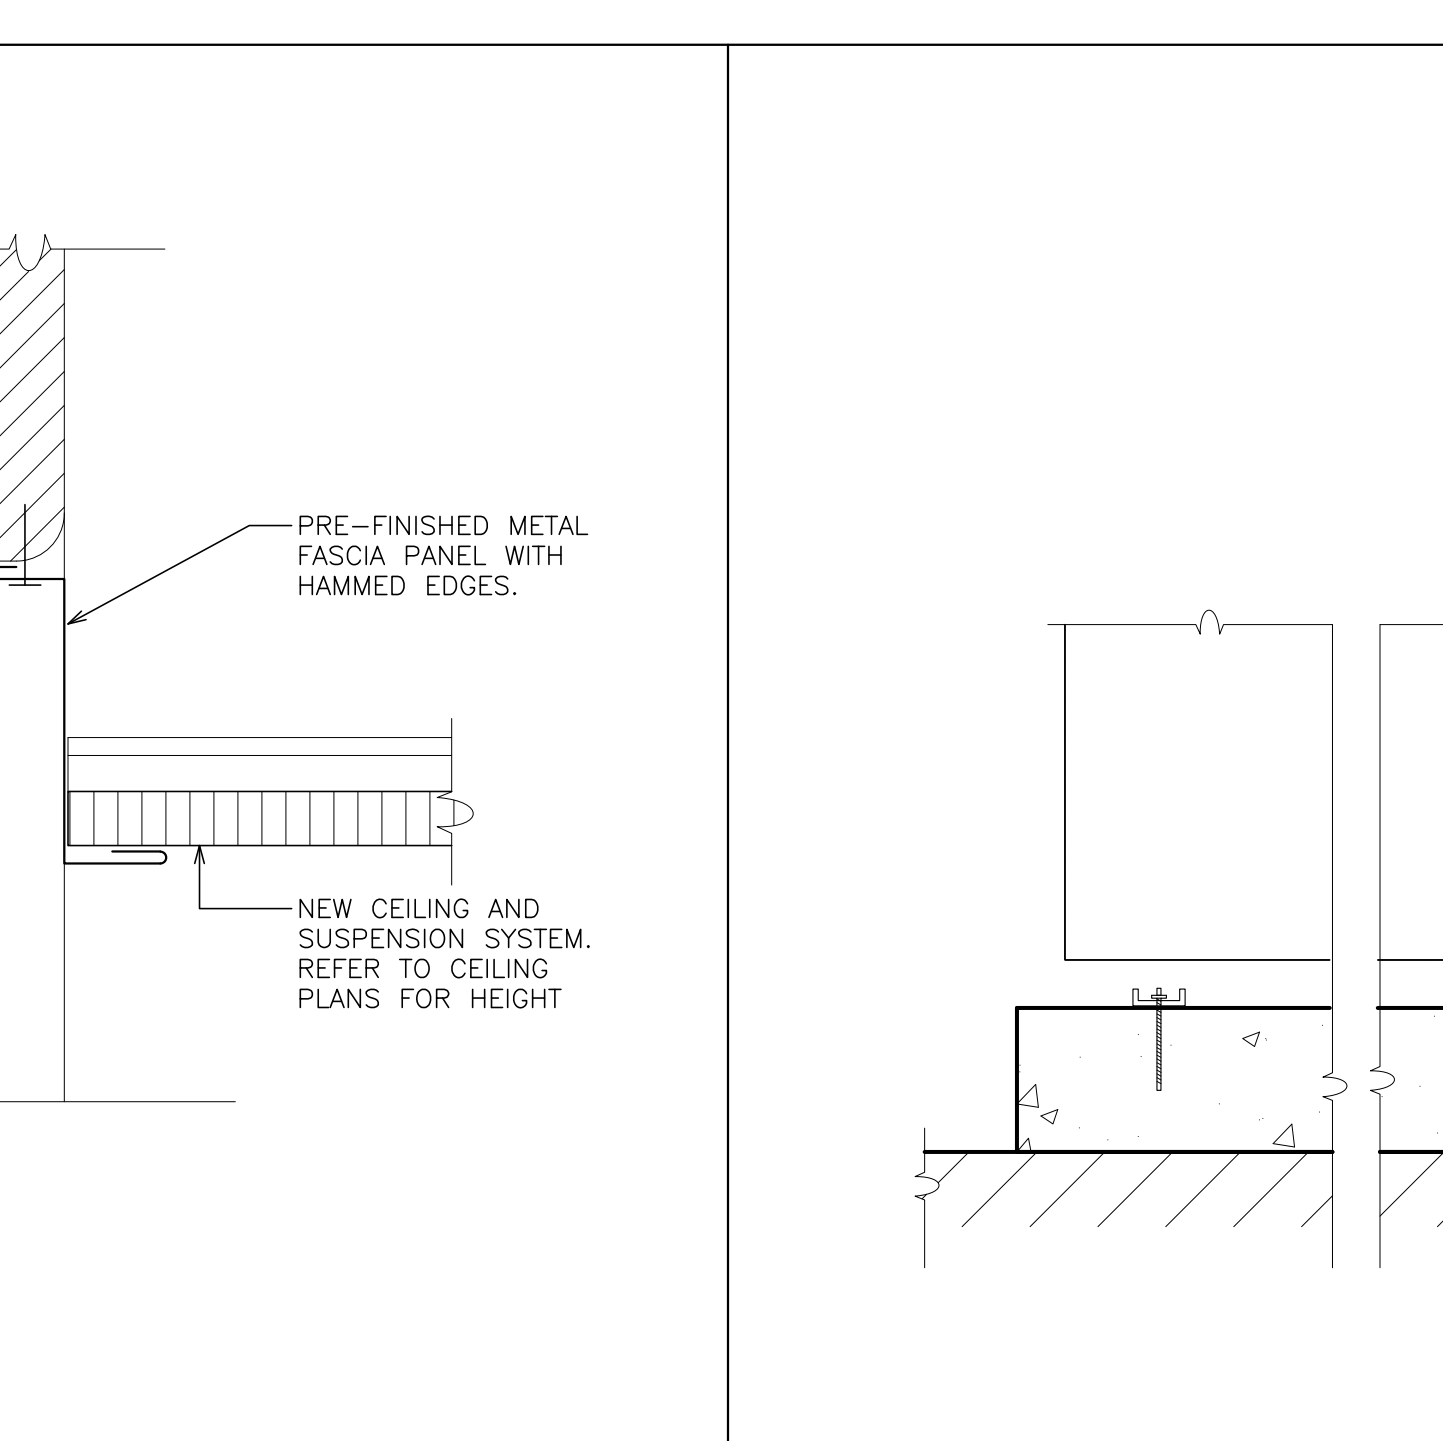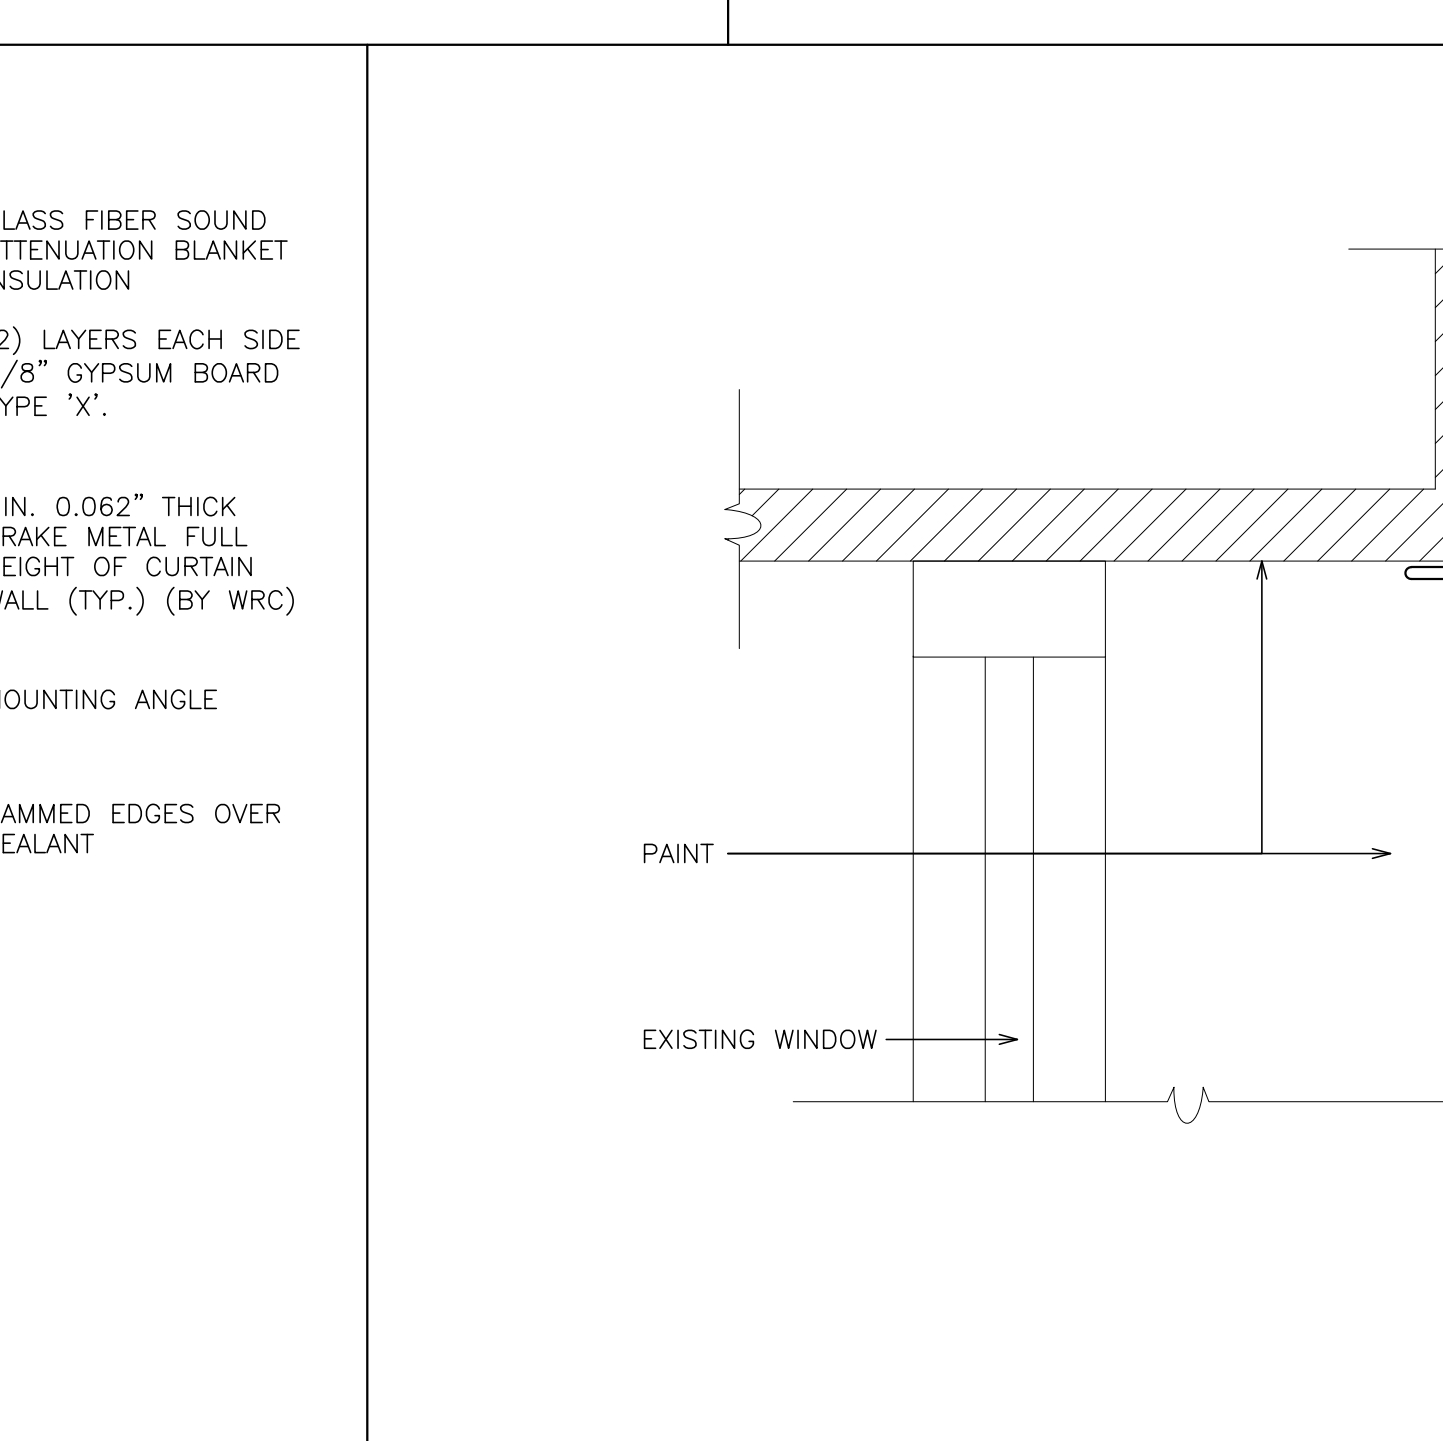

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FULLER & DANGELO P.C. ARCHITECTS & PLANNERS

PROJECT: PORT CHESTER - RYE UNION FREE SCHOOL DISTRICT, KING STREET ELEMENTARY SCHOOL LIBRARY ALTERNATIONS, JOINT KENNEDY ELEMENTARY SCHOOL OFFICE ALTERNATIONS, PORT CHESTER MIDDLE SCHOOL CLASSROOM ALTERNATIONS

DRAWING TITLE: PARTITION TYPES & MISCELLANEOUS DETAILS

DATE: 06-08-2021 ISSUED TO: B I D


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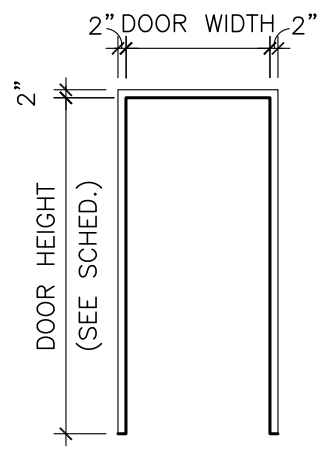
DRAWN BY: F & D FILE NO.: 21430.00

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SCALE: $1/4"=1'-0"$




SCALE: $1/4" = 1' - 0"$

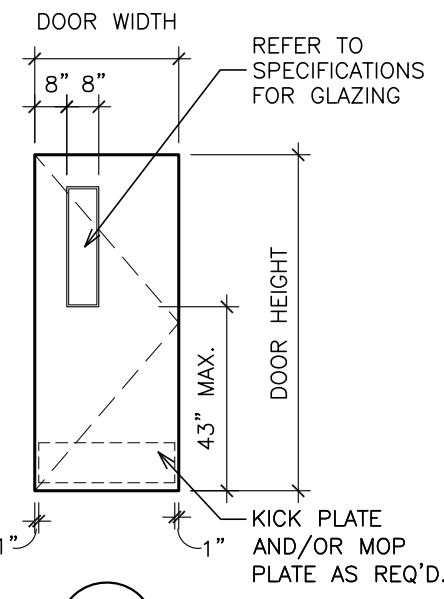

1. CONTRACTOR TO VERIFY ALL EXISTING CONDITIONS IN THE FIELD TO ENSURE COMPATIBILITY WITH HARDWARE SPECIFIED IN THE SPECIFICATIONS. ANY DISCREPANCIES BETWEEN THE EXISTING FIELD CONDITIONS AND SPECIFIED HARDWARE SHALL BE BROUGHT TO THE ATTENTION OF THE ARCHITECT IMMEDIATELY. HARDWARE SUPPLIER SHALL NOT ORDER ANY HARDWARE UNTIL ALL DISCREPANCIES ARE RECTIFIED AND ARCHITECT GRANTS WRITTEN APPROVAL.
2. DOOR HARDWARE SHALL COMPLY TO ALL APPLICABLE HANDICAPPED CODES. CLOSERS SHALL COMPLY TO STANDARDS REGARDING CLOSING SPEED AND OPENING FORCE.
3. ALL DOOR AND FRAME SIZES SHALL BE FIELD VERIFIED.
4. FIRE RATED DOORS SHALL COMPLY WITH NFPA 80, PROVIDE UL LABELS.
5. THERE SHALL BE NO PROJECTIONS BETWEEN 34" AND 80" ABOVE THE FLOOR OR GROUND. PROJECTIONS BETWEEN 34" AND 80" ABOVE THE FLOOR OR GROUND SHALL NOT EXCEED 4".
6. REFER TO SPECIFICATIONS FOR GLAZING TYPE FOR VISION PANELS.
7. ALL GLAZING IN FIRE RATED DOOR SHALL BE LABELED GLASS. REFER TO SPECIFICATIONS.
8. THE BOTTOM OF ALL DOOR VISION LITES SHALL BE A MAXIMUM OF 43" ABOVE THE FINISHED FLOOR.
9. PROVIDE SILICONE SEALANT AROUND ALL NEW DOOR LIGTS.
10. DOORS LEADING TO HAZARDOUS SPACES SHALL HAVE KNURING. HAZARDOUS SPACES SHALL INCLUDE CUSTODIAL, STAGES, STAIRS, STORAGE, BOILER ROOMS, TRASH ROOMS, MECHANICAL ROOMS, AND ELECTRICAL ROOMS.
11. COORDINATE DOOR SCHEDULE WITH DOOR HARDWARE SPECIFICATIONS AND HARDWARE SETS. ANY DISCREPANCIES MUST BE BROUGHT TO THE ARCHITECTS ATTENTION IN WRITING PRIOR TO PROCEEDING.
12. COORDINATE FRAME THROAT SIZE WITH PARTITION TYPES INDICATED ON FLOOR PLANS. NOTIFY ARCHITECT IN WRITING OF ANY DISCREPANCIES PRIOR TO PROCEEDING WITH FABRICATION.
13. 20. H.M. DOOR FRAMES TO BE PAINTED (BOTH SIDES).
14. COORDINATE ALL REMOVALS WITH ABATEMENT DOCUMENTS.
15. MATCH DOOR VENEER AND COLORS TO MATCH EXISTING DOORS.


- ① MATCH WOOD GRAIN AND COLOR OF EXISTING BUILDING DOORS. FINISH SHALL BE FACTORY APPLIED.
- ② CONTRACTOR SHALL PROVIDE TEMPORARY DOORS AND HARDWARE IF SPECIFIED DOORS AND HARDWARE ARE NOT INSTALLED BY THE COMPLETION DATE. TEMPORARY DOORS AND HARDWARE SHALL BE REMOVED WHEN NO LONGER NEEDED.

SCALE: 3"=1'-0"

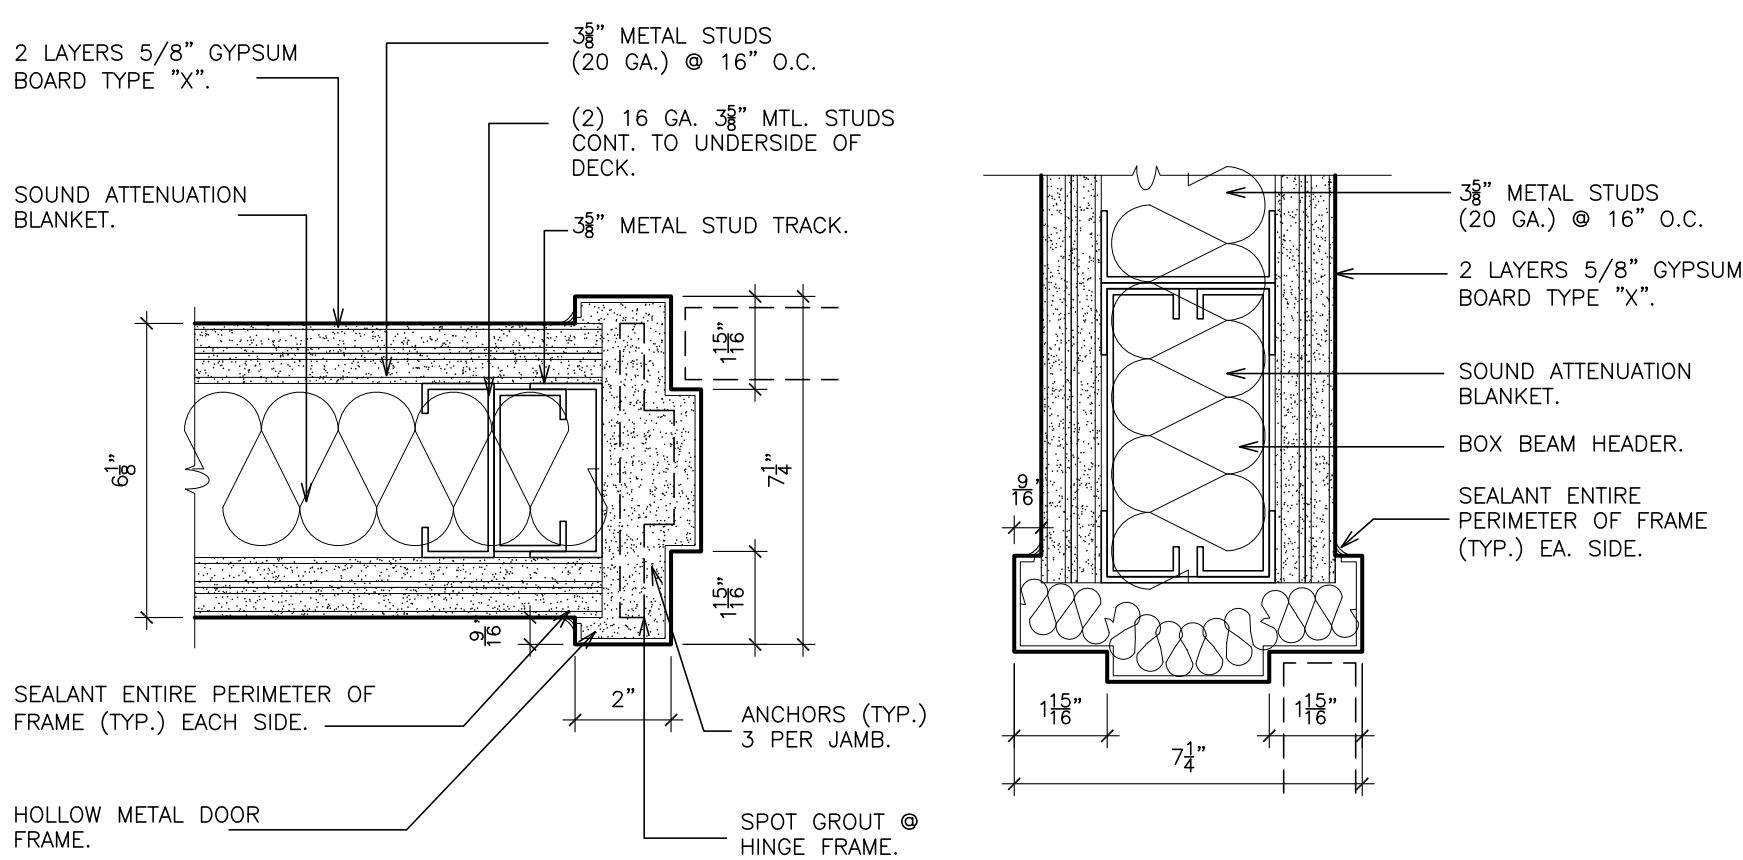

SCALE: 3" = 1'-0"

SCALE: 3" = 1'-0"

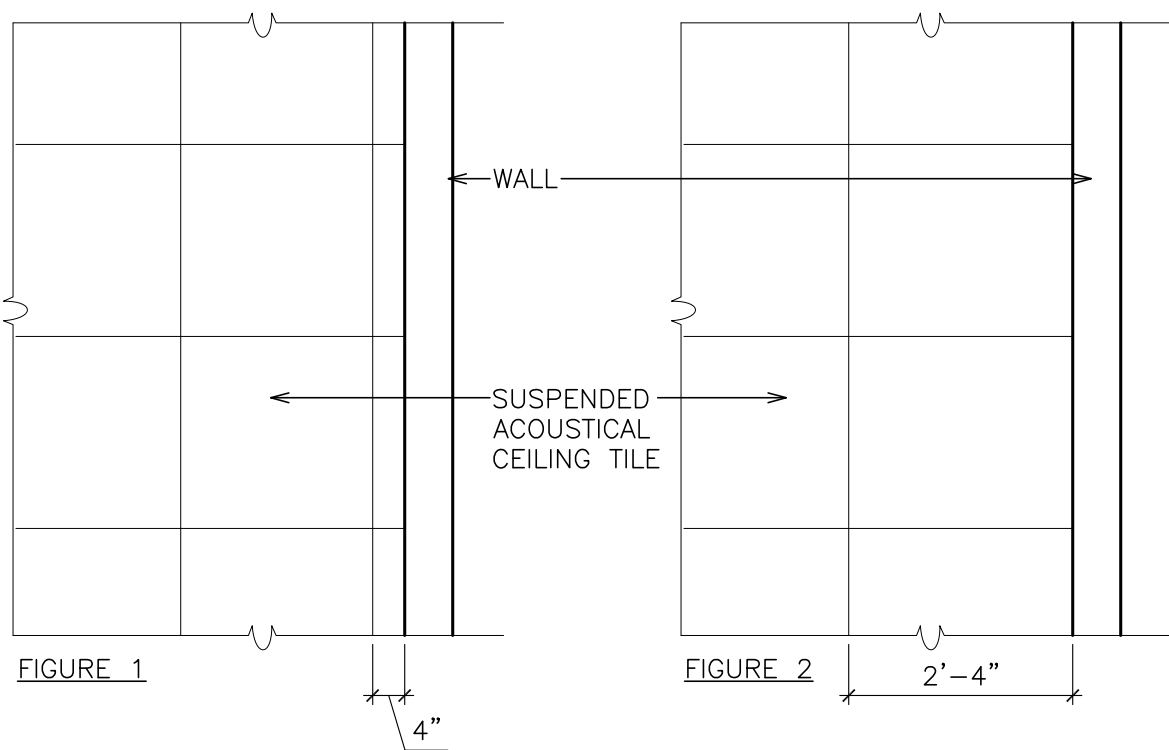

WALL INDICATIONS
ON PLAN

[illegible]


LEGEND	SIZE	MANUFACTURER	SERIES/MODEL No./COLOR	DESCRIPTION	LOCATION/REMARKS
ACT-1	—	ARMSTRONG	SCHOOL ZONE FINE FISSURED	2'x2' SQUARE EDGE	15/16" GRID
ACT-2	—	ARMSTRONG	MATCH EXISTING	2'x4' SQUARE EDGE	15/16" GRID
ACT-3	—	ARMSTRONG	MATCH EXISTING	2'x4' SQUARE EDGE	15/16" GRID
P-1	—	BENJAMIN MOORE	AC-41 / ACADIA WHITE	FLAT FINISH	SOFFIT, SHADE POCKET
P-2	—	BENJAMIN MOORE	HC-81 / MANCHESTER TAN	EGGSHELL FINISH	WALL PAINT (OFFICES)
P-3	—	BENJAMIN MOORE	MATCH EXISTING COLOR / FINISH		CLASSROOM
P-4	—	BENJAMIN MOORE	2112-30 / STONE BROWN	SEMI-GLOSS	DOOR FRAME
VT-1	12"x12"	TARKETT	COLOR AS SELECTED FROM STANDARD COLORS	VINYL ENHANCED TILE	—
RB-1	4" H	JOHNSONITE	COLOR AS SELECTED FROM STANDARD COLORS	TRADITIONAL WALL BASE	MATCH EXISTING

ACT.	—	ACOUSTIC CEILING TILE
CT.	—	CERAMIC TILE
P.	—	PAINT
PL.	—	PLASTER
CT.	—	STEEL
MAS.	—	MASONRY
CONC.	—	CONCRETE
G.B.	—	GYP SUM BOARD
EW C	—	EXISTING WALL COVERING


- ① REFER REFLECTED CEILING PLANS FOR ADDITIONAL INFORMATION.
- ② PAINT WINDOW POCKET P1.
- ③ PROVIDE CEMENTITIOUS SELF-LEVELING CONCRETE OVER ALL EXISTING FLOORS RECEIVING NEW FINISH. REFER TO FINISH SCHEDULE AND SPECIFICATIONS FOR FINISH TYPE. PAINT ALL DOORFRAMES.
- ④ PAINT SHADE POCKET.
- ⑤ PATCH FLOOR TILE AT LOCATIONS OF FLOORING ABATEMENT.
- ⑥ PAINT ENTIRE WALLS TO MATCH EXISTING.

1. COLORS OF ALL APPROVED FINISH MATERIALS SHALL BE COORDINATED WITH ARCHITECT IN FIELD.
2. PREPARE ALL SURFACES TO BE PAINTED IN ACCORDANCE TO MPI REQUIREMENTS. SEE SPECIFICATIONS FOR ALL PRIMERS.
3. ALL FINISHES SHALL COMPLY TO APPLICABLE CODES. ALL FINISHES CLASS--A.
4. PATCH / REPAIR AND PAINT ALL AREAS DISTURBED BY NEW WORK, MATCH EXISTING.
5. ITEMS NOTED THUS ☐ INDICATE EXISTING ITEMS TO REMAIN UNDISTURBED. PATCH/PAINT DAMAGED AREAS AS REQUIRED.
6. ITEMS NOTED THUS ☒ INDICATE NEW AND EXISTING ITEMS TO BE PAINTED.
7. ITEMS NOTED THUS ☒-P INDICATE EXISTING ITEMS TO BE PAINTED ONLY WITHIN THE IMMEDIATE VICINITY OF GENERAL WORK TO BE PAINTED. MINIMUM 4" EACH WAY.
8. ITEM NOTED THUS ☐ ARE NOT APPLICABLE.

1. ALL CEILING MOUNTED ITEMS (DETECTORS, GRILLS, ETC.) AND INDICATED ON THE MECHANICAL AND ELECTRICAL DRAWINGS. ALL ITEMS ARE TO BE CENTERED WITHIN THE CEILING TILES AND GRIDS. WHERE ITEMS ARE SHOWN ON ARCHITECTURAL DRAWINGS THEY DENOTE LOCATION AND LAYOUT WHERE PLACEMENT IS CRITICAL. THE ARCHITECTURAL DRAWINGS DO NOT REPRESENT COMPLETE SYSTEMS THAT ARE SHOWN ON OTHER DRAWINGS. REFER TO MECHANICAL AND ELECTRICAL DRAWINGS FOR ACCESS DOORS REQUIRED FOR ANY DEVICES WHICH MAY BE COVERED OVER DUE TO NEW CEILING AND SOFFIT WORK.
2. PAINT ALL NEW GYPSUM WALLBOARD SOFFITS AND CEILINGS.
3. REFER TO FINISH SCHEDULE FOR ADDITIONAL INFORMATION.
4. FIT CEILING TILES AND GRIDS AROUND VERTICAL PIPES THAT PASS THROUGH THE NEW CEILING.
5. REFER TO MECHANICAL DRAWINGS FOR TYPES, SIZES AND LOCATIONS OF AIR GRILLS.
6. REFER TO ELECTRICAL DRAWINGS FOR LIGHTING SCHEDULE AND DEVICES.
7. ALL BUILDING LIFE SAFETY SYSTEM SHALL BE MAINTAINED WHEN BUILDING IS OCCUPIED.
8. CEILING HEIGHTS INDICATED ARE EXISTING AND ARE TO BE FIELD VERIFIED BY CONTRACTOR. ALL NEW CEILING HEIGHTS ARE TO MATCH EXISTING UNLESS NOTED OTHERWISE.
9. DIMENSIONS AND CONDITIONS OF EXISTING ITEMS ARE APPROXIMATE (NOT AS-BUILTS). CONTRACTOR SHALL FIELD VERIFY.

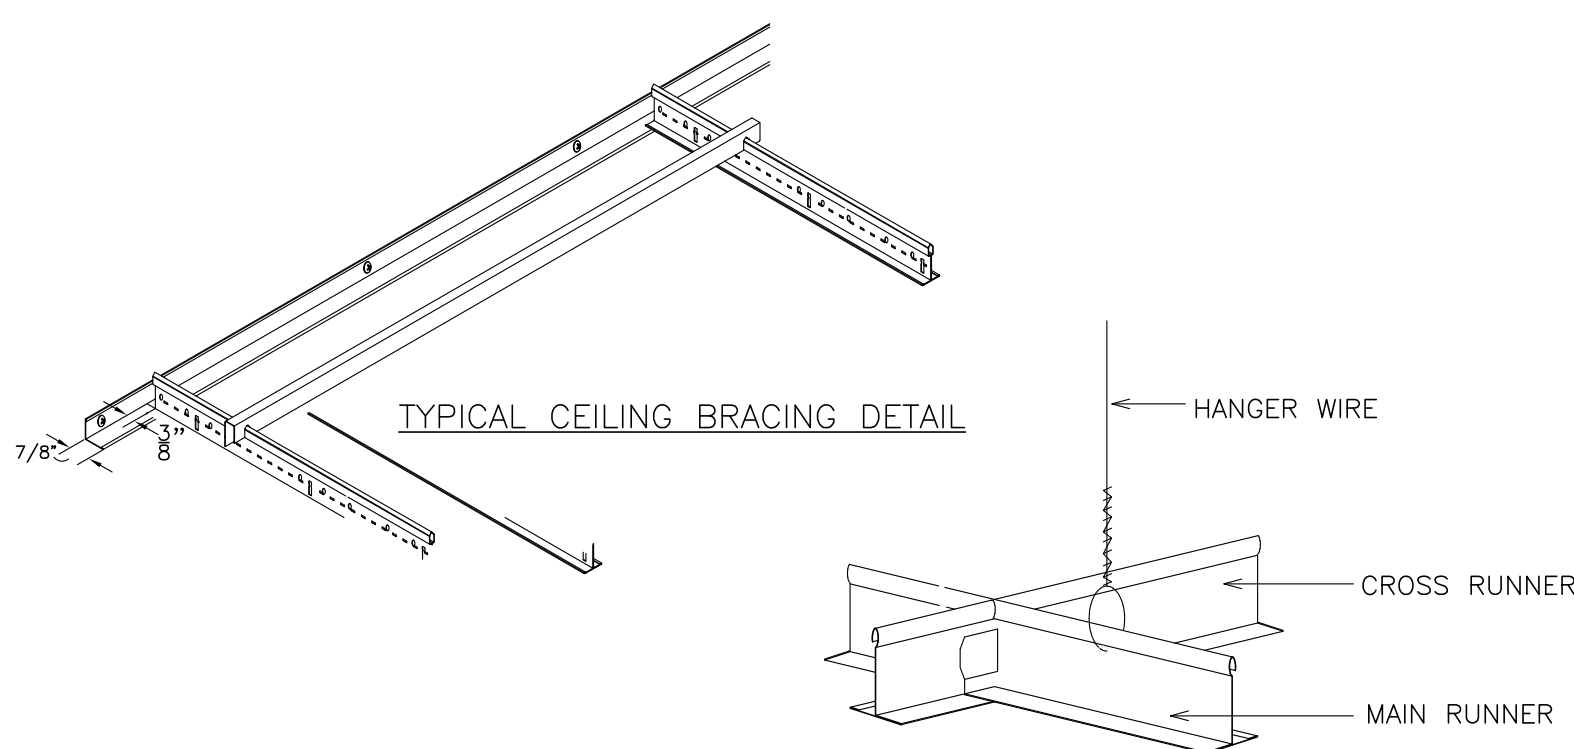

NOTE:
SPICES AND INTERSECTIONS OF RUNNERS SHALL BE ATTACHED WITH MECHANICAL INTERLOCKING CONNECTORS SUCH AS POP RIVETS, SCREWS, PINS, PLATES WITH BENT TABS, OR OTHER APPROVED CONNECTORS. DESIGN CONNECTORS FOR 2x DESIGN LOAD OR ULTIMATE AXIAL TENSION OR COMPRESSION (MINIMUM 60 POUNDS)

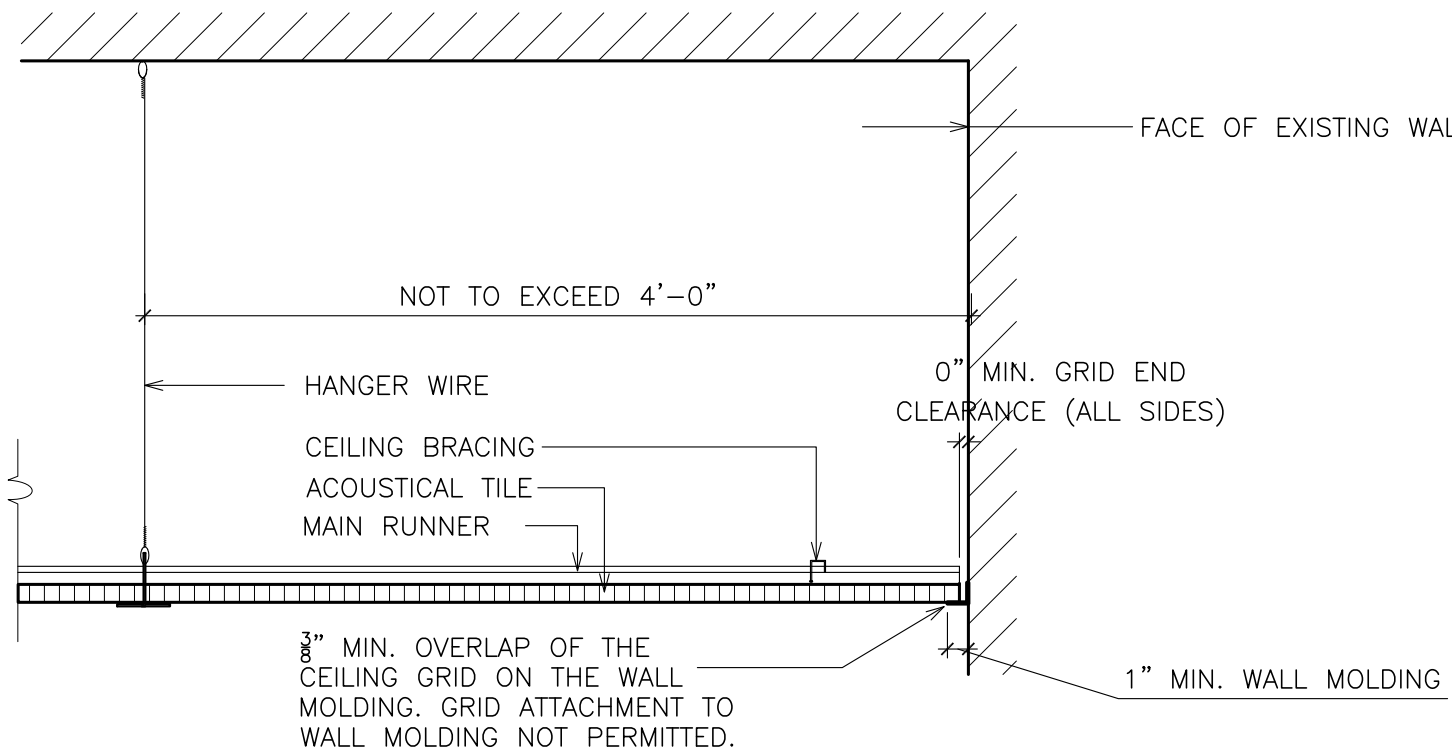

1. LIGHT FIXTURES LESS THAN 56lbs. REQUIRE ADDITIONAL HANGER WIRE AT EACH CORNER AND CONNECTIONS TO GRID. LIGHT FIXTURES GREATER THAN 56lbs. REQUIRE INDEPENDENT SUPPORT FROM STRUCTURE AND CONNECTIONS TO GRID. COORDINATE WITH MECHANICAL AND ELECTRICAL.
2. ALL CEILING MOUNTING SERVICES WEIGHING LESS THAN 20lbs. SHALL BE POSITIVELY ATTACHED TO THE CEILING SUSPENSION SYSTEM. ALL CEILING MOUNTED SERVICES WEIGHING MORE THAN 20lbs. AND NOT MORE THAN 56lbs. SHALL HAVE CONNECTORS TO THE GRID AND (2) APPROVED HANGER WIRES. ALL CEILING MOUNTED SERVICES GREATER THAN 56lbs. SHALL REQUIRE INDEPENDENT SUPPORT FROM STRUCTURE. COORDINATE WITH MECHANICAL AND ELECTRICAL.
3. ACCESSORIES
PROVIDE INSIDE/OUTSIDE CORNER COVERS AT THE 90° CORNERS.

1 CEILING
SCALE: N.T.S.

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D'ANGELO
P.C.

ARCHITECTS
PLANNERS

PROJECT TITLE

PARK AVENUE DISTRICT - RYE UNION FREE SCHOOL DISTRICT
PARK AVENUE ELEMENTARY SCHOOL OFFICE ALTERATIONS
KING STREET ELEMENTARY SCHOOL LIBRARY ALTERATION
EDISON ELEMENTARY SCHOOL OFFICE ALTERATIONS
PORT CHESTER MIDDLE SCHOOL CLASSROOM ALTERATIONS

DRAWING TITLE



DOOR SCHEDULE, TYPES AND DETAILS
FINISH SCHEDULE LEGEND,
FINISH SCHEDULE & DETAILS

06-08-2021	B I D
DATE	ISSUED TO
SHEET SIZE 30"x42"	DRAWING NO. A-700
SCALE AS NOTED	
DRAWN BY F & D	FILE NO. 21430.00

SCHEDULE OF DUCTLESS HEAT PUMP SPLIT SYSTEMS									
INDOOR AIR HANDLER INFORMATION						OUTDOOR CONDENSING UNIT INFORMATION			
GENERAL DATA		SUPPLY FAN DATA		COOLING	HEATING	GENERAL INFO.		ELECTRICAL INFORMATION	
MARK	MODEL No. ①	CFM	ELECTRIC SERVICE	(MBH)	(MBH)	MARK	MODEL No. ①	V/PH/Hz	TOTAL MCA (AMPS)
HP 1	40MBQ809C-3	380	208/1/60	9.0	10.0	CU 1	38MQ809-3	208/230 /1/60	15
HP 2						CU 2			
HP 3						CU 3			
HP 4						CU 4			
HP 5						CU 5			
NOTES						REMARKS			
① AS MANUFACTURED BY "CARRIER".						REFER TO ②③④⑤⑥⑦			
② INSTALL PER MANUFACTURER'S RECOMMENDATIONS.									
③ PROVIDE INDOOR UNITS WITH OUTDOOR AIR CONNECTION									
④ CABINET SHALL HAVE KNOCK-OUT ON SIDE PANEL FOR PROVISIONS FOR OUTDOOR AIR.									
⑤ PROVIDE PROGRAMMABLE THERMOSTAT AND WIRED REMOTE CONTROL.									
⑥ PROVIDE ALL CONTROLS, BMS INTEGRATION, REFRIGERATION SPECIALTIES, SENSORS, CONDENSATE PUMPS, FILTER RACKS AND EXTERNAL VIBRATION ISOLATION.									
⑦ INSECT SCREEN FOR AIR INTAKE.									

MARK	SERVICE	LOCATION	TYPE	MODEL No. ①	CFM	RPM	ELECTRIC SERVICE	REMARKS
EF 1	PARK OFFICE-1	CEILING	IN-LINE	SP-APO511W	110	934	115	②③④
EF 2	PARK OFFICE-2							
EF 3	JFK OFFICE-1							
EF 4	JFK OFFICE-2							
N ① AS MANUFACTURED BY "GREENHECK".								
O ② INSTALL PER MANUFACTURER'S RECOMMENDATIONS.								
T ③ PROVIDE MOTION AND CO2 SENSOR.								
E ④ PROVIDE C.U. WITH SNOW/ WIND GUARD AT FAN INTAKE AND DISCONNECT SWITCHES.								
S ⑤ COORDINATE LOCATION OF FENCE ENCLOSURE WITH SPACE REQUIRED TO SERVICE THE CONDENSING UNIT.								
⑥ PROVIDE WALL CAP WITH BUILT-IN DAMPER								

MECHANICAL LEGEND	
	EXISTING DUCTWORK, EQUIPMENT, ETC. TO REMAIN
	EXISTING DUCTWORK, EQUIPMENT, ETC. TO BE REMOVED
	NEW DUCTWORK
	NEW DUCTWORK (WITH ACCESS DOOR)
	NEW DUCTWORK (WITH ACCESS DOOR AND DIFFUSER)
	EXISTING REGISTER/DIFFUSER IDENTIFICATION
	EXISTING REGISTER/DIFFUSER IDENTIFICATION
	SQUARE DUCT TURN WITH TURNING VANES
	EXISTING 4-WAY CEILING DIFFUSER
	EXISTING CEILING REGISTER
	NEW 4-WAY CEILING DIFFUSER
	NEW 3-WAY CEILING DIFFUSER
	CEILING EXHAUST/RETURN REGISTER
	DUCT MTD. MANUAL AIR VOLUME DAMPER (W/LOCKING DEVICE)
	MOTORIZED AIR VOLUME DAMPER (WITH ACCESS DOOR)
	FIRE DAMPER (U.L. APPROVED) & ACCESS DOOR
	EXISTING HOT WATER SUPPLY PIPING
	EXISTING HOT WATER RETURN PIPING
	NEW HOT WATER SUPPLY PIPING
	NEW HOT WATER RETURN PIPING
	FLOW DIRECTION WITHIN PIPE
	SHUT OFF VALVE
	EXISTING EXHAUST FAN IDENTIFICATION
	EXISTING CABINET HEATER IDENTIFICATION
	NEW CABINET HEATER IDENTIFICATION
	EXISTING FINNED TUBE RADIATION IDENTIFICATION
	NEW DDC WALL MTD. (5'-2"+/- A.F.F.) TEMPERATURE SENSOR
	EXISTING PNEUMATIC THERMOSTAT
	EXISTING DDC SENSOR
	NEW THERMOSTAT
	POINT OF DISCONNECTION
	POINT OF CONNECTION, NEW TO EXISTING
	DOOR UNDERCUT BY C.C.
	LOW DOOR LOUVER BY C.C.
	CFM CUBIC FEET PER MINUTE
	CD CEILING DIFFUSER
	CR CEILING REGISTER
	BR BOTTOM WALL REGISTER
	TR TOP WALL REGISTER
	FSC FULL SIZE CONNECTION
	AFF ABOVE FINISHED FLOOR
	OAI OUTSIDE AIR INTAKE
	FC FLEXIBLE CONNECTION
	AD ACCESS DOOR
	TO ITEM CONTROLLED WALL MOUNTED (5'-2" AFF) TEMPERATURE SENSOR
	SECTION/DETAIL/ELEVATION/PART PLAN NUMBER
	SECTION/ELEVATION IDENTIFICATION
	(E) EXISTING TO REMAIN
	(ER) EXISTING TO BE RELOCATED
	(R) REMOVE EXISTING

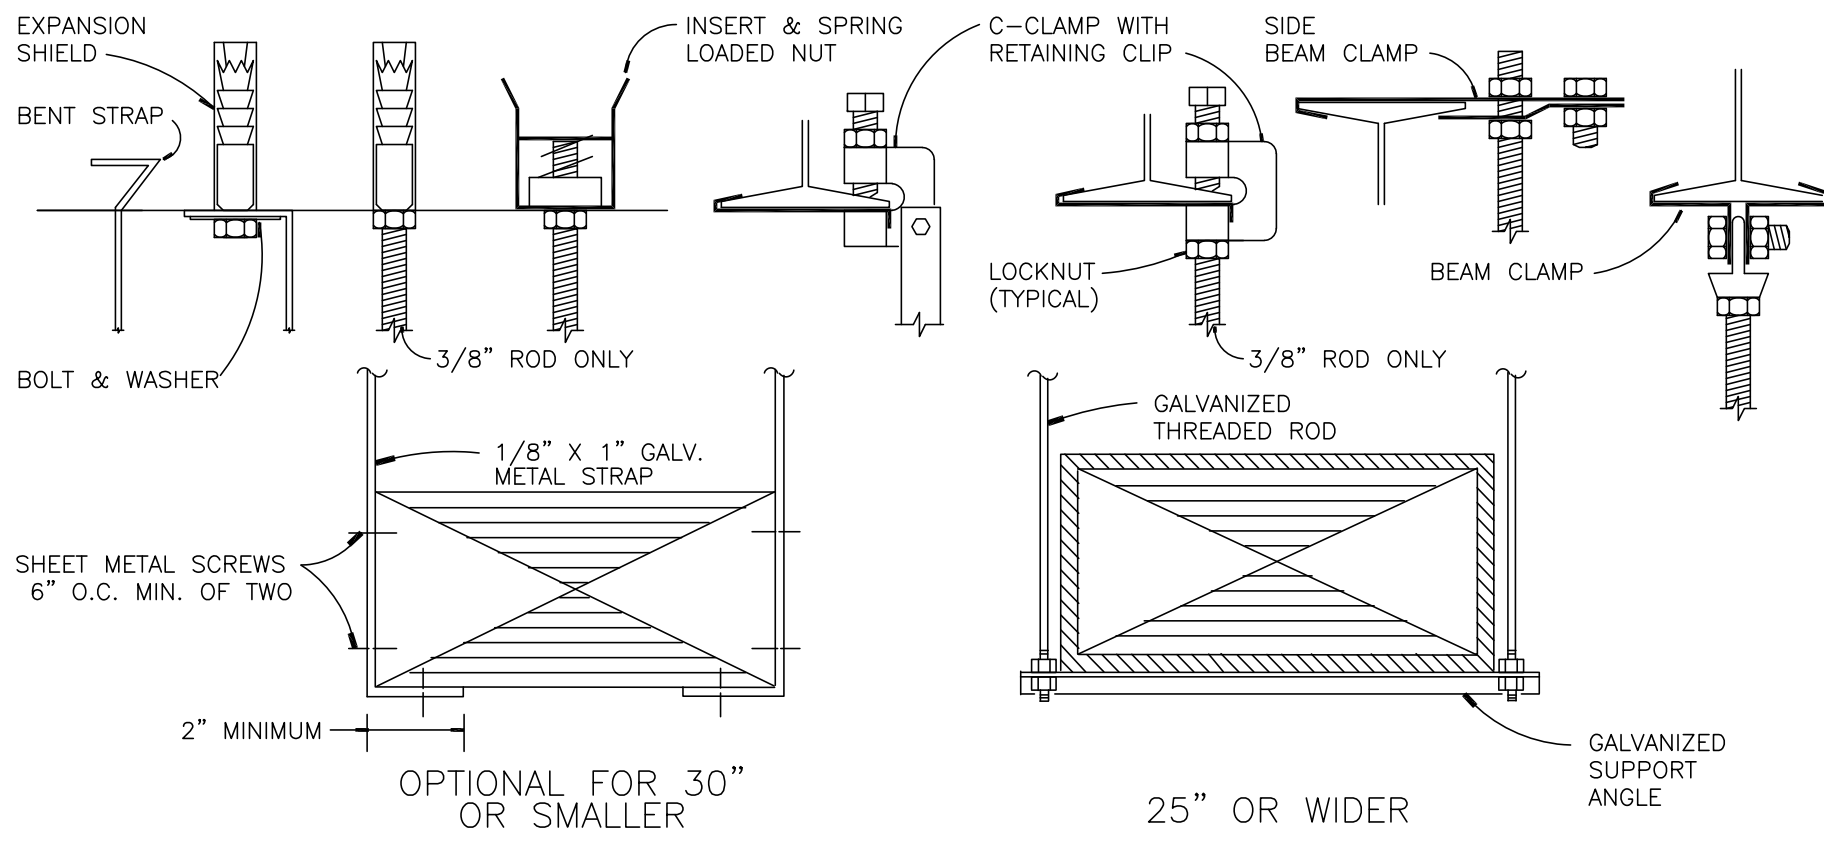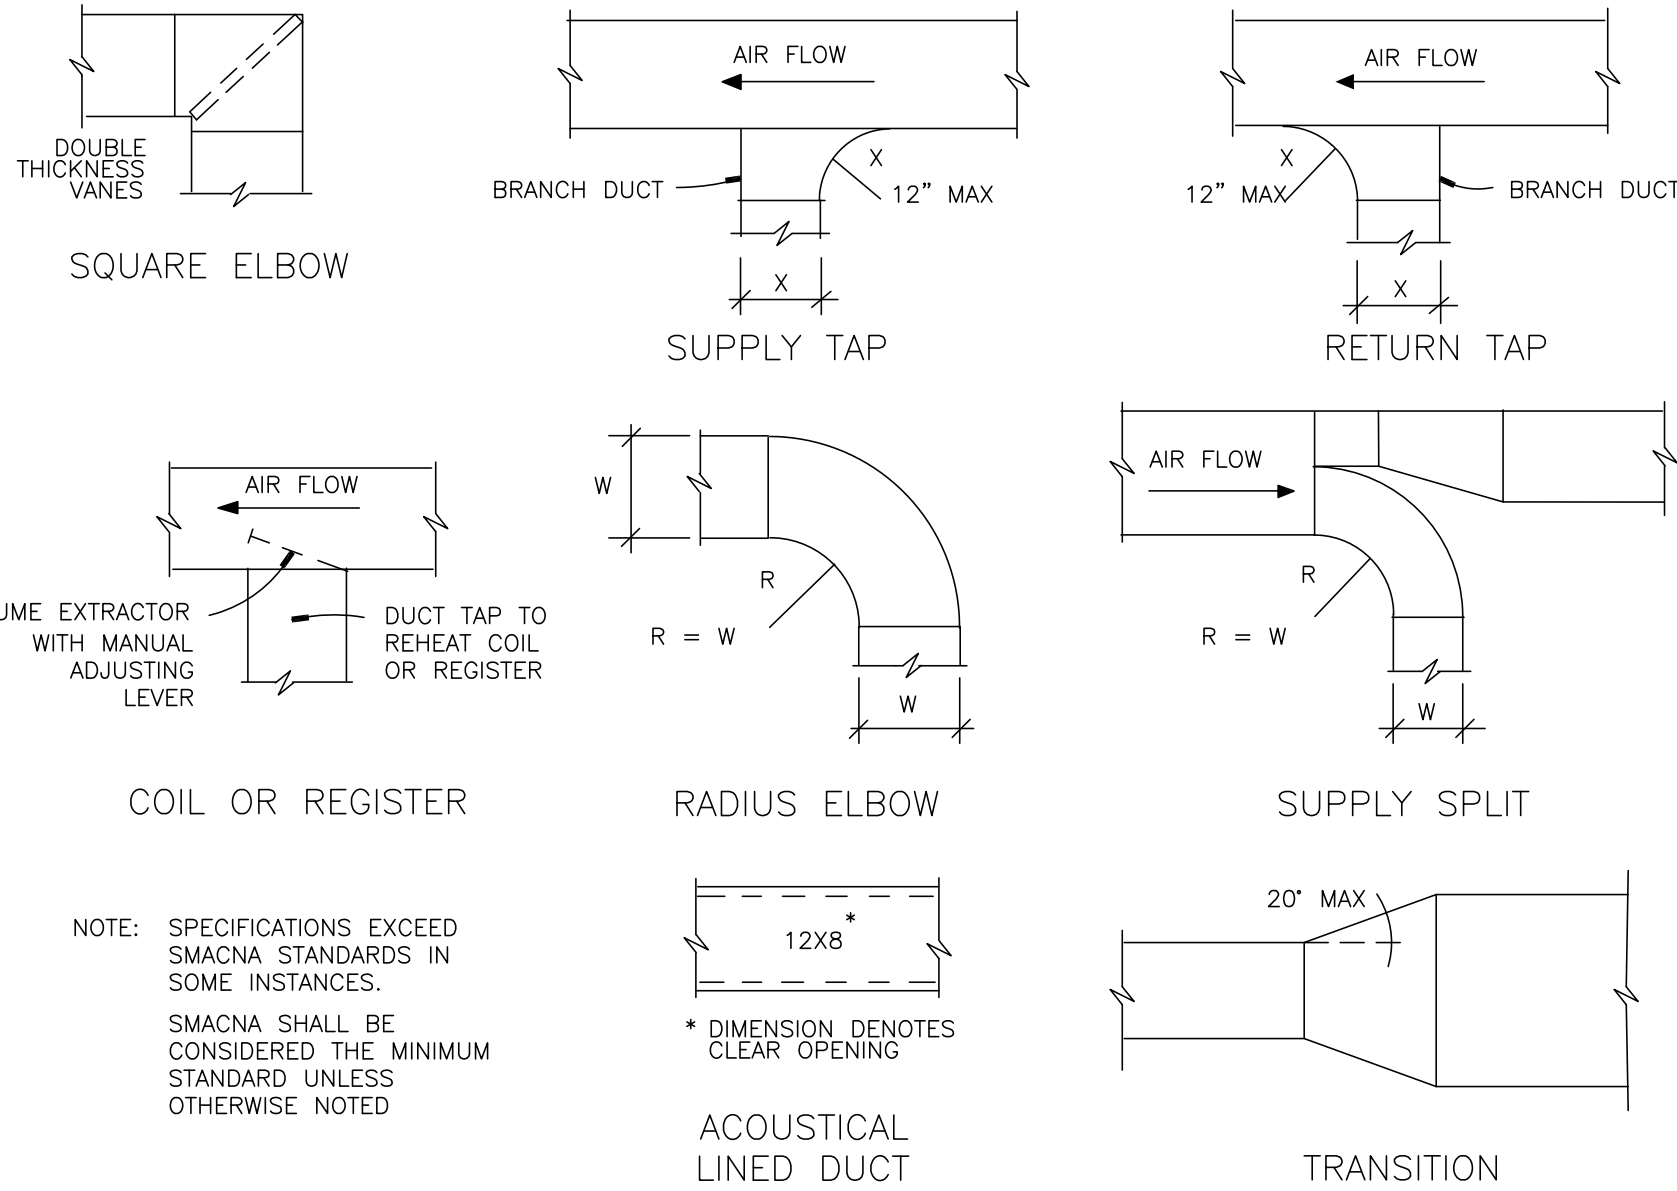

DUCT WIDTH	ROD DIA.	SUPPORT ANGLE OR EQUIV. CHANNEL	MAXIMUM SPACING	MAXIMUM AREA *
25" TO 30"	3/8"	1 1/2" X 1 1/2" X 1/8"	8'-0" O.C.	4 SQ. FT.
31" TO 42"	3/8"	1 1/2" X 1 1/2" X 1/8"	6'-0" O.C.	10 SQ. FT.
43" TO 60"	1/2"	1 1/2" X 1 1/2" X 1/8"	6'-0" O.C.	10 SQ. FT.
61" TO 84"	1/2"	2" X 2" X 1/4"	4'-0" O.C.	-----
85" AND UP	1/2"	2" X 2" X 1/4"	4'-0" O.C.	-----

* REDUCE SPACING TO NEXT SMALLER INTERVAL IF DUCT AREA EXCEEDS MAXIMUM

B DUCT SUPPORT DETAIL

SCALE: N.T.S.

PLUMBING REMOVAL NOTES

- REMOVE SINK AS INDICATED, INCLUDING BUT NOT LIMITED TO EQUIPMENT, SPECIALTIES, DRAINS, CONTROLS, HANGERS, BASES, SUPPORTS, PIPING, VALVES, TUBING AND PLUMBING ACCESSORIES THAT ARE NOT INCORPORATED IN THE NEW LAYOUT.
- WHERE REMOVAL IS INDICATED OR IMPLIED OR NOT INCORPORATED IN THE NEW LAYOUT, THE ITEM ITSELF IS TO BE REMOVED COMPLETELY TOGETHER WITH ALL CONNECTING PIPING, SPECIALTIES, SUPPORTS, CONTROLS, ETC. CONNECTING PIPING IS TO BE REMOVED BACK TO MAINS WHERE THEY ARE TO BE CAPPED OR DISCONNECTED. THIS INCLUDES ALL SANITARY, VENT, WATER, DISCHARGE PIPING. REFER TO DIVISION 1 OF SPECIFICATION FOR CUTTING AND PATCHING REQUIREMENTS.
- WHERE EXISTING PIPING ENTERS INACCESSIBLE TRENCHES, TUNNELS, SHAFTS, WALLS AND CEILINGS INSIDE THE EXISTING BUILDING, IT SHALL BE CUT BACK AT LEAST 2' INTO SUCH INACCESSIBLE SPACES AND SHALL BE SUITABLY CAPPED AND SEALED BY THE CONTRACTOR.
- THE CONTRACTOR SHALL EXERCISE NORMAL CAUTION TO PREVENT UNNECESSARY CUTTING AND DAMAGE TO THE EXISTING BUILDING. ANY EXCESSIVE DAMAGE AS DETERMINED BY THE OWNER SHALL BE REPAIRED AND PAID FOR BY THE CONTRACTOR CAUSING THE DAMAGE.
- ALL DEMOLISHED EQUIPMENT ETC. EXCEPT THOSE ITEMS SPECIFICALLY REQUESTED BY THE OWNER SHALL BECOME THE CONTRACTOR'S PROPERTY, SHALL BE REMOVED FROM THE PREMISES, AND DISPOSED OF LEGALLY.

MECHANICAL REMOVAL NOTES:

- THE SCOPE OF REMOVAL SHOWN ON "REMOVALS" DRAWINGS IS DIAGRAMMATIC ONLY AND INDICATES THE INTENT OF THE WORK TO BE PERFORMED AND NOT THE COMPLETE SCOPE OF DEMOLITION AND/OR REMOVAL WORK. IT SHALL BE THE RESPONSIBILITY OF THIS CONTRACTOR TO REMOVE ANY RELATED MECHANICAL DEVICES EVEN IF NOT SPECIFICALLY INDICATED TO BE REMOVED ON THESE DRAWINGS IN ORDER TO ACCOMMODATE NEW WORK.
- DEVICES SHOWN CROSS HATCHED ON DRAWINGS ARE ITEMS TO BE REMOVED. ANY DEVICES REMOVED SHALL INCLUDE (BUT SHALL NOT BE LIMITED TO) THE REMOVAL OF ALL ASSOCIATED PIPING, CONTROLS, ETC. THAT ARE NOT INCORPORATED IN THE NEW LAYOUT. UNTIL SUCH REMOVAL IS COMPLETE, THIS CONTRACTOR SHALL PERFORM ALL WORK REQUIRED TO INSURE CONTINUITY OF SERVICE TO EXISTING REMAINING EQUIPMENT. NO EXTRAS RELATING TO THE SCOPE OF WORK DESCRIBED WILL BE ALLOWED.
- EQUIPMENT, PIPING, ETC., REQUIRED TO RECONNECT SHALL BE INSTALLED CONCEALED WITHIN THE NEW SUSPENDED CEILINGS, PARTITIONS AND/OR WALLS, FLOORS, NO SURFACE MOUNTED OR EXPOSED EQUIPMENT, PIPING, ETC., SHALL BE PERMITTED, UNLESS SPECIFICALLY INDICATED.
- ALL ITEMS TO BE REMOVED SHALL BE REVIEWED WITH THE OWNER PRIOR TO REMOVAL. OWNER SHALL HAVE FIRST SALVAGE RIGHTS. ITEMS THE OWNER WISHES TO KEEP SHALL BE REMOVED WITH CARE AND STORED AS DIRECTED BY OWNER. ITEMS THE OWNER DOES NOT WISH TO KEEP SHALL BE REMOVED FROM THE SITE AND DISPOSED OF PROPERLY.

WORK SCOPE NOTES - KEYED

- WS1 MODIFY OPENING AND EXTEND DUCT TO NEW EXHAUST AIR GRILL MOUNTED IN SUSPENDED CEILING AND CENTERED IN TILE. REFER TO ARCHITECTURAL REFLECTED CEILING PLAN AND SPECIFICATIONS.
- WS2 MODIFY AND EXTEND EXISTING DUCTWORK FROM DUCT TO NEW REGISTER/DIFFUSER LOCATIONS
- WS3 PROVIDE NEW SUPPLY DUCT WORK INCLUDING INSULATION AND 2'X2' DIFFUSERS TO MATCH EXISTING.

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ARCHITECTS
PLANNERS

PROJECT TITLE
PORT CHESTER - RYE UNION FREE SCHOOL DISTRICT
KING STREET ELEMENTARY SCHOOL LIBRARY ALTERATIONS
JOHN KENNEDY ELEMENTARY SCHOOL OFFICE ALTERATIONS
PORT CHESTER MIDDLE SCHOOL CLASSROOM ALTERATIONS
DRAWING TITLE
MECHANICAL LEGENDS, NOTES AND
SCHEDULES
PLANS


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DATE ISSUED TO

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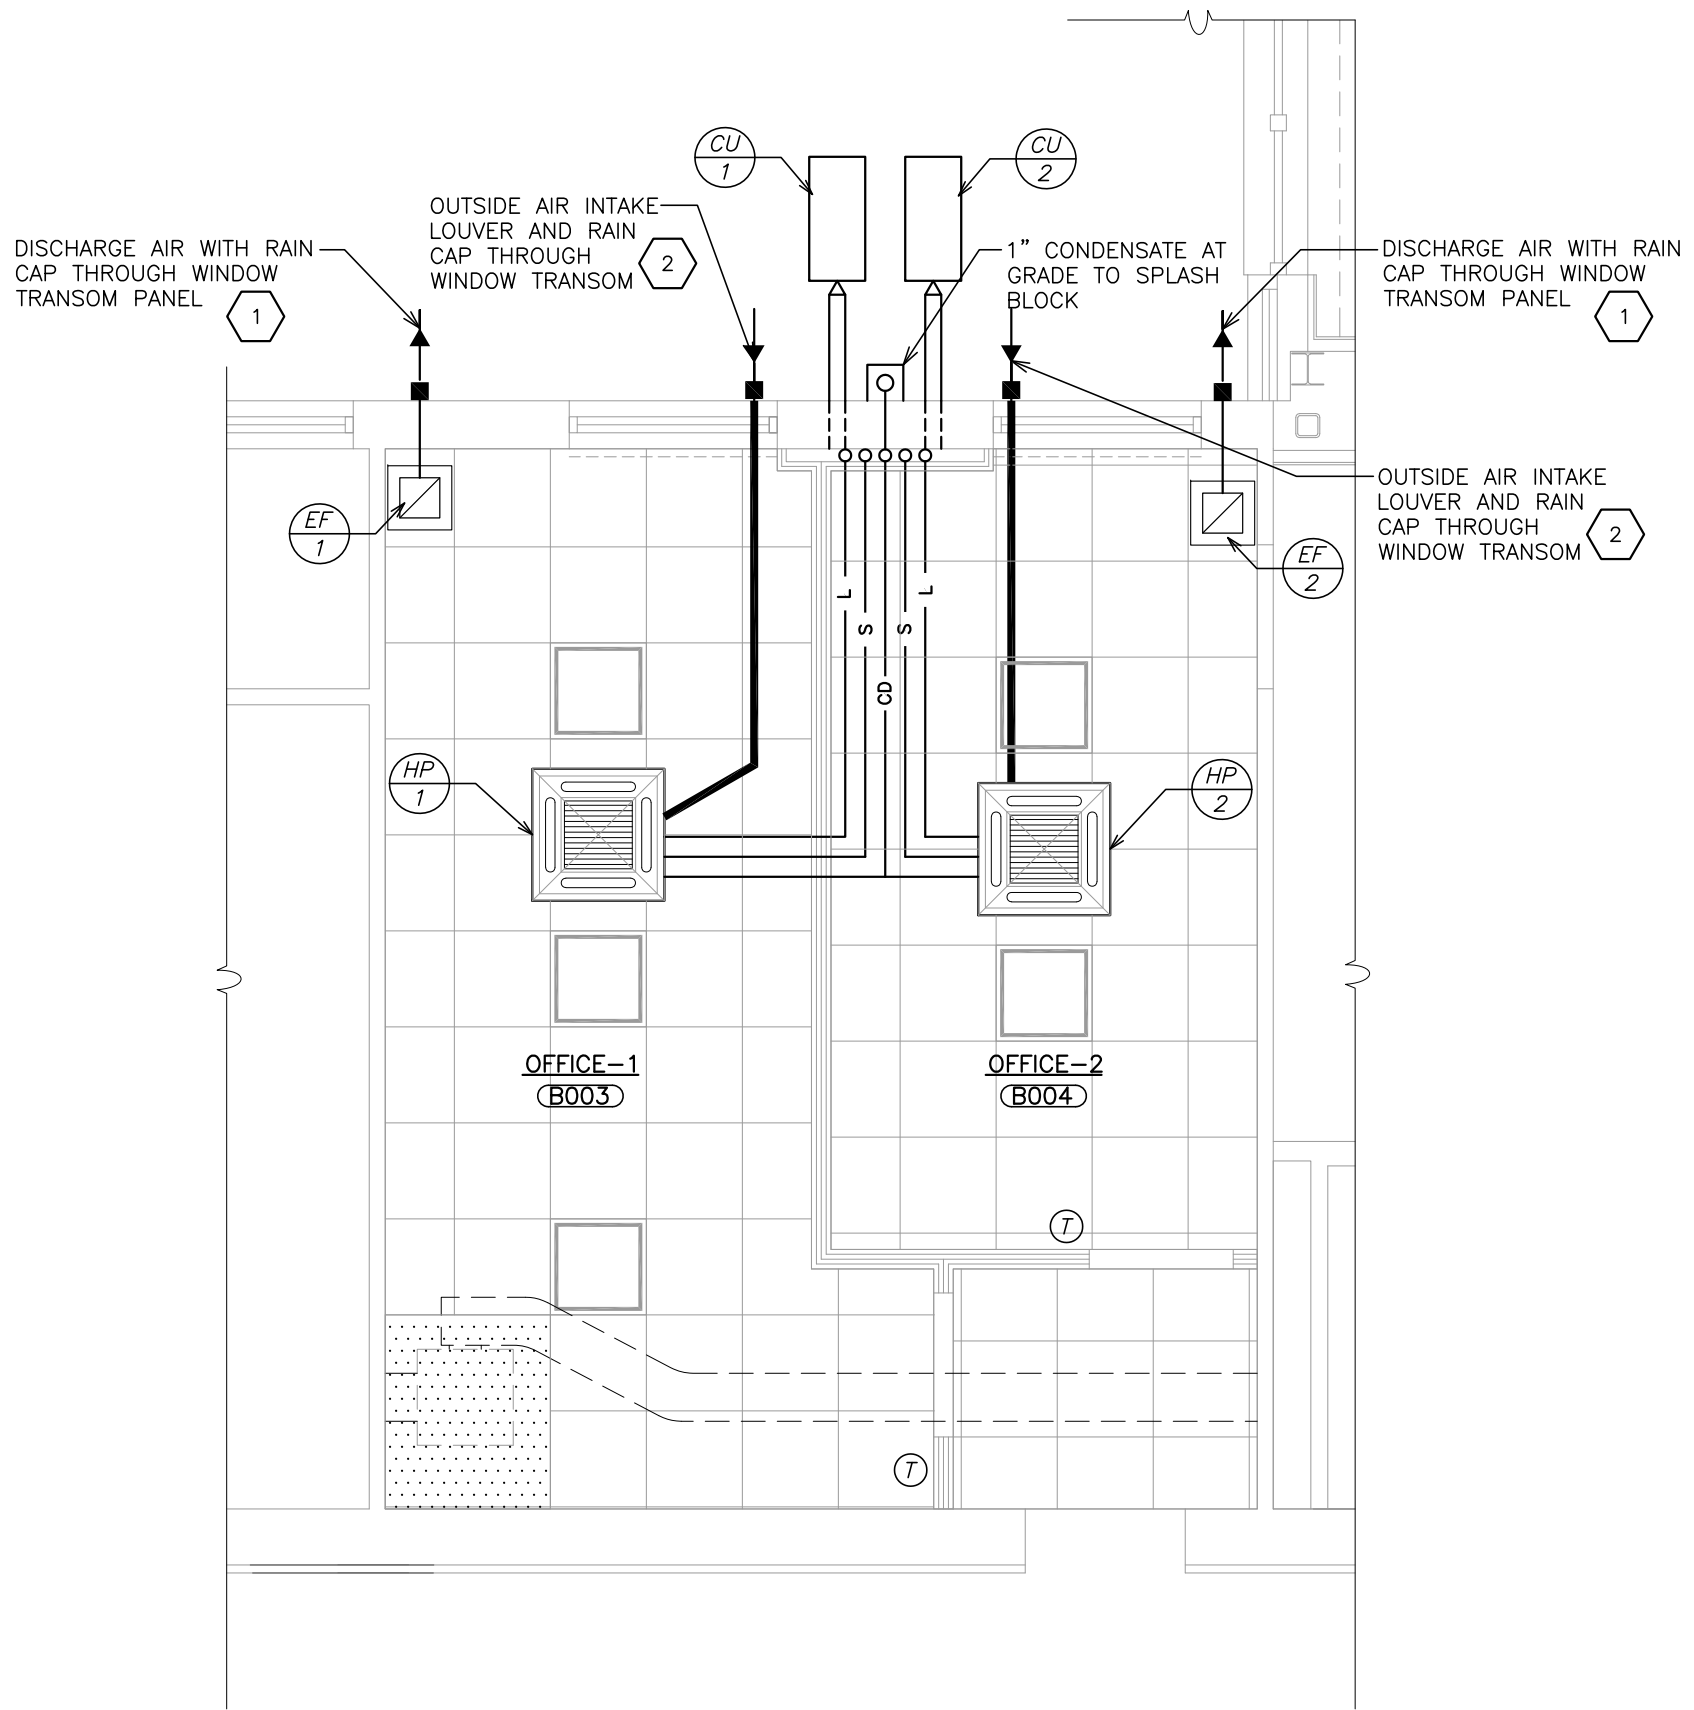
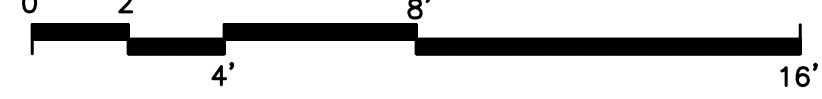
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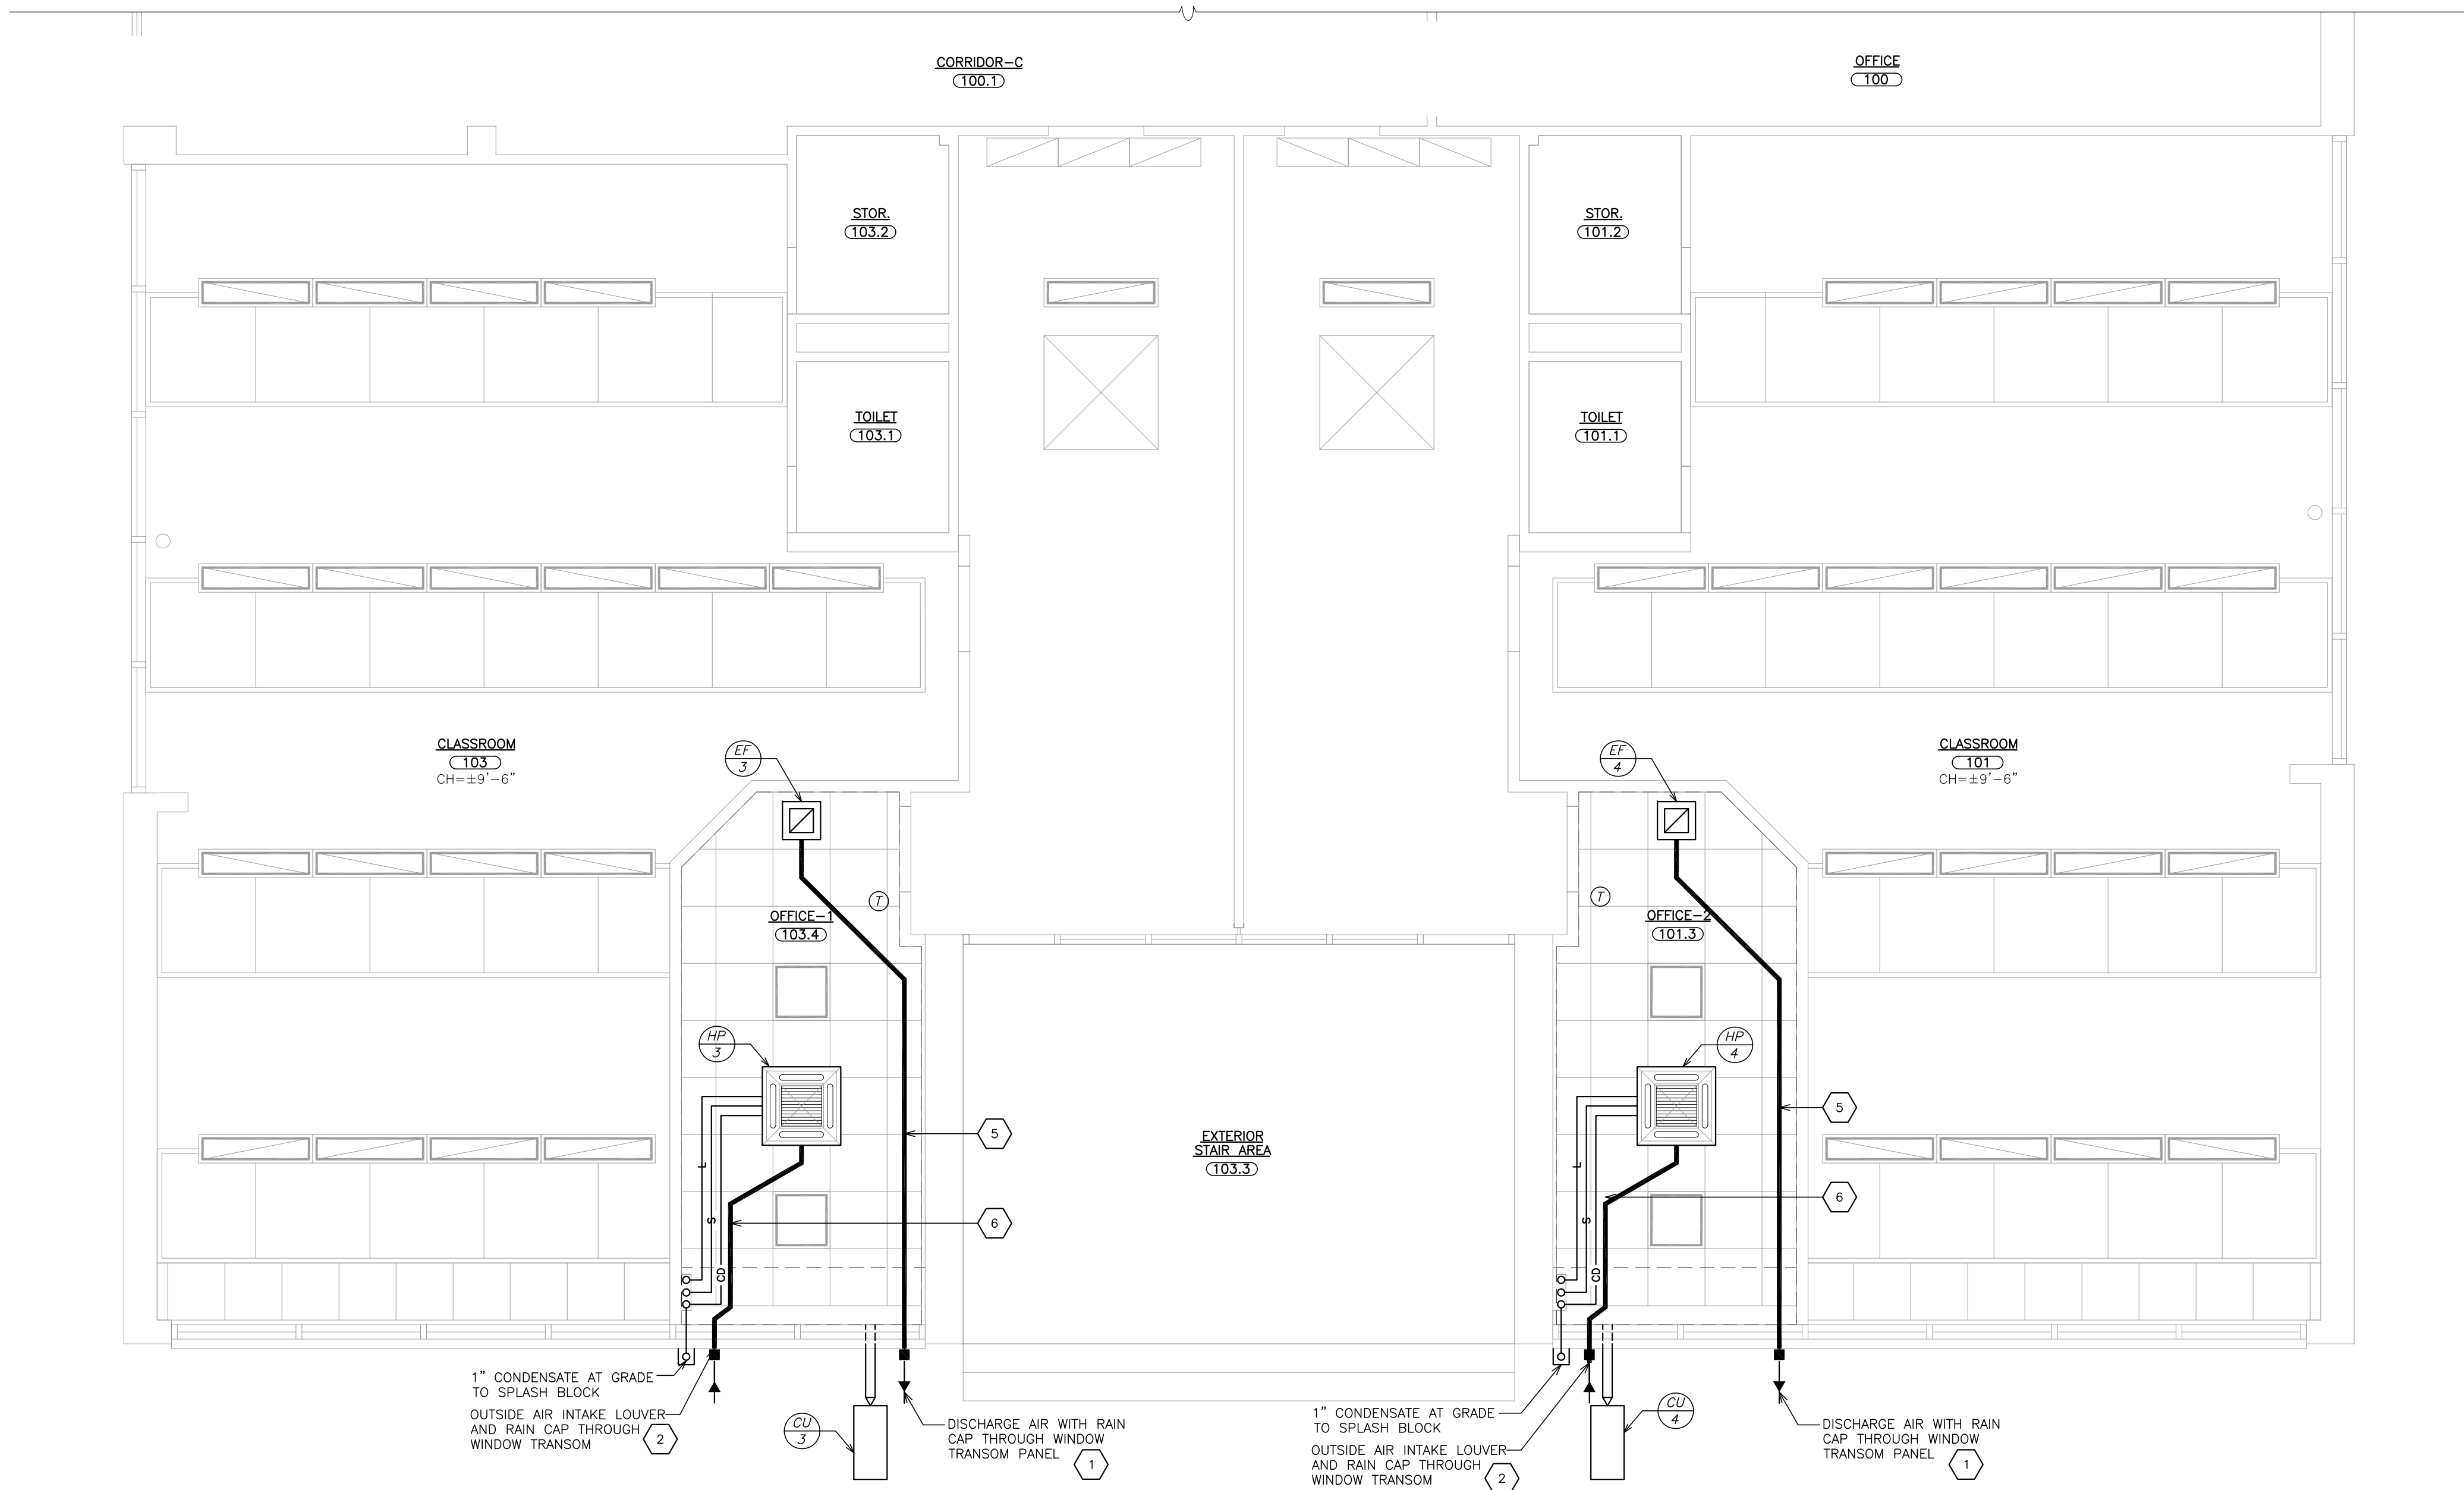
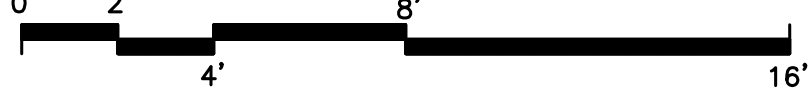
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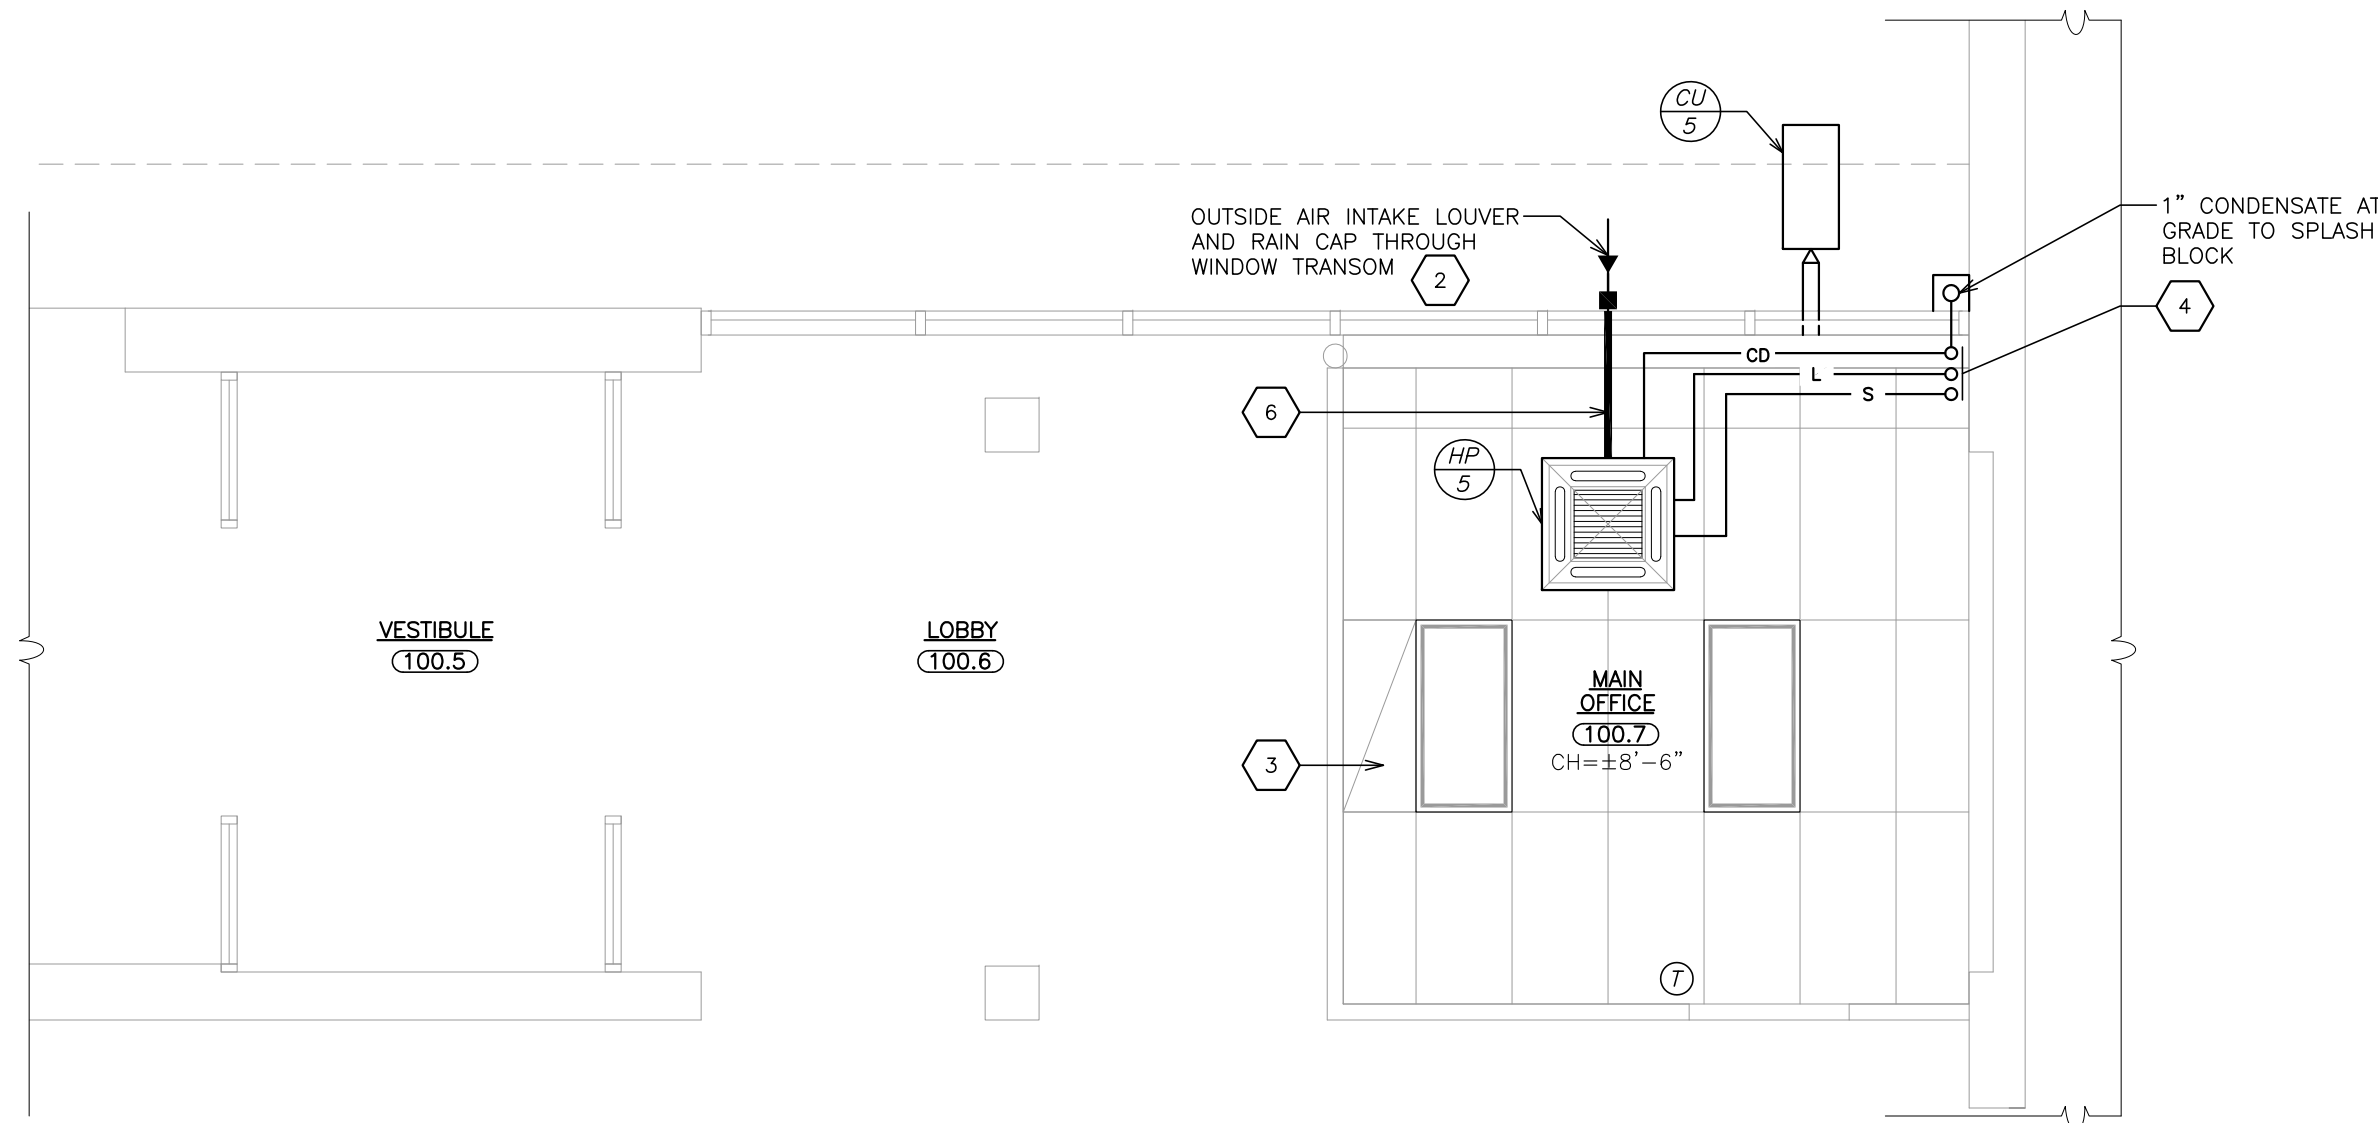
1 PARK AVE. ELEMENTARY SCHOOL
EXISTING/ REMOVAL PLAN
SCALE: 1/4" = 1'-0"




2 PARK AVE. ELEMENTARY SCHOOL
REFLECTED CEILING PLAN
SCALE: 1/4" = 1'-0"

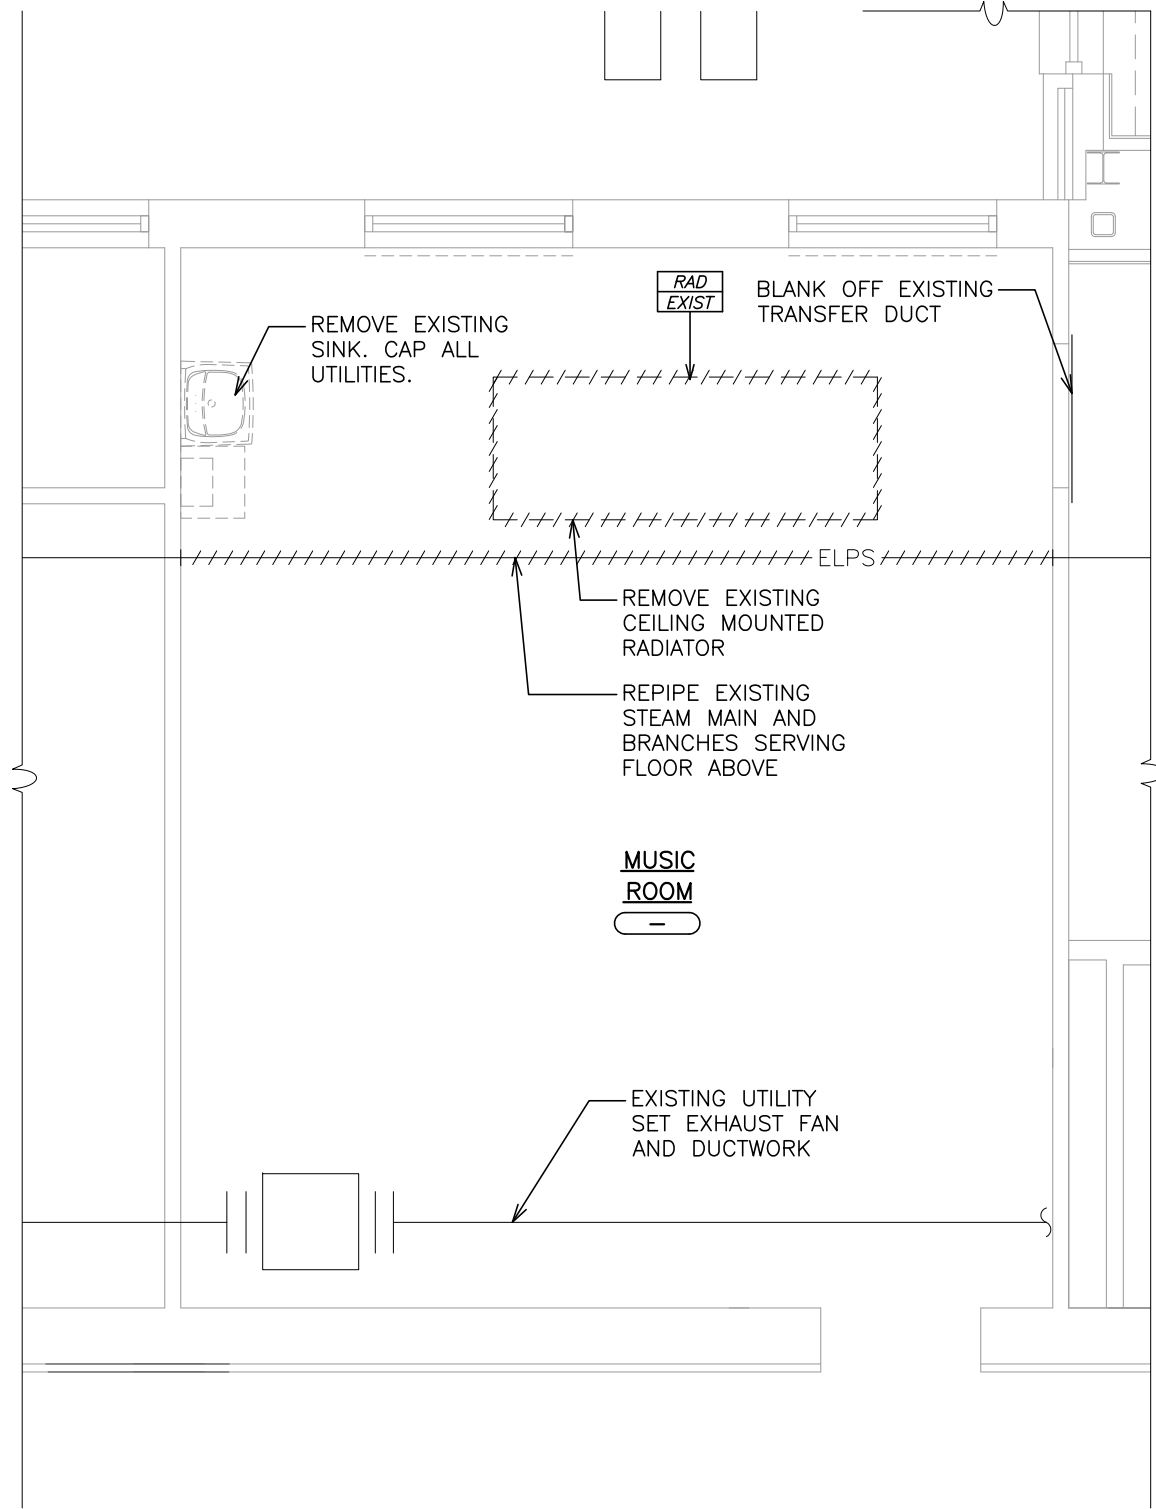


3 JOHN F. KENNEDY PRIMARY SCHOOL
REFLECTED CEILING PLAN
SCALE: 1/4" = 1'-0"



4 JOHN F. KENNEDY PRIMARY SCHOOL
REFLECTED CEILING PLAN
SCALE: 1/4" = 1'-0"

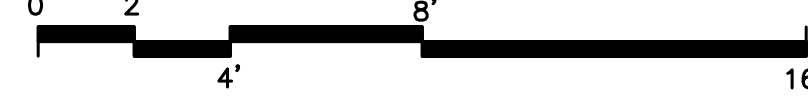

- WORKSCOPE NOTES**
- 1 MAINTAIN MAXIMUM DISTANCE BETWEEN EXHAUST FAN DISCHARGE AND HEAT PUMP AIR INTAKE. INSTALL DISCHARGE GRILLE THROUGH WINDOW TRANSOM. TRANSITION AS REQUIRED FROM FAN TO TRANSOM.
 - 2 INSTALL INTAKE THROUGH EXISTING WINDOW TRANSOM. TRANSITION AS REQUIRED FROM UNIT TO TRANSOM.
 - 3 EXISTING EXHAUST.
 - 4 PROVIDE PVC LINE SET COVER.
 - 5 RUN DUCT AND PIPING BELOW EXISTING CEILING AND ABOVE NEW CEILING. TRANSITION FROM FAN AS REQUIRED. SUPPORT FROM CONCEALED TEE OF CEILING.
 - 6 RUN DUCT AND PIPING BELOW EXISTING CEILING AND ABOVE NEW CEILING. TRANSITION FROM HP AS REQUIRED. SUPPORT FROM CONCEALED TEE OF CEILING.

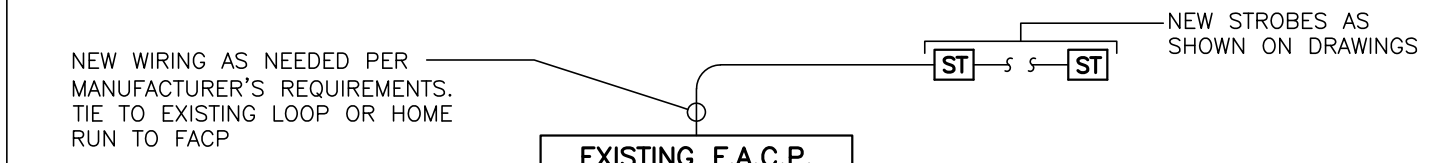

JF-K - PRIMARY

LOCATED IN BOILER ROOM

FIRE ALARM RISER DIAGRAM - JF-K

FIRE ALARM GENERAL NOTES:

- FIRE ALARM WIRING DIAGRAMS SHOWN ARE FOR GENERAL ARRANGEMENT ONLY. ELECTRICAL CONTRACTOR SHALL VERIFY AND OBTAIN POINT TO POINT WIRING DIAGRAM PRIOR TO INSTALLATION FROM MANUFACTURER.
 - PERMITS AND APPROVALS NECESSARY FOR INSTALLATION OF THE WORK SHALL BE OBTAINED PRIOR TO THE COMMENCEMENT OF THE WORK. ALL PERMIT COSTS AND INSPECTION FEES SHALL BE INCLUDED AS PART OF THIS CONTRACT.
 - IN AREAS WHERE DUST AND DIRT WILL BE AIRBORNE DURING DEMOLITION AND CONSTRUCTION THE CONTRACTOR SHALL PROVIDE PLASTIC WRAP OVER SMOKE DETECTORS AND THEN REMOVE ONCE SPACE IS CLEAN.
 - UNLESS DIRECTED OTHERWISE BY FIRE ALARM SYSTEM MANUFACTURER, FIRE ALARM DEVICE WIRING SHALL BE AS FOLLOWS (FOR BIDDING PURPOSES ONLY):
 - BELL WIRING - #16 AWG TESTED
 - STROBE WIRING - #14 AWG TWISTED
 - SIGNAL WIRING - #14 AWG TWISTED/SHIELDED
- THE WIRING SHALL HAVE THE FOLLOWING CHARACTERISTICS:
- MINIMUM TEMPERATURE RATING OF 150 °C
 - MINIMUM AVERAGE INSULATION THICKNESS OF 15 MILS
 - MINIMUM AVERAGE JACKET THICKNESS OF 25 MILS
 - THE COLOR OF THE CABLE SHALL BE RED
 - THE CABLE SHALL BE A TYPE FPLP (PLENUM TYPE) WHEN CONDUIT IS USED
 - SEE NOTE 5 FOR ADDITIONAL CLARIFICATION
 - THE CABLE SHALL BE VISIBLY MARKED EXTERNALLY THAT IT MEETS THE ABOVE REQUIREMENTS AND IS LISTED BY UL
- CONFIRM WIRING TYPE AND QUANTITY WITH FIRE ALARM SYSTEM MANUFACTURER PRIOR TO PURCHASING.

1 FIRE ALARM RISER DIAGRAM


SCALE: N.T.S.

GENERAL LIGHTING NOTES:

- DRAWINGS ARE DIAGRAMMATIC AND INDICATE THE GENERAL ARRANGEMENT OF SYSTEMS AND WORK. CONTRACTOR SHALL FURNISH ALL NECESSARY OUTLETS, SUPPORTS, FITTINGS AND ACCESSORIES TO FULFILL APPLICABLE CODES, REGULATIONS, BUILDING STANDARDS AND THE BEST PRACTICES OF THE TRADE FOR FIRST CLASS ELECTRICAL INSTALLATION.
- THE DRAWINGS INDICATE SIZE AND GENERAL LOCATION OF WORK. SCALED DIMENSIONS SHALL NOT BE USED. THE EXACT LOCATION AND ELEVATION OF ALL ELECTRICAL EQUIPMENT SHALL BE COORDINATED IN FIELD WITH RESPECTIVE CONTRACTOR/OWNER.
- WHERE PANELBOARDS, SWITCHES, CIRCUIT BREAKERS, ETC. ARE EXISTING AND TO BE REUSED THE CONTRACTOR SHALL CLEAN AND REPAIR THE EQUIPMENT. THIS SHALL INCLUDE TIGHTENING ALL CONNECTIONS, REPLACING DEFECTIVE MECHANISMS AND PROVIDING ALL REQUIRED AND NECESSARY MISCELLANEOUS COMPONENTS SO THAT THE EQUIPMENT SHALL BE IN PERFECT WORKING ORDER.
- THE CONTRACTOR SHALL COORDINATE WITH THE OWNER PRIOR TO SUBMISSION OF BID TO DETERMINE WHAT WORK MUST BE PERFORMED AFTER NORMAL BUSINESS HOURS, UNLESS OTHERWISE DIRECTED ANY NOISY WORK (CHOPPING, CORE DRILLING, HAMMERING, ETC.) AND BUILDING POWER INTERRUPTIONS SHALL BE PERFORMED OUTSIDE OF NORMAL BUSINESS HOURS.
- CONFIRM NORMAL BUSINESS HOURS WITH BUILDING OWNER. NO ADDITIONAL COST WILL BE CHARGED TO OWNER FOR WORK PERFORMED OUTSIDE NORMAL BUSINESS HOURS.
- ALL WORK SHOWN DARK/SOLID ON THE DRAWINGS IS NEW UNLESS OTHERWISE NOTED AND SHOWN DOTTED WITH OR WITHOUT LETTER (E) IS EXISTING TO REMAIN, WITH HATCH LINES WITH OR WITHOUT LETTER (R) IS EXISTING TO BE REMOVED. (ER) MEANS EXISTING TO BE RELOCATED AND (RW) MEANS EXISTING TO BE REPLACED WITH NEW.
- CIRCUIT NUMBERS ARE INDICATED FOR INTENT ONLY. ACTUAL CIRCUIT NUMBERS TO BE USED SHALL BE AS PER FIELD CONDITIONS BY UTILIZING SPARE CIRCUITS BREAKERS OR SPACES IN EXISTING PANEL, SIZE AS INDICATED ON THE PLANS. THE ELECTRICAL CONTRACTOR SHALL BALANCE LOAD OF CIRCUITS EVENLY ON ALL PHASES.
- FEEDERS AND BRANCH CIRCUITRY SHALL BE RUN IN CONDUIT MINIMUM #4 CONDUIT UNLESS OTHERWISE NOTED. FINAL CONNECTIONS TO MOTORS MAY BE DONE WITH FLEXIBLE METALLIC CONDUIT (NO LONGER THAN 18"). IN UNFINISHED AREA CONDUIT SHALL BE RUN EXPOSED AND IN FINISHED AREAS CONDUIT SHALL BE RUN CONCEALED.
- PROVIDE PANEL NAME PLATE MADE OF BLACK LAMINATED PLASTIC WITH WHITE ENGRAVED LETTERING AND TYPE WRITTEN DIRECTORY FOR ALL EXISTING PANEL BEING USED FOR THIS PROJECT.
- ALL CONDUCTORS SHALL BE COPPER, TYPE THHN/THWN INSULATED. ALL CONDUCTORS SHALL HAVE 600 VOLT RATED INSULATION UNLESS OTHERWISE NOTED.
- REFER TO ARCHITECT'S REFLECTED CEILING PLAN FOR EXACT LOCATION OF ALL CEILING MOUNTED LIGHTING FIXTURES AND OTHER CEILING INSTALLED ITEMS.
- THE USE OF FLEXIBLE CONDUIT FROM LIGHTING FIXTURES TO JUNCTION BOX IS PERMITTED ONLY WHEN A SEPARATE GROUND WIRE IS INSTALLED WITH THE CONDUCTORS INSIDE FLEXIBLE CONDUIT. THE GROUND WIRE MUST BOND THE FIXTURE HOUSING TO THE JUNCTION BOX. MAXIMUM LENGTH 6'-0".
- EXACT LOCATION AND MOUNTING HEIGHTS OF ALL WIRING DEVICES SHALL BE COORDINATED WITH THE ARCHITECT PRIOR TO THE INSTALLATION.
- WALL MOUNTED EQUIPMENT (SWITCHES, RECEPTACLES, ETC.) SHALL BE SURFACE MOUNTED IN UNFINISHED AREAS AND ON EXISTING CONCRETE BLOCK WALLS.
- CONDUIT RUNS SHALL BE PARALLEL WITH OR AT RIGHT ANGLES TO WALLS AND CEILINGS. CONDUIT SHALL BE SUPPORTED BY APPROVED MEANS. SUPPORTS FOR HORIZONTAL RUNS OF CONDUIT SHALL NOT EXCEED SEVEN FEET ON CENTERS.
- PROVIDE PULL BOXES, JUNCTION BOXES, CONDUIT ELBOWS AND OFFSETS TO SUIT FIELD CONDITIONS AND THE NATIONAL ELECTRICAL CODE.
- THE CONTRACTOR SHALL COORDINATE WITH THE FIRE DEPARTMENT AND F.A. VENDOR BEFORE PROCEEDING WITH WORK INVOLVING FIRE ALARM SYSTEM.
- ALL EMPTY CONDUIT SHALL BE PROVIDED WITH A DRAGWIRE.
- THE MINIMUM WIRE SIZE FOR 120 VOLT BRANCH CIRCUITS SHALL BE NO. 12 AWG, EXCEPT OVER 100' IN LENGTH SHALL BE NO. 10 AWG.
- PROVIDE ALL REQUIRED AND NECESSARY ACCESSORIES (EX. CONNECTORS, ADAPTERS, BUSHINGS, CLAMPS, ETC.) TO FACILITATE COMPLETE INSTALLATION.
- THE ELECTRICAL CONTRACTOR SHALL CONFIRM THE CONFIGURATION TYPE FOR ALL SPECIAL RECEPTACLES FOR X-RAY MACHINE, DATA PROCESSING EQUIPMENT, ETC. WITH OWNER PRIOR TO ORDERING.
- COORDINATE LOCATION OF ALL MECHANICAL EQUIPMENT WITH HVAC CONTRACTOR IN FIELD. FUSES FOR ALL MOTOR LOADS SHALL BE DUAL ELEMENT TIME DELAY TYPE.
- ALL RECEPTACLES SPECIFIED FOR PERSONAL COMPUTERS, LASER PRINTERS AND SIMILAR TYPES OF EQUIPMENT SHALL BE ISOLATED GROUND TYPE COLOR ORANGE AND PROVIDED WITH A SEPARATE NEUTRAL AND GROUND CONDUCTOR. THIS IS TO COMPENSATE FOR HARMONIC CURRENTS. SHARED NEUTRAL CONDUCTORS FOR THESE HOMERUNS ARE NOT PERMITTED.
- ALL JUNCTION OR OUTLET BOXES SHALL BE INSTALLED SO AS TO ALLOW ACCESS TO COVER. PROVIDE ARCHITECT APPROVED ACCESS DOORS OR PLATES AS REQUIRED IN AREAS WHERE UNOBSTRUCTED ACCESS TO BOX OR OUTLET IS NOT POSSIBLE.
- PRIOR TO ORDERING LIGHTING FIXTURES, COORDINATE WITH ARCHITECTURAL DRAWINGS AND SPECIFICATIONS. IF DISCREPANCIES EXIST BETWEEN ARCHITECTURAL AND ENGINEERING INFORMATION OBTAIN CLARIFICATION PRIOR TO PROCEEDING.
- MULTIPLE SWITCHES SHOWN IN SAME LOCATION SHALL BE GANGED TOGETHER WITH A COMMON FACEPLATE.
- ALL LIGHTING FIXTURES UTILIZING ELECTRONIC BALLASTS SHALL BE PROVIDED WITH A DEDICATED NEUTRAL OR AN OVERSIZED NEUTRAL WHEN SHARED.
- ALL EMERGENCY LIGHT FIXTURES DESIGNATED 'EM' SHALL BE SWITCHED UNLESS DESIGNATED WITH 'EM/NL' WHICH INDICATES FIXTURE TO SERVE AS NITE LIGHT AND SHALL NOT BE SWITCHED. PROVIDE UNSWITCHED HOT LEG FOR BATTERY CHARGER REGARDLESS OF FUNCTION. ALL EMERGENCY AND EMERGENCY/NITE LIGHT FIXTURES SHALL REVERT TO BATTERY OPERATION UPON INTERRUPTION OF NORMAL POWER AND ILLUMINATE REGARDLESS OF LIGHT SWITCH POSITION.
- PRIOR TO ANY CHASING, CHOPPING OR CORE DRILLING IS PERFORMED, THE CONTRACTOR SHALL FIELD INVESTIGATE CONDITIONS AND COORDINATE ALL WORK TO ENSURE THAT IT WILL BE IN HARMONY AND NOT AFFECT ANY EXISTING BUILDING T SYSTEMS. THIS WORK MUST BE APPROVED BY BUILDING OWNER PRIOR TO PROCEEDING.
- OPENINGS AROUND ELECTRICAL PENETRATIONS THROUGH FIRE RESISTANCE RATED WALLS, PARTITIONS, FLOORS OR CEILINGS SHALL BE FIRE STOPPED USING APPROVED METHOD. ALL SLEEVES MUST HAVE BUSHINGS. SEALANT SHALL BE 3 HOUR FIRE BARRIER #CP-25 (NO LESS THAN 3" THICK BACKED UP WITH MINERAL WOOL).
- PREPARE 'AS-BUILT' TRACINGS SHOWING ALL CHANGES IN WIRE SIZE, CIRCUIT NUMBERING, CIRCUIT ROUTING, EQUIPMENT LOCATIONS AND ALL ELECTRICAL WORK AS ACTUALLY INSTALLED.
- LIGHT FIXTURES SHALL BE CONSTRUCTED TO SUIT PARTICULAR TYPE OF CEILING AND WALL CONSTRUCTION AND SHALL BE PROVIDED WITH APPROPRIATE TRIMS, MOUNTING FRAMES AND ADAPTERS AS REQUIRED.

GENERAL POWER NOTES:

- REFER TO ARCHITECTURAL DRAWINGS FOR THE EXACT LOCATION AND MOUNTING HEIGHTS OF ALL DEVICES AND OUTLETS.
- RECEPTACLES SHALL BE CIRCUITED IN ACCORDANCE WITH CIRCUIT NUMBER INDICATED ADJACENT TO EACH DEVICE. CIRCUITRY MAY BE SHOWN IN CERTAIN INSTANCES.
- ALL RECEPTACLES SPECIFIED FOR PERSONAL COMPUTERS, LASER PRINTERS AND SIMILAR TYPES OF EQUIPMENT SHALL BE PROVIDED WITH A SEPARATE NEUTRAL AND GROUND CONDUCTOR. SHARED NEUTRAL CONDUCTORS FOR THESE HOMERUNS ARE NOT PERMITTED.
- THE ELECTRICAL CONTRACTOR SHALL CONFIRM THE CONFIGURATION TYPE FOR ALL SPECIAL RECEPTACLES FOR COPIERS, DATA PROCESSING EQUIPMENT, ETC. WITH OWNER AND ENGINEER PRIOR TO ORDERING.
- CIRCUIT NUMBERS ARE INDICATED FOR INTENT ONLY. THE ELECTRICAL CONTRACTOR SHALL ADJUST ACCORDINGLY IN THE FIELD, TO BALANCE THE CIRCUITS EVENLY ON ALL PHASES.
- EXACT LOCATION OF MECHANICAL EQUIPMENT SHALL BE COORDINATED IN THE FIELD.
- ALL WIRING SHALL BE RUN IN EMT CONDUIT. FLEXIBLE CABLE IS NOT ALLOWED.
- MECHANICAL EQUIPMENT IS LOCATED ABOVE THE HUNG CEILING UNLESS OTHERWISE NOTED. EXACT LOCATION SHALL BE DETERMINED FROM MECHANICAL DRAWINGS.
- ALL RECEPTACLES SHALL BE GROUND FAULT INTERRUPTING TYPE.
- ALL CIRCUITS SHALL BE SIZED #12, #10, #8 AND SHALL BE CONNECTED TO A NEW 200-1P CIRCUIT BREAKER IN SOURCE PANEL INDICATED UNLESS OTHERWISE NOTED.
- ALL 120VAC BRANCH CIRCUITS EXCEEDING 100' IN LENGTH SHALL BE INCREASED TO #6, #10, #8 UNLESS OTHERWISE NOTED.
- ALL DEVICES SHALL BE LABELED WITH SOURCE PANEL AND CIRCUIT NUMBER(S).

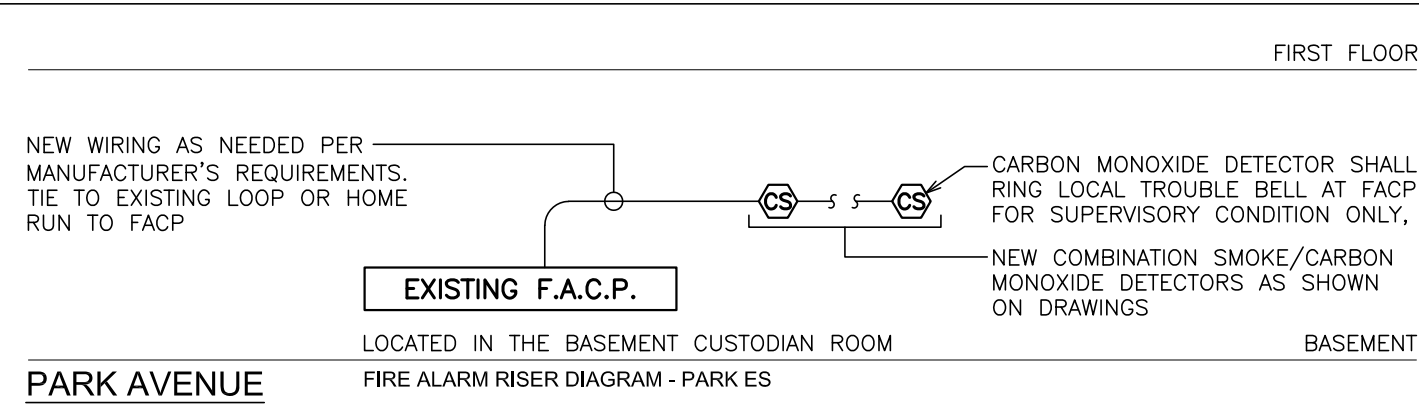

PARK AVENUE



LOCATED IN THE BASEMENT CUSTODIAN ROOM

FIRE ALARM RISER DIAGRAM - PARK AVENUE

GENERAL NOTES:

- DRAWINGS ARE DIAGRAMMATIC AND INDICATE THE GENERAL ARRANGEMENT OF SYSTEMS AND WORK. CONTRACTOR SHALL FURNISH ALL NECESSARY OUTLETS, SUPPORTS, FITTINGS AND ACCESSORIES TO FULFILL APPLICABLE CODES, REGULATIONS, BUILDING STANDARDS AND THE BEST PRACTICES OF THE TRADE FOR FIRST CLASS ELECTRICAL INSTALLATION.
- THE DRAWINGS INDICATE SIZE AND GENERAL LOCATION OF WORK. SCALED DIMENSIONS SHALL NOT BE USED. THE EXACT LOCATION AND ELEVATION OF ALL ELECTRICAL EQUIPMENT SHALL BE COORDINATED IN FIELD WITH RESPECTIVE CONTRACTOR/OWNER.
- WHERE PANELBOARDS, SWITCHES, CIRCUIT BREAKERS, ETC. ARE EXISTING AND TO BE REUSED THE CONTRACTOR SHALL CLEAN AND REPAIR THE EQUIPMENT. THIS SHALL INCLUDE TIGHTENING ALL CONNECTIONS, REPLACING DEFECTIVE MECHANISMS AND PROVIDING ALL REQUIRED AND NECESSARY MISCELLANEOUS COMPONENTS SO THAT THE EQUIPMENT SHALL BE IN PERFECT WORKING ORDER.
- THE CONTRACTOR SHALL COORDINATE WITH THE OWNER PRIOR TO SUBMISSION OF BID TO DETERMINE WHAT WORK MUST BE PERFORMED AFTER NORMAL BUSINESS HOURS, UNLESS OTHERWISE DIRECTED ANY NOISY WORK (CHOPPING, CORE DRILLING, HAMMERING, ETC.) AND BUILDING POWER INTERRUPTIONS SHALL BE PERFORMED OUTSIDE OF NORMAL BUSINESS HOURS.
- CONFIRM NORMAL BUSINESS HOURS WITH BUILDING OWNER. NO ADDITIONAL COST WILL BE CHARGED TO OWNER FOR WORK PERFORMED OUTSIDE NORMAL BUSINESS HOURS.
- ALL WORK SHOWN DARK/SOLID ON THE DRAWINGS IS NEW UNLESS OTHERWISE NOTED AND SHOWN DOTTED WITH OR WITHOUT LETTER (E) IS EXISTING TO REMAIN, WITH HATCH LINES WITH OR WITHOUT LETTER (R) IS EXISTING TO BE REMOVED. (ER) MEANS EXISTING TO BE RELOCATED AND (RW) MEANS EXISTING TO BE REPLACED WITH NEW.
- CIRCUIT NUMBERS ARE INDICATED FOR INTENT ONLY. ACTUAL CIRCUIT NUMBERS TO BE USED SHALL BE AS PER FIELD CONDITIONS BY UTILIZING SPARE CIRCUITS BREAKERS OR SPACES IN EXISTING PANEL, SIZE AS INDICATED ON THE PLANS. THE ELECTRICAL CONTRACTOR SHALL BALANCE LOAD OF CIRCUITS EVENLY ON ALL PHASES.
- FEEDERS AND BRANCH CIRCUITRY SHALL BE RUN IN CONDUIT MINIMUM #4 CONDUIT UNLESS OTHERWISE NOTED. FINAL CONNECTIONS TO MOTORS MAY BE DONE WITH FLEXIBLE METALLIC CONDUIT (NO LONGER THAN 18"). IN UNFINISHED AREA CONDUIT SHALL BE RUN EXPOSED AND IN FINISHED AREAS CONDUIT SHALL BE RUN CONCEALED.
- PROVIDE PANEL NAME PLATE MADE OF BLACK LAMINATED PLASTIC WITH WHITE ENGRAVED LETTERING AND TYPE WRITTEN DIRECTORY FOR ALL EXISTING PANEL BEING USED FOR THIS PROJECT.
- ALL CONDUCTORS SHALL BE COPPER, TYPE THHN/THWN INSULATED. ALL CONDUCTORS SHALL HAVE 600 VOLT RATED INSULATION UNLESS OTHERWISE NOTED.
- REFER TO ARCHITECT'S REFLECTED CEILING PLAN FOR EXACT LOCATION OF ALL CEILING MOUNTED LIGHTING FIXTURES AND OTHER CEILING INSTALLED ITEMS.
- THE USE OF FLEXIBLE CONDUIT FROM LIGHTING FIXTURES TO JUNCTION BOX IS PERMITTED ONLY WHEN A SEPARATE GROUND WIRE IS INSTALLED WITH THE CONDUCTORS INSIDE FLEXIBLE CONDUIT. THE GROUND WIRE MUST BOND THE FIXTURE HOUSING TO THE JUNCTION BOX. MAXIMUM LENGTH 6'-0".
- EXACT LOCATION AND MOUNTING HEIGHTS OF ALL WIRING DEVICES SHALL BE COORDINATED WITH THE ARCHITECT PRIOR TO THE INSTALLATION.
- WALL MOUNTED EQUIPMENT (SWITCHES, RECEPTACLES, ETC.) SHALL BE SURFACE MOUNTED IN UNFINISHED AREAS AND ON EXISTING CONCRETE BLOCK WALLS.
- CONDUIT RUNS SHALL BE PARALLEL WITH OR AT RIGHT ANGLES TO WALLS AND CEILINGS. CONDUIT SHALL BE SUPPORTED BY APPROVED MEANS. SUPPORTS FOR HORIZONTAL RUNS OF CONDUIT SHALL NOT EXCEED SEVEN FEET ON CENTERS.
- PROVIDE PULL BOXES, JUNCTION BOXES, CONDUIT ELBOWS AND OFFSETS TO SUIT FIELD CONDITIONS AND THE NATIONAL ELECTRICAL CODE.
- THE CONTRACTOR SHALL COORDINATE WITH THE FIRE DEPARTMENT AND F.A. VENDOR BEFORE PROCEEDING WITH WORK INVOLVING FIRE ALARM SYSTEM.
- ALL EMPTY CONDUIT SHALL BE PROVIDED WITH A DRAGWIRE.
- THE MINIMUM WIRE SIZE FOR 120 VOLT BRANCH CIRCUITS SHALL BE NO. 12 AWG, EXCEPT OVER 100' IN LENGTH SHALL BE NO. 10 AWG.
- PROVIDE ALL REQUIRED AND NECESSARY ACCESSORIES (EX. CONNECTORS, ADAPTERS, BUSHINGS, CLAMPS, ETC.) TO FACILITATE COMPLETE INSTALLATION.
- THE ELECTRICAL CONTRACTOR SHALL CONFIRM THE CONFIGURATION TYPE FOR ALL SPECIAL RECEPTACLES FOR X-RAY MACHINE, DATA PROCESSING EQUIPMENT, ETC. WITH OWNER PRIOR TO ORDERING.
- COORDINATE LOCATION OF ALL MECHANICAL EQUIPMENT WITH HVAC CONTRACTOR IN FIELD. FUSES FOR ALL MOTOR LOADS SHALL BE DUAL ELEMENT TIME DELAY TYPE.
- ALL RECEPTACLES SPECIFIED FOR PERSONAL COMPUTERS, LASER PRINTERS AND SIMILAR TYPES OF EQUIPMENT SHALL BE ISOLATED GROUND TYPE COLOR ORANGE AND PROVIDED WITH A SEPARATE NEUTRAL AND GROUND CONDUCTOR. THIS IS TO COMPENSATE FOR HARMONIC CURRENTS. SHARED NEUTRAL CONDUCTORS FOR THESE HOMERUNS ARE NOT PERMITTED.
- ALL JUNCTION OR OUTLET BOXES SHALL BE INSTALLED SO AS TO ALLOW ACCESS TO COVER. PROVIDE ARCHITECT APPROVED ACCESS DOORS OR PLATES AS REQUIRED IN AREAS WHERE UNOBSTRUCTED ACCESS TO BOX OR OUTLET IS NOT POSSIBLE.
- PRIOR TO ORDERING LIGHTING FIXTURES, COORDINATE WITH ARCHITECTURAL DRAWINGS AND SPECIFICATIONS. IF DISCREPANCIES EXIST BETWEEN ARCHITECTURAL AND ENGINEERING INFORMATION OBTAIN CLARIFICATION PRIOR TO PROCEEDING.
- MULTIPLE SWITCHES SHOWN IN SAME LOCATION SHALL BE GANGED TOGETHER WITH A COMMON FACEPLATE.
- ALL LIGHTING FIXTURES UTILIZING ELECTRONIC BALLASTS SHALL BE PROVIDED WITH A DEDICATED NEUTRAL OR AN OVERSIZED NEUTRAL WHEN SHARED.
- ALL EMERGENCY LIGHT FIXTURES DESIGNATED 'EM' SHALL BE SWITCHED UNLESS DESIGNATED WITH 'EM/NL' WHICH INDICATES FIXTURE TO SERVE AS NITE LIGHT AND SHALL NOT BE SWITCHED. PROVIDE UNSWITCHED HOT LEG FOR BATTERY CHARGER REGARDLESS OF FUNCTION. ALL EMERGENCY AND EMERGENCY/NITE LIGHT FIXTURES SHALL REVERT TO BATTERY OPERATION UPON INTERRUPTION OF NORMAL POWER AND ILLUMINATE REGARDLESS OF LIGHT SWITCH POSITION.
- PRIOR TO ANY CHASING, CHOPPING OR CORE DRILLING IS PERFORMED, THE CONTRACTOR SHALL FIELD INVESTIGATE CONDITIONS AND COORDINATE ALL WORK TO ENSURE THAT IT WILL BE IN HARMONY AND NOT AFFECT ANY EXISTING BUILDING T SYSTEMS. THIS WORK MUST BE APPROVED BY BUILDING OWNER PRIOR TO PROCEEDING.
- OPENINGS AROUND ELECTRICAL PENETRATIONS THROUGH FIRE RESISTANCE RATED WALLS, PARTITIONS, FLOORS OR CEILINGS SHALL BE FIRE STOPPED USING APPROVED METHOD. ALL SLEEVES MUST HAVE BUSHINGS. SEALANT SHALL BE 3 HOUR FIRE BARRIER #CP-25 (NO LESS THAN 3" THICK BACKED UP WITH MINERAL WOOL).
- PREPARE 'AS-BUILT' TRACINGS SHOWING ALL CHANGES IN WIRE SIZE, CIRCUIT NUMBERING, CIRCUIT ROUTING, EQUIPMENT LOCATIONS AND ALL ELECTRICAL WORK AS ACTUALLY INSTALLED.
- LIGHT FIXTURES SHALL BE CONSTRUCTED TO SUIT PARTICULAR TYPE OF CEILING AND WALL CONSTRUCTION AND SHALL BE PROVIDED WITH APPROPRIATE TRIMS, MOUNTING FRAMES AND ADAPTERS AS REQUIRED.

LIGHTING FIXTURE SCHEDULE

TYPE	MOUNTING	LAMPS	DESCRIPTION	MANUFACTURER & CAT. #
 A	RECESSED	29W LED UNV.	RECESSED 2'x2' ARCHITECTURAL LED FIXTURE WITH FROSTED ACRYLIC LENS, 2880 LUMENS, 3500K COLOR TEMPERATURE.	LSI LIGHTING CAT.# LPEC22-LED-SS-WW-UE
 B	RECESSED	25W LED 120V	RECESSED LED 4" APERTURE DOWN LIGHT, WITH 21,35 LUMEN, 3500K, CLEAR REFLECTOR.	PEACHTREE LIGHTING CAT.# 48LRD-20-35K-80-W-RPA-TRW-120
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


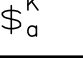
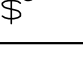
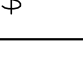
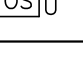

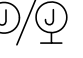
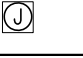
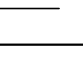
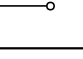
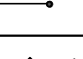
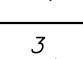
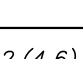

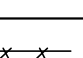
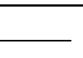



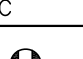
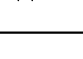

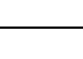





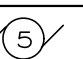
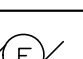
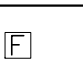
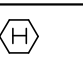
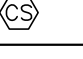




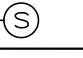
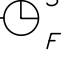

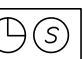
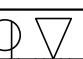
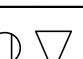

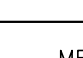

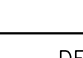
REMOVAL NOTES:

- BEFORE COMMENCING WORK, EXAMINE ALL ADJOINING AREAS THAT MAY BE AFFECTED BY REMOVAL. REPORT TO THE GENERAL CONTRACTOR ANY CONDITION THAT PREVENTS PERFORMANCE OF THE WORK.
- BECOME THOROUGHLY FAMILIAR WITH EXISTING CONDITIONS WHERE CONNECTIONS MUST BE MADE, CHANGED OR ALTERED. THE INTENT OF THE WORK IS SHOWN ON THE DRAWINGS AND DESCRIBED HEREINAFTER AND NO CONSIDERATION WILL BE GRANTED BY REASON OF LACK OF FAMILIARITY ON THE PART OF THE CONTRACTOR WITH ACTUAL PHYSICAL CONDITIONS AT THE SITE. INSPECT EACH AND EVERY AREA AFFECTED BY THE ALTERATION OF THE SPACE BEFORE SUBMITTAL OF BID.
- ALL EXISTING ELECTRICAL EQUIPMENT ARE TO BE REMOVED UNLESS OTHERWISE NOTED. THIS SHALL INCLUDE BUT NOT BE LIMITED TO THE FOLLOWING:
 - INTERIOR LUMINAIRES.
 - MECHANICAL EQUIPMENT DISCONNECT INCLUDING DISCONNECT SWITCHES.
 - CONDUIT AND WIRE.
 - WIRING DEVICES.
 - F.A. DEVICES.
 - P.A. SYSTEM DEVICES.
 - TEL AND DATA DEVICES AND/OR EQUIPMENT.
- ALL CONDUIT AND CONDUCTORS ASSOCIATED WITH THE ELECTRICAL EQUIPMENT TO BE REMOVED, SHALL BE DISCONNECTED COMPLETELY BACK TO ITS POWER SOURCE.
- ALL POWER CONDUCTORS, CONTROL WIRING AND CONDUIT ASSOCIATED WITH MECHANICAL EQUIPMENT SUCH AS FANS, AIR CONDITIONING UNITS, PUMPS, ETC. DESIGNATED FOR REMOVAL ON THE HVAC AND PLUMBING REMOVAL DRAWINGS SHALL BE DISCONNECTED AND REMOVED CLEAR BACK TO THE POWER SOURCE. ALL MOTOR STARTERS, DISCONNECT SWITCHES, CONTROL DEVICES, ETC. SHALL BE REMOVED. REFER TO MECHANICAL AND PLUMBING DRAWINGS FOR ADDITIONAL INFORMATION.
- CIRCUIT BREAKERS AND/OR SWITCHES IN PANELBOARD(S) OR DISTRIBUTION BOARD(S) MADE SPARE DUE TO DEMOLITION SHALL BE DESIGNATED AS SUCH ON THE PANEL DIRECTORY.
- THE ELECTRICAL CONTRACTOR SHALL BE RESPONSIBLE TO TRACE AND RELOCATE ALL EXISTING FEEDERS AND BRANCH CIRCUIT WIRING WHICH PASSES THROUGH THE DEMOLITION AREA THAT SERVE EXISTING OCCUPIED SPACES TO REMAIN. COORDINATE WITH BUILDING OWNER PRIOR TO ANY SHUTDOWNS OR DISRUPTIONS THAT MAY BE REQUIRED TO ACCOMPLISH THIS WORK.
- DISPOSE OF ALL REMOVED EQUIPMENT, WHICH IS NOT INTENDED TO BE REUSED WITH CONSENT OF BUILDING OWNER.
- EXISTING CIRCUIT BREAKERS AVAILABLE IN EXISTING PANEL(S) ARE TO BE REUSED. ELECTRICAL CONTRACTOR SHALL PROVIDE NEW CIRCUIT BREAKERS IN AVAILABLE SPACES AS SHOWN AT HOME RUNS ON THE DRAWING.
- EXISTING EQUIPMENT DESIGNATED FOR REUSE SHALL BE CLEANED, REFURBISHED AND RESTORED TO OPTIMUM PERFORMANCE. THIS SHALL INCLUDE BUT NOT LIMITED TO CLEANING OF LIGHT FIXTURES, REPLACEMENT OF INOPERABLE BALLASTS AND LAMPS, RESISTANCE TESTING OF BRANCH CIRCUITRY AND FEEDERS, ETC.
- EXTEND EXISTING CIRCUITRY TO THOSE DEVICES THAT ARE TO BE RELOCATED. MATCH EXISTING TYPE AND SIZE. RELOCATION OF EXISTING EQUIPMENT SHALL BE PERFORMED ONLY UPON OWNER'S ACCEPTANCE OF EXISTING EQUIPMENT.
- ELECTRICAL CONTRACTOR SHALL MAINTAIN CONTINUITY OF CIRCUIT FOR EXISTING EQUIPMENT AND DEVICES THAT ARE TO REMAIN, WHERE OUTLETS ARE REMOVED AND NOT AT THE CIRCUIT END, EXTEND CIRCUITRY AS REQUIRED TO MAINTAIN INTEGRITY OF ORIGINAL CIRCUIT. WHERE A WIRING DEVICE IS TO BE REMOVED AND THAT WALL IS TO REMAIN, THE ELECTRICAL CONTRACTOR SHALL REMOVE BRANCH CIRCUITRY FROM ITS SOURCE AND FILL IN OUTLET BOX. BLANK PLATES WILL BE PERMITTED.
- REMOVE EXISTING FACP IN ITS ENTIRETY, ONLY AFTER NEW FACP IS INSTALLED AND TESTED FOR 100% OPERATIONAL. KEEP EXISTING FIRE ALARM SYSTEM IN WORKING ORDER THROUGHOUT THE NEW INSTALLATION.

ABBREVIATIONS


ABBV.	DESCRIPTION
EM	EMERGENCY
ER	EXISTING TO BE RELOCATED
EXIST.	EXISTING
FA	FIRE ALARM
F.A.C.P.	FIRE ALARM CONTROL PANEL
F.B.O	FURNISHED BY OTHERS
FDR	FEEDER
GFI	GROUND FAULT INTERRUPTER
H	HOT (PHASE)
H.P.	HORSEPOWER
HR	HOME RUN
HVAC	HEATING, VENTILATING AND AIR-CONDITIONING UNIT
IG	ISOLATED GROUND
KV	KILOVOLT
KVA	KILOVOLT AMPERE
KW	KILOWATT
LGT	LIGHTING
MTD	MOUNTED
N	NEUTRAL
NEC	NATIONAL ELECTRICAL CODE
NTS	NOT TO SCALE
PC	PERSONAL COMPUTER
PNL	PANEL
PWR	POWER
PR	PRINTER
R	REMOVE EXISTING
RT	ROOFTOP UNIT
RN	REPLACE EXISTING W/NEW
TYP.	TYPICAL
U.O.N.	UNLESS OTHERWISE NOTED
UV	UNIT VENTILATOR
WP	WEATHERPROOF
A	AMP/AMPERE
ARCH	ARCHITECT
AWG	AMERICAN WIRE GAUGE
C	CONDUIT
CU	CONDENSING UNIT
DWG	DRAWING
E	EXISTING TO REMAIN
E.C.	ELECTRICAL CONTRACTOR
ELEC	ELECTRICAL

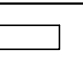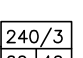SYMBOL LIST

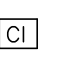	2'x2' LED CEILING MOUNTED LIGHT FIXTURE. UPPER CASE LETTER DENOTES TYPE, LOWER CASE LETTER DENOTES SWITCH CONTROL. FIXTURE SCHEDULE DENOTES TYPE.
	2'x2' CEILING MOUNTED LED LIGHT FIXTURE FOR EMERGENCY OPERATION. 'EM' INDICATES SWITCHED EMERGENCY FIXTURE.
	CEILING/WALL MOUNTED LED EXIT LIGHT WITH OUTLET BOX, DIRECTIONAL ARROWS SHADED PORTION INDICATES ILLUMINATED FACE. SCHEDULE DENOTES TYPE.
	FLUSH WALL MOUNTED LIGHTING CONTROL SWITCH CONTROLLING OUTLET "o". 'K' WHERE USED INDICATES KEY SWITCH.
	FLUSH WALL MOUNTED 3-WAY LIGHTING CONTROL SWITCH.
	FLUSH WALL MOUNTED 4-WAY LIGHTING CONTROL SWITCH.
	ULTRASONIC CEILING MOUNTED OCCUPANCY SENSOR FOR LIGHTING CONTROL. WATT STOPPER W-500A WITH A120 E-P POWER PACK.
	360° PW CEILING MOUNTED OCCUPANCY SENSOR FOR LIGHTING CONTROL. WATT STOPPER O-200-1 WITH A120 E-P POWER PACK.
	CEILING/WALL MOUNTED JUNCTION BOX.
	FLUSH FLOOR MOUNTED JUNCTION BOX
	CONDUCTORS IN CONDUIT CONCEALED BY WALL OR CEILING.
	CONDUIT TURNING UP.
	CONDUIT TURNING DOWN.
	FLEXIBLE LIQUIDTIGHT FINAL EQUIPMENT CONNECTION.
	HOMERUN TO DESIGNATED PANEL, ARROWHEAD INDICATES SINGLE POLE CIRCUIT. HOMERUN SHALL CONSIST OF 2#12-3/4" U.O.N.
	HOMERUN TO DESIGNATED PANEL, NUMBERS IN PARENTHESIS INDICATE MULTIPLE CIRCUIT, I.E. 3-HOTS AND 1-GROUND U.O.N.
	EXISTING TO REMAIN
	EXISTING TO BE REMOVED
	NEW
	125V-2P-3W-20A GROUNDED TYPE, SPECIFICATION GRADE WALL MOUNTED DUPLEX RECEPTACLE HUBBELL #5362.
	125V-2P-3W-20A ISOLATED GROUND TYPE, SPECIFICATION GRADE WALL MOUNTED DUPLEX RECEPTACLE HUBBELL #6-5362 FOR PERSONAL COMPUTER.
	SAME AS ABOVE EXCEPT DOUBLE DUPLEX RECEPTACLE.
	20A FLUSH WALL MOUNTED GROUND FAULT INTERRUPTING TYPE DUPLEX RECEPTACLE HUBBELL #65362.
	FLUSH WALL MOUNTED COMBINATION TELEPHONE/DATA OUTLET CONSISTING OF A 3 PORT STAINLESS STEEL COVER PLATE WITH LABEL WINDOW AND 1 1/4" CONDUIT WITH (2) CAT 6 CABLE AND (1) CAT 6 CABLE FOR VOIP, FOR NEW WALLS NO CONDUIT STUB-UP, FOR EXISTING WALLS PROVIDE WIRE MOLD, STUBBED UP 6" ABOVE CEILING WITH BUSHINGS, PROVIDE (3) RJ-45 FEMALE BULKHEADS FOR DATA, CAT 6 CABLES TO TERMINATE INTO PATCH PANEL, AT NEAREST IDF/MDF CLOSET.
	FLUSH WALL MOUNTED TELEPHONE OUTLET CONSISTING OF A STAINLESS STEEL COVER PLATE WITH RJ-11 MODULE WITH 1" CONDUIT (1) #22 GAUGE UTP PHONE CABLE STUBBED UP 6" ABOVE CEILING WITH BUSHINGS, PROVIDE COVER PLATE WITH WHITE RJ-11 MODULE.
	SPECIAL SIMPLEX RECEPTACLE SHALL MATCH PLUG CONFIGURATION OF X-RAY MACHINE.
	SURFACE MOUNTED EXISTING ELECTRICAL PANELBOARD.
	HEAVY DUTY TYPE DISCONNECT SWITCH WITH FINAL FLEXIBLE EQUIPMENT CONNECTION. 240 INDICATES VOLTAGE, 3 INDICATES NO. OF POLES, 60 INDICATES AMPERE RATING, NF INDICATES NON-FUSE/OVER FUSE SIZE) U.O.N. REFER TO SPECIFICATION AND DRAWINGS FOR ENCLOSURE. 'WP' WHERE USED INDICATES WEATHERPROOF ENCLOSURE (NEMA 3R).
	MOTOR (F.B.O. WIRED BY ELEC.) - NUMBER INDICATES HORSEPOWER. REFER TO PANEL SCHEDULES FOR WIRING AND OVER CURRENT PROTECTION.
	FRACTIONAL HORSEPOWER MOTOR (F.B.O. WIRED BY ELEC.). REFER TO PANEL SCHEDULES FOR WIRING AND OVER CURRENT PROTECTION.
	WALL MOUNTED FIRE ALARM MANUAL PULL STATION
	CEILING MOUNTED HEAT DETECTOR
	CEILING MOUNTED COMBINATION CARBON MONOXIDE AND SMOKE DETECTOR WITH SOUNDER BASE
	WALL MOUNTED FIRE ALARM STROBE LIGHT.
	WALL MOUNTED COMBINATION FIRE ALARM SPEAKER/STROBE DEVICE.
	INTERFACE MODULE CONSISTING OF CONTROL AND MONITOR MODULES. IN NEMA 1 ENCLOSURE.
	HAND SET RECEIVER FOR CALL-IN FUNCTION. (N.I.C.) PROVIDE BACKBOX WITH COVER PLATE FOR 1" GROMMETED OPENING AND 1" EMPTY CONDUIT WITH DRAG LINE STUBBED UP 6" ABOVE ACCESSIBLE CEILING.
	WALL MOUNTED CALL BUTTON
	WALL MOUNTED P.A. SPEAKER MATCH EXISTING.
	12" WALL MOUNTED PROGRAM CLOCK MATCH EXISTING. '2' WHERE USED INDICATES DUAL FACED, 'S' WHERE USED INDICATES SURFACE MOUNTED AND 'F' WHERE USED INDICATES FLUSH MOUNTED
	WALL MOUNTED CLOCK (N.I.C.) PROVIDE BACKBOX COVER PLATE FOR 1" GROMMETED OPENING AND 1" EMPTY CONDUIT WITH DRAGLINE STUBBED UP 6" ABOVE ACCESSIBLE CEILING.
	FLUSH WALL MOUNTED COMBINATION CLOCK AND SPEAKER. MATCH EXISTING SYSTEM.
	SURFACE MOUNTED WIREMOLD V700 FOR EITHER RECEPTACLE OR COMMUNICATION WIRING. REFER TO DRAWINGS FOR ADDITIONAL INFORMATION.
	SURFACE MOUNTED WIREMOLD SERIES 4000 CONTAINING RECEPTACLE CIRCUITS AND COMMUNICATION WIRING. REFER TO DRAWINGS FOR ADDITIONAL INFORMATION.
	TAG SYMBOL, NUMERAL DENOTES REFERENCE TO A WORK NOTE.
MECHANICAL EQUIPMENT IDENTIFICATION:	
	EQUIPMENT ABBREVIATION (FE, SF, HV, ETC. SEE ABBREVIATIONS ON THIS DWG.)
	EQUIPMENT NUMBER
DETAIL/PART PLAN NUMBER IDENTIFICATION:	
	DETAIL/PART PLAN NUMBER
	DRAWING NUMBER


DISPOSAL OF MERCURY CONTAINING LAMPS:

- ALL FLUORESCENT AND HID LAMPS WITHIN REMOVED LIGHT FIXTURES ARE CONSIDERED MERCURY CONTAINING AND SHALL BE TREATED AS HAZARDOUS MATERIAL.
- FLUORESCENT AND HID LAMPS SHALL BE REMOVED FROM DEMOLISHED LIGHT FIXTURES AND DISPOSE

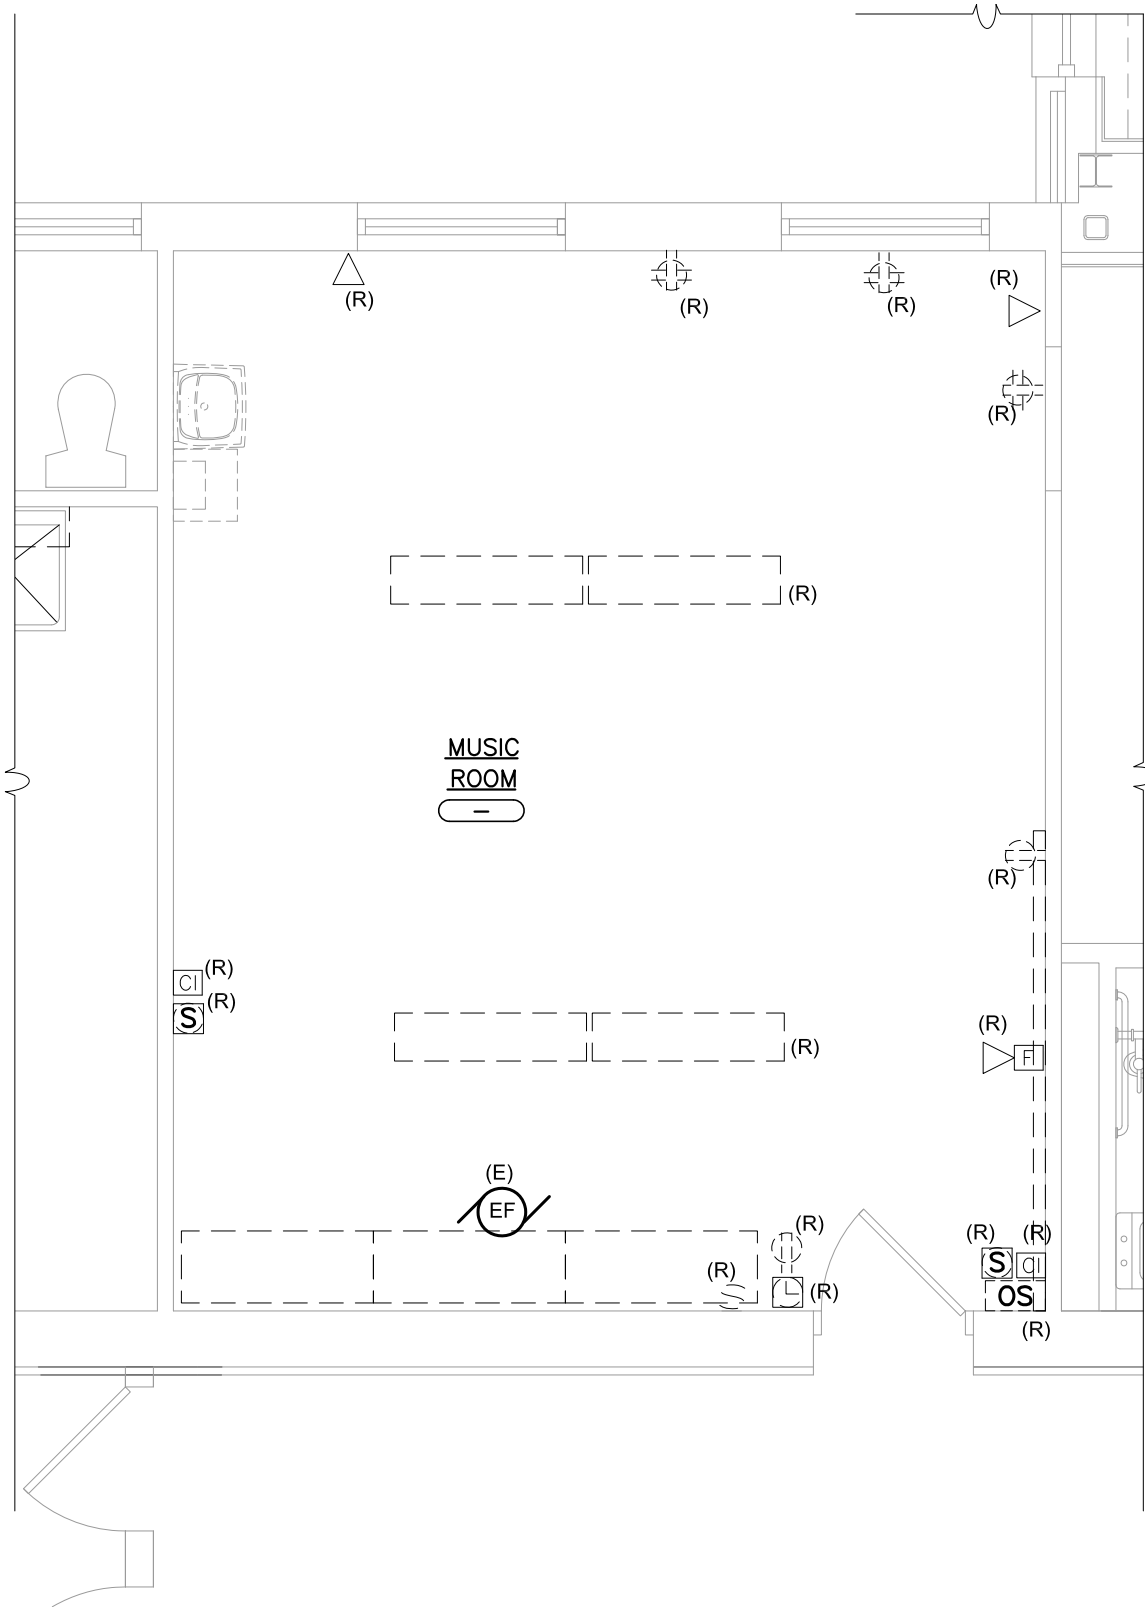



1 PARK AVE. ELEMENTARY SCHOOL
EXISTING/ REMOVAL PLAN
SCALE: 1/4" = 1'-0"

- UNLESS OTHERWISE NOTED, EXISTING LIGHTING, RECEPTACLE, FIRE ALARM AND DATA OUTLETS TO BE REMOVED FOR THIS AREA. EXISTING CIRCUIT WIRING TO BE SAFFED-OFF FOR RE-USE. REFER TO NEW WORK PLAN FOR ADDITIONAL WORK DETAILS.
- CONNECT NEW RECEPTACLES TO EXISTING CIRCUITS MADE AVAILABLE DURING DEMOLITION.

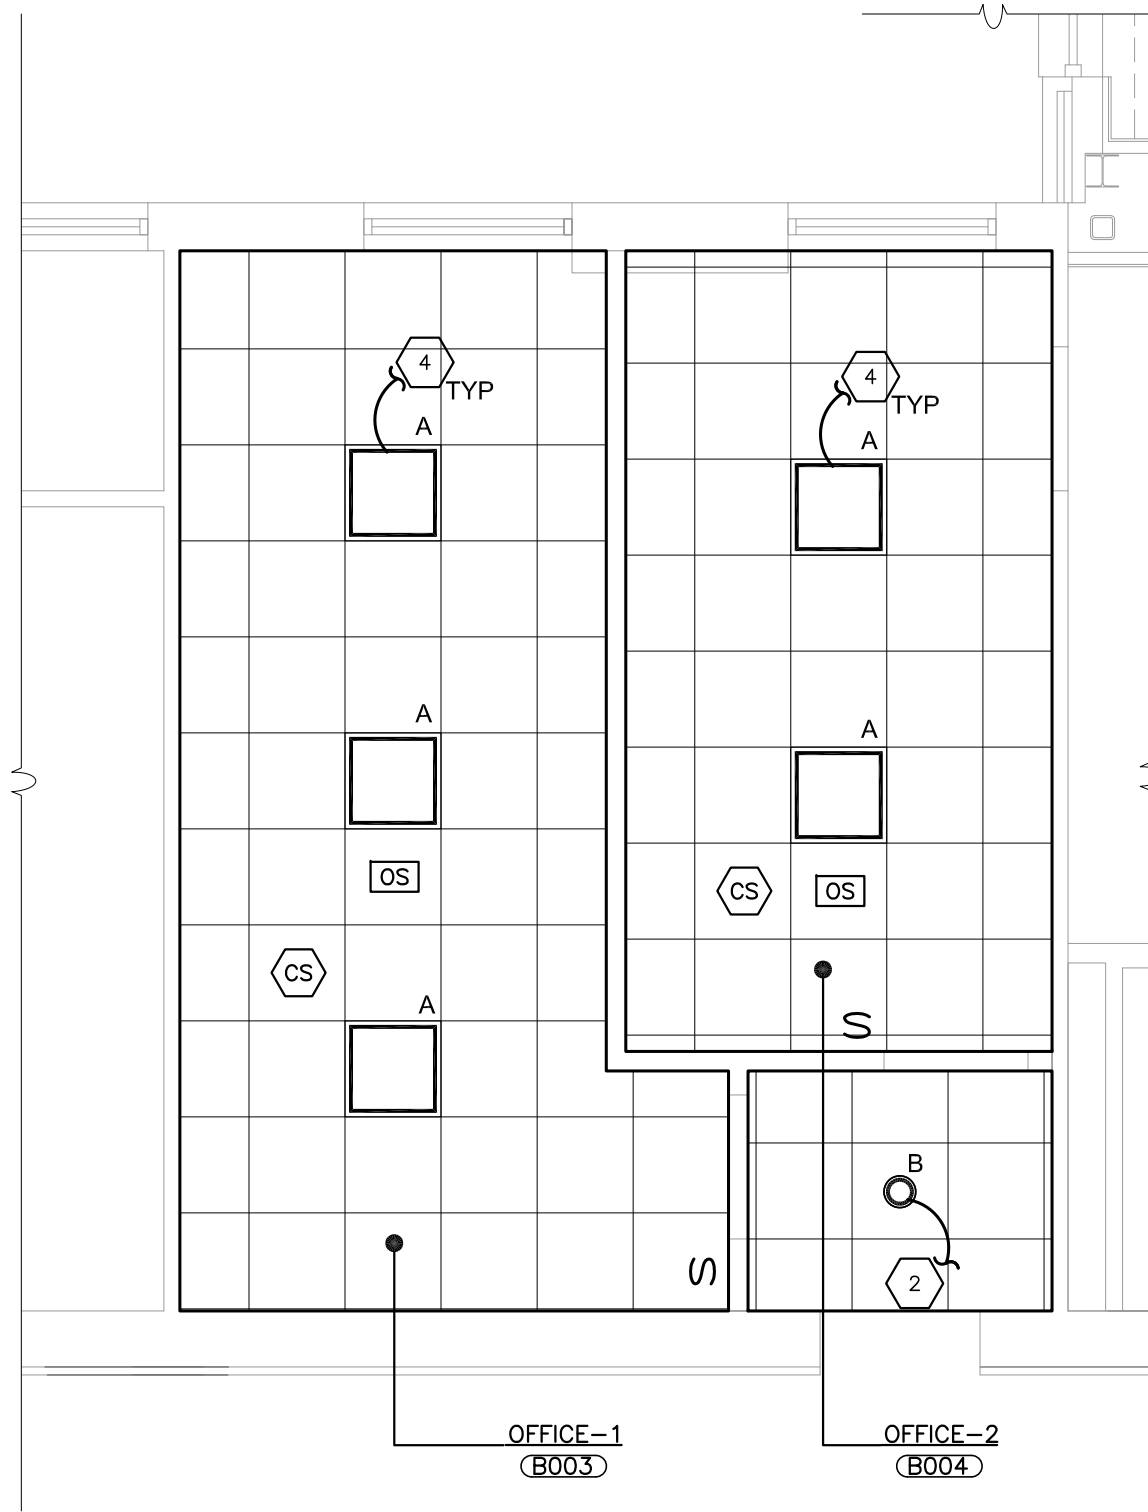


2 PARK AVE. ELEMENTARY SCHOOL
REFLECTED CEILING PLAN (LIGHTING)
SCALE: 1/4" = 1'-0"

- CONNECT NEW NORMAL LIGHTING FOR THIS AREA TO EXISTING LIGHTING CIRCUITS MADE AVAILABLE DURING DEMOLITION. PROVIDE NEW SWITCHING AS INDICATED. EXTEND CIRCUIT'S CONDUIT AND WIRING AS REQUIRED.

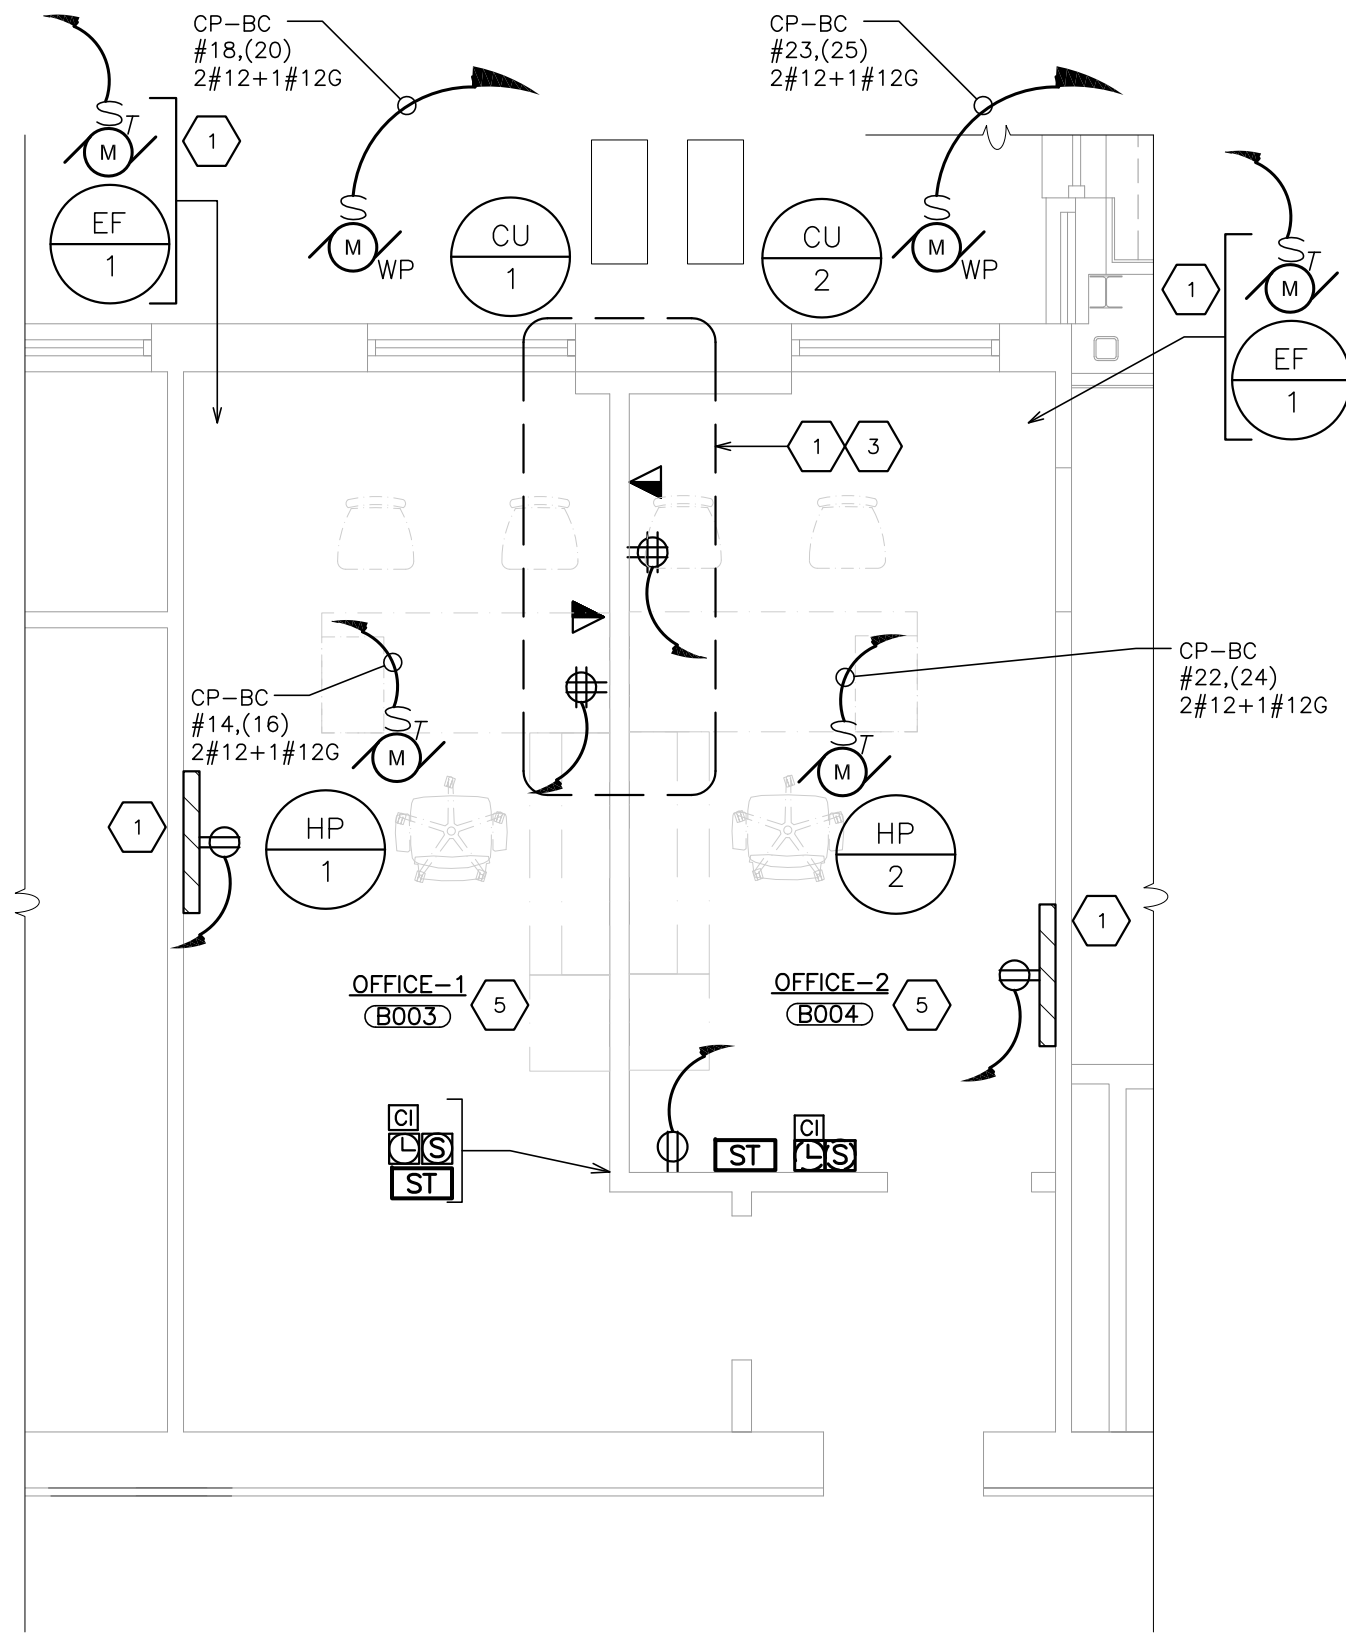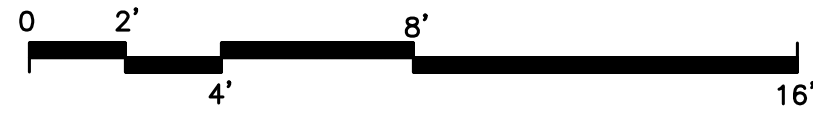

3 PARK AVE. ELEMENTARY SCHOOL
PLAN (POWER)
SCALE: 1/4" = 1'-0"

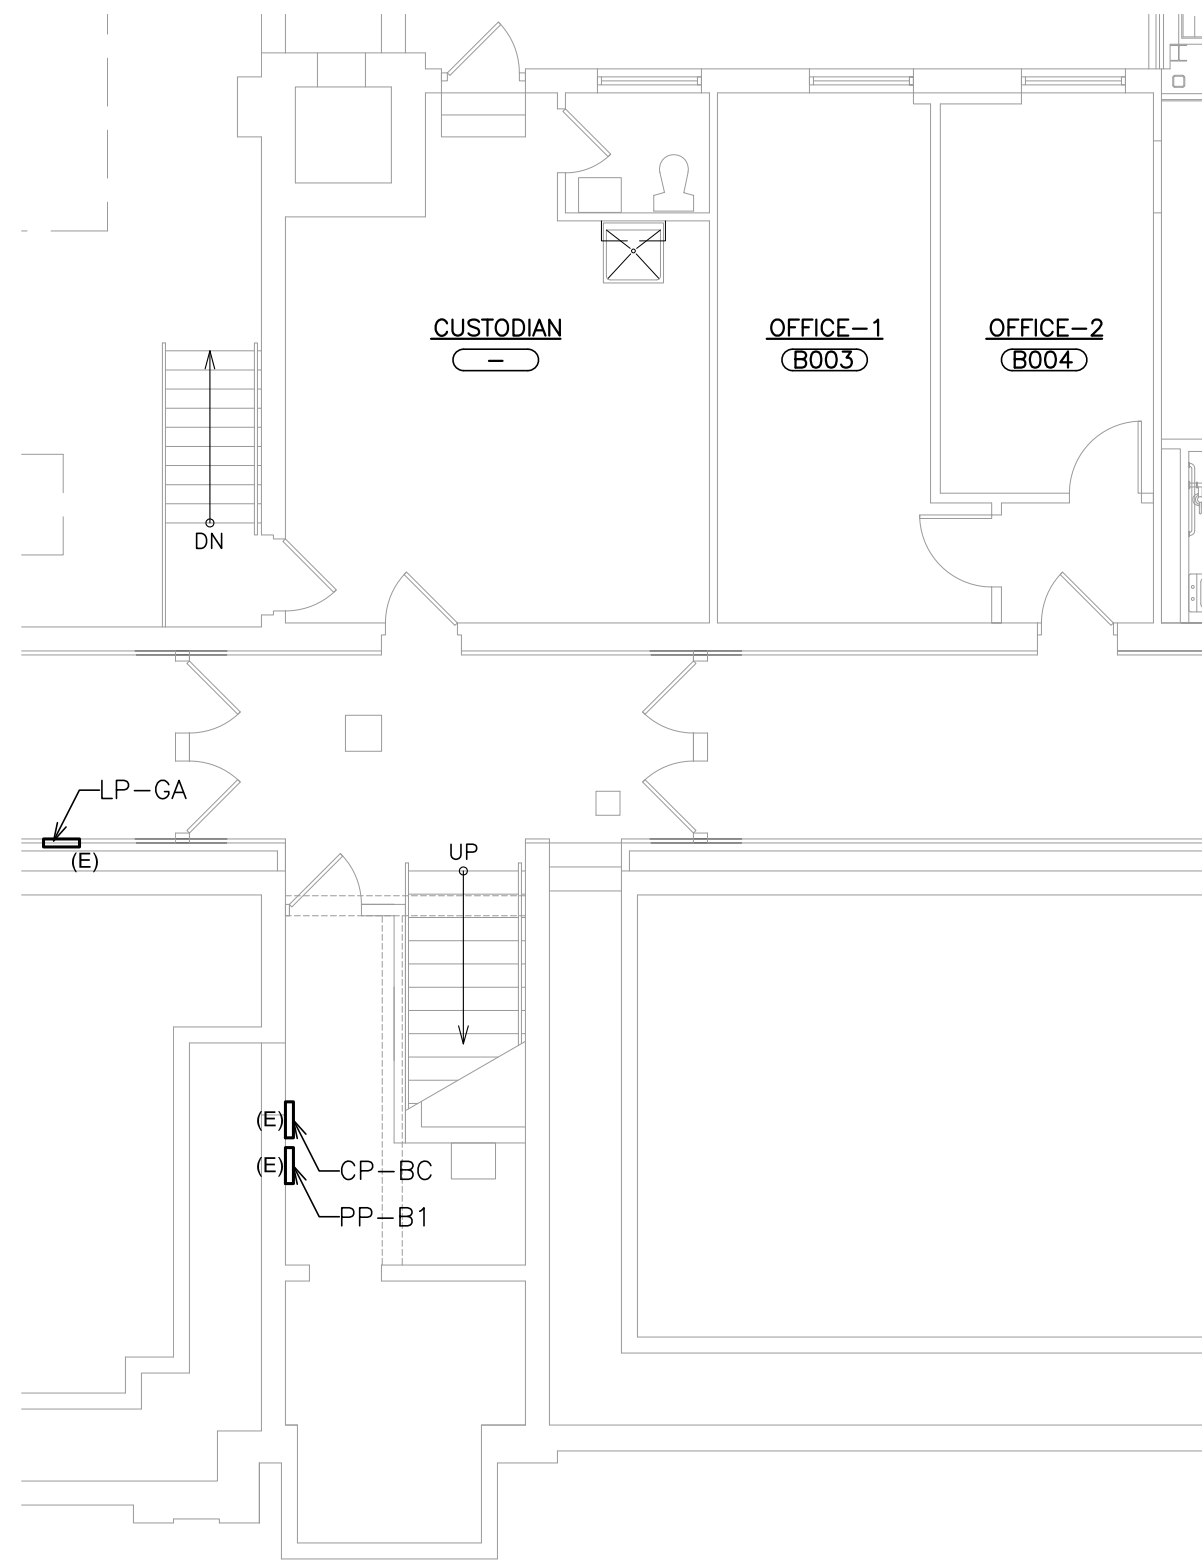


4 PARK AVE. ELEMENTARY SCHOOL
BASEMENT PLAN
SCALE: 1/8" = 1'-0"

- CONNECT TO EXISTING PANEL BOARD CP-BC TO EXISTING SPACES. CIRCUIT NUMBERS AND PANEL DESIGNATION ARE SHOWN FOR CONTRACTORS GUIDANCE ONLY. PROVIDE ALL REQUIRED AND NECESSARY ACCESSORIES.


KEY NOTES

1. CONTRACTOR SHALL USE EXISTING CIRCUIT MADE AVAILABLE BY REMOVALS IN THE ROOM, PROVIDE 2#12 + 1#12G - 3/4" AS NEEDED.
2. CIRCUIT NEW LIGHTING FIXTURE TO EXISTING CORRIDOR LIGHTING CIRCUIT.
3. COORDINATE FINAL LOCATIONS WITH FURNITURE LAYOUT.
4. CONNECT NEW LIGHTING FOR THIS AREA TO EXISTING LIGHTING CIRCUITS MADE AVAILABLE DURING DEMOLITION. PROVIDE NEW SWITCHING AS INDICATED. EXTEND CIRCUITS, CONDUIT AND WIRING AS REQUIRED.
5. 1. WHERE NEW CIRCUIT BREAKERS ARE ADDED TO EXISTING PANEL BOARDS, UPDATE THE EXISTING DIRECTORY TO CLEARLY IDENTIFY THE LOADS SERVED.
2. BRANCH CIRCUIT BREAKERS SHALL MATCH EXISTING MANUFACTURER AND A/C RATING.
3. MAINTAIN CORRECT PHASE SEQUENCE OF ALL FEEDERS AND CIRCUITS WITH PHASE IDENTIFICATION THROUGHOUT. REARRANGE CIRCUIT IN PANEL BOARDS TO BALANCE THE PHASE LOADS WITHIN 20%.
4. WHERE EXISTING PANEL BOARDS DO NOT HAVE SPARE CIRCUITS FOR NEW WORK, PROVIDE SUB-PANEL PER ALLOWANCE SECTION OF THE PROJECT SPECIFICATIONS.
6. REMOVE FAN AND FAN CONTROL SWITCH.
7. CONNECT NEW LIGHTING FOR THIS AREA TO EXISTING LIGHTING CIRCUITS MADE AVAILABLE DURING DEMOLITION. PROVIDE NEW SWITCHING AS INDICATED. EXTEND CIRCUITS, CONDUIT AND WIRING AS REQUIRED. OWNER TO FURNISH LIGHTING FIXTURES FOR CONTRACTOR TO INSTALL. MATCH EXISTING DUAL SWITCHING.

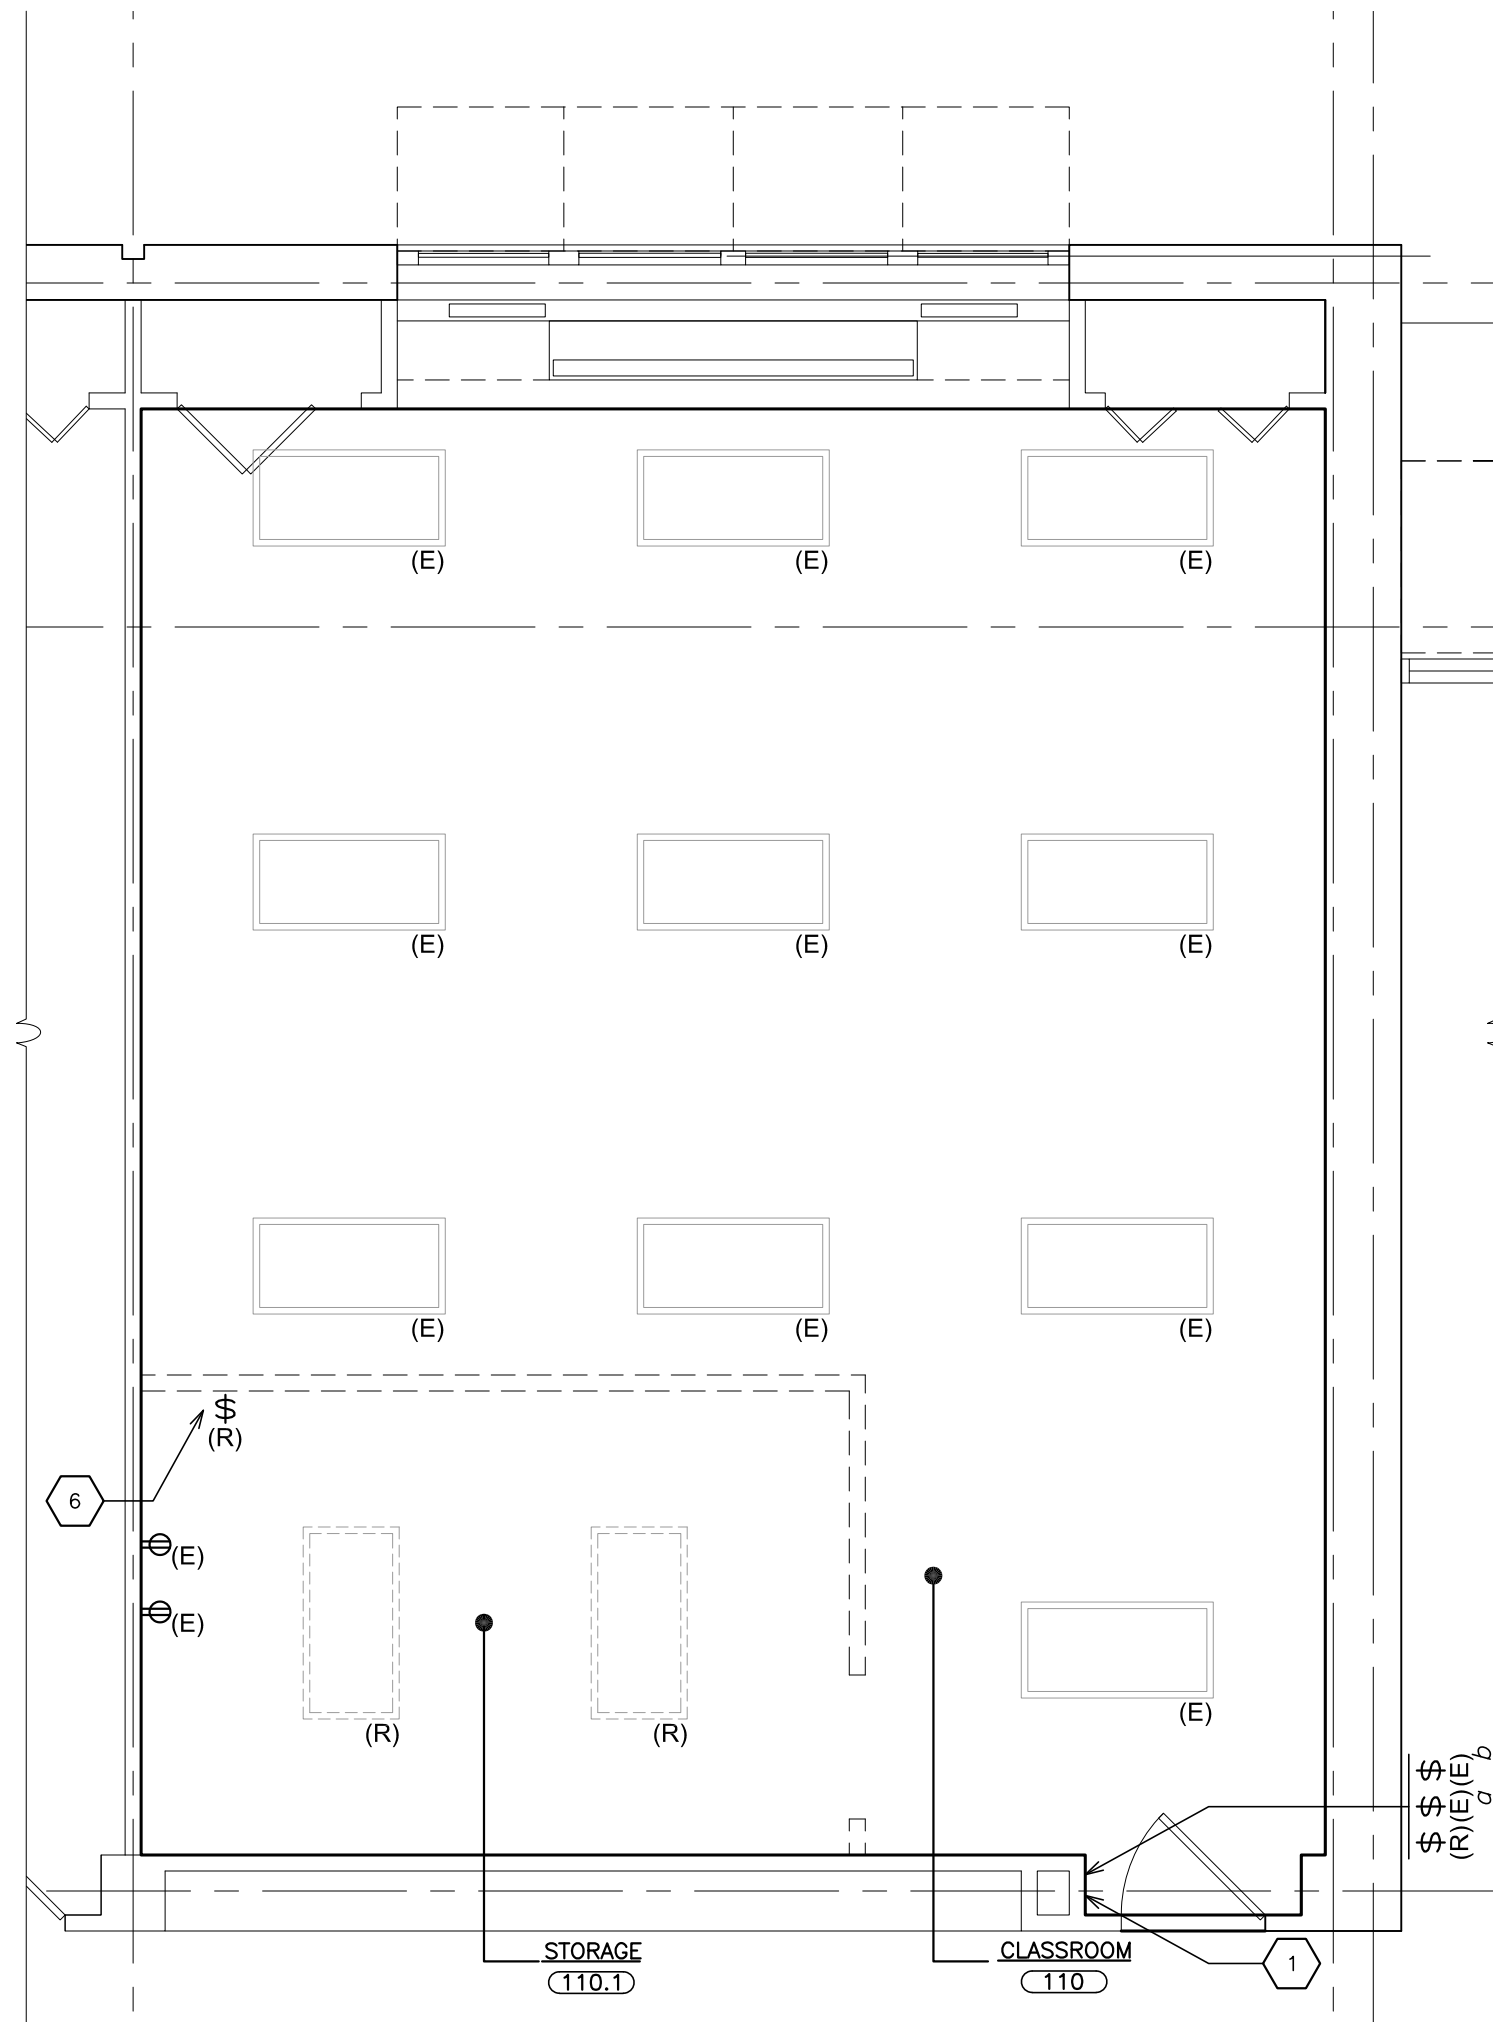


1 PORT CHESTER MIDDLE SCHOOL
EXISTING/ REMOVAL PLAN
SCALE: 1/4" = 1'-0"

- UNLESS OTHERWISE NOTED, EXISTING LIGHTING, RECEPTACLE, FIRE ALARM AND DATA OUTLETS TO BE REMOVED FOR THIS AREA. EXISTING CIRCUIT WIRING TO BE SAFFED-OFF FOR RE-USE. REFER TO NEW WORK PLAN FOR ADDITIONAL WORK DETAILS.
- CONNECT NEW RECEPTACLES TO EXISTING CIRCUITS MADE AVAILABLE DURING DEMOLITION.

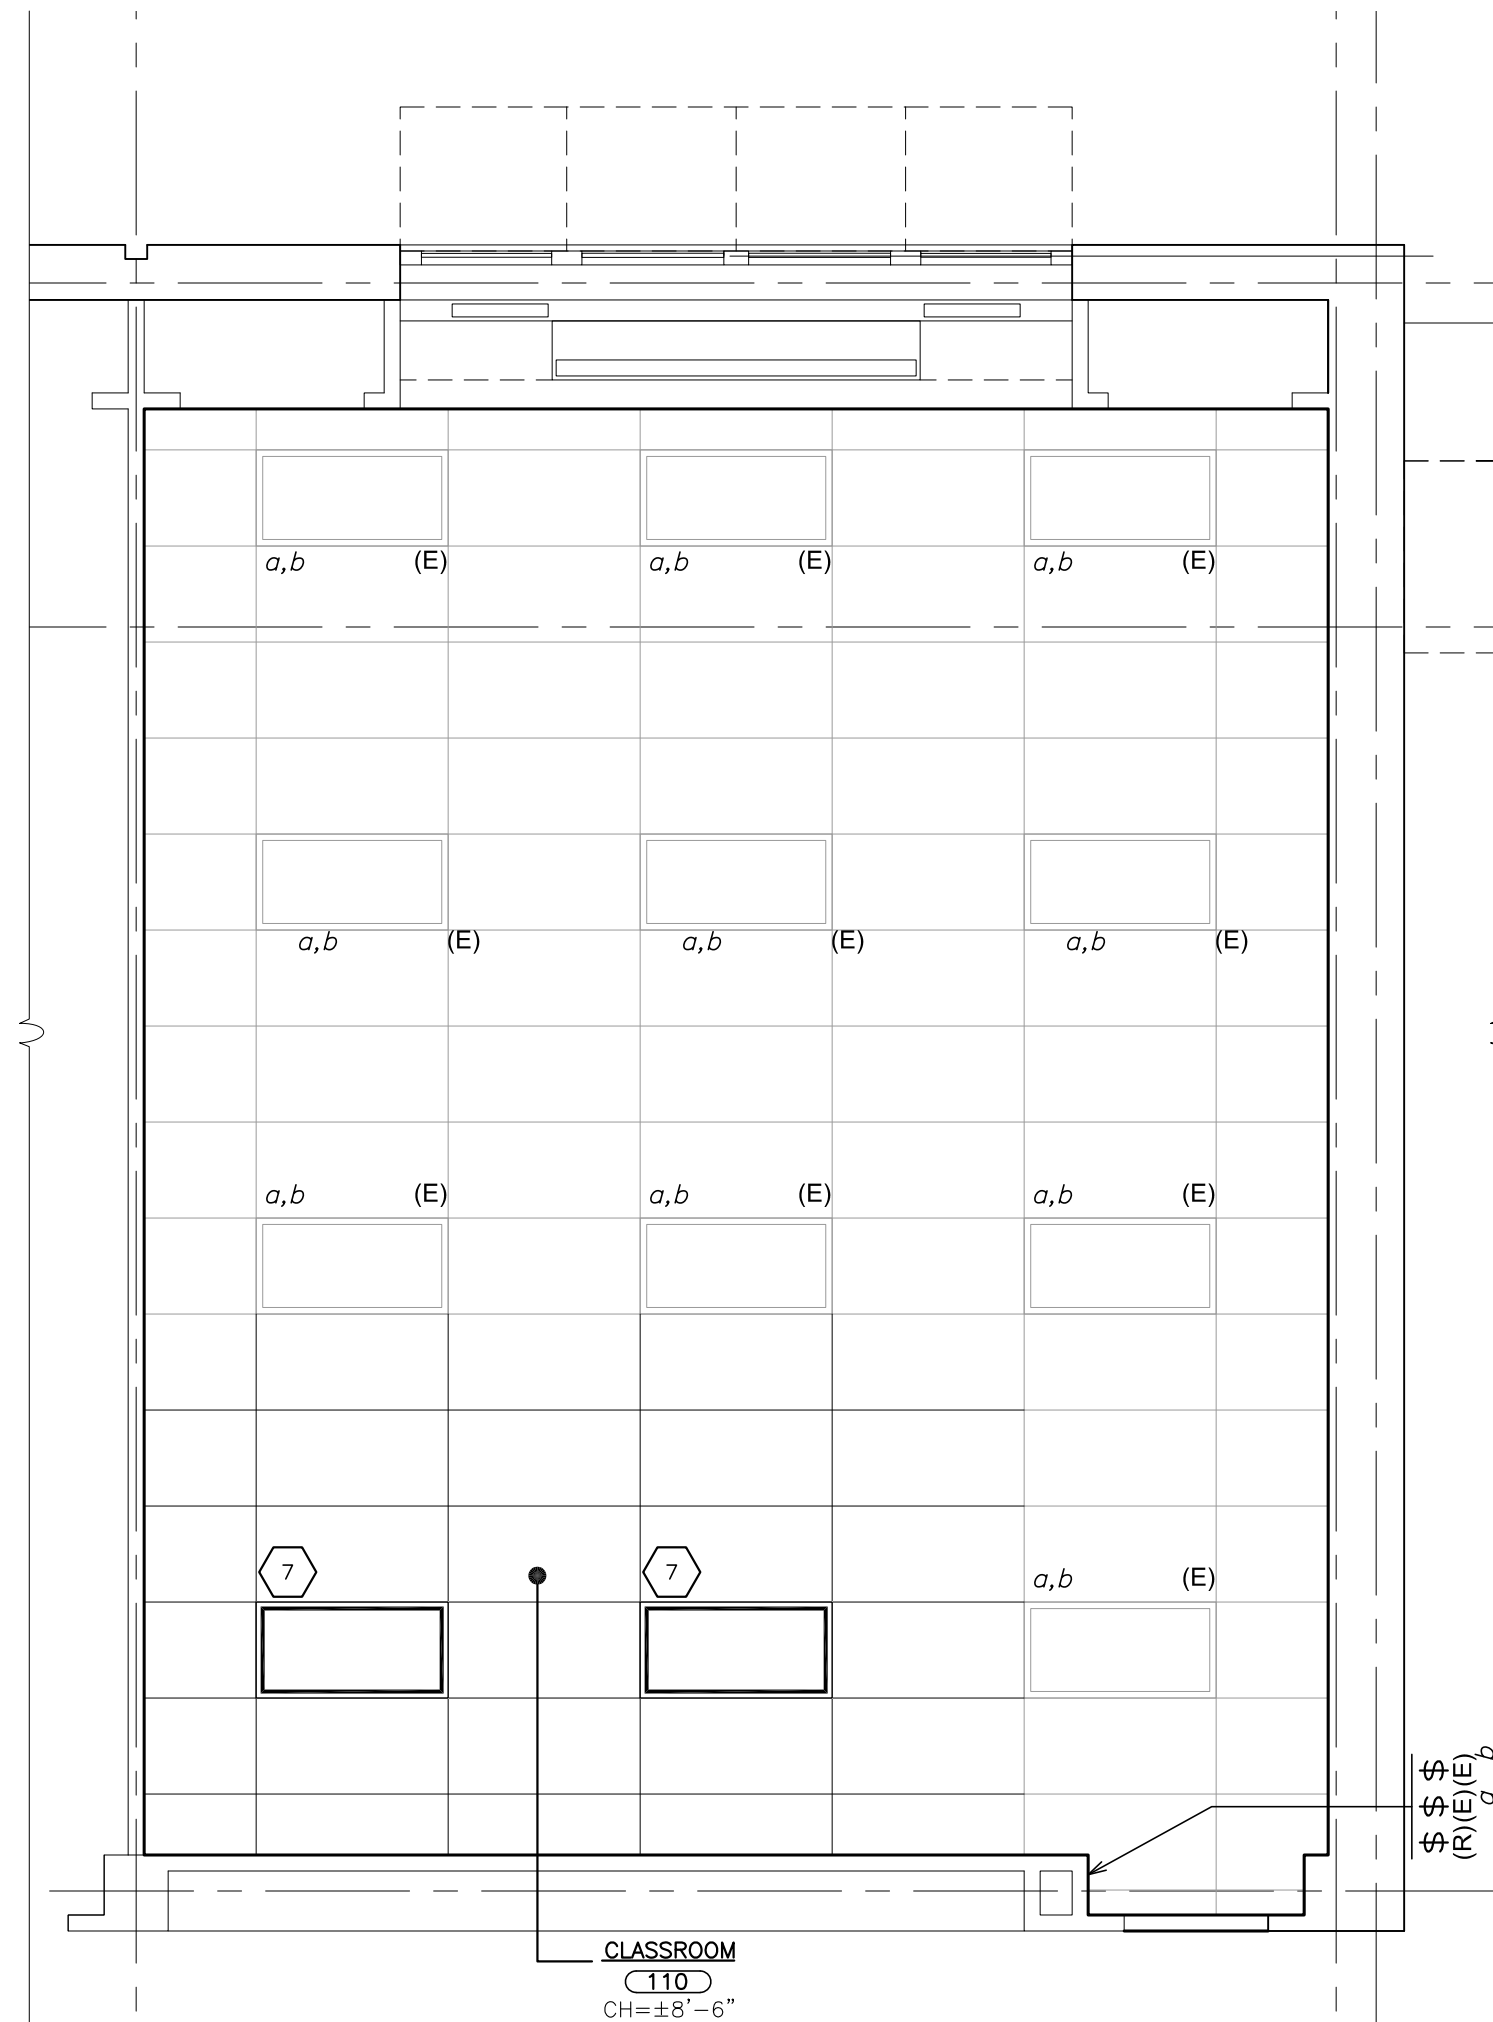

2 PORT CHESTER MIDDLE SCHOOL
REFLECTED CEILING PLAN (LIGHTING)
SCALE: 1/4" = 1'-0"

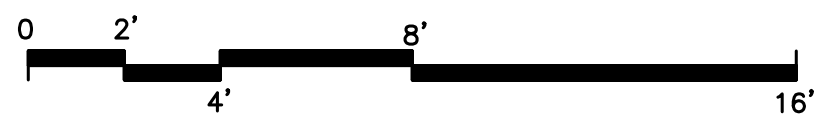

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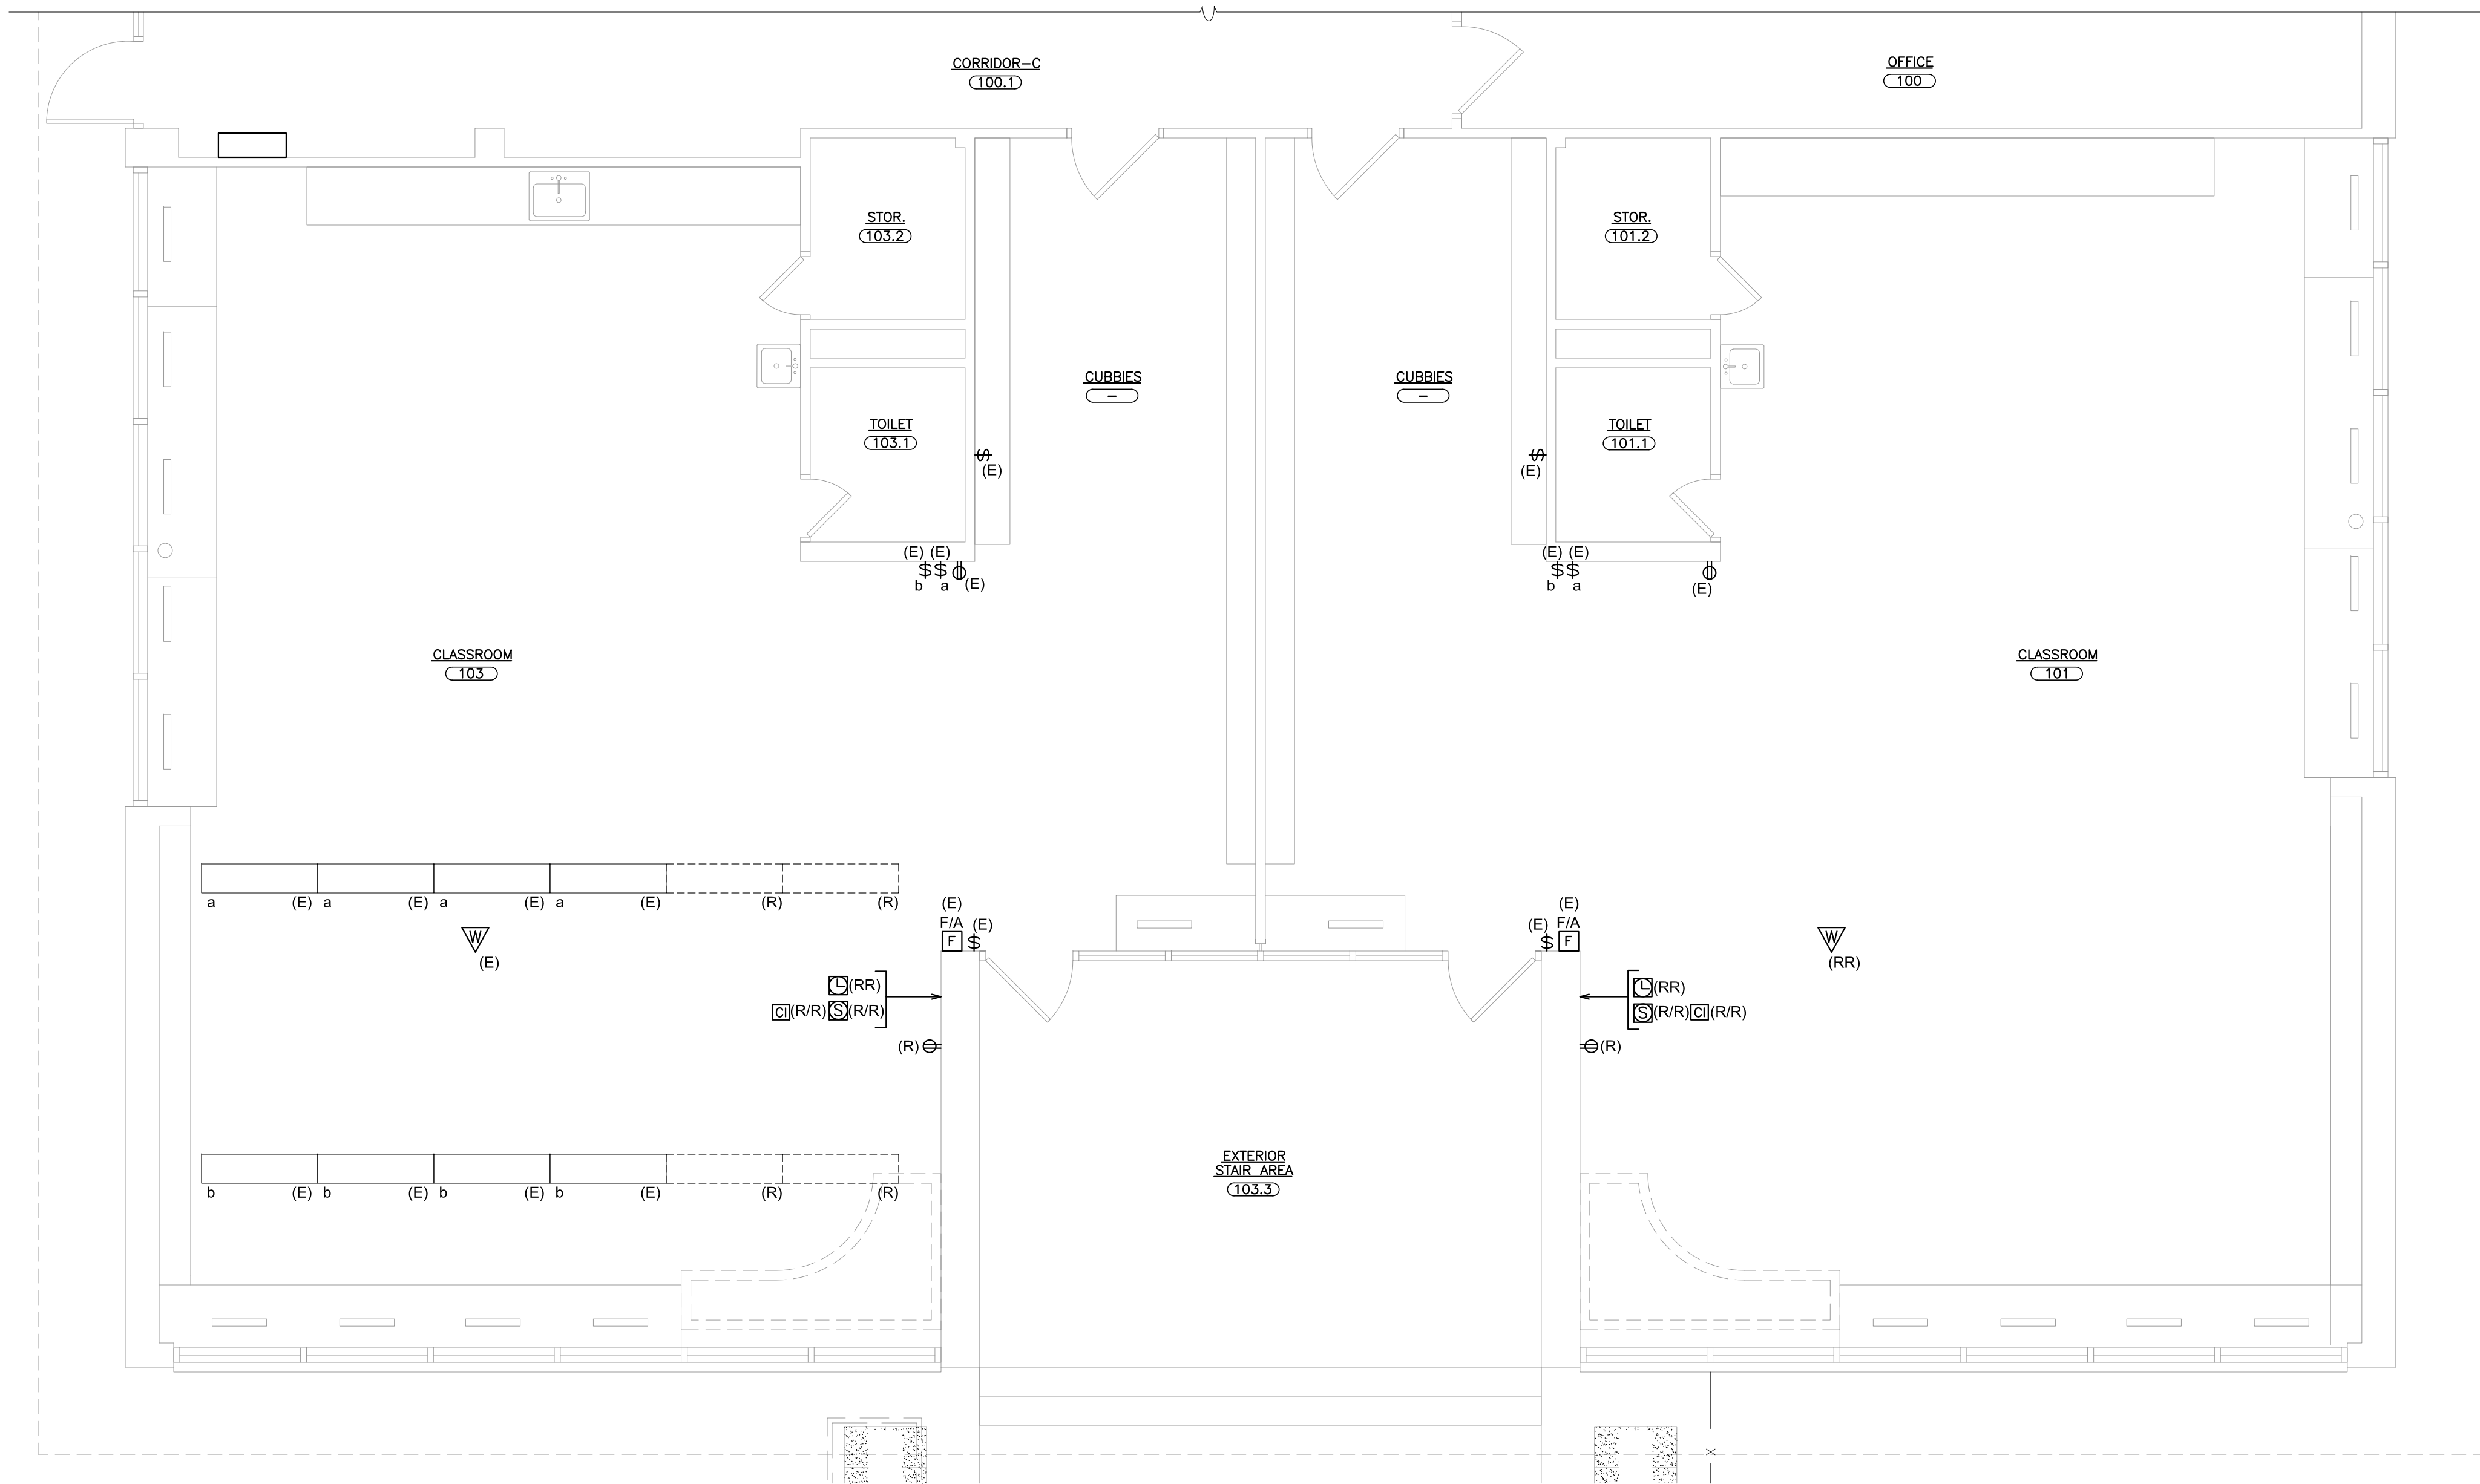
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PROJECT TITLE
PORT CHESTER - RYE UNION FREE SCHOOL DISTRICT
KING STREET ELEMENTARY SCHOOL LIBRARY ALTERATIONS
JOHN F. KENNEDY ELEMENTARY SCHOOL OFFICE ALTERATIONS
PORT CHESTER MIDDLE SCHOOL CLASSROOM ALTERATIONS
DRAWING TITLE
PARK AVENUE ELEMENTARY SCHOOL
PORT CHESTER MIDDLE SCHOOL
ELECTRICAL PLANS AND NOTES


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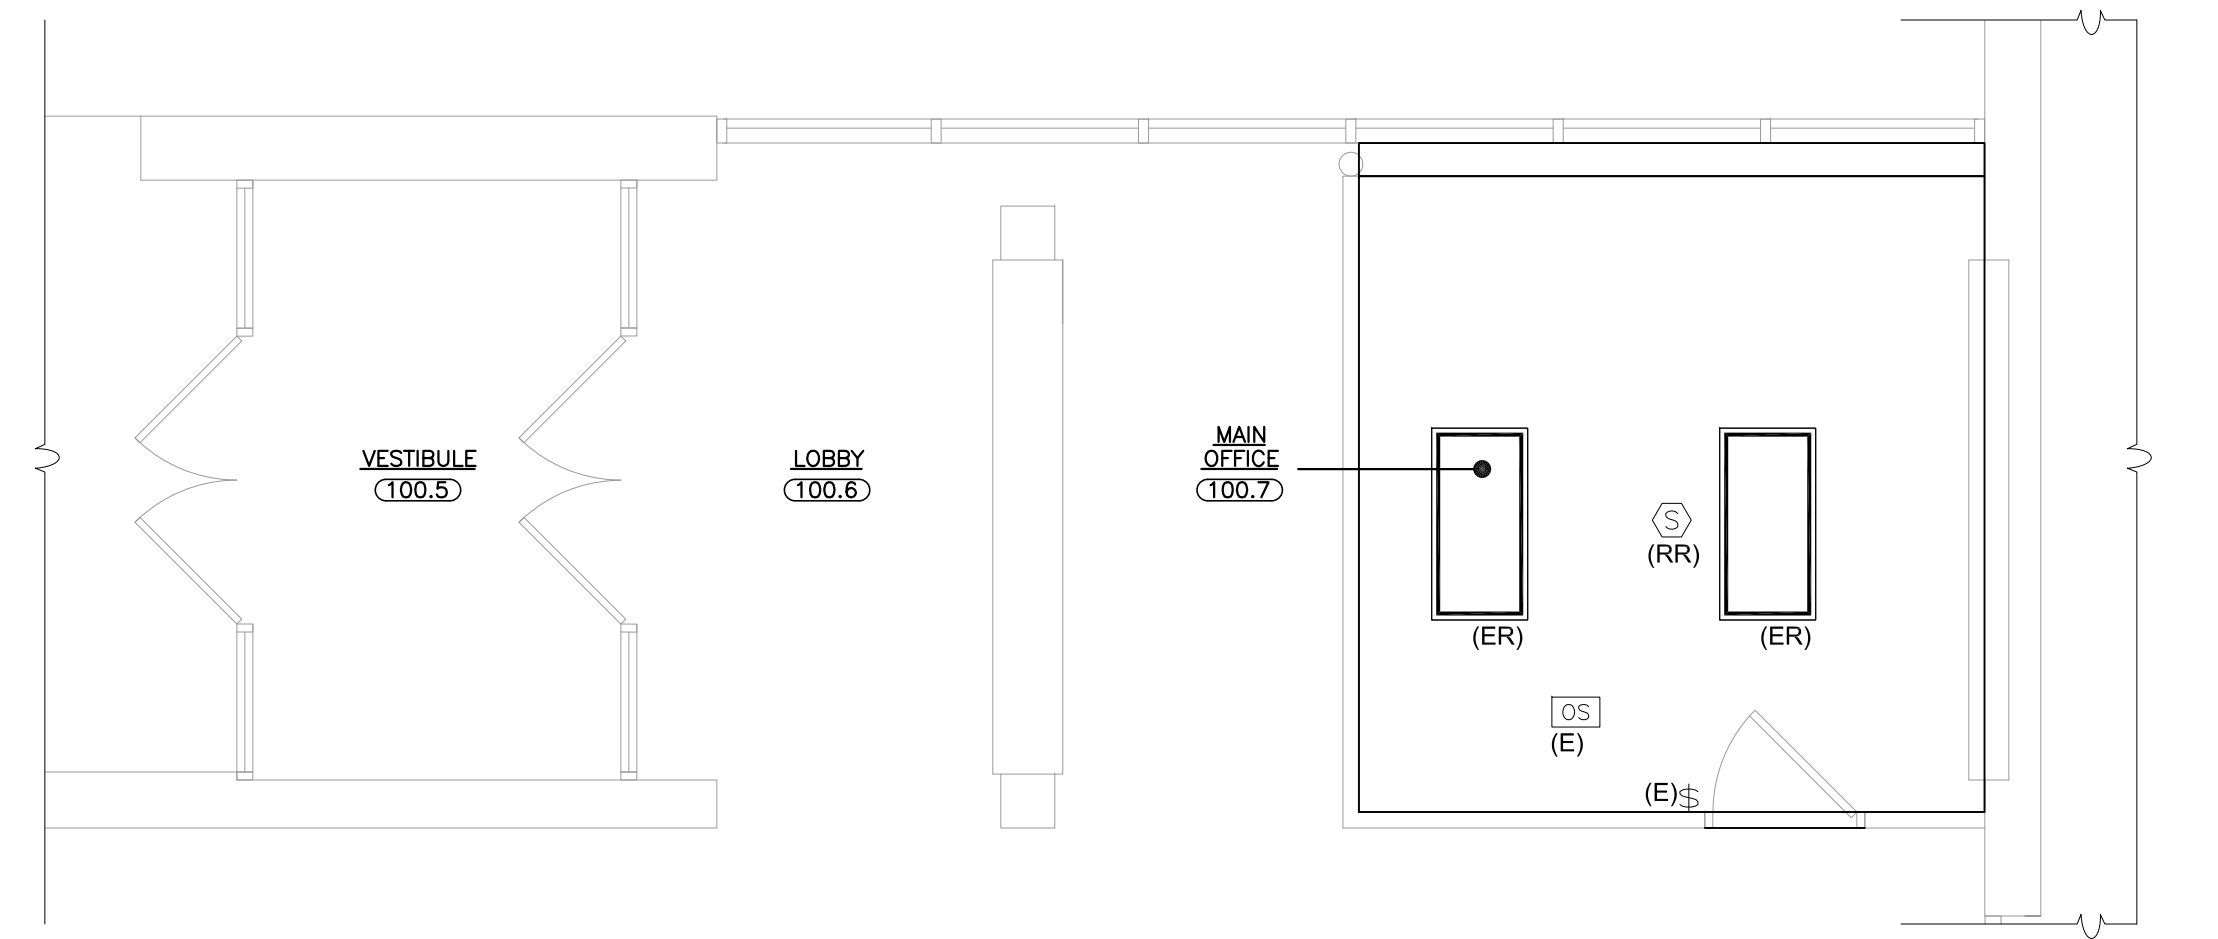
JOHN F. KENNEDY PRIMARY SCHOOL
EXISTING/ REMOVAL PLAN

- SCALE: 1/4" = 1'-0"
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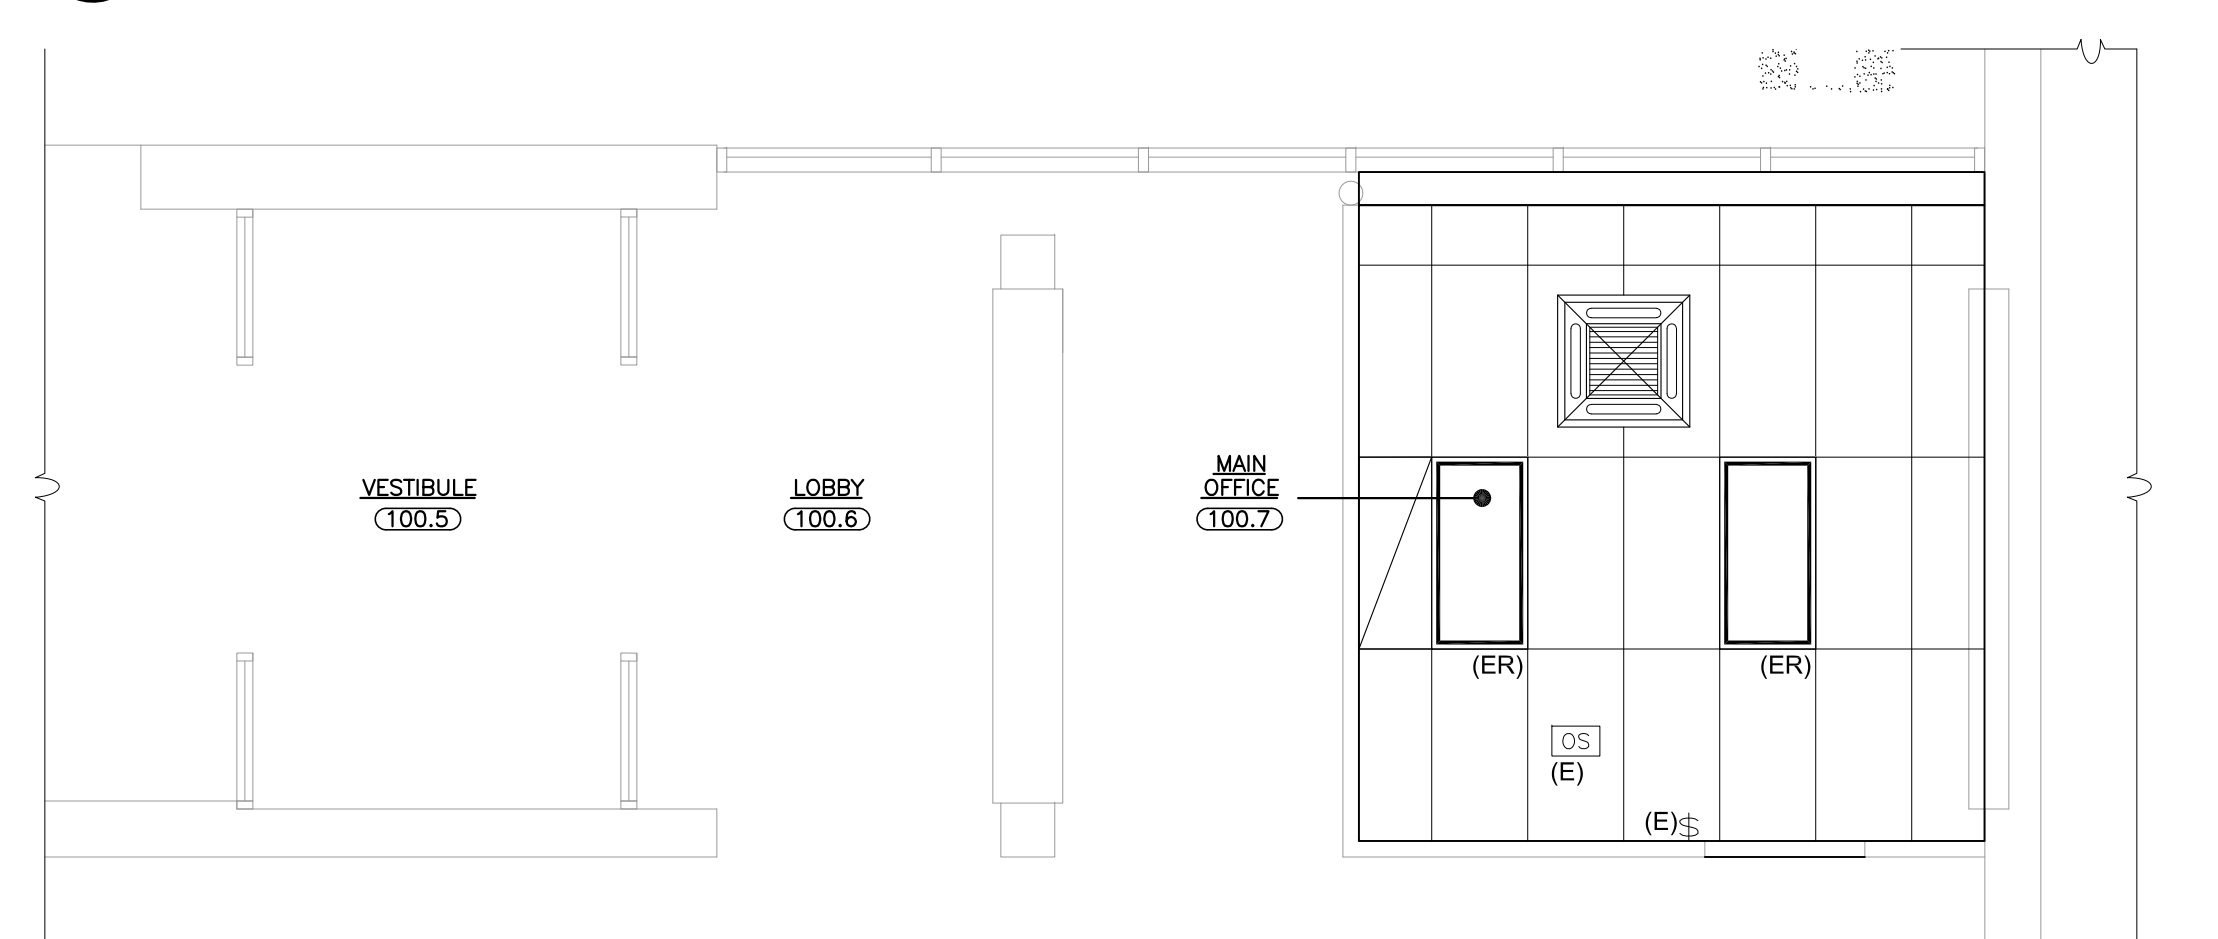
JOHN F. KENNEDY PRIMARY SCHOOL
REFLECTED CEILING PLAN (LIGHTING)

- SCALE: 1/4" = 1'-0"
- CONNECT NEW NORMAL LIGHTING FOR THIS AREA TO EXISTING LIGHTING CIRCUITS MADE AVAILABLE DURING DEMOLITION. PROVIDE NEW SWITCHING AS INDICATED. EXTEND CIRCUITS' CONDUIT AND WIRING AS REQUIRED.




JOHN F. KENNEDY PRIMARY SCHOOL
EXISTING/ REMOVAL PLAN

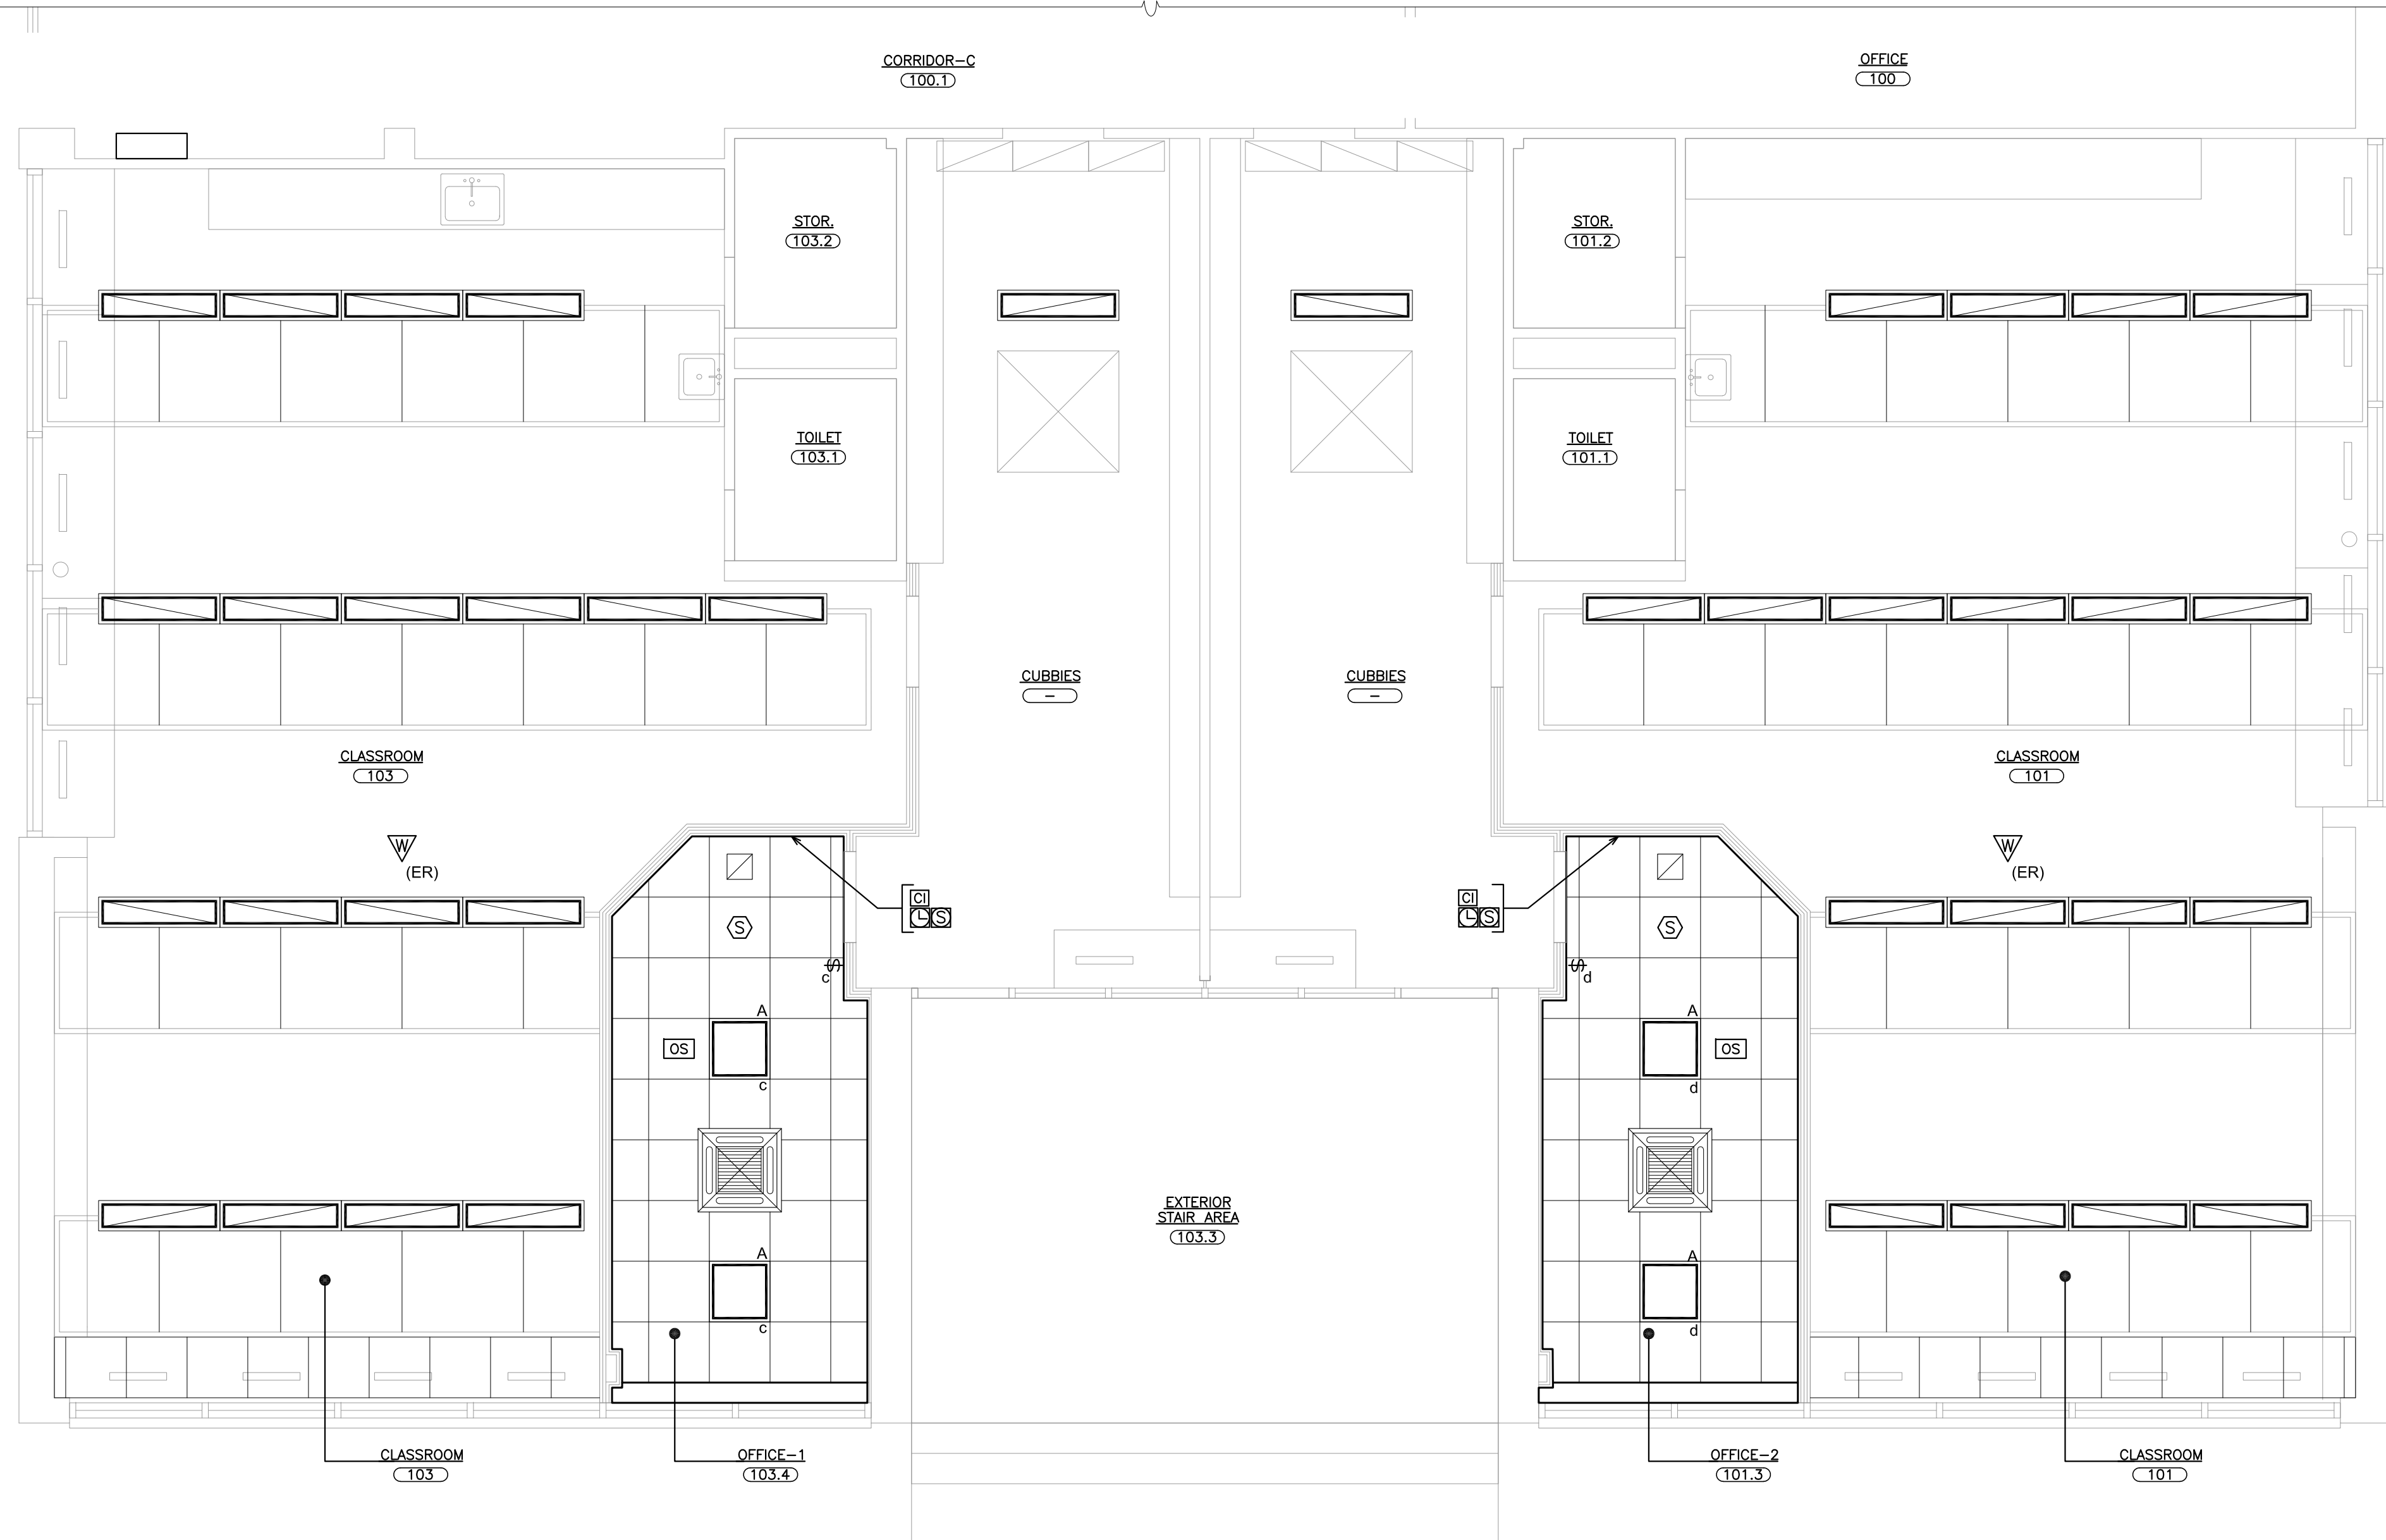SCALE: 1/4" = 1'-0"



JOHN F. KENNEDY PRIMARY SCHOOL
REFLECTED CEILING PLAN (LIGHTING)

SCALE: 1/4" = 1'-0"

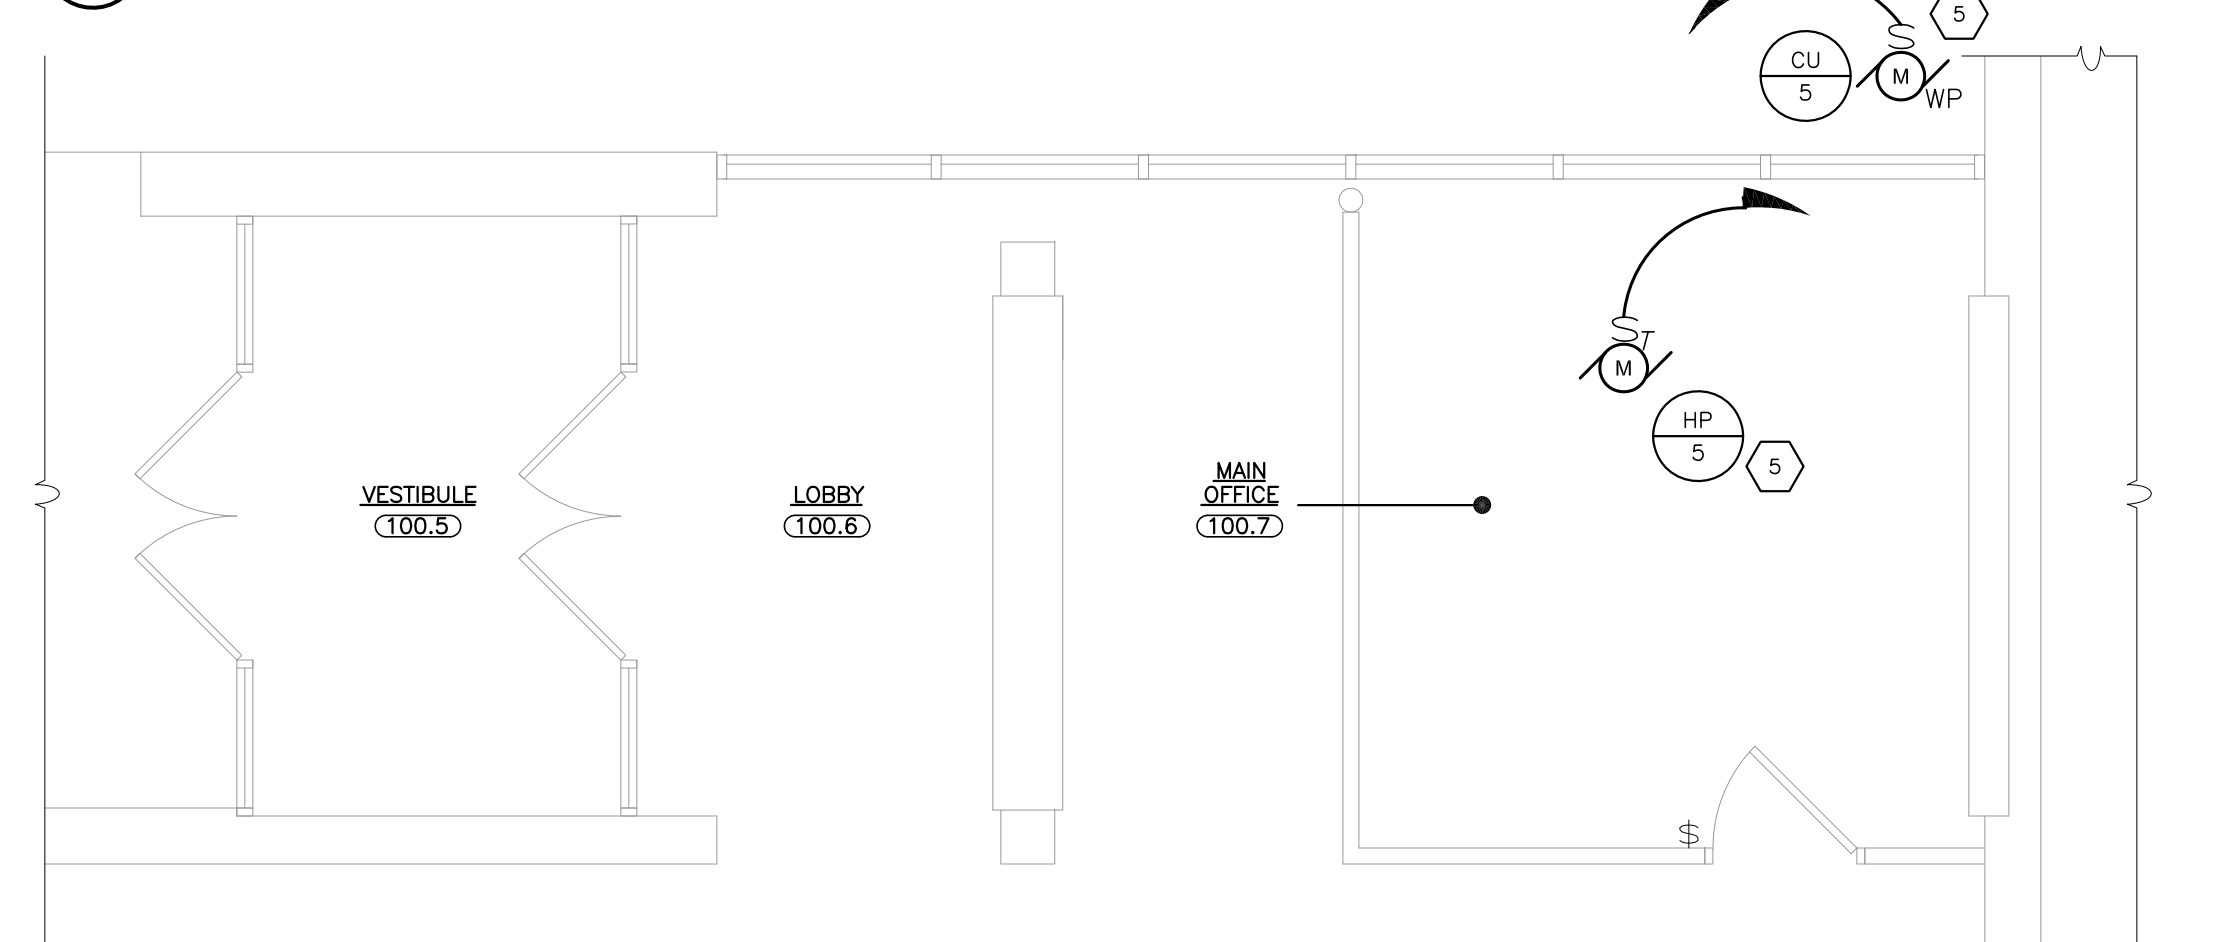

JOHN F. KENNEDY PRIMARY SCHOOL
REFLECTED CEILING PLAN (POWER)

SCALE: 1/4" = 1'-0"

KEY NOTES

1. CONTRACTOR SHALL USE EXISTING CIRCUIT MADE AVAILABLE BY REMOVALS IN THE ROOM, PROVIDE 2#12 + 1#12G - 3/4" AS NEEDED.
2. CIRCUIT NEW LIGHTING FIXTURE TO EXISTING CORRIDOR LIGHTING CIRCUIT.
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3. MAINTAIN CORRECT PHASE SEQUENCE OF ALL FEEDERS AND CIRCUITS WITH PHASE IDENTIFICATION THROUGHOUT. REARRANGE CIRCUIT IN PANEL BOARDS TO BALANCE THE PHASE LOADS WITHIN 20%.
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6. REMOVE FAN AND FAN CONTROL SWITCH.
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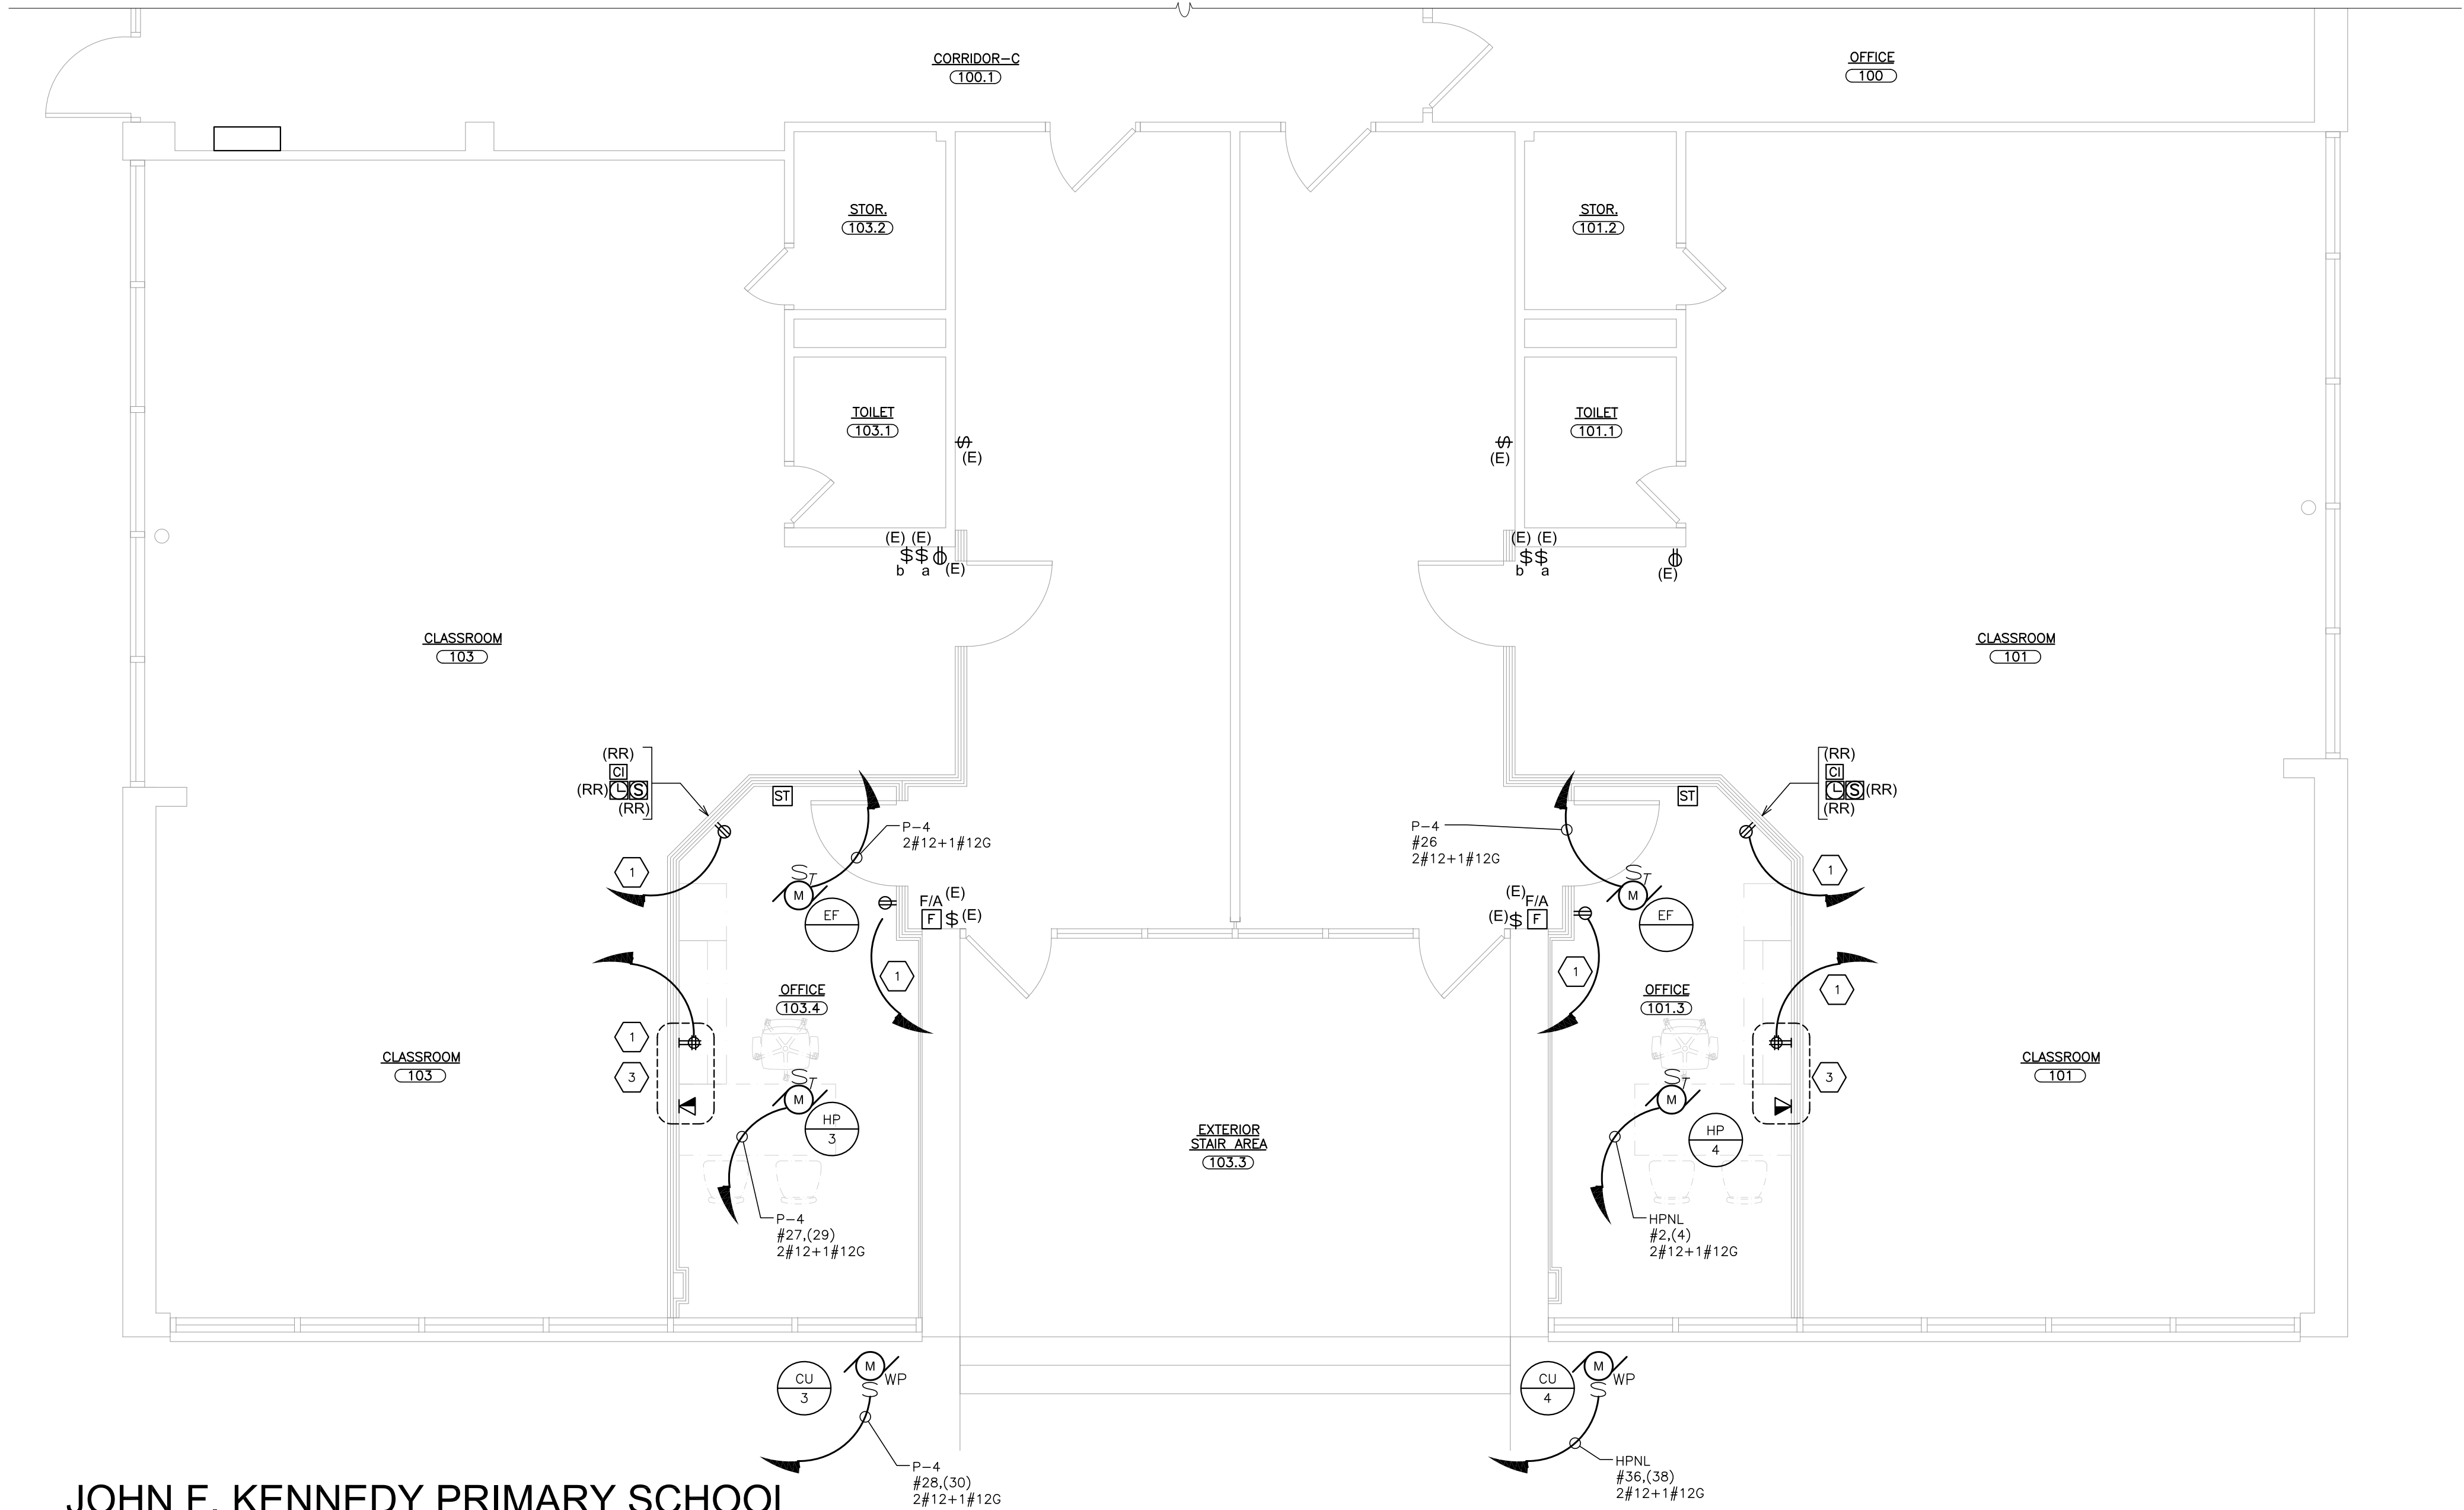
PROJECT: RYE UNION FREE SCHOOL DISTRICT
PORT CHESTER, NY
JOHN F. KENNEDY PRIMARY SCHOOL
LIBRARY ALTERATIONS
PORT CHESTER MIDDLE SCHOOL CLASSROOM ALTERATIONS
DRAWING TITLE: JOHN F. KENNEDY PRIMARY SCHOOL
FIRST FLOOR PLAN

06-08-2021 B I O
DATE ISSUED TO


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JOHN F. KENNEDY PRIMARY SCHOOL
② PLAN (POWER)
SCALE: 1/4" = 1'-0"



JOHN F. KENNEDY PRIMARY SCHOOL
⑤ FIRST FLOOR PLAN
SCALE: 1/16" = 1'-0"

CONNECT TO EXISTING PANEL BOARD "P-4 & HPNL" TO EXISTING SPACES. CIRCUIT NUMBERS AND PANEL DESIGNATION ARE SHOWN FOR CONTRACTORS GUIDANCE ONLY. PROVIDE ALL REQUIRED AND NECESSARY ACCESSORIES.

KEY NOTES

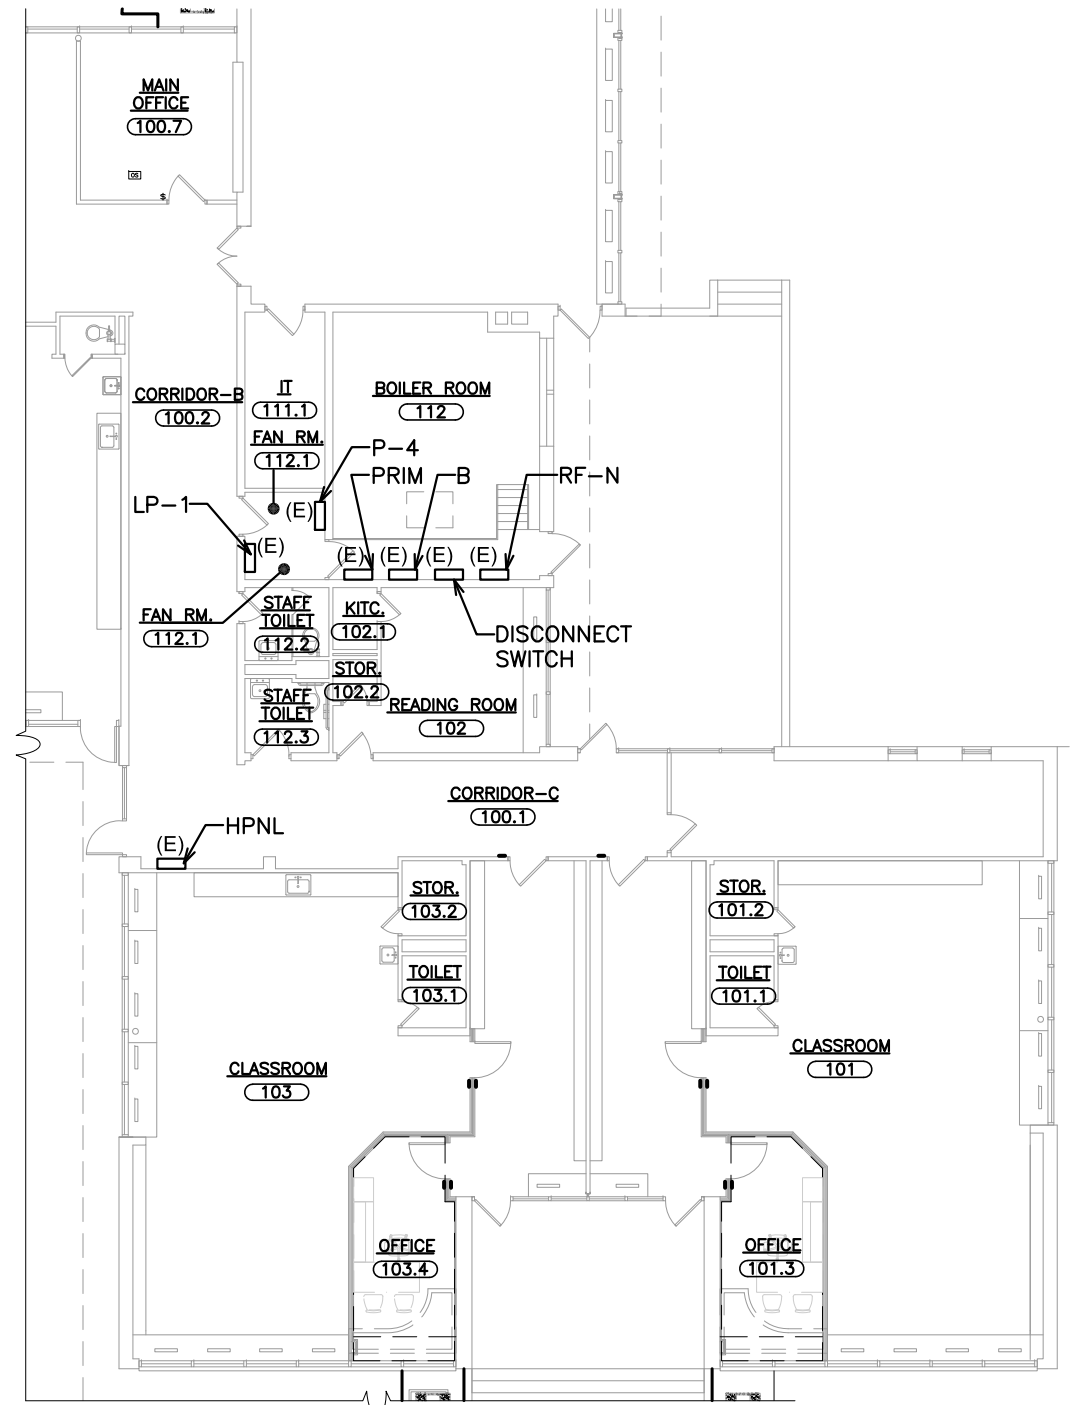- CONTRACTOR SHALL USE EXISTING CIRCUIT MADE AVAILABLE BY REMOVALS IN THE ROOM, PROVIDE 2#12 + 1#12G - 3/4" AS NEEDED.
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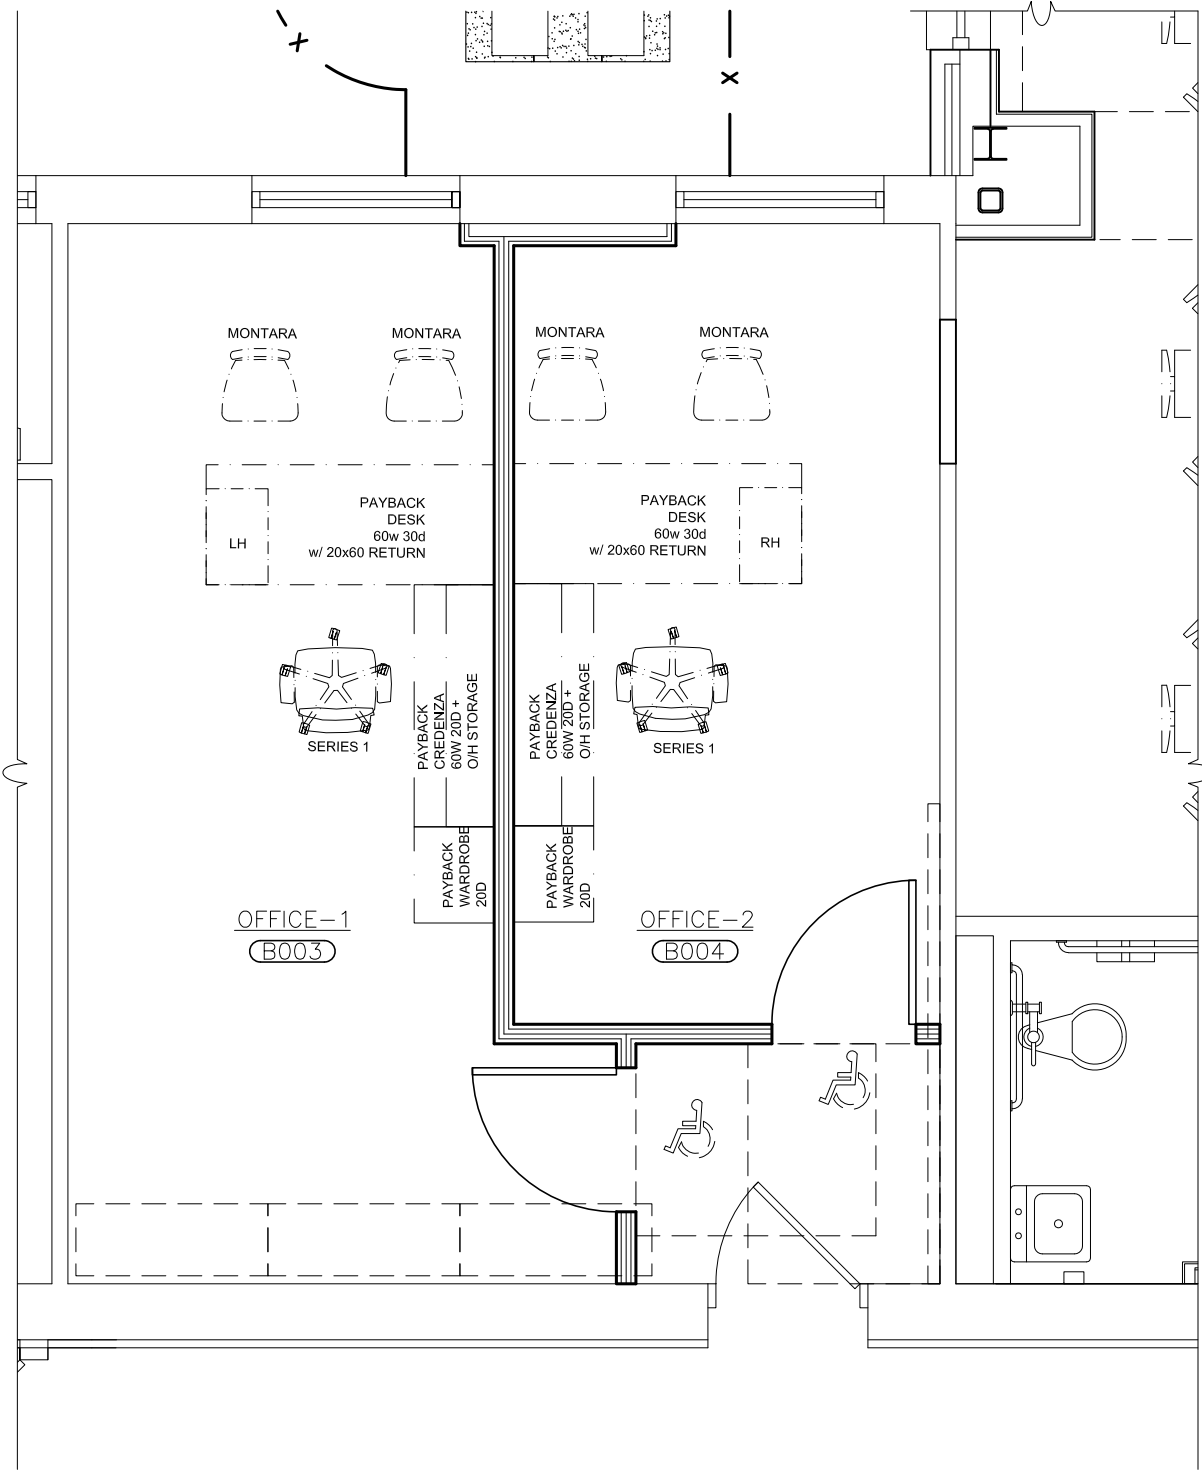
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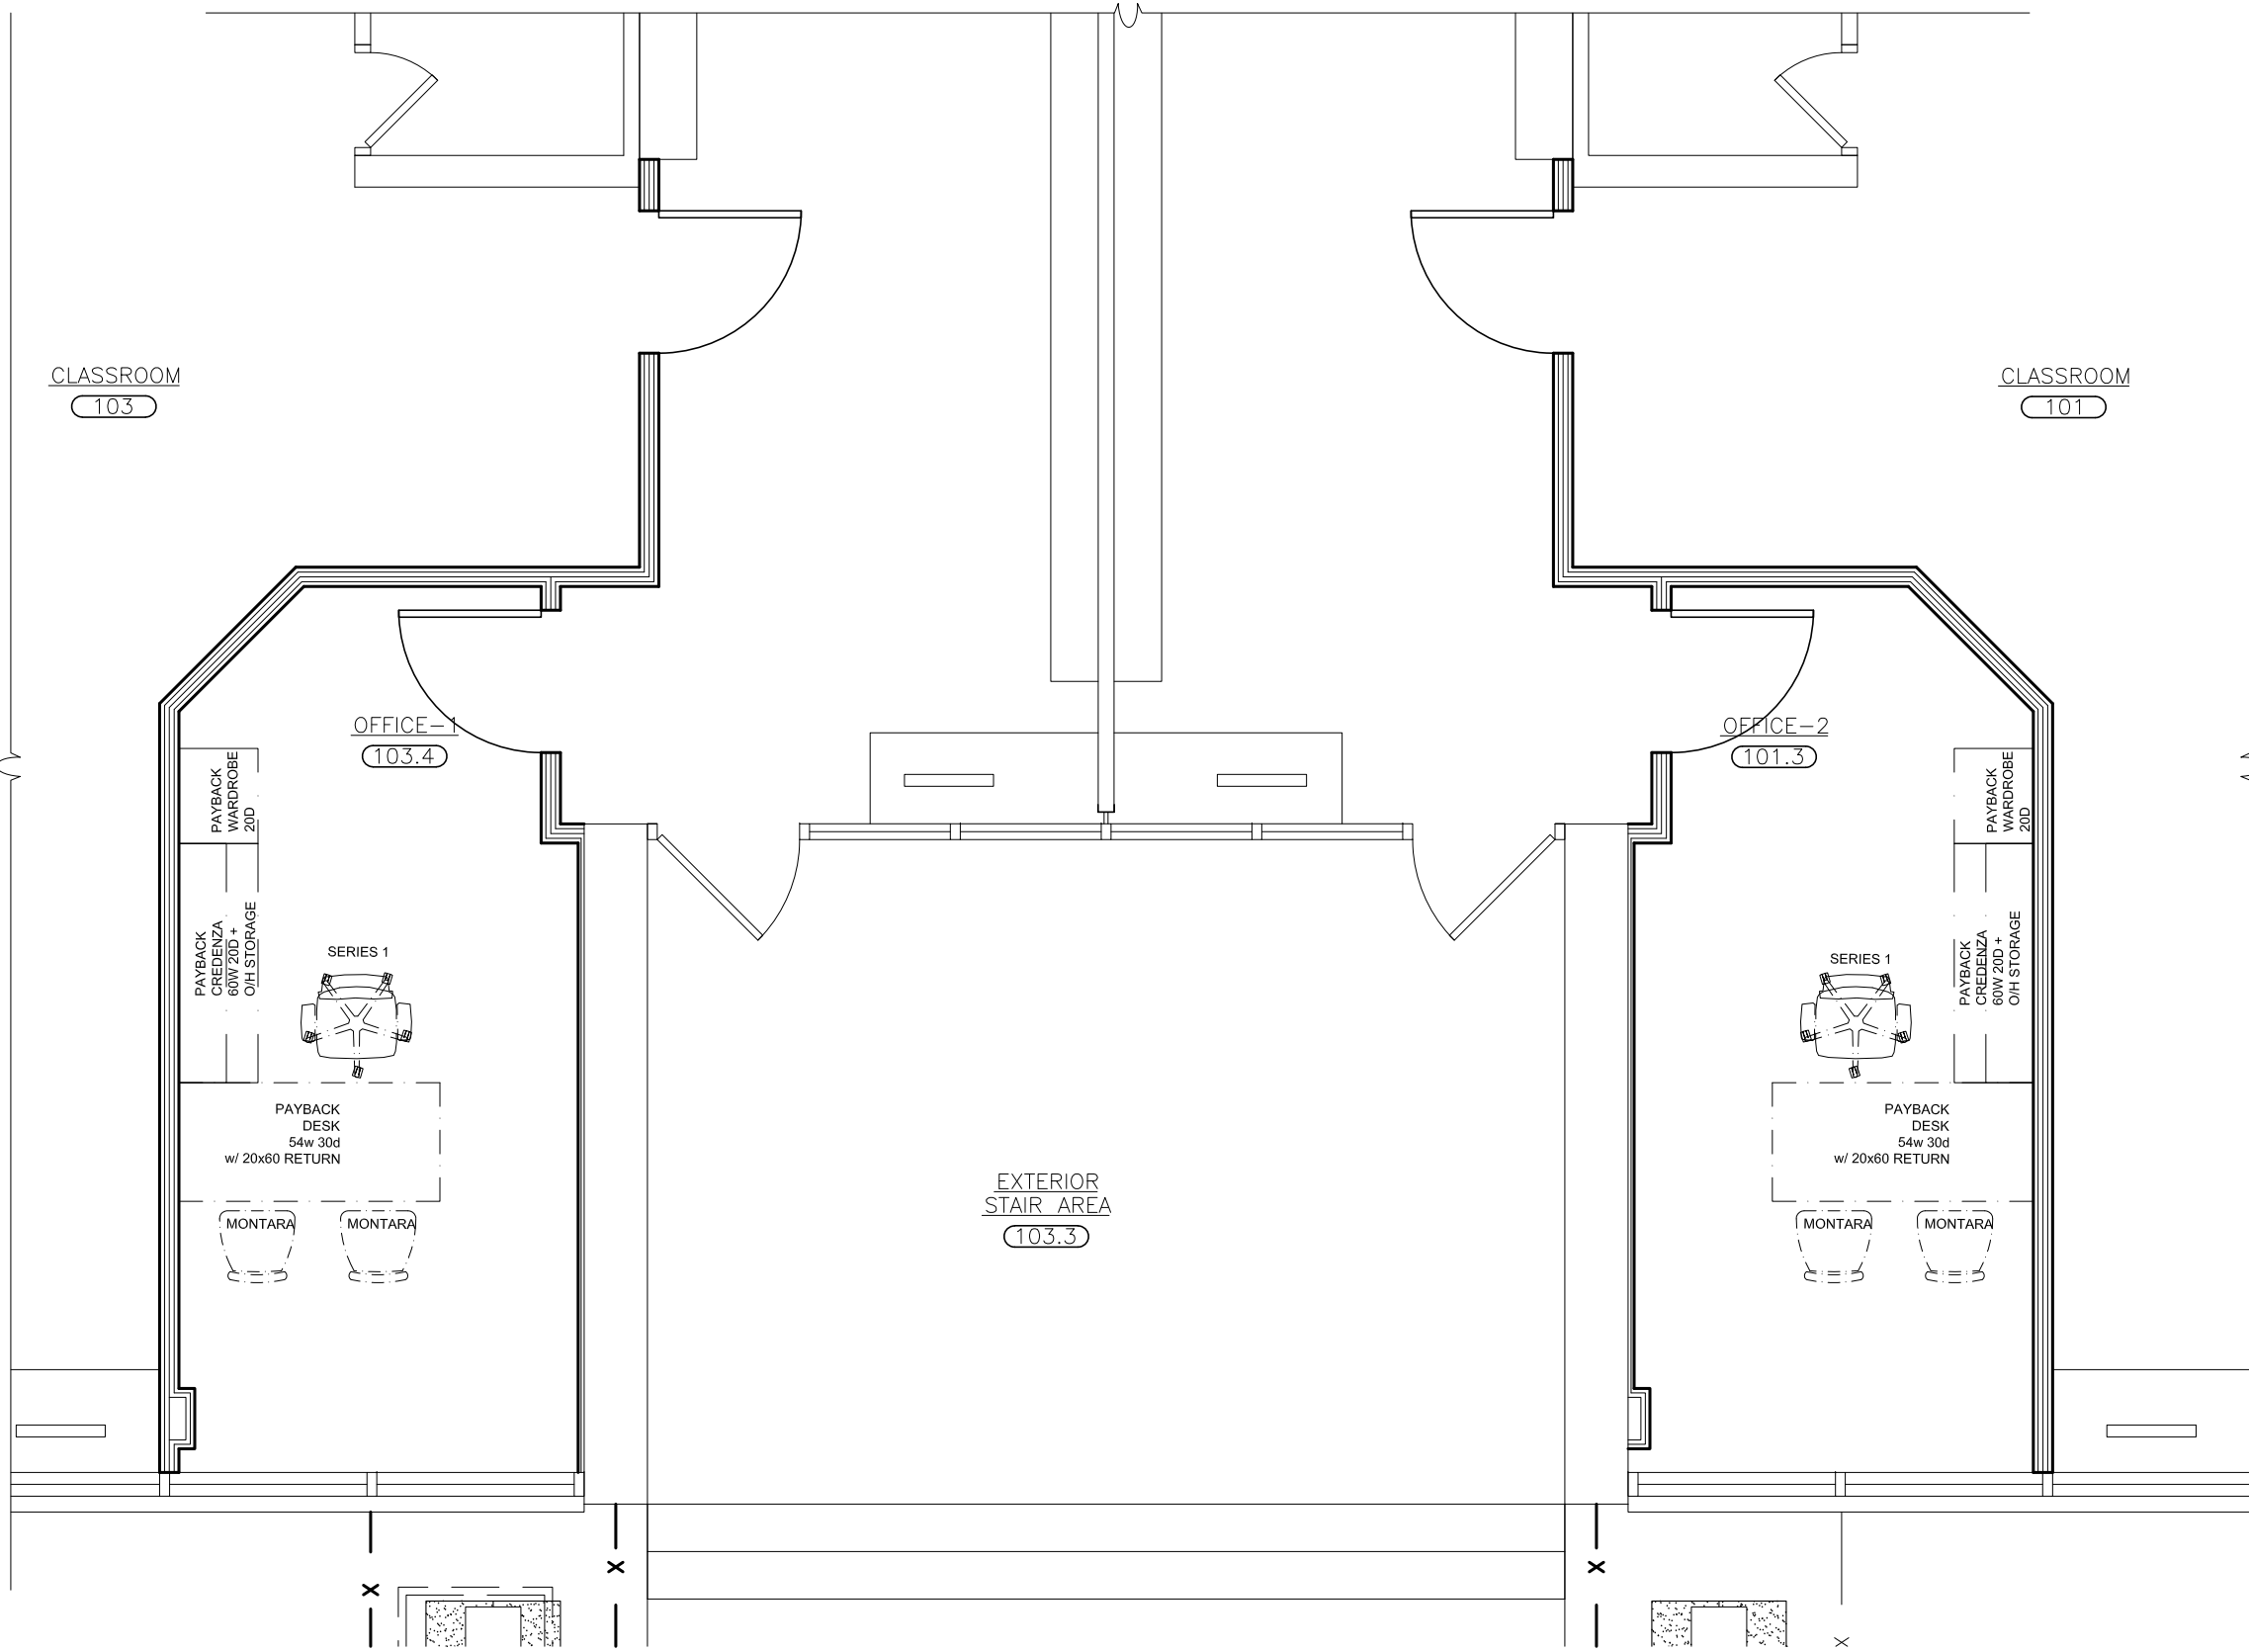
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PROJECT: JOHN F. KENNEDY PRIMARY SCHOOL
DRAWING TITLE: FIRST FLOOR PLAN
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SHEET SIZE: 30"x42"
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DATE
SHEET SIZE
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1 **PARK AVE. ELEMENTARY SCHOOL**
PARTIAL PLAN
SCALE: 1/4" = 1'-0"



2 **JOHN F. KENNEDY PRIMARY SCHOOL**
PARTIAL PLAN
SCALE: 1/4" = 1'-0"

PROJECT:
PORT CHESTER - RYE UNION FREE SCHOOL DISTRICT
PAES KSES PCMS ALTERATIONS
JOHN F. KENNEDY PRIMARY SCHOOL OFFICE ALTERATIONS
KING STREET ELEMENTARY SCHOOL LIBRARY ALTERATIONS
PORT CHESTER MIDDLE SCHOOL CLASSROOM ALTERATIONS

DRAWING TITLE
FF&E PLAN
FOR REFERENCE ONLY

06-08-2021

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