

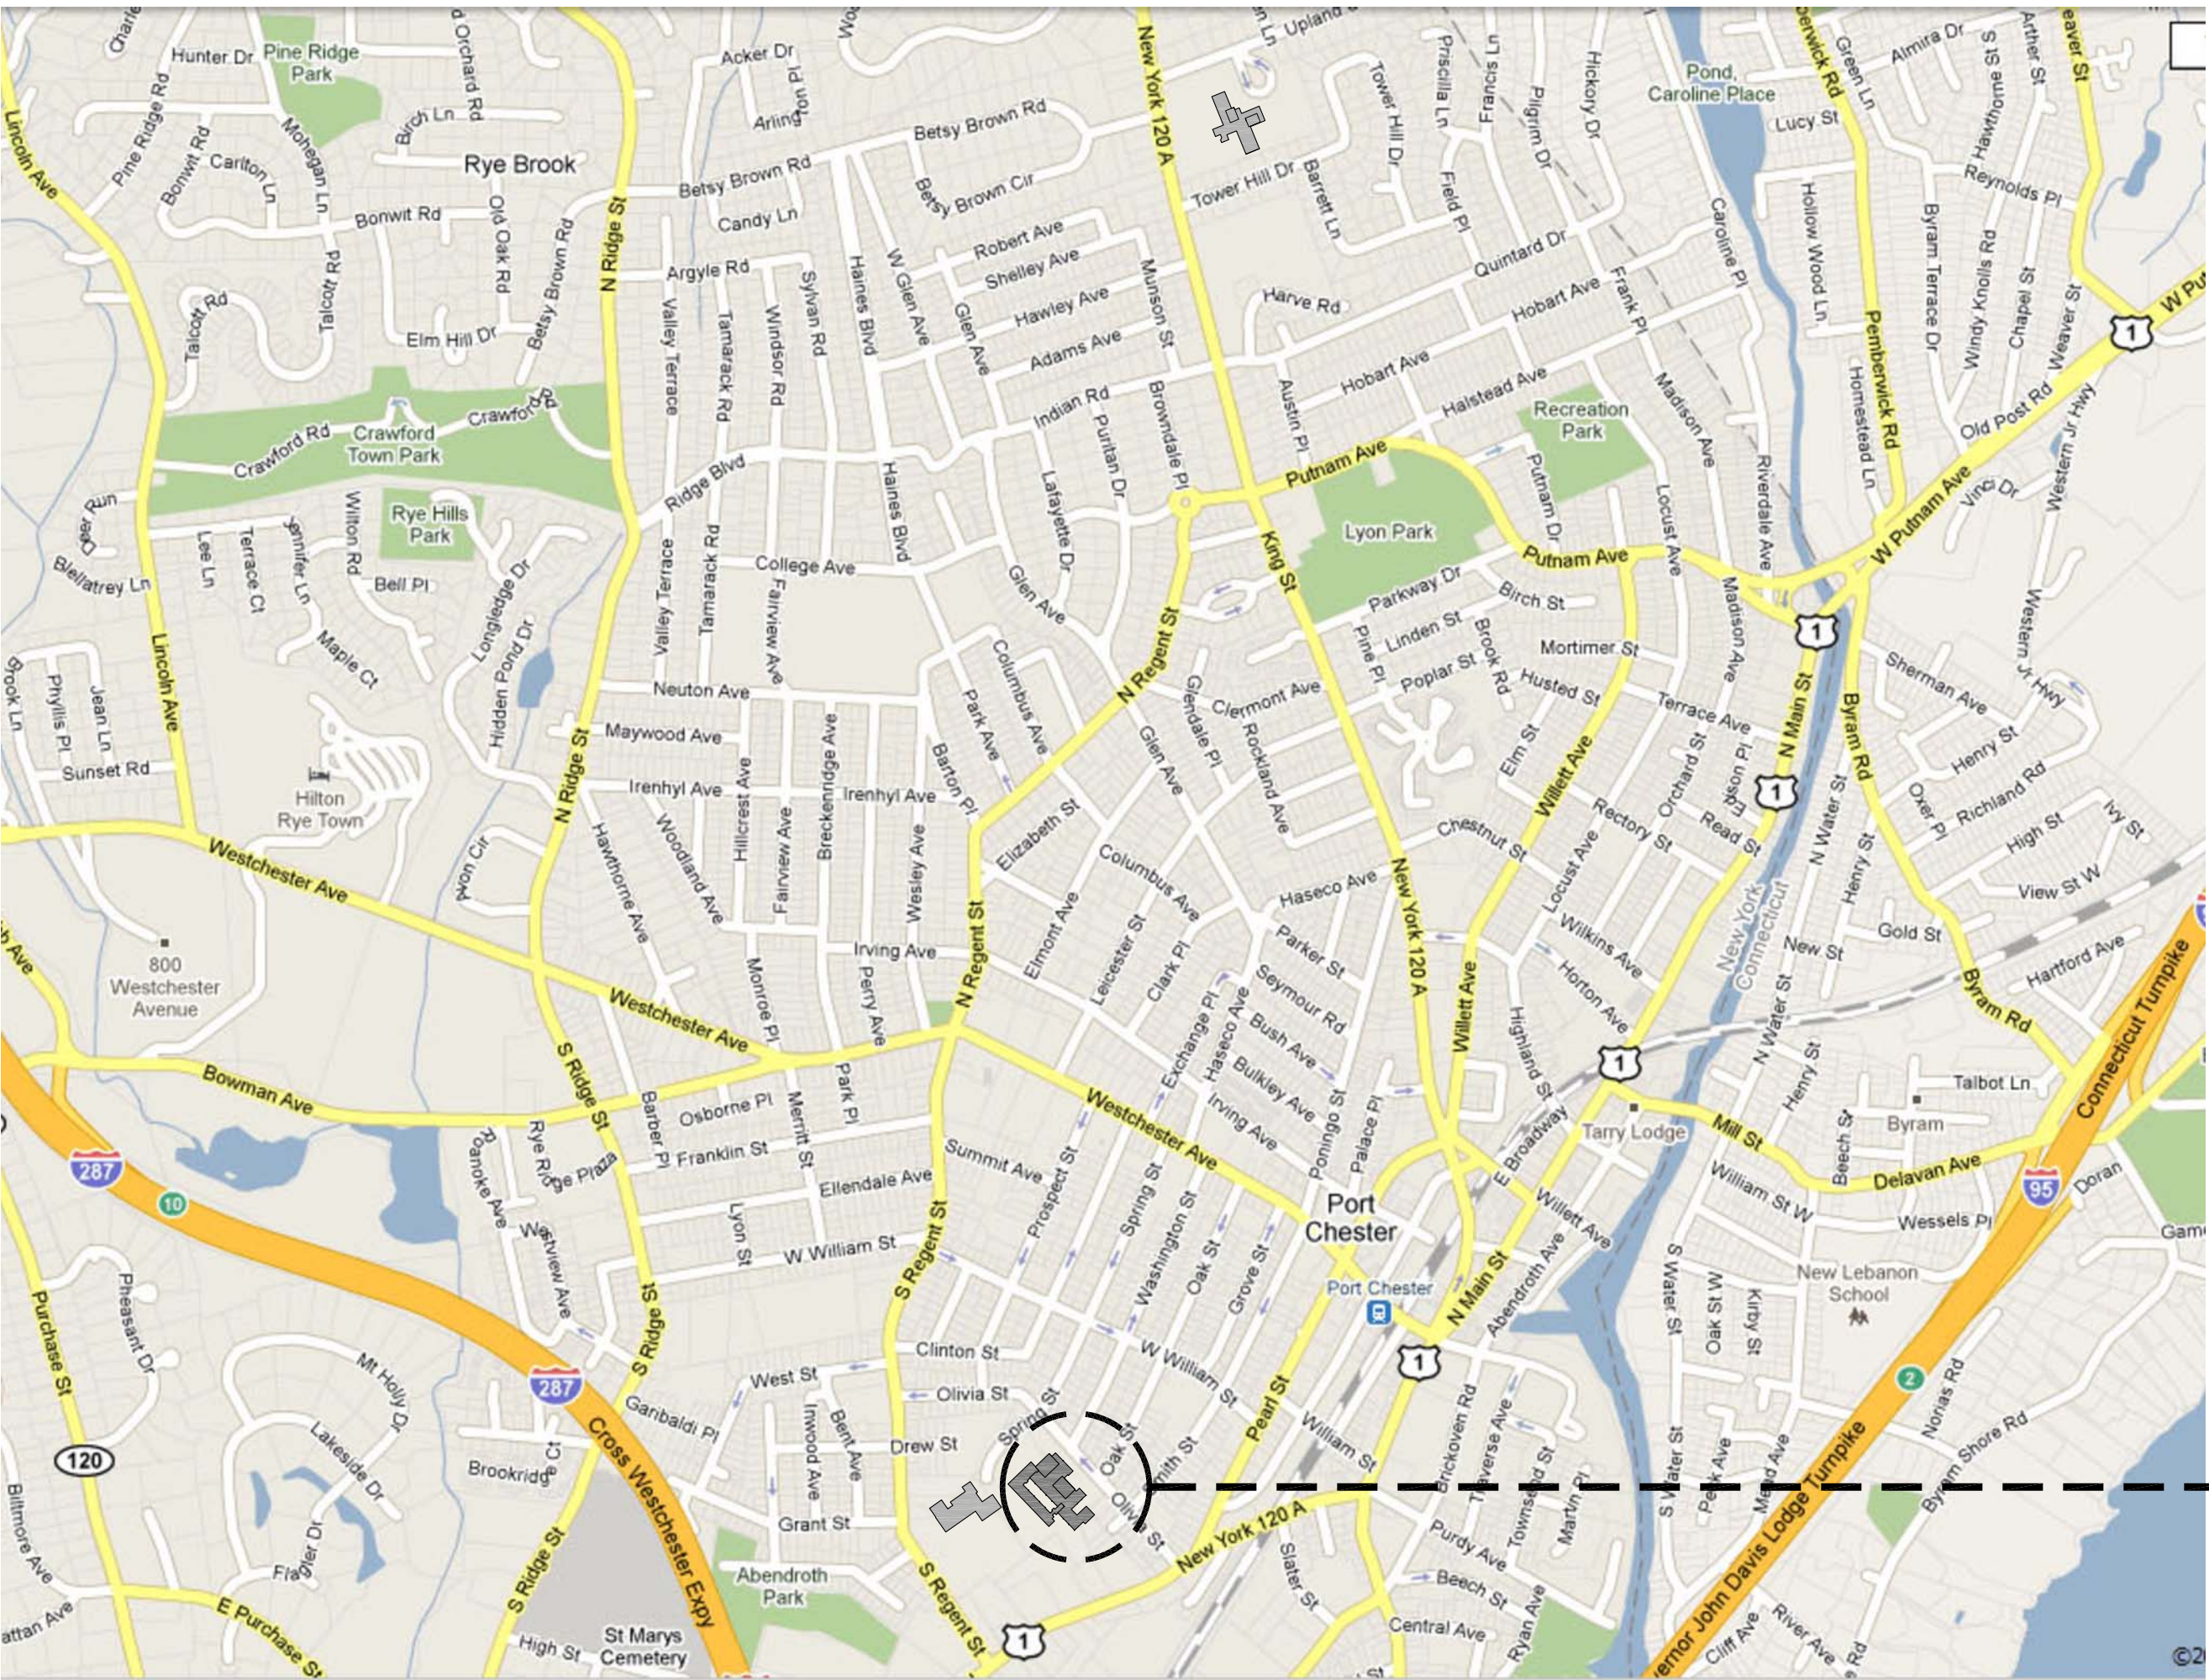
# PORT CHESTER - RYE UNION FREE SCHOOL DISTRICT

## JOHN F. KENNEDY ELEMENTARY SCHOOL

### FLOOD REPAIRS AND RELATED WORK

40 OLIVIA STREET, PORT CHESTER, NEW YORK 10573

SED PROJECT NO. 66-19-04-03 0-006-XXX



JOHN F. KENNEDY ELEMENTARY SCHOOL

FULLER  
D'ANGELO  
P.C.

ARCHITECTS  
PLANNERS

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DATE	10-18-2021	ISSUED TO	B I D
SHEET SIZE	30"x42"	DRAWING NO.	T-1
DRAWN BY	F & D	FILE NO.	21444.01
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ABBREVIATIONS

& - AND	EAT - ENTERING AIR TEMPERATURE	HX - HEAT EXCHANGER	REF - ROOF EXHAUST FAN
A/G - ALUMINUM & GLAZING	E-CONTR - ELECTRICAL CONTRACTOR	HZ - FREQUENCY(CYCLES PER MINUTE)	REIN - REINFORCED
ACU - AIR CONDITIONING UNIT (S)	EDR - ENTERING DRY BULB	INS - INSIDE DIAMETER	REIN/D - REINFORCED
ADM - ASBESTOS CONTAINING MATERIAL	EDR - EQUIVALENT DIRECT RADIATION	IN-LINE - IN-LINE EXHAUST FAN	RH - RELATIVE HUMIDITY
ACT - ACOUSTICAL CEILING TILE	EER - EMERGENCY ESCAPE AND RESCUE	INT - INTERIOR	RO - ROUGH OPENING
ACW - ASBESTOS CONTAINING WASTE	EFF - EXHAUST FAN	INT - INSULATION	RM - ROOM
AD - ACCESS DOOR	EFF - EFFICIENCY	INVT - INVERT	RNF - REVOLUTIONS PER MINUTE
ADJ - ADJACENT	EJ - EXPANSION JOINT	INCH - INCH	RTU - ROOF TOP UNIT
AFE - ABOVE FINISH FLOOR	ELEC - ELECTRICAL	J - JOINT	S - SINK
AHU - AIR HANDLER UNIT	EL - ELEVATION	JA - JANITOR'S CLOSET	SA - SUPPLY AIR
ALUM - ALUMINUM	EL/ELEV - ELEVATION	JB - JUNCTION BOX	SAN - SANITARY
ALT - ALTERNATE	E.M.H. - ELEMENTARY SCHOOL MOUNTING HEIGHT	KITCHEN	SCH - SCHEDULE
AMB - AMBIENT	ENCL - ENCLOSURE	KW - KINDERGARTEN	SD - SMOKE DETECTOR
AMP - AMPERE	ENTR - ENTRANCE	K.M.H. - KINDERGARTEN MOUNTING HEIGHT	S.D.MPR - SMOKE DAMPER
APD - AIR PRESSURE DROP	EQ - EQUIPMENT	L - LENGTH	SECT - SECTION
APPROX - APPROXIMATE	ESP - EXTERNAL STATIC PRESSURE	LAT - LEAKING AIR TEMPERATURE	SF - SQUARE FOOT
ARCH - ARCHITECTURAL	ETC - AND SO FORTH	LAM - LAMINATE	SHT - SHEET
AVG - AVERAGE	EVP - EVAPORATOR	LAV - LAVATORY	SH - SIMILAR
BDD - BACK DRAFT DAMPER	EWB - ENTERING WET BULB	LBS/# - POUNDS	SP - STATIC PRESSURE
BFW - BOILER FEED WATER	EX - EXPOSED	LDR - LEADER	SPEC(S) - SPECIFICATION (S)
BHP - BRAKE HORSE POWER	EXH - EXHAUST	LFD - LEADER	SQ - SQUARE
BTUM - BITUMINOUS	EXH - EXHAUST AIR	LQ - LIQUID	SQ FT - SQUARE FEET
BUDG - BUILDING	EXIST - EXISTING	LL - LIVE LOAD	SS - STAINLESS STEEL
BLK - BLOCK	EXP - EXPOSED CONSTRUCTION	LP - LOW POINT	STD - STANDARD
B.O.P. - BOTTOM OF PLANK	EXT - EXTERIOR	LP - LOW PRESSURE STEAM	STL - STEEL
B.O.S. - BOTTOM OF SLAB	F - FAHRENHEIT	LRG - LINEAR RETURN GRILLE	STM - STEAM
BTUH - BRITISH THERMAL UNITS/HOUR	FAI - FRESH AIR INTAKE	LSD - LINEAR SUPPLY DIFFUSER	STOR - STORAGE
BU - BUILT UP	FB - FIRE BLANKET	LWT - LEAKING WATER TEMPERATURE	STRUCT - STRUCTURAL
BU - BUILT UP ROOFING	FCU - FAN COIL UNIT	M - MIRROR	SUCT - SUCTION
CB - COEFFICIENT, VALVE FLOW	F.D. - FLOOR DRAIN	MAX - MAXIMUM	SUSP - SUSPENDED
CB - CATCH BASIN	F.D.M.P. - FIRE DAMPER	MCH - MOTOR	T - TREAD/TOILET
C.C. - COOLING COIL	F.E. - FIRE EXTINGUISHER	MBH - BTU PER HOUR (THOUSAND)	TEMP - TEMPERATURE CONTROL PANEL
CER/CEG - CEILING EXHAUST REGISTER/ GRILLE	F.E.-1 - FIRE EXTINGUISHER - SURF. MT.	MECH - MECHANICAL	T.DIFF - TEMPERATURE DIFFERENCE
CFM - CUBIC FEET PER MINUTE	F.E.-2 - FIRE EXTINGUISHER - RECESSED	MFR - MANUFACTURER	TEL - TELEPHONE
C.H. - CEILING HEIGHT	FG - FIBER GLASS	MIN - MINIMUM	TEMP - TEMPERATURE
CHW/CEG - CEILING EXHAUST REGISTER/ GRILLE	FIN - FINISH	MKB - MARKER BOARD	THK - THICK
CHWR - CHILLED WATER RETURN	FIXT - FIXTURE	MISCL - MISCELLANEOUS	TRBD - TRUCK BOARD
CMS - CHILLED WATER SUPPLY	FLR - FIRE HOSE CABINET	MPO - MEDIUM PRESSURE STEAM	T.O. - TOP OF CURB
C.J. - CONTROL JOINT	FLY/FLR - FLYING	MPS - MASONRY OPENING	T.O.M.D. - TOP OF METAL DECK
CL - CENTER LINE	FTG - FOOTING	MS - MARBLE SADDLE	T.O.P. - TOP OF PARAPET
CLG WTR - COOLING WATER	FOG - FOG ON BOTTOM	MTD - MOUNTED	T.O.S. - TOP OF STEEL
CLS - CLOSET	FOO - FUEL OIL GAUGE	MTL - METAL	TSP - TOTAL STATIC PRESSURE
CMU - CONCRETE MASONRY UNIT	FOS - FUEL OIL RETURN	N - NORTH	TSTAT - TYPICAL
CMP - CORRUGATED METAL PIPE	FOT - FLAT ON TOP	NC - NORMALLY CLOSED	U - URINAL
C.O. - CLEAN OUT	F.P. - FIRE PROOF	N/C - NOT IN CONTRACT	UH - UNIT HEATER
COL - COLUMN	FPM - FEET PER MINUTE	NO(S) - NUMBER(S)	UL - UNDERWATERS LABORATORY
COMP - COMPRESSOR	FRP - FEET PER SECOND	N/OPEN - NORMALLY OPEN	UNFIN - UNFINISHED
CONC - CONCRETE	FRP - FIBERGLASS REINFORCED POLYSTYRENE	N.T.S. - NOT TO SCALE	UV - UNIT VENTILATOR
COND - CONDENSER	FT - FOOT OR FEET	OC - ON CENTER	V - VOLT
CONST - CONSTRUCTION	GA - GAUGE	OD - OUTSIDE DIAMETER	VAV - VARIABLE AIR VOLUME
CONT - CONTINUOUS	GAL - GALLONS	ODR - OPEN DUCT RETURN	V.C.T. - VINYL COMPOSITION TILE
CONTR - CONTRACTOR	GALV - GALVANIZED	OF - OUTSIDE FACE	VD - VOLUME DAMPER
CONV - CONVERTER	G.C. - GENERAL CONSTRUCTION	O.H. - OPPOSITE HAND	VEL - VELOCITY
COOR/CRC - COORDINATE RETURN REGISTER/ GRILLE	GL - GLASS	O.H. - OVERHEAD	VEST - VESTIBULE
CRT - CARPET	GPH - GALLONS PER HOUR	OPNG - OPENING	VLF - VERIFY IN FIELD
CRT - CARPET	GRM - GALLONS PER MINUTE	OPP - OPPOSITE	VLV - VALVE
CRU - COMPUTER ROOM UNIT	GR - GRAINS	OZ - OUNCE	V.M. - VISION PANEL
CSD - CEILING SUPPLY DIFFUSER	G.T. - GLAZED WALL TILE	P - PART	V.W.C. - VINYL WALL COVERING
CT - CERAMIC TILE	G.V. - GAS VALVE	P-CONTR - PLUMBING CONTRACTOR	W - WOMEN/WIDTH/WASHER
CTB - CERAMIC TILE BASE	GYP. BD. - GYPSUM BOARD	PB - PANEL BOX	W/ - WITH
C.TWR. - COOLING TOWER	H.B. - HOSE BIB	PD - PRESSURE DROP	W.C. - WATER CLOSET
CD - CONDENSER UNIT	H-CONTR - HEATING, VENTING, AND AIR CONDITIONING	PH - PENTHOUSE	WD - WOOD
CU FT - CUBIC FEET	H-CONTR - HEATING, VENTING, AND AIR CONDITIONING	PI - PLASTIC LAMINATE	WEF - WALL EXHAUST FAN
CWH - CABINET UNIT HEATER	H-CONTR - HEATING, VENTING, AND AIR CONDITIONING	PLT - PLATE	WEG/WEG - WALL EXHAUST REGISTER/GRILLE
CWS - CONDENSER WATER RETURN	H-CONTR - HEATING, VENTING, AND AIR CONDITIONING	PLMB - PLUMBING	W'G - INCHES OF WATER, GAGE (PRESSURE)
CWS - CONDENSER WATER SUPPLY	H-CONTR - HEATING, VENTING, AND AIR CONDITIONING	PLYWOOD - PLYWOOD	W.G. - WIRE GLASS
D/M - DIAMETER	H-CONTR - HEATING, VENTING, AND AIR CONDITIONING	PNL - PANEL	W.K. - WORK
DB - DRY BULB TEMPERATURE	H-CONTR - HEATING, VENTING, AND AIR CONDITIONING	PL - PAINT	W.I. - WROUGHT IRON
DC - DECIBEL	H-CONTR - HEATING, VENTING, AND AIR CONDITIONING	PREAB - PREFABRICATED	W.P. - WATER PROOF
DEG - DEGREE	H-CONTR - HEATING, VENTING, AND AIR CONDITIONING	PRESS - PRESSURE	WPD - WATER PRESSURE DROP
DEMO - DEMOLITION	H-CONTR - HEATING, VENTING, AND AIR CONDITIONING	PSI - POUNDS PER SQUARE INCH	W.R. - WATER RESISTANT
D.F. - DRINKING FOUNTAIN	H-CONTR - HEATING, VENTING, AND AIR CONDITIONING	PRESS - PRESSURE	WRR/WRR - WALL RETURN REGISTER/GRILLE
D.H. - DOUBLE HUNG	H-CONTR - HEATING, VENTING, AND AIR CONDITIONING	PSI - POUNDS PER SQUARE INCH	WRR/WRR - WALL SUPPLY REGISTER/GRILLE
DM - DIMENSION	H-CONTR - HEATING, VENTING, AND AIR CONDITIONING	QTY - QUANTITY	W.W.F. - WELDED WIRE FABRIC
DN - DOWN	H-CONTR - HEATING, VENTING, AND AIR CONDITIONING	R - RISER/RADIUS	W.W.M. - WELDED WIRE MESH
D.O. - REPEAT/DOOR OPENING	H-CONTR - HEATING, VENTING, AND AIR CONDITIONING	RA - RETURN AIR	YD - YARD DRAIN
DP - DEEP	H-CONTR - HEATING, VENTING, AND AIR CONDITIONING	RAD - RADIATION	
DWC - DRAWING	H-CONTR - HEATING, VENTING, AND AIR CONDITIONING	RAT - RUBBER TILE	
DX - DIRECT EXPANSION	H-CONTR - HEATING, VENTING, AND AIR CONDITIONING	RO - ROOF DRAIN	
E - EAST	H-CONTR - HEATING, VENTING, AND AIR CONDITIONING		
EA - EACH	H-CONTR - HEATING, VENTING, AND AIR CONDITIONING		

GRAPHIC LEGEND

CLASSROOM	ROOM NAME & NUMBER	REMOVE EXISTING CONSTRUCTION
100	DOOR NUMBER	EXISTING CONSTRUCTION
100	ELEVATION KEY	NEW WALL CONSTRUCTION
100	INTERIOR WALL INDICATIONS	COLUMN GRID LINES
100	WINDOW TYPE	EXISTING COLUMN DESIGNATION
100	REMOVAL/WORKSCOPE NOTE	BUILDING/WALL SECTION/DETAIL
100	REVISION MARK	REFERENCE POINT
100	DETAIL NO.	HIDDEN LINE BELOW
100	DETAIL KEY	HIDDEN LINE ABOVE OR BEYOND
100	DWG. NO.	CENTERLINE OR N.I.C. LINE
100	WALL TYPE	EXISTING DOOR INDICATES DOOR NUMBER (SEE DOOR SCHEDULE)
100	EXTERIOR ELEVATION KEY	NEW DOOR INDICATES DOOR NUMBER (SEE DOOR SCHEDULE)
100	FLUSH THRESHOLD	5'-0" x 6" HANDICAPPED TURNING RADIUS
100	FLUSH	
100		

MATERIALS LEGEND

CONCRETE	PARTICLE BOARD
CONCRETE MASONRY UNITS	PLYWOOD
BRICK	ACOUSTICAL TILE
STONE	CONTINUOUS WOOD FRAMING THROUGH MEMBER
METALS	WOOD FRAMING THROUGH INTERRUPTED MEMBER
COMPACTED GRAVEL	FINISHED WOOD
EARTH/UNDISTURBED SOIL	BATT INSULATION
DRAINAGE BOARD	RIGID INSULATION

GENERAL NOTES

THE FOLLOWING NOTES SHALL APPLY THROUGHOUT. EXCEPTIONS ARE SPECIFICALLY NOTED ON EACH DRAWING:

- ALL ELEVATIONS AND DETAILS SHOWN ON THESE DRAWINGS ARE TYPICAL. MASONRY REPAIR WORK IS SHOWN AS SHOWN. CLARIFICATION CAN BE ISSUED DURING THE BID PERIOD. IN THE EVENT DISCREPANCIES, OMISSIONS OR AMBIGUITIES IN THE CONTRACT DOCUMENTS ARE NOT CLARIFIED, THE CONTRACTOR(S) SHALL COMPENSATE SAME IN THE WORK SCOPE, USING THE NECESSARY OR BETTER QUALITY MATERIAL OR METHOD OF WORK AND WILL INCLUDE IN HIS BID PROPOSAL, ALL COSTS FOR SAME.
- IT IS EACH CONTRACTOR'S RESPONSIBILITY TO BE FULLY INFORMED OF THE SCOPE OF THE PROJECT. THE CONTRACTOR SHALL VERIFY ALL EXISTING CONDITIONS; DIMENSIONS ETC. OF THE EXISTING BUILDING(S) AND SHALL ADAPT THE NEW WORK TO SUIT SUCH CONDITIONS UNLESS OTHERWISE SHOWN.
- EACH CONTRACTOR SHALL COORDINATE HIS OWN WORK WITH WORK OF ALL OTHER CONTRACTORS ENGAGED ON THE PROJECT INCLUDING BUT NOT LIMITED TO: PENETRATIONS, FABRICATIONS AND INSTALLATIONS. THE CONTRACTOR MUST COMPLY WITH ALL PROVISIONS OF THE CONTRACT DOCUMENTS AND APPLICABLE REFERENCED STANDARDS.
- INDICATED DIMENSIONS ARE TO FACE OF MASONRY, CONCRETE, FACE OF FINISH OR CENTERLINE AS NOTED.
- WRITTEN DIMENSIONS SHALL TAKE PRECEDENCE OVER SCALED DIMENSIONS.
- WHERE REQUIRED, SHOP DRAWINGS SHALL BE SUBMITTED AND APPROVED BY THE ARCHITECT BEFORE ANY SHOP FABRICATION OR FIELD WORK IS PERFORMED.
- EACH CONTRACTOR SHALL BE FULLY INFORMED OF ALL CODES HAVING JURISDICTION OVER ALL THE WORK INCLUDING ALL APPLICABLE STATE EDUCATION DEPARTMENT PLANNING STANDARDS. IN THE EVENT OF ANY CONFLICTS, THE MORE STRINGENT CODE OF STANDARD SHALL TAKE PRECEDENCE.
- USE ONLY NEW AND BEST QUALITY MATERIALS AND EQUIPMENT FOR THE INTENDED PURPOSE, AND THE BEST WORKMANSHIP TO CONSTRUCT THE NEW WORK WITHOUT DEFECTS.
- IN THE EVENT OF A CONFLICT, LARGE SCALE DRAWINGS SHALL TAKE PRECEDENCE OVER SMALL SCALE DRAWINGS WITHOUT OMITTING OTHER PORTIONS OF THE SMALL SCALE DRAWING IN QUESTION. SIMILARITY, NOTES SHALL TAKE PRECEDENCE OVER SCHEDULES, FINING AND DIMENSION DIAGRAM WITHOUT OMITTING OTHER WORK SHOWN OR DESCRIBED THAT ARE NOT IN QUESTION.
- PERFORM ALL NECESSARY DEMOLITION REQUIRED TO INSTALL NEW WORK PER THE CONTRACT DOCUMENTS AND PROVIDE PROTECTION FOR EXISTING CONSTRUCTION ADJACENT TO THE NEW WORK. THE CONTRACTOR(S) SHALL RESTORE ALL EXISTING CONDITIONS DISTURBED BY ALL THE WORK, ALL TO MATCH THE EXISTING UNLESS INDICATED OTHERWISE.
- ALL WORK SHALL BE SET STRAIGHT, PLUMB AND LEVEL OR WITH INDICATED SLOPE.
- EACH CONTRACTOR SHALL COLLECT HIS OWN RUBBISH AND CONSTRUCTION DEBRIS EACH DAY. PLACE IT IN APPROPRIATE CONTAINERS AND DISPOSE OF IT IN A LEGAL MANNER.
- ALL OCCUPIED PORTIONS OF SCHOOL BUILDINGS MUST CONTINUE TO OPERATE DURING NORMAL BUSINESS HOURS, AS WELL AS COMPLY WITH THE MINIMUM REQUIREMENTS NECESSARY TO MAINTAIN A CERTIFICATE OF OCCUPANCY. IF ANY CONSTRUCTION OPERATION IS DEEMED TO BE DISRUPTIVE BY THE SD TO THE NORMAL OPERATION OF THE SCHOOL BUILDING, THEN THE CONTRACTOR SHALL PERFORM THE WORK ON A PREMIUM TIME BASIS DURING OTHER THAN NORMAL BUSINESS HOURS. ALL COSTS ASSOCIATED WITH PREMIUM TIME WORK SHALL BE INCLUDED IN THE CONTRACTOR'S BID PROPOSAL. REFER TO MILESTONE SCHEDULE FOR SECOND SHIFT HOURS.
- ALL CONTRACTORS SHALL COMPLY WITH THE FOLLOWING MINIMUM SAFETY AND SECURITY REQUIREMENTS FOR THIS PROJECT: A) ALL MATERIALS SHALL BE STORED IN A SAFE, SECURE AND WEATHER TIGHT ENVIRONMENT; B) MAINTAIN SECURITY FENCES AROUND DEBRIS AND CONSTRUCTION WHERE DISPLAYED IN A VISIBLE PLACE ON THEIR PERSON.
- CONSTRUCTION AREAS WHICH UNDER THE CONTROL OF THE CONTRACTOR AND THEREFORE NOT OCCUPIED BY DISTRICT STAFF OR STUDENTS SHALL BE SEPARATED FROM OCCUPIED AREAS. PROVISIONS SHALL BE MADE TO PREVENT THE PASSAGE OF DUST AND CONTAMINANTS INTO OCCUPIED

THE FOLLOWING NOTES SHALL APPLY THROUGHOUT. EXCEPTIONS ARE SPECIFICALLY NOTED ON EACH DRAWING:

- A SPECIFIC STAIRWELL AND ENTRANCE SHALL BE PROVIDED FOR CONTRACTORS USE DURING WORK HOURS. WORKERS MAY NOT USE CORRIDORS, STAIRS OR ELEVATORS DESIGNATED FOR STUDENTS OR SCHOOL STAFF.
- REMOVAL OF ALL DEBRIS SHALL BE THROUGH DESIGNATED, SEPARATED AND PROTECTED AREAS OF THE BUILDING. THERE SHALL BE NO MOVEMENT OF DEBRIS OR EQUIPMENT THROUGH OCCUPIED SPACES OF THE BUILDING.
- ALL OCCUPIED PARTS OF A BUILDING AFFECTED BY CONSTRUCTION ACTIVITY SHALL BE CLEANED AT THE CLOSE OF EACH WORK DAY.
- CONSTRUCTION OPERATIONS SHALL NOT PRODUCE NOISE IN EXCESS OF 60DBA IN OCCUPIED SPACES OR SHALL BE SCHEDULED FOR TIMES WHEN THE AFFECTED BUILDING SPACES ARE NOT OCCUPIED OR ACOUSTICAL ABATEMENT MEASURES SHALL BE TAKEN.
- EACH RESPECTIVE CONTRACTOR SHALL BE RESPONSIBLE TO ENSURE THAT ITS ACTIVITIES AND MATERIALS WHICH RESULT IN "OFF-GASSING" OF VOLATILE ORGANIC COMPOUNDS SUCH AS GLUES, PAINTS, FURNITURE, CARPETING, WALL COVERING, DRAPERY, CURED OR VENTILATED IN ACCORDANCE WITH MANUFACTURERS RECOMMENDATIONS BEFORE SPACE CAN BE OCCUPIED. PRIOR APPROVAL OF PROTECTIVE MEASURES PLAN BY SD IS REQUIRED BEFORE PROCEEDING.
- ALL NEW WALLS, AND PARTITIONS AS NOTED SHALL BE CARRIED UP AN SECURED TIGHTLY TO ROOF DECK FLOOR DECK AND SLAB UNLESS OTHERWISE SPECIFIED. (SEE PARTITION TYPE DRAWING FOR MORE INFO.)
- THE CONTRACTOR SHALL PROVIDE THE NECESSARY LEVELING COMPOUNDS TO EXISTING AND NEW SUBSTRATE CONCRETE SLABS SO THAT NEW FLOOR FINISHES ARE INSTALLED PER THE MANUFACTURERS REQUIREMENTS.
- ALL PIPING IN FINISHED SPACES TO BE FURRED-OUT WITH METAL STUDS @ 12" O.C. AND 5/8" GYPSUM BOARD TYPE "X" AND FINISHED TO MATCH ADJACENT SURFACES.

LIST OF DRAWINGS

GENERAL:	TITLE SHEET
T-1	LOCATION MAP, ABBREVIATIONS, MATERIALS, GRAPHIC LEGEND, GENERAL NOTES, PROJECT CONTACTS & LIST OF DRAWINGS.
G-1	
ARCHITECTURAL	
A-100	GROUND FLOOR PLAN
A-150	PARTIAL GROUND FLOOR PLANS & INTERIOR ELEVATIONS
A-151	PARTIAL GROUND FLOOR PLANS & INTERIOR ELEVATIONS
A-152	PARTIAL GROUND FLOOR PLANS & INTERIOR ELEVATIONS
A-200	REFLECTED CEILING PLAN - GROUND FLOOR
A-410	ENLARGED STAIR PLANS, STAIR SECTIONS & DETAILS
A-500	PARTITION TYPES
A-525	CASEWORK DETAILS
A-650	MISCELLANEOUS DETAILS
A-700	DOOR SCHEDULE, TYPES & DETAILS
A-801	FLOOR TILE PATTERN PLANS, FINISH SCHEDULE
A-900	SIGNAGE PLAN - GROUND FLOOR
A-925	SIGN TYPES AND DETAIL
MECHANICAL	
H-101	LEGEND, REMOVAL NOTES AND PART GROUND FLOOR PLANS, REMOVALS AND NEW WORK
H-102	SCHEDULE, DETAILS AND PART GROUND FLOOR PLAN - REMOVALS AND NEW WORK
PLUMBING	
P-101	LEGEND, SCHEDULE, NOTES AND PART GROUND FLOOR PLAN - REMOVALS AND NEW WORK
ELECTRICAL	
E-001	ELECTRICAL LEGEND, NOTES AND ABBREVIATIONS
E-201	GROUND FLOOR ELECTRICAL LIGHTING PLAN
E-301	GROUND FLOOR ELECTRICAL POWER AND FIRE ALARM PLAN

MOUNTING HEIGHTS FOR ACCESSIBLE ITEMS

TEMPORARY CONSTRUCTION FENCE

SCALE: 1/2" = 1'-0" (STABILIZER STANDS SHALL BE USED ONLY OVER PAVED AREAS.)

LEGEND:

- EXISTING FENCING
- EXISTING FENCING REMOVAL
- TEMPORARY CONSTRUCTION FENCING
- BUILDING EGRESS
- GATE
- GRAVEL TRUCK DRIVE-OFF BY GC. DETAIL 3/G1.

WORKSCOPE NOTES:

- WS1 STABILIZED CONSTRUCTION ENTRANCE. SEE DETAIL 3/G1.
- WS2 ACCESS GATE. PROVIDE SIGNAGE "CONSTRUCTION AREA - NO ADMITTANCE"
- WS3 PROTECT ALL DRAINAGE STRUCTURE.
- WS4 TEMPORARY CONSTRUCTION FENCING AND GATE.

NOTES:

- ALL EXISTING SIDEWALKS AND PAVEMENT SHALL BE PROTECTED.
- ALL EXISTING CONSTRUCTION SHALL BE PROTECTED AND RETURNED TO THEIR ORIGINAL CONDITION.
- NO STORAGE OF ANY EQUIPMENT ON ANY NEW SIDEWALK/PATH PAVERS OR EXISTING ROOFS WILL BE ALLOWED.
- ALL WINDOWS SHALL BE PROTECTED.
- DO NOT BLOCK OR RESTRICT FLOW OF WATER TO EXISTING DRAINS.
- COMPLY WITH LOCAL NOISE ORDINANCES.
- DO NOT BLOCK BUILDING EXITS.

CONSTRUCTION ENTRANCE (CE)

SCALE: NTS

NOTE: GC SHALL PROVIDE NEW CONCRETE CURB AND NEW CONCRETE WALK TO MATCH WIDTH OF CONSTRUCTION ENTRANCE AT THE COMPLETION OF THE PROJECT.

STAGING PLAN

SCALE: 1/64" = 1'-0"

NOTE: WHERE FENCE IS LOCATED OVER EXISTING UNPAVED AREAS FENCE POST SHALL BE DRIVEN INTO GROUND A MINIMUM OF 3 FEET.

PORT CHSTER-KYLE UNION FREE SCHOOL DISTRICT

JOHN F. KENNEDY ELEMENTARY SCHOOL

FLOOR REPAIRS & RELATED WORK

40 OLIVIA STREET, PORT CHSTER, NY 10573

DRAWING TITLE

10-18-2021

DATE

30"x42"

SHEET SIZE

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DRAWN BY

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ISSUED TO

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FILE NO.

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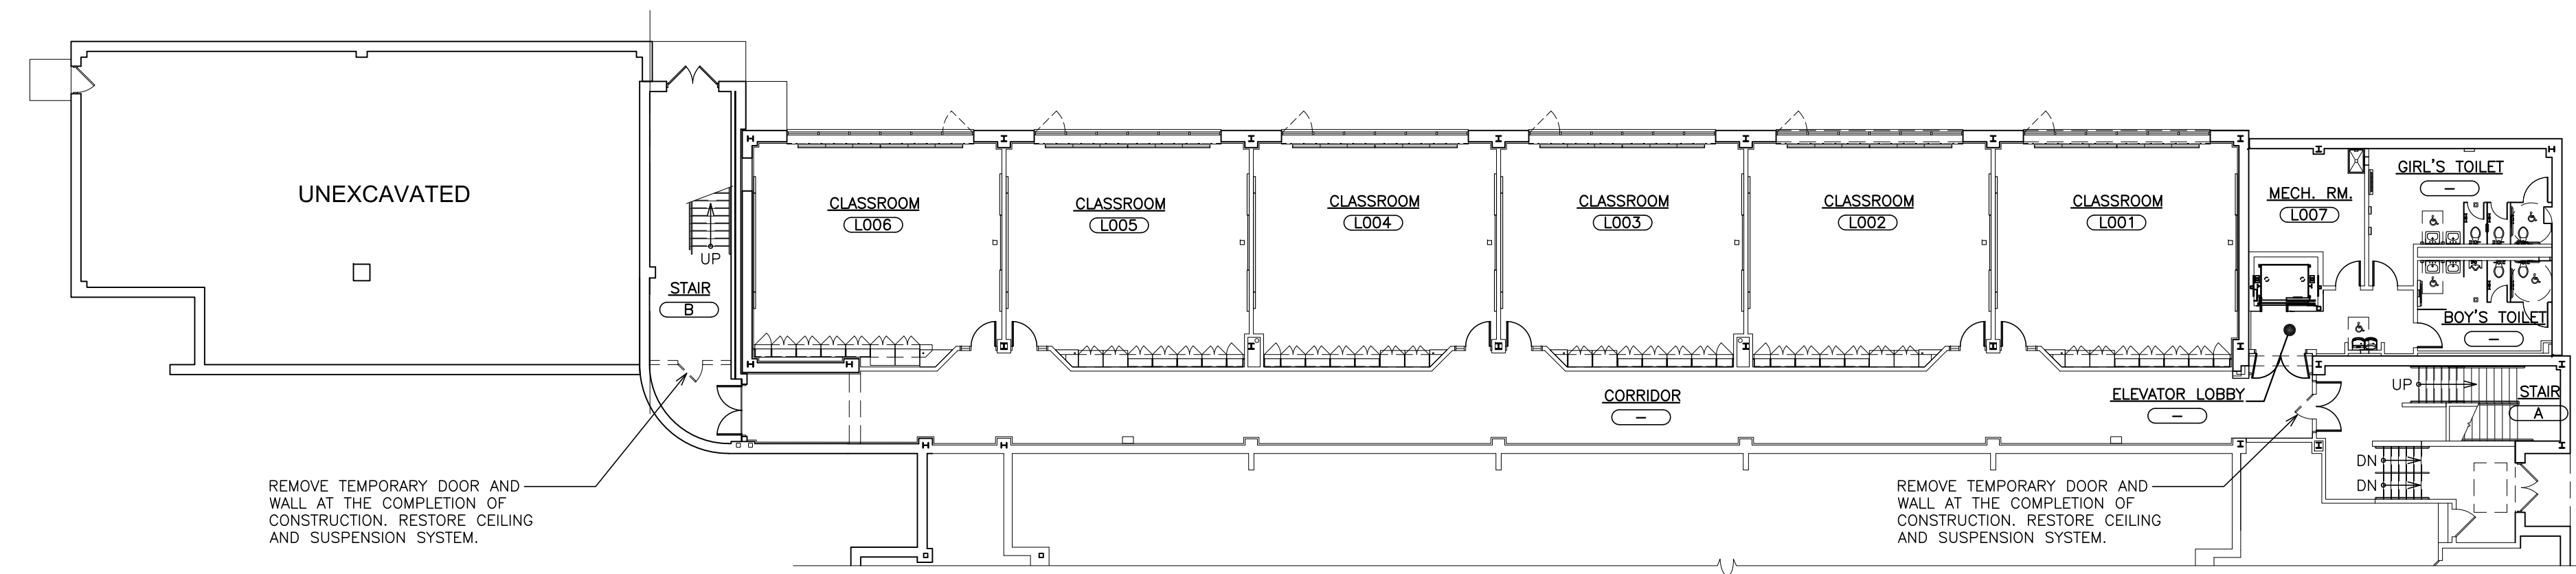
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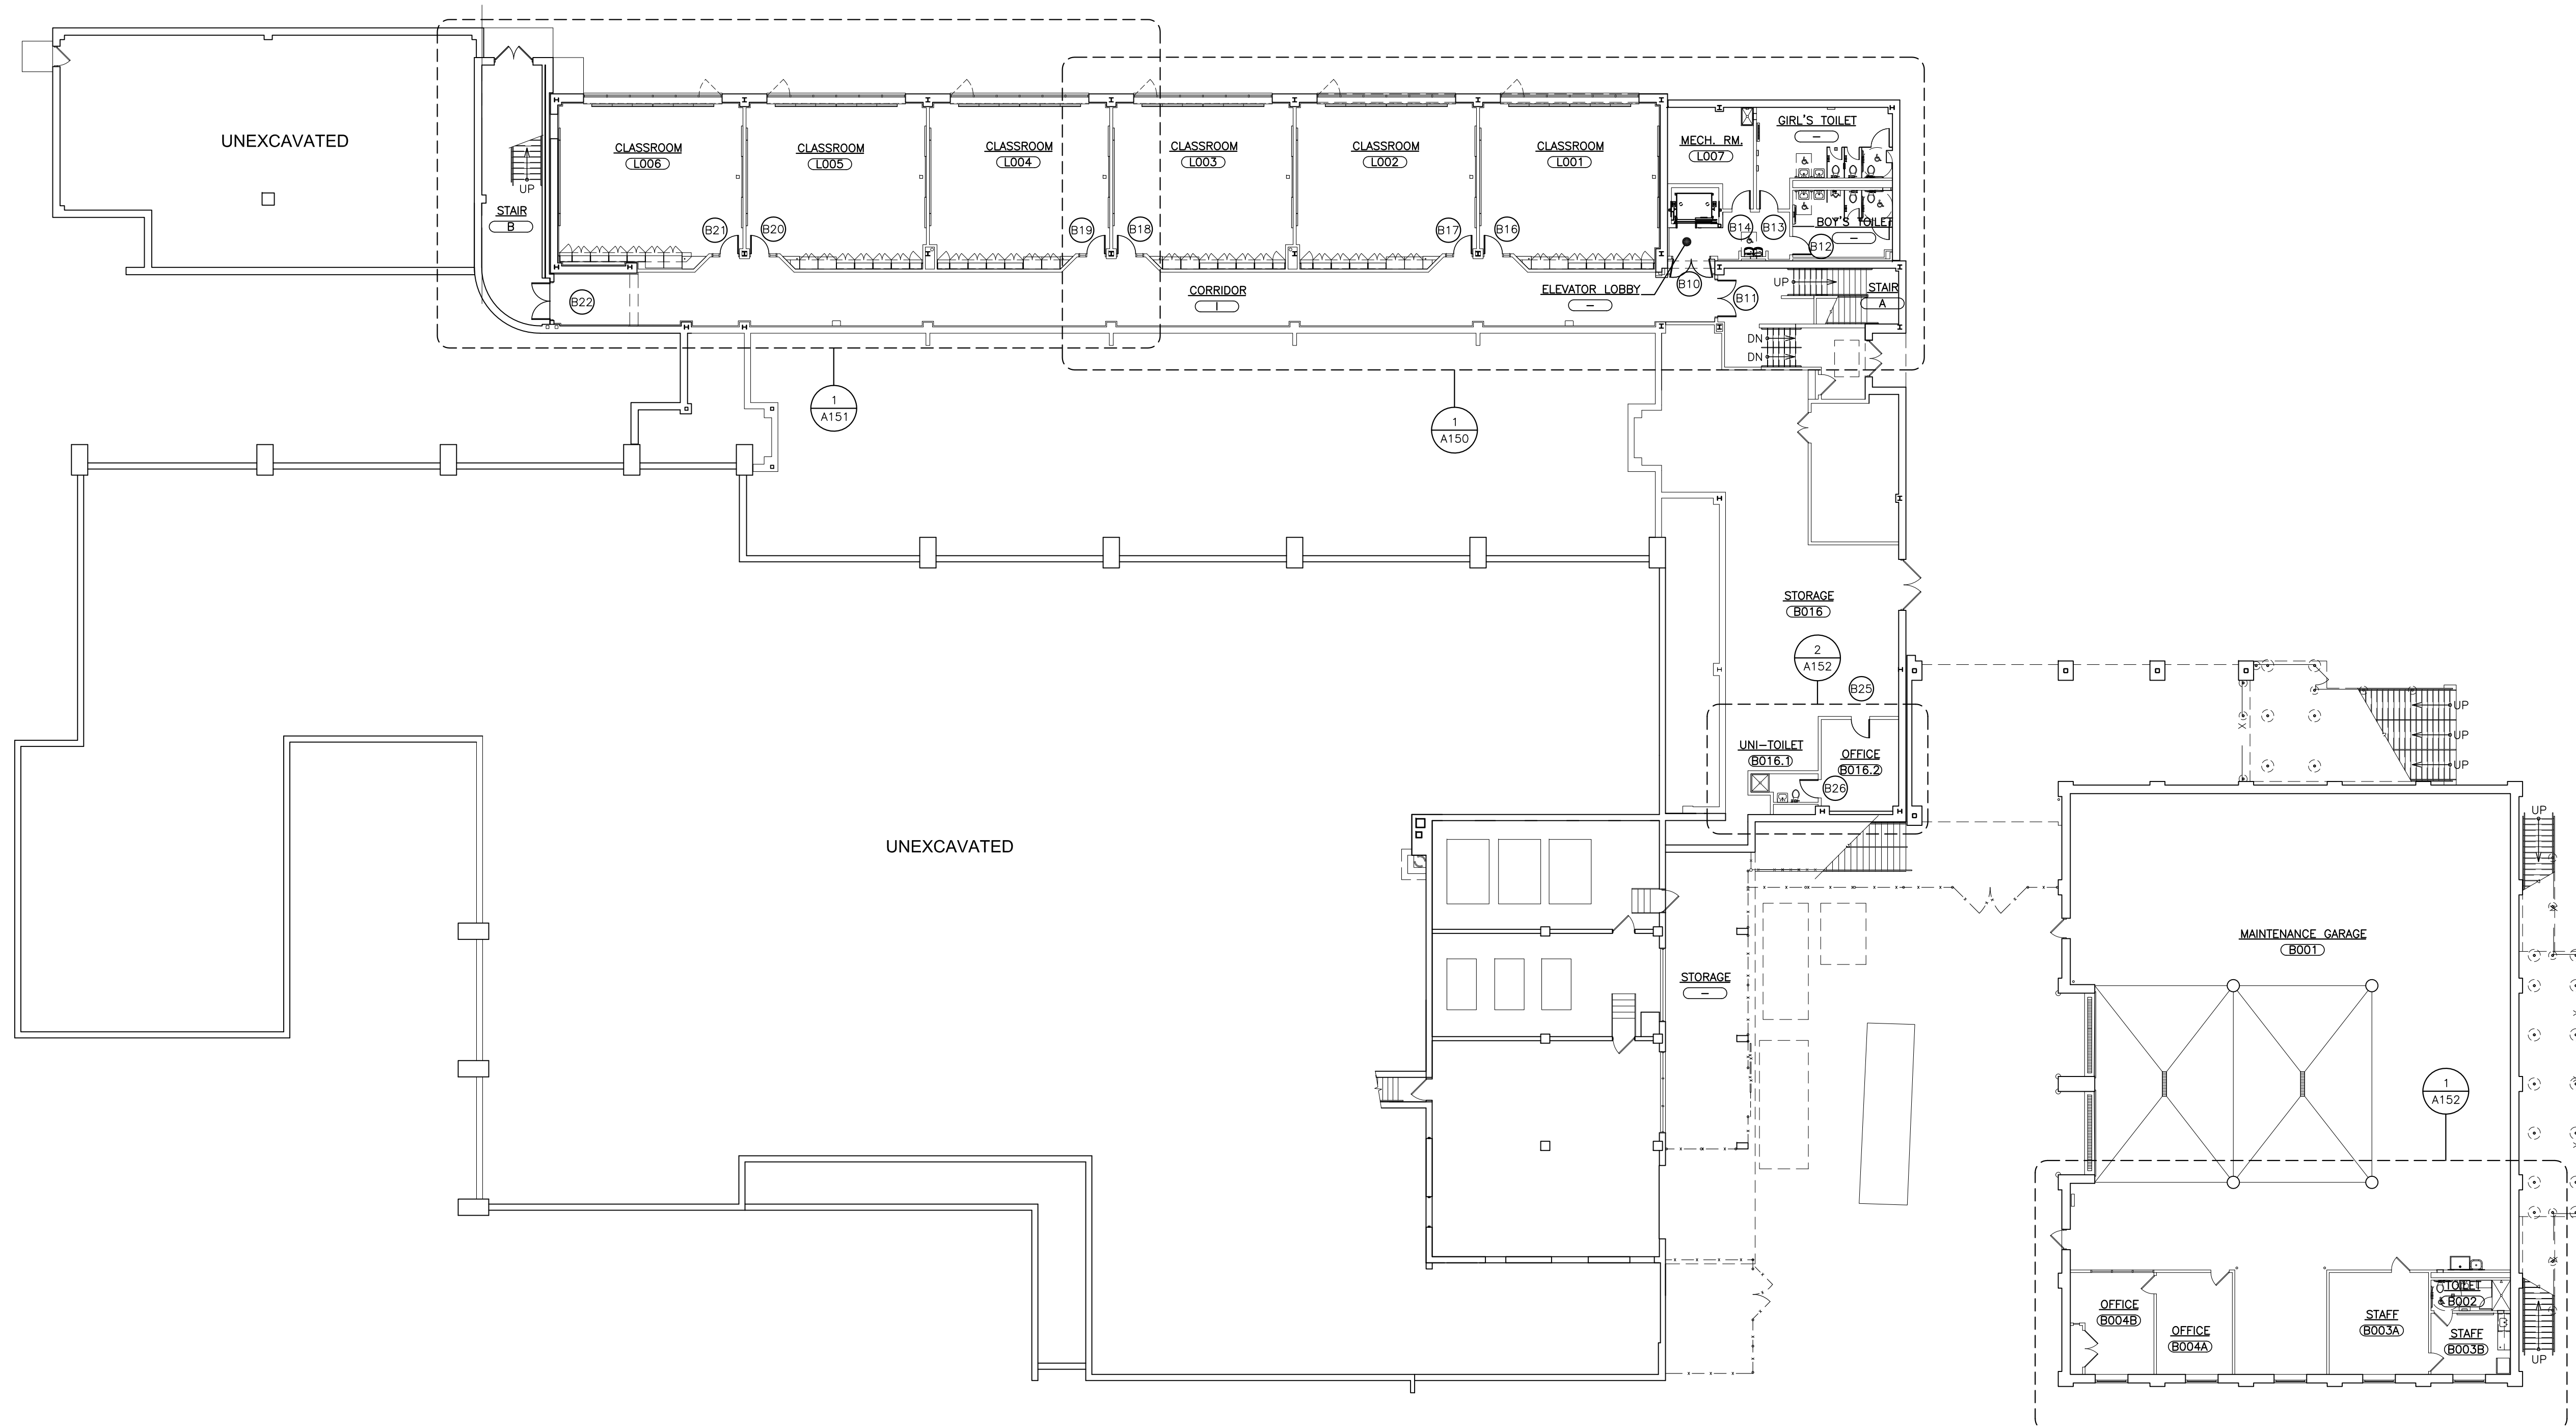
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PLOT DATE: October 18, 2021 7:47am

FILE: I:\21444.01 JFK Flood Repairs & Related Work\DRAWINGS\CURRENT\1-F&D\21444.01-G-1.dwg



**2 GROUND FLOOR PLAN - REMOVAL**  
SCALE: 1/16" = 1'-0"



**1 OVERALL GROUND FLOOR PLAN**  
SCALE: 1/16" = 1'-0"



PLOT DATE: October 18, 2021 -- 7:50am

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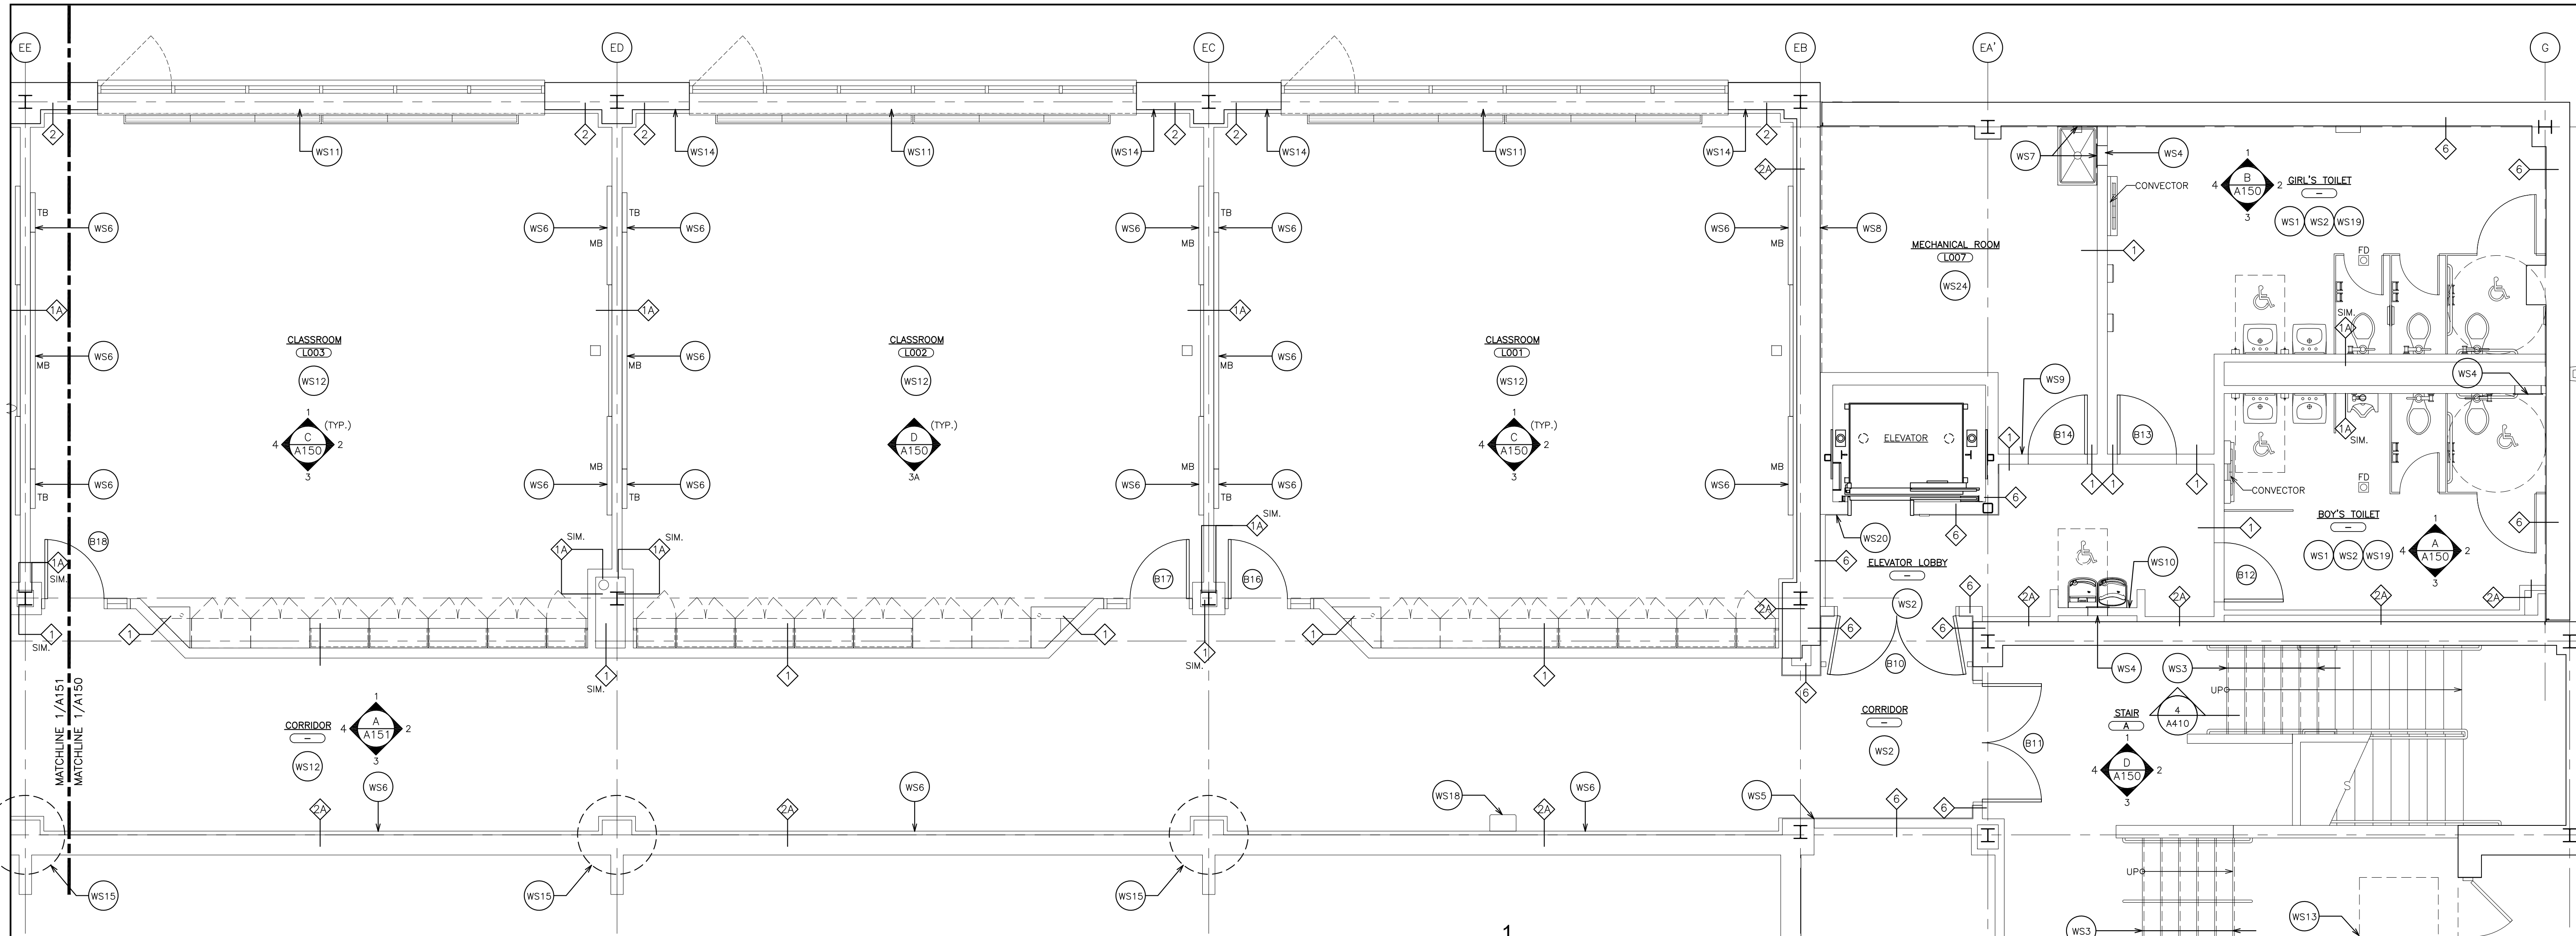
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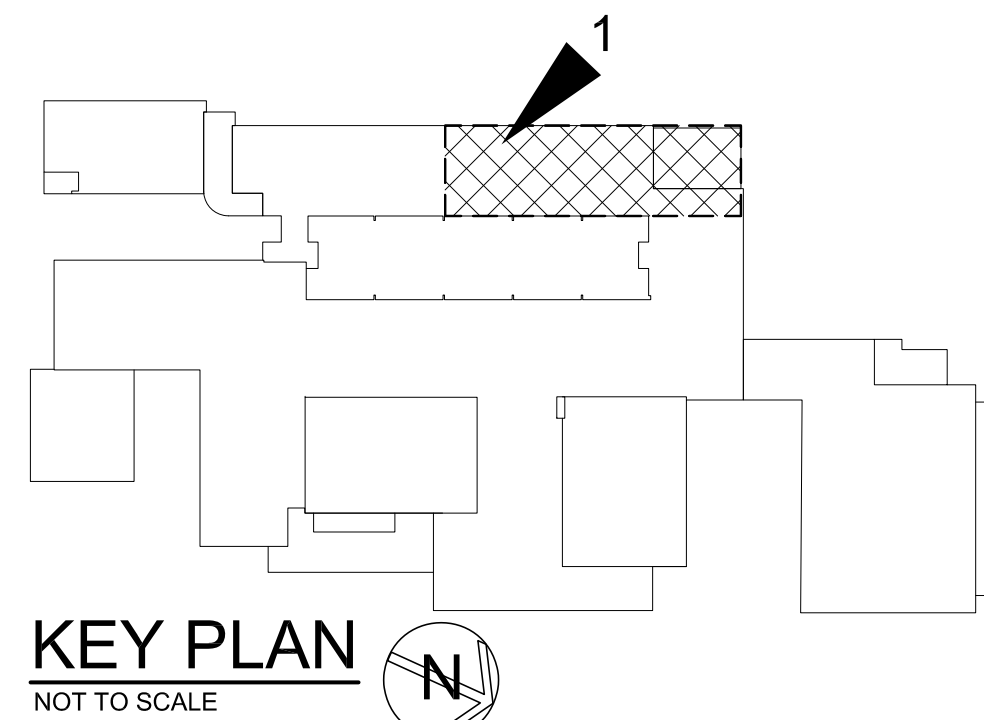
PROJECT: JOHN F. KENNEDY ELEMENTARY SCHOOL DISTRICT  
JOHN F. KENNEDY ELEMENTARY SCHOOL  
FLOOD REPAIRS & RELATED WORK  
40 DULVA STREET, PORT CHESTER, NY 10573  
DRAWING TITLE: JOHN F. KENNEDY ELEMENTARY SCHOOL  
OVERALL GROUND FLOOR PLAN

10-18-2021	B I O
DATE	ISSUED TO
SHEET SIZE 30"x42"	DRAWING NO. <b>A100</b>
DRAWN BY F & D	CHECKED BY F & D
FILE NO. <b>21444.01</b>	






**1 PARTIAL GROUND FLOOR PLAN**  
SCALE: 1/4" = 1'-0"




**KEY PLAN**  
NOT TO SCALE


- ### WORKSCOPE NOTES
- WS1 REMOVE REMNANTS OF EXISTING FLOOR TILE SETTING MATERIAL DOWN TO EXISTING CONCRETE FLOOR SLAB.
  - WS2 REMOVE REMNANTS OF EXISTING ADHESIVE ON WALLS.
  - WS3 PREPARE (6) RISERS & (5) TREADS TO RECEIVE NEW RUBBER COVERING. REMOVE EXISTING ADHESIVES AND PREPARE STAIRS TO RECEIVE NEW FINISH. REPAINT ENTIRE STAIR STRINGERS. SEE DETAIL 4/A410.
  - WS4 PROVIDE 12" X 12" STAINLESS STEEL ACCESS DOOR. FIELD VERIFY SIZE.
  - WS5 PROVIDE FULL HEIGHT CONTROL JOINT IN WALL TILE.
  - WS6 REMOVE EXISTING DISPLAY BOARD MOUNTING BRACKETS AND GLUE RESIDUE TO REINSTALL EXISTING TACK BOARD AND MARKER BOARD. SHIM AS REQUIRED.
  - WS7 PROVIDE CERAMIC TILE BACKSPLASH 48" HIGH ON EACH SIDE OF FLOOR SINK.
  - WS8 REMOVE EXISTING WATER PROOFING FROM MASONRY WALL.
  - WS9 REMOVE (2) LAYERS OF EXISTING GYPSUM BOARD UP TO 6'-3" A.F.F.
  - WS10 (3) INNER FACES OF WATER COOLER PARTITIONS SHALL BE SIMILAR TO PARTITION TYPE 2A.
  - WS11 INSTALL CEMENT BOARD AND INSULATION UNDER WINDOW SILL. SIMILAR TO PARTITION DETAIL 2. COORDINATE INSTALLATION WITH MECHANICAL CONTRACTOR DUE TO EXISTING FIN TUBE AND PIPING WHICH WILL REMAIN IN PLACE.
  - WS12 INSTALL (2) LAYERS OF CEMENT BOARD IN ALL LOCATIONS WHERE THERE IS EXPOSED FRAMING UNLESS NOTED OTHERWISE. REMOVE ANY REMAINING GYPSUM BOARD WITHIN 6'-3" FROM FINISH FLOOR. REFER TO PARTITION TYPES.
  - WS13 REMOVE EXISTING FLOOR MAT FRAME. PATCH SLAB IN ORDER TO RECEIVE NEW FLOOR FINISH.
  - WS14 FILL VOID AT COLUMN WITH BATT INSULATION.
  - WS15 INSTALL (2) LAYERS OF 5/8" CEMENT BOARD OVER EXPOSED FRAMING AROUND COLUMN. SIMILAR TO PARTITION DETAIL 2A. SEE DETAIL 6/A410 FOR ADDITIONAL INFORMATION.
  - WS16 REMOVE EXISTING WOOD DOOR TRIM AND CASING. REPLACE WITH HOLLOW METAL DOOR & FRAME.
  - WS17 REMOVE ALL REMAINING CERAMIC TILE AND BACKER BOARD (WALL AND CEILING) INSTALL NEW CEMENT BOARD AND TILE FULL HEIGHT AND ON CEILING.
  - WS18 FIRE EXTINGUISHER AND CABINET. REFER TO DETAIL 3/A652.
  - WS19 REFER TO DETAIL 1/A652 FOR TOILET PARTITIONS.
  - WS20 REMOUNT ELEVATOR KEY SWITCH IN ORDER TO INSTALL NEW WALL FINISH.
  - WS21 REMOVE ALL EXISTING TILE AND REPLACE WITH NEW. PREPARE EXISTING CMU AS REQUIRED PER TCA-W211-18. REMOVE AND REPLACE CEILING ANGLE AND ASSOCIATED FRAMING AS REQUIRED.
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  - WS23 INSTALL APPROXIMATELY 24" OF 1/2" GYPSUM BOARD OVER EXPOSED FRAMING.
  - WS24 PAINT ENTIRE FLOOR.

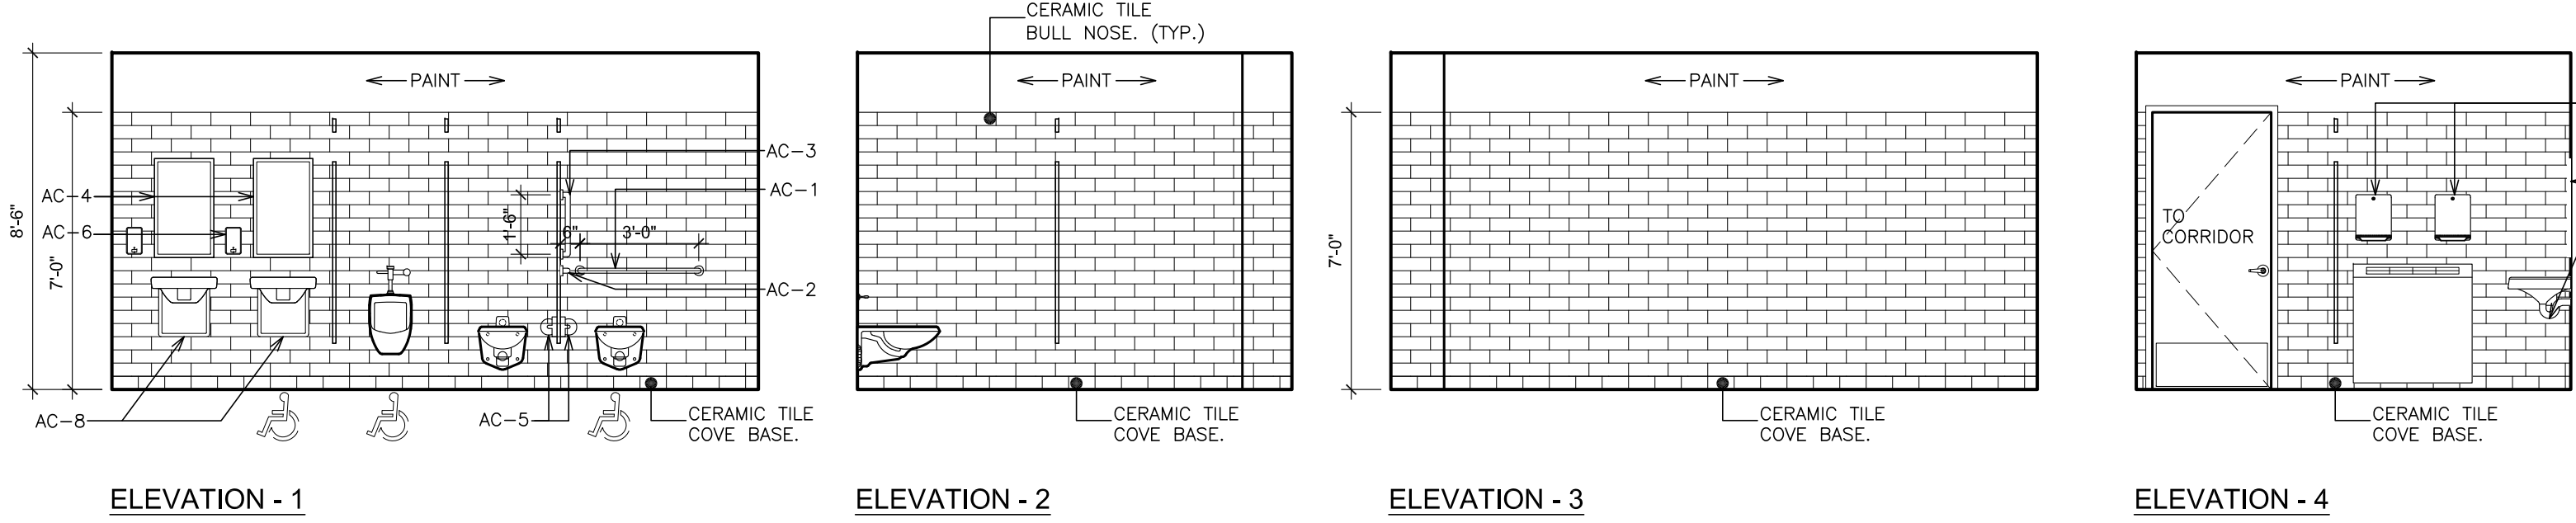

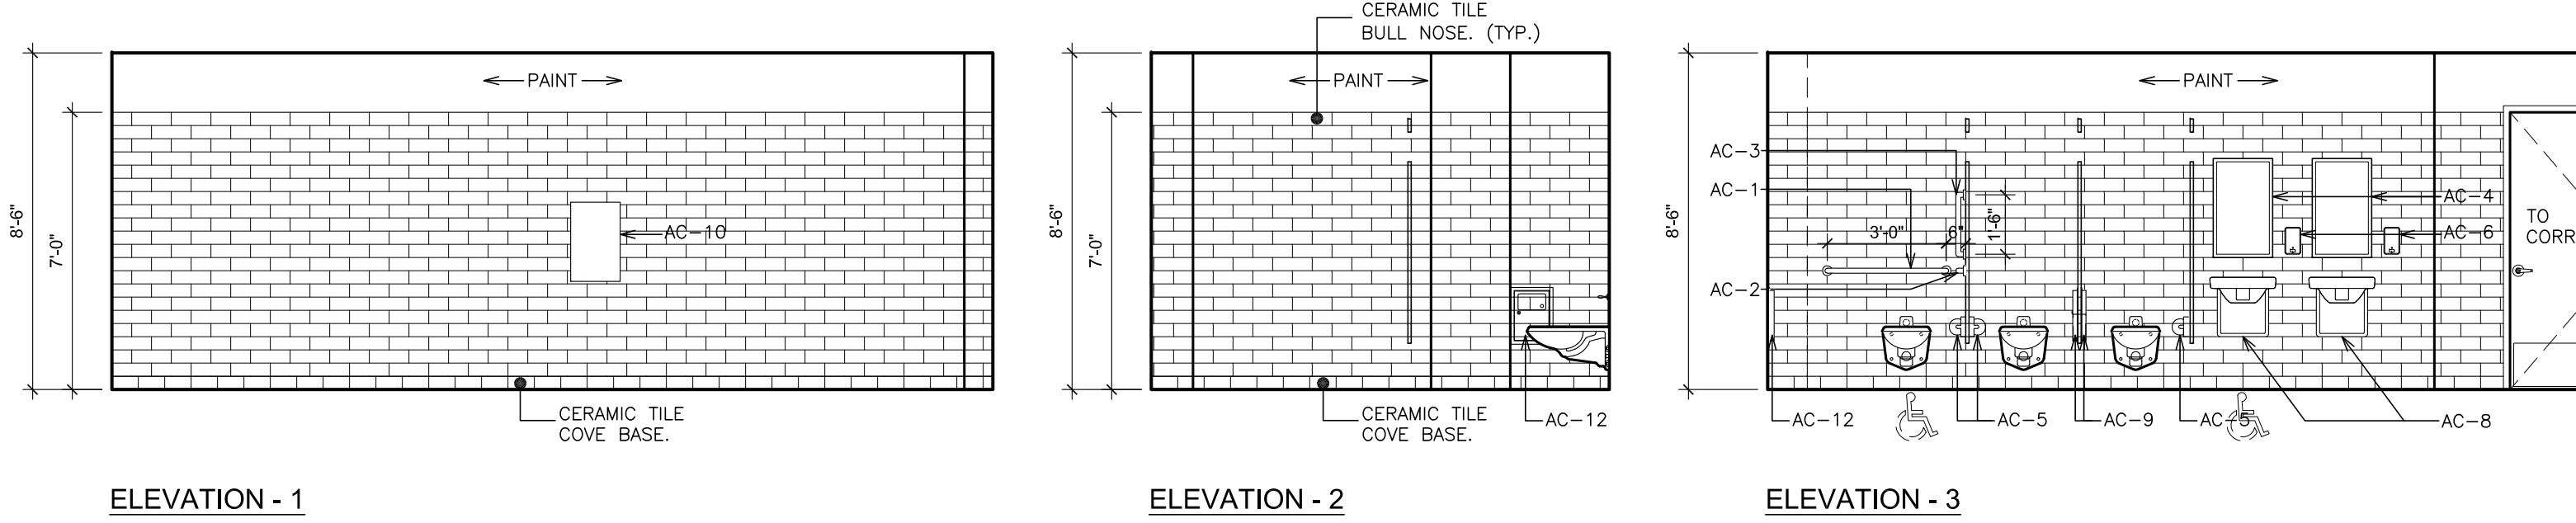
**A INTERIOR ELEVATIONS - BOY'S TOILET**  
SCALE: 1/4" = 1'-0"



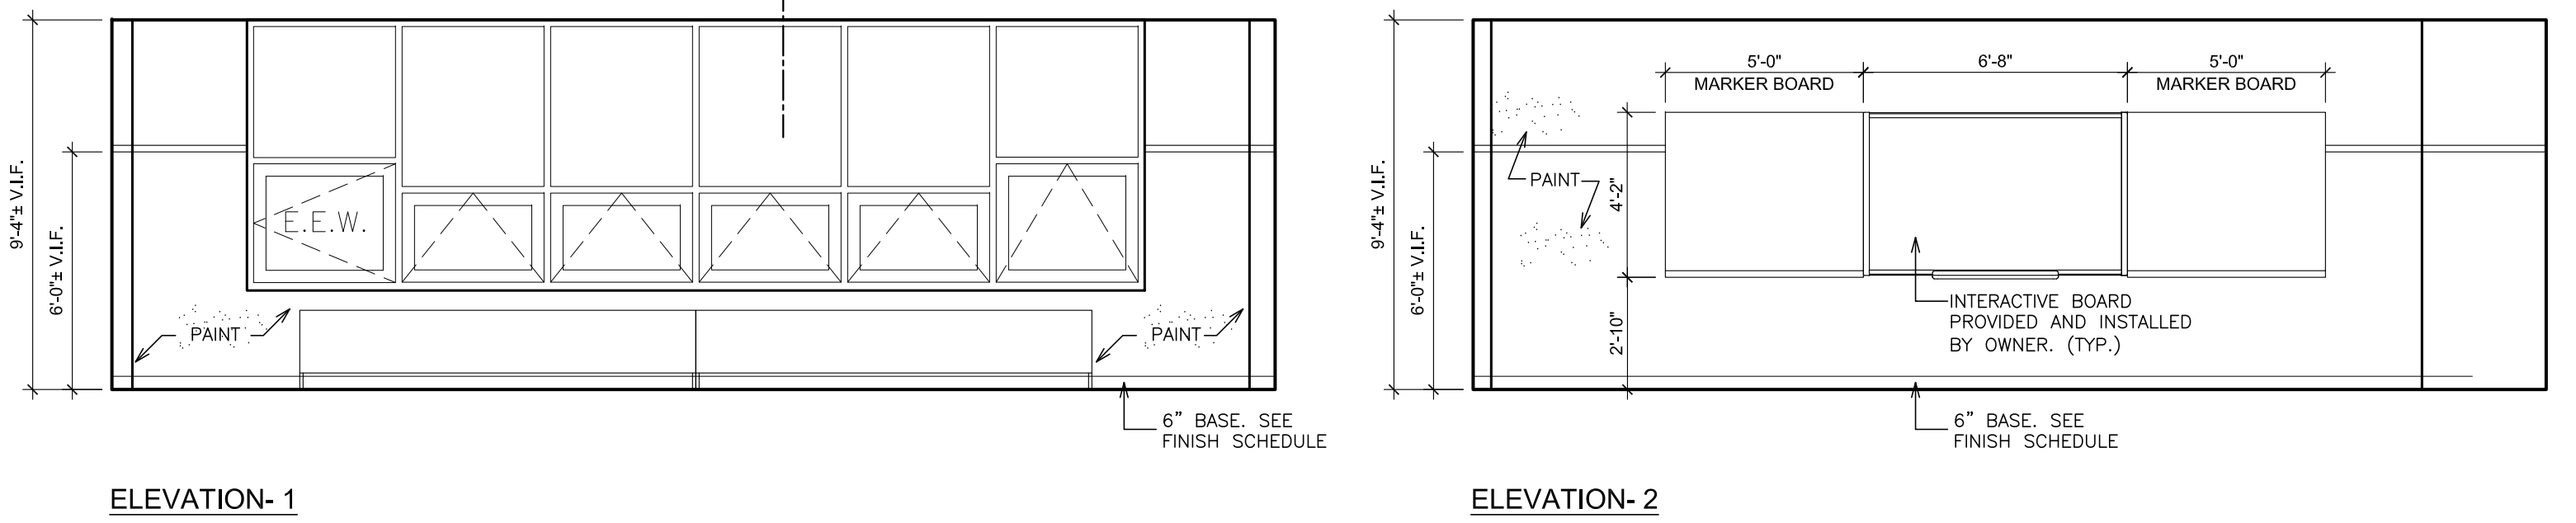
**B INTERIOR ELEVATIONS - GIRL'S TOILET**  
SCALE: 1/4" = 1'-0"



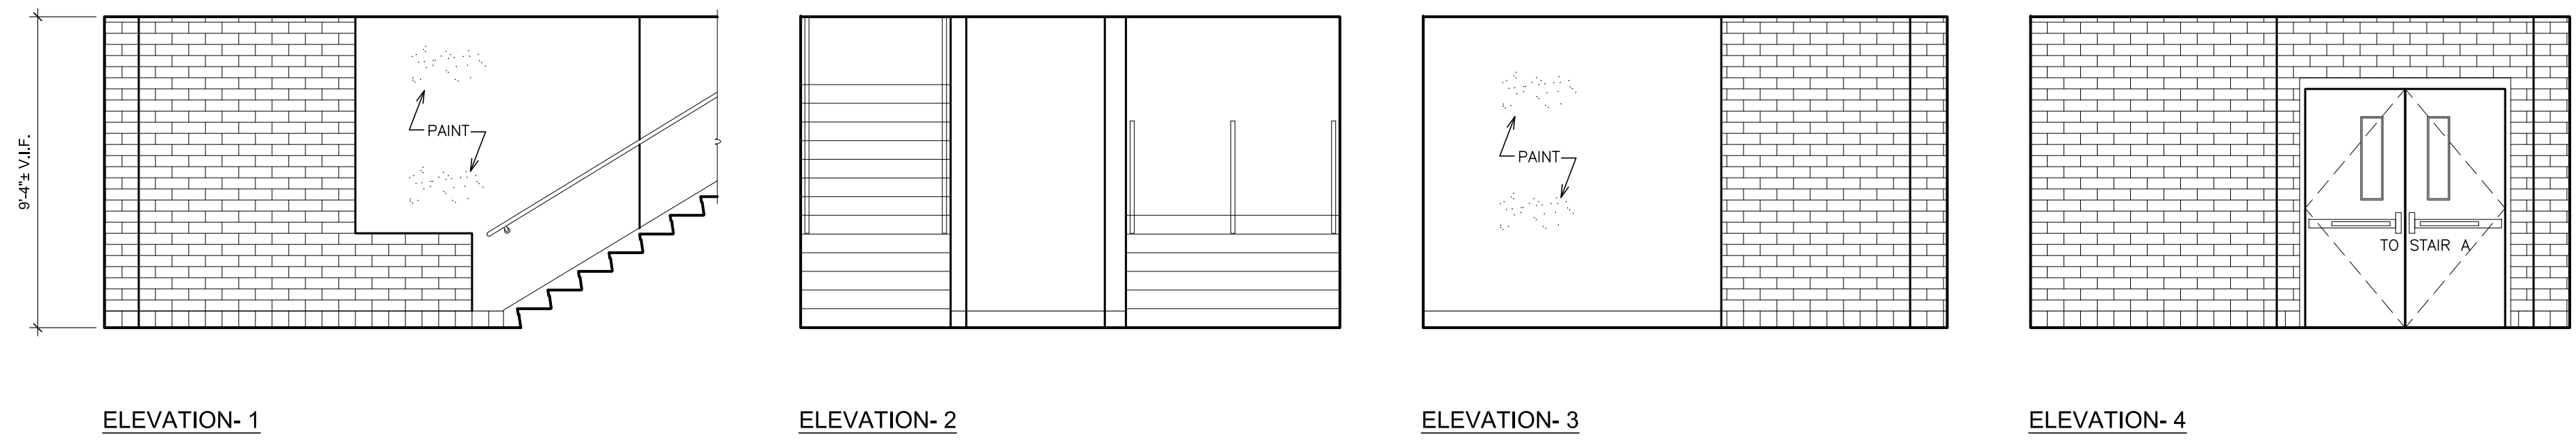
**C INTERIOR ELEVATIONS - TYPICAL CLASSROOM**  
SCALE: 1/4" = 1'-0"



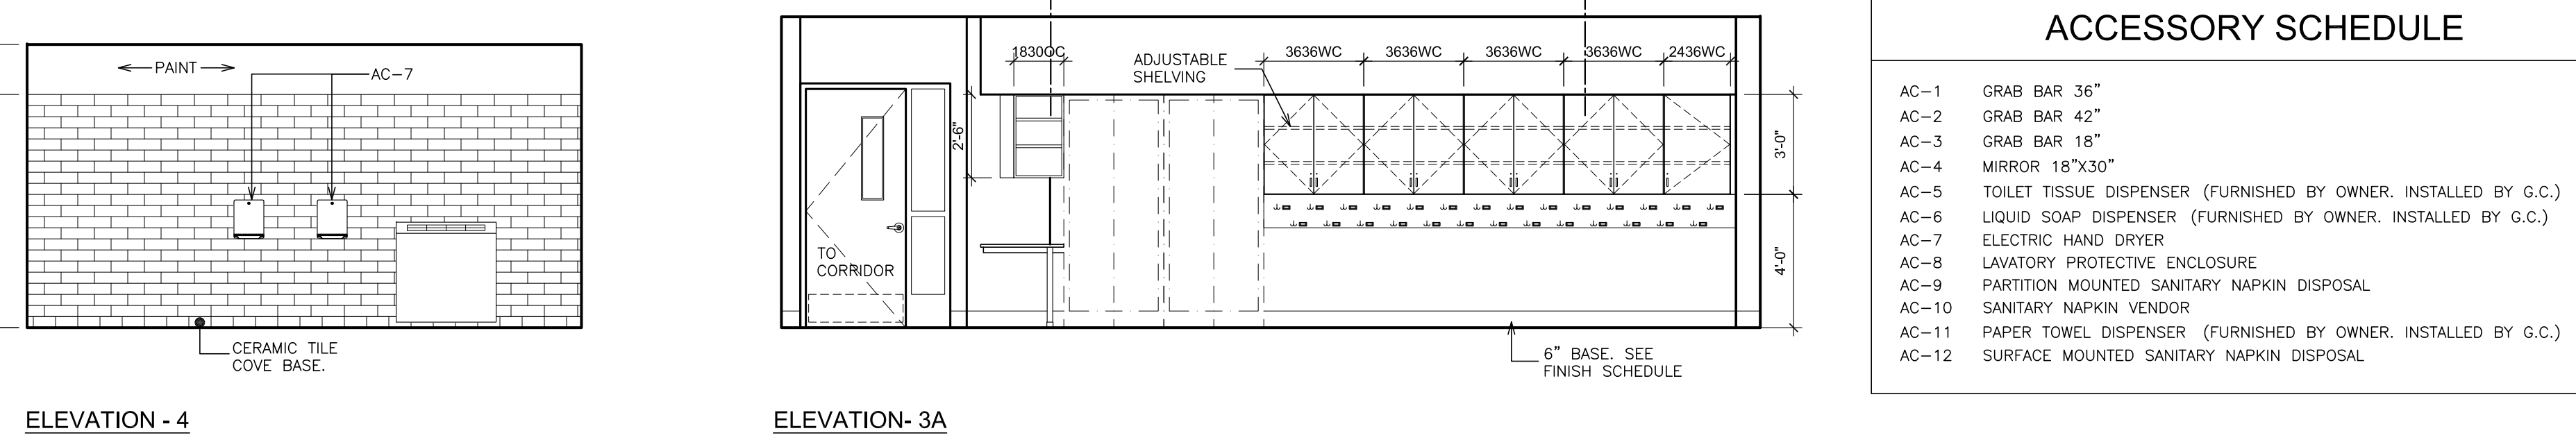**D INTERIOR ELEVATIONS - STAIR-A**  
SCALE: 1/4" = 1'-0"



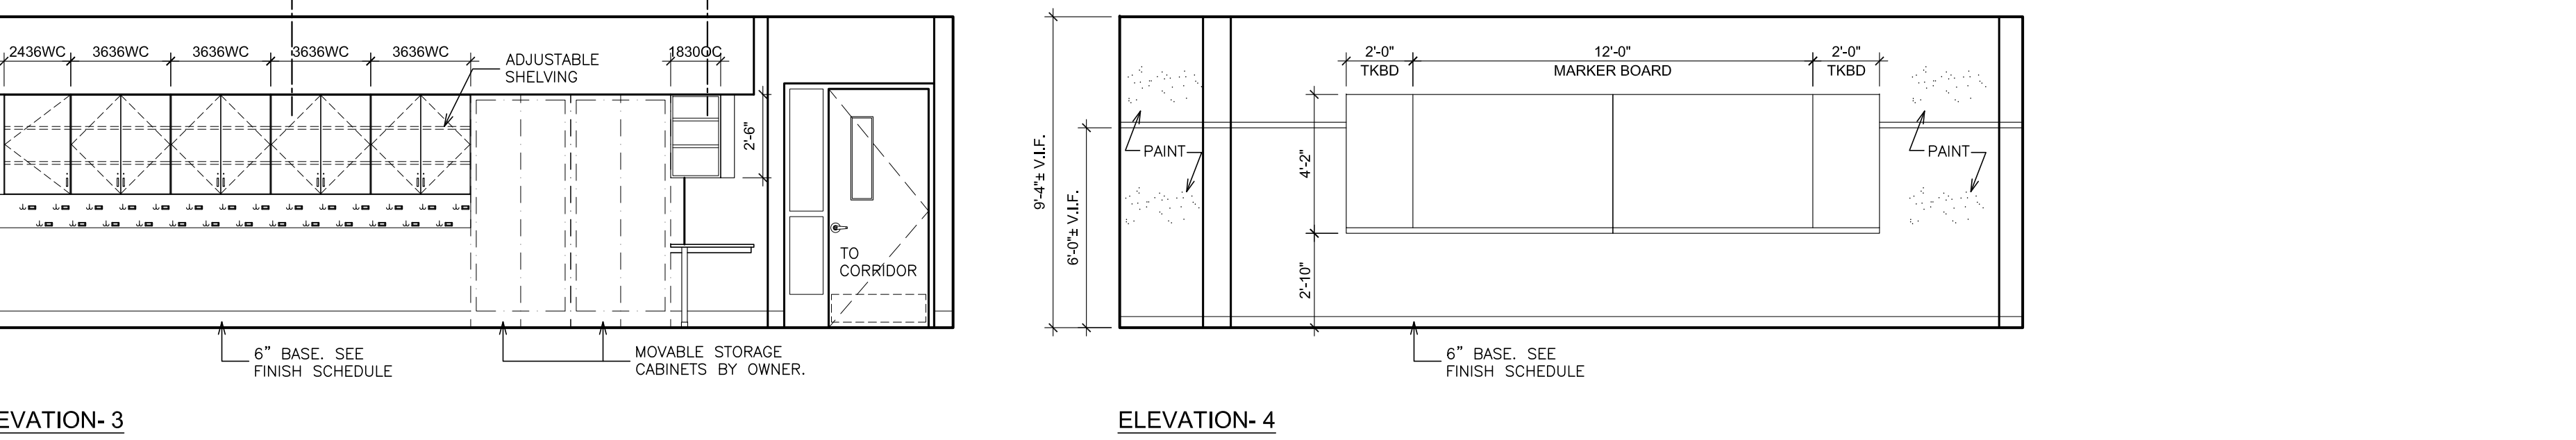**D INTERIOR ELEVATION - (TYP.)**  
SCALE: 1/4" = 1'-0"



**D INTERIOR ELEVATION - (TYP.)**  
SCALE: 1/4" = 1'-0"

ACCESSORY SCHEDULE	
AC-1	GRAB BAR 36"
AC-2	GRAB BAR 42"
AC-3	GRAB BAR 18"
AC-4	MIRROR 18"x30"
AC-5	TOILET TISSUE DISPENSER (FURNISHED BY OWNER. INSTALLED BY G.C.)
AC-6	LIQUID SOAP DISPENSER (FURNISHED BY OWNER. INSTALLED BY G.C.)
AC-7	ELECTRIC HAND DRYER
AC-8	LAUNDRY PROTECTIVE ENCLOSURE
AC-9	PARTITION MOUNTED SANITARY NAPKIN DISPOSAL
AC-10	SANITARY NAPKIN VENDOR
AC-11	PAPER TOWEL DISPENSER (FURNISHED BY OWNER. INSTALLED BY G.C.)
AC-12	SURFACE MOUNTED SANITARY NAPKIN DISPOSAL

PLOT DATE: October 13, 2021 10:20am

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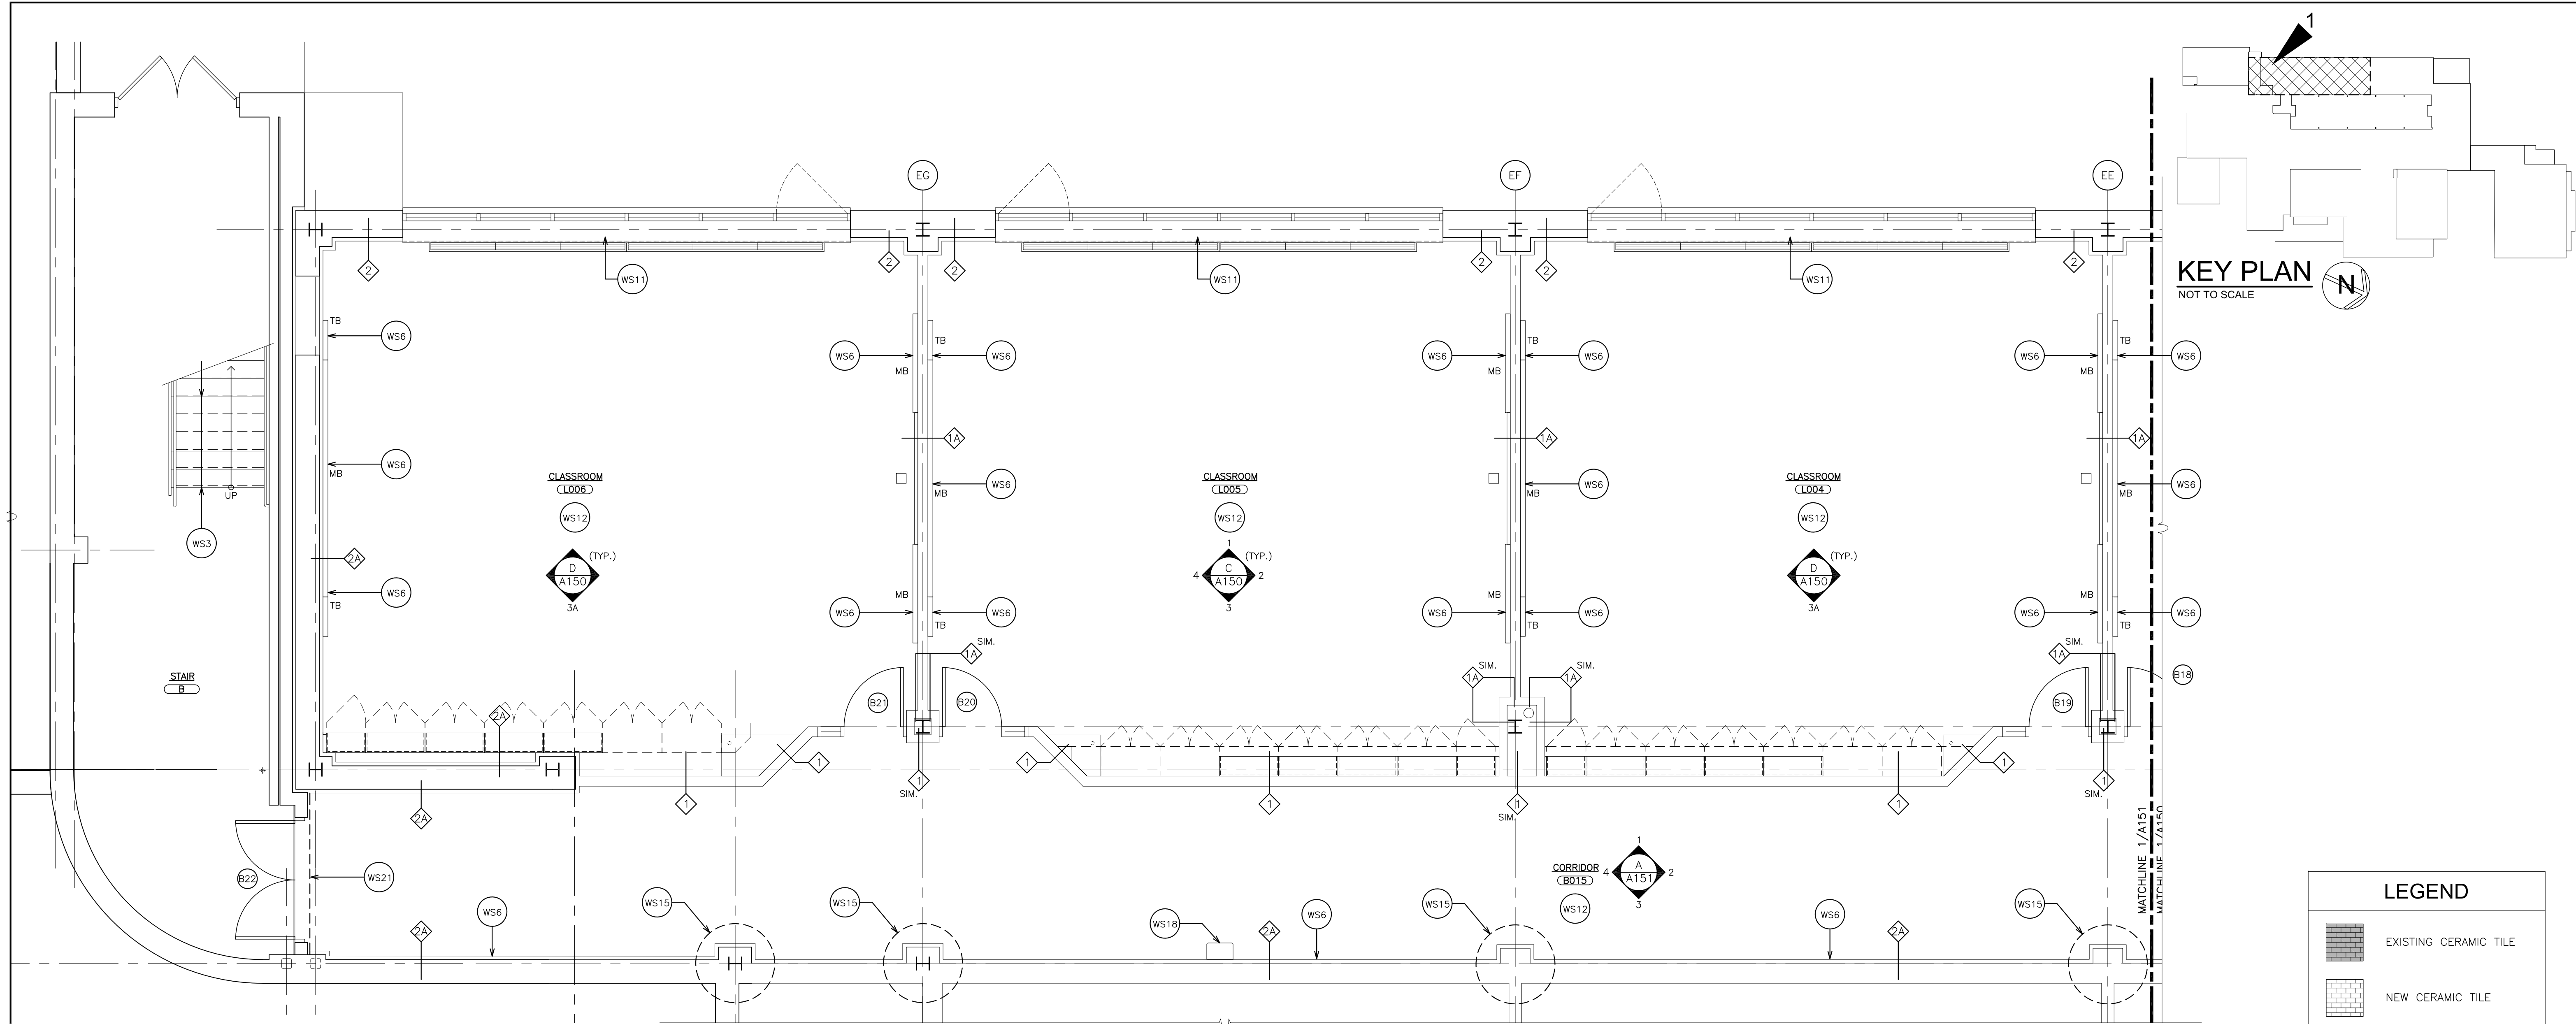
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JOHN F. KENNEDY ELEMENTARY SCHOOL  
PORT CHESTER - FRYE UNION FREE SCHOOL DISTRICT  
FLOOD REPAIRS & RELATED WORK  
40 DULVA STREET PORT CHESTER, NY 10573  
DRAWING TITLE  
JOHN F. KENNEDY ELEMENTARY SCHOOL  
PARTIAL GROUND FLOOR PLANS & INTERIOR  
ELEVATIONS

10-18-2021 B I O  
DATE ISSUED TO  
SHEET SIZE 30"x42"  
DRAWN BY F & D  
CHECKED BY F & D

21444.01  
FILE NO.  
A150





1 PARTIAL GROUND FLOOR PLAN  
SCALE: 1/4" = 1'-0"

WORKSCOPE NOTES

- WS1 REMOVE REMNANTS OF EXISTING FLOOR TILE SETTING MATERIAL DOWN TO EXISTING CONCRETE FLOOR SLAB.
- WS2 REMOVE REMNANTS OF EXISTING ADHESIVE ON WALLS.
- WS3 PREPARE (6) RISERS & (5) TREADS TO RECEIVE NEW RUBBER COVERING. REMOVE EXISTING ADHESIVES AND PREPARE STAIRS TO RECEIVE NEW FINISH. REPAINT ENTIRE STAIR STRINGERS. SEE DETAIL 4/A410.
- WS4 PROVIDE 12" X 12" STAINLESS STEEL ACCESS DOOR. FIELD VERIFY SIZE.
- WS5 PROVIDE FULL HEIGHT CONTROL JOINT IN WALL TILE.
- WS6 REMOVE EXISTING DISPLAY BOARD MOUNTING BRACKETS AND GLUE RESIDUE TO REINSTALL EXISTING TACK BOARD AND MARKER BOARD. SHIM AS REQUIRED.
- WS7 PROVIDE CERAMIC TILE BACKSPLASH 48" HIGH ON EACH SIDE OF FLOOR SINK.
- WS8 REMOVE EXISTING WATER PROOFING FROM MASONRY WALL.
- WS9 REMOVE (2) LAYERS OF EXISTING GYPSUM BOARD UP TO 6'-3" A.F.F.
- WS10 (3) INNER FACES OF WATER COOLER PARTITIONS SHALL BE SIMILAR TO PARTITION TYPE 2A.
- WS11 INSTALL CEMENT BOARD AND INSULATION UNDER WINDOW SILL. SIMILAR TO PARTITION DETAIL 2. COORDINATE INSTALLATION WITH MECHANICAL CONTRACTOR DUE TO EXISTING FIN TUBE AND PIPING WHICH WILL REMAIN IN PLACE.
- WS12 INSTALL (2) LAYERS OF CEMENT BOARD IN ALL LOCATIONS WHERE THERE IS EXPOSED FRAMING UNLESS NOTED OTHERWISE. REMOVE ANY REMAINING GYPSUM BOARD WITHIN 6'-3" FROM FINISH FLOOR. REFER TO PARTITION TYPES.
- WS13 REMOVE EXISTING FLOOR MAT FRAME. PATCH SLAB IN ORDER TO RECEIVE NEW FLOOR FINISH.
- WS14 FILL VOID AT COLUMN WITH BATT INSULATION.
- WS15 INSTALL (2) LAYERS OF 3/4" CEMENT BOARD OVER EXPOSED FRAMING AROUND COLUMN. SIMILAR TO PARTITION DETAIL 2A. SEE DETAIL 6/A410 FOR ADDITIONAL INFORMATION.
- WS16 REMOVE EXISTING WOOD DOOR TRIM AND CASING. REPLACE WITH HOLLOW METAL DOOR & FRAME.
- WS17 REMOVE ALL REMAINING CERAMIC TILE AND BACKER BOARD (WALL AND CEILING) INSTALL NEW CEMENT BOARD AND TILE FULL HEIGHT AND ON CEILING.
- WS18 FIRE EXTINGUISHER AND CABINET. REFER TO DETAIL 3/A652.
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- WS22 PROVIDE CERAMIC TILE BACKSPLASH 48" HIGH BEHIND BOTH SINKS.
- WS23 INSTALL APPROXIMATELY 24" OF 1/2" GYPSUM BOARD OVER EXPOSED FRAMING.
- WS24 PAINT ENTIRE FLOOR.

LEGEND

- EXISTING CERAMIC TILE
- NEW CERAMIC TILE

ELEVATION - 1

ELEVATION - 2

ELEVATION - 3

ELEVATION - 4

A INTERIOR ELEVATIONS - CORRIDOR B015  
SCALE: 1/4" = 1'-0"

PLOT DATE: October 18, 2021 10:19am

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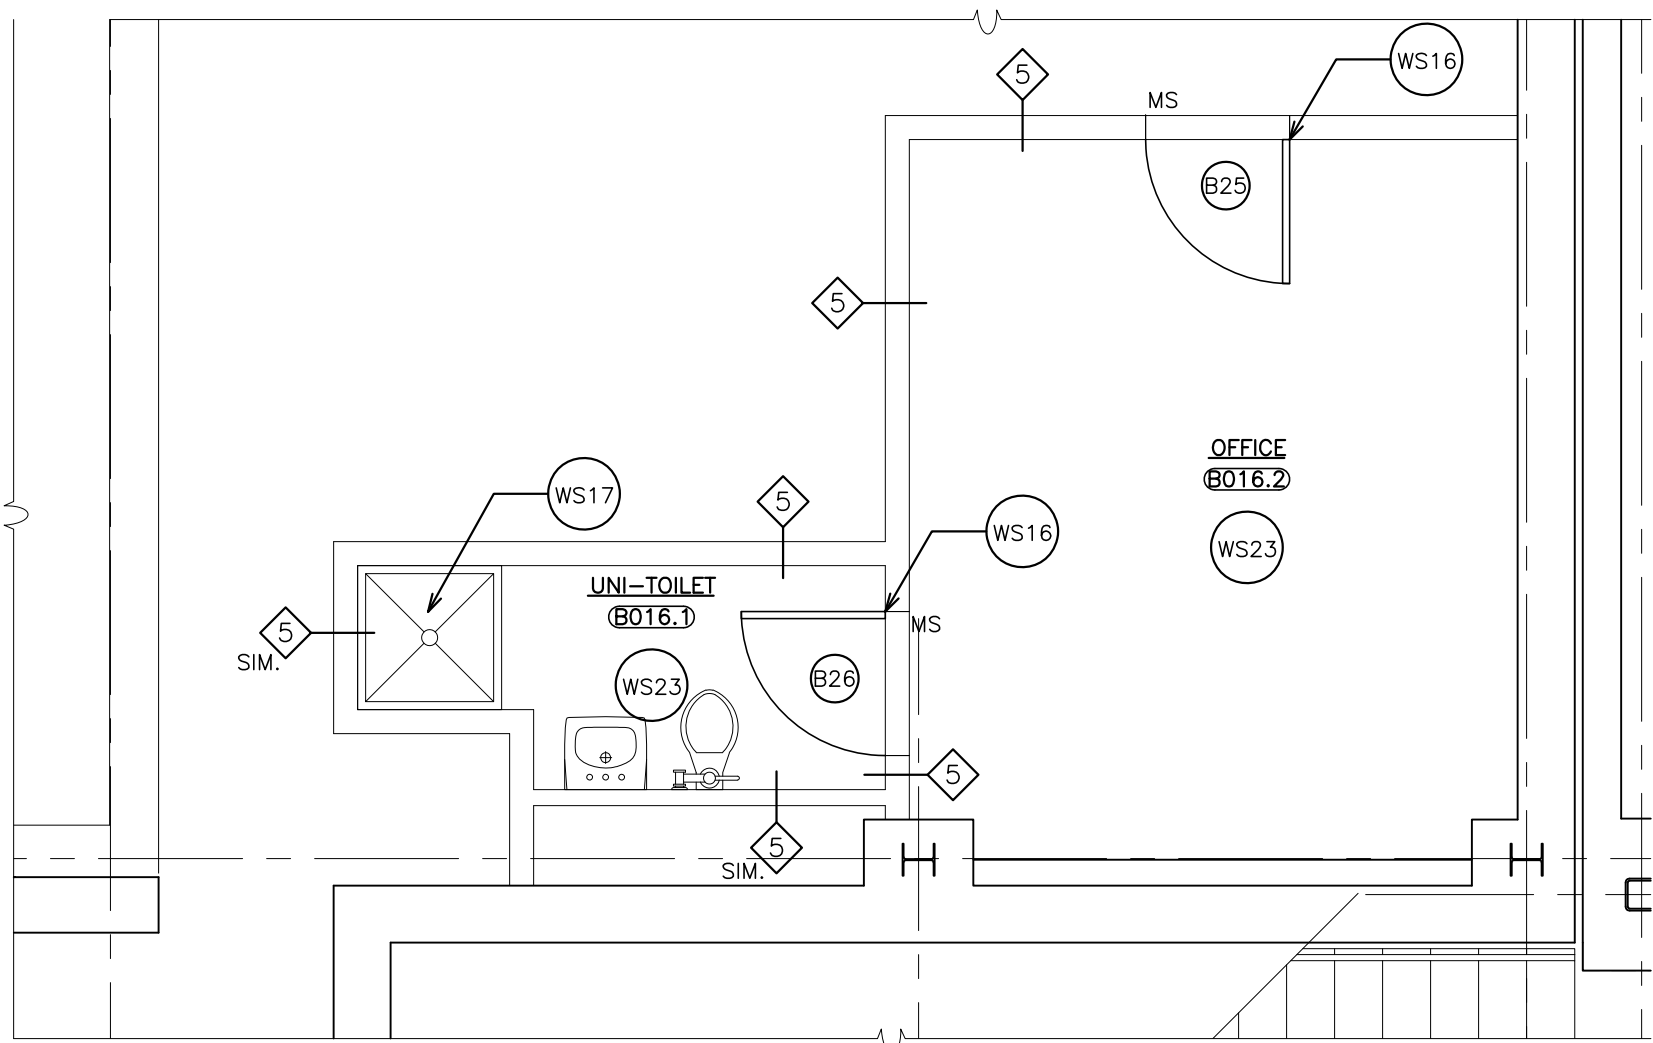
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JOHN F. KENNEDY ELEMENTARY SCHOOL  
FLOOD REPAIRS & RELATED WORK  
40 OLIVER STREET PORT CHESTER NY 10573  
DRAWING TITLE: JOHN F. KENNEDY ELEMENTARY SCHOOL  
PARTIAL GROUND FLOOR PLANS & INTERIOR ELEVATIONS


10-18-2021 B I O  
DATE ISSUED TO  
SHEET SIZE 30"x42"  
DRAWN BY F & D  
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FILE NO. 21444.01






2 PARTIAL GROUND FLOOR PLAN  
SCALE: 1/4" = 1'-0"


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WS24	PAINT ENTIRE FLOOR.

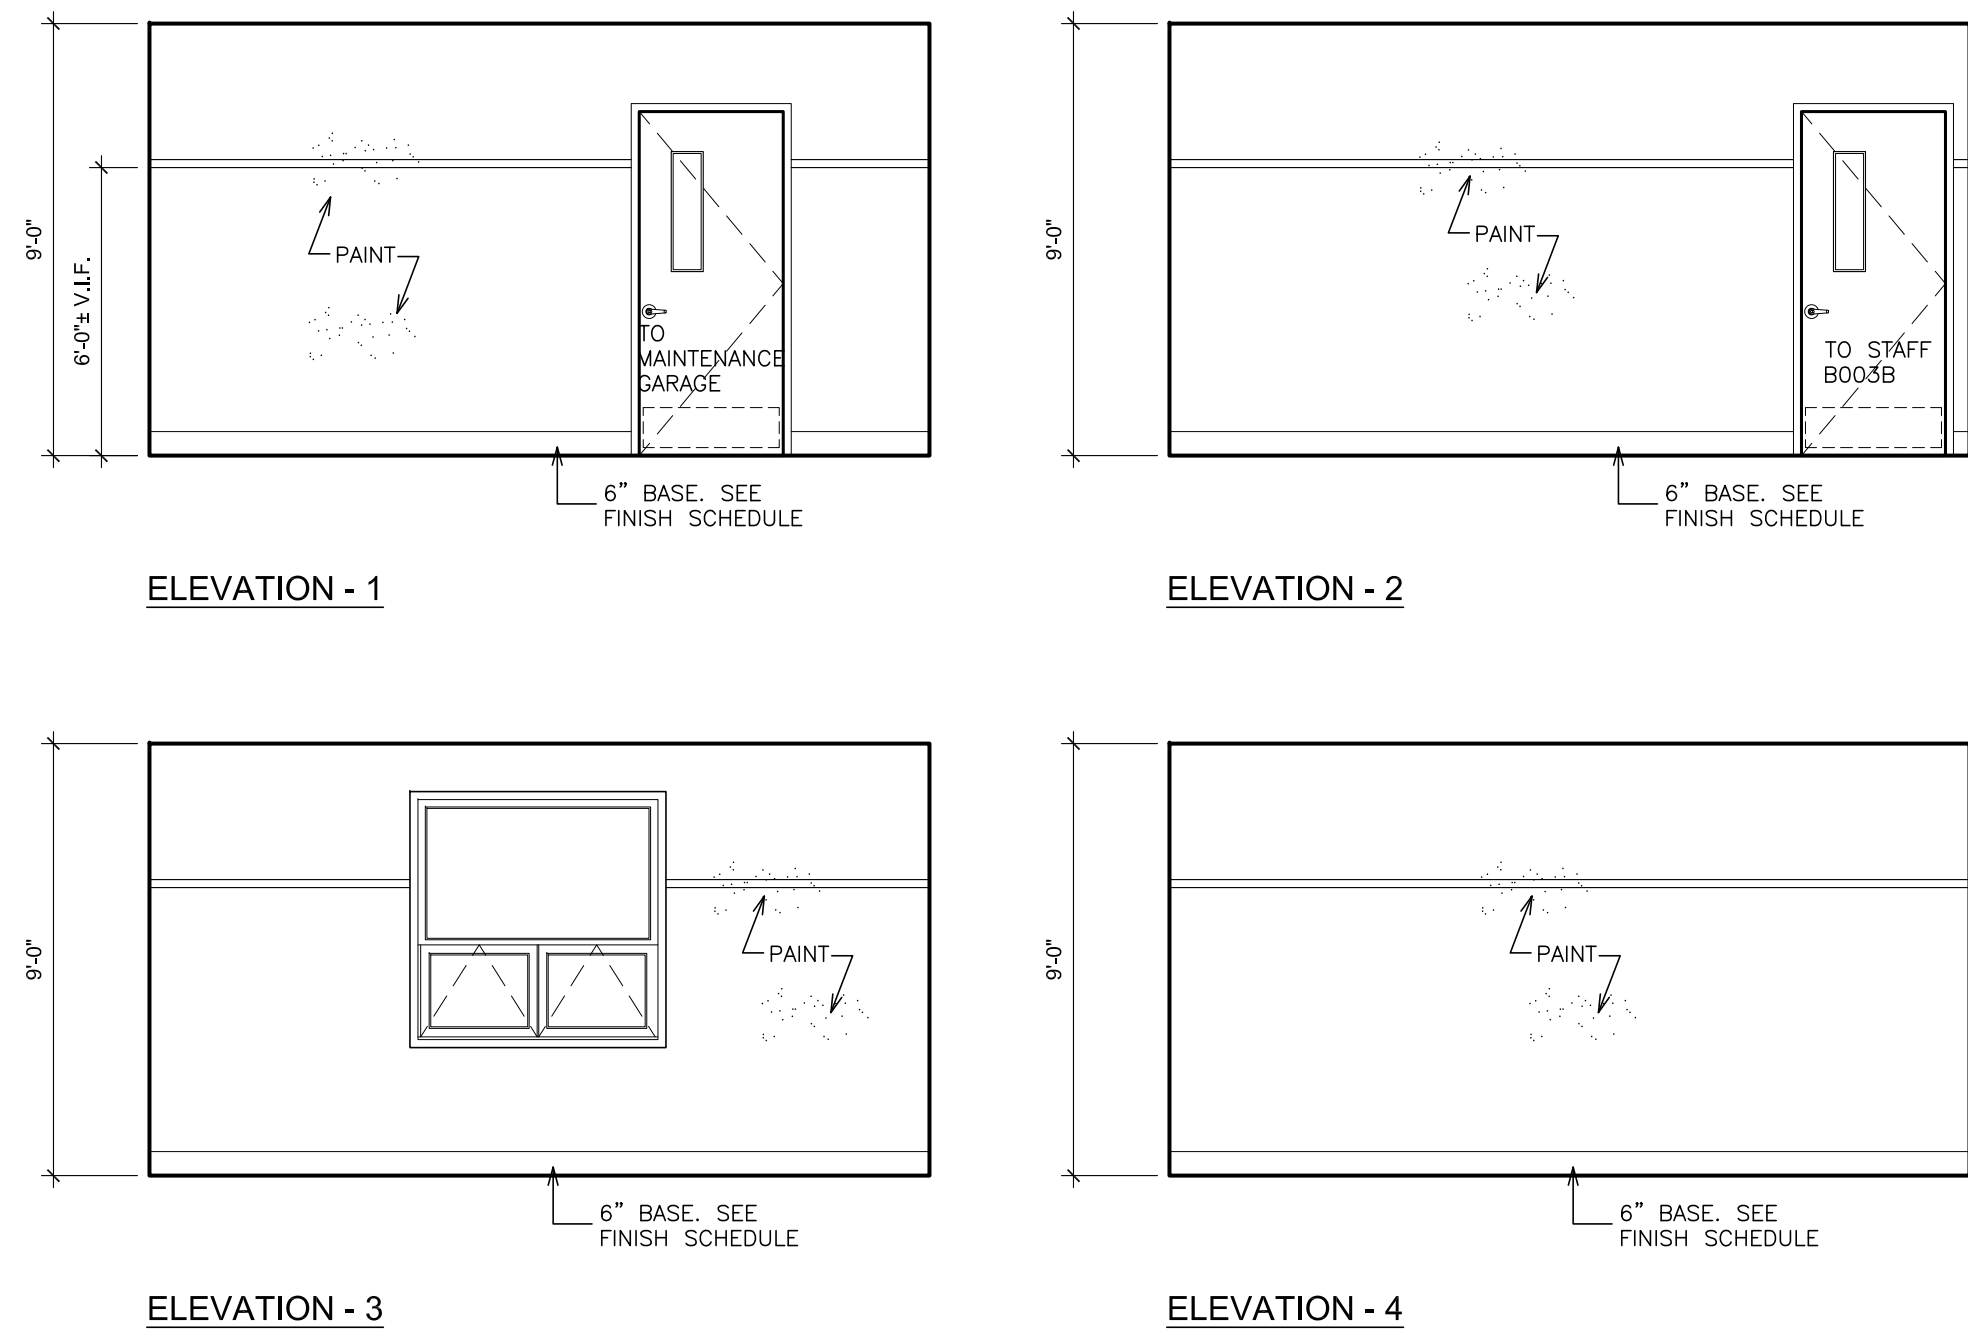

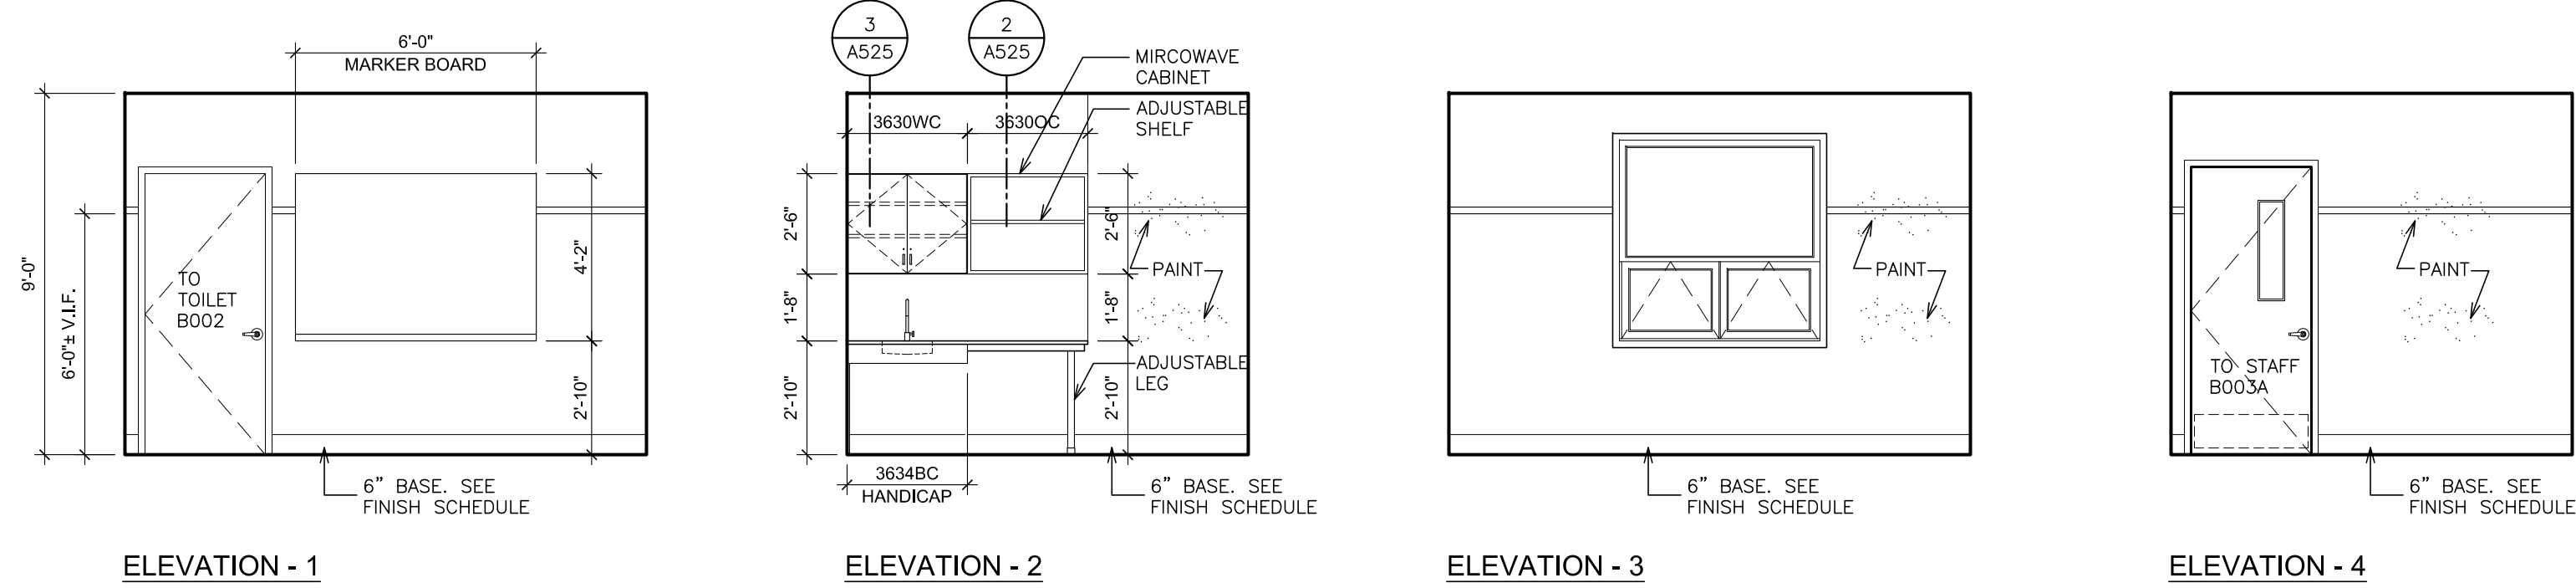
A INTERIOR ELEVATIONS - STAFF B003A  
SCALE: 1/4" = 1'-0"



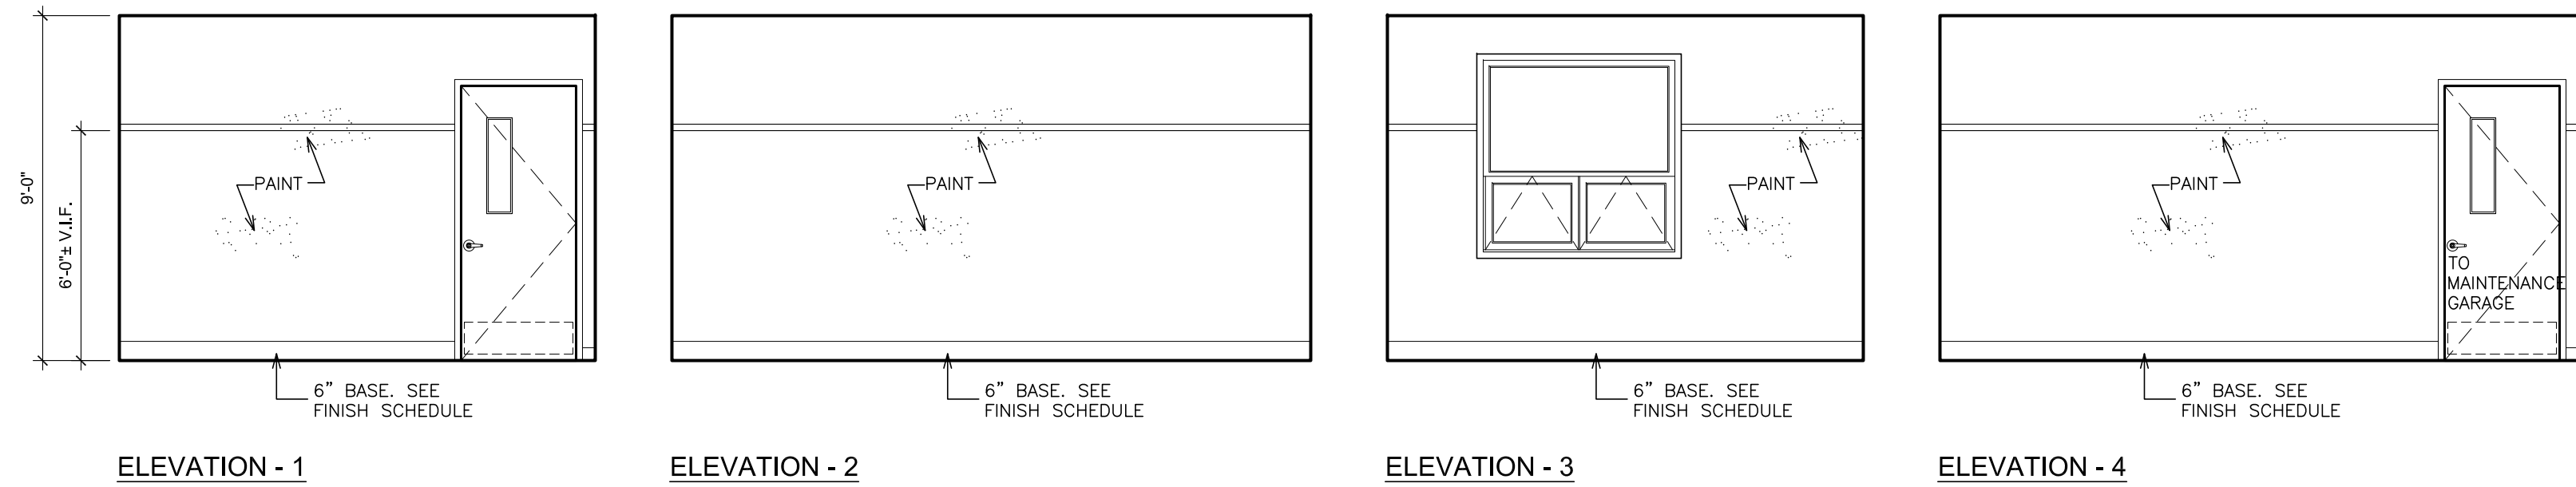
B INTERIOR ELEVATIONS - STAFF B003B  
SCALE: 1/4" = 1'-0"



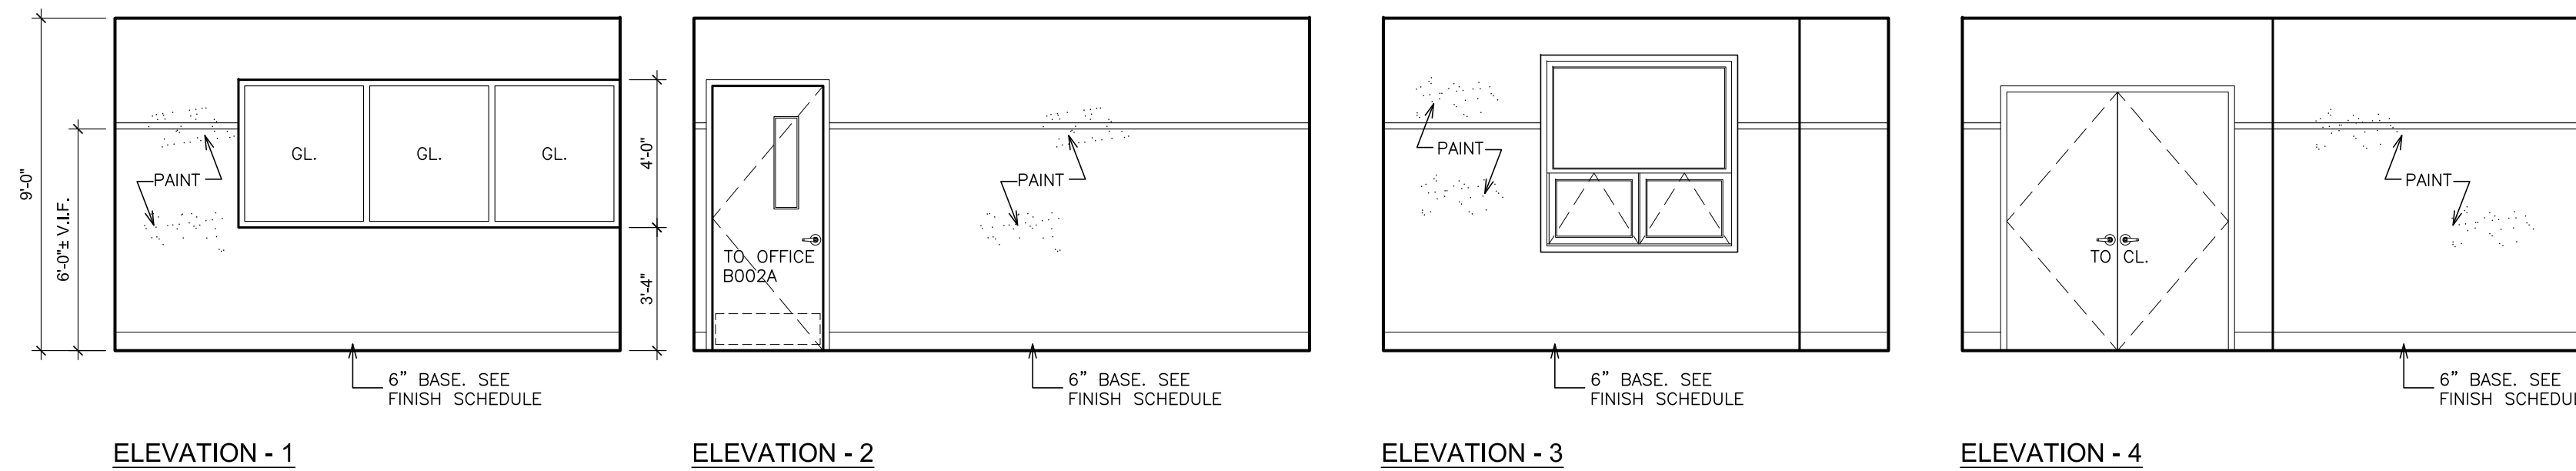C INTERIOR ELEVATIONS - OFFICE B004A  
SCALE: 1/4" = 1'-0"



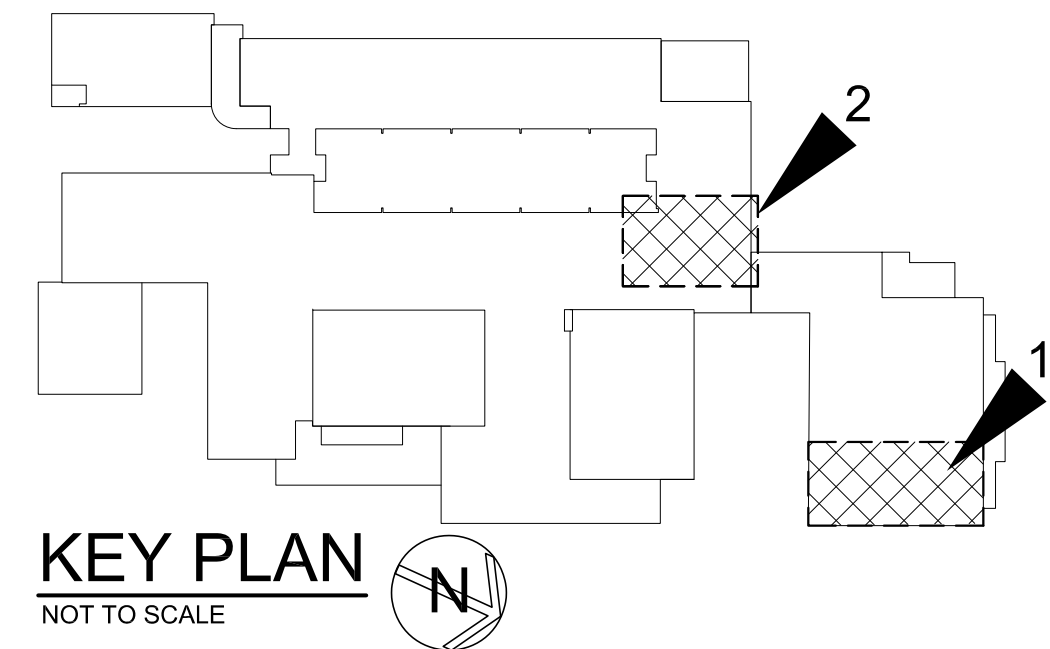D INTERIOR ELEVATIONS - OFFICE B004B  
SCALE: 1/4" = 1'-0"



LEGEND		NOTE:	
AC	ACCOUTICAL PARTITION	PTA-A	PASS-THRU DEMO ASSEMBLY- ACCESSIBLE
BC	BASE CABINET	PWS	PERIMETER WORK STATION
BL	BLIND CABINET	REF	REFRIGERATOR
BS	BASE OPEN SHELVES	RG	RANGE
C	CLOCK	SA	ACCESSIBLE SINK
CC	CORNER CASE	SB-A	SINK BASE-ACCESSIBLE
CHBD	CHALKBOARD	SS-A	SAFETY STATION- ACCESSIBLE
CS	COMPUTER WORKSTATION	SW	STUDENT WARDROBE
CP	CONTROL PANEL	TBOD	TACKBOARD
DR	DRAWER CABINET	TC	TALL CABINET
DW	DISHWASHER	TDI	TEACHER'S DEMONSTRATION TABLE
E.H.	EXHAUST HOOD	TS	TALL SHELVES
F.E.	FIRE EXTINGUISHER	TS	TEACHERS WARDROBE
F.B.C.	FIRE EXTINGUISHER	UC	UPPER CASE CABINET
FWBD	WHITEBOARD	VFCU	VERTICAL FAN COIL UNIT
IW	ISLAND WORK GROUP	WC	WALL CABINET
LFB	LABORATORY FEO BOARD	WK-A	WORKSTATION-ACCESSIBLE
LF	LATERAL FILE	WS	WALL OPEN SHELVES
MICR	MICROWAVE		
MIBD	MARKER BOARD		
OC	OPEN CABINET		
PS	PRINTER STATION		

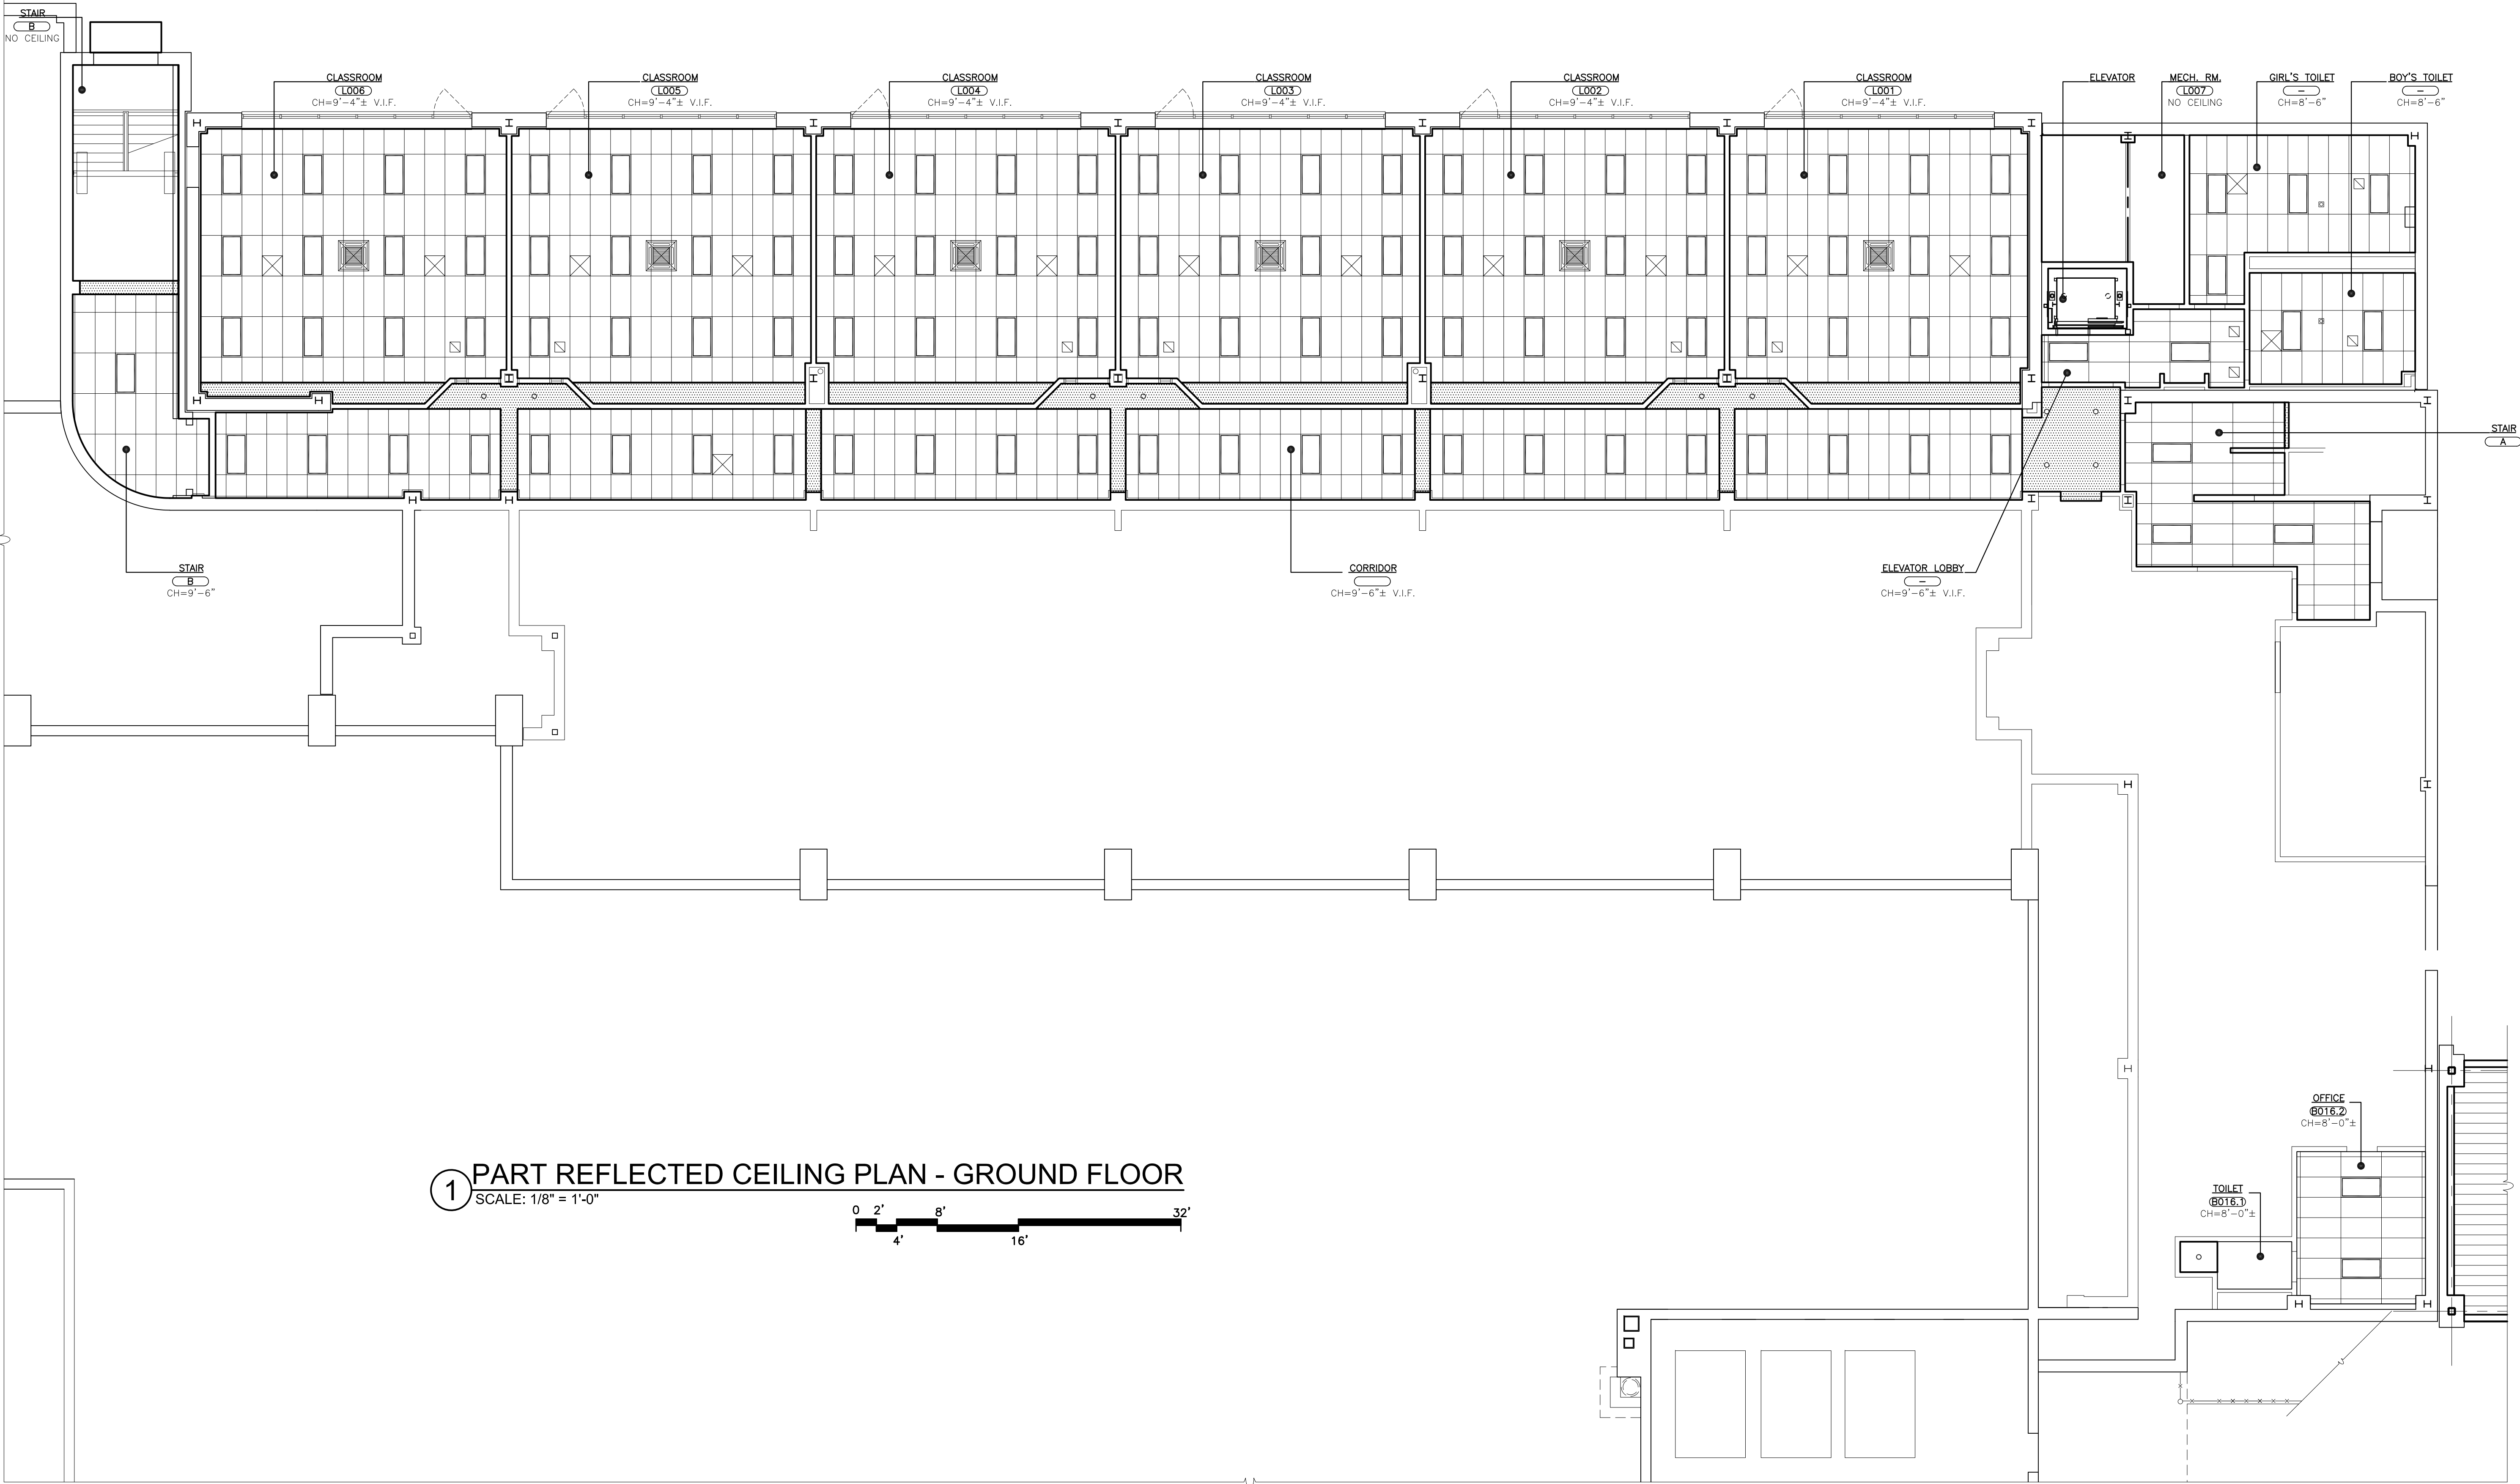
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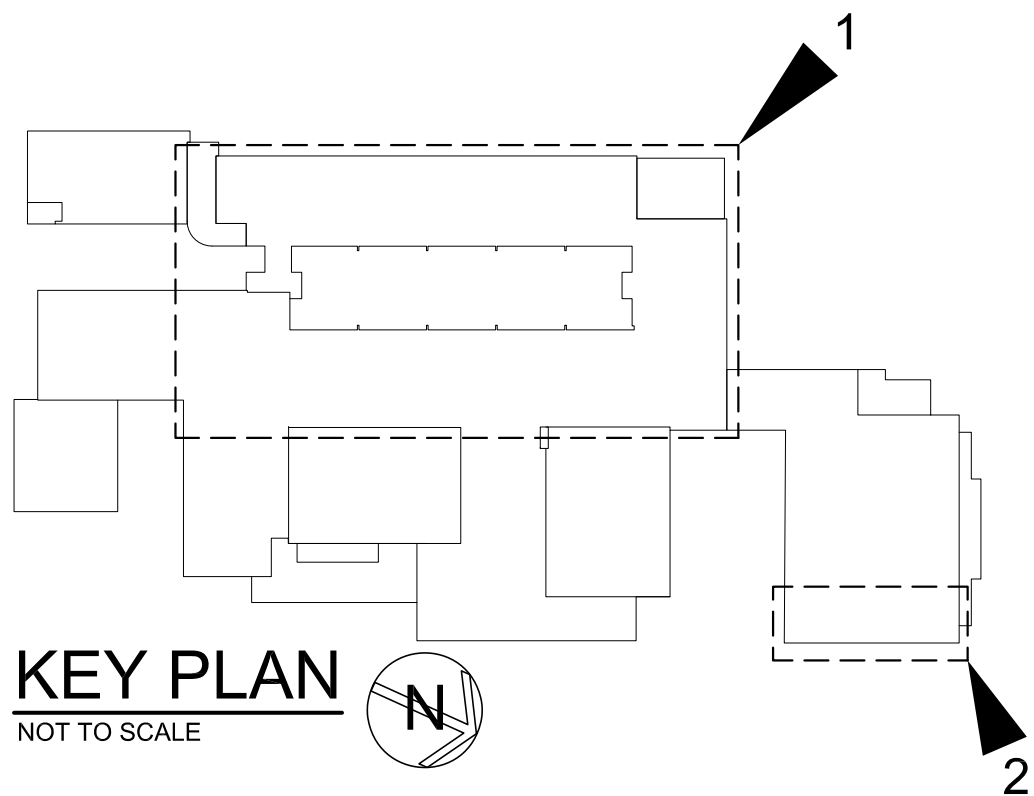
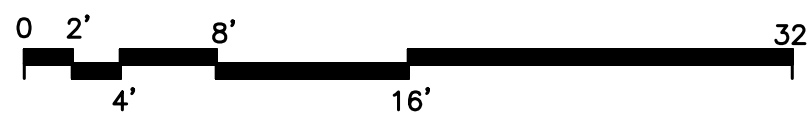
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PROJECT: JOHN F. KENNEDY ELEMENTARY SCHOOL  
FLOOR REPAIRS & RELATED WORK  
DRAWING TITLE: PARTIAL GROUND FLOOR PLANS & INTERIOR ELEVATIONS  
10-18-2021 B I O  
DATE ISSUED TO  
SHEET SIZE 30"x42"  
DRAWN BY F & D  
CHECKED BY F & D  
FILE NO. 21444.01





1 PART REFLECTED CEILING PLAN - GROUND FLOOR  
SCALE: 1/8" = 1'-0"




#### CEILING LEGEND

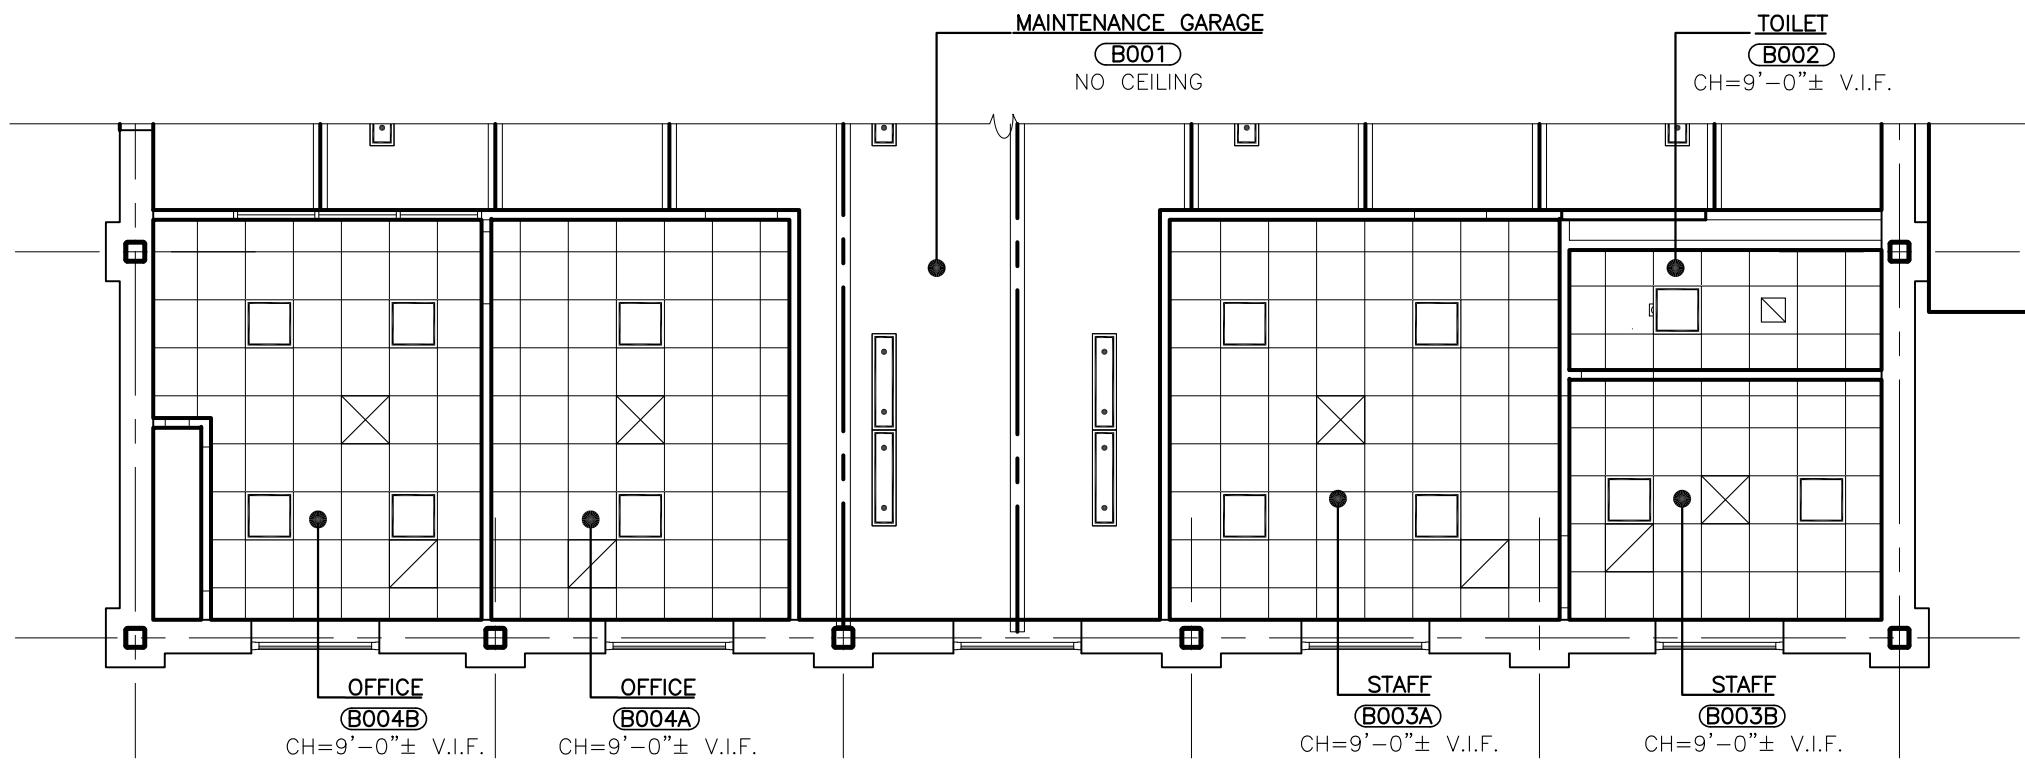- EXISTING 2'x4' RECESSED MOUNTED LIGHT FIXTURE
- RECESSED CAN LIGHT FIXTURE
- EXISTING GYPSUM BOARD SOFFIT PAINT
- FIRE ALARM SMOKE DETECTOR
- CEILING SPEAKER
- CEILING REGISTER, SIZE VARIES. SEE MECHANICAL DRAWINGS.
- CEILING DIFFUSER, SIZE VARIES. SEE MECHANICAL DRAWINGS.
- AIR HANDLING UNITS. SEE MECHANICAL DRAWINGS.
- CEILING MOUNTED EXIT SIGN W/ DIRECTIONAL ARROW
- WALL MOUNTED EXIT SIGN W/ DIRECTIONAL ARROW
- 2'x4' ACOUSTICAL CEILING TILE AND SUSPENSION SYSTEM

#### GENERAL CEILING NOTES

- ALL CEILING MOUNTED ITEMS (DETECTORS, GRILLS, ETC.) AND INDICATED ON THE MECHANICAL AND ELECTRICAL DRAWINGS. ALL ITEMS ARE TO BE CENTERED WITHIN THE CEILING TILES AND GRIDS. WHERE ITEMS ARE SHOWN ON ARCHITECTURAL DRAWINGS THEY DENOTE LOCATION AND LAYOUT WHERE PLACEMENT IS CRITICAL. THE ARCHITECTURAL DRAWINGS DO NOT REPRESENT COMPLETE SYSTEMS THAT ARE SHOWN ON OTHER DRAWINGS. REFER TO MECHANICAL AND ELECTRICAL DRAWINGS FOR ACCESS DOORS REQUIRED FOR ANY DEVICES WHICH MAY BE COVERED OVER DUE TO NEW CEILING AND SOFFIT WORK.
- THE CEILING GRID IS EXISTING.
- PAINT ALL NEW GYPSUM WALLBOARD SOFFITS AND CEILINGS.
- REFER TO FINISH SCHEDULE FOR ADDITIONAL INFORMATION.
- FIT CEILING TILES AND GRIDS AROUND VERTICAL PIPES THAT PASS THROUGH THE NEW CEILING.
- OWNER SHALL REMOVE AND RE-INSTALL WIFI RECEIVERS, CAMERA'S AND SECURITY DEVICES.
- NOT USED
- CEILING HEIGHTS INDICATED ARE EXISTING AND ARE TO BE FIELD VERIFIED BY CONTRACTOR.
- DIMENSIONS AND CONDITIONS OF EXISTING ITEMS ARE APPROXIMATE (NOT AS-BUILTS). CONTRACTOR SHALL FIELD VERIFY.



2 PARTIAL REFLECTED CEILING - GROUND FLOOR  
SCALE: 1/8" = 1'-0"

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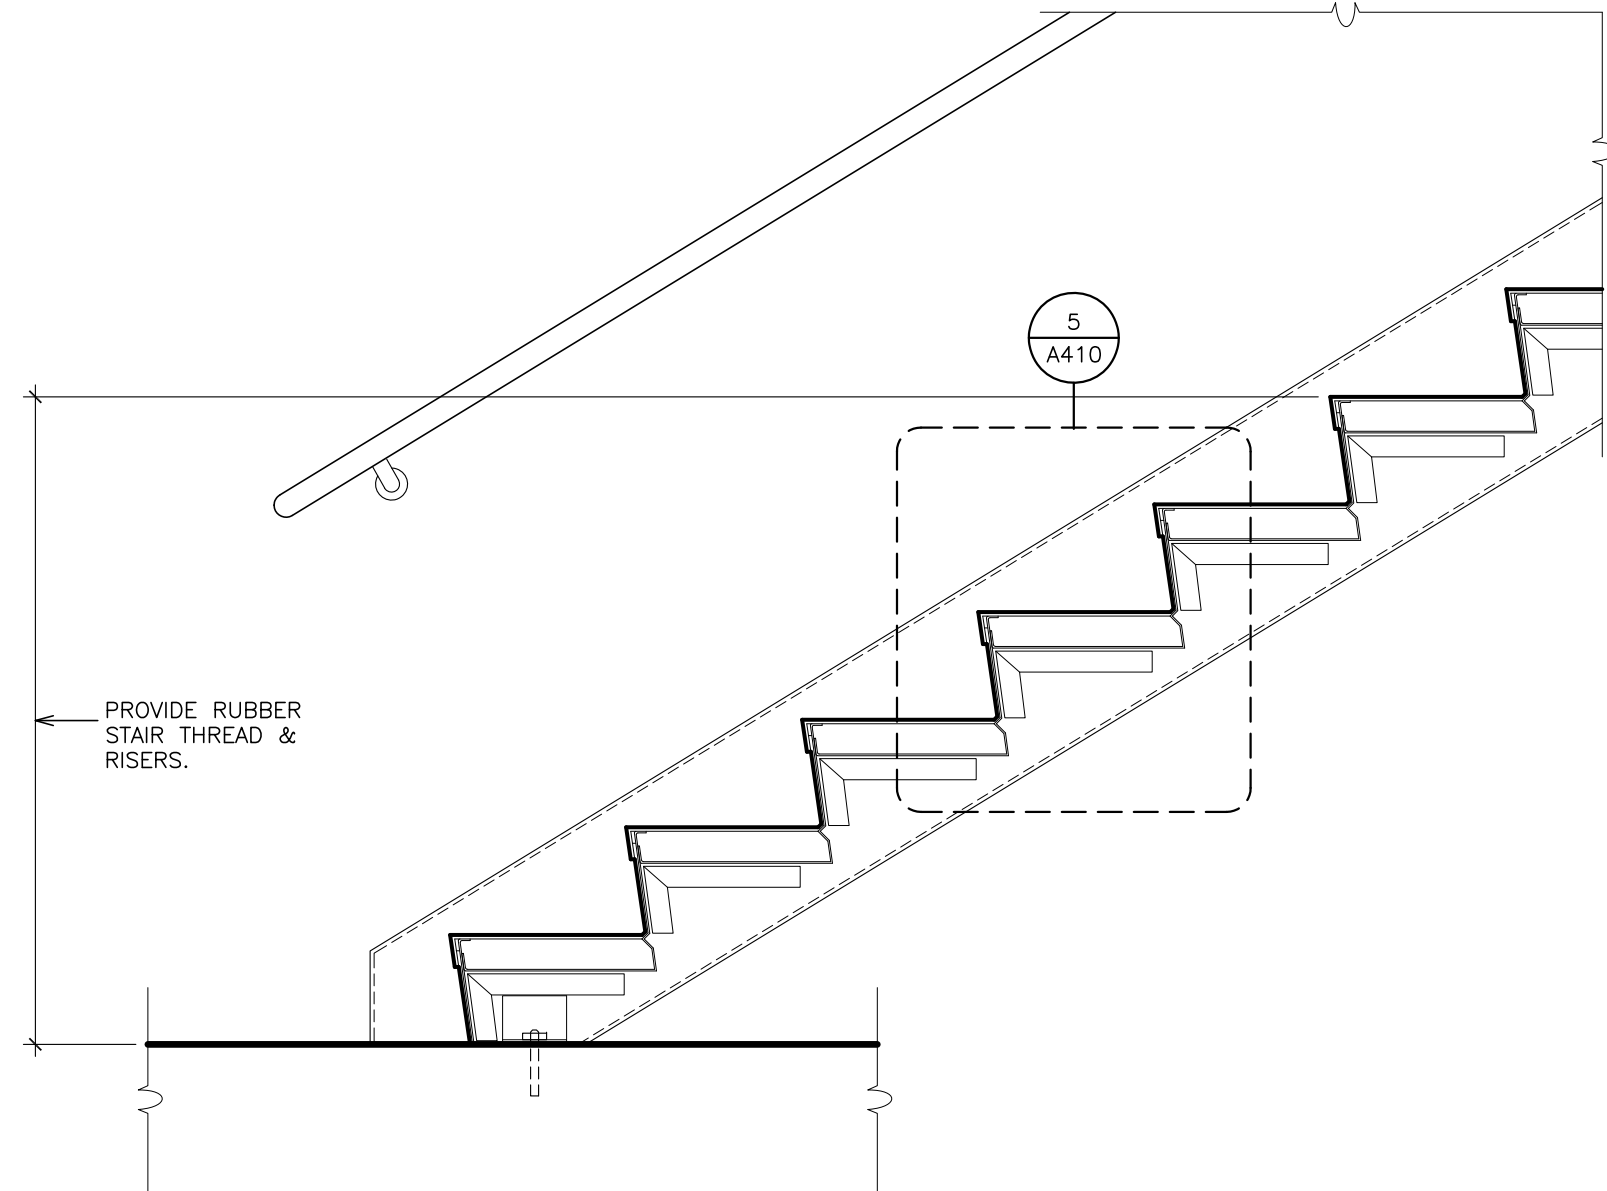
PROJECT: JOHN F. KENNEDY ELEMENTARY SCHOOL, DISTRICT  
JOHN F. KENNEDY ELEMENTARY SCHOOL  
FLOOD REPAIRS & RELATED WORK  
40 DAVENPORT STREET PORT CHESTER, NY 10573  
DRAWING TITLE  
JOHN F. KENNEDY ELEMENTARY SCHOOL  
REFLECTED CEILING PLANS - GROUND FLOOR

10-18-2021 B I D  
DATE ISSUED TO  
SHEET SIZE 30"x42"  
DRAWN BY F & D  
CHECKED BY F & D  
DRAWING NO. A200  
FILE NO. 21444.01

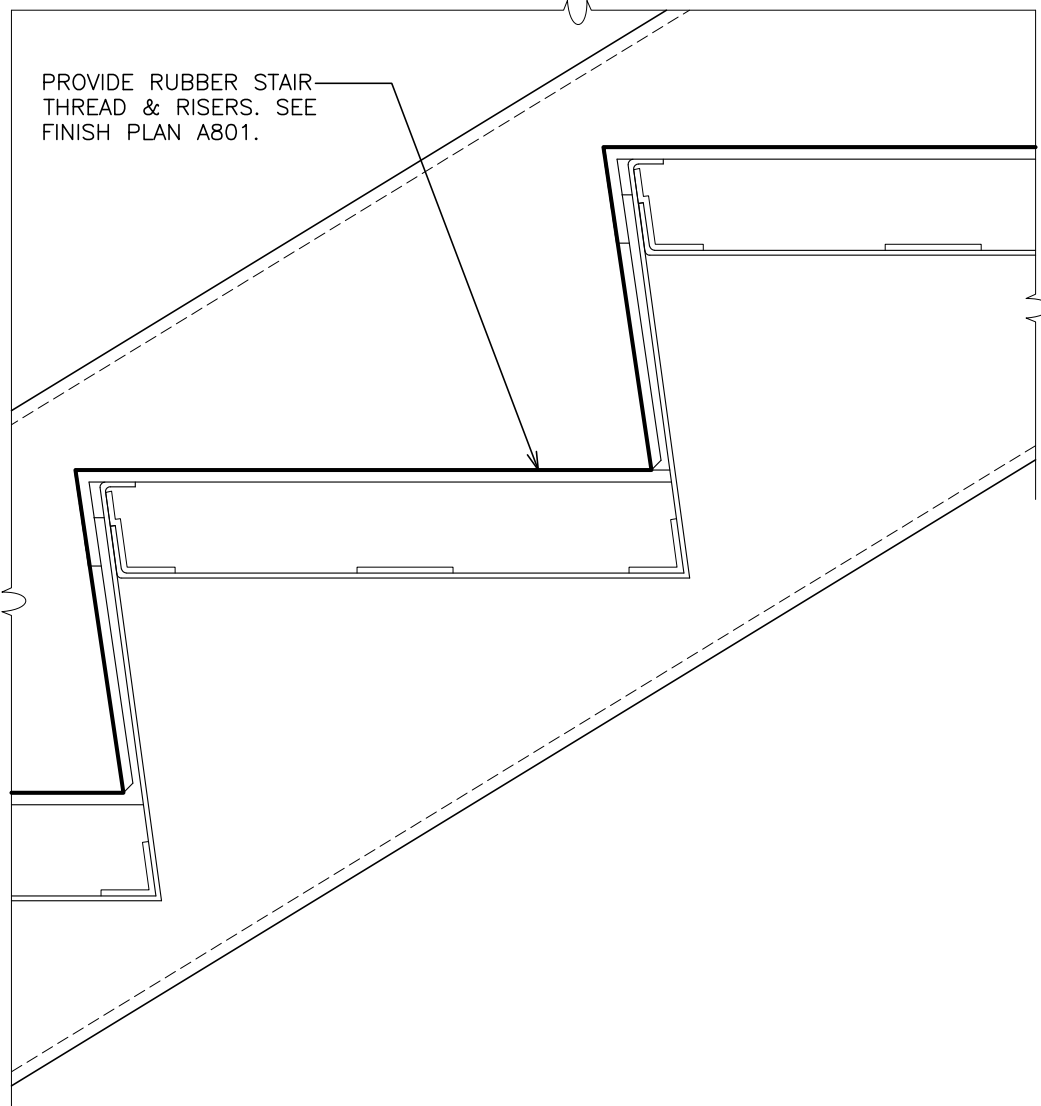


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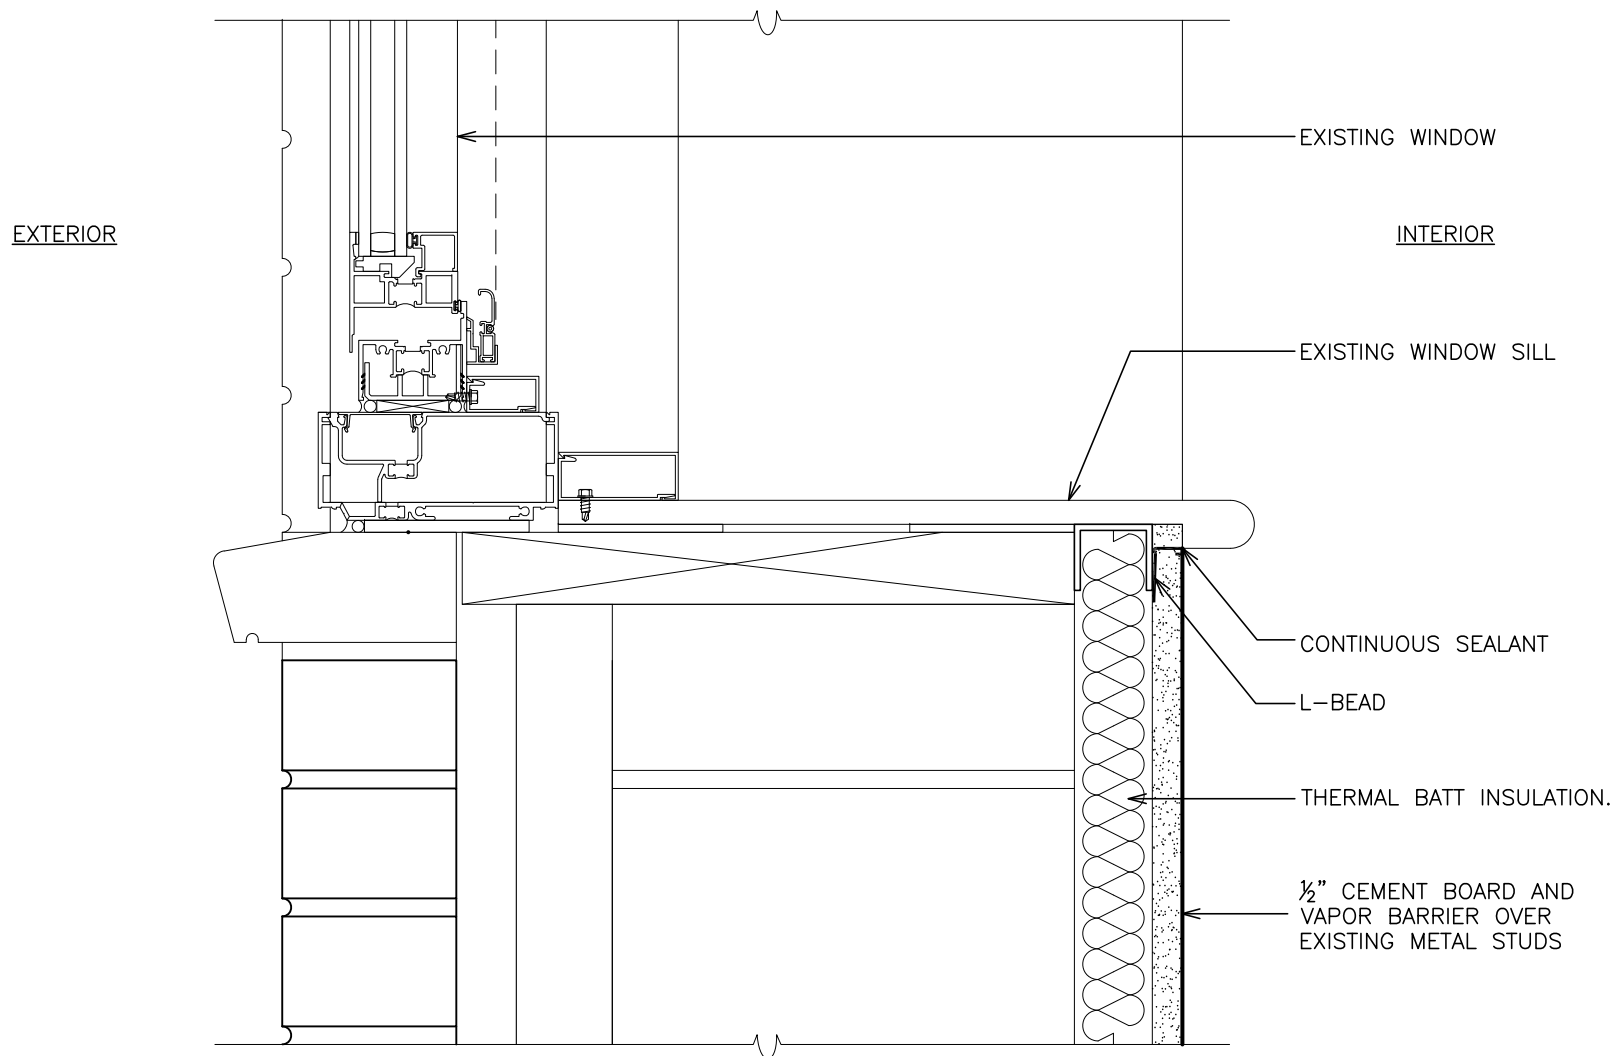
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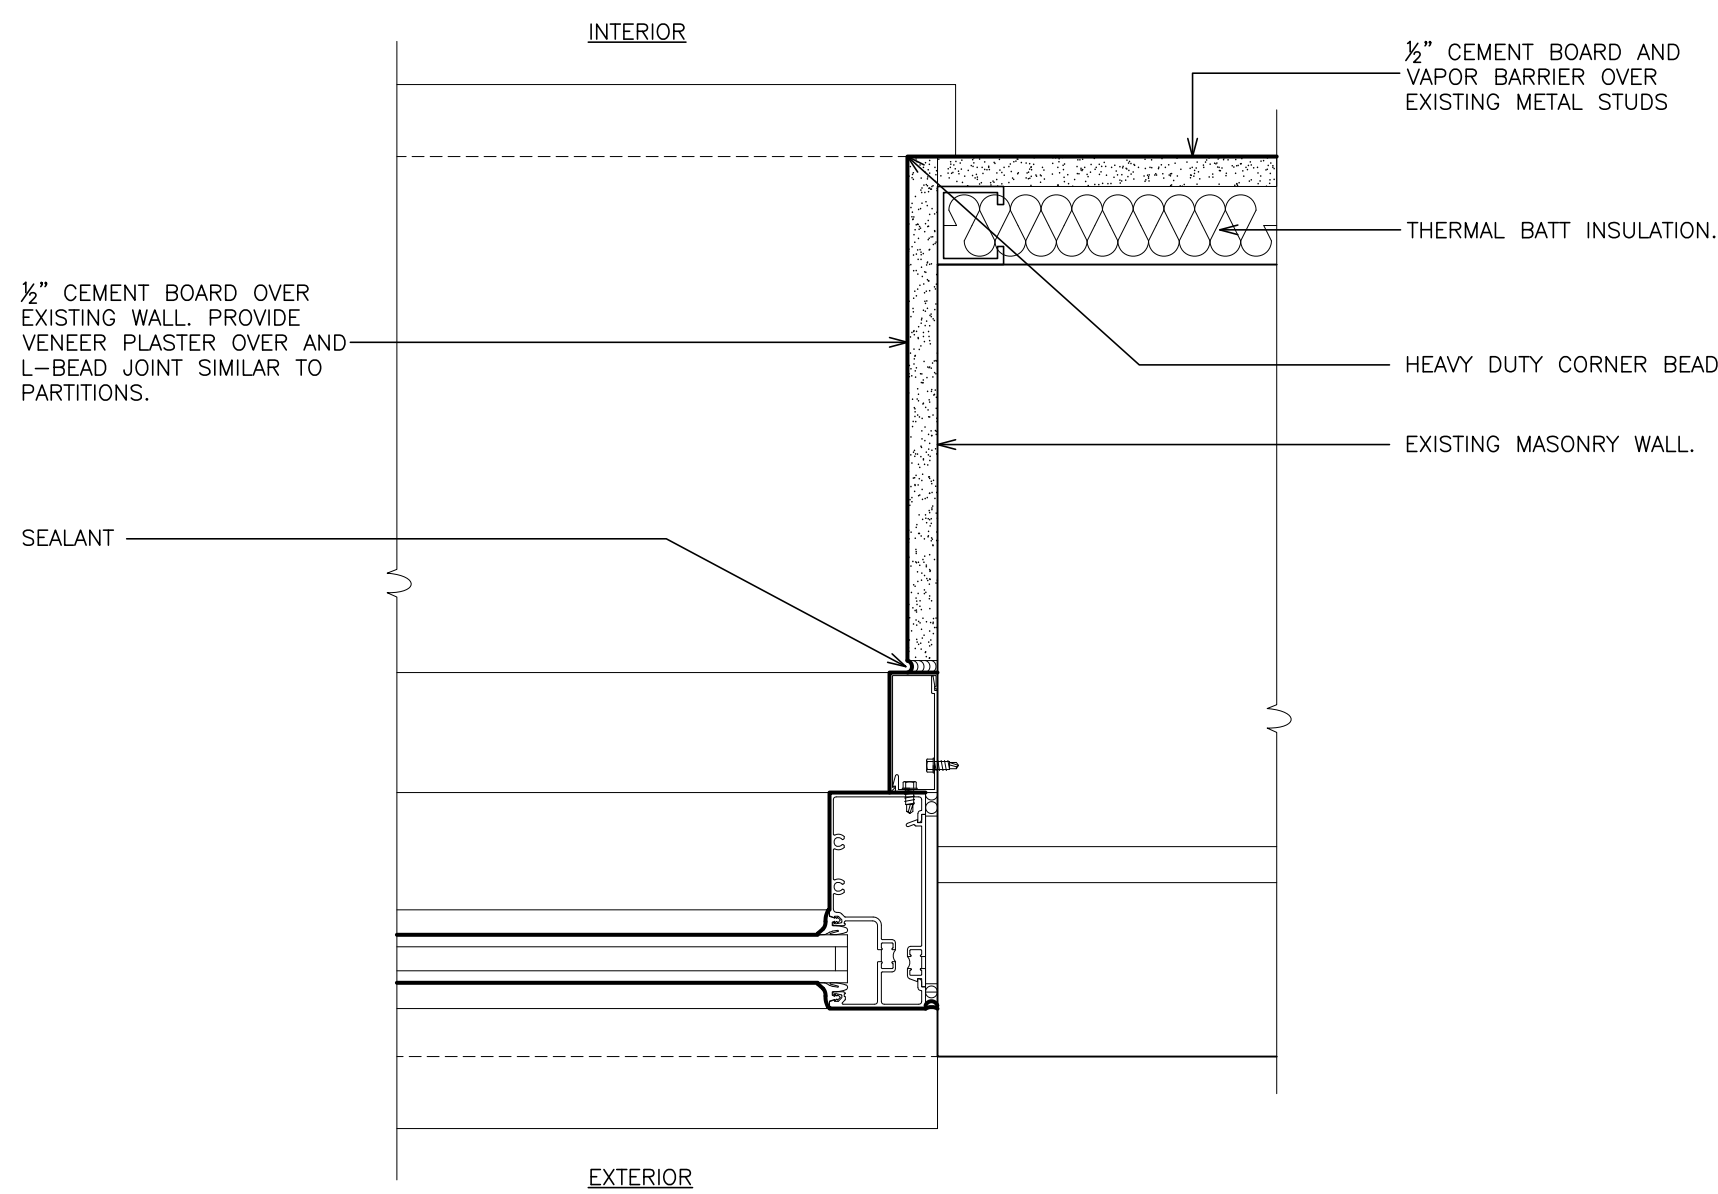
4 TYP. DETAIL  
SCALE: 1" = 1'-0"



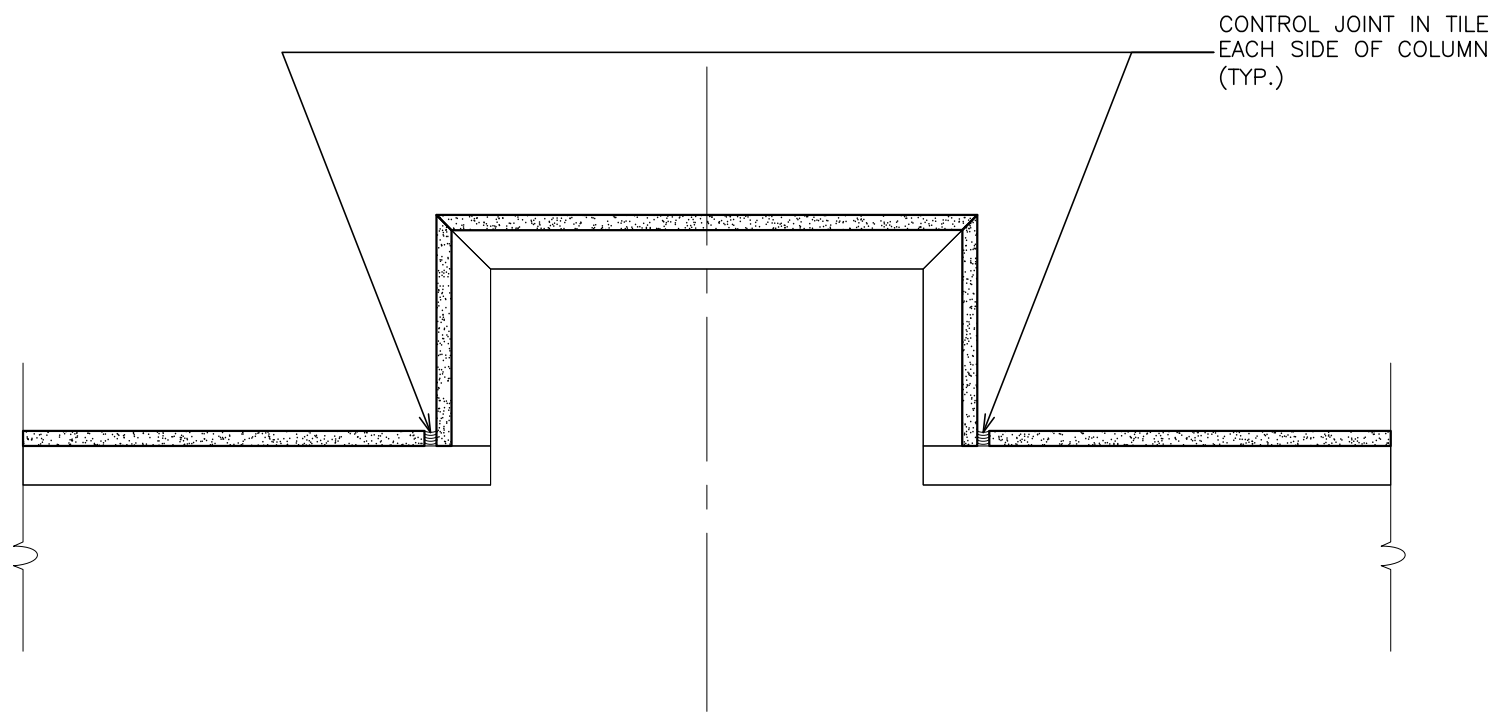
5 DETAIL @ TREAD  
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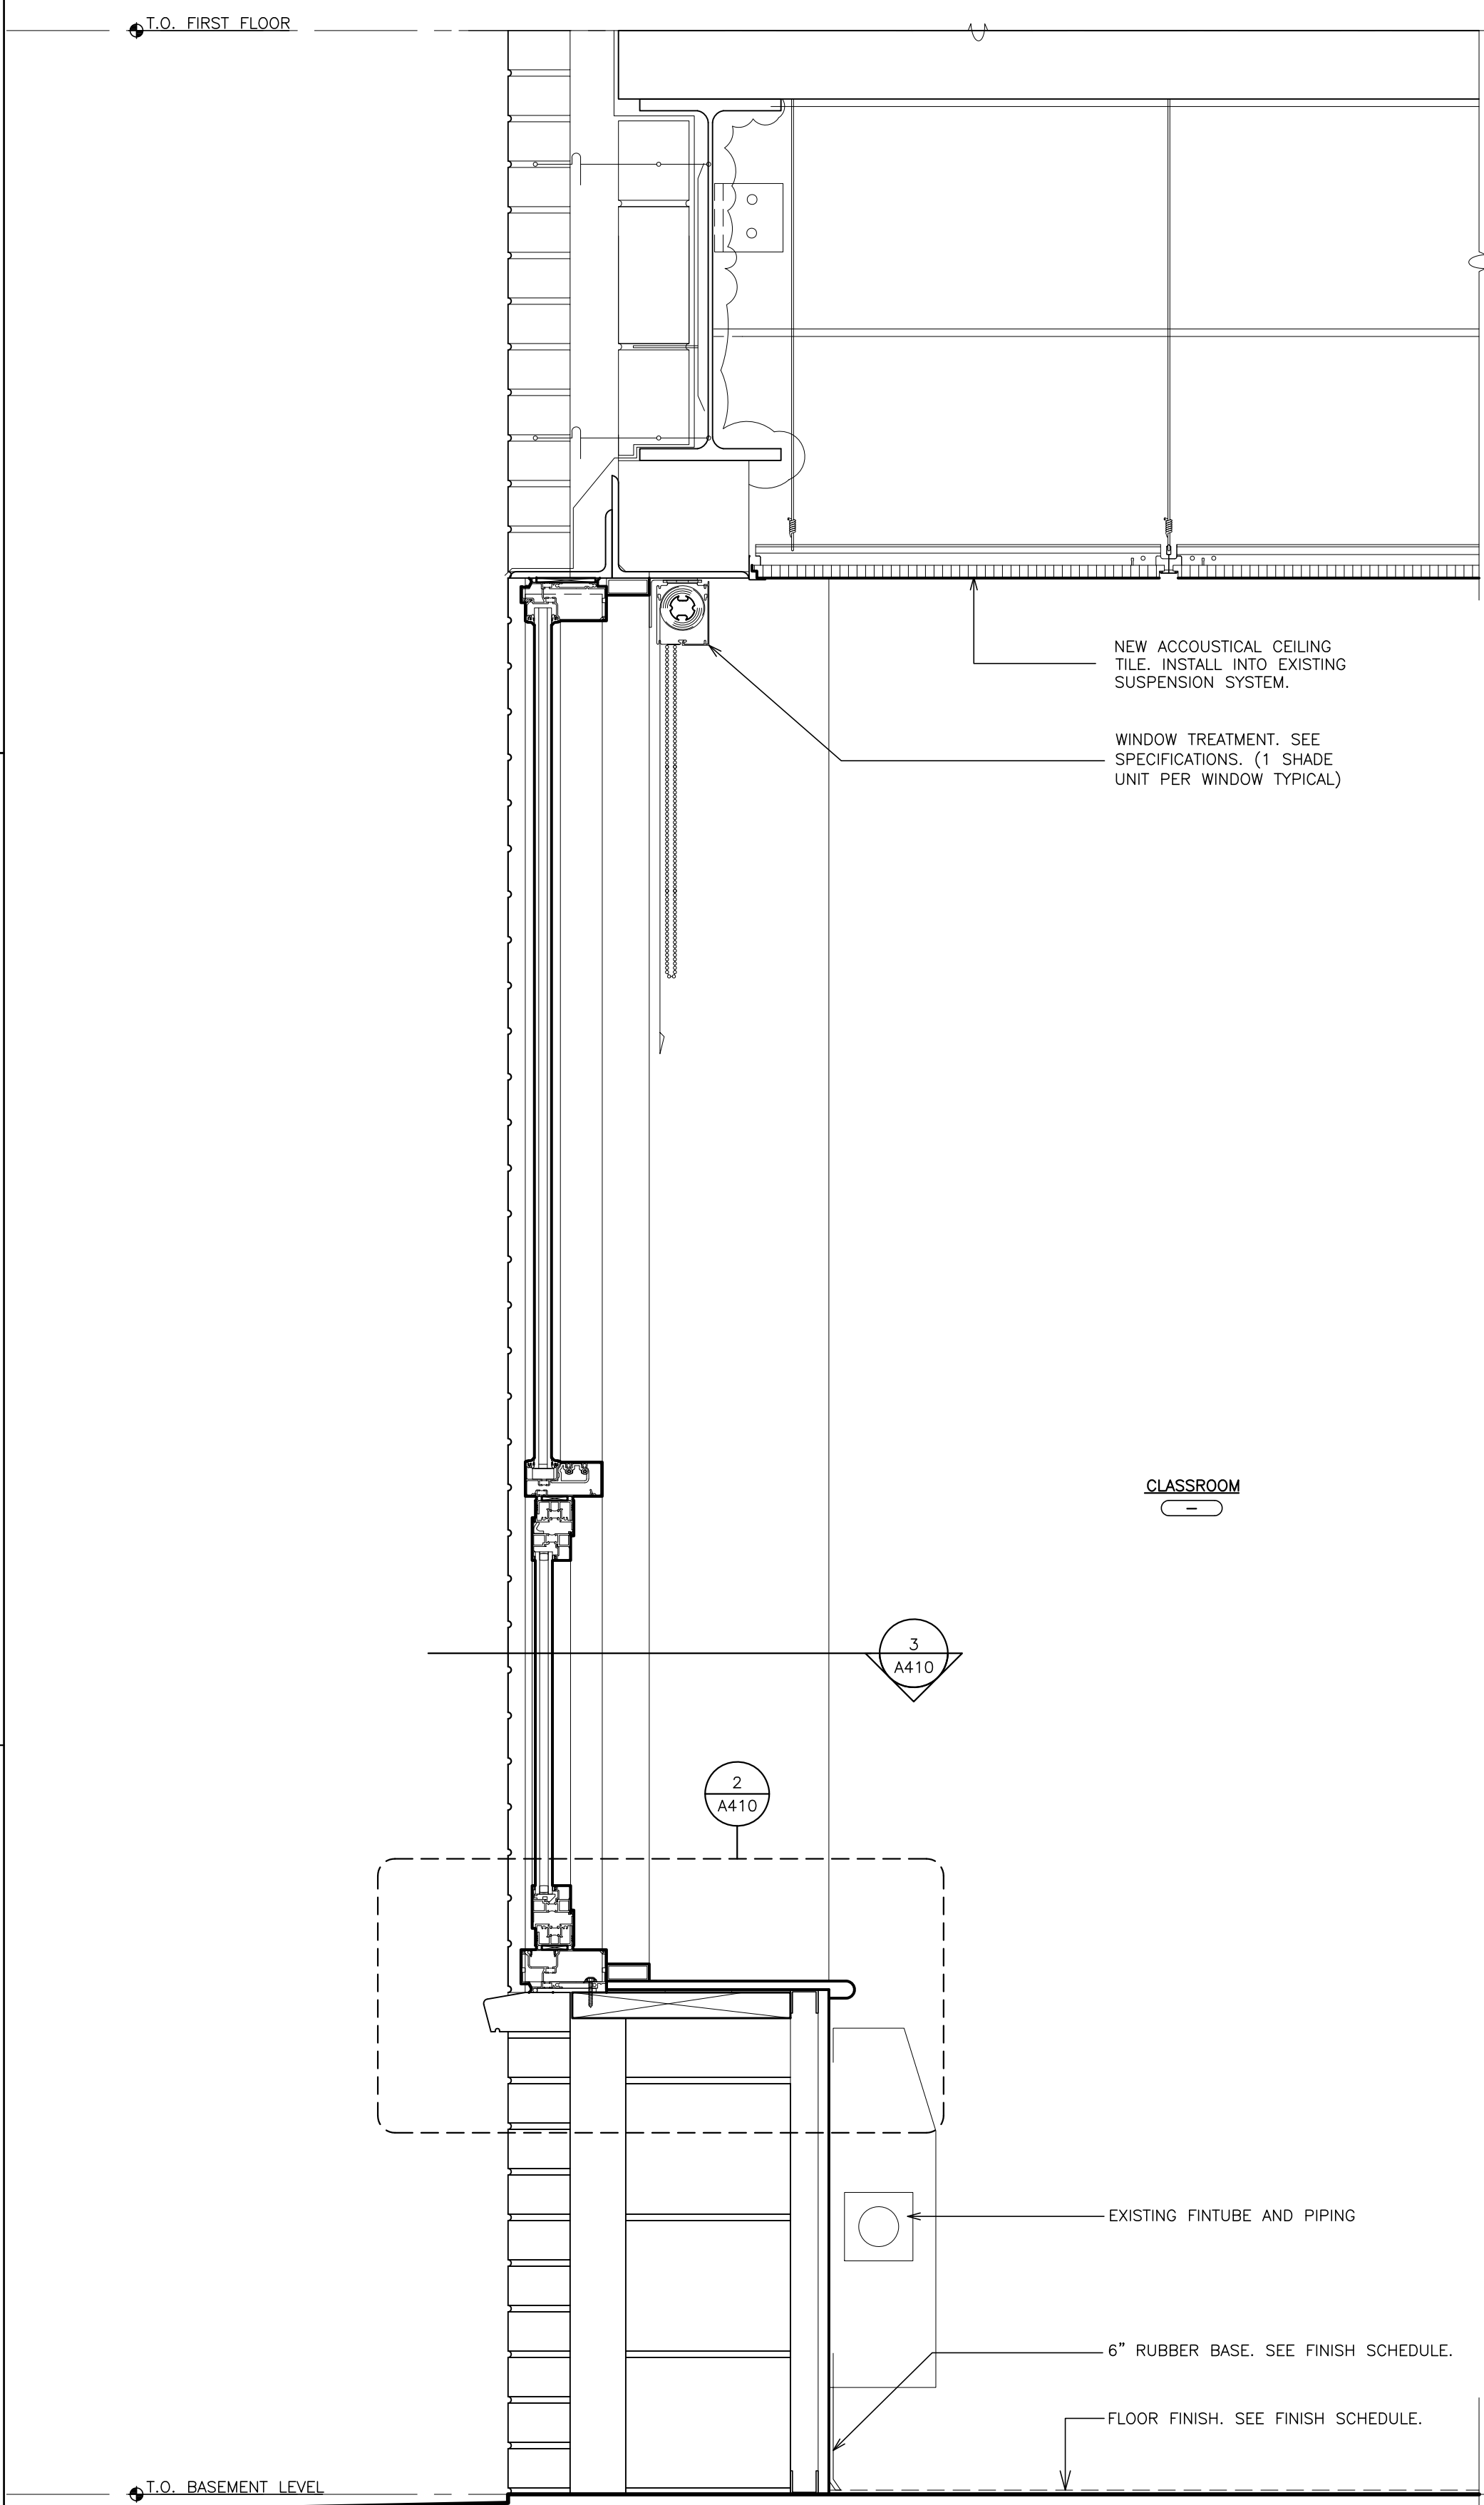
2 SILL  
SCALE: 3" = 1'-0"



3 JAMB  
SCALE: 3" = 1'-0"



6 DETAIL - JOINT @ COLUMN  
SCALE: 1 1/2" = 1'-0"



1 WALL SECTION  
SCALE: 1 1/2" = 1'-0"

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PROJECT: NEW YORK STATE  
PORT CHESTER-RYE UNION FREE SCHOOL DISTRICT  
JOHN F. KENNEDY ELEMENTARY SCHOOL  
FLOOD REPAIRS & RELATED WORK  
40 DAVENIA STREET PORT CHESTER NY 10573  
DRAWING TITLE  
ENLARGED STAIR PLANS, STAIR  
SECTION & DETAILS


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DATE	ISSUED TO
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DRAWN BY F & D	CHECKED BY F & D
FILE NO. 21444.01	









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② DETAIL- SHELF & DESK  
SCALE: 1 1/2" = 1'-0"

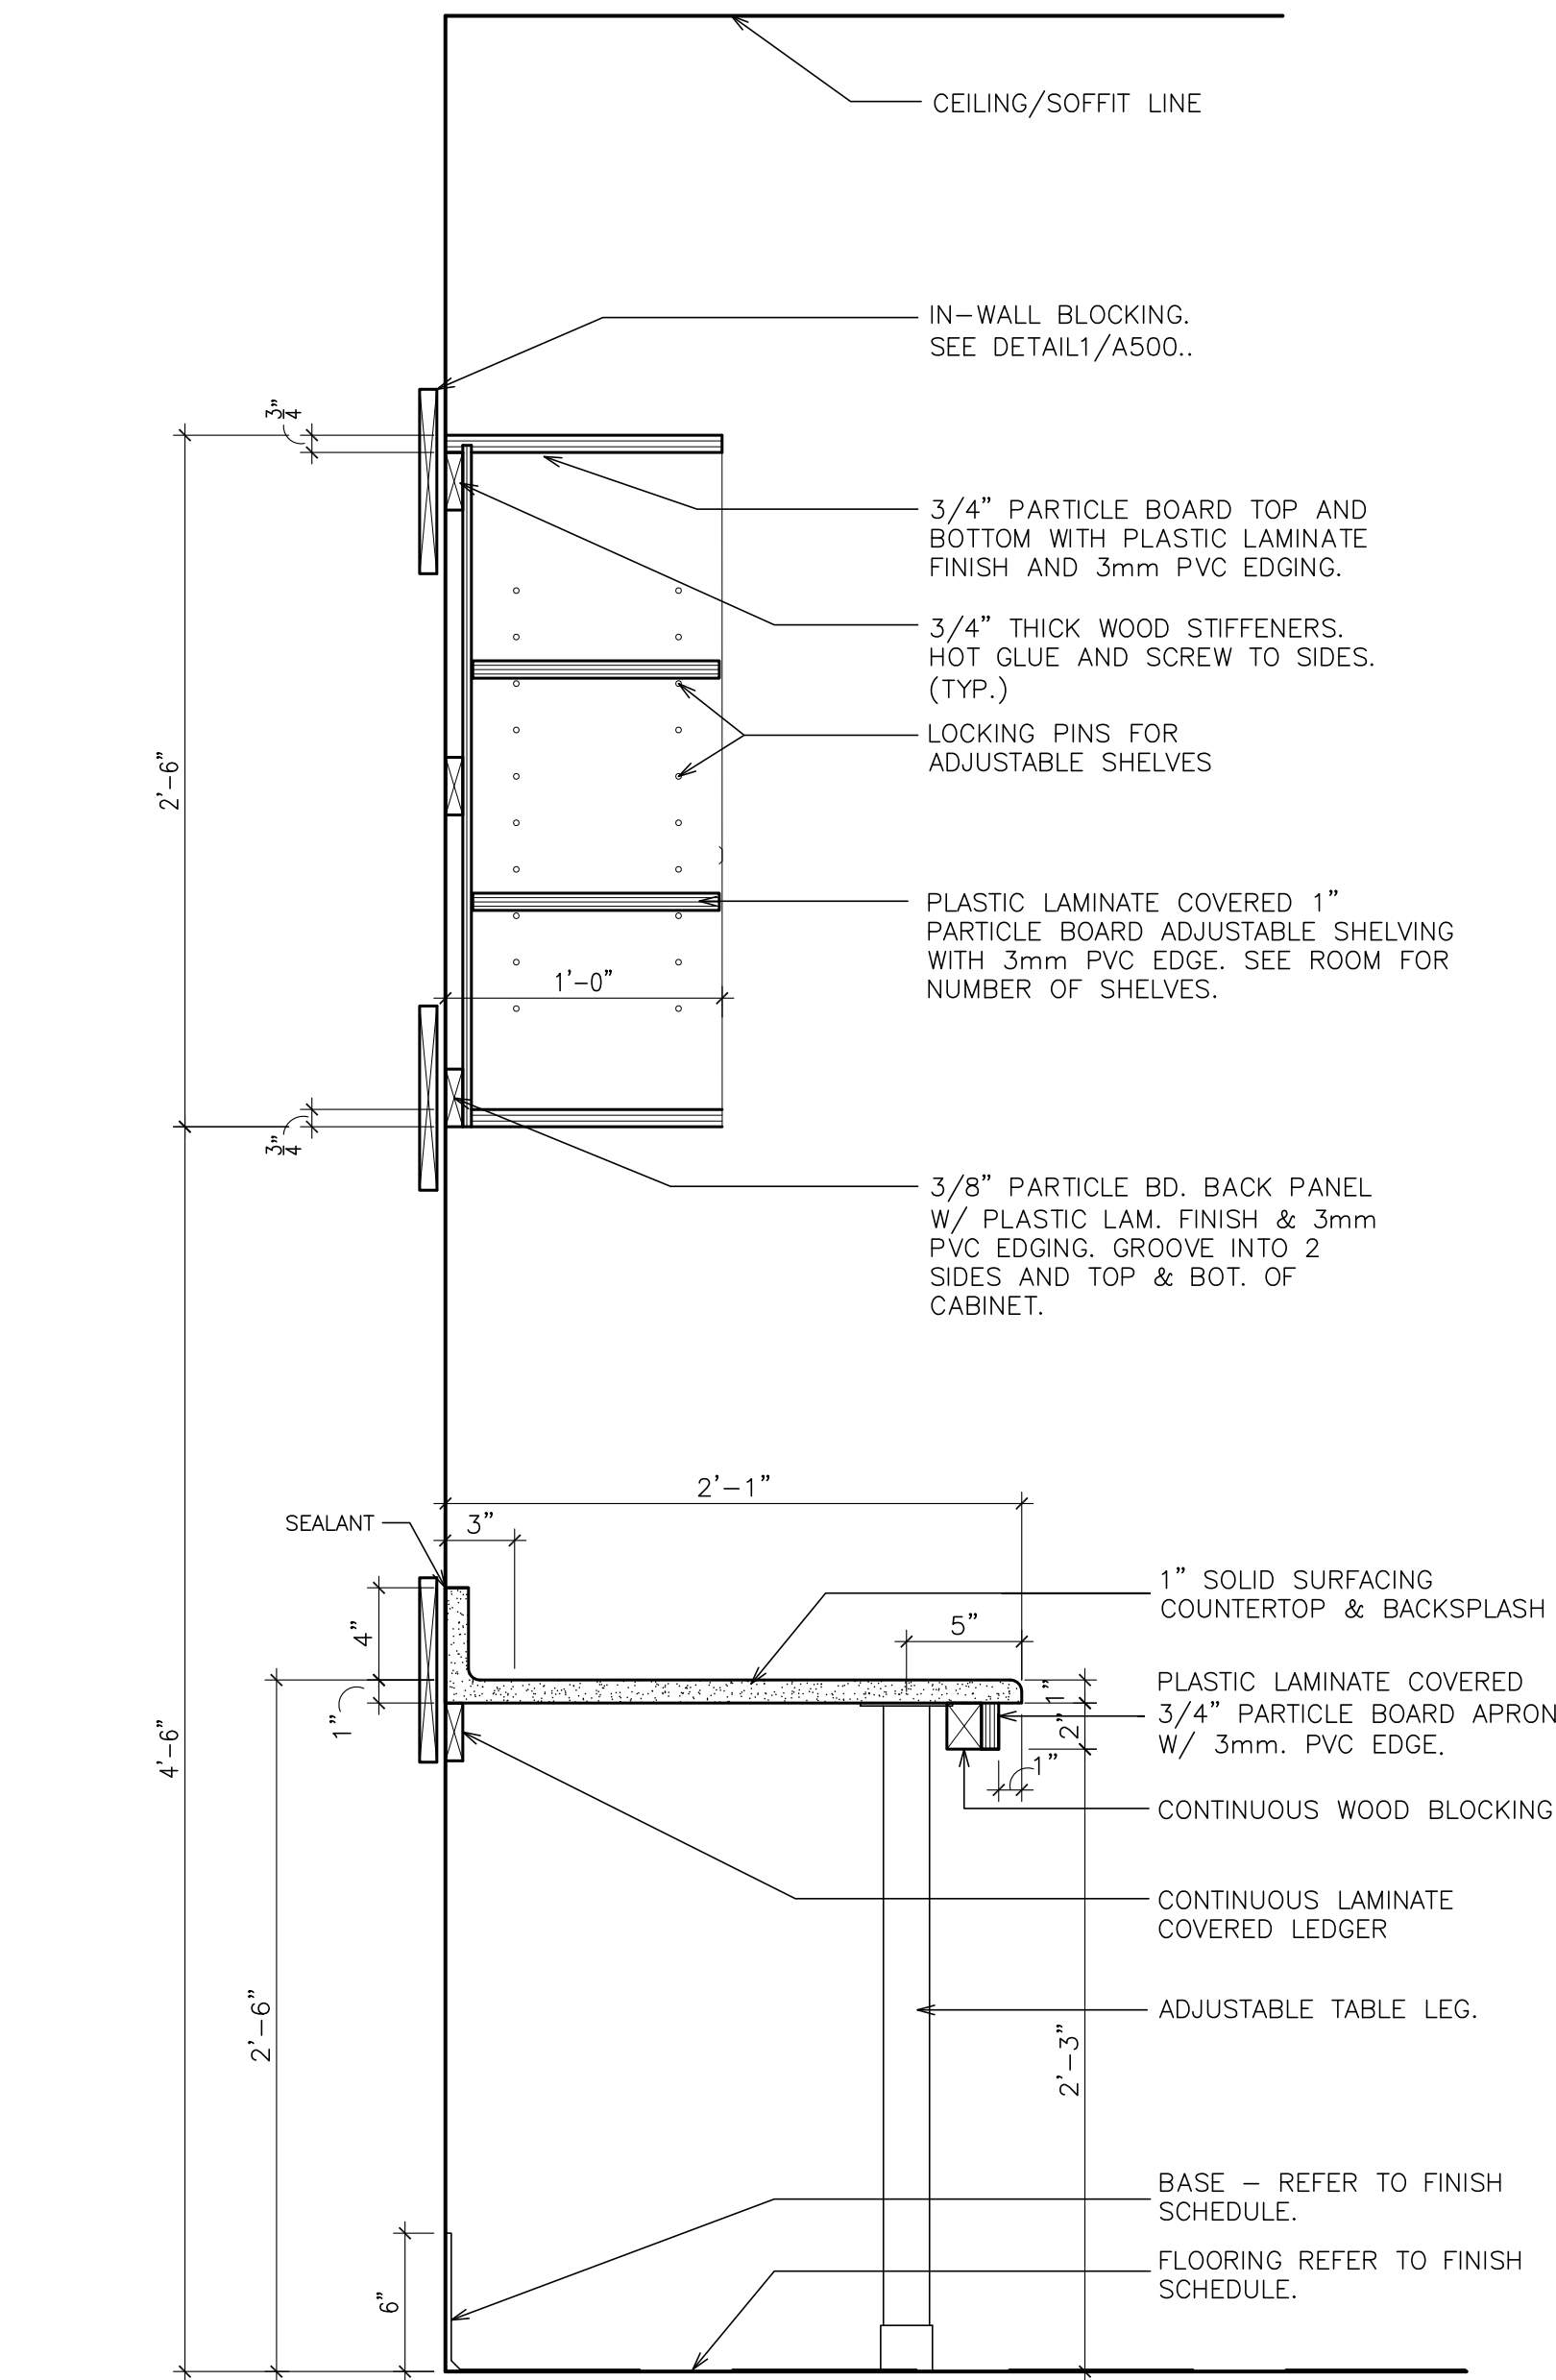

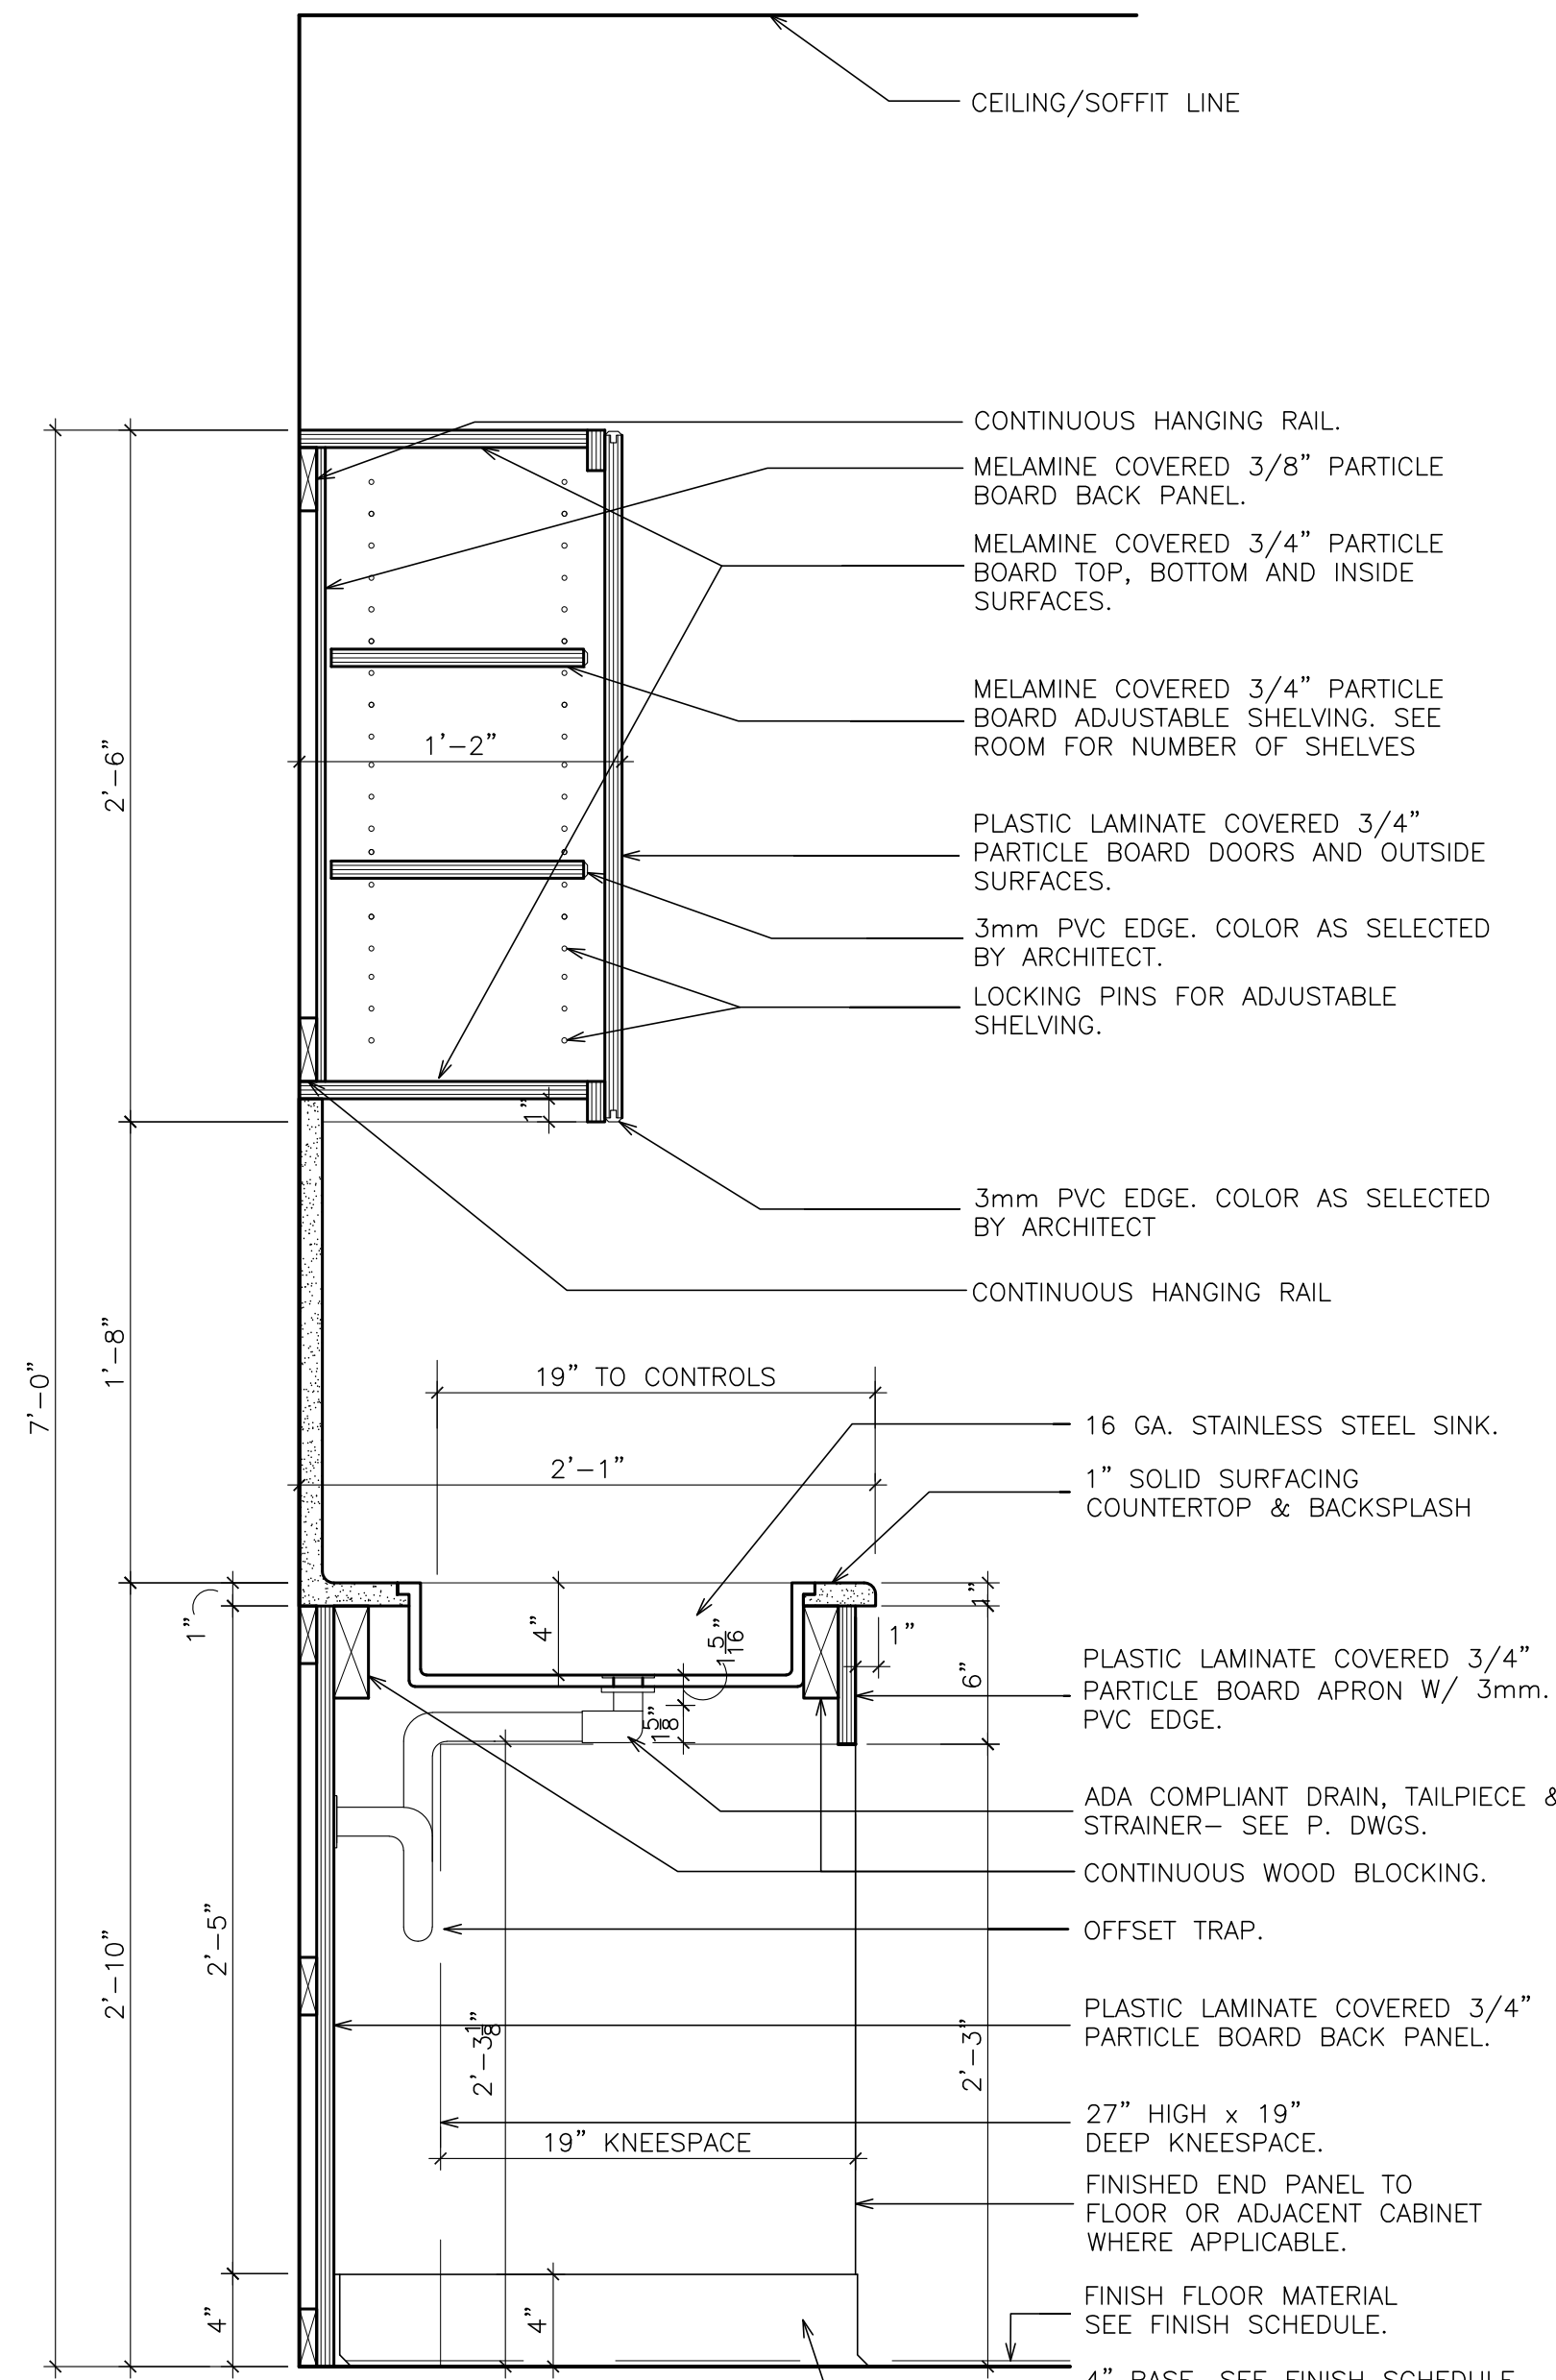③ DETAIL- ADA SINK ENCLOSURE  
SCALE: 1 1/2" = 1'-0"



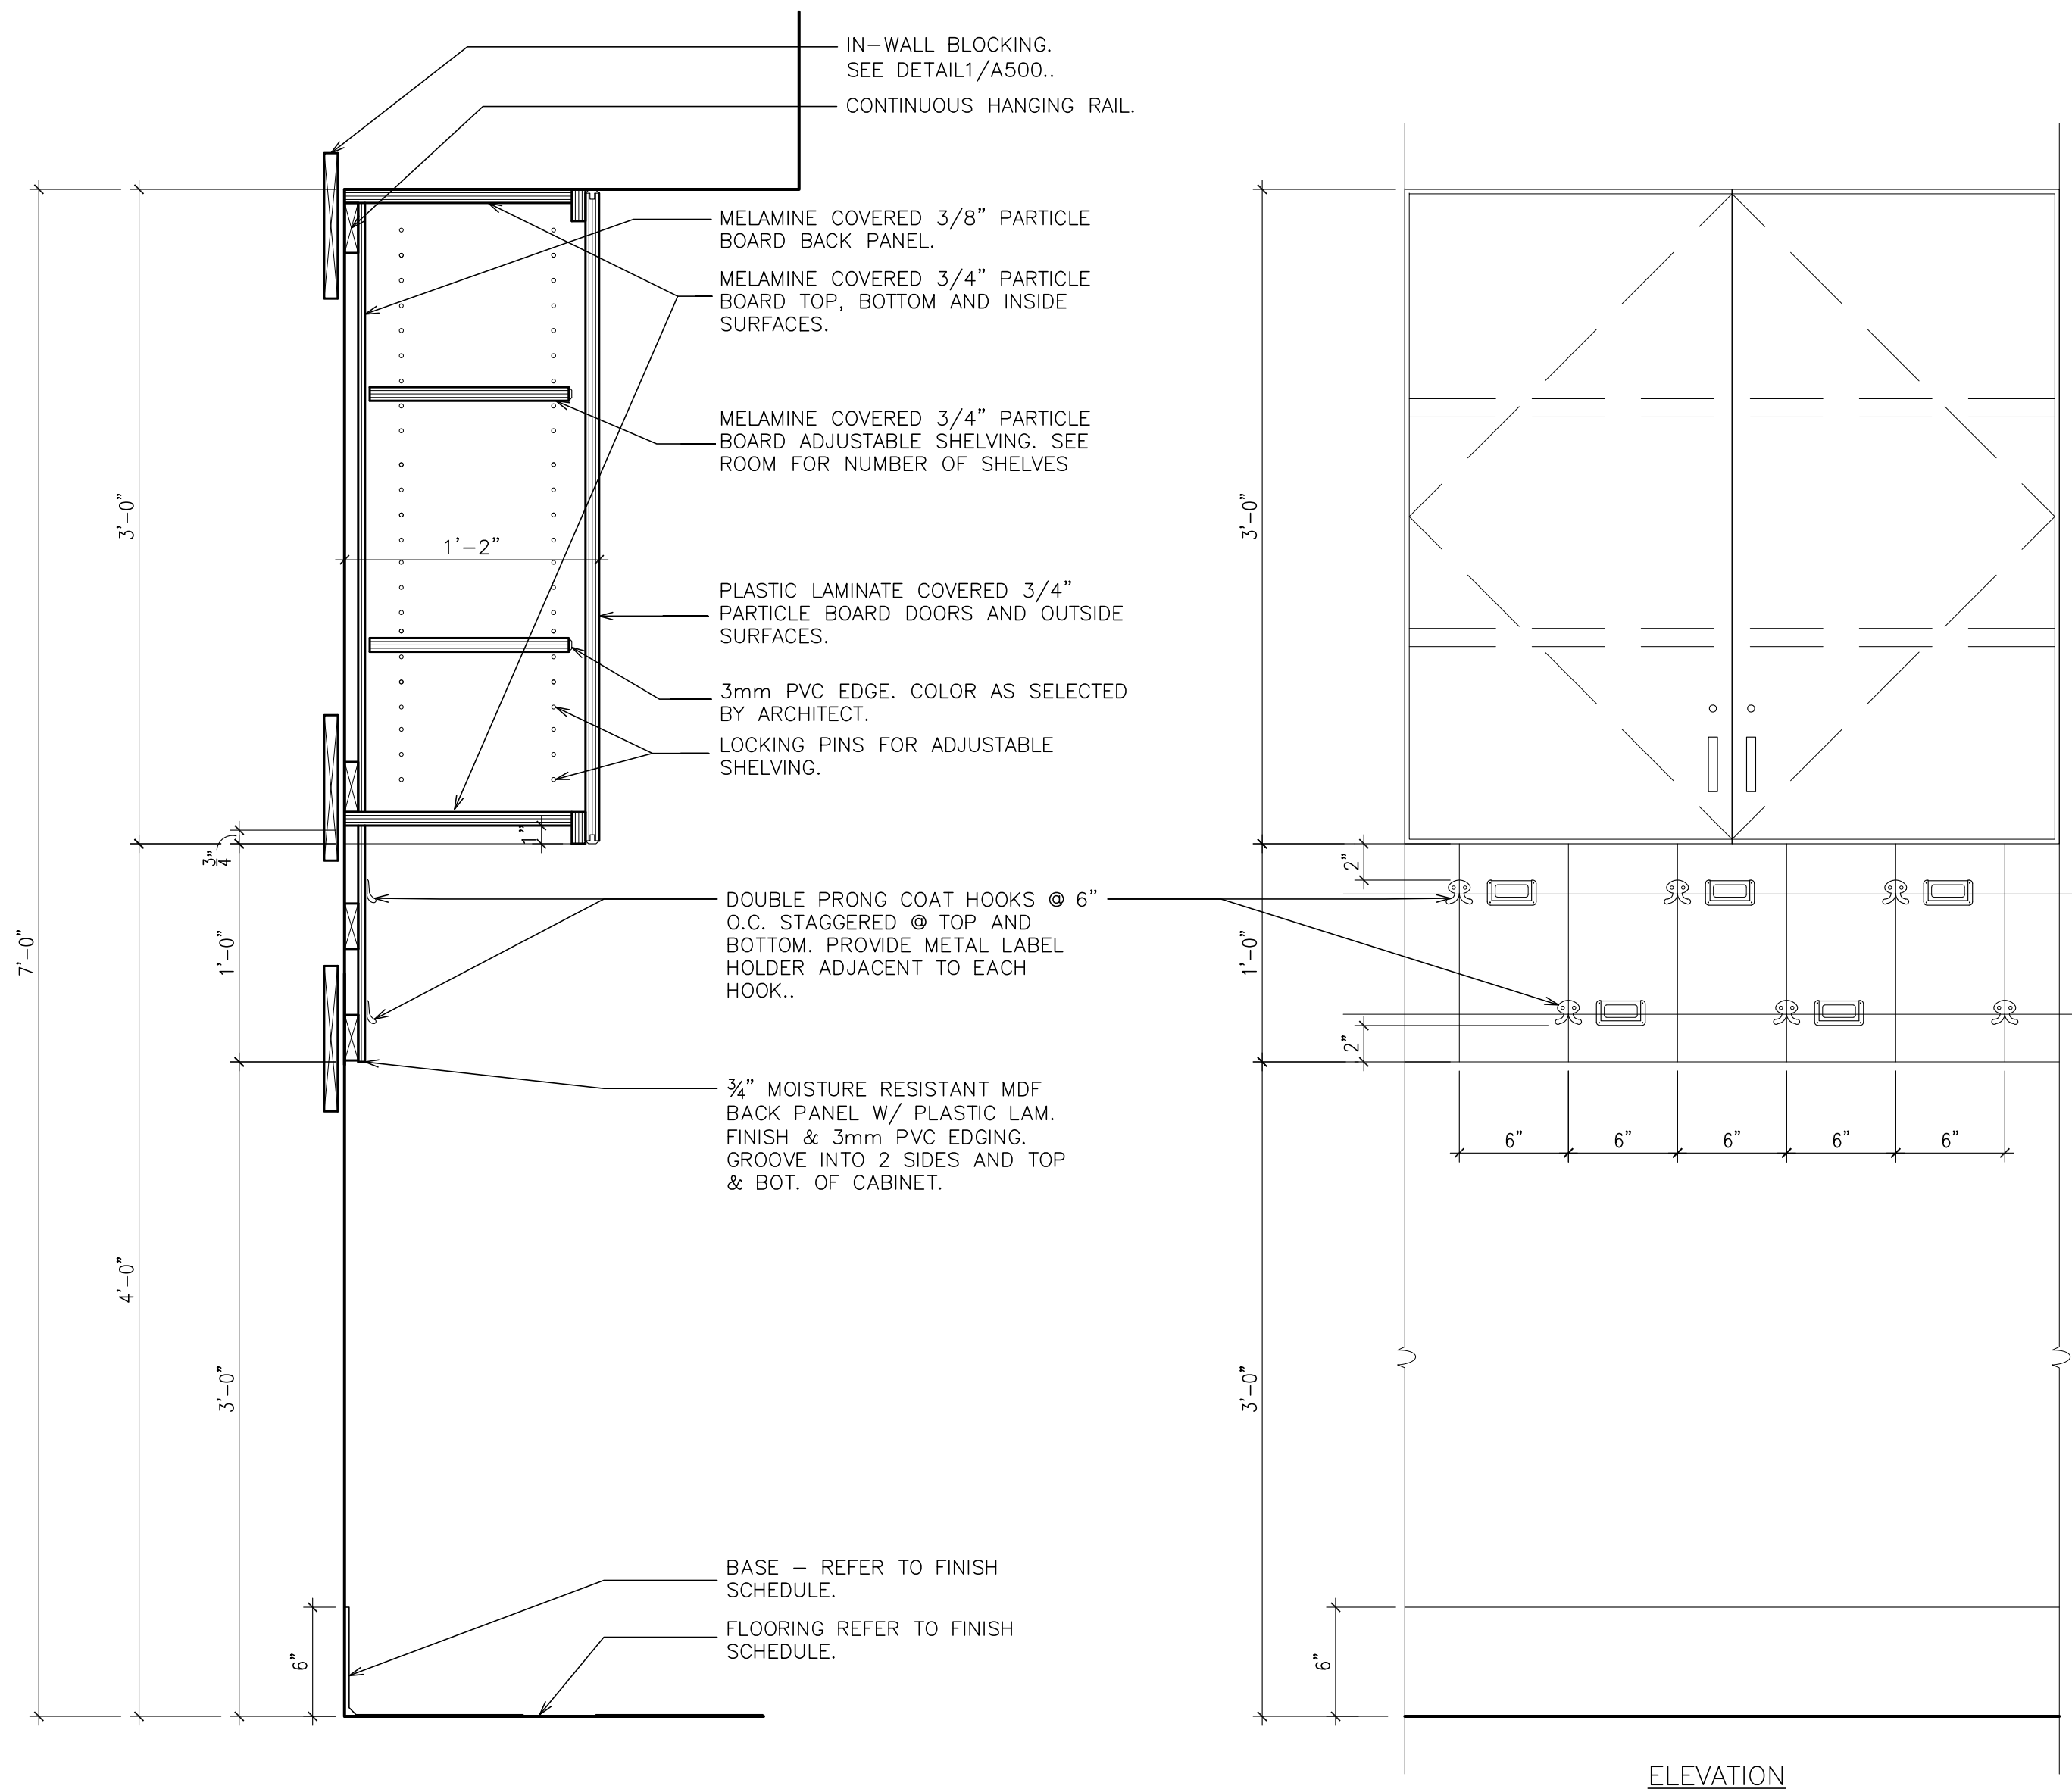① DETAIL- CABINET & SHELF  
SCALE: 1 1/2" = 1'-0"

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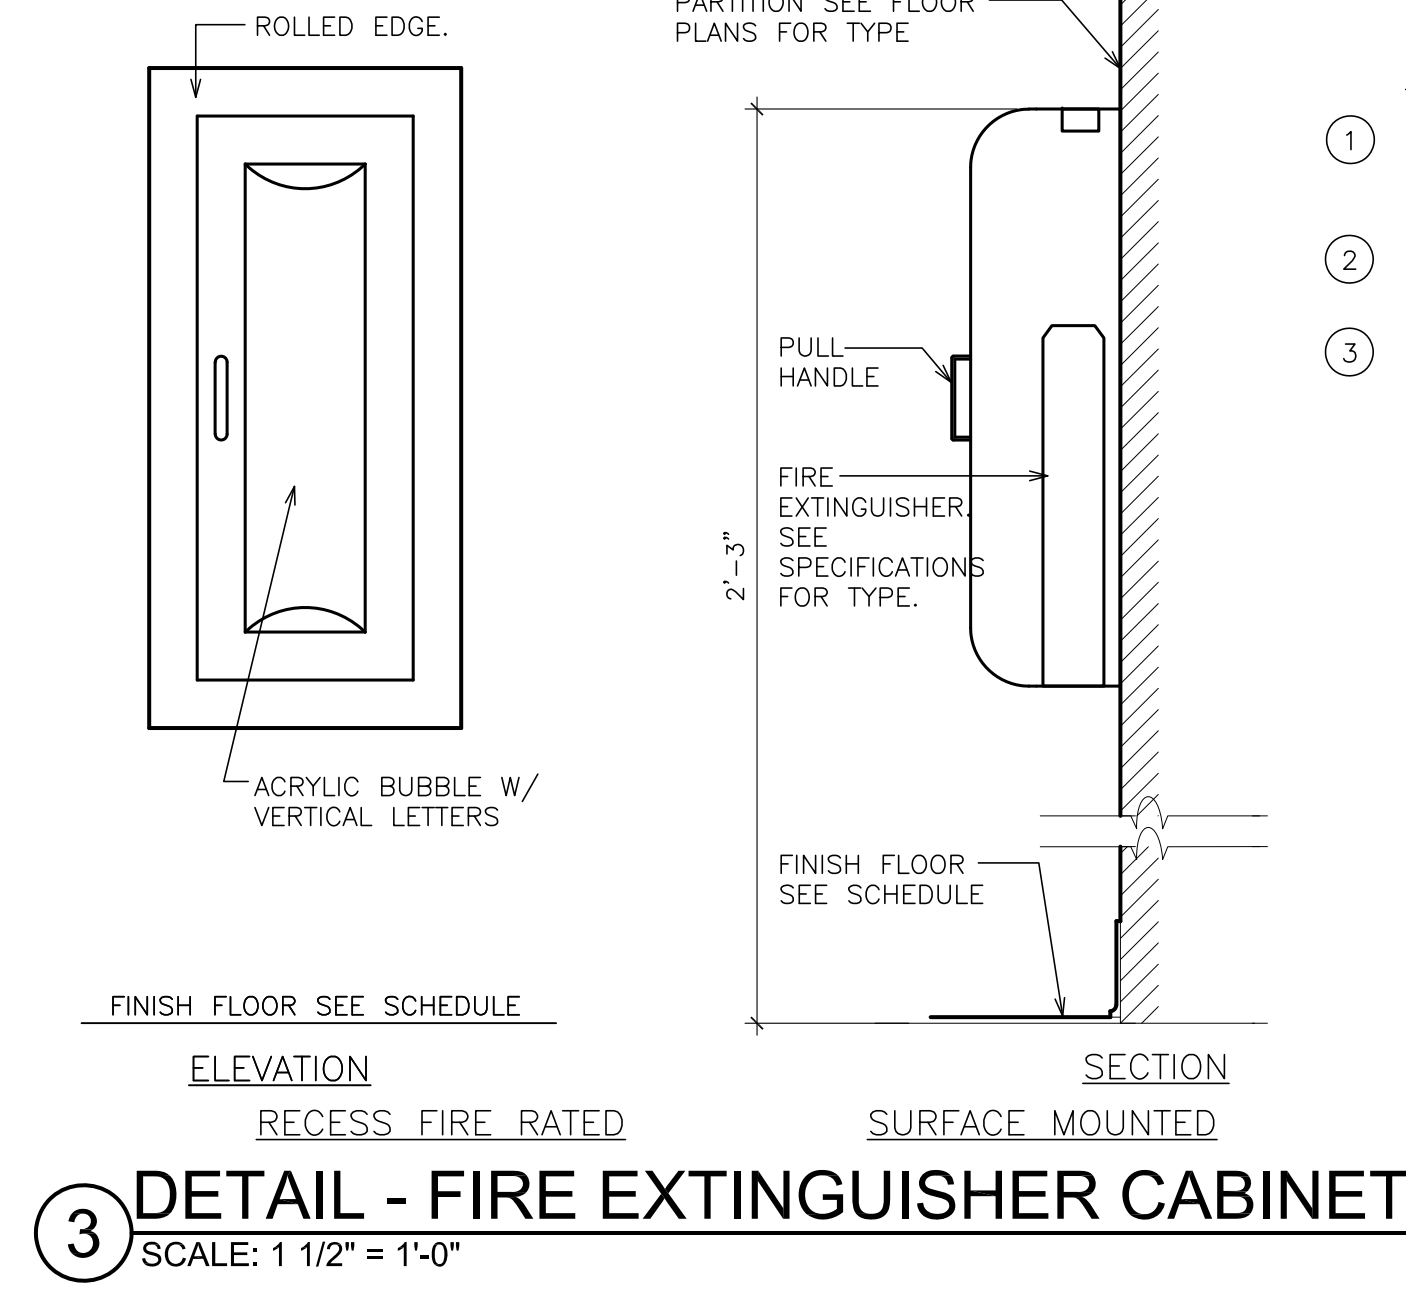
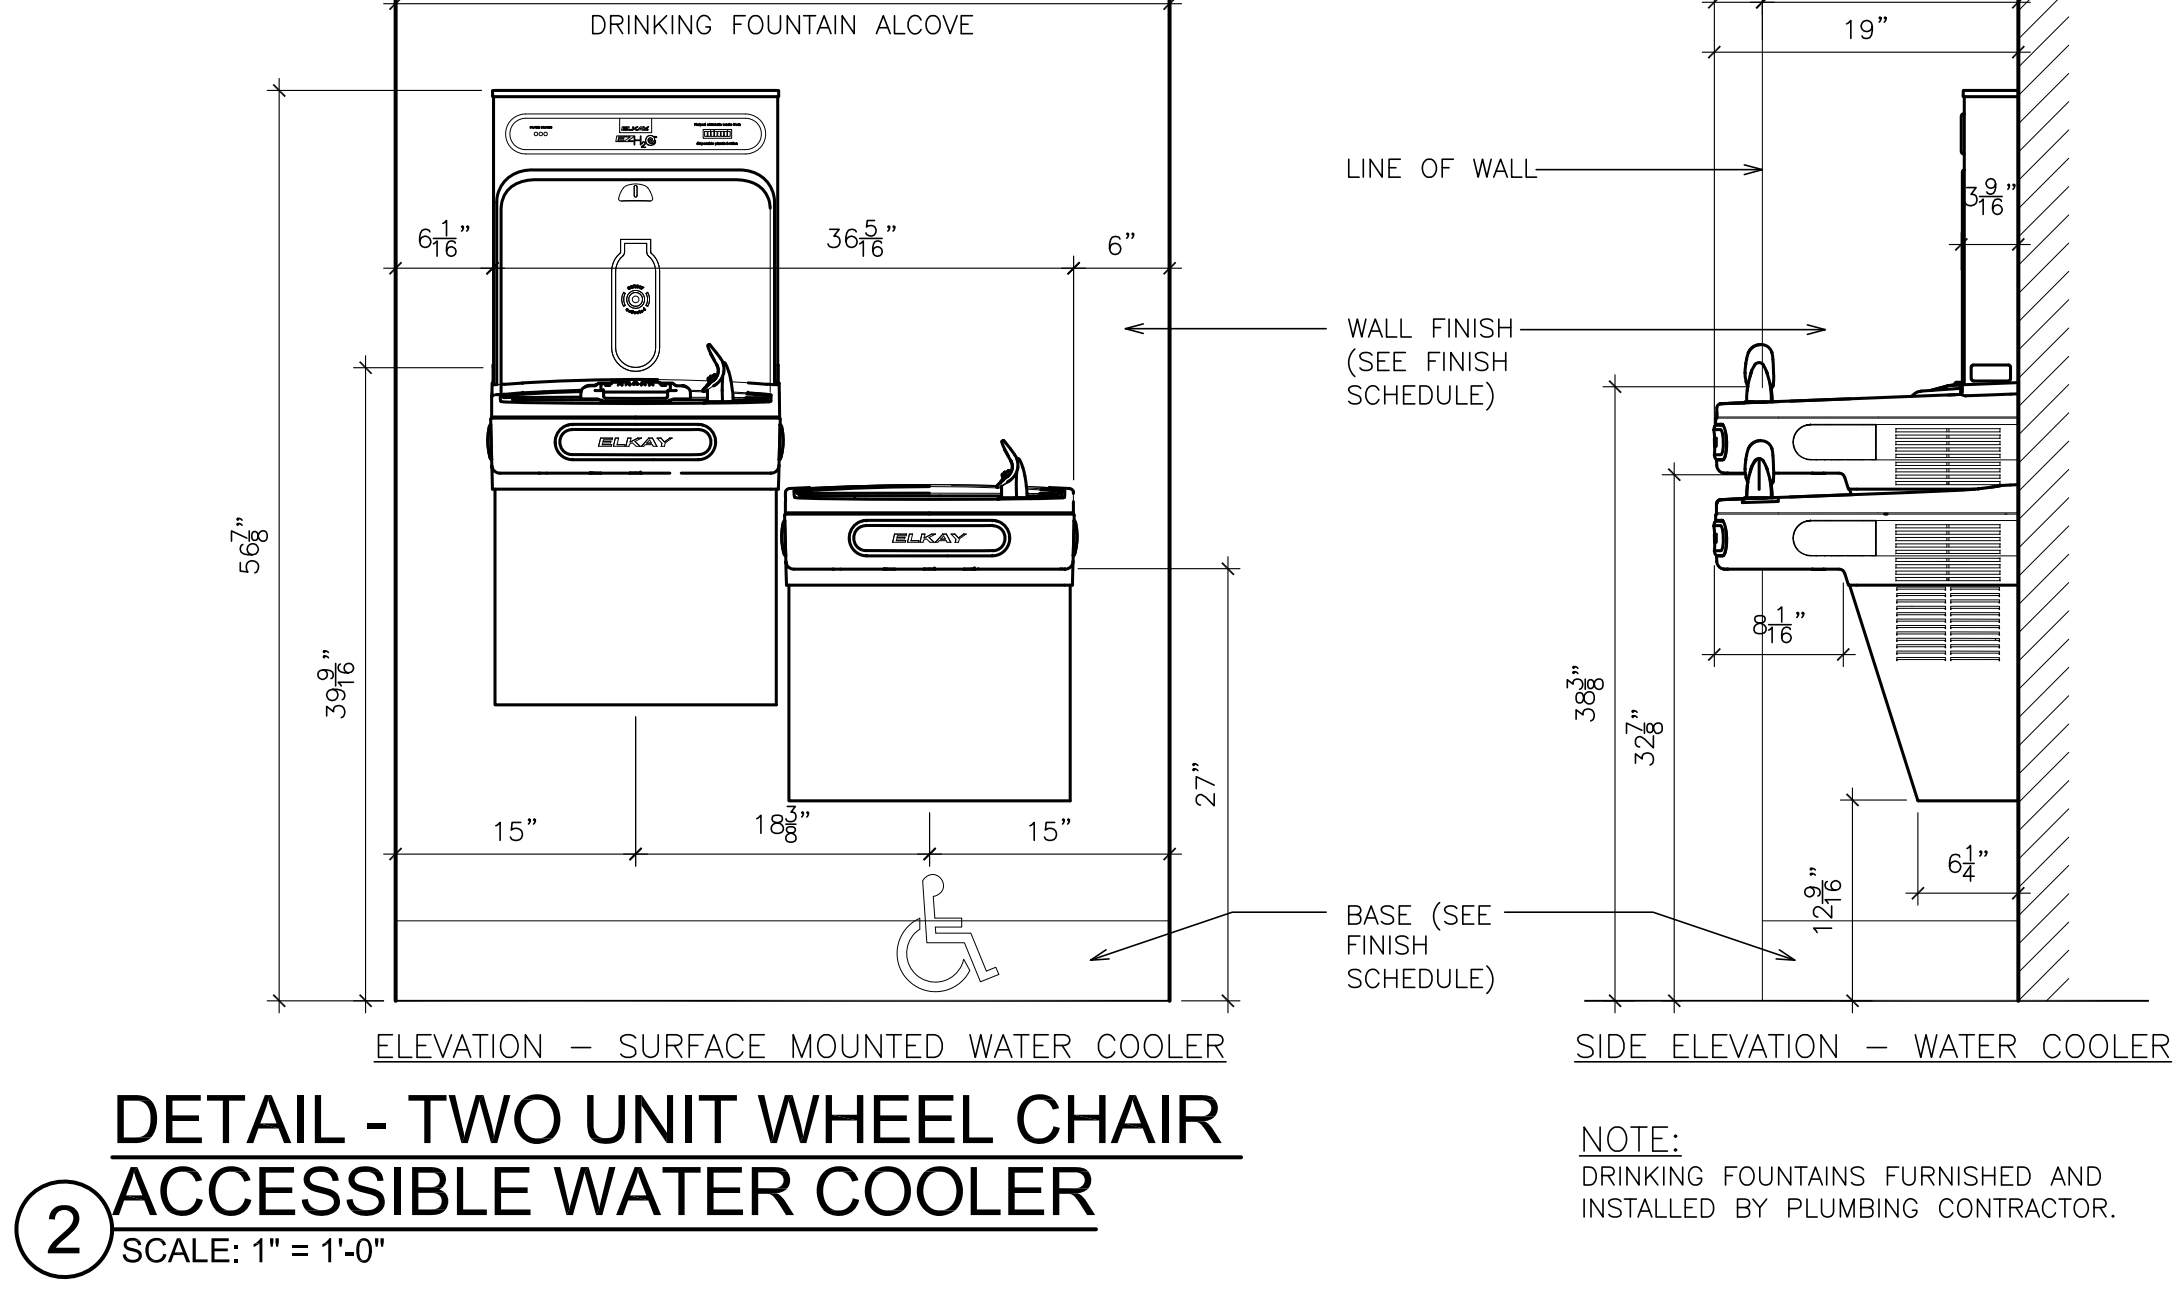
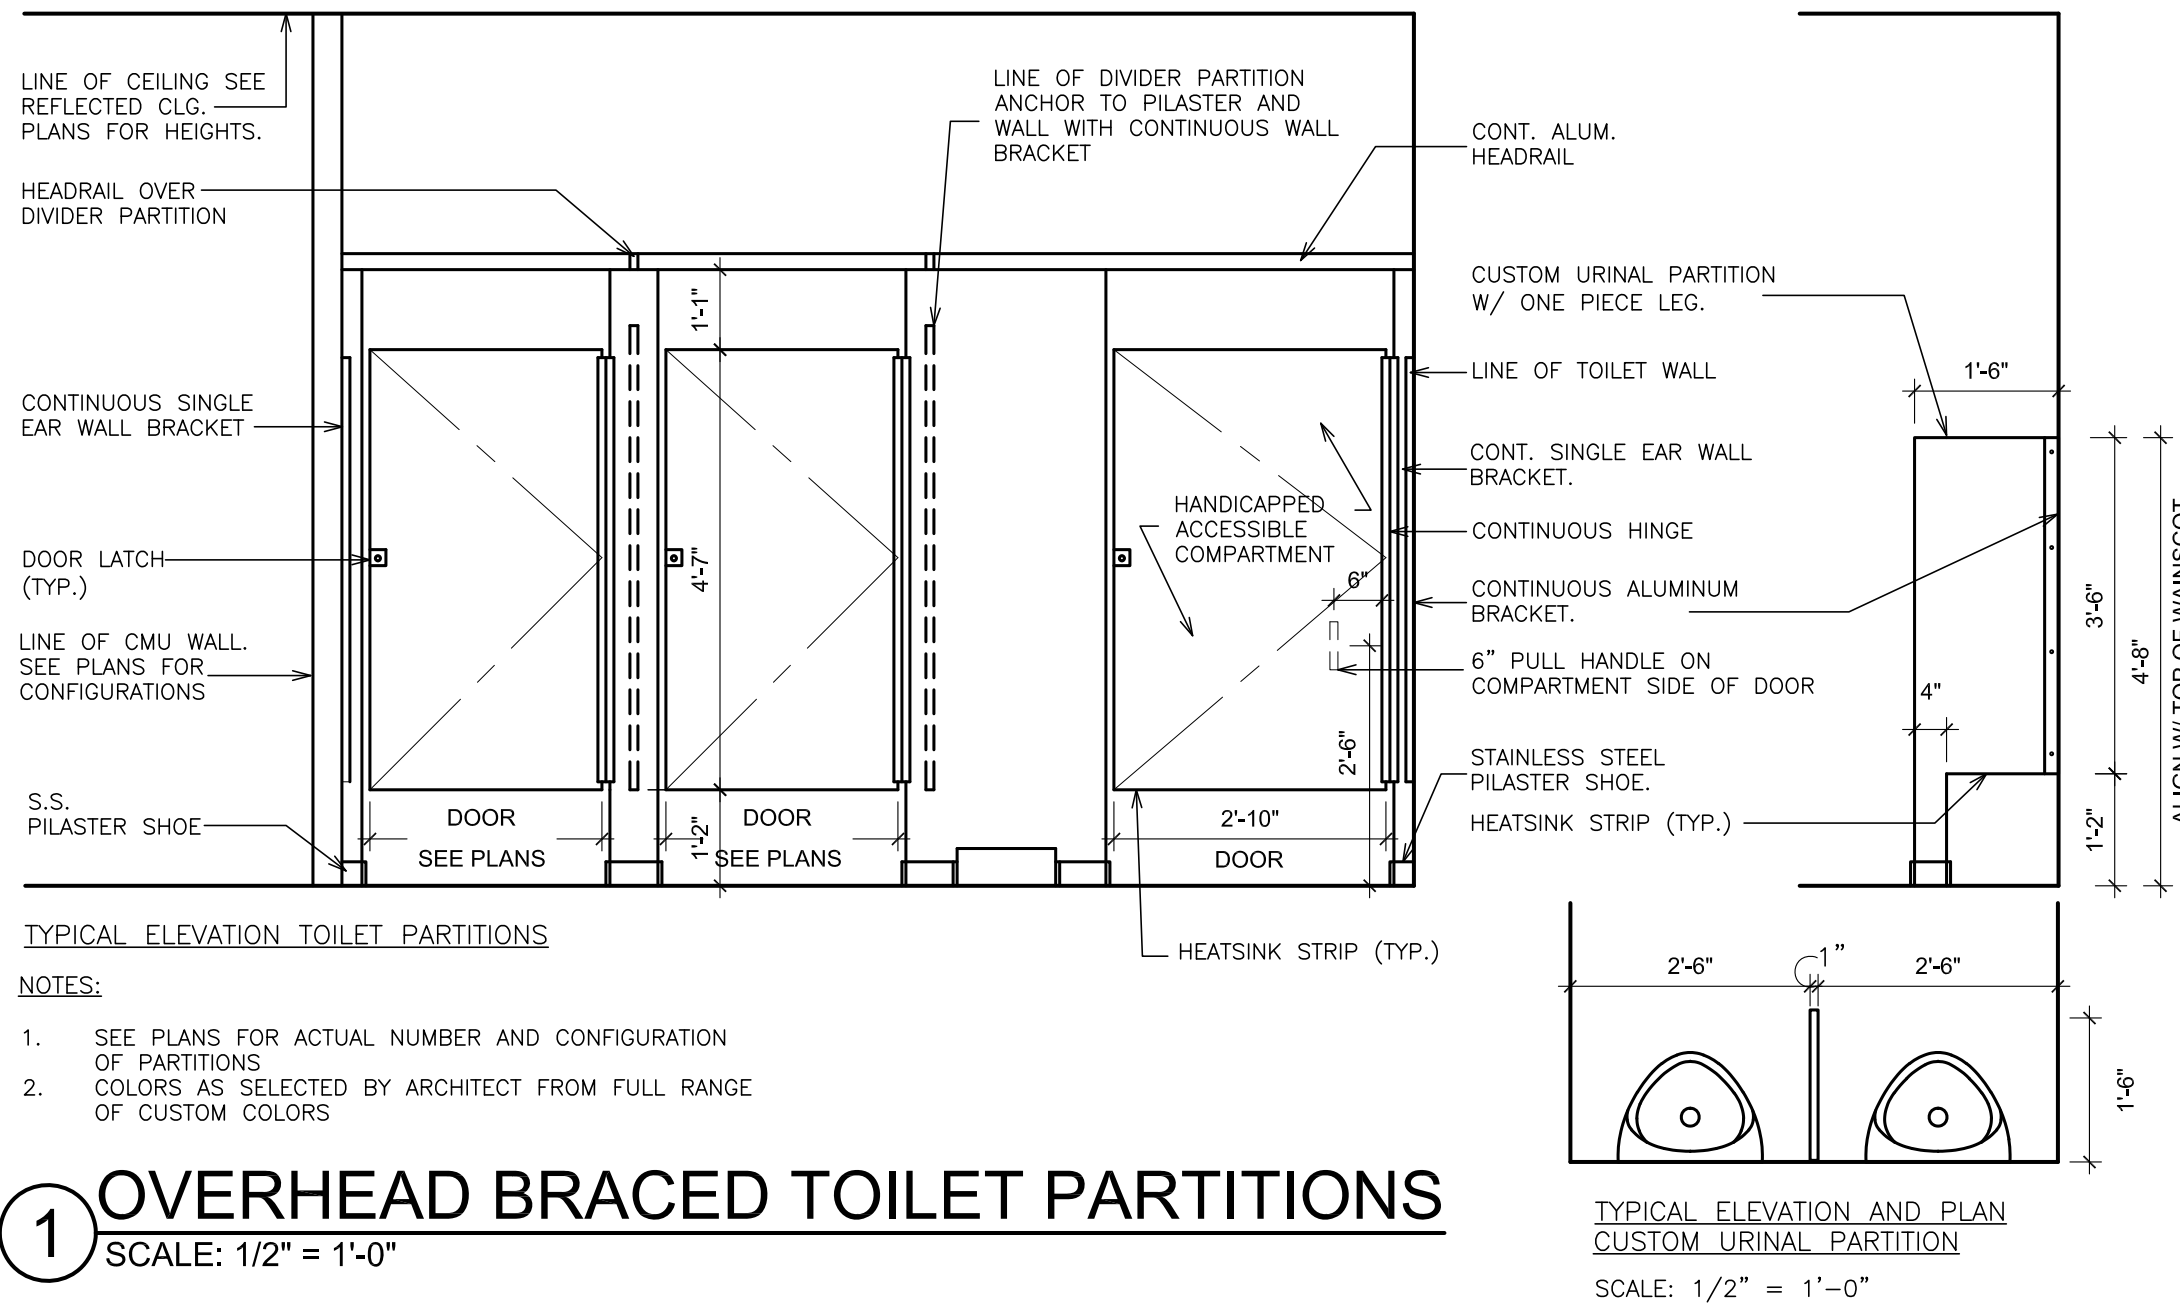
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PROJECT: 21444.01  
PORT CHESTER-RYE UNION FREE SCHOOL DISTRICT  
JOHN F. KENNEDY ELEMENTARY SCHOOL  
FLOOD REPAIRS & RELATED WORK  
40 DAVENIA STREET PORT CHESTER NY 10573




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CASEWORK DETAILS

10-18-2021	B I D
DATE	ISSUED TO
SHEET SIZE 30"x42"	DRAWING NO. A525
DRAWN BY F & D	CHECKED BY F & D
FILE NO. 21444.01	





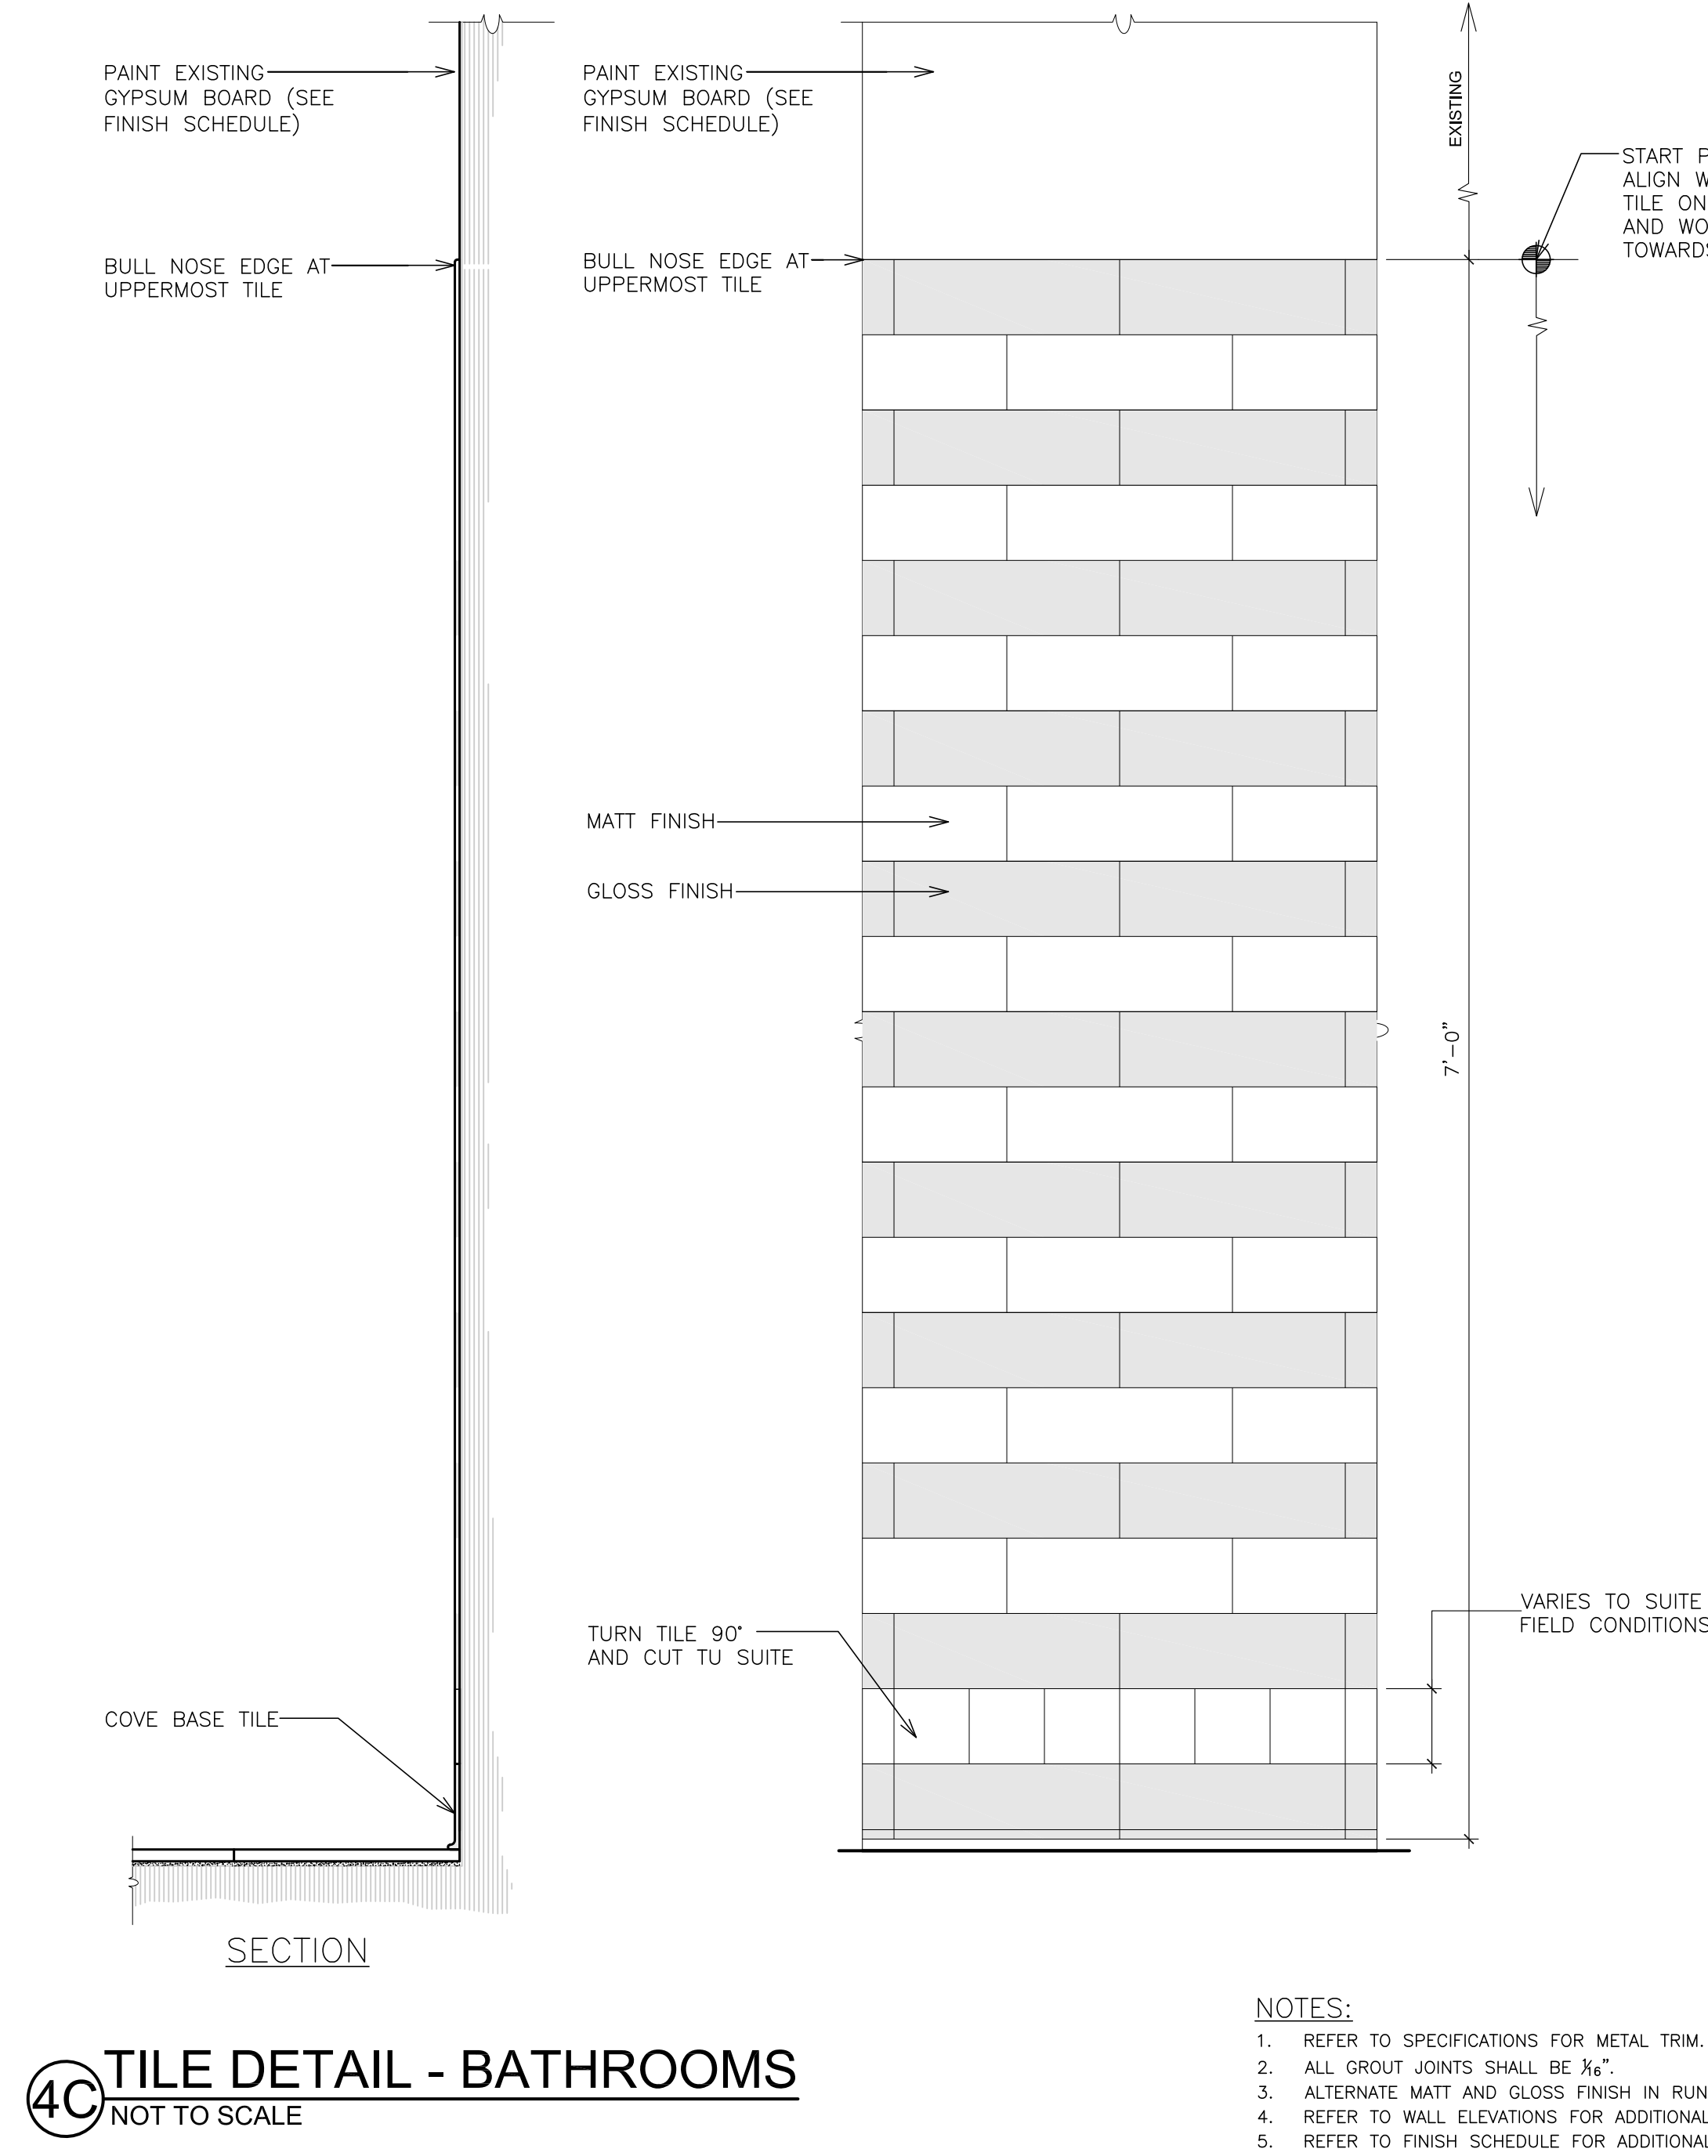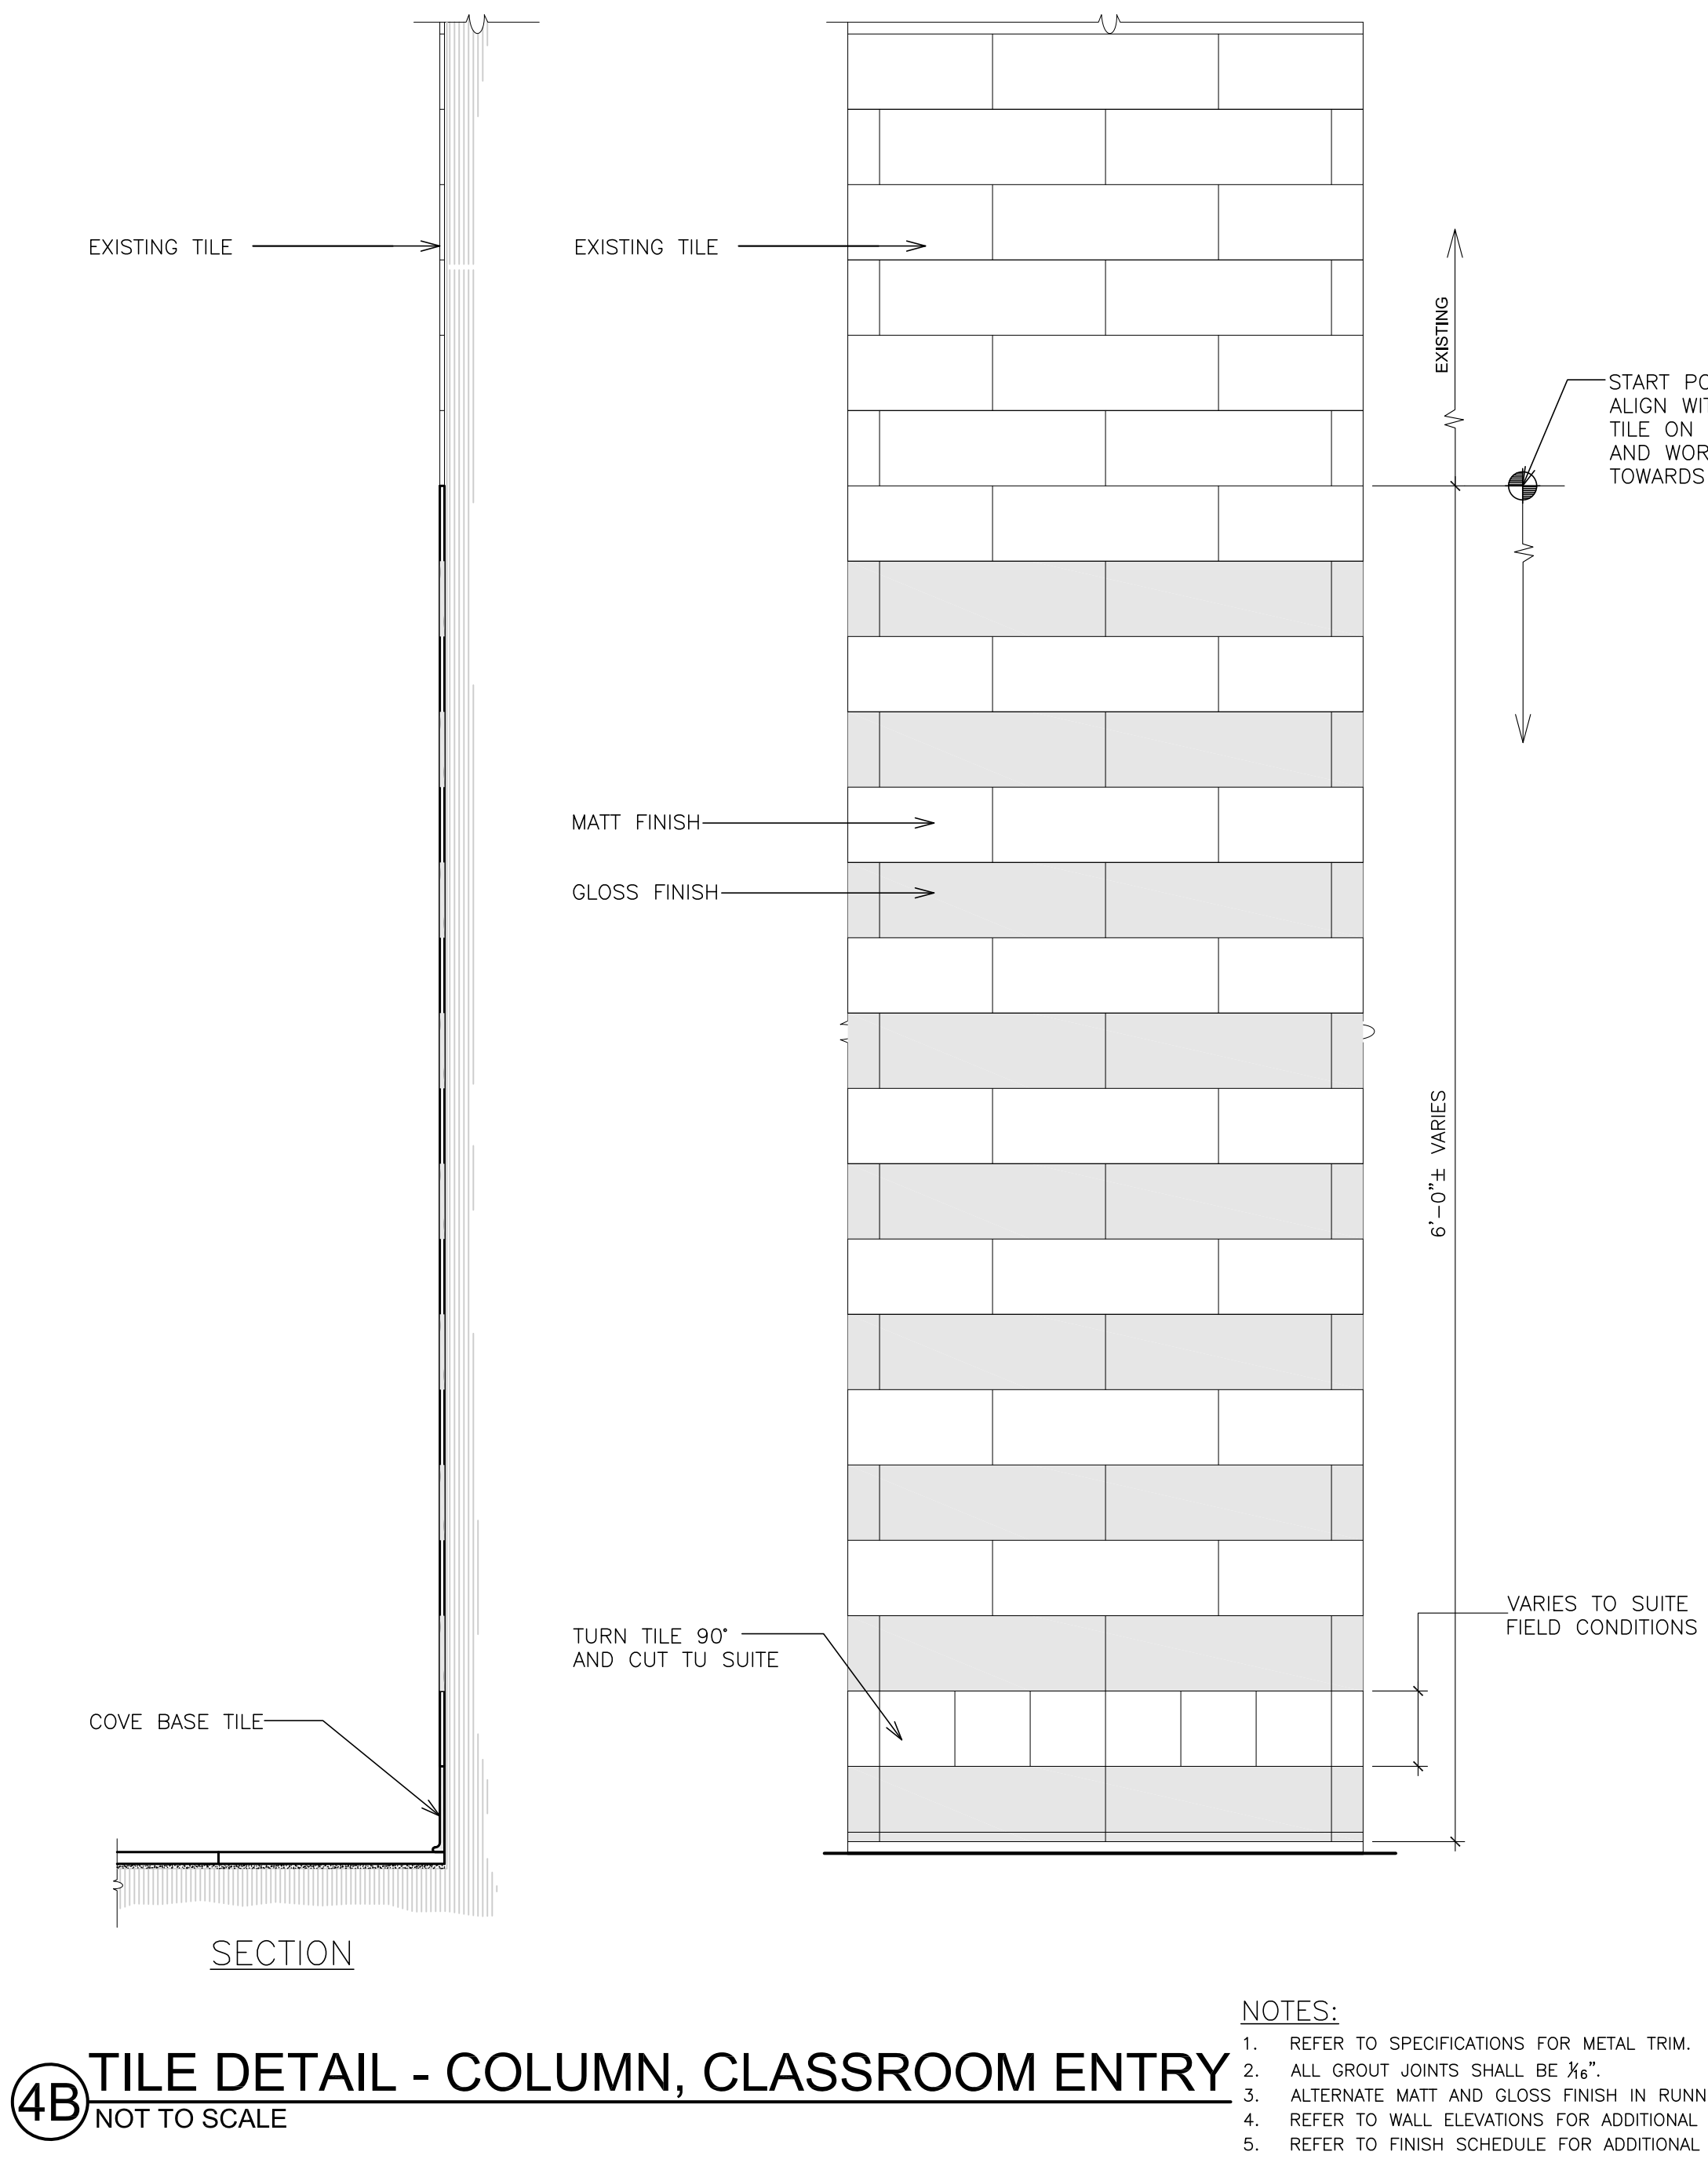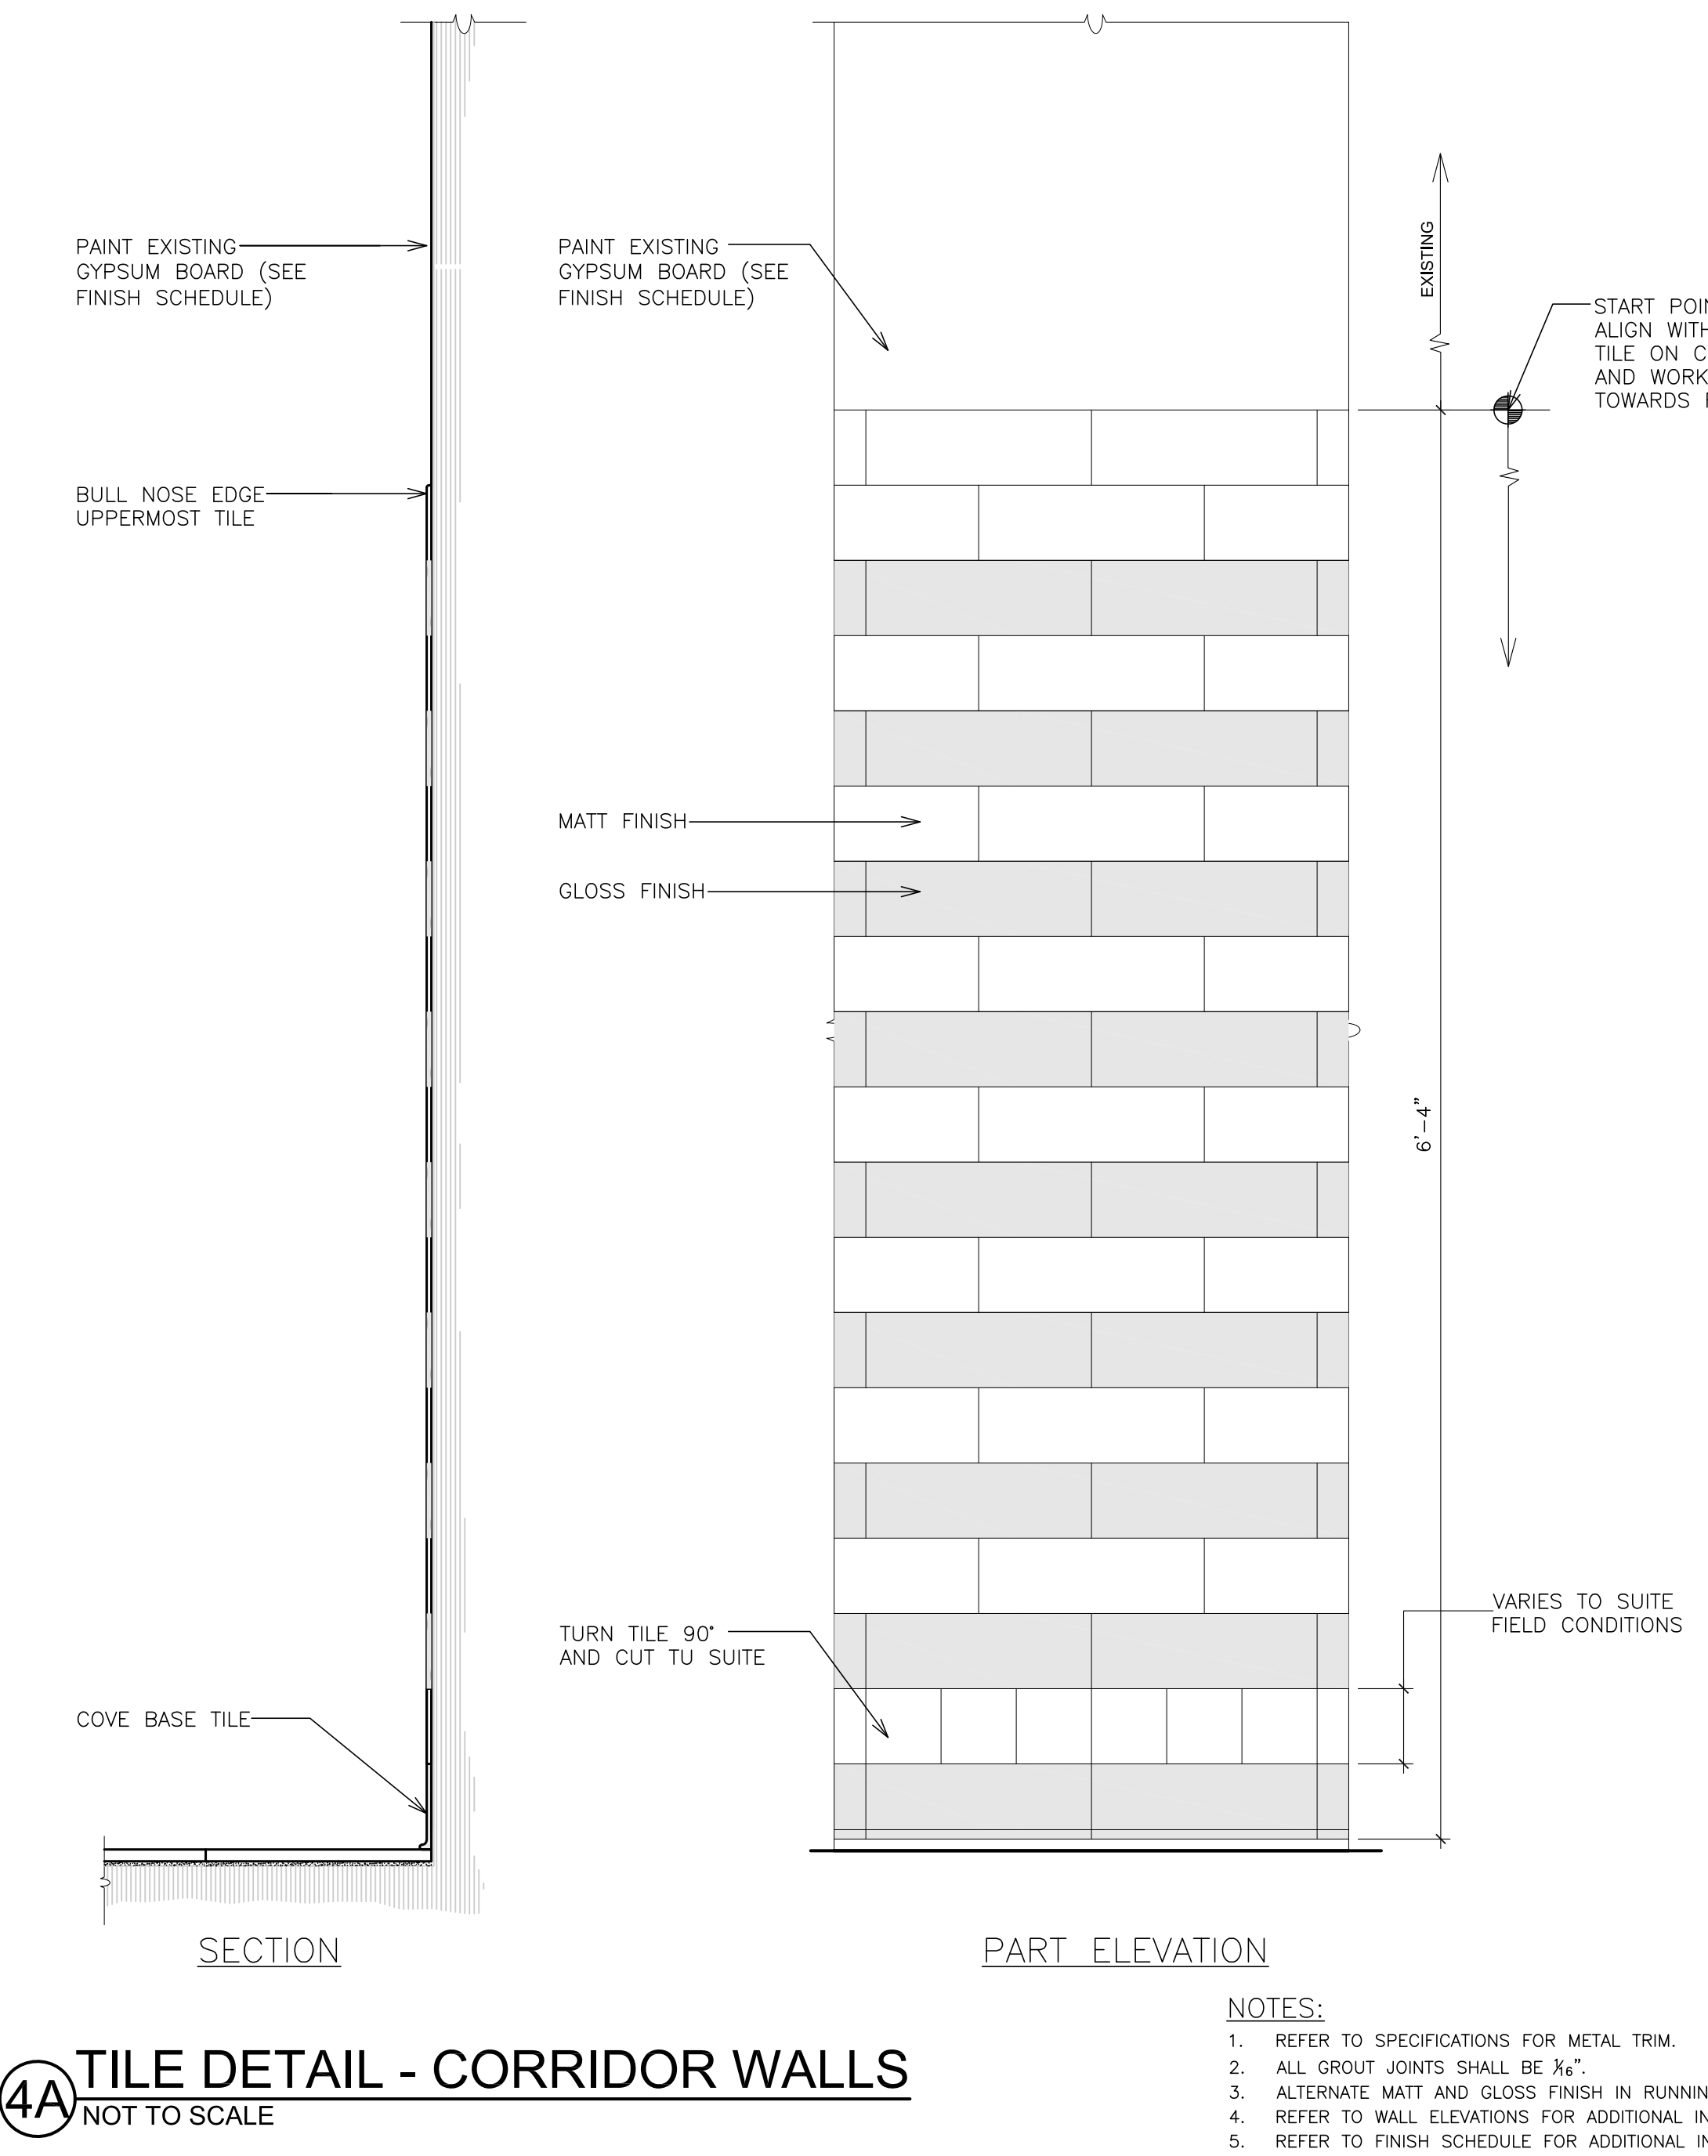- NOTES:
1. CABINET TO BE FABRICATED IN ACCORDANCE WITH UBC 43-6 (ASTM E814-88) TO MEASURE FIRE RESISTIVE PERFORMANCE.
  2. MOUNTING SHALL COMPLY WITH ADA WALL PROJECTION GUIDELINES.
  3. REFER TO FLOOR PLANS FOR LOCATIONS. PLAN DESIGNATION - F.E.



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4A

TILE DETAIL - CORRIDOR WALLS

NOT TO SCALE

NOTES:  
1. REFER TO SPECIFICATIONS FOR METAL TRIM.  
2. ALL GROUT JOINTS SHALL BE 3/16\"/>

4B

TILE DETAIL - COLUMN, CLASSROOM ENTRY

NOT TO SCALE

NOTES:  
1. REFER TO SPECIFICATIONS FOR METAL TRIM.  
2. ALL GROUT JOINTS SHALL BE 3/16\"/>

4C

TILE DETAIL - BATHROOMS

NOT TO SCALE

NOTES:  
1. REFER TO SPECIFICATIONS FOR METAL TRIM.  
2. ALL GROUT JOINTS SHALL BE 3/16\"/>

PROJECT  
PORT CHESTER-RYE UNION FREE SCHOOL DISTRICT  
JOHN F. KENNEDY ELEMENTARY SCHOOL  
FLOOD REPAIRS & RELATED WORK  
40 DAVENIA STREET, PORT CHESTER, NY 10573

MISCELLANEOUS DETAILS

10-18-2021  
DATE

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ISSUED TO

SHEET SIZE  
30"x42"

DRAWING NO.  
A652

DRAWN BY  
F & D

CHECKED BY  
F & D

FILE NO.  
21444.01

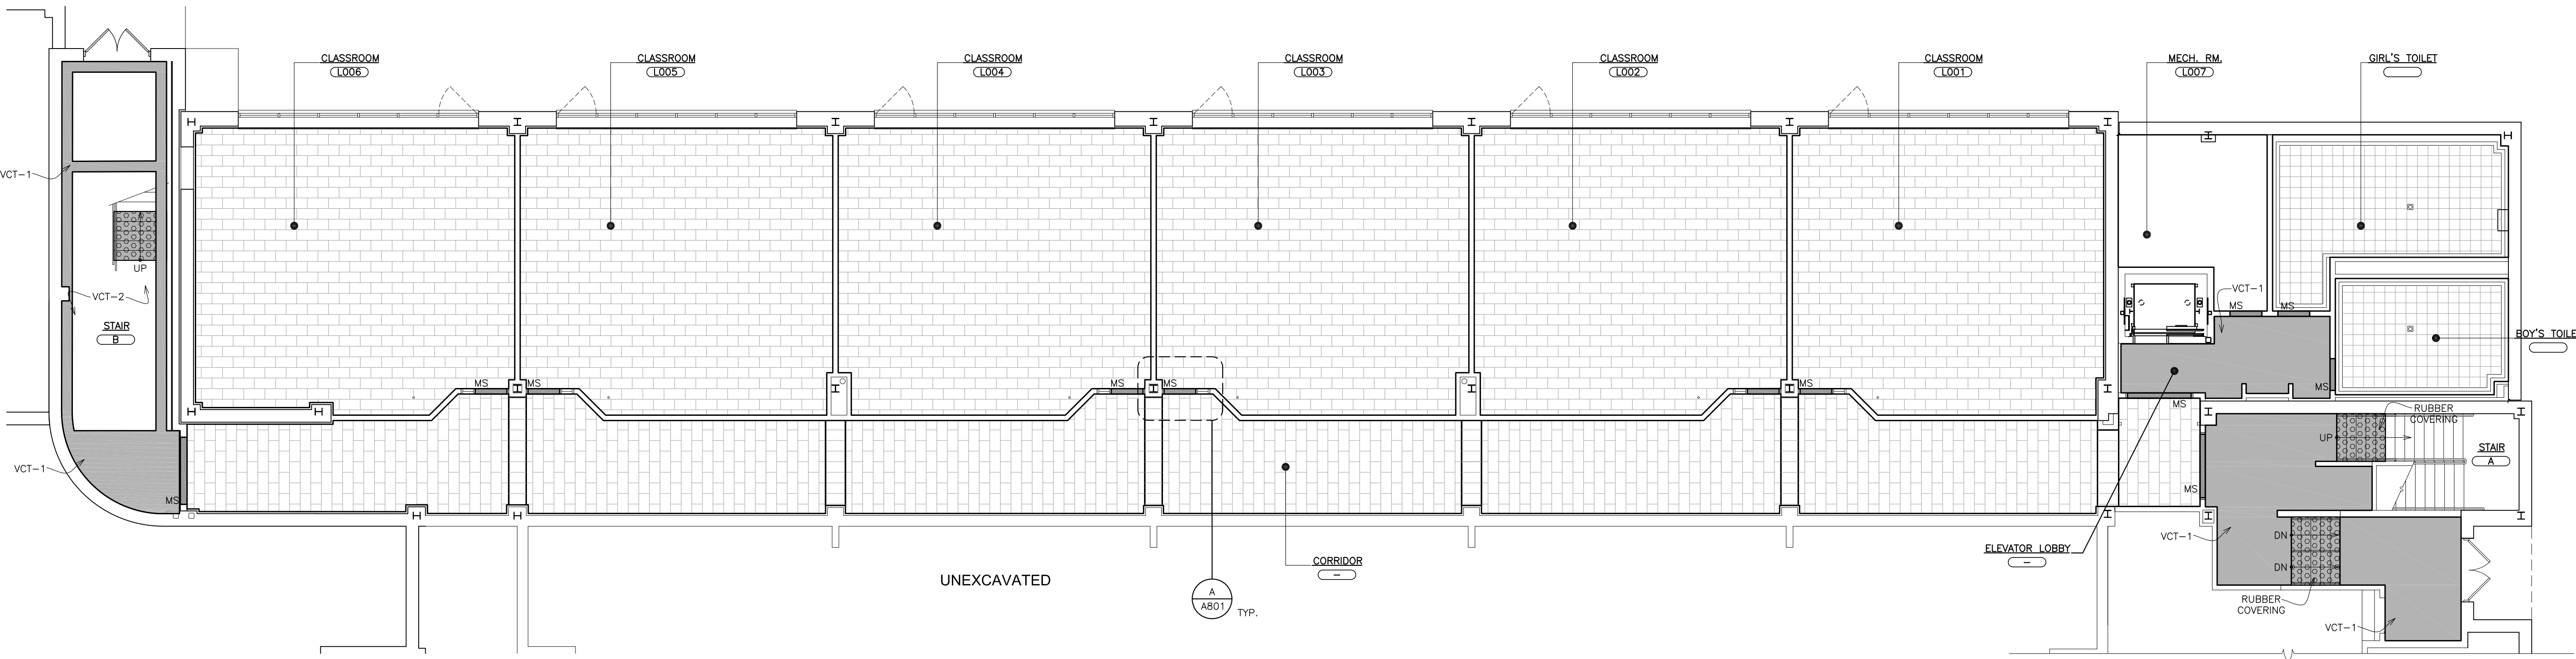
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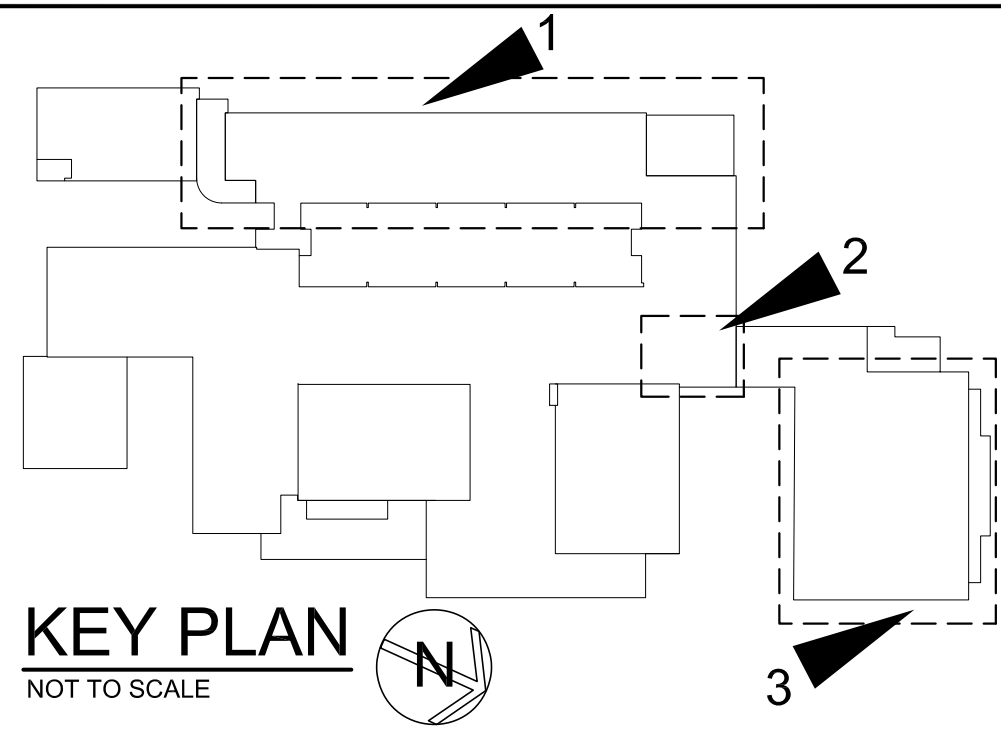










1 FLOOR FINISH PLAN - GROUND FLOOR  
SCALE: 1/8" = 1'-0"



FLOOR FINISH LEGEND	
	12"x12" VINYL ENHANCED TILE FLOORING, ACCENT BAND (COLOR VCT-1)
	12"x12" VINYL ENHANCED TILE FLOORING, FIELD TILE (COLOR VCT-2)
	24" X 12" CERAMIC TILE (FIELD COLOR). SEE FINISH SCHEDULE.
	12" X 12" CERAMIC TILE (FIELD COLOR). SEE FINISH SCHEDULE.
	RUBBER STAIR TREADS. SEE FINISH SCHEDULE / LEGEND.
	CONCRETE (MAINTENANCE GARAGE)
	STONE SADDLE
	WALL INDICATIONS ON FINISH SCHEDULE

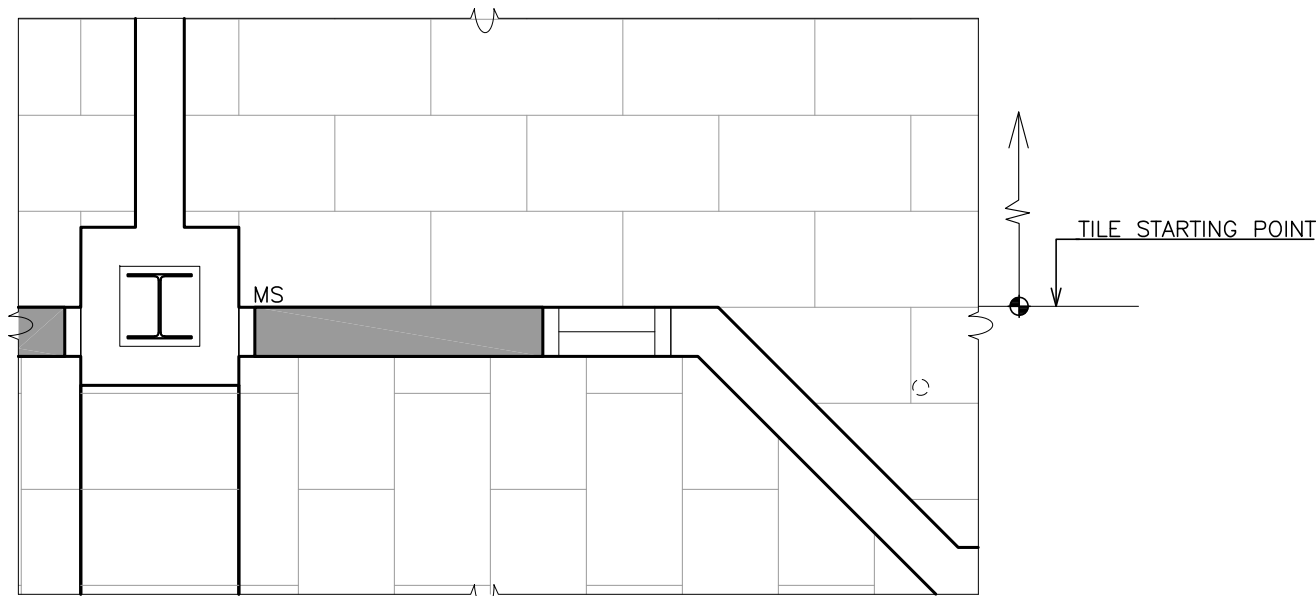

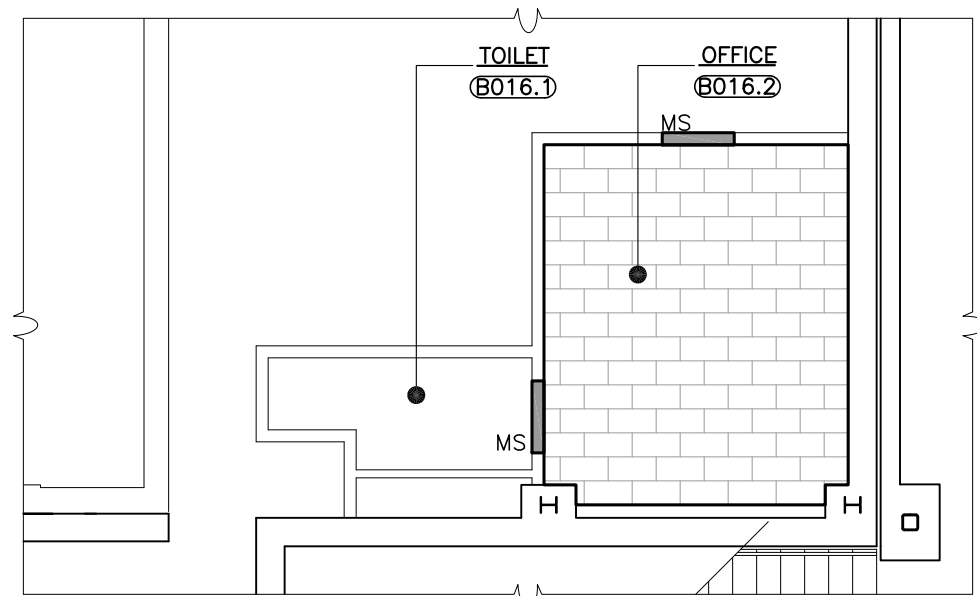A DETAIL - TILE STARTING POINT  
SCALE: 1/2" = 1'-0"



2 FLOOR FINISH PLAN  
SCALE: 1/8" = 1'-0"

FINISH SCHEDULE														 WALL INDICATIONS ON PLAN				
BLDG.	AREA	LINE	DESIGNATION	RM. No.	FLOOR	BASE (MAT.)	WALL 1	WALL 2	WALL 3	WALL 4	CLG.	TRIM		CASEWORK			REMARKS	
												DOORS	DOOR FRAMES	CABINETS	COUNTER TOPS	EDGE		
JFK ELEMENTARY SCHOOL	GROUND FLOOR	01	NOT USED	—	VCT-1	RB-1	CT-1	CT-1	CT-1	CT-1	ACT-1	—	P-5	—	—	—	(3) (6) (8)	
		02	ELEVATOR LOBBY	B003A	CT-3	RB-1	P-1	P-1	P-1	P-1	ACT-2	—	—	—	—	—	(1) (9)	
		04	STAFF	B003B	CT-3	RB-1	P-1	P-1	P-1	P-1	ACT-2	—	—	PL-1	COT-1	EG-1	(1) (9)	
		05	OFFICE	B004A	CT-3	RB-1	P-1	P-1	P-1	P-1	ACT-2	—	—	—	—	—	(1) (9)	
		06	OFFICE	B004B	CT-3	RB-1	P-1	P-1	P-1	P-1	ACT-2	—	—	—	—	—	(1) (9)	
		07	BOY'S TOILET	—	CT-3	CT-2	CT-1	CT-1	CT-1	CT-1	ACT-1	—	P-5	—	—	—	(1) (3) (6) (8) (9)	
		08	GIRL'S TOILET	—	CT-3	CT-2	CT-1	CT-1	CT-1	CT-1	ACT-1	—	P-5	—	—	—	(1) (3) (6) (8) (9)	
		09	MECHANICAL ROOM	L007	P-8	RB-1	—	—	—	—	—	—	P-5	—	—	—	—	(1) (3) (6) (8) (9)
		10	CLASSROOM	L001	CT-3	RB-1	P-1	P-1	P-1	P-1	P-4	ACT-1/ P-2	—	P-5	PL-1	COT-1	EG-1	(1) (2) (9)
		11	CLASSROOM	L002	CT-3	RB-1	P-1	P-1	P-4	P-1	P-1	ACT-1/ P-2	—	P-5	PL-1	COT-1	EG-1	(1) (2) (9)
		12	CLASSROOM	L003	CT-3	RB-1	P-1	P-1	P-1	P-1	P-4	ACT-1/ P-2	—	P-5	PL-1	COT-1	EG-1	(1) (2) (9)
		13	CLASSROOM	L004	CT-3	RB-1	P-1	P-4	P-1	P-1	P-1	ACT-1/ P-2	—	P-5	PL-1	COT-1	EG-1	(1) (2) (9)
		14	CLASSROOM	L005	CT-3	RB-1	P-1	P-1	P-1	P-1	P-4	ACT-1/ P-2	—	P-5	PL-1	COT-1	EG-1	(1) (2) (9)
		15	CLASSROOM	L006	CT-3	RB-1	P-1	P-4	P-1	P-1	P-1	ACT-1/ P-2	—	P-5	PL-1	COT-1	EG-1	(1) (2) (9)
		16	STAIR B	—	VCT-1	RB-1	P-1	P-1	P-1	P-1	P-1	—	—	P-5	—	—	—	(4)
		17	CORRIDOR	—	CT-3	CT-2	CT-1	CT-2	CT-1	CT-1	CT-1	ACT-1	—	P-5	—	—	—	(1) (3) (6) (8) (9)
		18	STAIR A	—	VCT-1	CT-2	CT-1	CT-2	CT-1	CT-1	CT-1	—	—	—	—	—	—	(1) (5) (6) (7) (8) (9)
		19	TOILET	B016.1	CT-3	CT-2	CT-1	CT-2	CT-1	CT-1	CT-1	—	P-5	P-5	—	—	—	(7) (9)
		20	OFFICE	B016.2	CT-3	RB-1	P-1	P-1	P-1	P-1	P-1	ACT-1	P-5	P-5	—	—	—	(9)

FINISH SCHEDULE LEGEND						NOTE: ALL FINISHES SHALL BE CLASS "A"	
LEGEND	SIZE	MANUFACTURER	SERIES/MODEL NO / COLOR	DESCRIPTION	LOCATION / REMARKS		
P-1	—	BENJAMIN MOORE	HC-81 / MANCHESTER TAN	EGGSHELL FINISH	WALLS		
P-2	—	BENJAMIN MOORE	I-01 / WHITE	FLAT FINISH	SOFFITS & CEILINGS		
P-3	—	BENJAMIN MOORE	AC-32 / PISMO DUNES	SEMI-GLOSS FINISH	ANY DOOR NEEDED TO BE PAINTED		
P-4	—	BENJAMIN MOORE	HC-35 / POWELL BUFF	EGGSHELL FINISH	ACCENT WALLS		
P-5	—	BENJAMIN MOORE	2112-30 STONE BROWN	SEMI-GLOSS FINISH	DOOR FRAMES		
P-6	—	BENJAMIN MOORE	2111-40 / TADS TAUPE	SEMI-GLOSS FINISH	RAILINGS		
P-7	—	BENJAMIN MOORE	2111-50 / STONE HARBOR	SEMI-GLOSS FINISH	STAIR PANS		
P-8	—	BENJAMIN MOORE	C112	HIGH GLOSS	FLOOR		
ACT-1	2'x4'	ARMSTRONG	551 / CIRRHUS HIGH-NRC / TEGULAR	ACOUSTICAL CEILING TILE	CLASSROOMS		
ACT-2	2'x2'	ARMSTRONG	556 / CIRRHUS HIGH-NRC / TEGULAR	ACOUSTICAL CEILING TILE	OFFICES		
VCT-1	12"x12"	TARKETT	CE104 / WARM & FUZZY	VINYL ENHANCED TILE	CLASSROOMS + CORRIDORS		
VCT-2	12"x12"	TARKETT	CE101 / LINEN	VINYL ENHANCED TILE	CLASSROOMS + CORRIDORS		
CT-1	4"x12"	PROSPEC LLC.	PROLINEAR CREAM MATT	WALL TILE	TOILETS / CORRIDOR		
CT-2	4"x12"	PROSPEC LLC.	PROLINEAR CREAM GLAZE	WALL TILE	TOILETS / CORRIDOR (GLAZE TO BE USED FOR ALL BASES)		
CT-3	12"x24"	PROSPEC LLC.	WAVE COLLECTION	FLOOR TILE			
SH-1	—	SCHLUTER	RONDEC AC - STAINLESS	CORNER FOR TILES			
RB-1	6" HIGH	JOHNSONITE	80 FAWN CB	RUBBER BASE			
ST-1	—	JOHNSONITE	RUBBER STAIR TREAD - MATCH EXISTING COLOR	HAMMERED SURFACE	FOR RISERS + TREADS ( STAIR-B )		
ST-2	—	JOHNSONITE	RUBBER STAIR TREAD - MATCH EXISTING COLOR	TEXTURED SURFACE	FOR RISERS + TREADS ( STAIR-A )		
PL-1	—	WILSONART	439-80 / WALLABY	PLASTIC LAMINATE	CABINETS		
EG-1	—	CHARTER INDUSTRIES	F929-OYSTER GREY	EDGE BAND	CABINET EDGES		
COT-1	—	CORIAN	SANDAL WOOD	SOLID SURFACING	COUNTERTOPS		

#### MATERIAL

##### ABBREVIATIONS

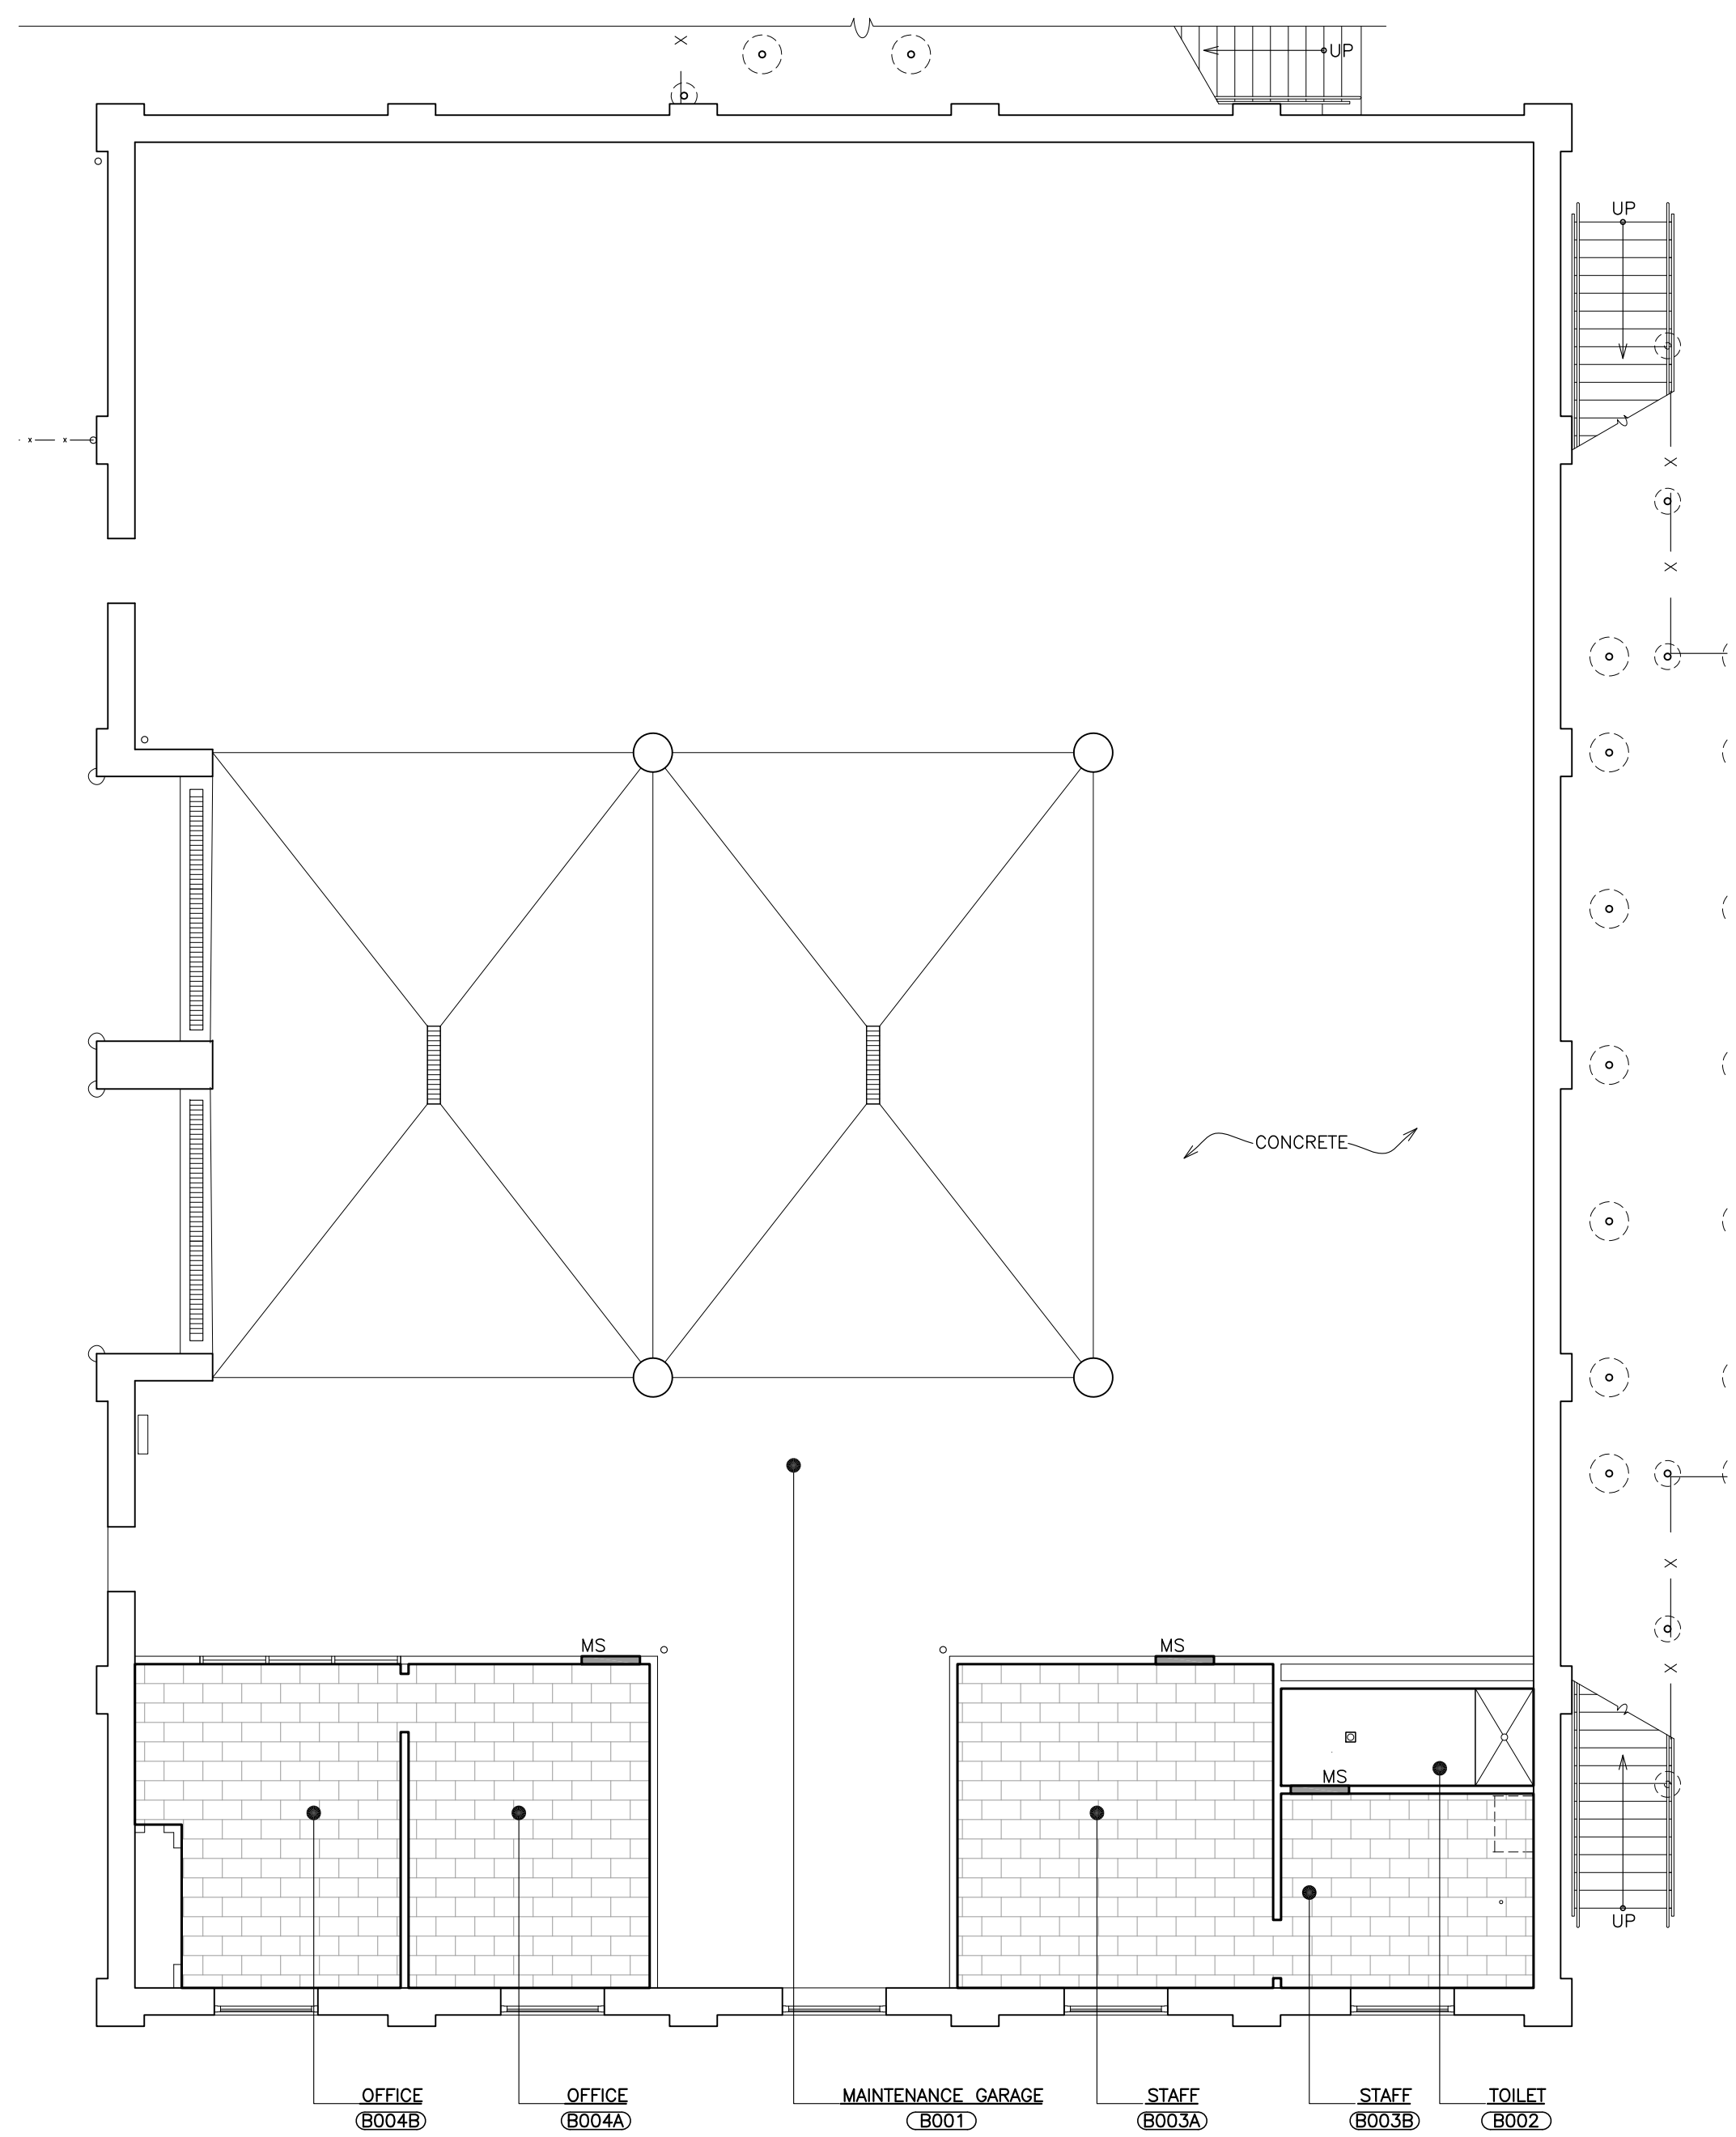
ACT	—	ACOUSTIC CEILING TILE
AC	—	ACOUSTIC
AD	—	SOUND ATTENUATION
PANEL	—	
BR	—	BRICK
CT	—	CERAMIC TILE
CPT	—	CARPET
FPT	—	FLOOR PAINT
P	—	PAINT
PLS	—	PLASTER
PL	—	PLASTIC LAMINATE
VCT	—	VINYL COMPOSITION TILE
MAS	—	MASONRY
CONC.A	—	CONCRETE
GB	—	GYPSUM BOARD
WD	—	WOOD
RB	—	RUBBER BASE
EP	—	EPOXY FLOORING
SS	—	SOLID SURFACING
T	—	TRIM
TP	—	TOILET PARTITION
TT	—	TERRAZZO TILE
VAF	—	VINYL ACOUSTIC FLOORING
RBT	—	RUBBER TILE
HWP	—	HIGH IMPACT WALL PANEL
TB	—	THIN BRICK
DEWC	—	DRY ERASE WALL
COVERING	—	
US	—	URINAL SCREEN

#### REMARKS FOR FINISH SCHEDULE

- REFER TO WALL ELEVATIONS AND REFLECTED CEILING PLANS FOR ADDITIONAL INFORMATION.
- PAINT SOFFITS.
- USE P-1 ABOVE WALL TILE
- USE ST-1 FOR STAIR-B
- USE ST-2 FOR STAIR-A
- USE SH-1 FOR TILE EDGES.
- WALL TILE FULL HEIGHT TO CEILING.
- SEE TILE DETAILS ON DRAWING A652.
- FLOOR TILE SUPPLIED BY OWNER FOR INSTALLATION BY CONTRACTOR.

#### GENERAL FINISH NOTES:

- SEE REFLECTED CEILING PLANS, AND INTERIOR ELEVATIONS FOR ADDITIONAL INFORMATION.
- CLEAN, SCRAPE, PATCH/ REPAIR ALL SURFACES SCHEDULED TO BE PAINTED.
- PATCH / REPAIR AND PAINT ALL AREAS DISTURBED IN NEW WORK, MATCH EXISTING ADJACENT FINISHES.
- ALL NEW CERAMIC TILE SHALL BE THINSET UNLESS OTHERWISE NOTED.
- PAINTING:**  
PAINT AREAS AS SHOWN ON DRAWINGS OR AS INSTRUCTED IN STRICT ACCORDANCE WITH THE PUBLISHED INSTALLATION SPECIFICATIONS OF THE MANUFACTURER OF THE MATERIALS USED. PREPARE ALL SURFACES TO BE PAINTED IN ACCORDANCE TO MPI REQUIREMENTS.
- ITEMS NOTED THUS INDICATE EXISTING ITEMS TO REMAIN UNDISTURBED UNLESS NOTED OTHERWISE. PATCH/PAINOTED DAMAGED AREAS AS REQUIRED.
- ITEMS NOTED THUS INDICATE NEW AND EXISTING ITEMS TO BE PAINTED.
- ITEMS NOTED THUS INDICATE EXISTING ITEMS TO BE PAINTED ONLY WITHIN THE IMMEDIATE VICINITY OF GENERAL WORK TO BE PAINTED. MINIMUM 4' EACH WAY.
- ITEM NOTED THUS ARE NOT APPLICABLE.
- CLEANING AND TOUCH-UP:**  
UPON COMPLETION, CONTRACTOR SHALL TOUCH UP AND RESTORE ALL DAMAGED FINISHED AND CLEAN AND POLISH ALL SURFACES.
- ALL WOOD DOORS TO BE FACTORY FINISHED. COLOR TO MATCH EXISTING.
- PROVIDE CEMENTITIOUS SELF-LEVELING CONCRETE OVER ALL EXISTING FLOORS RECEIVING NEW FINISH. REFER TO FINISH SCHEDULE AND SPECIFICATIONS FOR FINISH TYPE. PAINT ALL DOORFRAMES.
- THE PLUMBING CONTRACTOR SHALL INSTALL SEALANT AROUND ENTIRE PERIMETER OF ALL TOILET FIXTURES. MATCH COLOR OF FIXTURE.
- PAINT ALL MISCELLANEOUS METAL ITEMS (INTERIOR & EXTERIOR) INCLUDING BUT NOT LIMITED TO THE FOLLOWING: STEEL STAIR STRUCTURE, GUARDRAILS, BALUSTERS, POSTS, WIRE MESH PARTITIONS, SOFFITS, LINTEL ANGLES, PIPING (AS REQUIRED BY O.S.H.A.), EXPOSED STEEL CHANNELS, ROOF HATCHES, ACCESS LADDERS, FLOOR ACCESS HATCHES AND FRAMES, ECT. COLOR SELECTED BY ARCHITECT.



3 FLOOR FINISH PLAN - GROUND FLOOR  
SCALE: 1/8" = 1'-0"

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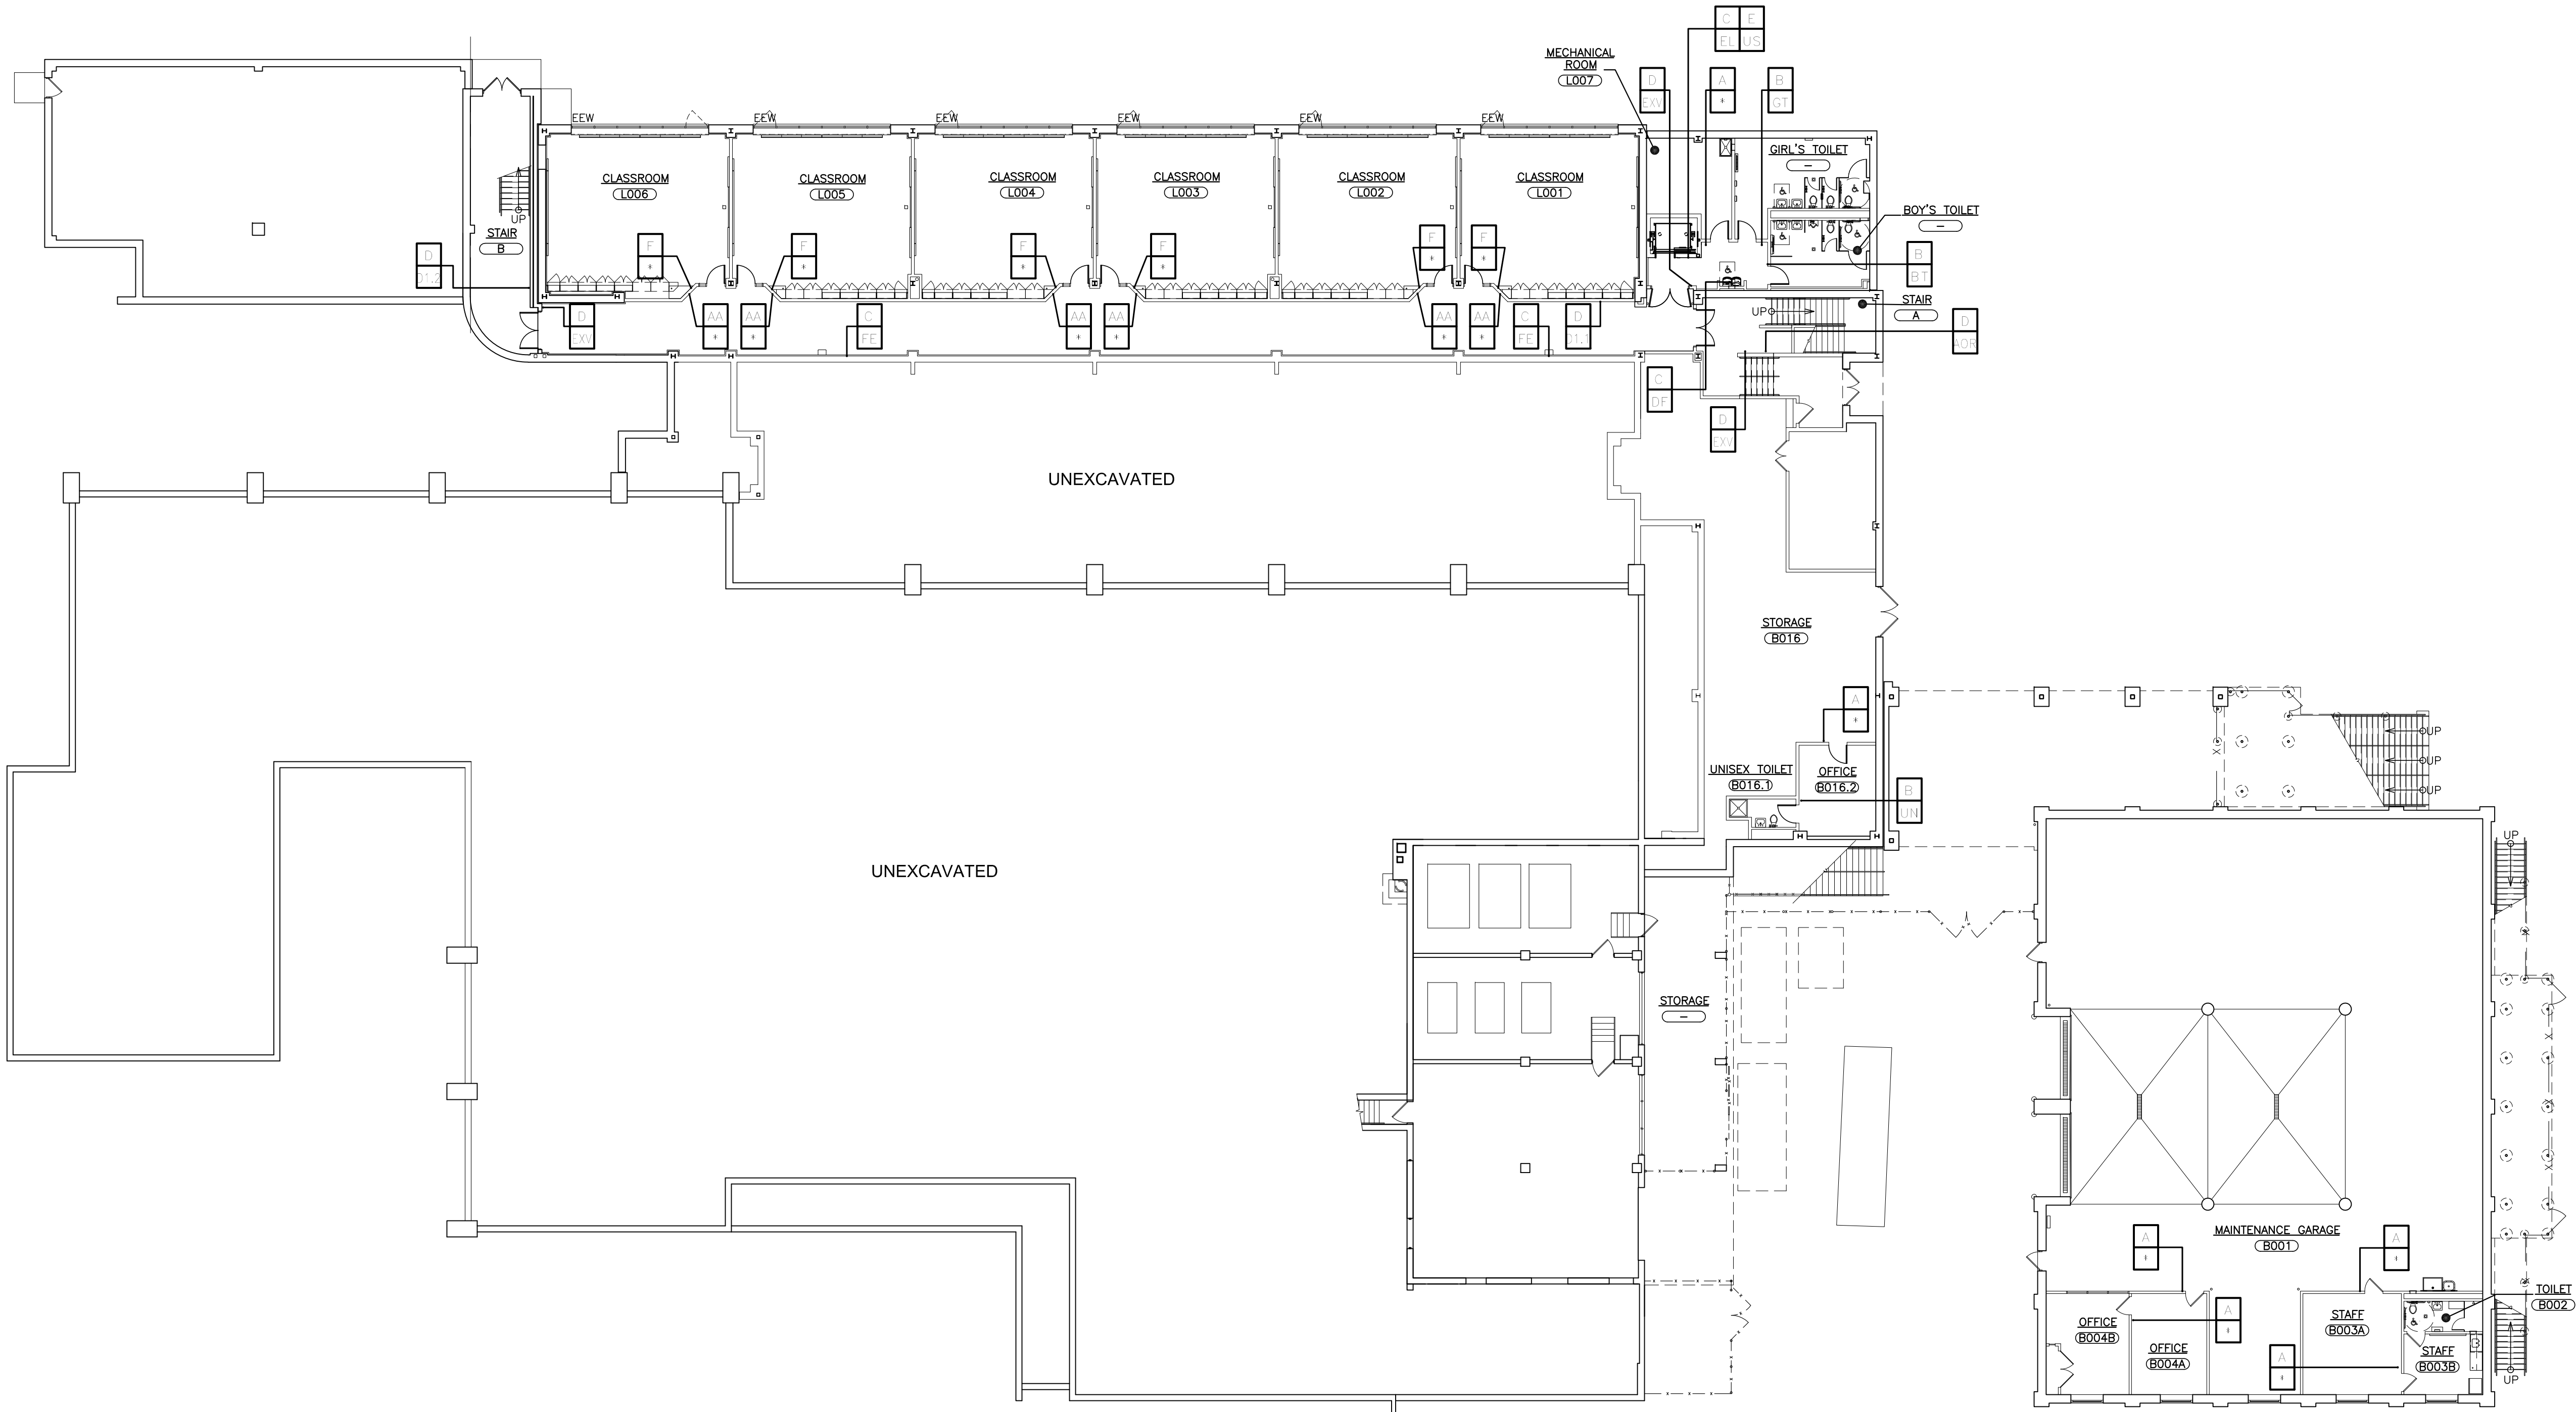
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PROJECT: JFK  
PORT KENNEDY ELEMENTARY SCHOOL  
FLOOR REPAIRS & RELATED WORK  
40 DAVENPORT STREET PORT KENNEDY NSW 1505  
DRAWING TITLE  
JOHN F. KENNEDY ELEMENTARY SCHOOL  
FLOOR TILE PATTERN PLANS

10-18-2021 B I D  
DATE ISSUED TO  
SHEET SIZE 30"x42"  
DRAWN BY F & D  
CHECKED BY F & D  
FILE NO. 21444.01

PLOT DATE: October 18, 2021 -- 8:25am

FILE: I:\21444.01 JFK Flood Repairs & Related Work\DRAWINGS\CURRENT\1-F&D\21444.01-A900.dwg



1 SIGNAGE PLAN - GROUND FLOOR  
SCALE: 1/16" = 1'-0"



SIGNAGE LEGEND			
	INDICATES SIGN TYPE A		INDICATES SIGN TYPE C
	INDICATES LOCATION OF SIGN		INDICATES LOCATION OF SIGN
	<u>NUMERICAL CLASSROOM SIGN</u>		<u>GRAPHIC SIGN</u>
	DENOTES ROOM NUMBER TO BE PLACED ON SIGN		SIGN DESCRIPTOR (SEE DWG. A-925)
	INDICATES SIGN TYPE B		INDICATES SIGN TYPE D
	INDICATES LOCATION OF SIGN		INDICATES LOCATION OF SIGN
	<u>ROOM FUNCTION SIGN</u>		<u>SPECIALTY SIGN</u>
	SIGN DESCRIPTOR (SEE DWG. A-925)		SIGN DESCRIPTOR (SEE DWG. A-925)

PROJECT NAME PORT CHESTER-FRYE UNION FREE SCHOOL DISTRICT JOHN F. KENNEDY ELEMENTARY SCHOOL FLOOD REPAIRS & RELATED WORK 40 DAVENIA STREET, PORT CHESTER, NY 10573		DRAWING TITLE JOHN F. KENNEDY ELEMENTARY SCHOOL SIGNAGE PLAN - GROUND FLOOR	
10-18-2021		B I D	
SHEET SIZE 30"x42"		DRAWING NO. A900	
DRAWN BY F & D		FILE NO. 21444.01	
CHECKED BY F & D			

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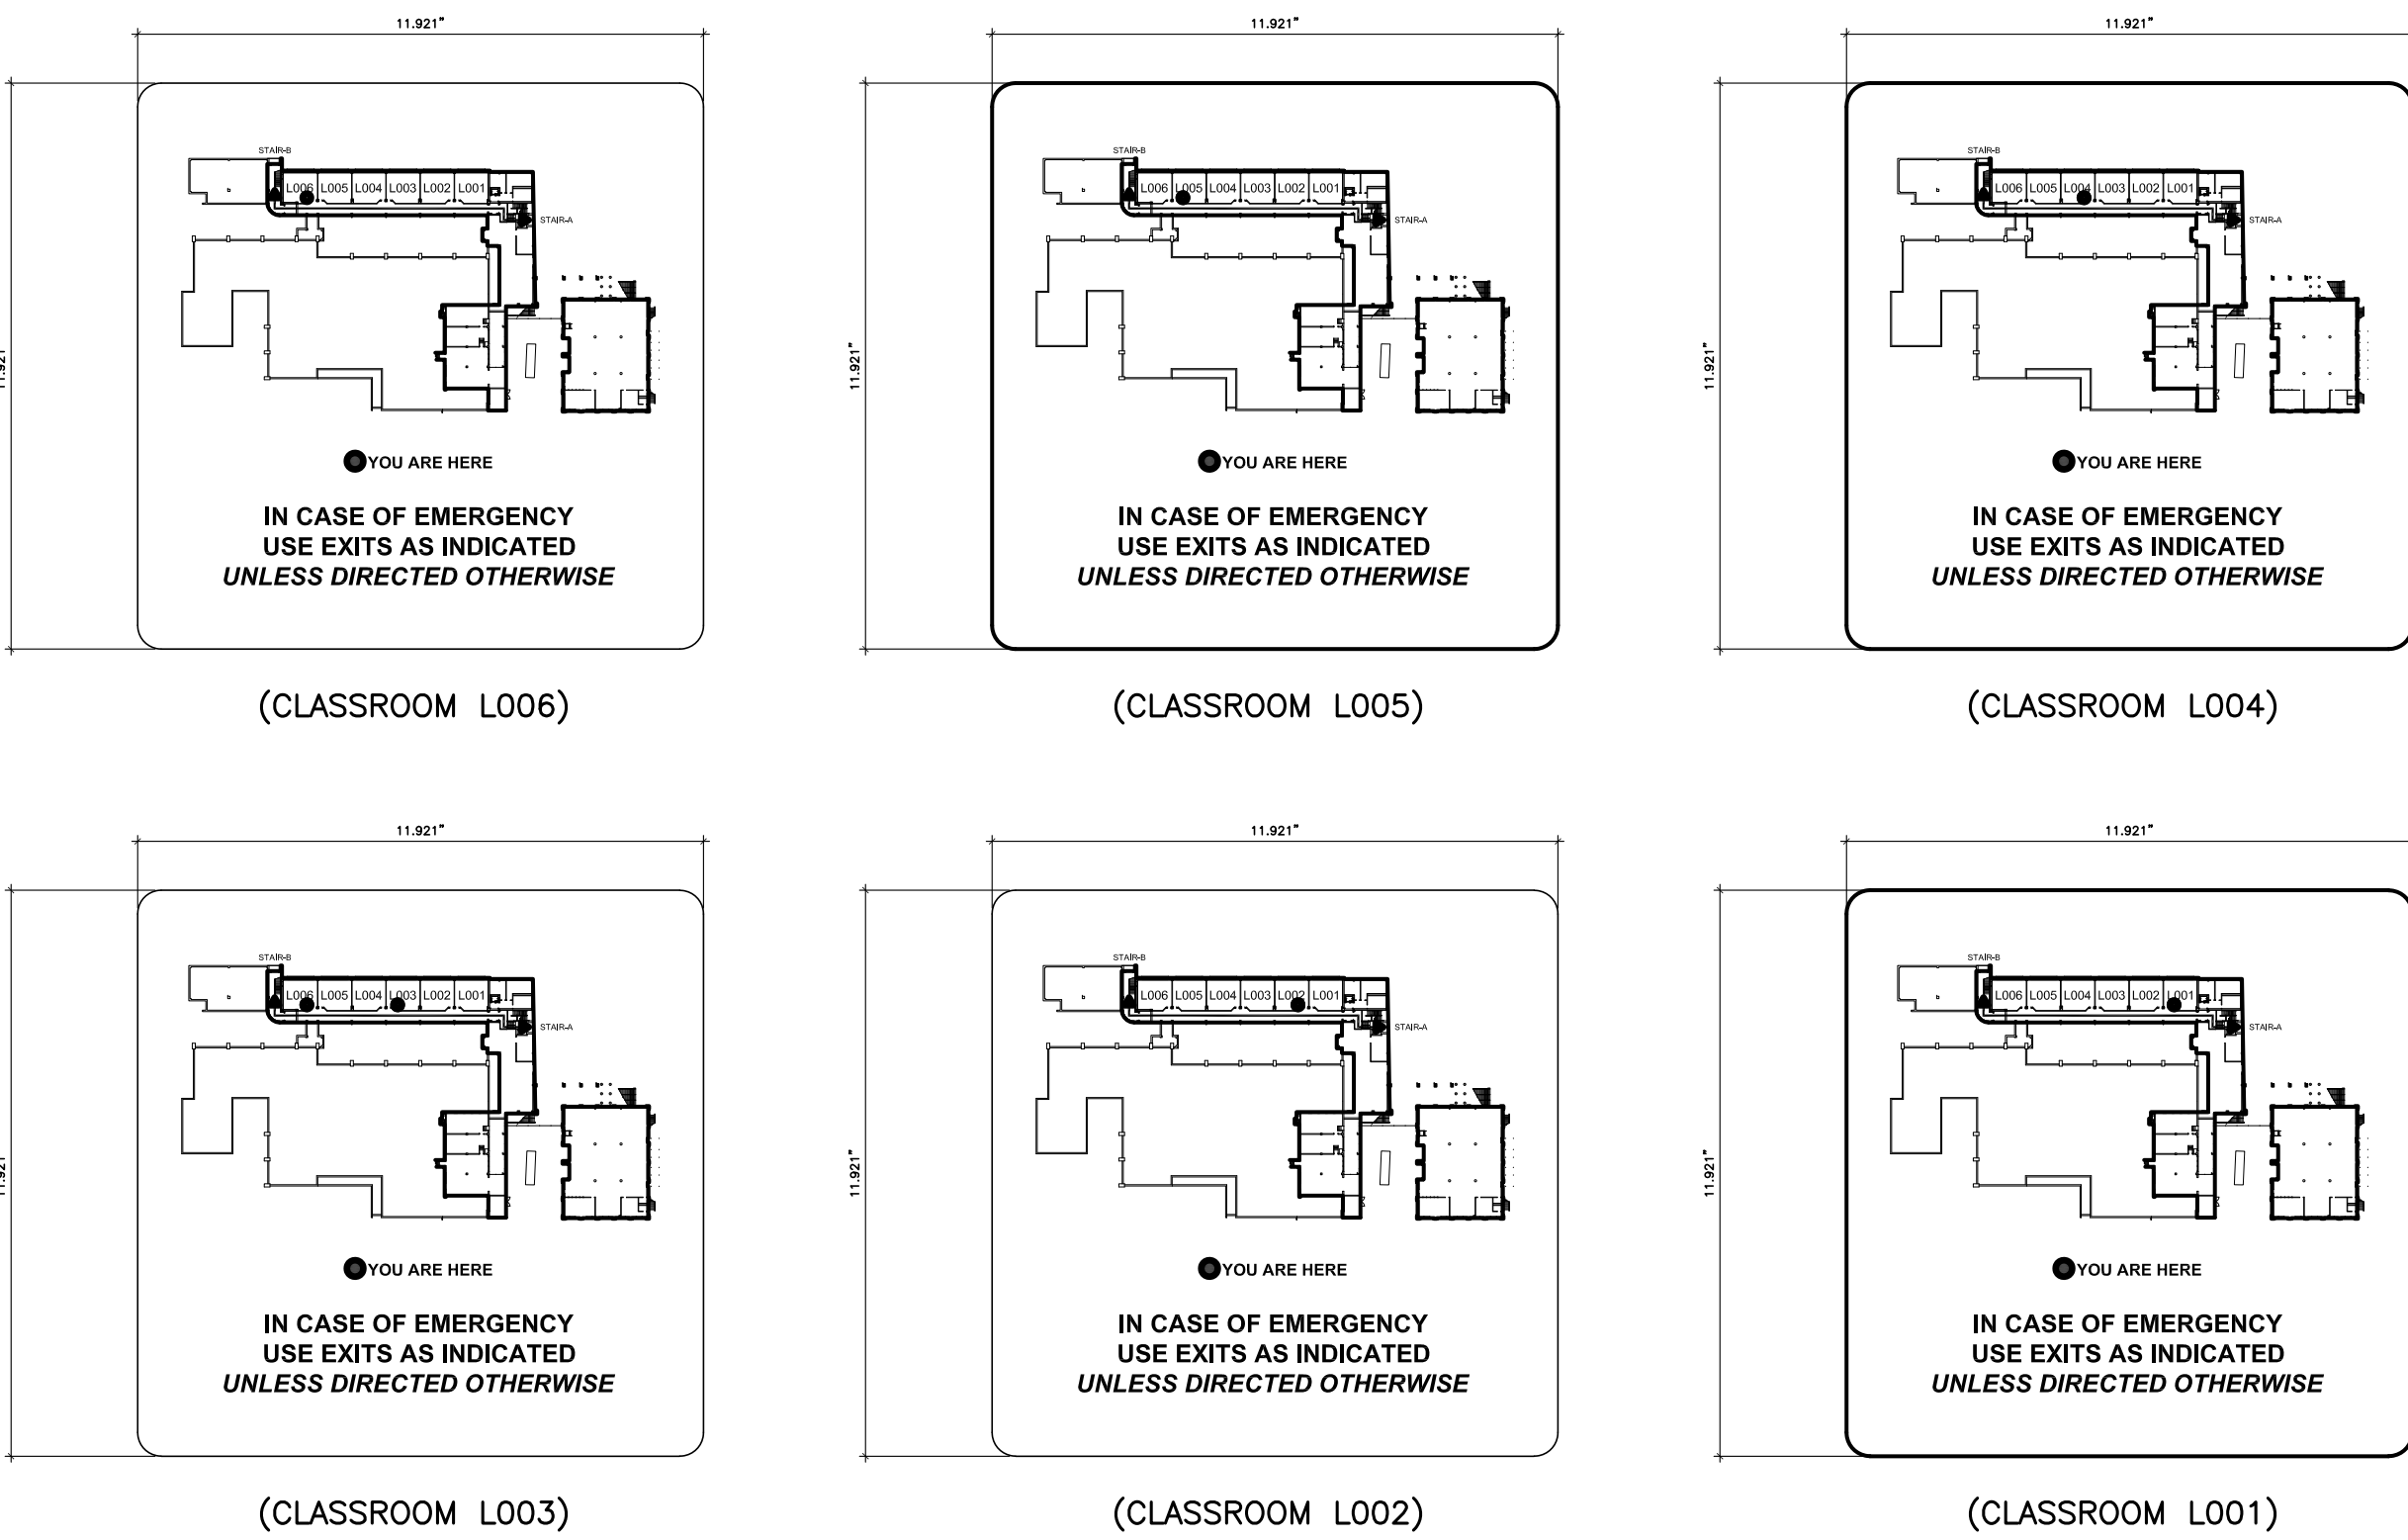
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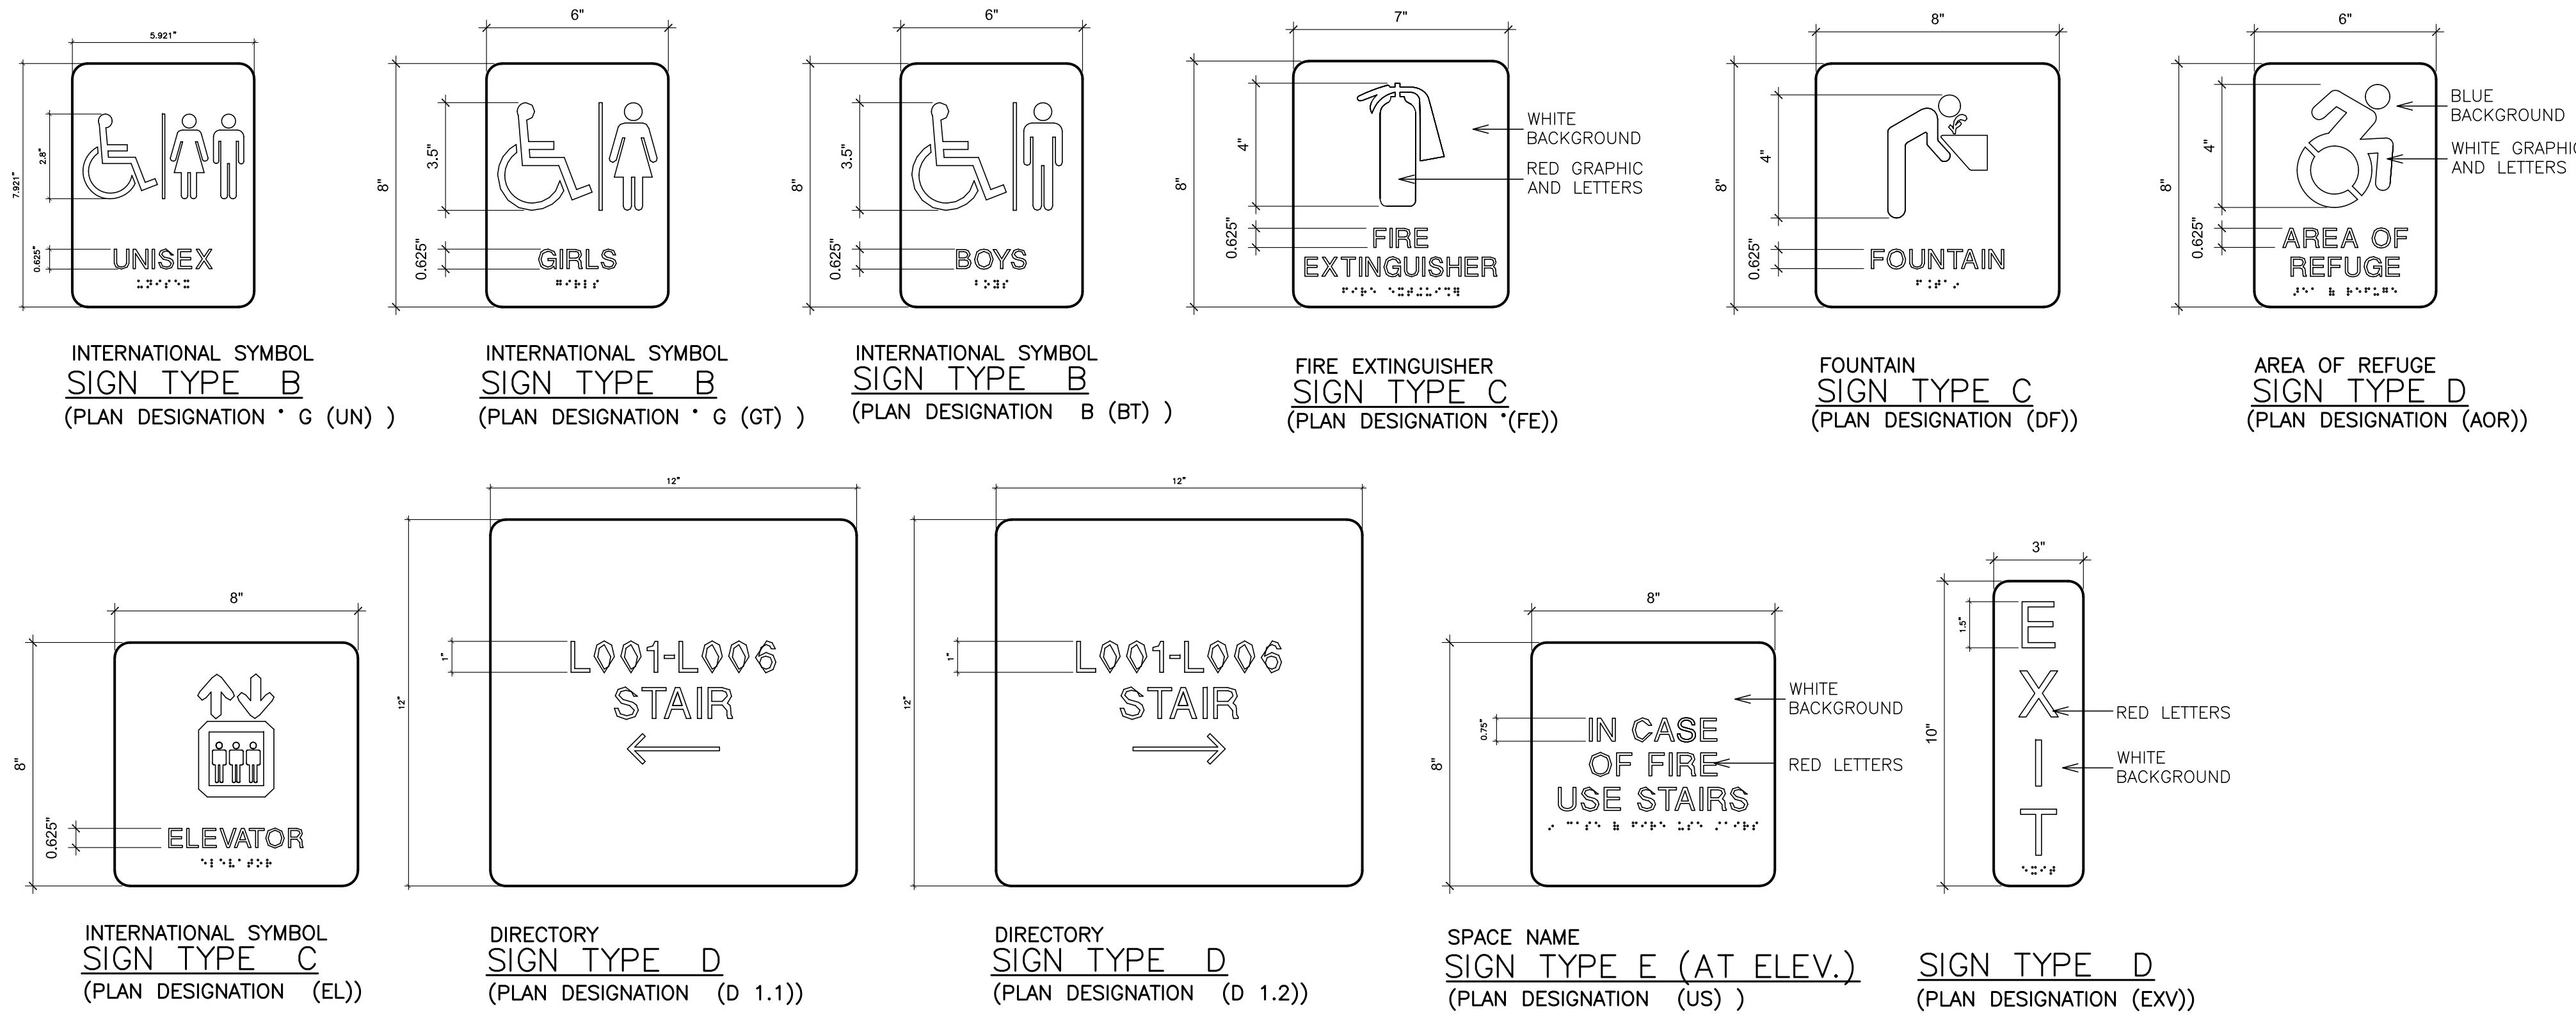
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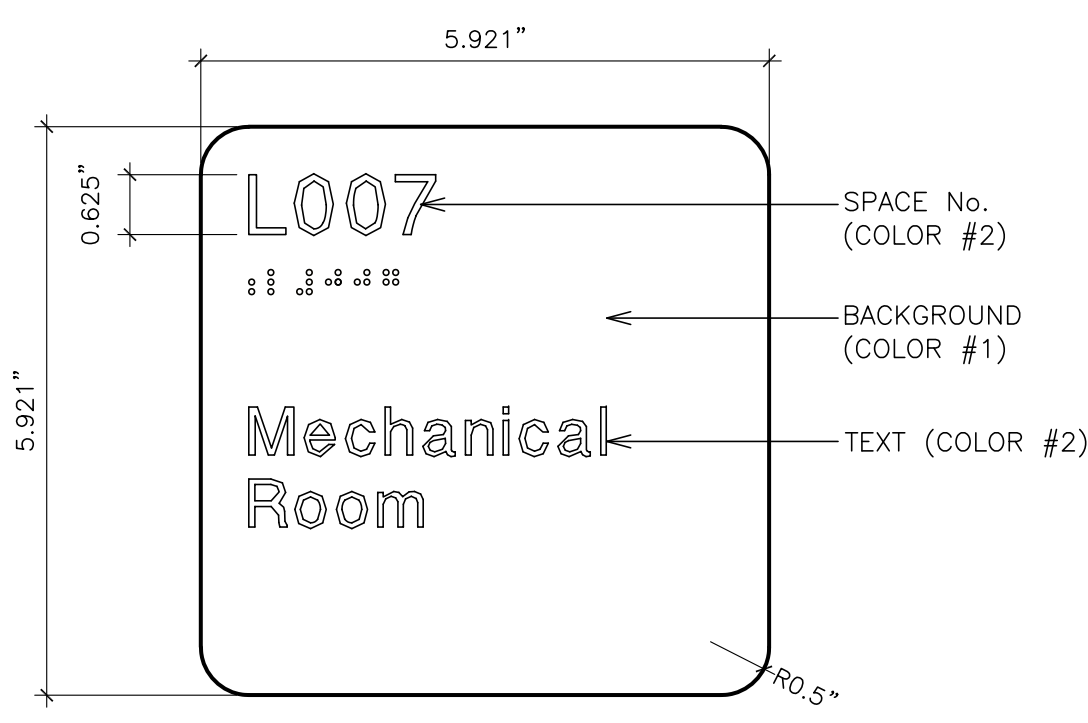
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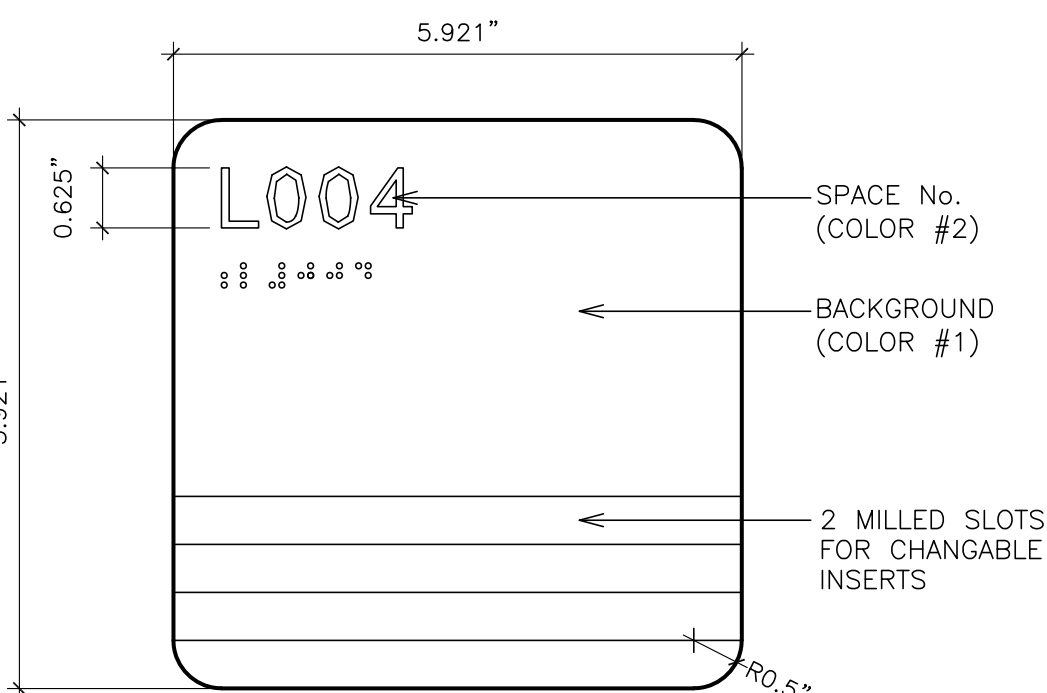
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SIGN TYPES: SCALE: 6"=1'-0"




SIGN TYPE A  
(PLAN DESIGNATION \*)



SIGN TYPE AA  
(PLAN DESIGNATION \*)

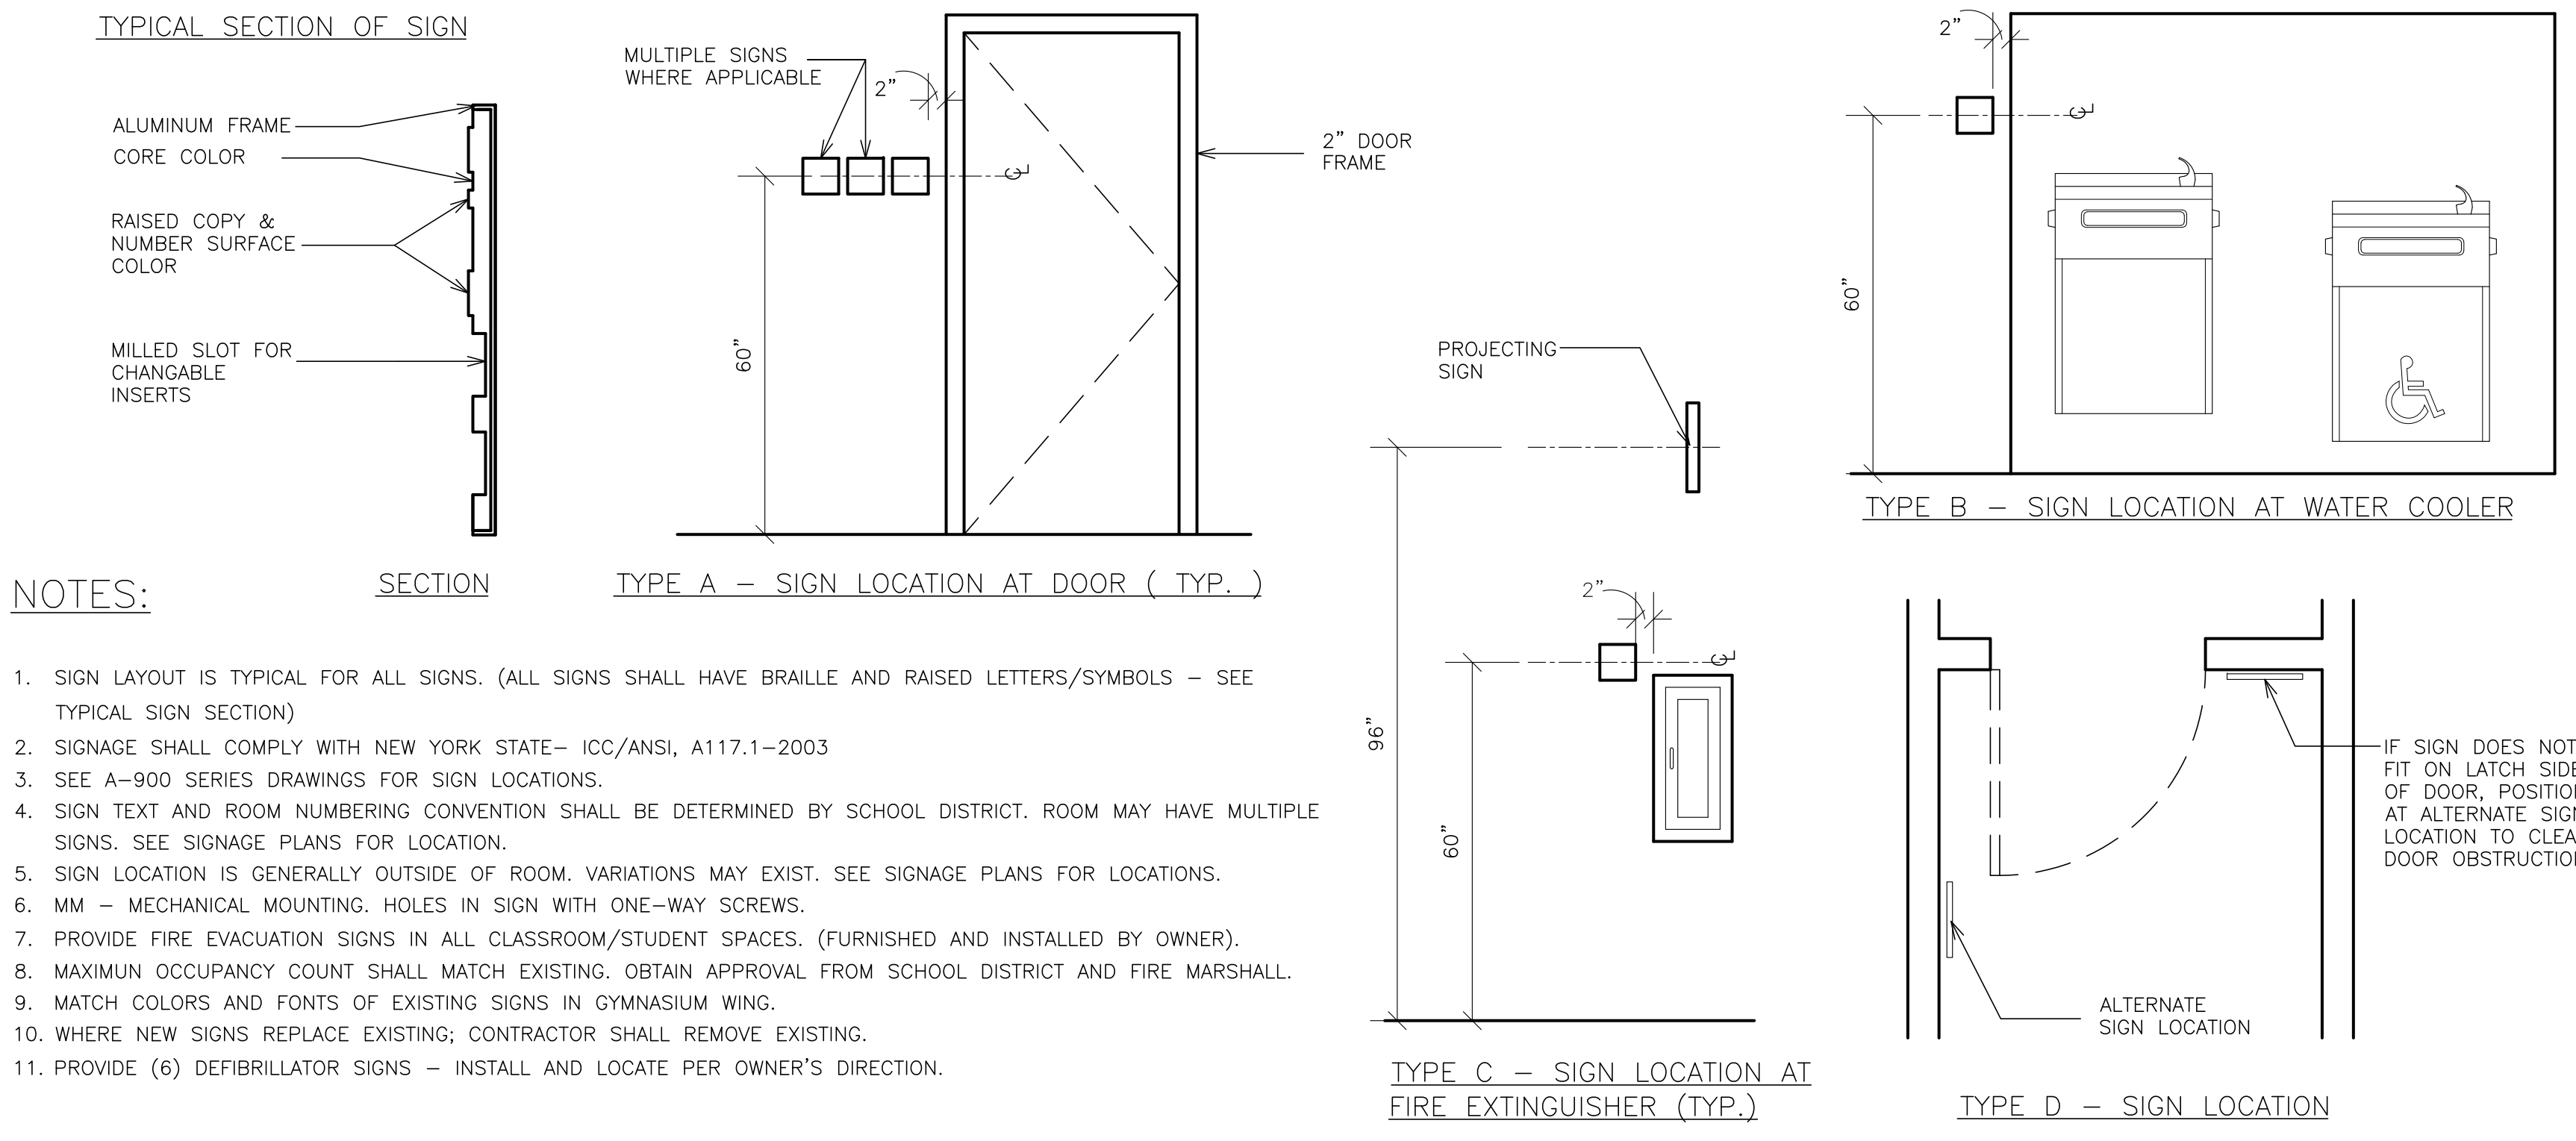SIGNAGE MOUNTING LOCATIONS: NOT TO SCALE



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ARCHITECTS  
PLANNERS

PROJECT TITLE  
PORT CHESTER-RYE UNION FREE SCHOOL DISTRICT  
JOHN F. KENNEDY ELEMENTARY SCHOOL  
FLOOD REPAIRS & RELATED WORK  
40 DAVENIA STREET, PORT CHESTER, NY 10573

DRAWING TITLE  
SIGN TYPES AND DETAILS

10-18-2021  
DATE

B I D  
ISSUED TO

SHEET SIZE  
30"x42"

DRAWN BY  
F & D

CHECKED BY  
F & D

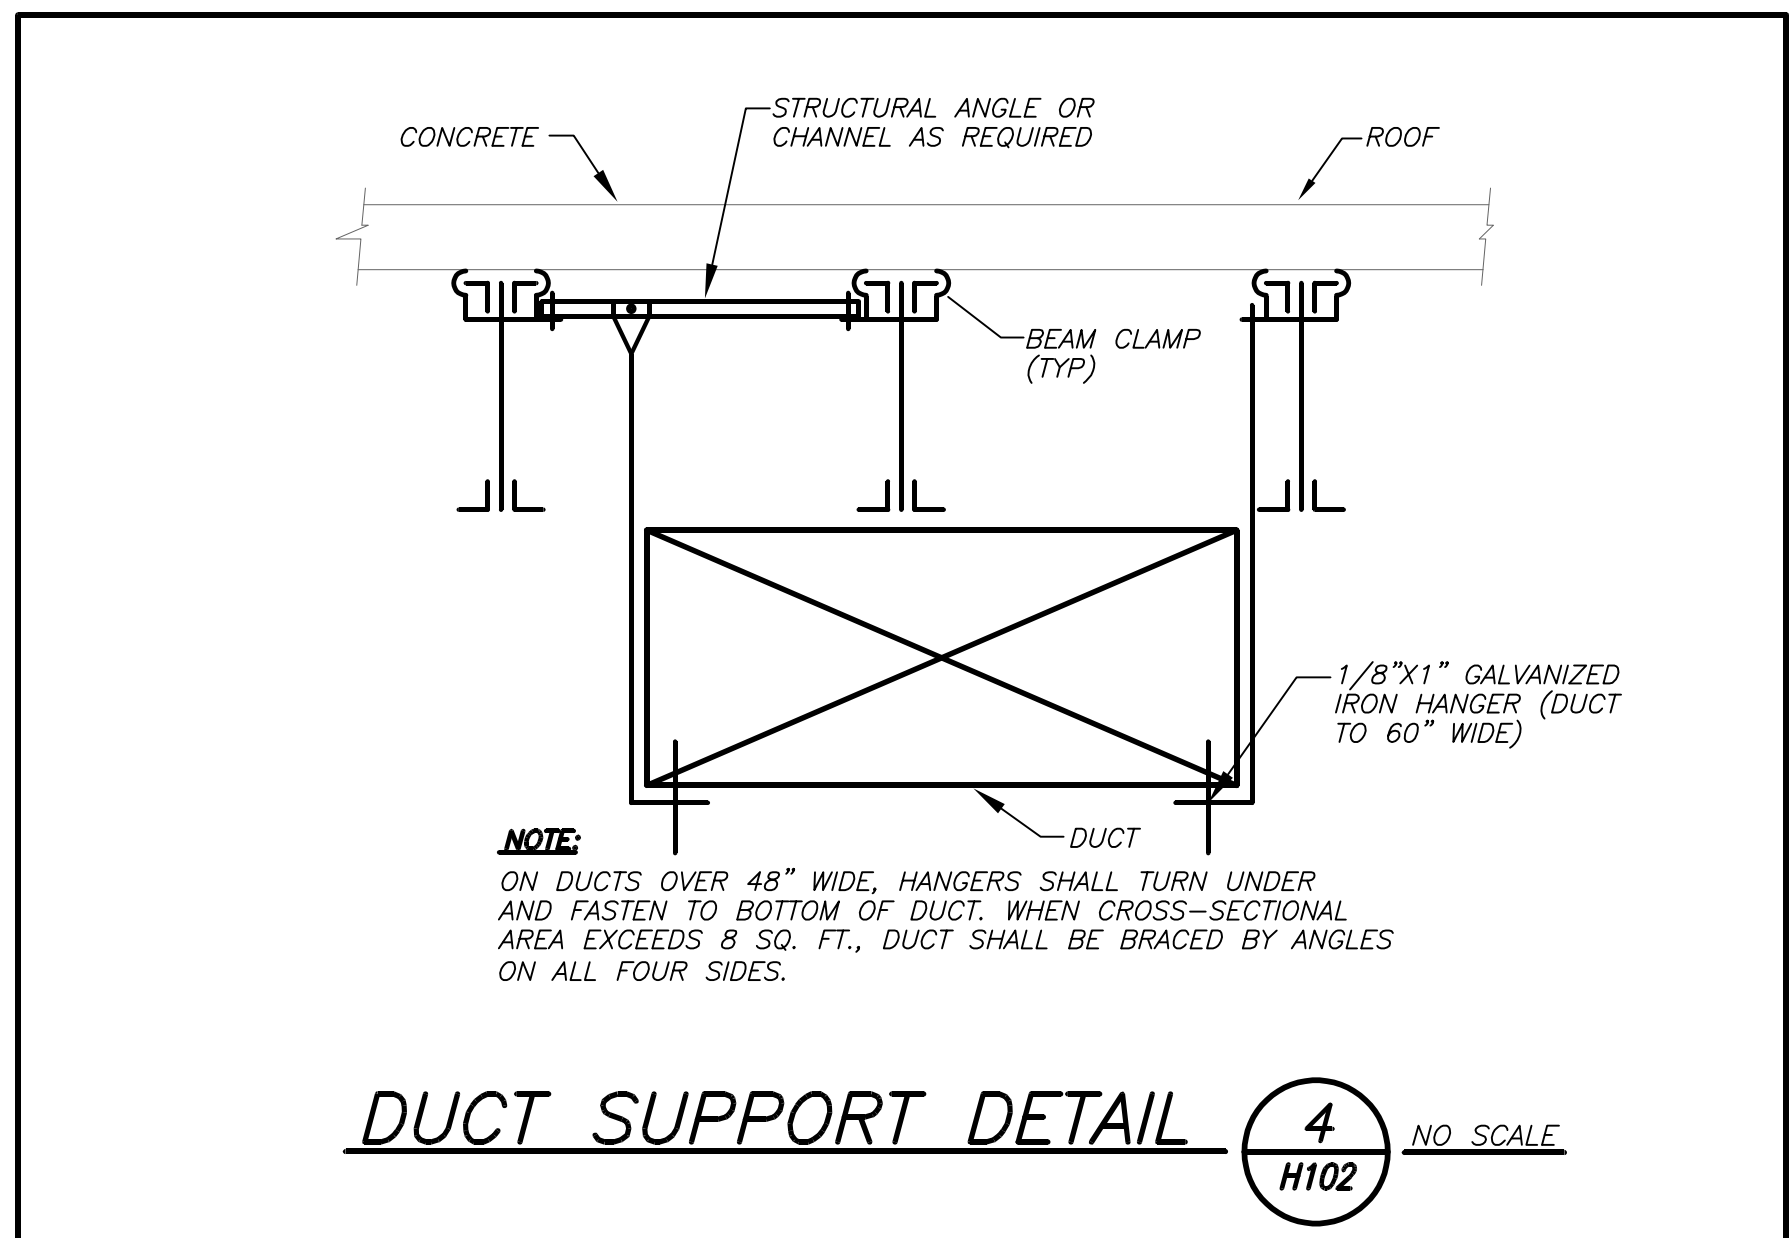
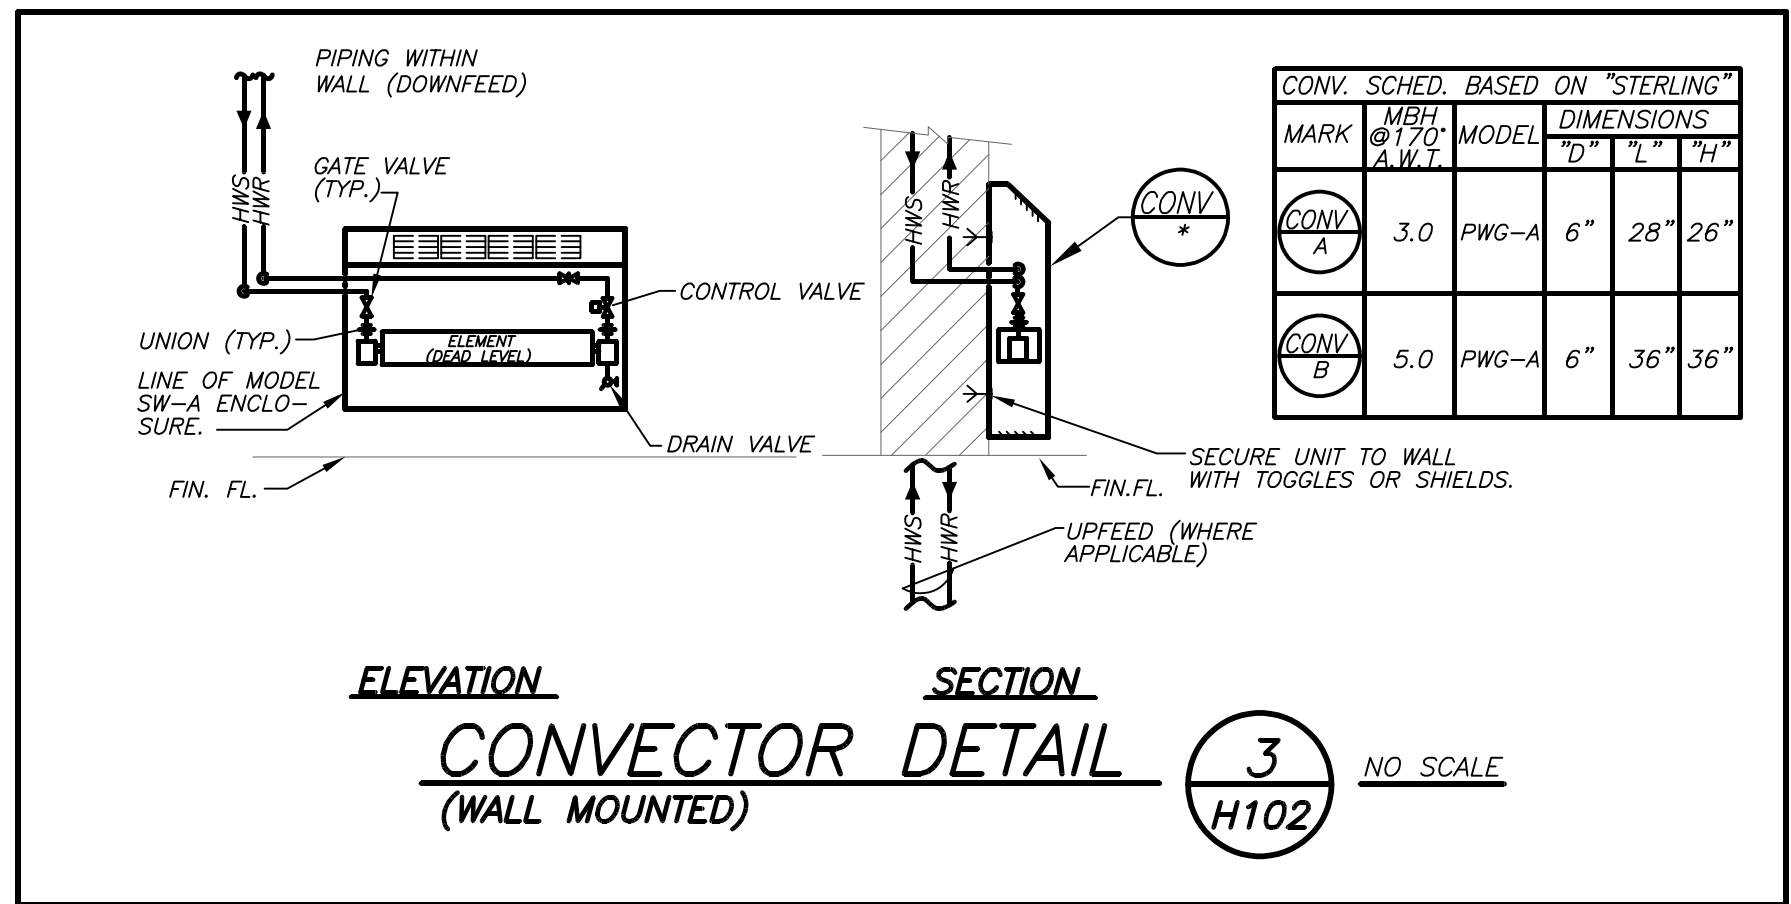
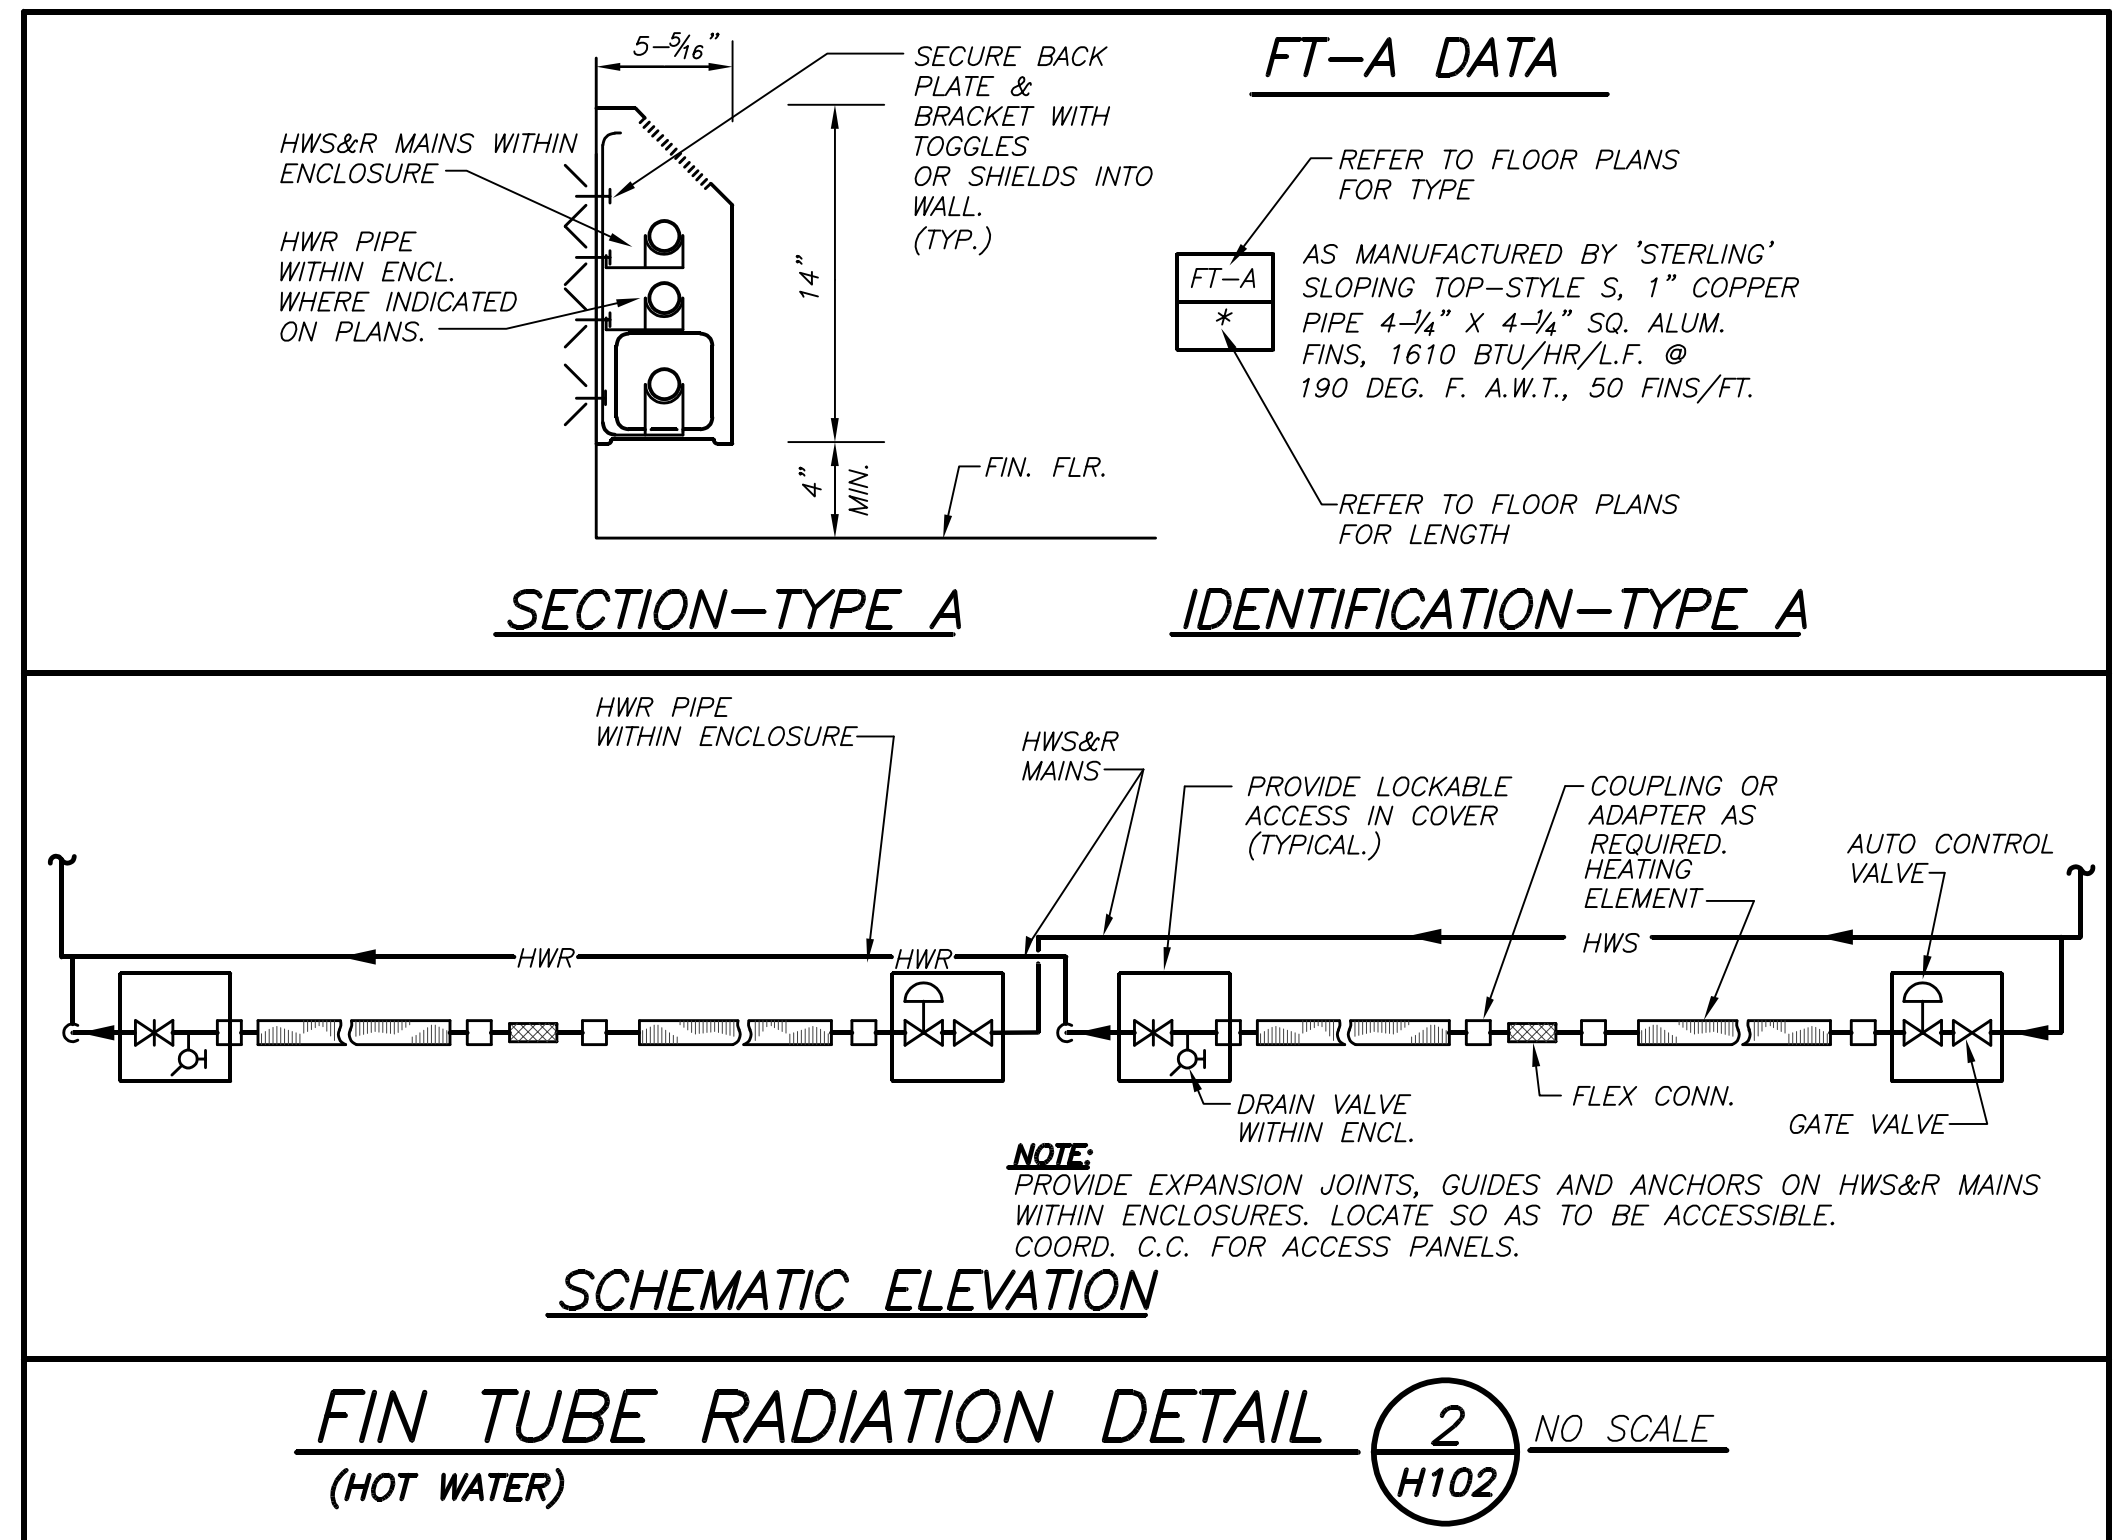
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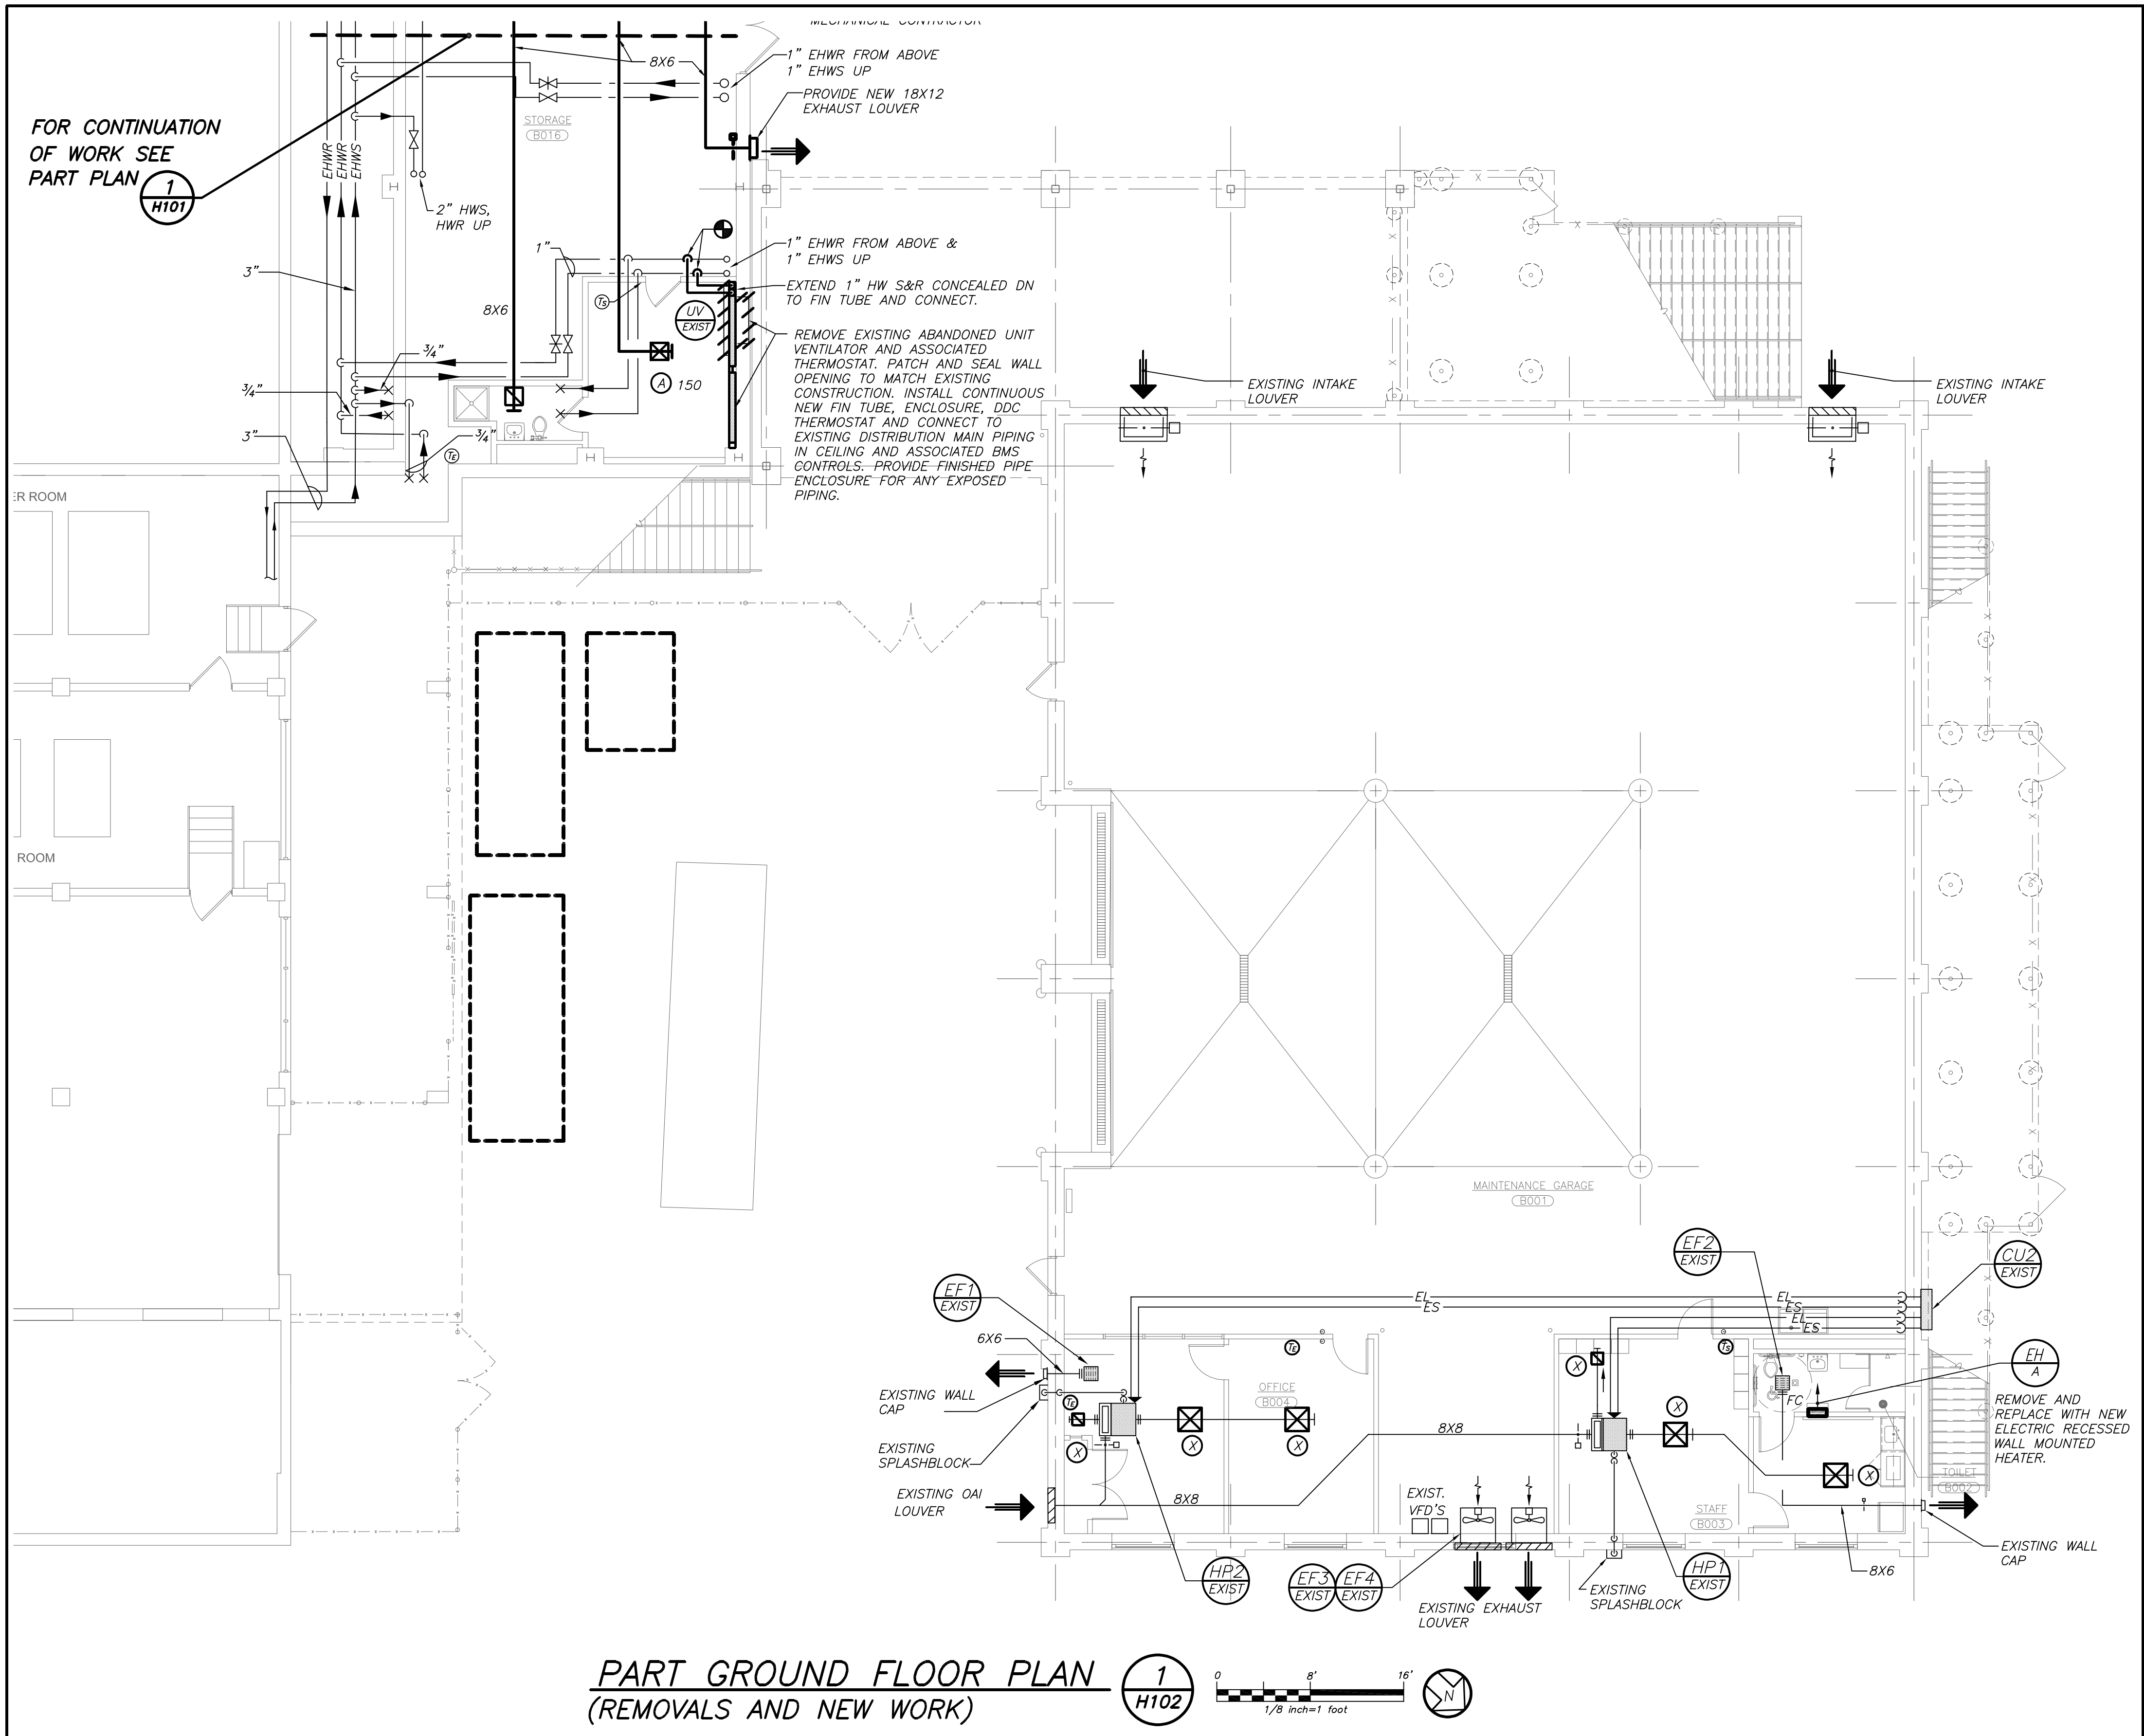




SCHEDULE OF ELECTRIC HEATERS						
MARK	SERVICE	TYPE	MODEL No.	CAPACITY BTU/HR KW	ELECTRIC SERVICE	AMPS
1	TOILET 8002	WALL MTD.	MCCSAR1802	6142/3070	1.8/0.9	120/1/60
2						
3						

NOTES:

- AS MANUFACTURED BY "O-MARK".
- INSTALL PER MANUFACTURER'S RECOMMENDATIONS.
- PROVIDE SEMI RECESSED FRAME. FINISH PER ARCHITECT.



SCHEDULE OF INDOOR ENERGY RECOVERY UNITS (PRE-PURCHASED BY OWNER)																			
MARK	SERVICE	LOCATION	MODEL No.	AIRFLOW CONDITIONS					SUPPLY FAN			EXHAUST FAN			HEATING COIL DATA				
				O.A. CFM	E.A. CFM	R.A. CFM	SAESP. IN. WC	RAESP. IN. WC	TYPE	CFM	HP	TYPE	CFM	HP	MARK	TOT. CAP. BTU/HR	MIN. COIL FACE AREA	ENT. AIR TEMP. °F	LVS. AIR TEMP. °F
1	CLSPMS 8009-8014	STORAGE ROOM	U-ERV-3000	3000	3000	3000	1.5	1.0	CENTR.	3000	3.0	CENTR.	3000	3.0	1	144,800	4.3	45.0	89.5
2	OFFICE	STORAGE ROOM	PE7.15ERV	125	125	125	1.0	.5	CENTR.	125	-	CENTR.	125	-	2	6200	-	45.0	90

NOTES:

- AS MANUFACTURED BY "ENERGY WALL" (KUMA NEW YORK, C 914-255-4390 | O 212-678-5100 | E RICKSV@KUMANY.COM 41-45 39TH ST LONG ISLAND CITY NY 11104 | WWW.KUMANY.COM)
- AS MANUFACTURED BY "GREENTEK"
- DESIGN AIR CONDITION: SUMMER O.A. (95°F/75°F) R.A. (75°F/63°F), WINTER O.A. (13°F/13°F) R.A. (68°F/52°F).
- INSTALL PER MANUFACTURER'S RECOMMENDATIONS.
- PROVIDE PRE-FILTER/FINAL FILTERS COMBINATION FOR OUTSIDE AIR INTAKES AND PRE-FILTER FOR RETURN AIR PRIOR TO HEAT EXCHANGER. PROVIDE TWO SETS OF FILTERS (ONE SET IS FOR WHEN UNIT IS OPERATING DURING TESTING AND BALANCING AND ONE SET IS FOR FILTER REPLACEMENT AT PROJECT COMPLETION).
- INTERLOCK UNIT CONTROLS INTO EXISTING BMS CONTROLS, ASSOCIATED HEAT-PUMP CONTROLS, EXISTING DUCT MOUNTED HEATING COIL & DX COOLING COIL CONTROLS.
- PROVIDE UNIT WITH INTEGRAL ECONOMIZER DAMPER AND VARIABLE SPEED CONTROLLERS FOR SUPPLY AND EXHAUST FAN MOTORS.
- ENERGY RECOVERY UNITS SHALL BE PRE-PURCHASED BY THE OWNER. MECHANICAL CONTRACTOR SHALL EXCEPT DELIVERY, STORE UNITS AS NEEDED PRIOR TO INSTALLATION AND FULLY INSTALL UNITS WITH ALL NECESSARY MOUNTING HARDWARE AND ASSOCIATED APPURTENANCES. MECHANICAL CONTRACTOR SHALL MODIFY EXISTING CONCRETE HOUSEKEEPING PAD AS NECESSARY FOR NEW UNIT INSTALLATION. DUCT MOUNTED HEATING COIL PROVIDED AND INSTALLED BY MECHANICAL CONTRACTOR.

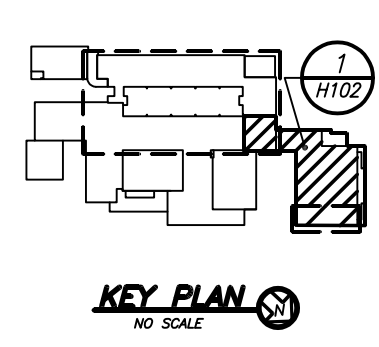
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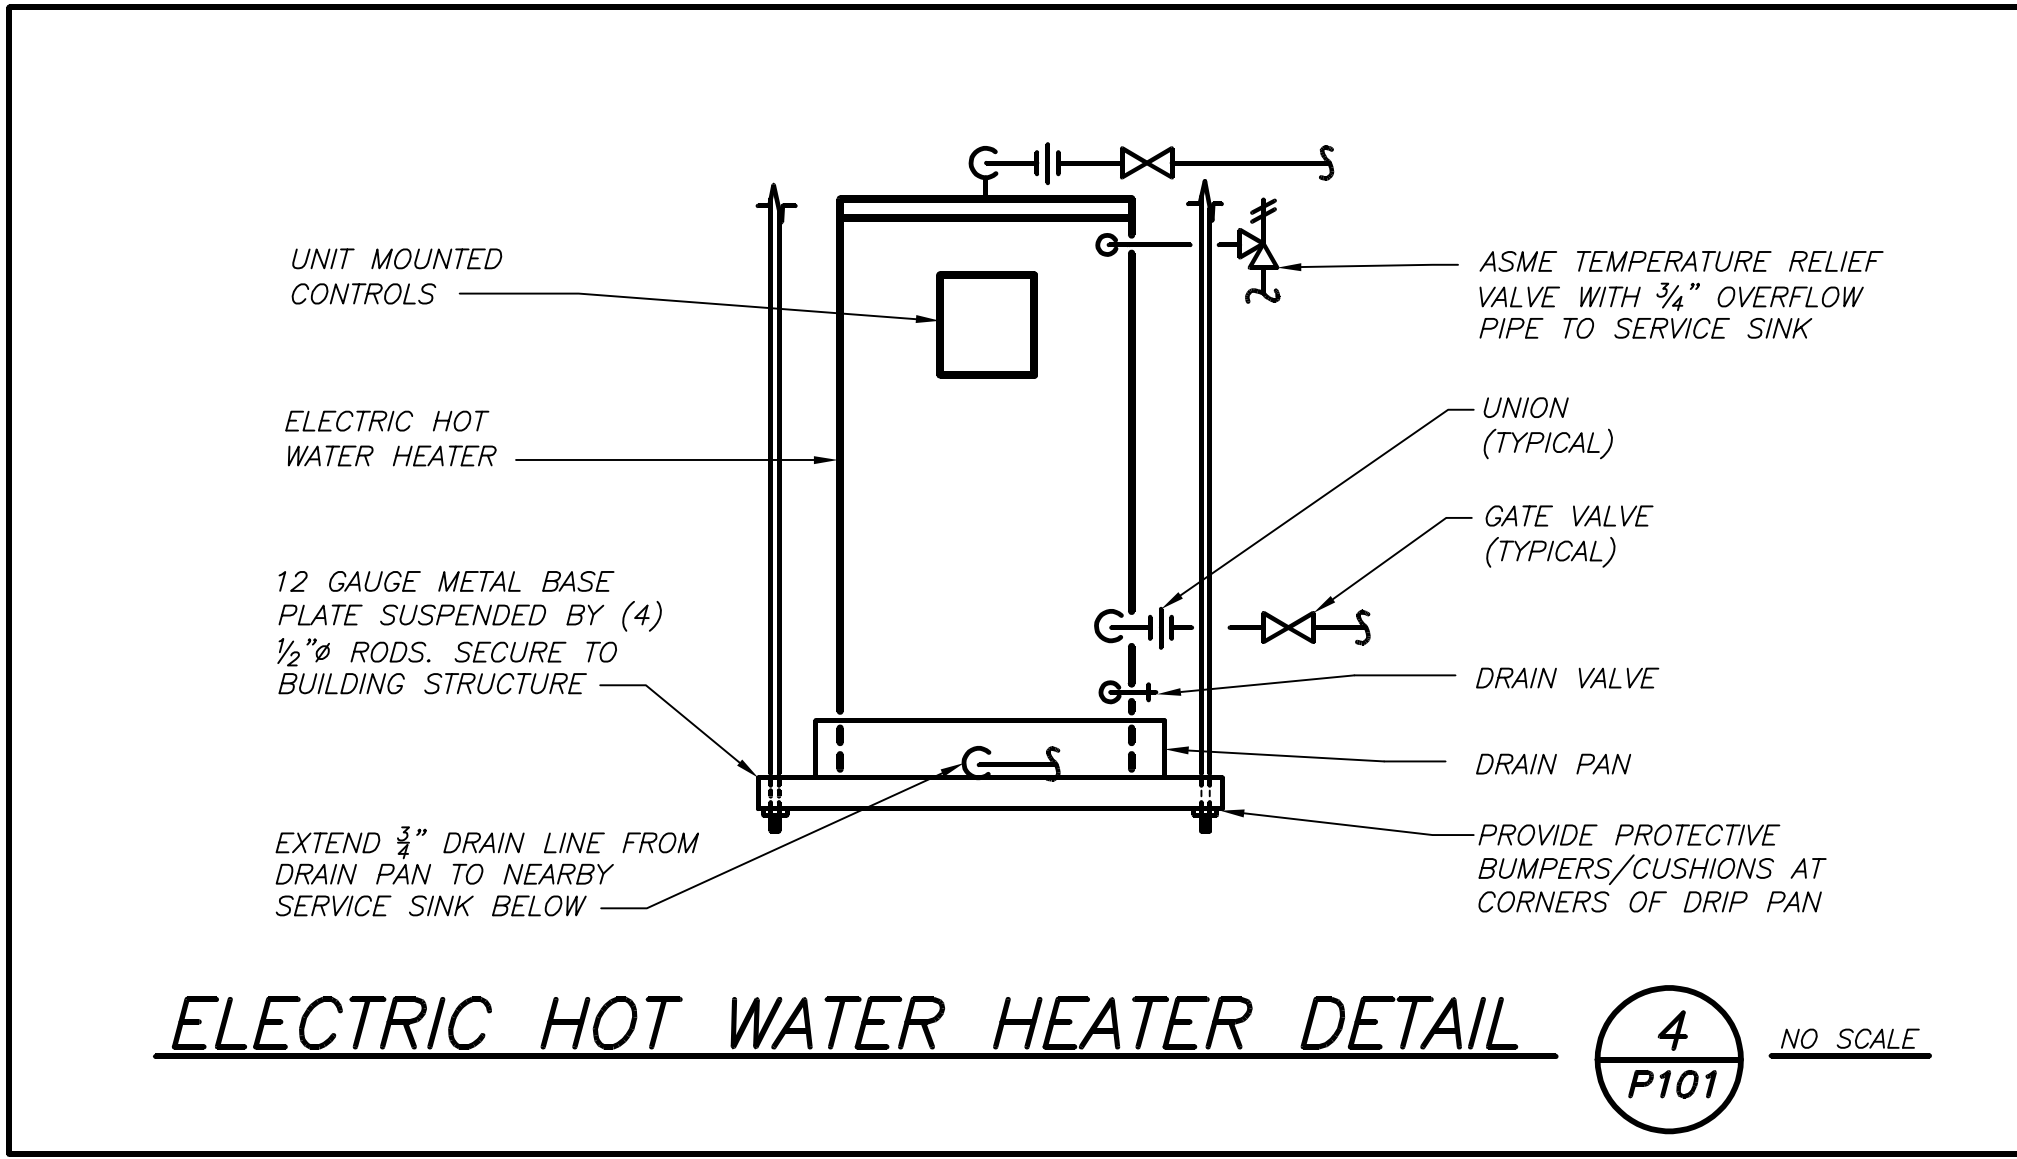
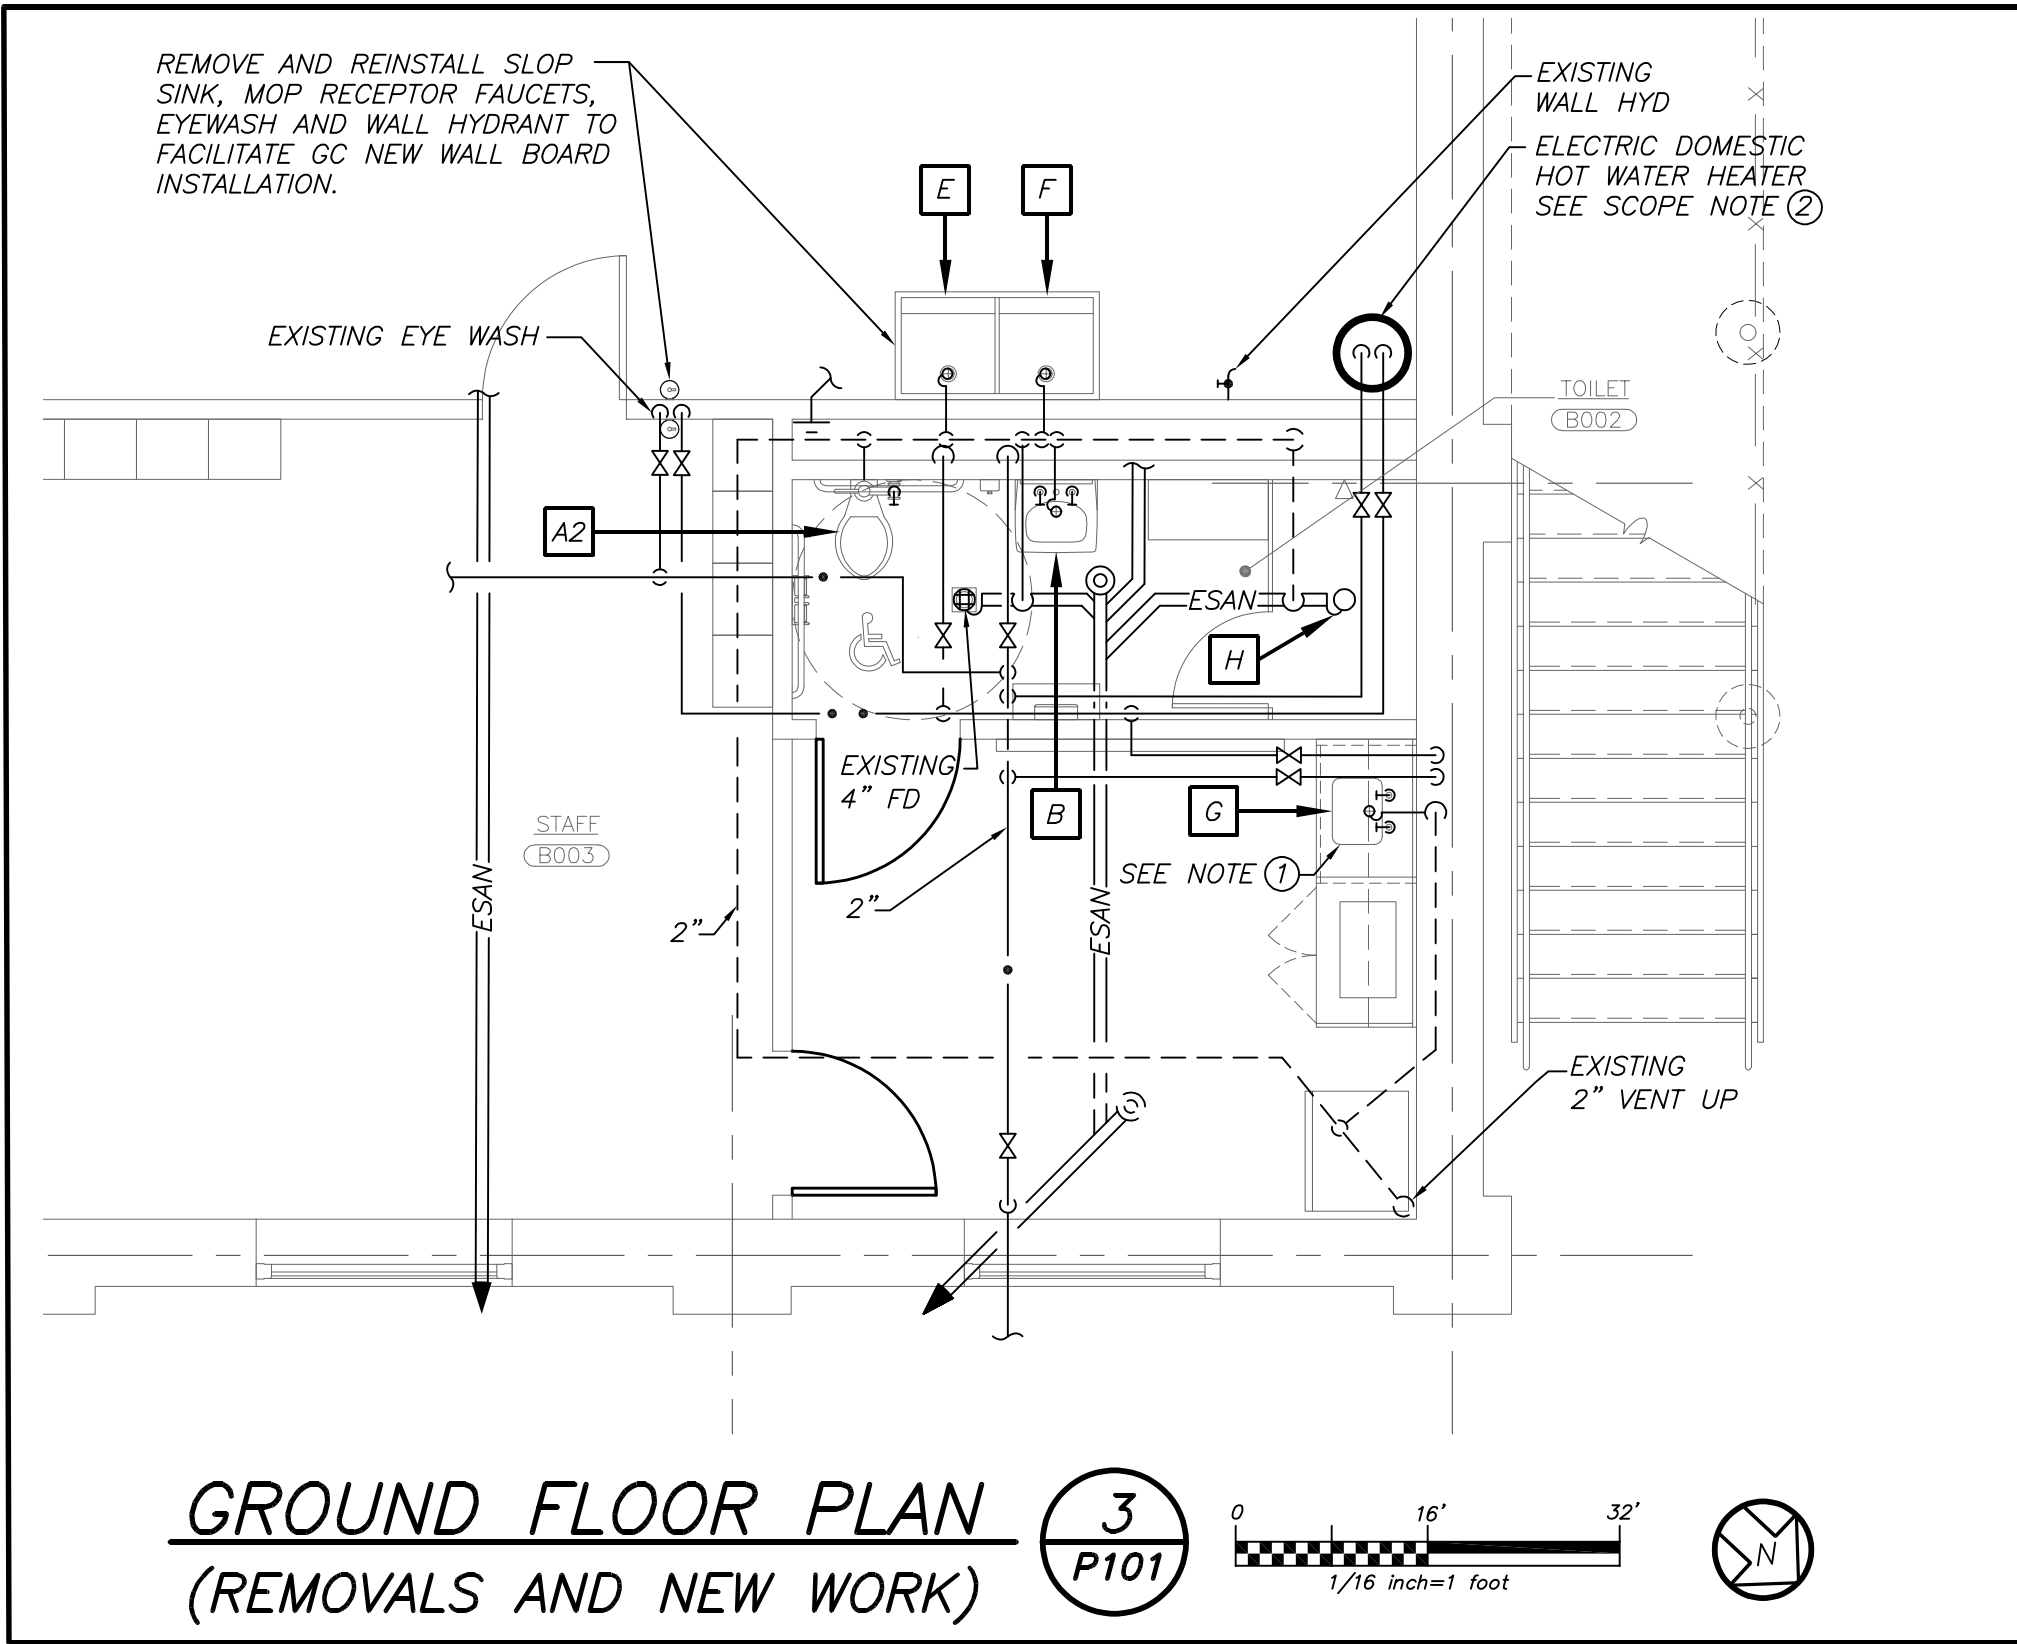
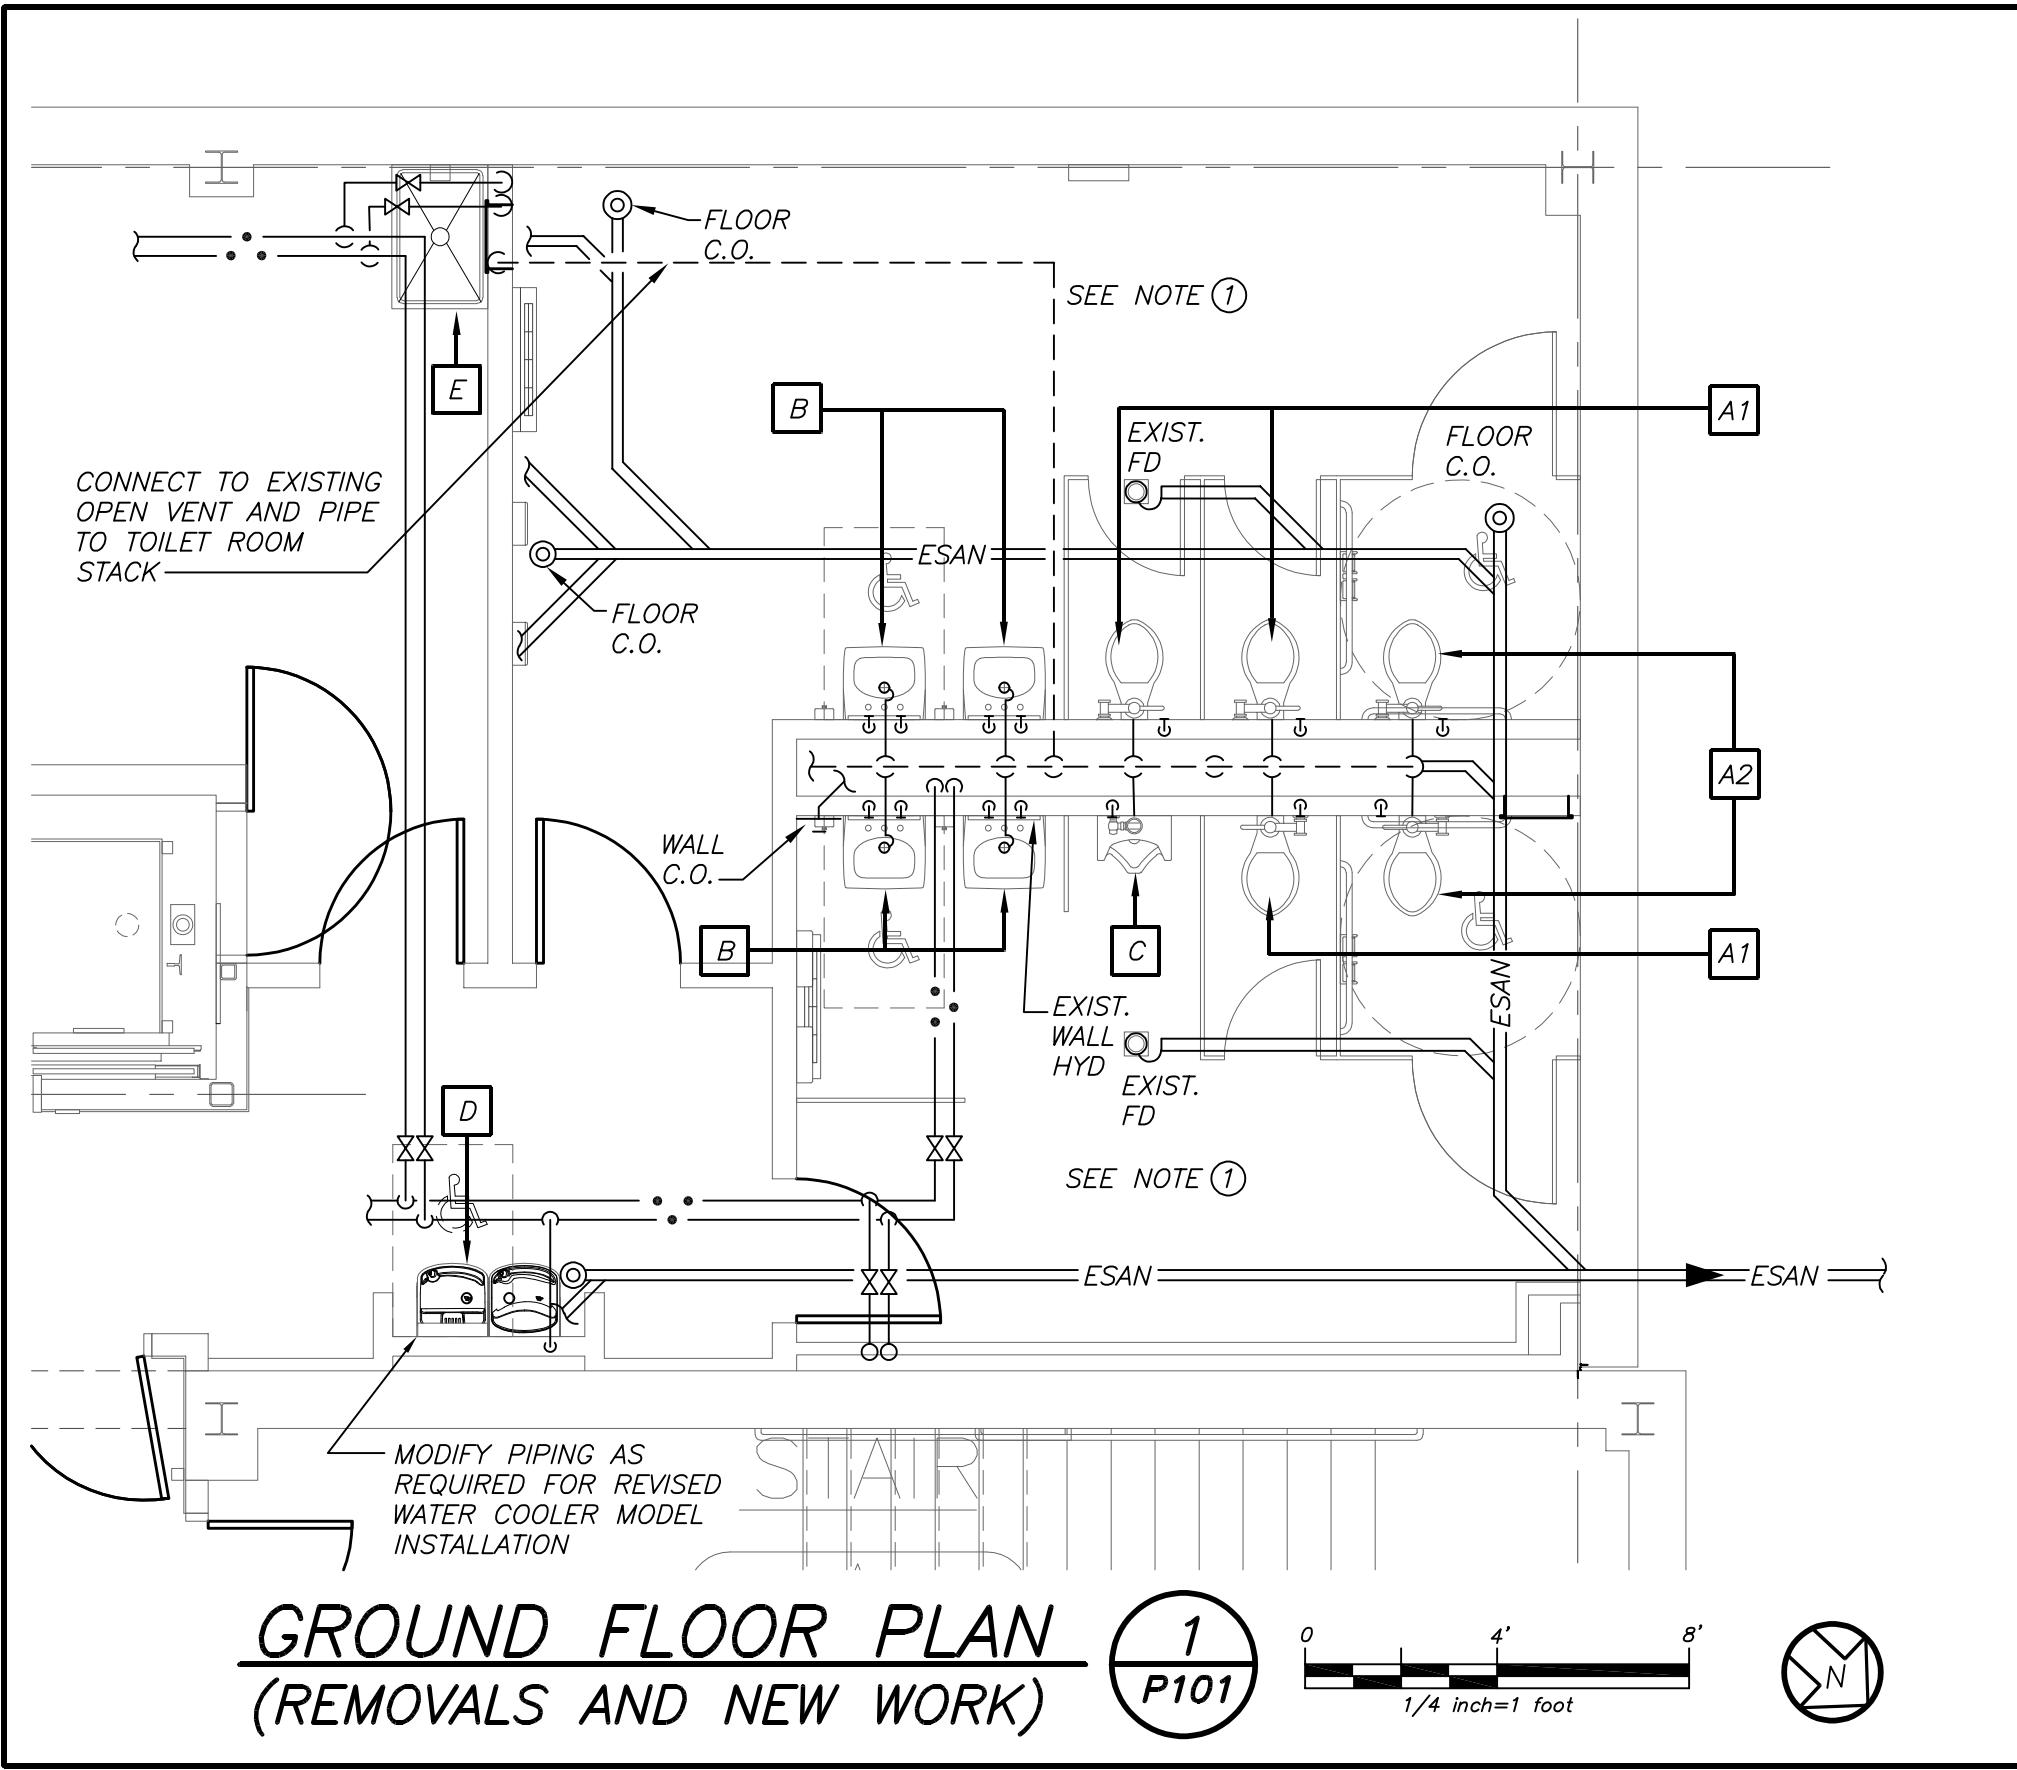
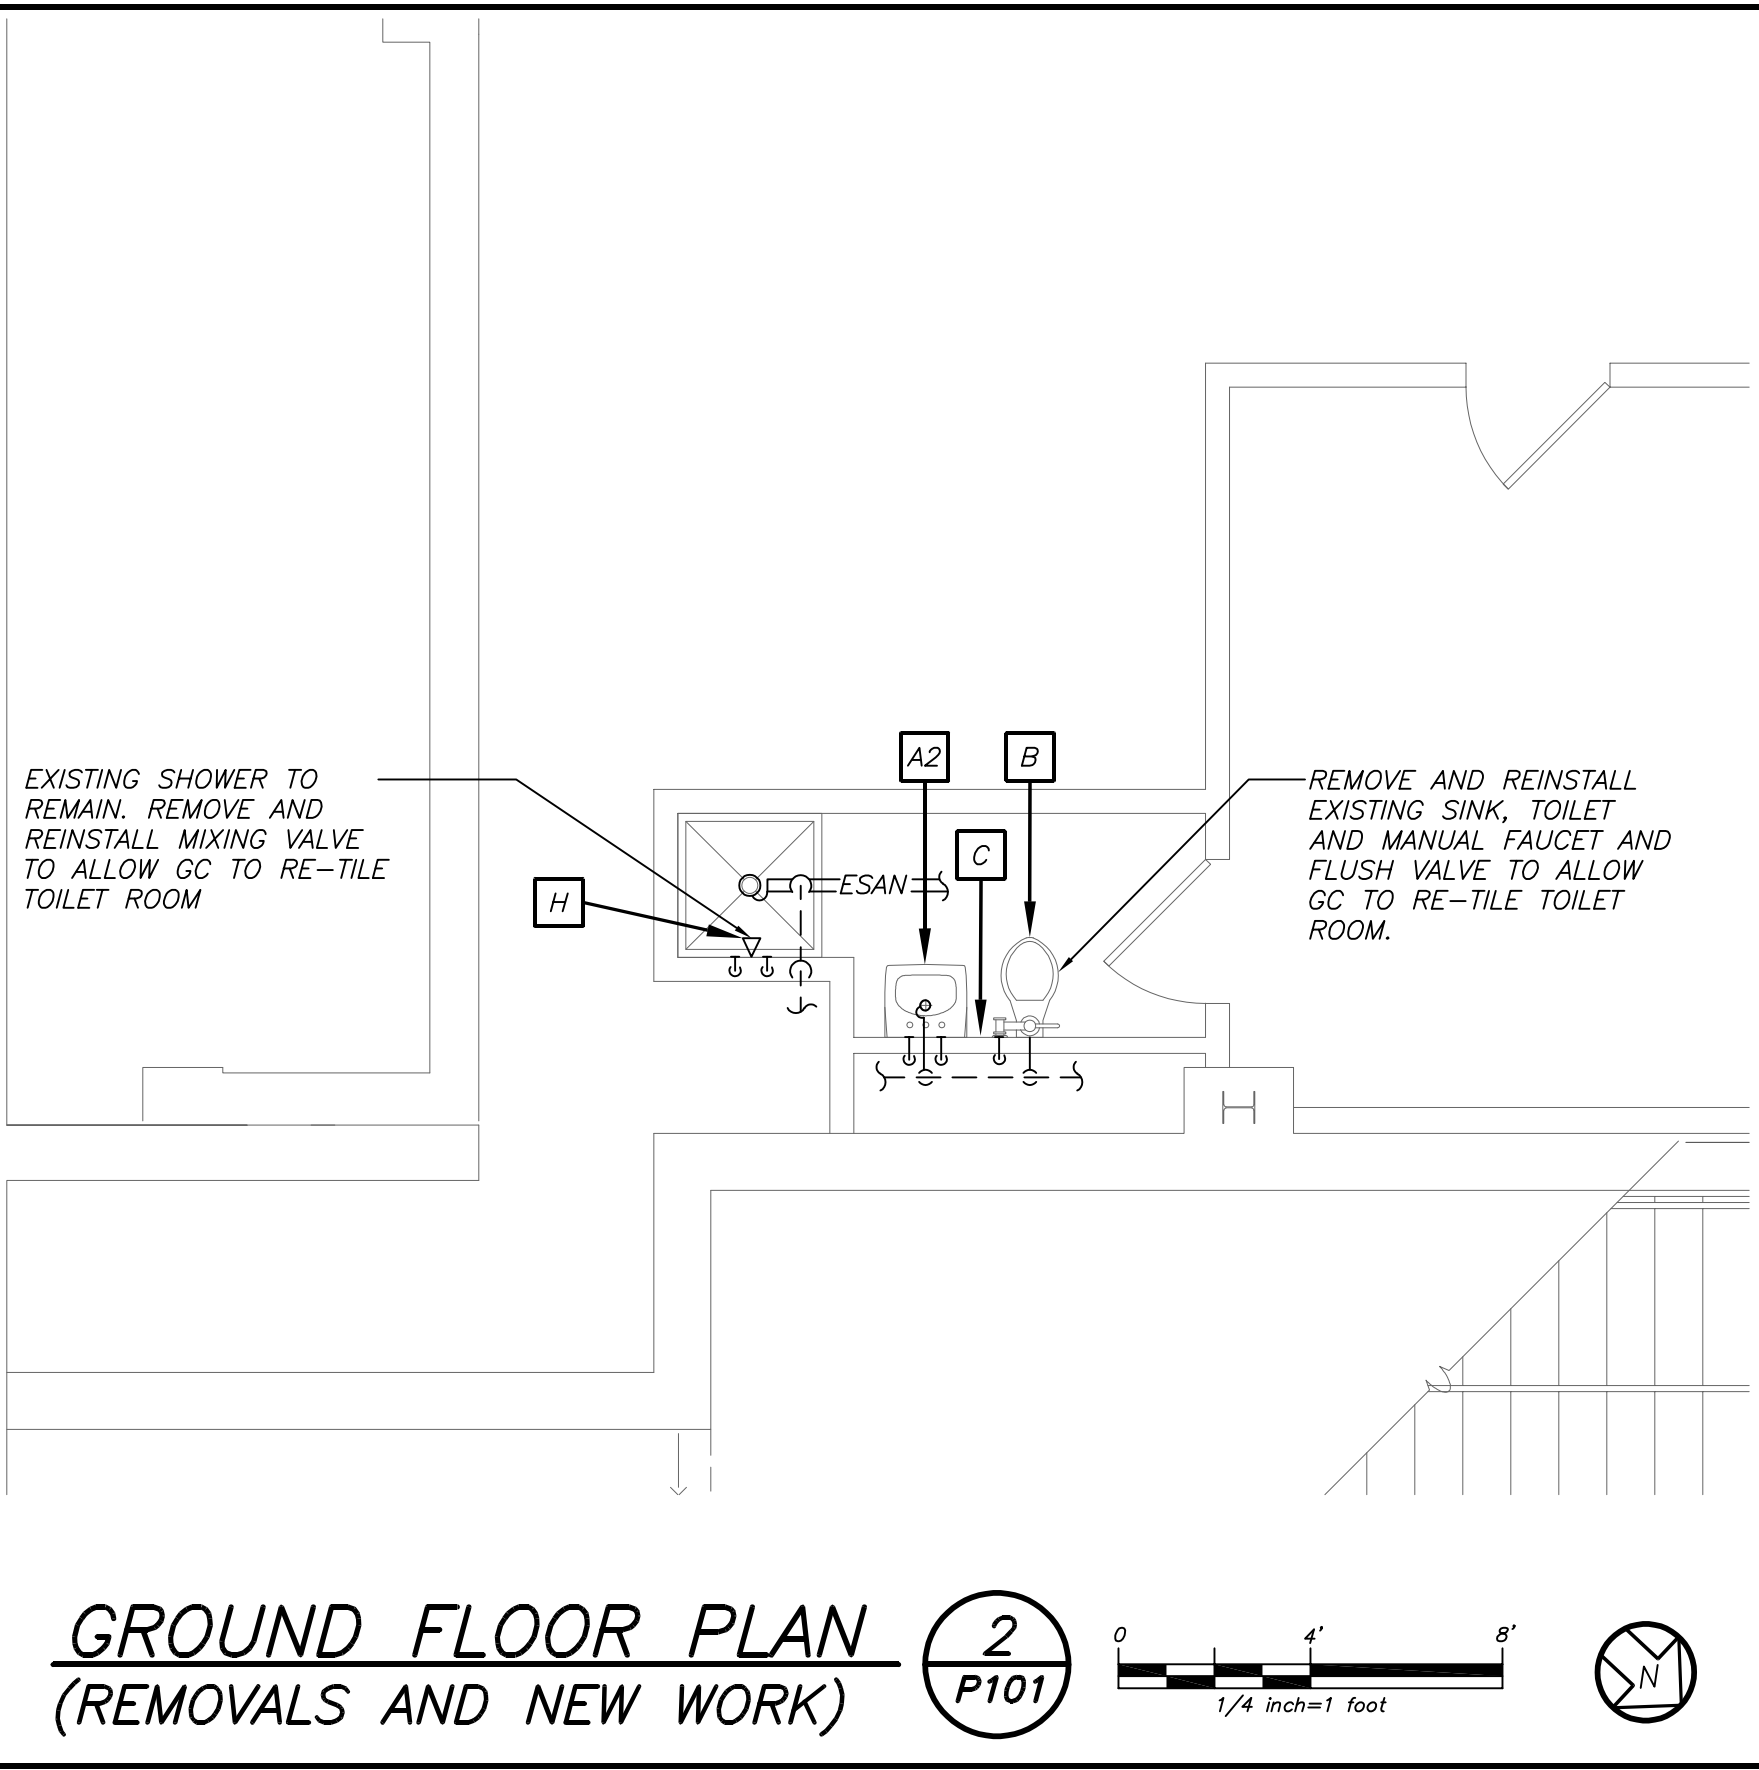
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ARCHITECTS  
PLANNERS



S.E.D. CONTROL NUMBER:  
JFK E.S. 06-19-04-035-000-016

PROJECT: JFC  
PORT CHESTER-RYE UNION FREE SCHOOL DISTRICT  
JOHN F. KENNEDY ELEMENTARY SCHOOL  
FLOOD REPAIRS & RELATED WORK  
DRAWING TITLE  
SCHEDULE DETAILS AND PART  
REMOVALS AND NEW WORK

10-18-2021  
DATE  
10-18-2021  
DATE  
SHEET SIZE  
30"x42"  
DRAWN BY  
BGA  
CHECKED BY  
BGA  
DRAWING NO.  
JFKES  
H102  
FILE NO.  
21444.01



LEGEND	
	EXISTING PIPING, FIXTURES, ETC. TO REMAIN
	EXISTING PIPING, FIXTURES, ETC. TO BE REMOVED
	NEW PIPING, FIXTURES, ETC.
	COLD WATER PIPING
	HOT WATER PIPING
	HOT WATER RETURN PIPING
	PLUMBING VENT PIPING
	SANITARY PIPING
	SANITARY PIPING (UNDERGROUND)
	EXISTING SANITARY PIPING
	EXISTING SANITARY PIPING (UNDERGROUND)
	FLOW DIRECTION WITHIN PIPE
	CLEANOUT
	CLEANOUT DECK PLATE
	SHUT-OFF VALVE
	COMBINATION BALANCING & SHUT-OFF VALVE
	CHECK VALVE
	PIPE CONNS. (BOTTOM; TOP 45 OR 90; PIPE UP)
	PLUMBING FIXTURE IDENTIFICATION
	PLUMBING CONTRACTOR
	G.C. GENERAL CONTRACTOR
	HVAC CONTRACTOR
	VTR VENT THRU ROOF
	FAI FRESH AIR INTAKE
	FD FLOOR DRAIN
	PRV PRESSURE REDUCING VALVE
	CIRCULATOR PUMP IDENTIFICATION
	SUMP PUMP IDENTIFICATION
	HOT WATER HEATER IDENTIFICATION
	POINT OF CONNECTION
	PART PLAN, DETAIL, SECTION NUMBER
	DRAWING NUMBER
	SECTION IDENTIFICATION

PLUMBING FIXTURE SCHEDULE	
SEE SCOPE NOTE #1 BELOW	
MARK	DESCRIPTION
A1	WALL MOUNTED WATER CLOSET (FLUSH VALVE)
A2	WALL MOUNTED WATER CLOSET (FLUSH VALVE) (HANDICAPPED)
B	WALL MOUNTED LAVATORY (HANDICAPPED)
C	URINAL - WALL MOUNTED
D	WATER COOLER (HANDICAPPED) - REMOVE & REPLACE WITH NEW
E	MOP RECEPTOR
F	SLOP SINK
G	PAENTRY SINK
H	SHOWER
X	EXISTING FIXTURE TO BE REMOVED
R	EXISTING FIXTURE TO REMAIN

REMOVAL NOTES	
①	REMOVE ALL PLUMBING FIXTURES, EQUIPMENT, SPECIALTIES, DRAINS, CONTROLS, HANGERS, BASES, SUPPORTS, PIPING, VALVES, TUBING AND PLUMBING ACCESSORIES THAT ARE NOT INCORPORATED IN THE NEW LAYOUT.
②	WHERE REMOVAL IS INDICATED OR IMPLIED OR NOT INCORPORATED IN THE NEW LAYOUT, THE ITEM ITSELF IS TO BE REMOVED COMPLETELY TOGETHER WITH ALL CONNECTING PIPING, SPECIALTIES, SUPPORTS, CONTROLS, ETC. CONNECTING PIPING IS TO BE REMOVED BACK TO MAINS WHERE THEY ARE TO BE CAPPED OR DISCONNECTED. THIS INCLUDES ALL GAS, SANITARY, VENT, WATER, COMPRESSED AIR, ACID WASTE, VACUUM, AND PUMP DISCHARGE PIPING. REFER TO DIVISION 1 OF SPECIFICATION FOR CUTTING AND PATCHING REQUIREMENTS.
③	WHERE EXISTING PIPING ENTERS INACCESSIBLE TRENCHES, TUNNELS, SHAFTS, WALLS AND CEILINGS INSIDE THE EXISTING BUILDING, IT SHALL BE CUT BACK AT LEAST 2" INTO SUCH INACCESSIBLE SPACES AND SHALL BE SUITABLY CAPPED AND SEALED BY THE CONTRACTOR.
④	THE CONTRACTOR SHALL EXERCISE NORMAL CAUTION TO PREVENT UNNECESSARY CUTTING AND DAMAGE TO THE EXISTING BUILDING. ANY EXCESSIVE DAMAGE AS DETERMINED BY THE OWNER SHALL BE REPAIRED AND PAID FOR BY THE CONTRACTOR CAUSING THE DAMAGE.
⑤	ALL DEMOLISHED EQUIPMENT ETC. EXCEPT THOSE ITEMS SPECIFICALLY REQUESTED BY THE OWNER SHALL BECOME THE CONTRACTORS PROPERTY, SHALL BE REMOVED FROM THE PREMISES, AND DISPOSED OF LEGALLY.


SCOPE NOTES	
①	RE-INSTALL ALL FIXTURES, WALL/FLOOR CLEANOUT COVERS, FLOOR DRAIN COVERS, ETC. REMOVED BY OWNER. RECONNECT FIXTURES TO EXISTING FIXTURES CARRIERS, ASSOCIATED WATER PIPING AND DRAIN CONNECTIONS. PROVIDE ALL NEW P-TRAPS, FLUSH VALVES, PIPE INSULATION (WHERE REMOVED OR DAMAGED). EACH PIPE DROP TO FIXTURE OR PIPE RISERS WILL REQUIRE A MINIMUM OF 36" OF PIPE INSULATION. ALL NEW PIPING INSULATION SHALL BE NEOPRENE TYPE.
②	REMOVE AND REPLACE EXISTING ELECTRIC DOMESTIC HOT WATER HEATER WITH NEW. CONNECT TO EXISTING ASSOCIATED PIPING. EXISTING HEATER SHALL BE PROTECTED AND TURNED OVER TO OWNER.

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S.E.D. CONTROL NUMBER:  
JFK E.S. 06-19-04-030-008-016

PROJECT: JPMCC  
JOHN F. KENNEDY ELEMENTARY SCHOOL  
FLOOD REPAIRS & RELATED WORK  
DRAWING TITLE  
LEGEND: SCHEDULES, NOTES AND REMOVAL AND NEW WORK

10-18-2021	BID
DATE	ISSUED TO
SHEET SIZE 30"x42"	DRAWING NO. JFKES P101
DRAWN BY BGA	CHECKED BY BGA
FILE NO. 21444.01	

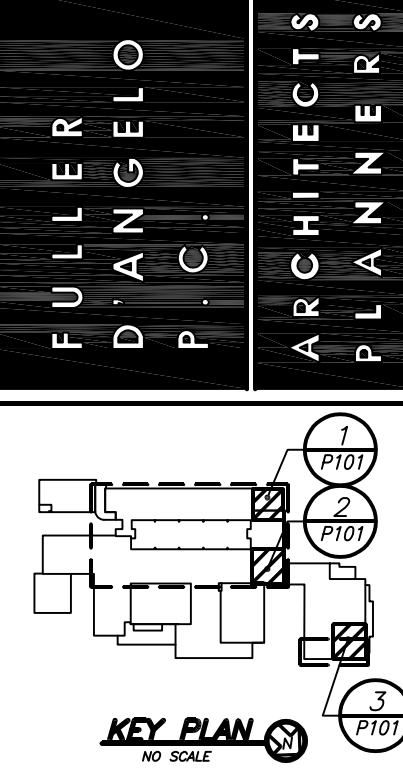

BEFORE FABRICATION THIS CONTRACTOR SHALL VERIFY ALL MEASUREMENTS AND CONDITIONS ON JOB AND COORDINATE HIS WORK WITH THE WORK OF ALL OTHER CONTRACTORS.

DBE: TAB: JFKES-E001 - Y:\PC-RYE UFSD\PC-Rye UFSD - JFK ES TS Ida Flood (2133.00)\Drawings\Electrical\213300E001.dwg - DATE: Oct 15, 2021 - 4:11pm

GENERAL NOTES	
1.	DRAWINGS ARE DIAGRAMMATIC AND INDICATE THE GENERAL ARRANGEMENT OF SYSTEMS AND WORK. CONTRACTOR SHALL FURNISH ALL NECESSARY OUTLETS, SUPPORTS, FITTINGS AND ACCESSORIES TO FULFILL APPLICABLE CODES, REGULATIONS, BUILDING STANDARDS AND THE BEST PRACTICES OF THE TRADE FOR FIRST CLASS ELECTRICAL INSTALLATION.
2.	THE DRAWINGS INDICATE SIZE AND GENERAL LOCATION OF WORK. SCALED DIMENSIONS SHALL NOT BE USED. THE EXACT LOCATION AND ELEVATION OF ALL ELECTRICAL EQUIPMENT SHALL BE COORDINATED IN FIELD WITH RESPECTIVE CONTRACTOR/OWNER.
3.	WHERE PANELBOARDS, SWITCHES, CIRCUIT BREAKERS, ETC. ARE EXISTING AND TO BE REUSED THE CONTRACTOR SHALL CLEAN AND REFURBISH THE EQUIPMENT. THIS SHALL INCLUDE TIGHTENING ALL CONNECTIONS, REPLACING DEFECTIVE MECHANISMS AND PROVIDING ALL REQUIRED AND NECESSARY MISCELLANEOUS COMPONENTS SO THAT THE EQUIPMENT SHALL BE IN PERFECT WORKING ORDER.
4.	THE CONTRACTOR SHALL COORDINATE WITH THE OWNER PRIOR TO SUBMISSION OF BID TO DETERMINE WHAT WORK MUST BE PERFORMED AFTER NORMAL BUSINESS HOURS. UNLESS OTHERWISE DIRECTED ANY NOISY WORK (CHOPPING, CORE DRILLING, HAMMERING, ETC.) AND BUILDING POWER INTERRUPTIONS SHALL BE PERFORMED OUTSIDE OF NORMAL BUSINESS HOURS. CONFIRM NORMAL BUSINESS HOURS WITH BUILDING OWNER. NO ADDITIONAL COST WILL BE CHARGED TO OWNER FOR WORK PERFORMED OUTSIDE NORMAL BUSINESS HOURS.
5.	ALL WORK WHERE SHOWN WITH DARK/SOLID LINES ON THE DRAWINGS IS NEW UNLESS OTHERWISE NOTED. WHERE SHOWN WITH DASHED LINES WITH LETTER (E) IS EXISTING TO REMAIN, WITH LETTER (R) IS EXISTING TO BE REMOVED, WITH LETTER (ER) IS EXISTING RELOCATED, WITH LETTER (RN) IS EXISTING TO BE REPLACED WITH NEW AND WITH LETTER (RR) IS EXISTING TO BE REMOVED AND RELOCATED.
6.	CIRCUIT NUMBERS TO EXISTING PANELS ARE SHOWN FOR INTENT ONLY. ACTUAL CIRCUIT NUMBERS TO BE USED SHALL BE AS PER FIELD CONDITIONS BY UTILIZING SPARE CIRCUITS, BREAKERS OR SPACES IN EXISTING PANEL, SIZE AS INDICATED ON THE PLANS. THE ELECTRICAL CONTRACTOR SHALL BALANCE LOAD OF CIRCUITS EVENLY ON ALL PHASES.
7.	FEEDERS AND BRANCH CIRCUITRY SHALL BE RUN IN MINIMUM 3/4" CONDUIT UNLESS OTHERWISE NOTED. FINAL CONNECTIONS TO MOTORS MAY BE MADE WITH FLEXIBLE METALLIC CONDUIT (NO LONGER THAN 18"), IN UNFINISHED AREAS CONDUIT SHALL BE RUN EXPOSED AND IN FINISHED AREAS CONDUIT SHALL BE RUN CONCEALED.
8.	PROVIDE PANEL NAME PLATE MADE OF BLACK LAMINATED PLASTIC WITH WHITE ENGRAVED LETTERING AND TYPE WRITTEN DIRECTORY FOR ALL NEW AND EXISTING PANELS BEING USED FOR THIS PROJECT.
9.	ALL CONDUCTORS SHALL BE COPPER, TYPE THHN/THWN INSULATED. ALL CONDUCTORS SHALL HAVE 600 VOLT RATED INSULATION UNLESS OTHERWISE NOTED.
10.	REFER TO ARCHITECT'S REFLECTED CEILING PLAN FOR EXACT LOCATION OF ALL CEILING MOUNTED LIGHTING FIXTURES AND OTHER CEILING INSTALLED ITEMS.
11.	THE USE OF FLEXIBLE CONDUIT FROM LIGHTING FIXTURES TO JUNCTION BOX IS PERMITTED ONLY WHEN A SEPARATE GROUND WIRE IS INSTALLED WITH THE CONDUCTORS INSIDE FLEXIBLE CONDUIT. THE GROUND WIRE MUST BOND THE FIXTURE HOUSING TO THE JUNCTION BOX. MAXIMUM LENGTH 6'-0".
12.	EXACT LOCATION AND MOUNTING HEIGHTS OF ALL DEVICES SHALL BE COORDINATED WITH THE ARCHITECT PRIOR TO THE INSTALLATION.
13.	WALL MOUNTED EQUIPMENT (SWITCHES, RECEPTACLES, ETC.) SHALL BE SURFACE MOUNTED IN UNFINISHED AREAS AND ON EXISTING CONCRETE BLOCK WALLS AND FLUSH MOUNTED IN NEW WALLS/PARTITIONS.
14.	CONDUIT RUNS SHALL BE PARALLEL WITH OR AT RIGHT ANGLES TO WALLS AND CEILINGS. CONDUIT SHALL BE SUPPORTED BY APPROVED MEANS. SUPPORTS FOR HORIZONTAL RUNS OF CONDUIT SHALL NOT EXCEED SEVEN FEET ON CENTERS.
15.	PROVIDE PULL BOXES, JUNCTION BOXES, CONDUIT ELBOWS AND OFFSETS TO SUIT FIELD CONDITIONS AND THE NATIONAL ELECTRICAL CODE.
16.	CONTRACTOR SHALL COORDINATE WITH THE FIRE DEPARTMENT AND F.A. VENDOR BEFORE PROCEEDING WITH WORK INVOLVING FIRE ALARM SYSTEM.
17.	ALL EMPTY CONDUIT SHALL BE PROVIDED WITH A DRAGWIRE.
18.	THE MINIMUM WIRE SIZE FOR 120 VOLT BRANCH CIRCUITS SHALL BE NO. 12 AWG, EXCEPT OVER 100' IN LENGTH SHALL BE NO. 10 AWG.
19.	PROVIDE ALL REQUIRED AND NECESSARY ACCESSORIES (EX. CONNECTORS, ADAPTERS, BUSHINGS, CLAMPS, ETC.) TO FACILITATE COMPLETE INSTALLATION.
20.	THE ELECTRICAL CONTRACTOR SHALL CONFIRM THE CONFIGURATION TYPE FOR ALL SPECIAL RECEPTACLES FOR COPIERS, DATA PROCESSING EQUIPMENT, ETC. WITH OWNER AND ENGINEER PRIOR TO ORDERING.
21.	COORDINATE LOCATION OF ALL MECHANICAL EQUIPMENT WITH HVAC CONTRACTOR IN FIELD. FUSES FOR ALL MOTOR LOADS SHALL BE DUAL ELEMENT TIME DELAY TYPE.
22.	ALL JUNCTION OR OUTLET BOXES SHALL BE INSTALLED SO AS TO ALLOW ACCESS TO COVER PERMITTED ARCHITECT APPROVED ACCESS DOORS OR PLATES AS REQUIRED IN AREAS WHERE UNOBSTRUCTED ACCESS TO BOX OR OUTLET IS NOT POSSIBLE.
23.	PRIOR TO ORDERING LIGHTING FIXTURES, COORDINATE WITH ARCHITECTURAL DRAWINGS AND SPECIFICATIONS. IF DISCREPANCIES EXIST BETWEEN ARCHITECTURAL AND ENGINEERING INFORMATION OBTAIN CLARIFICATION PRIOR TO PROCEEDING.
24.	PRIOR TO ANY CHASING, CHOPPING OR CORE DRILLING BEING PERFORMED, THE CONTRACTOR SHALL FIELD INVESTIGATE CONDITIONS AND COORDINATE ALL WORK TO ENSURE THAT IT WILL BE IN HARMONY AND NOT AFFECT ANY EXISTING BUILDING SYSTEMS. THIS WORK MUST BE APPROVED BY BUILDING OWNER PRIOR TO PROCEEDING.
25.	OPENINGS AROUND ELECTRICAL PENETRATIONS THROUGH FIRE RESISTANCE RATED WALLS, PARTITIONS, FLOORS OR CEILINGS SHALL BE FIRE STOPPED USING APPROVED METHODS. ALL SLEEVES MUST HAVE BUSHINGS. SEALANT SHALL BE 3 HOUR FIRE BARRIER #CP-25 (NO LESS THAN 3" THICK BACKED UP WITH MINERAL WOOL).
26.	ALL PANELBOARD COVERS SHALL BE INSTALLED IN PLACE AT THE COMPLETION OF EACH DAYS WORK.
27.	PREPARE "AS-BUILT" DRAWINGS THAT REFLECT ACTUAL CONSTRUCTION AND SHOW DEVIATIONS FROM DESIGN DRAWINGS.
28.	LIGHT FIXTURES SHALL BE CONSTRUCTED TO SUIT PARTICULAR TYPE OF CEILING AND WALL CONSTRUCTION AND SHALL BE PROVIDED WITH APPROPRIATE TRIMS, MOUNTING FRAMES AND ADAPTERS AS REQUIRED.
29.	ALL NEW CIRCUIT BREAKERS INSTALLED INTO EXISTING PANELBOARDS SHALL BE UL LISTED FOR USE IN THE PANEL.


TEST CAT. 6 CABLE (TELEPHONE & DATA), P.A. WIRING & FIRE ALARM CABLE

1. **PAIRED AND MULTI-CONDUCTOR METALLIC CABLES: PERFORM AN END-TO-END TEST FOR CONTINUITY, GROUND FAULT, SHORTS AND CROSSED PAIRS FOR EACH CABLE PAIR/CONDUCTOR.**
  - A. **TEST CABLE PAIRS FROM THE WORK AREA OUTLET, THROUGH ALL CONDUCTORS TO PATCH BOARD IN DATA CLOSET/RACK ROOM.**
  - B. **TEST FIRE ALARM CABLE LOOP FROM DEVICE TO DEVICE BACK TO FIRE ALARM CONTROL PANEL.**

GENERAL REMOVAL NOTES	
1.	BEFORE COMMENCING WORK, EXAMINE ALL ADJOINING AREAS THAT MAY BE AFFECTED BY REMOVAL. REPORT TO THE GENERAL CONTRACTOR ANY CONDITION THAT PREVENTS PERFORMANCE OF THE WORK.
2.	BECOME THOROUGHLY FAMILIAR WITH EXISTING CONDITIONS WHERE CONNECTIONS MUST BE MADE, CHANGED OR ALTERED. THE INTENT OF THE WORK IS SHOWN ON THE DRAWINGS AND DESCRIBED HEREINAFTER AND NO CONSIDERATION WILL BE GRANTED BY REASON OF LACK OF FAMILIARITY ON THE PART OF THE CONTRACTOR WITH ACTUAL PHYSICAL CONDITIONS AT THE SITE. INSPECT EACH AND EVERY AREA AFFECTED BY THE ALTERATION OF THE SPACE BEFORE SUBMITTAL OF BID.
3.	ALL ELECTRICAL EQUIPMENT IN THE AREA OF WORK IS EXISTING TO BE REMOVED UNLESS OTHERWISE NOTED. THIS SHALL INCLUDE BUT NOT BE LIMITED TO THE FOLLOWING: <ol style="list-style-type: none"><li>A. DISTRIBUTION BOARDS AND PANELBOARDS.</li><li>B. LIGHTING FIXTURES AND SWITCHES.</li><li>C. CIRCUIT BREAKERS AND DISCONNECT SWITCHES.</li><li>D. RECEPTACLES, OUTLETS AND DEVICES.</li></ol>
4.	ALL CONDUCTORS AND CONDUIT ASSOCIATED WITH REMOVED ELECTRICAL EQUIPMENT SHALL BE REMOVED COMPLETELY BACK TO ITS SOURCE OF POWER AND DISCONNECTED.
5.	ALL POWER CONDUCTORS, CONTROL WIRING AND CONDUIT ASSOCIATED WITH MECHANICAL EQUIPMENT SUCH AS FANS, AIR CONDITIONING UNITS, PUMPS, ETC. DESIGNATED FOR REMOVAL ON THE HVAC AND PLUMBING REMOVAL DRAWINGS SHALL BE REMOVED CLEAR BACK TO THE SOURCE OF POWER AND DISCONNECTED. ALL MOTOR STARTERS, DISCONNECT SWITCHES, CONTROL DEVICES, ETC. SHALL BE REMOVED. REFER TO MECHANICAL AND PLUMBING DRAWINGS FOR ADDITIONAL INFORMATION.
6.	CIRCUIT BREAKERS AND/OR SWITCHES IN PANELBOARD(S) OR DISTRIBUTION BOARD(S) MADE SPARE DUE TO REMOVAL SHALL BE DESIGNATED AS SUCH ON THE PANEL SCHEDULE.
7.	THE ELECTRICAL CONTRACTOR SHALL BE RESPONSIBLE TO TRACE AND RELOCATE ALL EXISTING FEEDERS AND BRANCH CIRCUIT WIRING WHICH PASSES THROUGH THE REMOVAL AREA THAT SERVE EXISTING OCCUPIED SPACES TO REMAIN. COORDINATE WITH BUILDING MANAGER PRIOR TO ANY SHUTDOWNS OR DISRUPTIONS THAT MAY BE REQUIRED TO ACCOMPLISH THIS WORK.
8.	DISPOSE OF ALL REMOVED EQUIPMENT, WHICH IS NOT INTENDED TO BE REUSED. PRIOR TO DISPOSAL, CONTACT BUILDING MANAGER TO DETERMINE IF ANY REMOVED EQUIPMENT IS DESIRED FOR STOCK.
9.	EXISTING CIRCUIT BREAKERS IN PANEL(S) ARE TO BE RE-USED. ELECTRICAL CONTRACTOR TO DISCONNECT PANEL AND CIRCUIT BREAKERS WITH GREAT CARE TO ENSURE AGAINST DAMAGE. THIS CONTRACTOR SHALL PROVIDE NEW CIRCUIT BREAKERS AS REQUIRED. ALL NEW CIRCUIT BREAKERS INSTALLED INTO EXISTING PANELBOARDS SHALL BE UL LISTED FOR USE IN THE PANEL.
10.	EXISTING EQUIPMENT DESIGNATED FOR REUSE SHALL BE CLEANED, REFURBISHED AND RESTORED TO OPTIMUM PERFORMANCE. THIS SHALL INCLUDE BUT NOT LIMITED TO CLEANING OF LIGHT FIXTURES, REPLACEMENT OF INOPERABLE BALLASTS AND LAMPS, RESISTANCE TESTING OF BRANCH CIRCUITRY AND FEEDERS, ETC.
11.	EXTEND EXISTING CIRCUITRY TO THOSE DEVICES THAT ARE TO BE RELOCATED. MATCH EXISTING TYPE AND SIZE. RELOCATION OF EXISTING EQUIPMENT SHALL BE PERFORMED ONLY UPON OWNERS ACCEPTANCE OF EXISTING EQUIPMENT.
12.	EXTEND EXISTING CIRCUITS SERVING EQUIPMENT TO REMAIN FROM PANELS THAT ARE TO BE REMOVED TO NEW PANELS OR EXISTING PANELS THAT ARE TO REMAIN.

ABBREVIATIONS	
ABBV.	DESCRIPTION
A	AMP/AMPERE
AC	AIR CONDITIONING UNIT
A.F.F.	ABOVE FINISHED FLOOR
AHU	AIR HANDLING UNIT
AWG	AMERICAN WIRE GAUGE
C	CONDUIT
C.B.	CIRCUIT BREAKER
CH	CABINET HEATER
A.F.F.	ABOVE FINISHED FLOOR
CKT	CIRCUIT
CU	CONDENSING UNIT
CP	CONDENSATE PUMP
(E)	EXISTING TO REMAIN
E.C.	ELECTRICAL CONTRACTOR
EF	EXHAUST FAN
EM	EMERGENCY
(ER)	EXISTING RELOCATED
EXIST.	EXISTING
FA	FIRE ALARM
F.A.C.P.	FIRE ALARM CONTROL PANEL
F.C.O	FUSE CUT OUT
G.GRD	GROUND
GFI	GROUND FAULT INTERRUPTER
HVAC	HEATING, VENTILATING AND AIR-CONDITIONING UNIT
HHW	HOT WATER HEATER
HWP	HOT WATER HEATING PUMP
kcml	THOUSAND CIRCULAR MILLS
KV	KILOVOLT
KVA	KILOVOLT AMPERE
KW	KILOWATT
LTG	LIGHTING
MCB	MAIN CIRCUIT BREAKER
MDP	MAIN DISTRIBUTION PANEL
MLO	MAIN LUGS ONLY
MTD	MOUNTED
NTS	NOT TO SCALE
P.A.	PUBLIC ADDRESS
P.NL	PANEL
(R)	REMOVE EXISTING
RAH	ROOF TOP AIR HANDLING UNIT
RECPT	RECEPTACLE
RF	RETURN FAN
(RN)	REPLACE EXISTING W/NEW
(RR)	REMOVE AND REINSTALL
SF	SUPPLY FAN
TYP.	TYPICAL
UH	UNIT HEATER
U.O.N.	UNLESS OTHERWISE NOTED
UPS	UNINTERRUPTABLE POWER SYSTEM
UV	UNIT VENTILATOR
W	WATT
WP	WEATHERPROOF

LEGEND	
	CLOSED CIRCUIT TELEVISION CAMERA (CCTV). REFER TO SPECIFICATION SECTION 01 6190-3.1, MATRIX OF BUILDING SYSTEM RESPONSIBILITIES, FOR ADDITIONAL SCOPE OF WORK.
	KEY FOB. PROVIDE (1) CAT 6 CABLE TO NEAREST PATCH PANEL.
	WIRELESS ACCESS POINT. REFER TO SPECIFICATION SECTION 01 6190-3.1, MATRIX OF BUILDING SYSTEM RESPONSIBILITIES, FOR ADDITIONAL SCOPE OF WORK.
	FLUSH WALL MOUNTED DATA OUTLET CONSISTING OF (2) PORT STAINLESS STEEL COVER PLATE WITH LABEL WINDOW AND 1 1/4" CONDUIT WITH (2) CAT 6 CABLE STUBBED UP 6" ABOVE FINISHED CEILING WITH BUSHINGS. PROVIDE (2) RJ-45 FEMALE BULKHEADS. CAT 6 CABLES TO TERMINATE INTO PATCH PANEL AT NEAREST IDF/MDF CLOSET. # INDICATES NUMBER OF PORTS/CABLES/BULKHEADS. REFER TO SPECIFICATION SECTION 01 6190-3.1, MATRIX OF BUILDING SYSTEM RESPONSIBILITIES, FOR ADDITIONAL SCOPE OF WORK.
	FLUSH WALL MOUNTED COMBINATION TELEPHONE/DATA OUTLET CONSISTING OF A 3 PORT STAINLESS STEEL COVER PLATE WITH LABEL WINDOW AND 1 1/4" CONDUIT WITH (2) CAT 6 CABLE AND (1) CAT 6 CABLE FOR VOIP STUBBED UP 6" ABOVE CEILING WITH BUSHINGS. PROVIDE (3) RJ-45 FEMALE BULKHEADS FOR DATA. CAT 6 CABLES TO TERMINATE INTO PATCH PANEL AT NEAREST IDF/MDF CLOSET. REFER TO SPECIFICATION SECTION 01 6190-3.1, MATRIX OF BUILDING SYSTEM RESPONSIBILITIES, FOR ADDITIONAL SCOPE OF WORK.
	FLUSH WALL MOUNTED TELEPHONE OUTLET CONSISTING OF A STAINLESS STAINLESS STEEL COVER PLATE WITH RJ-11 MODULE WITH 1" CONDUIT (1) #22 GAUGE UTP PHONE CABLE STUBBED UP 6" ABOVE CEILING WITH BUSHINGS. PROVIDE COVER PLATE WITH WHITE RJ-11 MODULE. PHONE CABLE SHALL TERMINATE INTO EXISTING PBX BOX. REFER TO SPECIFICATION SECTION 01 6190-3.1, MATRIX OF BUILDING SYSTEM RESPONSIBILITIES, FOR ADDITIONAL SCOPE OF WORK.
	EXISTING WALL MOUNTED CLOCK.
	FOR CALL-IN FUNCTION.
	WALL MOUNTED P.A. SPEAKER MATCH EXISTING.
	SURFACE MOUNTED P.A. HORN SPEAKER.
	CEILING RECESS MOUNTED P.A. SPEAKER MATCH EXISTING U.O.N.
	VOLUME ATTENUATOR.
	SURFACE MOUNTED WIREMOLD V700 FOR EITHER RECEPTACLE OR COMMUNICATION WIRING. REFER TO DRAWINGS FOR ADDITIONAL INFORMATION.
	TAG SYMBOL. NUMERAL DENOTES REFERENCE TO A WORK NOTE.
	TEACHER'S WALL STATION, CONSISTS OF TWO GANG AV WALL BOX (HUBBELL #HBL985), HUBBELL ISTATION MODULAR DOUBLE FACEPLATE WITH LABELS (HUBBELL #IMF2XX), CONTAINING (1) HDMI 110 UTP VIDEO EXTENDER (SOURCE) DECORATOR TYPE FEMALE ADAPTER (HUBBELL #ISFH110XX), (3) ISTATION SINGLE PORT WITH KEYSTONE OPENING (HUBBELL #IMK1XX) WITH RJ45 FEMALE BULKHEADS (HUBBELL #HJXBXX) - (2) RJ45 DATA CAT. 6 CABLE (BLUE) AND (1) RJ45 FOR VOIP CONNECTION CAT. 6 CABLE (PURPLE), ALSO PROVIDE (2) CAT. 6 CABLE (BLUE) FROM HDMI FEMALE ADAPTER TO SMART BOARD HDMI ADAPTER. (PROVIDE STAINLESS STEEL COVER PLATE. DEVICE COLOR TO BE SELECTED BY OWNER/ARCH. INCLUDE ALL ASSOCIATED ACCESSORIES FOR A COMPLETE SYSTEM.
	SMART BOARD WALL STATION, CONSISTS OF 4-GANG IN-WALL ENCLOSURE WITH NEW WORK STUD BRACKETS AND COVER CONTAINING CABLE EXIT (HUBBELL #NS4V124M, NS4V12C, NS4V10W), (2) DUPLEX RECEPTACLES (HUBBELL #ISOFPT9), (2) HUBBELL ISTATION MODULAR FACEPLATE WITH LABELS (HUBBELL #IMF1XX)HDMI 110 UTP VIDEO EXTENDER (DISPLAY) DECORATOR TYPE FEMALE ADAPTER (HUBBELL #ISFH110XX), (1) ISTATION SINGLE PORT WITH KEYSTONE OPENING (HUBBELL #IMK1XX) WITH RJ45 FEMALE BULKHEAD (HUBBELL #HJXBXX) FOR (1) RJ45 DATA CAT. 6 CABLE (BLUE) AND (2) BLANKS (HUBBELL #B1XX). ALSO HDMI ADAPTER WILL BE WIRED TO "HDV" AT TEACHERS DESK AS INDICATED ABOVE. DEVICE COLOR TO BE SELECTED BY OWNER/ARCH. INCLUDE ALL ASSOCIATED ACCESSORIES FOR A COMPLETE SYSTEM.
	RESCUE ASSISTANCE CALL STATION AS INDICATED ON PLAN.
	AREA OF REFUGE LIGHTING
	RESCUE ASSISTANCE REMOTE ANNUNCIATOR
	RESCUE ASSISTANCE ANNUNCIATOR PANEL
MECHANICAL EQUIPMENT IDENTIFICATION:	
	EQUIPMENT ABBREVIATION (FE, SF, HV, ETC. SEE ABBREVIATIONS ON THIS DWG.)
	EQUIPMENT NUMBER
DETAIL/PART PLAN NUMBER IDENTIFICATION:	
	DETAIL/PART PLAN NUMBER
	DRAWING NUMBER

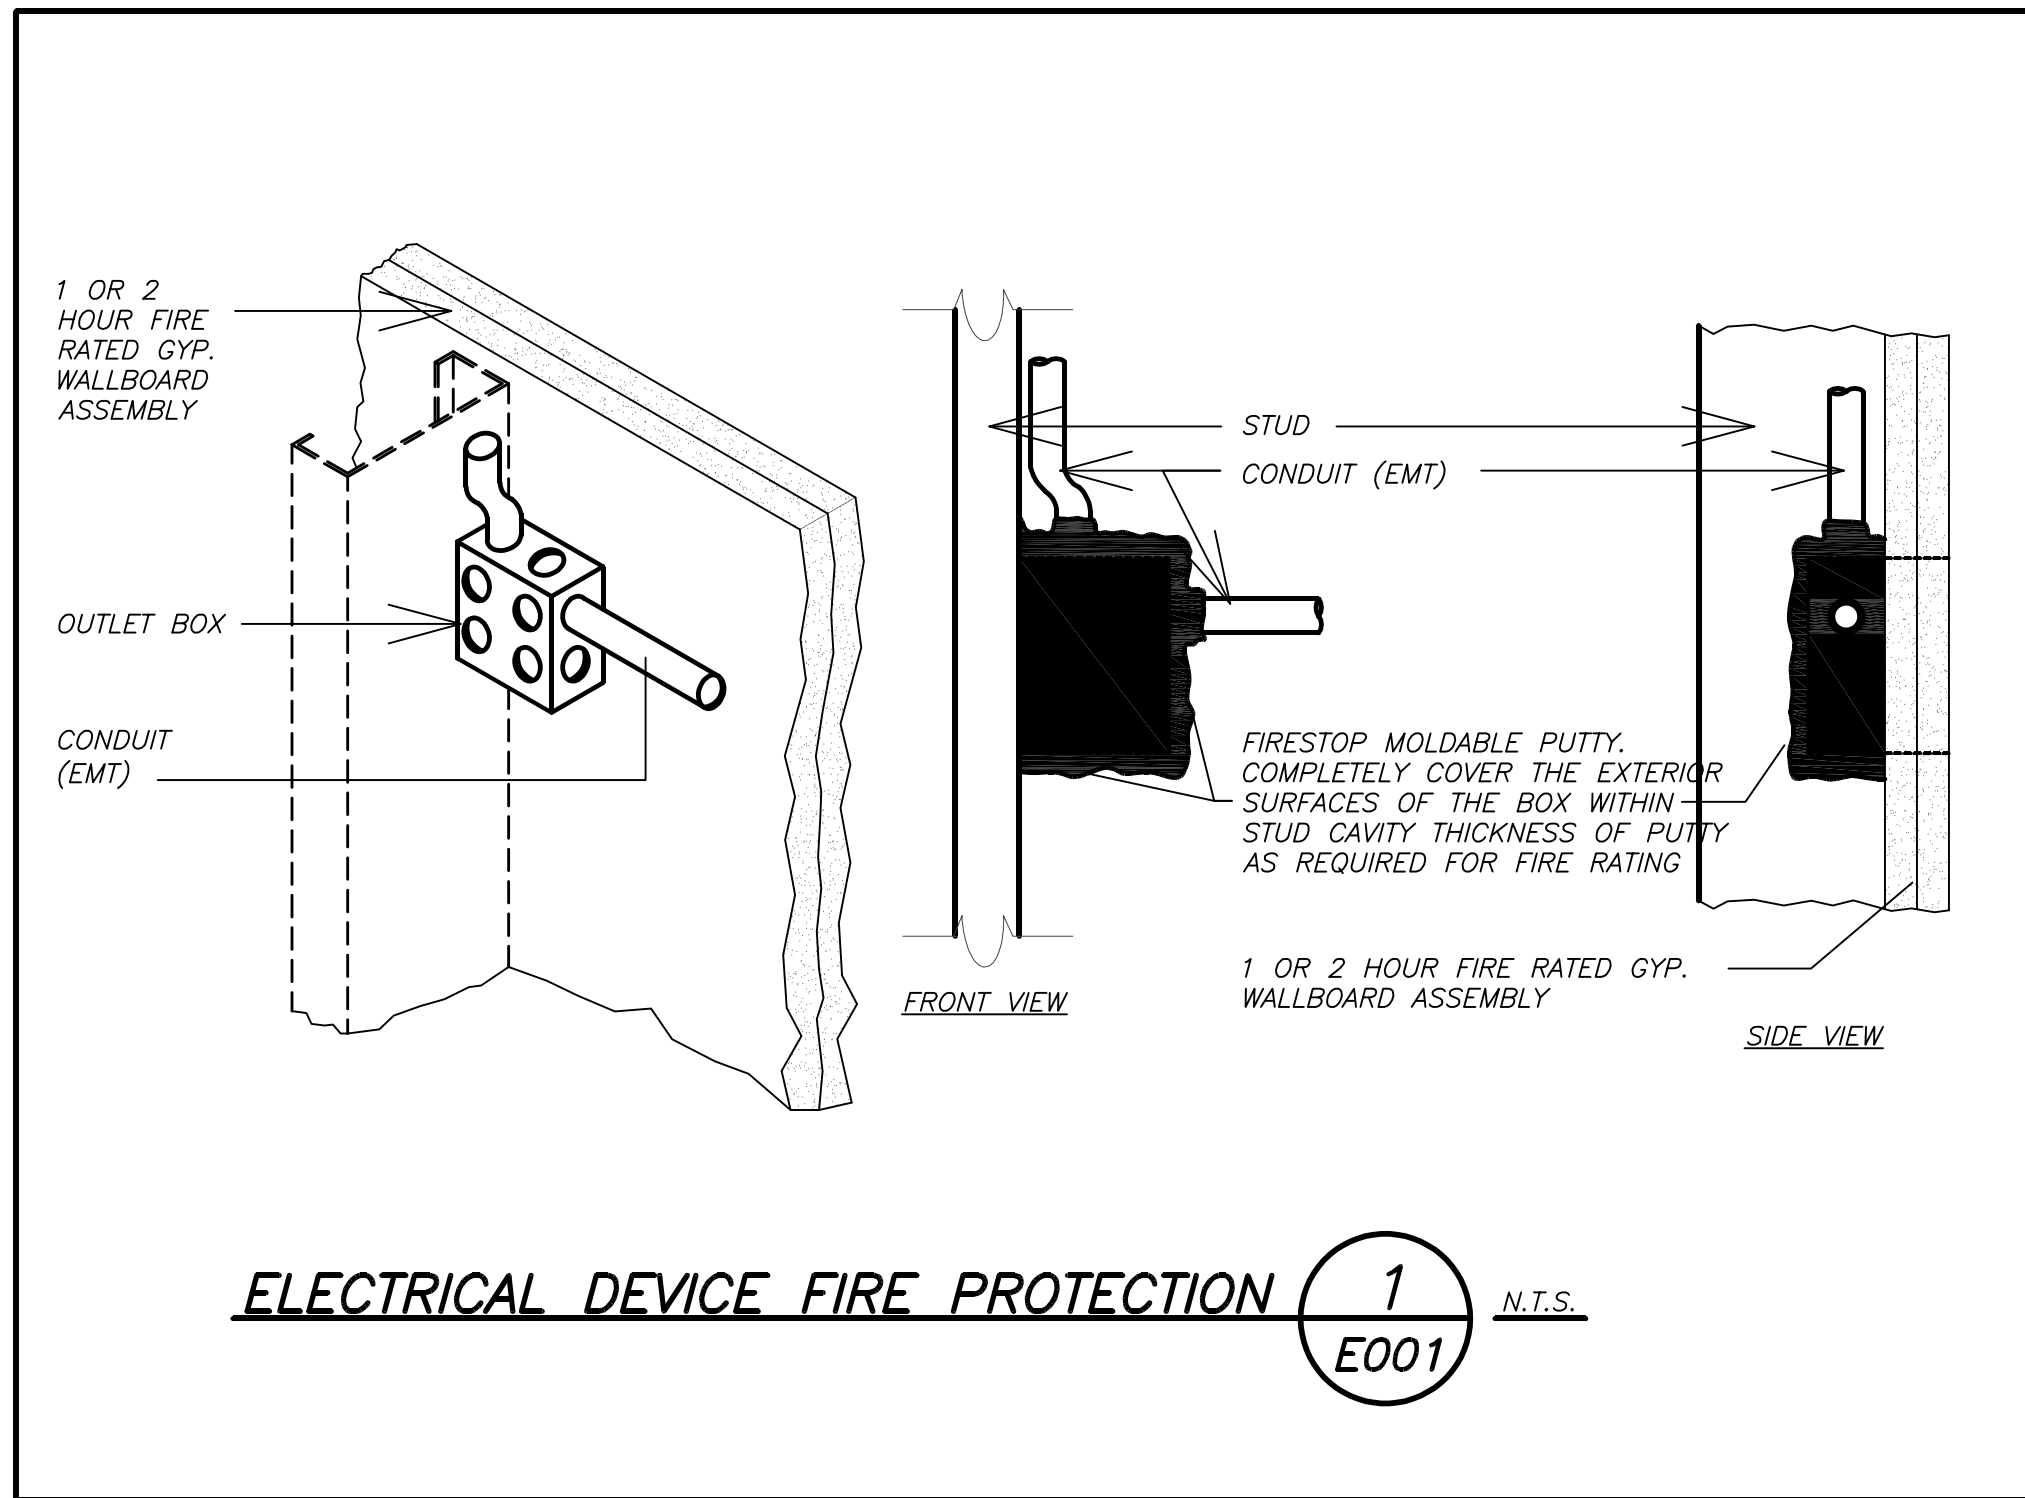

LEGEND	
	2'x2' FLUORESCENT CEILING MOUNTED FIXTURE. CAPITAL LETTER INDICATES TYPE, LOWER CASE LETTER INDICATES SWITCH CONTROL. REFER TO LIGHTING FIXTURE SCHEDULE FOR DETAIL.
	CEILING/WALL MOUNTED EXIT LIGHT WITH OUTLET BOX, DIRECTIONAL ARROWS SHADED PORTION INDICATES ILLUMINATED FACE. SCHEDULE DENOTES TYPE.
	WALL MOUNTED EMERGENCY LIGHT FIXTURE WITH INTEGRAL BATTERY BACK-UP.
	CEILING/WALL MOUNTED COMBO EXIT/EMERGENCY BATTERY PACK LIGHT WITH OUTLET BOX, DIRECTIONAL ARROWS SHADED PORTION INDICATES ILLUMINATED FACE. SCHEDULE DENOTES TYPE.
	FLUSH WALL MOUNTED LIGHTING CONTROL SWITCH CONTROLLING ZONE "G", "K" WHERE USED INDICATES KEY SWITCH. '3' INDICATES 3 WAY SWITCH.
	FLUSH WALL MOUNTED LIGHTING CONTROL TOGGLE SWITCH.
	CEILING MOUNTED DUAL TECHNOLOGY SENSOR, SIMILAR TO WATTSTOPPER MODEL# DT-300, MANUAL ON, AUTO OFF, WORK WITH LOCAL WALL SWITCH.
	CEILING MOUNTED ULTRASONIC SENSOR, SIMILAR TO WATTSTOPPER MODEL# WT-2250, WITH LONG CORRIDOR COVERAGE PATTERN INCLUDE POWER PACK. AUTO ON, AUTO OFF, WORK WITH LOCAL KEY SWITCHES.
	WALL RECESS MOUNTED DUAL TECHNOLOGY VACANCY SENSOR, SIMILAR TO WATTSTOPPER MODEL# DSW-100, MANUAL ON, AUTO OFF.
	NETWORK DIGITAL ROOM CONTROLLER FOR LIGHTING CONTROL. SIMILAR TO WATTSTOPPER MODEL LMRC-213. HOT WIRE TO LOAD, CAT 5 WIRE CONNECTIONS TO CONTROL DEVICES. RC# DENOTES LMRC-21# WITH # OF ZONES.
	NETWORK DIGITAL CEILING MOUNTED DUAL TECHNOLOGY OCCUPANCY SENSOR, SIMILAR TO WATTSTOPPER MODEL LMDC-100. WORKS WITH DIGITAL ROOM CONTROLLER.
	NETWORK DIGITAL CEILING MOUNTED SINGLE ZONE PHOTO SENSOR. SINGLE ZONE PHOTO SENSOR. SIMILAR TO WATT STOPPER MODEL LMS-400. WORKS WITH ROOM CONTROLLER.
	NETWORK DIGITAL FLUSH MOUNTED PRESET WALL STATIONS, SIMILAR TO WATTSTOPPER MODEL LMSW-102, WORKS WITH DIGITAL ROOM CONTROLLER. INCLUDES BUTTON ENGRAVING. WS# DENOTES LMSW-10# WITH # OF BUTTONS. SUPERScript '3' DENOTES 3 WAY SWITCH.
	EMERGENCY LIGHTING UL924 RELAY. PROVIDE WATTSTOPPER ELCU-200 MODULE FOR EMERGENCY LIGHT FUNCTION FOR INTERIOR LIGHTING AND LVS MODEL #EPC-D FOR EXTERIOR LIGHTING FIXTURES.
	SURFACE MOUNTED SINGLE ZONE PHOTO SENSOR WITH LONG RANGE. SIMILAR TO HUBBELL #DLCP01.
	EXTERIOR WALL MOUNTED SINGLE ZONE PHOTO SENSOR. SIMILAR TO HUBBELL #DLCP00.
	WALL MOUNTED OCCUPANCY SENSOR DEDICATED FOR MOTORIZED CURTAIN, ONE ON EACH SIDE OF THE CURTAIN AS SHOWN
	CEILING/WALL MOUNTED JUNCTION BOX.
	FLUSH FLOOR MOUNTED JUNCTION BOX
	HOMERUN TO DESIGNATED PANEL, ARROWHEAD INDICATES SINGLE POLE CIRCUIT. HOMERUN SHALL CONSIST OF 2#12-3/4" U.O.N.
	HOMERUN TO DESIGNATED PANEL, NUMBERS IN PARENTHESIS INDICATE MULTIPLE CIRCUIT, I.E. 3-HOTS AND 1-GROUND U.O.N.
	EXISTING TO REMAIN
	NEW
	125V-2P-3W-20A GROUNDED TYPE, SPECIFICATION GRADE WALL MOUNTED DUPLEX RECEPTACLE HUBBELL #5362.
	SAME AS ABOVE EXCEPT DOUBLE DUPLEX RECEPTACLE.
	DEDICATED OUTLET. OUTLET SHALL BE AS DESIGNATED ON DRAWING.
	20A FLUSH WALL MOUNTED GROUND FAULT INTERRUPTING TYPE DUPLEX RECEPTACLE HUBBELL #GF5362.
	125V-2P-3W-20A ISOLATED GROUND TYPE, SPECIFICATION GRADE CEILING MOUNTED DUPLEX RECEPTACLE HUBBELL #5362.
	125V-2P-3W-20A GROUNDED TYPE, SPECIFICATION GRADE CEILING MOUNTED DUPLEX RECEPTACLE.
	SURFACE MOUNTED ELECTRICAL PANELBOARD.
	SURFACE MOUNTED EXISTING ELECTRICAL PANELBOARD.
	HEAVY DUTY TYPE DISCONNECT SWITCH WITH FINAL FLEXIBLE EQUIPMENT CONNECTION. 240 INDICATES VOLTAGE, 3 INDICATES NO. OF POLES, 60 INDICATES AMPERE RATING, NF INDICATES NON-FUSED(OR FUSE SIZE) U.O.N. REFER TO SPECIFICATION AND DRAWINGS FOR ENCLOSURE. WP WHERE USED INDICATES WEATHERPROOF ENCLOSURE (NEMA 3R).
	VARIABLE FREQUENCY DRIVE; FURNISHED BY MECHANICAL CONTRACTOR, WIRED AND INSTALLED BY ELECTRICAL CONTRACTOR. THE CONDUIT AND WIRING FROM VFD TO MECHANICAL UNIT INTER CONNECTION SHALL MATCH THE SAME SIZE AND CONDUIT AND WIRE FROM VFD TO DESIGNATED PANELBOARD. REFER TO PANEL SCHEDULE OR NOTES FOR CONDUIT WIRE AND SIZE.
	THERMAL SWITCH, CUTLER-HAMMER MS SERIES MANUAL STARTERS SINGLE-PHASE 20AMP, 120V U.O.N. WHERE INDICATED WITH "WP" PROVIDE WEATERTIGHT ENCLOSURE TYPE 3.
	208 VOLT, SINGLE PHASE 2 POLE, THERMAL OVERLOAD PROTECTED TOGGLE TYPE SWITCH. SIMILAR TO Eaton #AH4361 + #AH2794GG NEMA 1 ENCLOSURE.
	MOTOR (F.B.O. WIRED BY ELEC.) - NUMBER INDICATES HORSEPOWER. REFER TO PANEL SCHEDULES FOR WIRING AND OVER CURRENT PROTECTION.
	WALL MOUNTED COMBINATION FIRE ALARM BELL/STROBE DEVICE.
	WALL MOUNTED COMBINATION FIRE ALARM SPEAKER/STROBE DEVICE.
	WALL MOUNTED FIRE ALARM MANUAL PULL STATION
	DUCT MOUNTED PHOTOELECTRIC TYPE SMOKE DETECTOR WITH (REMOTE) CONTROL RELAY MODULE FOR FAN SHUT DOWN. RELAY MODULE TO BE MOUNTED ADJACENT TO MECHANICAL EQUIPMENT. ALSO PROVIDE LOAD RELAY AS REQUIRED IF EXISTING DISCONNECT/STARTERS DO NOT HAVE A SET OF DRY CONTACTS TO TIE-IN FOR FAN SHUTDOWN.
	CEILING MOUNTED IONIZATION TYPE SMOKE DETECTOR
	CEILING MOUNTED COMBINATION CARBON MONOXIDE AND SMOKE DETECTOR WITH SOUNDER BASE
	CEILING MOUNTED HEAT DETECTOR
	CEILING MOUNTED COMBINATION CARBON MONOXIDE AND HEAT DETECTOR WITH SOUNDER BASE
	WALL MOUNTED FIRE ALARM STROBE LIGHT.
	FIRE ALARM CONTROL PANEL.
	FIRE SMOKE DAMPER
	ELECTROMAGNETIC DOOR HOLDER. REFER TO SPECIFICATION SECTION 01 6190-3.1 FOR SCOPE OF WORK MATRIX.
	INTERFACE MODULE CONSISTING OF CONTROL RELAY AND MONITOR MODULES. IN NEMA 1 ENCLOSURE. ALSO PROVIDE LOAD RELAY AS REQUIRED IF EXISTING DISCONNECT/STARTERS DO NOT HAVE A SET OF DRY CONTACTS TO TIE-IN FOR FAN SHUTDOWN.
	SPRINKLER WATER FLOW SWITCH.
	SPRINKLER TAMPER SWITCH.

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KEY PLAN  
NO SCALE

S.E.D. CONTROL NUMBER:  
JFK ES 06-19-04-004-008-018

PROJECT: JPMCC  
PORT CHESTER-RYE UNION FREE SCHOOL DISTRICT  
JOHN F. KENNEDY ELEMENTARY SCHOOL  
FLOOD REPAIRS & RELATED WORK  
40-0018A STREET PORT CHESTER, NY 10573

DRAWING TITLE  
ELECTRICAL LEGEND, NOTES AND ABBREVIATIONS

10-18-2021  
DATE

BID  
ISSUED TO

SHEET SIZE  
30"x42"

DRAWING NO.  
JFKES  
E001

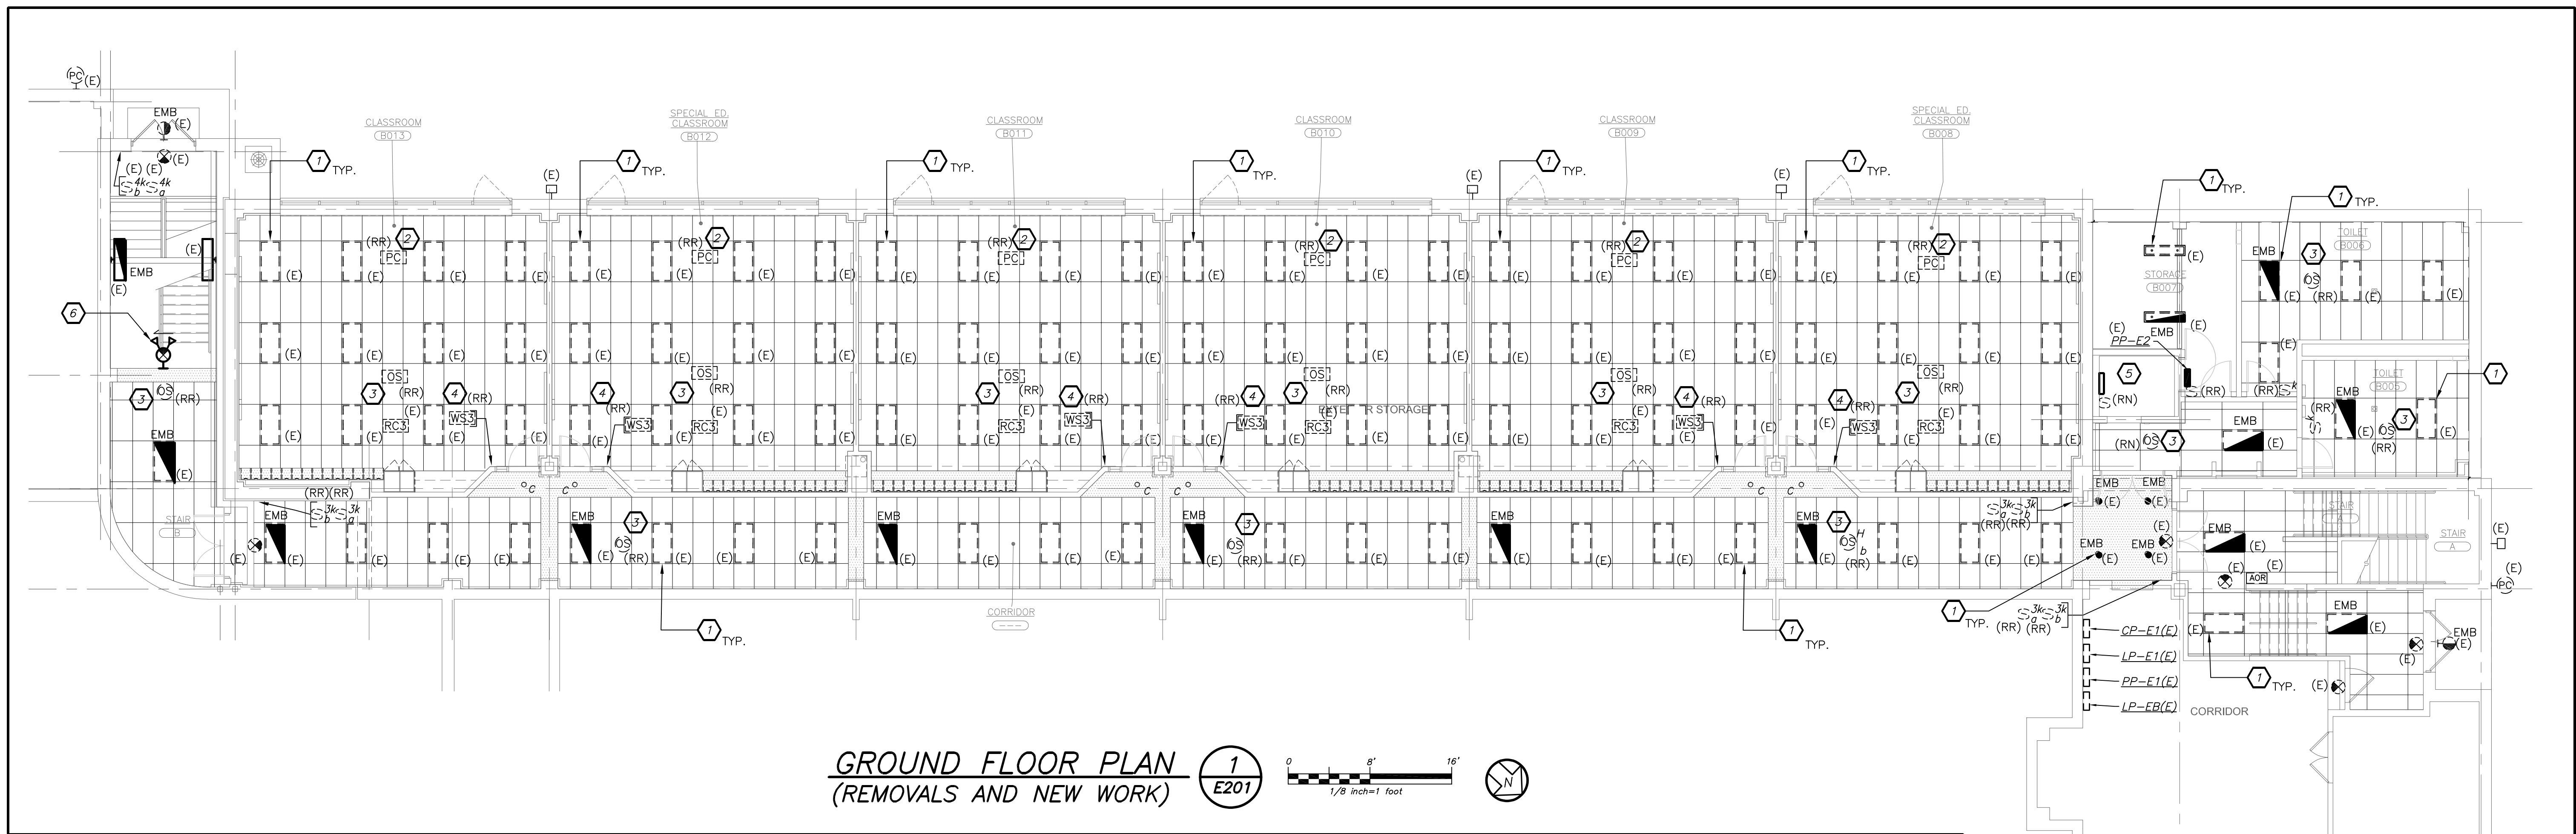
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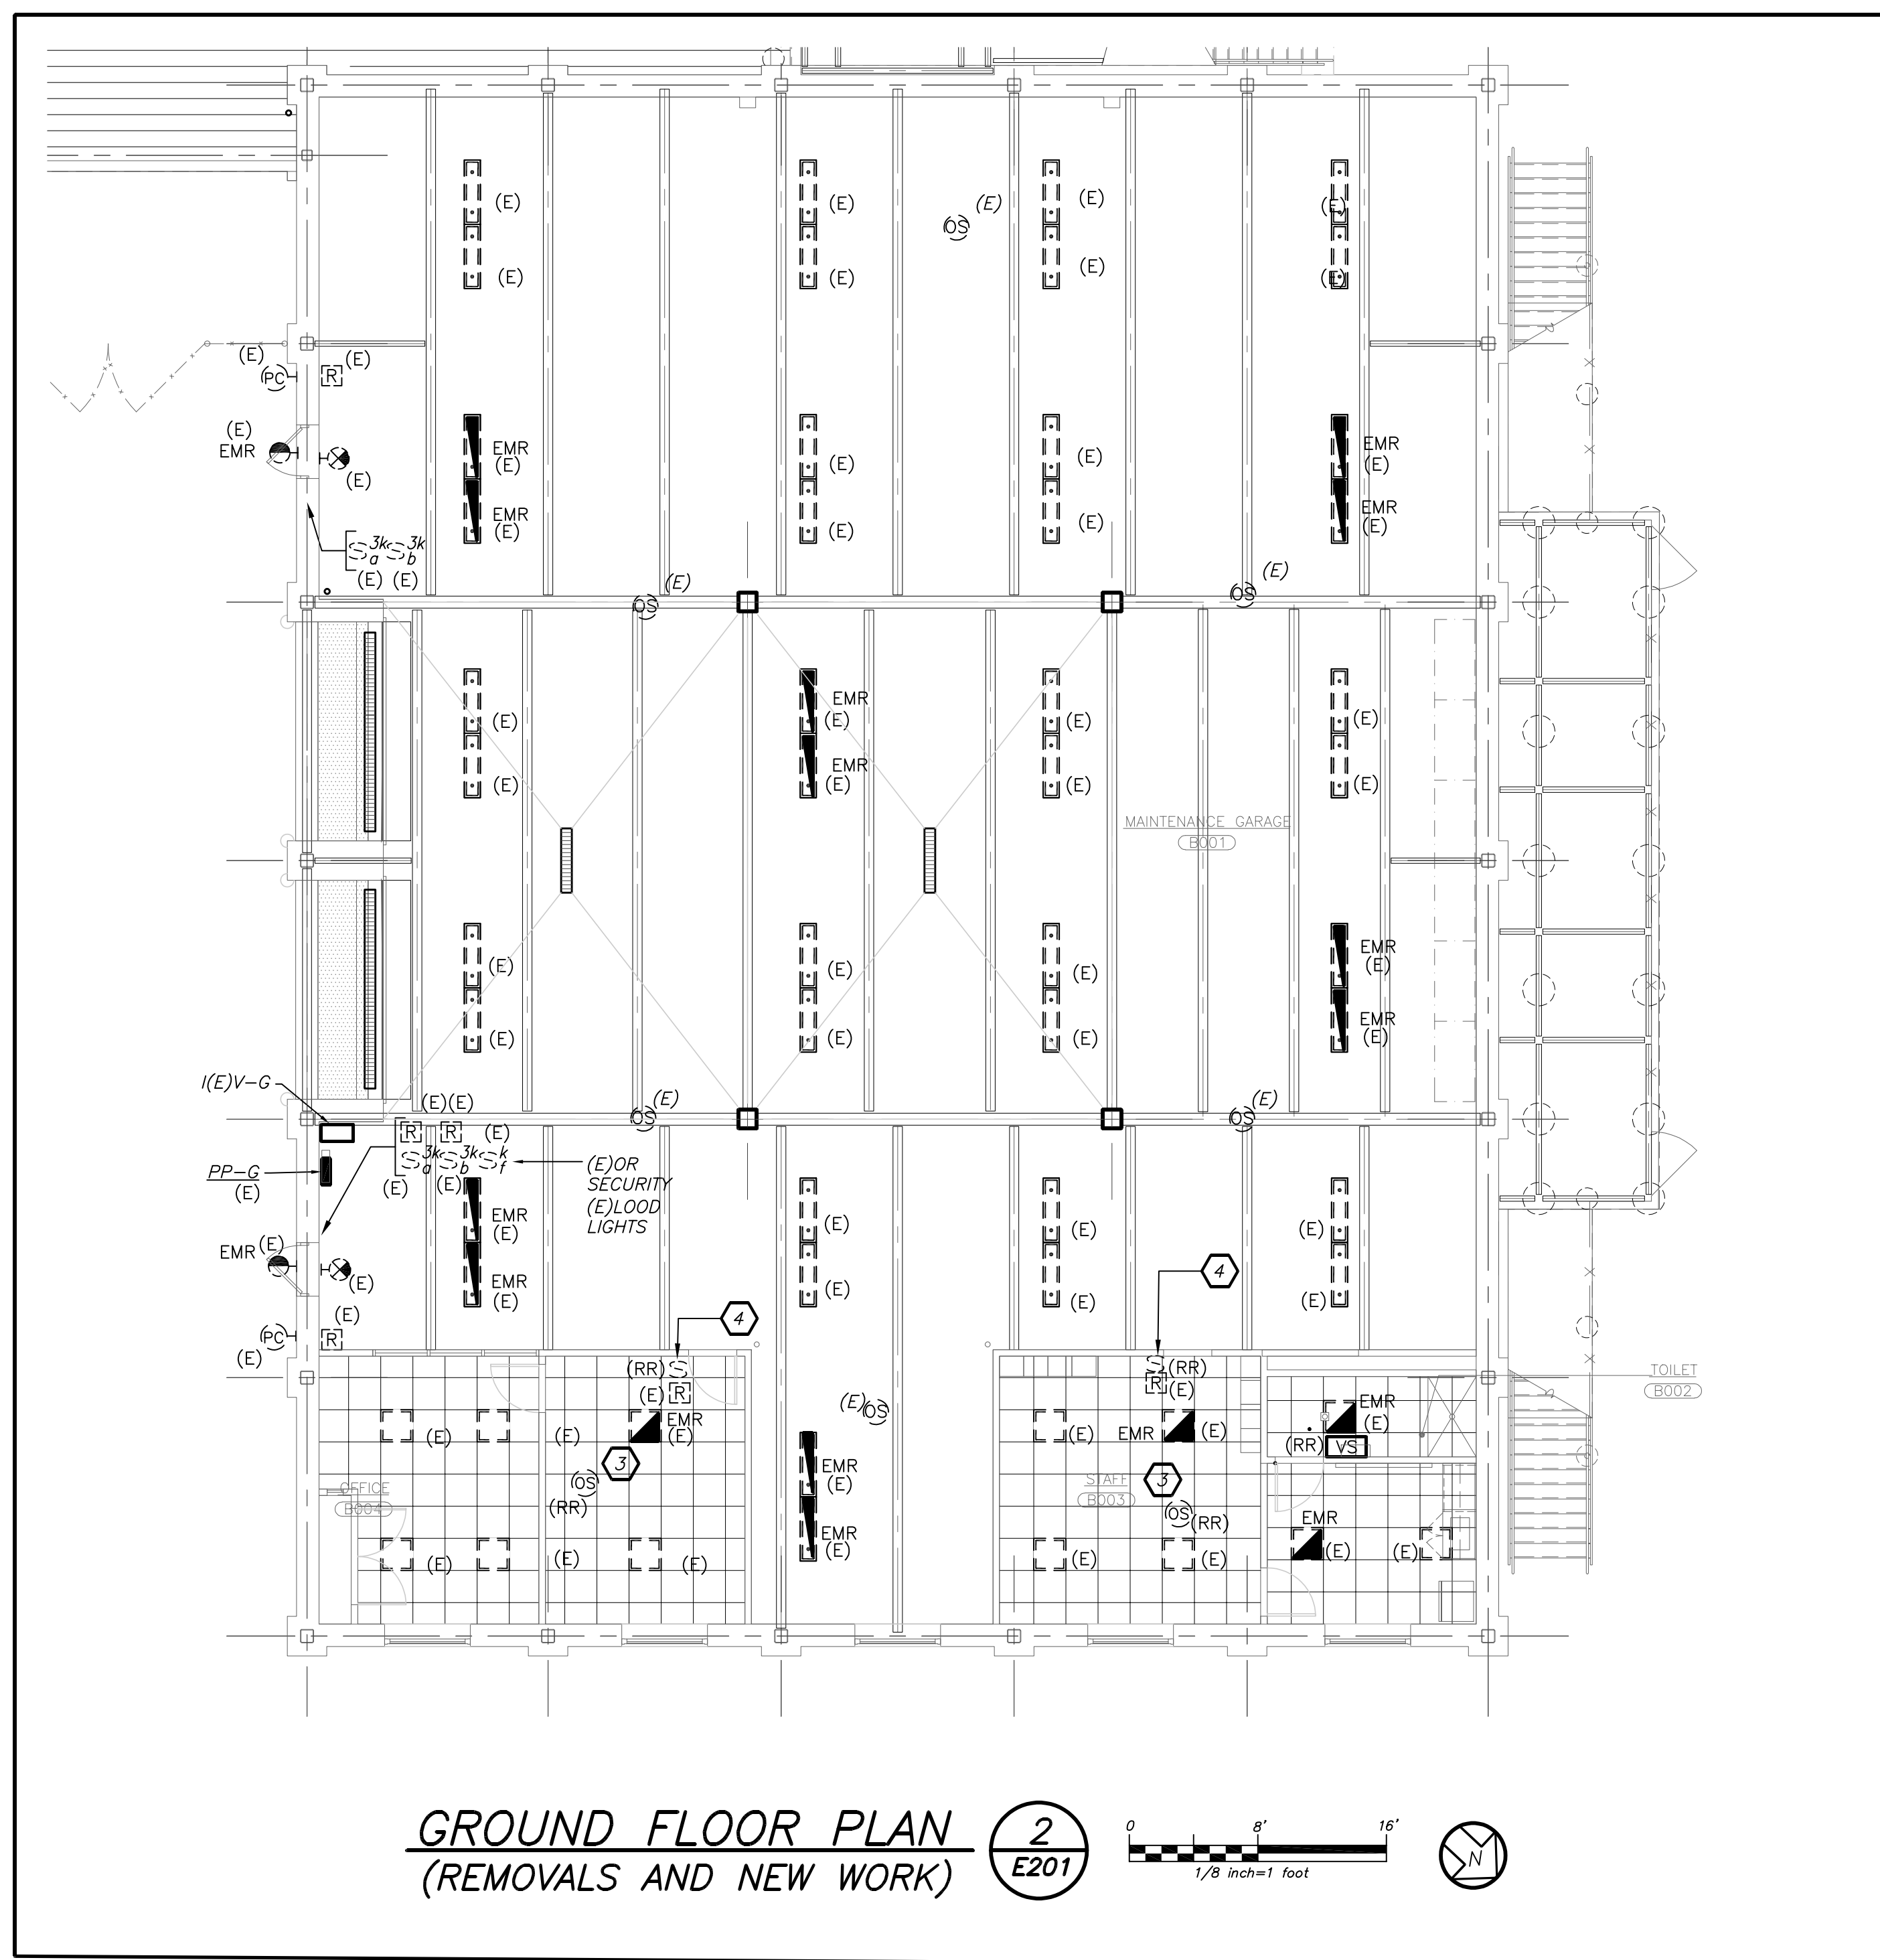
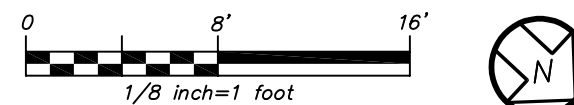
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GROUND FLOOR PLAN  
(REMOVALS AND NEW WORK)

1  
E201



GROUND FLOOR PLAN  
(REMOVALS AND NEW WORK)

2  
E201



WORK NOTES:

- EXISTING LIGHT FIXTURE SHALL BE CLEANED. LENS SHALL BE REMOVED AND WIPED DOWN WITH CLEANER ALONG WITH THE REFLECTOR.
- EXISTING PHOTOCELL SHALL BE REMOVED FROM CEILING TILE AND CEILING TILE SHALL BE DISPOSED BY EC. PHOTOCELL SHALL BE STORED WITH BUBBLE WRAP, CLEANED, AND REINSTALLED ONTO NEW CEILING TILE.
- EXISTING OCCUPANCY SENSOR SHALL BE REMOVED FROM CEILING TILE AND CEILING TILE SHALL BE DISPOSED BY EC. OCCUPANCY SENSOR SHALL BE STORED WITH BUBBLE WRAP, CLEANED, AND REINSTALLED ONTO NEW CEILING TILE.
- EXISTING LIGHT SWITCH CONTROL SHALL REMOVED, STORED WITH BUBBLE WRAP, CLEANED, AND REINSTALLED ONCE NEW WALL INSTALLATION HAS BEEN COMPLETED.
- PROVIDE NEW ELEVATOR PIT LIGHT FIXTURE COLUMBIA LIGHTING MODEL #CSLA-4040, 4' STRIP LIGHTING, 4000 LUMENS, 4000K COLOR TEMPERATURE. 0-10V DIMMING.
- PROVIDE WALL MOUNTED 120V COMBINATION EMERGENCY LIGHT AND EXIT LIGHT SIMILAR TO ENCORE MODEL #LPCRM-6-1. CIRCUIT LIGHT TO LIGHTING CIRCUIT WITHIN AREA AHEAD OF LOCAL SWITCHING.
- CONNECT NEW EXIT, EMERGENCY OR COMBO LIGHT TO LIGHTING CIRCUIT WITHIN AREA AHEAD OF LOCAL LIGHTING SWITCH.

BEFORE FABRICATION THIS CONTRACTOR SHALL  
VERIFY ALL MEASUREMENTS AND CONDITIONS ON  
JOB AND COORDINATE HIS WORK WITH THE WORK  
OF ALL OTHER CONTRACTORS.


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S.E.D. CONTROL NUMBER:  
JFK E.S. 06-19-04-035-008-016

PROJECT: RYE UNION FREE SCHOOL DISTRICT  
JOHN F. KENNEDY ELEMENTARY SCHOOL  
FLOOR REPAIRS & RELATED WORK  
40 OLIVER STREET, PORT CHESTER, NY 10573  
DRAWING TITLE  
GROUND FLOOR ELECTRICAL LIGHTING PLAN

10-18-2021  
DATE

BID  
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SHEET SIZE  
30"x42"



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21444.01

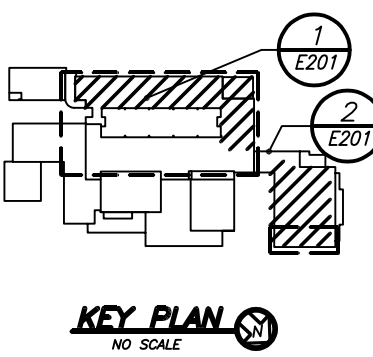JFKES  
E201





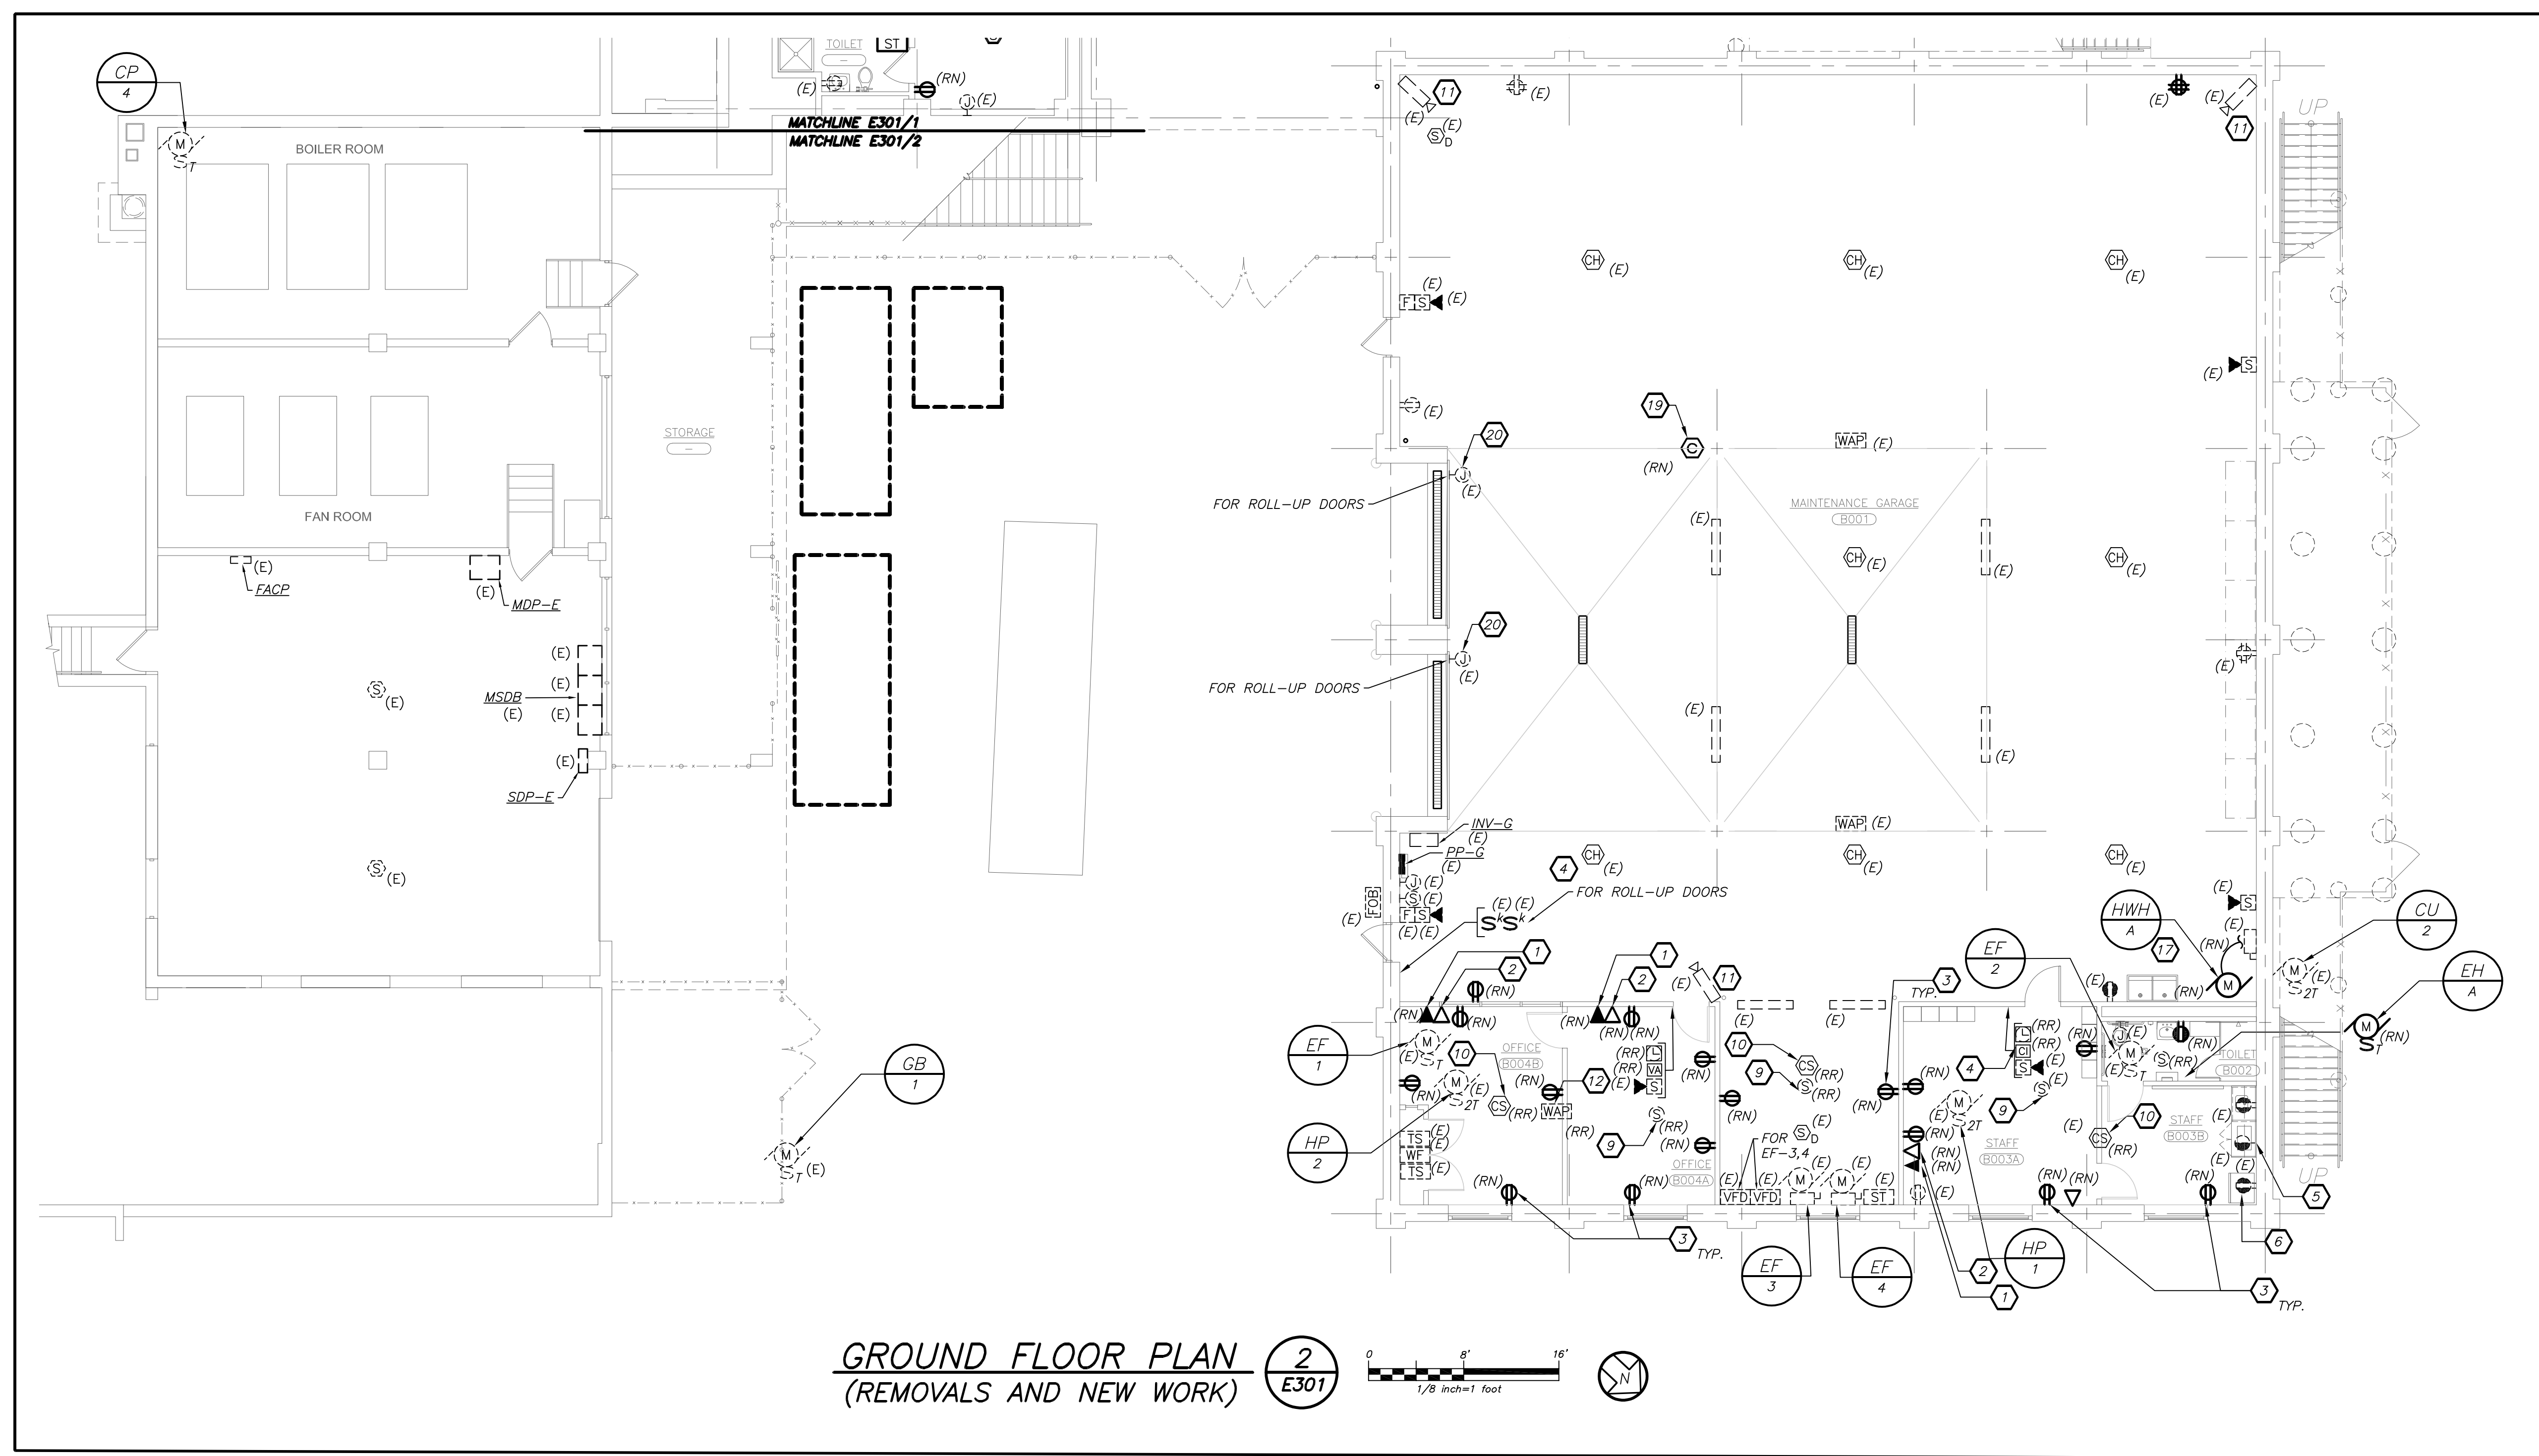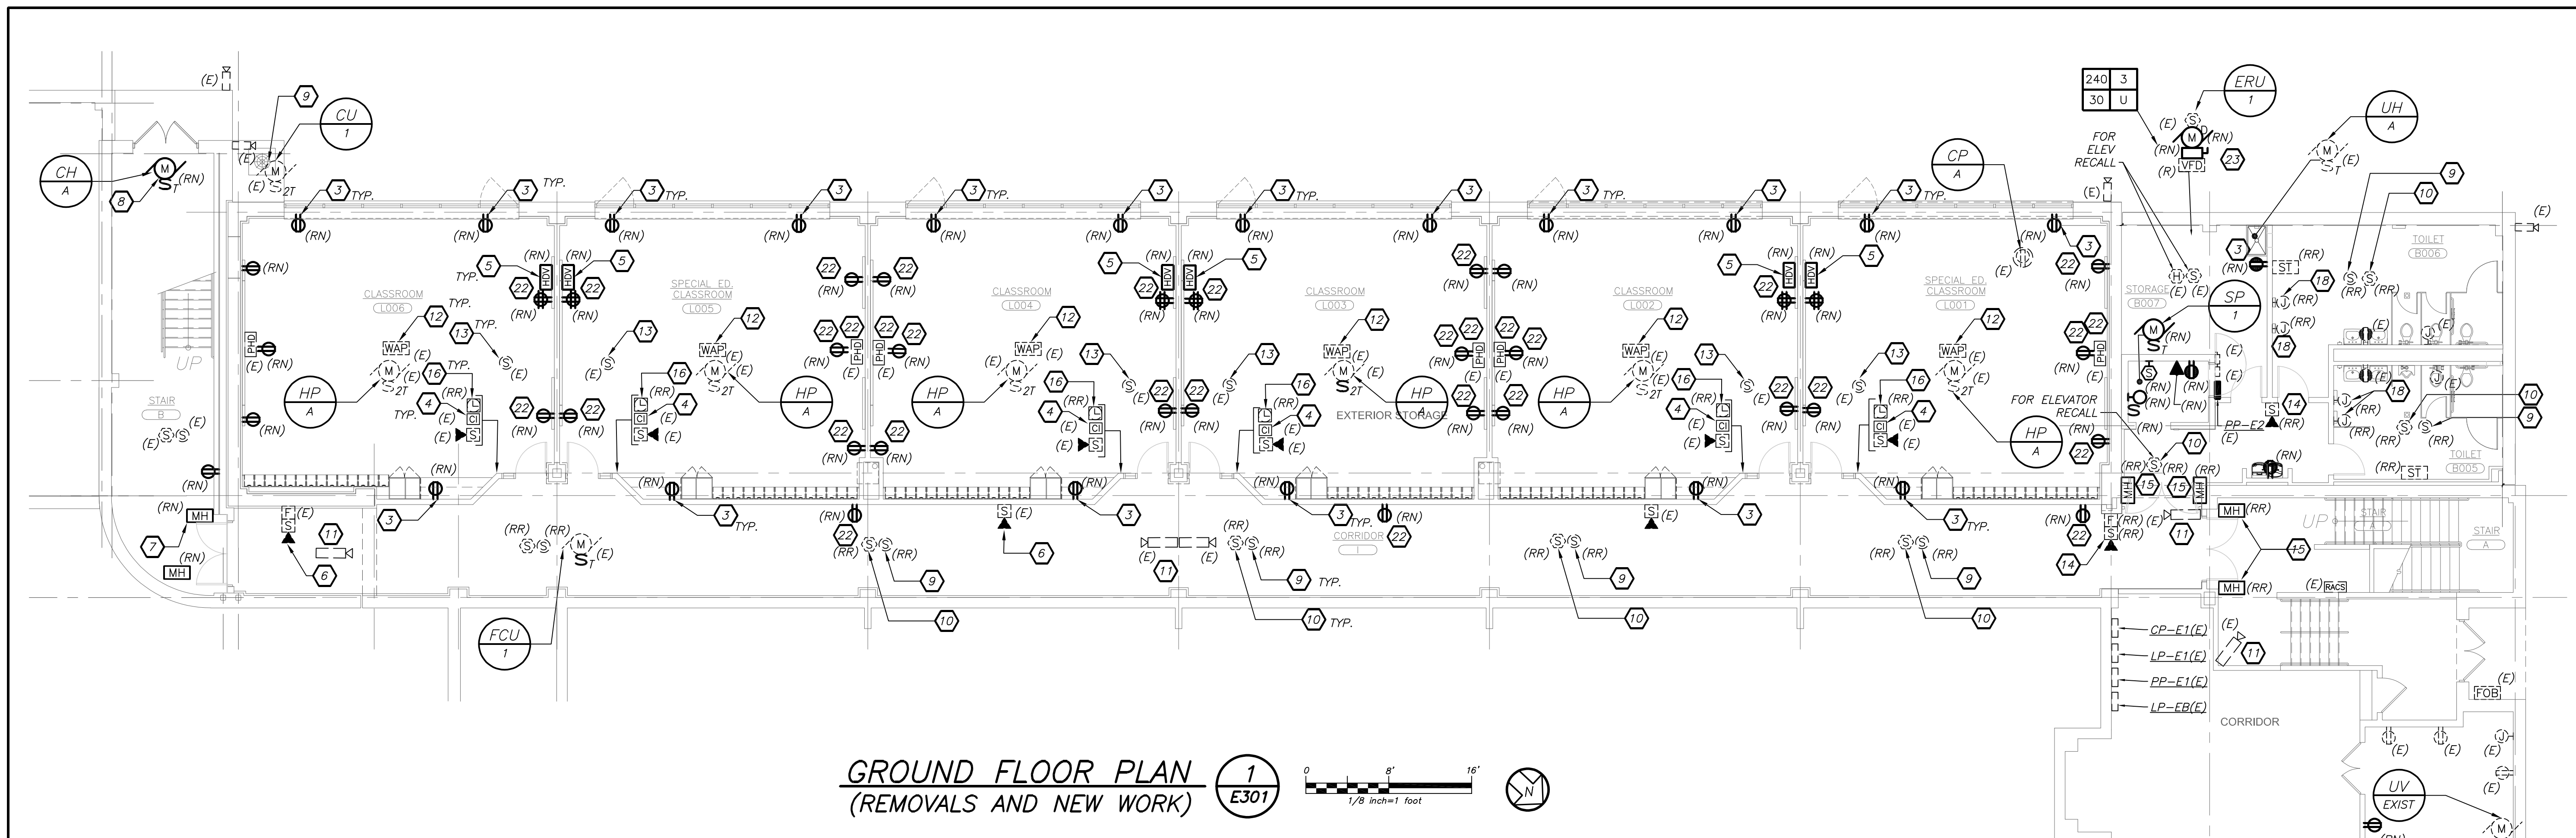- WORK NOTES:**
- 1 REMOVE AND REPLACE EXISTING TELEPHONE CAT 6 BULKHEAD WITH NEW PURPLE COLOR BULKHEAD AND MATCH EXISTING WIRING CONFIGURATION. PROVIDE NEW STAINLESS STEEL COVER PLATE.
  - 2 REMOVE AND REPLACE EXISTING DATA CAT 6 BULKHEAD WITH BLUE COLOR BULKHEAD AND MATCH EXISTING WIRING CONFIGURATION. PROVIDE NEW STAINLESS STEEL COVER PLATE.
  - 3 REMOVE EXISTING RECEPTACLE AND REPLACE WITH NEW. PROVIDE NEW STAINLESS STEEL COVER PLATE.
  - 4 EXISTING CALL-IN BUTTON SHALL BE REMOVED STORED WITH BUBBLE WRAP, CLEANED AND REINSTALLED INTO EXISTING JUNCTION BOX ONCE NEW WALL AND FINISH IS COMPLETED.
  - 5 REMOVE AND REINSTALL EXISTING HDMI OUTLET, TWO (2) DATA CAT 6 BLUE BULKHEAD, ONE (1) TELEPHONE CAT 6 PURPLE BULKHEAD. PROVIDE NEW STAINLESS STEEL COVER PLATE.
  - 6 REMOVE AND REPLACE EXISTING SPEAKER/SYROBE WITH NEW TO MATCH EXISTING TYPE.
  - 7 REPLACE EXISTING FLOOR MOUNTED FIRE ALARM MAGNETIC DOOR HOLDER WITH NEW ONCE NEW FLOOR FINISH IS COMPLETED. MATCH EXISTING TYPE.
  - 8 DISCONNECT AND REPLACE EXISTING THERMAL SWITCH WITH NEW FOR EXISTING CABINET HEATER BEING REPLACED WITH NEW.
  - 9 EXISTING SPEAKER AND SPEAKER BRIDGE SUPPORT SHALL BE REMOVED AND REINSTALLED USING EXISTING WIRING ONTO NEW CEILING TILE.
  - 10 EXISTING SMOKE DETECTOR SHALL BE REMOVED FROM CEILING TILE AND CEILING TILE SHALL BE DISPOSED BY EC. SMOKE DETECTOR SHALL BE STORED WITH BUBBLE WRAP, CLEANED, AND REINSTALLED ONTO NEW CEILING TILE.
  - 11 EXISTING CAMERA SHALL BE REMOVED AND REINSTALLED BY OWNER.
  - 12 EXISTING WAP'S SHALL BE REMOVED AND REINSTALLED BY OWNER.
  - 13 EXISTING CLASSROOM RECESSED MOUNTED SPEAKER SHALL BE DUSTED AND CLEANED BY EC.
  - 14 EXISTING FIRE ALARM DEVICE SHALL BE REMOVED AND REINSTALLED USING EXISTING WIRING AND EXISTING JUNCTION BOX ONCE NEW WALL AND FINISHES ARE COMPLETED.
  - 15 EXISTING MAGNETIC DOOR HOLDER AND WIREMOLD SHALL BE REMOVED AND REINSTALLED ONCE NEW WALL AND FINISHES ARE COMPLETED.
  - 16 CLOCKS SHALL BE INSTALLED BY OWNER.
  - 17 EXISTING CONDUIT AND LIQUID TIGHT FLEXIBLE CONDUIT FROM DISCONNECT SWITCH TO HOT WATER HEATER SHALL BE REMOVED AND REPLACED WITH NEW CONDUIT AND LIQUID TIGHT FLEXIBLE CONDUIT FROM DISCONNECT TO NEW LOCATION OF HOT WATER HEATER. COORDINATE WITH PLUMBER BEFORE THE START OF ANY WORK.
  - 18 RECONNECT EXISTING HAND DRYERS AND PROVIDE ALL REQUIRED AND NECESSARY ACCESSORIES.


- WORK NOTES:**
- 19 REPLACE EXISTING CARBON MONOXIDE SENSOR WITH NEW. MATCH EXISTING. PROVIDE ALL REQUIRED AND NECESSARY ACCESSORIES.
  - 20 DISCONNECT AND RECONNECT POWER TO GARAGE DOOR AND COORDINATE WITH OTHER CONTRACTOR.
  - 21 PROVIDE 2#12+1#12GND IN 3/4" CONDUIT FROM ERU-2 TO PANELBOARD PP-E1 AT AVAILABLE SPACE. PROVIDE 1P-20A CIRCUIT BREAKER. CIRCUIT NUMBER IS SHOWN FOR CONTRACTOR GUIDANCE ONLY.
  - 22 PROVIDE FIRESTOP MOLDABLE PUTTY SIMILAR TO SPECSEAL PUDDY PADS FOR EACH OUTLET BOX REFERENCED BY THIS NOTE. REFER TO DETAIL 1/ED01 ON DRAWING E001 FOR ADDITIONAL INFORMATION.
  - 23 THE EXISTING VFD AND DISCONNECT SWITCH SHALL BE REMOVED FROM UNIT ERU-1. PROVIDE NEW DISCONNECT SWITCH AS INDICATED AND EXTEND EXISTING CONDUIT AND FEEDER AS REQUIRED AND NECESSARY TO INTERCONNECT DISCONNECT SWITCH TO SERVE NEW ERU-1.

BEFORE FABRICATION THIS CONTRACTOR SHALL VERIFY ALL MEASUREMENTS AND CONDITIONS ON JOB AND COORDINATE HIS WORK WITH THE WORK OF ALL OTHER CONTRACTORS.

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S.E.D. CONTROL NUMBER:  
JFK ES 06-19-24-035-000-018

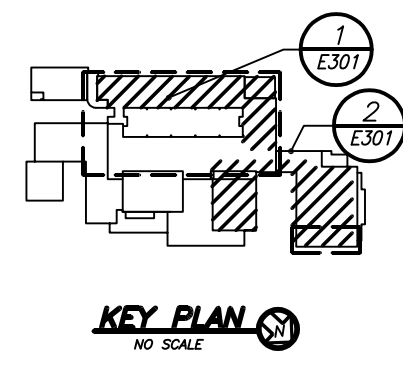PROJECT: PORT CHESTER-RYE UNION FREE SCHOOL DISTRICT JOHN F. KENNEDY ELEMENTARY SCHOOL FLOOR REPAIRS & RELATED WORK 40-0010A STREET PORT CHESTER, NY 10573	
DRAWING TITLE GROUND FLOOR ELECTRICAL POWER AND FIRE ADJUSTMENT	
DATE 10-18-2021	ISSUED TO BID
SHEET SIZE 30"x42"	DRAWING NO. JFKES E301
DRAWN BY BGA	CHECKED BY BGA
FILE NO. 21444.01	