PLUMBING GENERAL NOTES:

- 1. ALL DRAWINGS ARE DIAGRAMMATIC. CONTRACTOR SHALL CHECK AND VERIFY ALL DIMENSIONS AND JOB CONDITIONS IN THE FIELD. HE SHALL NOTIFY THE DESIGNER OF RECORD ANY DISCREPANCIES PRIOR TO SUBMITTING SHOP DRAWINGS OR PLACING ORDERS FOR EQUIPMENT DURING THE COURSE OF THE CONTRACT.
- 2. REMOVE FIXTURES AND WASTE, VENTS, AND WATER PIPING THAT ARE EITHER BEING ELIMINATED OR BEING RECONFIGURED. PROVIDE NEW FIXTURES AND WASTE, VENT, COLD WATER & HOT WATER PIPING TO SUIT THE NEW LAYOUTS. ALL INSTALLED IN CONFORMANCE WITH THE NEW YORK STATE PLUMBING CODE AND BUILDING CODE.
- 3. THE CONTRACTOR SHALL PERFORM ALL CUTTING AND PATCHING OF THE EXISTING STRUCTURE AS REQUIRED. CONTRACTOR SHALL NOTIFY THE ENGINEER OF ANY DISCREPANCIES BETWEEN EXISTING CONDITIONS AND THE CONTRACT DOCUMENTS BEFORE PROCEEDING WITH THAT PORTION OF THE WORK. FAILURE TO NOTIFY THE ENGINEER WILL NOT RELIEVE THE CONTRACTOR OF RESPONSIBILITY TO PERFORM THE WORK INTENDED BY THE CONTRACT DOCUMENTS. THE CONTRACTOR IS TO CORRECT ANY AND ALL WORK ARISING FROM SUCH FAILURE TO COORDINATE DISCREPANCIES TO THE SATISFACTION OF THE ENGINEER.
- 4. ALL WORK SHALL BE PERFORMED IN A WORKMANLIKE MANNER EXECUTED IN ACCORDANCE WITH THE BEST ACCEPTED TRADES PRACTICES.
- 5. THE CONTRACTOR IS TO PROTECT AND PRESERVE ALL EXISTING ITEMS TO REMAIN AND IS TO REPAIR OR REPLACE ANY ITEM DAMAGED DURING THE COURSE OF WORK TO THE SATISFACTION AND APPROVAL OF THE ENGINEER WITHOUT ANY ADDITIONAL COST TO THE OWNER.
- 6. REMOVE ALL EXISTING HYDRANTS/HOSE BIBBS THAT ARE NOT SHOWN ON THE DRAWING. PROVIDE REQUIRED NEW CONNECTIONS TO HYDRANTS.
- 7. ALL SURFACES DAMAGED IN THE COURSE OF THE WORK SHALL BE RESTORED TO THEIR ORIGINAL CONDITION.
- 8. EQUIPMENT SCHEDULES DO NOT CONSTITUTE A COMPLETE IDENTIFICATION OF THE EQUIPMENT. REFER TO ALL DRAWINGS AND SPECIFICATIONS.
- 9. ALL NEW AND EXISTING EQUIPMENT / FIXTURES SHALL BE INSTALLED AND ADJUSTED IN ACCORDANCE WITH THE MANUFACTURER'S RECOMMENDATIONS.
- 10. ALL NEW AND EXISTING EQUIPMENT SHALL BE ARRANGED TO PERMIT EASY ACCESS FOR MAINTENANCE.
- 11. ALL BRACKETS, PLATES, CHANNELS, ETC. SHALL BE GALVANIZED, UNLESS OTHERWISE SPECIFIED.
- 12. ALL GALVANIZED PARTS SHALL BE PAINTED AS PER SPECIFICATIONS.
- 13. OPENINGS AROUND PIPE PASSING THRU EXTERIOR WALLS OR ROOF OF THE BUILDING OR THRU THE WALLS AND FLOORS OF INTERIOR ROOMS REQUIRED TO HAVE A FIRE RATING SHALL BE SEALED USING LINK—SEAL MODEL FS OR EQUAL, FOR USE IN A CORE—BIT DRILLED HOLE.
- 14. ALL WATER PIPING SHALL BE TESTED PER SPECIFICATIONS AND NYS PC BEFORE INSULATION IS PLACED ON THE PIPE.
- 15. ALL NEW AND EXISTING WATER PIPING SHALL BE INSULATED.
- 16. PROVIDE CLEANOUTS AS SHOWN ON DRAWINGS & AS REQUIRED PER NY STATE BUILDING CODE.
- 17. EXACT POSITIONING OF PLUMBING FIXTURES SHALL BE COORDINATED WITH ARCHITECTURAL AND STRUCTURAL FLOOR PLANS.
- 18. WHEN IT IS INDICATED, ON A DRAWING, TO CONNECT NEW PIPES TO EXISTING PIPES, CLEAN OUT EXISTING WITH THE REQUIRED WATER PRESSURE (100 PSI MIN.) BEFORE, DURING AND AFTER CONSTRUCTION UNTIL IT HAS PROPER FLOW FOR THE RESPECTIVE PIPE SIZE AND SHALL BE WITNESSED BY THE ENGINEER.
- 19. CONSTRUCTION, SPACING OF HANGERS AND SUPPORTS, AND SEISMIC SUPPORTS SHALL BE IN ACCORDANCE WITH NYS PC.
- 20. INDIRECT WASTE AND PIPING SHALL BE AS REQUIRED IN CHAPTER 8 OF THE NYS PC.

GENERAL DEMOLITION NOTES:

- 1. THE CONTRACTOR SHALL PROTECT EXISTING EQUIPMENT AND PROPERTY DURING CONSTRUCTION. REPAIR OR REPLACE, WITHOUT ADDITIONAL CHARGE TO THE OWNER, ANY EXISTING WORK DAMAGED DURING THE COURSE OF CONSTRUCTION.
- 2. CONTRACTOR SHALL BE RESPONSIBLE FOR REVIEWING ALL DRAWINGS AND SPECIFICATIONS TO DETERMINE THE EXTENT OF EXCAVATION AND DEMOLITION.
- 3. ANY DISCREPANCIES OR CONFLICTS BETWEEN THE DRAWINGS AND EXISTING CONDITIONS, EXISTING CONDITIONS TO REMAIN, TEMPORARY CONSTRUCTION AND PERMANENT CONSTRUCTION SHALL BE BROUGHT TO THE ATTENTION OF THE OWNER BEFORE PROCEEDING. ITEMS ENCOUNTERED IN AREAS OF EXCAVATION THAT ARE NOT INDICATED ON THE DRAWINGS, BUT ARE VISIBLE ON SURFACE, SHALL BE THE CONTRACTOR'S RESPONSIBILITY AND SHALL BE REMOVED AT NO ADDITIONAL COST TO THE OWNER.
- 4. ALL EXISTING SITE FEATURES TO REMAIN SHALL BE PROTECTED THROUGHOUT THE CONSTRUCTION PERIOD. ANY FEATURES DAMAGED DURING CONSTRUCTION OPERATIONS SHALL BE REPAIRED OR REPLACED TO THE SATISFACTION OF THE OWNER'S REPRESENTATIVE AT NO ADDITIONAL COST.
- 5. THE CONTRACTOR SHALL PROVIDE SAFETY AND DUST PROOF BARRIERS FROM ALL OCCUPIED AREAS DURING THE ENTIRE CONSTRUCTION PERIOD. ALL SURFACES, FURNISHINGS, EQUIPMENT, ETC. ADJACENT TO DEMOLITION AREAS SHALL BE PROTECTED FROM DAMAGE.
- 6. THE OWNER HAS FIRST RIGHT OF ALL MATERIALS REMOVED AS A RESULT OF THE DEMOLITION OF EXISTING CONDITIONS. ANY OR ALL NON-CLAIMED ITEMS BY THE OWNER ARE THE RESPONSIBILITY OF THE CONTRACTOR TO BE REMOVED AND PROPERLY DISPOSED OF FROM THE SITE.

DISCLAIMER NOTES:

THIS PLAN IS APPROVED ONLY FOR THE WORK INDICATED ON DRAWINGS AND SPECIFICATIONS. ALL OTHER MATTERS ARE NOT TO BE RELIED UPON, OR TO BE CONSIDERED AS EITHER BEING APPROVED OR IN ACCORDANCE WITH APPLICABLE CODES.

ALL CONTRACTORS ARE RESPONSIBLE FOR COORDINATION OF THEIR WORK WITH THE WORK OF OTHER TRADESMEN. ALL DRAWINGS RELATED TO THE CONSTRUCTION OF THIS PROJECT, AS ENUMERATED ON SHEET G-001, ARE HEREIN REFERENCED FOR COORDINATION PURPOSES. ALL CONTRACTORS SHALL FAMILIARIZE THEMSELVES WITH THE COMPLETE SET OF DOCUMENTS AND SPECIFICATIONS FOR THIS PURPOSE. NO CHANGE ORDERS OR ADDITIONS TO THE CONTRACT SUM SHALL BE ENTERTAINED FOR LACK OF COORDINATION BETWEEN TRADES

TO THE BEST OF MY KNOWLEDGE, BELIEF AND PROFESSIONAL JUDGEMENT, THESE PLANS AND SPECIFICATIONS ARE IN COMPLIANCE WITH THE ENERGY CONSERVATION CONSTRUCTION CODE OF NY STATE.

PLUMBING FIXTURE SCHEDULE

- LOWDING TIX	TONE SOMEDOLE	 		 				1		
MFG.	MARK	MODEL	MODEL #	COLOR	SEAT	OUTLET	FLUSH VALVE	FAUCET	CARRIER	NOTES
SLOAN	WC-1	ELONGATED WALL MOUNT	ST-2459	WHITE	CHURCH 295SSCT	4"	1 1/2" TOP INLET SPUD SLOAN SENSOR REGAL 111 SFSM-1.28	_	ZURN Z-1201	MOUNT AS PER ARCHITECTURAL ELEVATION
SLOAN	WC-1HC	ELONGATED WALL MOUNT	ST-2459	WHITE	CHURCH 295SSCT	4"	1 1/2" TOP INLET SPUD SLOAN SENSOR REGAL 111 SFSM-1.28	_	ZURN Z-1201	MOUNT AS PER ARCHITECTURAL ELEVATION
SLOAN	UR-1	STANDARD WASHDOWN	SU-1009	WHITE	-	2"	3/4" TOP INLET SPUD SLOAN SENSOR REGAL 186 SFSM-0.5	_	ZURN Z-1221	MOUNT AS PER ARCHITECTURAL ELEVATION
AMERICAN STANDARD	LAV-1	OVALYN UNDERCOUNTER SINK	0496.221	WHITE	-	1-1/4"	-	AMERICAN STANDARD INNSBROOK 6053.204 ELECT. BATT. PWRD VDL RESIST METERING FAUCET.	-	MOUNT PER ARCHITECTURAL ELEVATION. PROVIDE W/ GRID DI #Z8743-PC, P-TRAP #Z8700-PC. PROVIDE LAVGUARDS ON EXPOSED DOMESTIC AND SANITARY PIPING. FAUCETS LOCATED SOUTH EVENT SPACE AND VENDOR SPACE PUBLIC TOILETS TO HAVE INTEGRATED THERMOSTATIC MIXING VALVE 605XTMV1070
AMERICAN STANDARD	LAV-1HC	OVALYN UNDERCOUNTER SINK	0496.221	WHITE	-	1-1/4"	_	AMERICAN STANDARD INNSBROOK 6053.204 ELECT. BATT. PWRD VDL RESIST METERING FAUCET	-	MOUNT PER ARCHITECTURAL ELEVATION. PROVIDE W/ GRID DI #Z8743-PC, P-TRAP #Z8700-PC. PROVIDE LAVGUARDS ON EXPOSED DOMESTIC AND SANITARY PIPING. FAUCETS LOCATED SOUTH EVENT SPACE AND VENDOR SPACE PUBLIC TOILETS TO HAVE INTEGRATED THERMOSTATIC MIXING VALVE 605XTMV1070
AMERICAN STANDARD	LAV-2	LUCERNE WALL HUNG LAVATORY	0356.421	WHITE	-	1-1/4"	_	AMERICAN STANDARD INNSBROOK 6053.204 ELECT. BATT. PWRD VDL RESIST METERING FAUCET	ZURN Z-1231	MOUNT PER ARCHITECTURAL ELEVATION. PROVIDE W/ GRID DE #Z8743-PC, P-TRAP #Z8700-PC. PROVIDE LAVGUARDS ON EXPOSED DOMESTIC AND SANITARY PIPING. FAUCETS LOCATED SOUTH EVENT SPACE AND VENDOR SPACE PUBLIC TOILETS TO HAVE INTEGRATED THERMOSTATIC MIXING VALVE 605XTMV1070
AMERICAN STANDARD	LAV-2HC	LUCERNE WALL HUNG LAVATORY	0356.421	WHITE	-	1-1/4"	_	AMERICAN STANDARD INNSBROOK 6053.204 ELECT. BATT. PWRD VDL RESIST METERING FAUCET	ZURN Z-1231	MOUNT PER ARCHITECTURAL ELEVATION. PROVIDE W/ GRID DI #Z8743-PC, P-TRAP #Z8700-PC. PROVIDE LAVGUARDS ON EXPOSED DOMESTIC AND SANITARY PIPING. FAUCETS LOCATED SOUTH EVENT SPACE AND VENDOR SPACE PUBLIC TOILETS TO HAVE INTEGRATED THERMOSTATIC MIXING VALVE 605XTMV1070
E.L Mustee	MS-1	MOP SERVICE BASIN	63M	WHITE	-	3"	_	AMERICAN STANDARD EXPOSED YOKE WALL MOUNT UTILITY FAUCET 8344.212	-	24" x 24" x 10", W/STRAINER
ELKAY	DF-1HC	EZH20 BI LEVEL BOTTLE FILLING STATION	EZSTLDDWSSK	STAINLESS STEEL	-	1-1/2"	-	-	-	MOUNT PER ARCHITECTURAL ELEVATION. PROVIDE NON FILTER NON REFRIGERATED UNIT.
ELKAY	DF-2HC	EZH20 BI LEVEL OUTDOOR PEDESTAL BOTTLE FILLING STATION	LK4420BF1L	BY OWNER	-	1-1/2"	_	_	-	COLOR BY OWNER/ARCHITECT. PROVIDE NON FILTERED NON REFRIGERATED UNIT.
BRADLEY	SH-1	IN WALL SHOWER	-	STAINLESS STEEL	-	-	_	BRADLEY S15 STANDARD 1.5 GPM SHOWERHEAD	-	PROVIDE WITH BRADLEY 50B MECHANICAL PUSH BUTTON METERING VALVE.
BRADLEY	SH-2HC	ADA COMPLIANT IN WALL SHOWER	1C-AST- S15-A24	STAINLESS STEEL	-	-	_	BRADLEY S15 STANDARD 1.5 GPM SHOWERHEAD WITH HAND SHOWER	-	PROVIDE WITH BRADLEY AIR METERING VALVE FOR ADA COMPLIANCE. PROVIDE WITH HAND SHOWER WITH VACUUM BREAKER
OUTDOOR SHOWER COMPANY	SH-3HC	FREE STANDING SHOWER	BS-2000-ADA	STAINLESS STEEL	-	_	-	_	-	1.75 GPM SHOWER HEAD WITH METERED PUSH VALVE.
REGENCY SINKS	SK-1	WORK TABLE WITH SINK	600ST3048LFT	STAINLESS STEEL	-	1-1/2"	_	DECK MOUNTED FAUCET INCLUDED	-	-
JR SMITH	WH-1	COMMERCIAL BOXED WALL HYDRANTS	5518	BRONZE	-	_	_	-	-	3/4" HOSE CONNECTION. SELF DRAINING. INTEGRAL VACUUM BREAKER COMPLYING WITH ASSE 1011.

PLUMBING SYMBOL LEGEND:

	EX. SAN OR EX. W	EXISTING SANITARY OR WASTE PIPING ABOVE GRADE TO REMAIN
	EX. SAN OR EX. W	EXISTING SANITARY OR WASTE PIPING BELOW GRADE TO REMAIN
	EX. V	EXISTING SANITARY VENT PIPING TO REMAIN
ST	EX. ST	EXISTING STORM DRAINAGE PIPING TO REMAIN
	EX. CW	EXISTING COLD WATER PIPING TO REMAIN
	SAN OR W	NEW SANITARY OR WASTE PIPING ABOVE GRADE
	SAN OR W	NEW SANITARY OR WASTE PIPING BELOW GRADE
	V	NEW SANITARY VENT PIPING
ST	ST	NEW STORM DRAINAGE PIPING
	CW	NEW DOMESTIC COLD WATER PIPING
	HW	NEW DOMESTIC HOT WATER PIPING
	HWC	NEW DOMESTIC HOT WATER CIRCULATING PIPING
TW	TW	NEW TEMPERED WATER PIPING
7		NEW CHECK VALVE
\bowtie		NEW SHUT OFF/ BALL VALVE
×	TMV	NEW THERMOSTATIC MIXING VALVE
•		PIPE DROP
0		PIPE RISE
•	POC	POINT OF CONNECTION TO EXISTING PIPING
~		PIPE BREAK
c.o.	со	CLEAN OUT
	CODP	CLEAN OUT DECK PLATE
FD	FD	FLOOR DRAIN

NEW EXPANSION JOINT

ENERGY ANALYSIS FOR ALTERATION - CLIMATE ZONE 4

	ENERGY ANALISIS FOR ALTERATION		
ITEM DESCRIPTION	PROPOSED DESIGN VALUE	CODE PRESCRIPTIVE VALUE: REFERENCE — NYS ECC 2020	DRAWING REFERENCE
SERVICE WATER HEATING EQUIPMENT	SPECIFIED EQUIPMENT (ELECTRIC RESISTANCE TYPE ≥ 20 GAL & ≤ 55 GAL) SL (%/HR) = 0.93	MINIMUM PERFORMANCE EFFICIENCY FOR ELECTRIC RESISTANCE WATER HEATERS WITH INPUT \leq 12KW SHALL BE (0.3+27/V _m) (V _m =47) = 0.875	P-500
	SPECIFIED EQUIPMENT (STORAGE WATER HEATER GAS >155,000 BTU/H; < 4000 BTU/H/GAL) E _t = 96%	MINIMUM PERFORMANCE EFFICIENCY FOR STORAGE WATER HEATER GAS >155,000 BTU/H; < 4000 BTU/H/GAL E _t = 80%	
HEATED WATER CIRCULATING AND TEMPERATURE MAINTENANCE SYSTEMS	SPECIFIED CONTROL: AQUASTAT	HEATED WATER CIRCULATION SYSTEMS SHALL BE PROVIDED WITH A CIRCULATION PUMP. CONTROL FOR PUMP SHALL AUTOMATICALLY TURN ON/OFF BASED ON DEMAND FOR HOT WATER AND BY MEETING DESIRED TEMPERATURE.	P-500
PIPE INSULATION	TABLE C403.11.3 ON DRAWING FOR REFERENCE FOR MINIMUM INSULATION SIZING.	PIPING FROM A WATER HEATER TO THE TERMINATION OF THE HEATED WATER FIXTURE SUPPLY PIPE SHALL BE INSULATED IN ACCORDANCE WITH TABLE C403.11.3. (SECTION C404.4)	P-001 SPECIFICATION 224000
OPERATING AND MAINTENANCE MANUAL	PROVIDE MANUALS	PLUMBING CONTRACTOR SHALL PROVIDE OWNER WITH OPERATING AND MAINTENANCE MANUAL (SECTION C408.1.1)	SPECIFICATION 224000

ENERGY CODE COMPLIANCE NOTES:

- THE ENERGY CODE INCORPORATES THE 2018 IECC AND ASHRAE 90.1-2016 BY REFERENCE. THE NEWLY
 ADOPTED ENERGY CODE WILL BECOME FORMALLY EFFECTIVE
 ON MAY 12, 2020. THERE WILL BE NO TRANSITION PERIOD.
- 2. THE DRAWING AND SPECIFICATION WHICH COMPRISE THE CONSTRUCTION DOCUMENT FOR THIS PROJECT ARE IN COMPLIANCE WITH THE LATEST EDITION OF THE 2020 NEW YORK STATE ENERGY CONSERVATION CONSTRUCTION CODE.

ABBREVIATIONS:

ABC	ABOVE CEILING	NTS	NOT TO SCALE
AD	area drain		
AFF	ABOVE FINISHED FLOOR	POC	POINT OF CONNECTION
AHJ	AUTHORITIES HAVING	RD	ROOF DRAIN
, u 10	JURISDICTION	REF	REFERENCE
ALILI			
AHU	AIR HANDLING UNIT	REQ'D	REQUIRED
APPROX	APPROXIMATE	REV	REVISION
DI DO	DI III DINIO	RPZ	REDUCED PRESSURE
BLDG	BUILDING		ZONE DEVICE
CLG	CEILING	SD	SHOWER DRAIN
CO	CLEANOUT	SH	SHOWER
CODP	CLEANOUT W/ DECKPLATE	SHT	SHEET
COND	CONDENSATE LINE	SK	SINK
CONST	CONSTRUCTION	SPECS	SPECIFICATION(S)
CONT	CONTINUATION	SF	SQUARE FEET
CW	DOMESTIC COLD WATER		
C VV	DOMESTIC COLD WATER	ST	STORM DRAINAGE
DF	DRINKING WATER FOUNTAIN	TD	TRENCH DRAIN
DTL	DETAIL	TEL	TELEPHONE
DN	DOWN	TEMP	TEMPORARY
DWG(S)	DRAWING(S)	TW	TEMPERED WATER
		TYP	TYPICAL
EA	EACH ELEVATION	LID	LIDINIAL
EL	ELEVATION	UR	URINAL
ELEC	ELECTRICAL	.,	VENT
(E) OR (EX)	EXISTING	٧	VENT
		V.I.F.	VERIFY IN FIELD
F&I	FURNISH & INSTALL	V.T.R.	VENT THRU ROOF
FD	FLOOR DRAIN		
FL	FLOOR	W	SANITARY WASTE
FT	FOOT/FEET	W/	WITH
	,	WC	WATER CLOSET
GH	GROUND HYDRANT	WCO	WALL CLEANOUT
HC	HANDICAP		
HVAC	HEATING, VENTILATION,		
	AND AIR CONDITIONING		
HW	DOMESTIC HOT WATER		
HWC	HOT WATER CIRCULATING		
HWH	HOT WATER CIRCULATING		
114411	HOI WAILN HEATEN		
INV	INVERT		
LAV	LAVATORY		
LDR	LEADER		
MAX	MAXIMUM		
MECH	MECHANICAL		
MEP	MECHANICAL MECHANICAL, ELECTRICAL		
IVI∟F	AND PLUMBING		
MFR	MANUFACTURER		
MIN			
MIIN	MINIMUM		
MS	MOP SINK		

PLUMBING FIXTURE CONNECTION SCHEDULE:

MARK	ITEM	H.W.	C.W.	140° H.W.	WASTE	VENT	GAS
DF-#	DRINKING FOUNTAIN	_	1/2"	1	2"	1 1/2"	ı
LAV-#	LAVATORY	1/2"	1/2"	1	2"	1 1/2"	ı
MS-#	MOP SINK	1/2"	1/2"	1	3"	1 1/2"	ı
SK-#	SINK	1/2"	1/2"	1	2"	1 1/2"	ı
UR-#	URINAL	_	3/4"	1	3"	1 1/2"	ı
WC-#	WATER CLOSET	_	1"	_	4"	2"	-

[NY] C106.2.3 PLUMBING SYSTEM

INSPECTIONS SHALL VERIFY THE TYPE AND SIZE OF INSULATION, R-VALUES, PROTECTION REQUIRED, CONTROLS AND HEAT TRAPS AS REQUIRED BY THE CODE, APPROVED PLANS AND SPECIFICATIONS.

SCHEDULE OF PROGRESS INSPECTIONS CODE REFERENCE (ASHRAE 90.1) INSPECTION DESCRIPTION

(ASHRAE 90.1)	
7.4.2	SERVICE WATER HEATING EQUIPMENT MEETS EFFICIENCY REQUIREMENTS.
7.4.4.1	TEMPERATURE CONTROLS INSTALLED ON SERVICE WATER HEATING SYSTEMS (<=120°F TO MAXIMUM TEMPERATURE FOR INTENDED USE).
7.4.4.2	AUTOMATIC TIME SWITCHES INSTALLED TO AUTOMATICALLY SWITCH OFF THE RECIRCULATING HOT-WATER SYSTEM OR HEAT TRACE.
7.4.6	HEAT TRAPS INSTALLED ON NON-CIRCULATING STORAGE WATER TANKS.

SCHEDULE OF FINAL INSPECTIONS

CODE REFERENCE (ASHRAE 90.1)	INSPECTION DESCRIPTION
7.4.3	FIRST 8 FT OF OUTLET PIPING IN NONRECIRCULATING STORAGE SYSTEM, OR BRANCH PIPING CONNECTED TO RECIRCULATED, HEAT TRACED, OR IMPEDANCE HEATED PIPING IS INSULATED.
7.4.4.3	PUBLIC LAVATORY FAUCET TEMPERATURE < = 110°F
7.4.4.4	CONTROLS ARE INSTALLED THAT LIMIT THE OPERATION OF A RECIRCULATION PUMP INSTALLED TO MAINTAIN TEMPERATURE OF A STORAGE TANK.





UNAUTHORIZED A ADDITION TO THIS							RECORD DRAWI	NG CERTIFICATION	
VIOLATION OF SECTINEW YORK STATE	TION 7209 OF THE						AS BUILT — CHANGES AS NOTED AS BUILT — NO CHANGES		
IN CHARGE OF _	JHM						CONTRACTOR	PROJECT COORDINATOR	
CHECKED BY	CAL						NAME	NAME	
MADE BY	PAD	REVISION NUMBER	DATE	MADE BY	APP'D BY	REVISION	SIGNATURE DATE	SIGNATURE DATE	

WESTCHESTER COUNTY, NEW YORK
DEPARTMENT OF PUBLIC WORKS & TRANSPORTATION
DIVISION OF ENGINEERING

REHABILITATION OF ENGINEERING

REHABILITATION OF POOL AND BATHHOUSE
PLAYLAND PARK, RYE, NEW YORK

PLUMBING SYMBOLS, NOTES & ABBREVIATIONS

SHEET NUMBER


20-504 P-001

SHEET NO. 108 OF 201

SCALE: AS NOTED
DATE: NOVEMBER 10, 2020

DPW FILE NO.

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AREA OF WORK-

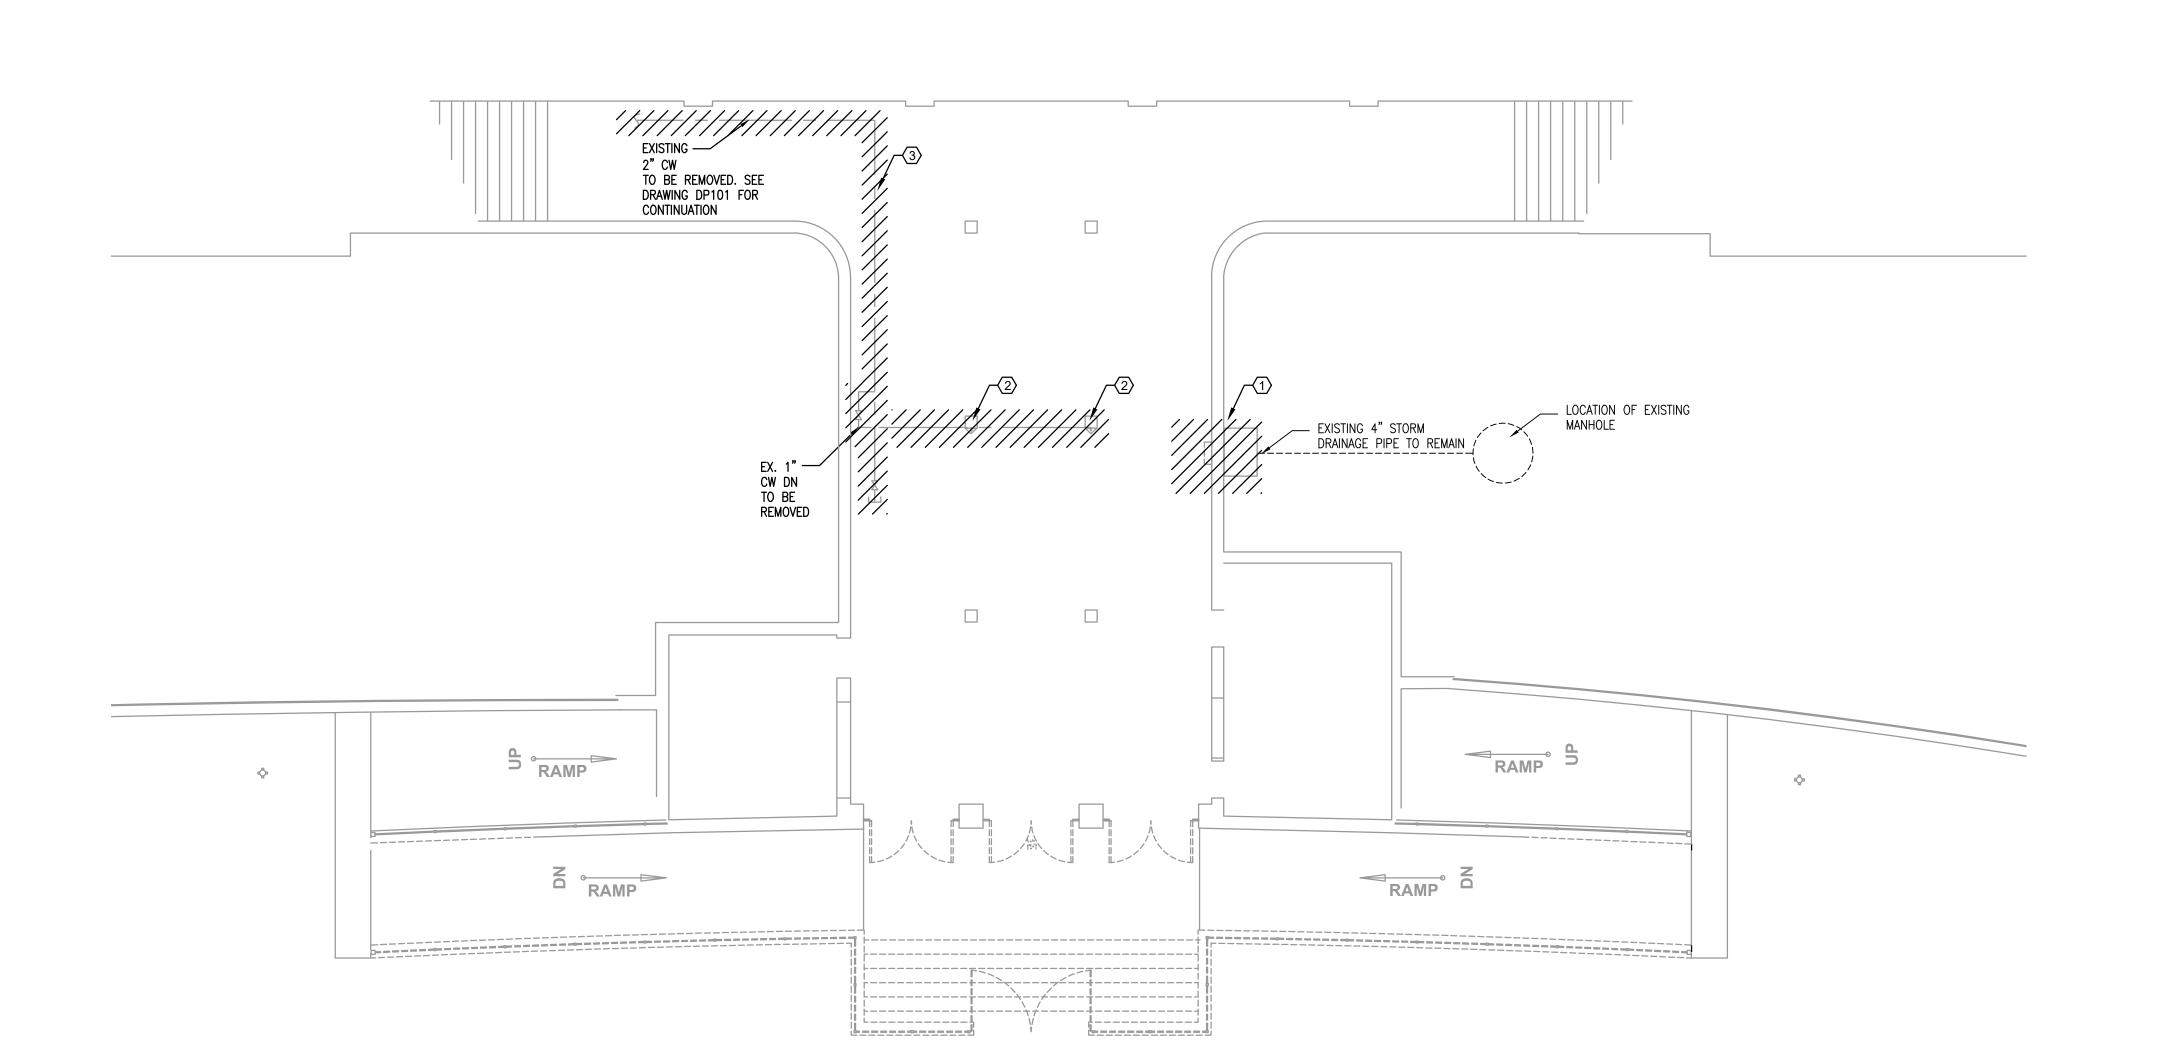KEY PLAN
NOT TO SCALE

DEMOLITION NOTES

- EXISTING SUMP PUMP AND ALL ASSOCIATED PIPING TO BE REMOVED. DISCONNECT AND MAKE SAFE PRIOR TO REMOVAL.
- EXISTING FOOT WASH STATIONS AND ASSOCIATED PIPING TO BE REMOVED.
- 3. EXISTING 2" CW LINE AND ASSOCIATED HANGERS AND SUPPORTS TO BE REMOVED. SEE DRAWING DP-101 FOR CONTINUATION

1 PLUMBING DEMOLITION PLAN - TUNNEL
DP100 SCALE: 1/8" = 1'-0"







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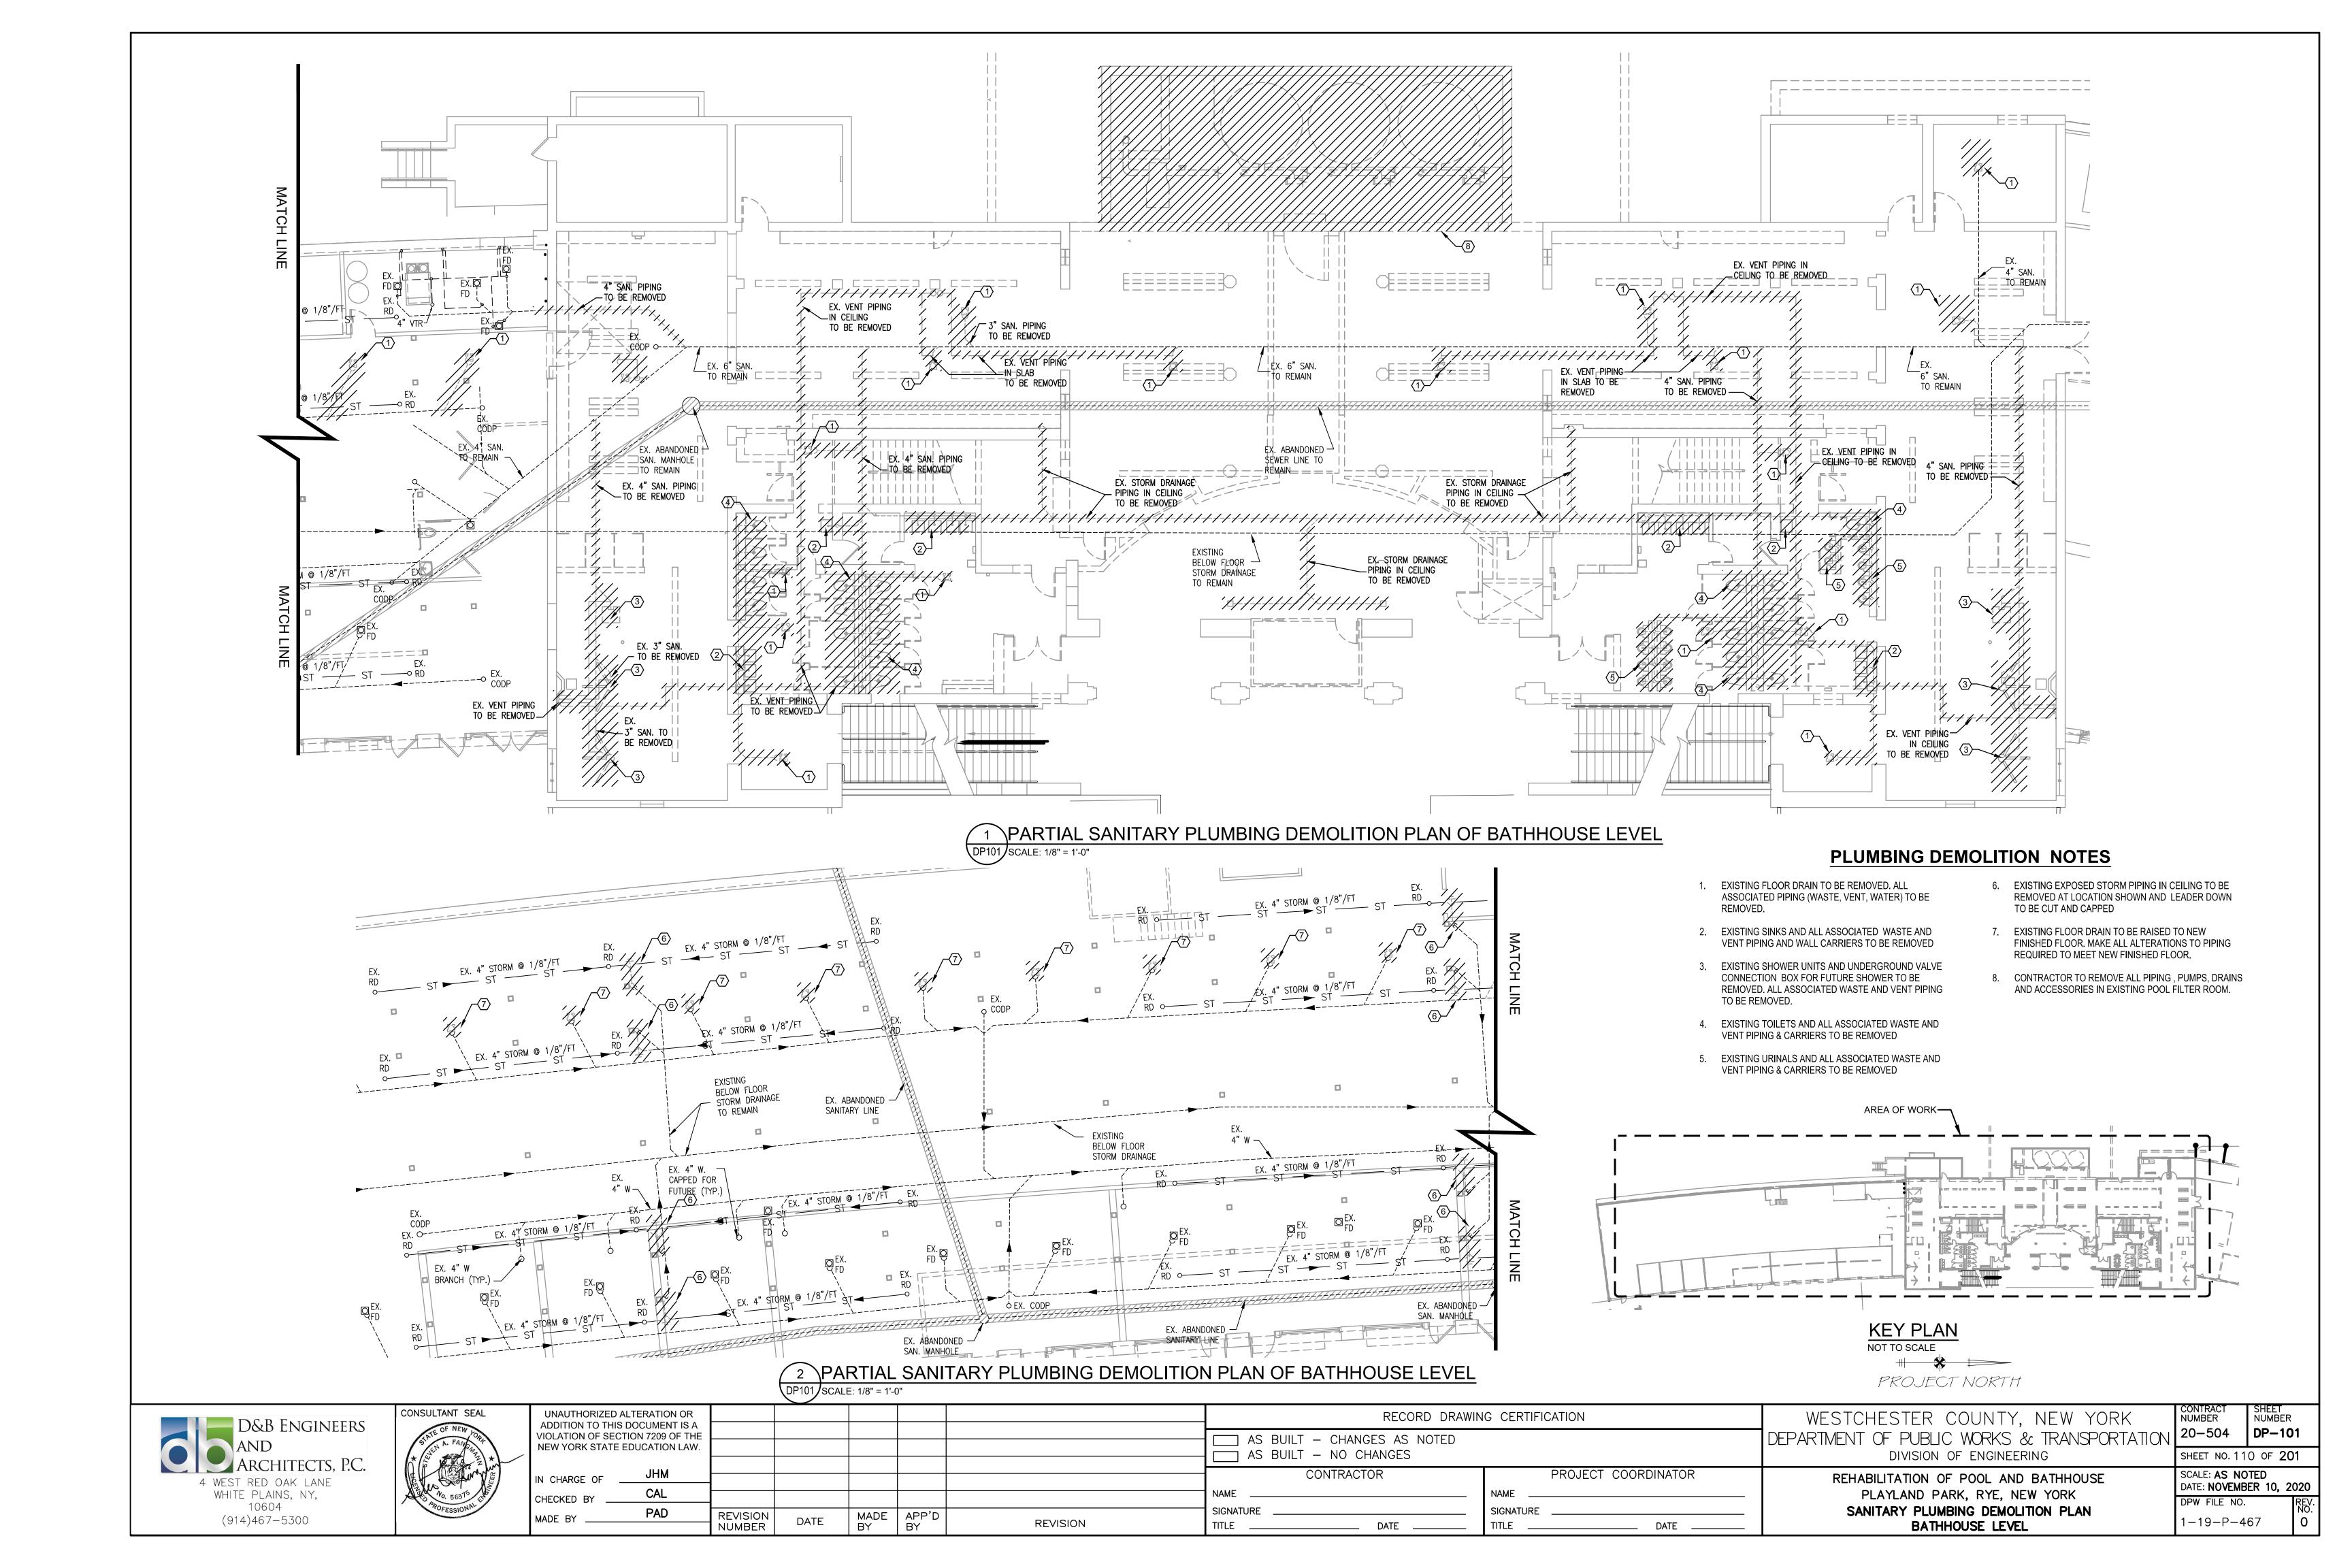
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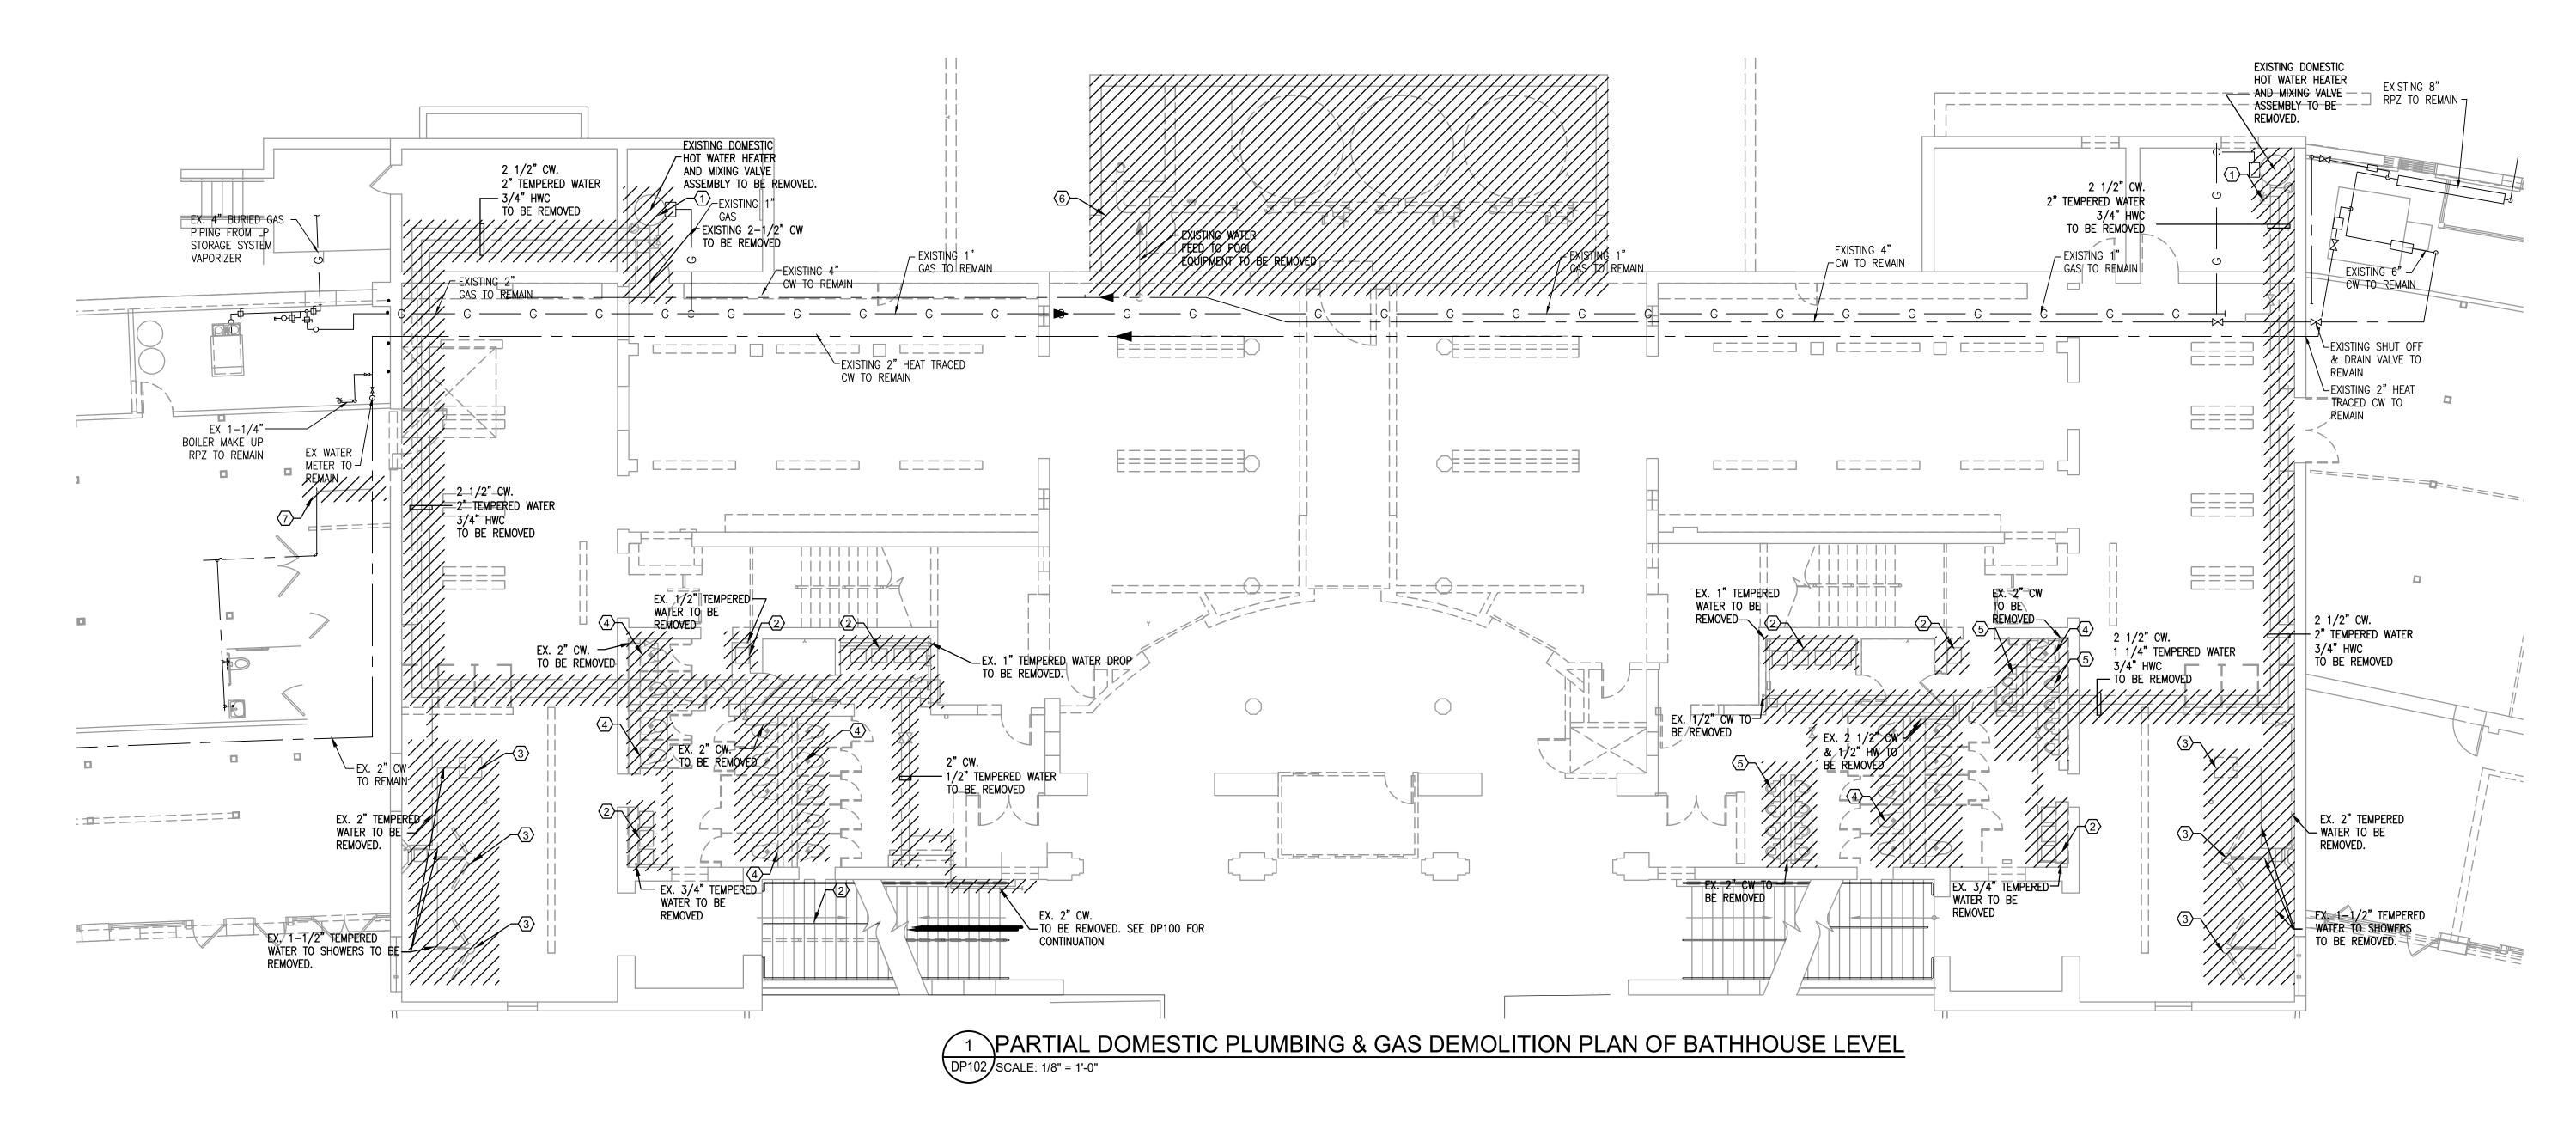
WESTCHESTER COUNTY, NEW YORK ES AS NOTED ANGES PROJECT COORDINATOR SIGNATURE

DIVISION OF ENGINEERING REHABILITATION OF POOL AND BATHHOUSE PLAYLAND PARK, RYE, NEW YORK PLUMBING DEMOLITION PLAN TUNNEL

CONTRACT NUMBER SHEET NUMBER DEPARTMENT OF PUBLIC WORKS & TRANSPORTATION 20-504 DP-100 SHEET NO. 109 OF 201 SCALE: **AS NOTED**DATE: **NOVEMBER 10, 2020**

DPW FILE NO.





PLUMBING DEMOLITION NOTES

- 1. EXISTING HOT WATER HEATER AND ALL ASSOCIATED WATER PIPING, CIRCULATOR PUMPS, THERMOSTATIC MASTER MIXING VALVE AND VENT PIPING TO BE REMOVED. EXISTING GAS PIPING TO BE DISCONNECTED AND SAFED OFF PRIOR TO REMOVAL.
- 2. EXISTING SINKS AND ALL ASSOCIATED WATER PIPING AND WALL CARRIERS TO BE REMOVED
- 3. EXISTING SHOWER UNITS AND UNDERGROUND VALVE CONNECTION BOX FOR FUTURE SHOWER TO BE REMOVED. ALL ASSOCIATED WATER PIPING TO BE REMOVED.
- 4. EXISTING TOILETS AND ALL ASSOCIATED WATER PIPING & CARRIERS TO BE REMOVED
- 5. EXISTING URINALS AND ALL ASSOCIATED WATER PIPING & CARRIERS TO BE REMOVED

- 6. CONTRACTOR TO REMOVE ALL PIPING, PUMPS, WATER PIPING AND ACCESSORIES IN EXISTING POOL FILTER ROOM. ALL PIPING FEEDING EXISTING POOL EQUIPMENT SHALL BE CUT BACK TO THE MAIN.
- 7. CONTRACTOR TO REMOVE 2" CW TIE IN FROM CONCESSION LINE TO BATHROOM.

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PAD


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VIOLATION OF SECTION 7209 OF THE NEW YORK STATE EDUCATION LAW.			AS BUILT — CHANGES AS NOTED AS BUILT — NO CHANGES		DEPARTMENT OF PUBLIC WORKS & TRANSPORTATION DIVISION OF ENGINEERING	
IN CHARGE OFJHM			CONTRACTOR	PROJECT COORDINATOR	REHABILITATION OF POOL AND BATHHOUSE	+;

DATE __

SIGNATURE

SIGNATURE

PLAYLAND PARK, RYE, NEW YORK DOMESTIC PLUMBING DEMOLITION PLAN BATHHOUSE LEVEL

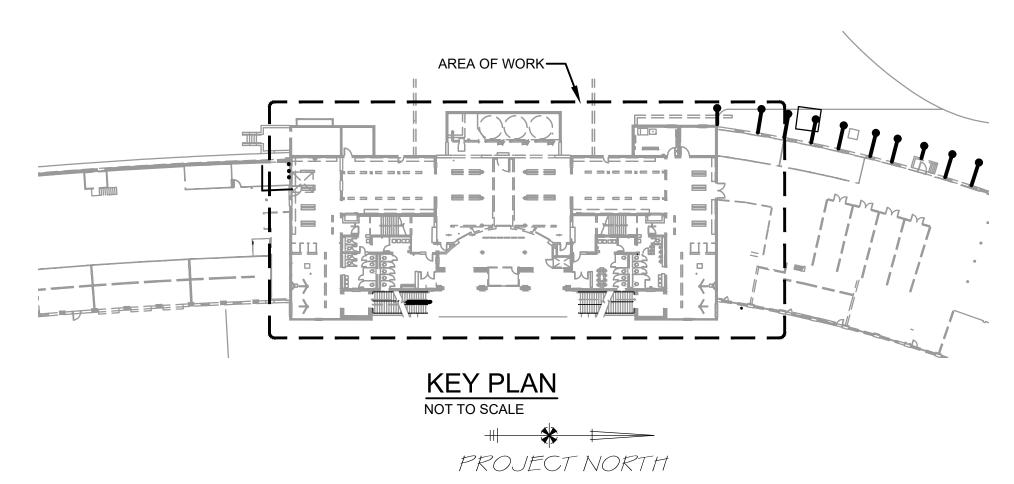SCALE: **AS NOTED** DATE: NOVEMBER 10, 2020 DPW FILE NO. 1-19-P-468


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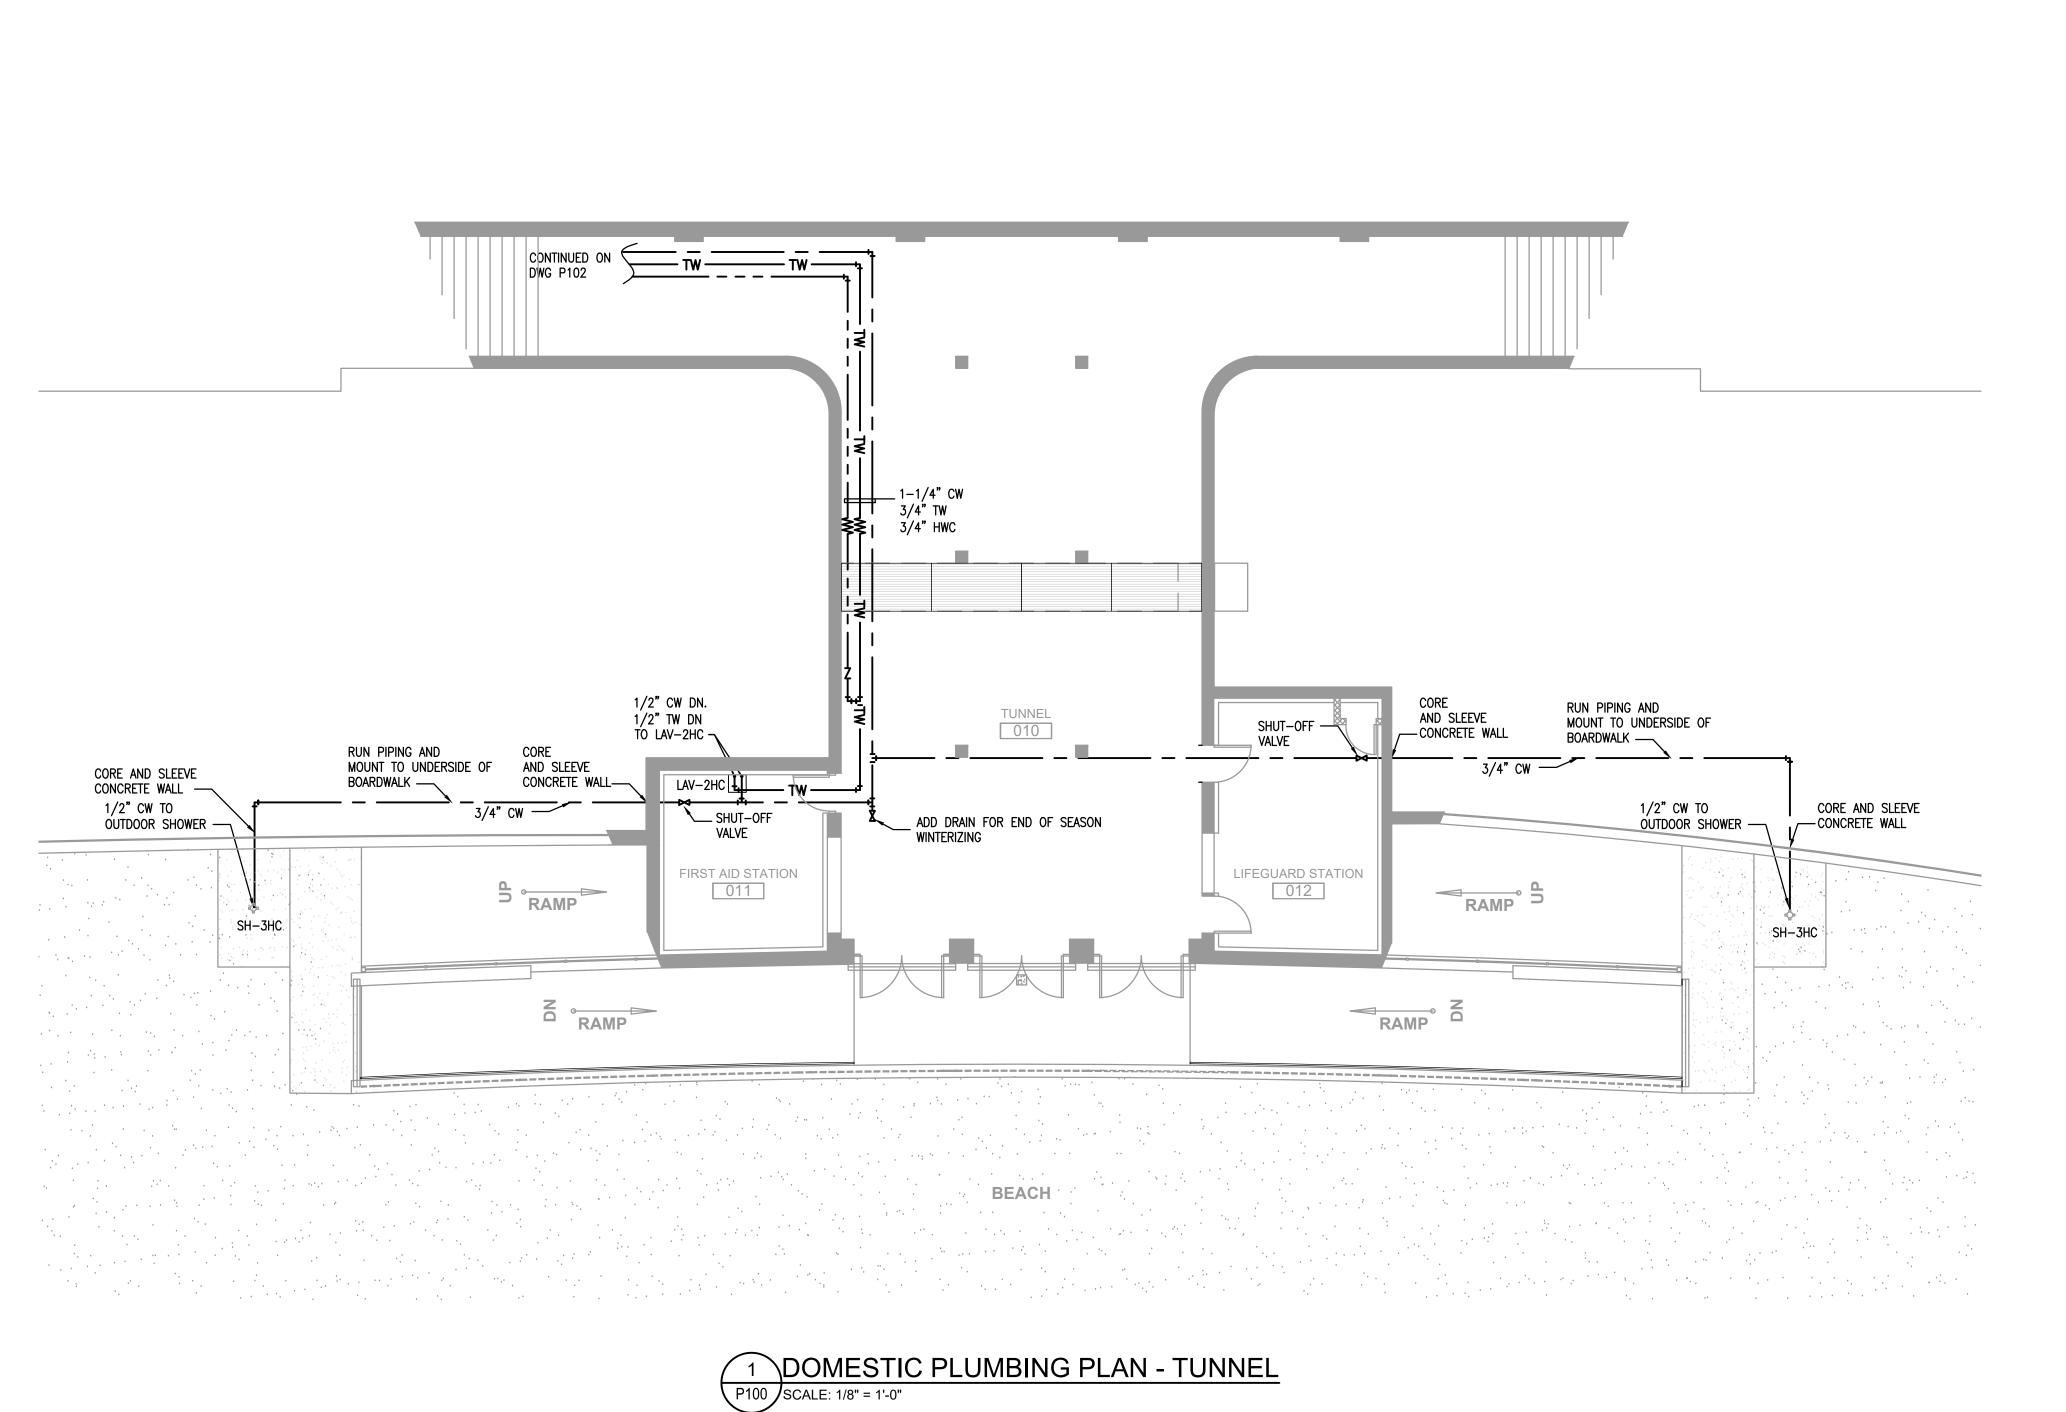
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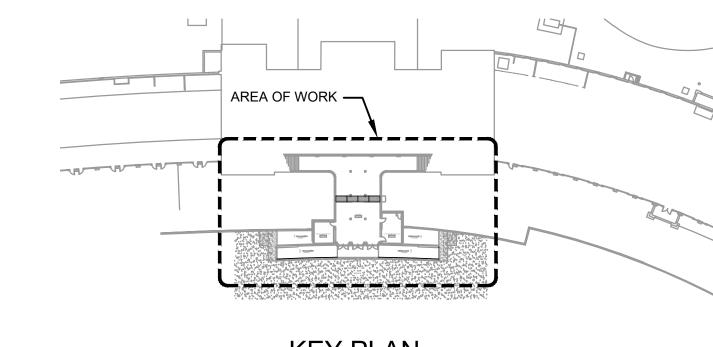
DP-102

CONTRACT NUMBER

20-504





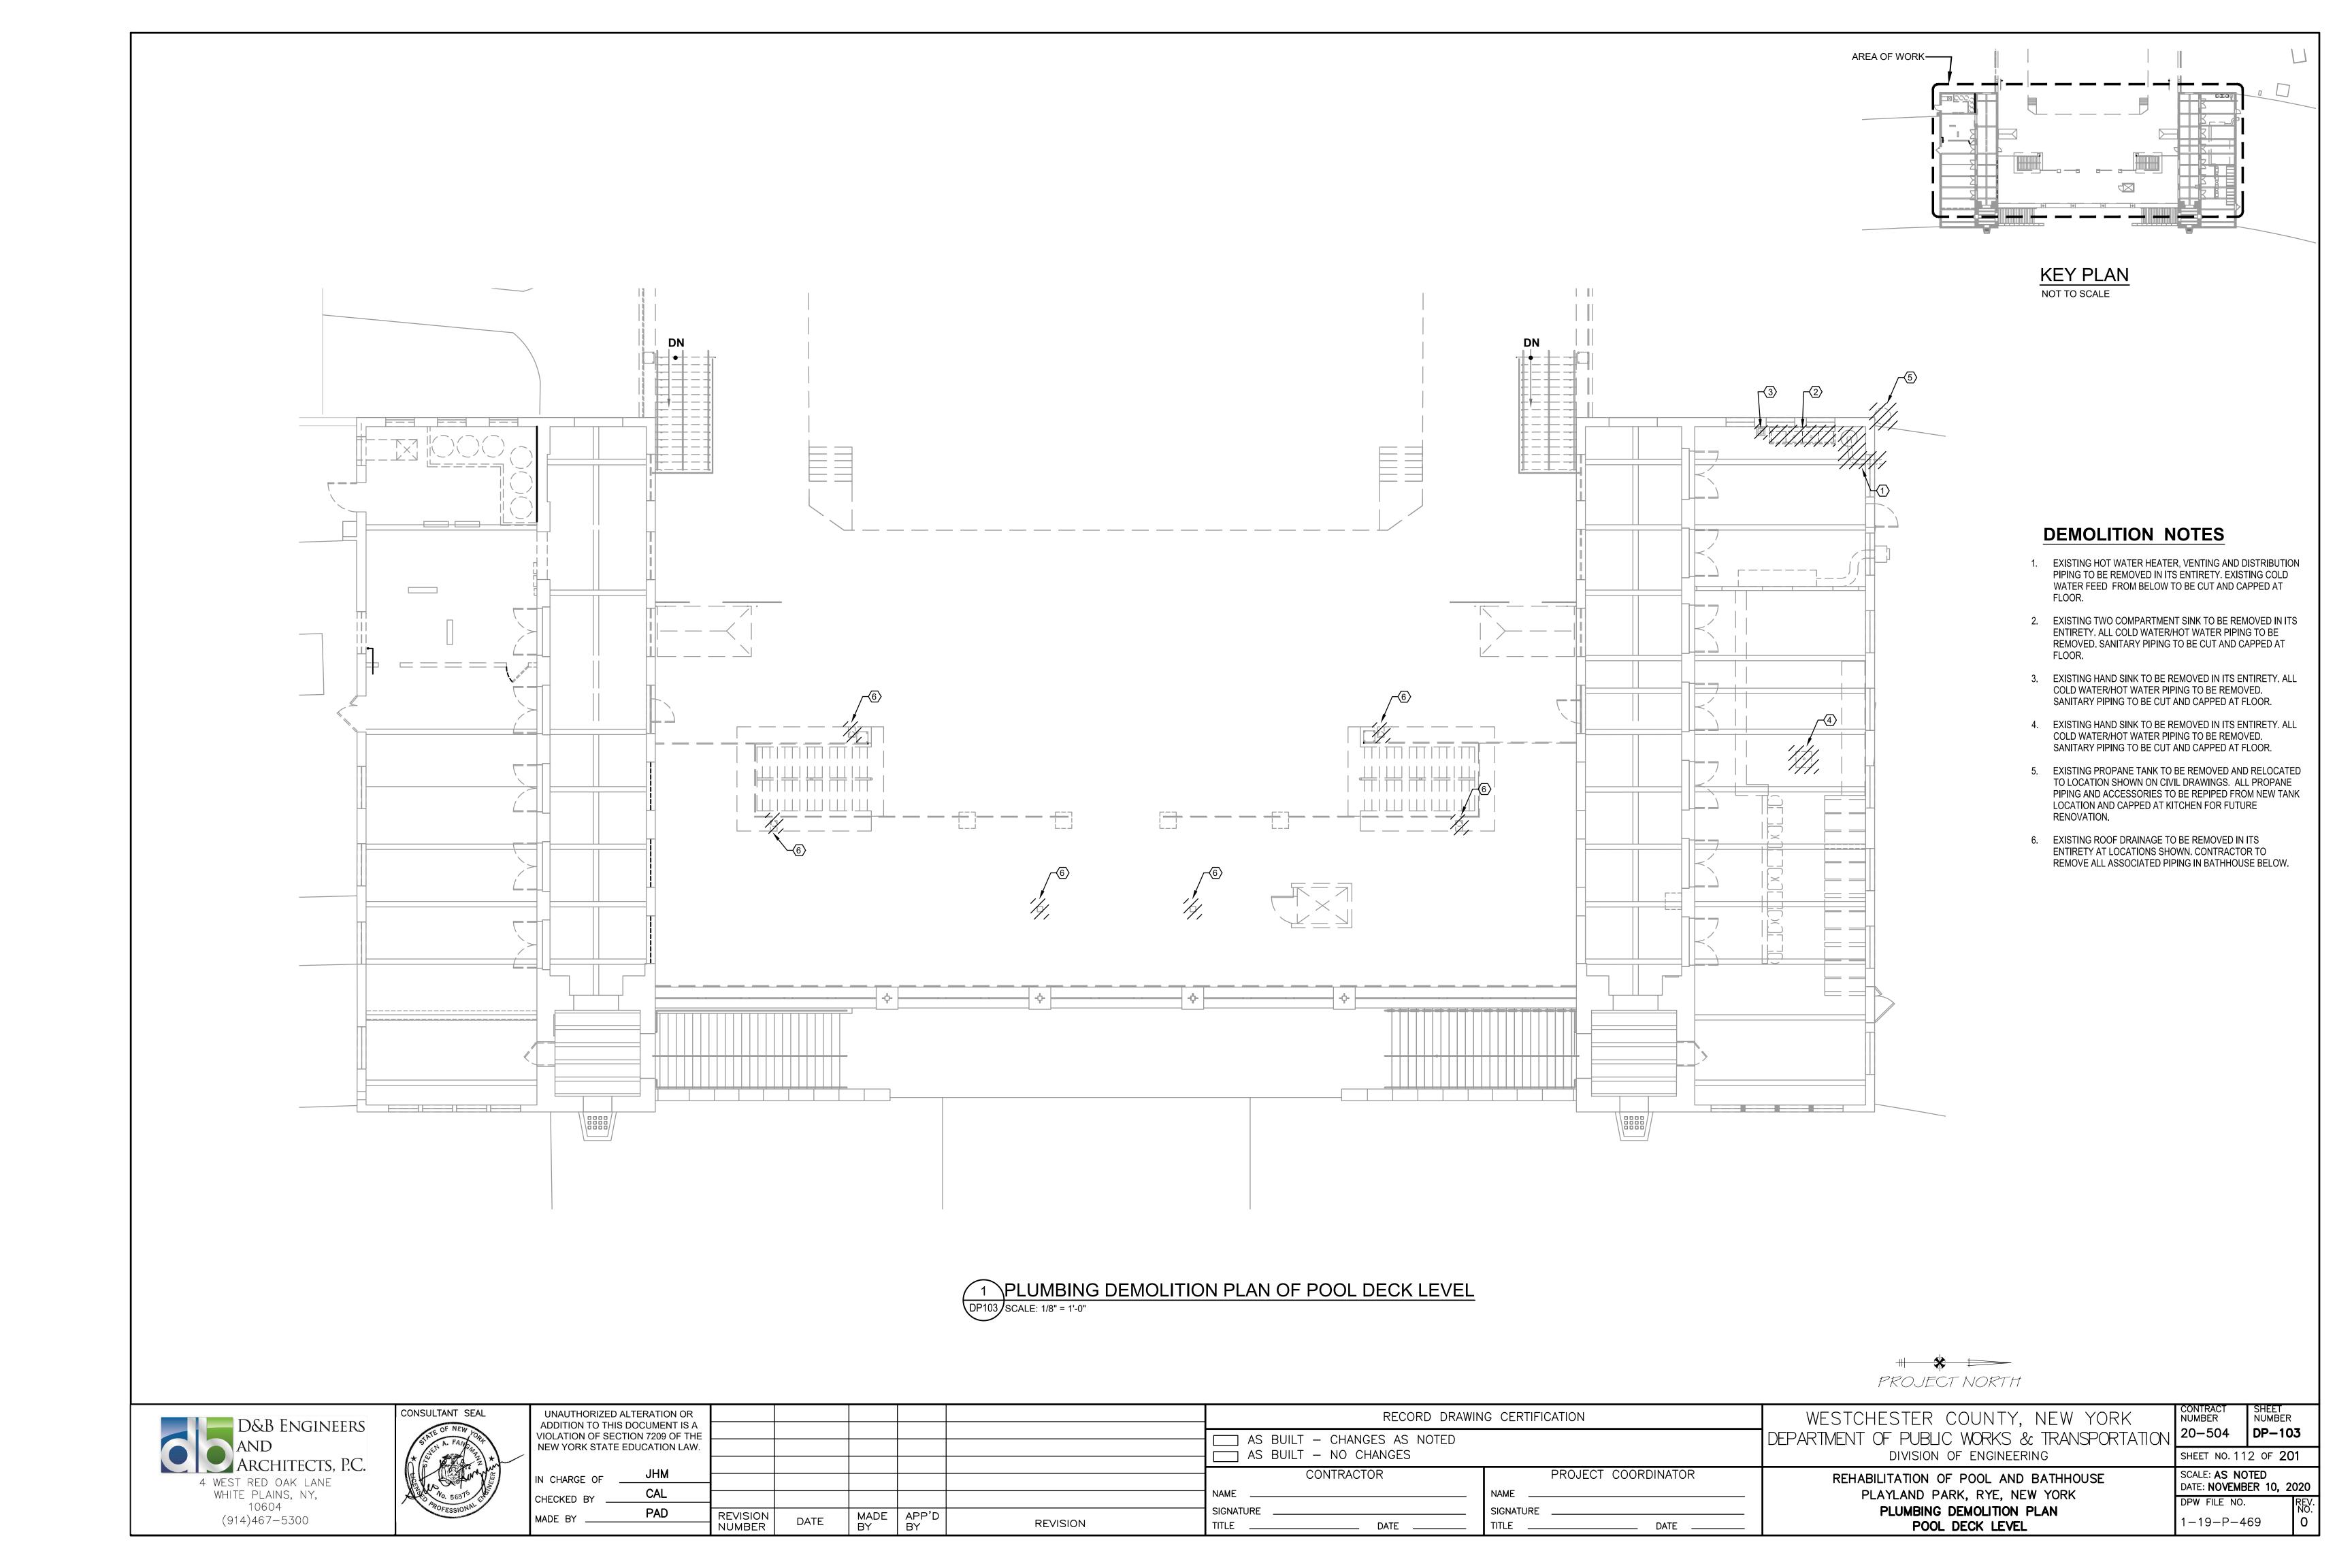

KEY PLAN
NOT TO SCALE








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		•						AS BUILT - NO CHANGES		DIVISION OF ENGINEERING	SHEET NO.	113
	IN CHARGE OF	JHM						CONTRACTOR	PROJECT COORDINATOR		SCALE: AS I DATE: NOVE I	
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	WADE DI		NUMBER	DATE	BY	BY	REVISION	TITLE DATE	TITLE DATE	TUNNEL	1-19-P-	-4/0


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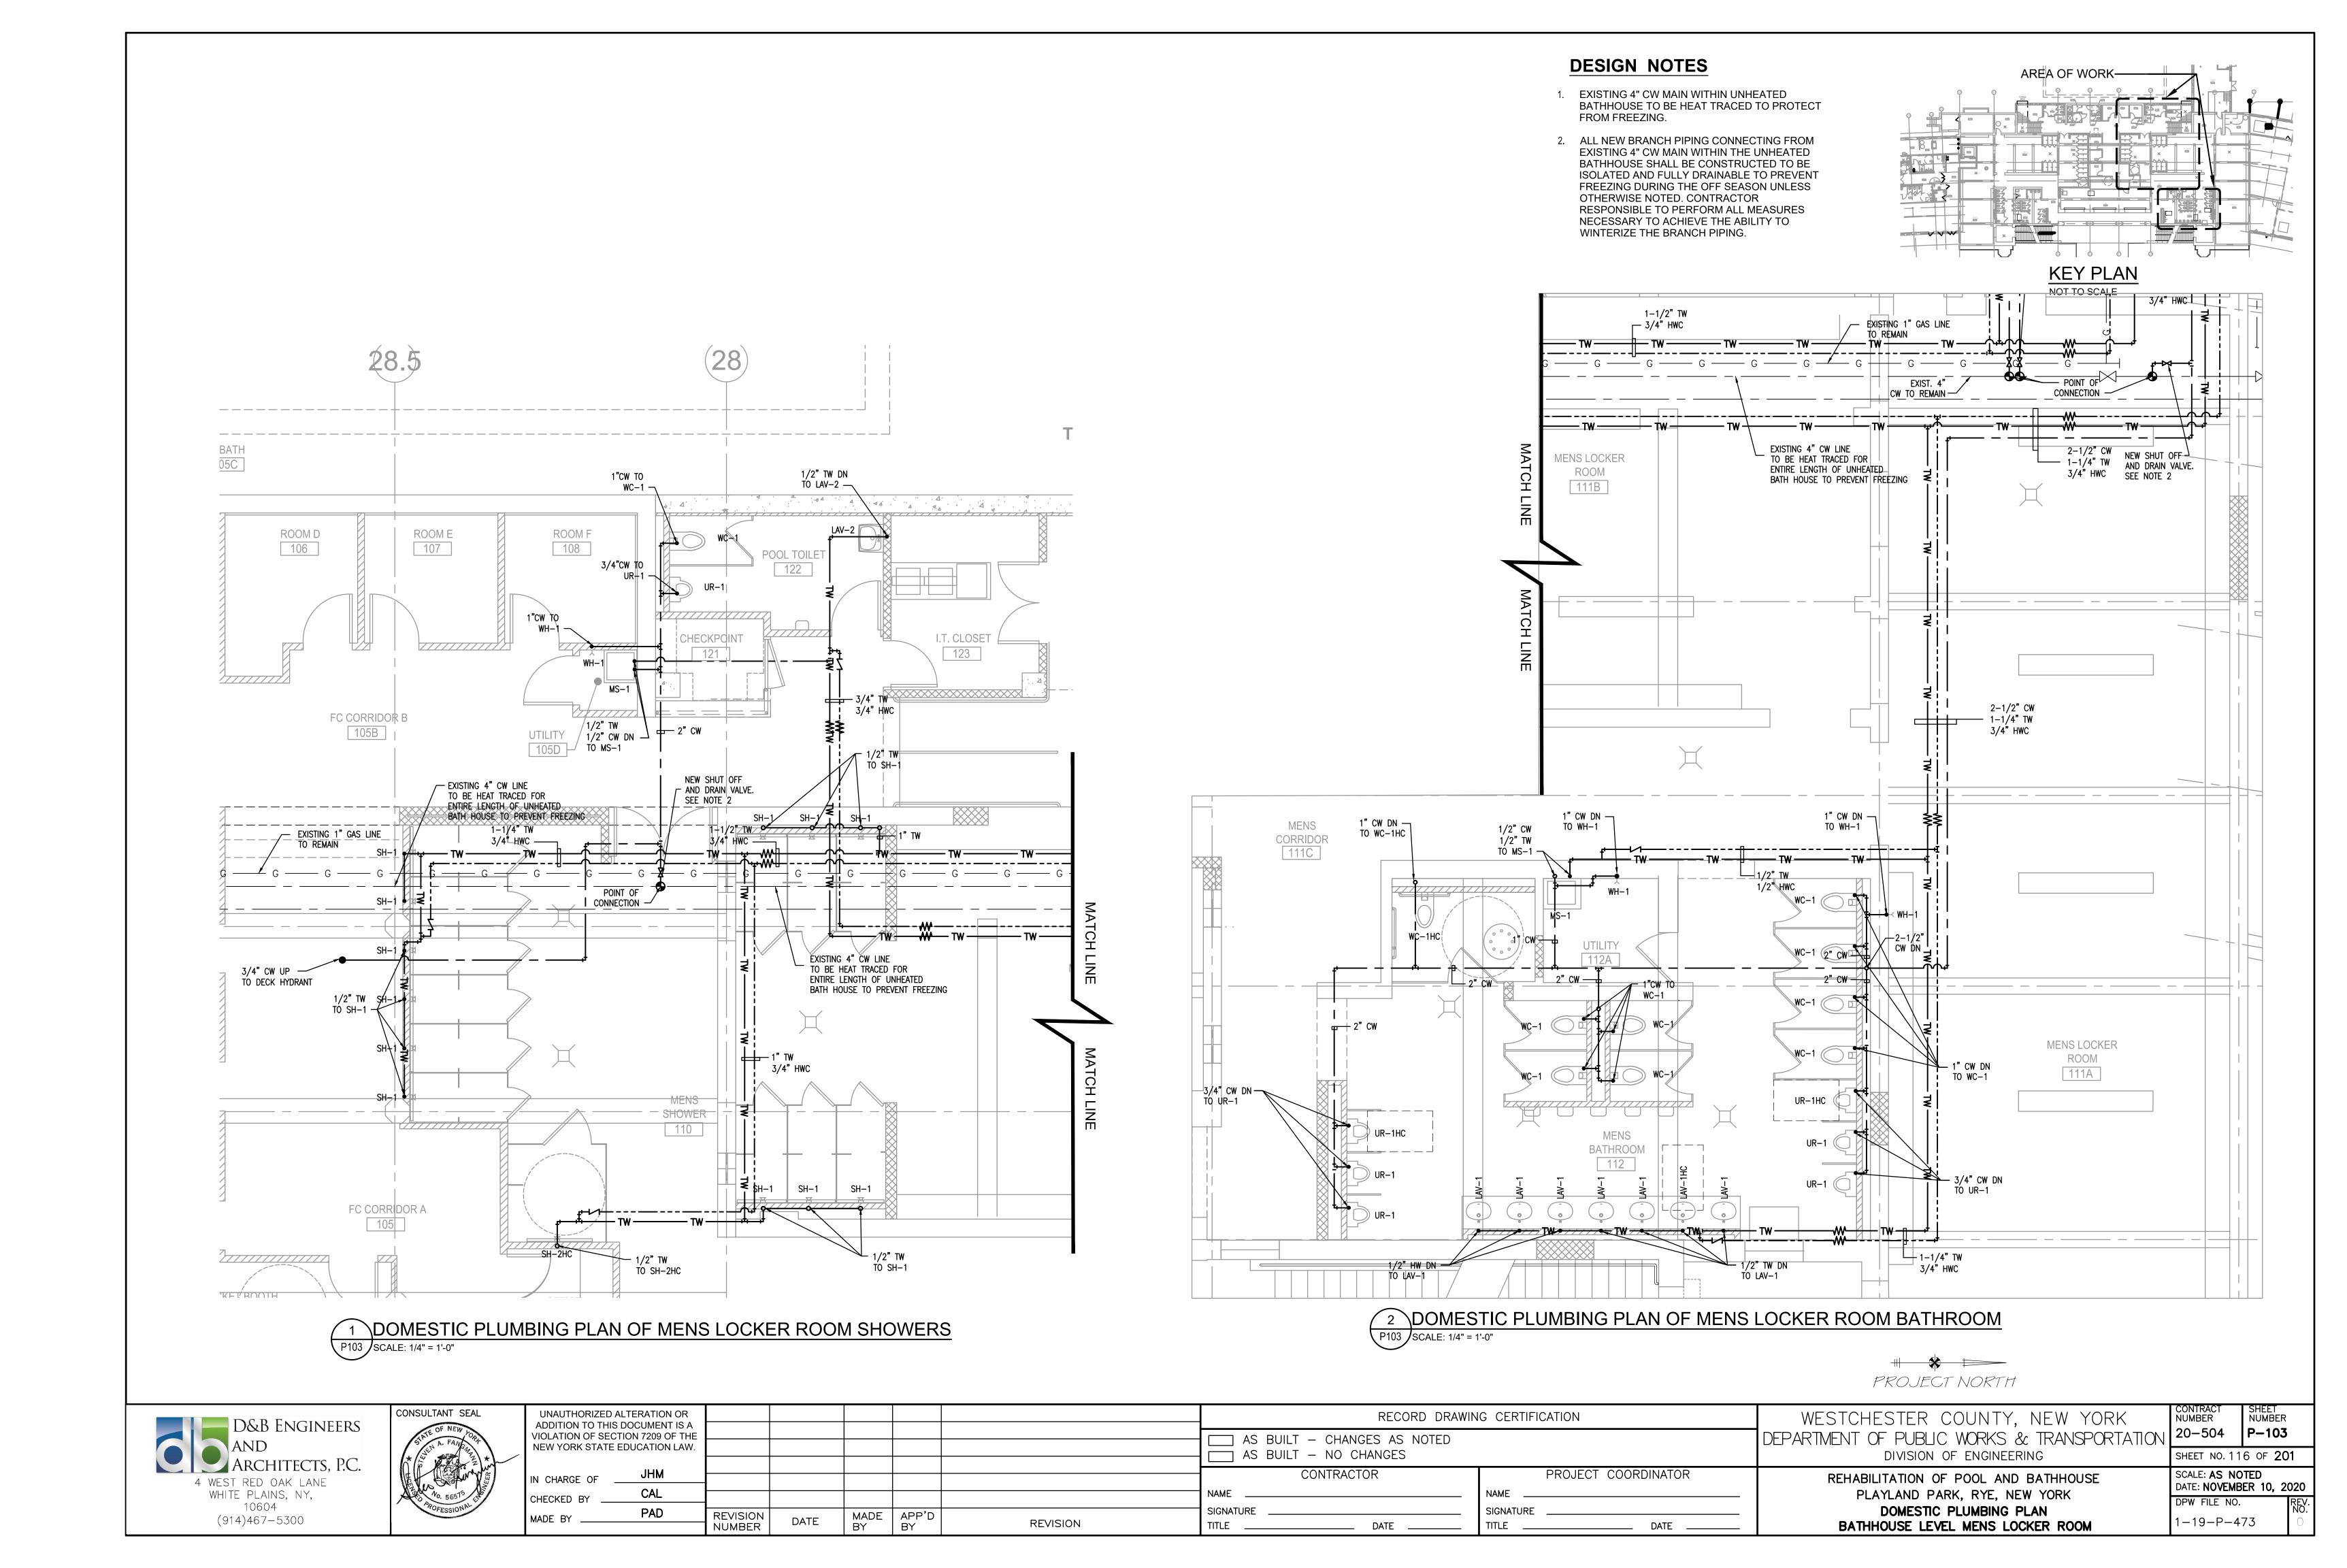
SHEET NO. 113 OF **201**


SHEET NUMBER


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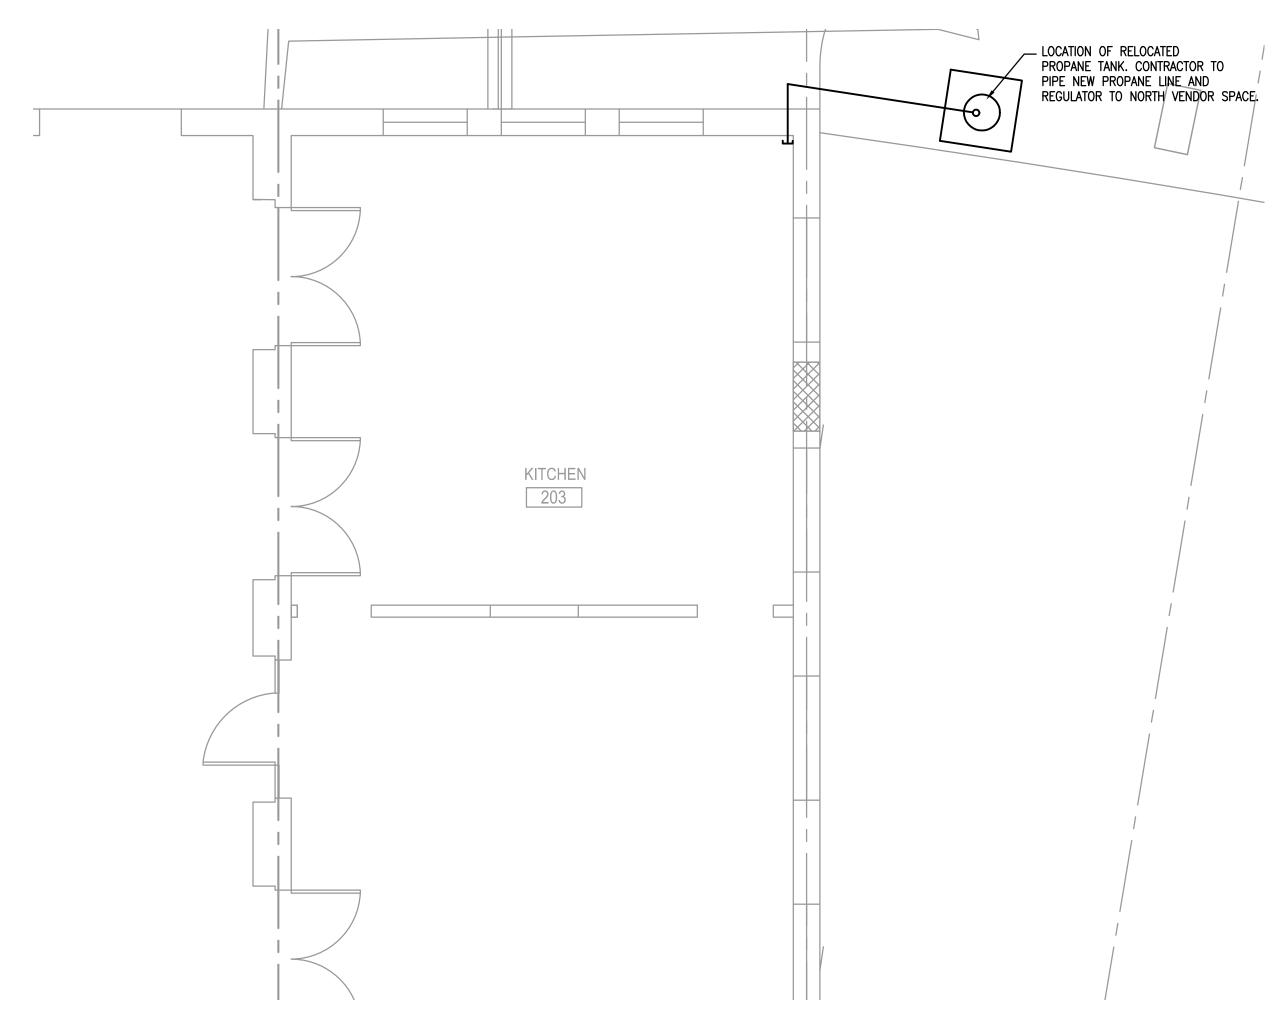




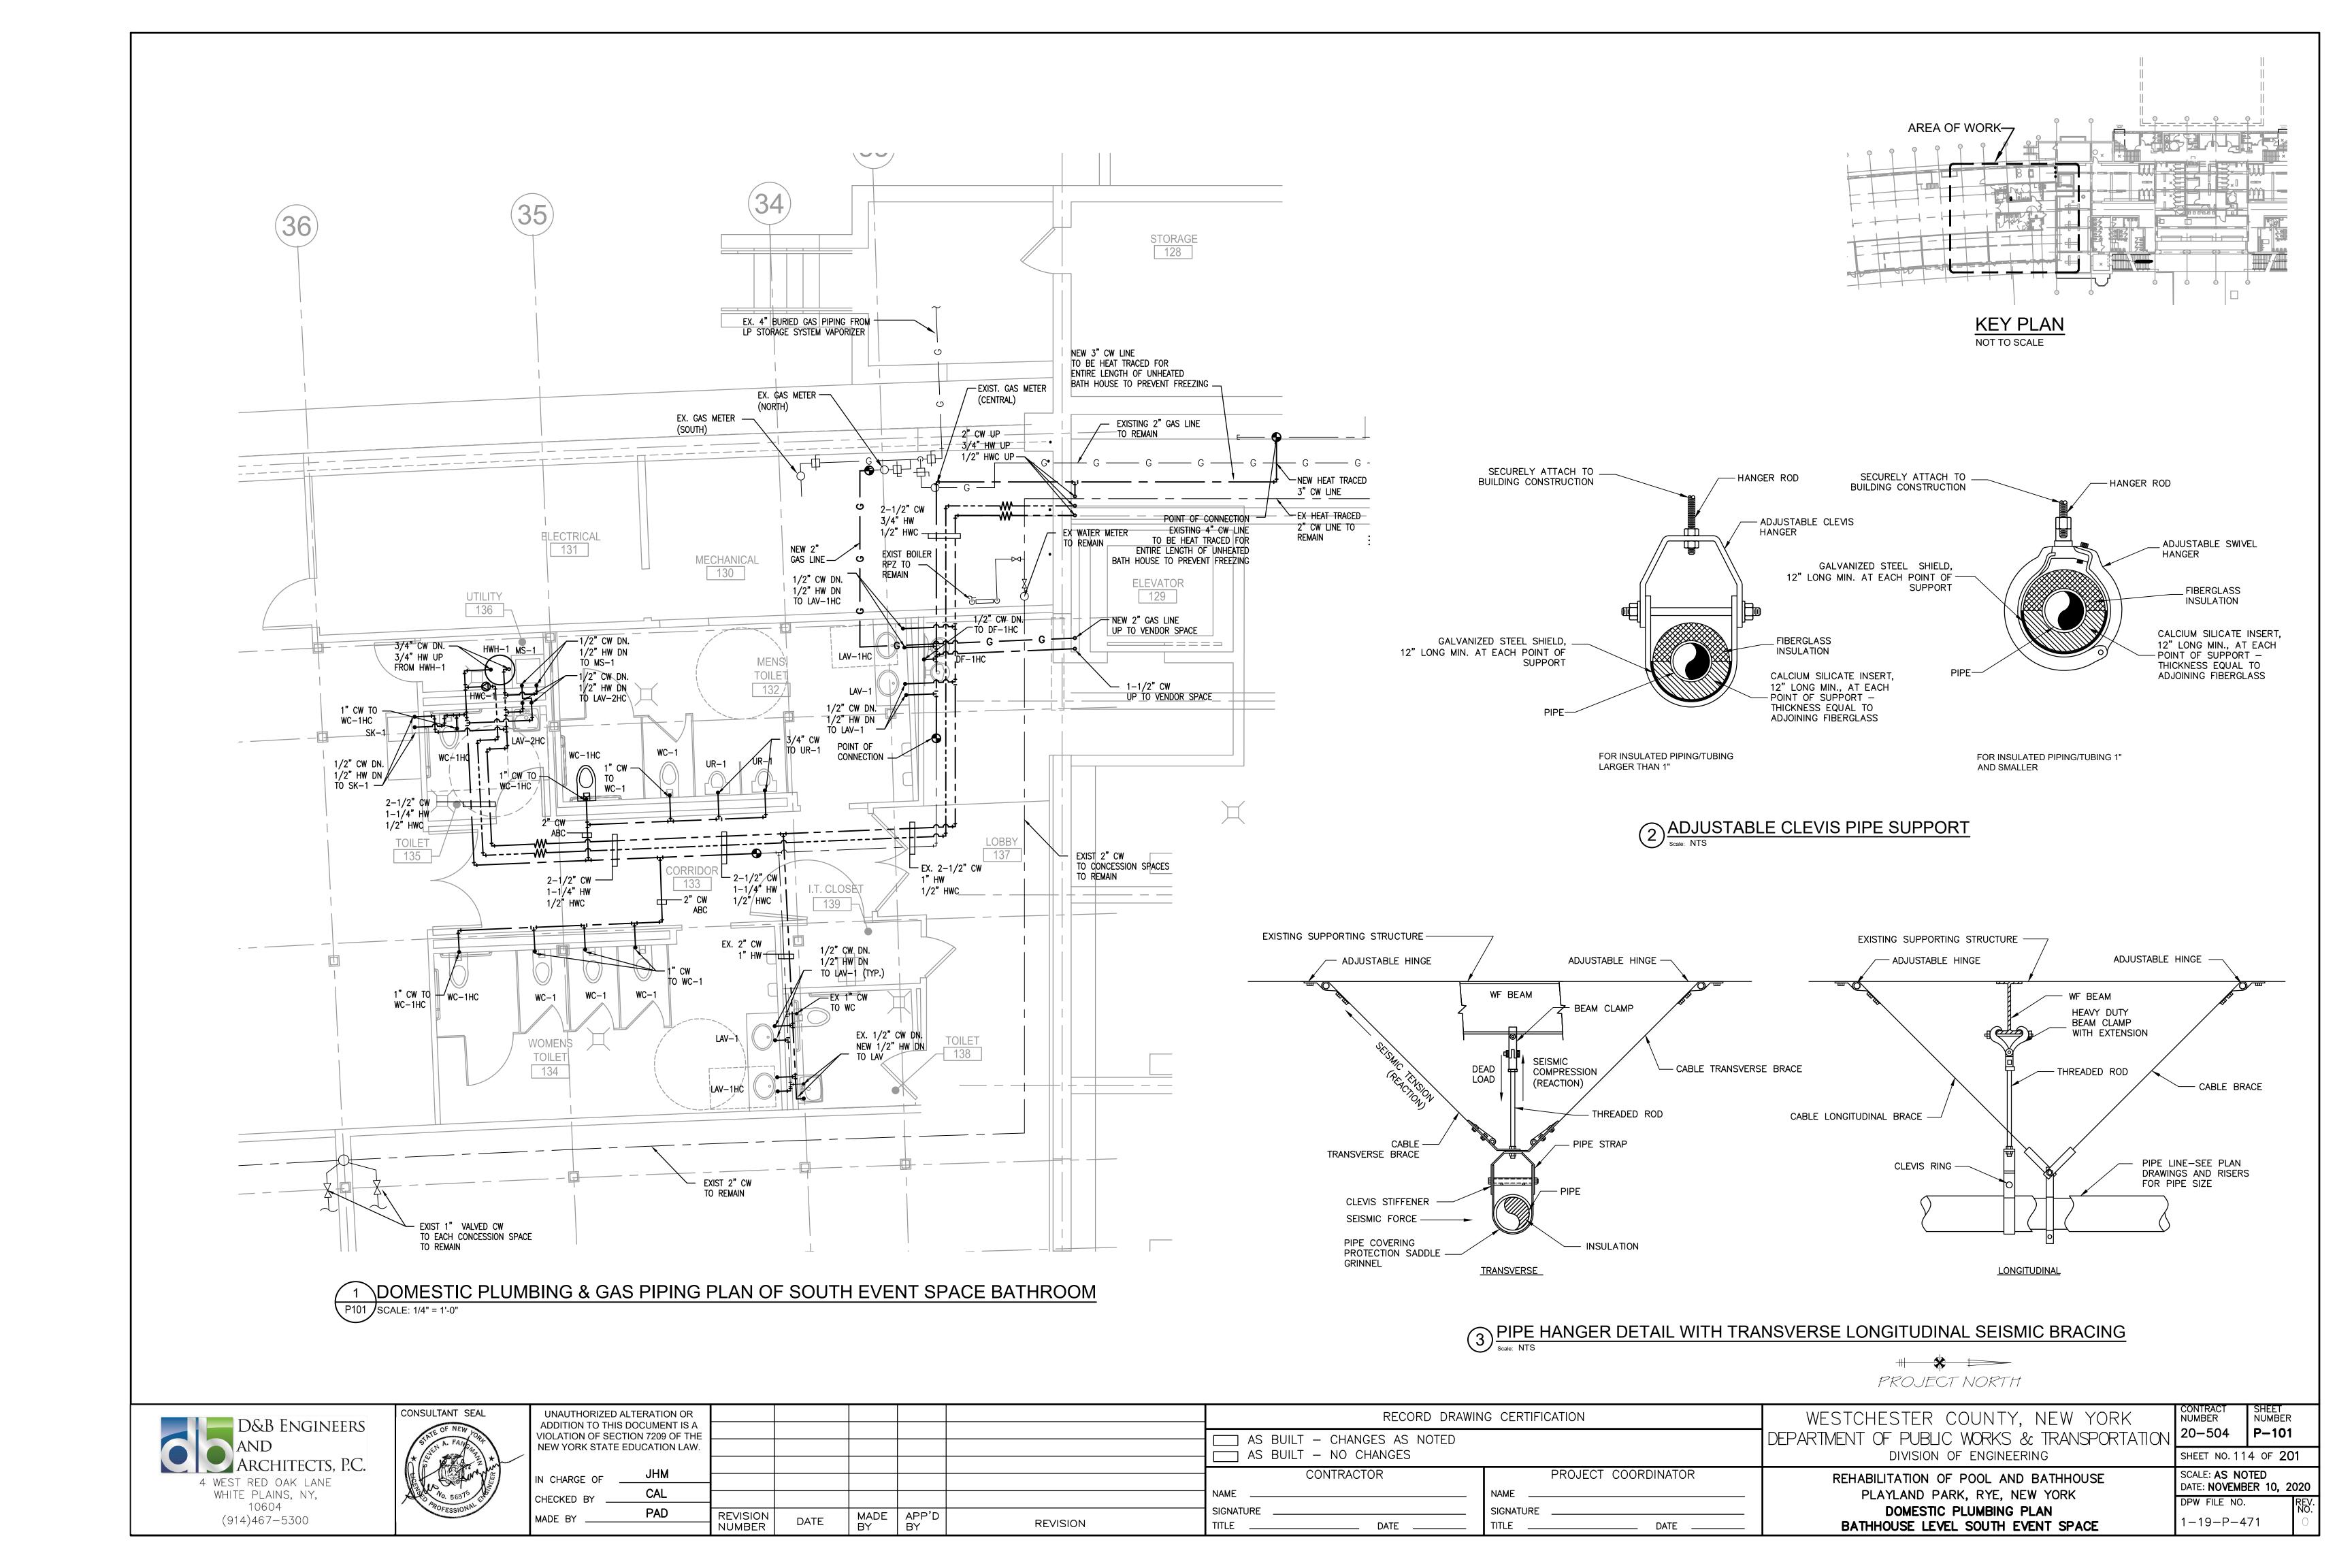

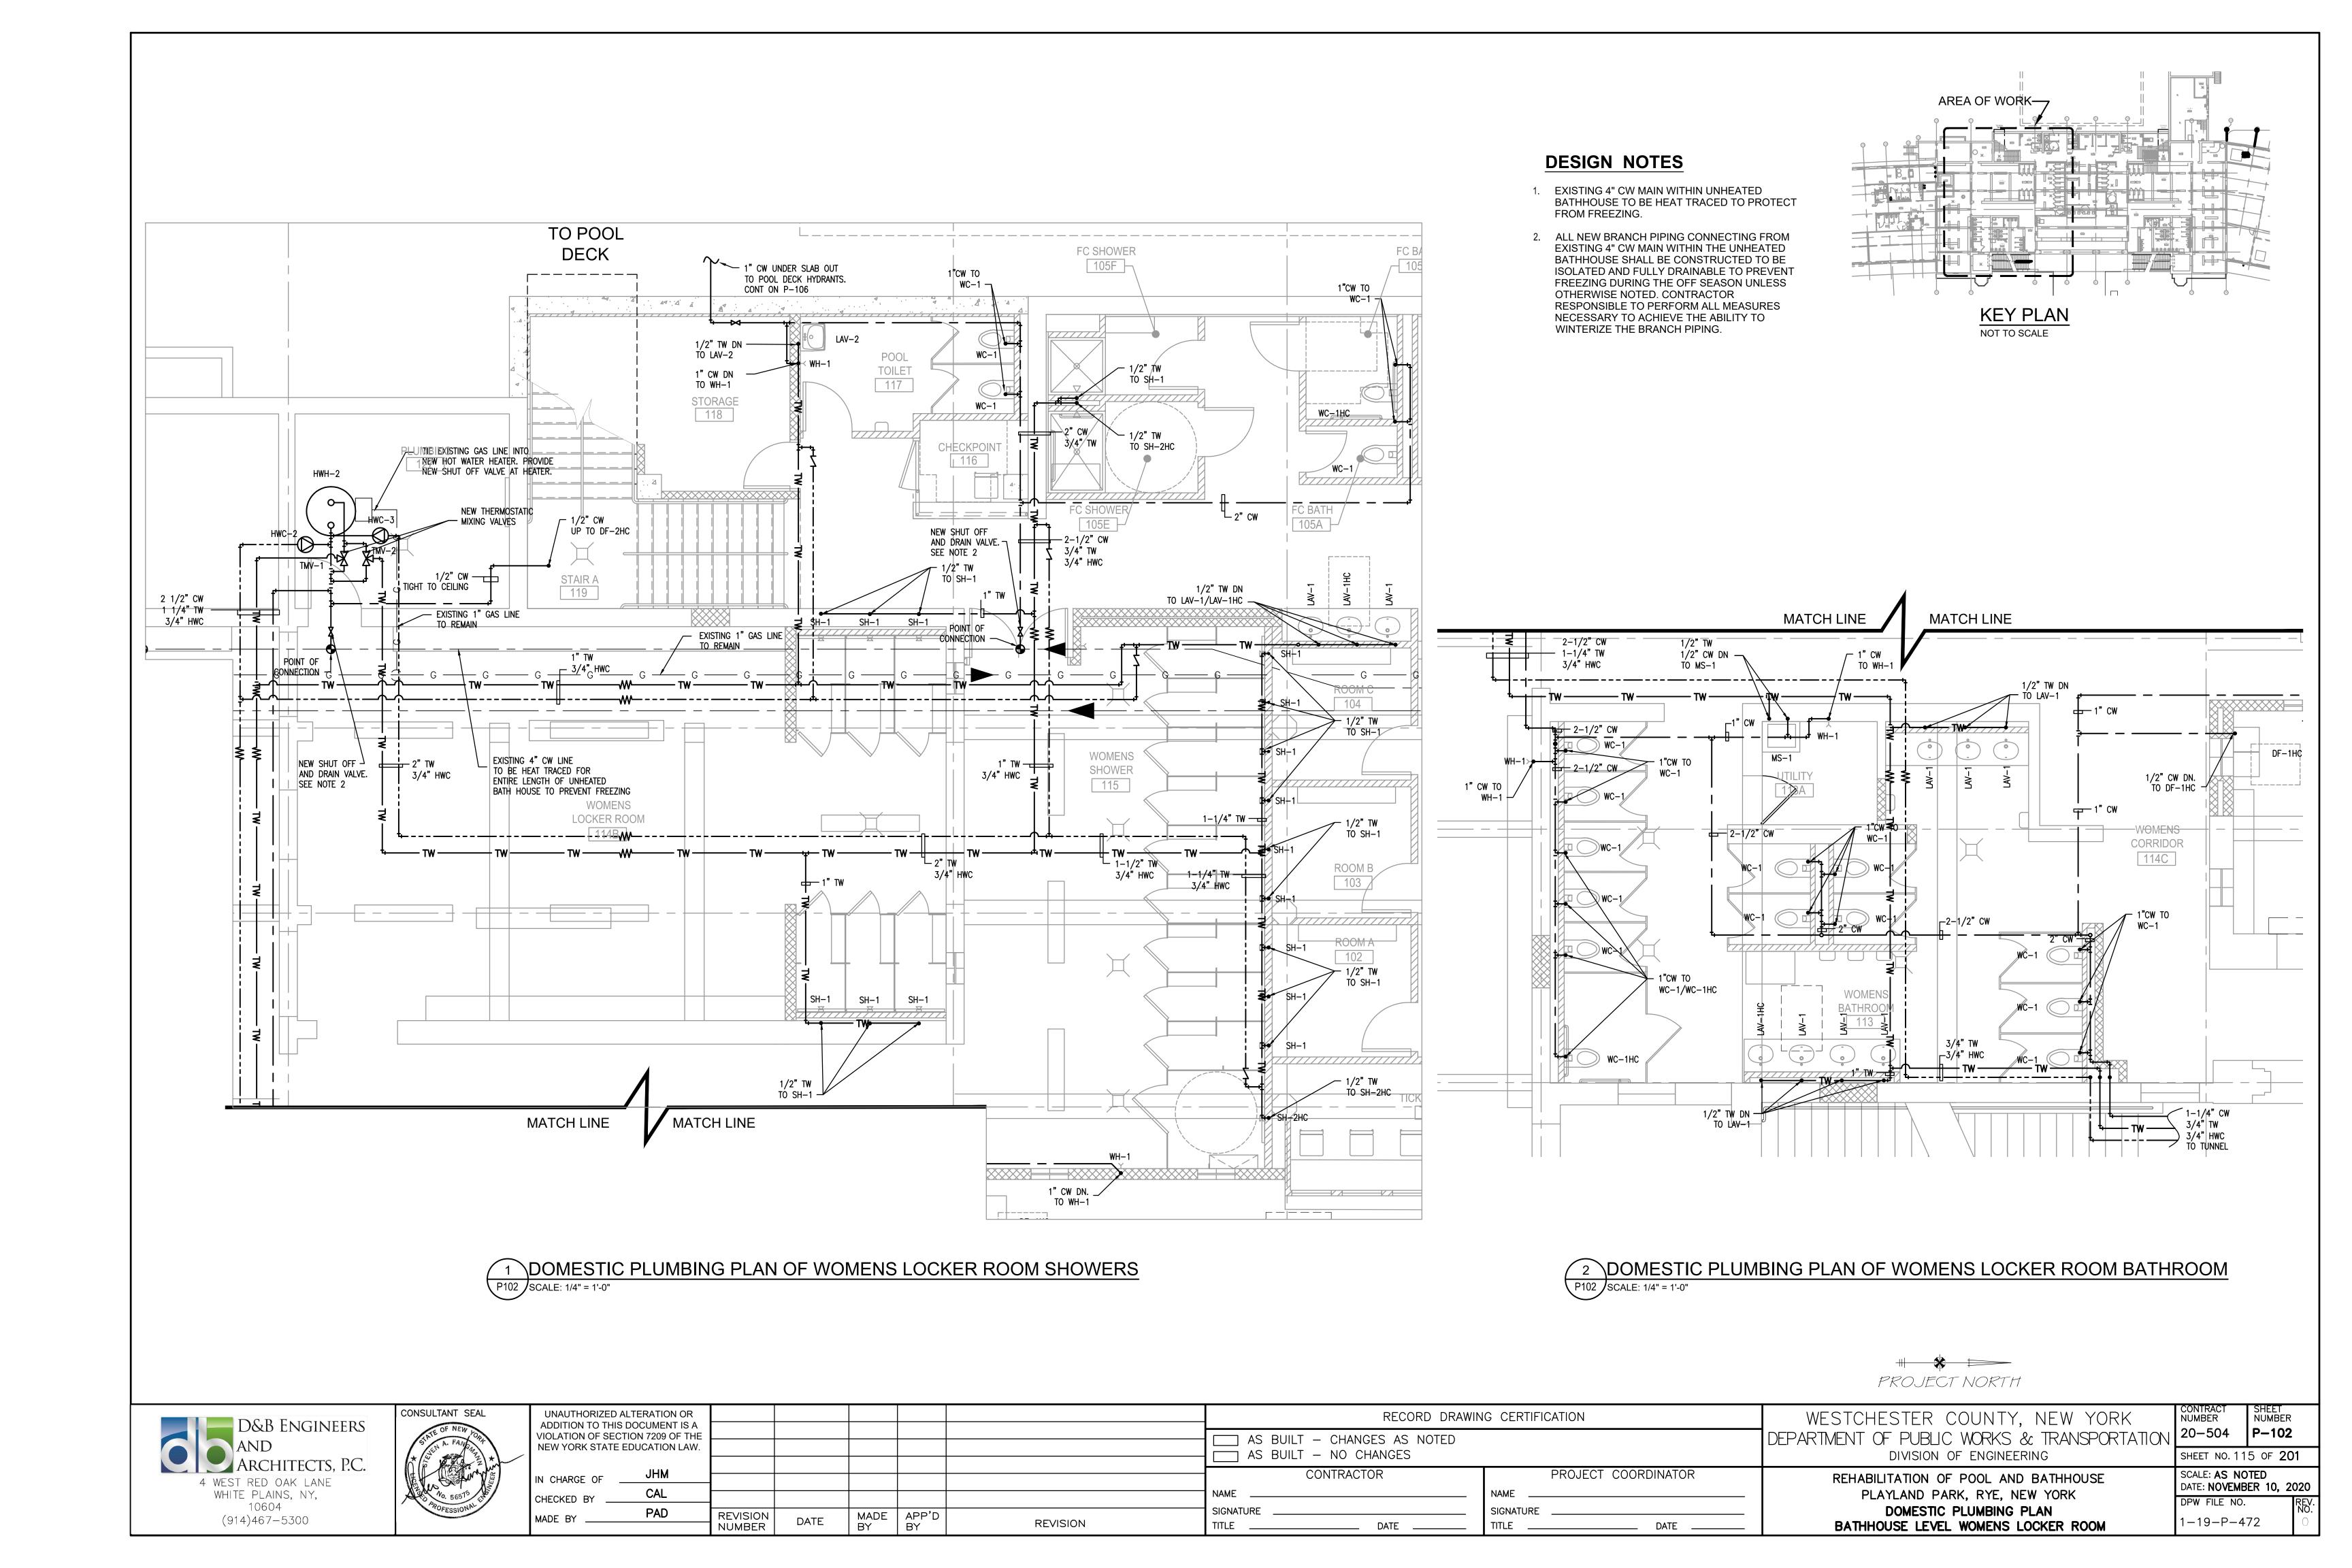

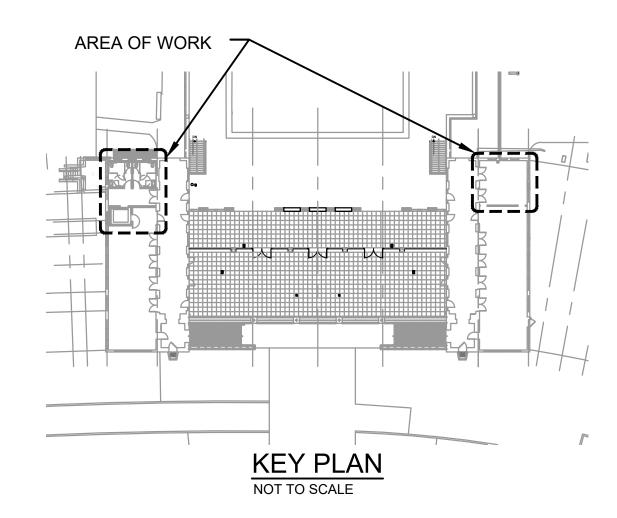1 DOMESTIC PLUMBING PLAN OF POOL DECK SOUTH VENDOR SPACE
P104 SCALE: 1/4" = 1'-0"

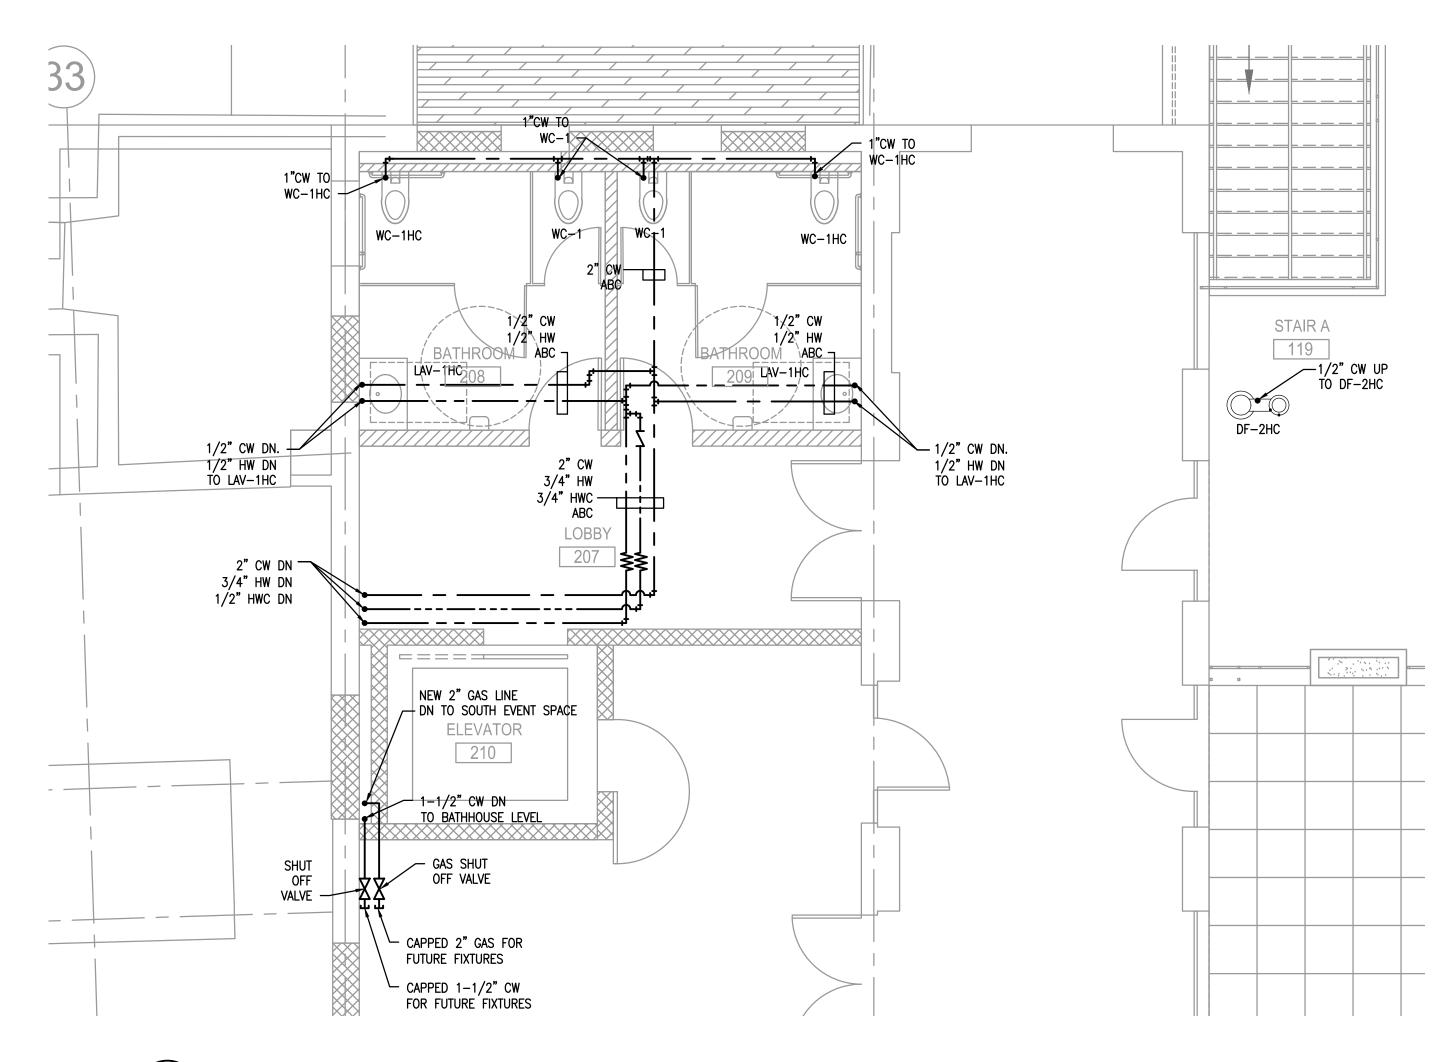

2 DOMESTIC PLUMBING PLAN OF POOL DECK NORTH VENDOR SPACE P104 SCALE: 1/4" = 1'-0"

SIGNATURE

DATE ___

SIGNATURE







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RECORD DRAWIN	G CERTIFICATION	WESTCHESTER COUNTY, NEW YORK
☐ AS BUILT — CHANGES AS NOTED☐ AS BUILT — NO CHANGES		DEPARTMENT OF PUBLIC WORKS & TRANSPORTATION OF ENGINEERING
CONTRACTOR	PROJECT COORDINATOR	REHABILITATION OF POOL AND BATHHOUSE

REHABILITATION OF POOL AND BATHHOUSE
PLAYLAND PARK, RYE, NEW YORK

DOMESTIC PLUMBING PLAN
POOL DECK LEVEL

20-504 P-104


SHEET NO. 117 OF 201


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DATE: NOVEMBER 10, 2020


DPW FILE NO.
1-19-P-474


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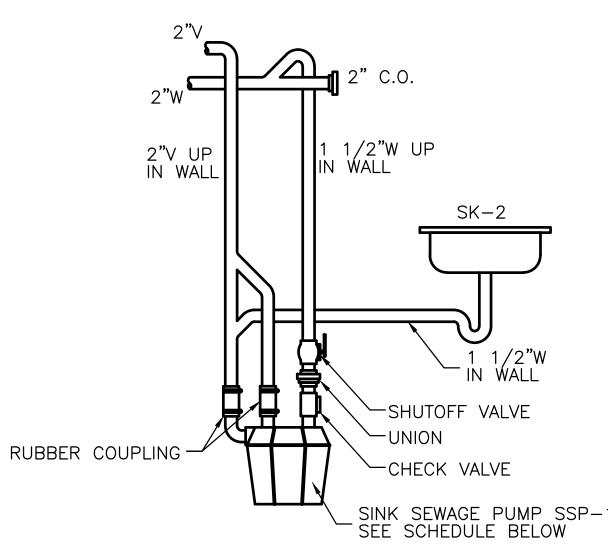
CONTRACT NUMBER



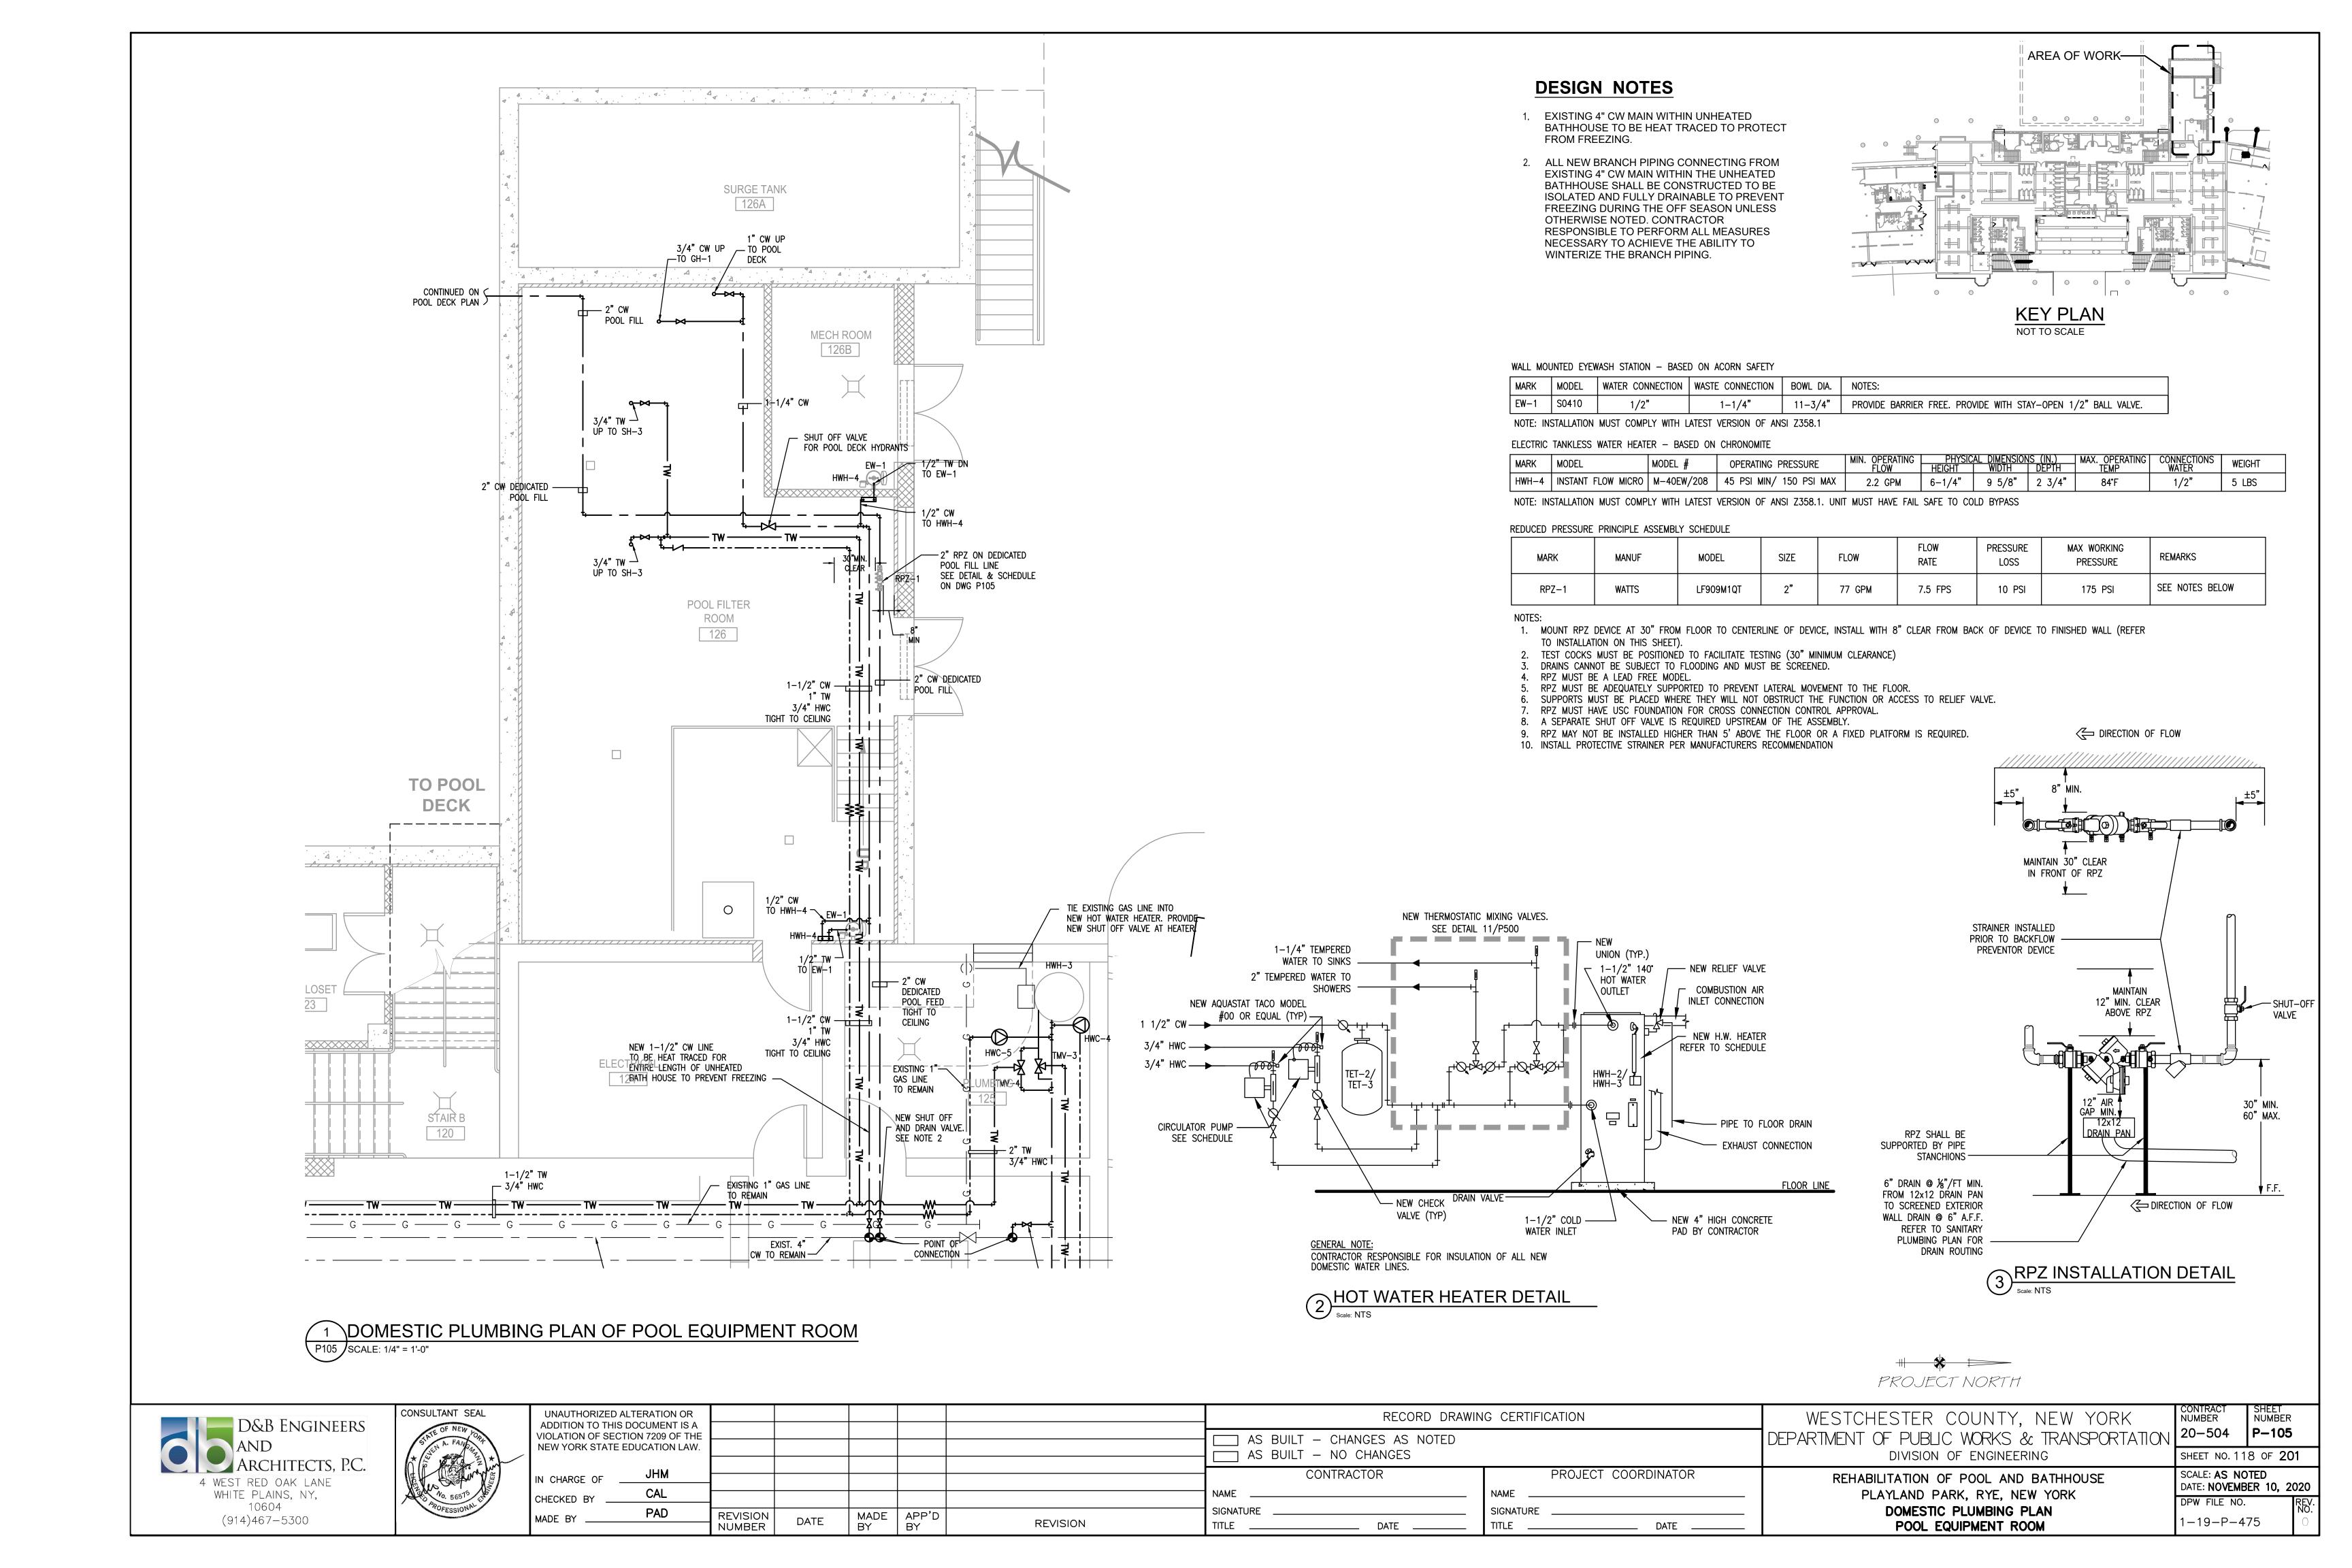

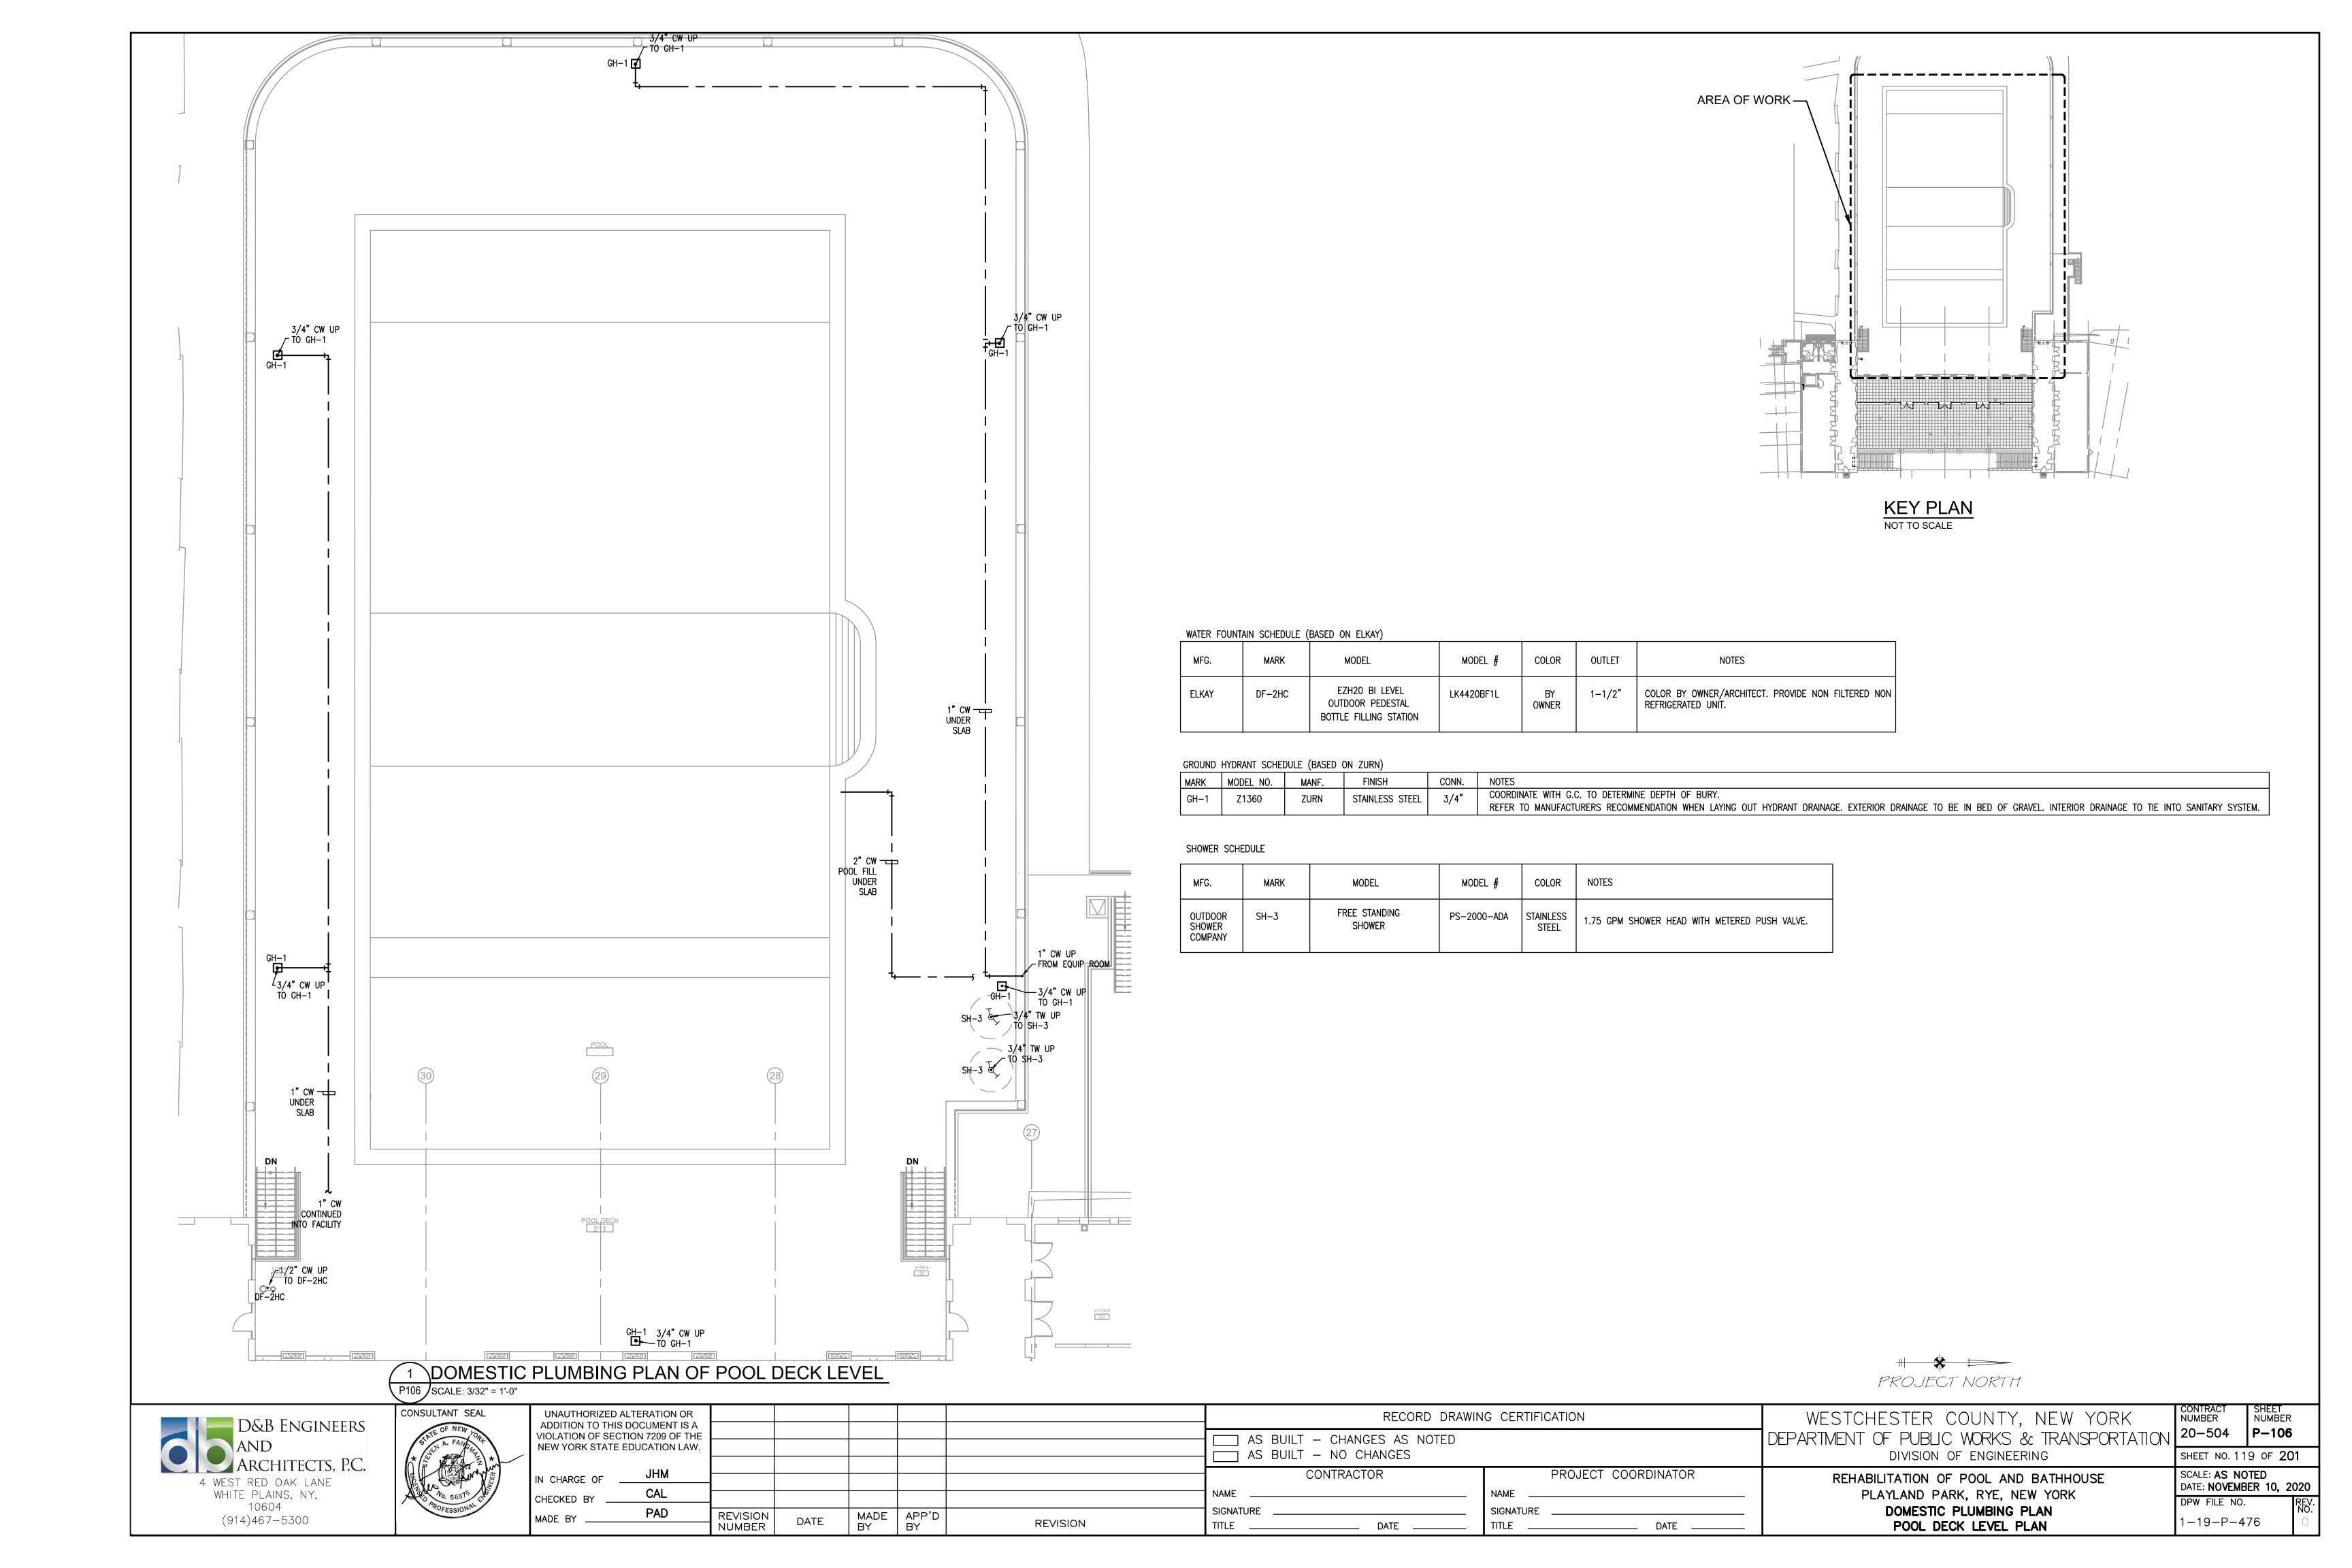

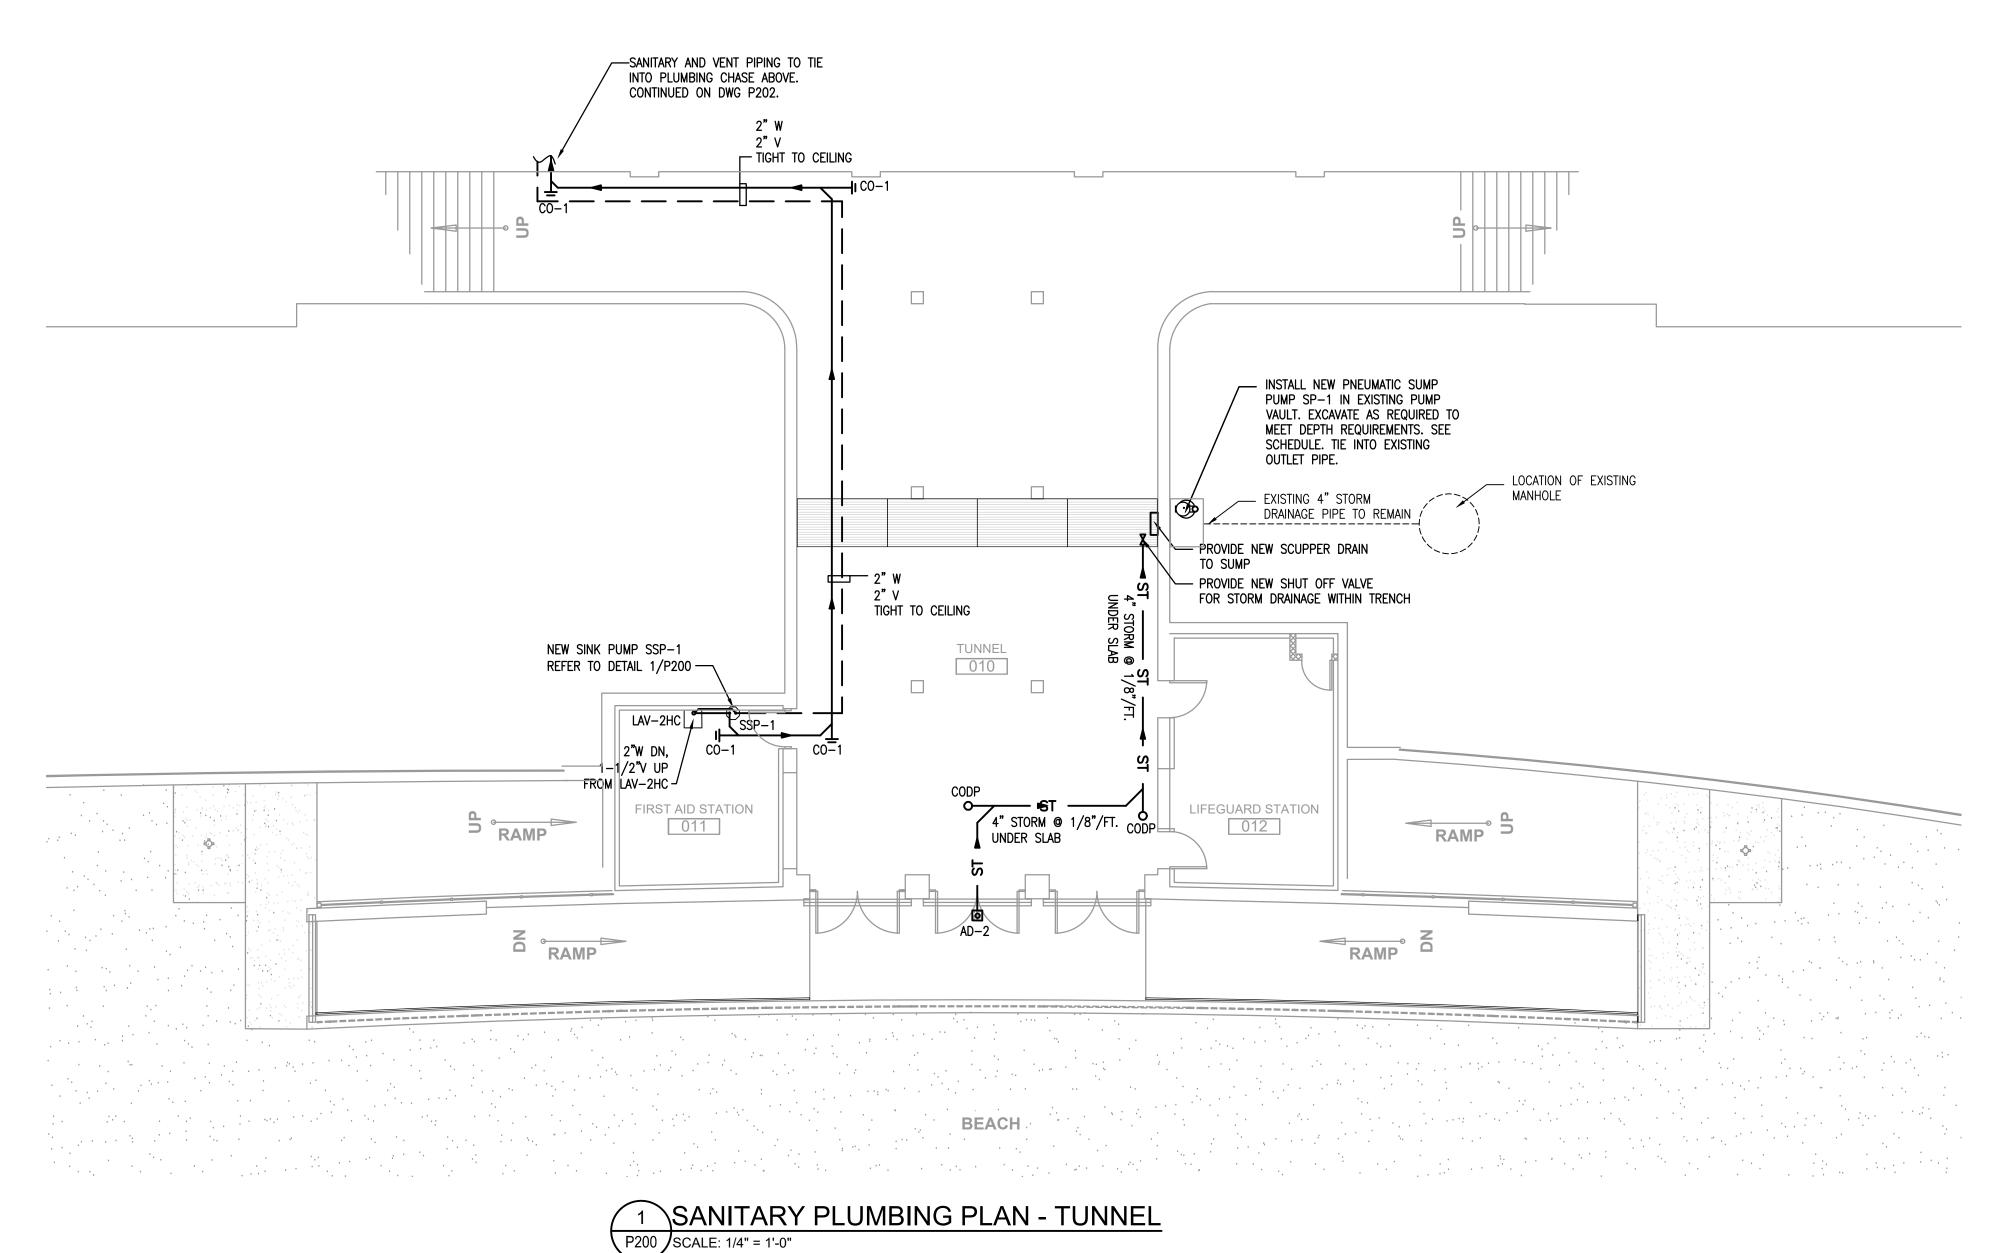

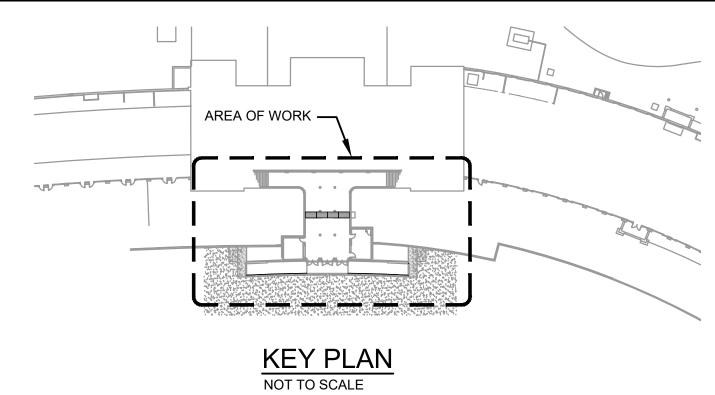

FIRST AID SINK PUMP PIPING DETAIL

Scale: NTS

Ì		MERSIBLE SUMP PUMP SCHEDULE: ARK MFR. MODEL # GPM HEAD IN PUMP DIA. SUMP INLET OUTLET CONTROL AIR INPUT INPUT REMOTE AIR COMPRESSOR OUTLET CONTROL AIR INPUT INPUT SCHOOL AIR COMPRESSOR								NOTES									
L	MARK	MFR.	MODEL #	MODEL # GPM		I OMI DIA	DEPTH SIZE SIZ		OUTLET SIZE	PANEL CONN. PRE		INPUT PRESSURE	RËSSURE SCFM SET PSI MAX PSI MOTOR POWER RECEIVER		RECEIVER	≀ Notes			
		CHICAGO INDUSTRIAL PUMP COMPANY	PITBULL S3C	40 AVG	20	18" NOM.	22" MIN	3*	3*	AP300	3/4"	100 PSIG	18.1 © 90PSIG	100 PSIG	155 PSIG	5.5HP PSIG	208V 1 PH 24 AMP	80 GAL.	STAINLESS STEEL CONSTRUCTION

SINK SEWAGE PUMP SCHEDULE:

	CIIII CEIII	<u> </u>								
	MARK	4455	MODEL #	ODM (1154D			MOTOR	RECEIVER	MAX LIQUID	
		MFR.	MODEL #	GPM/HEAD	H.P	RPM	ELECTRIC	AMPS	RECEIVER	TEMP.
	SSP-1	LIBERTY PUMPS	404	25 GPM • 12FT 5 GPM • 18FT	1/3	3450	115/1/60	5.3	MOLDED POLYOLEFIN	140°F

area drain	SCHEDUL	_E:				
LOCATION	MARK	MFG.	MODEL #	OUTLET	DRAIN	NOTES
TUNNEL ENTRANCE	AD-2	ZURN	Z1730	4"ø	9" DIA	

PROJECT NORTH

D&B ENGINEERS AND ARCHITECTS, P.C.
ARCHITECTS, P.C.
4 WEST RED OAK LANE
WHITE PLAINS, NY,
10604
(914)467-5300




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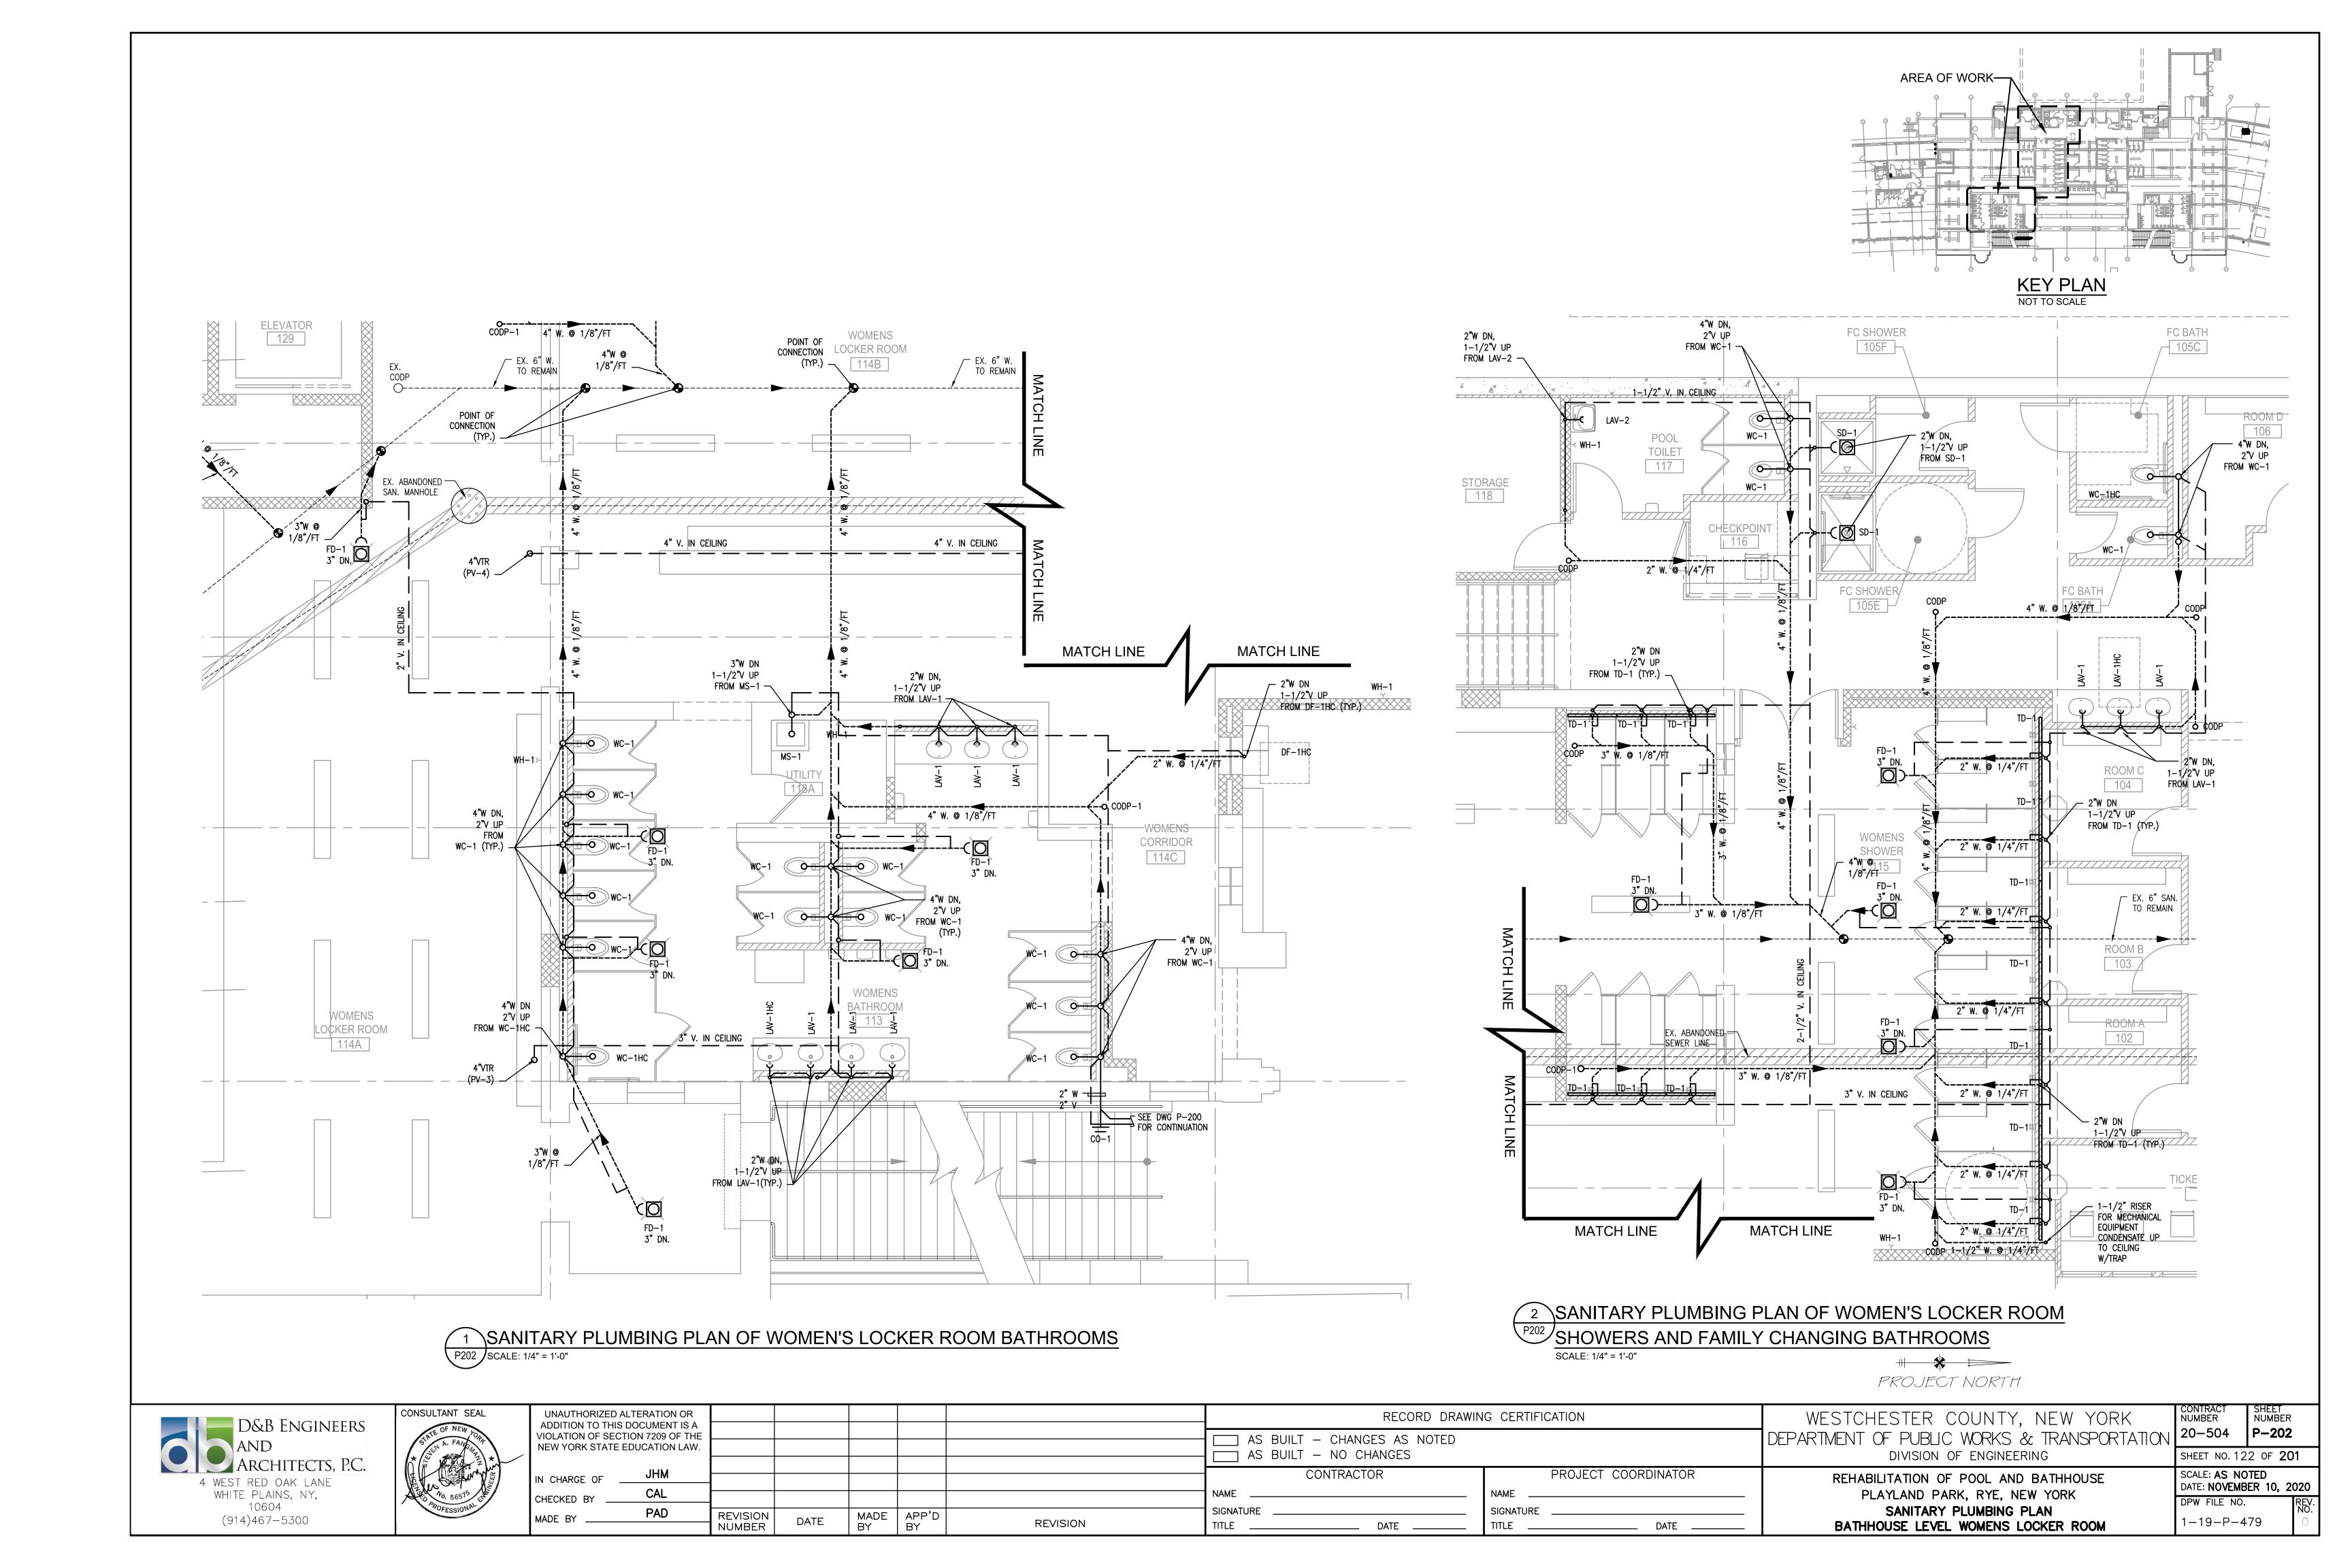
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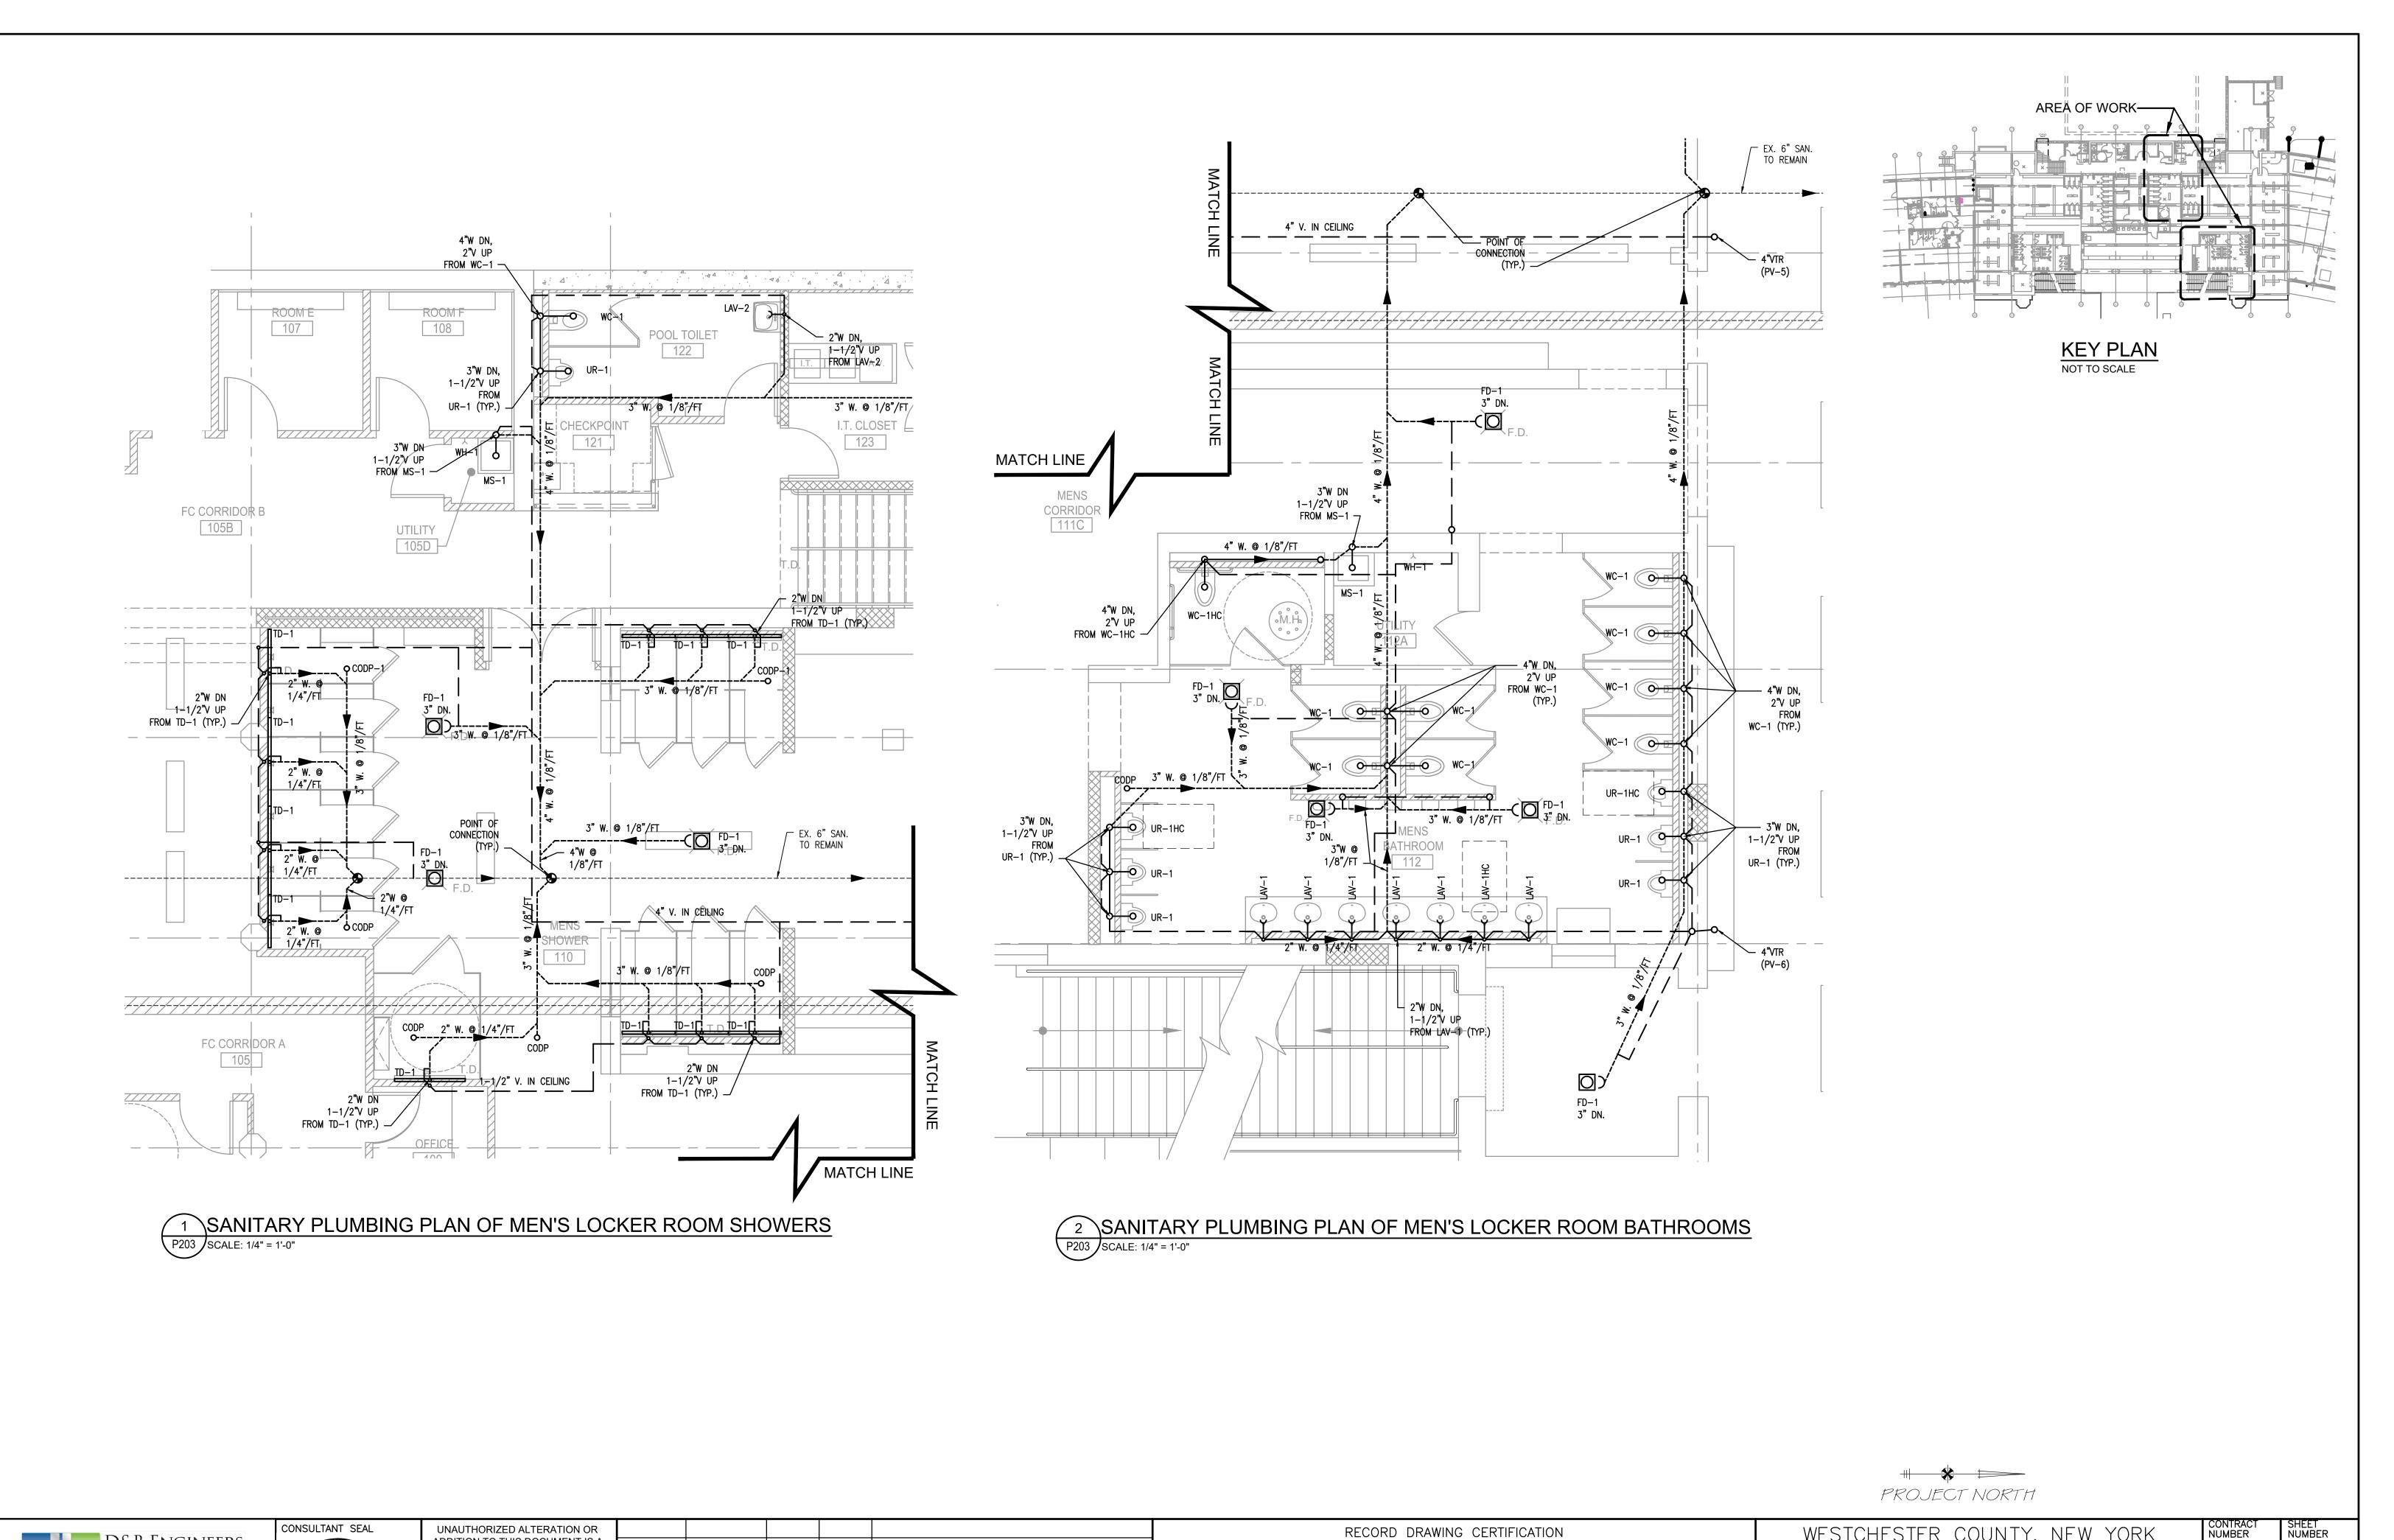
WESTCHESTER COUNTY, NEW YORK DEPARTMENT OF PUBLIC WORKS & TRANSPORTATION 20-504 P-200 DIVISION OF ENGINEERING

REHABILITATION OF POOL AND BATHHOUSE PLAYLAND PARK, RYE, NEW YORK SANITARY PLUMBING PLAN TUNNEL

CONTRACT NUMBER SHEET NUMBER SHEET NO. 120 OF **201** SCALE: **AS NOTED** DATE: NOVEMBER 10, 2020 DPW FILE NO.





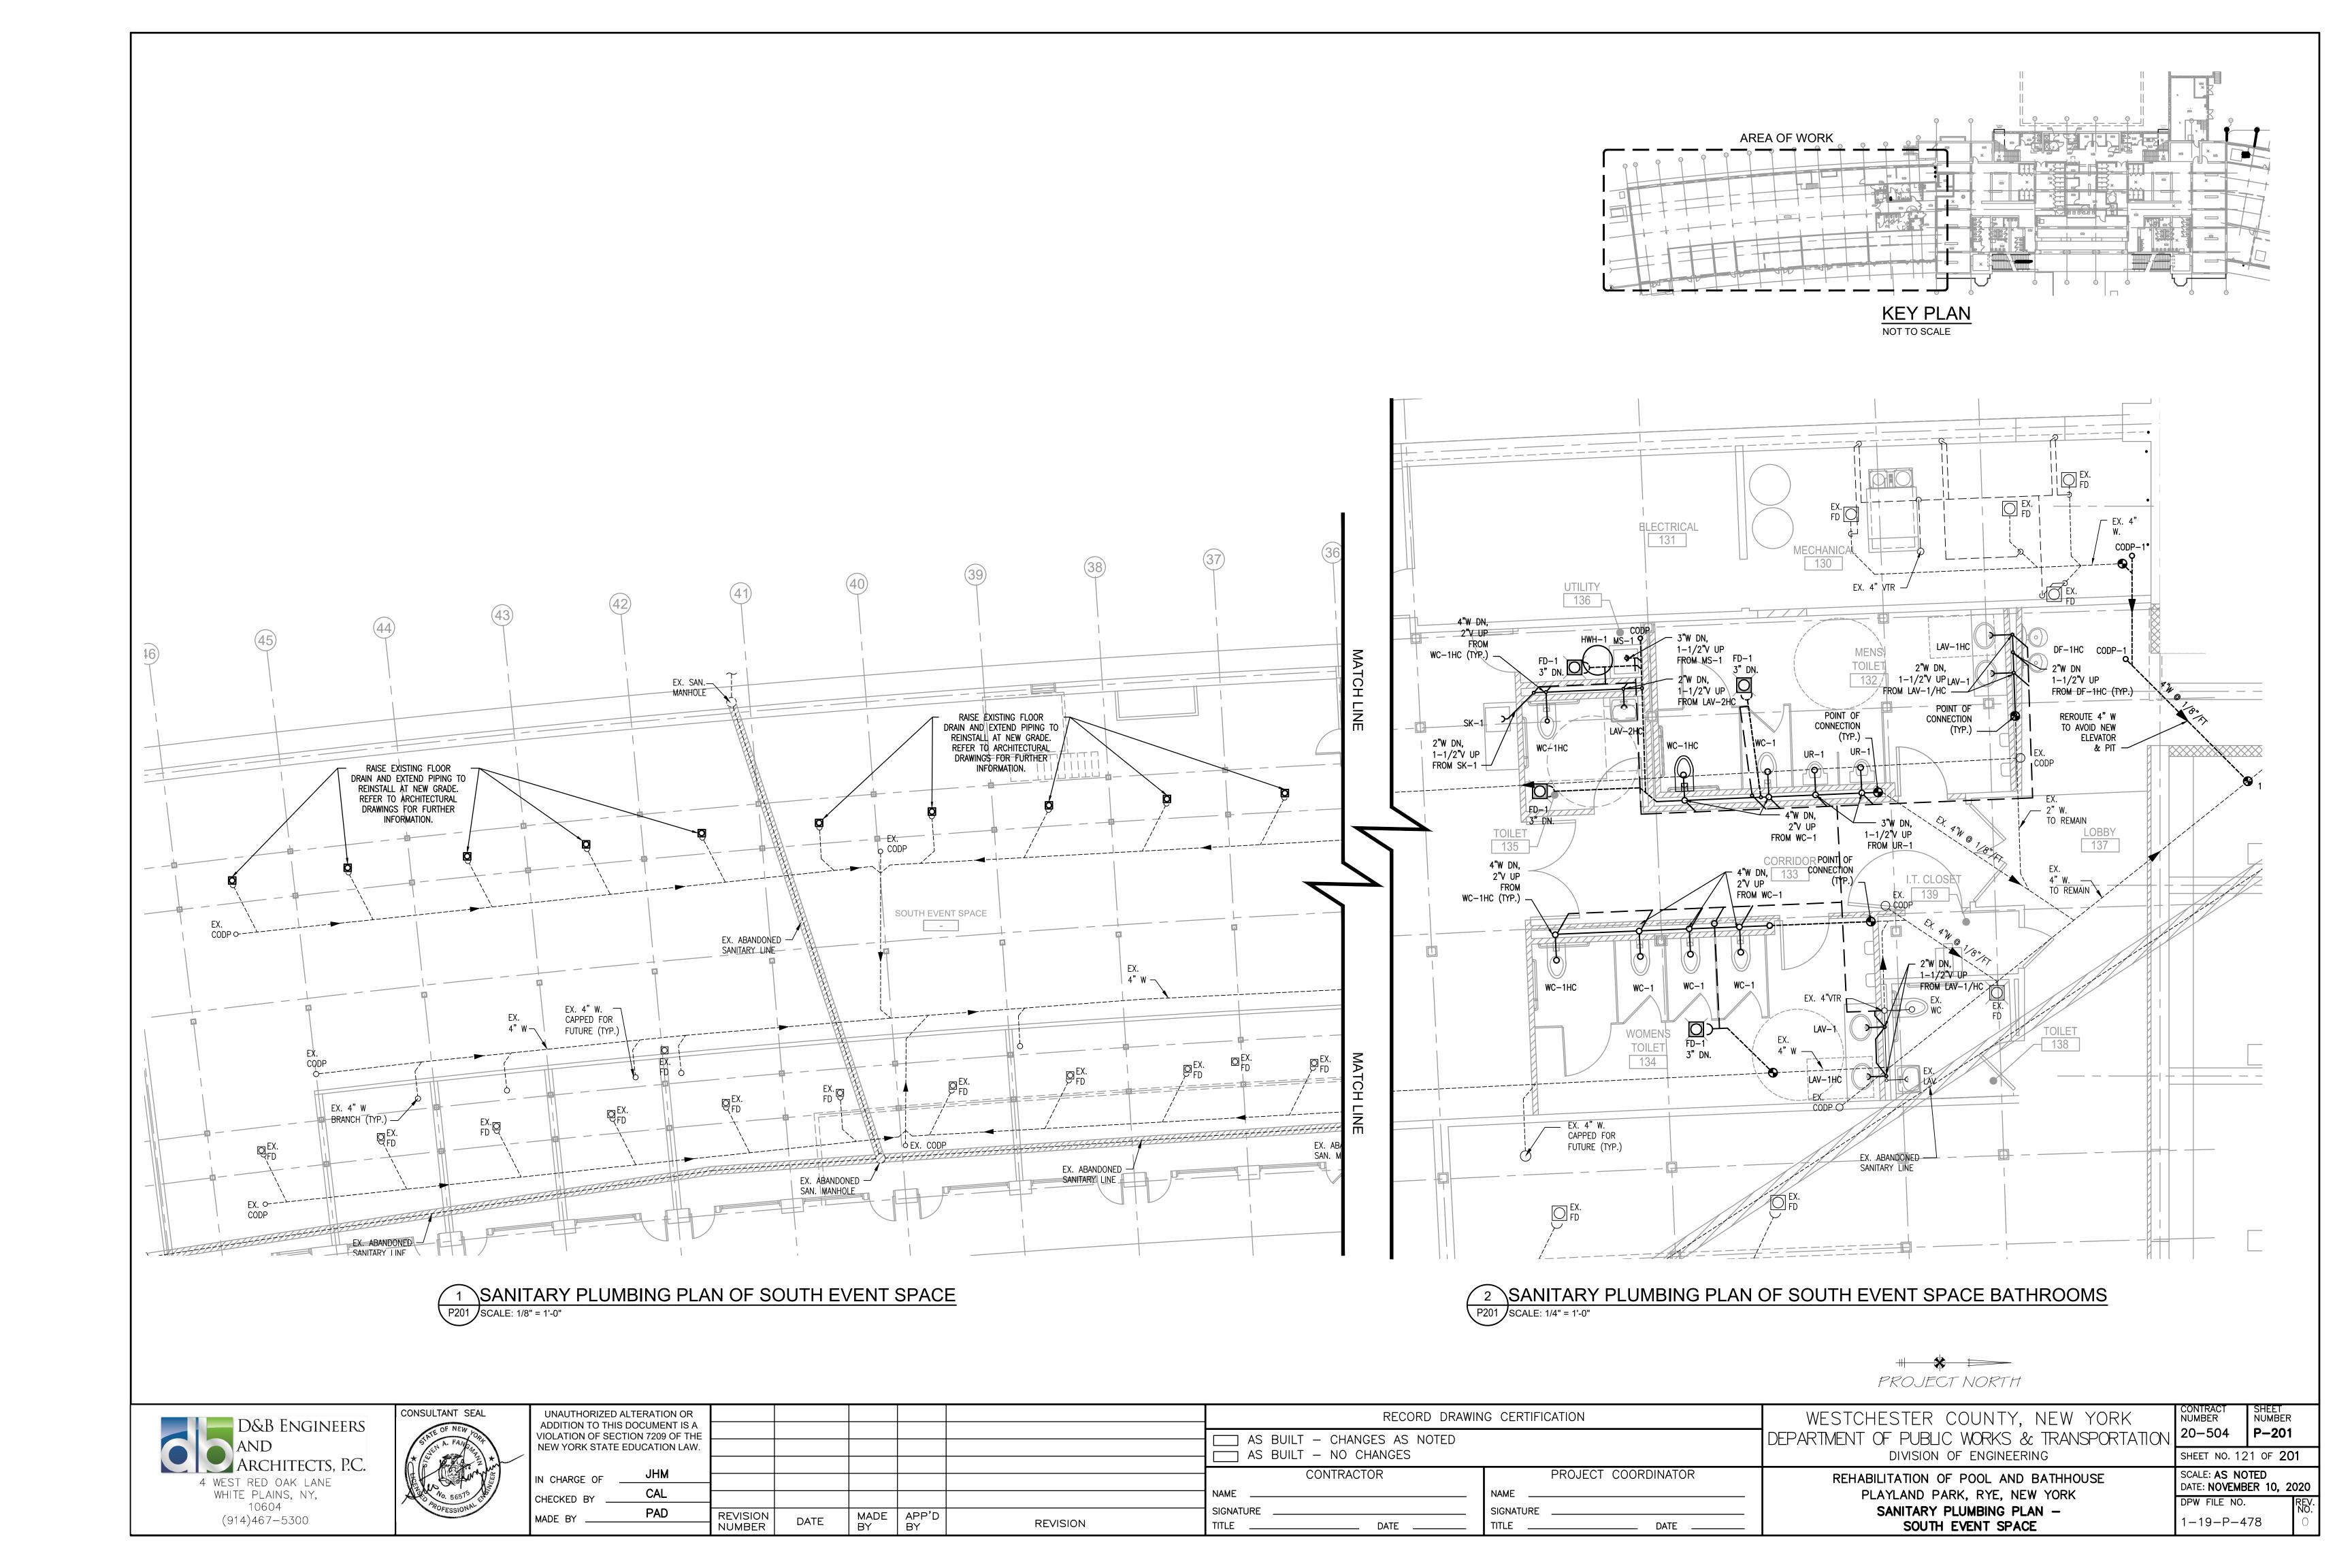

d	D&B ENGINEERS AND ARCHITECTS, P.C.
	VEST RED OAK LANE VHITE PLAINS, NY, 10604 (914)467-5300



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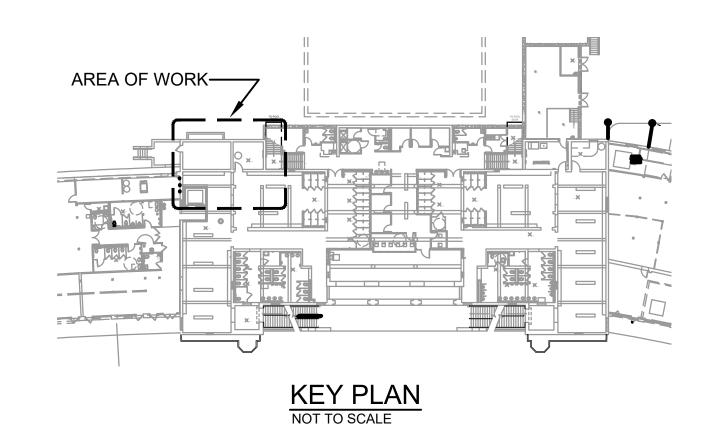
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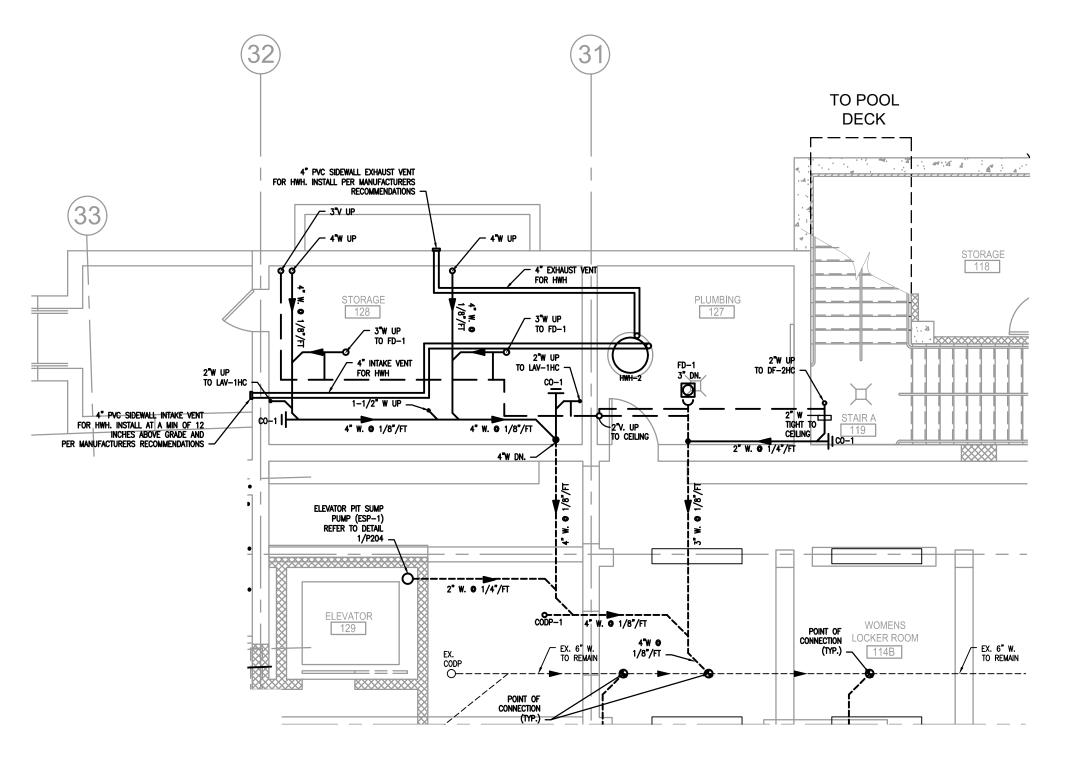
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WESTCHESTER COUNTY, NEW YORK DEPARTMENT OF PUBLIC WORKS & TRANSPORTATION 20-504 DIVISION OF ENGINEERING

REHABILITATION OF POOL AND BATHHOUSE PLAYLAND PARK, RYE, NEW YORK SANITARY PLUMBING PLAN BATHHOUSE LEVEL MENS LOCKER ROOM

CONTRACT NUMBER SHEET NUMBER P-203 SHEET NO. 123 OF **201** SCALE: **AS NOTED**DATE: **NOVEMBER 10, 2020** DPW FILE NO.





1 SANITARY PLUMBING PLAN OF WOMENS LOCKER ROOM STORAGE ROOM P204 SCALE: 1/4" = 1'-0"

ELEVATOR SUMP PUMP SCHEDULE

MARK	MFG.	MODEL #	MIN. SUMP DIA.	O.A. PUMP HT.	DISCHARGE	CORD	MAX. AMB. TEMP.	WGT.	STD. FLOAT TRAVEL
ESP-1	FEDERAL PUMP CORP.	1 1/2P-1/3-4	12"	12"	1 1/2"	20'	130°F	40 LBS.	9"

REVISION NUMBER MADE APP'D BY BY

NOTE: PROVIDE GATE VALVE, CHECK VALVE AND COVER.

ALARM BELL AND LIGHT IN CORRIDOR OUTSIDE ELEVATOR TO PANEL
* / / /
FLOAT SWITCH ASSEMBLY
FOR ALARM
ALARM PANEL IN
MECHANICAL ROOM
Д Д
OUMP.
SUMP —
SUBMERSIBLE SUMP PUMP W/ INDEPENDENT CONTROL 18" MAX
INDEPENDENT CONTROL REFER TO SCHEDULE AND PLANS
ESP-1
ALARM PANEL BY FEDERAL PUMP CORPORATION "TYPE B" SINGLE STATION OR

ALARM PANEL BY FEDERAL PUMP CORPORATION "TYPE B" SINGLE STATION OR APPROVED EQUAL. FLOAT SWITCH MODEL "FS-1" BY FEDERAL PUMP CORPORATION OR APPROVED EQUAL. ALL WIRING TO BE IN ACCORDANCE WITH MANUFACTURER'S REQUIREMENTS AND APPLICABLE CODES

ELEVATOR PIT SUMP PUMP DET AIL

Scale: NTS



D&B ENGINEERS
AND
ARCHITECTS, P.C.
4 WEST RED OAK LANE
WHITE PLAINS, NY,
10604
(914)467-5300



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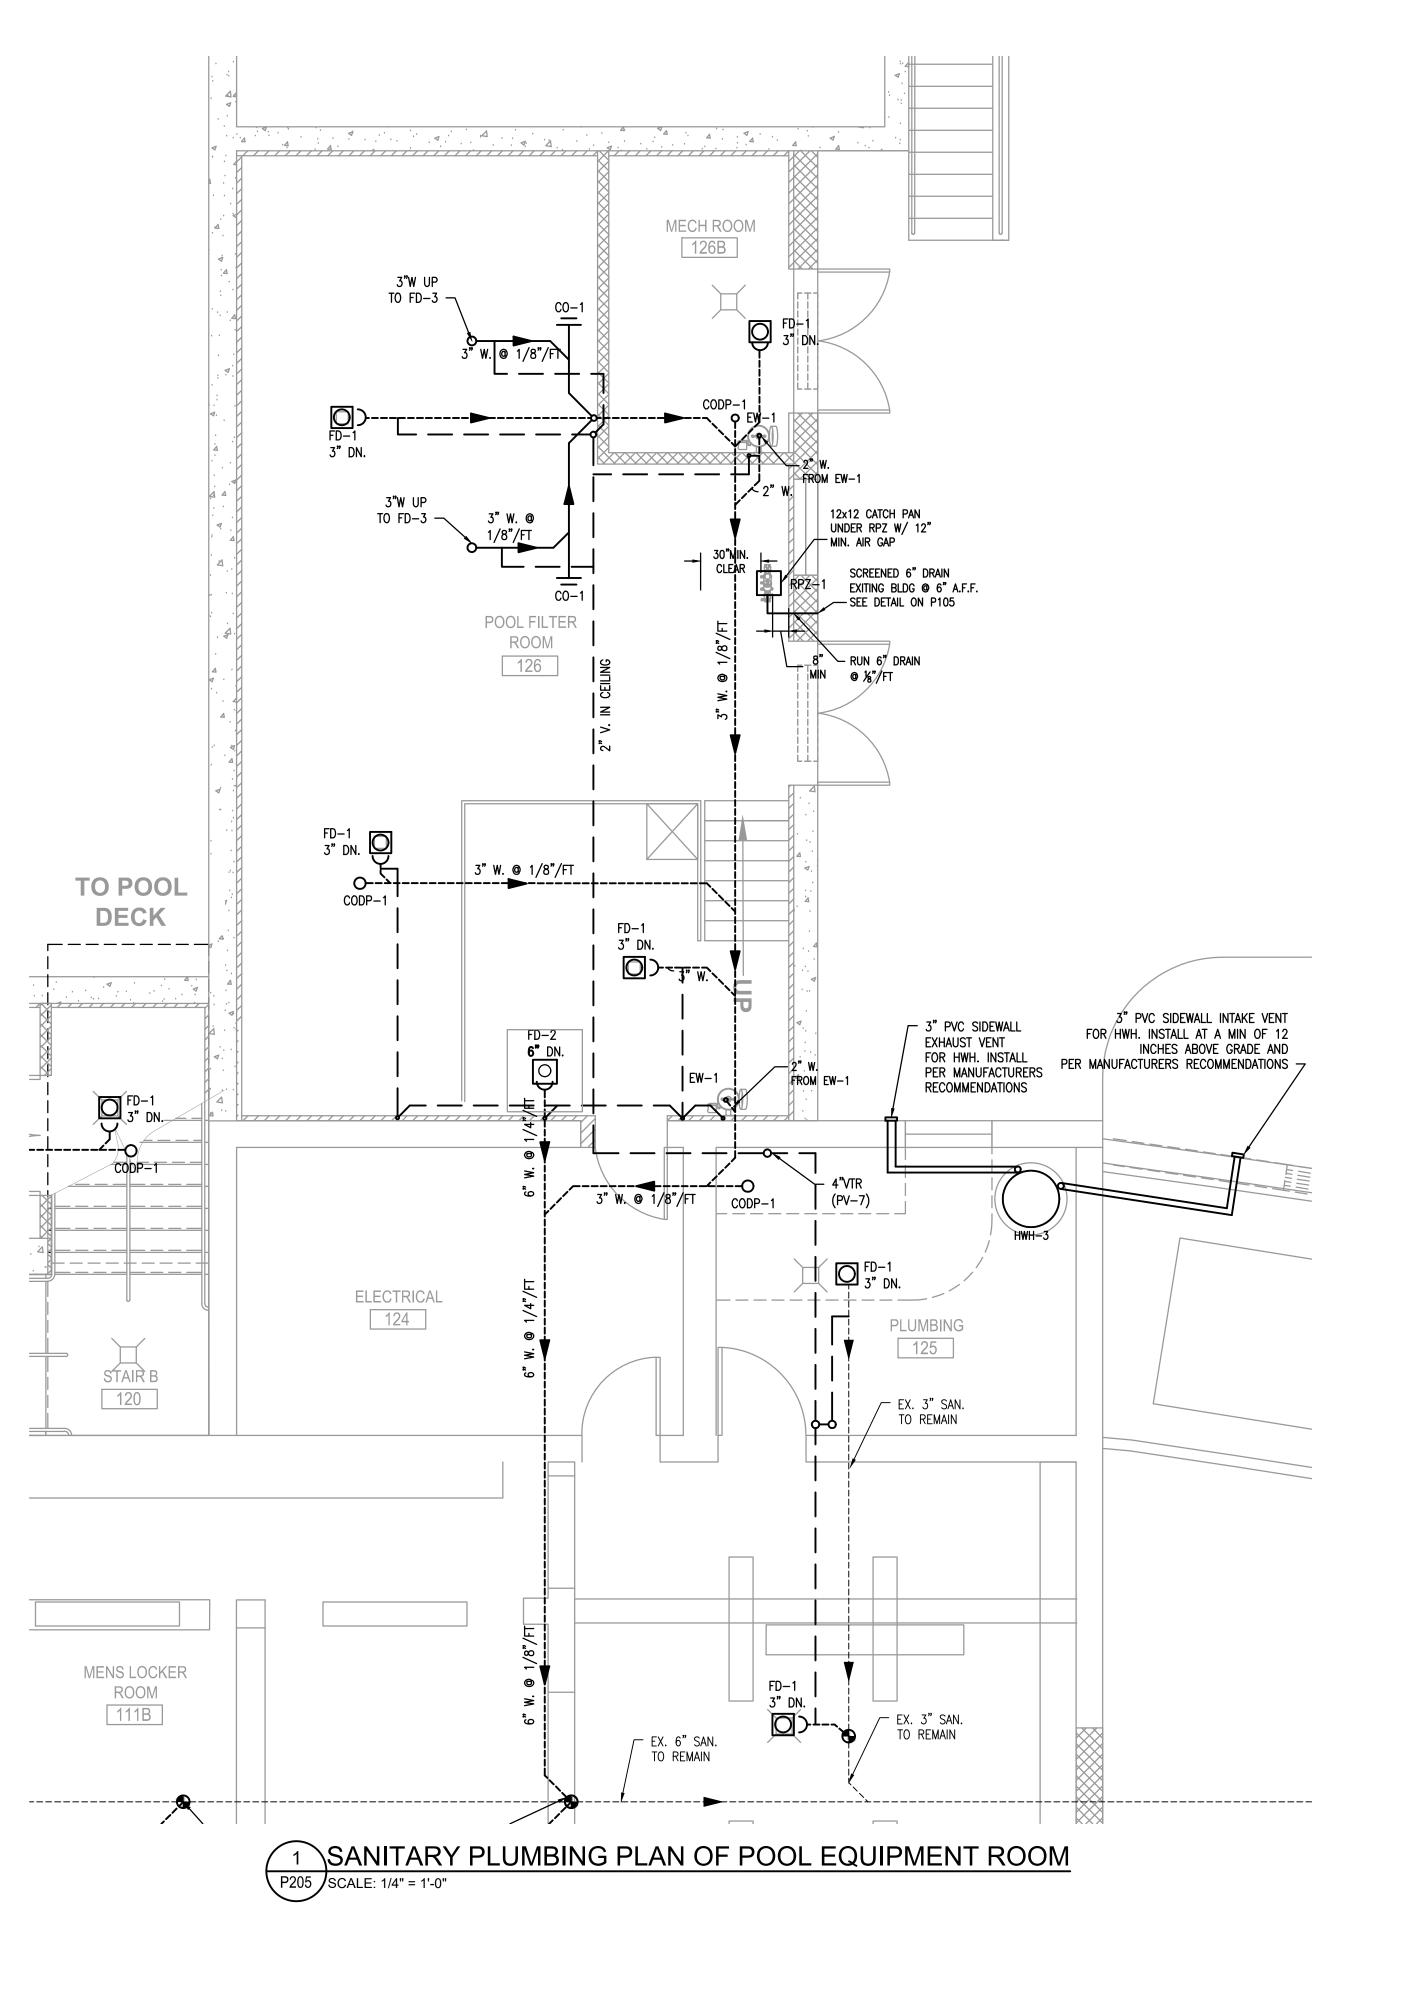
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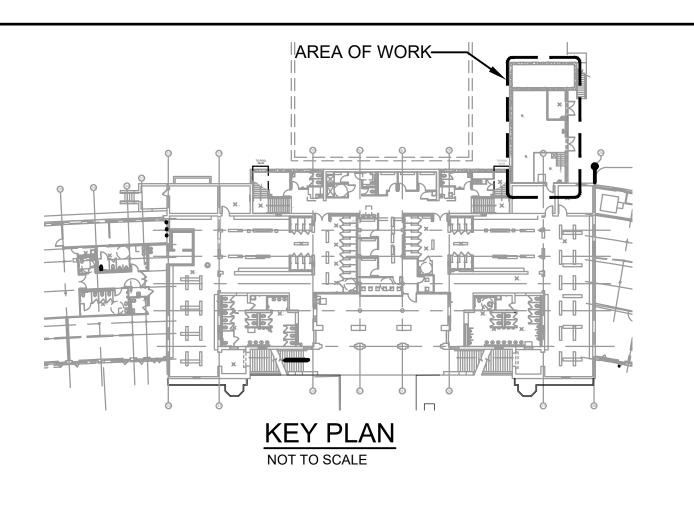
REVISION

WESTCHESTER COUNTY, NEW YORK
DEPARTMENT OF PUBLIC WORKS & TRANSPORTATION
DIVISION OF ENGINEERING

REHABILITATION OF POOL AND BATHHOUSE
PLAYLAND PARK, RYE, NEW YORK
SANITARY PLUMBING PLAN
BATHHOUSE LEVEL WOMENS LOCKER ROOM STORAGE

7	20-504 P-204							
	SHEET NO. 12	4 OF 201						
	SCALE: AS NO DATE: NOVEMB	TED ER 10, 2020						
	DPW FILE NO.	REV.						





CLEANOUT SCHEDULE:

MARK	LOCATION	MFG.	MODEL #	SIZE	BODY	PIPE	TYPE
CODP-1	SEE PLANS	ZURN	ZANB-1456	4"ø	C.I.	C.I.	FLOOR
CO-1	SEE PLANS	ZURN	Z-1440-A	4"ø	C.I.	C.I.	WALL/PARTITION

FLOOR DRAIN SCHEDULE:

LOCATION	MARK	MFG.	MODEL #	PIPE SIZE	BODY	NOTES
EQUIP ROOM	FD-1	ZURN	ZN-415-P-VP	3 " ø	C.I.	W/DEEP SEAL TRAP AND 1/2" PRIMER TAP
EQUIP ROOM	FD-2	ZURN	Z610	6 " ø	C.I.	W/DEEP SEAL TRAP AND 1/2" PRIMER TAP
POOL DECK	FD-3	ZURN	Z610	3 " ø	C.I.	W/DEEP SEAL TRAP AND 1/2" PRIMER TAP

* === PROJECT NORTH





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ADDITION TO THIS VIOLATION OF SEC						
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CONTRACTOR	PROJECT COORDINATOR							
NAME	NAME							
SIGNATURE	SIGNATURE							
TITLE DATE	TITLE DATE							

MODEL #

Z158

OUTLET

4**"**ø

DRAIN

10" SQ.

NOTES

VANDAL RESISTANT WITH SEDIMENT BUCKET

AREA DRAIN SCHEDULE:

POOL DECK


LOCATION MARK MFG.


AD-1 ZURN


DIVISION OF ENGINEERING REHABILITATION OF POOL AND BATHHOUSE PLAYLAND PARK, RYE, NEW YORK SANITARY PLUMBING PLAN POOL EQUIPMENT ROOM

WESTCHESTER COUNTY, NEW YORK

CONTRACT NUMBER SHEET NUMBER PARTMENT OF PUBLIC WORKS & TRANSPORTATION 20-504 P-205 SHEET NO. 125 OF **201** SCALE: AS NOTED DATE: NOVEMBER 10, 2020 DPW FILE NO. 1-19-P-482

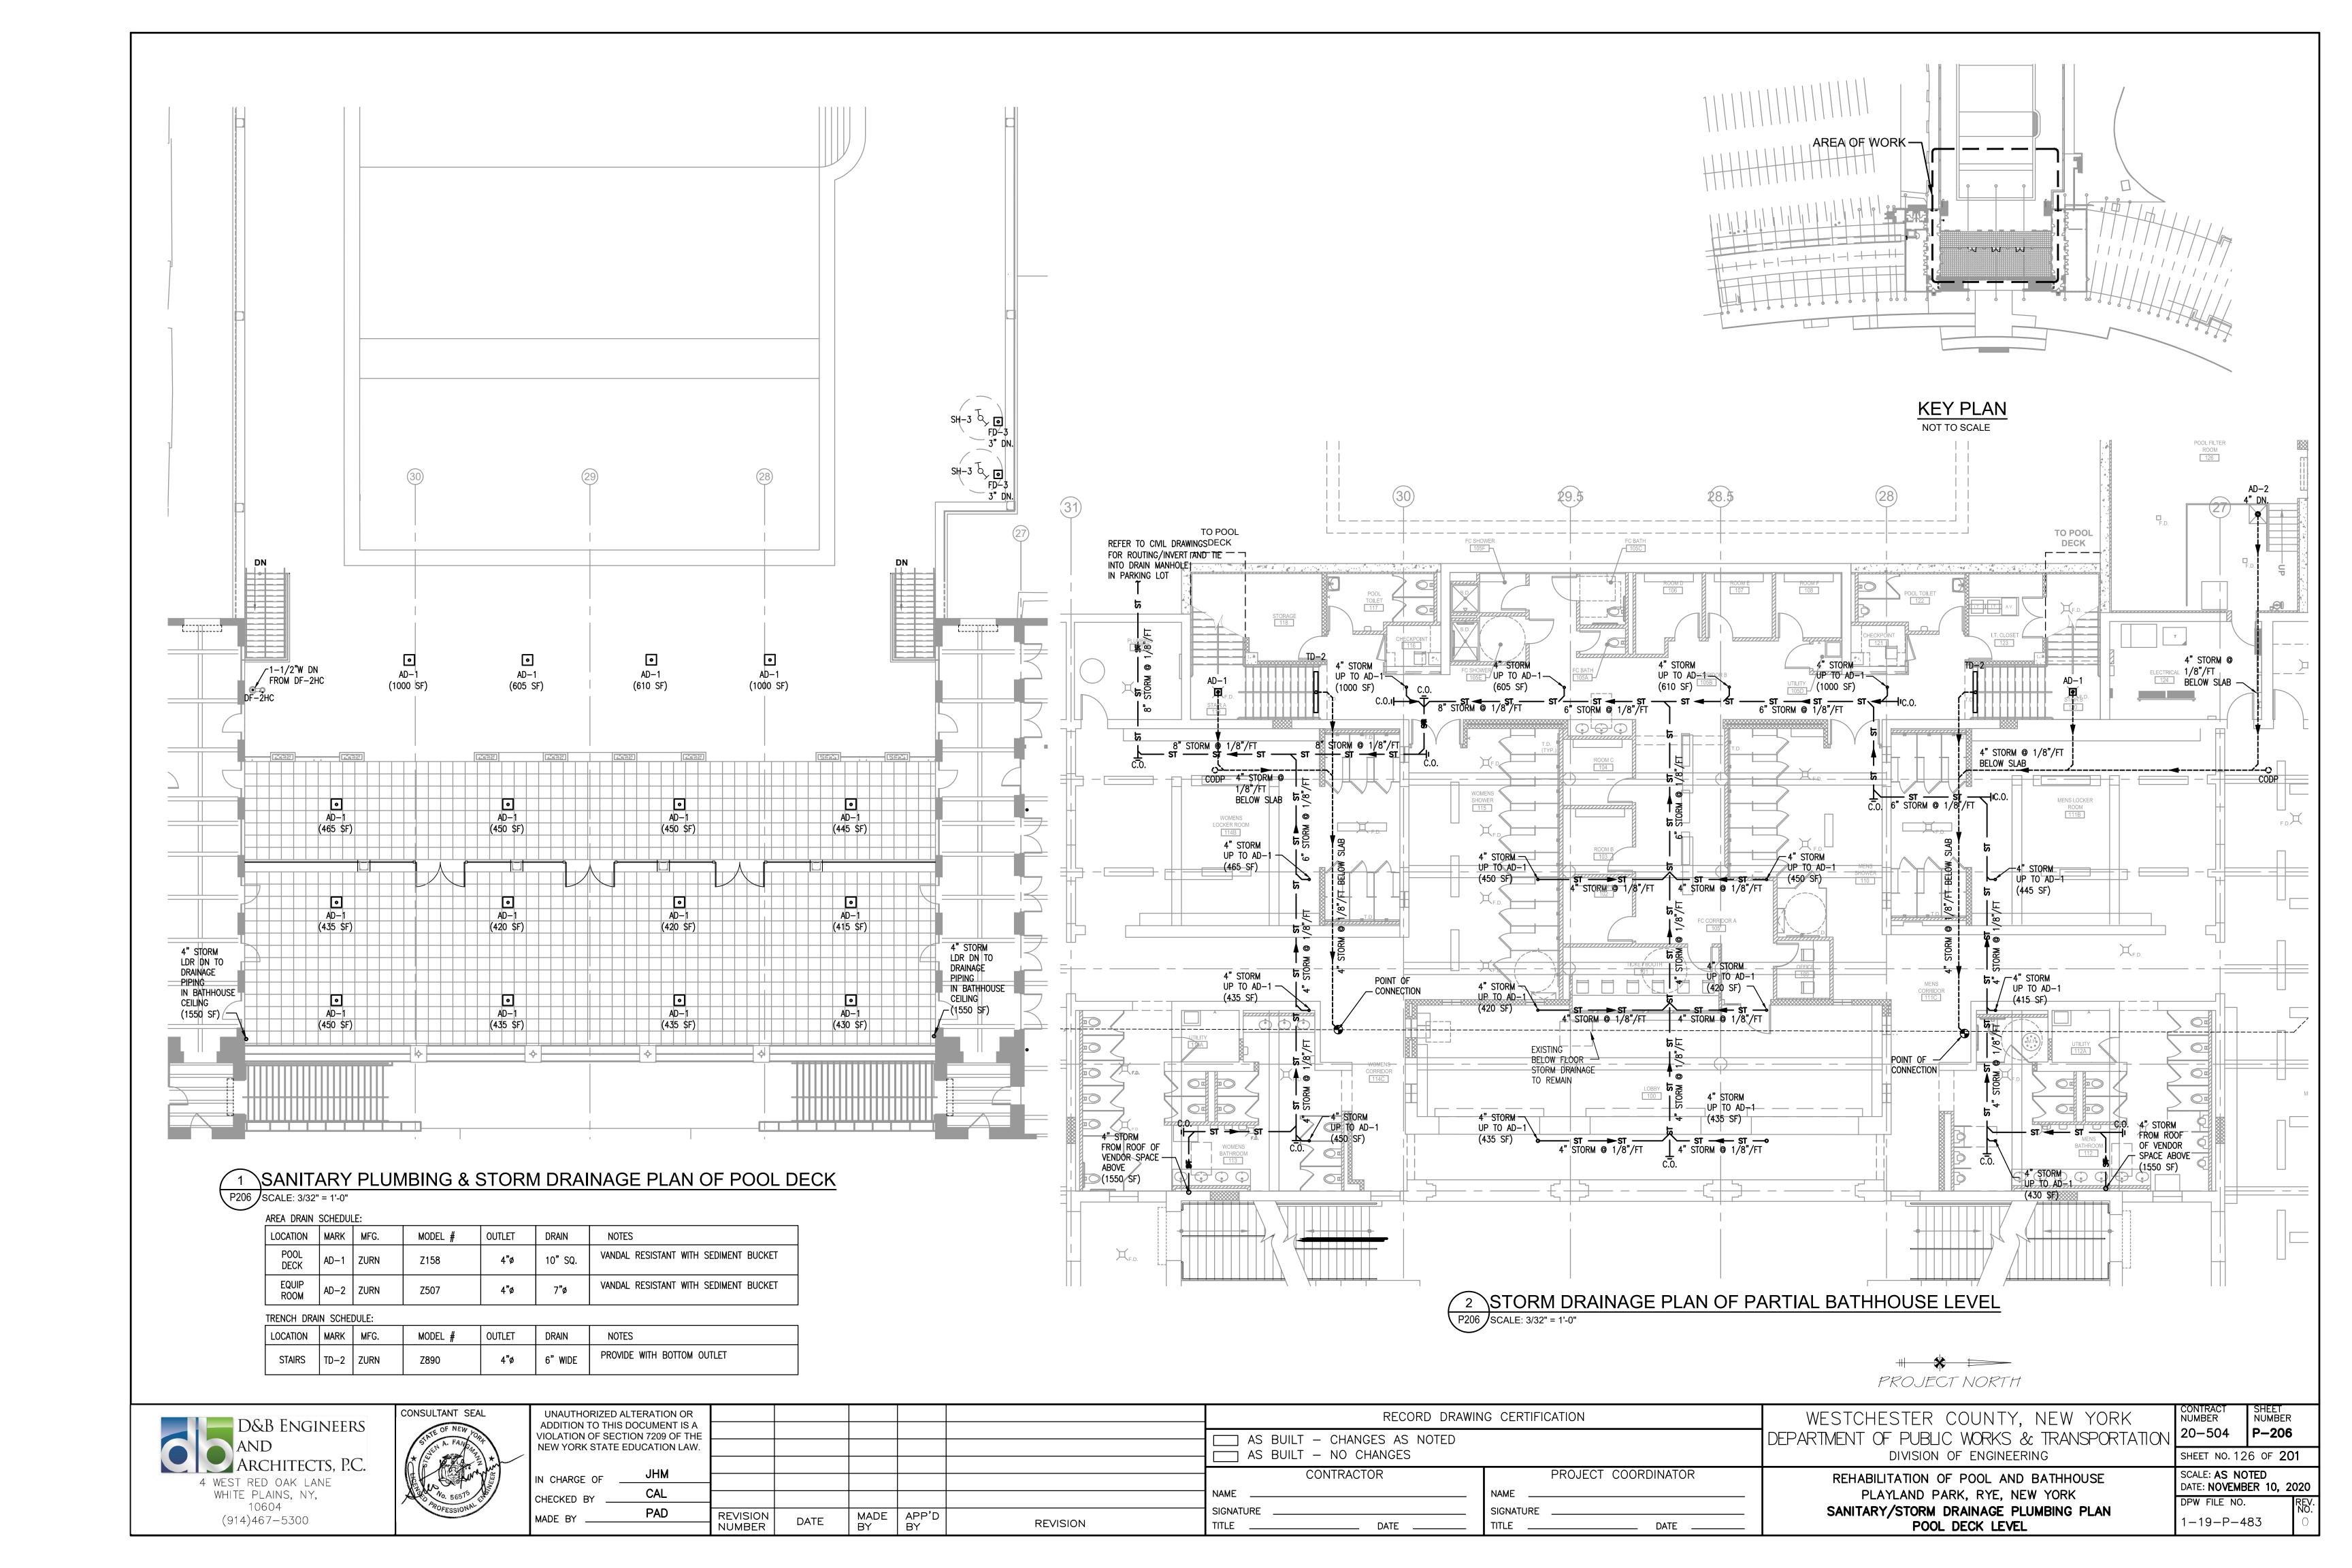

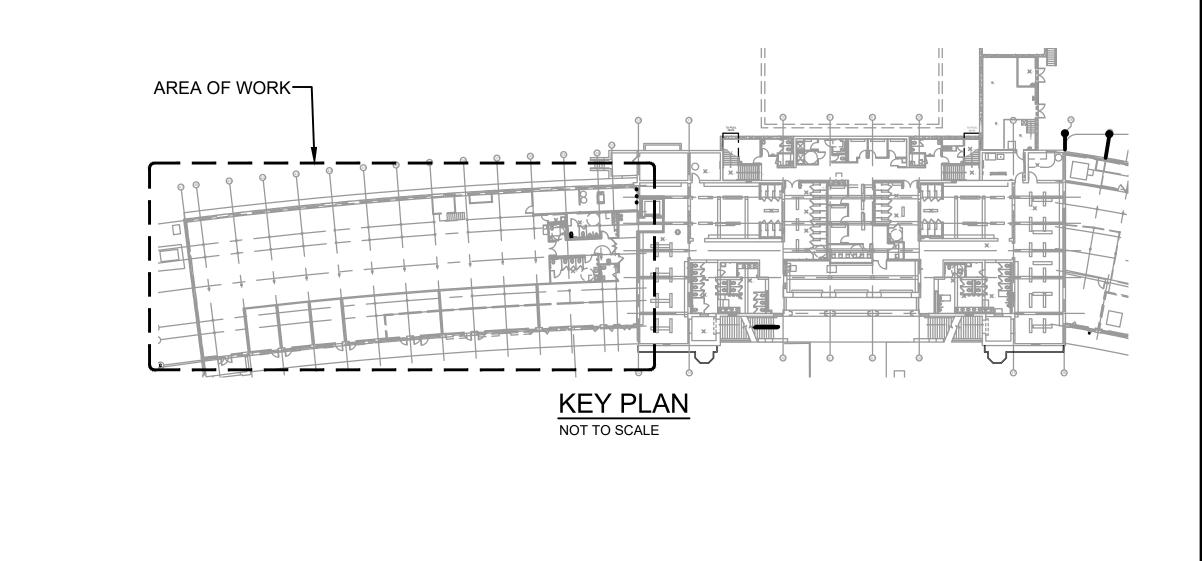

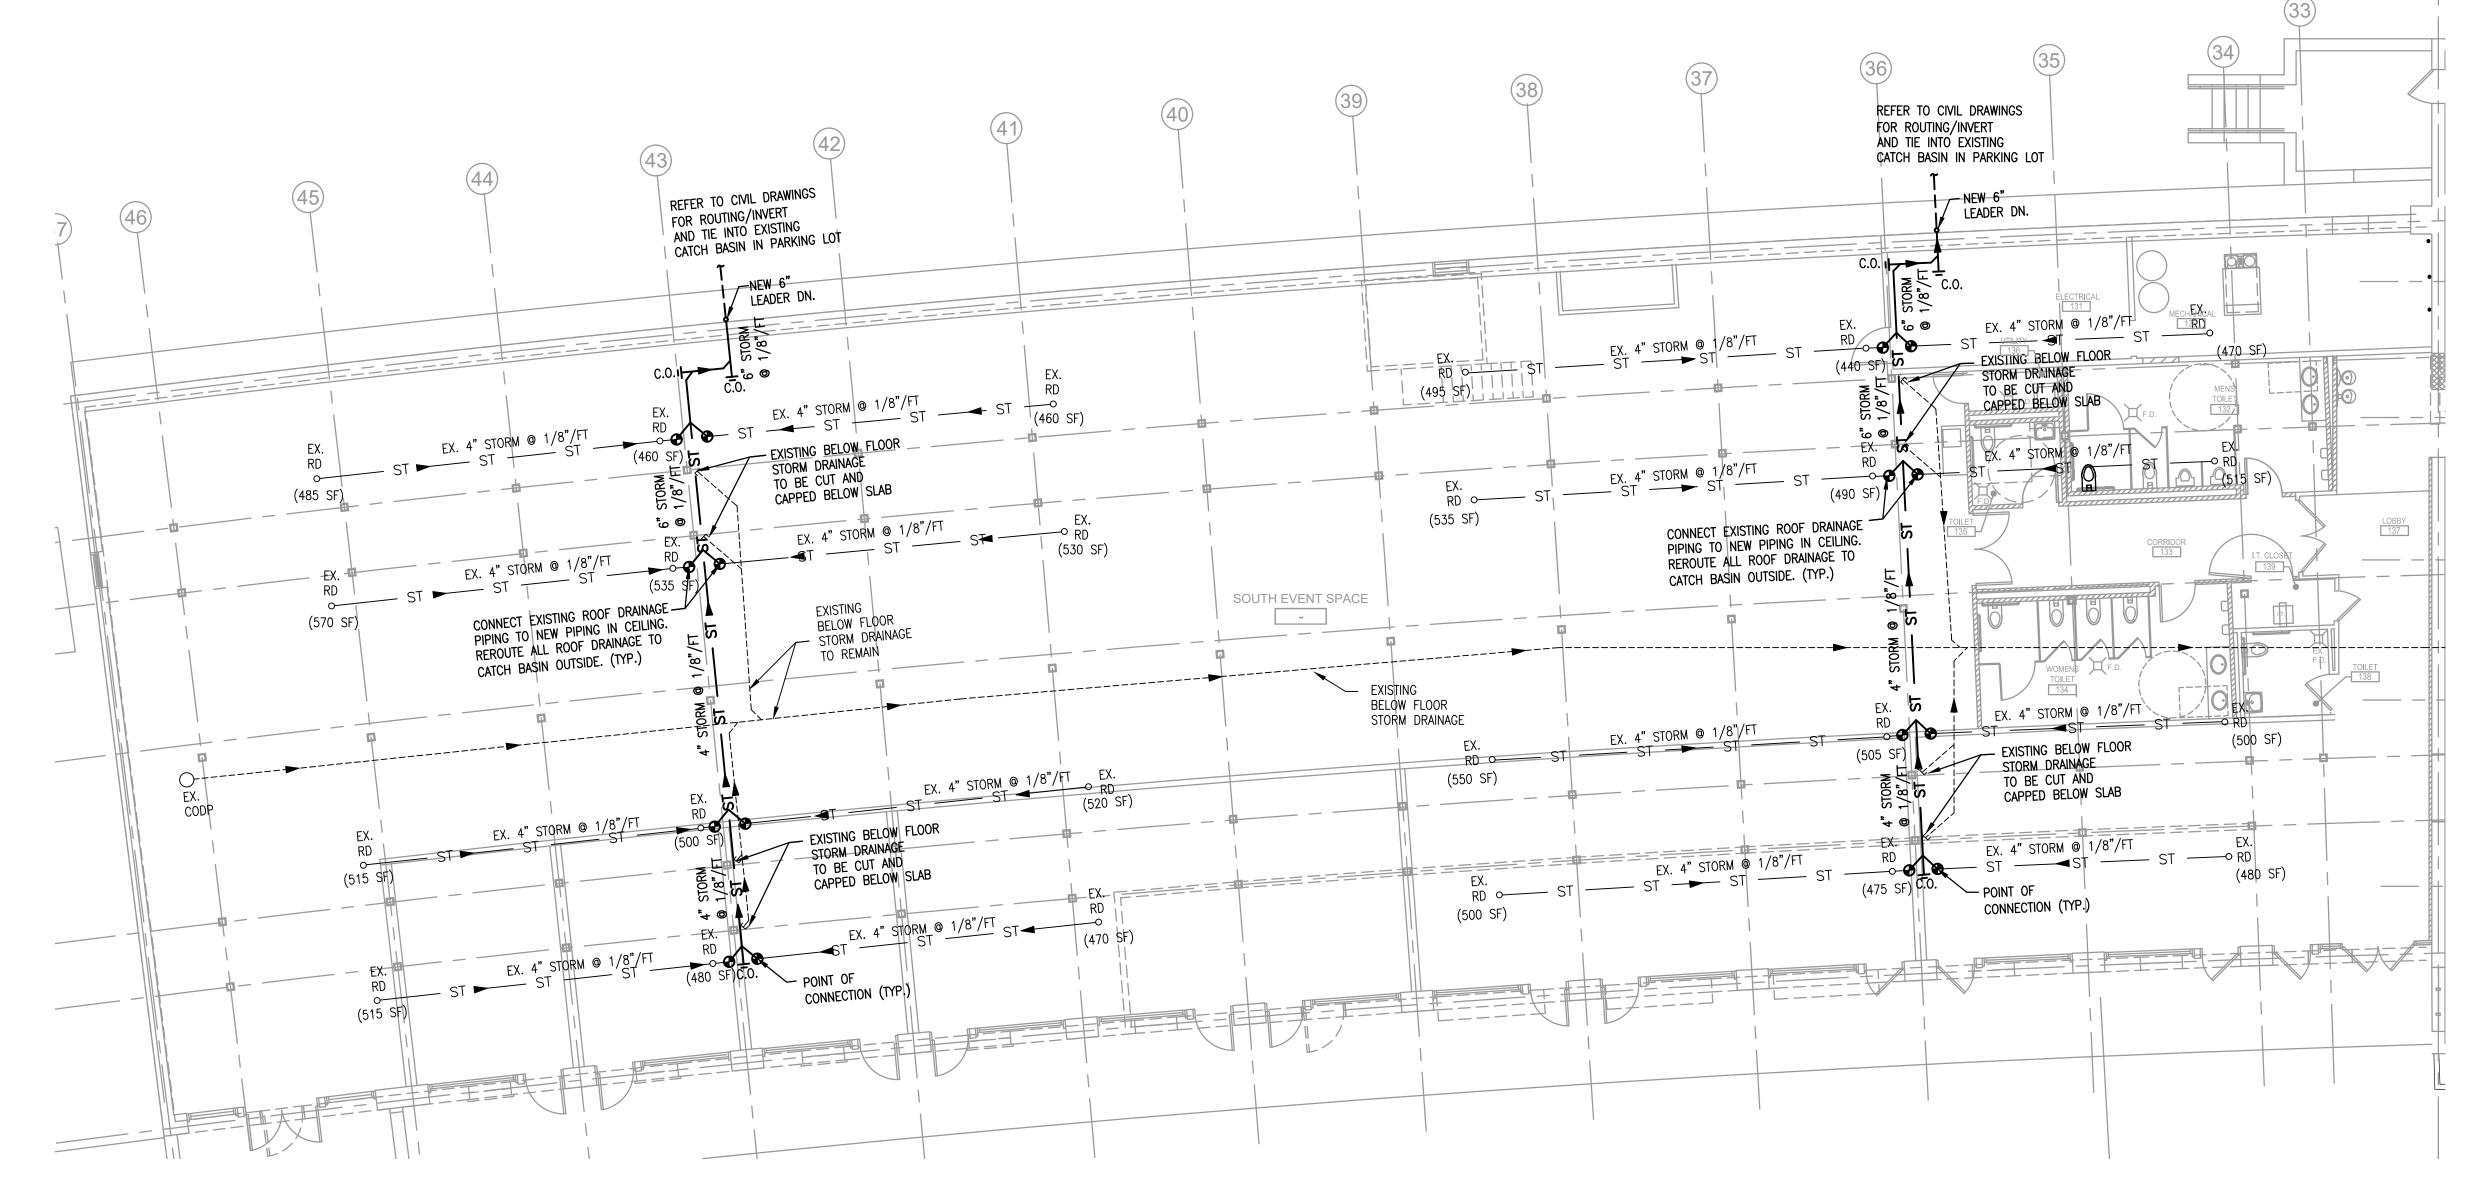

1 STORM DRAINAGE PLAN OF SOUTH EVENT SPACE P207 SCALE: 3/32" = 1'-0"

> # * === PROJECT NORTH







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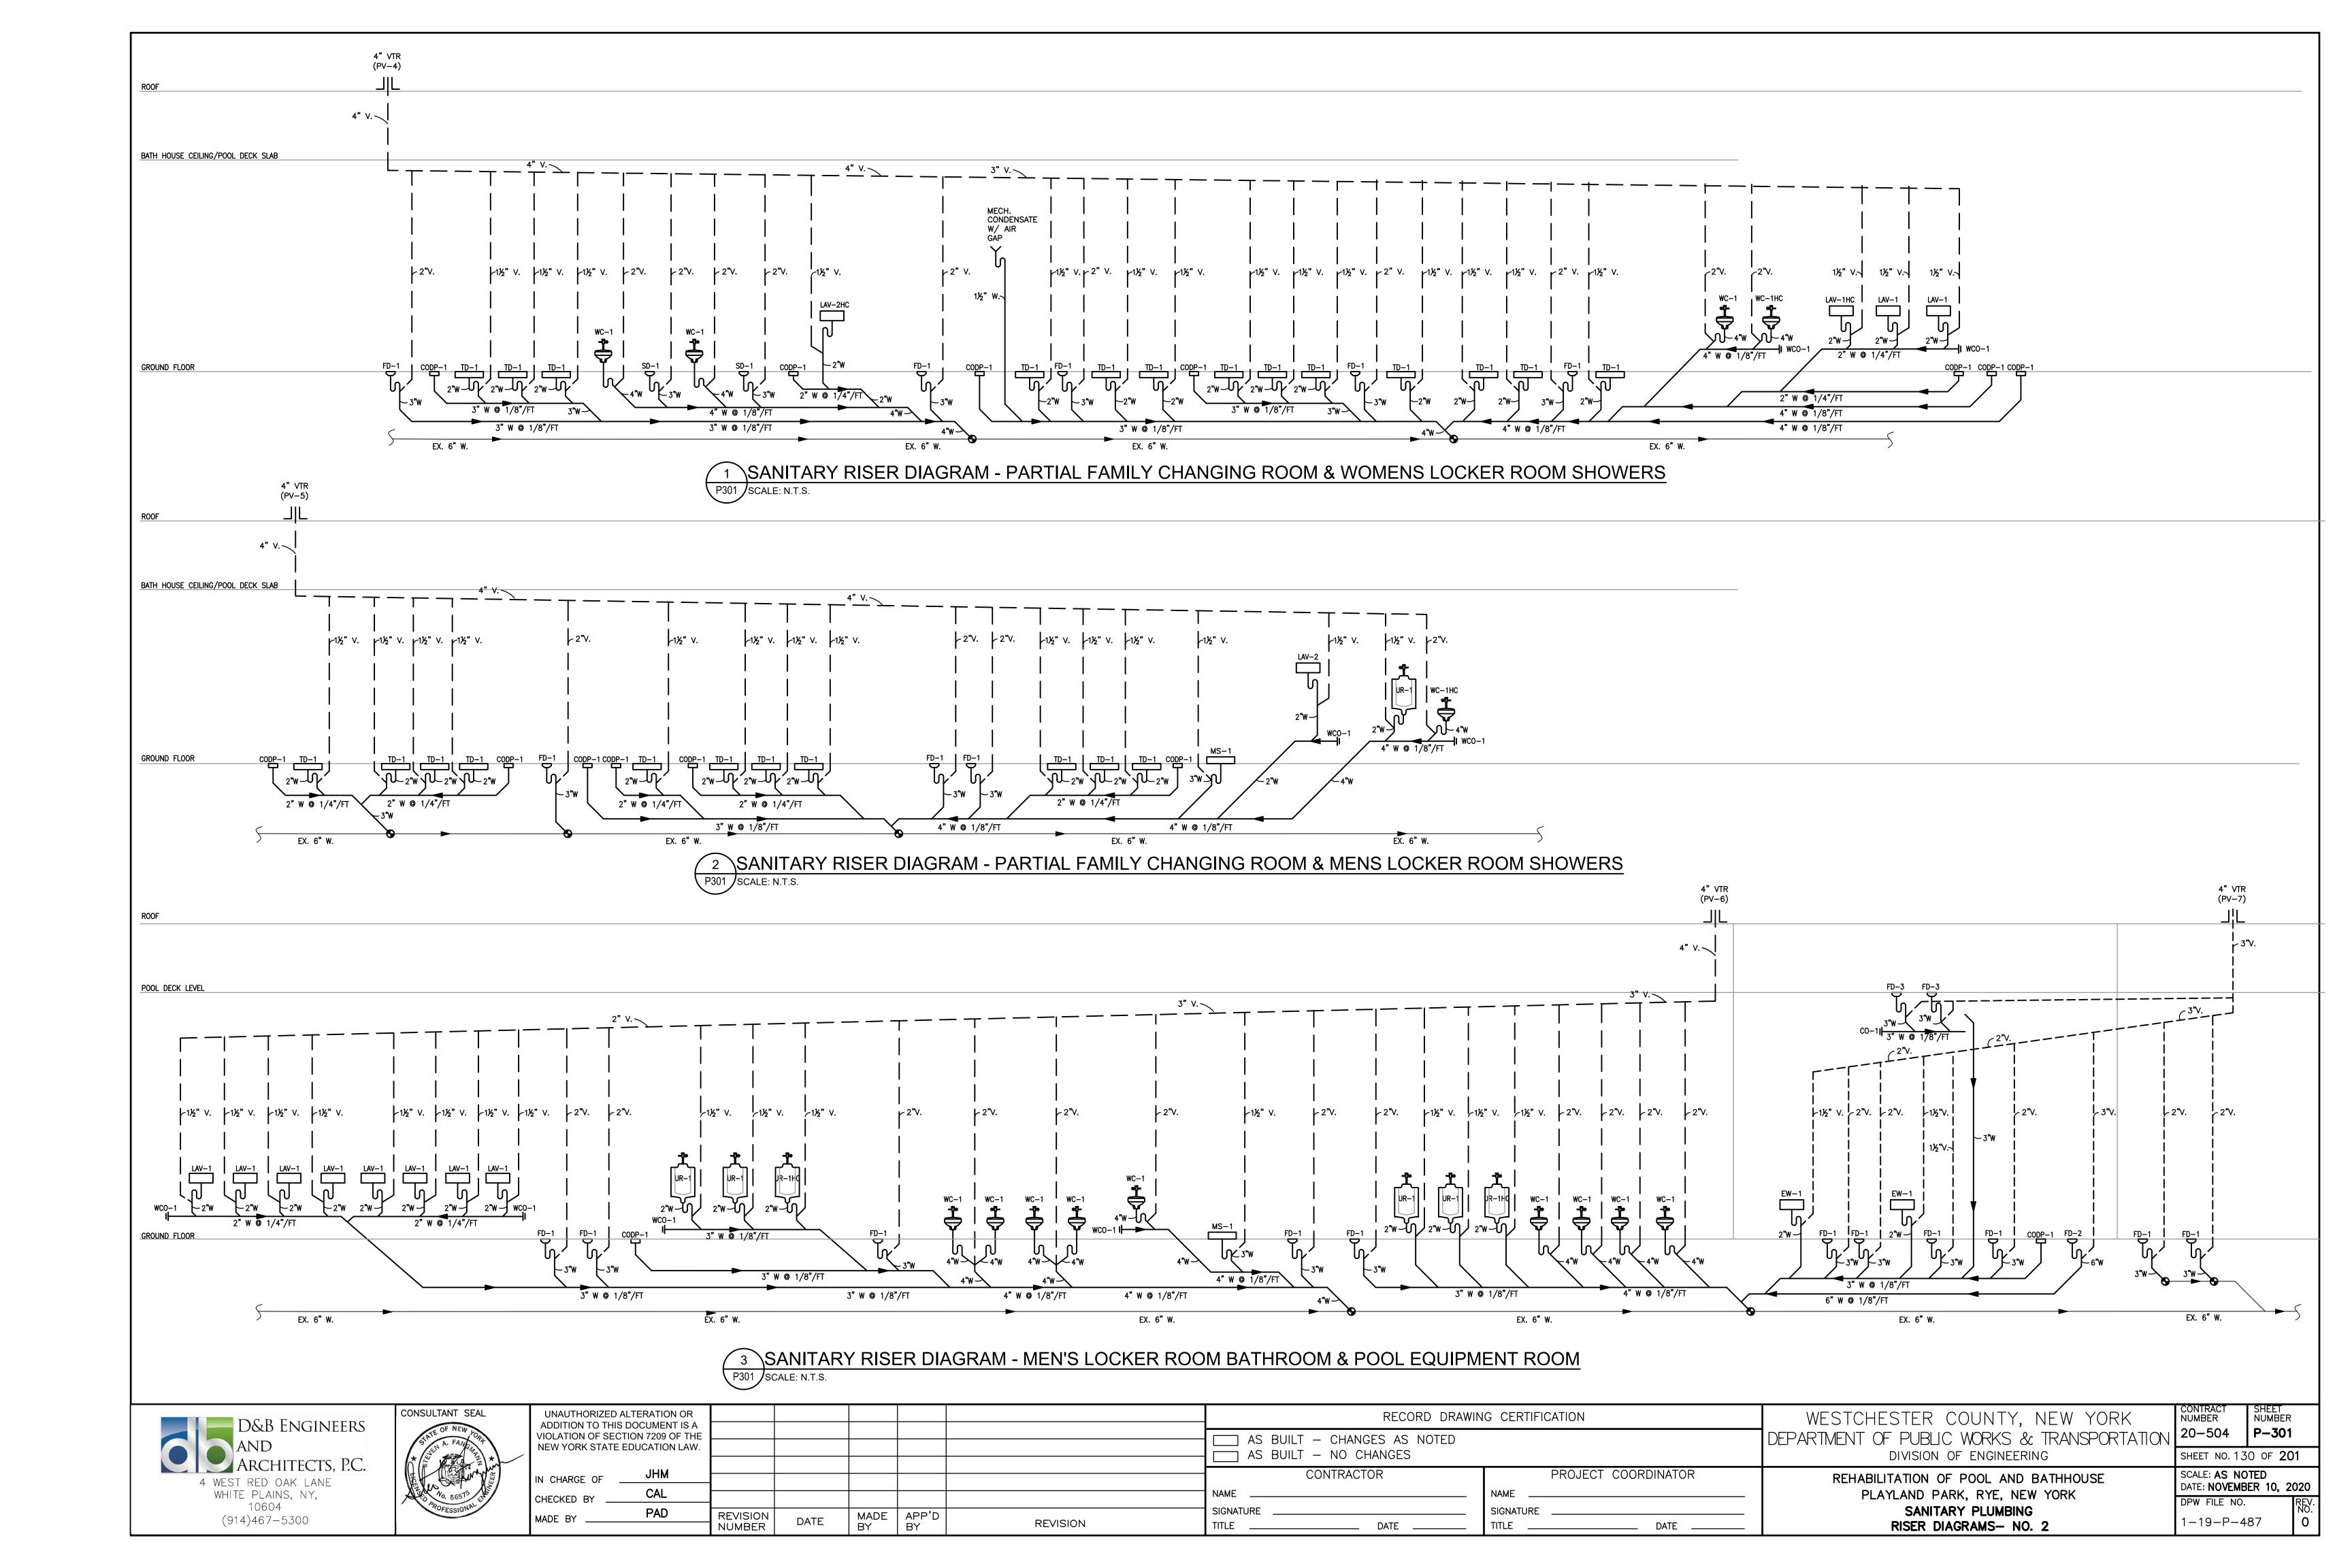
RECORD DRAWIN	WESTCHESTER COUNTY, NEW YORK			
AS BUILT — CHANGES AS NOTED AS BUILT — NO CHANGES		DEPARTMENT OF PUBLIC WORKS & TRANSPORTAT DIVISION OF ENGINEERING		
CONTRACTOR	PROJECT COORDINATOR	REHABILITATION OF POOL AND BATHHOUSE		
NAME	NAME	PLAYLAND PARK, RYE, NEW YORK		
SIGNATURE	SIGNATURE	STORM DRAINAGE PLAN		
TITLE DATE	TITLE DATE	SOUTH EVENT SPACE		


MENT OF PUBLIC WORKS & TRANSPORTATION 20-504 DIVISION OF ENGINEERING REHABILITATION OF POOL AND BATHHOUSE PLAYLAND PARK, RYE, NEW YORK STORM DRAINAGE PLAN SOUTH EVENT SPACE


CONTRACT NUMBER SHEET NUMBER P-207 SHEET NO. 127 OF **201** SCALE: **AS NOTED** DATE: NOVEMBER 10, 2020 DPW FILE NO. 1-19-P-484




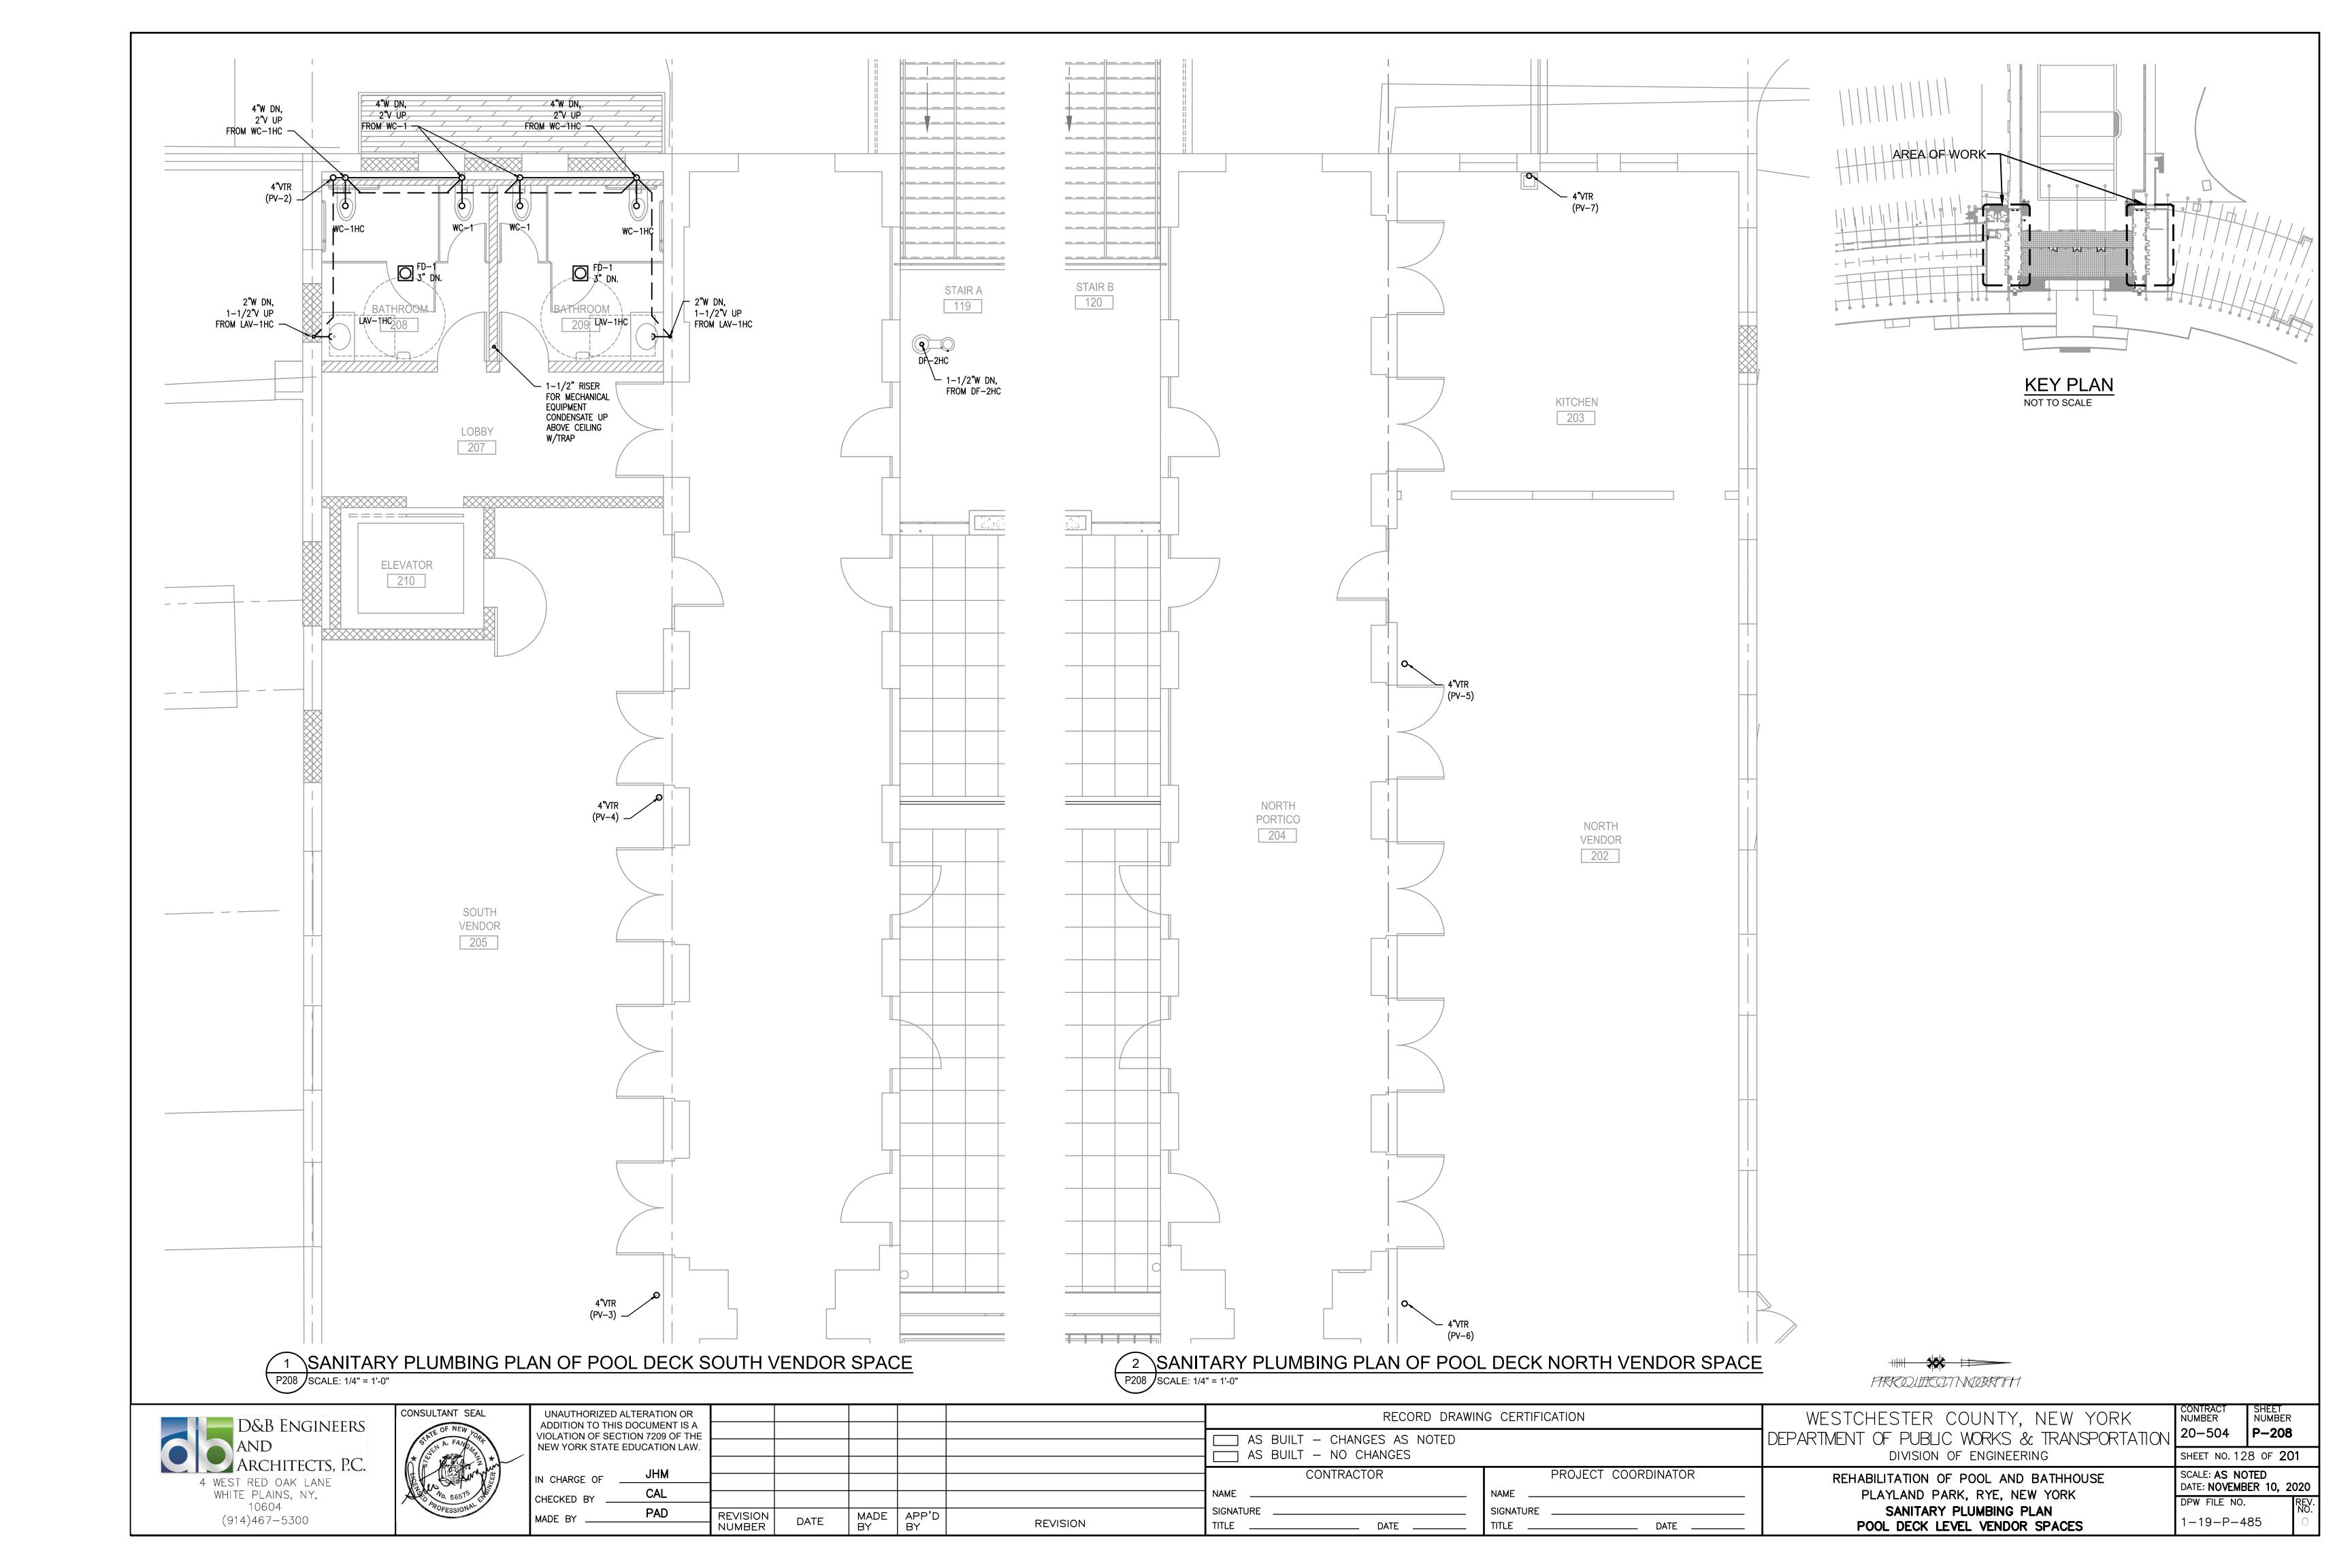

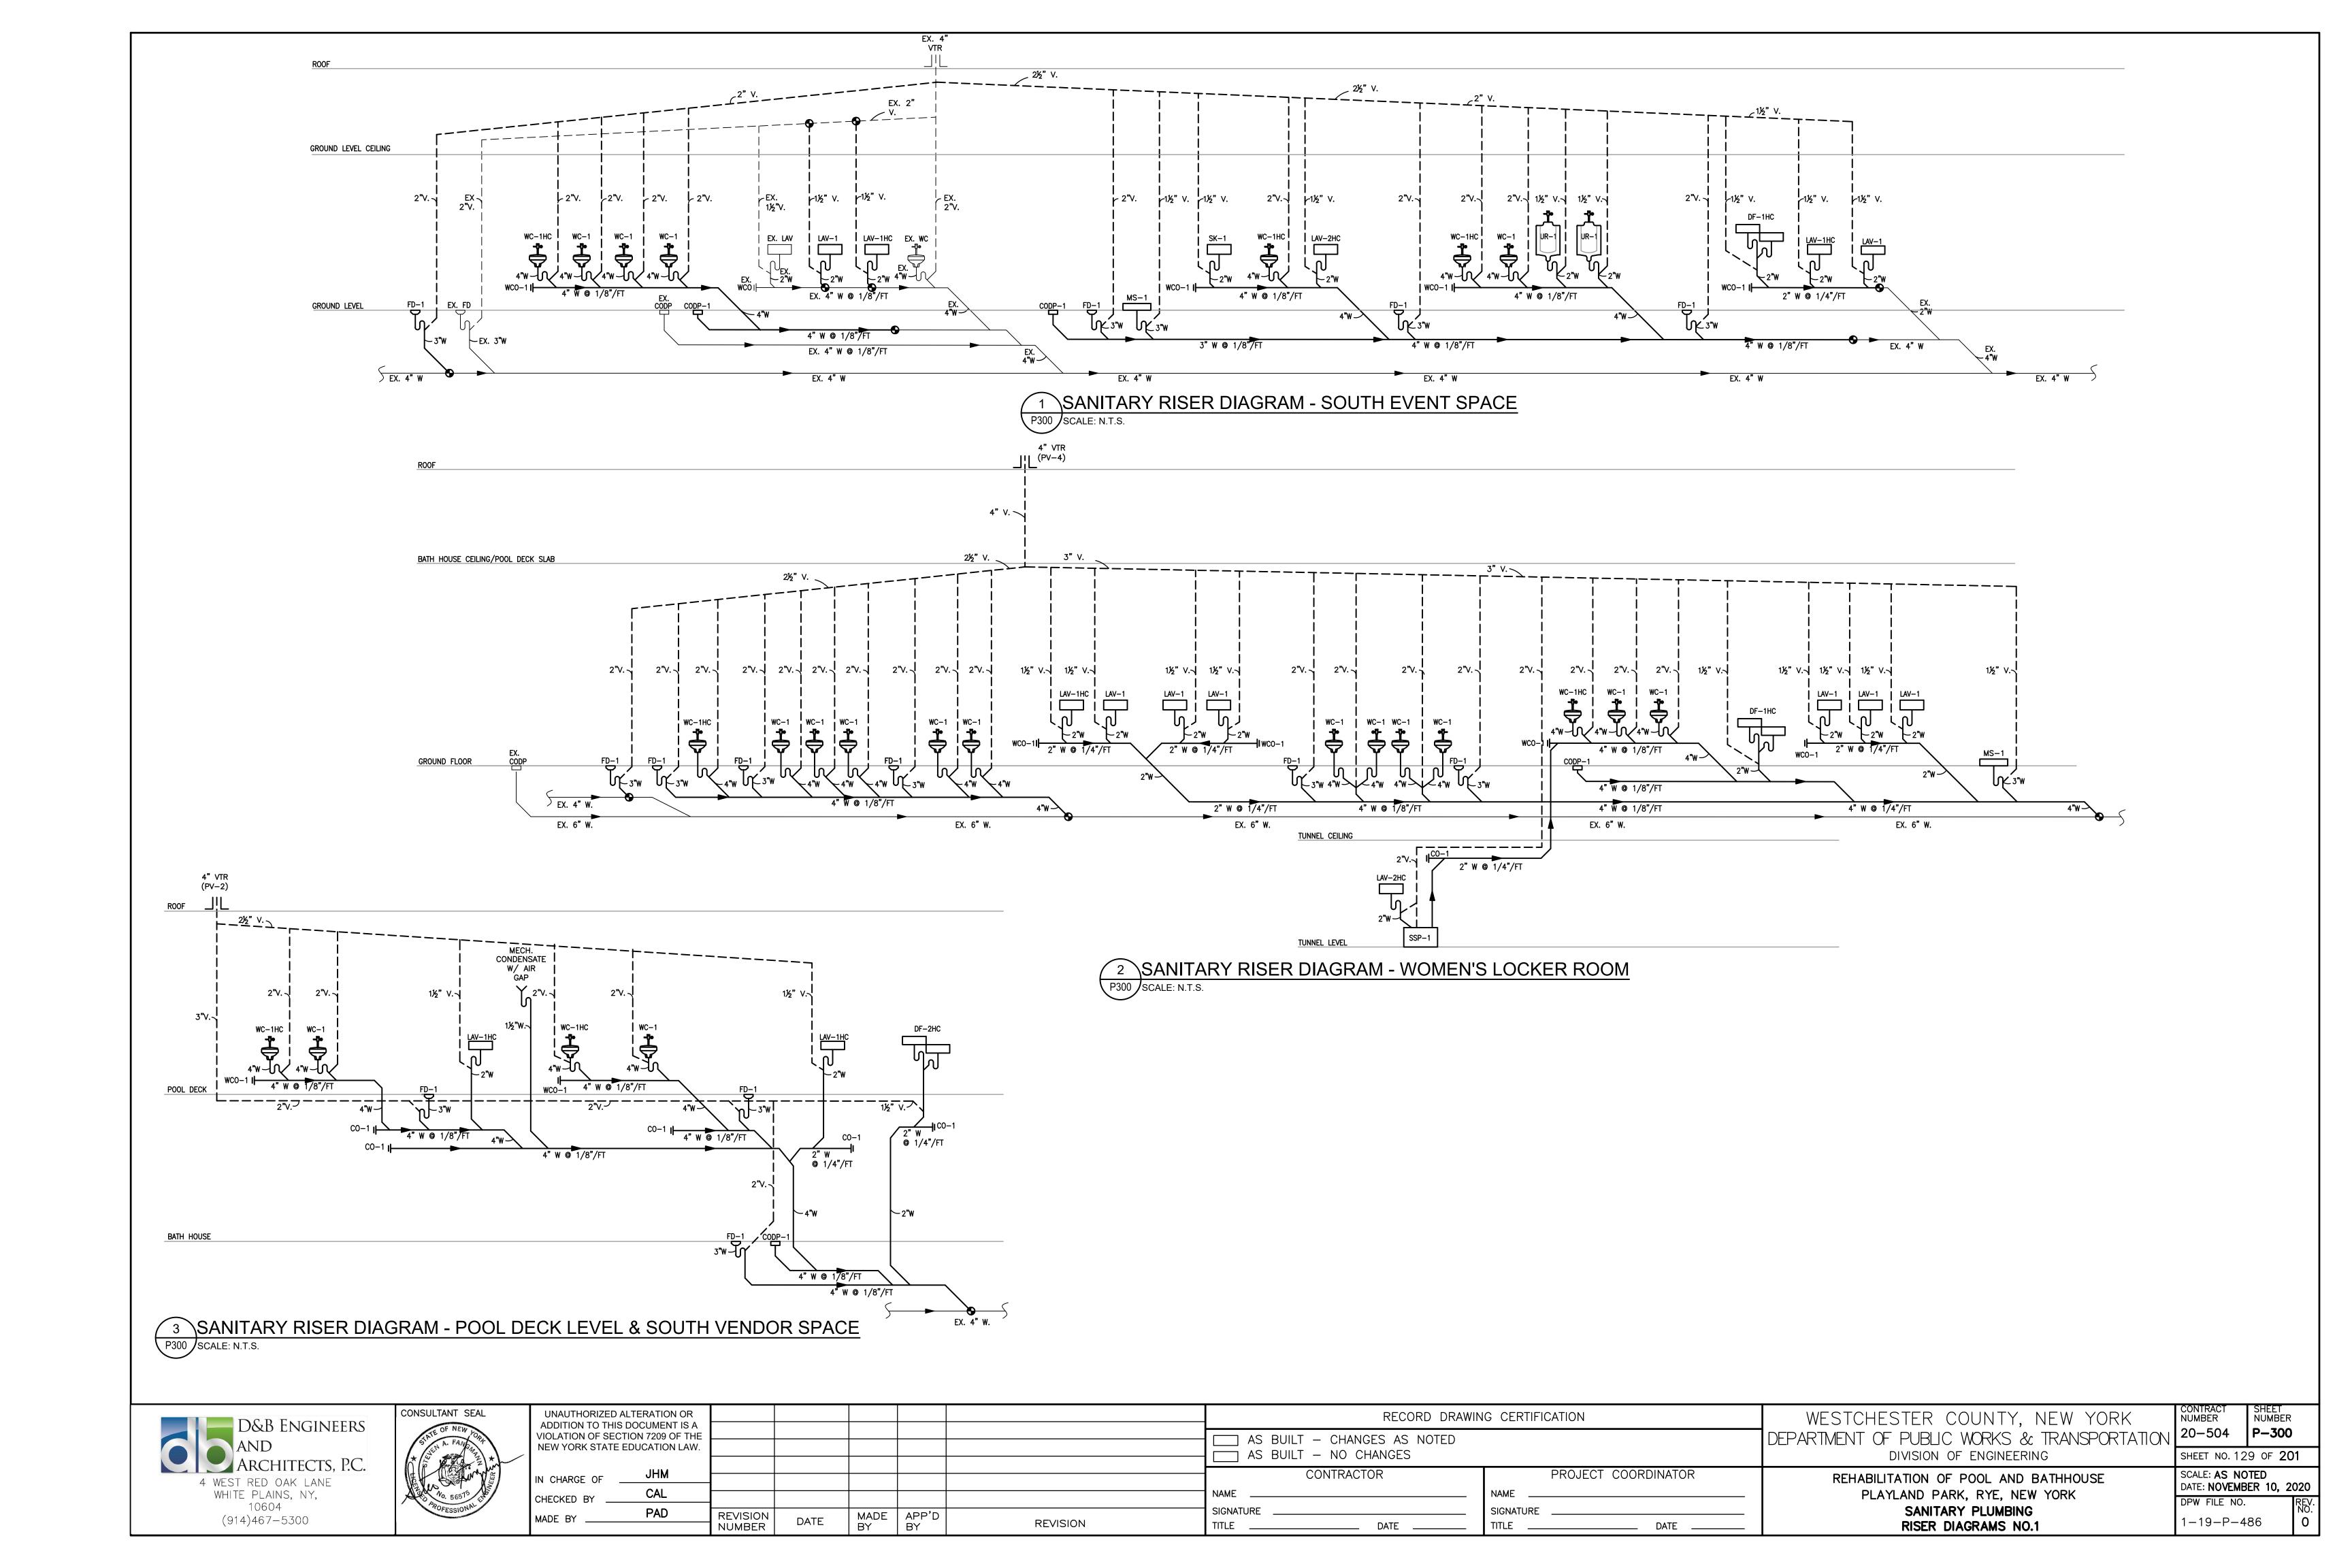

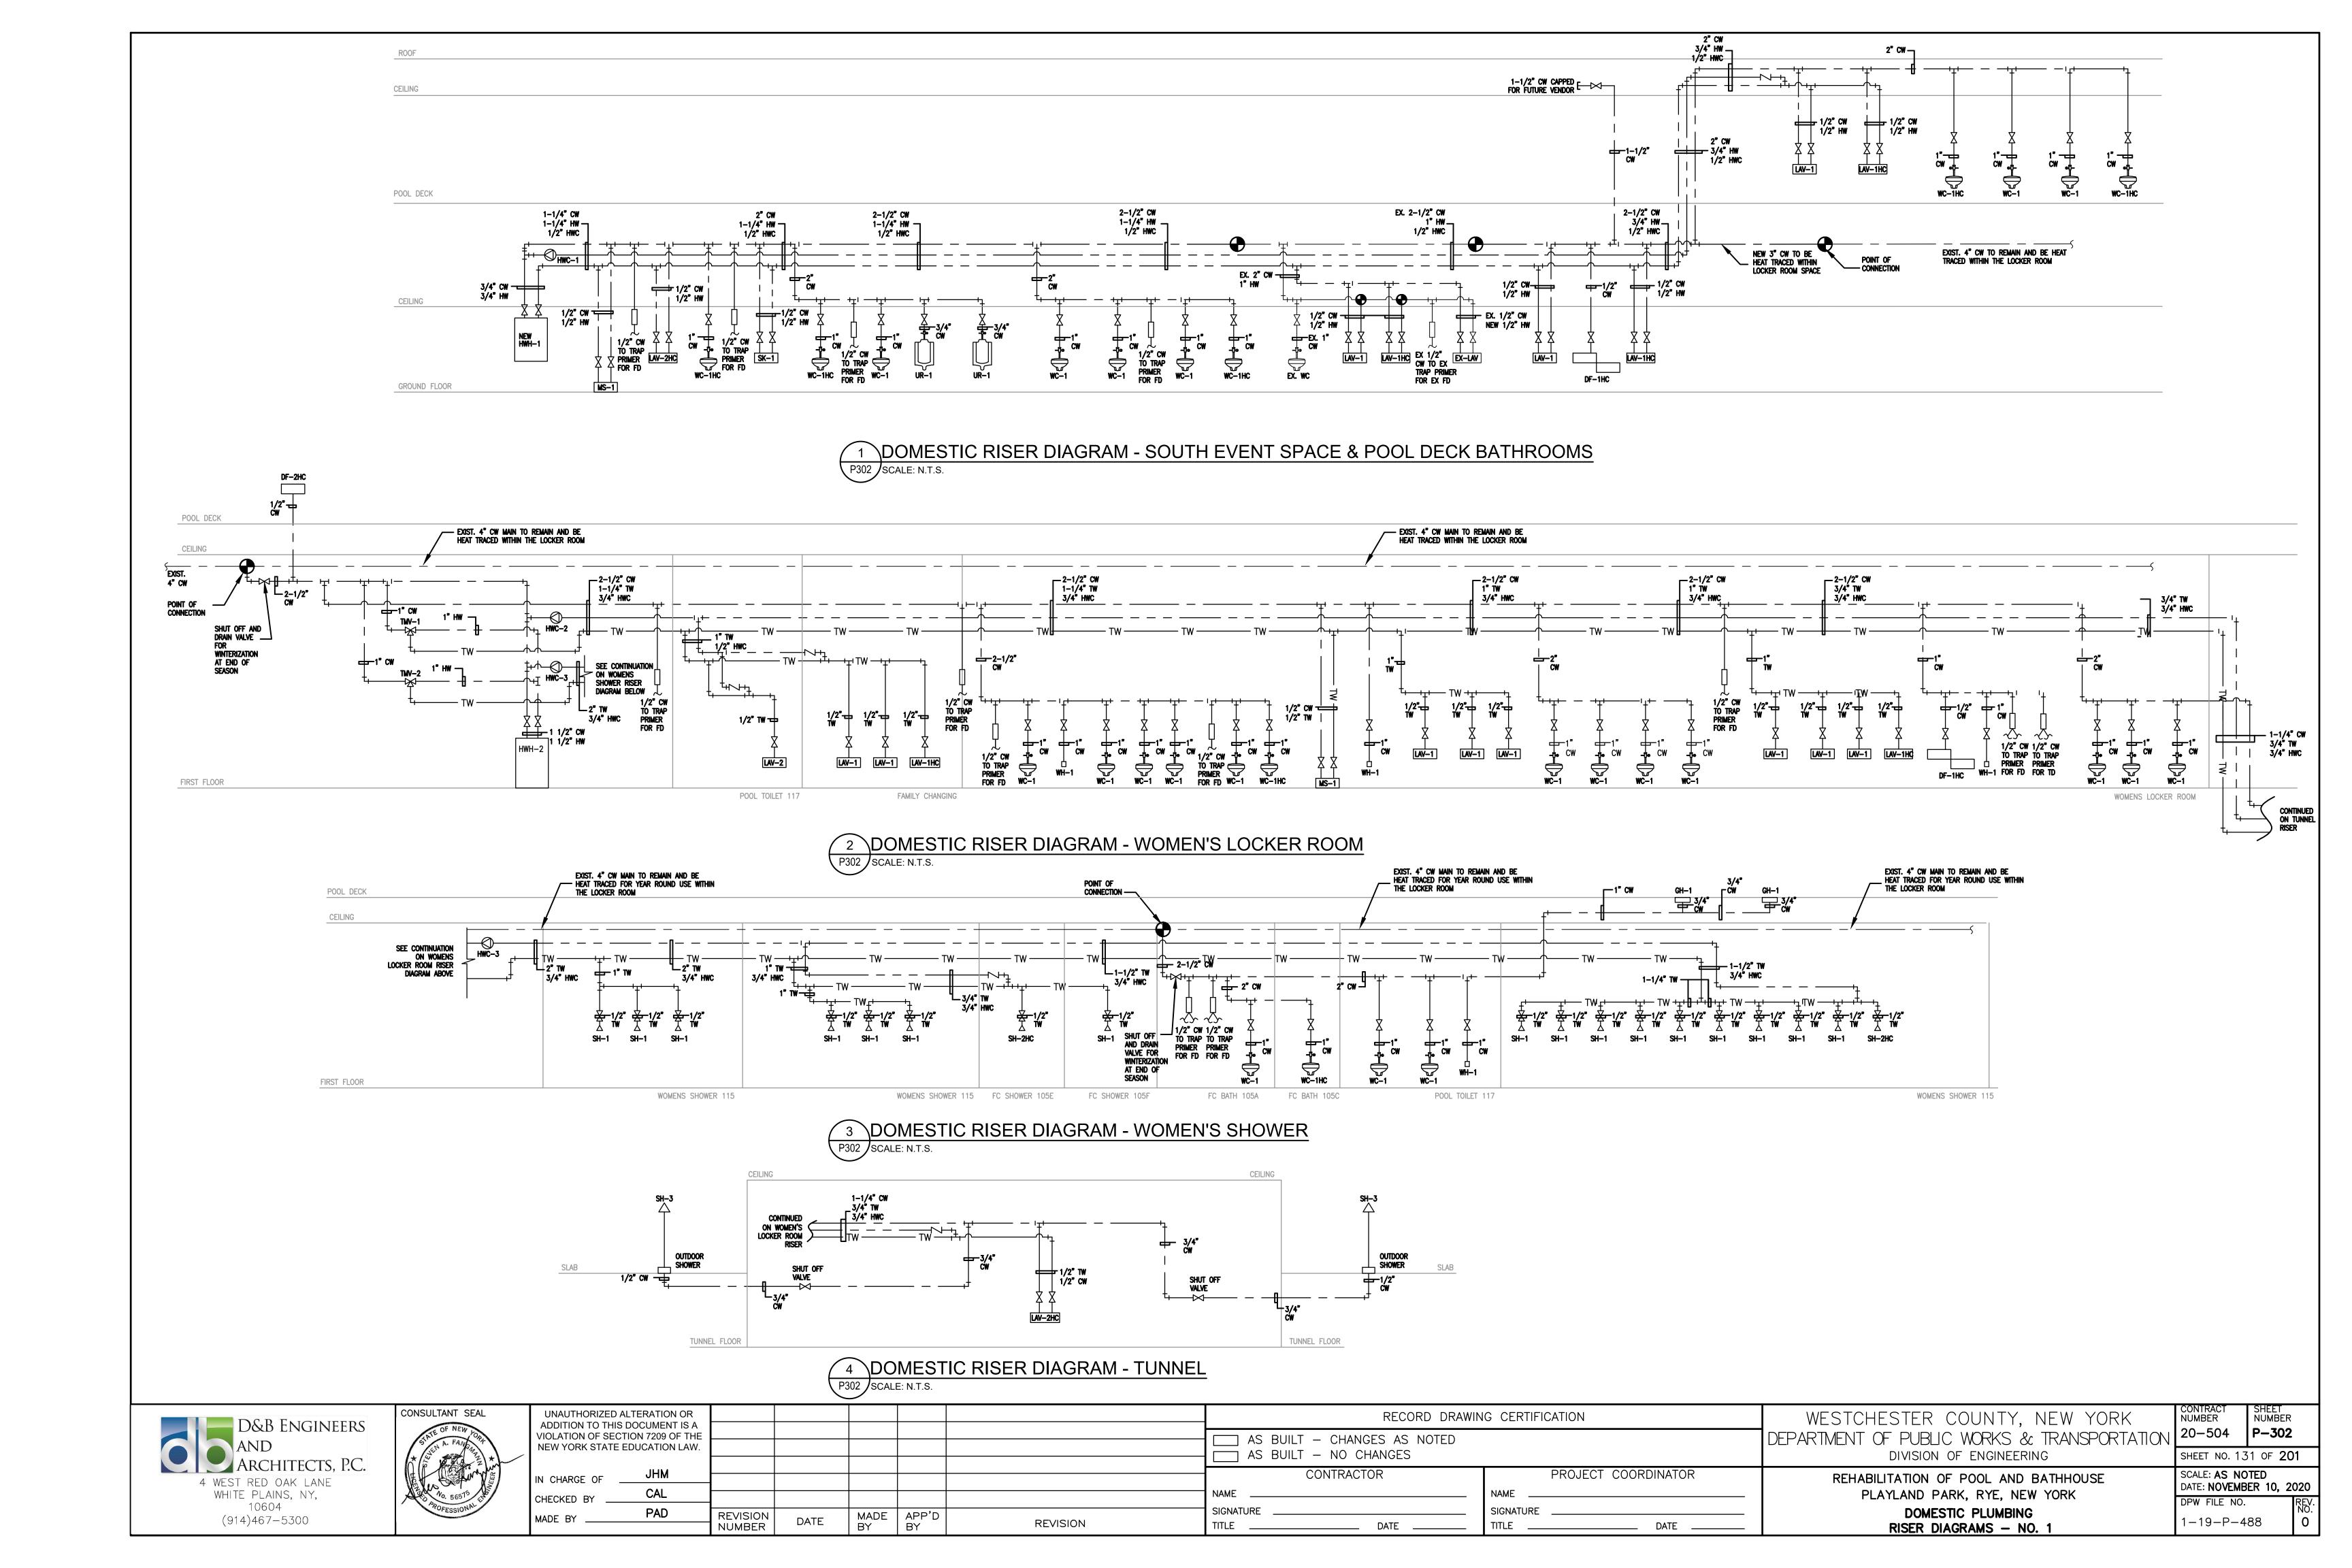


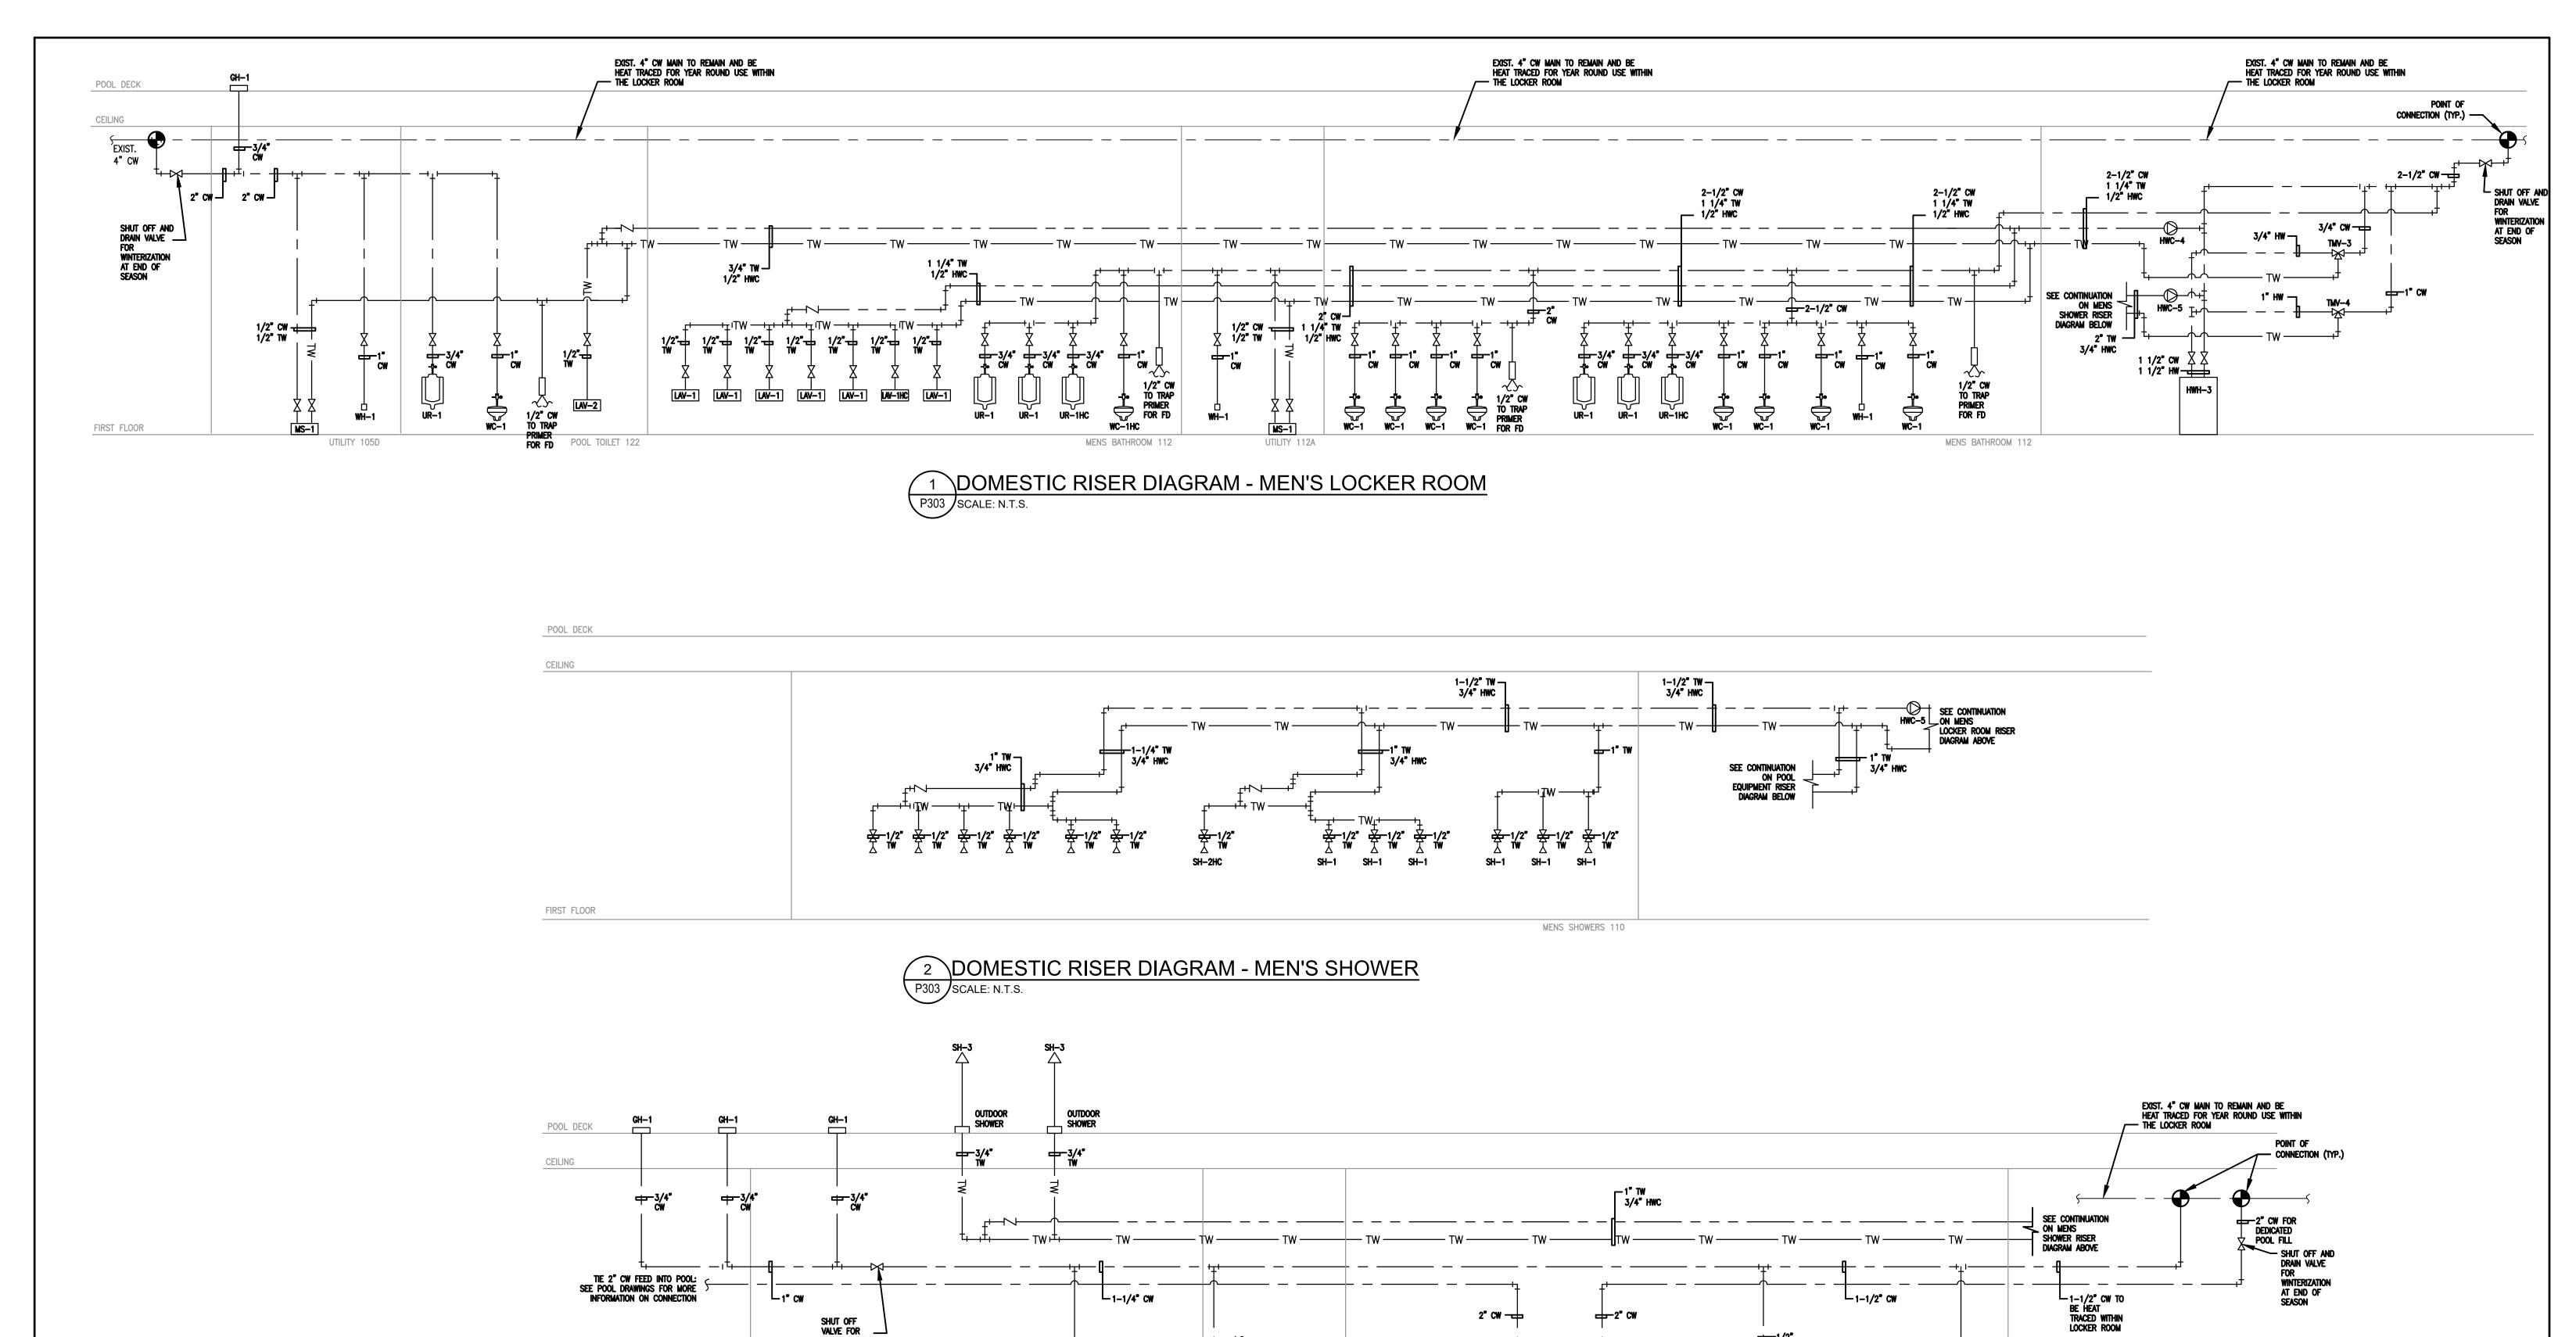

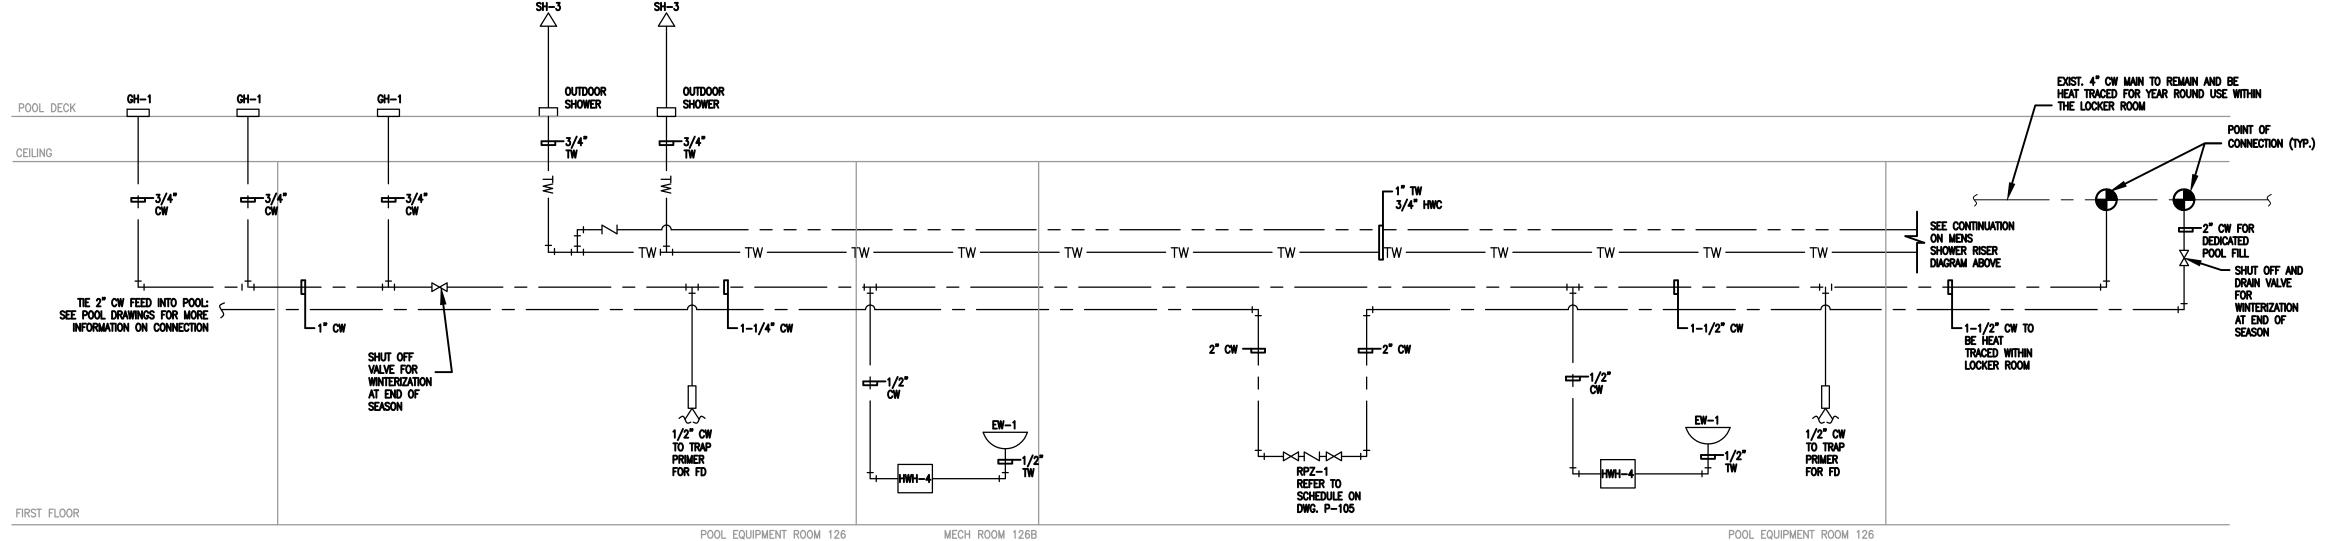

PROJECT COORDINATOR

3 DOMESTIC RISER DIAGRAM - POOL EQUIPMENT ROOM P303 SCALE: N.T.S.

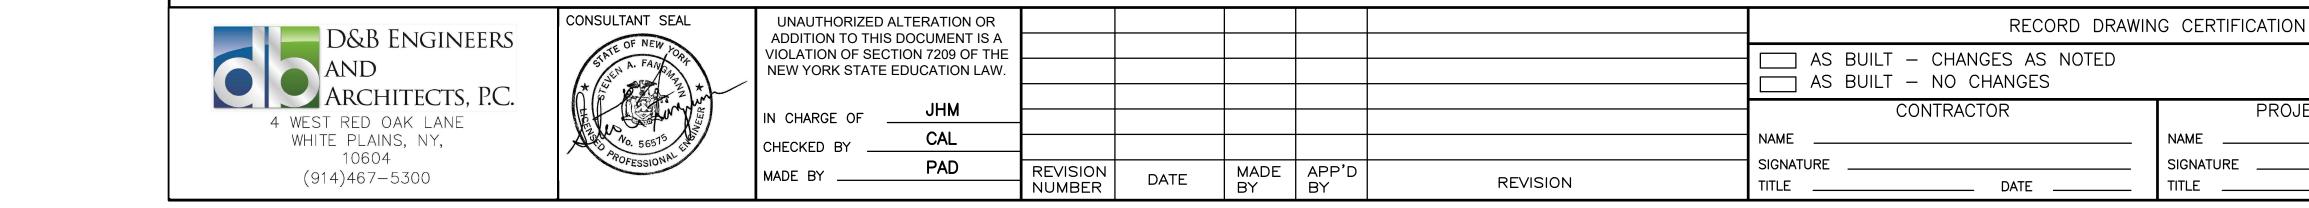


WESTCHESTER COUNTY, NEW YORK DEPARTMENT OF PUBLIC WORKS & TRANSPORTATION	CONTRACT NUMBER 20-504
DIVISION OF ENGINEERING	SHEET NO. 1
REHABILITATION OF POOL AND BATHHOUSE	SCALE: AS N


RISER DIAGRAMS - NO. 2


DIVISION OF ENGINEERING	SHEET NO. 132 OF 20 1	1
HABILITATION OF POOL AND BATHHOUSE PLAYLAND PARK, RYE, NEW YORK	SCALE: AS NOTED DATE: NOVEMBER 10, 20	20
DOMESTIC PLUMBING	DPW FILE NO. 1-19-P-489	REV. NO. O

SHEET NUMBER

P-303

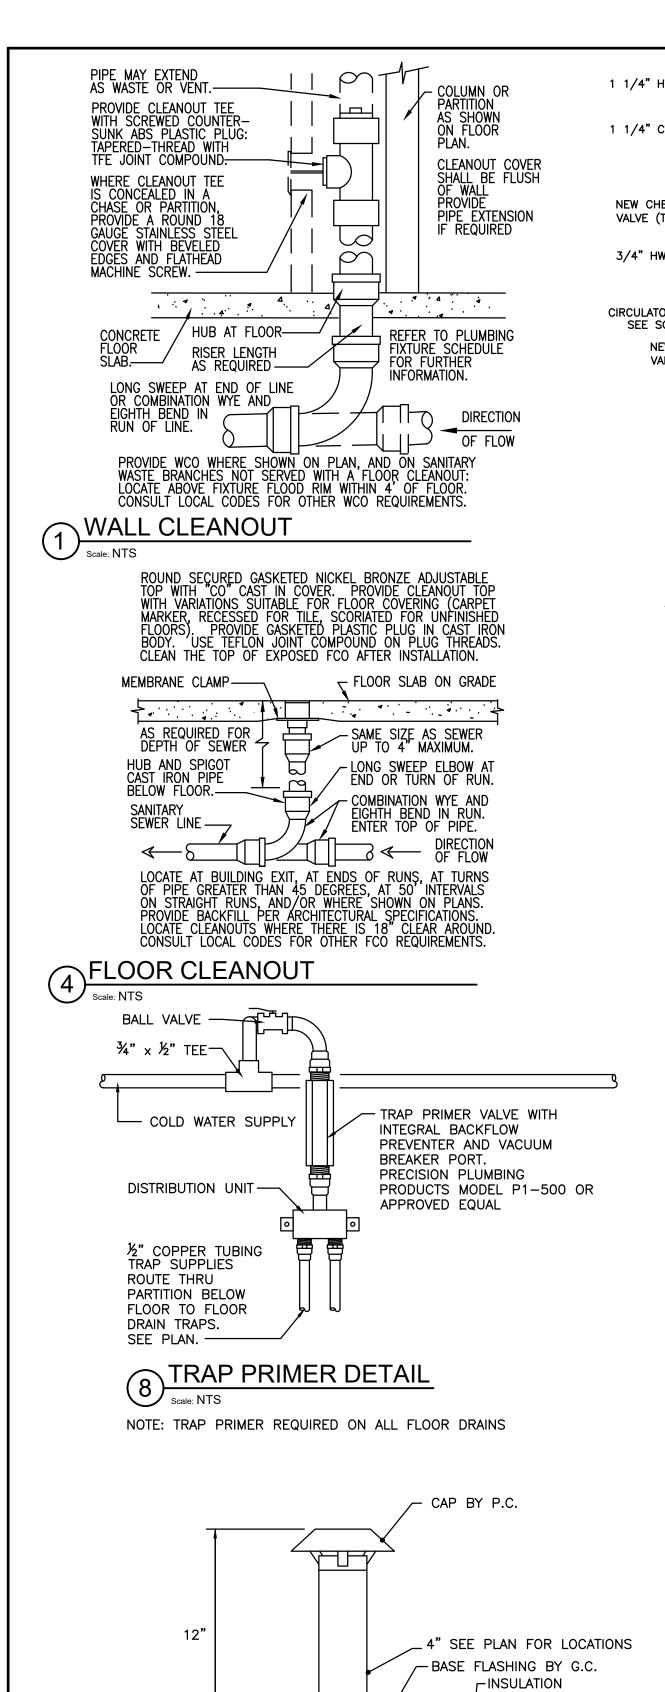


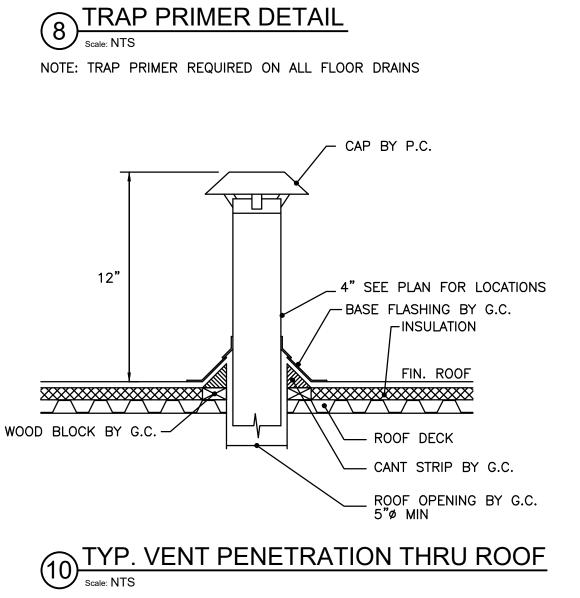

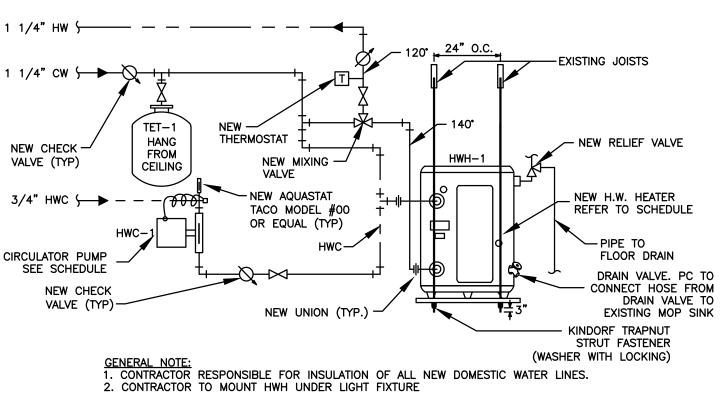

SELECTRIC WATER HEATER DETAIL

NOTE: PROVIDE PAN AND LEAK DETECTOR FOR HOT WATER HEATER. AUTOMATIC ISOLATION VALVES SHALL CLOSE AND HEATER SHALL CLOSE AND HEATER SHALL BE DE-ENERGIZED UPON ACTIVATION OF LEAK DETECTION. ALARM SHALL ALSO BE TIED INTO THE BMS REMOTE NOTIFICATION DIAL OUT ALARM SYSTEM. BASE BUILDING FIRE ALARM AND SECURITY VENDOR MUST BE USED.

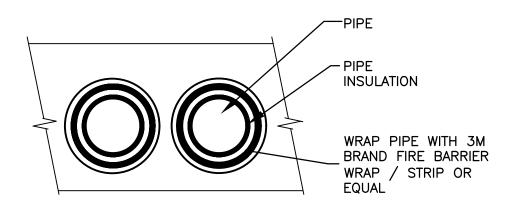

PIPE PENETRATION DETAIL THRU FIRE RATED WALL

DETAIL OF VERTICAL 3 PIPE GUIDE

╡║╞

LINE OF-STRUCTURAL


WELD OR BOLT— TO STRUCTURAL SUPPORT

SUPPORT

-PIPE SIZE VARIES

18 GAUGE X 12" LONG

INSULATION

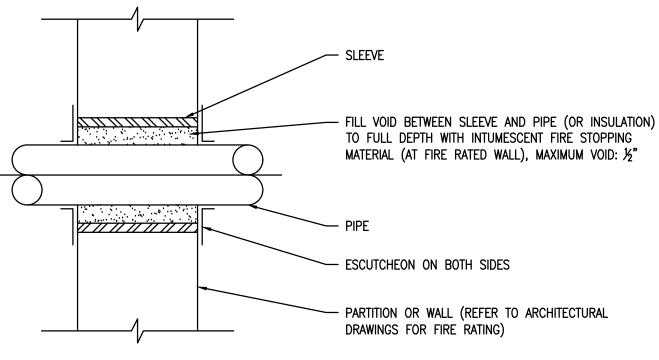

WEIGHT

3/4" | 4"ø | 900 LBS

3/4" | 4"ø | 900 LBS

PIPE PENETRATION THRU FIRE WALL

ELECTRIC DOMESTIC WATER HEATER - BASED ON BRADFORD WHITE

MARK	MODEL	TYPE	STORAGE	KW INPUT	RECOVERY @ 100° F RISE	PHYSI Di/	CAL DIMENSION A. HEIG	S (IN.) HT	CONNE WATER	CTIONS RELIEF	WEIGHT	
HWH-1	LE150LE-3	ELECTRIC	47 GAL	5.0 KW (SIMULTANEOUS)	42 GPH	22"	34-	1/2"	3/4"	3/4"	140 LBS	
HOT WATER CIRCULATOR PUMP SCHEDULE -BASED ON TACO												
MARK	MODEL NO.	MANF.	FLOW	MOTOR	VOLTAGE	RPM	CONTROL	DISC	CONNECT	REMARKS	5	
11110 4	000 004	T400	75 GPM	1/40 HP	445)/	7050	AUIIVAT &	ON /05	E CWITOLI	ALL DDON'	7.5	

	TO CHILOCOL HOIL	T OWN COLLEGE	5,1015 011		Г				
MARK	MODEL NO.	MANF.	FLOW	MOTOR	VOLTAGE	RPM	CONTROL	DISCONNECT	REMARKS
HWC-1	006-BC4	TACO	.75 GPM @ 4.5 HEAD	1/40 HP 60 HZ, 1 PH	115V	3250	AQUASTAT & 12 HR. TIMER	ON/OFF SWITCH	ALL BRONZE CONSTRUCTION
HWC-2	007-B4	TACO	1.5 GPM @ 9.0' HEAD	1/40 HP 60 HZ, 1 PH	115V	3250	AQUASTAT & 12 HR. TIMER	ON/OFF SWITCH	ALL BRONZE CONSTRUCTION
HWC-3	006-BC4	TACO	.85 GPM © 5.2 HEAD	1/40 HP 60 HZ, 1 PH	115V	3250	AQUASTAT & 12 HR. TIMER	ON/OFF SWITCH	ALL BRONZE CONSTRUCTION
HWC-4	006-BC4	TACO	.8 GPM @ 6.4' HEAD	1/40 HP 60 HZ, 1 PH	115V	3250	AQUASTAT & 12 HR. TIMER	ON/OFF SWITCH	ALL BRONZE CONSTRUCTION
HWC-5	006-BC4	TACO	1 GPM @ 5.5' HEAD	1/40 HP 60 HZ, 1 PH	115V	3250	AQUASTAT & 12 HR. TIMER	ON/OFF SWITCH	ALL BRONZE CONSTRUCTION

HOT WATER EXPANSION TANK SCHEDULE -BASED ON AMTROL

MARK	MODEL NO.	MANF.	VOLUME	DIAMETER	HEIGHT	CONN.	WEIGHT	
TET-1	ST-5-C	AMTROL	2 GAL.	8"	14"	3/4"	10 LBS	
TET-2	ST-12-C	AMTROL	6.4 GAL.	12"	18"	3/4"	26 LBS	
TET-3	ST-12-C	AMTROL	6.4 GAL.	12"	18"	3/4"	26 LBS	

FLOOR	(FD-1)	8	TRENCH	DRAIN	(TD-1)	SCHEDULE

HWH-2 | EF-100T-250-3X | PROPANE | 100 GAL

HWH-3 | EF-100T-250-3X | PROPANE

LOCATION	MARK	MFG.	MODEL #	PIPE SIZE	STRAINER	BODY	STRAINER	NOTES
RESTROOM	FD-1	ZURN	ZN-415-P-VP	3"ø	6 " ø	C.I.	TYPE B, NICKEL BRONZE	W/DEEP SEAL TRAP AND 1/2" PRIMER TAP
SHOWERS	TD-1	JR SMITH	9667 — WG	2"ø		C.I.	STAINLESS STEEL	W/DEEP SEAL TRAP AND 1/2" PRIMER TAP REFER TO ARCHITECTURAL DRAWINGS FOR LENGTH

96%

96%

28-1/4"

28-1/4"

DOMESTIC	WATER HEATER - E	BASED ON BR	ADFORD WI	HITE COMMERCIAL	HIGH EFFICIENCY	PROPANE F	FIRED WATER HI	EATER		
MARK	MODEL	GAS TYPE	CAPACITY	BTU/HR INPUT	RECOVERY @ 100° F RISE	THERM EFF.	PHYSICAL DI DIA.	MENSIONS (IN.) HEIGHT	CONNE WATER	CTIO L

291 GPH


291 GPH

MASTER MIX	(ER TEMPERED W	ATER VALVE	SCHEDULE - BASEI	ON LEONARD			
MARK	LOCATION	MFG.	MODEL #	GPM FLOW	MIN GPM	INLET	OUTLET
TMV-1	WOMENS LR	LEONARD	270-4PS-LF	19	.5	1 " ø	1-1/4 " ø
TMV-2	WOMENS LR	LEONARD	XL-690-LF-DT	33	1	1"ø	1-1/4"ø
TMV-3	MENS LR	LEONARD	270-4PS-LF	19	.5	1 " ø	1-1/4"ø
TMV-4	MENS LR	LEONARD	XL-690-LF-DT	33	1	1"ø	1-1/4 " ø

| 100 GAL|

GENERAL PLUMBING SHEET NOTES

- 1. THE PLUMBING WORK SHALL BE PERFORMED IN STRICT ACCORDANCE WITH THE PROJECT SPECIFICATIONS AND WITH THE LATEST EDITION OF THE PREVAILING STATE PLUMBING CODES AS WELL AS ALL LOCAL REGULATIONS THAT MAY APPLY. IN CASE OF CONFLICT BETWEEN THE CONTRACT DOCUMENTS AND A GOVERNING CODE OR ORDINANCE THE MORE STRINGENT STANDARD SHALL APPLY.
- 2. ALL PLUMBING WORK SHALL BE COORDINATED WITH ALL OTHER TRADES BEFORE PROCEEDING.
- 3. INVERT ELEVATIONS AND EXACT LOCATIONS OF ALL EXISTING UTILITIES SHALL BE VERIFIED BEFORE PROCEEDING WITH NEW WORK.
- 4. NO CHANGES ARE TO BE MADE IN PLUMBING LAYOUT WITHOUT WRITTEN PERMISSION BY THE ARCHITECT AND/OR ENGINEER.
- 5. NO PIPING SHALL BE EXPOSED IN FINISHED AREAS.
- 6. ROUGHING DIMENSIONS OF TOILET FIXTURES MUST BE COORDINATED WITH ALL TRADES.
- 7. WATER SUPPLY PIPING SHALL BE TYPE "L" COPPER, OR EQUAL.
- 8. INSULATE ALL WATER PIPING EXCEPT EXPOSED TO FIXTURES WITH 1/2" FIBERGLASS INSULATION WITH NON-COMBUSTIBLE UL RATED VAPOR BARRIER OR CLOSED CELL FLEXIBLE INSULATION.
- 9. PROVIDE SHUT-OFF VALVES AT EACH FIXTURE ON WATER SUPPLY PIPES, COLD AND HOT.
- 10. ALL ACCESS PANELS & LOCATIONS SHALL BE BY CONTRACTOR AND COORDINATED WITH ALL OTHER TRADES.
- 11. INSTALL ALL REQUIRED CLEANOUTS TO CLEAR EQUIPMENT AND FIXTURES.
- 12. ALL WORK SHALL BE PROPERLY TESTED, BALANCED, CLEANED AND DISINFECTED.
- 13. CONTRACTOR TO FIRESEAL ALL THRU-WALL PENETRATIONS THROUGH RATED WALLS WITH 3M BRAND FIRESTOP SEALANT OR APPROVED EQUAL.
- 14. REFER TO PLUMBING FIXTURE CONNECTION SCHEDULE.
- 15. ALL UNDERGROUND COPPER WATER PIPING SHALL BE PROTECTED IN A PVC CASING PIPE 2" GREATER THAN THE LARGEST DIAMETER SUPPLY LINE. PIPING SHALL BE COATED WITH ASPHALTUM AND BITUMASTIC.
- 16. ALL PIPING TO BE RUN AS TIGHT AS POSSIBLE TO STRUCTURE. COORDINATE WITH ALL
- 17. CONTRACTOR IS RESPONSIBLE FOR THE PRODUCTION OF PLUMBING AS BUILT DRAWINGS AND ASSOCIATED DOCUMENTS.
- 18. CONTRACTOR TO PROTECT PLUMBING PIPING FROM DAMAGE RESULTING FROM EXPANSION, CONTRACTION AND STRUCTURAL SETTLEMENT.
- 19. EXPANSION JOINT FITTINGS TO BE USED WHERE NECESSARY TO PROVIDE FOR EXPANSION
- SIDE ELEVATION AND CONTRACTION OF PIPING.

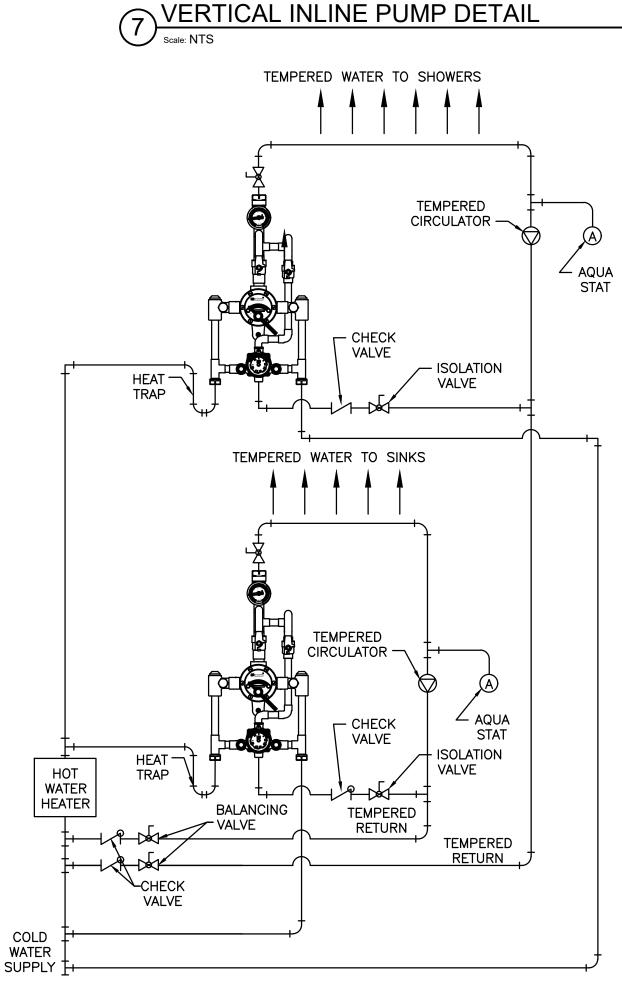

SYSTEM

REDUCING TEE ----

— GATE VALVE

- GAUGE COCK

COMBINATION BALANCING & SHUT

OFF VALVE

PUMP

PIPE FROM

SYSTEM


AQUASTAT FOR CONTROL OF

-INLINE CICULATING PUMP, SEE

SCHEDULE FOR MODEL


— DIAL TYPE PRESSURE

GAUGE (0-100 PSIG)

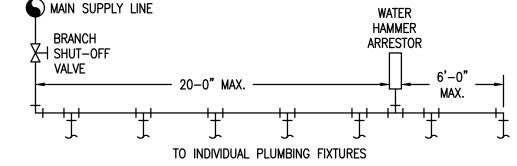

- 1. WATER HAMMER ARRESTORS (WHA) SHALL CONFORM TO ASSE-1010 (LATEST EDITION) WHA SHALL BE MANUFACTURED BY WATTS, SIOUX CHIEF OR APPROVED EQUAL PROVIDE WHA ON ALL NEW/RENOVATED HOT AND COLD WATER SUPPLY BRANCH PIPING 4. WHA SHALL BE INSTALLED WITHIN 20' OF CONNECTION TO SUPPLY MAIN AND WITHIN 6' OF THE
- LAST FIXTURE SERVED BY THE DEVICE. 5. IF BRANCH LINES EXCEED 20', INSTALL MULTIPLE WHA AT 20' O.C. WITH THE FINAL ARRESTOR
- BEING PLACED WITHING 6' OF THE LAST FIXTURE SERVED ON THE BRANCH. 6. PROVIDE ACCESS PANELS FOR ALL WHA, COORDINATE WITH ALL TRADES

9 WATER HAMMER ARRESTOR DETAIL Scale: NTS

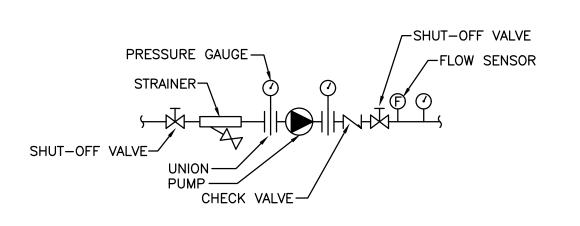



CLEANOUT SCHEDULE:

MARK	LOCATION	MFG.	MODEL #	SIZE	BODY	PIPE	TYPE
CODP-1	SEE PLANS	ZURN	ZANB-1456	4"ø	C.I.	C.I.	FLOOR
CO-1	SEE PLANS	ZURN	Z-1440-A	4"ø	C.I.	C.I.	WALL/PARTITION

TEMPERED WATER SCHEMATIC DIAGRAM

NOTE: CONTRACTOR TO REFER TO MANUFACTURERS RECOMMENDATIONS FOR PIPING





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294	ADD VIOL
***	NEW
NEER Y	IN CI
	CHEC
	MADE

UNAUTHORIZED AL ADDITION TO THIS I							RECORD DRAW	ING CERTIFICATION	
VIOLATION OF SECT NEW YORK STATE E	ION 7209 OF THE						AS BUILT — CHANGES AS NOTED AS BUILT — NO CHANGES		DE
N CHARGE OF	JHM						CONTRACTOR	PROJECT COORDINATOR	
HECKED BY	CAL						NAME	NAME	-
ADE BY	PAD	REVISION NUMBER	DATE	MADE BY	APP'D BY	REVISION	SIGNATURE DATE	SIGNATURE DATE	- -

77-1/8"

77–1/8**"**

1-1/2"

1-1/2"

WESTCHESTER COUNTY, NEW YORK DEPARTMENT OF PUBLIC WORKS & TRANSPORTATION 20-504 DIVISION OF ENGINEERING

REHABILITATION OF POOL AND BATHHOUSE PLAYLAND PARK, RYE, NEW YORK PLUMBING DETAILS

CONTRACT NUMBER SHEET NUMBER P-500 SHEET NO. 133 OF 201 SCALE: AS NOTED DATE: NOVEMBER 10, 2020 DPW FILE NO.