

					$\frac{1}{PROJECT NORTH}$		
			RECORD DRAWING CERTIFICATION AS BUILT - CHANGES AS NOTED AS BUILT - NO CHANGES CONTRACTOR NAME		DEPARTMENT OF PUBLIC WORKS & TRANSPORTATION	20-504	SHEET NUMBER FP-101
					REHABILITATION OF POOL AND BATHHOUSE	SHEET NO. 134 SCALE: AS NOT DATE: NOVEMBE DPW FILE NO.	TED
ATE	MADE APP'D BY BY	REVISION	SIGNATURE DATE	SIGNATURE DATE	I FIRE PROTECTION PLAN		191 0


FIRE	PROTECTION LEGEND
+ ^C _N	NEW CONCEALED FIRE SPRINKLER HEAD
→ ^{SW}	NEW SIDEWALL FIRE SPRINKLER HEAD
-¢_ EX	EXISTING UPRIGHT FIRE SPRINKLER HEAD
-+ _{EX}	EXISTING CONCEALED FIRE SPRINKLER HEAD
	EXISTING SPRINKLER PIPING
	NEW SPRINKLER PIPING
Ð	POINT OF CONNECTION TO EXISTING PIPING

GENERAL NOTES


- REFER TO SPRINKLER SPECIFICATIONS FOR ADDITIONAL REQUIREMENTS FOR PIPING AND HANGERS.
- SPRINKLER PIPE AND FITTINGS SHALL BE SO INSTALLED THAT THE SYSTEM MAY BE DRAINED TO THE EXISTING DRAIN VALVE.
- HANGER ASSEMBLIES AND COMPONENTS SHALL BE LISTED. PROVIDE RETAINING STRAPS WHEN INSTALLING BEAM CLAMPS OR CLAMPS.
- 4. THE UNSUPPORTED LENGTH BETWEEN THE END SPRINKLER AND THE LAST HANGER SHALL NOT EXCEED 36 INCHES.
- 5. THE LENGTH OF AN UNSUPPORTED ARMOVER SHALL NOT EXCEED 24 INCHES.
- 6. ALL NEW SPRINKLERS ADDED AS PART OF THIS WORK SHALL BE IDENTICAL TO THOSE INSTALLED.

LIGHT HAZAI	RD PIPE SCHEDULE	Ξ	
PIPE SIZE	STEEL PIPE MAX # HEADS	HANGER/SPA	ACING
1"	2	7' STEEL	6' COPPER
1 1/4"	3	7' STEEL	6' COPPER
1 1/2"	5	10' STEEL	8' COPPER
2"	10	11' STEEL	9' COPPER
2" 1/2"	30	10' STEEL	8' COPPER
3"	60	12' STEEL	10' COPPER
3 1/2"	100	12' STEEL	10' COPPER

THIS TABLE COMPILED FROM NFPA-13 9.2.2.1(a) AND 22.5.2.2.1

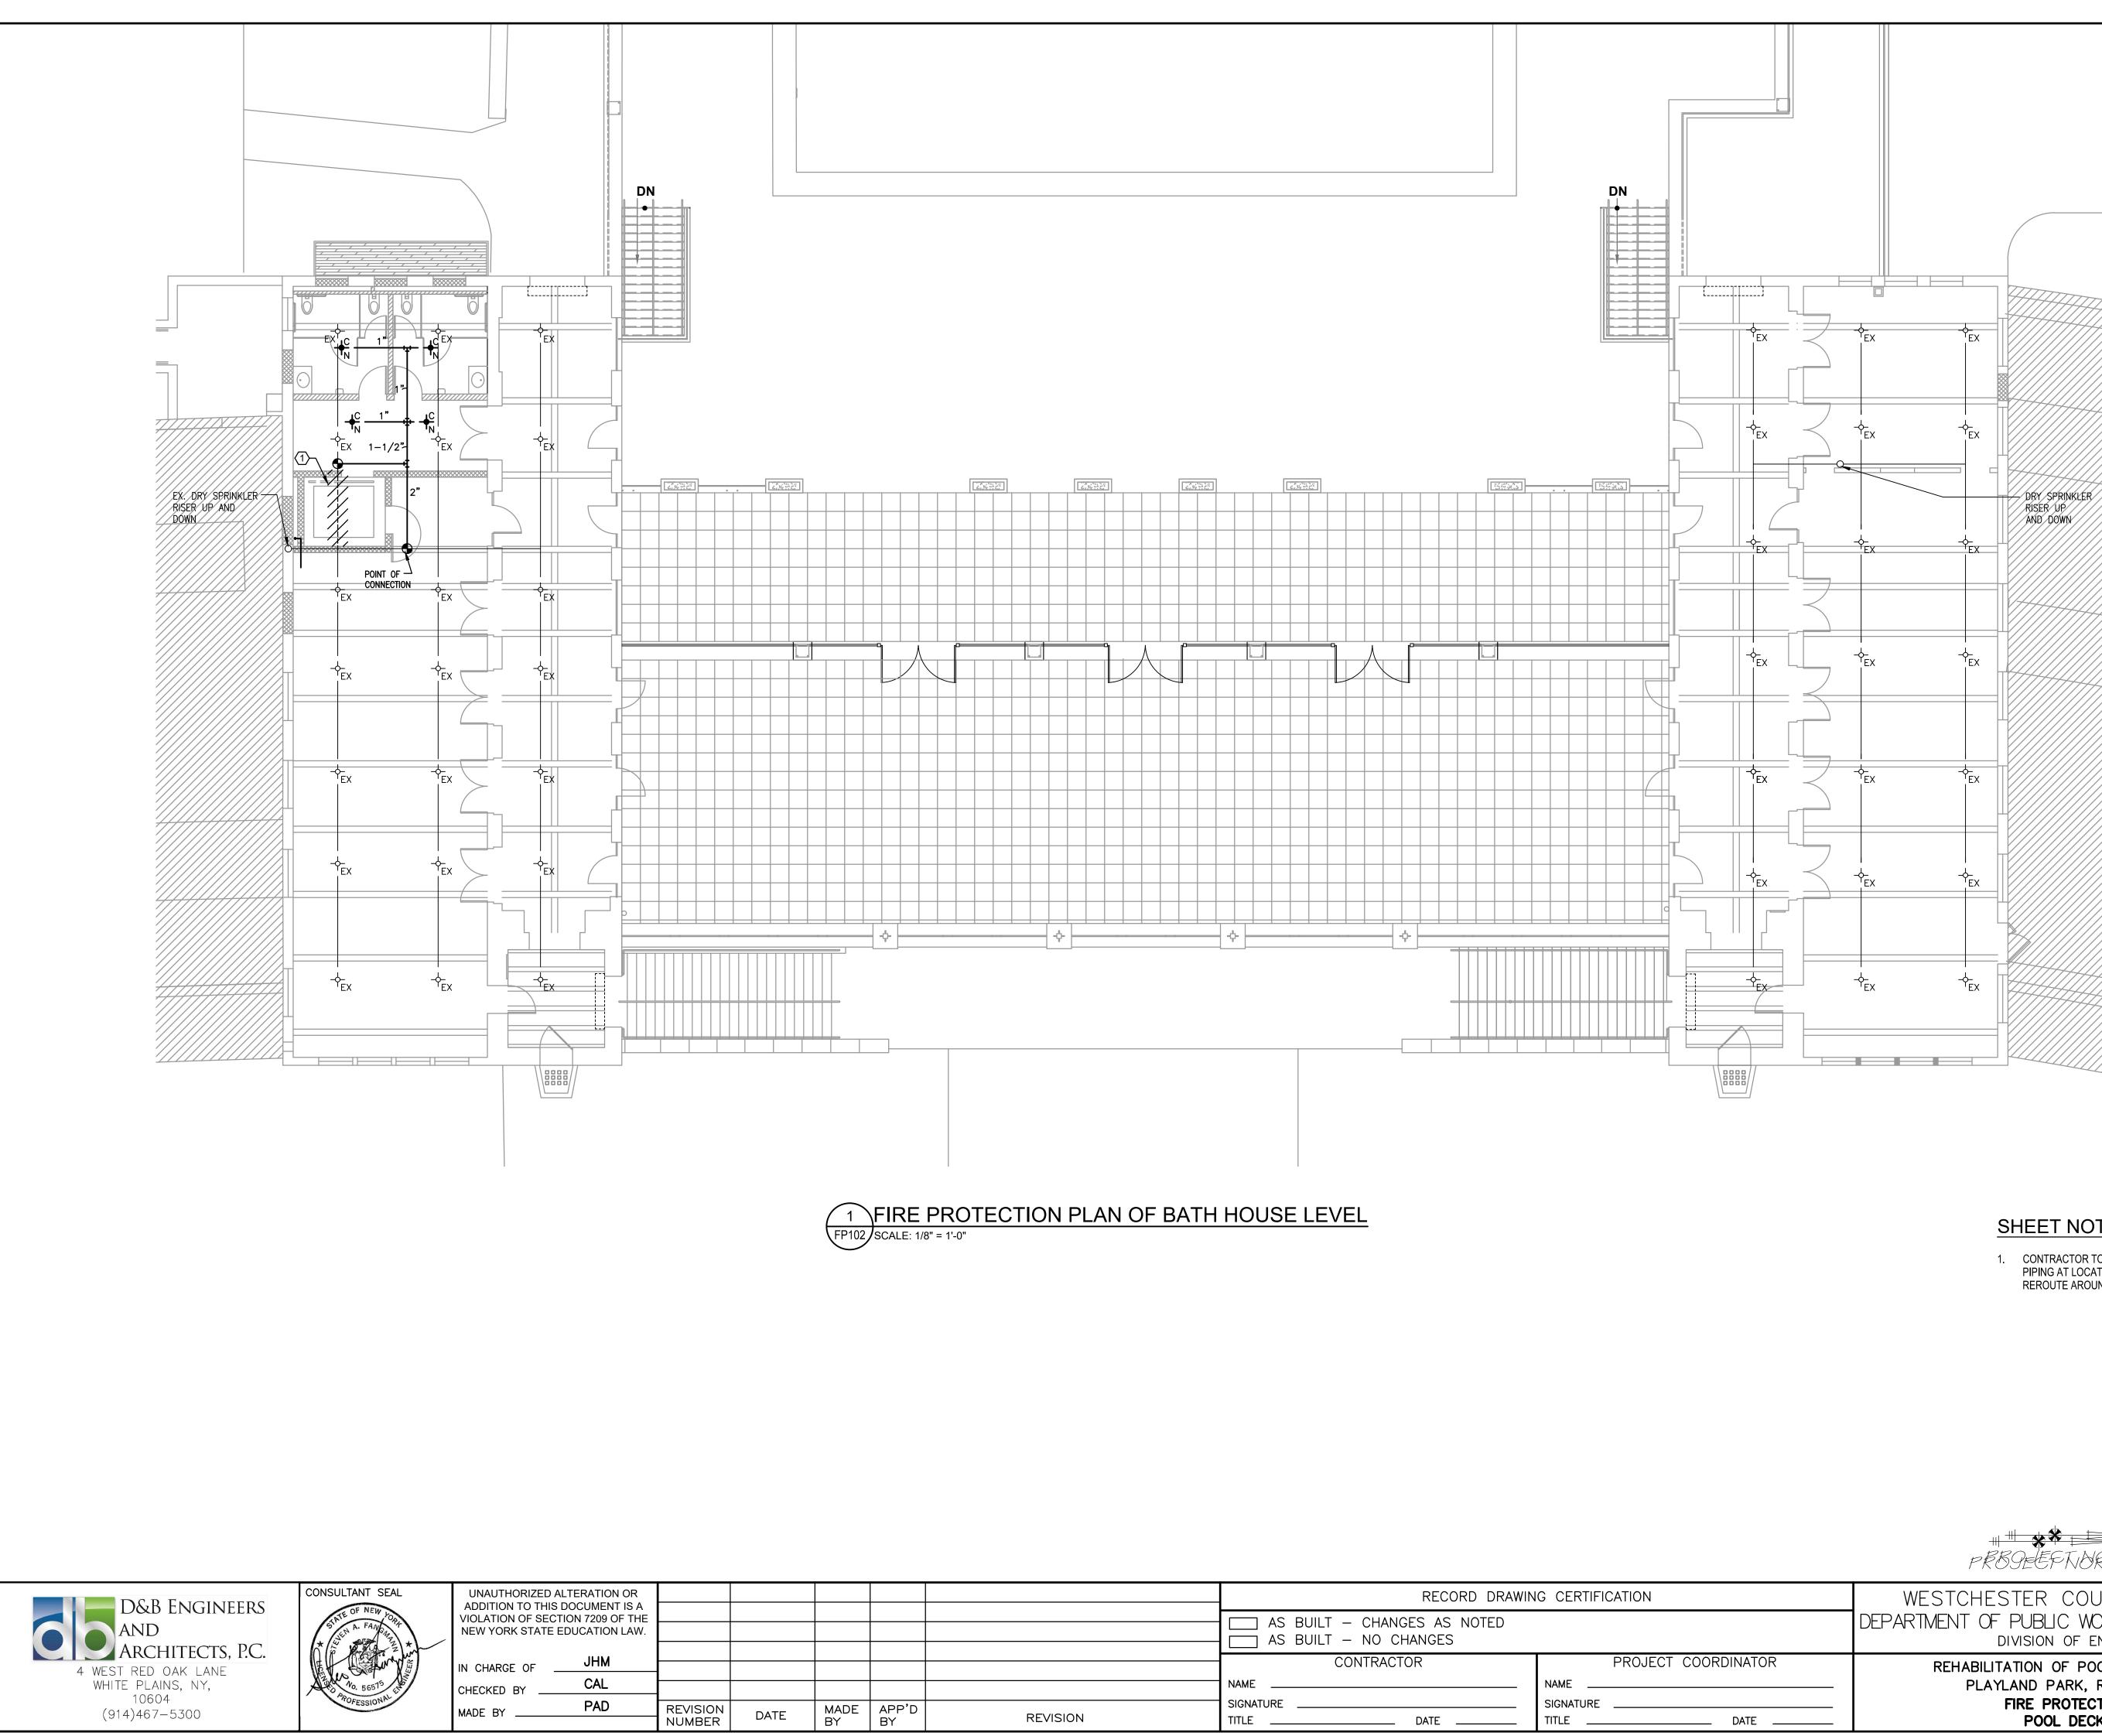

				RECORD DRAWING CERTIFICATION			
				AS BUILT – CHANGES AS NOTED AS BUILT – NO CHANGES			
				CONTRACTOR	PROJECT COOF		
				NAME	NAME		
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- 5. THE LENGTH OF AN UNSUPPORTED ARMOVER SHALL NOT EXCEED 24 INCHES.
- 6. ALL NEW SPRINKLERS ADDED AS PART OF THIS WORK SHALL BE IDENTICAL TO THOSE INSTALLED.

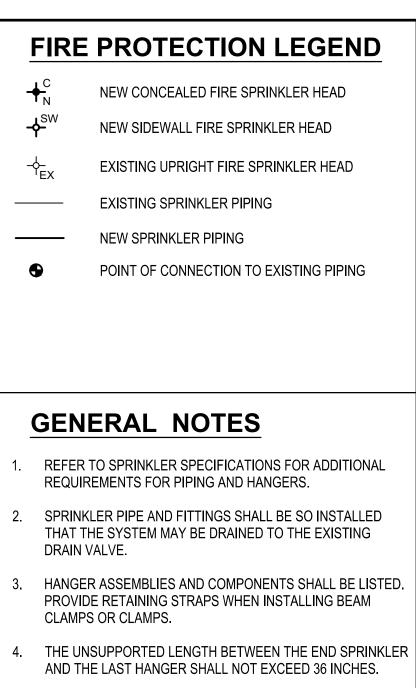
RD PIPE SCHEDULE	Ξ	
STEEL PIPE MAX # HEADS	HANGER/SPA	CING
2	7' STEEL	6' COPPER
3	7' STEEL	6' COPPER
5	10' STEEL	8' COPPER
10	11' STEEL	9' COPPER
30	10' STEEL	8' COPPER
60	12' STEEL	10' COPPER
100	12' STEEL	10' COPPER
	STEEL PIPE MAX # HEADS 2 3 5 10 30 60	MAX # HEADS Investor (1000) 2 7' STEEL 3 7' STEEL 5 10' STEEL 10 11' STEEL 30 10' STEEL 60 12' STEEL

THIS TABLE COMPILED FROM NFPA-13 9.2.2.1(a) AND 22.5.2.2.1

SHEET NOTES

1. CONTRACTOR TO REMOVE EXISTING EXPOSED SPRINKLER PIPING AT LOCATION OF NEW ELEVATOR SHAFT AND REROUTE AROUND SHAFT.

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	WESTCHESTER COUNTY, NEW YORK DEPARTMENT OF PUBLIC WORKS & TRANSPORTATION	CONTRACT NUMBER 20–504	SHEET NUMBER FP-102	
	DIVISION OF ENGINEERING	SHEET NO. 13	5 OF 201	
DRDINATOR			SCALE: AS NOTED DATE: NOVEMBER 10, 2020	
	FIRE PROTECTION PLAN	DPW FILE NO.	REV. NO.	
_ DATE	POOL DECK LEVEL	1-19-FS-	492 0	

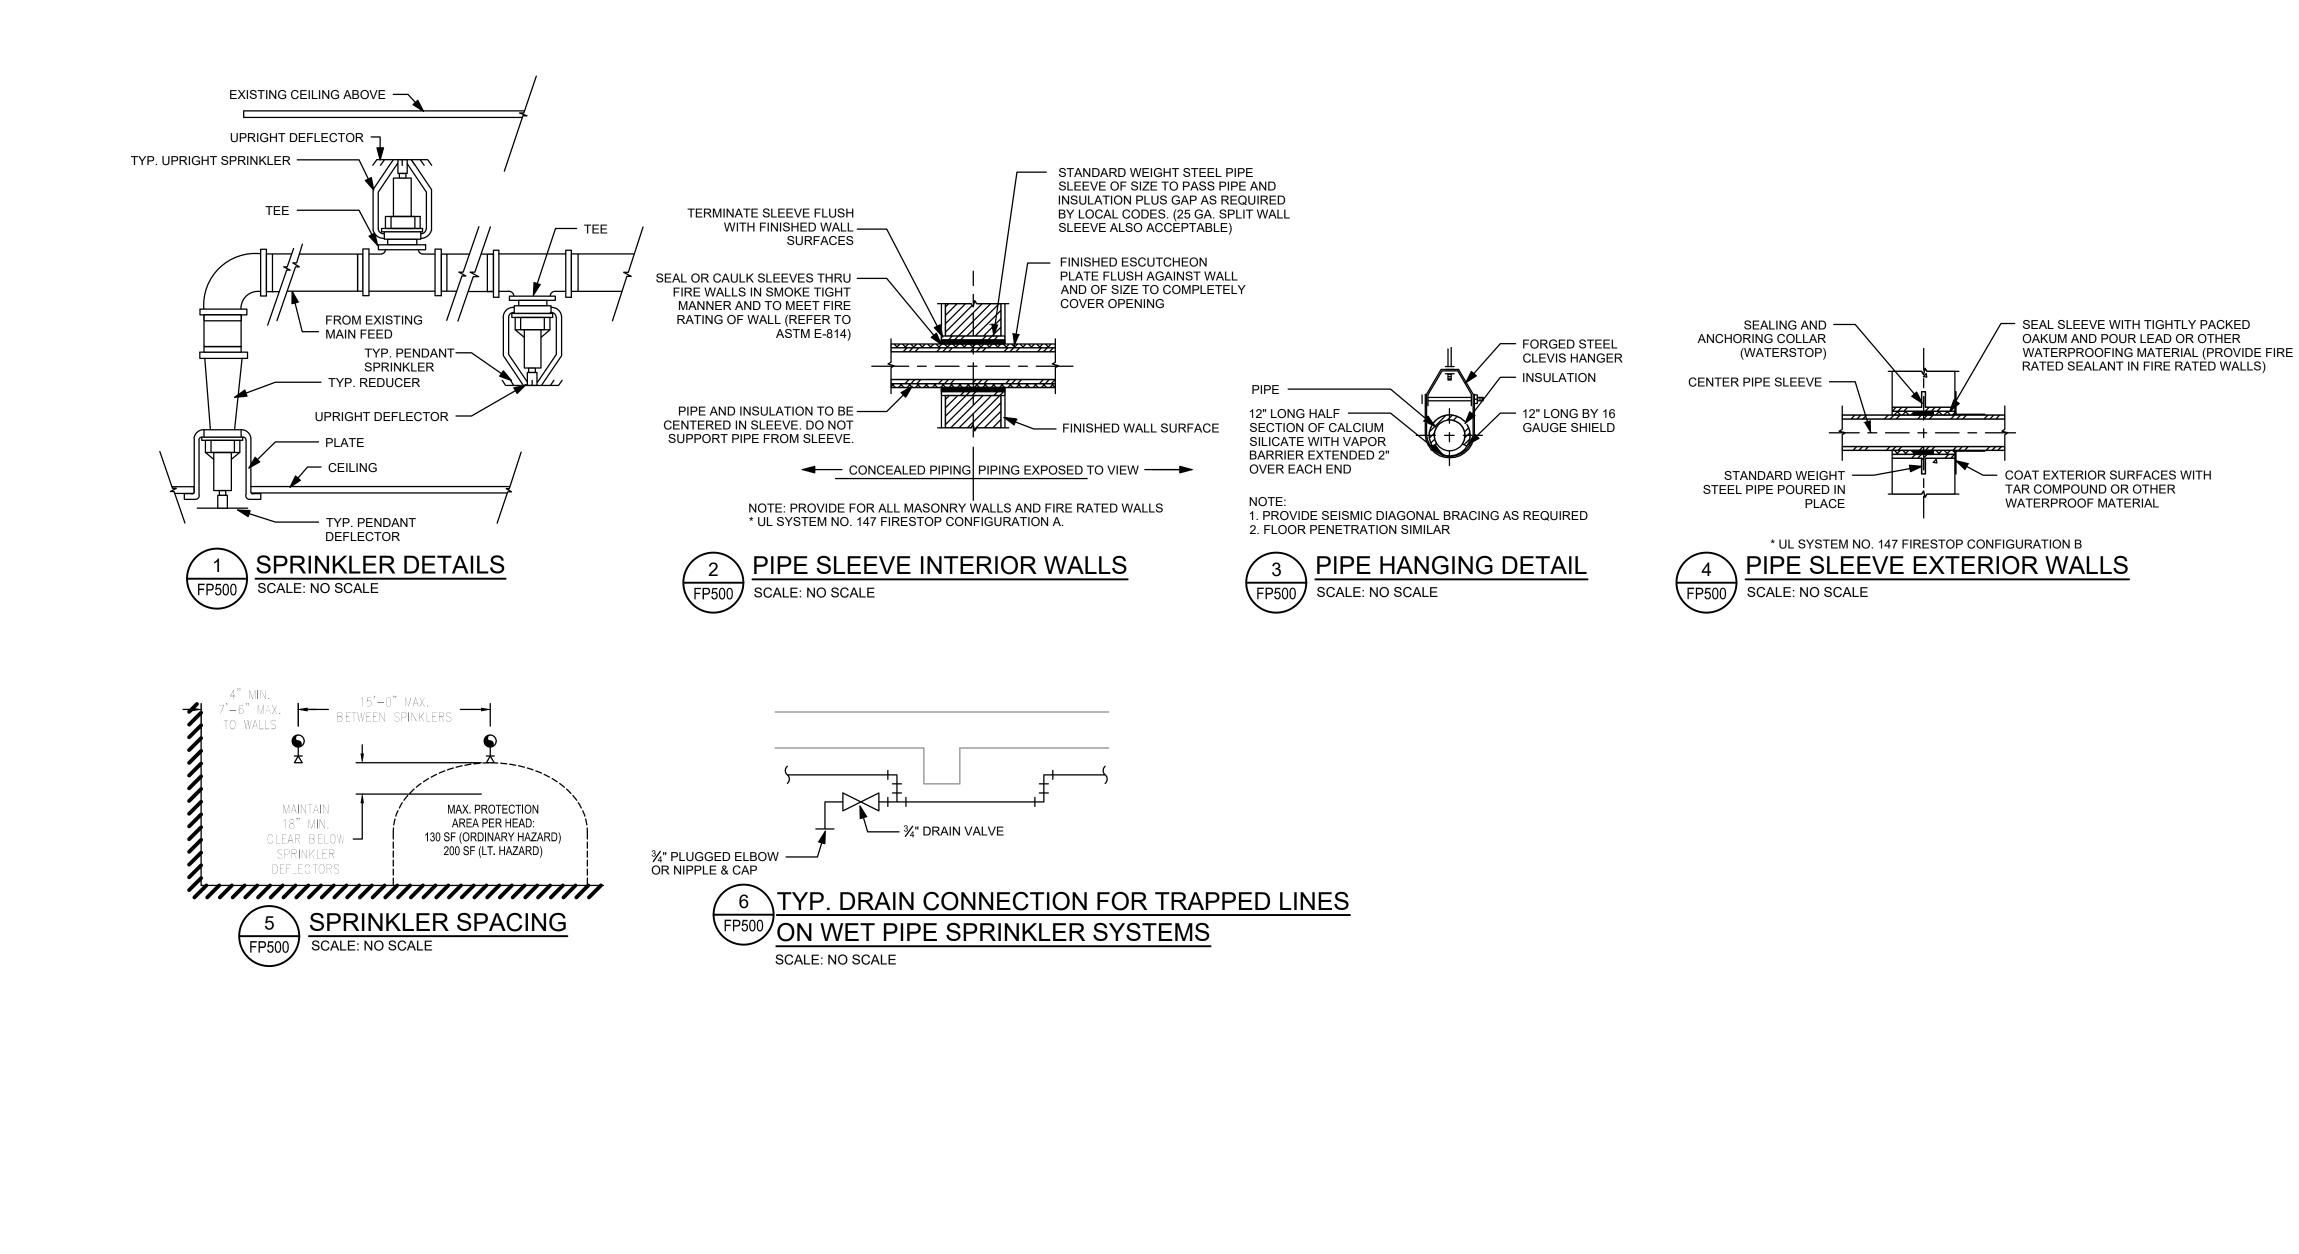



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SPRINKLER NOTES:

1. THE SPRINKLER SYSTEM SHALL BE DESIGNED TO CONFORM WITH NFPA-13 CODES (LATEST EDITION).

2. THE SYSTEM SHALL BE DESIGNED TO CONFORM TO ALL LIGHT HAZARD CLASSIFICATIONS AS DEFINED BY NFPA-13, SECTION 2-1.2.2. 3. ONLY NEW INTERMEDIATE-TEMPERATURE CLASSIFICATION SPRINKLERS SHALL BE USED THROUGHOUT THE INSTALLATION. SPRINKLERS SHALL CONFORM TO NFPA-13 SECTION 3.2. A STOCK OF SPRINKLER AND SPECIAL SPRINKLER WRENCH SHALL BE SUPPLIED AS PER SECTION 3-2.9 OF NFPA-13.

4. UPRIGHT SPRINKLERS SHALL BE INSTALLED WITH FRAME ARMS PARALLEL TO THE BRANCH LINE.

5. THE SPRINKLERS SHALL BE PROTECTED AGAINST FREEZING AND INJURY AS PER NFPA-13 SECTION 5-14.3.

6. SPRINKLERS SHALL BE LOCATED, SPACED AND POSITIONED IN ACCORDANCE WITH THE REQUIREMENTS OF SECTION 5-5 OF NFPA-13. 7. THE PROTECTION AREA OF COVERAGE PER SPRINKLER SHALL BE DETERMINED IN ACCORDANCE WITH SECTION 5-5.2.1 OF NFPA-13. 8. THE MAXIMUM DISTANCE BETWEEN SPRINKLERS SHALL COMPLY WITH TABLES 5-6.2.2 (a) THRU (d) OF NFPA-13.

9. SPRINKLERS SHALL BE INSTALLED IN ACCORDANCE WITH THEIR LISTING.

10. DISTANCE TO ROOF DECK CANNOT EXCEED 22 INCHES AND DEFLECTOR MUST BE WITHIN 1 INCH TO 6 INCHES OF THE STRUCTURAL MEMBER.

11. SPRINKLERS SHALL BE LOCATED SO AS TO MINIMIZE

OBSTRUCTIONS TO DISCHARGE AS DEFINED BY SECTION 5-6.5.2 AND 5-6.5.3 OF NFPA-13. CONTRACTOR TO ALLOW IN HIS BID TO PROVIDE AN ADDITIONAL 16 HEADS AND ASSOCIATED PIPING TO ENSURE ADEQUATE COVERAGE OF THE HAZARD DUE TO OBSTRUCTIONS.

12. THE SPRINKLER SYSTEM SHALL BE DESIGNED AND ARRANGED FOR FLUSHING PER NFPA-13 SECTION 5-13.17. 13. SPRINKLER SYSTEM SHOULD BE ABLE TO BE ISOLATED SO THAT

THE ENTIRE SYSTEM IS NOT IMPAIRED. FLOOR OR ZONE CONTROL VALVES ARE TO BE USED.

14. INSTALLATIONS OF ALL PIPE, FITTINGS AND ASSOCIATED EQUIPMENT ARE TO CONFORM TO NFPA-13 SECTION 5-14 AND CONFORM TO SECTION 3-3.

15. THE SPRINKLER SYSTEM SHALL BE PROVIDED WITH A LISTED INDICATING VALVE IN AN ACCESSIBLE LOCATION, SO LOCATED AS TO CONTROL ALL AUTOMATIC SOURCES OF WATER SUPPLY. 16. IDENTIFICATION SIGNS ARE TO BE PROVIDED AT EACH VALVE TO

INDICATE ITS FUNCTION AND WHAT IT CONTROLS. 17. TWO VALVE WRENCHES ARE TO BE PROVIDED. COORDINATE

STORAGE LOCATION WITH OWNER. 18. LOCATION OF VALVE AND WRENCHES TO BE CLEARLY MARKED IN

MECHANICAL ROOM. 19. ALL SYSTEM PIPING AND FITTINGS SHALL BE SO INSTALLED THAT THE SYSTEM CAN BE DRAINED. ALL PIPING IS TO BE ARRANGED TO

DRAIN TO THE MAIN DRAIN VALVE. 20. WATERFLOW ALARMS SHALL BE PROVIDED ON THE SPRINKLER SYSTEMS.

21. THE CONTRACTOR SHALL TIE FLOW SWITCHES INTO THE FIRE ALARM CONTROL PANEL.

22. HOSE CONNECTIONS FOR FIRE DEPARTMENT USE TO CONFORM TO NFPA-13 SECTION 5-15.5.2. COORDINATE WITH LOCAL FIRE DEPARTMENT.

23. HANGERS SHALL BE IN ACCORDANCE WITH THE REQUIREMENTS OF SECTION 6-1 OF NFPA-13. SET SCREWS SHALL NOT BE USED. 24. RISERS SHALL BE SUPPORTED BY PIPE CLAMPS AS SPECIFIED IN SECTION 6-2.4.5 OF NFPA-13.

25. ALL TEES, PLUGS, CAPS, BENDS, REDUCERS, VALVES, PIPING TO BE RESTRAINED BY THE USE OF THRUST BLOCKS AS SPECIFIED IN NFPA-13 SECTION 6-3.1 THRU 6-3.3.5.

26. MINIMUM WATER SUPPLY REQUIREMENTS FOR HYDRAULICALLY DESIGNED OCCUPANCY HAZARD FIRE CONTROL SPRINKLER SYSTEM SHALL BE DETERMINED BY ADDING THE HOSE STREAM DEMAND FOR TABLE 7-2.3.1.1 TO THE WATER SUPPLY FOR SPRINKLER DETERMINED IN 7-2.3.1.2. THIS SHALL BE AVAILABLE FOR THE MINIMUM DURATION SPECIFIED IN TABLE 7-2.3.1.1 OF NFPA-13.

27. THE CONTRACTOR SHALL PREPARE SHOP DRAWINGS AND HYDRAULIC CALCULATIONS, SIGNED AND SEALED BY A NEW YORK STATE LICENSED PROFESSIONAL ENGINEER, AND SUBMIT FOR APPROVAL OF THE LOCAL FIRE DEPARTMENT, INSURANCE CARRIER, LOCAL BUILDING DEPARTMENT AND ALL AUTHORIZATION HAVING JURISDICTION.

28. NO WORK CAN COMMENCE UNTIL ALL APPROVALS ARE IN PLACE. 29. CONTRACTORS SHALL DO THE FOLLOWING AND SUPPLY ALL REQUIRED DOCUMENTS PRIOR TO ACCEPTANCE BY THE OWNER. NOTIFY THE AHJ AND OWNER'S REPRESENTATIVE OF THE TIME AND DATE TESTING WILL BE PERFORMED. PERFORM ALL REQUIRED ACCEPTANCE TESTS PER SECTION 10-2 OF NFPA-13. COMPLETE AND SIGN THE APPROPRIATE CONTRACTOR'S MATERIAL AND TEST CERTIFICATES. CONSTRUCTION MATERIAL AND TEST CERTIFICATE FOR UNDERGROUND PIPING ALL REQUIRED FORMS FOR WESTCHESTER COUNTY, TOWN OF RYE, AND ANY ADDITIONAL FORMS REQUIRED BY THE LOCAL AHJ, BUILDING DEPARTMENT AND INSURANCE CARRIER.

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	WESTCHESTER COUNTY, NEW YORK DEPARTMENT OF PUBLIC WORKS & TRANSPORTATION	CONTRACT NUMBER 20–504	SHEET NUMBER FP-500)	
	DIVISION OF ENGINEERING	SHEET NO. 13	6 OF 201		
RDINATOR	PLAYLAND PARK, RYE, NEW YORK FIRE PROTECTION		SCALE: AS NOTED DATE: NOVEMBER 10, 2020		
			DPW FILE NO.		
DATE	NOTES & DETAILS		100	0	

