

GENERAL NOTES

- DESIGN, CONSTRUCTION, AND MAINTENANCE OF THE POOL AND RELATED FACILITY SHALL BE IN ACCORDANCE WITH THE N.Y.S. SANITARY CODE SUBPART 6-1, N.Y.S. BUILDING CODE, AND ALL THE RULES AND REGULATIONS OF THE WESTCHESTER COUNTY DEPARTMENT OF HEALTH. WHERE THERE IS CONFLICT BETWEEN CODES THE MORE STRINGENT CODE REQUIREMENT WILL APPLY.
- 2. NO REFRESHMENTS OF ANY KIND SHALL BE ALLOWED ON THE POOL DECK.
- 3. FLOORS, DECKS, AND BOTTOM OF POOL TO HAVE A NON-SLIP SURFACE.
- 4. POOL DEPTH MARKERS, INDICATED WITH MINIMUM 4" HIGH NUMERALS SHALL BE PROVIDED IN ACCORDANCE WITH THE LAYOUT ON THE DRAWINGS. NUMBER SHALL BE PLACED ON BOTH THE POOL SIDE WALL AND DECK.
- 5. FLOORS SHALL BE PITCHED A MINIMUM OF 1/4" PER FOOT TO DRAINS.
- 6. HOSE BIBS SHALL BE PROVIDED WITH VACUUM BREAKERS.
- ADEQUATE VENTILATION SHALL BE PROVIDED IN THE POOL EQUIPMENT ROOM TO PROVIDE A
- 8. THE POOL SHALL BE OPERATED UNDER SUPERVISION LEVEL II AS DEFINED BY THE N.Y.S. SANITARY CODE SUBPART 6-1.23 AS PER SAFETY PLAN FILES AND APPROVED BY WCDOH.
- 9. ALL CONNECTIONS TO STREET WATER MAINS SHALL BE IN ACCORDANCE WITH LOCAL DEPARTMENT
- 10. HOUSE SEWER CONNECTIONS AND APPROVAL TO HANDLE POOL WASTE AND DRAINS SHALL BE IN
- 11. THE POOL OPERATOR MUST DEVELOP, UPDATE, AND IMPLEMENT A WRITTEN POOL SAFETY PLAN CONSISTING OF PROCEDURES FOR REACTING TO EMERGENCIES, INJURIES AND OTHER INCIDENTS, PROVIDING FIRST AID, AND SUMMONING HELP. THE SAFETY PLAN MUST BE SUBMITTED TO, AND APPROVED BY THE WESTCHESTER COUNTY DEPARTMENT OF HEALTH PRIOR TO THE OPENING OF THE
- 12. THE POOL BUILDER SHALL PROVIDE A POOL OPERATION MANUAL. INCLUDED SHALL BE INSTRUCTIONS FOR EACH FILTER, PUMP, CHEMICAL FEED EQUIPMENT, OPENING & CLOSING POOL, DRAINING, BACKWASHING, FILLING AND GENERAL OPERATION, INCLUDING WINTERIZATION, DRAWINGS. ILLUSTRATIONS, AND PARTS LISTS SHALL BE INCLUDED ALONG WITH INSTRUCTIONS FOR THE
- 13. THE DRAWING SET HAS BEEN PREPARED FOR THE EXCLUSIVE USE BY THE CLIENT AND IS NOT INTENDED FOR ANY OTHER PURPOSE.
- 14. THESE DRAWINGS HAVE BEEN PREPARED TO MEET ALL OF THE REQUIREMENTS SET FORTH BY THE WESTCHESTER COUNTY DEPARTMENT OF HEALTH (WCDOH).
- 15. THE POOL MUST BE CONSTRUCTED IN STRICT ACCORDANCE WITH THE APPROVED DRAWINGS IN ORDER TO QUALIFY FOR A DOH OPERATING PERMIT.
- 16. ALL CHANGES MUST HAVE WRITTEN APPROVAL FROM LOTHROP ASSOCIATES LLP, dba AQUATECTONIC ARCHITECTS AND WCDOH PRIOR TO SUCH CHANGE OR ALTERATION BEING
- 17. IN ORDER TO BE ELIGIBLE FOR CERTIFICATION NECESSARY FOR AN OPERATING PERMIT, THE FOLLOWING SITE OBSERVATIONS ARE REQUIRED BY LOTHROP ASSOCIATES LLP, dba AQUATECTONIC ARCHITECTS (AQT) TO CONFIRM WORKMANSHIP, QUALITY STANDARDS AND CONFORMANCE TO THE APPROVED DRAWINGS.
- A. <u>REQUIRED SITE OBSERVATIONS BY AQT</u>
- # 1: REINFORCED STRUCTURAL OUTER POOL SHELL, MAIN DRAIN DEPRESSION AND EXTERIOR PIPE SUPPORT SHELF AS DESIGNED BY OTHERS (NOTE: PRIOR TO POOL FLOOR & WALL REINFORCING).
- # 2 POOL WALL & FLOOR REINFORCING, EMBEDDED FLOOR & WALL PIPING, FITTING ROUGH INS, MAIN DRAIN SUMPS, CONCRETE GUTTER FORM/REINFORCING. (PRIOR TO THE CONCRETE / SHOTCRETE INSTALLATION)
- & POOL EQUIPMENT ROOM, UTILITY STUBS & SANITARY/STORM CONNECTIONS, SURGE TANK AND POOL EQUIPMENT ROOM SUMP DEPRESSIONS AND FILTRATION SYSTEM EQUIPMENT PIPING. PRESSURE TEST TO BE PREFORMED. (NOTE: PRIOR TO PIPE TRENCH BACKFILL)
- # 4: POOL & GUTTER WATERPROOFING (PRIOR TO FINISH COAT APPLICATION AND FILLING OF THE POOL).
- # 5: POOL GUTTER FLOOD AND OVERFLOW TEST (CONSISTENT GUTTER OVERFLOW AT 1/6" THICK WATER FILM MUST BE OBSERVED).
- # 6: FINAL WALK THROUGH / OBSERVATIONS (PRIOR TO WCDOH'S OPERATING PERMIT INSPECTION).
- REQUIRED SITE INSPECTIONS BY WESTCHESTER DEPARTMENT OF HEALTH (WCDOH)
- POOL FLOOR, WALL & GUTTER REINFORCING.
- ALL PIPING INCLUDING EMBEDDED PIPING IN POOL WALL & FLOOR, ALL EXTERIOR SUPPLY & DRAINAGE PIPING, PIPING TO AND FROM POOL SURGE TANK, EQUIPMENT ROOM AND ALL FILTRATION SYSTEM PIPING.
- POOL SHELL PRIOR TO FILLING OF POOL.
- FINAL WALK THROUGH PRIOR TO DOH OPERATING PERMIT CERTIFICATION.
- **WORKMANSHIP STANDARDS:**
- THE QUALITY AND APPEARANCE OF THE WORK SHALL BE OF HIGH QUALITY AND BE SUBJECT TO AQT'S JUDGEMENT AS TO COMPLIANCE WITH EXCELLENT WORKMANSHIP STANDARDS.
- WORK DEEMED BY AQT AS SUB-STANDARD OR OF SUB-QUALITY WILL NOT BE RECOMMENDED FOR ACCEPTANCE.
- 18. THE ARCHITECT'S SEAL AFFIXED TO THESE DRAWINGS IS LIMITED TO HYDRAULICS, DOH
- COMPLIANCE AND INTERIOR CONCRETE STRUCTURAL ENGINEERING ONLY.
- 19. ALL ELECTRICAL COMPONENTS, WIRING, ETC, ARE SHOWN HEREON TO INDICATE SUGGESTED LOCATIONS ONLY, AS WELL AS DESIGN-INTENT. PRIOR TO CONSTRUCTION, THE ELECTRICAL DESIGN PORTION OF THIS PROJECT SHALL BE PROVIDED BY OTHERS (NOT AQUATECTONIC).
- REQUIRED FIELD OBSERVATIONS ARE TO BE PERFORMED BY AQUATECTONIC (AQT) AND THE GENERAL CONTRACTOR SHALL SUBMIT A FORMAL REQUEST TO AQT WITH AT LEAST 2 WEEK'S NOTICE PRIOR TO EACH VISIT.

SIGNATURE

POOL SIGNAGE NOTES

- SIGN VERBIAGE INDICATED IS THE MINIMUM REQUIRED BY THE DEPARTMENT OF HEALTH AND MAY BE EXPANDED AT THE DISCRETION OF FACILITY.
- SIGNS MUST BE PERMANENT TYPE WITH GRAPHICS COLOR CONTRASTING TO THE FIELD COLOR.
- 2. IT IS ASSUMED THAT THE SIGNS WILL BE DESIGNED TO MATCH THE SIGN PACKAGE USED THROUGHOUT THE BUILDING OR IT MAY BE DEVELOPED SPECIFICALLY
- SIGNS SHOWN ARE GENERIC IN NATURE. REFER TO INTERIOR OR GRAPHICS DESIGN DRAWINGS FOR LAYOUT AND FONT DETAILS.

FOR THE POOL.

- 4. IN ADDITION TO SIGNS SHOWN, PROVIDE SIGNS INDICATING: "MEN'S LOCKER ROOM", "WOMEN'S LOCKER ROOM", "TO POOL", "POOL MECHANICAL ROOM", ETC. AS APPLICABLE.
- 5. SIGNS MUST BE PLACED AT EYE LEVEL AND DESIGNED OF A SUFFICIENT SIZE AND FONT FOR LEGIBILITY.
- 6. A SIGN SHALL BE CONSPICUOUSLY POSTED IN THE POOL AREA STATING:
- a. THE MAXIMUM NUMBER OF BATHERS WHO MAY USE THE POOL AT ONE TIME THE HOURS THAT THE SWIMMING POOL IS OPEN; AND
- THAT THE POOL USE IS PROHIBITED AT ANY OTHER TIME
- 8. SIGNS WITH THE FOLLOWING INFORMATION SHALL BE POSTED CONSPICUOUSLY AT THE SWIMMING POOL OR ENCLOSURE AND IN THE DRESSING ROOMS AND OFFICES OF ALL SWIMMING POOLS
- a. POLLUTION OF SWIMMING POOL PROHIBITED. URINATING, DISCHARGE OF FECAL MATTER, EXPECTORATING OR BLOWING THE NOSE IN ANY SWIMMING POOL IS PROHIBITED.

FACILITY DATA

	LAVATORIES	WATER CLOSETS	URINALS	SHOWERS
UNISEX RESTROOMS — POOL DECK LEVEL	2	4	_	_
UNISEX RESTROOMS — BATHHOUSE LEVEL	2	4	_	_
MEN'S RESTROOMS — BATHHOUSE LEVEL	7	9	6	13
WOMEN'S RESTROOM — BATHHOUSE LEVEL	7	13	_	16

ELECTRICAL NOTE

THE POOL ELECTRICAL SYSTEM SHALL CONFORM TO ARTICLE 680 OF THE NATIONAL ELECTRICAL CODE. - SEE ELECTRICAL DRAWINGS

SWIMMING POOL RULES


- A. ALL PERSONS MUST SHOWER BEFORE ENTERING THE POOL.
- B. A MAXIMUM OF 936 PERSONS PERMITTED WITHIN THE POOL AREA. (POOLS & DECK)
- C. A MAXIMUM OF 757 PERSONS PERMITTED IN THE MAIN POOL AT ANY ONE TIME.
- D. NO REFRESHMENTS ARE ALLOWED ON THE POOL DECK.
- E. SHALLOW WATER. NO DIVING ALLOWED.
- F. PROLONGED AND REPETITIVE BREATH—HOLDING CAN BE DEADLY. NO INTENTIONAL HYPERVENTILATION OR COMPETITIVE BREATH-HOLDING IS PERMITTED.
- G. POLLUTION OF SWIMMING POOL PROHIBITED. URINATING, DISCHARGE OF FECAL MATTER, EXPECTORATING OR BLOWING THE NOSE IN THE SWIMMING POOL IS PROHIBITED. CHILDREN'S DIAPERS SHALL BE FULLY ENCLOSED WITH IMPERVIOUS MATERIAL SO THAT LIQUID AND SOLID WASTE ARE CONTAINED THEREIN AND DO NOT CONTAMINATE THE POOL
- H. NO PERSON HAVING ANY CONTAGIOUS DISEASE OR INFECTIOUS CONDITION SUCH AS SORES OR INFLAMED EYES, A COLD, NASAL OR EAR DISCHARGE, CUTS, BOILS, OR OTHER EVIDENT SKIN OR OTHER BODILY INFECTION SHALL ENTER THE POOL.
- . NO PERSON UNDER THE INFLUENCE OF ALCOHOL OR EXHIBITING ERRATIC BEHAVIOR SHALL ENTER THE POOL OR THE POOL DECK.
- J. NO ONE IS PERMITTED IN THE POOL WHEN A LIFEGUARD IS NOT AT THE POOL SIDE.
- K. PETS ARE NOT PERMITTED IN THE POOL AREA.
- . EMERGENCY TELEPHONE NUMBER FOR POLICE, FIRE AND HOSPITAL IS 911.
- M. SWIMMING IS PROHIBITED WHEN LIGHTNING IS PRESENT INCLUDING A 30-MINUTE PERIOD AFTER THUNDER OR LIGHTNING WERE LAST OBSERVED.

NOTE: THE FOLLOWING SHALL BE POSTED CONSPICUOUSLY AT THE SWIMMING POOL OR ENCLOSURE AND IN THE DRESSING ROOMS AND OFFICES OF THE SWIMMING POOL.

FACILITY NOTES

SHOWERS SHALL BE SUPPLIED WITH WATER AT A TEMPERATURE OF AT LEAST 90° F AND NO MORE THEN 110°F AT A RATE OF AT LEAST 1.5 GPM PER SHOWER HEAD. THERMOSTATIC, TEMPERING OR MIXING VALVES SHALL BE KEPT IN GOOD OPERATION TO PREVENT SCALDING OF THE USERS.

LOCKER ROOMS, TOILETS, SHOWER AREA WALLS AND TOILET/SHOWER PARTITION WALLS TO TO HAVE SMOOTH, IMPERVIOUS FINISH AS FOLLOWS:

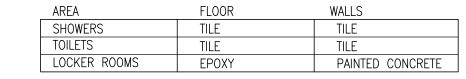

- LIQUID SOAP DISPENSERS SHALL BE PROVIDED AT EACH LAVATORY AND IN ALL SHOWERS. GLASS DISPENSERS ARE <u>NOT</u> PERMITTED.
- DRESSING ROOMS, MECHANICAL EQUIPMENT ROOMS, STORAGE AREAS, SHOWER ROOMS, AND LAVATORIES SHALL BE VENTILATED PURSUANT TO APPLICABLE CODES OR ANY SUCCESSOR LAW OR
- BASE AT FLOOR-WALL JUNCTURE IN SHOWER & TOILET ROOMS SHALL BE COVED.
- FLOORS SHALL BE SLOPED 1/4" PER FOOT TO DECK DRAINS IN POOL AREA, SHOWER AND TOILET AREAS. FLOORS SHALL BE SLIP-RESISTANT WITH A DCOF OF 0.42 MINIMUM IN ACCORDANCE WITH ANSI A137.1-2017.
- CARPETING SHALL NOT BE PERMITTED IN TOILET AREAS.
- HOSE BIBS WITH VACUUM BREAKER SHALL BE PROVIDED IN EACH BATHHOUSE AND IN POOL AREA LOCATED TO PERMIT THE ENTIRE AREA TO BE FLUSHED WITH A 50 FT. HOSE.
- PAPER TOWELS OR ELECTRIC HAND DRYERS AND A COVERED WASTE RECEPTACLE SHALL BE PROVIDED IN EACH TOILET ROOM.
- A TELEPHONE SHALL BE PROVIDED WITHIN THE POOL ENCLOSURE FOR EMERGENCY COMMUNICATIONS IN THE BATHING ESTABLISHMENT. THE TELEPHONE NUMBERS OF LOCAL POLICE, EMERGENCY MEDICAL SERVICES, NEAREST HOSPITAL, FIRE DEPARTMENT, AND POISON CONTROL CENTER SHALL BE POSTED IN A CONSPICUOUS PLACE NEAR THE TELEPHONE. THE NAME, ADDRESS AND TELEPHONE NUMBER OF THE ESTABLISHMENT SHALL BE LISTED BY THE TELEPHONE.

MAINTENANCE & SAFETY EQUIPMENT SCHEDULE

QTY.	DESCRIPTION (FURNISHED BY POOL CONTRACTOR)
1	PORTABLE VACUUM: TO BE POLARIS NO. 9550 SPORT WITH 7 DAY PROGRAMMABLE TIMER, 70'-0" CABLE LENGTH AND FOUR WHEEL DRIVE TECHNOLOGY.
2	FLOOR BRUSH: W/16'-0" LONG 2 PC. TELESCOPIC POLE
2	LEAF SKIMMER: W/16'-0" LONG 2 PC. TELESCOPIC POLE
4	RESCUE TUBES: W/ 6'-0" OF 3/8" DIA. LINE & MOUNTING HARDWARE
4	SHEPHERD'S CROOK: MIN. 15'-0" LONG POLE & MOUNTING HARDWARE
1	FIRST AID KIT: AMERICAN NATIONAL RED CROSS, STANDARD 24 UNIT KIT W/ ADULT & CHILD SIZED CPR FACE MASK & 2 PR. LATEX GLOVES
15	POOL ALARM: POOLGUARD MODEL #PGRM—SB, BATTERY POWERED. ASTM F—2208 COMPLIANT W/ REMOTE RECEIVER & HORN.
1	SPINEBOARD: 78"x20" MARINE PLYWOOD BOARD W/ RUNNERS, FURN. COMPLETE W/ NYLON STRAPS, HEAD IMMOBILIZER & VELCRO STRIPS. C.J. AQUATICS PRO-WOOD 1000 COMPLETE RESCUE KIT
2	WOOL BLANKET
1	TEST KIT: TAYLOR TECHNOLOGIES PROFESSIONAL POOL TEST KIT MODEL K-2005 OR EQUAL WITH 0.5 TO 5 P.P.M. CHLORINE RANGE IN THE FOLLOWING INCREMENTS: 0.2, 0.4, 0.6, 0.8, 1.0, 1.5, 2.0, 3.0, PH RANGE FROM 7.0 TO 8.0, TOTAL BROMINE 1.0 TO 2.0 PPM, CALCIUM HARDNESS, AND TOTAL ALKALINITY

NOTE: POOL CONTRACTOR SHALL FURNISH GOGGLES, APRONS AND

RUBBER GLOVES FOR HANDLING CHEMICALS. (2 SETS OF EACH ITEM)


HOURS OF OPERATION COORDINATE TIMES POOL SUNDAY WITH MANAGEMENT MONDAY EMERGENCY STOP TUESDAY WEDNESDAY INSTALL ABOVE EMERGENCY THURSDAY _____ STOP BUTTON FRIDAY SATURDAY POOL USE PROHIBITED AT ANY OTHER TIME NOTE: DIMENSIONS SHOWN ARE SUGGESTED VALUES HOURS OF OPERATION SIGN UNLESS NOTED OTHERWISE

SIGNAGE REQUIREMENTS SCALE

AQUATECTONIC Lothrop Associates LLP

333 WESTCHESTER AVENUE WHITE PLAINS, NEW YORK 10604 TEL.: (914) 741-1115



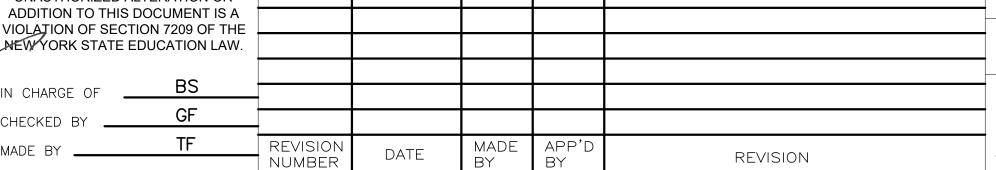

RECORD DRAWING CERTIFICATION AS BUILT — CHANGES AS NOTED AS BUILT - NO CHANGES

CONTRACTOR PROJECT COORDINATOR SIGNATURE DATE ____ __ DATE __

WESTCHESTER COUNTY, NEW YORK DEPARTMENT OF PUBLIC WORKS & TRANSPORTATION DIVISION OF ENGINEERING

REHABILITATION OF POOL AND BATHHOUSE PLAYLAND PARK, RYE, NEW YORK BATHHOUSE LEVEL FACILITY PLAN, SIGNAGE REQUIREMENTS AND GENERAL NOTES

SHEET NO. 182 OF 201 DPW FILE NO.

CONTRACT


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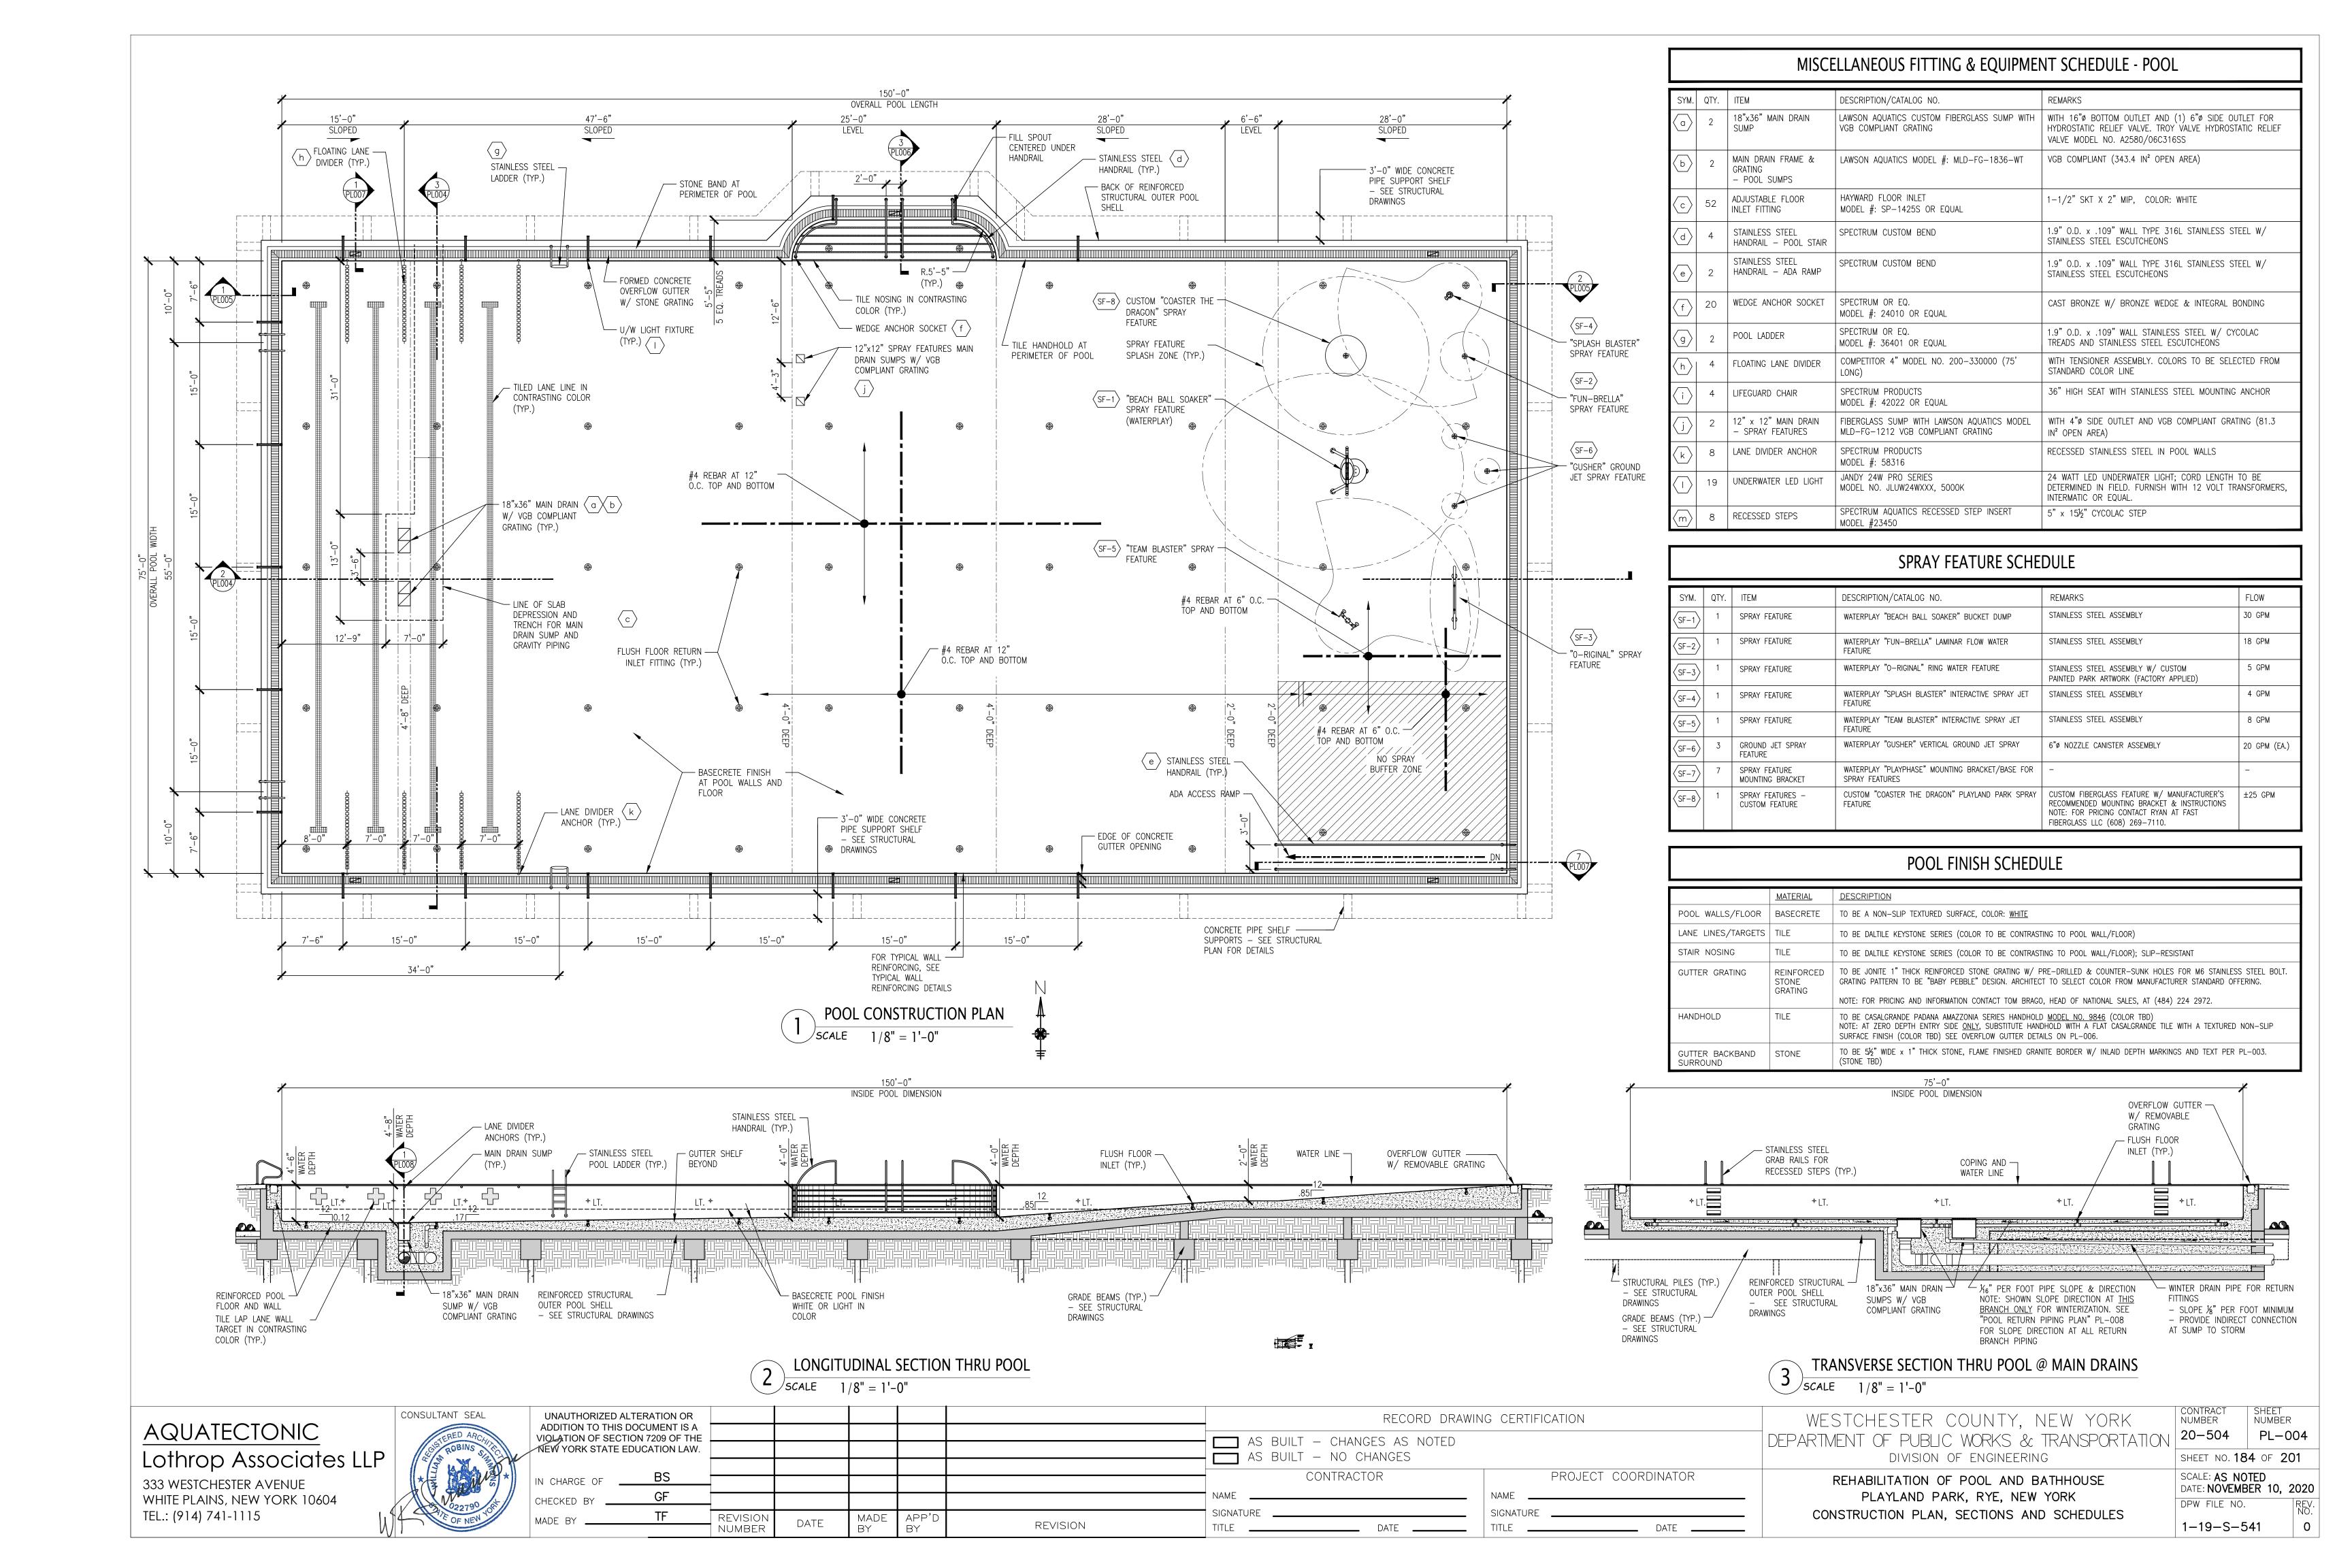
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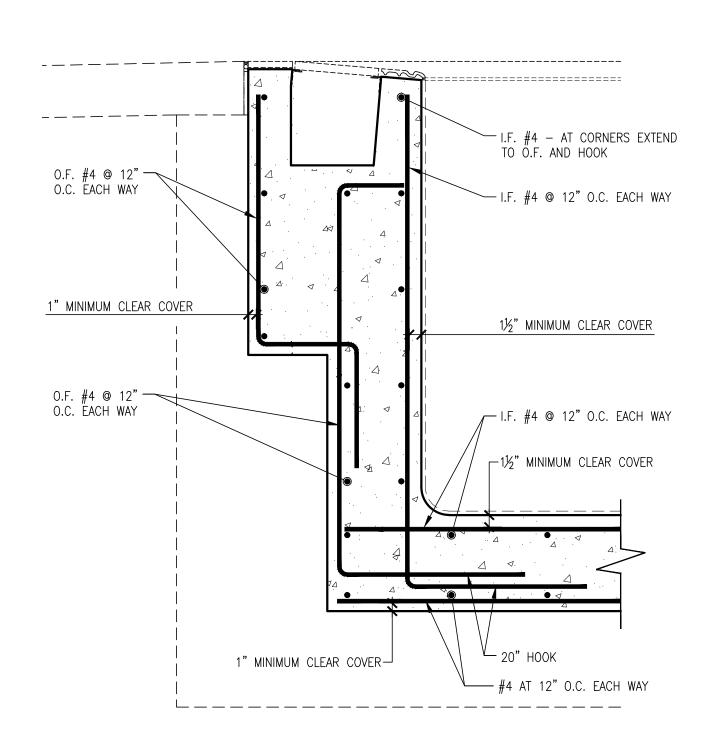
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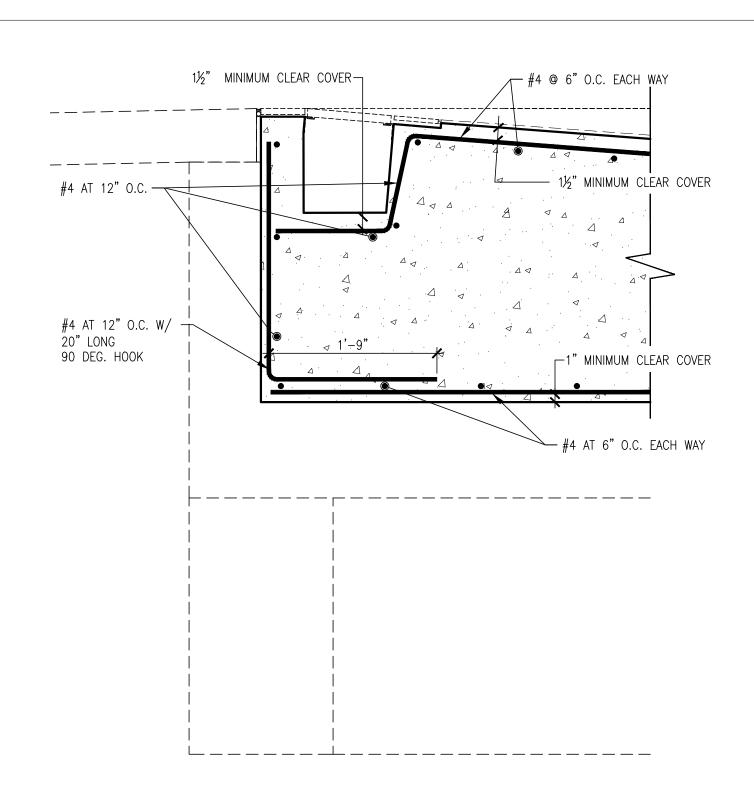
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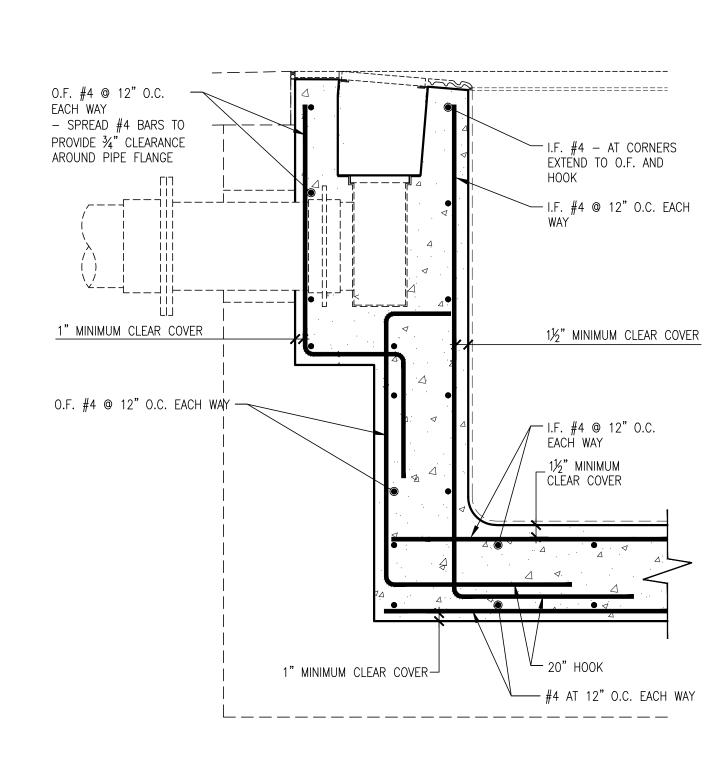












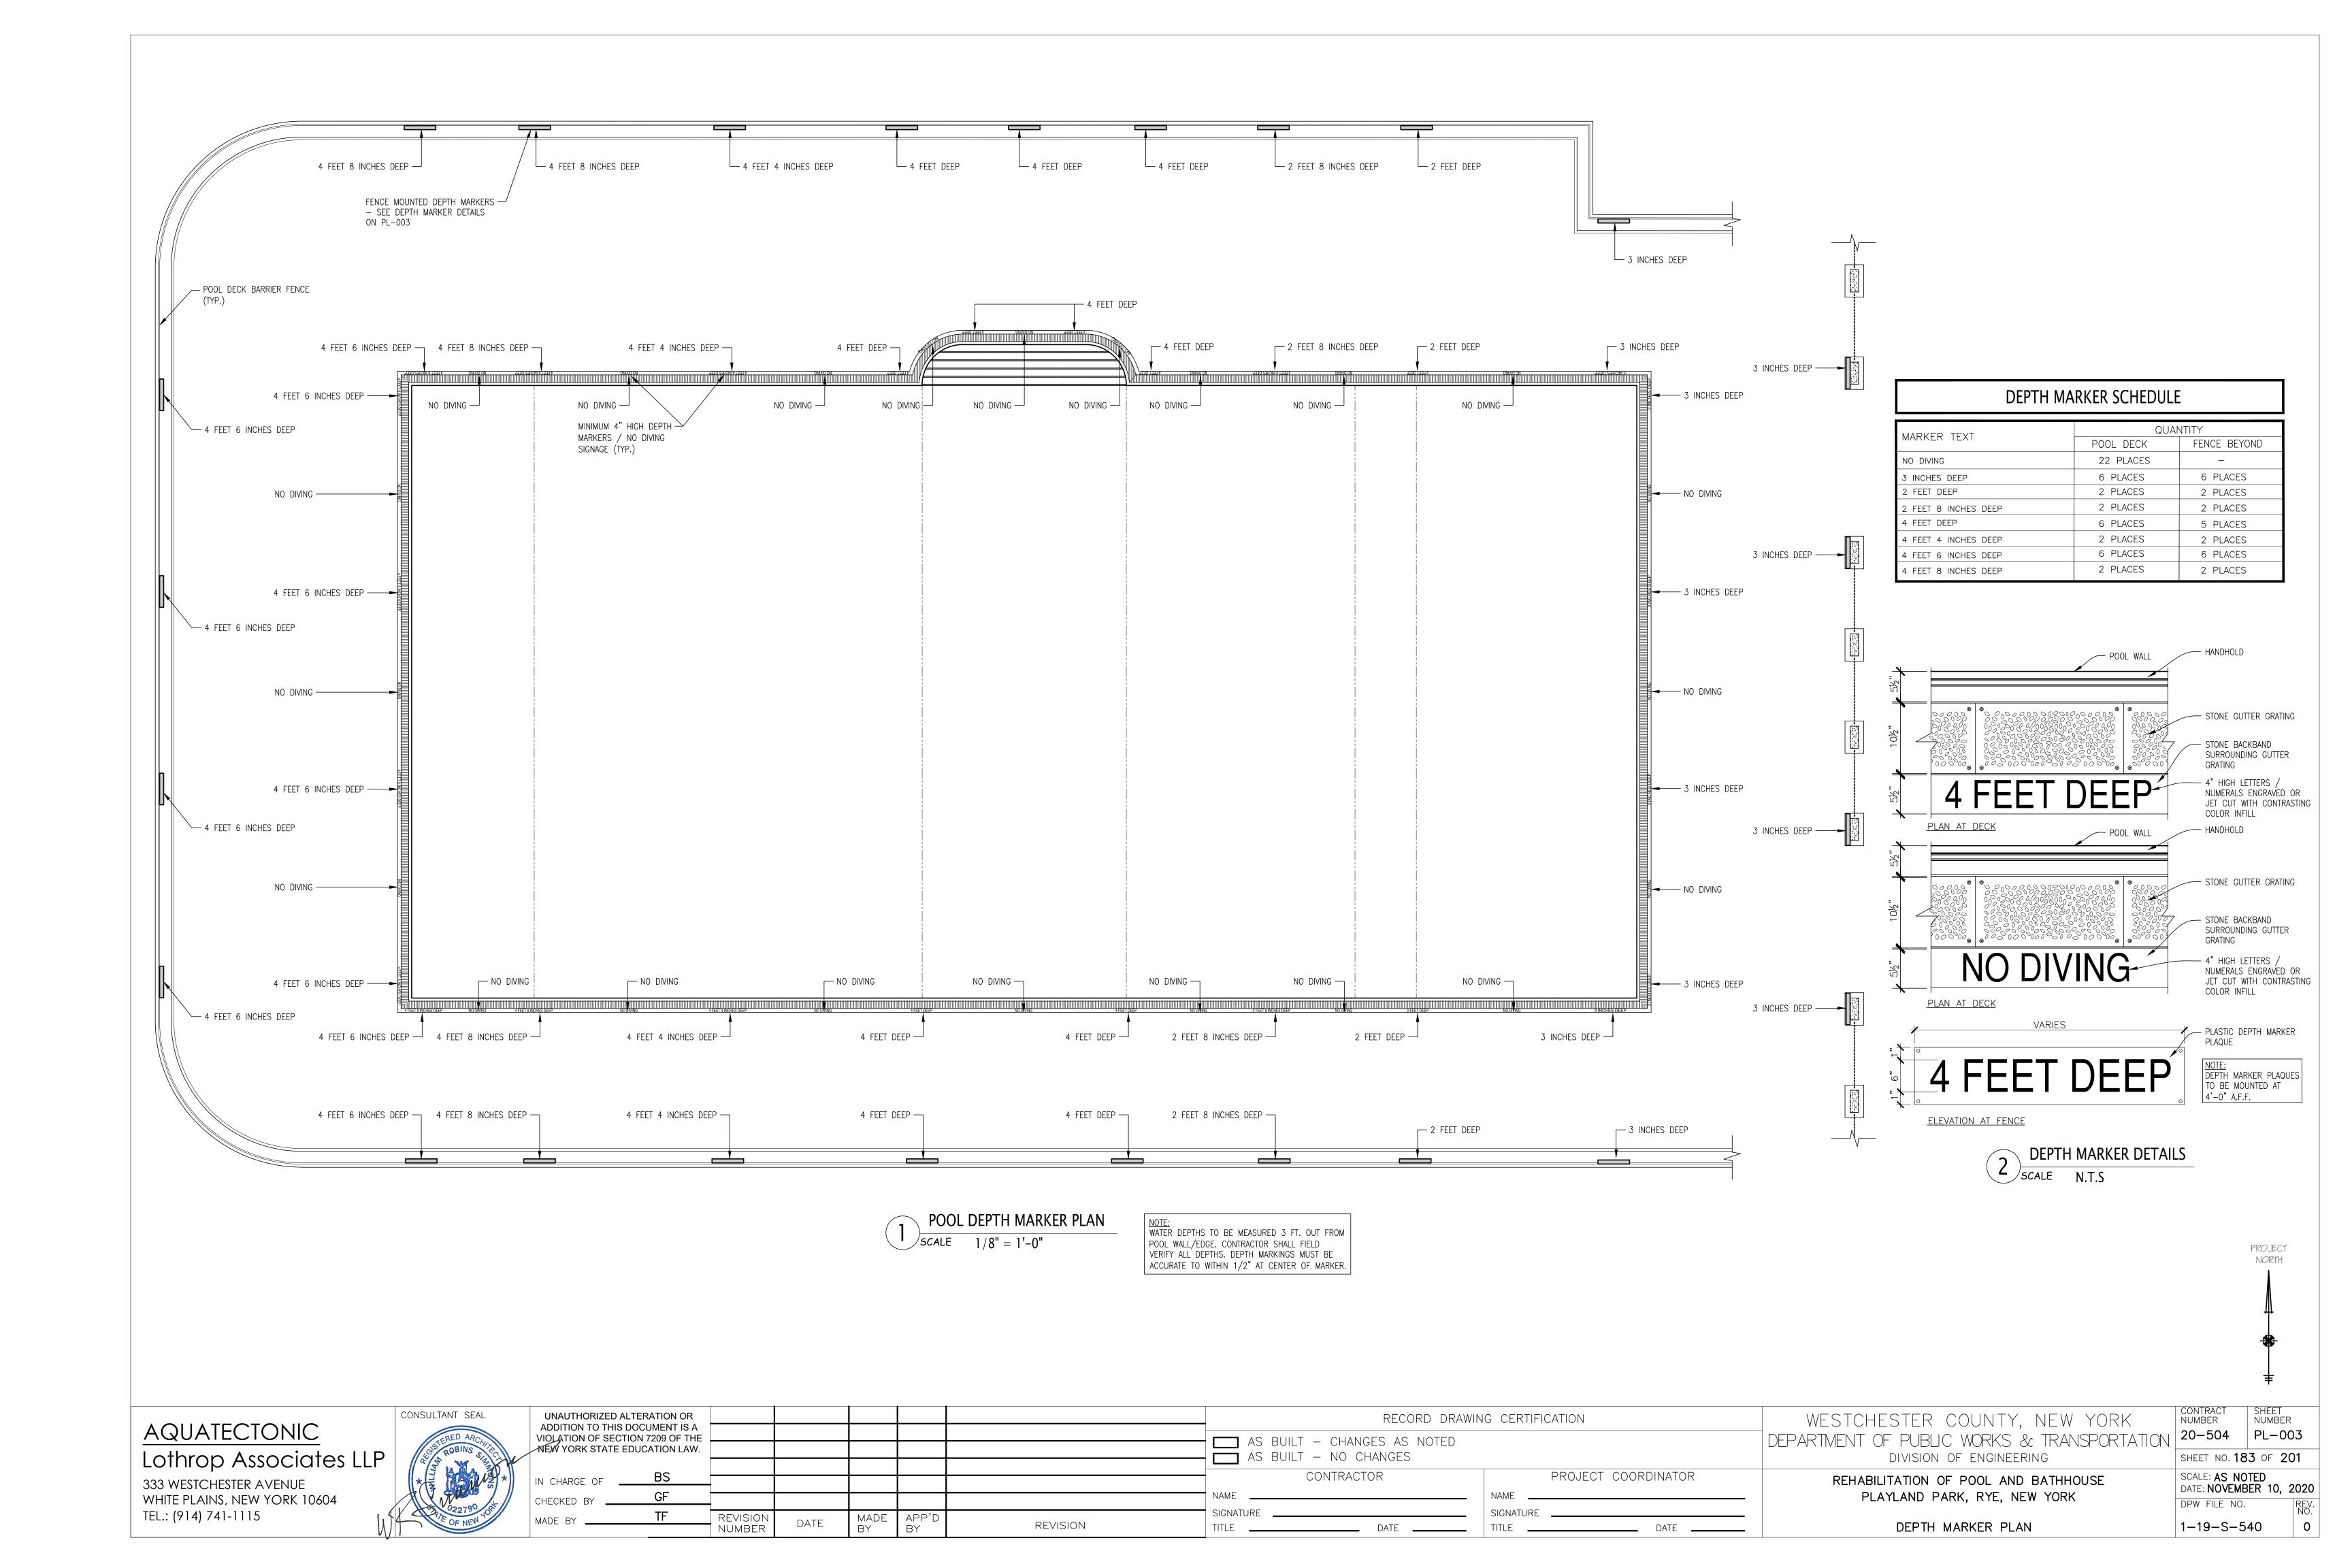

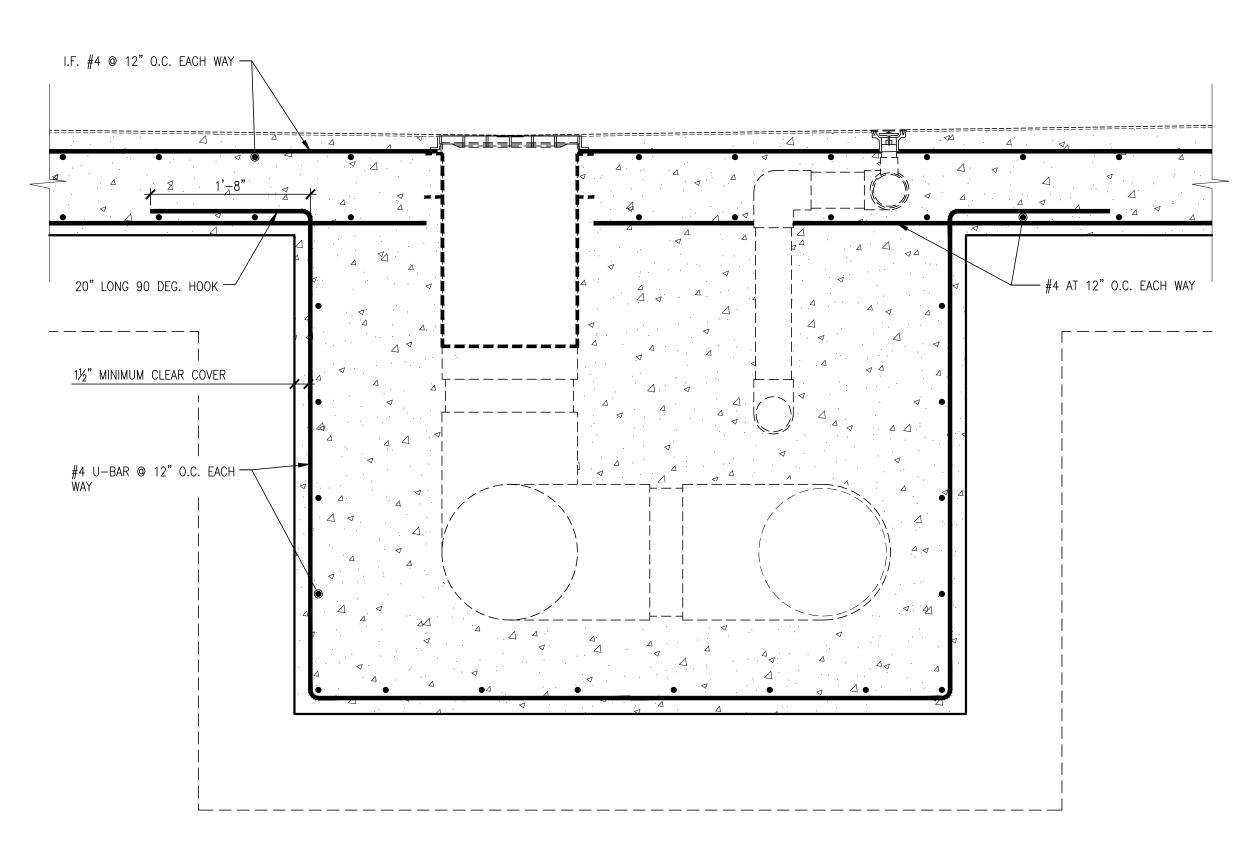

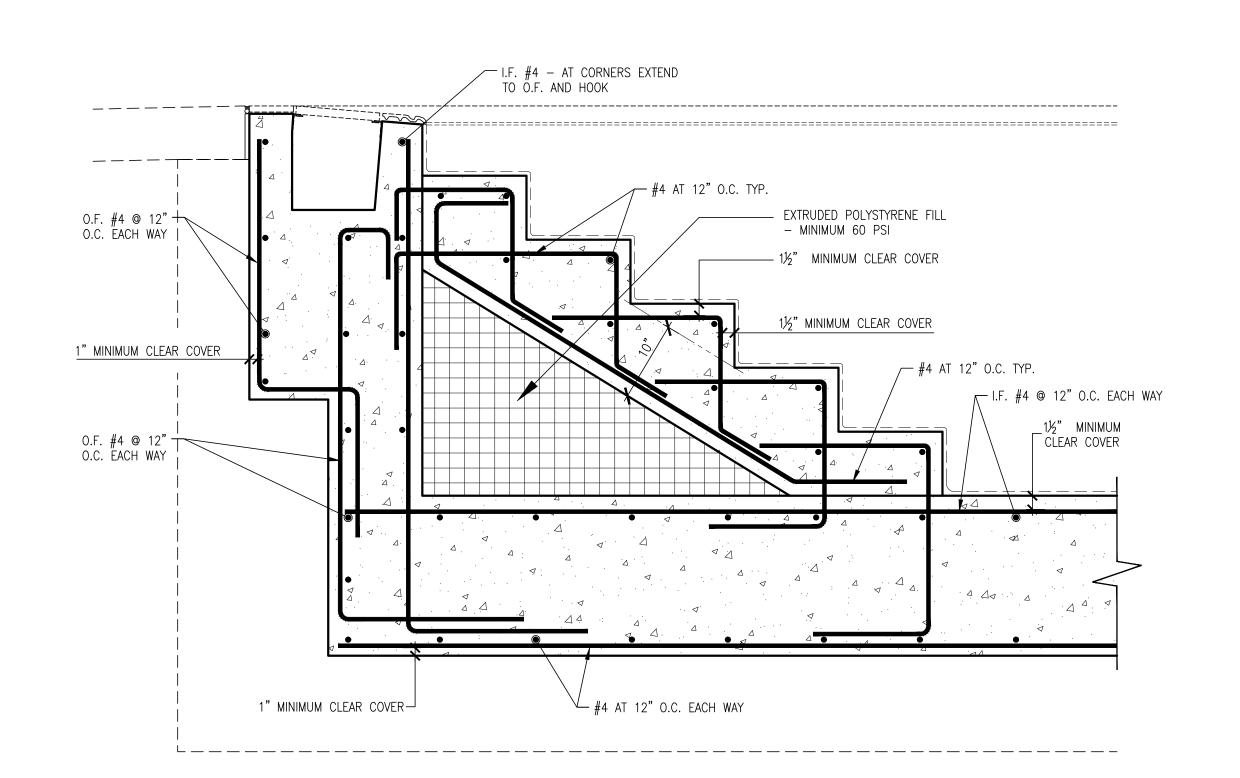

<u>AQUATECTONIC</u> Lothrop Associates LLP 333 WESTCHESTER AVENUE WHITE PLAINS, NEW YORK 10604

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WESTCHESTER COUNTY, NEW YORK DEPARTMENT OF PUBLIC WORKS & TRANSPORTATION	CONTRACT NUMBER 20-504
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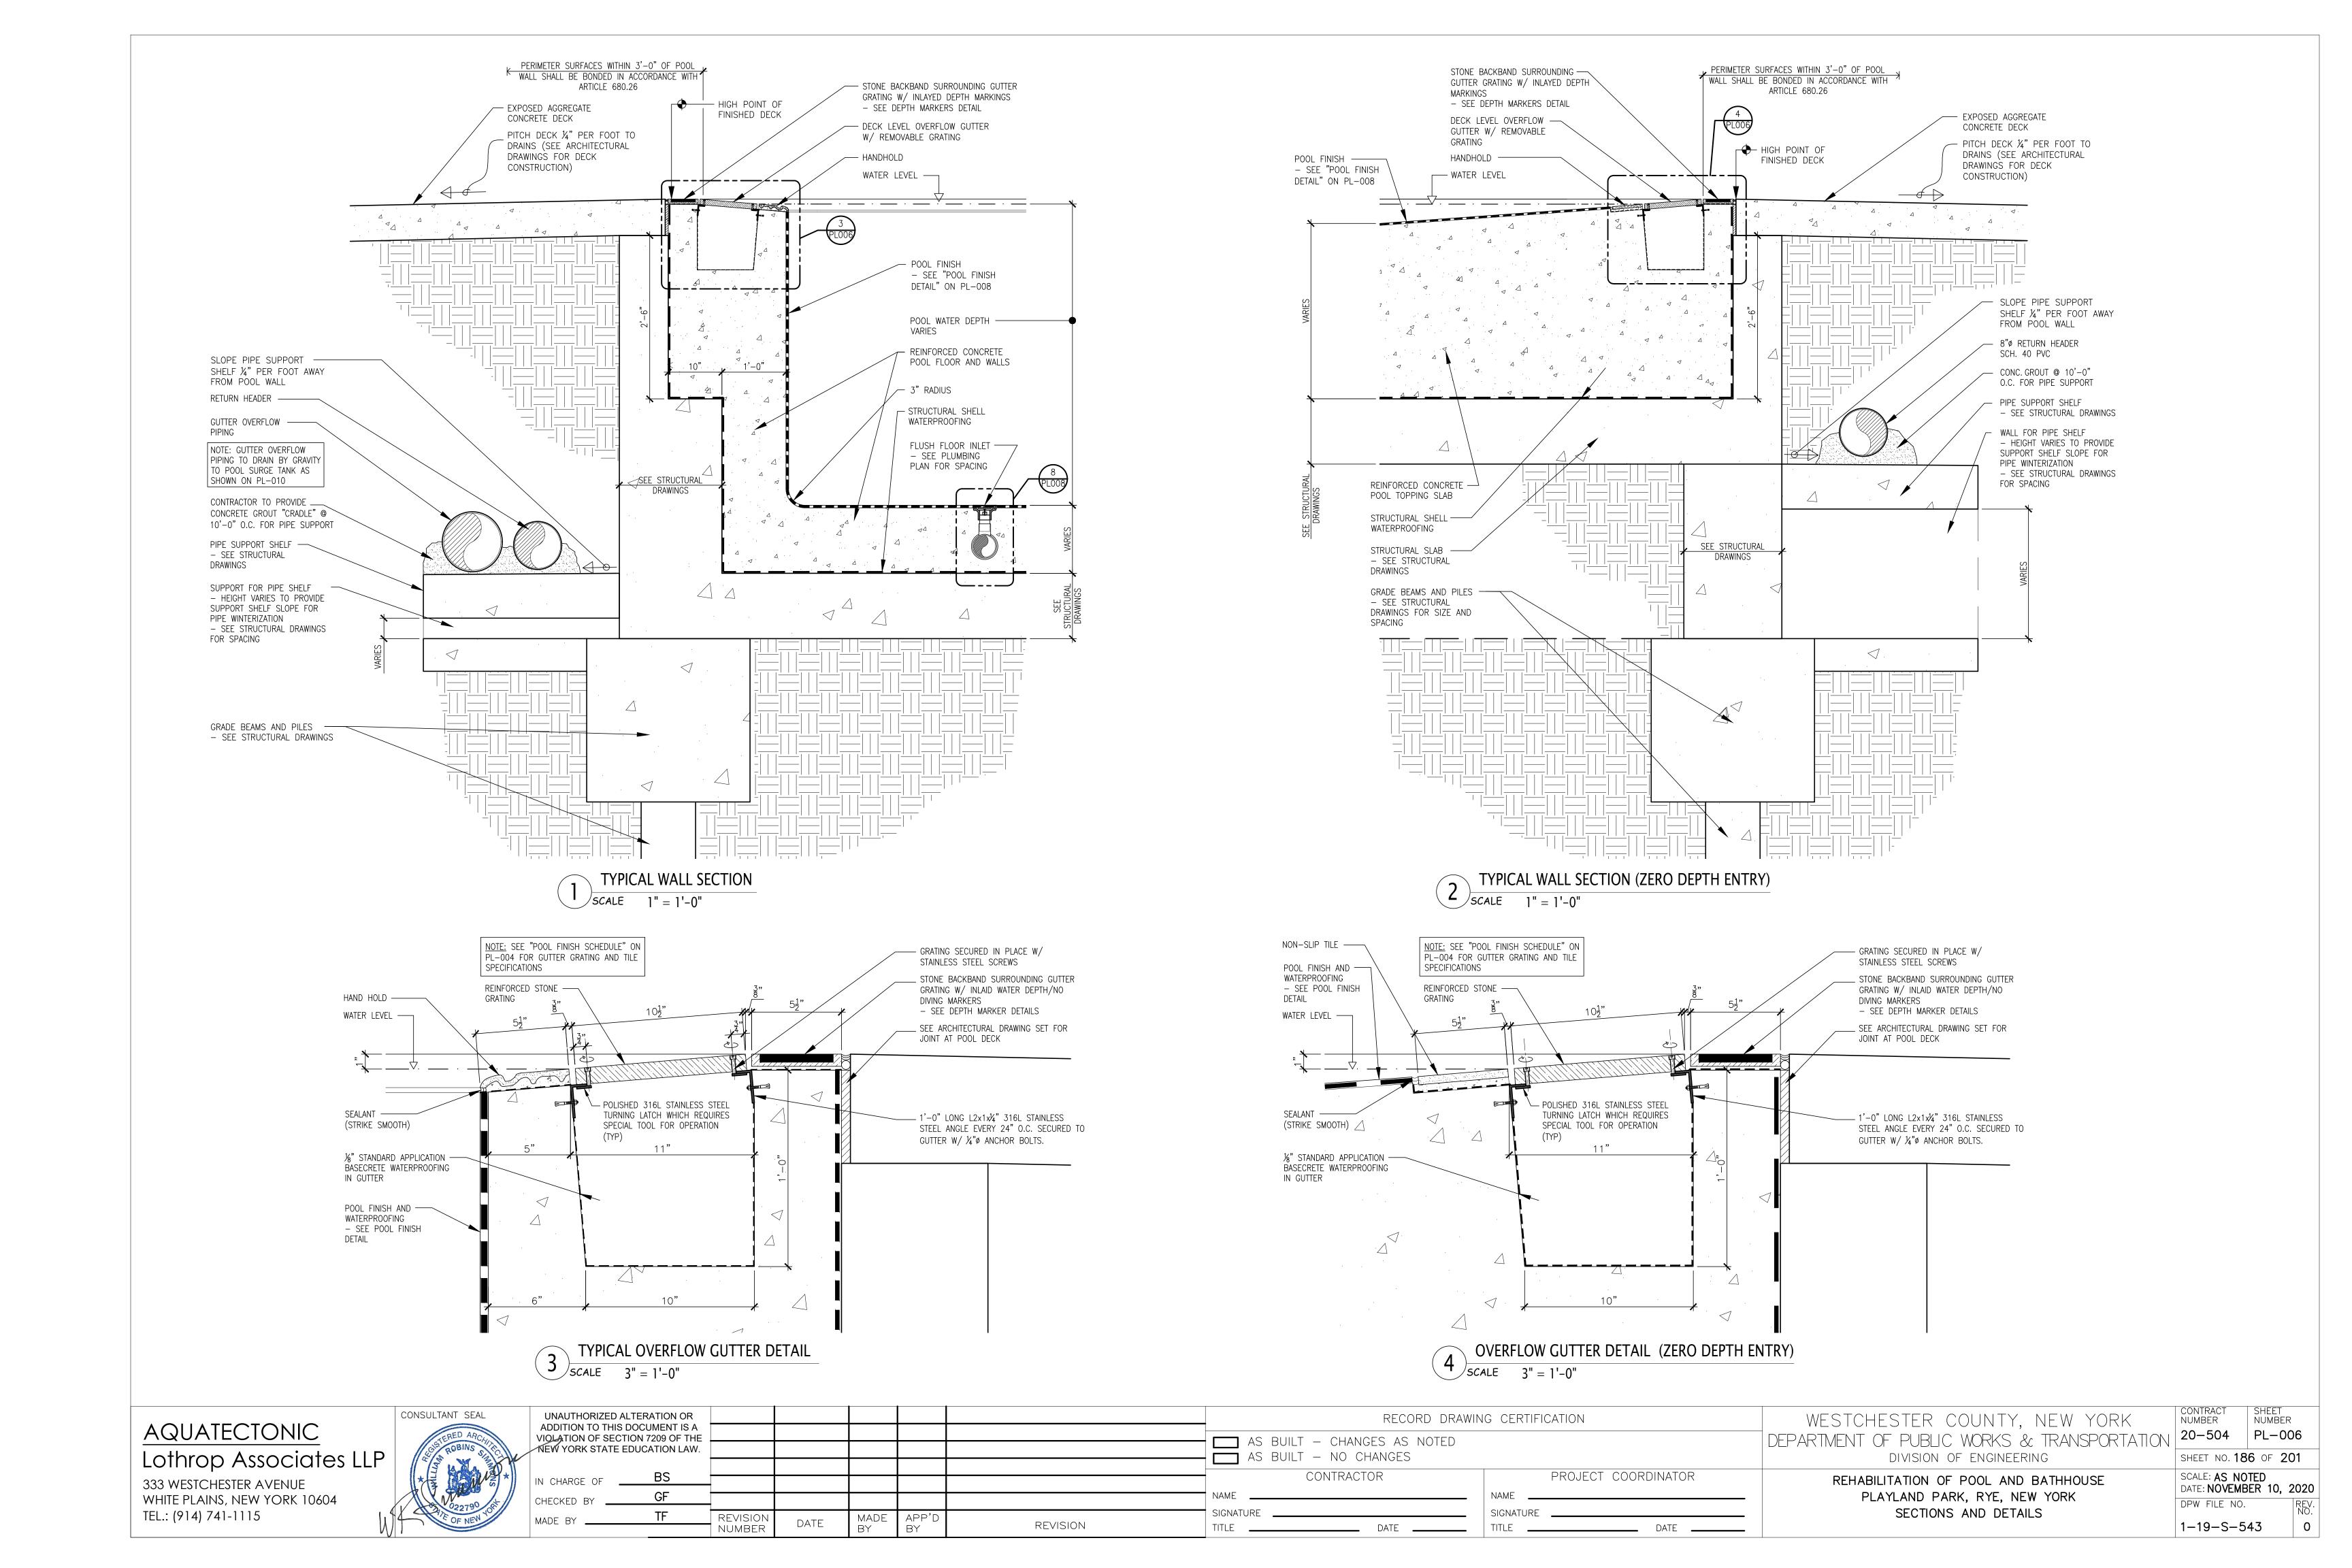
PLAYLAND PARK, RYE, NEW YORK


POOL REINFORCING DETAILS


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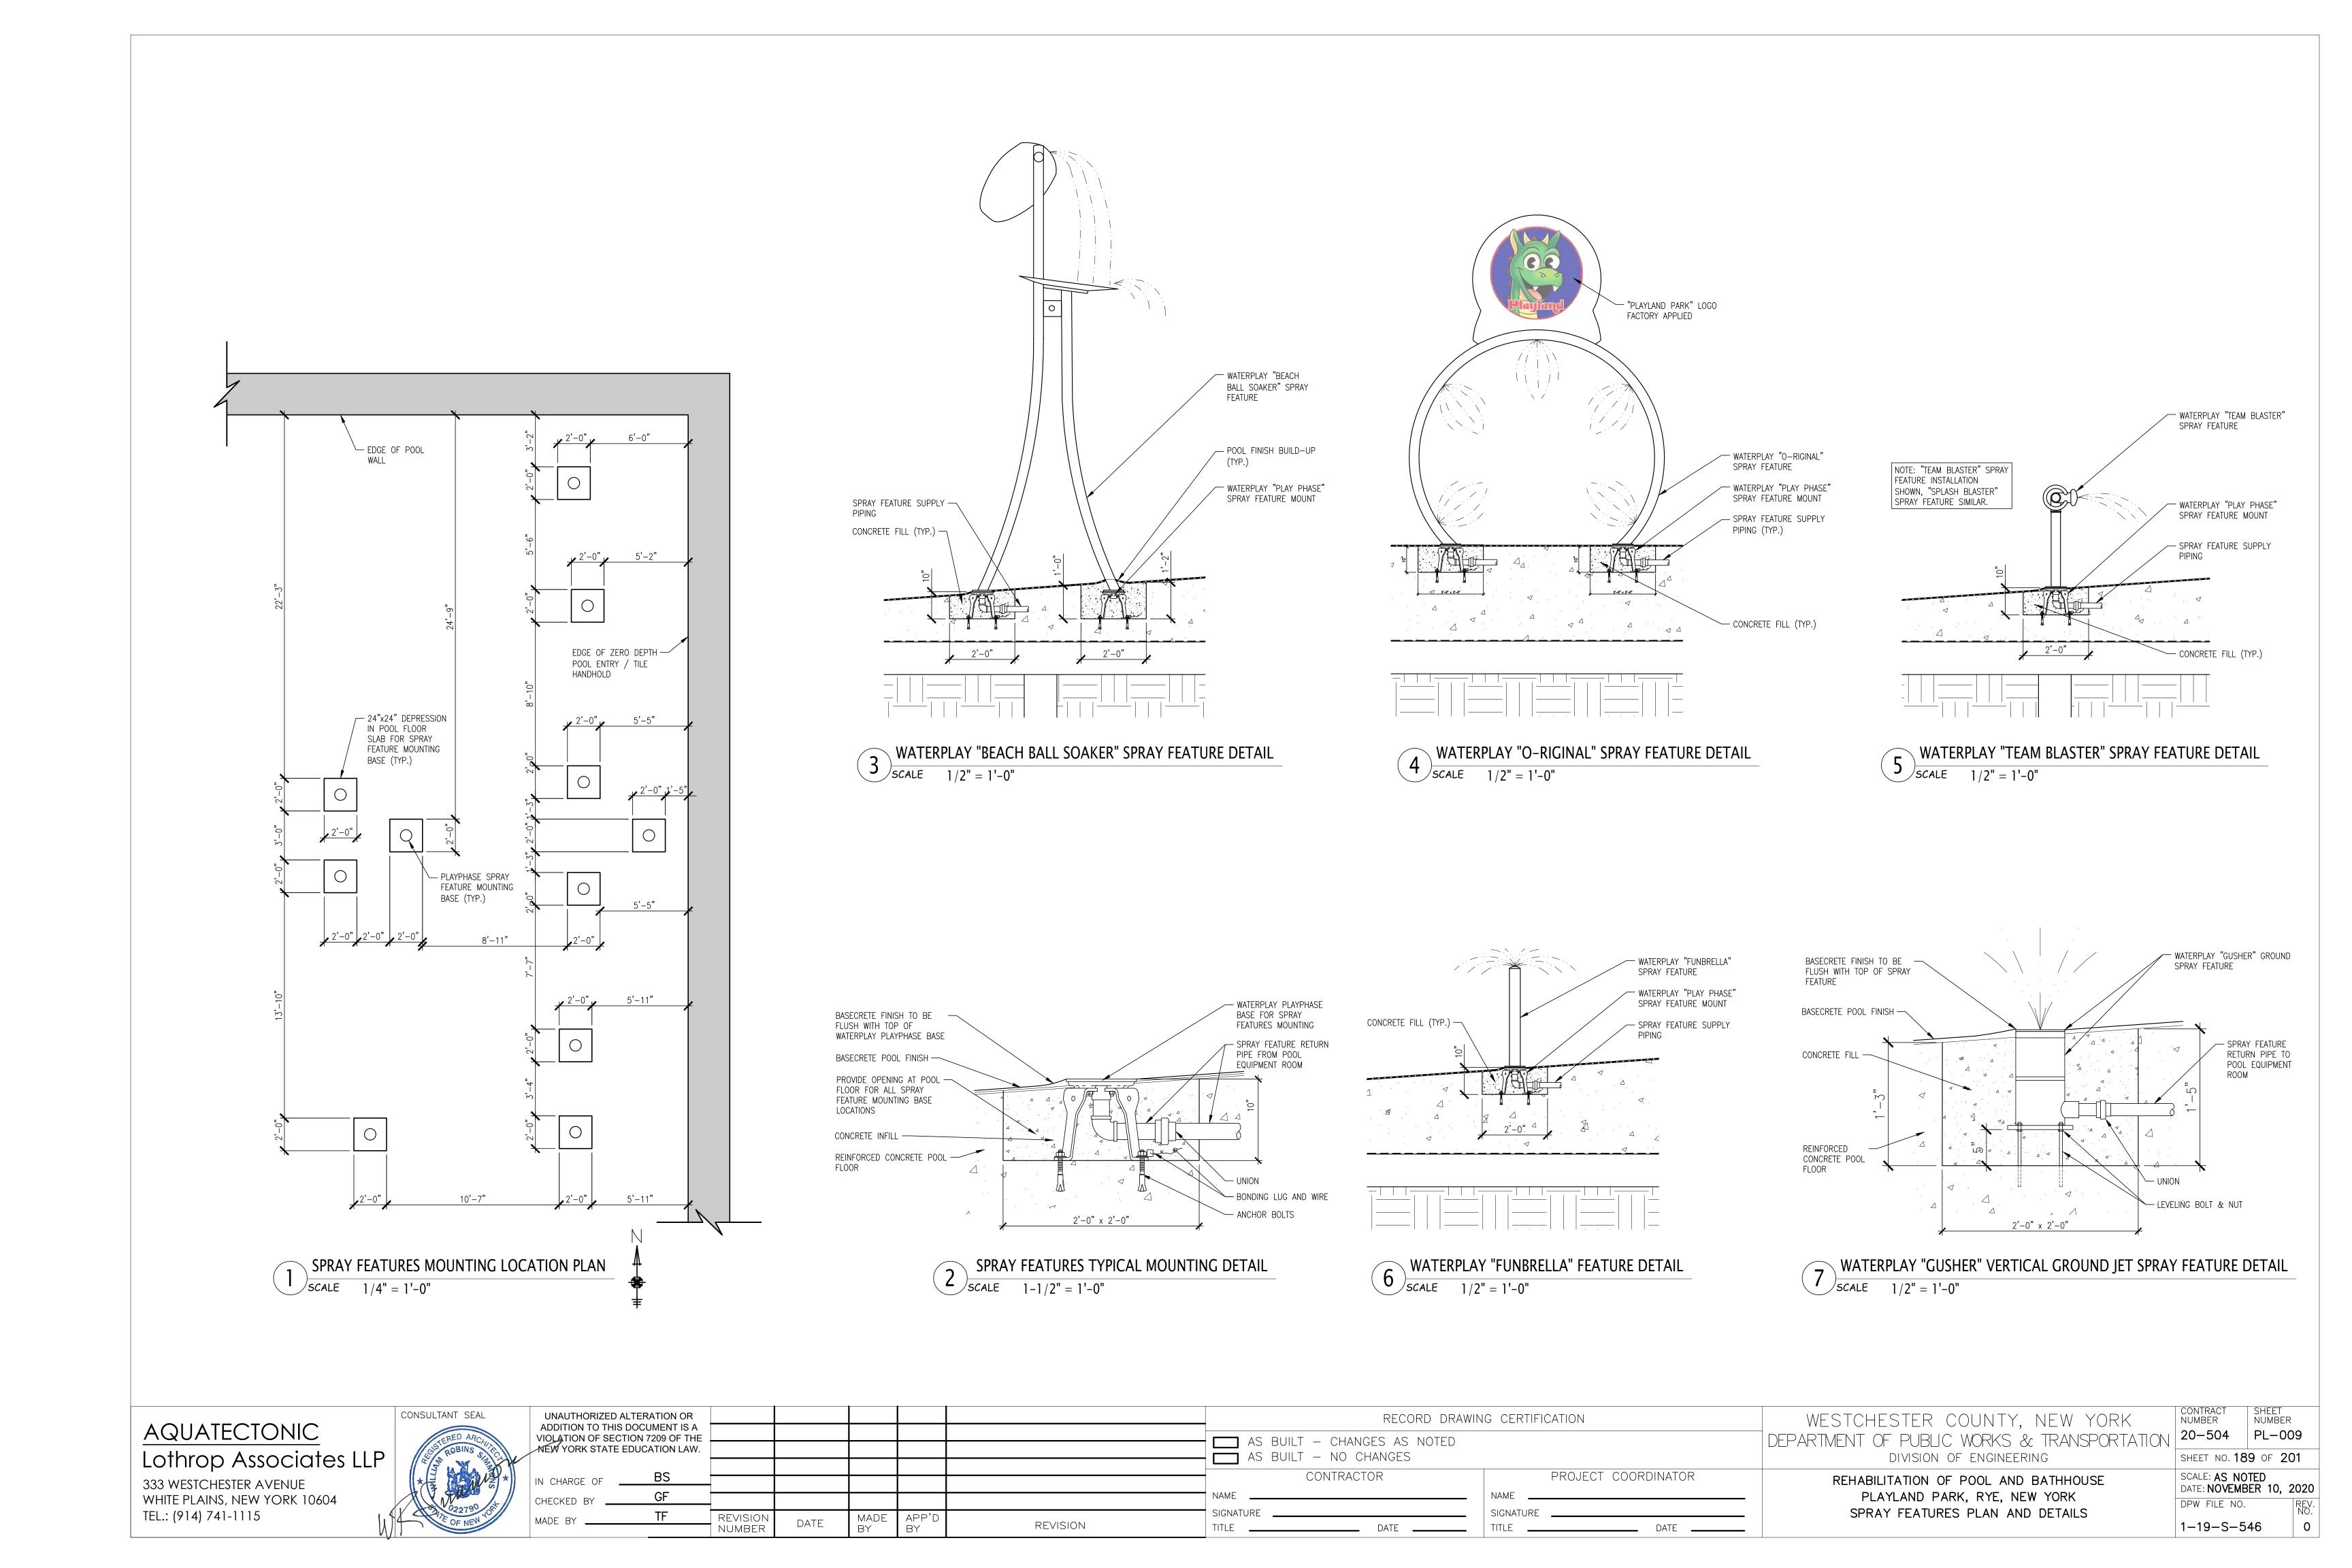
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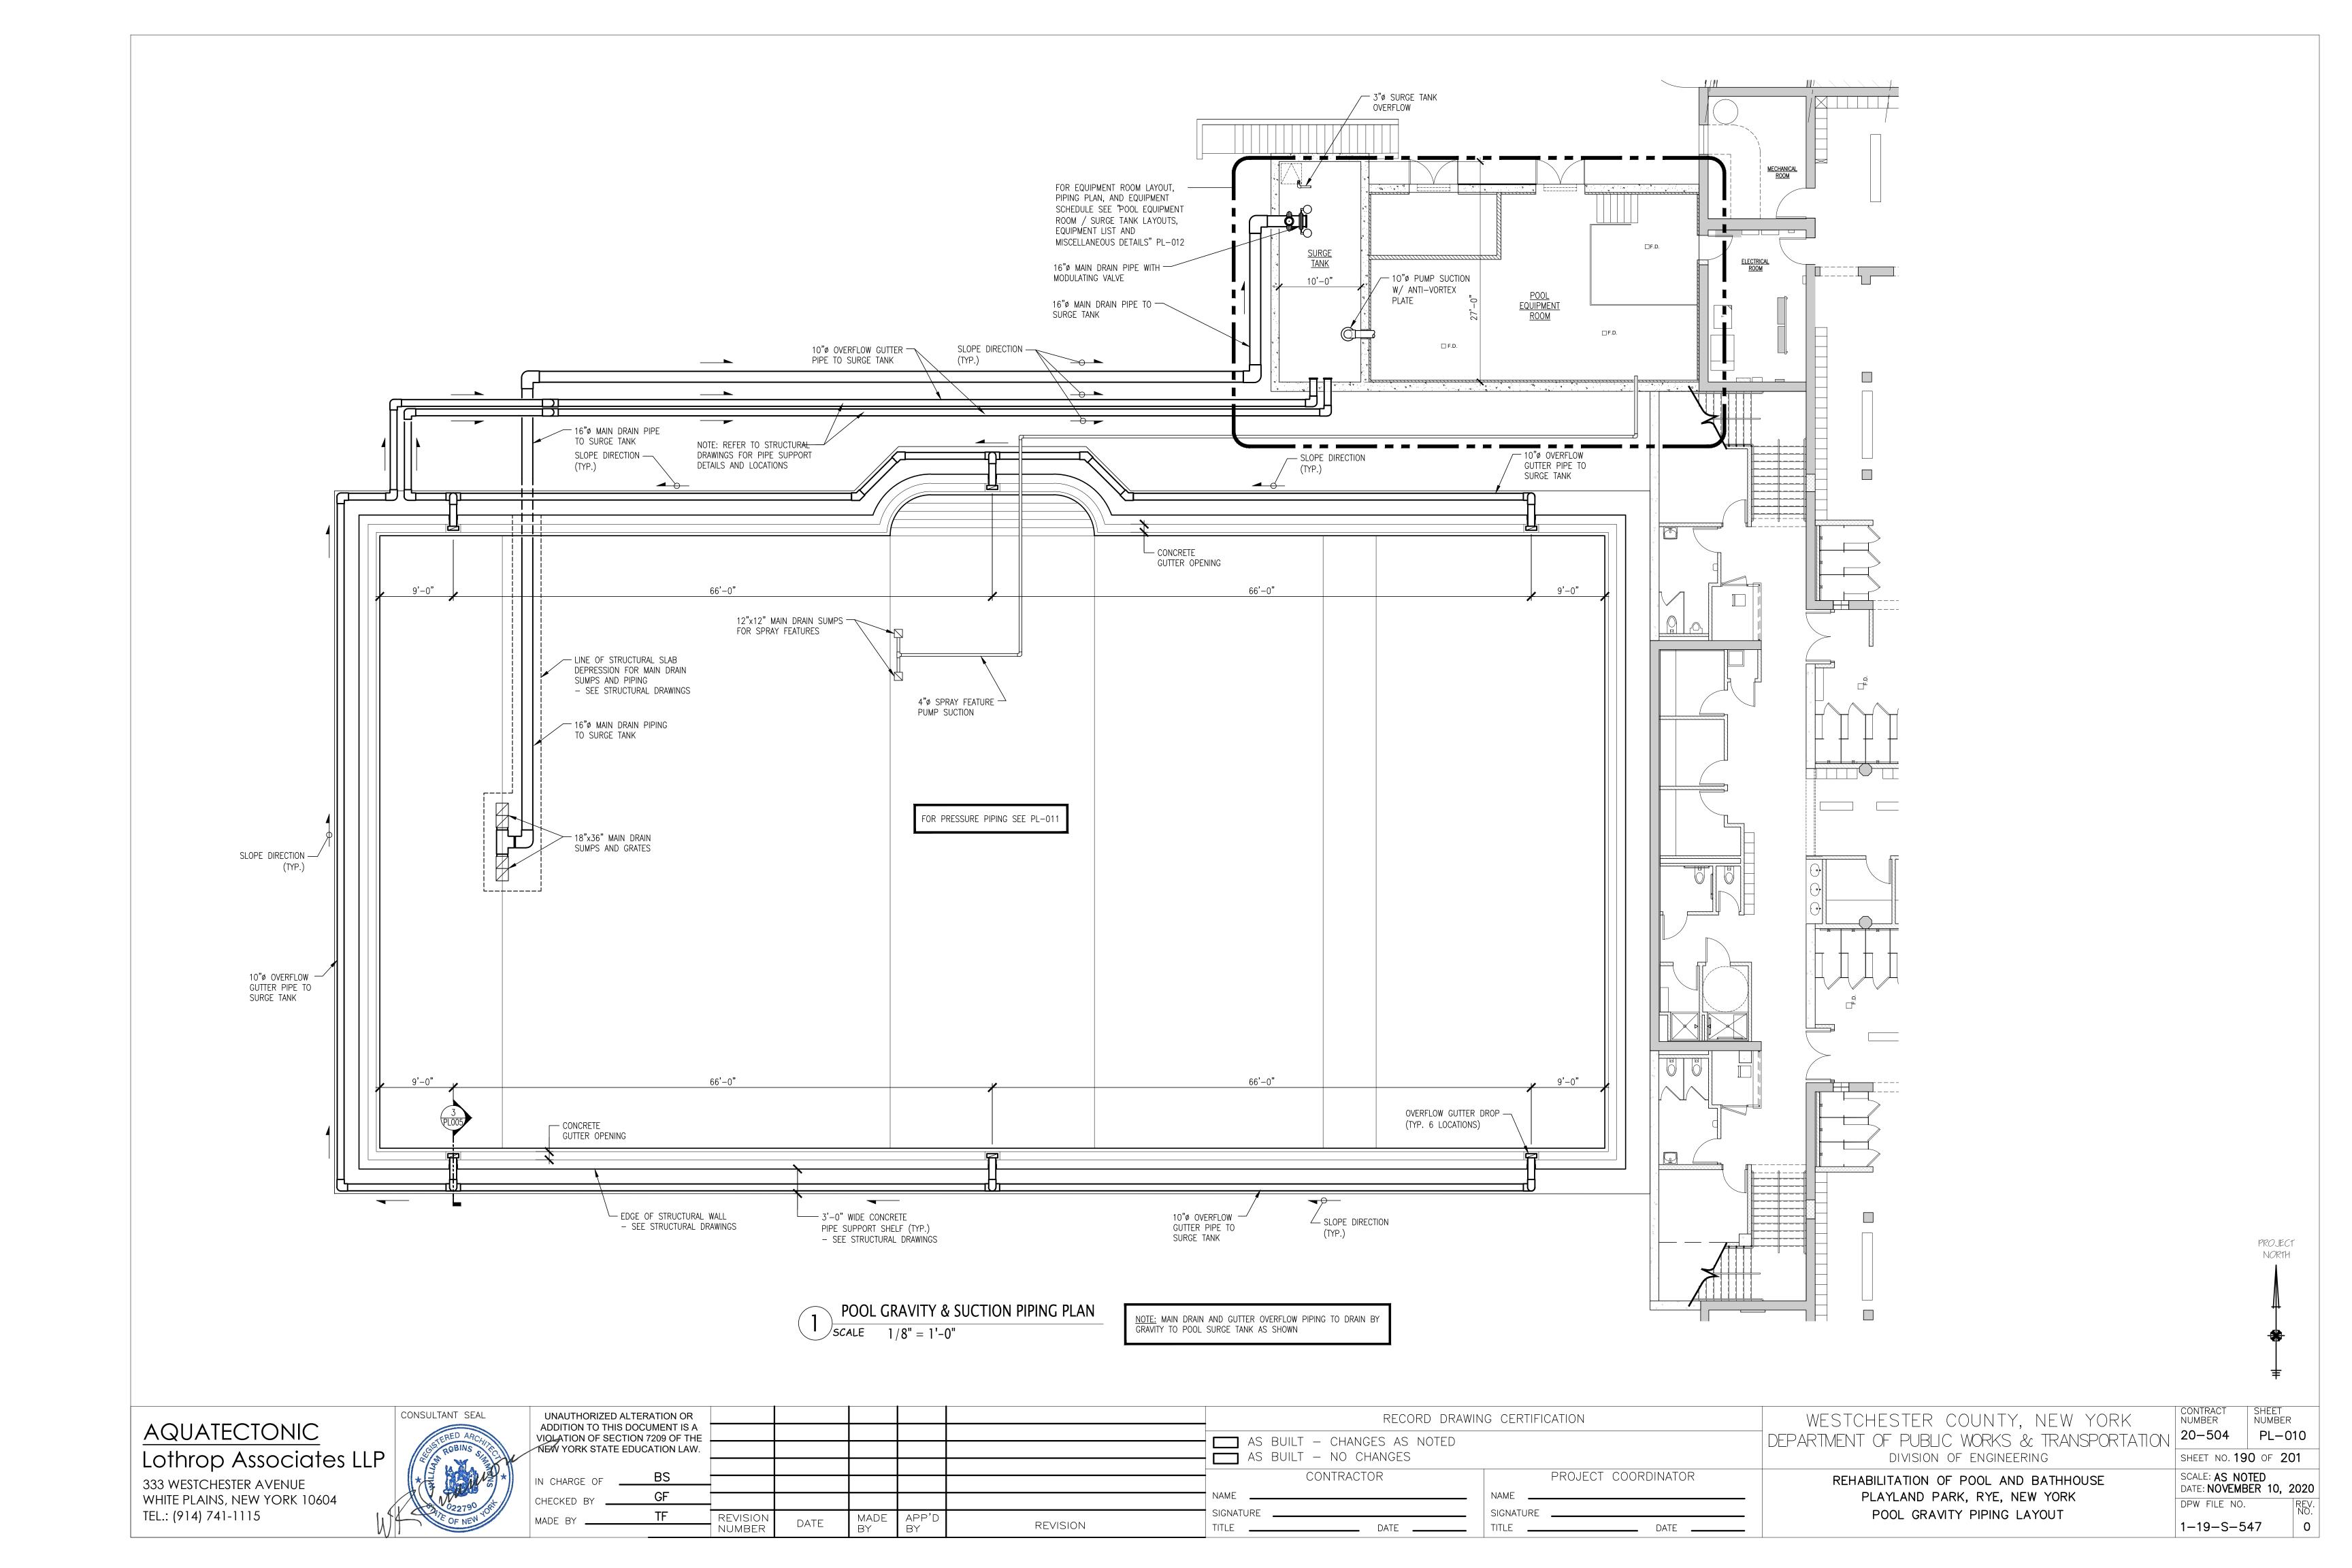
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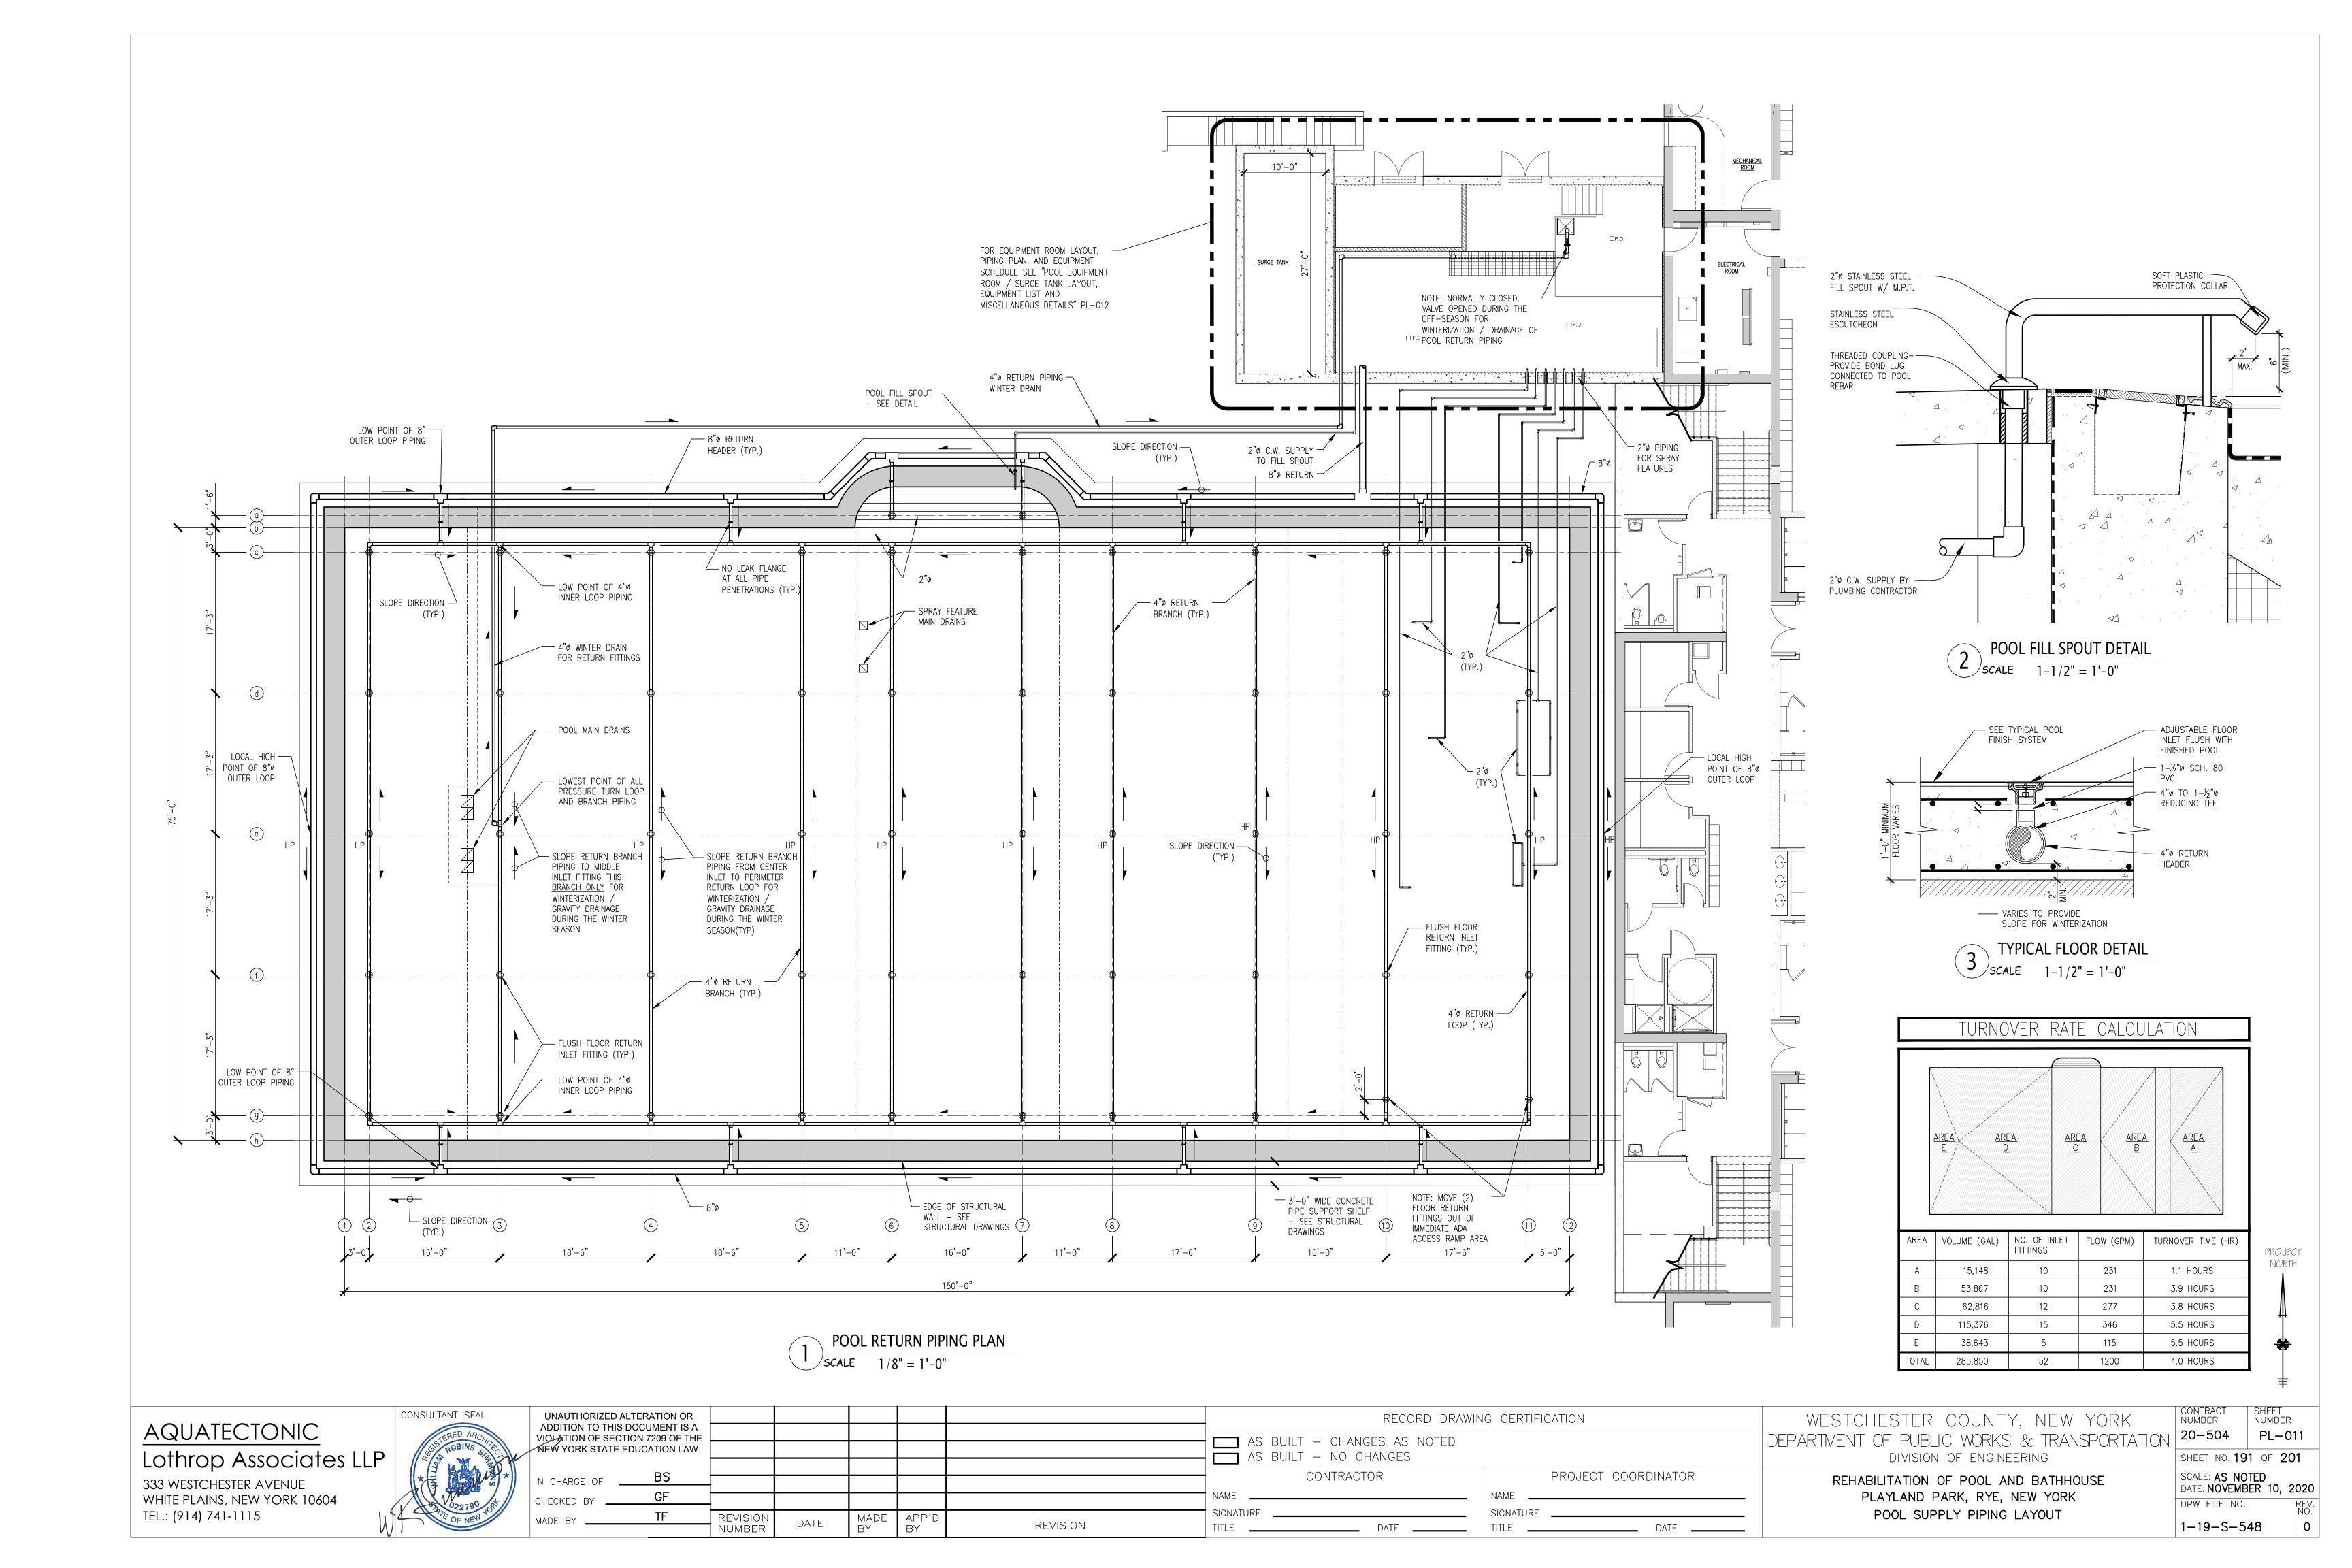











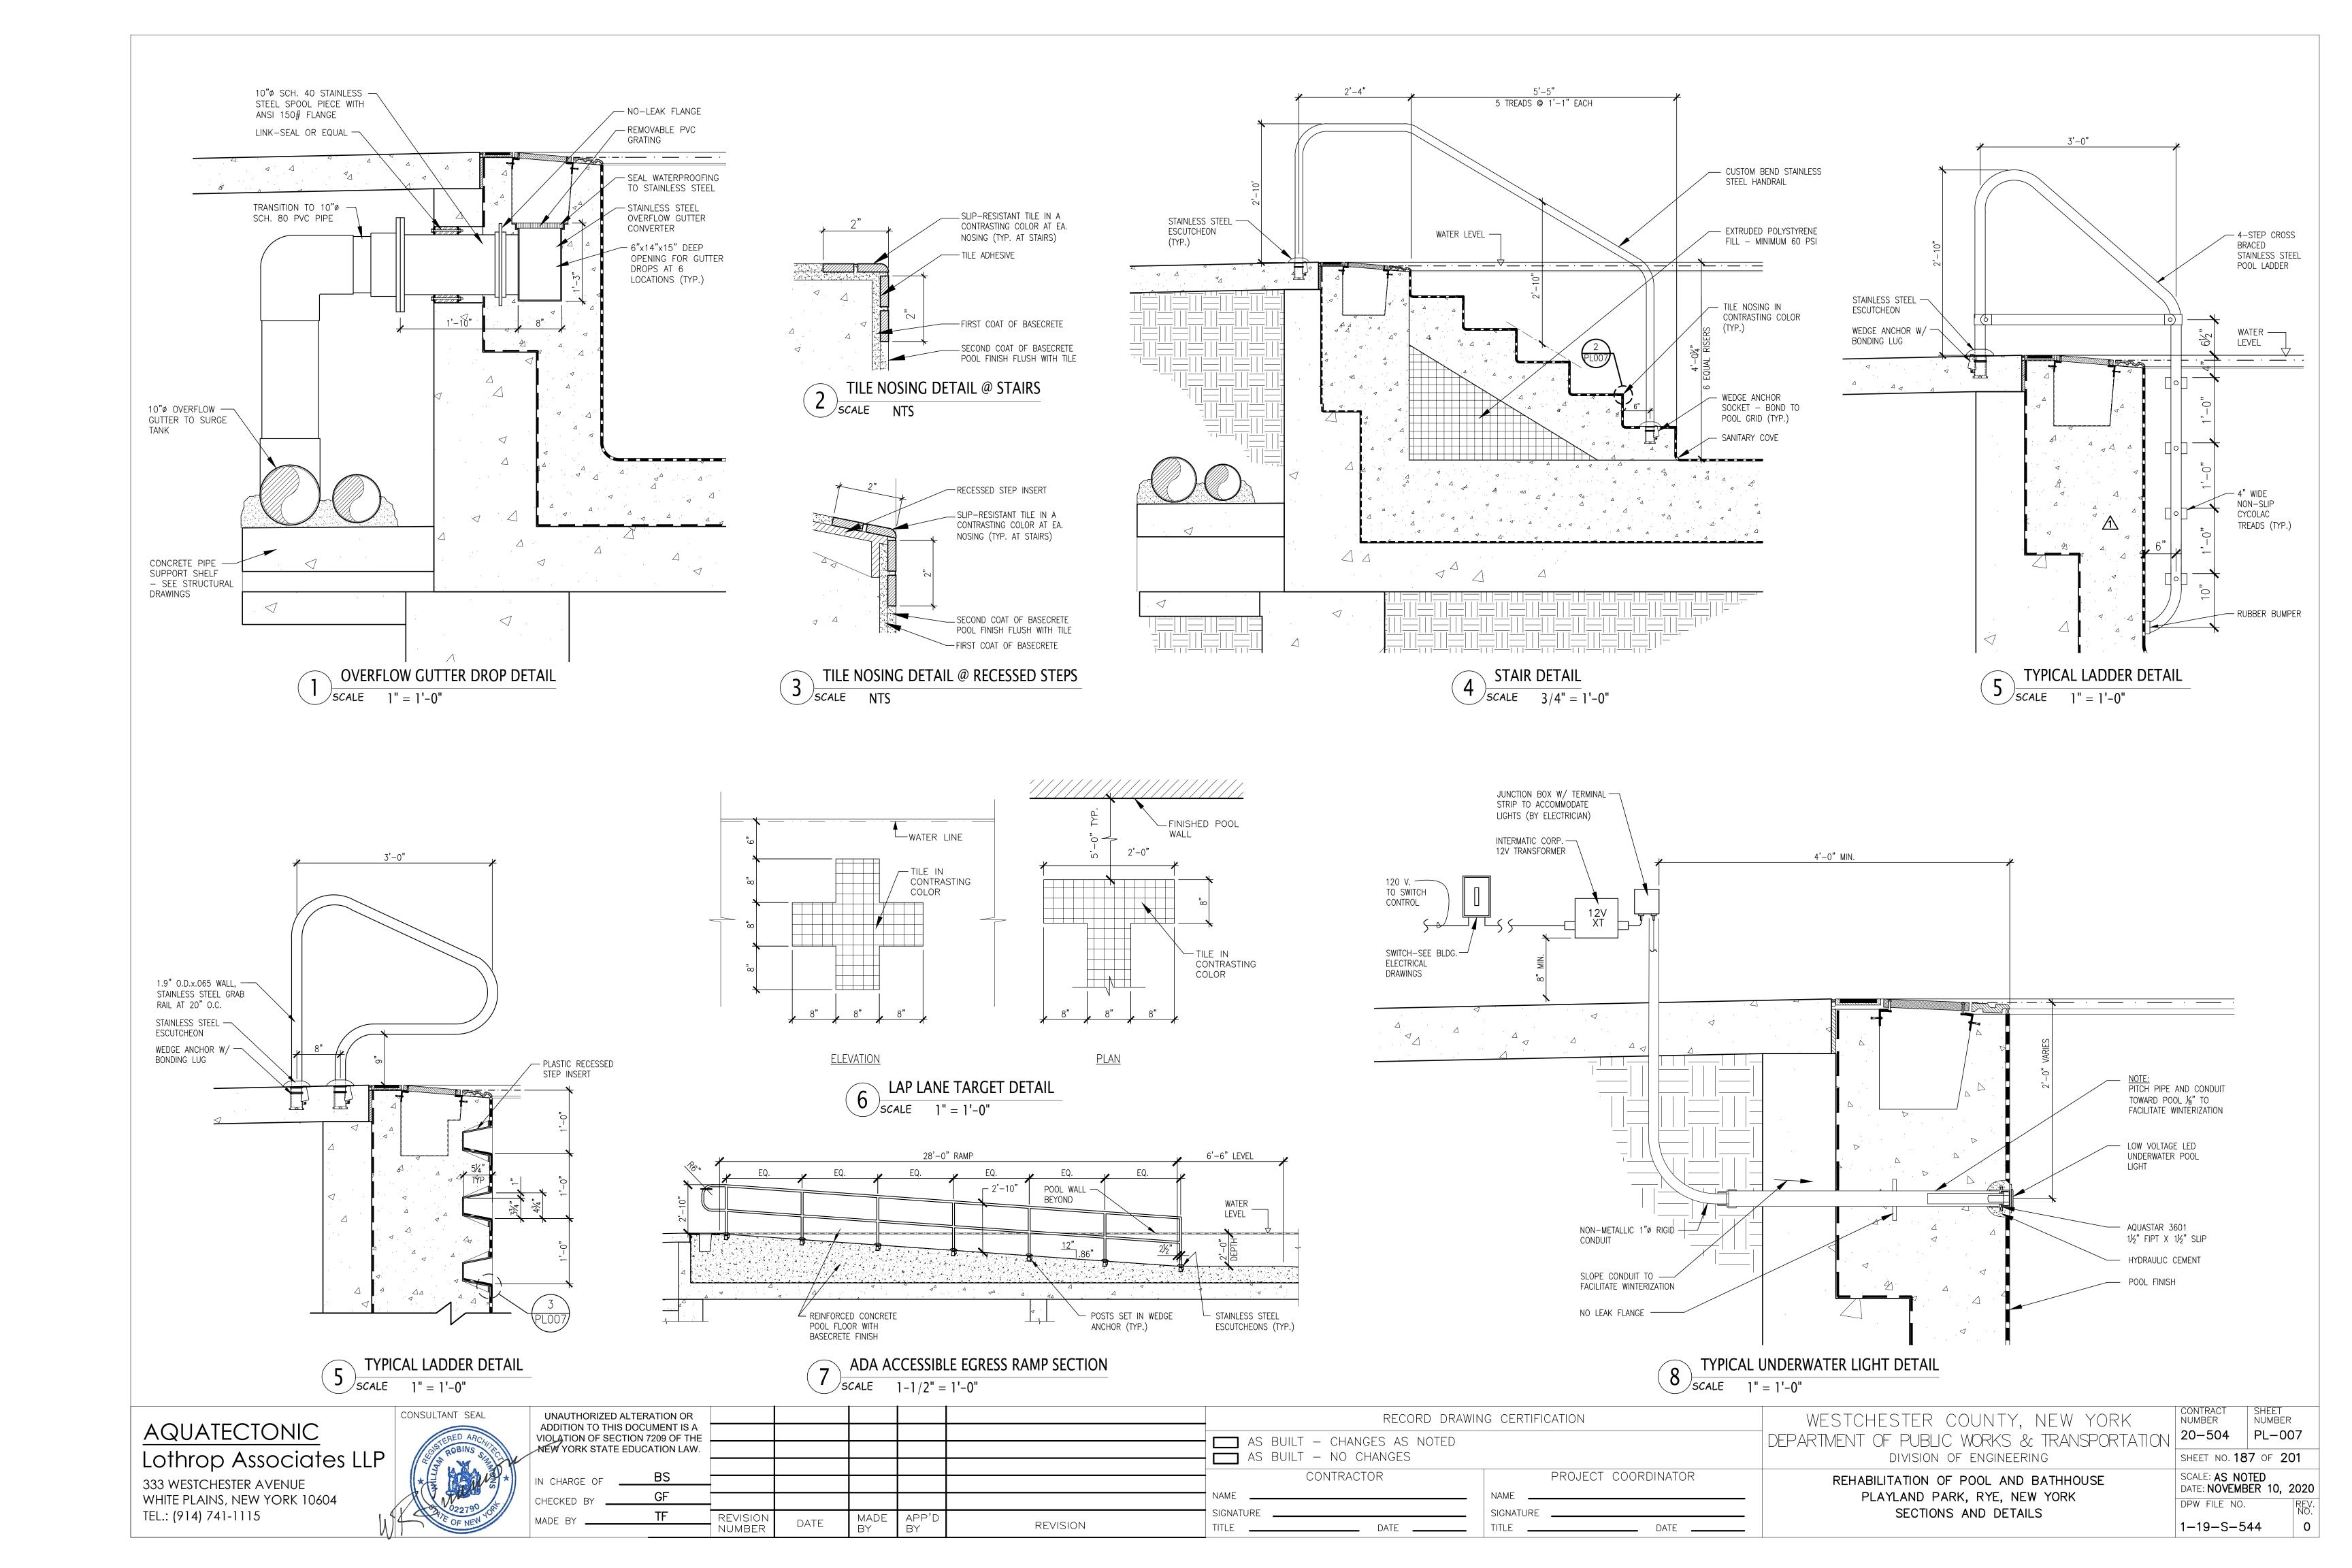


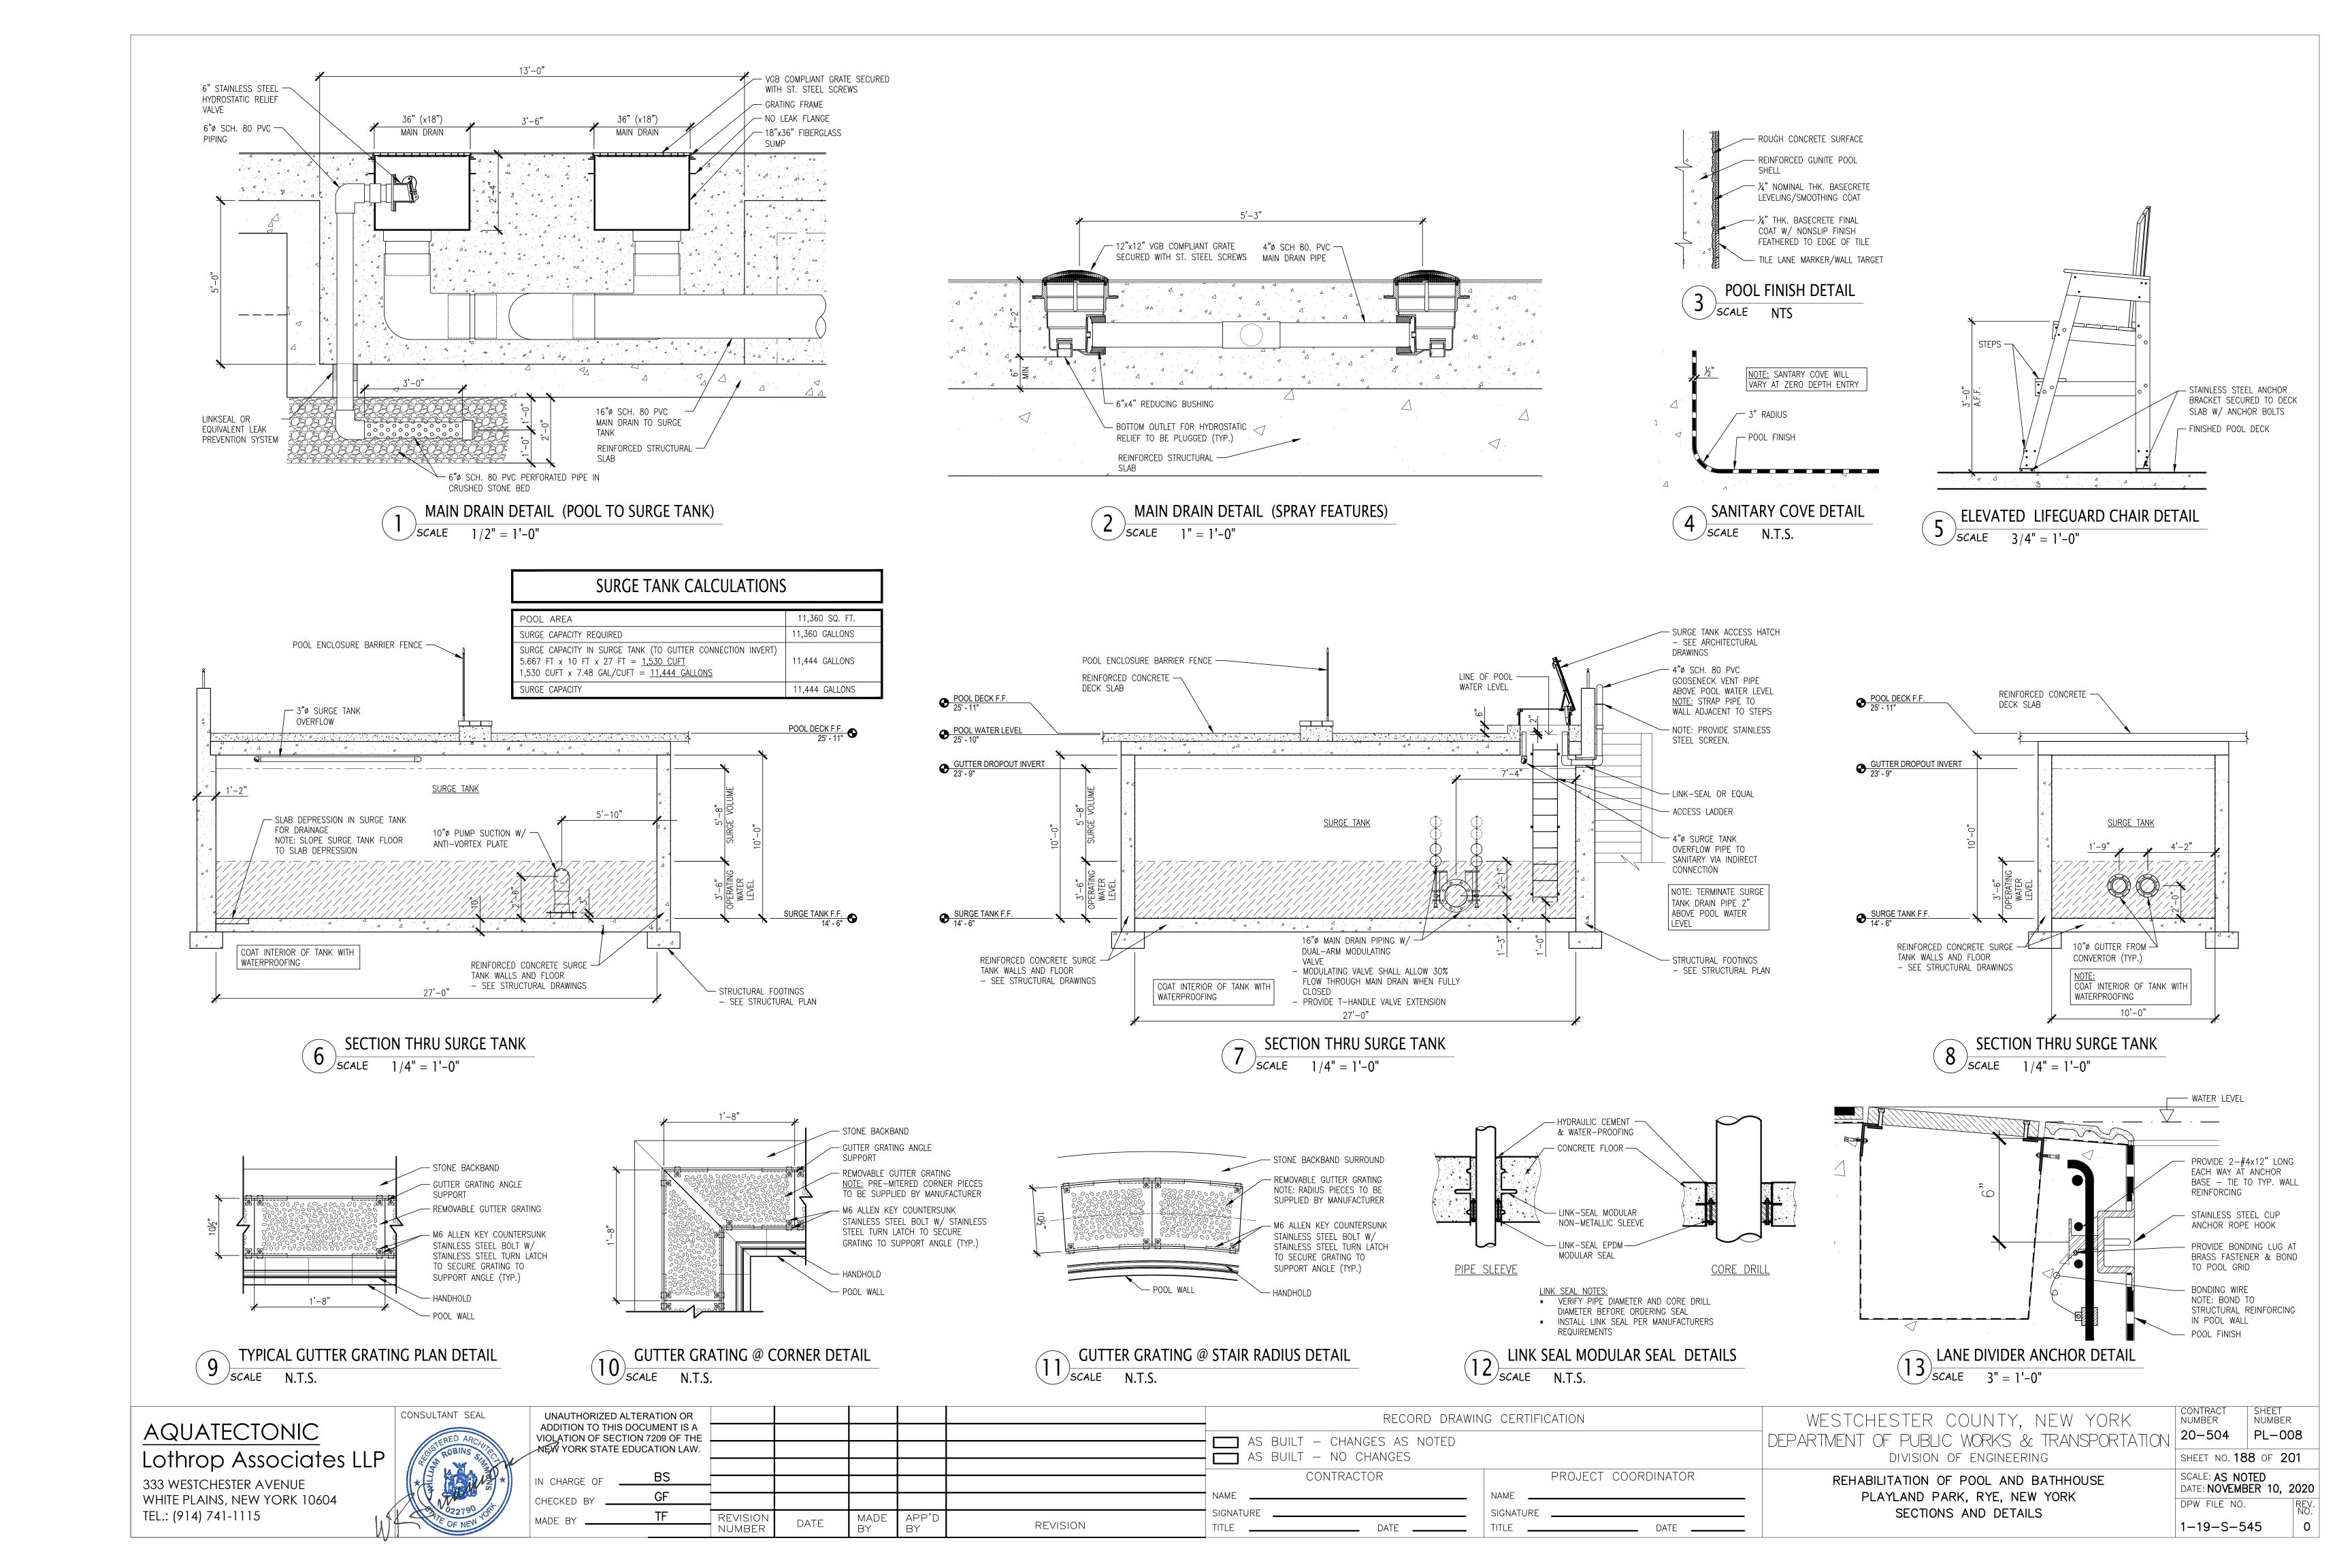

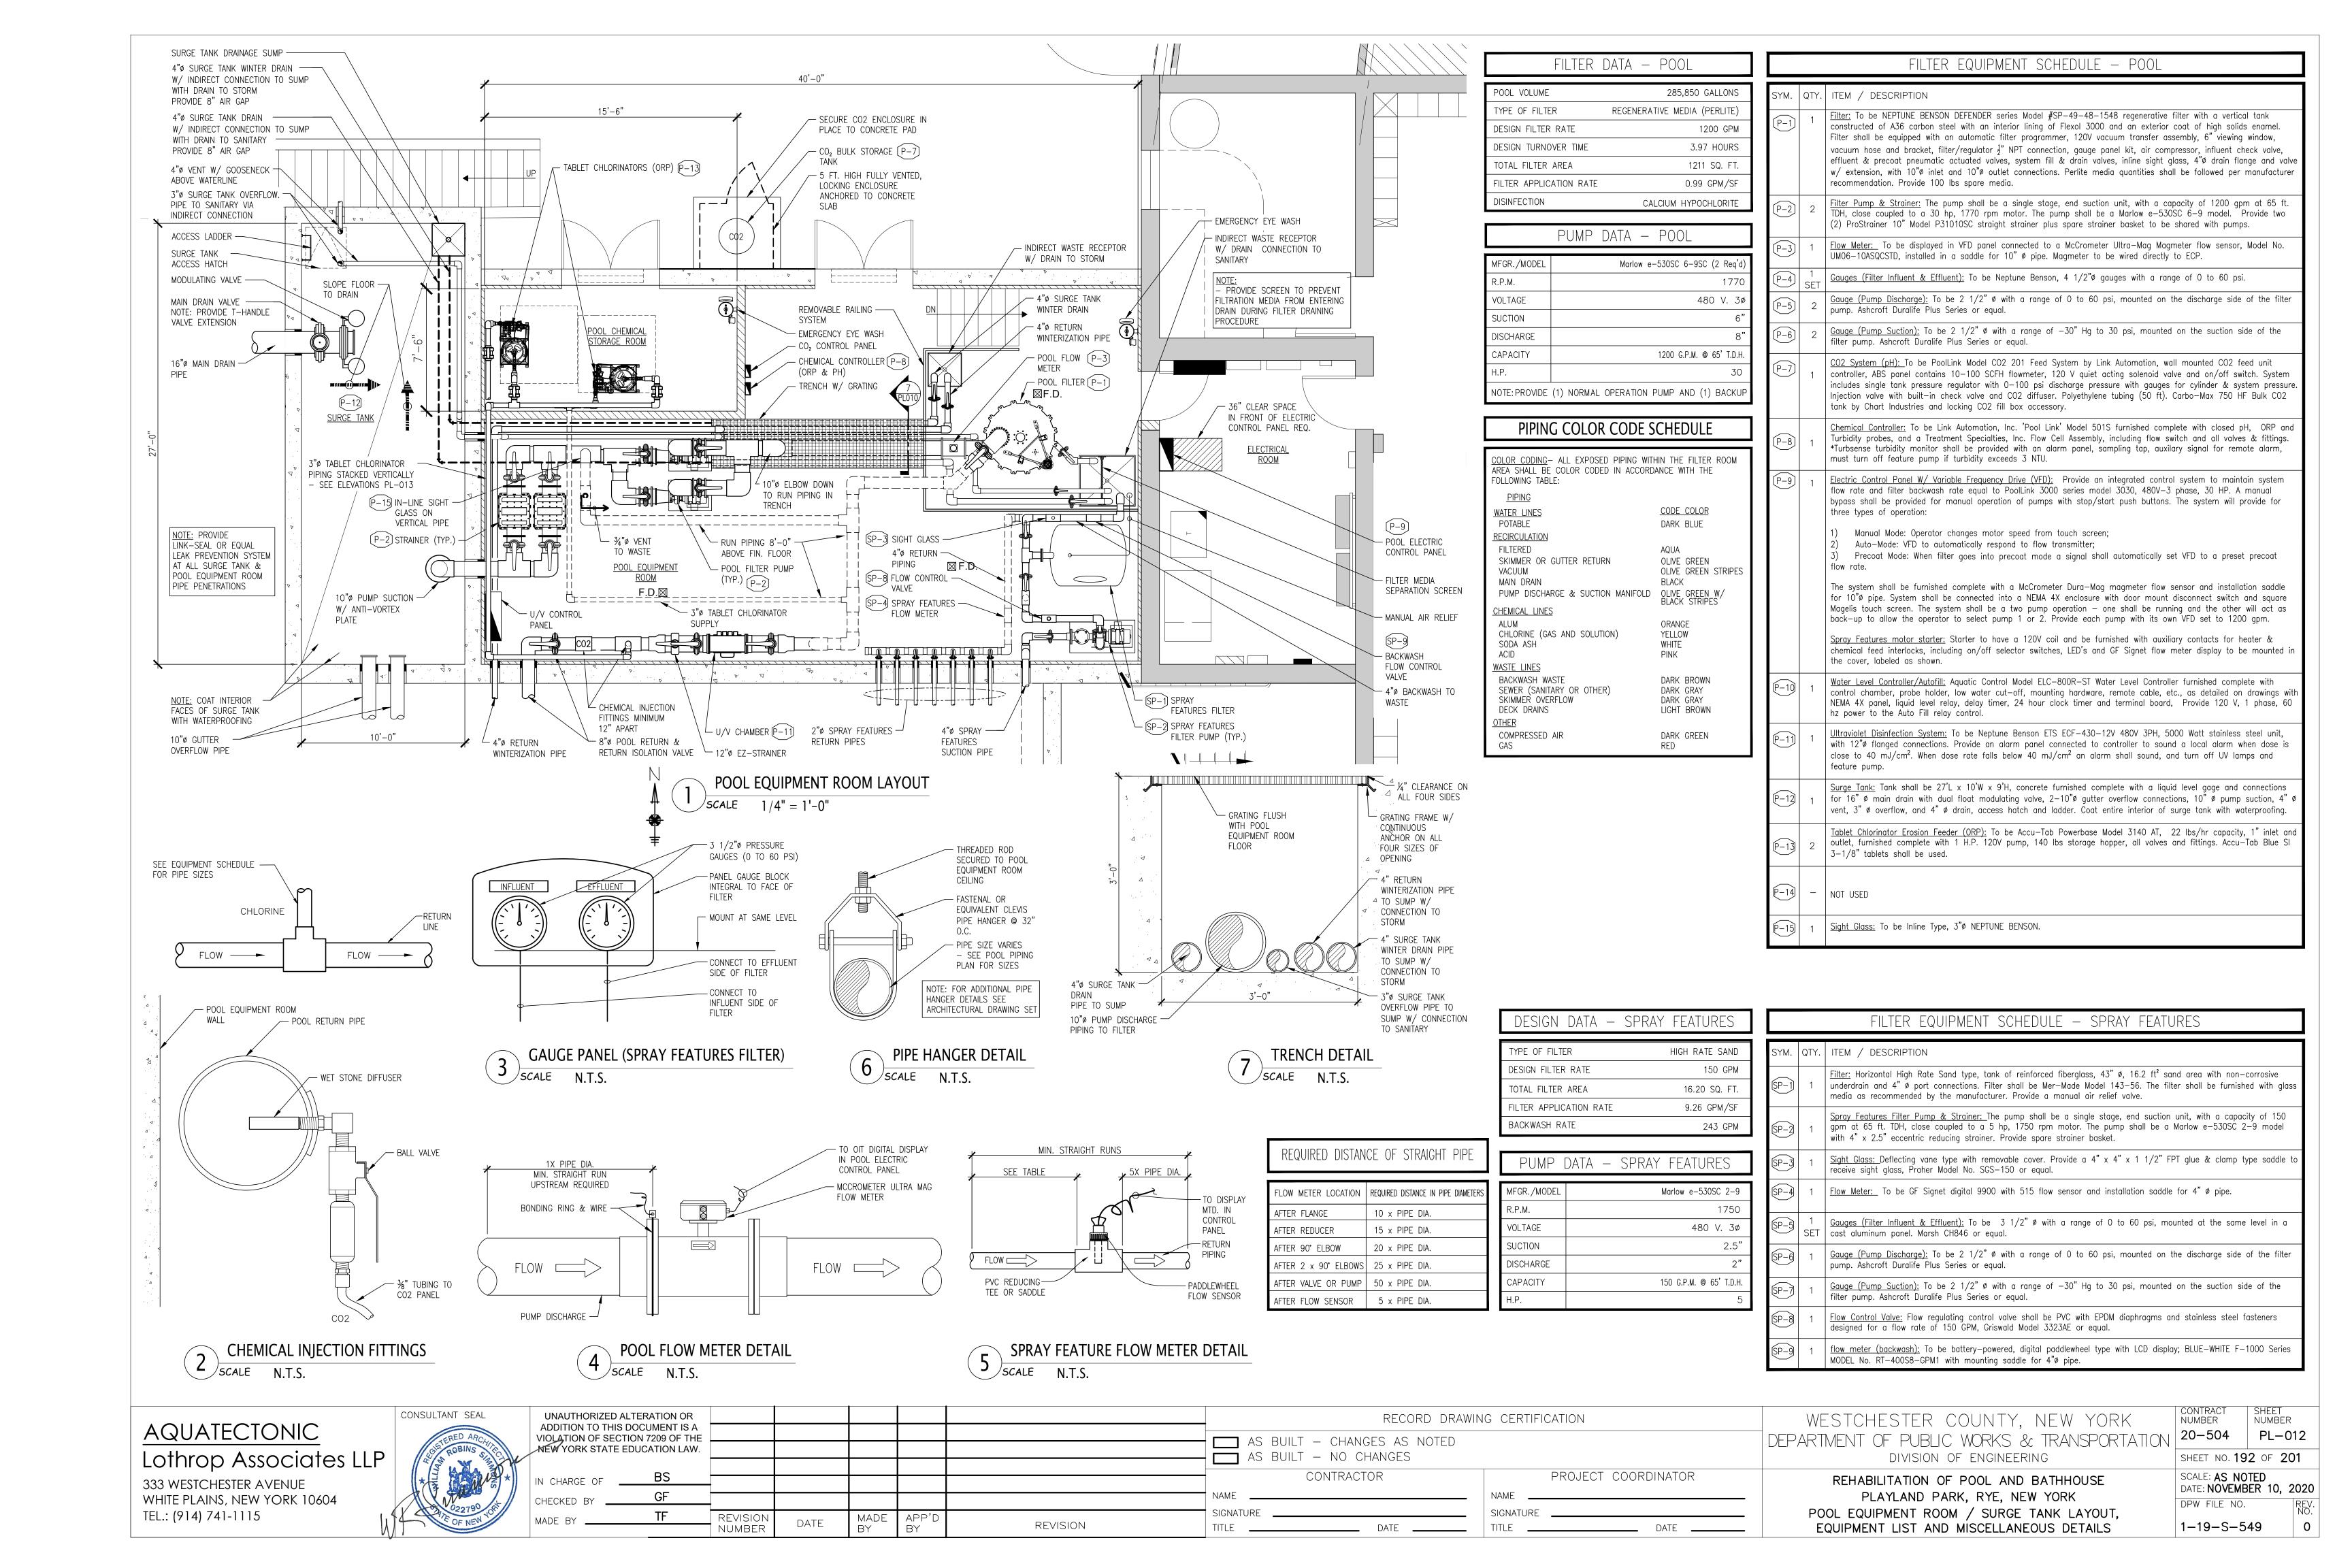

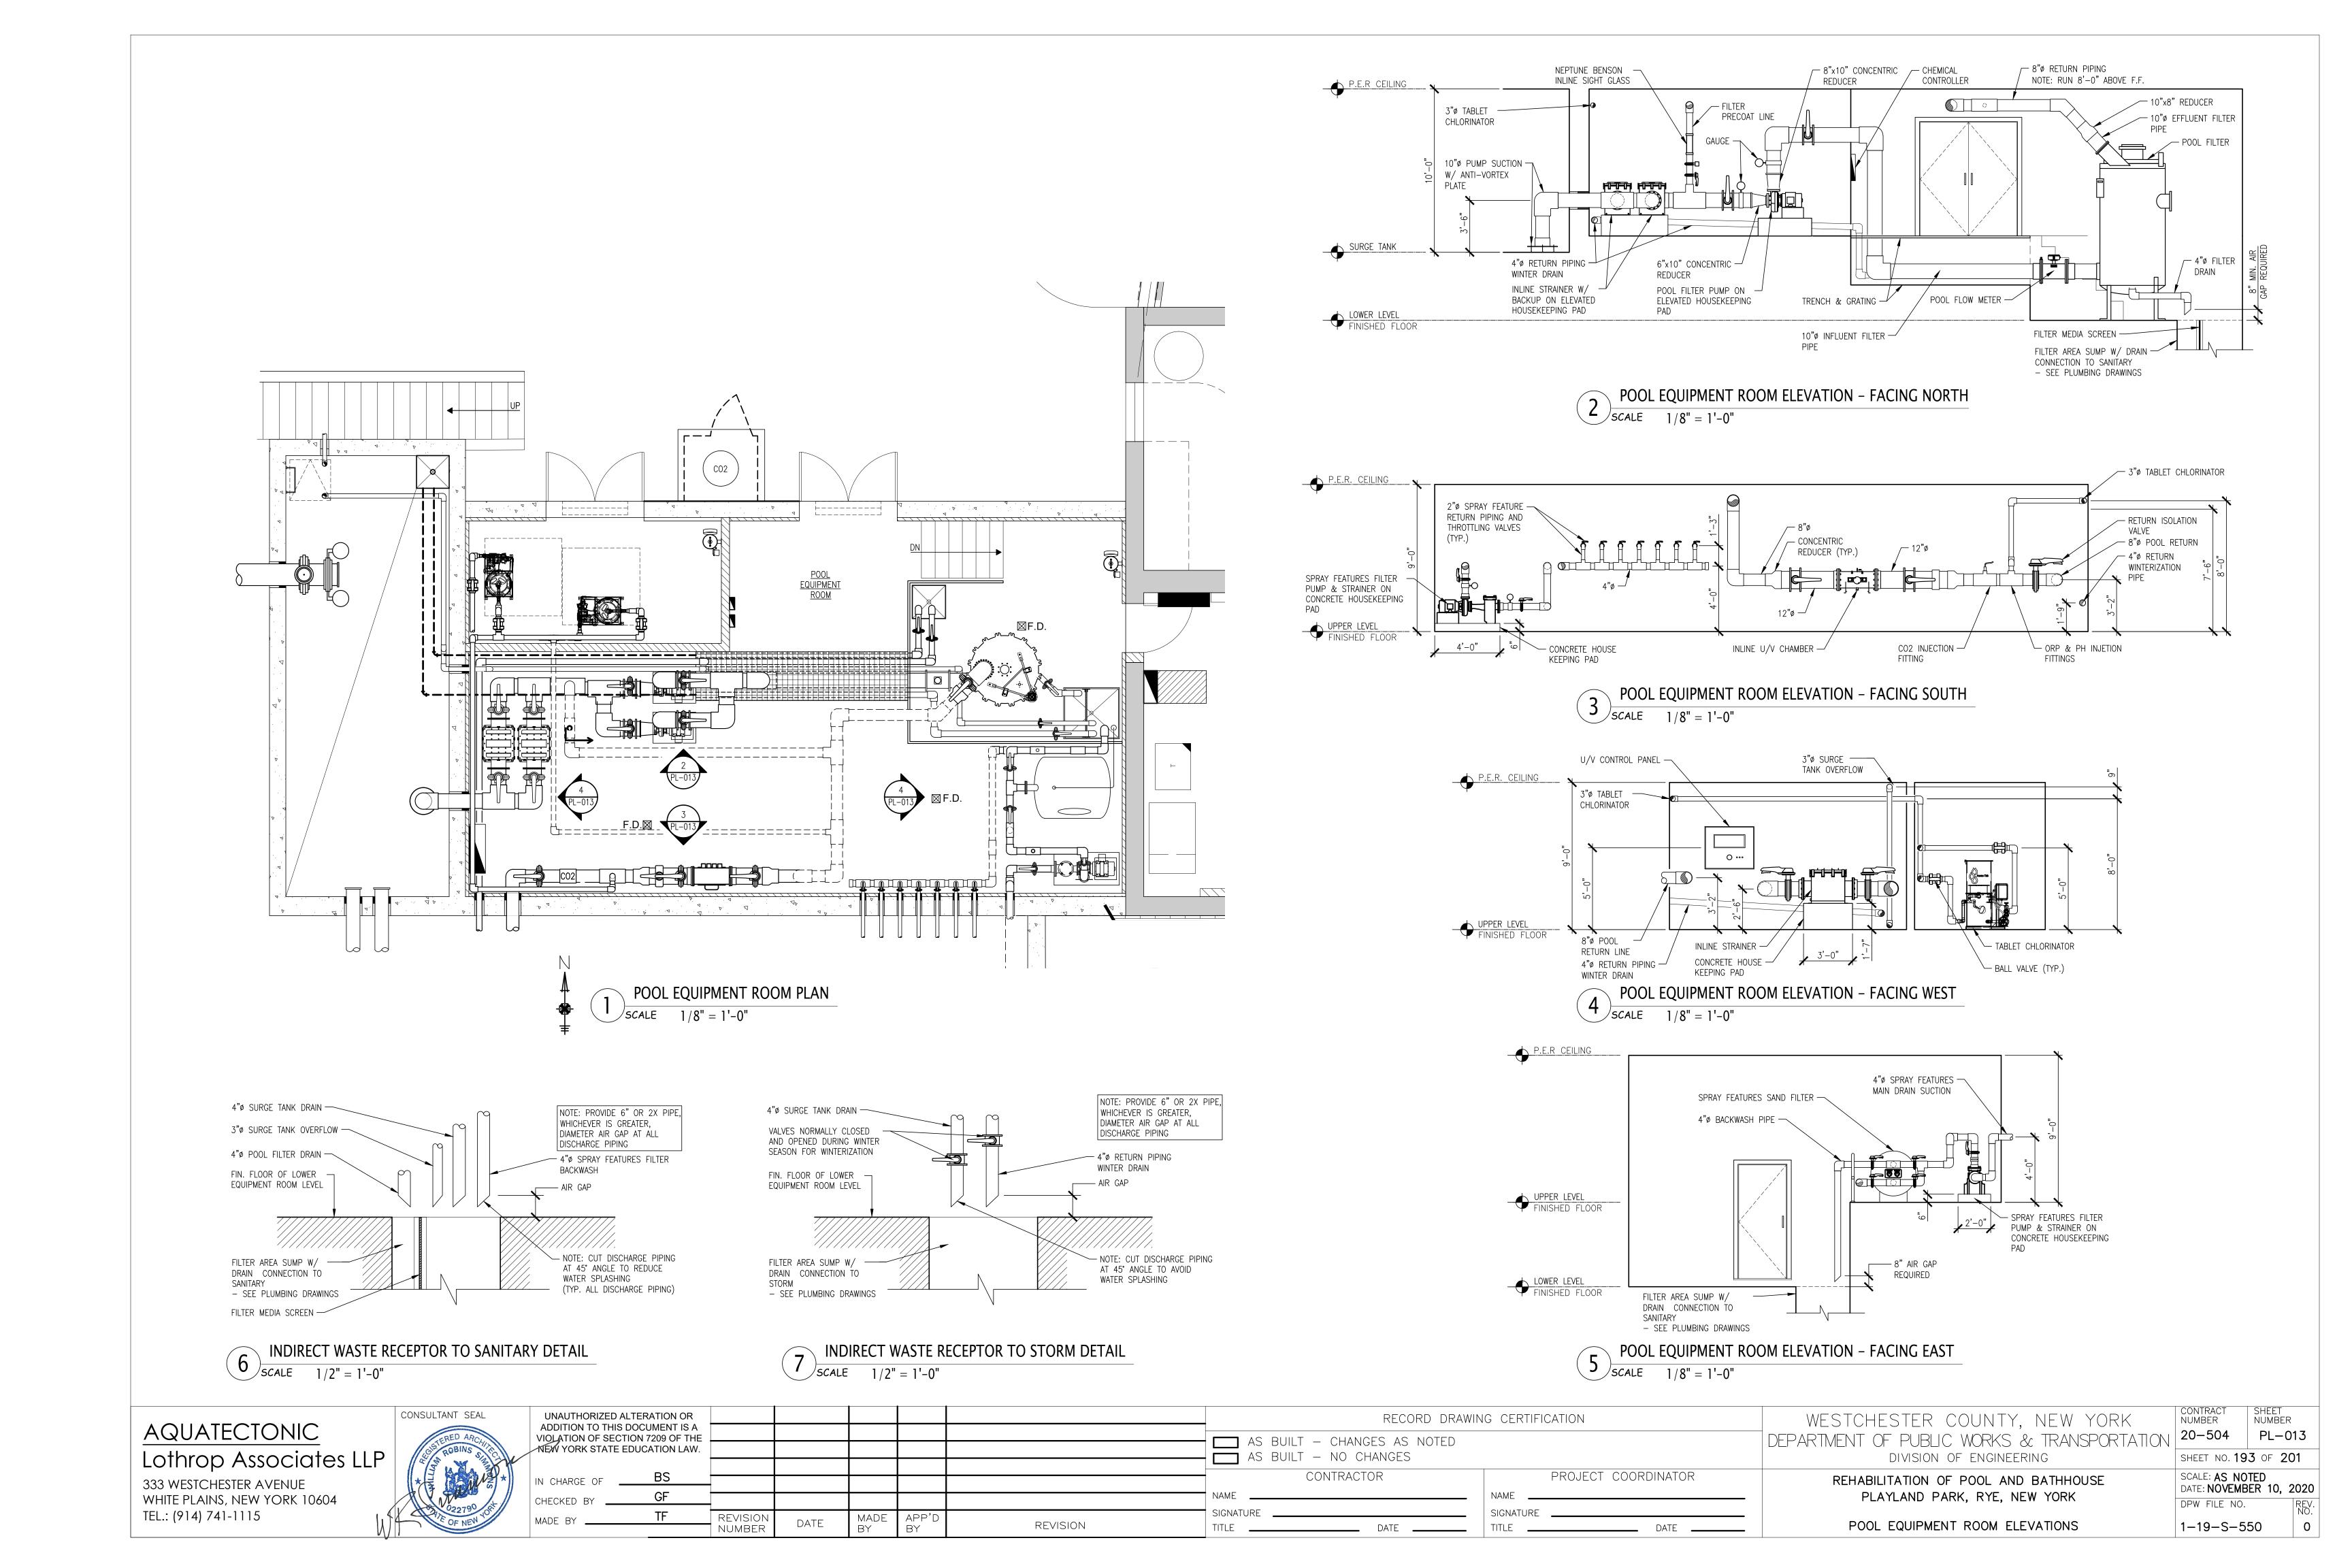

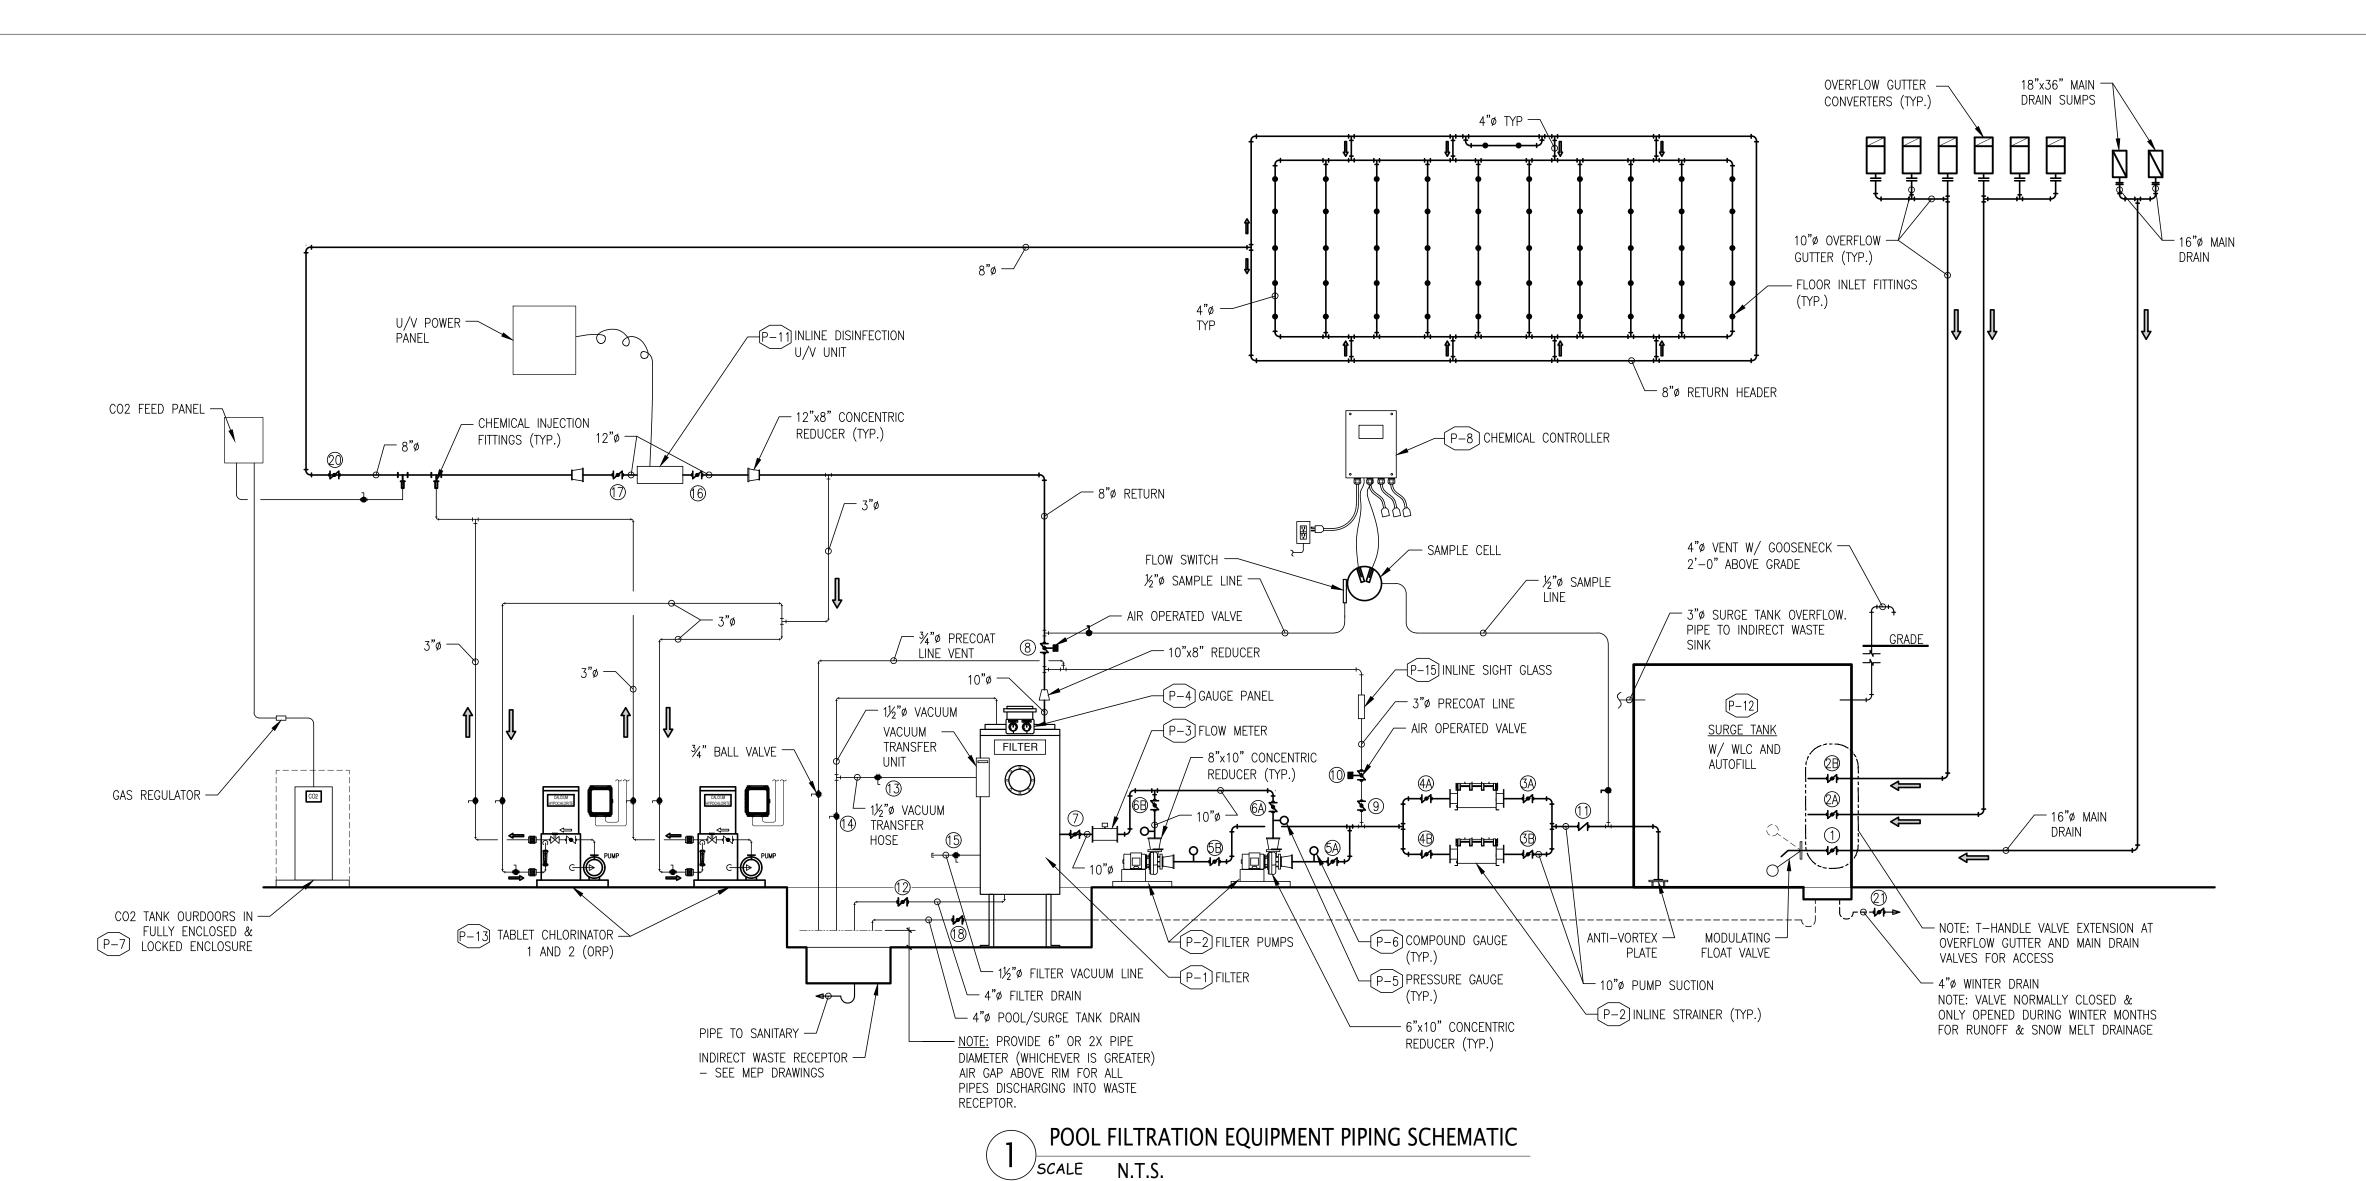

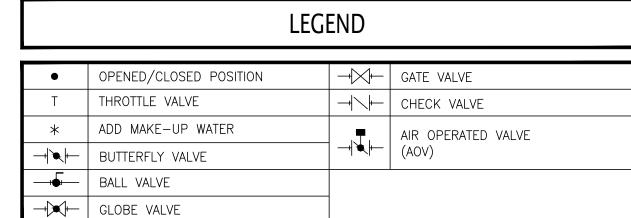


POOL VALVE SCHEDULE

					C	PER	RATIO	Ν						
NO.	DESCRIPTION	SIZE	FIL	TER	FILTER	DRAIN	P00L	DRAIN	FI	LL	PREC	OAT	WINTE	RIZE
			0	С	0	С	0	С	0	С	0	С	0	С
(1)	MAIN DRAIN	16"	•,		\		•		<u> </u>		•,		\	
2A)	GUTTER OVERFLOW	10"	•				•				•			
23	GUTTER OVERFLOW	10"	•				•				•			
(3A)	STRAINER "A" (ISOLATION IN)	10"	•		\Box		1		\perp		•			
33	STRAINER "B" (ISOLATION IN)	10"		•			\mathbb{L}					•		
(4A)	STRAINER "A" (ISOLATION OUT)	10"	•		$ \ $		$ \cdot $				•			
4B	STRAINER "B" (ISOLATION OUT)	10"		•			$ \ $		\			•		
(5A)	PUMP "A" (SUCTION)	8"	•				\prod				•			
<u>5B</u>	PUMP "B" (SUCTION)	8"		•			\Box					•		
(6A)	PUMP "A" (DISCHARGE)	10"	•								•			
63	PUMP "B" (DISCHARGE)	10"		•								•		
7	FILTER ISOLATION (IN)	10"	•					\sqcap			•			
8	FILTER ISOLATION (OUT) (AOV)	10"	•					\prod				•		
9	FILTER PRECOAT	3"		•							•			
10	FILTER PRECOAT EFFLUENT (AOV)	3"		•				$ \ $			•			
11	FILTER PRECOAT EFFLUENT (CHECK)	10"	•								•			
12	FILTER DRAIN	4"		•	•			•		•		•		
13	FILTER VACUUM TRANSFER	1½"		•	\				$\overline{}$		\			
14)	FILTER VACUUM VENT	1½"		•			\Box		\top					
15)	FILTER VACUUM HOSE	1½"		•	\Box									
16	U/V IN	12"	•					\square			\Box			
17	U/V OUT	12"	•											
18	POOL & SURGE TANK DRAIN	3"		•			•			•		\setminus		•
19	POOL FILL	2"		•				•	•					
20	RETURN ISOLATION	8"	•											
<u>(21)</u>	WINTER DRAIN	4"		•		•				•		•	•	

	SPRAY FEATURES VALVE SCHEDULE											
						OPER/	ATION					
NO.	DESCRIPTION	SIZE	FIL	TER	B'K	WASH	DR	AIN	FI	ILL		
			0	С	0	С	0	С	0	С		
1	MAIN DRAIN	6"	•		•							
2	PUMP ISOLATION (DISCHARGE)	4"	•		•					\Box		
3	FILTER	4"	•			•				7		
4	BACKWASH	4"		•	•		/			/		
(5)	RETURN	4"	•			•			\Box			
(6)	WA OFF	۸"					7		\Box			

(7) RETURN ISOLATION

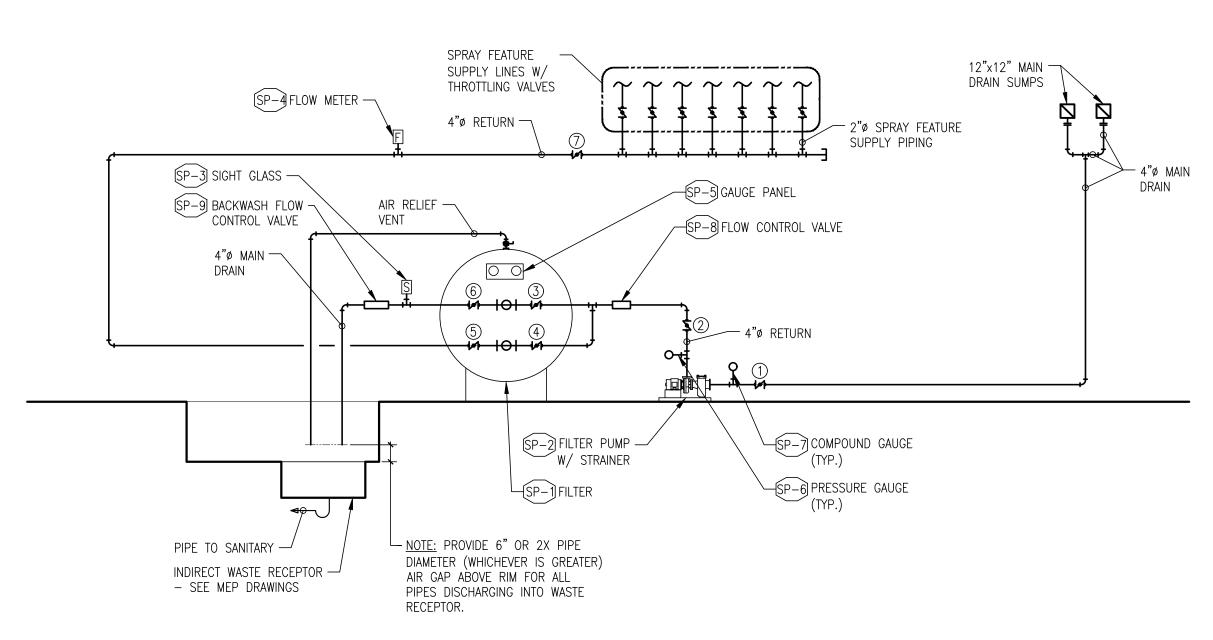

SPRAY FEATURES FILTRATION EQUIPMENT PIPING SCHEMATIC SPKAT FEATO, SCALE N.T.S.

CONSULTANT SEAL AQUATECTONIC Lothrop Associates LLP 333 WESTCHESTER AVENUE WHITE PLAINS, NEW YORK 10604

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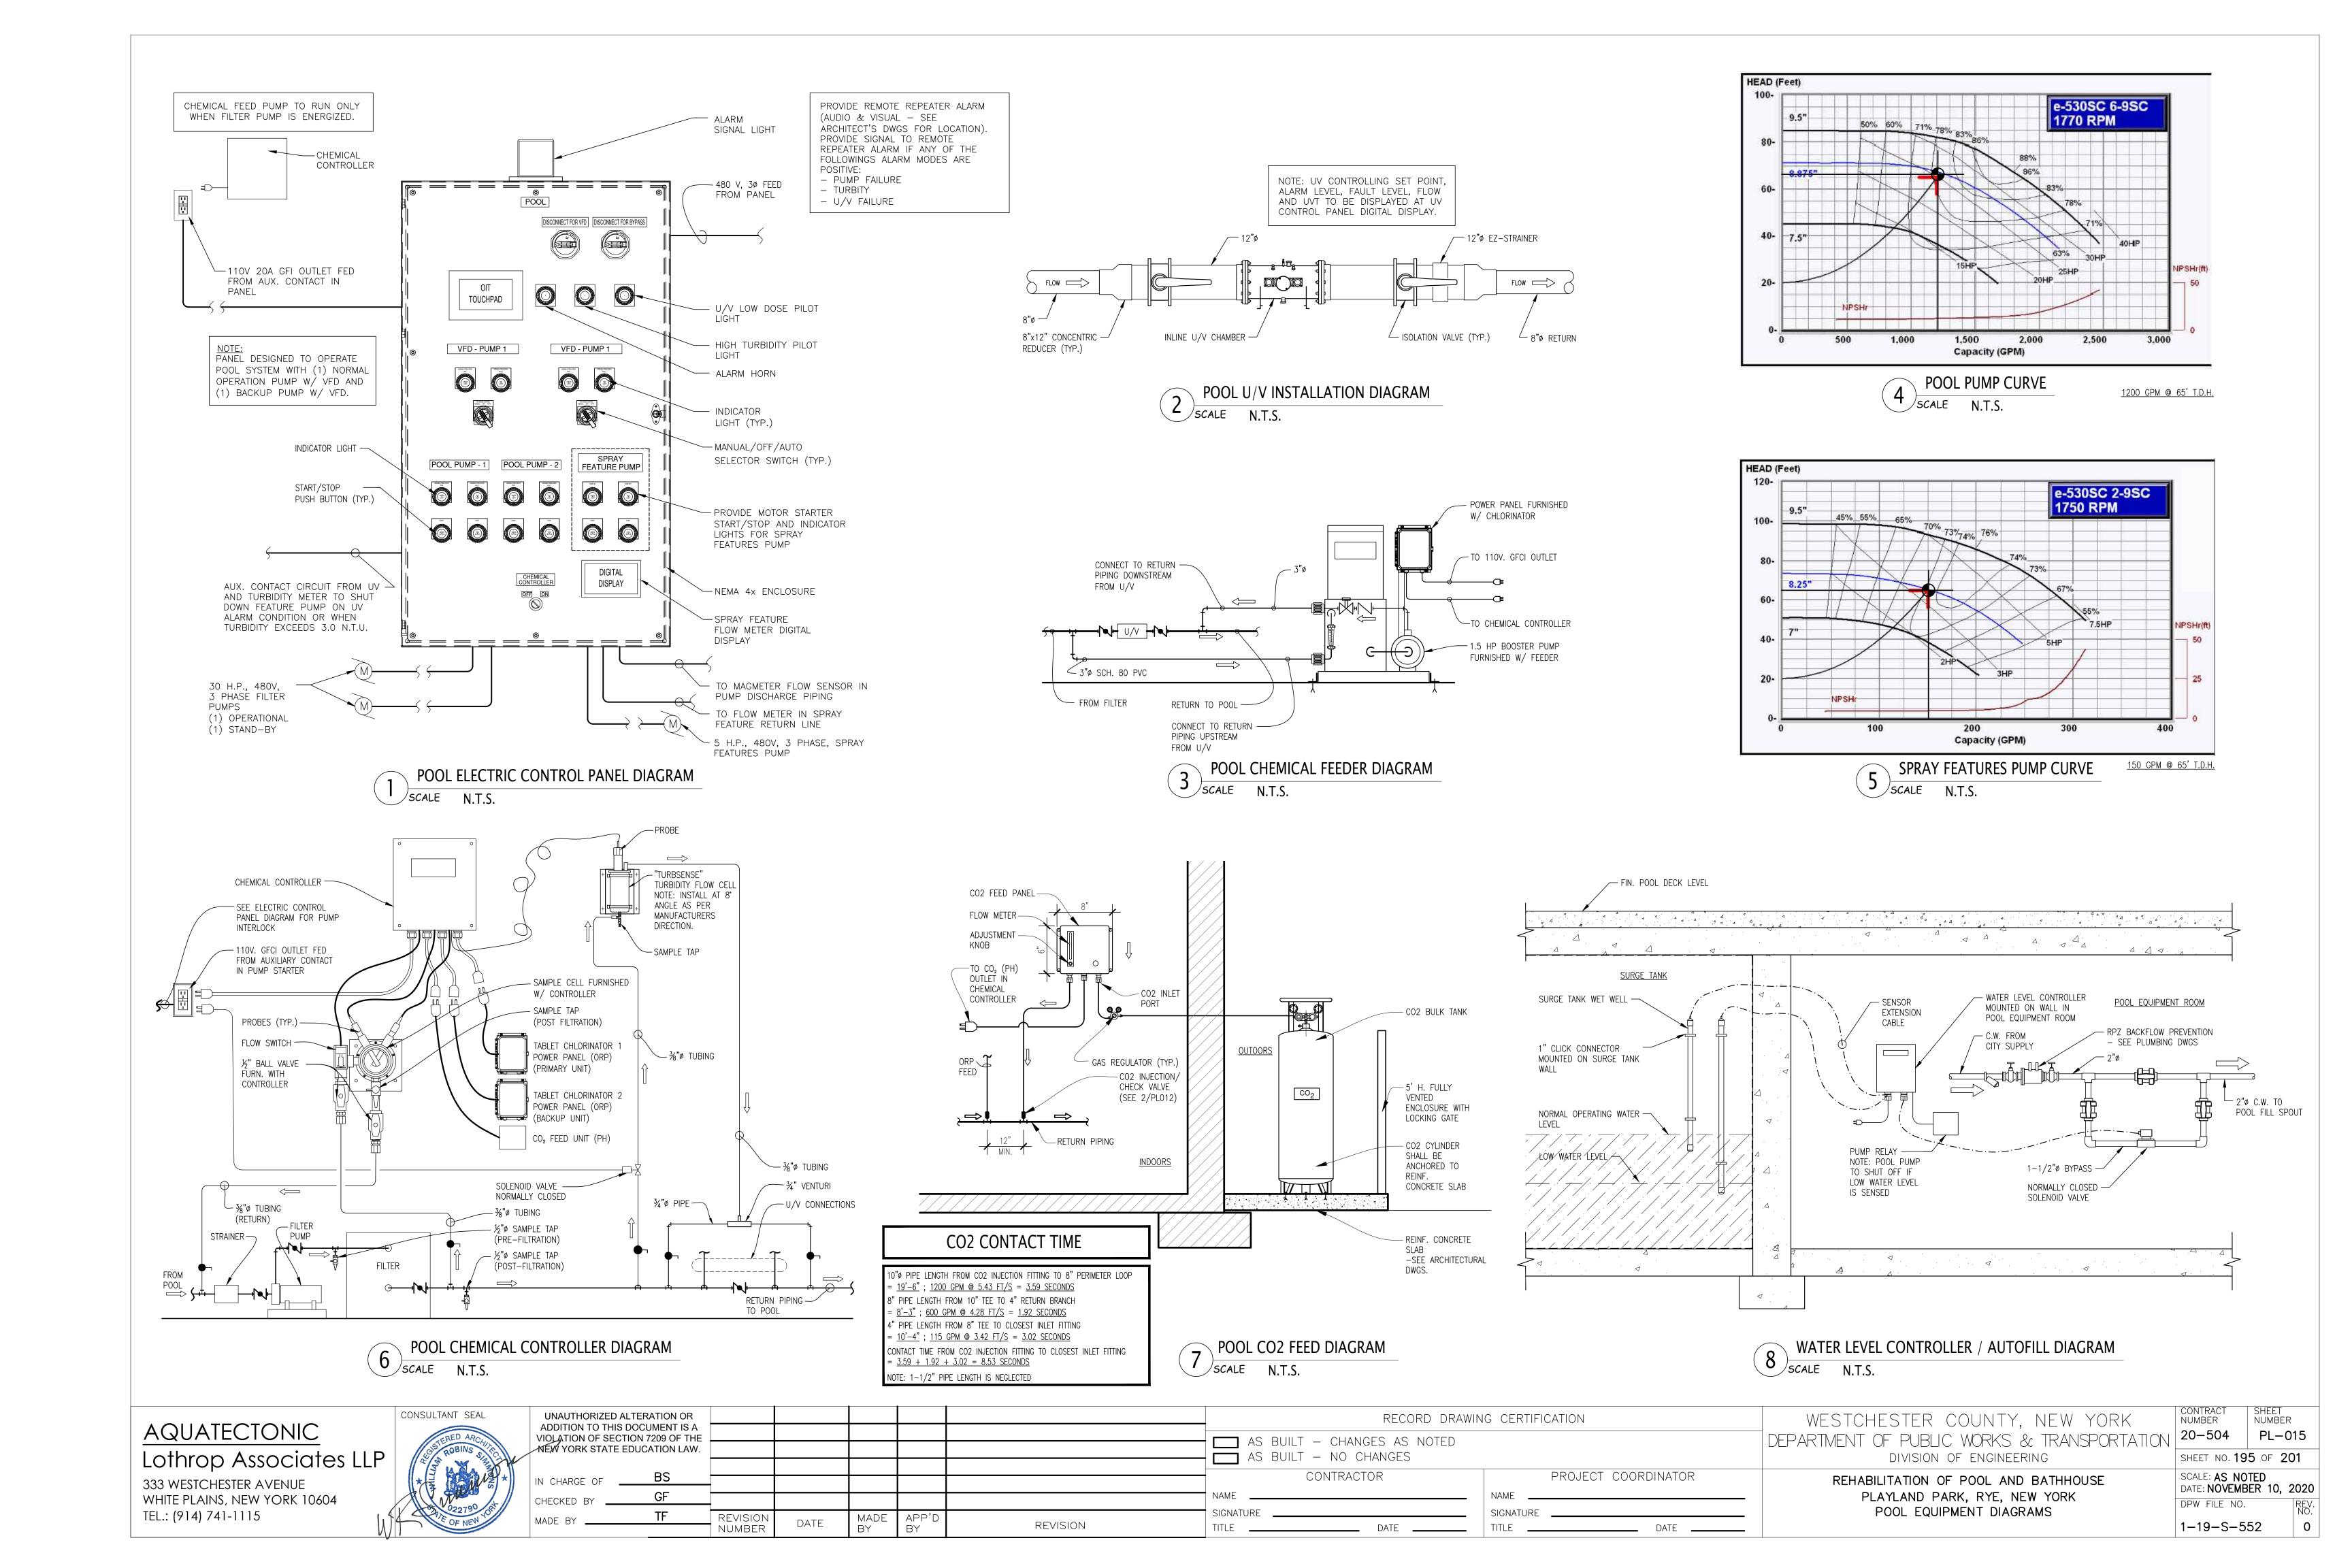
WESTCHESTER COUNTY, NEW YORK DEPARTMENT OF PUBLIC WORKS & TRANSPORTATION DIVISION OF ENGINEERING


20-504 PL-014 REHABILITATION OF POOL AND BATHHOUSE PLAYLAND PARK, RYE, NEW YORK DPW FILE NO. POOL FILTRATION EQUIPMENT SCHEMATICS AND VALVE SCHEDULES

SHEET NO. 194 OF 201 SCALE: AS NOTED
DATE: NOVEMBER 10, 2020 1-19-S-551

SHEET NUMBER

CONTRACT NUMBER



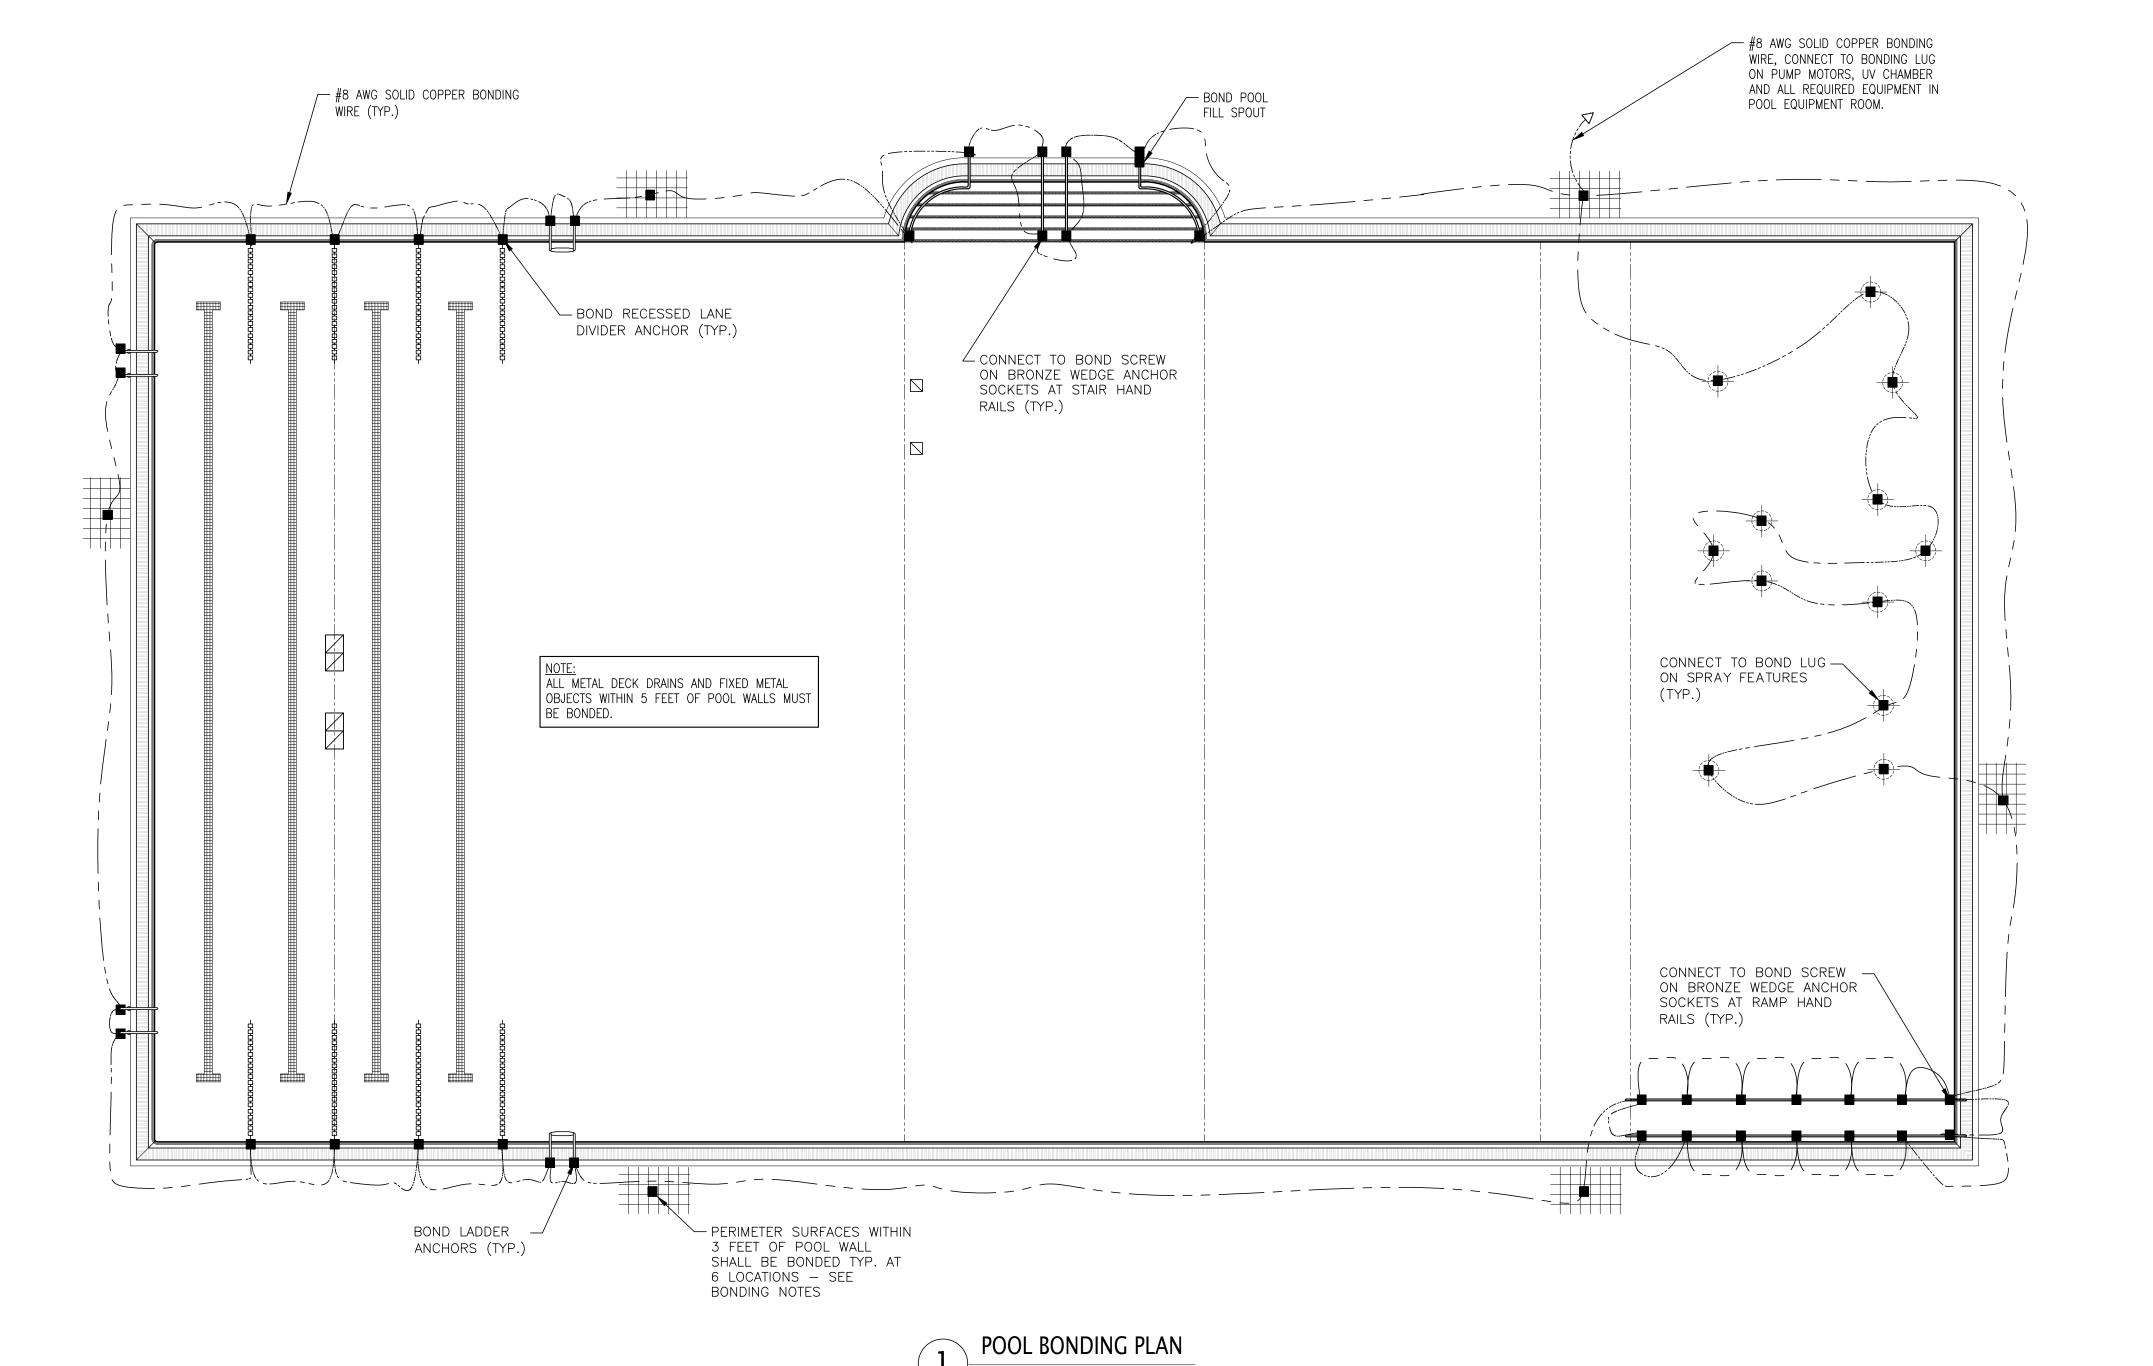

BONDING NOTES

- 1. SWIMMING POOL SHALL BE BONDED BY THE ELECTRICAL CONTRACTOR IN ACCORDANCE WITH NEC ARTICLE 680.26 AND ALL APPLICABLE STATE & LOCAL CODES.
- 2. GROUNDING CONDUCTOR AND BONDING JUMPERS SHALL BE CONNECTED BY EXOTHERMIC WELDING, LISTED PRESSURE CONNECTORS, LISTED CLAMPS, OR OTHER LISTED MEANS. CONNECTION DEVICES OR FITTINGS THAT DEPEND SOLELY ON SOLDER SHALL NOT BE USED. SHEET METAL SCREWS SHALL NOT BE USED TO ATTACH CONNECTION DEVICES TO ENCLOSURES.
- 3. THE FOLLOWING PARTS SHALL BE BONDED TOGETHER:
- -METALLIC STRUCTURAL COMPONENTS
 -UNDERWATER LIGHTING: ALL METAL FORMING SHELLS AND MOUNTING BRACKETS OF NO-NICHE LUMINAIRES SHALL BE BONDED. EXCEPTION: LISTED LOW-VOLTAGE LIGHTING SYSTEMS WITH NONMETALLIC FORMING SHELLS SHALL NOT REQUIRE BONDING.
- -METAL FITTINGS (ANY DIMENSION GREATER THAN 4" AND PROJECTING MORE THAN 1" INTO POOL)
 -ELECTRICAL EQUIPMENT (POOL PUMPS, ELECTRIC MOTORS FOR POOL COVERS, ETC.)
- -ELECTRICAL EQUIPMENT (POOL PUMPS, ELECTRIC MOTORS FOR POOL COVERS, ETC.)

 -METAL WIRING METHODS & EQUIPMENT— METAL SHEATHED CABLES & RACEWAYS, METAL PIPING, AND ALL FIXED METAL PARTS NOT

 SEPARATED FROM THE POOL BY A PERMANENT BARRIER (WITHIN 5 FT. HORIZONTALLY OF THE INSIDE POOL WALL, AND 12 FT. VERTICALLY

 ABOVE MAX. WATER LEVEL)
- 4. THE PARTS SPECIFIED (ABOVE) IN 680.26(B) SHALL BE CONNECTED TO A COMMON BONDING GRID. THE COMMON BONDING GRID SHALL BE PERMITTED TO BE ANY OF THE FOLLOWING:
- A) THE WALL OF A BOLTED OR WELDED METAL POOL.
- B) A SOLID COPPER CONDUCTOR, INSULATED, COVERED, OR BARE, NOT SMALLER THAN #8 AWG
- C) RIGID METAL CONDUIT OR INTERMEDIATE METAL CONDUIT OF BRASS OR OTHER IDENTIFIED CORROSION-RESISTANT METAL CONDUIT.
- D) CONDUCTIVE POOL SHELLS: BONDING TO CONDUCTIVE POOL SHELLS SHALL BE PROVIDED AS SPECIFIED IN ITEM 1.1 OR 1.2. POURED CONCRETE, PNEUMATICALLY APPLIED OR SPRAYED CONCRETE, AND CONCRETE BLOCK WITH PAINTED OR PLASTERED COATINGS SHALL BE CONSIDERED TO BE CONDUCTIVE MATERIALS BECAUSE OF THEIR WATER PERMEABILITY AND POROSITY. VINYL LINERS AND FIBERGLASS COMPOSITE SHELLS SHALL BE CONSIDERED TO BE NONCONDUCTIVE MATERIALS.
- E) STRUCTURAL REINFORCING STEEL: UNENCAPSULATED STRUCTURAL REINFORCING STEEL SHALL BE BONDED TOGETHER BY STEEL TIE WIRES OR THE EQUIVALENT. WHERE STRUCTURAL REINFORCING STEEL IS ENCAPSULATED IN A NONCONDUCTIVE COMPOUND, A COPPER CONDUCTOR GRID SHALL BE INSTALLED IN ACCORDANCE WITH 680.26 ITEM 1.2.
- F) COPPER CONDUCTOR GRID: A COPPER CONDUCTOR GRID SHALL BE PROVIDED AND SHALL COMPLY WITH THE FOLLOWING:

 (1) BE CONSTRUCTED OF MINIMUM 8 AWG BARE SOLID COPPER CONDUCTORS BONDED TO EACH OTHER AT ALL POINTS OF CROSSING.
- (2) CONFORM TO THE CONTOUR OF THE POOL AND THE POOL DECK
- (3) BE ARRANGED IN A 12-IN. BY 12-IN. NETWORK OF CONDUCTORS IN A UNIFORMLY SPACED PERPENDICULAR GRID PATTERN WITH A TOLERANCE OF 4 IN.

 (4) BE SECURED WITHIN OR UNDER THE POOL NO MORE THAN 6 IN. FROM THE OUTER CONTOUR OF THE POOL SHELL.
- 5. PERIMETER SURFACES: THE PERIMETER SURFACE SHALL EXTEND FOR 3 FEET HORIZONTALLY BEYOND THE INSIDE WALLS OF THE POOL AND SHALL INCLUDE UNPAVED SURFACES, POURED CONCRETE AND OTHER TYPES OF PAVING. BONDING TO PERIMETER SURFACES SHALL BE PROVIDED AS SPECIFIED IN 680.26(B)(2)(a) OR (2)(b) AND SHALL BE ATTACHED TO THE POOL, SPA, OR HOT TUB REINFORCING STEEL OR COPPER CONDUCTOR GRID AT A MINIMUM OF FOUR POINTS UNIFORMLY SPACED AROUND THE PERIMETER OF THE POOL, SPA, OR HOT TUB. FOR NONCONDUCTIVE POOL SHELLS, BONDING AT FOUR POINTS SHALL NOT BE REQUIRED.
- 6. POOL WATER: THE POOL WATER SHALL BE INTENTIONALLY BONDED BY MEANS OF A CONDUCTIVE SURFACE AREA NOT LESS THAN 9 SQUARE INCHES INSTALLED IN CONTACT WITH THE POOL WATER. THIS BOND SHALL BE PERMITTED TO CONSIST OF PARTS THAT ARE REQUIRED TO BE BONDED IN 680.26(B).
- 7. EXTEND BONDING WIRE TO MECHANICAL/FILTER EQUIPMENT ROOM AND CONNECT TO BOND LUG ON POOL PUMP MOTOR(S), AND METAL FILTER TANK(S) WHEN APPLICABLE.

NOTE: A #8 AWG SOLID COPPER BONDING CONDUCTOR PROVIDED TO REDUCE VOLTAGE GRADIENTS IN THE POOL AREA SHALL NOT BE REQUIRED TO BE EXTENDED OR ATTACHED TO REMOTE PANELBOARDS, SERVICE EQUIPMENT OR ELECTRODES.

ELECTRICAL NOTES

- 1. THE POOL ELECTRICAL SYSTEM, INCLUDING UNDERWATER LIGHT FIXTURES SHALL BE INSTALLED IN ACCORDANCE WITH THE REQUIREMENTS OF THE NATIONAL ELECTRICAL CODE ARTICLE 680.
- 2. SEE BUILDING ELECTRICAL DRAWINGS FOR LOCATION OF JUNCTION BOXES, SWITCHES, TRANSFORMERS, CIRCUITING,
- 3. WIRE CORD LENGTH FOR EACH LIGHT FIXTURE TO BE DETERMINED PRIOR TO ORDER.
- 4. THE ELECTRICAL CONTRACTOR SHALL GROUND AND BOND THE POOL, METALLIC POOL ACCESSORIES AND PIPING, AND ALL ELECTRICAL EQUIPMENT IN ACCORDANCE WITH THE BONDING NOTES FOUND WITHIN THIS DRAWING SET AND WITH N.E.C. ARTICLE 680.
- 5. LIGHTING AND OTHER ELECTRICAL CIRCUITS IN THE POOL AREA MUST HAVE GROUND FAULT AND THERMAL PROTECTION AS REQUIRED BY ALL APPLICABLE CODES. ALL OUTLETS IN THE IMMEDIATE POOL AREA WILL BE TESTED BY WCDOH AT THE TIME OF FINAL INSPECTION
- 6. PUMP AND ELECTRICAL CONTROL SHALL BE FURNISHED BY THE POOL CONTRACTOR. THE ELECTRICAL CONTRACTOR SHALL FURNISH AND INSTALL DISCONNECT, WIRE, CONDUIT, ETC.. AND MAKE ALL CONNECTIONS. POOL CONTRACTOR TO FURNISH ELECTRICAL CONTROL PANEL.
- 7. DEFECTS IN THE ELECTRICAL SYSTEM, INCLUDING UNDERWATER LIGHTS, OVERHEAD LIGHTS AND THEIR RESPECTIVE LENSES, SHALL BE IMMEDIATELY REPAIRED.
- 8. PORTABLE ELECTRIC DEVICES, SUCH AS ANNOUNCING SYSTEMS AND RADIOS WITHIN THE REACH OF BATHERS, SHALL BE PROHIBITED.
- 9. UNDERWATER LIGHTS SHALL ALLOW AN OBSERVER ON THE POOL DECK TO CLEARLY SEE ALL PORTIONS OF THE POOL, INCLUDING THE BOTTOM.
- 10. NO OVERHEAD ELECTRICAL WIRING SHALL PASS WITHIN 20 FEET HORIZONTALLY OF THE SWIMMING POOL.
- 11. THE ELECTRICAL SUBCONTRACTOR SHALL OBTAIN AN UNDERWRITER'S CERTIFICATE FOR THE POOL STRUCTURE AND POOL DECK REBAR BONDING WHICH IS TO BE FURNISHED TO THE WCDOH PRIOR TO THEIR INITIAL INSPECTION. AT THE CONCLUSION OF THE PROJECT, A FINAL UNDERWRITERS CERTIFICATE FOR ALL POOL RELATED ELECTRICAL WORK, INCLUDING GFCI RECEPTACLES IN BATHROOMS AND ALL AREAS SERVING POOL PATRONS, SHALL BE FURNISHED TO THE WCDOH PRIOR TO THEIR FINAL INSPECTION.



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PROJECT COORDINATOR

NAME
SIGNATURE
TITLE
DATE

WESTCHESTER COUNTY, NEW YORK
DEPARTMENT OF PUBLIC WORKS & TRANSPORTATION
DIVISION OF ENGINEERING

POOL BONDING PLAN & NOTES

REHABILITATION OF POOL AND BATHHOUSE PLAYLAND PARK, RYE, NEW YORK

NUMBER NUMBER
20-504 PL-016

SHEET NO. 196 OF 201

SCALE: AS NOTED
DATE: NOVEMBER 10, 2020

DATE: NOVEMBER 10, 20

DPW FILE NO. | R

1-19-S-553

CONTRACT

GENERAL NOTES:

- 1. CONTRACTOR SHALL BE RESPONSIBLE FOR VERIFYING ALL QUANTITIES AND DIMENSIONS BEFORE BID SUBMISSION AND COMMENCING WORK.
- 2. CONTRACTOR'S PERSONNEL SHALL RESTRICT ACTIVITIES TO THE DESIGNATED WORK AND MOBILIZATION AREAS.
- 3. HAND POWER TOOLS USED TO DRILL, CUT INTO, OR OTHERWISE DISTURB ASBESTOS—CONTAINING MATERIAL (ACM) SHALL BE MANUFACTURER EQUIPPED WITH HEPA—FILTERED LOCAL EXHAUST VENTILATION, PER APPLICABLE REGULATIONS.
- 4. CONTRACTOR SHALL PROVIDE AS MANY SHIFTS OF CERTIFIED HANDLERS AND SUPERVISORS AS WILL BE NECESSARY TO COMPLETE THE PROJECT IN THE AMOUNT OF TIME SPECIFIED IN THE CONTRACT DOCUMENTS.
- 5. ALL PENETRATIONS THROUGH EXTERIOR WALLS INCLUDING, BUT NOT LIMITED TO, PIPES, DUCTS, AND CONDUITS AS REQUIRED BY THE FIELD CONDITIONS SHALL BE LOCATED AND SEALED WITH NON—ACM FIRESTOPPING MATERIALS BY THE CONTRACTOR PRIOR TO ABATEMENT.
- 6. THE CONTRACTOR SHALL PROVIDE THE BEST AVAILABLE TECHNOLOGY AND STATE—OF—THE—ART PROCEDURES AND METHODS PER APPLICABLE REGULATIONS OF EXECUTION FOR ASBESTOS REMOVAL, CLEANUP, DISPOSAL AND SAFETY.
- 7. THE CONTRACTOR'S ELECTRICIAN AND/OR PLUMBER SHALL CONFIRM ALL UTILITIES PASSING THROUGH THE WORK AREAS HAVE BEEN DISCONNECTED.
- 8. THE CONTRACTOR SHALL APPLY FOR A SITE SPECIFIC VARIANCE, IF NEEDED.
- 9. EVERY EFFORT HAS BEEN MADE BY THE OWNER TO LOCATE ALL ACM IN EACH AREA OF WORK WITHIN EACH BUILDING. THE CONTRACTOR IS RESPONSIBLE FOR VISITING THE JOB SITE AND DETERMINING THE EXACT QUANTITIES OF ACM TO BE
- 10. THE OWNER HAS INSPECTED AND IDENTIFIED MATERIALS WHICH WERE OBSERVABLE AND ACCESSIBLE TO THE SURVEY TEAM. IN THE EVENT THAT CONCEALED SUSPECT ACM NOT INCLUDED IN THE CONTRACT DOCUMENTS IS ENCOUNTERED, THE ENGINEER AND OWNER SHALL BE NOTIFIED IMMEDIATELY.
- 11. CONTRACTOR SHALL PROVIDE AND MAINTAIN TEMPORARY UTILITIES INCLUDING WATER, TOILET FACILITIES, POWER AND ELECTRICITY TO CONFORM WITH ALL PERTINENT FEDERAL, STATE AND LOCAL CODES. A LICENSED ELECTRICIAN AND/OR PLUMBER SHALL PROVIDE ALL CONNECTIONS.
- 12. THE ABATEMENT AND DEMOLITION WORK UNDER THIS CONTRACT MAY EXTEND DURING THE RAINY AND WINTER SEASON. THE CONTRACTOR SHALL PROVIDE ENOUGH SITE FACILITIES EQUIPPED WITH HEATING SYSTEM TO ACCOMMODATE ALL HIS WORKERS ON—SITE.
- 13. THE GENERAL SEQUENCE OF THE ACM REMOVAL OPERATION SHALL BE FROM MOST FRIABLE TO LEAST FRIABLE MATERIALS.
- 14. ACM SHALL NOT BE DROPPED UNDER ANY CIRCUMSTANCES FROM ANY HEIGHT. AN ENCLOSED MECHANICAL HOIST OR EQUIVALENT SHALL BE USED TO LOWER AND RAISE THE ACM.
- 15. THE CONTRACTOR SHALL FIELD LOCATE AIR FILTRATION DEVICES (AFDs) AS NECESSARY FOR THE COMPLETION OF HIS WORK.
- 16. THE CONTRACTOR SHALL ESTABLISH ONE (1) DECONTAMINATION ENCLOSURE SYSTEM CONTIGUOUS TO EACH WORK AREA UNDER FULL CONTAINMENT. DECONTAMINATION ENCLOSURES SHALL BE ATTACHED DIRECTLY TO THE ACTIVE WORK AREA AND POSITIONED TO FACILITATE WASTE LOAD OUT. THE CONTRACTOR SHALL FIELD LOCATE DECONTAMINATION ENCLOSURE SYSTEM AS NECESSARY FOR THE PERFORMANCE OF THE WORK. THE WASTE HOLDING AREA SHALL BE SUFFICIENT ENOUGH TO HOLD ALL ACCUMULATED ACM WASTE PRIOR TO DISPOSAL. ALL DECONTAMINATION ENCLOSURE SYSTEMS SHALL BE FULLY FRAMED AND HARD—WALL SHEATHED FOR SAFETY AND SECURITY.
- 17. THE CONTRACTOR SHALL UTILIZE REMOTE DECONTAMINATION ENCLOSURE SYSTEMS FOR ABATEMENT ACTIVITIES OCCURRING ON EXTERIOR AREAS. THE REMOTE DECONTAMINATION ENCLOSURE SYSTEMS SHALL BE LOCATED WITHIN 25 FEET OF THE WORK AREA. THE WASTE HOLDING AREA SHALL BE SUFFICIENT ENOUGH TO HOLD ALL ACCUMULATED ACM WASTE PRIOR TO DISPOSAL. ALL DECONTAMINATION ENCLOSURE SYSTEMS SHALL BE FULLY FRAMED AND HARD—WALL SHEATHED FOR SAFETY AND SECURITY.
- 18. ALL DIMENSIONS INDICATED ON THE DRAWINGS ARE APPROXIMATE. THE INFORMATION PROVIDED HEREIN IS BASED ON AVAILABLE RECORDS AND LIMITED FIELD INSPECTIONS AND SHALL SERVE TO AID THE CONTRACTOR IN THE EVALUATION OF EXISTING STRUCTURE CONDITIONS, BUT SHALL NOT BE HELD TO BE ACCURATE OR ALL—INCLUSIVE. THE CONTRACTOR SHALL BE RESPONSIBLE FOR INSPECTING THE STRUCTURE AND ASSOCIATED SITE CONDITIONS TO BECOME FAMILIAR WITH AND VERIFY EXISTING CONDITIONS PRIOR TO SUBMISSION OF BIDS, AND SHALL MAKE NO ADDITIONAL CLAIMS REGARDING SITE CONDITIONS THEREAFTER.
- 19. BEFORE COMMENCEMENT OF WORK, THE CONTRACTOR SHALL APPLY FOR AND OBTAIN ALL APPLICABLE PERMITS FROM FEDERAL, STATE AND LOCAL REGULATORY AGENCIES NECESSARY TO COMPLETE THE WORK. THE CONTRACTOR SHALL ALSO BE RESPONSIBLE FOR ENSURING COMPLIANCE WITH ALL CONDITIONS AND NOTIFICATION REQUIREMENTS OF ISSUED PERMITS.
- 20. ALL WORK SHALL BE ACCOMPLISHED IN STRICT ADHERENCE TO THE CONTRACT DOCUMENTS AND SPECIFICATIONS, AND ALL APPLICABLE FEDERAL, STATE AND LOCAL REGULATIONS. WHENEVER THERE IS A CONFLICT OR OVERLAP OF THE ABOVE REFERENCES, THE MORE STRINGENT PROVISION SHALL APPLY.
- 21. PRIOR TO DEMOLITION AND/OR RENOVATION, THE CONTRACTOR SHALL PROPERLY REMOVE AND OFF-SITE DISPOSE ALL AFFECTED ASBESTOS AND HAZARDOUS MATERIALS IN ACCORDANCE WITH ALL APPLICABLE FEDERAL, STATE AND LOCAL REQUIREMENTS.
- 22. PRIOR TO ABATEMENT, THE CONTRACTOR SHALL BE RESPONSIBLE FOR THE RELOCATION OF ANY AFFECTED UTILITIES AND SERVICES IN ACCORDANCE WITH ALL APPLICABLE FEDERAL, STATE AND LOCAL REQUIREMENTS, INCLUDING ALL REQUIRED COORDINATION WITH THE APPROPRIATE UTILITY COMPANIES.
- 23. THE CONTRACTOR SHALL FIELD VERIFY THE AMOUNT OF ACM TO BE ABATED AND FAMILIARIZE HIMSELF WITH ALL VARIABLE FIELD CONDITIONS BEFORE THE SUBMISSION OF HIS BID AND COMMENCING WORK. IN THE EVENT THAT SUSPECT MATERIALS NOT INCLUDED IN THESE CONTRACT DRAWINGS ARE ENCOUNTERED WHILE THE WORK IS IN PROGRESS, SUCH MATERIAL SHALL BE TESTED AND, IF CONFIRMED ACM, REMOVED AS ACM IN ACCORDANCE WITH THE PROCEDURES CONTAINED HEREIN. THE DISCOVERY OF ANY NEW MATERIAL SHALL NOT DELAY THE PROGRESS OF THE WORK.
- 24. DO NOT UNREASONABLY ENCUMBER THE SITE WITH MATERIALS OR EQUIPMENT. CONFINE ALL THE NECESSARY MATERIALS TO THE AREAS INDICATED BY THE OWNER. THE CONTRACTOR SHALL REMOVE FROM THE SITE, AS QUICKLY AS IT ACCUMULATES, ITEMS OF SALVAGE, RUBBISH, WRECKING DEBRIS AND ASBESTOS DEBRIS.

- 25. BEFORE STARTING ANY WORK, THE CONTRACTOR SHALL EXAMINE THE TECHNICAL SPECIFICATIONS FOR COMPLIANCE WITH CODES AND REGULATIONS APPLICABLE TO THE WORK AND SHALL IMMEDIATELY REPORT ANY DISCREPANCY TO THE ENGINEER.
- 26. REMOVAL OF OTHER REGULATED AND/OR HAZARDOUS MATERIAL SHALL BE COORDINATED WITH ASBESTOS ABATEMENT SO AS TO NOT COMMINGLE WASTE STREAMS.
- 27. THE CONTRACTOR SHALL BE RESPONSIBLE FOR THE SEGREGATION AND DISPOSAL OF HAZARDOUS AND REGULATED WASTE FROM ACM WASTE DURING THE WORK.
- 28. THE CONTRACTOR IS ADVISED THAT THE WORK OF THE CONTRACT MAY IMPOSE CERTAIN OBLIGATIONS AND REQUIREMENTS MANDATED BY THE U.S. DEPARTMENT OF LABOR OCCUPATIONAL SAFETY & HEALTH ADMINISTRATION REGULATIONS FOUND AT TITLE 29 CFR 1926.62 (LEAD EXPOSURE IN CONSTRUCTION), RELATIVE TO THE POTENTIAL EXPOSURE TO LEAD BY ITS EMPLOYEES. THE CONTRACTOR ASSUMES ENTIRE RESPONSIBILITY AND LIABILITY FOR COMPLYING FULLY IN ALL RESPECTS WITH THESE REGULATIONS. ADDITIONALLY, IF THE SCOPE OF WORK REQUIRES THE CONTRACTOR TO SCRAPE LOOSE PAINT, THEN THE WASTE GENERATED SHALL BE ANALYZED FOR APPROPRIATE WASTE DISPOSAL.
- 29. THE HAZARDOUS MATERIAL WORK LISTED HEREIN SHOULD BE COORDINATED WITH THE DEMOLITION AND ARCHITECTURAL DRAWINGS.
- 30. THE CONTRACTOR SHALL MANAGE ASBESTOS—CONTAINING MATERIALS IN ACCORDANCE WITH SPECIFICATION SECTION 02 82 13 (ASBESTOS REMOVAL) AND ALL OTHER HAZARDOUS MATERIALS IN ACCORDANCE WITH SPECIFICATION SECTION 02 83 00 (HAZARDOUS MATERIALS REMOVAL).
- 31. LEAD IN PAINT ANALYTICAL RESULTS ARE SUMMARIZED IN THE HAZARDOUS MATERIALS ASSESSMENT REPORT. SEE SECTION 02 83 00 (HAZARDOUS MATERIALS REMOVAL) REGARDING MANAGEMENT.
- 32. FOR BIDDING PURPOSES, THE CONTRACTOR SHALL ASSUME THAT ALL PAINT CHIPS GENERATED DURING THE WORK SHALL BE MANAGED AS HAZARDOUS WASTE IN ACCORDANCE WITH 40 CFR 260 THROUGH 268 AND 6 NYCRR 370 THROUGH 376. SEE SECTION 02 83 00 (HAZARDOUS MATERIALS REMOVAL) FOR FURTHER INSTRUCTIONS.
- 33. THE ABATEMENT CONTRACTOR SHALL COORDINATE WITH THE GENERAL CONTRACTOR TO DETERMINE THE QUANTITY OF STUCCO TO BE REMOVED AROUND EACH OF THE CRACKS AND SPALLS SHOWN ON THESE DRAWINGS. THE GENERAL CONTRACTOR SHALL BE REQUIRED TO PERFORM ALL NECESSARY TESTING (E.G., SOUNDING) TO DETERMINE THE LIMITS OF STUCCO REMOVAL AND COMMUNICATE THOSE LIMITS OF REMOVAL TO THE CONTRACTOR.
- 34. THE ABATEMENT CONTRACTOR SHALL REMOVE ROOFING MATERIALS NECESSARY TO ALLOW PERFORMANCE OF THE WORK CONTAINED IN THESE CONTRACT DOCUMENTS. THE GENERAL CONTRACTOR SHALL COMMUNICATE THE LIMITS OF ROOFING MATERIALS REMOVAL (E.G., IN THE VICINITY OF NEW PENETRATIONS) NECESSARY TO FACILITATE PERFORMANCE OF THE WORK TO THE ABATEMENT CONTRACTOR.

STUCCO REMOVAL FOR REPAIR OF DEFECTS:

- I. REMOVAL OF EXTERIOR STUCCO WILL BE REQUIRED TO REPAIR DEFECTS IN THE EXISTING STUCCO FINISH, INCLUDING CRACK REPAIR, SPALL REPAIR AND REPLACEMENT.
- 2. FOR SCOPE OF REPAIR OF DEFECTS IN THE EXTERIOR STUCCO FINISH, REFER TO THE STRUCTURAL REPAIR DRAWINGS (SR-001 THROUGH SR-115).

STUCCO REMOVAL FOR NEW WORK:

- 1. REMOVAL OF EXTERIOR STUCCO FINISH WILL BE REQUIRED FOR THE REMOVAL AND INSTALLATION OF BUILDING IMPROVEMENTS, INCLUDING BUT NOT LIMITED TO DOORS, WINDOWS, WALL PENETRATIONS, ETC.
- 2. FOR SCOPE OF NEW WORK, REFER TO ARCHITECTURAL, MECHANICAL AND PLUMBING DRAWINGS.

SUMMARY OF REGULATED ASBESTOS-CONTAINING MATERIALS											
MATERIAL DESCRIPTION	LOCATION	APPROXIMATE QUANTITY *	ABATEMENT PROCEDURE								
EXTERIOR WALL STUCCO (SEE NOTE 33)	EXTERIOR OF NORTH AND SOUTH VENDOR SPACES AND BEACHFRONT ELEVATION	6,220 SF	FULL CONTAINMENT WITH ATTACHED PERSONAL AND WASTE								
EXTERIOR CONCRETE PATCH ON BRICK	NORTH VENDOR SPACE, SPACE OF NORTH FACING WALL	5 SF	DECONTAMINATION UNIT								
WATERPROOFING TAR BENEATH BRICK COPING STONE	EXTERIOR WALL FACING BEACH	112 SF	EXTERIOR PROJECT - REMOVAL OF ACM MATERIALS WITH A REMOTE PERSONAL AND WASTE DECONTAMINATION UNIT								
ROOFING MATERIALS (ASSUMED) (SEE NOTE 34)	ADJACENT SOUTH BUILDING	50 SF	EXTERIOR PROJECT - REMOVAL OF ACM MATERIALS WITH A REMOTE PERSONAL AND WASTE DECONTAMINATION UNIT								

*THE CONTRACTOR SHALL BE RESPONSIBLE FOR PERFORMING THE NECESSARY INVESTIGATION TO DETERMINE THE EXTENT OF REMOVAL REQUIRED PRIOR TO PERFORMING ANY ABATEMENT WORK. REFER TO STRUCTURAL REPAIR DRAWINGS FOR MORE INFORMATION.

SUMMARY OF MATERIALS CONTAINING GREATER THAN 50 PPM PCBs							
WASTE DESCRIPTION	QUANTITY*						
EXTERIOR FOUNDATION WALL CAULK	NORTH VENDOR SPACE, SOUTH FACING WALL	40 LINEAR FEET (69 PPM)					

SUMMARY OF SUSPECT PCB-CONTAINING ITEMS					
WASTE TYPE	LOCATION	QUANTITY*			
	CHLORINE ROOM, SOUTH VENDOR SPACE	4			
	WOMEN'S RESTROOM - SLOP SINK ROOM	1			
BALLASTS	WOMEN'S LOCKER ROOM - HOT WATER HEATER ROOM	2			
	HALL TO POOL FILTRATION ROOM	2			
	POOL FILTRATION ROOM	4			

SUMMARY OF UNIVERSAL WASTE				
WASTE TYPE	LOCATION	QUANTITY*		
FLUORESCENT BULBS	LAMP POSTS, SURROUNDING POOL	7		
	CHLORINE ROOM, SOUTH VENDOR SPACE	16		
	WOMEN'S RESTROOM - SLOP SINK ROOM	2		
	WOMEN'S LOCKER ROOM - HOT WATER HEATER ROOM	4		
	HALL TO POOL FILTRATION ROOM	4		
	POOL FILTRATION ROOM	8		

SUMMARY OF REFRIGERANT-CONTAINING EQUIPMENT						
WASTE DESCRIPTION	LOCATION	QUANTITY*				
REFRIGERATION UNITS	NORTH VENDOR SPACE - CONCESSION AREA	8				
ICE MACHINE	NORTH VENDOR SPACE - CONCESSION AREA	1				

SUMMARY OF CHEMICAL AND PETROLEUM PRODUCTS					
WASTE DESCRIPTION	LOCATION	QUANTITY*			
PAINT	SOUTH VENDOR SPACE - VACANT/STORAGE	TWENTY 1-GALLON CONTAINERS			
CLEANER/SANITIZER	WOMEN'S RESTROOM - SLOP SINK ROOM	ONE 5-GALLON CONTAINER			
	NORTH VENDOR SPACE - CONCESSION AREA	1			
FIRE EXTINGUISHERS	WOMEN'S LOCKER ROOM	1			
	MEN'S LOCKER ROOM	1			





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CONTRACTOR

PROJECT COORDINATOR

NAME

SIGNATURE

SIGNATURE

TITLE

DATE

TITLE

DATE

DATE

DEPARTMENT OF PUBLIC WORKS & TRANSPORTATION
DIVISION OF ENGINEERING

REHABILITATION OF POOL AND BATHHOUSE
PLAYLAND PARK, RYE, NEW YORK
HAZARDOUS MATERIAL ABATEMENT
GENERAL NOTES


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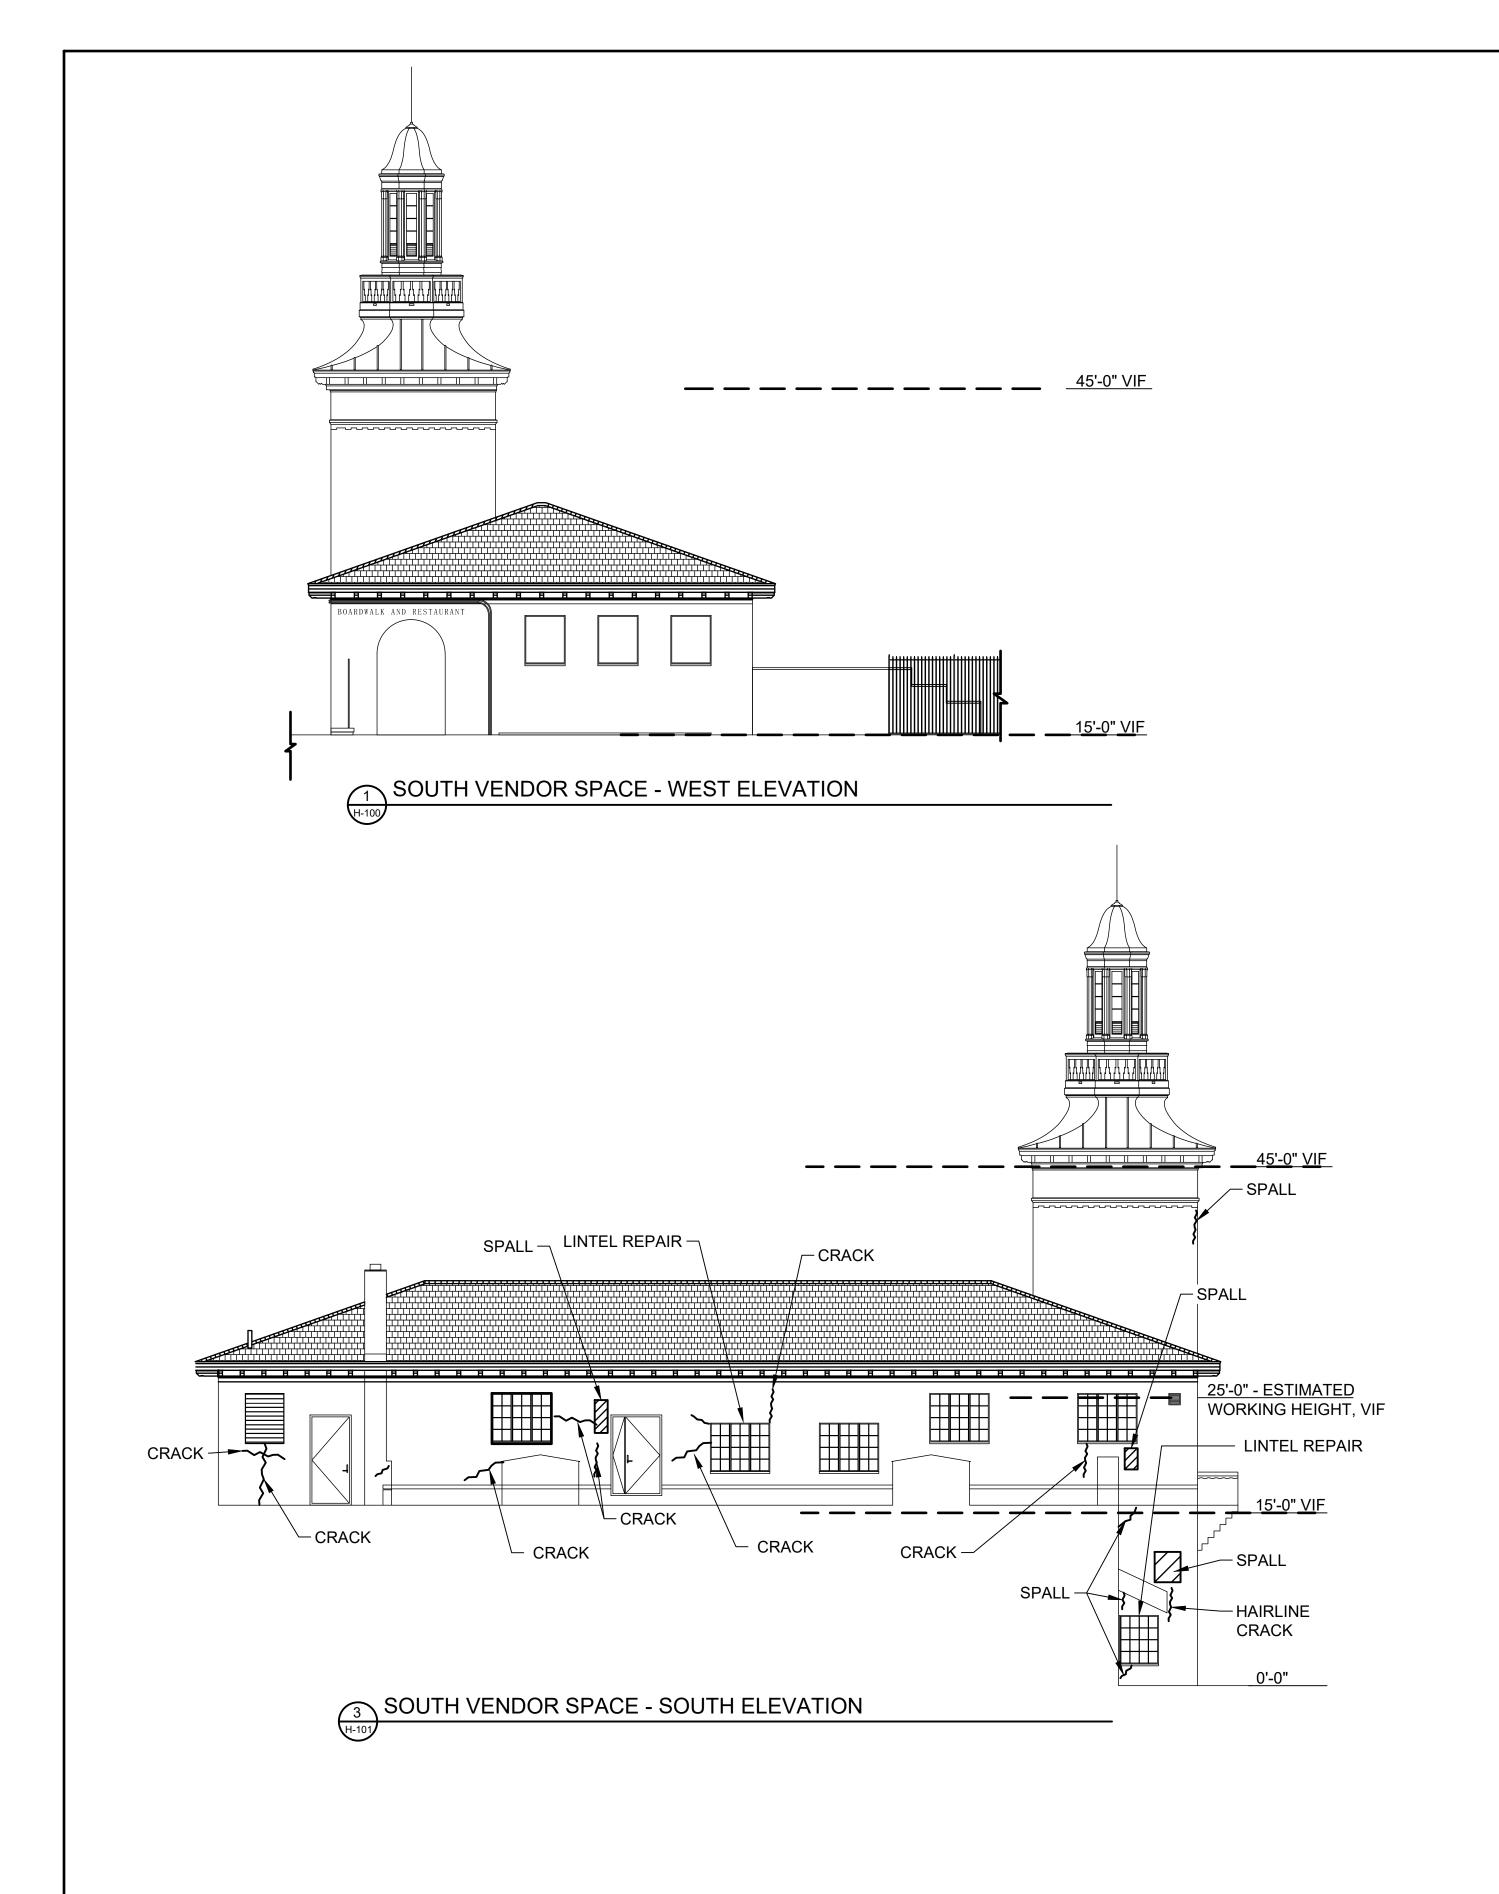
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20-504 H-001


SHEET NO. 197 OF 201

SCALE: AS NOTED
DATE: NOVEMBER 10, 2020

DPW FILE NO. REV. NO. 1-19-G-554 0



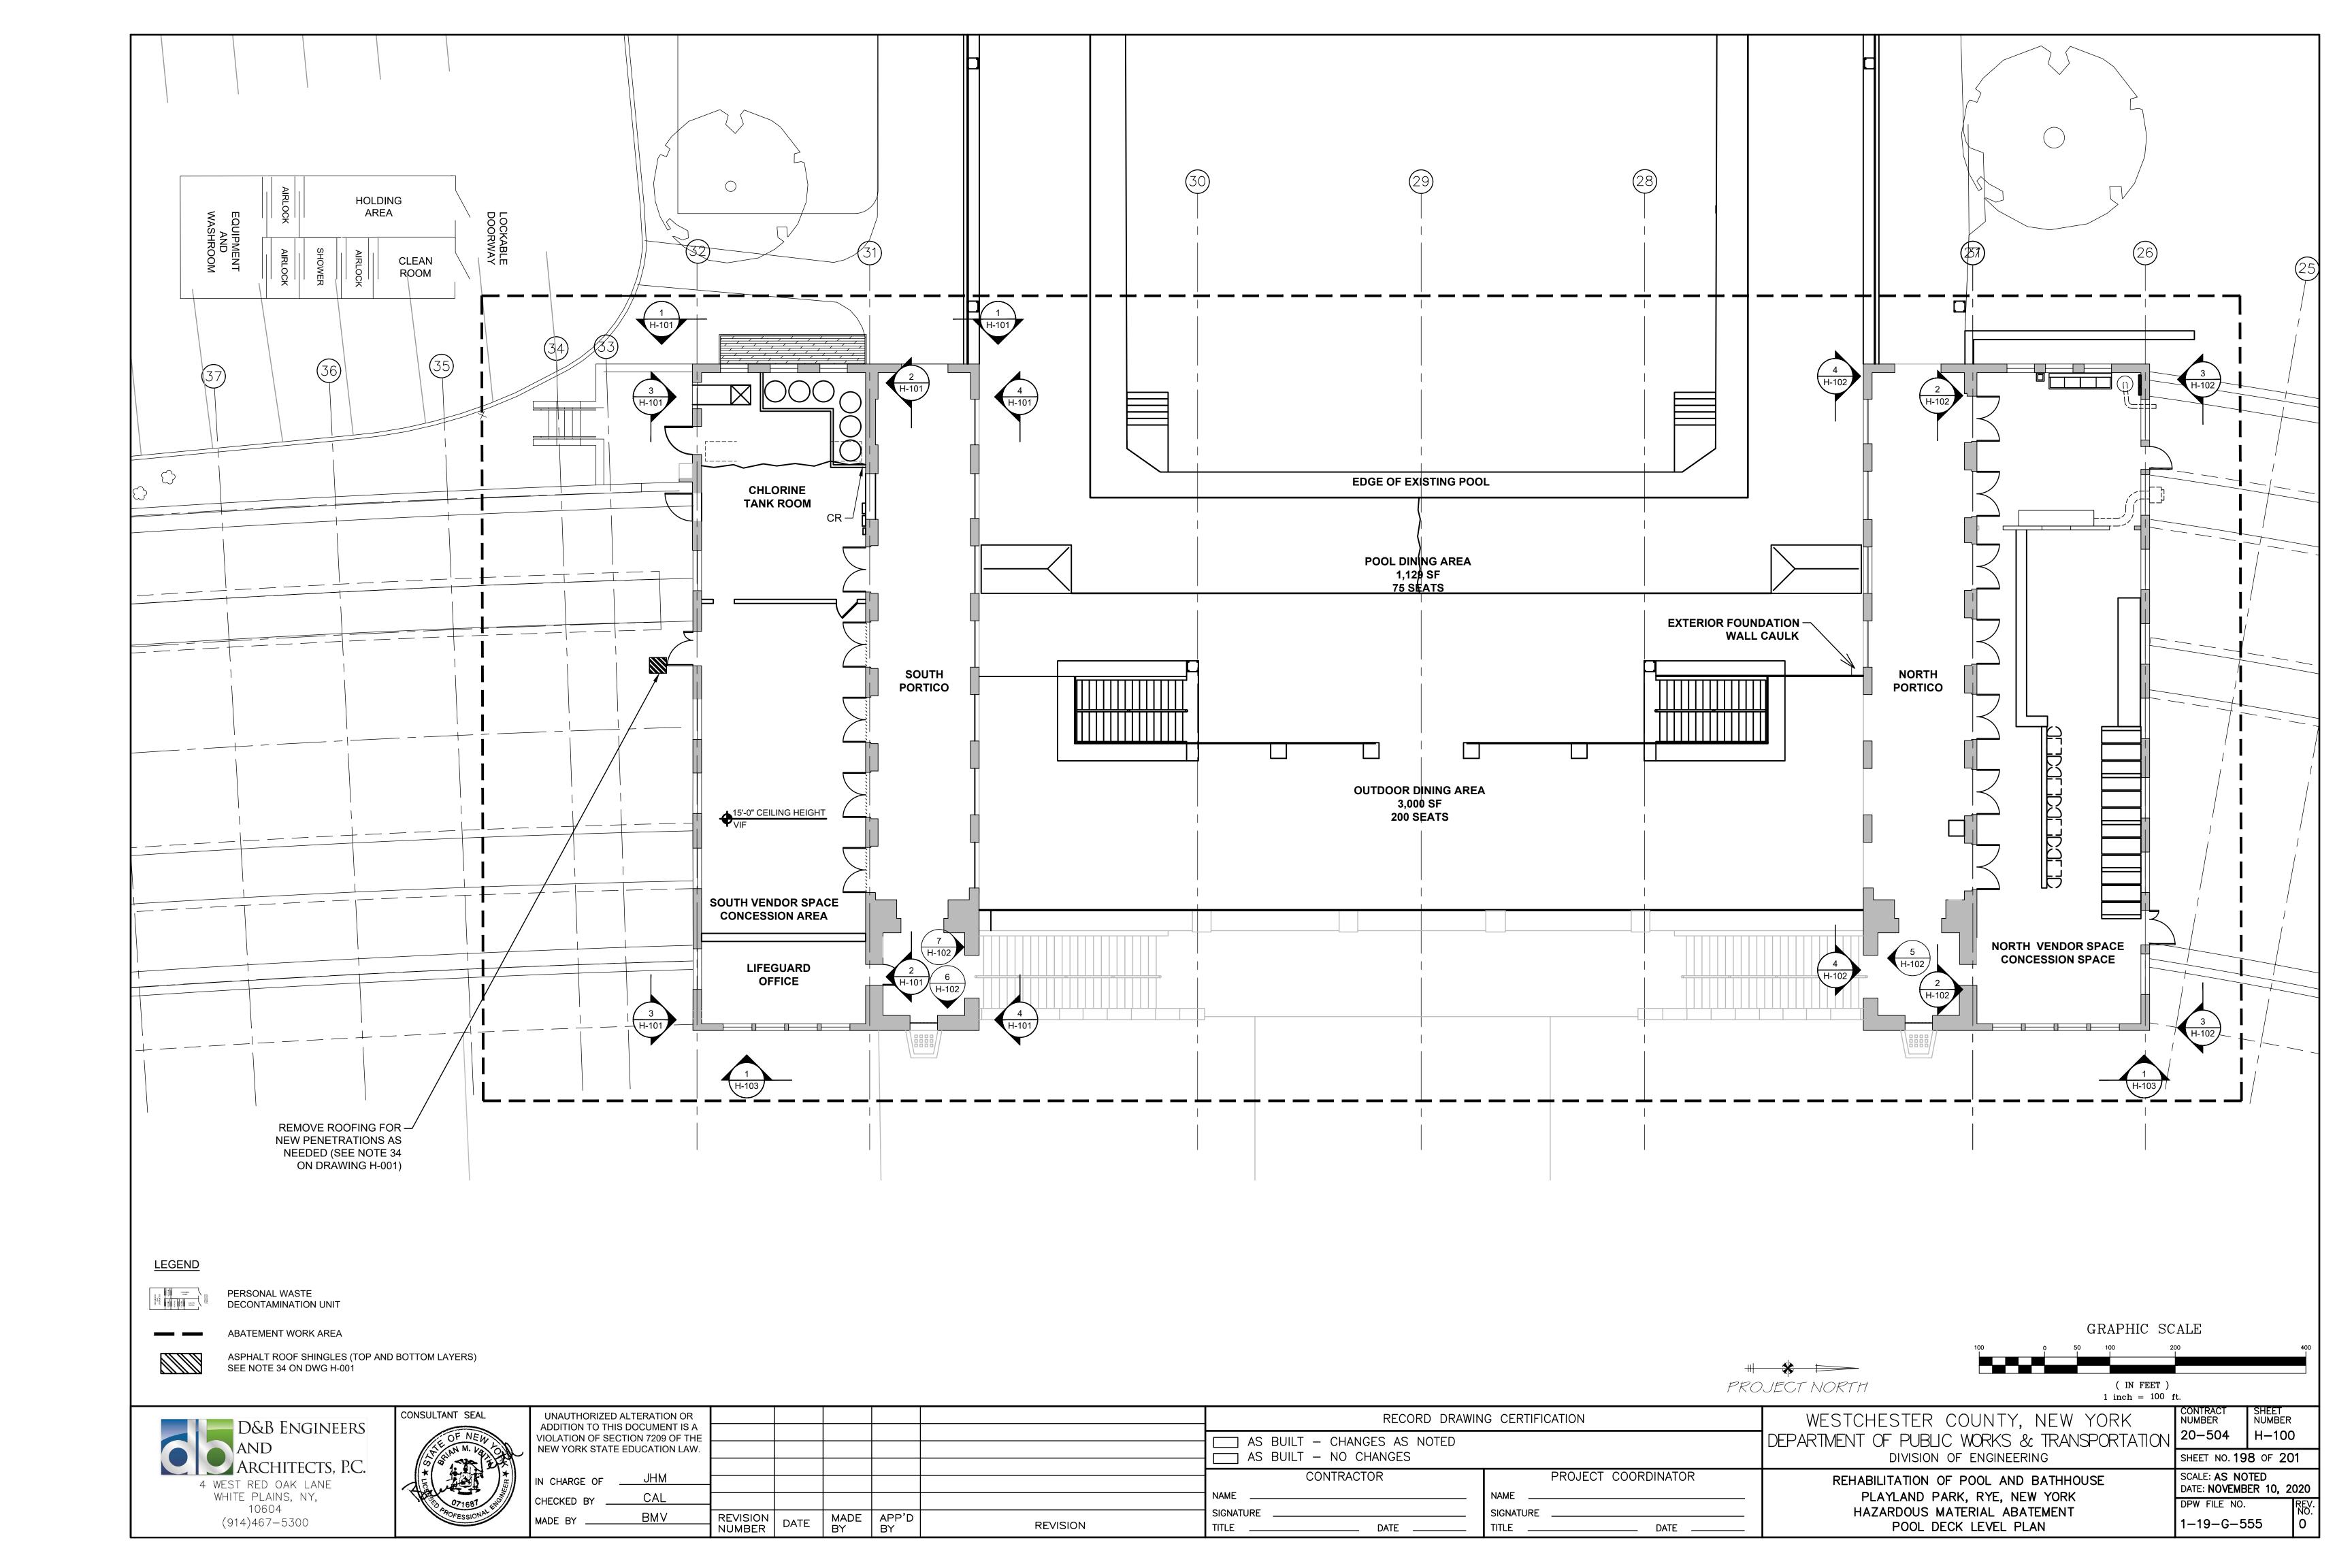

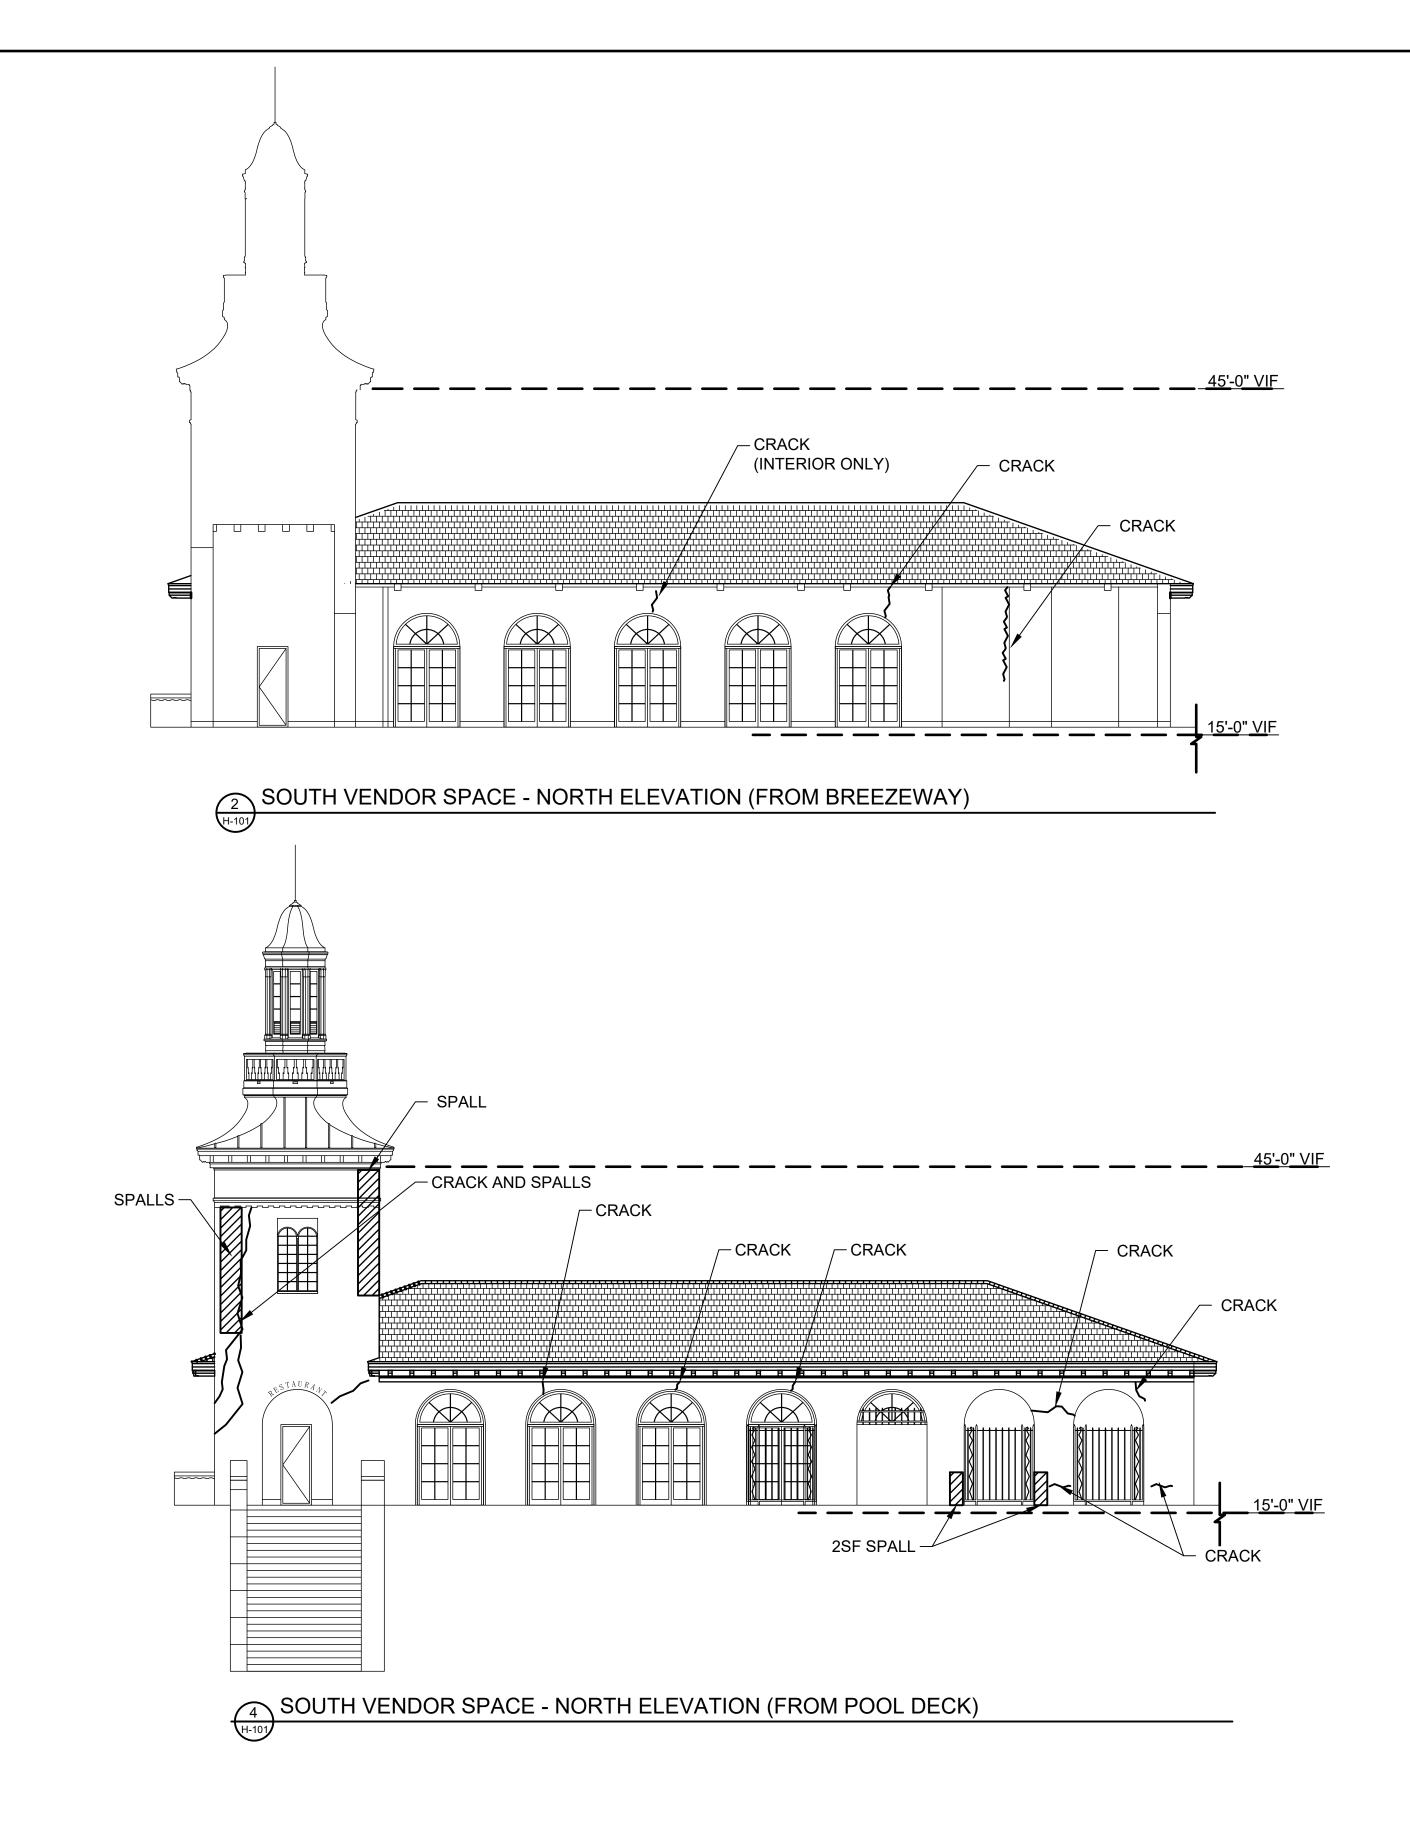

<u>LEGEND</u>

STUCCO REMOVAL (IN ADDITION TO THE MATERIAL SHOWN ON THIS SHEET, SEE NOTE 33 ON DWG H-001)

(914)467-5300

CONSULTANT SEAL D&B ENGINEERS 4 WEST RED OAK LANE WHITE PLAINS, NY, 10604

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GRAPHIC SCALE (IN FEET) 1 inch = 100 ft. WESTCHESTER COUNTY,

PLAYLAND PARK, RYE, NEW YORK

SOUTH VENDOR SPACE EXTERIOR ELEVATIONS

HAZARDOUS MATERIAL ABATEMENT

ESTCHESTER COUNTY, NEW YORK TMENT OF PUBLIC WORKS & TRANSPORTATION		SHEET NUMBER H-101
DIVISION OF ENGINEERING	SHEET NO. 19	9 OF 201
REHABILITATION OF POOL AND BATHHOUSE	SCALE: AS NO DATE: NOVEMB	

DPW FILE NO.

1-19-G-556

