


EDGEMONT SCHOOL DISTRICT TOILET RENOVATION AND RELATED WORK AT HIGH SCHOOL ADMINISTRATION BUILDING 300 WHITE OAK LANE, SCARSDALE, NY 10583

SED PROJECT NUMBERS:

HIGH SCHOOL ADMINISTRATION BUILDING:
66-04-06-03-0-011-012

EDGEMONT HIGH SCHOOL
300 WHITE OAK LANE, SCARSDALE, NY 10583

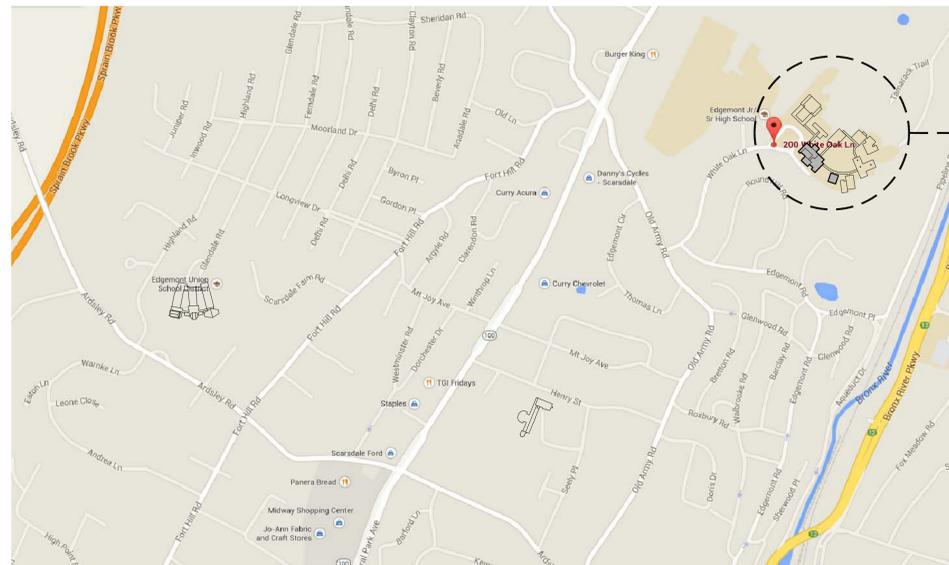

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**ARCHITECTS
PLANNERS**


45 KNOLLWOOD ROAD ELMSFORD NEW YORK 10523
TEL 914.592.4444 FAX 914.592.1717
WWW.FULLERDANGELO.COM

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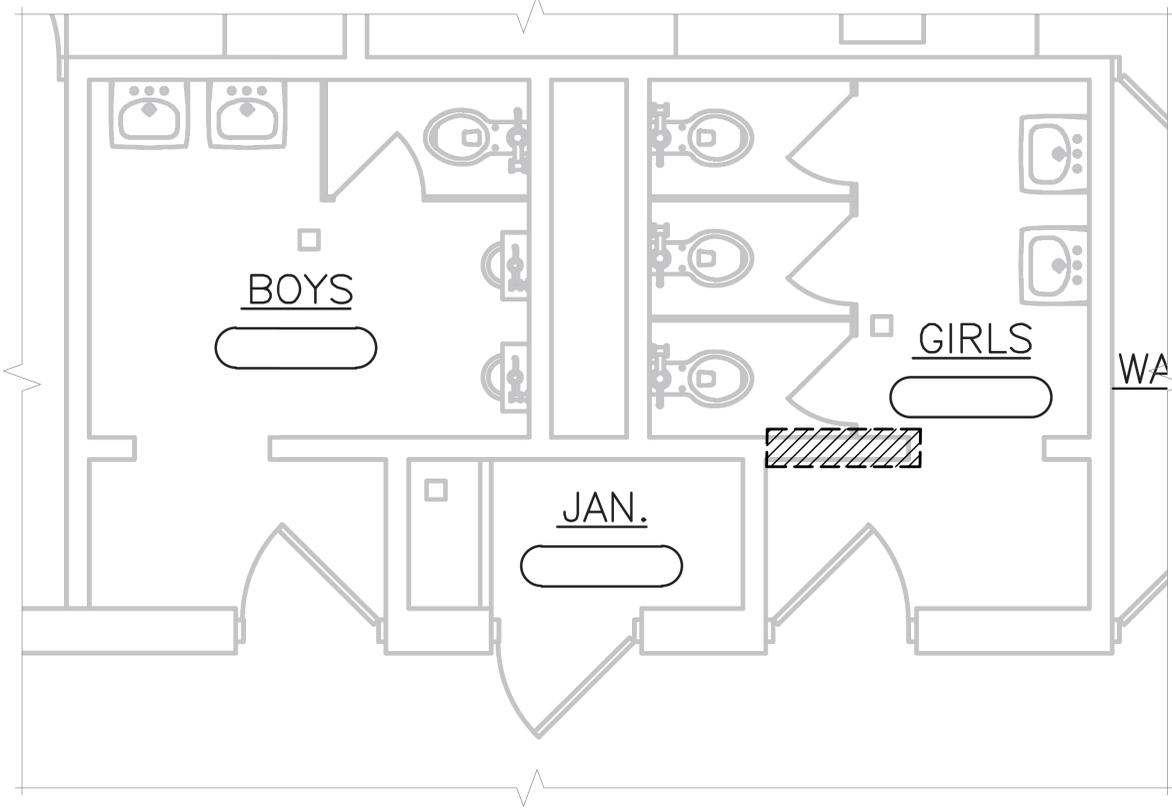
CONSULTANTS:

ENVIRONMENTAL :
WARREN & PANZER
228 EAST 45TH STREET
NEW YORK, NY 10017
phone: 212.922.0077
fax: 212.922.0630

02-24-2021	BID
07-01-2015	SED SUBMISSION
DATE	ISSUED TO
SCALE	DRAWING NO.
AS NOTED	T-1
DRAWN BY F & D	CHECKED BY F & D
CHECKED BY F & D	FILE NO. 20381.00

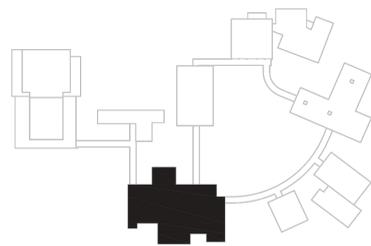


KEY PLAN
SCALE: N.T.S.



1 GANG BATHROOMS - FIRST FLOOR PLAN - ADMIN BLDG
SCALE: N.T.S.

KEY			
MATERIAL	LOCATION	APPROXIMATE QUANTITY	LEGEND
PLASTER	ENTRY DIVIDER WALL	120 SF	
LIGHTWEIGHT CONCRETE DECK/ FIBERBOARD	CEILING	150 SF	
PIPE INSULATION AND FITTINGS	ABOVE CEILING	140 LF	

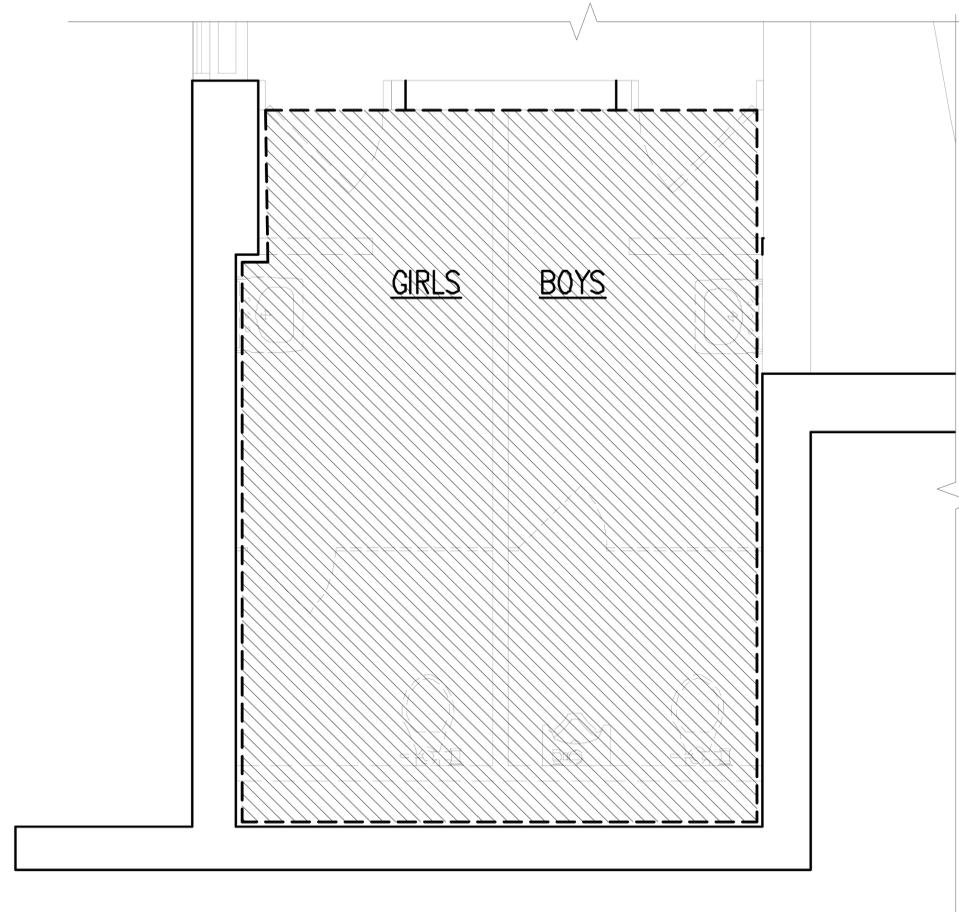

2 AUDITORIUM BATHROOMS - FIRST FLOOR PLAN - ADMIN BLDG
SCALE: N.T.S.

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ENVIRONMENTAL CONSULTANTS:
warren panzer
208 EAST 45TH STREET
2ND FLOOR
NEW YORK, NY 10017
TEL: 917-899-4444
48 SCHLITZWOOD ROAD ELMSFORD NEW YORK 10523
TEL: 914-899-4444
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PLANNERS**


SEAL:

S.E.D. CONTROL NUMBER
HIGH SCHOOL ADMINISTRATION BUILDING
16-04-00-00-001-012

PROJECT TITLE
EDGEMONT SCHOOL DISTRICT
ADMINISTRATION BUILDING
TOILET RENOVATIONS AND RELATED WORK
300 WHITE OAK LANE, SCHENECTADY NY 12305


DRAWING TITLE
ADMIN BUILDING TOILETS ASBESTOS
CONTAINING MATERIAL LOCATION

02-24-2021	BID
07-01-2015	S.E.D. SUBMISSION
DATE	ISSUED TO
SHEET SIZE 30"x42"	DRAWING NO.
SCALE AS NOTED	ASB-200
DRAWN BY F & D	FILE NO. 20381.00

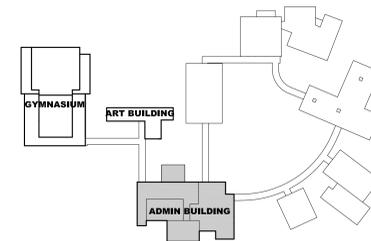


KEY PLAN
SCALE N.T.S.

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1 ADMINISTRATION BUILDING - FIRST FLOOR PLAN
SCALE: 1/8" = 1'-0"

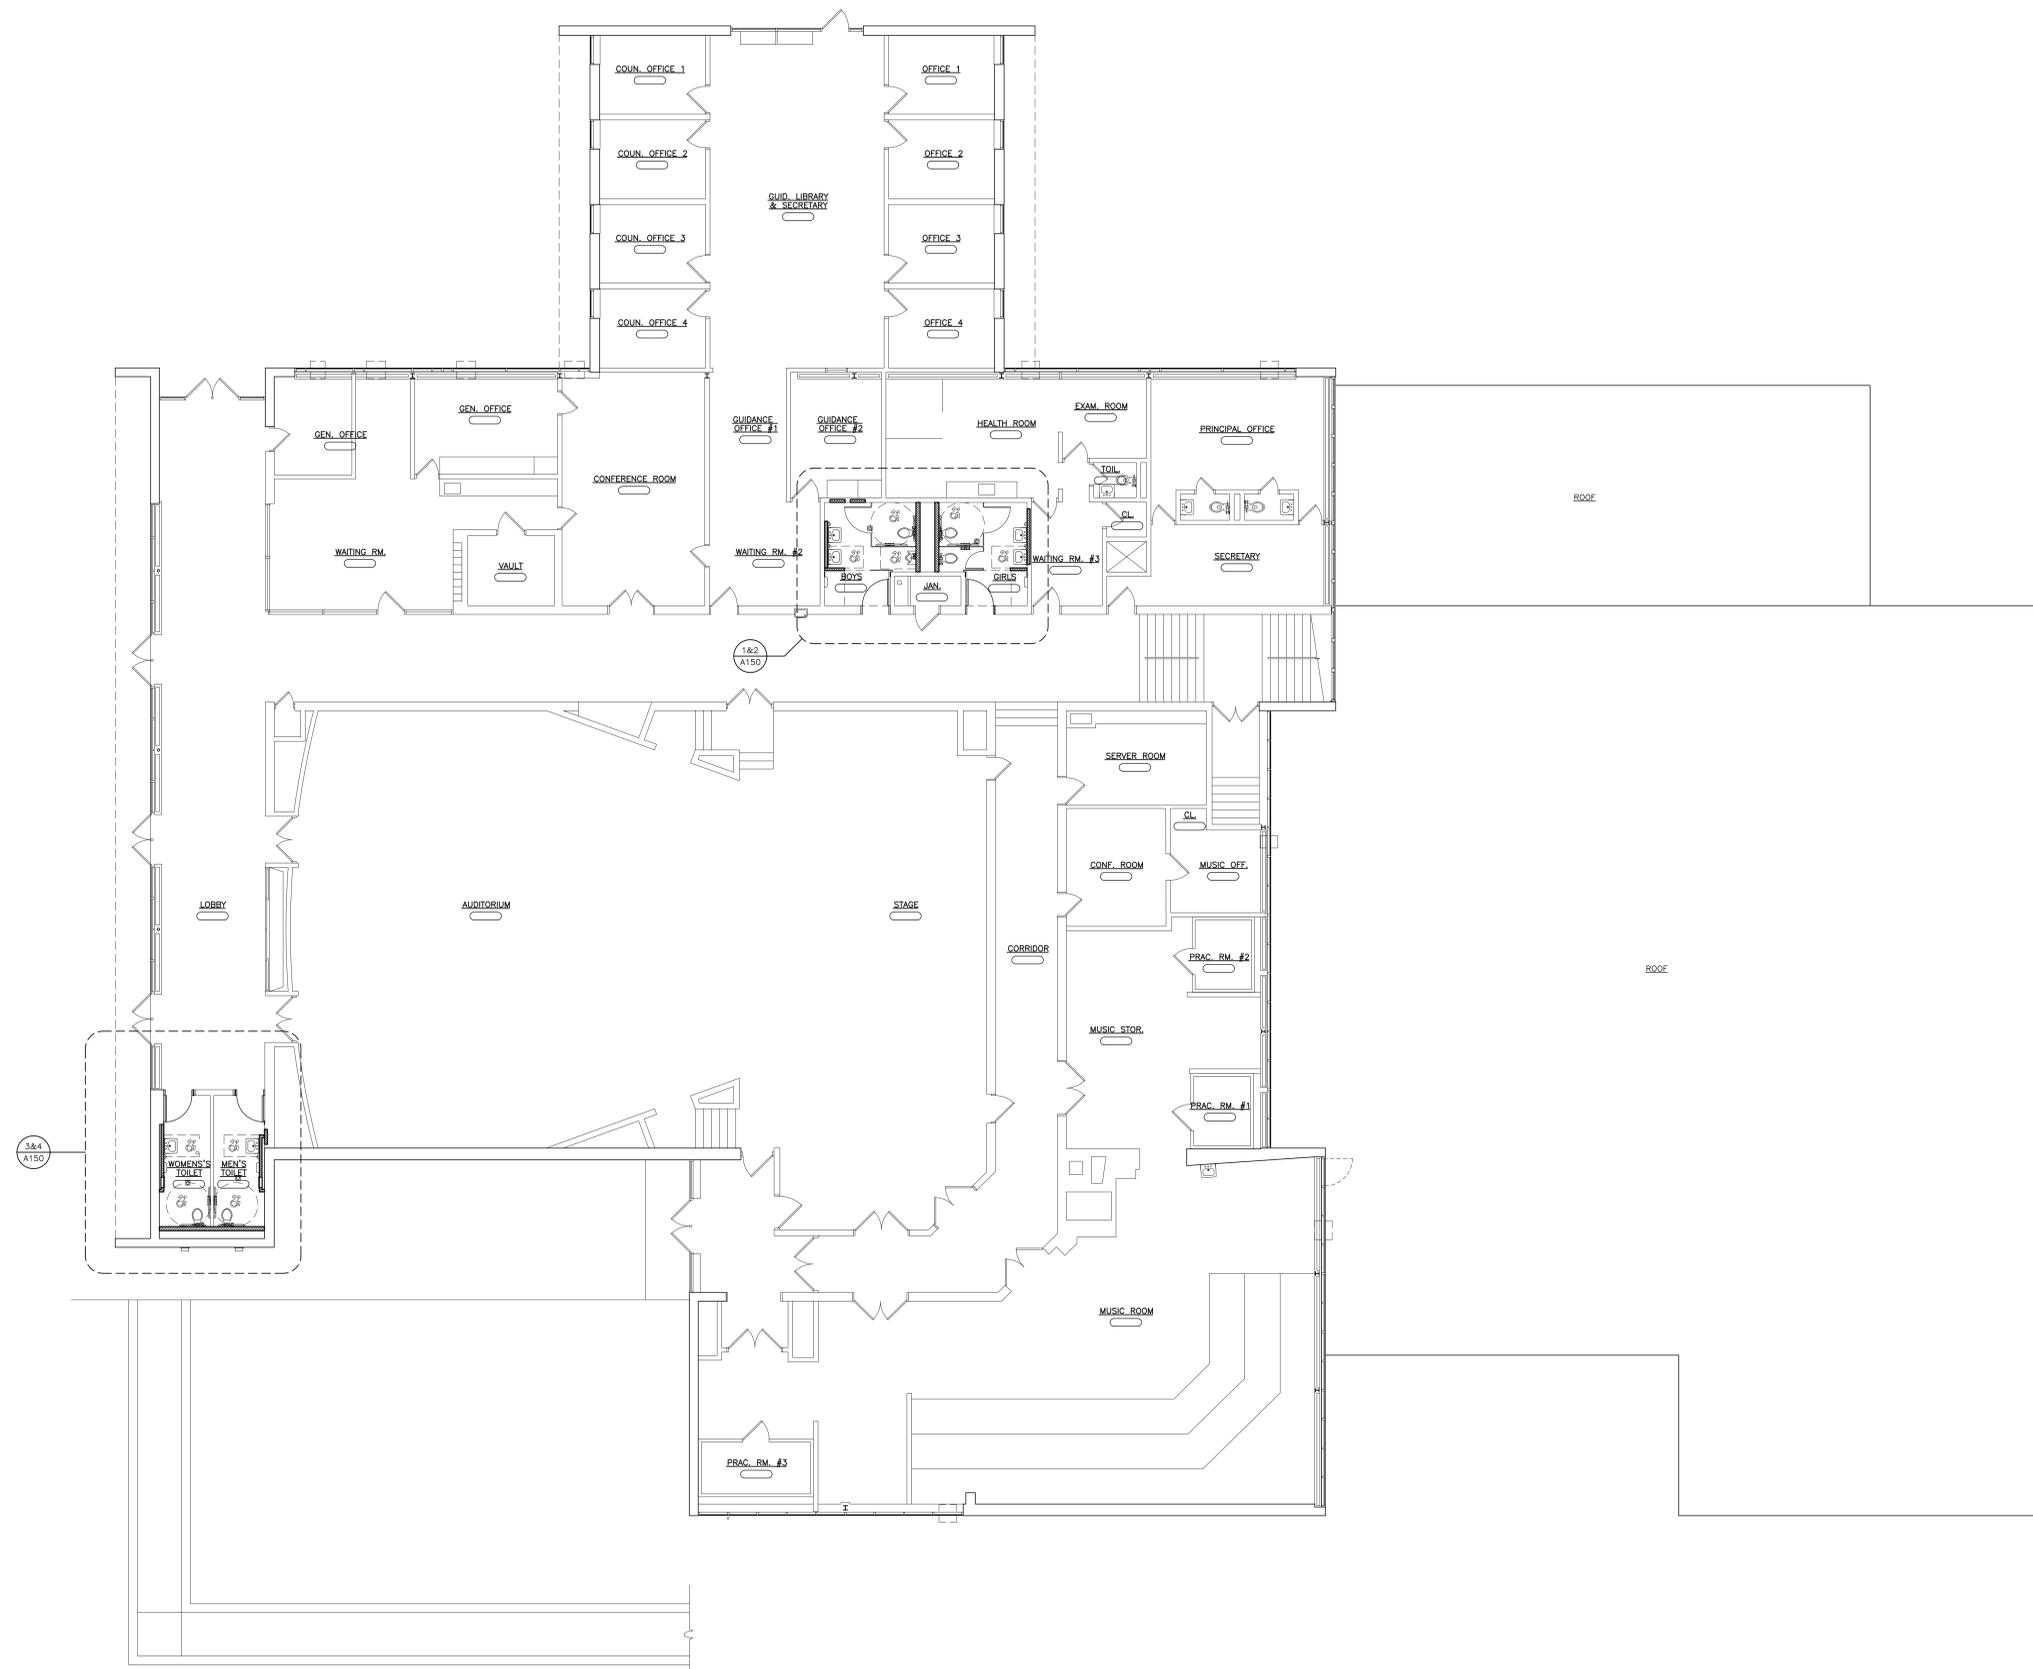

PLOT DATE: February 23, 2021 - 3:40pm
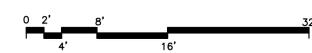
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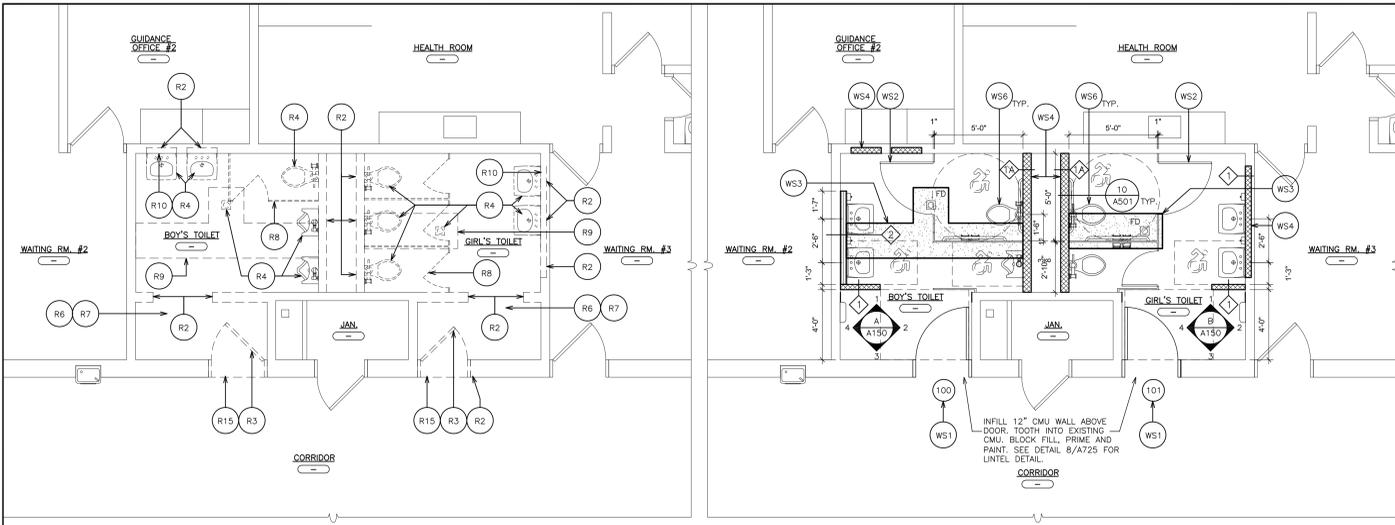
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P.C.**
**ARCHITECTS
PLANNERS**

S.E.D. CONTROL NUMBER:
HIGH SCHOOL ADMINISTRATION BUILDING
#6248000011012

PROJECT TITLE:
EDGEMONT SCHOOL DISTRICT
ADMINISTRATION BUILDING
TOILET RENOVATIONS AND RELATED WORK
300 WHITE OAK LANE, SCHENECTADY, NY 10883


DRAWING TITLE:
ADMINISTRATION BUILDING
FIRST FLOOR PLAN

02-24-2021	BID
07-01-2015	S.E.D. SUBMISSION
DATE	ISSUED TO
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SCALE AS NOTED	
DRAWN BY F & D	FILE NO. 20381.00




1 PARTIAL FIRST FLOOR REMOVAL PLAN
SCALE: 1/4" = 1'-0"


2 PARTIAL FIRST FLOOR PLAN
SCALE: 1/4" = 1'-0"

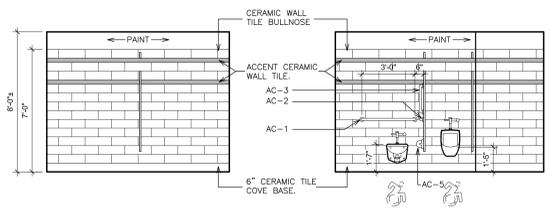

A INTERIOR ELEVATIONS- BOY'S TOILET
SCALE: 1/4" = 1'-0"

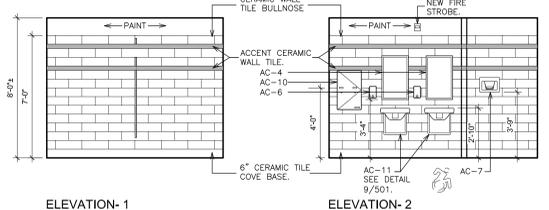


B INTERIOR ELEVATIONS- GIRL'S TOILET
SCALE: 1/4" = 1'-0"

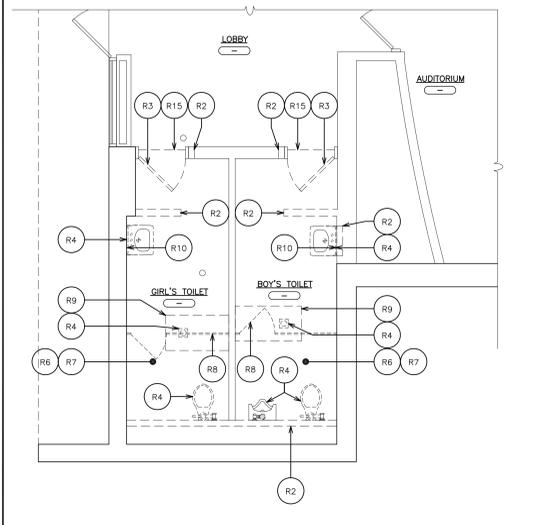


3 PARTIAL FIRST FLOOR REMOVAL PLAN
SCALE: 1/4" = 1'-0"

4 PARTIAL FIRST FLOOR PLAN
SCALE: 1/4" = 1'-0"

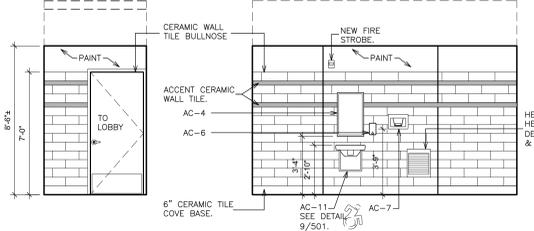

C INTERIOR ELEVATIONS- MEN'S TOILET
SCALE: 1/4" = 1'-0"

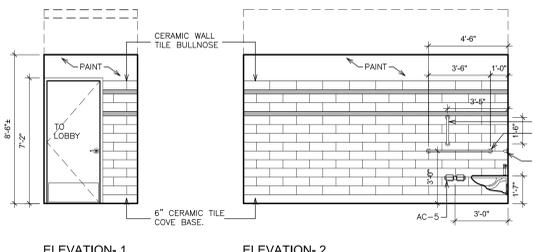

D INTERIOR ELEVATIONS- WOMEN'S TOILET
SCALE: 1/4" = 1'-0"

ACCESSORY SCHEDULE		
AC-1	GRAB BAR 36"	BOBRICK #B-5806-36
AC-2	GRAB BAR 42"	BOBRICK #B-5806-42
AC-3	GRAB BAR 18"	BOBRICK #B-5806-18
AC-4	MIRROR 18"x30"	BOBRICK #B-2908
AC-5	TOILET TISSUE DISPENSER	(PROVIDE BY OWNER, INSTALLED BY G.C.)
AC-6	LIQUID SOAP DISPENSER	(PROVIDE BY OWNER, INSTALLED BY G.C.)
AC-7	ELECTRIC HAND DRYER	EXCEL DRYER INC. TA-SB-110/120V
AC-8	PARTITION MOUNTED SANITARY NAPKIN DISPOSAL	BOBRICK #B-354
AC-9	RECESSED SANITARY NAPKIN DISPOSAL	BOBRICK #B-353
AC-10	SEMI-RECESSED TAMPON VENDOR	BOBRICK #B-47064C
AC-11	LAVATORY PROTECTIVE ENCLOSURE	TRU-BRO LAV-SHIELD (BY P-CONTRACTOR)

- TOILET REMOVAL NOTES:**
- R1 REMOVE EXISTING VCT FLOOR TILE, (MULTIPLE LAYER MAY EXIST) BASE, MASTIC AND SUBSTRATE DOWN TO EXISTING SLAB. MECHANICALLY PROFILE EXISTING SLAB FOR NEW FLOOR FINISHES. **COORDINATE REMOVALS WITH ASBESTOS ABATEMENT DRAWINGS.**
 - R2 SAW-CUT AND REMOVE PARTITION FROM SLAB TO STRUCTURE ABOVE. PATCH DISTURBED SURFACES TO MATCH EXISTING ADJACENT SURFACES. GRIND DOWN ANY HIGH SPOTS UNDER EXISTING WALL. FLASH PATCH SMOOTH TO ADJACENT SURFACES.
 - R3 REMOVE EXISTING DOOR, HARDWARE, THRESHOLD AND ALL RELATED ITEMS FOR THE INSTALLATION OF NEW DOOR AND HARDWARE. PROVIDE AND WELD MORTISE CLOSURE PLATES. CHOP OUT AND REMOVE EXISTING FLOOR CLOSER ASSEMBLY BOX AND PATCH EXISTING RECESS.
 - R4 EXISTING PLUMBING FIXTURE TO BE REMOVED. SEE PLUMBING DRAWINGS.
 - R5 EXISTING HEATING CONNECTOR TO BE REMOVED. SEE PLUMBING DRAWINGS.
 - R6 REMOVE EXISTING CERAMIC TILE FLOOR, MORTAR SETTING BED, MASTICS DOWN TO EXISTING SLAB. PATCH ANY VOIDS BEHIND.
 - R7 REMOVE EXISTING CERAMIC TILE WALL BASE AND SETTING BED. GRIND DOWN ALL HIGH SPOTS. INFILL W/ PLASTER FOR SMOOTH TRANSITION TO ADJACENT SURFACES.
 - R8 REMOVE EXISTING TOILET PARTITIONS, BRACKETS, PLASTERS, SHOES AND ALL RELATED ITEMS. PATCH DISTURBED SURFACES TO MATCH EXISTING ADJACENT SURFACES.
 - R9 SAW-CUT AND REMOVE PORTION OF EXISTING SLAB, VAPOR BARRIER AND SUB-BASE FOR INSTALLATION OF PLUMBING PIPE.
 - R10 REMOVE EXISTING BATHROOM ACCESSORIES. PATCH DISTURBED SURFACES TO MATCH EXISTING ADJACENT SURFACE.
 - R11 REMOVE HALF HEIGHT PARTITION. PATCH DISTURBED SURFACES TO MATCH EXISTING ADJACENT SURFACES.
 - R12 REMOVE EXISTING LIGHT FIXTURE. SEE ELECTRICAL DRAWINGS.
 - R13 REMOVE EXISTING SUSPENDED CEILING ASSEMBLY INCLUDING CLIPS, HANGERS, WALL TRIM, BLACK IRON, PANELS AND ASSOCIATED ITEMS.
 - R14 REMOVE EXISTING PLASTER CEILING ASSEMBLY INCLUDING HANGERS, BLACK IRON, PANELS AND ASSOCIATED ITEMS.
 - R15 REMOVE EXISTING MARBLE SADDLE AND SETTING BED.

- TOILET WORKSCOPE NOTES:**
- WS1 INSTALL NEW DOOR, FRAME AND HARDWARE. SEE DOOR DETAILS & SCHEDULE.
 - WS2 PROVIDE TOILET PARTITION COMPARTMENTS. SEE FINISH SCHEDULE, SPECIFICATION & 10&11/A500.
 - WS3 PIPE TRENCH INFILL. SEE DETAILS 7/A500.
 - WS4 PROVIDE CMU PARTITION / INFILL. CMU THICK TO MATCH EXISTING.
 - WS5 PROVIDE NEW DOOR MARBLE THRESHOLD, DEPTH TO MATCH DOOR FRAME. SEE DETAIL 5/A700.
 - WS6 PLUMBING FIXTURE. SEE P-DWGS.
 - WS7 PROVIDE SUSPENDED ACOUSTICAL CEILING SYSTEM DO NOT FASTEN HANGER WIRE DIRECTLY TO CONCRETE DECK ABOVE (ACM). PROVIDE UNI-STRUT SUPPORTS CHANNELS BETWEEN STEEL FRAMING MEMBERS TO SUPPORT CEILING, LIGHTS, DUCTWORK ETC. SEE FINISH SCHEDULE, SPECIFICATION & DETAIL 6/A501.
 - WS8 PROVIDE CERAMIC TILE FLOOR. SEE FINISH SCHEDULE, SPECIFICATION & DETAIL 8&9/A500.
 - WS9 PROVIDE GLAZED CERAMIC WALL TILE. SEE FINISH SCHEDULE, SPECIFICATION & DETAIL 8&9/A500.
 - WS10 PROVIDE CEMENT-BASED SELF-LEVELING UNDERLAYMENT TO ACHIEVE FLUSH CONDITION WITH ADJACENT FLOOR(S) ON 100% FLOOR SURFACE.
 - WS11 PROVIDE ELECTRIC CABINET UNIT HEATER. SEE DETAIL 12/A500 & H-DWGS.
 - WS12 ABRASE EXISTING PLASTER & CMU WALLS AND SKIM COAT TO PROVIDE SMOOTH SURFACE FOR CERAMIC TILE INSTALLATION AND PAINTED SURFACES.
 - WS13 PROVIDE NEW DIFFUSERS AND EXTEND EXISTING DUCTWORK. MODIFY EXISTING DUCTWORK AS REQUIRED FOR NEW LOCATION.
 - WS14 ELECTRICAL CONTRACTOR TO REMOVE EXISTING WIREMOLD/CONDUIT. GENERAL CONSTRUCTION CONTRACTOR TO PROVIDE SLOT IN EXISTING WALL FOR INSTALLATION OF NEW WIRING AND CONDUIT BY ELECTRICAL CONTRACTOR PATCH SLOTS. PROVIDE SMOOTH AND LEVEL TRANSITION TO ADJACENT SURFACE.

COORDINATE ALL REMOVALS WITH ASBESTOS AND LEAD ABATEMENT DRAWINGS AND SPECIFICATIONS.

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**ARCHITECTS
PLANNERS**

S.E.D. CONTROL NUMBER
HIGH SCHOOL ADMINISTRATION BUILDING
66-00-00010102


PROJECT: EDGEMONT SCHOOL DISTRICT
ADMINISTRATION BUILDING
TOILET RENOVATIONS AND RELATED WORK
300 WHITE OAK LANE, SCHENECTADY, NY 12305

DRAWING TITLE
PARTIAL FIRST FLOOR LOWER LEVEL
REMOVAL PLANS & PARTIAL FIRST FLOOR,
LOWER LEVEL TUNING & INTERIOR ELEVATIONS



02-24-2021 BID
07-01-2015 S.E.D. SUBMISSION
DATE ISSUED TO

SHEET SIZE 30"x42"
SCALE AS NOTED
DRAWING NO. A150



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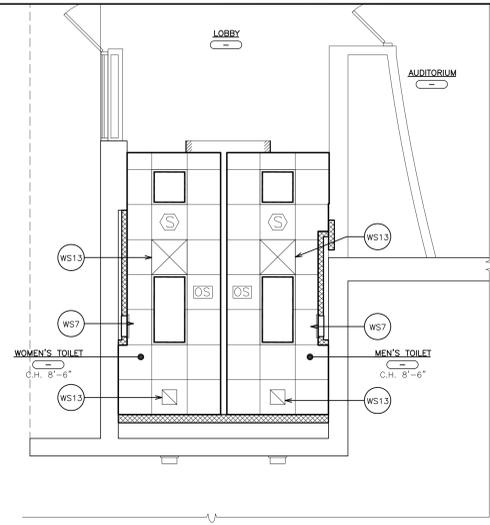
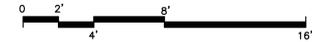
1 REMOVAL REFLECTED CEILING PLAN
SCALE: 1/4" = 1'-0"

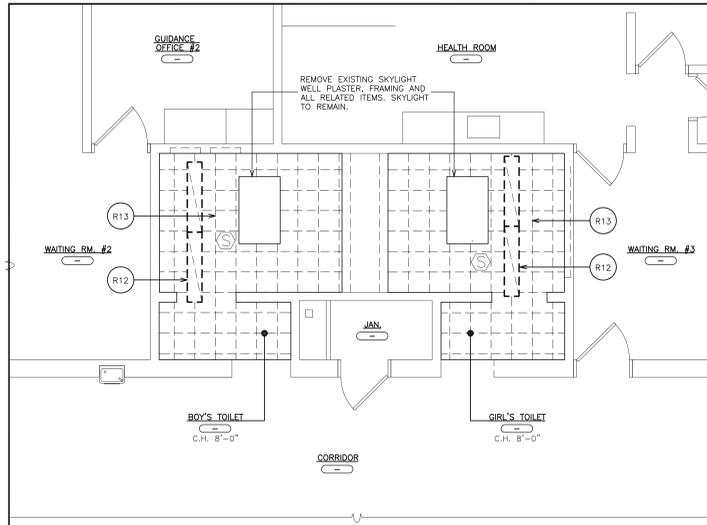


2 REFLECTED CEILING PLAN
SCALE: 1/4" = 1'-0"

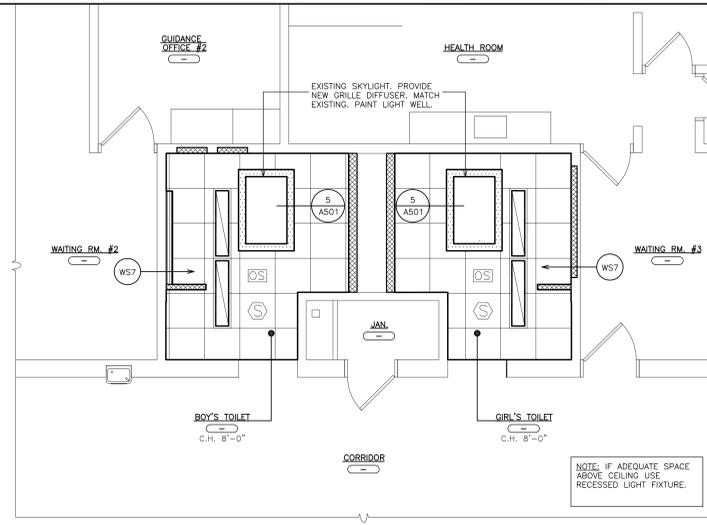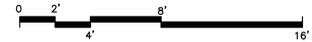

3 REMOVAL REFLECTED CEILING PLAN
SCALE: 1/4" = 1'-0"

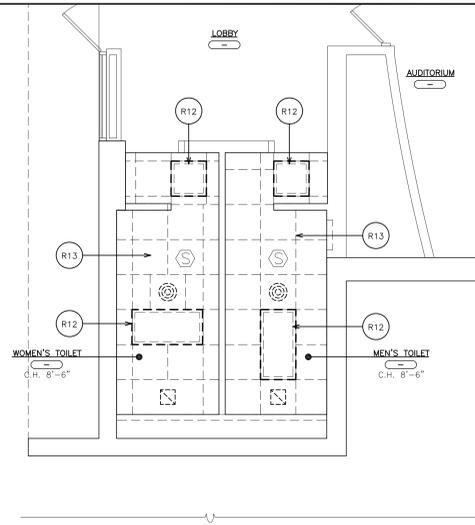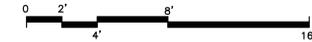

4 REFLECTED CEILING PLAN
SCALE: 1/4" = 1'-0"

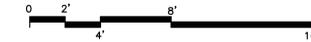

CEILING LEGEND	
	2'x2' RECESSED MOUNTED LIGHT FIXTURE
	2'x4' RECESSED MOUNTED LIGHT FIXTURE
	RECESSED CAN LIGHT FIXTURE
	SURFACE MOUNTED LIGHT FIXTURE
	GYPSUM BOARD OR SOFFIT
	FIRE ALARM SMOKE DETECTOR
	CEILING SPEAKER
	CEILING REGISTER. SIZE VARIES. SEE MECHANICAL DRAWINGS.
	CEILING DIFFUSER. SIZE VARIES. SEE MECHANICAL DRAWINGS.
	CEILING MOUNTED EXIT SIGN W/ DIRECTIONAL ARROW
	WALL MOUNTED EXIT SIGN W/ DIRECTIONAL ARROW
	2'x2' OR 2'x4' ACOUSTICAL CEILING TILE AND SUSPENSION SYSTEM
	CEILING GRID STARTING POINT

- TOILET REMOVAL NOTES:**
- R1 REMOVE EXISTING VCT FLOOR TILE. (MULTIPLE LAYER MAY EXIST) BASE, MASTIC AND SUBSTRATE DOWN TO EXISTING SLAB. MECHANICALLY PROFILE EXISTING SLAB FOR NEW FLOOR FINISHES. **COORDINATE REMOVALS WITH ASBESTOS ABATEMENT DRAWINGS.**
 - R2 SAW-CUT AND REMOVE PARTITION FROM SLAB TO STRUCTURE ABOVE. PATCH DISTURBED SURFACES TO MATCH EXISTING ADJACENT SURFACES. GRIND DOWN ANY HIGH SPOTS UNDER EXISTING WALL. FLASH PATCH SMOOTH TO ADJACENT SURFACES.
 - R3 REMOVE EXISTING DOOR, HARDWARE, THRESHOLD AND ALL RELATED ITEMS FOR THE INSTALLATION OF NEW DOOR AND HARDWARE. PROVIDE AND WELD MORTISE CLOSURE PLATES. CHOP OUT AND REMOVE EXISTING FLOOR CLOSER ASSEMBLY BOX AND PATCH EXISTING RECESS.
 - R4 EXISTING PLUMBING FIXTURE TO BE REMOVED. SEE PLUMBING DRAWINGS.
 - R5 EXISTING HEATING CONNECTOR TO BE REMOVED. SEE PLUMBING DRAWINGS.
 - R6 REMOVE EXISTING CERAMIC TILE FLOOR, MORTAR SETTING BED, MASTICS DOWN TO EXISTING SLAB. PATCH ANY VOIDS BEHIND.
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 - R10 REMOVE EXISTING BATHROOM ACCESSORIES. PATCH DISTURBED SURFACES TO MATCH EXISTING ADJACENT SURFACE.
 - R11 REMOVE HALF HEIGHT PARTITION. PATCH DISTURBED SURFACES TO MATCH EXISTING ADJACENT SURFACES.
 - R12 REMOVE EXISTING LIGHT FIXTURE. SEE ELECTRICAL DRAWINGS.
 - R13 REMOVE EXISTING SUSPENDED CEILING ASSEMBLY INCLUDING CLIPS, HANGERS, WALL TRIM, BLACK IRON, PANELS AND ASSOCIATED ITEMS.
 - R14 REMOVE EXISTING PLASTER CEILING ASSEMBLY INCLUDING HANGERS, BLACK IRON, PANELS AND ASSOCIATED ITEMS.
 - R15 REMOVE EXISTING MARBLE SADDLE AND SETTING BED.
- COORDINATE ALL REMOVALS WITH ASBESTOS AND LEAD ABATEMENT DRAWINGS AND SPECIFICATIONS.**

- TOILET WORKSCOPE NOTES:**
- WS1 INSTALL NEW DOOR, FRAME AND HARDWARE. SEE DOOR DETAILS & SCHEDULE.
 - WS2 PROVIDE TOILET PARTITION COMPARTMENTS. SEE FINISH SCHEDULE, SPECIFICATION & 10&11/A500.
 - WS3 PIPE TRENCH INFILL. SEE DETAILS 7/A500.
 - WS4 PROVIDE CMU PARTITION / INFILL. CMU THICK TO MATCH EXISTING.
 - WS5 PROVIDE NEW DOOR MARBLE THRESHOLD, DEPTH TO MATCH DOOR FRAME. SEE DETAIL 5/A700.
 - WS6 PLUMBING FIXTURE. SEE P-DWGS.
 - WS7 PROVIDE SUSPENDED ACOUSTICAL CEILING SYSTEM DO NOT FASTEN HANGER WIRE DIRECTLY TO CONCRETE (DECK ABOVE (ACK)). PROVIDE UNI-STRUT SUPPORTS CHANNELS BETWEEN STEEL FRAMING MEMBERS TO SUPPORT CEILING, LIGHTS, DUCTWORK ETC. SEE FINISH SCHEDULE, SPECIFICATION & DETAIL 6/A501.
 - WS8 PROVIDE CERAMIC TILE FLOOR. SEE FINISH SCHEDULE, SPECIFICATION & DETAIL 8&9/A500.
 - WS9 PROVIDE GLAZED CERAMIC WALL TILE. SEE FINISH SCHEDULE, SPECIFICATION & DETAIL 8&9/A500.
 - WS10 PROVIDE CEMENT-BASED SELF-LEVELING UNDERLAYMENT TO ACHIEVE FLUSH CONDITION WITH ADJACENT FLOOR(S) ON 100% FLOOR SURFACE.
 - WS11 PROVIDE ELECTRIC CABINET UNIT HEATER. SEE DETAIL 12/A500 & H-DWGS.
 - WS12 ABRASIVE EXISTING PLASTER & CMU WALLS AND SKIM COAT TO PROVIDE SMOOTH SURFACE FOR CERAMIC TILE INSTALLATION AND PAINTED SURFACES.
 - WS13 PROVIDE NEW DIFFUSERS AND EXTEND EXISTING DUCTWORK. MODIFY EXISTING DUCTWORK AS REQUIRED FOR NEW LOCATION.
 - WS14 ELECTRICAL CONTRACTOR TO REMOVE EXISTING WIREMOLD/CONDUIT. GENERAL CONSTRUCTION CONTRACTOR TO PROVIDE SLOT IN EXISTING WALL FOR INSTALLATION OF NEW WIRING AND CONDUIT BY ELECTRICAL CONTRACTOR PATCH SLOTS. PROVIDE SMOOTH AND LEVEL TRANSITION TO ADJACENT SURFACE.

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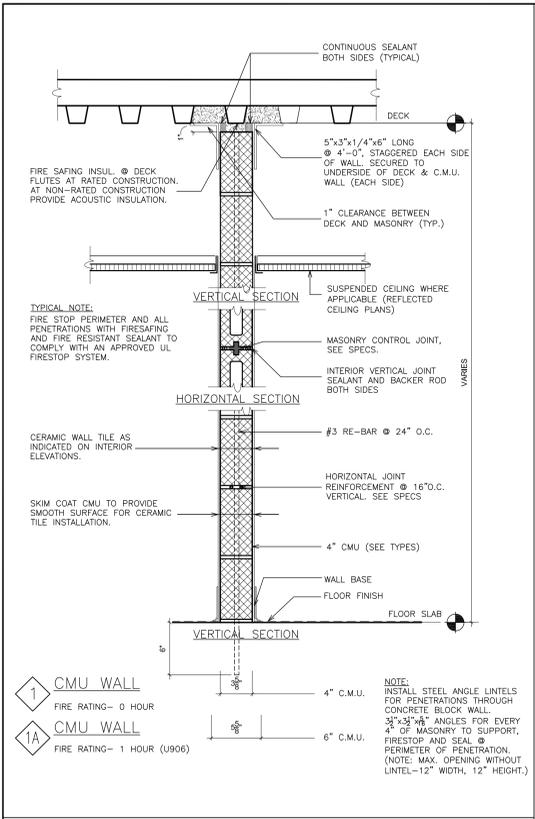
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D'ANGELO
P.C.**
**ARCHITECTS
PLANNERS**

S.E.D. CONTROL NUMBER
HIGH SCHOOL ADMINISTRATION BUILDING
#6248000010102

PROJECT BY
EDGEWOOD SCHOOL DISTRICT
ADMINISTRATION BUILDING
TOILET RENOVATIONS AND RELATED WORK
300 WHITE OAK LANE, SCHENECTADY, NY 10855

DRAWING TITLE
FIRST FLOOR REMOVAL REFLECTED CEILING
FIRST FLOOR REFLECTED CEILING
PLANS


02-24-2021	BID
07-01-2015	S.E.D. SUBMISSION
DATE	ISSUED TO
SHEET SIZE 30"x42"	DRAWING NO. A200
SCALE AS NOTED	FILE NO. 20381.00
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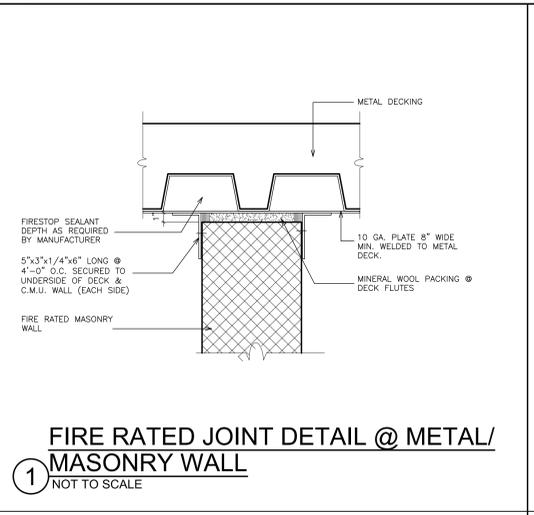
1 CMU WALL
FIRE RATING - 0 HOUR

1A CMU WALL
FIRE RATING - 1 HOUR (U906)


GENERAL NOTES: (ALL PARTITION TYPES)
 1 REFER TO FINISH SCHEDULE FOR ALL FINISHES.
 2 REFER TO A-500 FOR APPLICABLE DETAILS.
 3 TILE BACKER-BOARD TO BE USED WHERE C.T. IS USED ON STUD WALLS.
 4 ALL NEW PARTITIONS SHOULD BE FULL HEIGHT AND SHALL BE SEALED TO RESIST THE PASSAGE OF SMOKE (UNLESS OTHERWISE NOTED).
 5 ALL NEW PARTITIONS SHALL BE CONSTRUCTED USING TYPE "X" GYPSUM BOARD. (UNLESS OTHERWISE NOTED).
 6 ALL INTERIOR GYPSUM BOARD PARTITIONS SHALL HAVE SOUND ATTENUATION INSULATION EQUAL TO METAL STUD THICKNESS FOR FULL HEIGHT (UNLESS OTHERWISE NOTED).
 7 ALL FIRE RATED WALL ASSEMBLIES TO MEET THE FOLLOWING TEST REQUIREMENTS:
 *ASTM E119- STANDARD TEST METHOD FOR FIRE TESTS OF BUILDING CONSTRUCTION AND MATERIALS.
 *ASTM E84- STANDARD TEST METHOD FOR SURFACE BURNING CHARACTERISTICS OF BUILDING MATERIALS.
 *ASTM 814- STANDARD TEST METHOD FOR FIRE TESTS OF THROUGH-PENETRATION FIRE STOPS.




2 METAL STUD FURRING
FIRE RATING - 0 HOUR

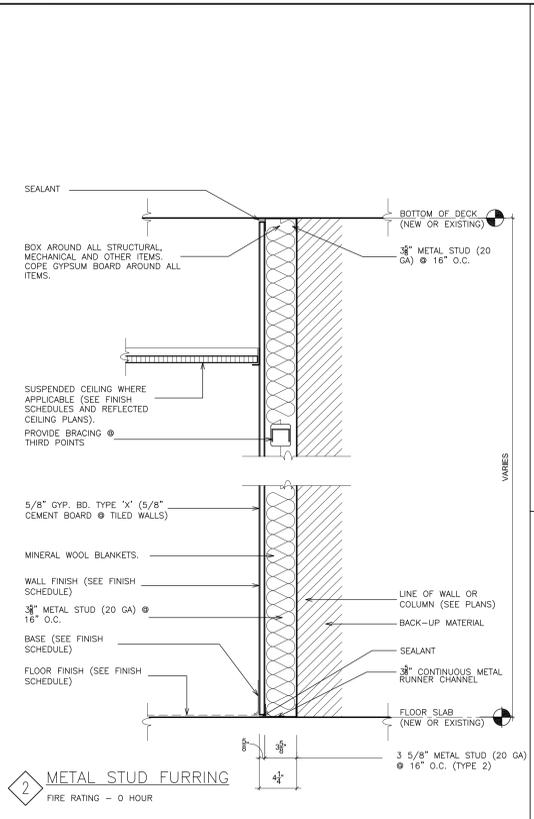


3 FIRE RATED JOINT DETAIL @ METAL/MASONRY WALL
NOT TO SCALE

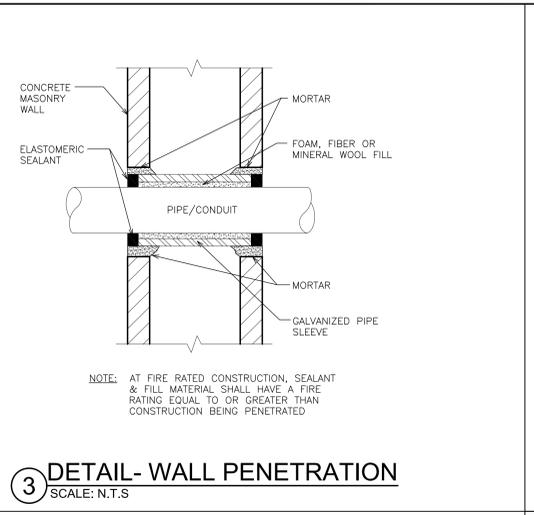


4 DETAIL- WALL PENETRATION
SCALE: N.T.S.

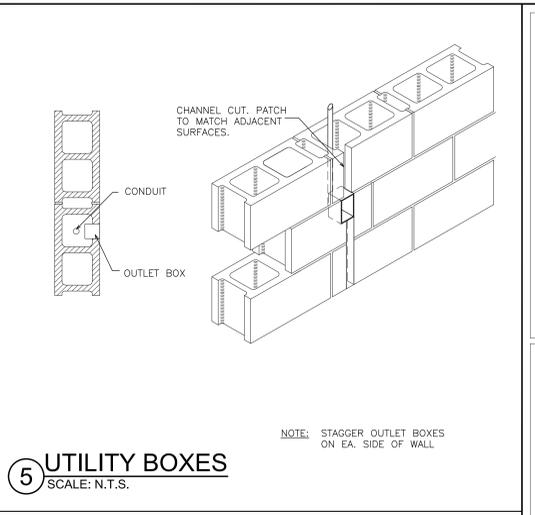


5 UTILITY BOXES
SCALE: N.T.S.

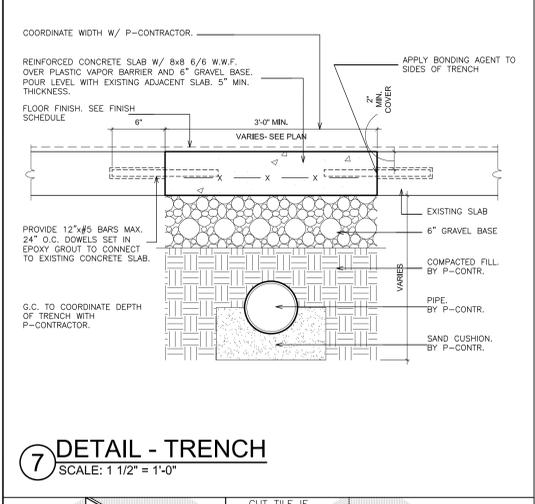


7 DETAIL - TRENCH
SCALE: 1 1/2" = 1'-0"

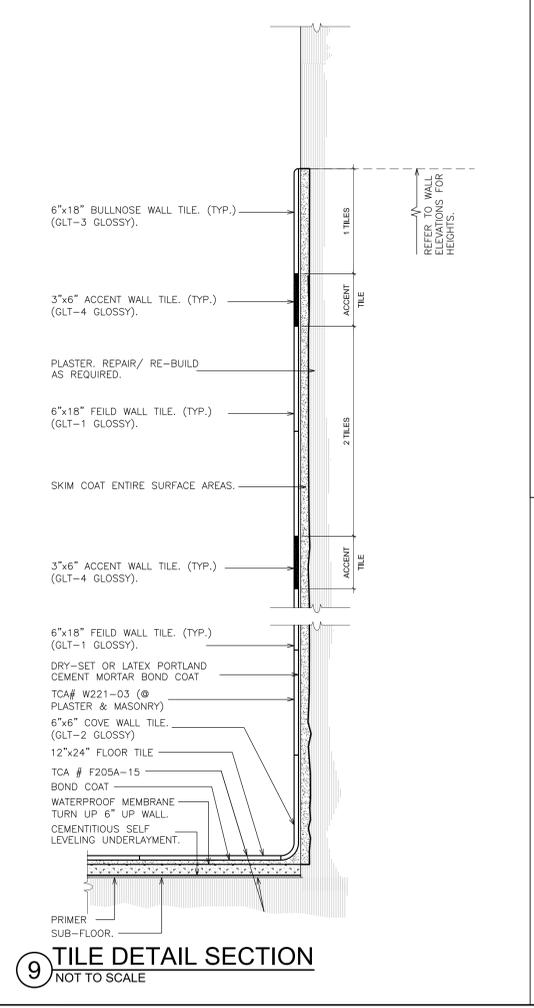


8 TYP. TILE BASE DETAIL
SCALE: N.T.S.

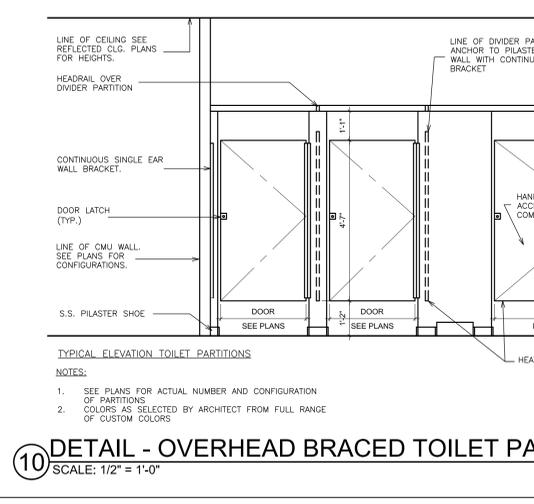


9 TILE DETAIL SECTION
NOT TO SCALE

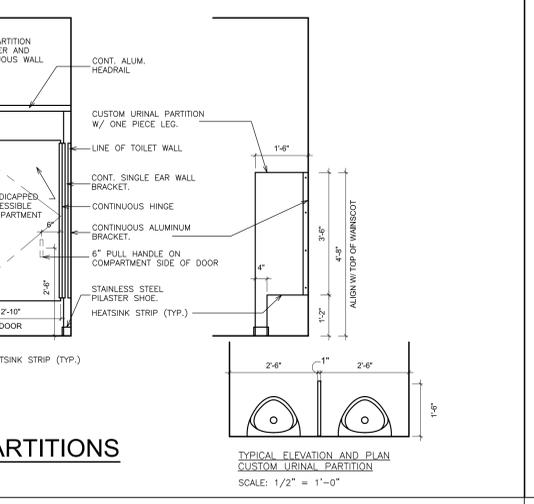

10 DETAIL - OVERHEAD BRACED TOILET PARTITIONS
SCALE: 1/2" = 1'-0"

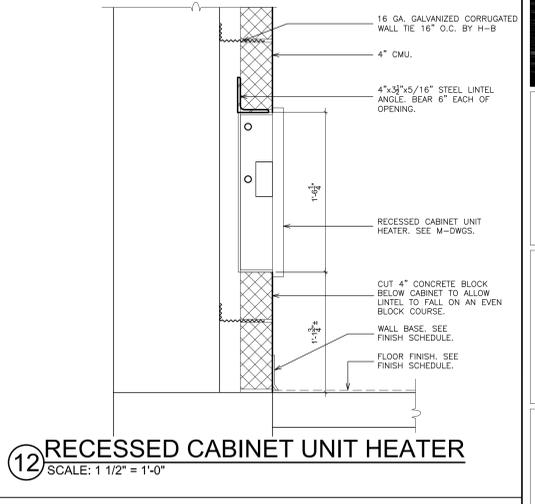

11 DETAIL - TOILET PARTITIONS
SCALE: 3" = 1'-0"

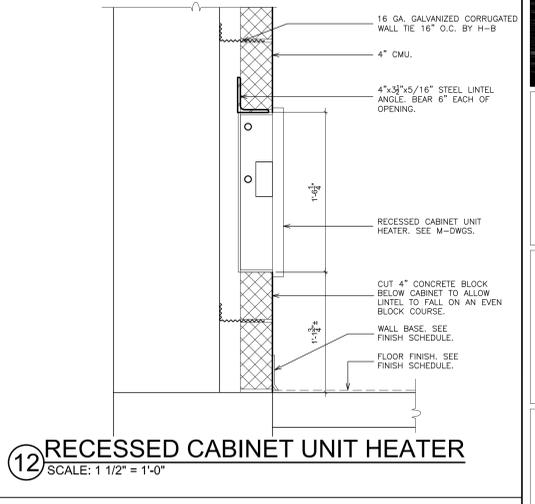

12 RECESSED CABINET UNIT HEATER
SCALE: 1 1/2" = 1'-0"

PLOT DATE: February 23, 2021 - 3:41 pm

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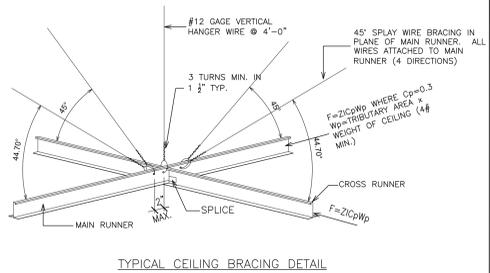
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ELMSFORD NEW YORK 10523
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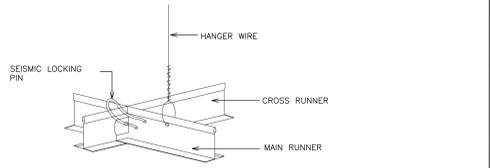
S.E.D. CONTROL NUMBER
HIGH SCHOOL ADMINISTRATION BUILDING
66-046-00011012

PROJECT: EDGEMONT SCHOOL DISTRICT ADMINISTRATION BUILDING TOILET RENOVATIONS AND RELATED WORK
300 WHITE OAK LANE, SCHENECTADY, NY 10585
DRAWING TITLE: PARTITION TYPES & MISCELLANEOUS DETAILS


02-24-2021	BID
07-01-2015	S.E.D. SUBMISSION
DATE	ISSUED TO
SHEET SIZE 30"x42"	DRAWING NO. A500
SCALE AS NOTED	FILE NO. 20381.00
DRAWN BY F & D	




TYPICAL CEILING BRACING DETAIL




LOCKING PIN DETAIL

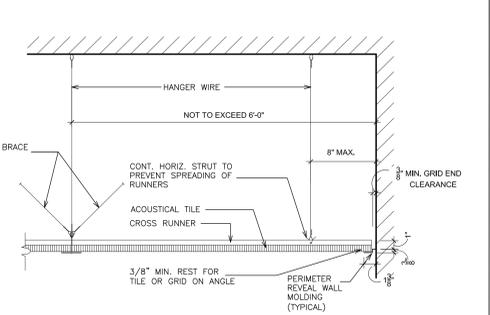


1 SEISMIC DETAIL @ ALL NEW SUSP. CEILINGS
SCALE: N.T.S.

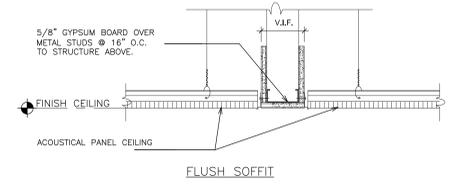


2 DETAIL - GRID TRANSITION SOFFIT
SCALE: 1 1/2" = 1'-0"

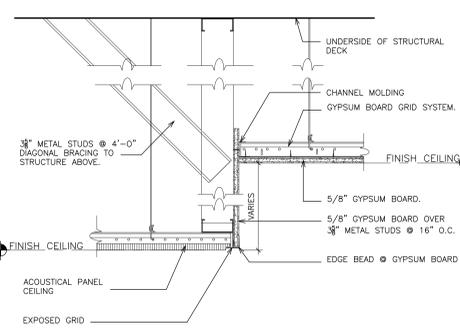


3 DETAIL - ACOUSTICAL CEILING TO DRYWALL SOFFIT
SCALE: 1 1/2" = 1'-0"

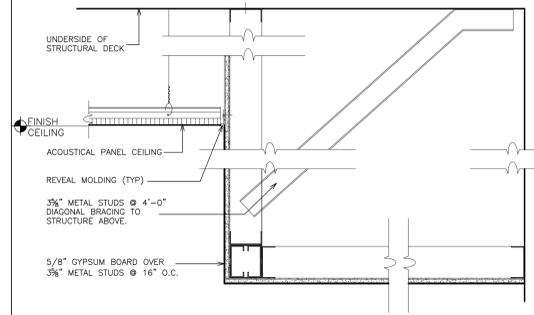


4 DETAIL - TRANSITION SOFFIT AND ACOUSTICAL CEILINGS
SCALE: 1 1/2" = 1'-0"

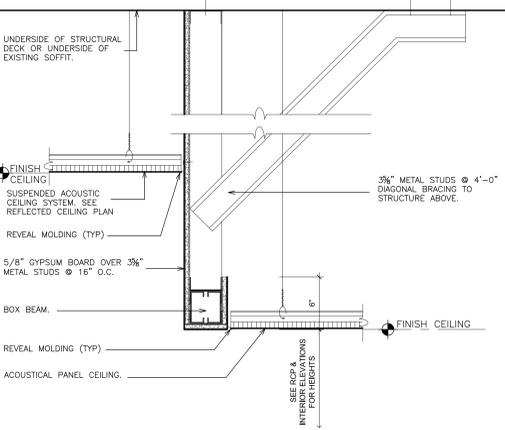


6 DETAIL - DROPPED SOFFIT
SCALE: 1 1/2" = 1'-0"

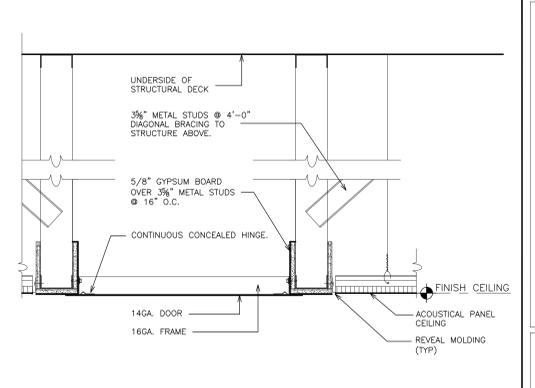

7 DETAIL - ACCESS DOOR
SCALE: 1 1/2" = 1'-0"

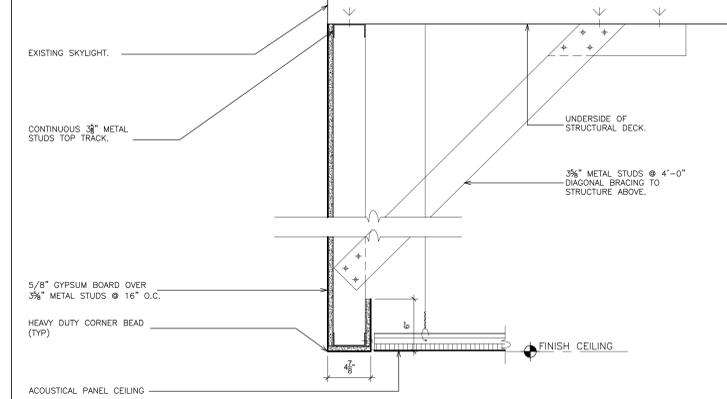


5 DETAIL - SOFFIT @ EXISTING SKYLIGHT
SCALE: 1 1/2" = 1'-0"

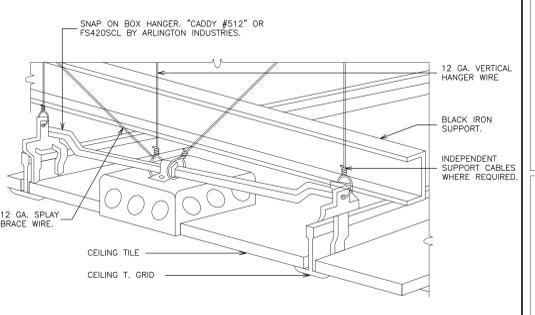


- NOTES:
- FOR USE WITH NEW CEILING MOUNTED DEVICES (SMOKE DETECTORS, RECEPTACLES, SPEAKERS, FANS ETC.).
 - INDEPENDENT SUPPORT FROM BUILDING STRUCTURE REQUIRED FOR ITEMS EXCEEDING 20 LBS. AND FANS.



8 DETAIL - CEILING MOUNTED DEVICE
NOT TO SCALE

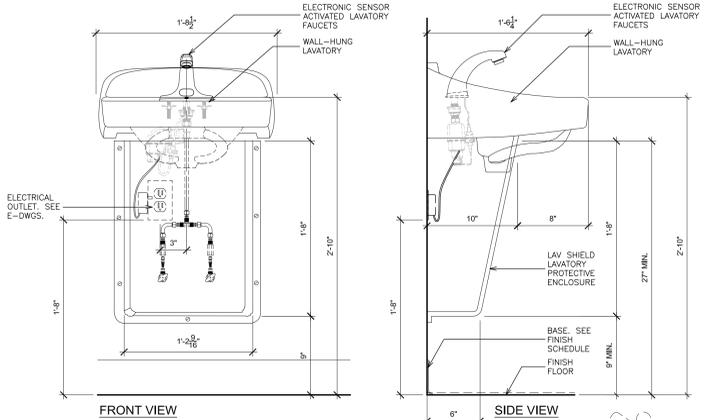

9 DETAIL - HANDICAP ACCESSIBLE VANITY
SCALE: 1 1/2" = 1'-0"

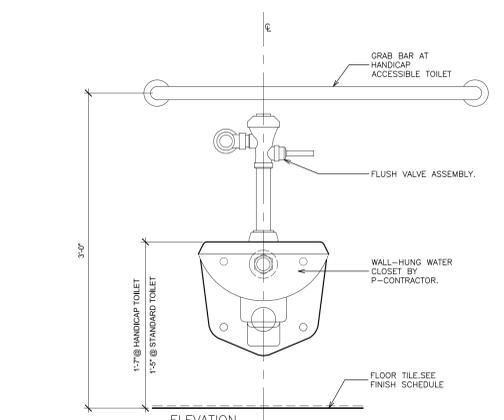

10 DETAIL - SENSOR ACCESS PANEL
SCALE: 1 1/2" = 1'-0"

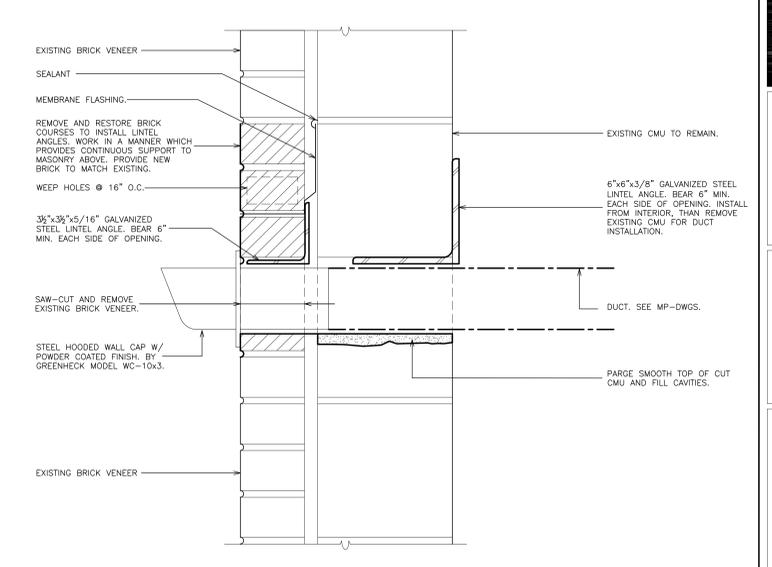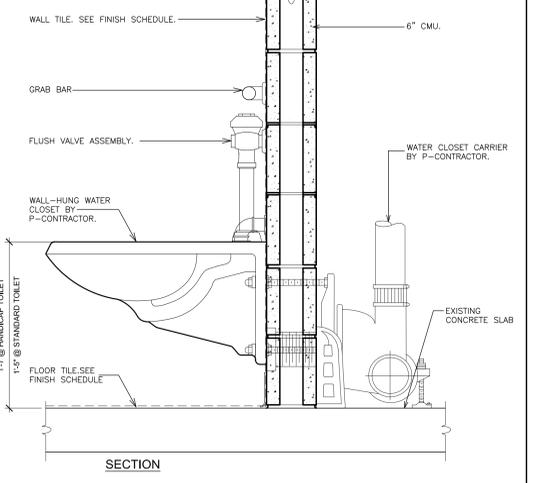

11 DETAIL - EXHAUST FAN HOODED WALL CAP
SCALE: 3" = 1'-0"

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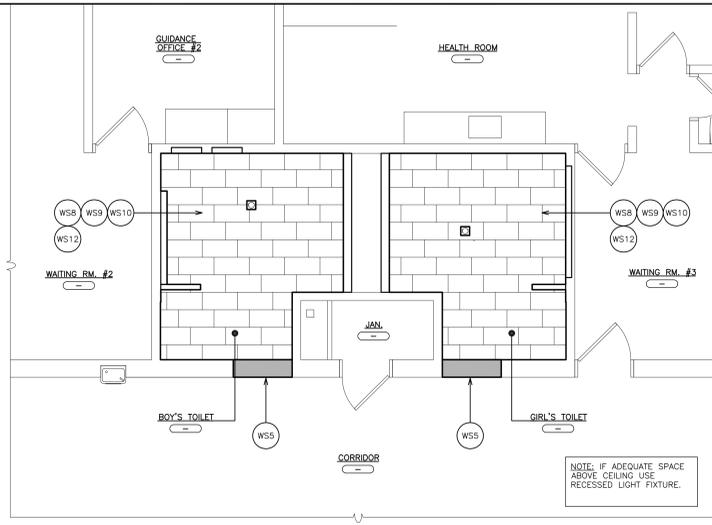
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TEL 914.889.4444 FAX 914.889.1919
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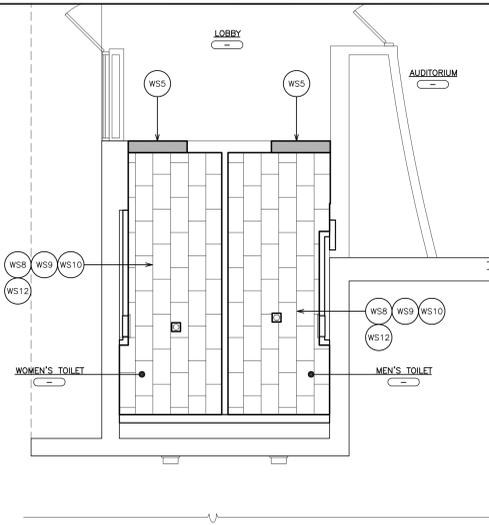
S.E.D. CONTROL NUMBER:
HIGH SCHOOL ADMINISTRATION BUILDING
#624600010102

PROJECT: EDGEMONT SCHOOL DISTRICT ADMINISTRATION BUILDING TOILET RENOVATIONS AND RELATED WORK
300 WHITE OAK LANE, SCHENECTADY, NY 10883
DRAWING TITLE: CEILING DETAILS, MISC. DETAILS & CASEWORK DETAILS


02-24-2021 BID
07-01-2015 S.E.D. SUBMISSION
DATE ISSUED TO
SHEET SIZE 30"x42"
SCALE AS NOTED
DRAWN BY F & D
FILE NO. 20381.00



1 FIRST FLOOR FINISH PLAN
SCALE: 1/4" = 1'-0"



2 FIRST FLOOR FINISH PLAN
SCALE: 1/4" = 1'-0"

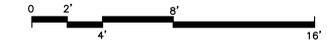

- TOILET WORKSCOPE NOTES:**
- WS1 INSTALL NEW DOOR, FRAME AND HARDWARE. SEE DOOR DETAILS & SCHEDULE.
 - WS2 PROVIDE TOILET PARTITION COMPARTMENTS. SEE FINISH SCHEDULE, SPECIFICATION & DETAIL 10K11/A500.
 - WS3 PIPE TRENCH INFILL. SEE DETAILS 7/A500.
 - WS4 PROVIDE CMU PARTITION / INFILL. CMU THICK TO MATCH EXISTING.
 - WS5 PROVIDE NEW DOOR MARBLE THRESHOLD, DEPTH TO MATCH DOOR FRAME. SEE DETAIL 5/A700.
 - WS6 PLUMBING FIXTURE. SEE P-DWGS.
 - WS7 PROVIDE SUSPENDED ACOUSTICAL CEILING SYSTEM DO NOT FASTEN HANGER WIRE DIRECTLY TO CONCRETE DECK ABOVE (ACM). PROVIDE UNI-STRUT SUPPORTS CHANNELS BETWEEN STEEL FRAMING MEMBERS TO SUPPORT CEILING, LIGHTS, DUCTWORK ETC. SEE FINISH SCHEDULE, SPECIFICATION & DETAIL 6/A501.
 - WS8 PROVIDE CERAMIC TILE FLOOR. SEE FINISH SCHEDULE, SPECIFICATION & DETAIL 8&9/A500.
 - WS9 PROVIDE GLAZED CERAMIC WALL TILE. SEE FINISH SCHEDULE, SPECIFICATION & DETAIL 8&9/A500.
 - WS10 PROVIDE CEMENT-BASED SELF-LEVELING UNDERLAYMENT TO ACHIEVE FLUSH CONDITION WITH ADJACENT FLOOR(S) ON 100% FLOOR SURFACE.
 - WS11 PROVIDE ELECTRIC CABINET UNIT HEATER. SEE DETAIL 12/A500 & H-DWGS.
 - WS12 ABRASIVE EXISTING PLASTER & CMU WALLS AND SKIM COAT TO PROVIDE SMOOTH SURFACE FOR CERAMIC TILE INSTALLATION AND PAINTED SURFACES.
 - WS13 PROVIDE NEW DIFFUSERS AND EXTEND EXISTING DUCTWORK. MODIFY EXISTING DUCTWORK AS REQUIRED FOR NEW LOCATION.
 - WS14 ELECTRICAL CONTRACTOR TO REMOVE EXISTING WIRE/MOLD/CONDUIT. GENERAL CONSTRUCTION CONTRACTOR TO PROVIDE SLOT IN EXISTING WALL FOR INSTALLATION OF NEW WIRING AND CONDUIT BY ELECTRICAL CONTRACTOR PATCH SLOTS. PROVIDE SMOOTH AND LEVEL TRANSITION TO ADJACENT SURFACE.

FLOOR FINISH LEGEND

12"x24" CERAMIC TILE. LAID THIRD. SEE FINISH SCHEDULE.

MARBLE SADDLE

NOTE:
1. SEE SPECIFICATIONS FOR FINISH SCHEDULE.

WALL INDICATIONS ON FINISH SCHEDULE

FINISH SCHEDULE LEGEND

NOTE: ALL FINISHES SHALL BE CLASS "A"

LEGEND	SIZE	MANUFACTURER	SERIES/MODEL NO./COLOR	DESCRIPTION	LOCATION / REMARKS
P-1	-	BENJAMIN MOORE	E-77 / SAIL CLOTH	EGGSHELL PAINT	TOILET WALLS
P-2	-	BENJAMIN MOORE	I-02 / SUPER WHITE	FLAT PAINT	SOFFITS & CEILINGS
P-3	-	BENJAMIN MOORE	COLOR TO BE SELECTED BY ARCHITECT	SEMI-GLOSS DOOR FRAMES	CORRIDOR SIDE DOOR FRAMES
P-4	-	BENJAMIN MOORE	COLOR TO BE SELECTED BY ARCHITECT	SEMI-GLOSS DOOR FRAMES	ROOM SIDE DOOR FRAMES
ACT-1	2'x2'4"	ARMSTRONG	563 / CIRRUS HIGH-NRC / LAY-IN	ACOUSTICAL CEILING TILE	TOILETS
GLT-1	6"x18"	UNITED STATES CERAMIC	U761 / TENDER GRAY BRIGHT	GLAZED CERAMIC WALL TILE	TOILET WALLS - FIELD
GLT-2	6"x6"	UNITED STATES CERAMIC	A73610 / TENDER GRAY BRIGHT	GLAZED COVE BASE	TOILET WALLS - FIELD
GLT-3	6"x18"	UNITED STATES CERAMIC	S4618 / TENDER GRAY BRIGHT	GLAZED BULLNOSE	TOILET WALLS - FIELD
GLT-4	3"x6"	UNITED STATES CERAMIC	U721 / DENIM BRIGHT	GLAZED WALL TILE (GLOSSY)	TOILETS ACCENT
CT-1	12"x24"	CASALGRANDE PADANA	BASALTINA / STROMBOU / NATURAL MATT	PORCELAIN FLOOR TILE	TOILET FLOORS FIELD / JOINTS @ 1/3 POINTS OF TILE
TOILET-1	-	SCRANTON PRODUCTS	SOLID PLASTIC / STAINLESS / ROTARY BRUSHED	TOILET PARTITION	BOY'S TOILET PARTITIONS

FINISH SCHEDULE



LEVEL	LINE	DESIGNATION	FLOOR	BASE (MAT.)	WALL 1	WALL 2	WALL 3	WALL 4	CLG.	TRIM			CASEWORK			REMARKS
										DOORS	DOOR FRAMES	CABINETS	COUNTER TOPS	EDGING		
FIRST FLOOR	01	BOY'S TOILET	CT-1	GLT-2	GLT-1,3,4 PT-1	GLT-1,3,4 PT-1	GLT-1,3,4 PT-1	GLT-1,3,4 PT-1	ACT-1	-	PT-3&4	-	-	-	-	-
	02	GIRL'S TOILET	CT-1	GLT-2	GLT-1,3,4 PT-1	GLT-1,3,4 PT-1	GLT-1,3,4 PT-1	GLT-1,3,4 PT-1	ACT-1	-	PT-3&4	-	-	-	-	-
	03	MEN'S TOILET	CT-1	GLT-2	GLT-1,3,4 PT-1	GLT-1,3,4 PT-1	GLT-1,3,4 PT-1	GLT-1,3,4 PT-1	ACT-1	-	PT-3&4	-	-	-	-	-
	04	WOMEN'S TOILET	CT-1	GLT-2	GLT-1,3,4 PT-1	GLT-1,3,4 PT-1	GLT-1,3,4 PT-1	GLT-1,3,4 PT-1	ACT-1	-	PT-3&4	-	-	-	-	-
	05															
	06															
	07															
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ARCHITECTS PLANNERS

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S.E.D. CONTROL NUMBER:
HIGH SCHOOL ADMINISTRATION BUILDING
#6248000011012

PROJECT TITLE:
EDGEMONT SCHOOL DISTRICT
ADMINISTRATION BUILDING
TOILET RENOVATIONS AND RELATED WORK
300 WHITE OAK LANE, SCHENECTADY, NY 10853

DRAWING TITLE:
FINISH FLOOR PLANS
FINISH SCHEDULE, AND
WORKSCOPE NOTES

02-24-2021 BID
07-01-2015 S.E.D. SUBMISSION
DATE ISSUED TO

SHEET SIZE: 30"x42"
SCALE: AS NOTED
DRAWING NO.: **A800**

DRAWN BY: F & D
FILE NO.: 20381.00

ELECTRICAL SYMBOL LIST	
	2'x4' LED RECESSED FIXTURE. CAPITAL LETTER INDICATES TYPE, LOWER CASE LETTER INDICATES SWITCH CONTROL. FIXTURE SCHEDULE DENOTES TYPE.
	2'x4' RECESSED LED LIGHT FIXTURE FOR EMERGENCY OPERATION WITH INTEGRAL BATTERY BACK-UP, TEST BUTTON AND L.E.D.
	WALL MOUNTED OUTDOOR WALL PACK LIGHT FIXTURE WITH INTEGRAL PHOTOCELL
	AUTOMATIC TIME CLOCK FOR LIGHTING CONTROL. TORK 120v 7100 SERIES.
	FLUSH WALL MOUNTED LIGHTING CONTROL SWITCH CONTROLLING OUTLET "C".
	FLUSH WALL MOUNTED SWITCH. "3" WHERE USED INDICATES 3-WAY, "6" INDICATES SWITCH CONTROL.
	WALL MOUNTED FIRE ALARM HORN/STROBE DEVICE.
	WALL MOUNTED FIRE ALARM STROBE LIGHT. MATCH EXISTING TYPE. PROVIDE CONDUIT & WIRING BACK TO EXISTING FIRE PANEL. CHANNEL CUT AND RUN WIRING IN WALLS.
	CEILING MOUNTED SMOKE DETECTOR. MATCH EXISTING TYPE.
	CEILING/WALL MOUNTED JUNCTION BOX.
	FLUSH FLOOR MOUNTED JUNCTION BOX.
	CONDUCTORS IN CONDUIT CONCEALED IN WALL OR CEILING.
	CONDUIT/WIRING CHASED IN CONCRETE SLAB.
	CONDUIT TURNING UP.
	CONDUIT TURNING DOWN.
	FLEXIBLE LIQUIDTIGHT FINAL EQUIPMENT CONNECTION.
	HOMERUN TO DESIGNATED PANEL. ARROWHEAD INDICATES SINGLE POLE CIRCUIT. HOMERUN SHALL CONSIST OF MINIMUM 2#12-3/4" U.O.N.
	HOMERUN TO DESIGNATED PANEL. NUMBERS IN PARENTHESIS INDICATE MULTIPLE CIRCUIT. IE. 3-HOTS, IN AND 1-GROUND U.O.N.
	125V-2P-3W-20A GROUNDED TYPE, SPECIFICATION GRADE FLUSH WALL MOUNTED DUPLEX RECEPTACLE HUBBELL #5362.
	125V-2P-3W-20A FLUSH WALL MOUNTED GROUND FAULT INTERRUPTING TYPE DUPLEX RECEPTACLE HUBBELL #GF5362.
	125V-2P-3W-20A WEATHER PROOF FLUSH WALL MOUNTED GROUND FAULT INTERRUPTING TYPE DUPLEX RECEPTACLE HUBBELL #GF5362.
	SURFACE MOUNTED ELECTRICAL PANELBOARD.
	WALL MOUNTED EMERGENCY LIGHT FIXTURE W/ EXIT SIGN
	LINE VOLTAGE DUAL TECHNOLOGY CEILING MOUNTED OCCUPANCY SENSOR FOR LIGHTING CONTROL. WATTSTOPPER DT-355.
	INTERFACE MODULE CONSISTING OF CONTROL RELAY AND MONITOR MODULES. IN NEMA 1 ENCLOSURE. ALSO PROVIDE LOAD RELAY AS REQUIRED IF EXISTING DISCONNECT/STARTERS DO NOT HAVE A SET OF WY CONTACTS TO TIE-IN FOR FAN SHUTDOWN.
	MINIMUM VENTILATION CONTROL SWITCH. GREENHECK. ASHRAE 62.2.

ABBREVIATIONS	
ABBV.	DESCRIPTION
A	AMP/AMPERE
A.F.F.	ABOVE FINISHED FLOOR
AWG	AMERICAN WIRE GAUGE
C	CONDUIT
C.F.	CEILING FAN
CU	CONDENSING UNIT
(E)	EXISTING TO REMAIN
E.C.	ELECTRICAL CONTRACTOR
EF	EXHAUST FAN
(E)	EXISTING TO BE RELOCATED
EXIST.	EXISTING
F.A.	FIRE ALARM
F.A.C.P.	FIRE ALARM CONTROL PANEL
F.B.O.	FURNISHED BY OTHERS
G.GRD	GROUND
GFI	GROUND FAULT INTERRUPTER
kmil	THOUSAND CIRCULAR MILLS
KVA	KILOVOLT AMPERE
KW	KILOWATT
MCB	MAIN CIRCUIT BREAKER
MSB	MAIN SWITCH BOARD
M.L.O.	MAIN LUGS ONLY
N.T.S.	NOT TO SCALE
PNL	ELECTRICAL PANELBOARD
(R)	REMOVE EXISTING
RECP	RECEPTACLE
(RN)	REPLACE EXISTING W/NEW
TYP.	TYPICAL
U.O.N.	UNLESS OTHERWISE NOTED
UVAC	UNIT VENTILATOR
W	WATT
WG	WHERE INDICATED E.C. SHALL PROVIDE WIRE GUARD AS REQUIRED
WP	WEATHERPROOF

GENERAL REMOVAL ELECTRICAL NOTES:

- BEFORE COMMENCING WORK, EXAMINE ALL ADJOINING AREAS THAT MAY BE AFFECTED BY REMOVAL. REPORT TO THE GENERAL CONTRACTOR ANY CONDITION THAT PREVENTS PERFORMANCE OF THE WORK.
- BECOME THOROUGHLY FAMILIAR WITH EXISTING CONDITIONS WHERE CONNECTIONS MUST BE MADE, CHANGED OR ALTERED. THE INTENT OF THE WORK IS SHOWN ON THE DRAWINGS AND DESCRIBED HEREINAFTER AND NO CONSIDERATION WILL BE GRANTED BY REASON OF LACK OF FAMILIARITY ON THE PART OF THE CONTRACTOR WITH ACTUAL PHYSICAL CONDITIONS AT THE SITE. INSPECT EACH AND EVERY AREA AFFECTED BY THE ALTERATION OF THE SPACE BEFORE SUBMITTAL OF BID.
- ALL ELECTRICAL EQUIPMENT IS EXISTING TO BE REMOVED UNLESS OTHERWISE NOTED. THIS SHALL INCLUDE BUT NOT BE LIMITED TO THE FOLLOWING:
 - PANEL BOARDS
 - PUBLIC ADDRESS DEVICES
 - LIGHTING FIXTURES AND SWITCHES
 - CIRCUIT BREAKERS AND DISCONNECT SWITCHES
 - RECEPTACLES, OUTLETS AND DEVICES
 - FIRE ALARM DEVICES
- ALL CONDUCTORS AND CONDUIT ASSOCIATED WITH THE ELECTRICAL EQUIPMENT SHALL BE REMOVED COMPLETELY BACK TO ITS SOURCE OF POWER AND DISCONNECTED.
- ALL POWER CONDUCTORS, CONTROL WIRING AND CONDUIT ASSOCIATED WITH MECHANICAL EQUIPMENT SUCH AS FANS, AIR CONDITIONING UNITS, PUMPS, ETC. DESIGNATED FOR REMOVAL ON THE HVAC AND PLUMBING REMOVAL DRAWINGS SHALL BE REMOVED CLEAR BACK TO THE SOURCE OF POWER AND DISCONNECTED. ALL MOTOR STARTERS, DISCONNECT SWITCHES, CONTROL DEVICES, ETC. SHALL BE REMOVED. REFER TO MECHANICAL AND PLUMBING DRAWINGS FOR ADDITIONAL INFORMATION.
- CIRCUIT BREAKERS AND/OR SWITCHES IN PANEL BOARD(S) OR DISTRIBUTION BOARD(S) MADE SPARE DUE TO REMOVAL SHALL BE DESIGNATED AS SUCH ON THE EQUIPMENT SCHEDULE.
- THE ELECTRICAL CONTRACTOR SHALL BE RESPONSIBLE TO TRACE AND RELOCATE ALL EXISTING FEEDERS AND BRANCH CIRCUIT WIRING WHICH PASSES THROUGH THE REMOVAL AREA THAT SERVE EXISTING OCCUPIED SPACES TO REMAIN. COORDINATE WITH BUILDING MANAGER PRIOR TO ANY SHUTDOWNS OR DISRUPTIONS THAT MAY BE REQUIRED TO ACCOMPLISH THIS WORK.
- DISPOSE OF ALL REMOVED EQUIPMENT, WHICH IS NOT INTENDED TO BE REUSED. PRIOR TO DISPOSAL, CONTACT BUILDING MANAGER TO DETERMINE IF ANY REMOVED EQUIPMENT IS DESIRED FOR STOCK.
- EXISTING CIRCUIT BREAKERS IN PANEL(S) ARE TO BE RE-USED. ELECTRICAL CONTRACTOR TO DISCONNECT PANEL AND CIRCUIT BREAKERS WITH GREAT CARE TO ENSURE AGAINST DAMAGE. THIS CONTRACTOR SHALL PROVIDE NEW CIRCUIT BREAKERS AS REQUIRED.
- ALL FIRE ALARM DEVICES ARE EXISTING TO BE REUSED UNLESS OTHERWISE NOTED.
- EXISTING EQUIPMENT DESIGNATED FOR REUSE SHALL BE CLEANED, REFURBISHED AND RESTORED TO OPTIMUM PERFORMANCE. THIS SHALL INCLUDE BUT NOT LIMITED TO CLEANING OF LIGHT FIXTURES, REPLACEMENT OF INOPERABLE BALLASTS AND LAMPS, RESISTANCE TESTING OF BRANCH CIRCUITRY AND FEEDERS, ETC.
- EXTEND EXISTING CIRCUITRY TO THOSE DEVICES THAT ARE TO BE RELOCATED. MATCH EXISTING TYPE AND SIZE. RELOCATION OF EXISTING EQUIPMENT SHALL BE PERFORMED ONLY UPON OWNERS ACCEPTANCE OF EXISTING EQUIPMENT.

ELECTRICAL WORK NOTES

- CONNECT NEW RECEPTACLES TO EXISTING INDICATED PANEL BOARD. PROVIDE NEW 1P-20AMP BREAKER IN EXISTING SPACE AND CIRCUIT WITH 2#12-1#12G IN 3". PROVIDE ALL ACCESSORIES FOR COMPLETE INSTALLATION. CIRCUIT NUMBERS ARE SHOWN FOR CONTRACTORS GUIDANCE ONLY.
- EXISTING ELECTRICAL PANELS WHICH CURRENTLY HAVE NO IDENTIFICATION TAGS HAVE BEEN ARBITRARILY LABELED IN THESE DOCUMENTS FOR IDENTIFICATION PURPOSES.
- CONNECT NEW RECEPTACLE TO EXISTING PANEL BOARD LOCATED IN EXISTING ELECTRICAL ROOM. PROVIDE NEW 1P-20AMP BREAKER IN EXISTING SPACE AND CIRCUIT WITH 2#12-1#12G IN 3". PROVIDE ALL ACCESSORIES FOR COMPLETE INSTALLATION. CIRCUIT NUMBERS ARE SHOWN FOR CONTRACTORS GUIDANCE ONLY.
- ELECTRICAL CONTRACTOR SHALL REPLACE EXISTING PANEL BOARD COVER WITH NEW LOCKABLE TYPE PANEL COVER TO MATCH EXISTING. NEW PANEL BOARD COVERS SHALL ALL BE KEYPED THE SAME AND PROVIDE THE OWNER WITH 2 KEYS FOR EACH PANEL BOARD.

GENERAL POWER NOTES:

- REFER TO ARCHITECTURAL DRAWINGS FOR THE EXACT LOCATION AND MOUNTING HEIGHTS OF ALL DEVICES AND OUTLETS.
- RECEPTACLES SHALL BE CIRCUITED IN ACCORDANCE WITH CIRCUIT NUMBER INDICATED ADJACENT TO EACH DEVICE. CIRCUITRY MAY BE SHOWN IN CERTAIN INSTANCES.
- ALL RECEPTACLES SPECIFIED FOR PERSONAL COMPUTERS, LASER PRINTERS AND SIMILAR TYPES OF EQUIPMENT SHALL BE PROVIDED WITH A SEPARATE NEUTRAL AND GROUND CONDUCTOR. SHARED NEUTRAL CONDUCTORS FOR THESE HOMERUNS ARE NOT PERMITTED.
- THE ELECTRICAL CONTRACTOR SHALL CONFIRM THE CONFIGURATION TYPE FOR ALL SPECIAL RECEPTACLES FOR COPIERS, DATA PROCESSING EQUIPMENT, ETC. WITH OWNER AND ENGINEER PRIOR TO ORDERING.
- CIRCUIT NUMBERS ARE INDICATED FOR INTENT ONLY. THE ELECTRICAL CONTRACTOR SHALL ADJUST ACCORDINGLY IN THE FIELD TO BALANCE THE CIRCUITS EVENLY ON ALL PHASES.
- EXACT LOCATION OF MECHANICAL EQUIPMENT SHALL BE COORDINATED IN THE FIELD.
- ALL WIRING SHALL BE RUN IN EMT CONDUIT. FLEXIBLE CABLE IS NOT ALLOWED.
- MECHANICAL EQUIPMENT IS LOCATED ABOVE THE HUNG CEILING UNLESS OTHERWISE NOTED. EXACT LOCATION SHALL BE DETERMINED FROM MECHANICAL DRAWINGS.
- ALL RECEPTACLES SHALL BE GROUND FAULT INTERRUPTING TYPE.



GENERAL LIGHTING NOTES:

- REFER TO ARCHITECTURAL DRAWINGS FOR THE EXACT LOCATION OF LIGHTING FIXTURES AND SWITCHES.
- ALL JUNCTION OR OUTLET BOXES SHALL BE INSTALLED SO AS TO ALLOW ACCESS TO COVER. PROVIDE ARCHITECT APPROVED ACCESS DOORS OR PLATES AS REQUIRED IN AREAS WHERE UNOBSTRUCTED ACCESS TO BOX OR OUTLET IS NOT POSSIBLE.
- PRIOR TO ORDERING LIGHTING FIXTURES, COORDINATE WITH ARCHITECTURAL DRAWINGS AND SPECIFICATIONS. IF DISCREPANCIES EXIST BETWEEN ARCHITECTURAL AND ENGINEERING INFORMATION OBTAIN CLARIFICATION PRIOR TO PROCEEDING.
- CIRCUIT NUMBERS ARE INDICATED FOR INTENT ONLY. THE ELECTRICAL CONTRACTOR SHALL ADJUST ACCORDINGLY IN THE FIELD TO BALANCE THE CIRCUITS EVENLY ON ALL PHASES.
- MULTIPLE SWITCHES SHOWN IN SAME LOCATION SHALL BE GANGED TOGETHER WITH A COMMON FACE PLATE.
- ALL LIGHTING FIXTURES CIRCUITS SHALL BE PROVIDED WITH A DEDICATED NEUTRAL.
- ALL WIRING SHALL BE IN EMT CONDUIT, FLEXIBLE CABLE IS NOT ALLOWED EXCEPT FOR FAN CONNECTIONS TO LIGHT FIXTURES.

GENERAL NOTES:


- DRAWINGS ARE DIAGRAMMATIC AND INDICATE THE GENERAL ARRANGEMENT OF SYSTEMS AND WORK. CONTRACTOR SHALL FURNISH ALL NECESSARY OUTLETS, SUPPORTS, FITTINGS AND ACCESSORIES TO FULFILL APPLICABLE CODES, REGULATIONS, BUILDING STANDARDS AND THE BEST PRACTICES OF THE TRADE FOR FIRST CLASS ELECTRICAL INSTALLATION.
- THE DRAWINGS INDICATE SIZE AND GENERAL LOCATION OF WORK. SCALED DIMENSIONS SHALL NOT BE USED. THE EXACT LOCATION AND ELEVATION OF ALL ELECTRICAL EQUIPMENT SHALL BE COORDINATED IN FIELD WITH RESPECTIVE CONTRACTOR/OWNER.
- THE CONTRACTOR SHALL COORDINATE WITH THE OWNER PRIOR TO SUBMISSION OF BID TO DETERMINE WHAT WORK MUST BE PERFORMED AFTER NORMAL BUSINESS HOURS. UNLESS OTHERWISE DIRECTED ANY NOISY WORK (CHOPPING, CORE DRILLING, HAMMERING, ETC.) AND BUILDING POWER INTERRUPTIONS SHALL BE PERFORMED OUTSIDE OF NORMAL BUSINESS HOURS. CONFIRM NORMAL BUSINESS HOURS WITH BUILDING OWNER. NO ADDITIONAL COST WILL BE CHARGED TO OWNER FOR WORK PERFORMED OUTSIDE NORMAL BUSINESS HOURS.
- FEEDERS AND BRANCH CIRCUITRY SHALL BE RUN IN CONDUIT MINIMUM 3/4" CONDUIT UNLESS OTHERWISE NOTED. FINAL CONNECTIONS TO MOTORS MAY BE DONE WITH FLEXIBLE METALLIC CONDUIT (NO LONGER THAN 18"). IN UNFINISHED AREA CONDUIT SHALL BE RUN EXPOSED AND IN FINISHED AREAS CONDUIT SHALL BE RUN CONCEALED.
- PROVIDE PANEL NAME PLATE MADE OF BLACK LAMINATED PLASTIC WITH WHITE ENGRAVED LETTERING AND TYPE WRITTEN DIRECTORY FOR ALL NEW AND EXISTING PANEL BEINGS USED FOR THIS PROJECT.
- ALL CONDUCTORS SHALL BE COPPER, TYPE THHN/THWN INSULATED. ALL CONDUCTORS SHALL HAVE 600 VOLT RATED INSULATION UNLESS OTHERWISE NOTED.
- PROVIDE LOCK-ON CIRCUIT BREAKERS FOR CIRCUITS SERVING EXIT SIGN FIXTURES AND EMERGENCY BATTERY PACK FIXTURES.
- REFER TO ARCHITECT'S REFLECTED CEILING PLAN FOR EXACT LOCATION OF ALL CEILING MOUNTED LIGHTING FIXTURES AND OTHER CEILING INSTALLED ITEMS.
- THE USE OF FLEXIBLE CONDUIT FROM LIGHTING FIXTURES TO JUNCTION BOX IS PERMITTED ONLY WHEN A SEPARATE GROUND WIRE IS INSTALLED WITH THE CONDUCTORS INSIDE FLEXIBLE CONDUIT. THE GROUND WIRE MUST BOND THE FIXTURE HOUSING TO THE JUNCTION BOX. MAXIMUM LENGTH 6'-0".
- EXACT LOCATION AND MOUNTING HEIGHTS OF ALL WIRING DEVICES SHALL BE COORDINATED WITH THE ARCHITECT PRIOR TO THE INSTALLATION.
- WALL MOUNTED EQUIPMENT (SWITCHES, RECEPTACLES, ETC.) SHALL BE SURFACE MOUNTED IN UNFINISHED AREAS.
- CONDUIT RUNS SHALL BE PARALLEL WITH OR AT RIGHT ANGLES TO WALLS AND CEILINGS. CONDUIT SHALL BE SUPPORTED BY APPROVED MEANS. SUPPORTS FOR HORIZONTAL RUNS OF CONDUIT SHALL NOT EXCEED SEVEN FEET ON CENTERS.
- PROVIDE PULL BOXES, JUNCTION BOXES, CONDUIT ELBOWS AND OFFSETS TO SUIT FIELD CONDITIONS AND THE NATIONAL ELECTRICAL CODE.
- CONTRACTOR SHALL COORDINATE WITH THE FIRE DEPARTMENT AND F.A. VENDOR BEFORE PROCEEDING WITH WORK INVOLVING FIRE ALARM SYSTEM.
- ALL EMPTY CONDUIT SHALL BE PROVIDED WITH A DRAGWIRE.
- THE MINIMUM WIRE SIZE FOR 120 VOLT BRANCH CIRCUITS SHALL BE NO. 12 AWG, EXCEPT OVER 100' IN LENGTH SHALL BE NO. 10 AWG.
- PROVIDE ALL REQUIRED AND NECESSARY ACCESSORIES (EX. CONNECTORS, ADAPTERS, BUSHINGS, CLAMPS, ETC.) TO FACILITATE COMPLETE INSTALLATION.
- COORDINATE LOCATION OF ALL MECHANICAL EQUIPMENT WITH HVAC CONTRACTOR IN FIELD. FUSES FOR ALL MOTOR LOADS SHALL BE DUAL ELEMENT TIME DELAY TYPE.
- ALL JUNCTION OR OUTLET BOXES SHALL BE INSTALLED SO AS TO ALLOW ACCESS TO COVER. PROVIDE ARCHITECT APPROVED ACCESS DOORS OR PLATES AS REQUIRED IN AREAS WHERE UNOBSTRUCTED ACCESS TO BOX OR OUTLET IS NOT POSSIBLE.
- PRIOR TO ORDERING LIGHTING FIXTURES, COORDINATE WITH ARCHITECTURAL DRAWINGS AND SPECIFICATIONS. IF DISCREPANCIES EXIST BETWEEN ARCHITECTURAL AND ENGINEERING INFORMATION OBTAIN CLARIFICATION PRIOR TO PROCEEDING.
- MULTIPLE SWITCHES SHOWN IN SAME LOCATION SHALL BE GANGED TOGETHER WITH A COMMON FACEPLATE.
- ALL LIGHTING FIXTURES UTILIZING ELECTRONIC BALLASTS SHALL BE PROVIDED WITH A DEDICATED NEUTRAL OR AN OVERSIZED NEUTRAL WHEN SHARED.
- PRIOR TO ANY CHASING, CHOPPING OR CORE DRILLING IS PERFORMED, THE CONTRACTOR SHALL FIELD INVESTIGATE CONDITIONS AND COORDINATE ALL WORK TO ENSURE THAT IT WILL BE IN HARMONY AND NOT AFFECT ANY EXISTING BUILDING SYSTEMS. THIS WORK MUST BE APPROVED BY BUILDING OWNER PRIOR TO PROCEEDING.
- OPENINGS AROUND ELECTRICAL PENETRATIONS THROUGH FIRE RESISTANCE RATED WALLS, PARTITIONS, FLOORS OR CEILINGS SHALL BE FIRE STOPPED USING APPROVED METHODS. ALL SLEEVES MUST HAVE BUSHINGS. SEALANT SHALL BE 3 HOUR FIRE BARRIER #CP-25 (NO LESS THAN 3" THICK BACKED UP WITH MINERAL WOOL).
- ALL PANELBOARD COVERS SHALL BE INSTALLED IN PLACE AT THE COMPLETION OF EACH DAYS WORK.
- PREPARE "AS-BUILT" DRAWINGS SHOWING ALL CHANGES IN WIRE SIZE, CIRCUIT NUMBERING, CIRCUIT ROUTING, EQUIPMENT LOCATIONS AND ALL ELECTRICAL WORK AS ACTUALLY INSTALLED.
- LIGHT FIXTURES SHALL BE CONSTRUCTED TO SUIT PARTICULAR TYPE OF CEILING AND WALL CONSTRUCTION AND SHALL BE PROVIDED WITH APPROPRIATE TRIMS, MOUNTING FRAMES AND ADAPTERS AS REQUIRED.

LIGHTING FIXTURE SCHEDULE					
TYPE	MOUNTING	LAMPS	DESCRIPTION	MANUFACTURER & CAT.#	
'A'	RECESSED	5000L-35K 120V	2'x4' RECESSED FLAT PANEL LED LIGHT FIXTURE WITH NOMINAL 2.8" DEEP, HIGH REFLECTIVE, LIGHT STABILIZED .125" FROSTED ACRYLIC LENS.	HE WILLIAMS MODEL#- LP SERIES LP-24-LSO/835-UNV	
'A1'	RECESSED	5000L-35K 120V	SIMILAR TO FIXTURE TYPE 'A' EXCEPT FOR EMERGENCY OPERATION WITH SELF-CONTAINED 90 MINUTE BATTERY BACK-UP.	HE WILLIAMS MODEL#- LP SERIES LP-24-LSO/835-EM/10WRM-UNV	
'B'	RECESSED	5000L-35K 120V	2'x2' RECESSED FLAT PANEL LED LIGHT FIXTURE WITH NOMINAL 2.8" DEEP, HIGH REFLECTIVE, LIGHT STABILIZED .125" FROSTED ACRYLIC LENS.	HE WILLIAMS MODEL#- LP SERIES LP-22-LSO/835-UNV	
'B1'	RECESSED	5000L-35K 120V	SIMILAR TO FIXTURE TYPE 'B' EXCEPT FOR EMERGENCY OPERATION WITH SELF-CONTAINED 90 MINUTE BATTERY BACK-UP.	HE WILLIAMS MODEL#- LP SERIES LP-22-LSO/835-EM/10WRM-UNV	
'C'	SURFACE	6200L-35K 120V	1'x4" SURFACE MOUNTED WRAP LED LIGHT FIXTURE WITH NOMINAL 2-7/8" DEEP, HEAVY DUTY MARINE GRADE ALUMINUM HOUSING, HIGH REFLECTIVE, LIGHT STABILIZED, POLYCARBONATE LENS.	HE WILLIAMS MODEL#- AVX SERIES AVX-4-L62/835-WPC-DRV-UNV	
'C1'	SURFACE	6200L-35K 120V	SIMILAR TO FIXTURE TYPE 'C' EXCEPT FOR EMERGENCY OPERATION WITH SELF-CONTAINED 90 MINUTE BATTERY BACK-UP.	HE WILLIAMS MODEL#- AVX SERIES AVX-4-L62/835-WPC-EM/10WLP-DRV-UNV	

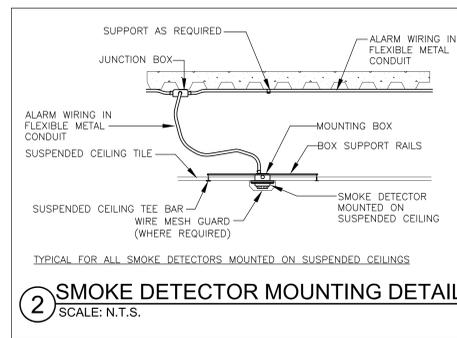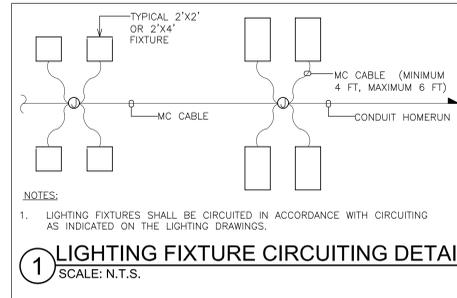

DISPOSAL OF MERCURY CONTAINING LAMPS

- ALL FLUORESCENT AND HID LAMPS WITHIN REMOVED LIGHT FIXTURES ARE CONSIDERED MERCURY CONTAINING AND SHALL BE TREATED AS HAZARDOUS MATERIAL.
- FLUORESCENT AND HID LAMPS SHALL BE REMOVED FROM DEMOLISHED LIGHT FIXTURES AND DISPOSED OF AS PER NEW YORK STATE DEC REGULATIONS AND METHODS.
- LAMPS MUST BE BAGGED IN NON-LEACHING PLASTIC BAGS AND SEALED TO PREVENT LEAKING.
- EACH LAMP OR BAGGED CONTAINER IN WHICH THESE LAMPS ARE CONTAINED MUST BE LABELED OR MARKED CLEARLY WITH ONE OF THE FOLLOWING PHRASES: UNIVERSAL WASTE LAMPS, OR WASTE LAMPS, OR USED LAMPS.
- THESE MARKED BAGS MUST BE DELIVERED TO THE PROPER NEW YORK STATE D.E.C. AUTHORIZED LANDFILL OR RECYCLE CENTERS.

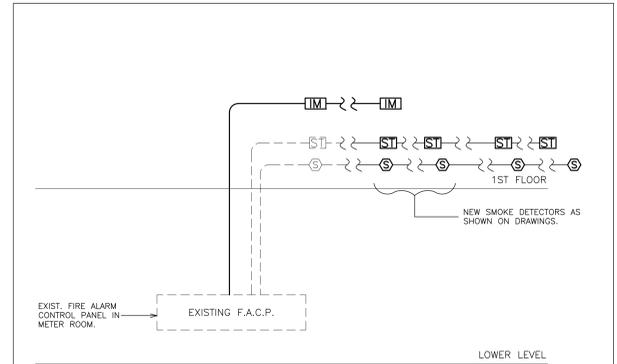

FIRE ALARM RISER NOTES:

- FIRE ALARM WIRING DIAGRAMS SHOWN ARE FOR GENERAL ARRANGEMENT ONLY. ELECTRICAL CONTRACTOR SHALL VERIFY AND OBTAIN POINT TO POINT WIRING DIAGRAM PRIOR TO INSTALLATION BY MANUFACTURER.
- PERMITS AND APPROVALS NECESSARY FOR INSTALLATION OF THE WORK SHALL BE OBTAINED PRIOR TO THE COMMENCEMENT OF THE WORK. ALL PERMIT COSTS AND INSPECTION FEES SHALL BE INCLUDED AS PART OF THIS CONTRACT.
- IN AREAS WHERE DUST AND DIRT WILL BE AIRBORNE DURING DEMOLITION AND CONSTRUCTION THE CONTRACTOR SHALL PROVIDE PLASTIC WRAP OVER SMOKE DETECTORS AND THEN REMOVE ONCE SMOKE IS CLEAN.
- UNLESS DIRECTED OTHERWISE BY FIRE ALARM SYSTEM MANUFACTURER FIRE ALARM DEVICE WIRING SHALL BE AS FOLLOWS (FOR BIDDING PURPOSES ONLY):
 - HORN WIRING - #16 AWG TWISTED APPROVED TEFLON CABLE
 - STROBE WIRING - #14 AWG TWISTED APPROVED TEFLON CABLE
 - SIGNAL WIRING - #14 AWG TWISTED/SHIELDED APPROVED TEFLON CABLE
- THE WIRING SHALL HAVE THE FOLLOWING CHARACTERISTICS:
 - A. A MINIMUM TEMPERATURE RATING OF 150 C
 - B. A MINIMUM AVERAGE INSULATION THICKNESS OF 15 MILS
 - C. A MINIMUM AVERAGE JACKET THICKNESS OF 25 MILS
 - D. THE COLOR OF THE CABLE SHALL BE RED
 - E. THE CABLE SHALL BE A TYPE FPLP (PLENUM TYPE)
 - F. THE CABLE SHALL BE VISIBLY MARKED EXTERNALLY THAT IT MEETS THE ABOVE REQUIREMENTS AND IS LISTED BY UL. CONFIRM WIRING TYPE AND QUANTITY WITH FIRE ALARM SYSTEM MANUFACTURER PRIOR TO PURCHASING.
- PROVIDE MC FIRE ALARM CABLE WITH RED STRIPE AS MANUFACTURED BY AFC SERIES 1800 WHEN CABLE IS CONCEALED OR ABOVE HUNG CEILING. WHEN FIRE ALARM CABLE IS RUN EXPOSED IN FINISHED AREAS, CABLE SHALL RUN IN WIREBOLD V-700. WHEN FIRE ALARM CABLE IS RUN EXPOSED IN UNFINISHED AREAS, PROVIDE PLENUM RATED CABLE IN MIN. 3/4" CONDUIT.
- STROBES SHALL HAVE A MINIMUM LIGHT OUTPUT OF 75 CANDELA AND A FLASH RATE OF 1-3 HZ.
- WALL MOUNTED HORN/STROBE UNITS SHALL NOT HAVE ANY OTHER DEVICES OR APPURTENANCES WITHIN 5 FEET OF THE DEVICE. THEY SHALL BE A MAXIMUM OF 80 INCHES ABOVE FLOOR OR 6" BELOW THE CEILING, WHICHEVER IS LOWER. DEVICES SHALL BE FLUSH MOUNTED IN ALL FINISHED AREAS. PROVIDE DOUBLE DEEP DEVICE BOX IN WALL.
- AFTER THE SYSTEM IS COMPLETE, TEST ALL COMPONENTS IN ACCORDANCE WITH SEQUENCE OF OPERATION PRIOR TO FIRE DEPARTMENT INSPECTION.
- ALL PULL STATIONS SHALL BE PROVIDED WITH CLEAR PROTECTIVE LEXAN COVER. COVER SHALL BE AS MANUFACTURED BY SAFETY TECHNOLOGY INTERNATIONAL INC. CAT.#STI 1100 STOPPER II.
- IF CAPACITY EXISTS ON EXISTING CIRCUITS E.C. MAY CONNECT NEW DEVICES TO EXISTING CIRCUITS. IN LIEU OF PROVIDING NEW CIRCUIT, COORDINATE WITH SYSTEM MANUFACTURE / VENDOR PRIOR TO TIE-IN.
- FIRE ALARM SEQUENCE OF OPERATION SEE SPECIFICATIONS.
- ELECTRICAL CONTRACTOR SHALL VERIFY AND COORDINATE WITH THE BUILDING FIRE ALARM MAINTENANCE VENDOR FOR TYPE OF FIRE ALARM DEVICES TO BE USED. CONTACT BUILDING MANAGEMENT FOR CONTACT INFORMATION. ALL NEW DEVICES INSTALLED SHALL BE COMPATIBLE AND CONSISTENT WITH THE EXISTING BUILDING FIRE ALARM SYSTEM INSTALLATION.
- ELECTRICAL CONTRACTOR SHALL BE RESPONSIBLE TO RETAIN AND COORDINATE WITH THE BUILDING FIRE ALARM MAINTENANCE VENDOR FOR PROGRAMMING AND FINAL CONNECTIONS TO THE FIRE ALARM SYSTEM. ELECTRICAL CONTRACTOR SHALL INCLUDE PROGRAMMING AND FINAL CONNECTION COSTS IN THEIR BID.
- THE FIRE ALARM INSTALLATION SHALL COMPLY WITH NEW YORK STATE EDUCATION DEPT. NEC, THE AMERICANS WITH DISABILITIES ACT (ADA) AND ALL AUTHORITIES HAVING JURISDICTION.
- ELECTRICAL CONTRACTOR SHALL BE RESPONSIBLE TO MAINTAIN AND PROTECT EXISTING FIRE ALARM SPEAKERS, SMOKE DETECTORS, STATIONS AND OTHER FIRE ALARM SAFETY DEVICES IN OPERATION AT ALL TIMES. IF ANY PORTION OF FIRE ALARM SYSTEM IS DISABLED, NOTIFY BUILDING MANAGER IMMEDIATELY.
- SHUTDOWN OF EXHAUST FANS OF 1,000 CFM OR GREATER, SHALL BE PERFORMED VIA INTERFACE SYSTEM. SEND SIGNAL TO BUILDING AUTOMATED TEMPERATURE CONTROL SYSTEM INDICATING SHUTDOWN HAS OCCURRED. EQUIPMENT RESTART SHALL BE BY BUILDING ATC SYSTEM UPON FIRE ALARM RESET TO NORMAL MODE. RESTART OF EQUIPMENT SHALL BE SEQUENTIAL.

3 PART F.A. RISER DIAGRAM

SCALE: N.T.S.

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DANGELO
P.C.
ARCHITECTS
PLANNERS

S.E.D. CONTROL NUMBER:
HIGH SCHOOL ADMINISTRATION BUILDING
66-040-00010102

PROJECT TITLE:
EDGEWORTH SCHOOL DISTRICT
ADMINISTRATION BUILDING
TOILET RENOVATIONS AND RELATED WORK
300 WHITE OAK LANE, EDGEWORTH, NY 10883

DRAWING TITLE:
GENERAL NOTE DETAILS & SCHEDULE


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ISSUED TO: BID

DATE: 07-01-2015
ISSUED TO: S.E.D. SUBMISSION



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ISSUED TO: E100


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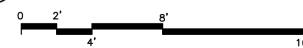
1 REMOVAL REFLECTED CEILING PLAN
SCALE: 1/4" = 1'-0"

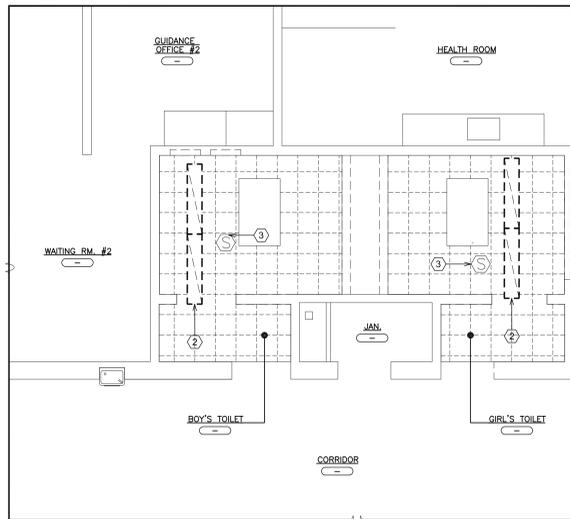


2 REFLECTED CEILING PLAN
SCALE: 1/4" = 1'-0"

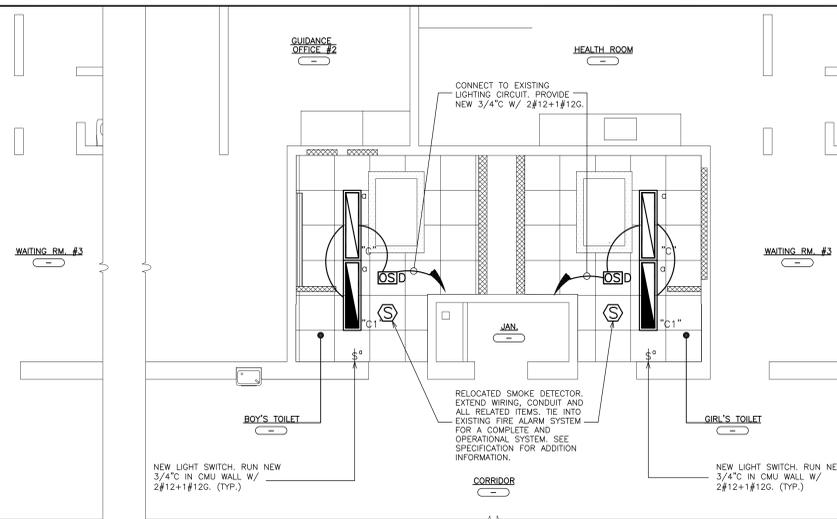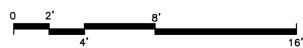



3 REFLECTED CEILING PLAN
SCALE: 1/4" = 1'-0"

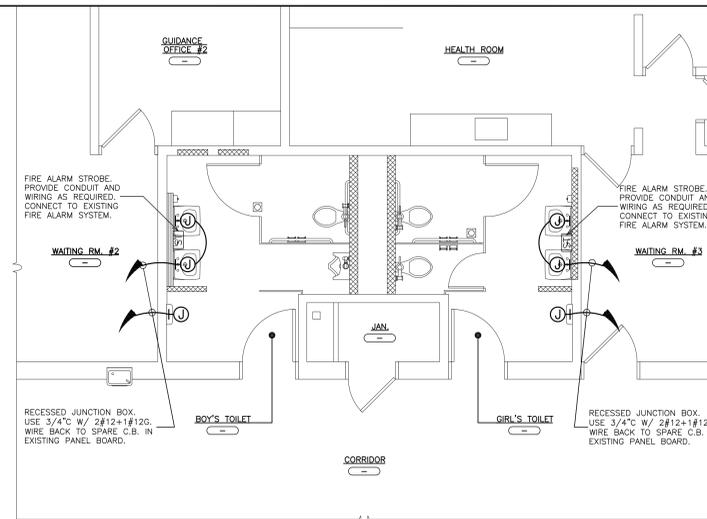



NOTE: IF ADEQUATE SPACE ABOVE CEILING USE FIXTURE TYPES "A" & "B" SIMILAR LAYOUT TO 2/E100.

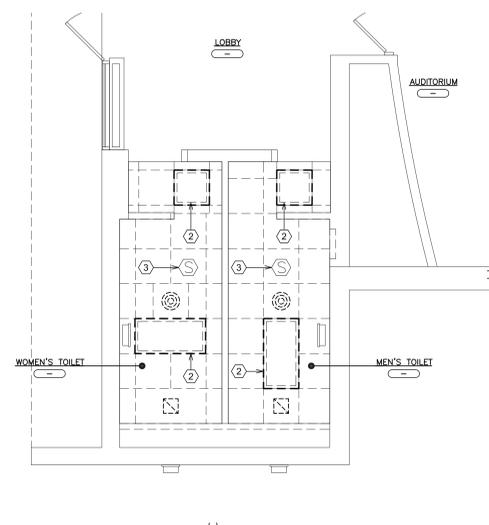

4 REMOVAL REFLECTED CEILING PLAN
SCALE: 1/4" = 1'-0"

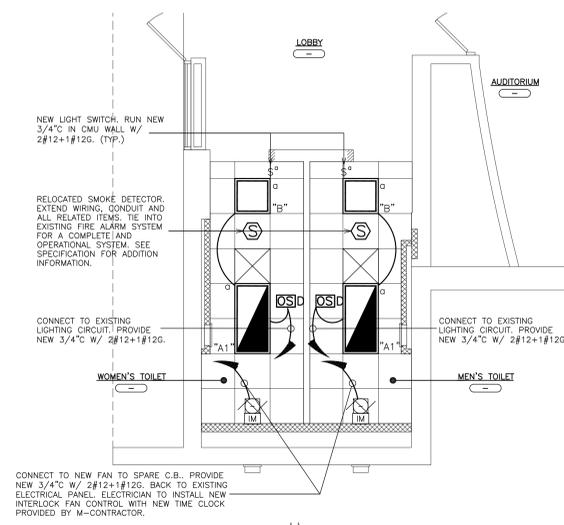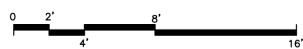

5 REFLECTED CEILING PLAN
SCALE: 1/4" = 1'-0"

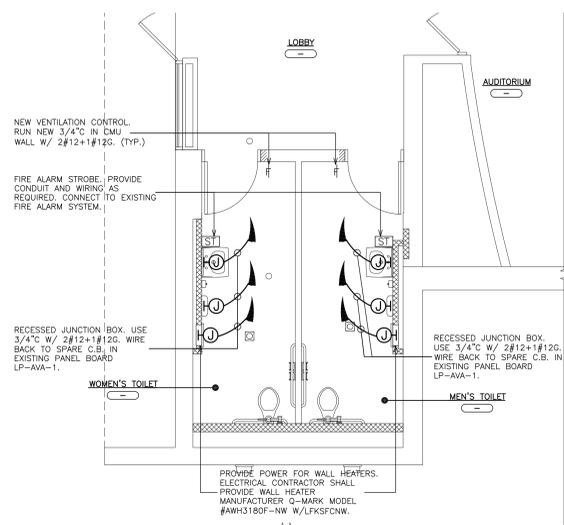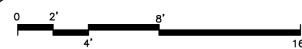


6 REFLECTED CEILING PLAN
SCALE: 1/4" = 1'-0"



ELECTRICAL REMOVE / WORKSCOPE NOTES:

- 1 EXISTING SURFACE MOUNTED DEVICE TO BE RELOCATED. EXTEND CONDUIT & WIRING AS REQUIRED. VERIFY LOCATION IN FIELD.
- 2 EXISTING LIGHT FIXTURE, EXIT LIGHTS, ETC. TO BE REMOVED, DISCONNECT AND PULL WIRES AND CONDUIT BACK TO CLOSEST JUNCTION BOX ON SWITCHED CIRCUIT. COORDINATE REMOVAL WITH GENERAL CONTRACTOR.
- 3 EXISTING FIRE ALARM DEVICE TO BE RELOCATED. EXTEND CONDUIT AND WIRING AS REQUIRED.
- 4 REMOVE EXISTING LIGHT SWITCH AND ASSOCIATED ITEMS, DISCONNECT AND PULL WIRES AND CONDUIT BACK TO THE SOURCE. COORDINATE REMOVAL WITH GENERAL CONTRACTOR.
- 5 CONTRACTOR TO REUSE EXISTING LIGHTING SWITCH GANG BOXES FOR NEW SWITCH LOCATIONS. PROVIDE BLANK COVER AS REQUIRED. CONFIRM EXACT LOCATION ON SITE BEFORE START OF ANY WORK. PROVIDE SURFACE MOUNTED BOX AS REQUIRED.

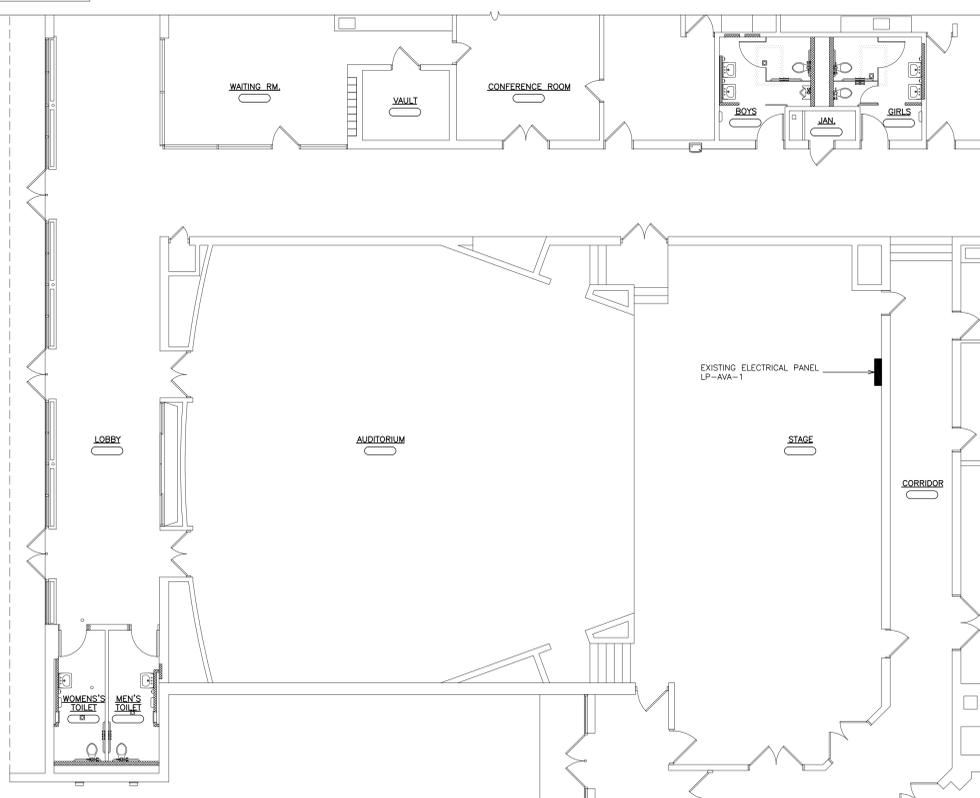

7 PARTIAL FIRST FLOOR PLAN
SCALE: 1/8" = 1'-0"



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S.E.D. CONTROL NUMBER:
HIGH SCHOOL ADMINISTRATION BUILDING
#624000001012

PROJECT: EDGEMONT SCHOOL DISTRICT ADMINISTRATION BUILDING TOILET RENOVATIONS AND RELATED WORK
300 WHITE OAK LANE, SCHENECTADY, NY 12305
DRAWING TITLE: ELECTRICAL REMOVAL & PROPOSED POWER, LIGHTING PLANS

02-24-2021	BID
07-01-2015	S.E.D. SUBMISSION
DATE	ISSUED TO
SHEET SIZE 30"x42"	DRAWING NO. E101
SCALE AS NOTED	FILE NO. 20381.00
DRAWN BY F & D	

MECHANICAL LEGEND	
	EXISTING DUCTWORK, EQUIPMENT, ETC. TO REMAIN
	EXISTING DUCTWORK, EQUIPMENT, ETC. TO BE REMOVED
	NEW DUCTWORK
	NEW DUCTWORK WITH 1" THERMAL BREAK (WHERE APPLICABLE)
	CEILING REGISTER IDENTIFICATION
	EXISTING REGISTER/DIFFUSER IDENTIFICATION
	SQUARE DUCT TURN WITH TURNING VANES
	EXISTING 4-WAY CEILING DIFFUSER
	EXISTING CEILING REGISTER
	NEW 4-WAY CEILING DIFFUSER
	NEW 4-WAY CEILING DIFFUSER WITH 1" THERMAL BREAK (WHERE APPLICABLE)
	CEILING EXHAUST/RETURN REGISTER
	DUCT MTD. MANUAL AIR VOLUME DAMPER (W/LOCKING DEVICE)
	MOTORIZED AIR VOLUME DAMPER (WITH ACCESS DOOR)
	FIRE DAMPER (U.L. APPROVED) & ACCESS DOOR
	EXISTING HOT WATER SUPPLY PIPING
	EXISTING HOT WATER RETURN PIPING
	NEW HOT WATER SUPPLY PIPING
	NEW HOT WATER RETURN PIPING
	FLOW DIRECTION WITHIN PIPE
	SHUT-OFF VALVE
	EXISTING EXHAUST FAN IDENTIFICATION
	EXISTING CABINET HEATER IDENTIFICATION
	NEW CABINET HEATER IDENTIFICATION
	EXISTING FINNED TUBE RADIATION IDENTIFICATION
	NEW DDC WALL MTD. (5'-2" +/- A.F.F.) TEMPERATURE SENSOR
	EXISTING PNEUMATIC THERMOSTAT
	EXISTING DDC SENSOR
	POINT OF DISCONNECTION
	POINT OF CONNECTION, NEW TO EXISTING
	DOOR UNDERCUT BY C.C.
	LOW DOOR LOUVER BY C.C.
	CFM CUBIC FEET PER MINUTE
	CD CEILING DIFFUSER
	CR CEILING REGISTER
	BR BOTTOM WALL REGISTER
	TR TOP WALL REGISTER
	FSC FULL SIZE CONNECTION
	AFF ABOVE FINISHED FLOOR
	OAI OUTSIDE AIR INTAKE
	FC FLEXIBLE CONNECTION
	AD ACCESS DOOR
	ITEM CONTROLLED WALL MOUNTED (5'-2" AFF) TEMPERATURE SENSOR
	SECTION/DETAIL/ELEVATION/PART PLAN NUMBER
	DRAWING NUMBER
	SECTION/ELEVATION IDENTIFICATION
	(E) EXISTING TO REMAIN
	(ER) EXISTING TO BE RELOCATED
	(R) REMOVE EXISTING

MECHANICAL REMOVAL NOTES:



- THE SCOPE OF REMOVAL SHOWN ON "REMOVALS" DRAWINGS IS DIAGRAMMATIC ONLY AND INDICATES THE INTENT OF THE WORK TO BE PERFORMED AND NOT THE COMPLETE SCOPE OF DEMOLITION AND/OR REMOVAL WORK. IT SHALL BE THE RESPONSIBILITY OF THIS CONTRACTOR TO REMOVE ANY RELATED MECHANICAL DEVICES EVEN IF NOT SPECIFICALLY INDICATED TO BE REMOVED ON THESE DRAWINGS IN ORDER TO ACCOMMODATE NEW WORK.
- DEVICES SHOWN CROSS HATCHED ON DRAWINGS ARE ITEMS TO BE REMOVED. ANY DEVICES REMOVED SHALL INCLUDE (BUT SHALL NOT BE LIMITED TO) THE REMOVAL OF ALL ASSOCIATED PIPING, CONTROLS, ETC. THAT ARE NOT INCORPORATED IN THE NEW LAYOUT, UNTIL SUCH REMOVAL IS COMPLETE. THIS CONTRACTOR SHALL PERFORM ALL WORK REQUIRED TO INSURE CONTINUITY OF SERVICE TO EXISTING REMAINING EQUIPMENT. NO EXTRAS RELATING TO THE SCOPE OF WORK DESCRIBED WILL BE ALLOWED.
- EQUIPMENT, PIPING, ETC., REQUIRED TO RECONNECT SHALL BE INSTALLED CONCEALED WITHIN THE NEW SUSPENDED CEILINGS, PARTITIONS AND/OR WALLS, FLOORS, NO SURFACE MOUNTED OR EXPOSED EQUIPMENT, PIPING, ETC., SHALL BE PERMITTED, UNLESS SPECIFICALLY INDICATED.
- ALL ITEMS TO BE REMOVED SHALL BE REVIEWED WITH THE OWNER PRIOR TO REMOVAL. OWNER SHALL HAVE FIRST SALVAGE RIGHTS. ITEMS THE OWNER WISHES TO KEEP SHALL BE REMOVED WITH CARE AND STORED AS DIRECTED BY OWNER. ITEMS THE OWNER DOES NOT WISH TO KEEP SHALL BE REMOVED FROM THE SITE AND DISPOSED OF PROPERLY.

HVAC CRITERIA:

EXHAUST: 12 AC/HR TOILETS MIN 75 PER TOILET. INLINE FANS.
 DUCTWORK SIZED ON MAXIMUM 0.1"/100 FEET.

SCHEDULE OF EXHAUST FAN									
MARK	SERVICE	LOCATION	TYPE	MODEL No. (1)	CFM	RPM	HP	ELECTRIC SERVICE	REMARKS
EF 1	EXHAUST	MEN'S TOILET	DIRECT	SP-490-130-VG	110	960	-	115/1/60	REFER TO 203030
EF 2	EXHAUST	WOMEN'S TOILET	DIRECT	SP-490-130-VG	110	960	-	115/1/60	REFER TO 203030







N (1) AS MANUFACTURED BY "GREENHECK."
 O (2) INSTALL PER MANUFACTURERS' RECOMMENDATIONS.
 T (3) PROVIDE MOUNTING HARDWARE, VIBRATION ISOLATORS.
 E (4) INTERLOCK FAN CONTROL PROVIDED BY M-CONTRACTOR & INSTALLED E-CONTRACTOR.
 S (5) PROVIDE ON/OFF/DISCONNECT SWITCHES. MINIMUM VENTILATION CONTROL ASHRAE 62.2 BY M-CONTRACTOR & INSTALLED E-CONTRACTOR.
 (6) PROVIDE HOODED WALL CAP MODEL WC-10x3 W/ POWDER COATED FINISH.

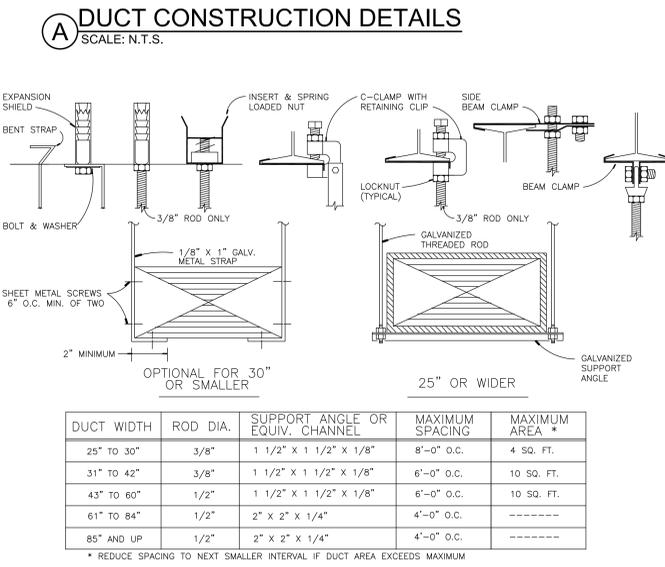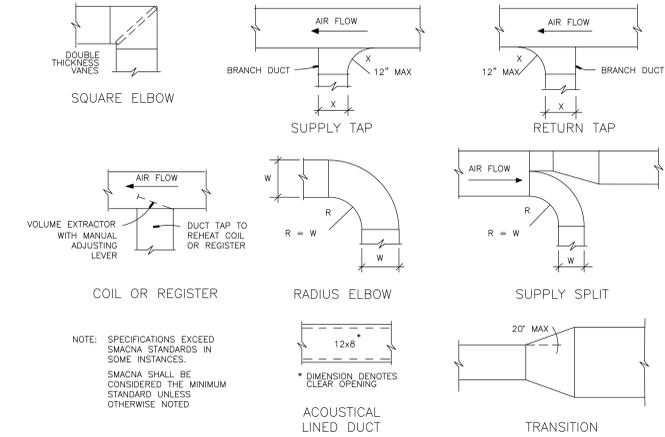

PLUMBING LEGEND	
	EXISTING PIPING, FIXTURES, ETC. TO REMAIN
	EXISTING PIPING, FIXTURES, ETC. TO BE REMOVED
	NEW PIPING, FIXTURES, ETC.
	COLD WATER PIPING
	HOT WATER PIPING
	HOT WATER RETURN PIPING
	PLUMBING VENT PIPING
	SANITARY PIPING
	EXISTING SANITARY PIPING
	EXISTING WATER PIPING
	EXISTING GAS PIPING
	GAS PIPING
	FLOW DIRECTION WITHIN PIPE
	CLEANOUT
	CLEANOUT DECK PLATE
	SHUT-OFF VALVE
	COMBINATION BALANCING & SHUT-OFF VALVE
	CHECK VALVE
	GAS SHUT OFF COCK
	PIPE CONNS. (BOTTOM; TOP 45 OR 90; PIPE UP)
	PLUMBING FIXTURE IDENTIFICATION
	VENT THRU ROOF
	EXISTING FLOOR DRAIN
	FLOOR DRAIN
	EXISTING CLEAN OUT
	CLEAN OUT
	GENERAL CONTRACTOR
	PLUMBING CONTRACTOR
	POINT OF CONNECTION
	PART PLAN, DETAIL, SECTION NUMBER
	DRAWING NUMBER
	SECTION IDENTIFICATION

PLUMBING FIXTURE SCHEDULE					
MARK	DESCRIPTION	BRANCH SIZE			
		W	V	H	C
A1	WALL MOUNTED WATER CLOSET (FLUSH VALVE) (HANDICAPPED)	4"	2"	-	1"
A2	FLOOR MOUNTED WATER CLOSET (FLUSH VALVE) (HANDICAPPED)	4"	2"	-	1"
B1	WALL MOUNTED LAVATORY (FAUCET) (HANDICAPPED) W/ LAVATORY PROTECTIVE ENCLOSURE BY TRU-BRO MODEL: LAV-SHIELD	1 1/2"	1-1/2"	1/2"	1/2"
C1	WALL MOUNTED URINAL (HANDICAPPED)	3"	2"	-	3/4"
H	HOSE BIB	-	-	-	1/2"
R	EXISTING FIXTURE TO REMAIN	-	-	-	-
X	EXISTING FIXTURE TO BE REMOVED	-	-	-	-

- PLUMBING REMOVAL NOTES:**
- REMOVE ALL PLUMBING FIXTURES, EQUIPMENT, SPECIALTIES, DRAINS, CONTROLS, HANGERS, BASES, SUPPORTS, PIPING, VALVES, TUBING AND PLUMBING ACCESSORIES THAT ARE NOT INCORPORATED IN THE NEW LAYOUT.
 - WHERE REMOVAL IS INDICATED OR IMPLIED OR NOT INCORPORATED IN THE NEW LAYOUT, THE ITEM ITSELF IS TO BE REMOVED COMPLETELY TOGETHER WITH ALL CONNECTING PIPING, SPECIALTIES, SUPPORTS, CONTROLS, ETC. CONNECTING PIPING IS TO BE REMOVED BACK TO MAINS WHERE THE ARE TO BE CAPPED OR DISCONNECTED. THIS INCLUDES ALL GAS, SANITARY, VENT, WATER, ACID WASTE AND PUMP DISCHARGE PIPING. REFER TO DIVISION 1 OF SPECIFICATION FOR CUTTING AND PATCHING REQUIREMENTS.
 - WHERE EXISTING PIPING ENTERS INACCESSIBLE TRENCHES, TUNNELS, SHAFTS, WALLS AND CEILINGS INSIDE THE EXISTING BUILDING, IT SHALL BE CUT BACK AT LEAST 2" INTO SUCH INACCESSIBLE SPACES AND SHALL BE SUITABLY CAPPED AND SEALED BY THE CONTRACTOR.
 - THE CONTRACTOR SHALL EXERCISE NORMAL CAUTION TO PREVENT UNNECESSARY CUTTING AND DAMAGE TO THE EXISTING BUILDING. ANY EXCESSIVE DAMAGE AS DETERMINED BY THE OWNER SHALL BE REPAIRED AND PAID FOR BY THE CONTRACTOR CAUSING THE DAMAGE.
 - ALL DEMOLISHED EQUIPMENT ETC. EXCEPT THOSE ITEMS SPECIFICALLY REQUESTED BY THE OWNER SHALL BECOME THE CONTRACTORS PROPERTY, SHALL BE REMOVED FROM THE PREMISES, AND DISPOSED OF LEGALLY.

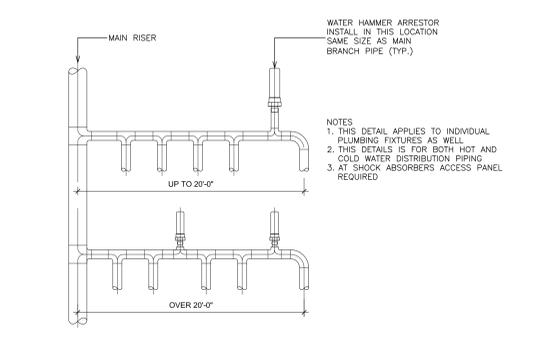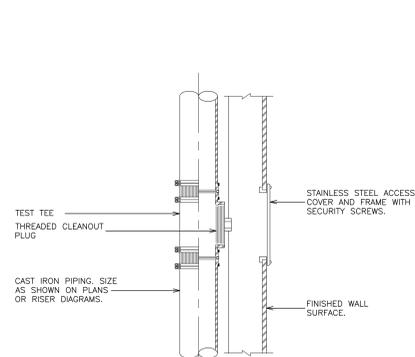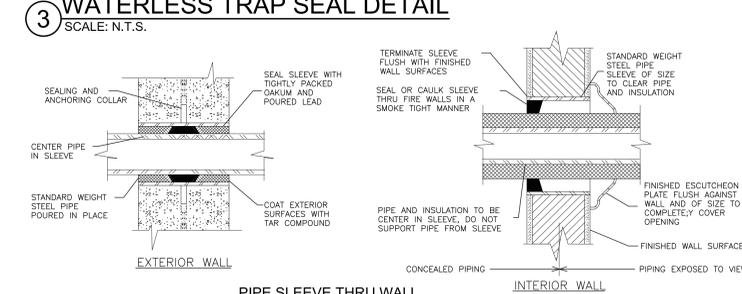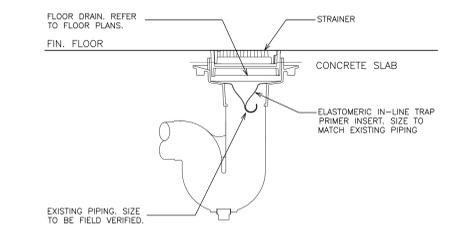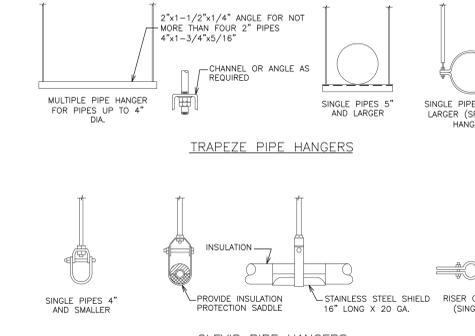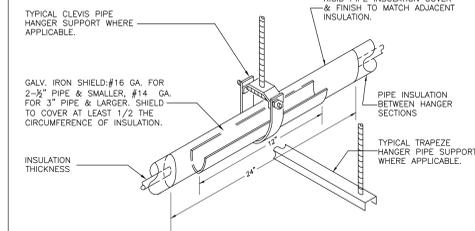


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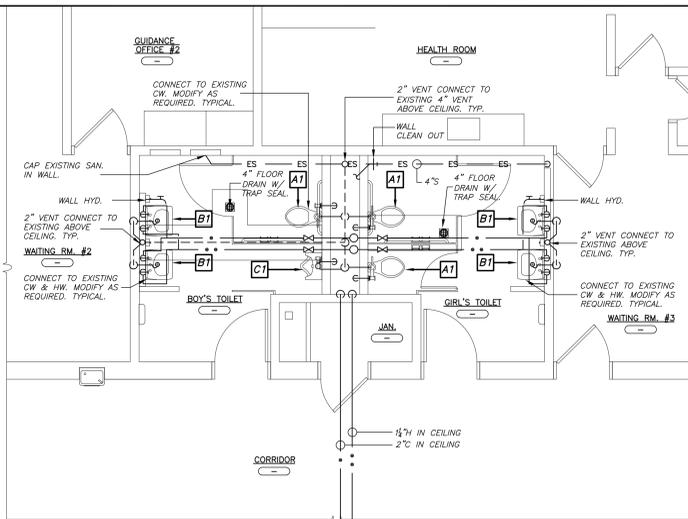
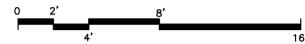
S.E.D. CONTROL NUMBER:
 HIGH SCHOOL ADMINISTRATION BUILDING
 66-046-00-01-012

PROJECT BY: EDGEMONT SCHOOL DISTRICT ADMINISTRATION BUILDING TOILET RENOVATIONS AND RELATED WORK 300 WHITE OAK LANE, SCHENECTADY, NY 12305	DRAWING TITLE: PLUMBING NOTES & DETAILS
DATE: 02-24-2021	BID
DATE: 07-01-2015	S.E.D. SUBMISSION
DATE: 07-01-2015	ISSUED TO
SHEET SIZE: 30"x42"	DRAWING NO.:
SCALE: AS NOTED	MP100
DRAWN BY: F & D	FILE NO.:
	20381.00




1 FIRST FLOOR PLUMBING REMOVAL PLAN

SCALE: 1/4" = 1'-0"

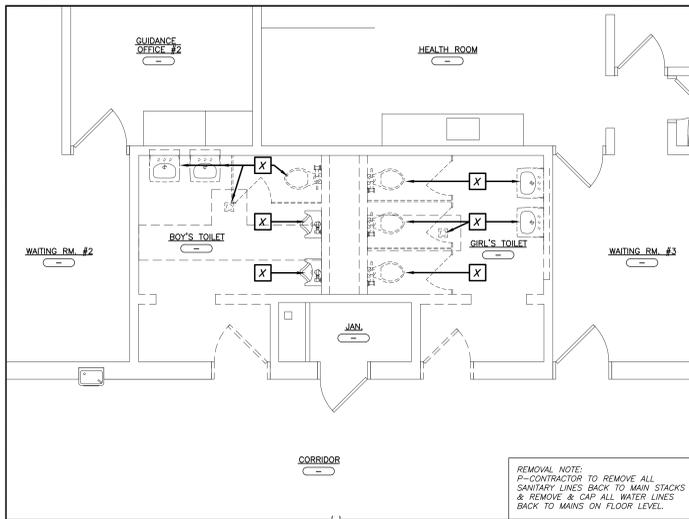


2 FIRST FLOOR PLUMBING PLAN

SCALE: 1/4" = 1'-0"


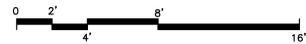


NOTES:
 1. PROVIDE NEW WATER LINES AND RECONNECT TO EXISTING WATER MAINS SERVING GANG TOILETS & LAVATORIES. PROVIDE NEW SHUT OFF VALVES AT EACH FIXTURE.
 2. CONNECT NEW DRAINS & SANITARY LINES BACK TO EXISTING SANITARY STACKS.

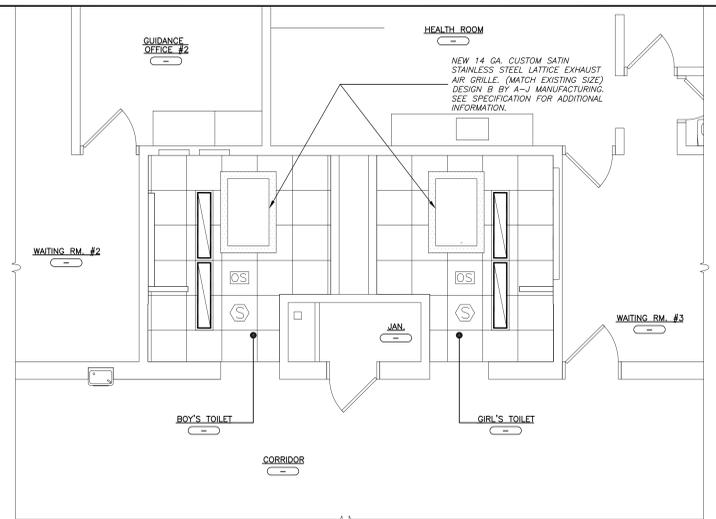


5 FIRST FLOOR MECHANICAL PLAN

SCALE: 1/4" = 1'-0"

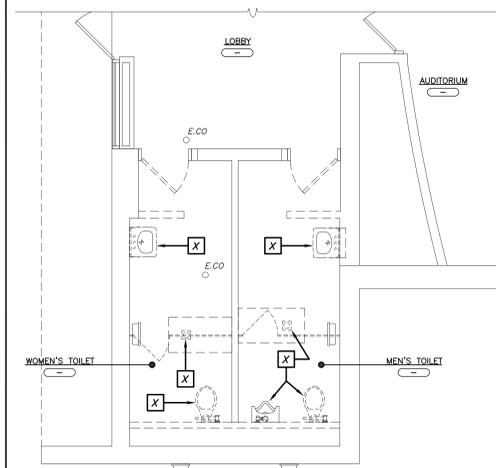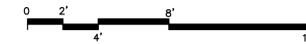

3 FIRST FLOOR PLUMBING REMOVAL PLAN

SCALE: 1/4" = 1'-0"

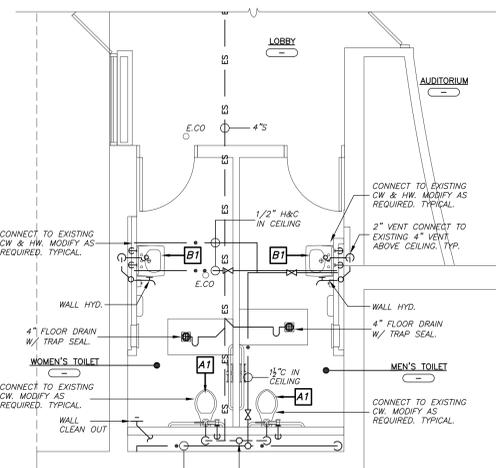


4 FIRST FLOOR PLUMBING PLAN

SCALE: 1/4" = 1'-0"



IMPORTANT NOTICE:
 THE EXISTING CONDITIONS REPRESENTED HEREON ARE BASED ON THE EXISTING DRAWINGS. THEY ARE INCLUDED FOR CONTRACTORS REFERENCE ONLY. ACTUAL LOCATION OF PIPING AND UTILITIES MAY VARY IN FIELD. PIPING CONTRACTOR SHALL VERIFY LOCATIONS IN FIELD AND MAKE ALLOWANCE IN BID FOR LOCATIONS AND ARRANGEMENTS OTHER THAN SHOWN.
 F&D CANNOT GUARANTEE THE CORRECTNESS OF THE EXISTING CONDITIONS SHOWN AND ASSUMES NO RESPONSIBILITY THEREFORE. INCLUSION OF THESE EXISTING CONDITIONS HEREON SHALL IN NO WAY ALLEVIATE THE CONTRACTOR(S) OF THEIR RESPONSIBILITY TO VISIT THE SITE TO VERIFY ALL EXISTING CONDITIONS.

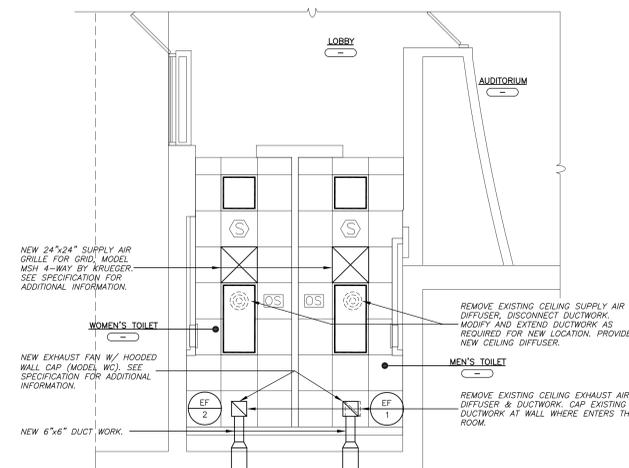

6 FIRST FLOOR MECHANICAL PLAN

SCALE: 1/4" = 1'-0"



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S.E.D. CONTROL NUMBER:
 HIGH SCHOOL ADMINISTRATION BUILDING
 66-048-00-011-012

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 ADMINISTRATION BUILDING
 TOILET RENOVATIONS AND RELATED WORK
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