#### MECHANICAL LEGEND EXISTING DUCTWORK, EQUIPMENT, ETC. TO REMAIN <del>,,,,,,,,,</del> EXISTING DUCTWORK, EQUIPMENT, ETC. TO BE REMOVED — POINT OF CHANGE IN DUCT SIZE NEW DUCTWORK 1" THERMAL ACOUSTIC LINING (WHERE APPLICABLE) POINT OF CHANGE IN DUCT SIZE TYPE-SEE SCHEDULE REGISTER/DIFFUSER IDENTIFICATION (\*)\*\*\* EXISTING REGISTER/DIFFUSER IDENTIFICATION SQUARE DUCT TURN WITH TURNING VANES EXISTING 4-WAY CEILING DIFFUSER EXISTING CEILING REGISTER TYPE -SEE SCHEDULE NEW 4-WAY CEILING DIFFUSER TYPE -SEE SCHEDULE NEW 3-WAY CEILING DIFFUSER YPE -SEE SCHEDULE CEILING EXHAUST/RETURN REGISTER DUCT MTD. MANUAL AIR VOLUME DAMPER (W/LOCKING DEVICE) MOTORIZED AIR VOLUME DAMPER (WITH ACCESS DOOR) \_\_\_\_ \_\_\_\_\_ FIRE DAMPER (U.L. APPROVED) & ACCESS DOOR — EHWS — EXISTING HOT WATER SUPPLY PIPING — EHWR — EXISTING HOT WATER RETURN PIPING NEW HOT WATER SUPPLY PIPING — HWS — — HWR — NEW HOT WATER RETURN PIPING FLOW DIRECTION WITHIN PIPE \_\_\_ $\longrightarrow \bigvee \longleftarrow$ SHUT OFF VALVE EXISTING EXHAUST FAN IDENTIFICATION EXISTING CABINET HEATER IDENTIFICATION NEW CABINET HEATER IDENTIFICATION EXISTING FINNED TUBE RADIATION IDENTIFICATION NEW DDC WALL MTD. (5'-2"+/- A.F.F.) TEMPERATURE SENSOR EXISTING PNEUMATIC THERMOSTAT EXISTING DDC SENSOR POINT OF DISCONNECTION **— →** POINT OF CONNECTION, NEW TO EXISTING DOOR UNDERCUT BY C.C LOW DOOR LOUVER BY C.C. CUBIC FEET PER MINUTE CFMCDCEILING DIFFUSER CRCEILING REGISTER BOTTOM WALL REGISTER TOP WALL REGISTER FULL SIZE CONNECTION ABOVE FINISHED FLOOR AFFOUTSIDE AIR INTAKE FLEXIBLE CONNECTION ACCESS DOOR TO ITEM CONTROLLED WALL MOUNTED (5'-2" AFF) TEMPERATURE SENSOR -SECTION/DETAIL/ELEVATION/PART PLAN NUMBER -DRAWING NUMBER SECTION/ELEVATION IDENTIFICATION EXISTING TO REMAIN (ER) EXISTING TO BE RELOCATED (R) REMOVE EXISTING

#### MECHANICAL REMOVAL NOTES:

- (1) THE SCOPE OF REMOVAL SHOWN ON "REMOVALS" DRAWINGS IS DIAGRAMMATIC ONLY AND INDICATES THE INTENT OF THE WORK TO BE PERFORMED AND NOT THE COMPLETE SCOPE OF DEMOLITION AND/OR REMOVAL WORK. IT SHALL BE THE RESPONSIBILITY OF THIS CONTRACTOR TO REMOVE ANY RELATED MECHANICAL DEVICES EVEN IF NOT SPECIFICALLY INDICATED TO BE REMOVED ON THESE DRAWINGS IN ORDER TO ACCOMMODATE NEW WORK.
- (2) DEVICES SHOWN CROSS HATCHED ON DRAWINGS ARE ITEMS TO BE REMOVED. ANY DEVICES REMOVED SHALL INCLUDE (BUT SHALL NOT BE LIMITED TO) THE REMOVAL OF ALL ASSOCIATED PIPING, CONTROLS, ETC. THAT ARE NOT INCORPORATED IN THE NEW LAYOUT, UNTIL SUCH REMOVAL IS COMPLETE. THIS CONTRACTOR SHALL PERFORM ALL WORK REQUIRED TO INSURE CONTINUITY OF SERVICE TO EXISTING REMAINING EQUIPMENT. NO EXTRAS RELATING TO THE SCOPE OF WORK DESCRIBED WILL BE ALLOWED.
- 3 EQUIPMENT, PIPING, ETC., REQUIRED TO RECONNECT SHALL BE INSTALLED CONCEALED WITHIN THE NEW SUSPENDED CEILINGS, PARTITIONS AND/OR WALLS, FLOORS, NO SURFACE MOUNTED OR EXPOSED EQUIPMENT, PIPING, ETC., SHALL BE PERMITTED, UNLESS SPECIFICALLY
- (4) ALL ITEMS TO BE REMOVED SHALL BE REVIEWED WITH THE OWNER PRIOR TO REMOVAL. OWNER SHALL HAVE FIRST SALVAGE RIGHTS. ITEMS THE OWNER WISHES TO KEEP SHALL BE REMOVED WITH CARE AND STORED AS DIRECTED BY OWNER. ITEMS THE OWNER DOES NOT WISH TO KEEP SHALL BE REMOVED FROM THE SITE AND DISPOSED OF PROPERLY.

#### **HVAC CRITERIA:**

12 AC/HR TOILETS MIN 75 PER TOILET. INLINE FANS. EXHAUST:

DUCTWORK SIZED ON MAXIMUM 0.1"/100 FEET.


SCHEDULE OF EXHAUST FAN									
MARK	SERVICE	LOCATION	TYPE	MODEL No. 1	CFM	RPM	HP	ELECTRIC SERVICE	REMARKS
EF 1	EXHAUST	MEN'S TOILET	DIRECT	SP-A90- 130-VG	110	960	_	115/1/60	REFER TO 23456
EF 2	EXHAUST	WOMEN'S TOILET	DIRECT	SP-A90- 130-VG	110	960	_	115/1/60	REFER TO 23456
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 $\mathbb{N}(1)$  as manufactured by "greenheck."


INSTALL PER MANUFACTURERS RECOMMENDATIONS.

PROVIDE MOUNTING HARDWARE, VIBRATION ISOLATORS.  $\mathsf{E}\left(4
ight)$  interlock fan control provided by m-contractor & installed e-contractor.

S (5) PROVIDE ON/OFF/DISCONNECT SWITCHES. MINIMUM VENTILATION CONTROL ASHRAE 62.2 BY M-CONTRACTOR & INSTALLED E-CONTRACTOR. PROVIDE HOODED WALL CAP MODEL WC-10x3 W/ POWDER COATED FINISH.

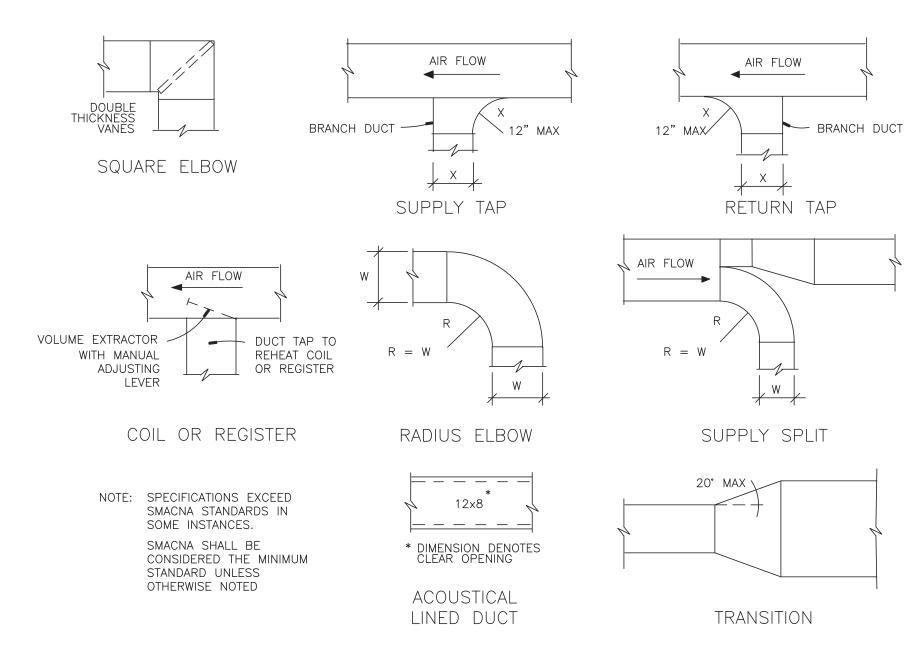

# DUCT CONSTRUCTION DETAILS SCALE: N.T.S.

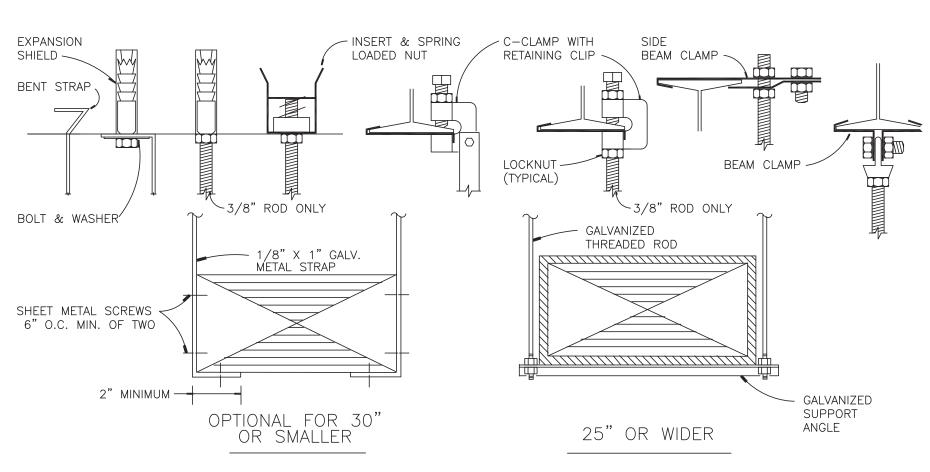

DUCT WIDTH	ROD DIA.	SUPPORT ANGLE OR EQUIV. CHANNEL	MAXIMUM SPACING	MAXIMUM AREA *
25" TO 30"	3/8"	1 1/2" X 1 1/2" X 1/8"	8'-0" O.C.	4 SQ. FT.
31" TO 42"	3/8"	1 1/2" X 1 1/2" X 1/8"	6'-0" O.C.	10 SQ. FT.
43" TO 60"	1/2"	1 1/2" X 1 1/2" X 1/8"	6'-0" O.C.	10 SQ. FT.
61" TO 84"	1/2"	2" X 2" X 1/4"	4'-0" O.C.	
85" AND UP	1/2"	2" X 2" X 1/4"	4'-0" O.C.	
* REDUCE SPACING TO NEXT SMALLER INTERVAL IF DUCT AREA EXCEEDS MAXIMUM				

	PLUMBING LEGEND
	EXISTING PIPING, FIXTURES, ETC. TO REMAIN
<del>\\\\</del>	EXISTING PIPING, FIXTURES, ETC. TO BE REMOVED
	NEW PIPING, FIXTURES, ETC.
o	COLD WATER PIPING
• •	HOT WATER PIPING
	HOT WATER RETURN PIPING
	PLUMBING VENT PIPING
— s —	SANITARY PIPING
— ES —	EXISTING SANITARY PIPING
——EW ——	EXISTING WATER PIPING
——EG ——	EXISTING GAS PIPING
—— G ——	GAS PIPING
<b>—</b>	FLOW DIRECTION WITHIN PIPE
1	CLEANOUT
<u></u>	CLEANOUT DECK PLATE
<b>─</b> ₩	SHUT-OFF VALVE
— <del> </del>	COMBINATION BALANCING & SHUT-OFF VALVE
	CHECK VALVE
—ф—	GAS SHUT OFF COCK
<del></del>	PIPE CONNS. (BOTTOM; TOP 45 OR 90; PIPE UP)
*	PLUMBING FIXTURE IDENTIFICATION
VTR	VENT THRU ROOF
EFD	EXISTING FLOOR DRAIN
FD	FLOOR DRAIN
ECO	EXISTING CLEAN OUT
CO	CLEAN OUT
G.C.	GENERAL CONTRACTOR
P.C.	PLUMBING CONTRACTOR
•	POINT OF CONNECTION
*	PART PLAN, DETAIL, SECTION NUMBER  DRAWING NUMBER  SECTION IDENTIFICATION

PLUMBING FIXTURE SCHEDULE						
MARK	DESCRIPTION	BRANCH SIZE				
IVI/ALALA	BESOMI HOW	W V		Н	С	
A1	WALL MOUNTED WATER CLOSET (FLUSH VALVE) (HANDICAPPED)	4"	2"	_	1"	
A2	FLOOR MOUNTED WATER CLOSET (FLUSH VALVE) (HANDICAPPED)	4"	2"	_	1"	
B1	WALL MOUNTED LAVATORY (FAUCET) (HANDICAPPED) W/ LAVATORY PROTECTIVE ENCLOSURE BY TRU-BRO MODEL: LAV-SHIELD	1 1/2"	1-1/2"	1/2"	1/2"	
C1	WALL MOUNTED URINAL (HANDICAPPED)	3"	2"	_	3/4"	
	HOSE BIB	_	_	_	1/2"	
R	EXISTING FIXTURE TO REMAIN	_	_	-	_	
X	EXISTING FIXTURE TO BE REMOVED	_	_	_	_	


#### PLUMBING REMOVAL NOTES:

- 1 REMOVE ALL PLUMBING FIXTURES, EQUIPMENT, SPECIALTIES, DRAINS, CONTROLS, HANGERS, BASES, SUPPORTS, PIPING, VALVES, TUBING AND PLUMBING ACCESSORIES THAT ARE NOT INCORPORATED IN THE NEW LAYOUT.
- 2 WHERE REMOVAL IS INDICATED OR IMPLIED OR NOT INCORPORATED IN THE NEW LAYOUT, THE ITEM ITSELF IS TO BE REMOVED COMPLETELY TOGETHER WITH ALL CONNECTING PIPING, SPECIALTIES, SUPPORTS, CONTROLS, ETC. CONNECTING PIPING IS TO BE REMOVED BACK TO MAINS WHERE THE ARE TO BE CAPPED OR DISCONNECTED. THIS INCLUDES ALL GAS, SANITARY, VENT, WATER, ACID WASTE AND PUMP DISCHARGE PIPING. REFER TO DIVISION I OF SPECIFICATION FOR CUTTING AND PATCHING
- 3 WHERE EXISTING PIPING ENTERS INACCESSIBLE TRENCHES, TUNNELS, SHAFTS, WALLS AND CEILINGS INSIDE THE EXISTING BUILDING, IT SHALL BE CUT BACK AT LEAST 2" INTO SUCH INACCESSIBLE SPACES AND SHALL BE SUITABLY CAPPED AND SEALED BY THE CONTRACTOR.
- 4 THE CONTRACTOR SHALL EXERCISE NORMAL CAUTION TO PREVENT UNNECESSARY CUTTING AND DAMAGE TO THE EXISTING BUILDING. ANY EXCESSIVE DAMAGE AS DETERMINED BY THE OWNER SHALL BE REPAIRED AND PAID FOR BY THE CONTRACTOR CAUSING THE DAMAGE.
- 5 ALL DEMOLISHED EQUIPMENT ETC. EXCEPT THOSE ITEMS SPECIFICALLY REQUESTED BY THE OWNER SHALL BECOME THE CONTRACTORS PROPERTY, SHALL BE REMOVED FROM THE PREMISES, AND DISPOSED OF LEGALLY.


TEST TEE ---

THREADED CLEANOUT PLUG


CAST IRON PIPING. SIZE AS SHOWN ON PLANS -OR RISER DIAGRAMS.

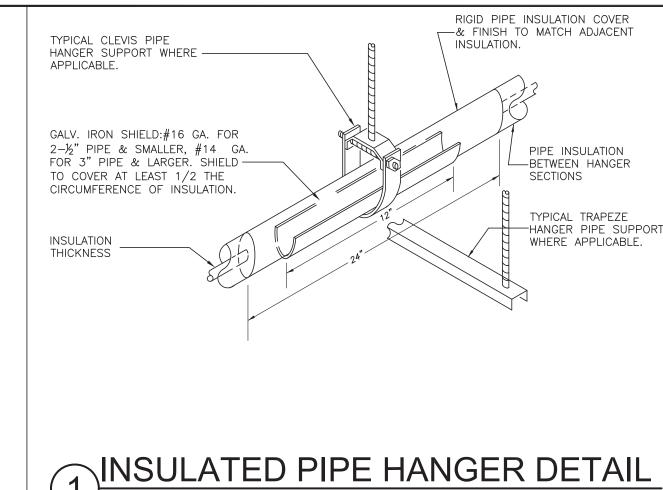

## SCALE: N.T.S.

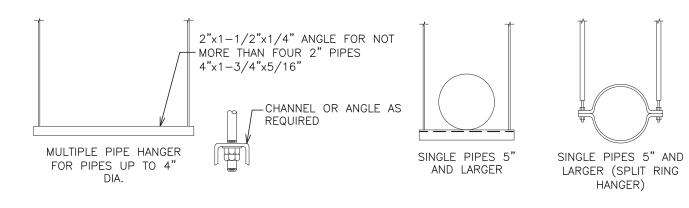


TRAPEZE PIPE HANGERS

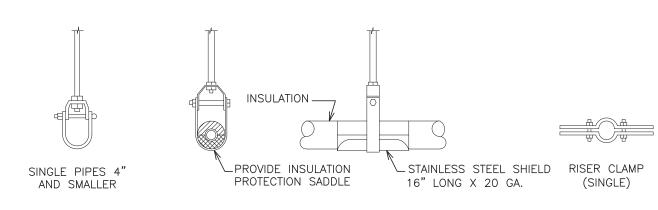



CLEVIS PIPE HANGERS

### METHOD OF PIPE SUPPORT

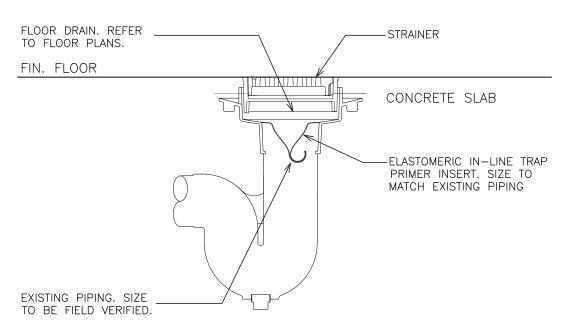

### WATERLESS TRAP SEAL DETAIL

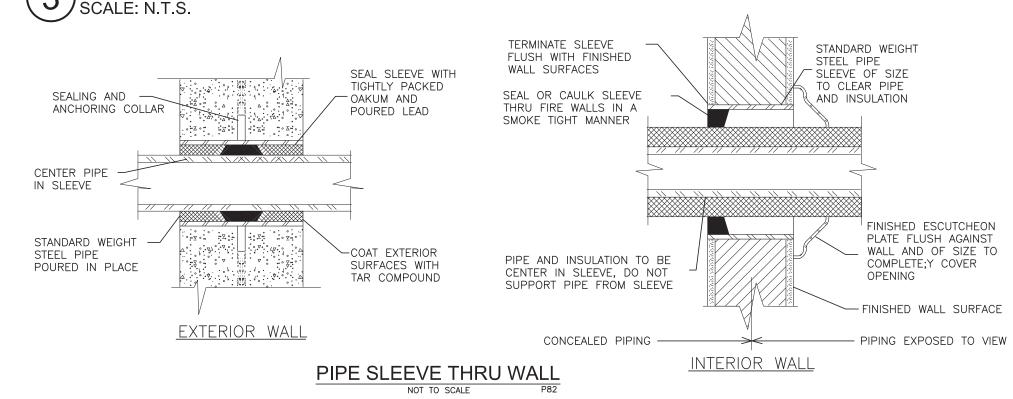

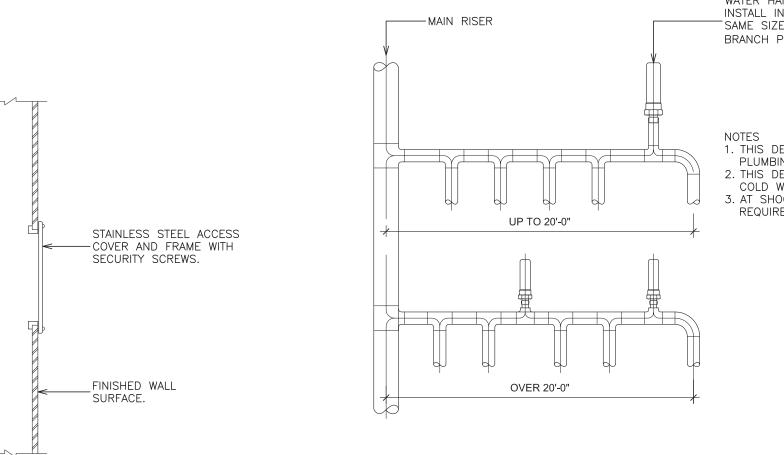

AIR CHAMBER & WALL CLEANOUT DETAIL
SCALE: N.T.S.

/	—— MAIN RISER	V	WATER HAMMER ARRESTOR INSTALL IN THIS LOCATION SAME SIZE AS MAIN BRANCH PIPE (TYP.)
	UP TO 20'-0"		NOTES  1. THIS DETAIL APPLIES TO INDIVIDUAL PLUMBING FIXTURES AS WELL  2. THIS DETAILS IS FOR BOTH HOT AND COLD WATER DISTRIBUTION PIPING  3. AT SHOCK ABSORBERS ACCESS PANEL REQUIRED
\	OVER 30'-0"		

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S.E.D. CONTROL NUMBER: HIGH SCHOOL ADMINISTRATION BUILDING:

07-01-2015

DATE

SHEET SIZE 30"x42"

AS NOTED

F&D

DRAWN BY

SCALE

S.E.D. SUBMISSION

ISSUED TO

20381.00

FILE NO.

SHOCK ABSORBER LOCATIONS
SCALE: N.T.S.