STATE UNIVERSITY CONSTRUCTION FUND

STATE UNIVERSITY PLAZA 353 BROADWAY ALBANY, NY 12246

STATE UNIVERSITY OF NEW YORK - NEW PALTZ


1 HAWK DR NEW PALTZ, NY 12561

CONTRACT NUMBER:

SUCF #081047-00

CONTRACT TITLE:

REPLACE ROOFS - SMILEY ARTS, COLLEGE THEATRE, DORSKY MUSEUM AND FACULTY OFFICE BUILDING

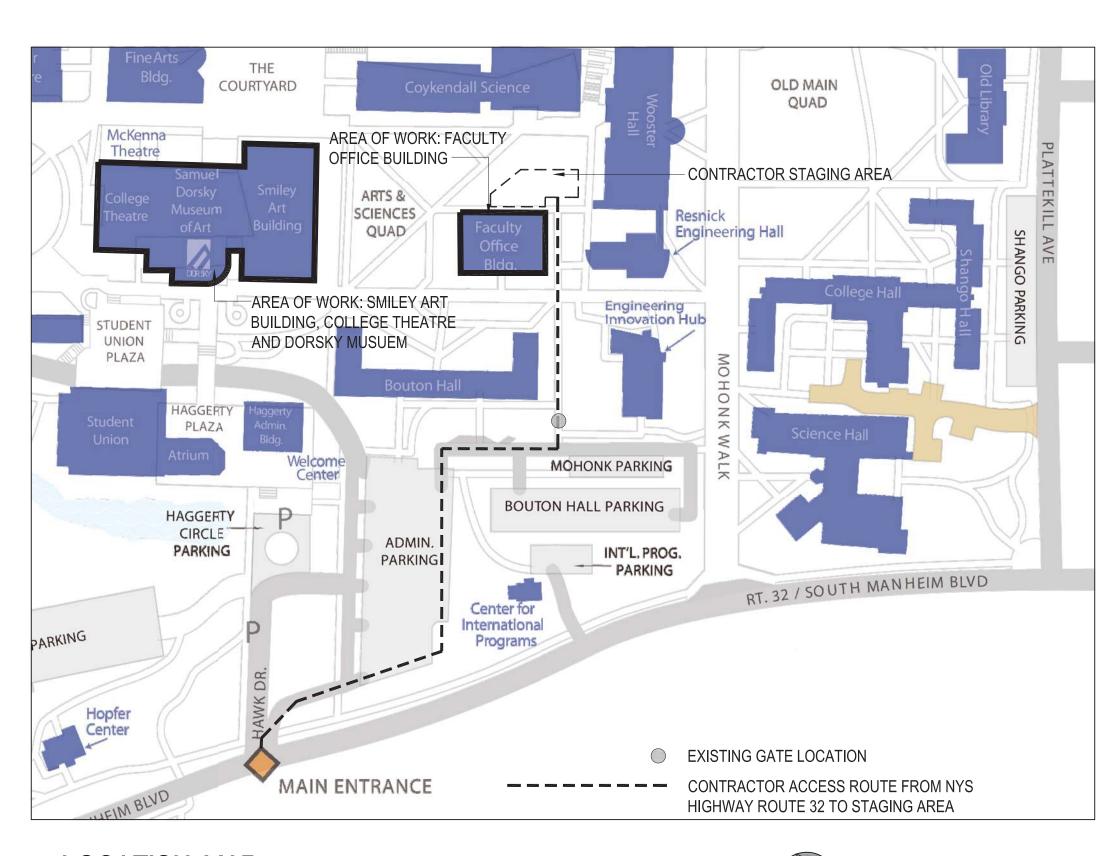

LOCATION MAP SCALE: NOT TO SCALE



DRAWING LIST

COVER SHEET

ARCHITECTURA	L
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T003	CONTRUCTION BARRIERS, WALKWAYS & STAGING AREA FENCING
R001	SMILEY ARTS BUILDING REFERENCE SHEET 1 OF 2
R002	COLLEGE THEATRE REFERENCE SHEET 2 OF 2
A061	SAB ROOF REMOVALS PLAN
A062	FACULTY OFFICE BUILDING (FOB) REMOVALS PLAN AND SECTIONS
A101	SAB CONSTRUCTION ROOF PLAN
A102	FOB CONSTRUCTION ROOF PLAN AND ENLARGED SECTIONS
A103	ROOF "R8" CONSTRUCTION PLAN
A104	ROOF "R10" CONSTRUCTION PLAN
A301	SECTIONS AND DETAILS
A302	ROOF STAIR AND LADDER SECTIONS AND DETAILS
A303	SKYLIGHT SECTIONS AND DETAILS
A304	MISCELLANEOUS SECTIONS AND DETAILS
A305	EXPANSION JOINT SECTIONS AND DETAILS

GENERAL NOTES, CODE COMPLIANCE, ACCESSIBILITY NOTES

HAZMAT

SAB ROOF ABATEMENT PLAN

TYPICAL ROOF DETAILS

"To the best of my knowledge, information, and belief, the construction documents for this project are in conformance with the Building Code of New York State and all other applicable Federal and State laws and regulations, all as currently amended."

NYS Registration No. Date

Michael D. Szerbaty, AIA	17767	01/08/2021
Name of Registered Professional who sealed these drawings	NYS Registration No.	Date
Sai S. Barade, PE	081788	01/08/2021

Name of Registered Professional who

sealed these drawings

MECH	IANICAL
M001 M002 M003	HVAC SYMBOLS LIST & ABBREVIATIONS HVAC NOTES NOTES & SCHEDULES
DM100	HVAC ROOF REMOVAL PLAN & 1ST FL PART PLAN - SMILEY ARTS, MCKENNA THEATRE AND DORSKY MUSEUM (SAB)
DM101 M100	HVAC ROOF REMOVAL PLAN - FACULTY OFFICE BUILDING HVAC ROOF CONSTRUCTION PLAN - SMILEY ARTS, MCKENNA THEATRE AND
M101	DORSKY MUSEUM (SAB) HVAC ROOF CONSTRUCTION PLAN - FACULTY OFFICE BUILDING
M401 M402 M403	HVAC CONTROLS SHEET 1 OF 3 HVAC CONTROLS SHEET 2 OF 3 HVAC CONTROLS SHEET 3 OF 3
M501 M502	HVAC - DETAILS SHEET 1 OF 2 HVAC - DETAILS SHEET 2 OF 2
M800 M801	TEMPORARY CONSTRUCTION PLAN 1 TEMPORARY CONSTRUCTION PLAN 2
PLUM	BING
P001	PLUMBING - GENERAL NOTES
P062 P064	PLUMBING - SAB ROOF DEMOLITION PLAN PLUMBING - FOB ROOF DEMOLITION PLAN
P102 P104	PLUMBING - SAB ROOF CONSTRUCTION PLAN PLUMBING - FOB ROOF CONSTRUCTION PLAN
P301 P302	PLUMBING - RISER DIAGRAM II PLUMBING - RISER DIAGRAM II
ELEC [®]	TRICAL ELECTRICAL SYMBOLS, NOTES & ABBREVIATIONS
E002	ELECTRICAL NOTES AND DRAWING LIST
DE404	FLECTRICAL DOCE DEMOVAL DUANT CAMERY ADTO MOVEMBLA THEATDE AND

ELECTRICAL ROOF REMOVAL PLAN - SMILEY ARTS, MCKENNA THEATRE AND

ELECTRICAL ROOF CONSTRUCTION PLAN - SMILEY ARTS, MCKENNA THEATRE AND

ELECTRICAL ROOF REMOVAL PLAN - FACULTY OFFICE BUILDING

ELECTRICAL ROOF CONSTRUCTION PLAN - FACULTY OFFICE BUILDING

DORSKY MUSEUM (SAB)

DORSKY MUSEUM (SAB)

ELECTRICAL DETAILS

ELECTRICAL POWER TO TEMPORARY AC UNIT

SUNY PROGRAM UNIT:

MDSZERBATY ASSOCIATES ARCHITECTURE




307 7th AVENUE 15th FLOOR NEW YORK, NY 10001

555 8th AVENUE, SUITE 1502 NEW YORK, NY 10018 TEL: 212.680.8945

SUNY NEW PALTZ **Building Address:** 1 HAWK DRIVE, NEW PALTZ, NY 12561 SMILEY ARTS BUILDING, COLLEGE THEATRE DORSKY MUSEUM AND

FACULTY OFFICE BUILDING

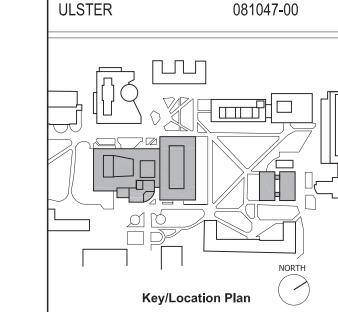

Project No.:

Contract Title: ROOF REPLACEMENT - SMILEY ARTS, COLLEGE THEATRE, DORSKY MUSEUM AND FACULTY OFFICE BUILDING


Project No.: 081047-00

Drawing Title: **COVER SHEET**



JASON CAMPAGNA Drawn By: JOHN O'CONNOR Checked By: JANUARY 8, 2021

Drawing No.:

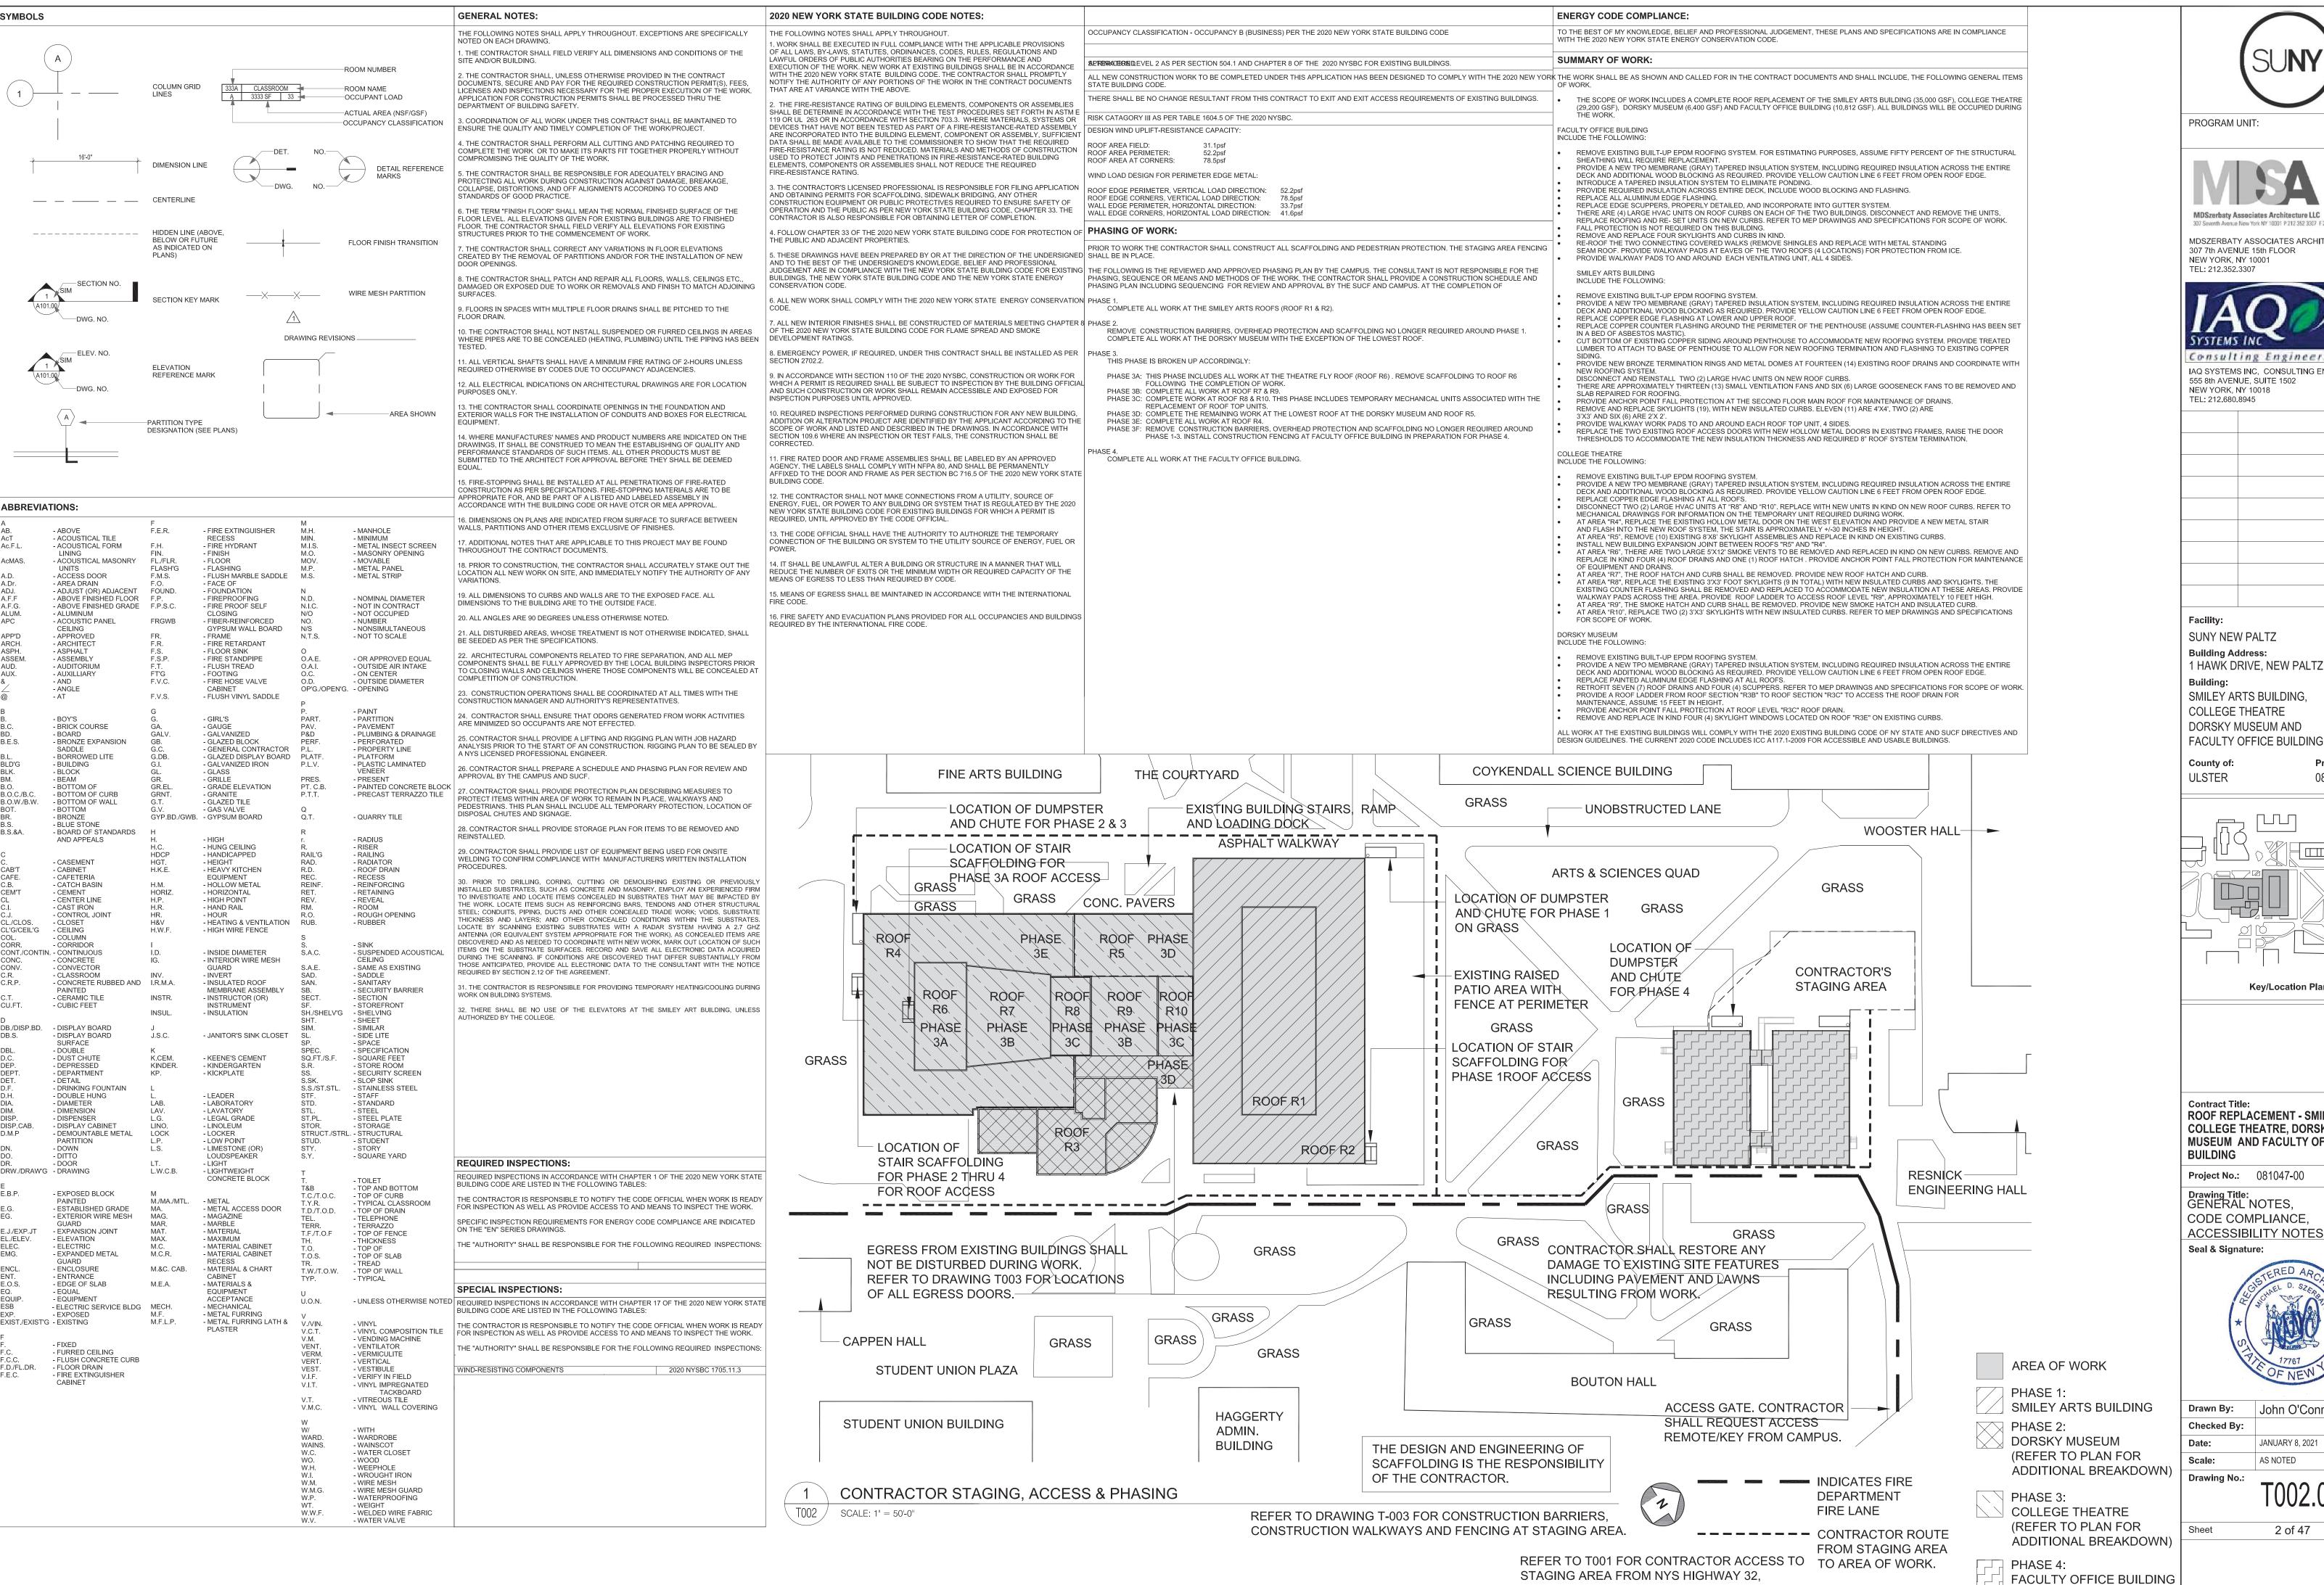



307 Seventh Avenue New York NY 10001 P 212 352 3307 F 212 352 9266 mdsnyc.com

MDSZERBATY ASSOCIATES ARCHITECTURE 307 7th AVENUE 15th FLOOR



Consulting Engineers IAO SYSTEMS INC. CONSULTING ENGINEERS 555 8th AVENUE, SUITE 1502

1 HAWK DRIVE, NEW PALTZ, NY 12561

SMILEY ARTS BUILDING, **COLLEGE THEATRE** DORSKY MUSEUM AND **FACULTY OFFICE BUILDING**

081047-00

Key/Location Plan


ROOF REPLACEMENT - SMILEY ARTS. COLLEGE THEATRE, DORSKY MUSEUM AND FACULTY OFFICE


Project No.: 081047-00

Drawing Title: GENERAL NOTES, CODE COMPLIANCE,



John O'Connor JANUARY 8, 2021 AS NOTED

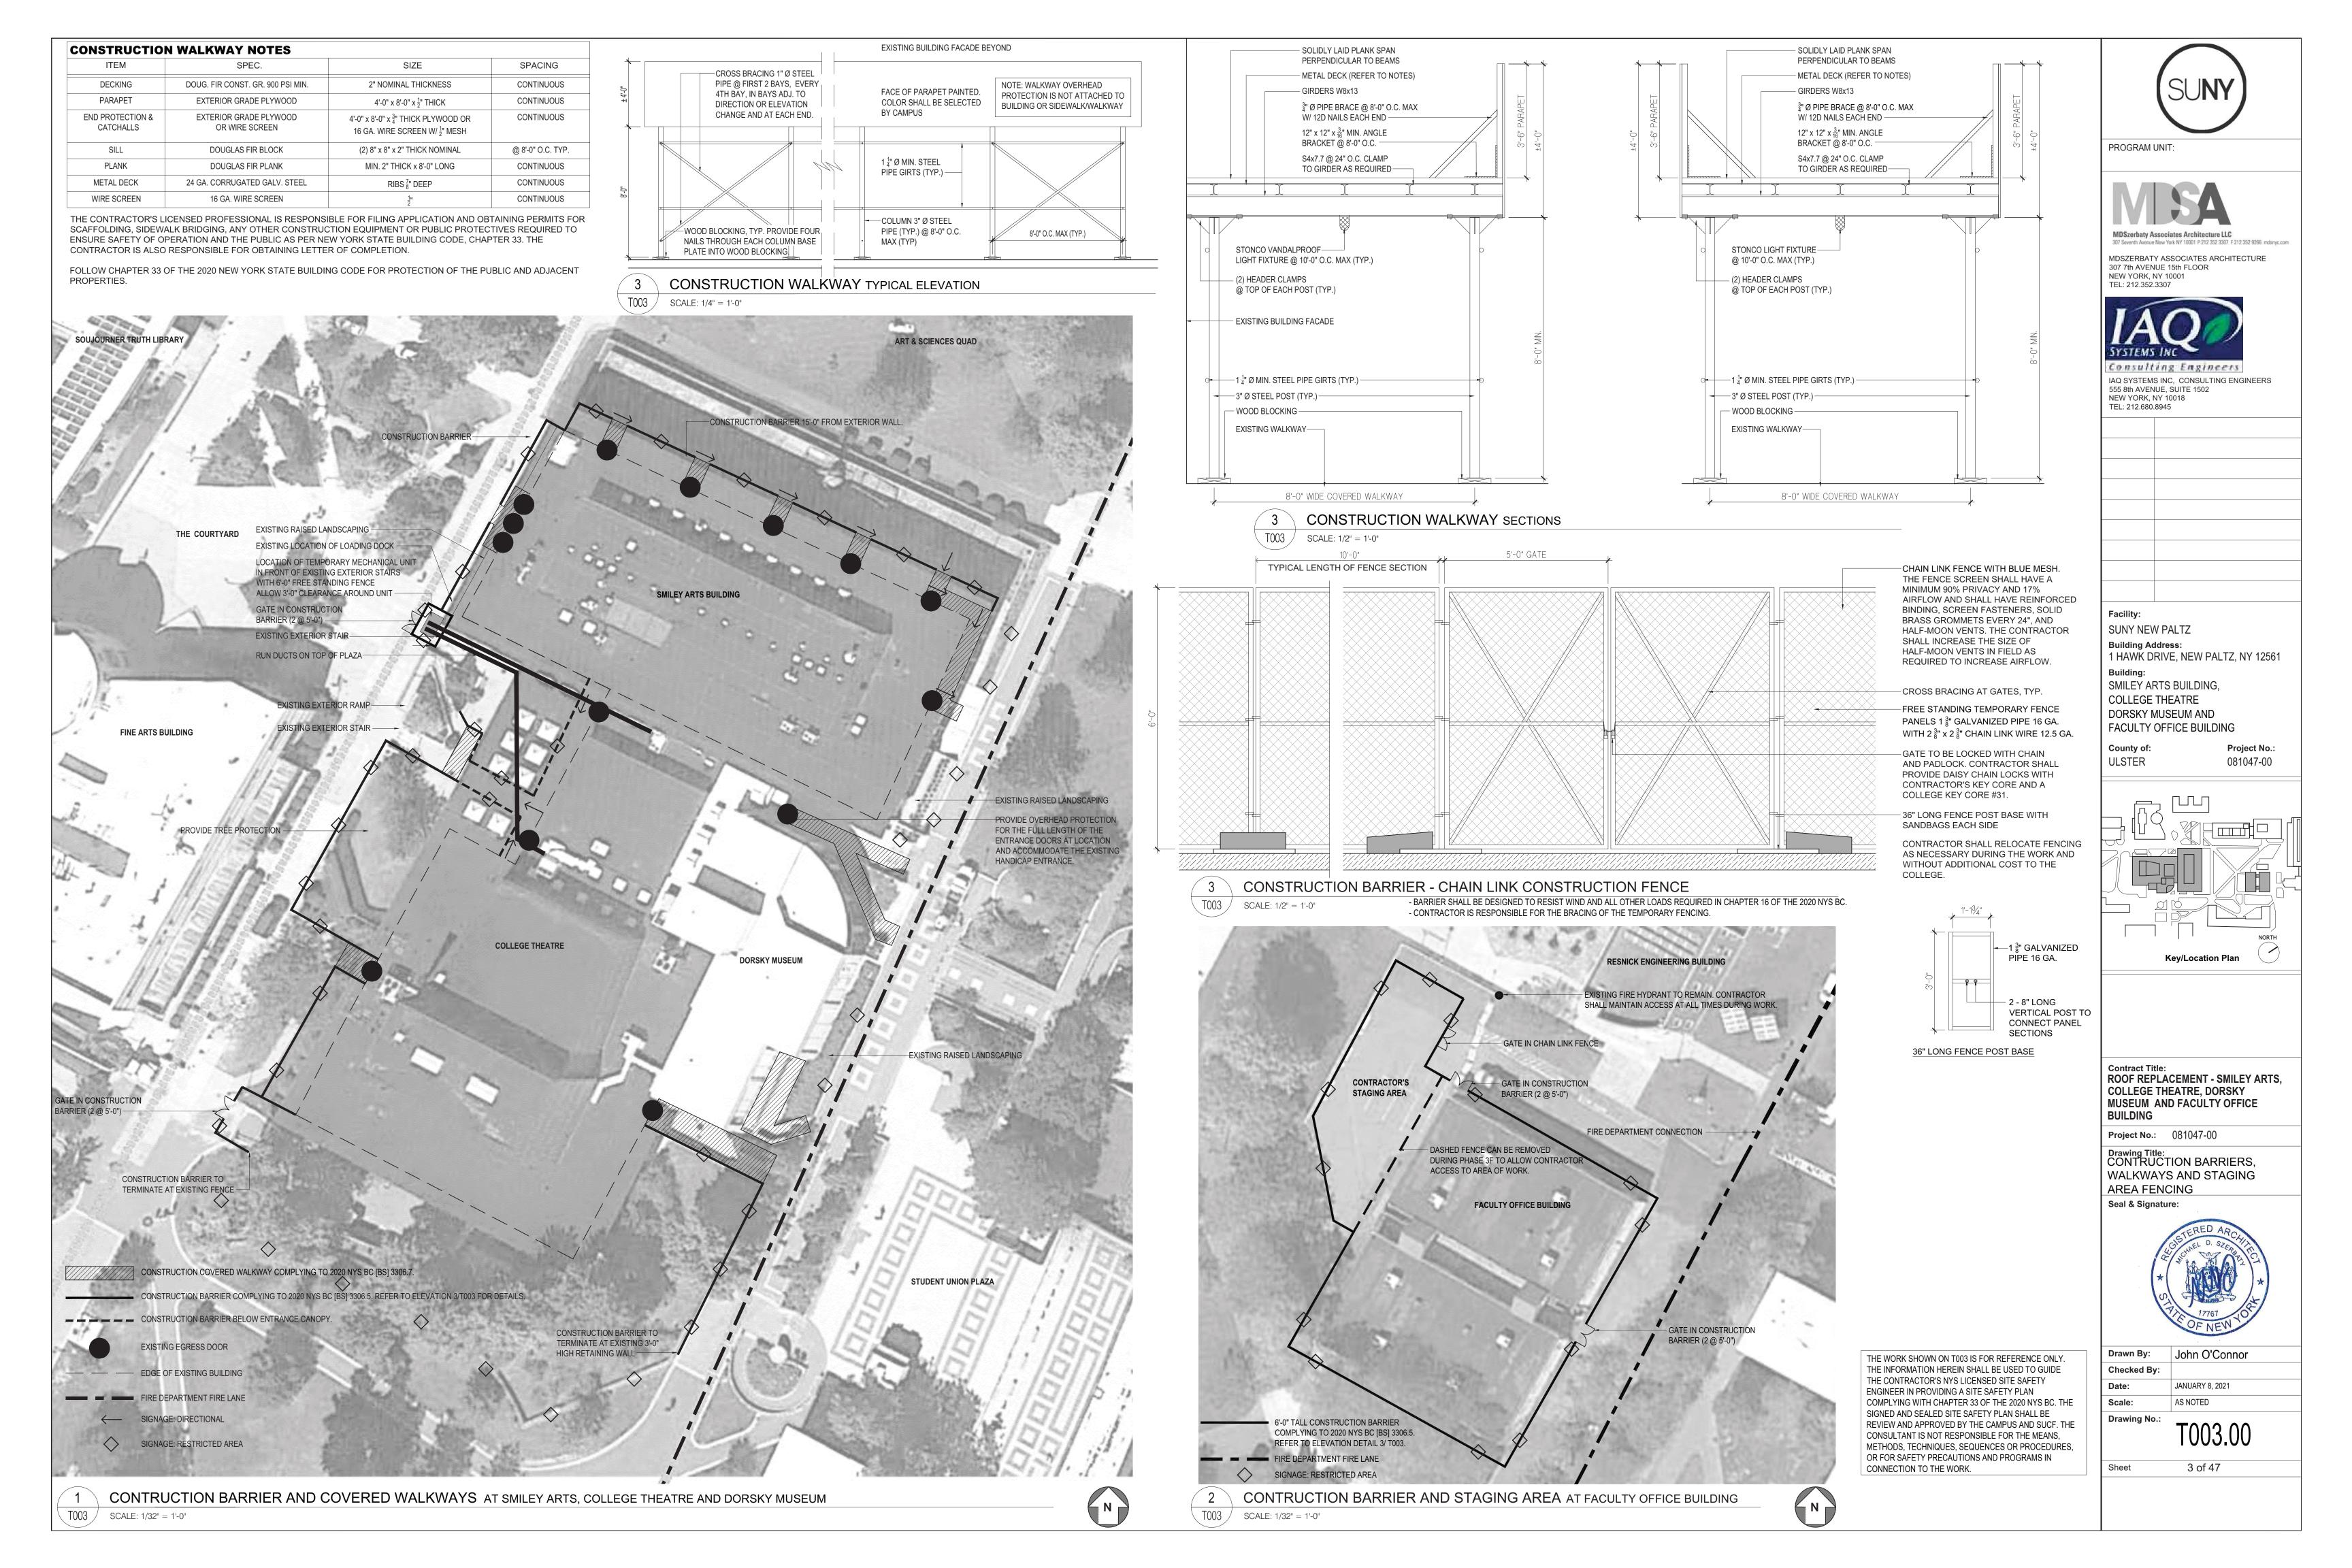

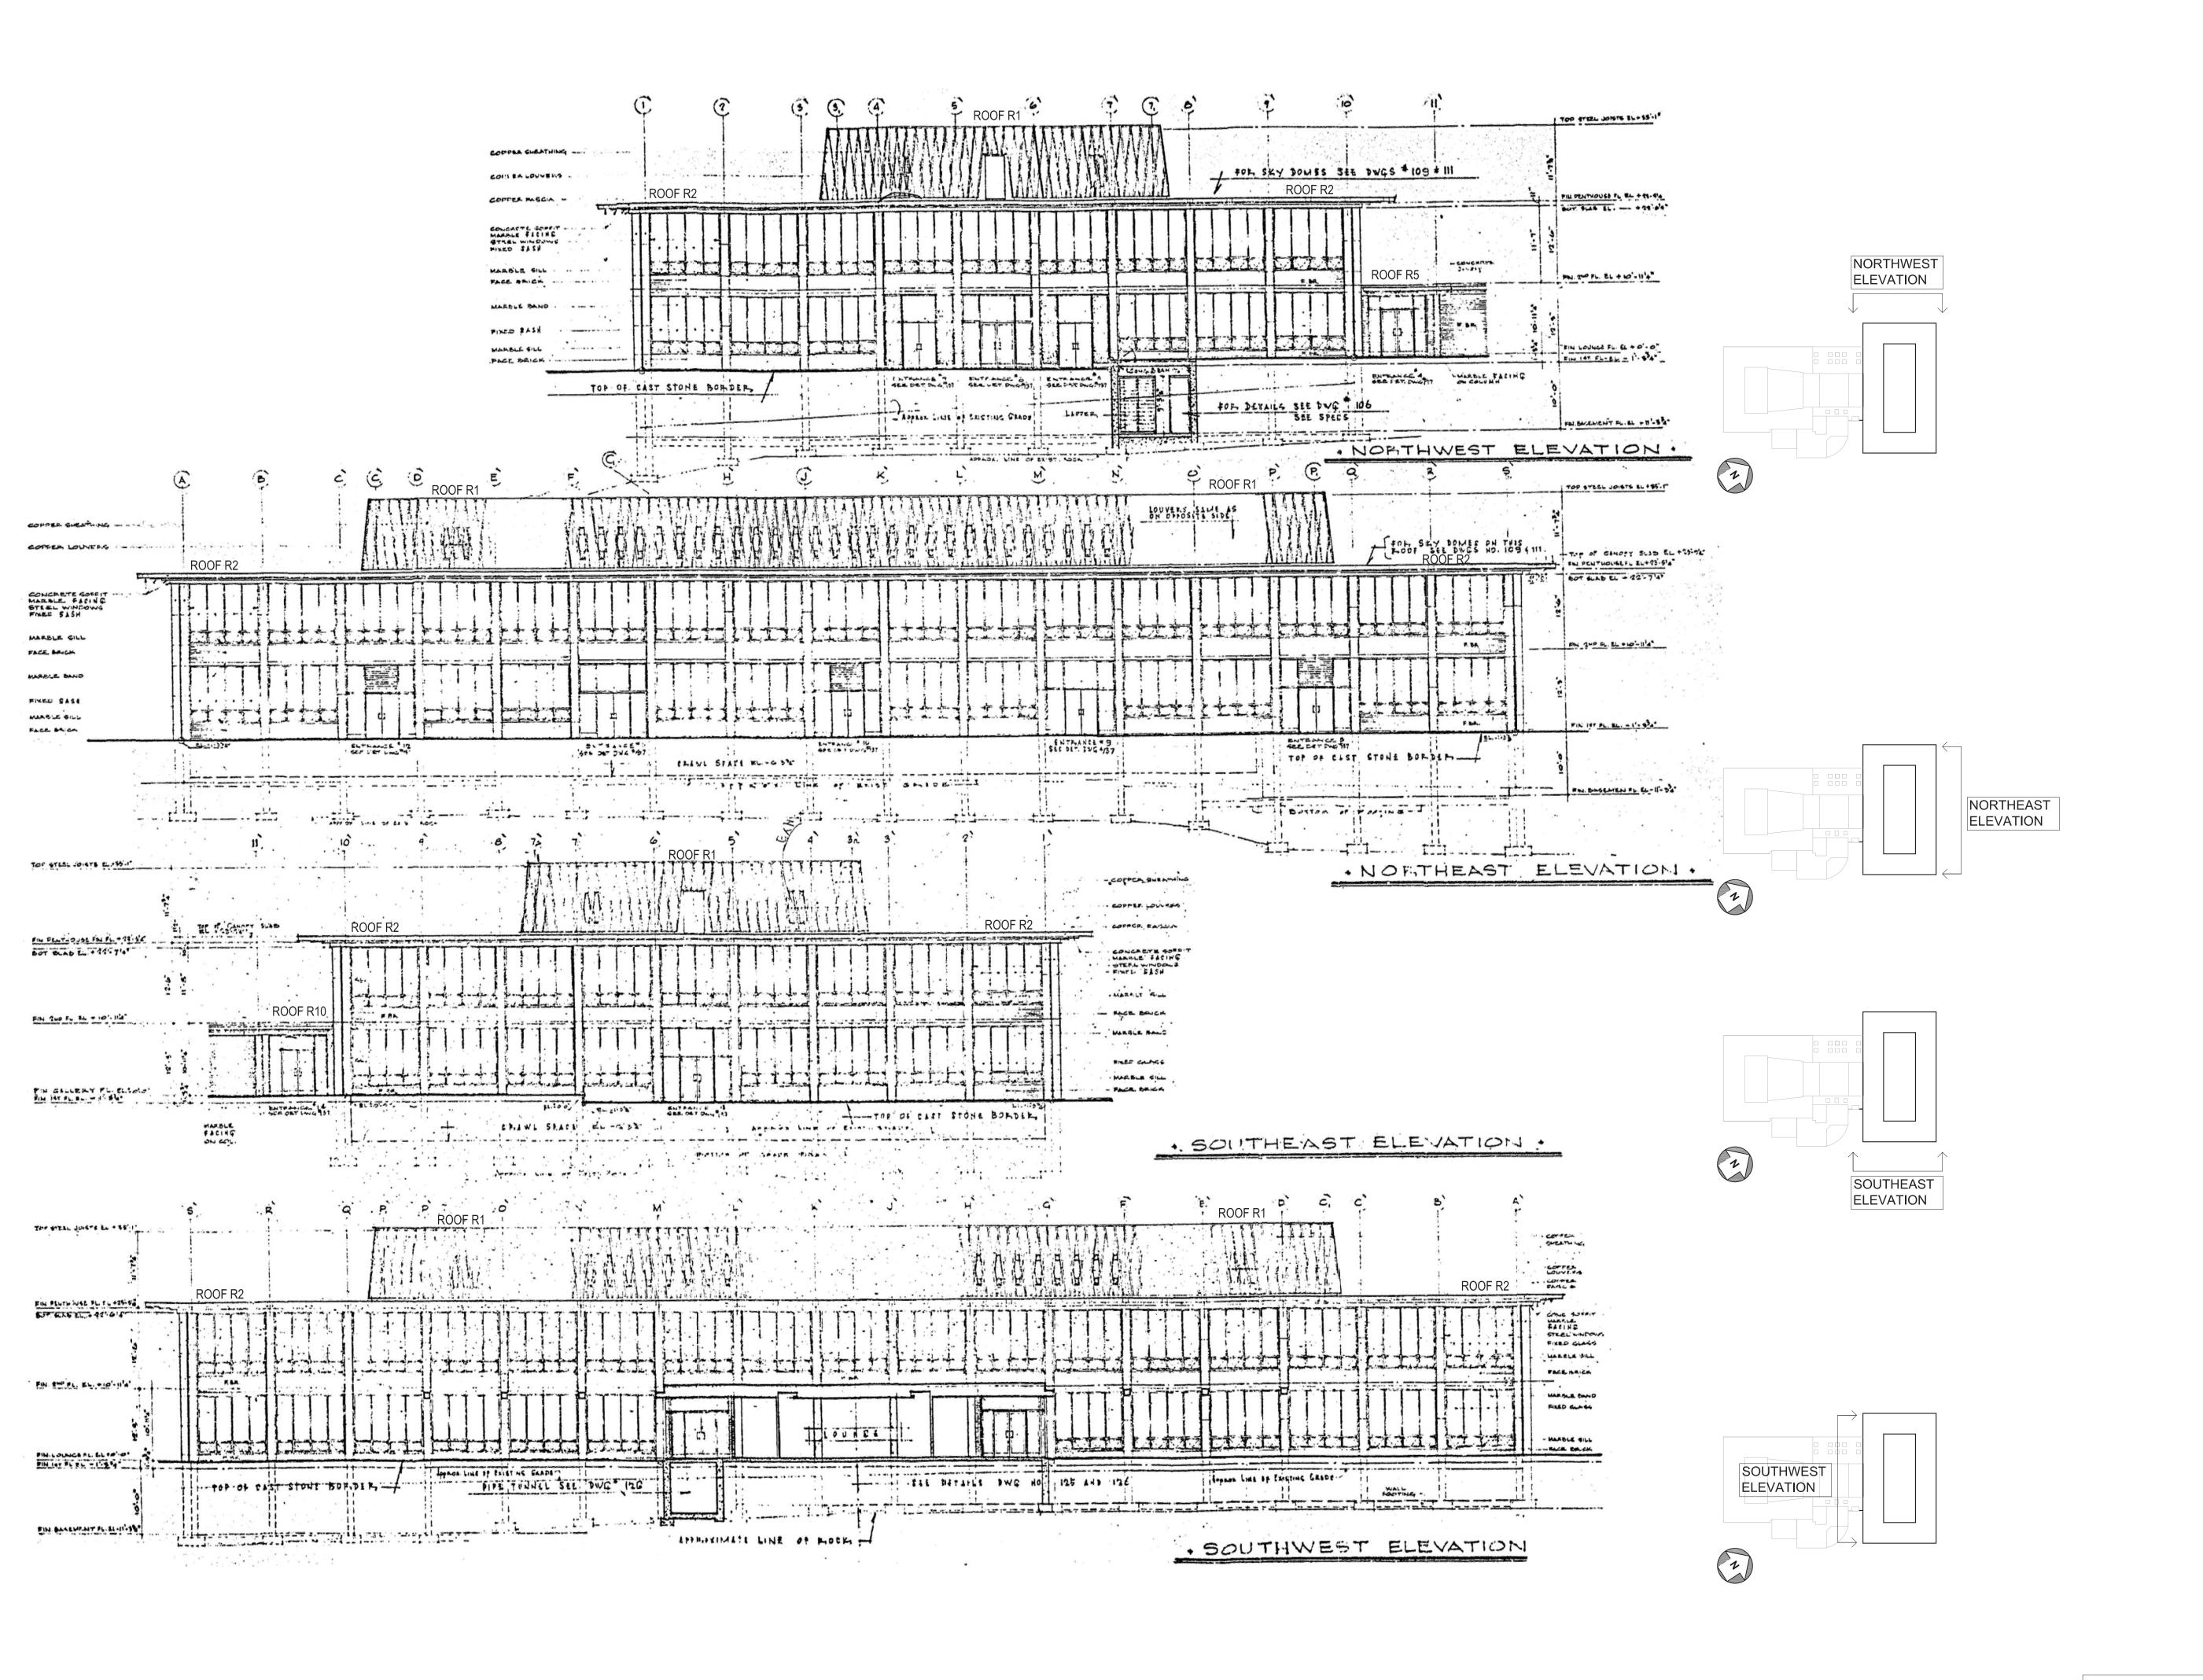



PROGRAM UNIT:



307 Seventh Avenue New York NY 10001 P 212 352 3307 F 212 352 9266 md

MDSZERBATY ASSOCIATES ARCHITECTURE
307 7th AVENUE 15th FLOOR



NEW YORK, NY 10001

Consulting Engineers

IAQ SYSTEMS INC, CONSULTING ENGINEE
555 8th AVENUE, SUITE 1502

NEW YORK, NY 10018

TEL: 212.680.8945


Facility:

SUNY NEW PALTZ

Building Address:
1 HAWK DRIVE, NEW PALTZ, NY 12561

Building:
SMILEY ARTS BUILDING,
COLLEGE THEATRE
DORSKY MUSEUM AND
FACULTY OFFICE BUILDING

County of: ULSTER Project No.: 081047-00

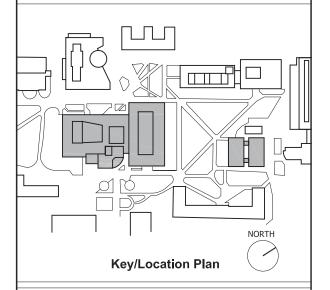

Contract Title:
ROOF REPLACEMENT - SMILEY ARTS,
COLLEGE THEATRE, DORSKY
MUSEUM AND FACULTY OFFICE
BUILDING

Project No.: 081047-00

Drawing Title:
SMILEY ARTS BUILDING
REFERENCE SHEET 1 OF 2

Seal & Signature:



Drawn By: JASON CAMPAGNA

Checked By: JOHN O'CONNOR

Date: JANUARY 8, 2021


Scale: AS NOTED


Prawing No.: R001.00

Sheet 4 of 47


DRAWING FOR REFERENCE ONLY


Elevations taken from drawings dated February 6, 1961

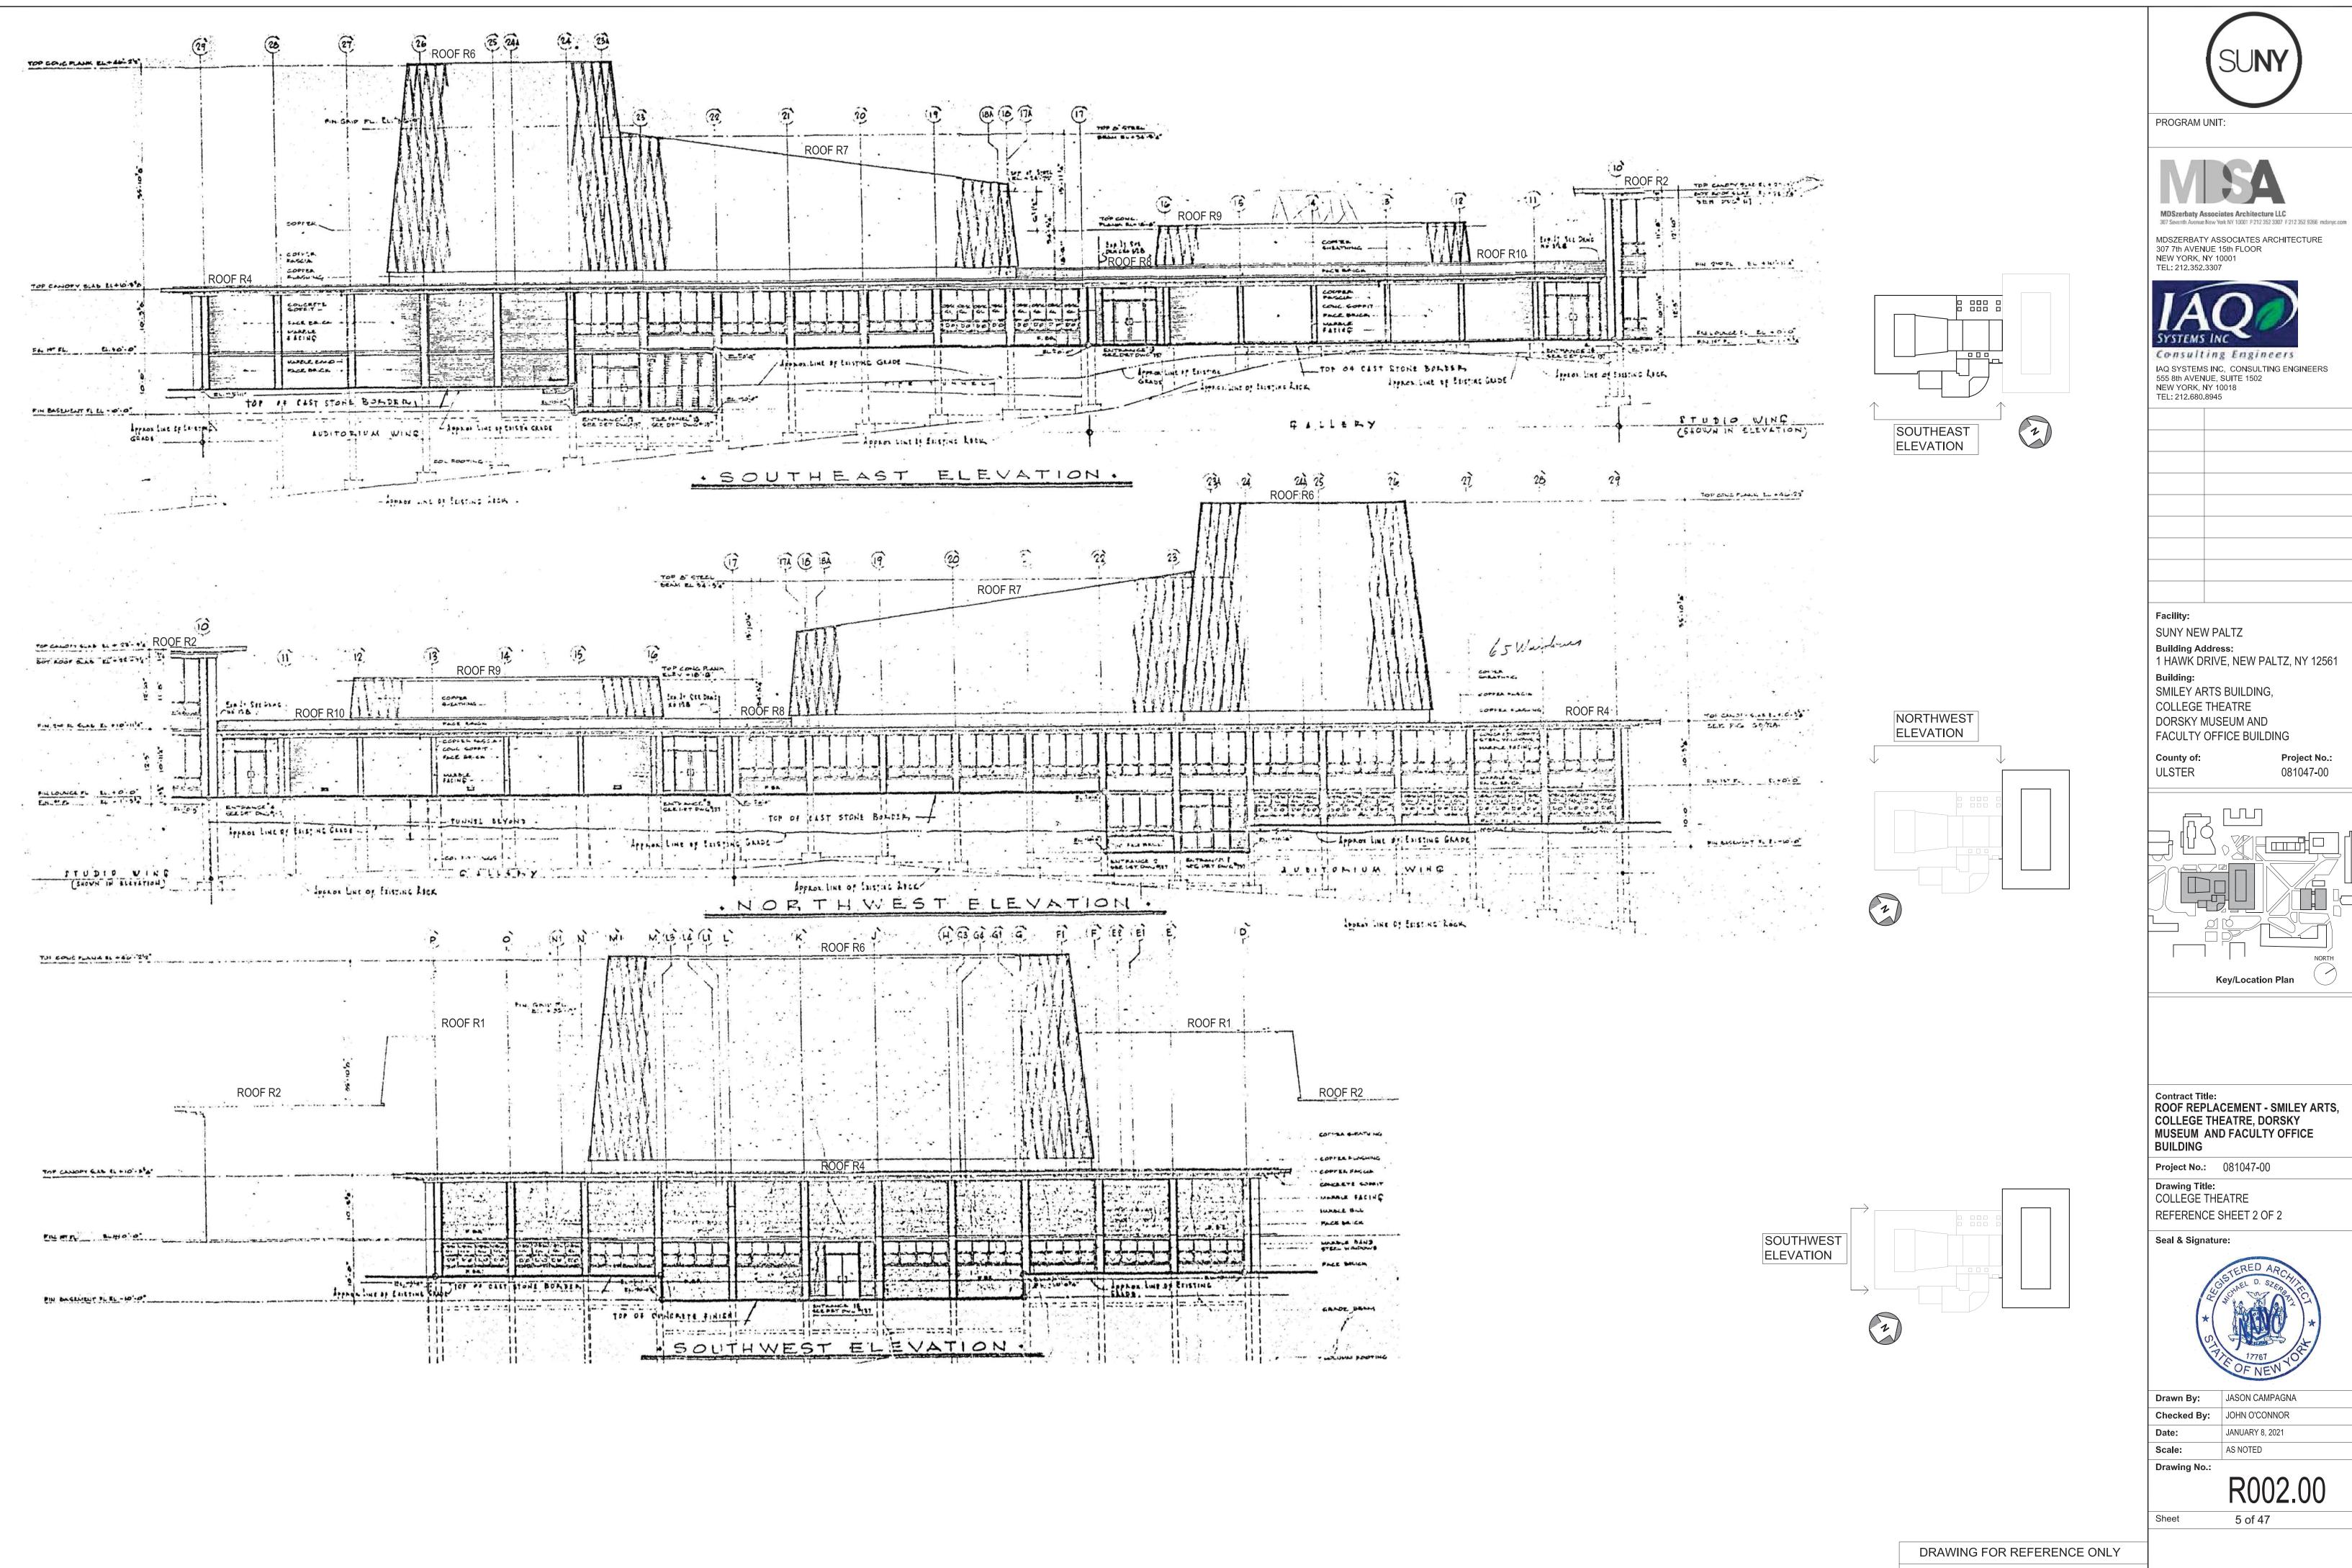

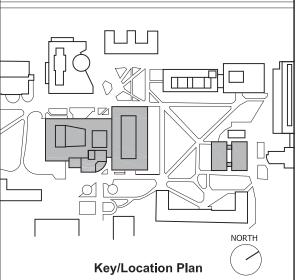


Elevations taken from drawings dated February 6, 1961

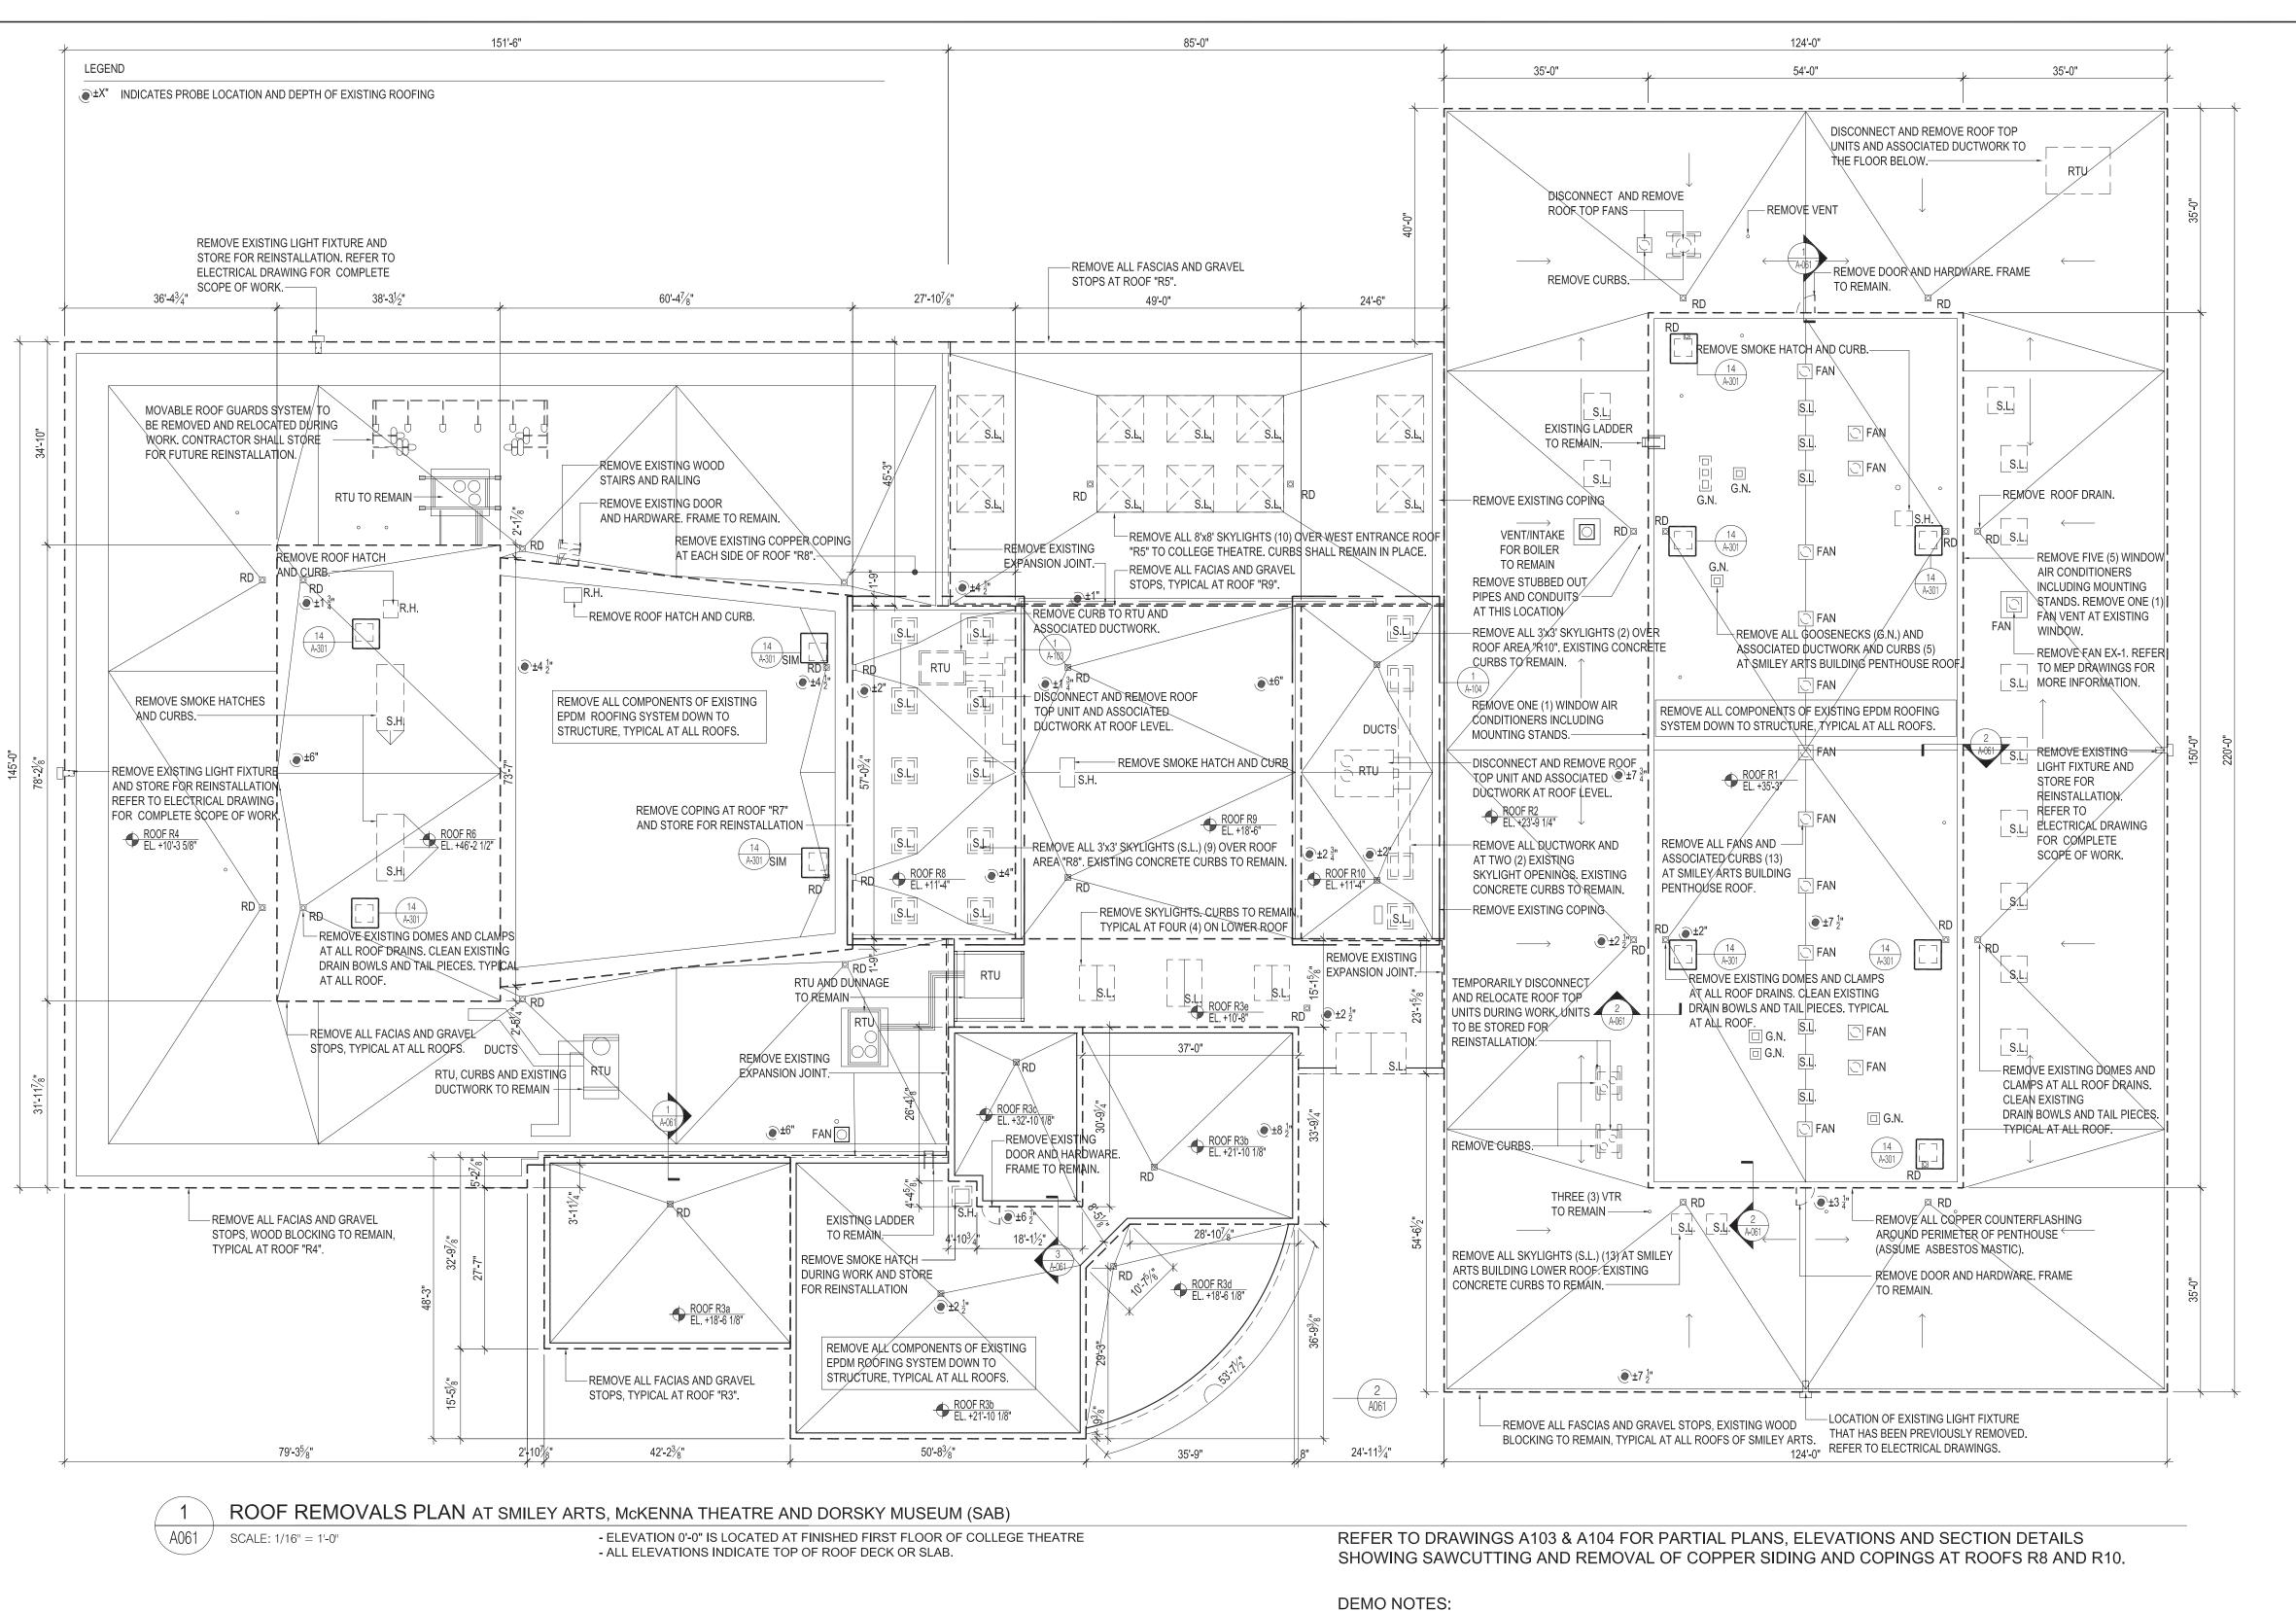

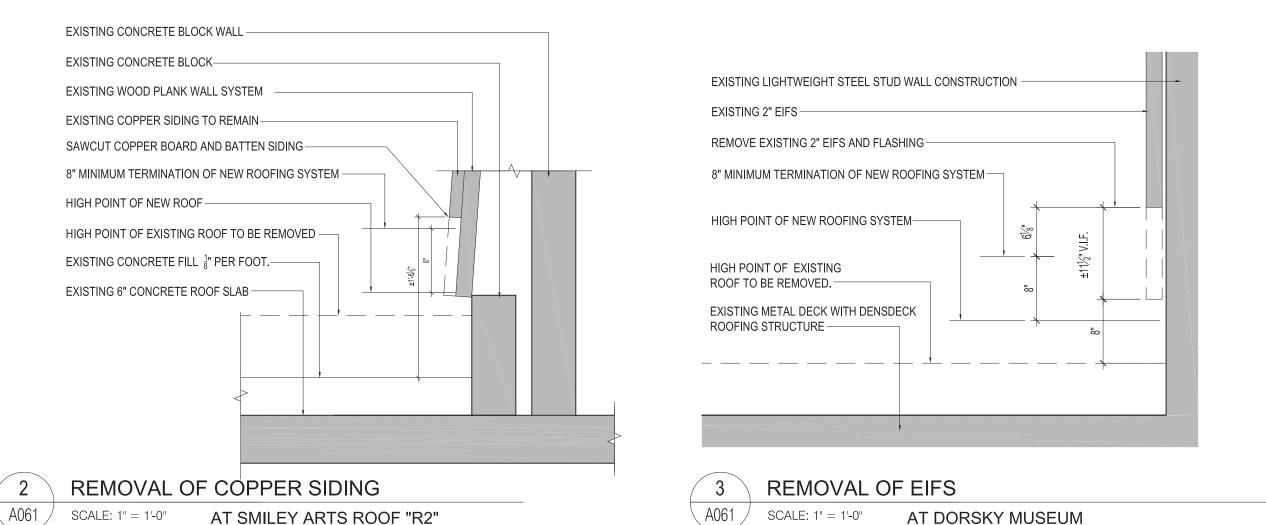

REFER TO A103 AND A104 FOR SIMILAR REMOVALS AT ROOFS "R8" & "R10"

1. THE CONTRACTOR SHALL MAINTAIN A CONSTRUCTION WASTE REPORT TO BE KEPT UPDATED THROUGHOUT THE COURSE OF WORK. REFER TO ALL REQUIREMENTS IN SPECIFICATION 01 74 19. 2. AS PER SPECIFICATION 01 35 13 10 SALVAGE OF MATERIALS, THE CONTRACTOR SHALL NEATLY STACK ON A PALLET ALL COPPER REMOVED AS PART OF THE WORK AND TRANSPORT TO THE CAMPUS SERVICE BUILDING GROUNDS FENCED AREA.

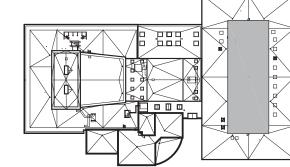

2" CONCRETE PLANK

ROOF R2 EXISTING ROOF STRUCTURE: 6" CONCRETE SLAB W/ CONC. FILL

ROOF R1 EXISTING ROOF STRUCTURE:



PROGRAM UNIT:

MDSZERBATY ASSOCIATES ARCHITECTURE 307 7th AVENUE 15th FLOOR NEW YORK, NY 10001





Consulting Engineers IAQ SYSTEMS INC, CONSULTING ENGINEERS 555 8th AVENUE, SUITE 1502 NEW YORK, NY 10018 TEL: 212.680.8945

Facility:

Building:

County of:

ULSTER

SUNY NEW PALTZ

Building Address:

SMILEY ARTS BUILDING,

DORSKY MUSEUM AND


FACULTY OFFICE BUILDING

COLLEGE THEATRE


1 HAWK DRIVE, NEW PALTZ, NY 12561

Project No.:


081047-00

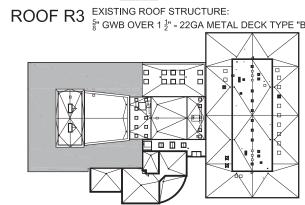


ROOF R4 EXISTING ROOF STRUCTURE: 4" CONCRETE SLAB W/ CONC. FILL

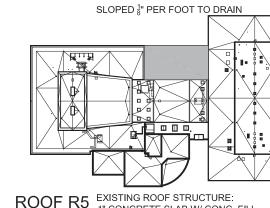


ROOF R5 EXISTING ROOF STRUCTURE: 4" CONCRETE SLAB W/ CONC. FILL

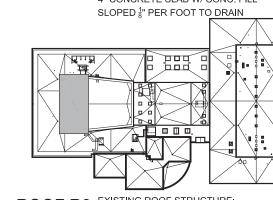

ROOF R6 EXISTING ROOF STRUCTURE: 2" ACOUSTICAL CONCRETE PLANK

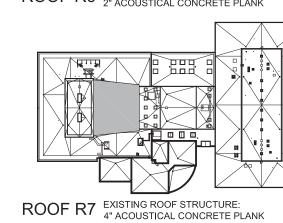

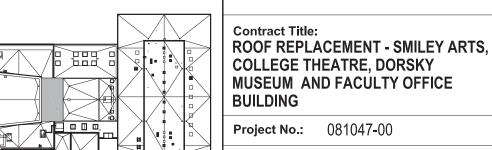


MUSEUM AND FACULTY OFFICE

SAB ROOF REMOVALS PLAN


Key/Location Plan



Seal & Signature:

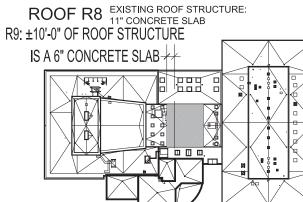

ROOF R9 EXISTING ROOF STRUCTURE: 6" CONCRETE SLAB ABOVE FAN

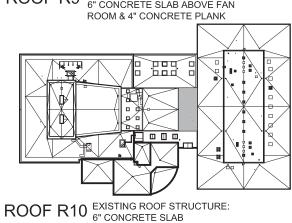


6 of 47

Drawn By:


John O'Connor

JANUARY 8, 2021 AS NOTED

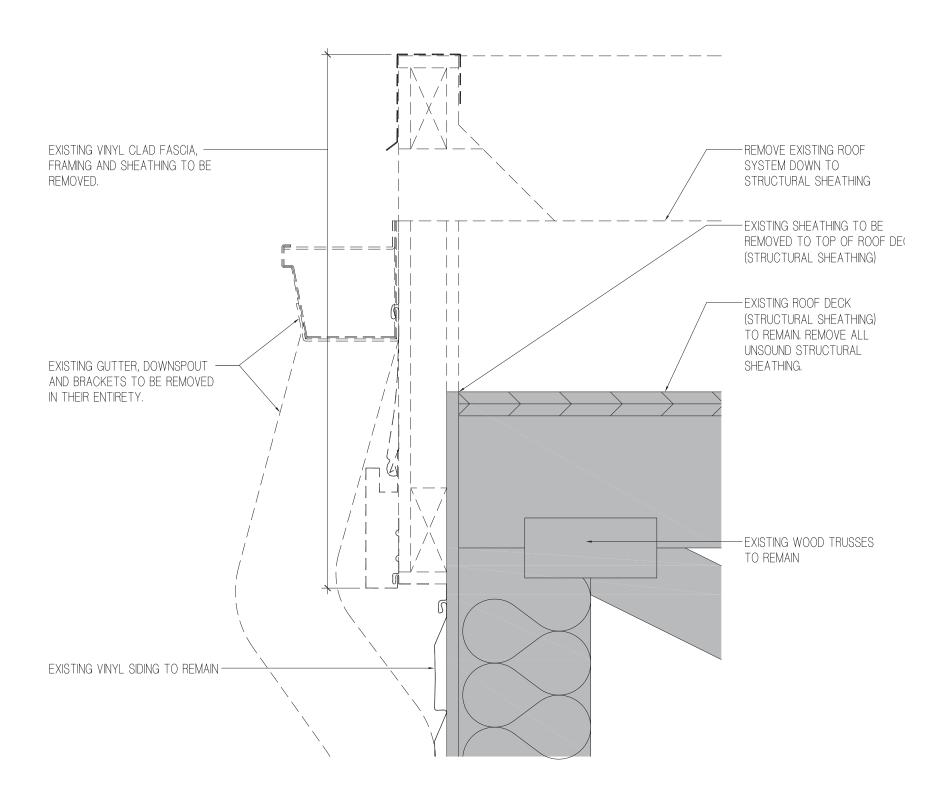


SECTION AT GUTTERS

A062 SCALE: 3" = 1'-0"

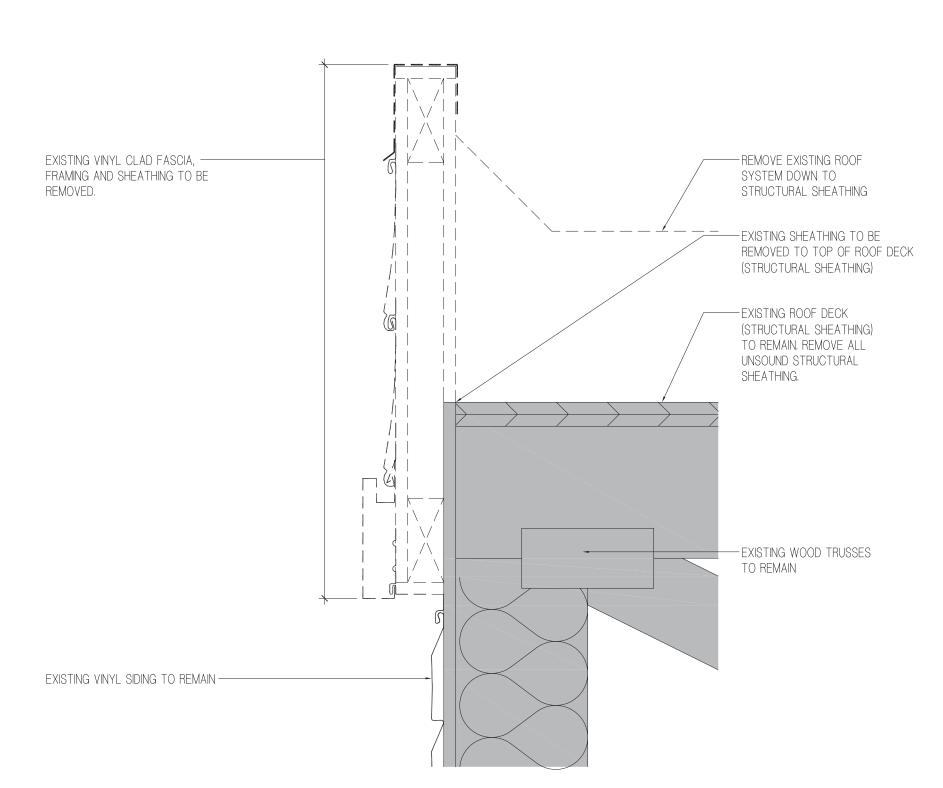



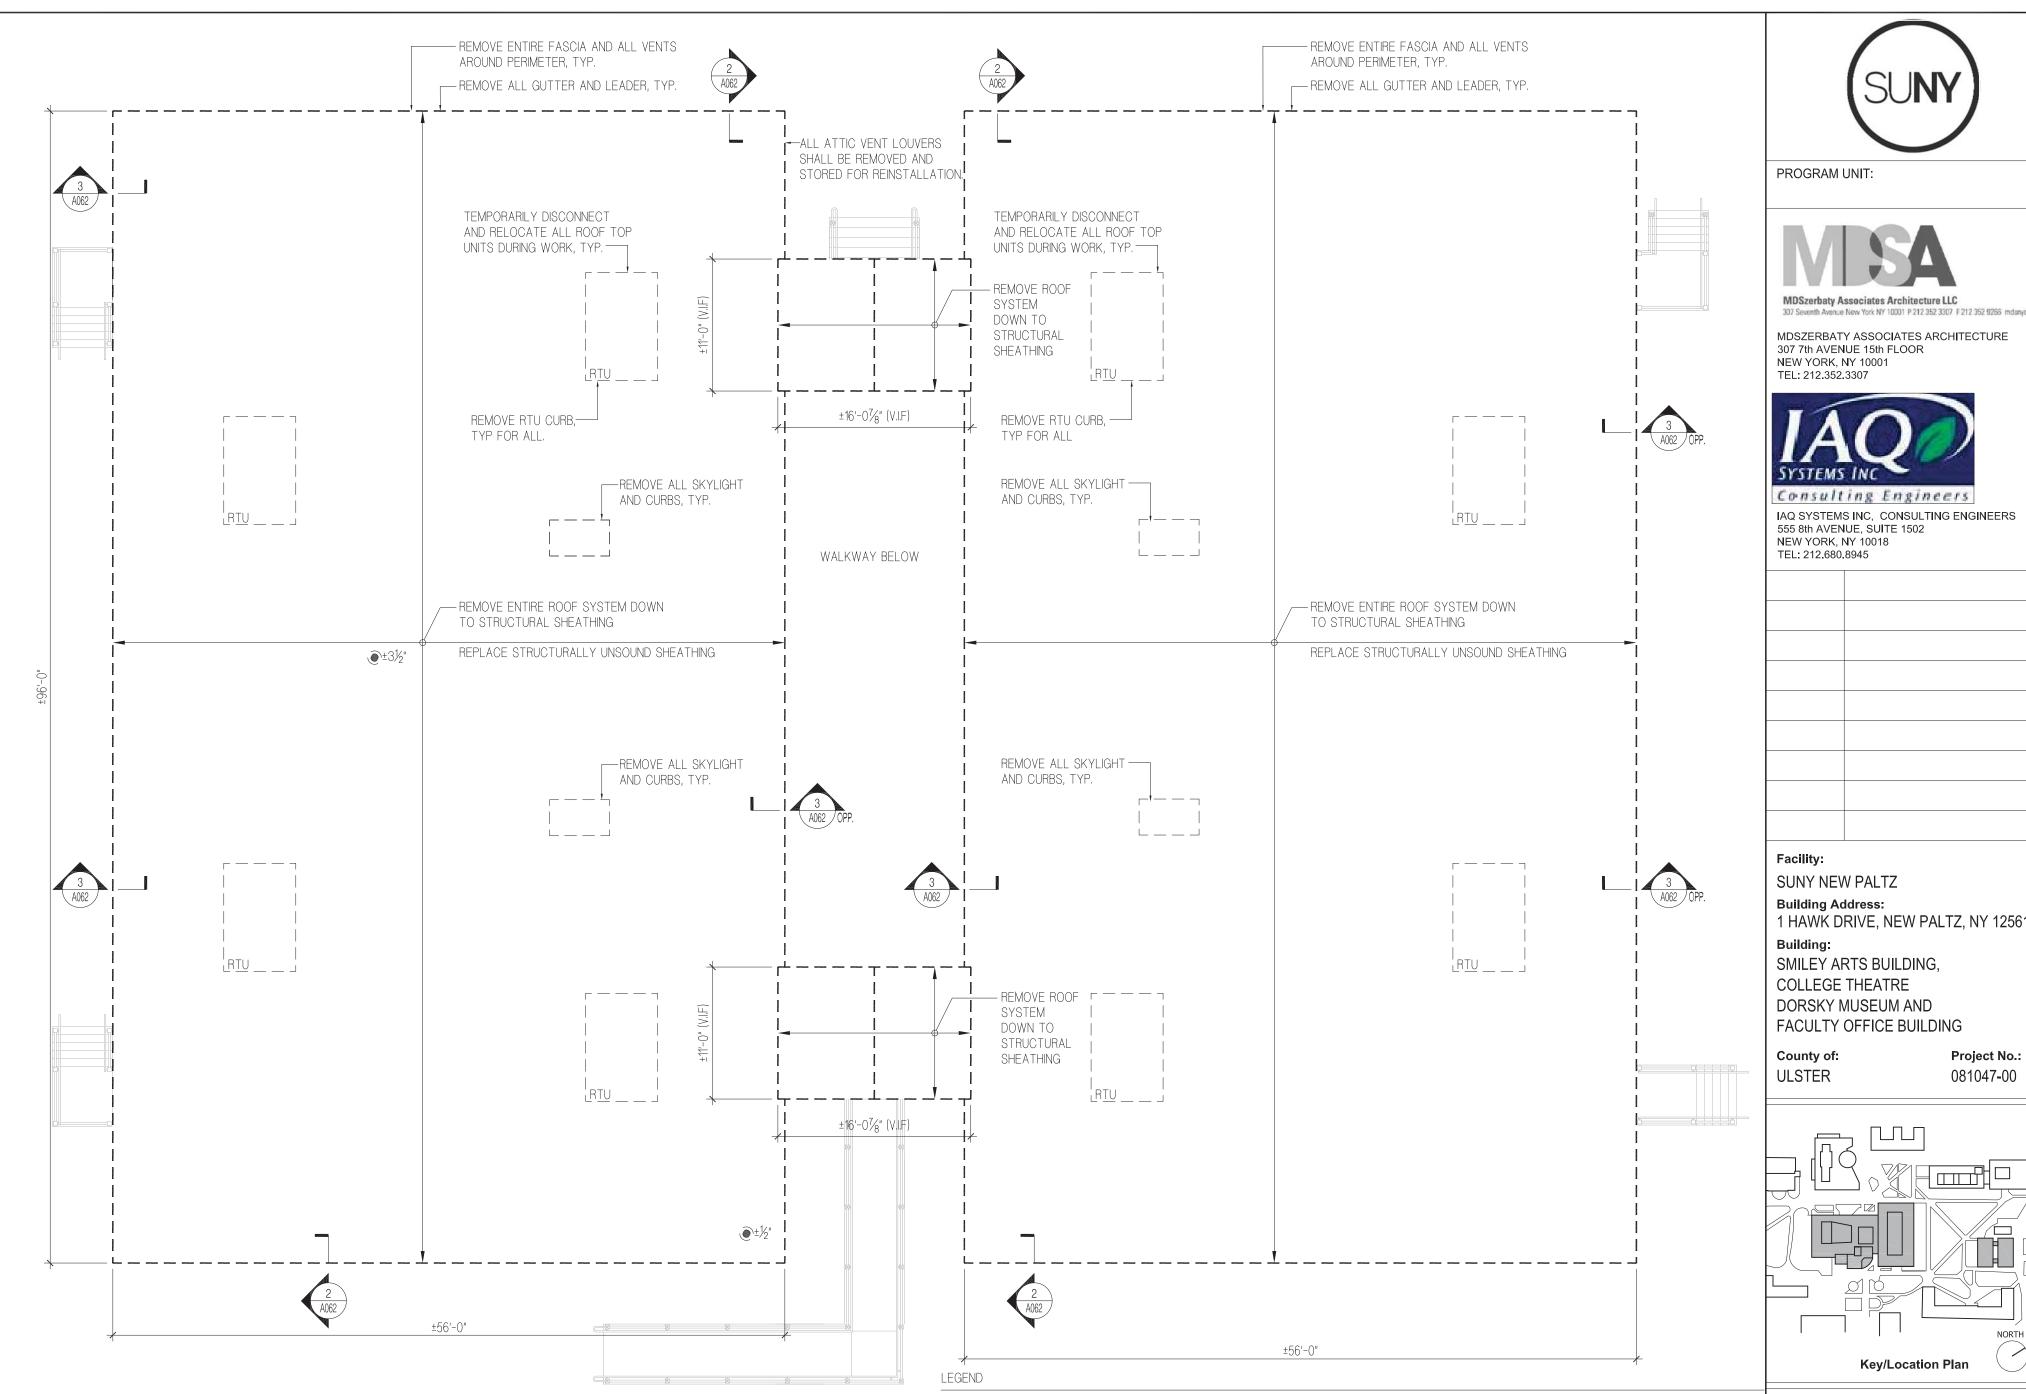

**DICATES PROBE LOCATION AND DEPTH OF EXISTING ROOFING

FACULTY OFFICE BUILDING ROOF REMOVALS PLAN

A062 SCALE: 1/8" = 1'-0"

Contract Title: ROOF REPLACEMENT - SMILEY ARTS, COLLEGE THEATRE, DORSKY MUSEUM AND FACULTY OFFICE

Key/Location Plan

Project No.: 081047-00

BUILDING

PROGRAM UNIT:

NEW YORK, NY 10001 TEL: 212.352.3307

NEW YORK, NY 10018

TEL: 212.680.8945

Facility:

Building:

County of:

ULSTER

SUNY NEW PALTZ **Building Address:**

SMILEY ARTS BUILDING,

1 HAWK DRIVE, NEW PALTZ, NY 12561

Project No.:

081047-00


307 Seventh Avenue New York NY 10001 P 212 352 3307 F 212 352 9266 mdsnyc.com


Drawing Title: FACULTY OFFICE BUILDING (FOB) REMOVALS ROOF PLAN AND SECTIONS

Seal & Signature:



Drawn By:	JASON CAMPAGNA
Checked By:	JOHN O'CONNOR
Date:	JANUARY 8, 2021
Scale:	AS NOTED

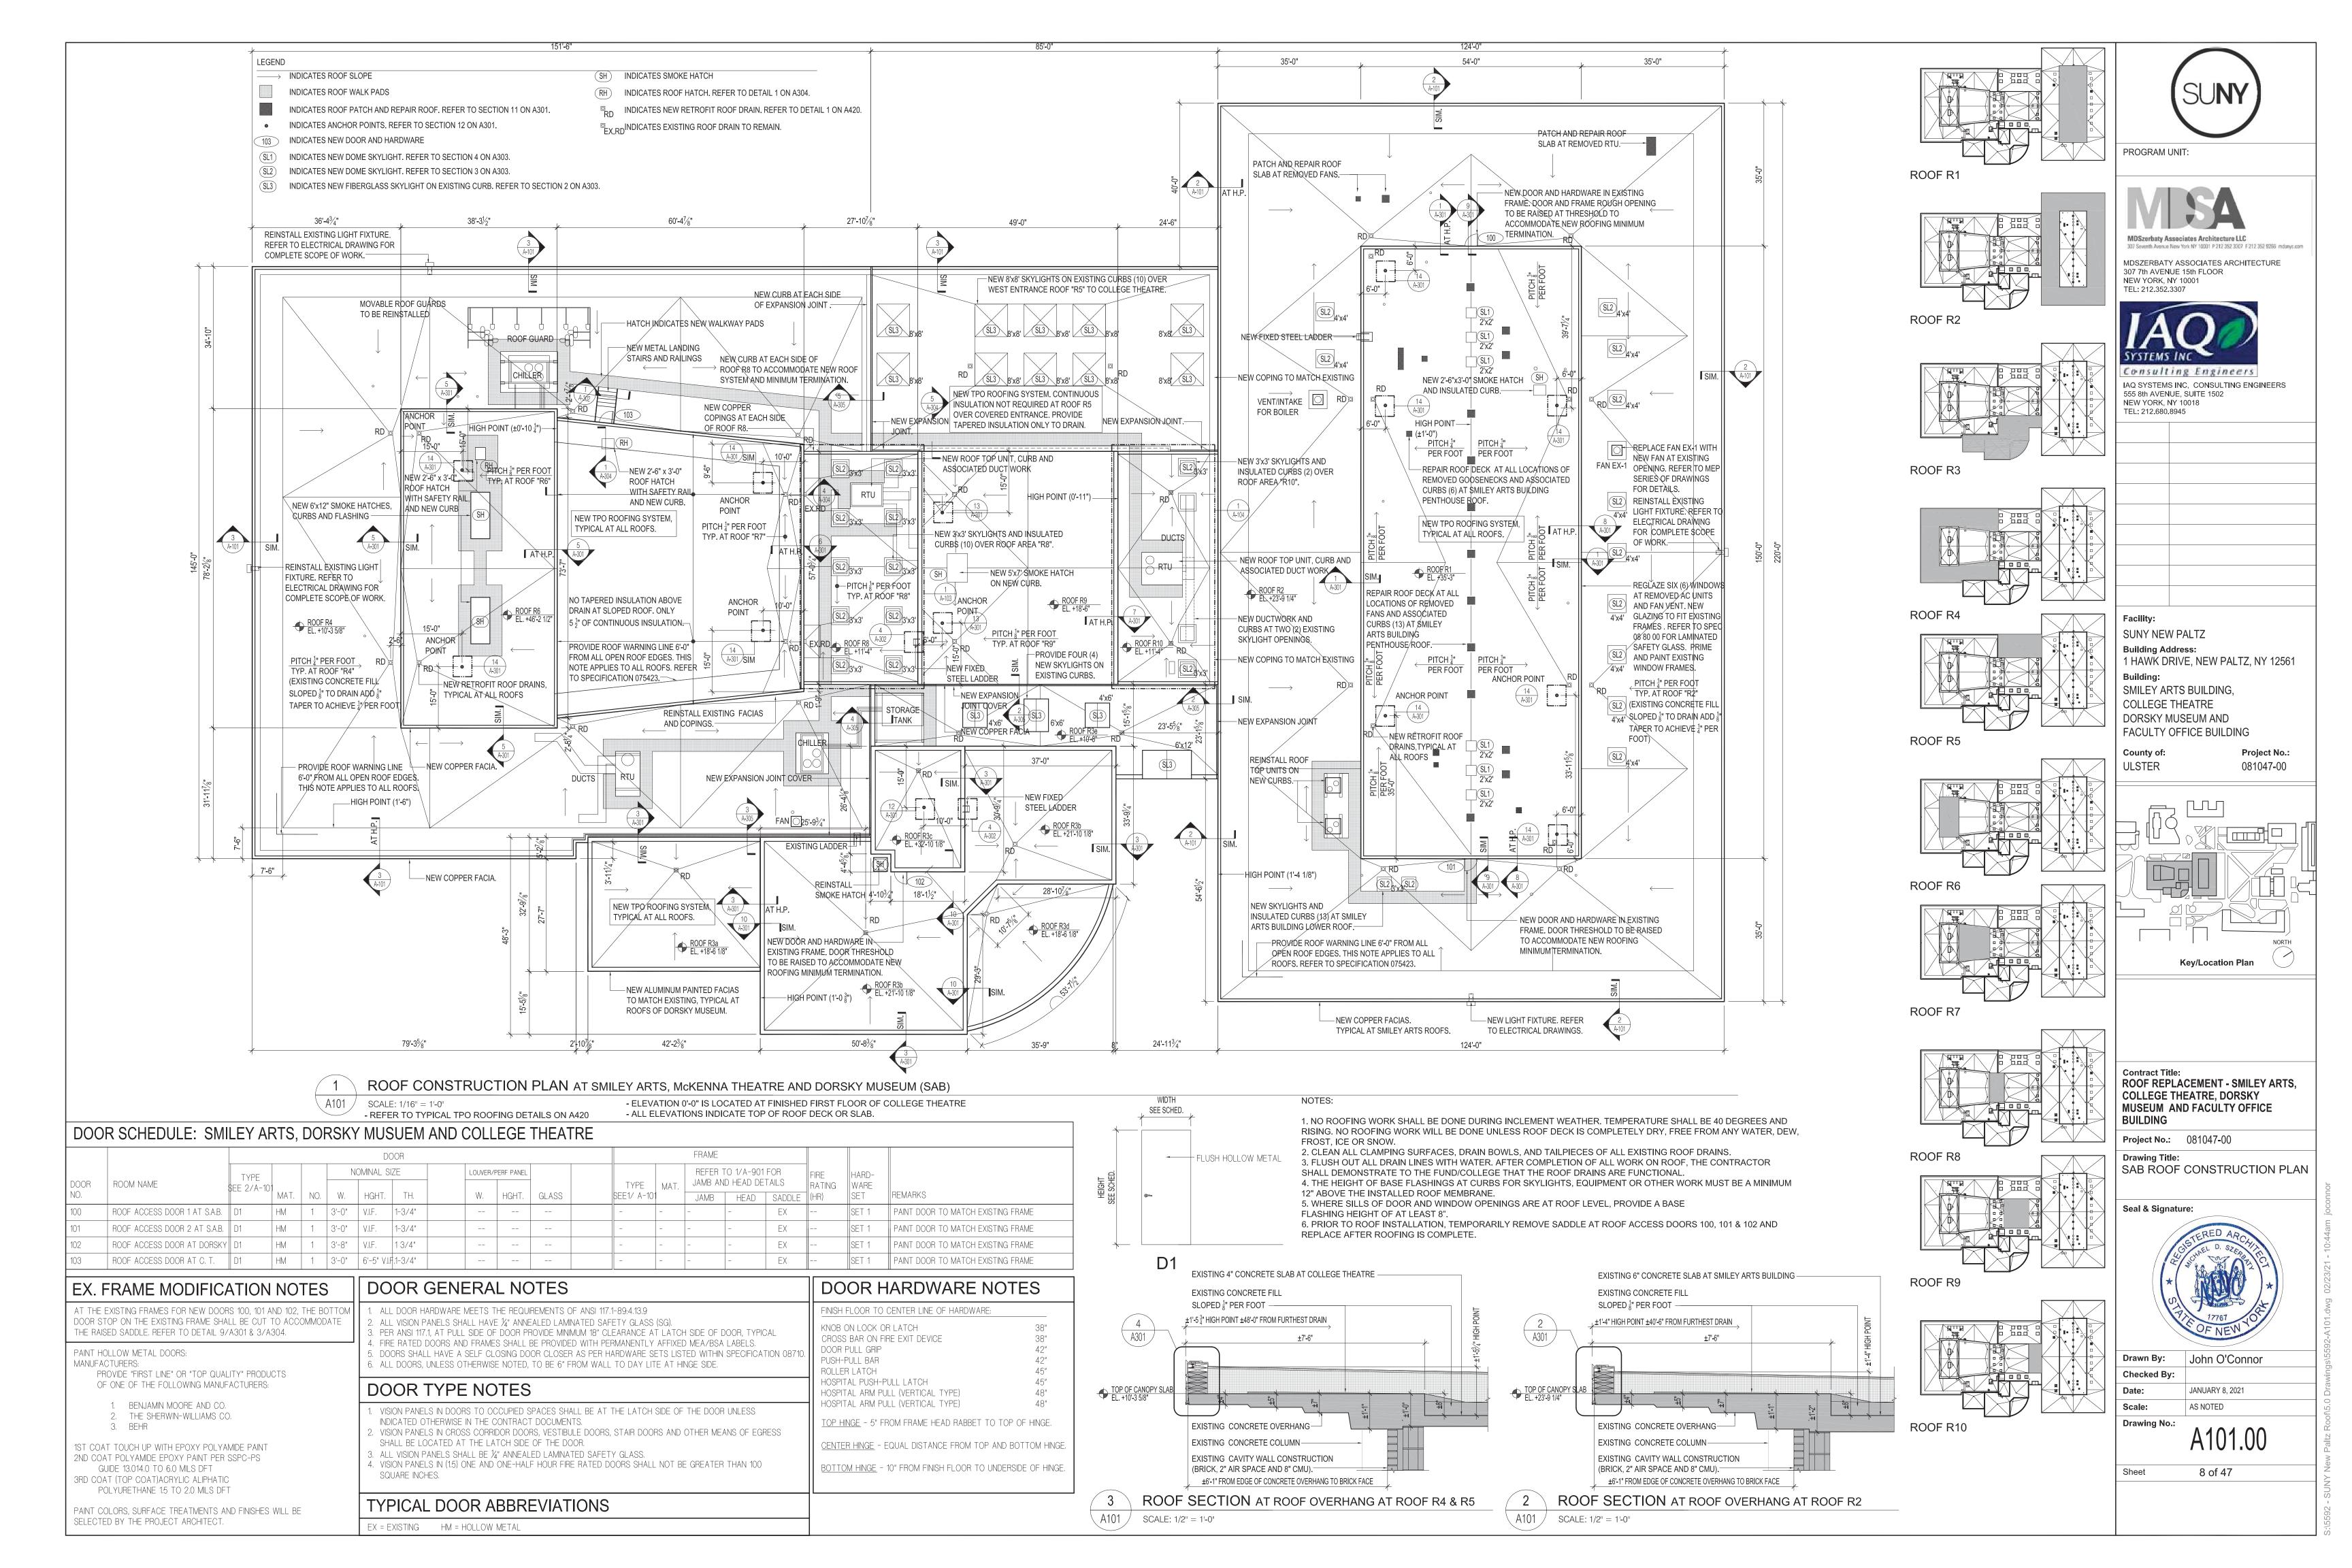

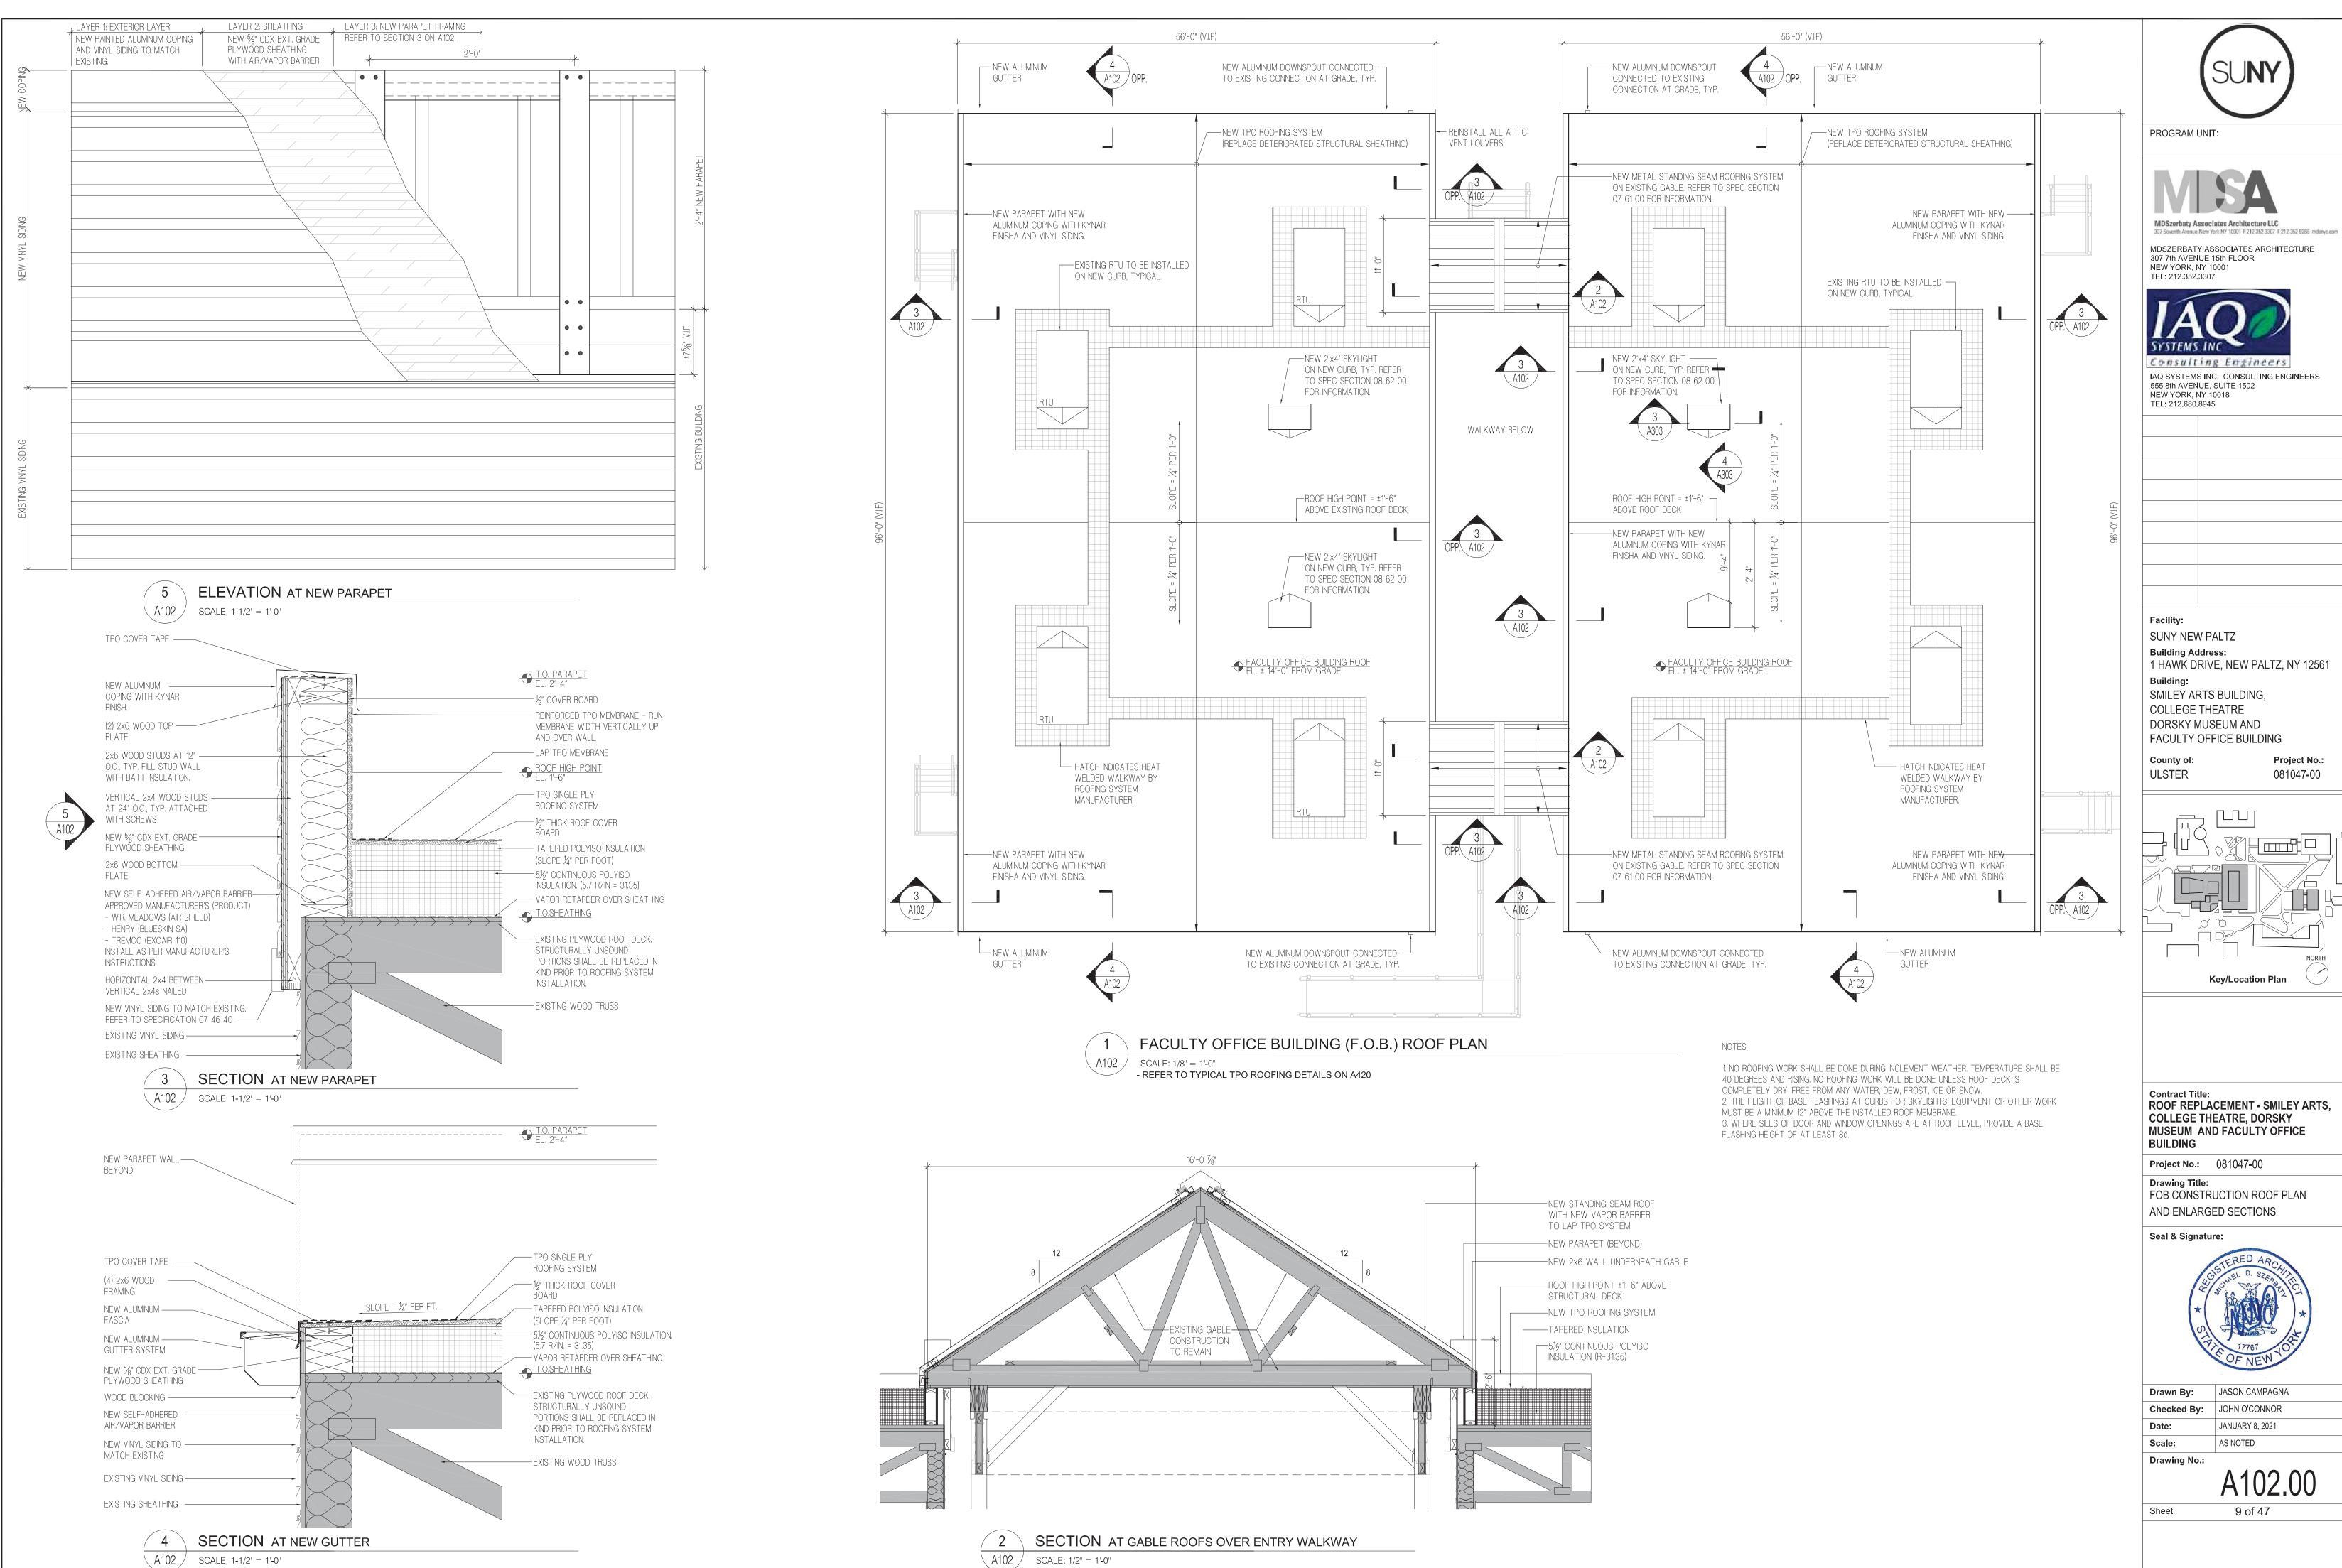

MDSZERBATY ASSOCIATES ARCHITECTURE 307 7th AVENUE 15th FLOOR NEW YORK, NY 10001




Consulting Engineers IAQ SYSTEMS INC, CONSULTING ENGINEERS 555 8th AVENUE, SUITE 1502

Building Address: 1 HAWK DRIVE, NEW PALTZ, NY 12561

SMILEY ARTS BUILDING, COLLEGE THEATRE DORSKY MUSEUM AND FACULTY OFFICE BUILDING

081047-00

Project No.:

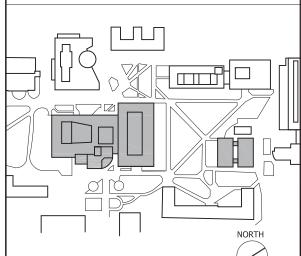

Key/Location Plan

ROOF REPLACEMENT - SMILEY ARTS, COLLEGE THEATRE, DORSKY MUSEUM AND FACULTY OFFICE


Project No.: 081047-00

FOB CONSTRUCTION ROOF PLAN AND ENLARGED SECTIONS



	· · · · · · · · · · · · · · · · · · ·
Drawn By:	JASON CAMPAGNA
Checked By:	JOHN O'CONNOR
Date:	JANUARY 8, 2021
Scale:	AS NOTED

A102.00

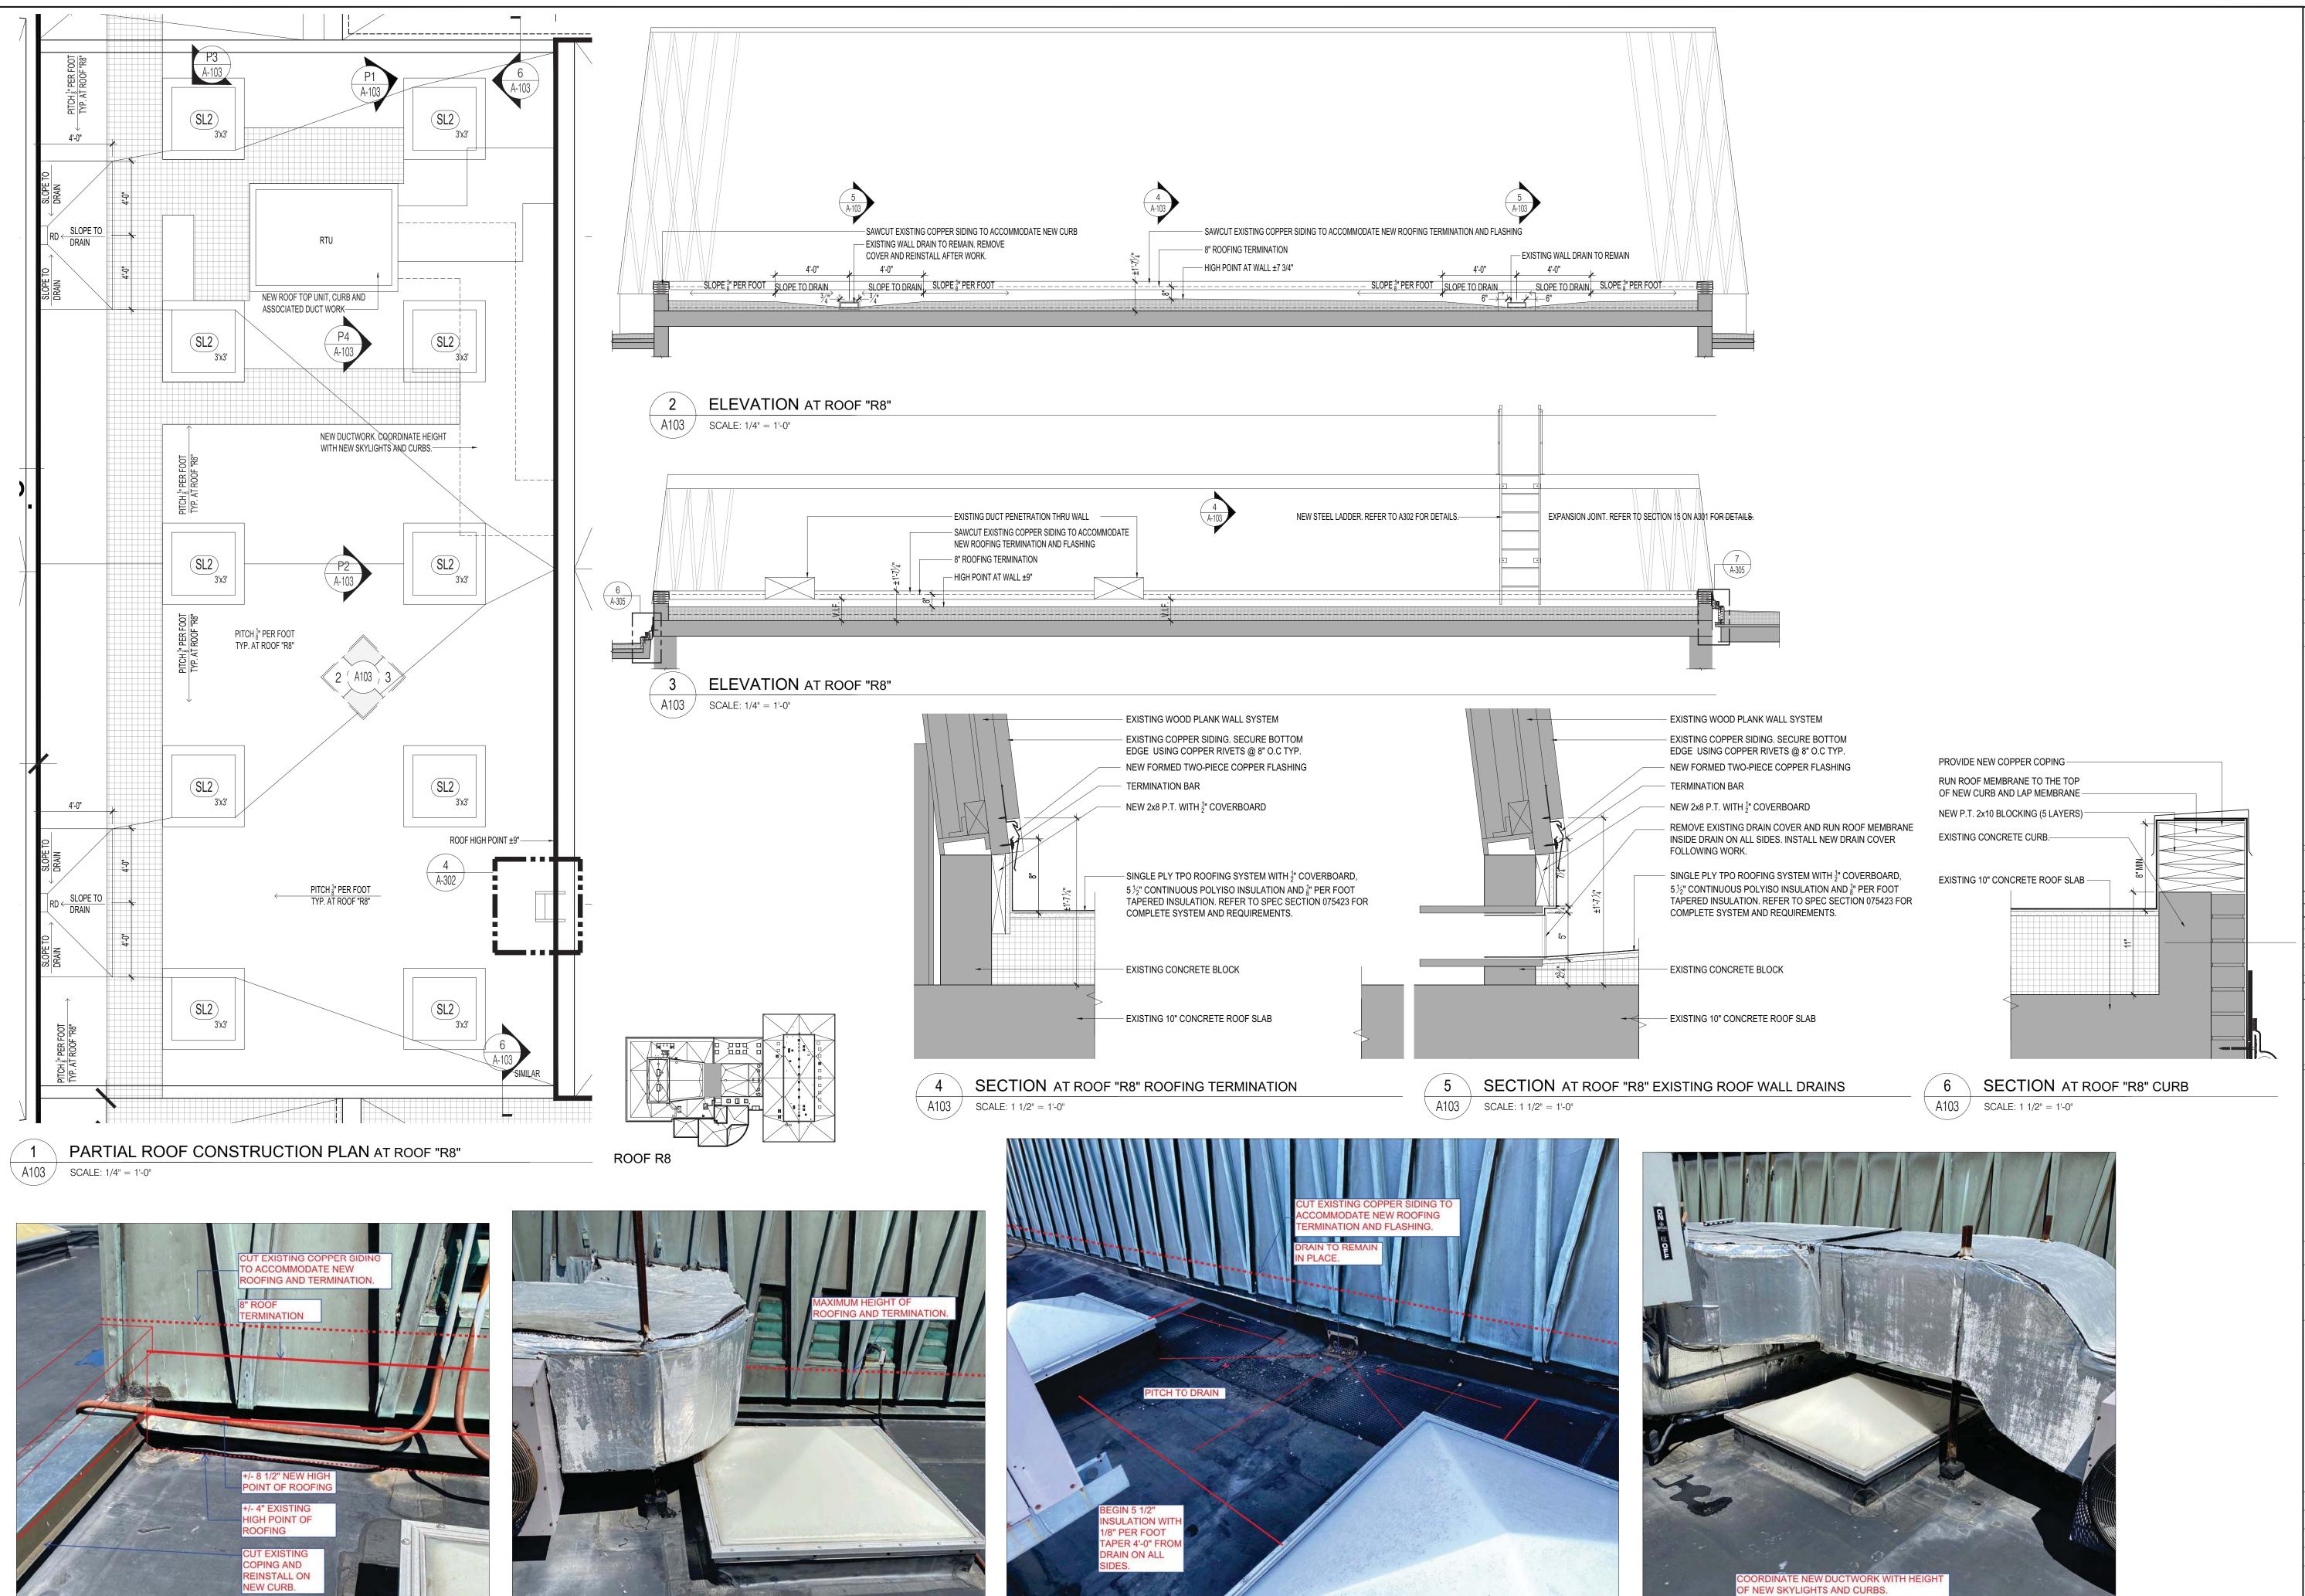

P1 PHOTO 1 AT ROOF "R8" COPING A103 SCALE: NOT TO SCALE

\ A103 \ SCALE: NOT TO SCALE

P2 PHOTO 2 AT ROOF "R8" EXISTING WALL VENTS

P3 PHOTO 3 AT ROOF "R8" WALL DRAIN A103 / SCALE: NOT TO SCALE

P4 PHOTO 4 AT ROOF "R8" WALL DRAIN

A103 SCALE: NOT TO SCALE

PROGRAM UNIT:

MDSZERBATY ASSOCIATES ARCHITECTURE



307 7th AVENUE 15th FLOOR

NEW YORK, NY 10018

TEL: 212.680.8945

Consulting Engineers IAQ SYSTEMS INC, CONSULTING ENGINEERS 555 8th AVENUE, SUITE 1502

Facility: SUNY NEW PALTZ


Building Address: 1 HAWK DRIVE, NEW PALTZ, NY 12561 Building:

SMILEY ARTS BUILDING, COLLEGE THEATRE DORSKY MUSEUM AND FACULTY OFFICE BUILDING

County of: ULSTER

081047-00

Project No.:

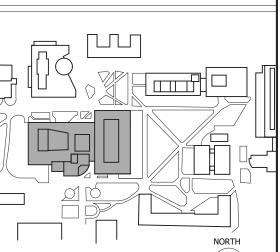

Key/Location Plan

Contract Title: ROOF REPLACEMENT - SMILEY ARTS, COLLEGE THEATRE, DORSKY MUSEUM AND FACULTY OFFICE BUILDING

Project No.: 081047-00

ROOF "R8" CONSTRUCTION PLAN


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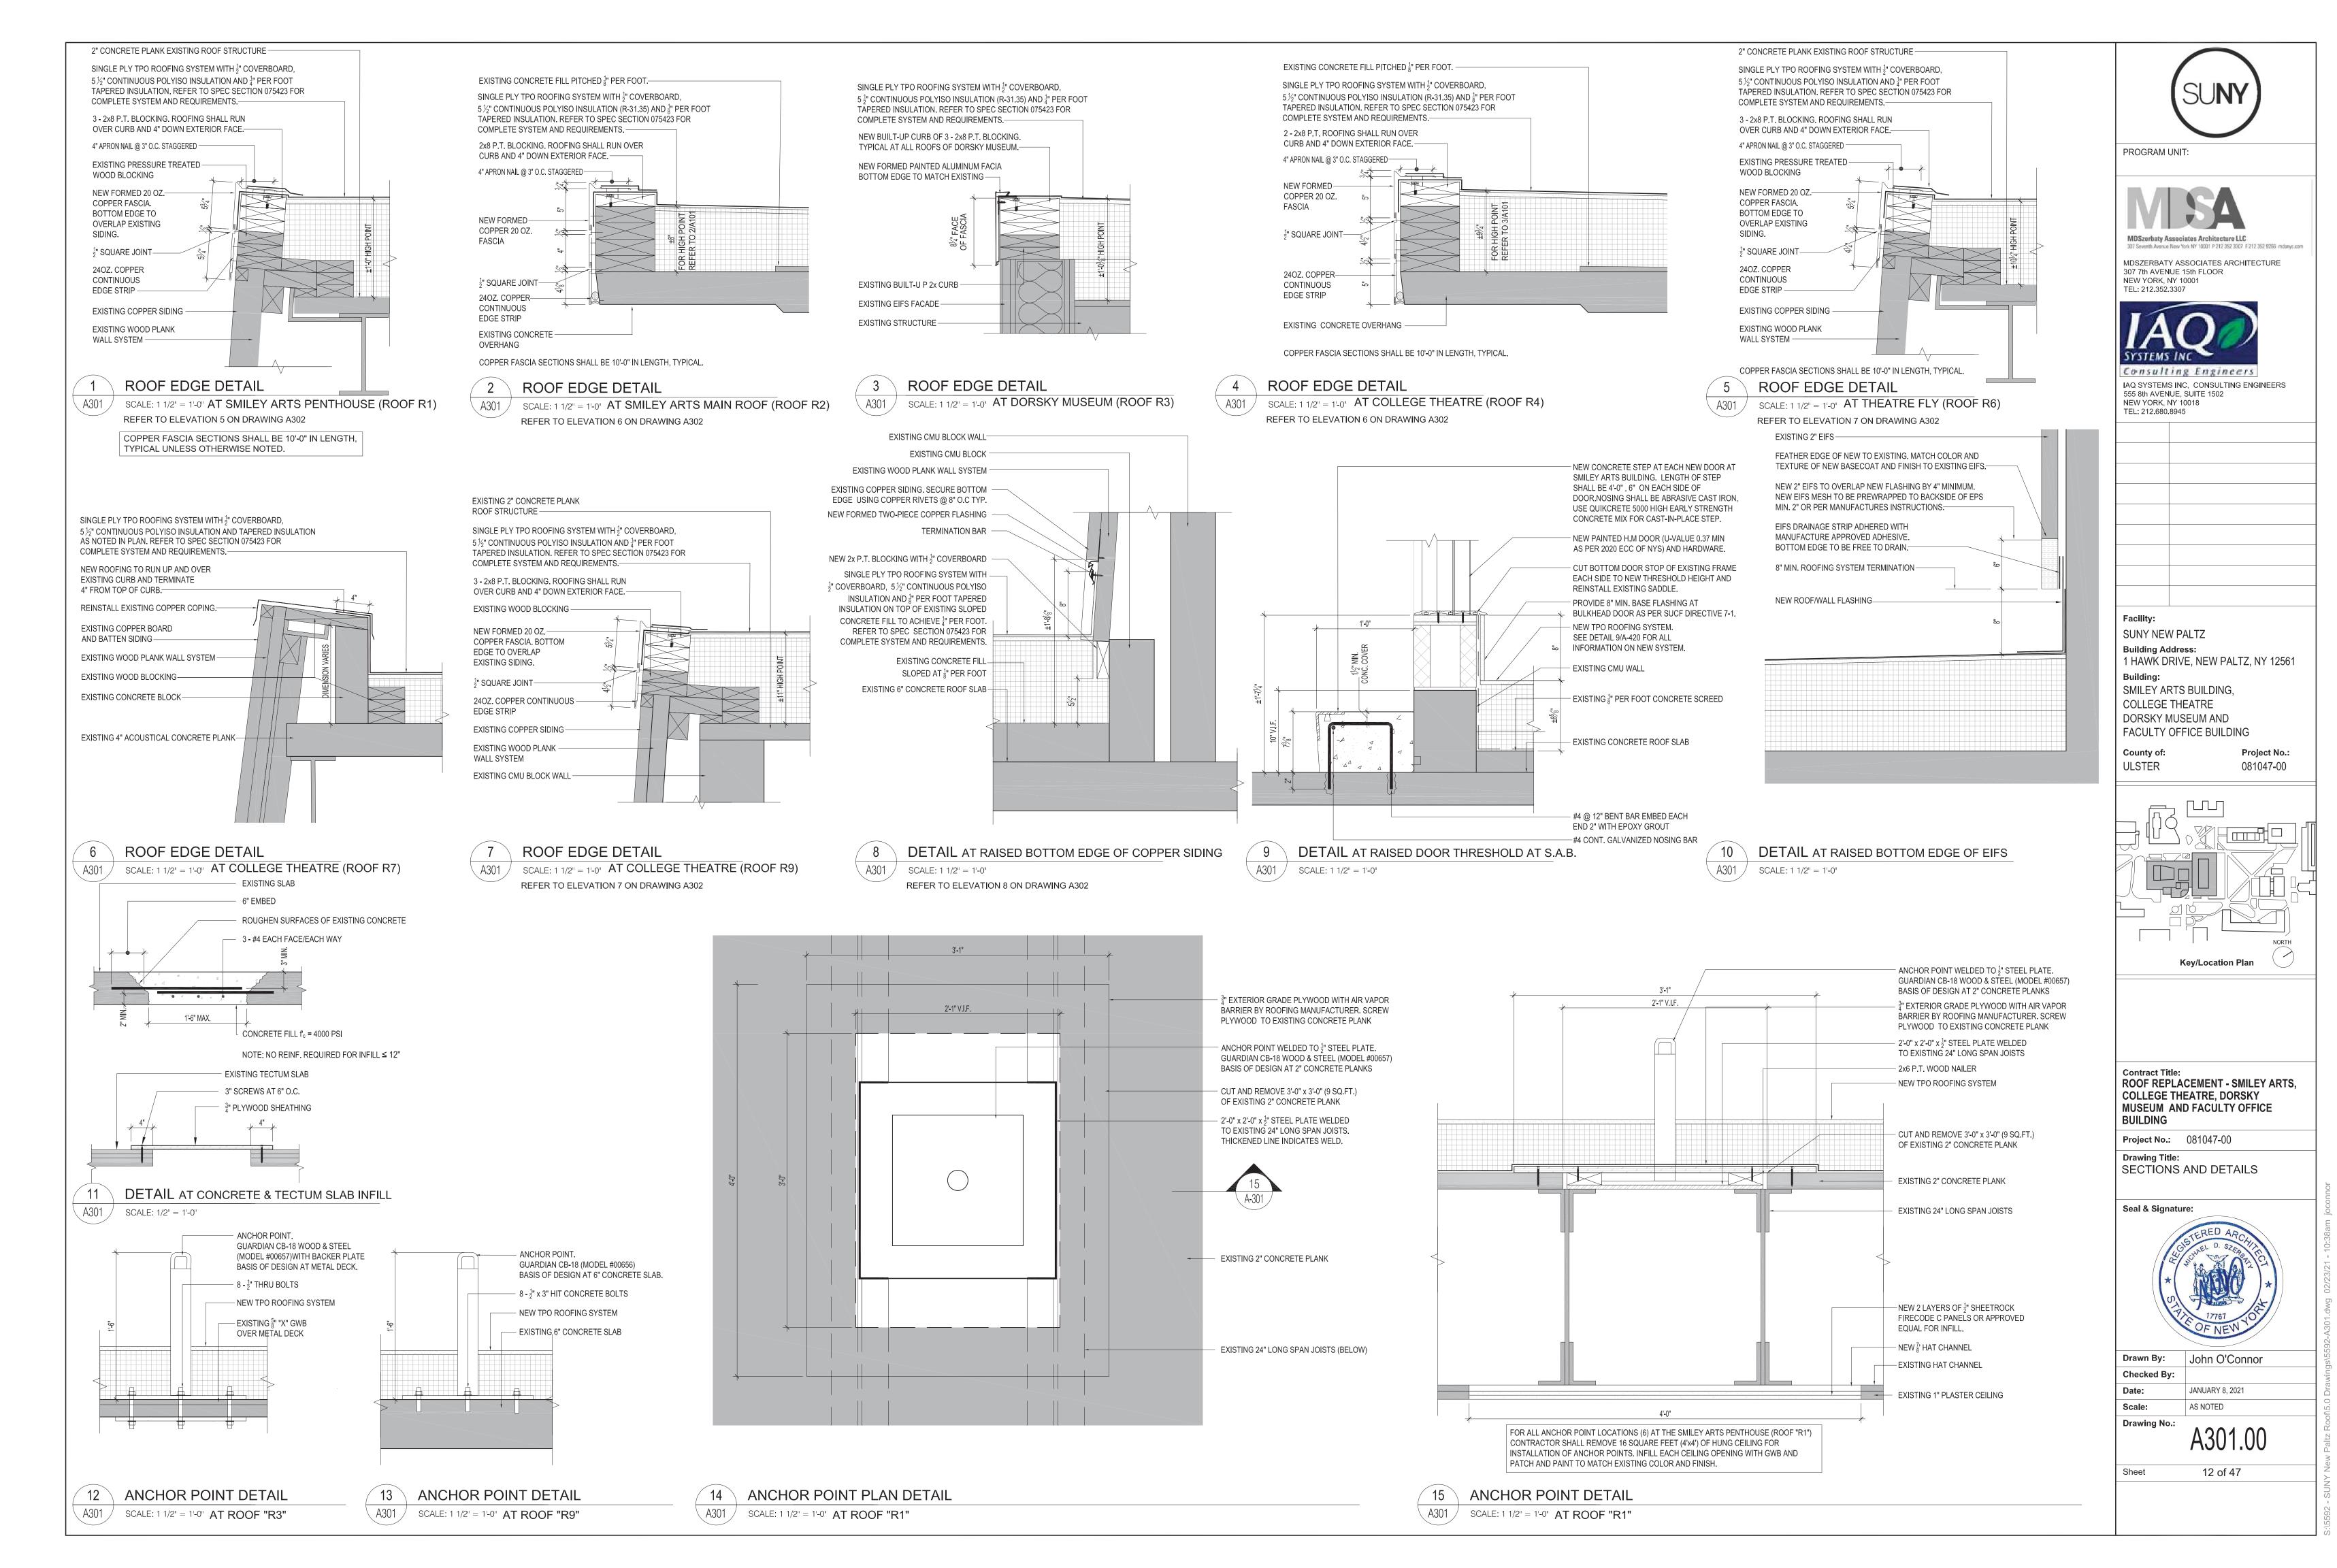



John O'Connor

Drawn By: Checked By: JANUARY 8, 2021 AS NOTED Scale:

Drawing No.



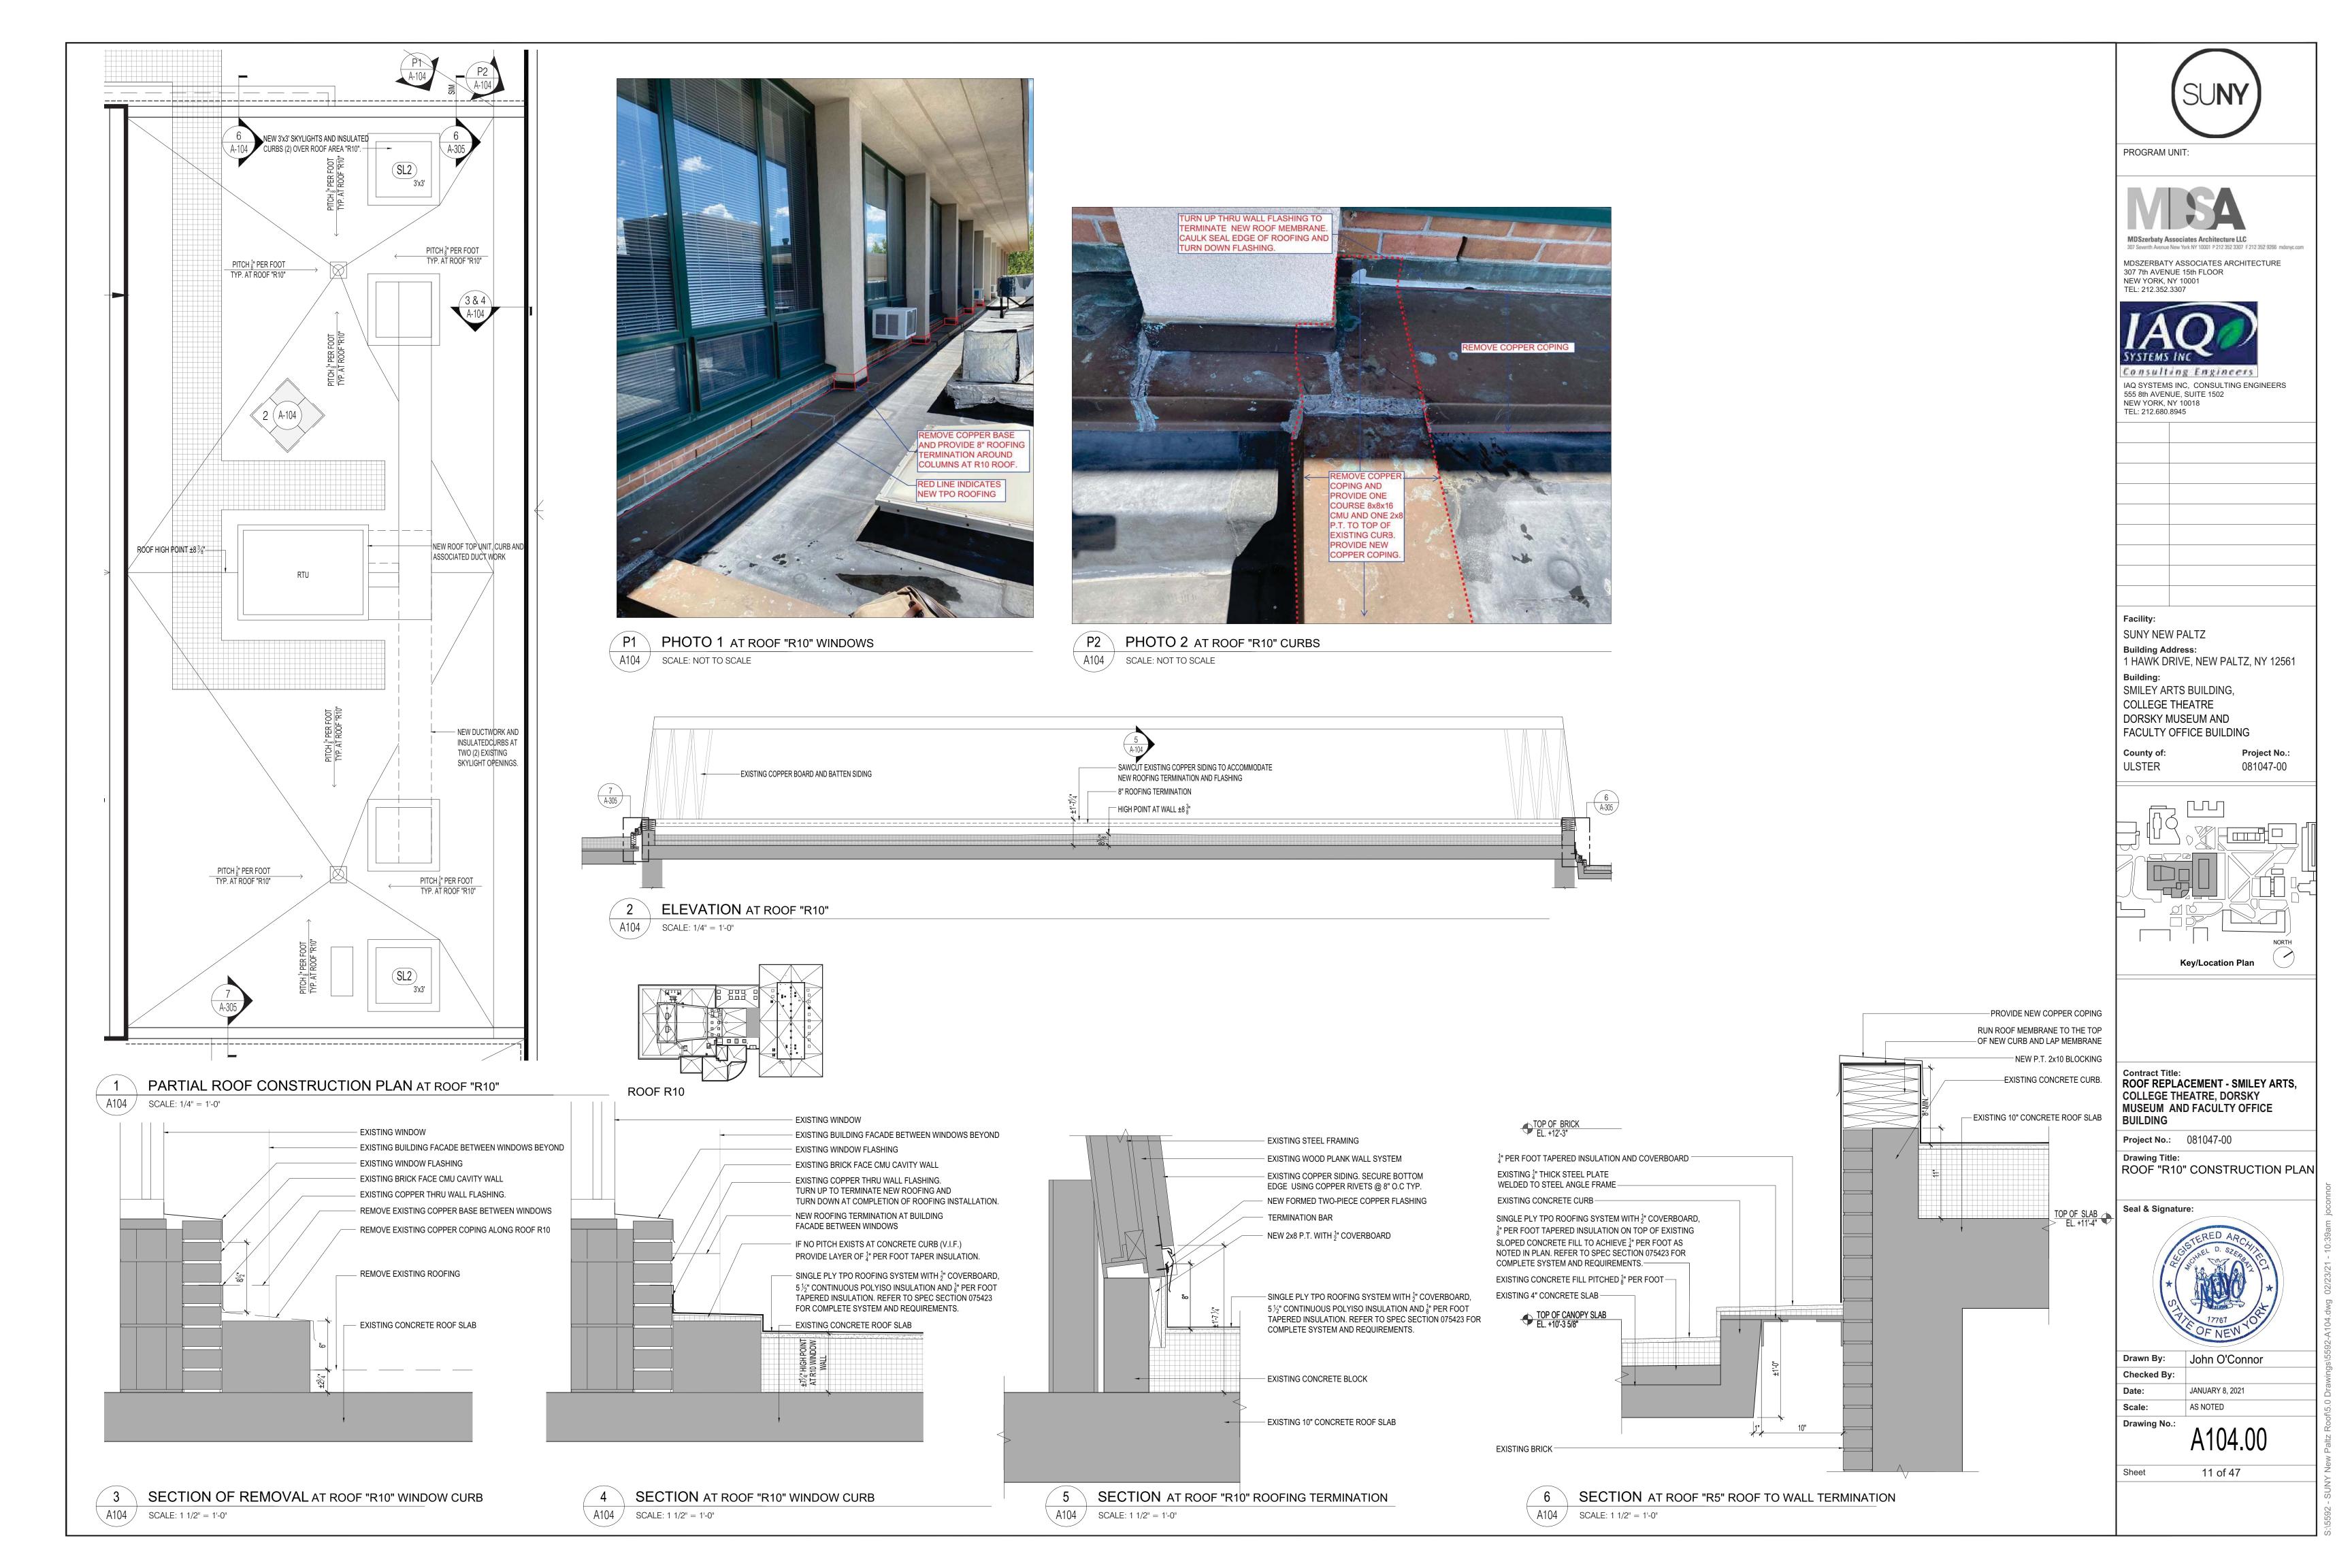

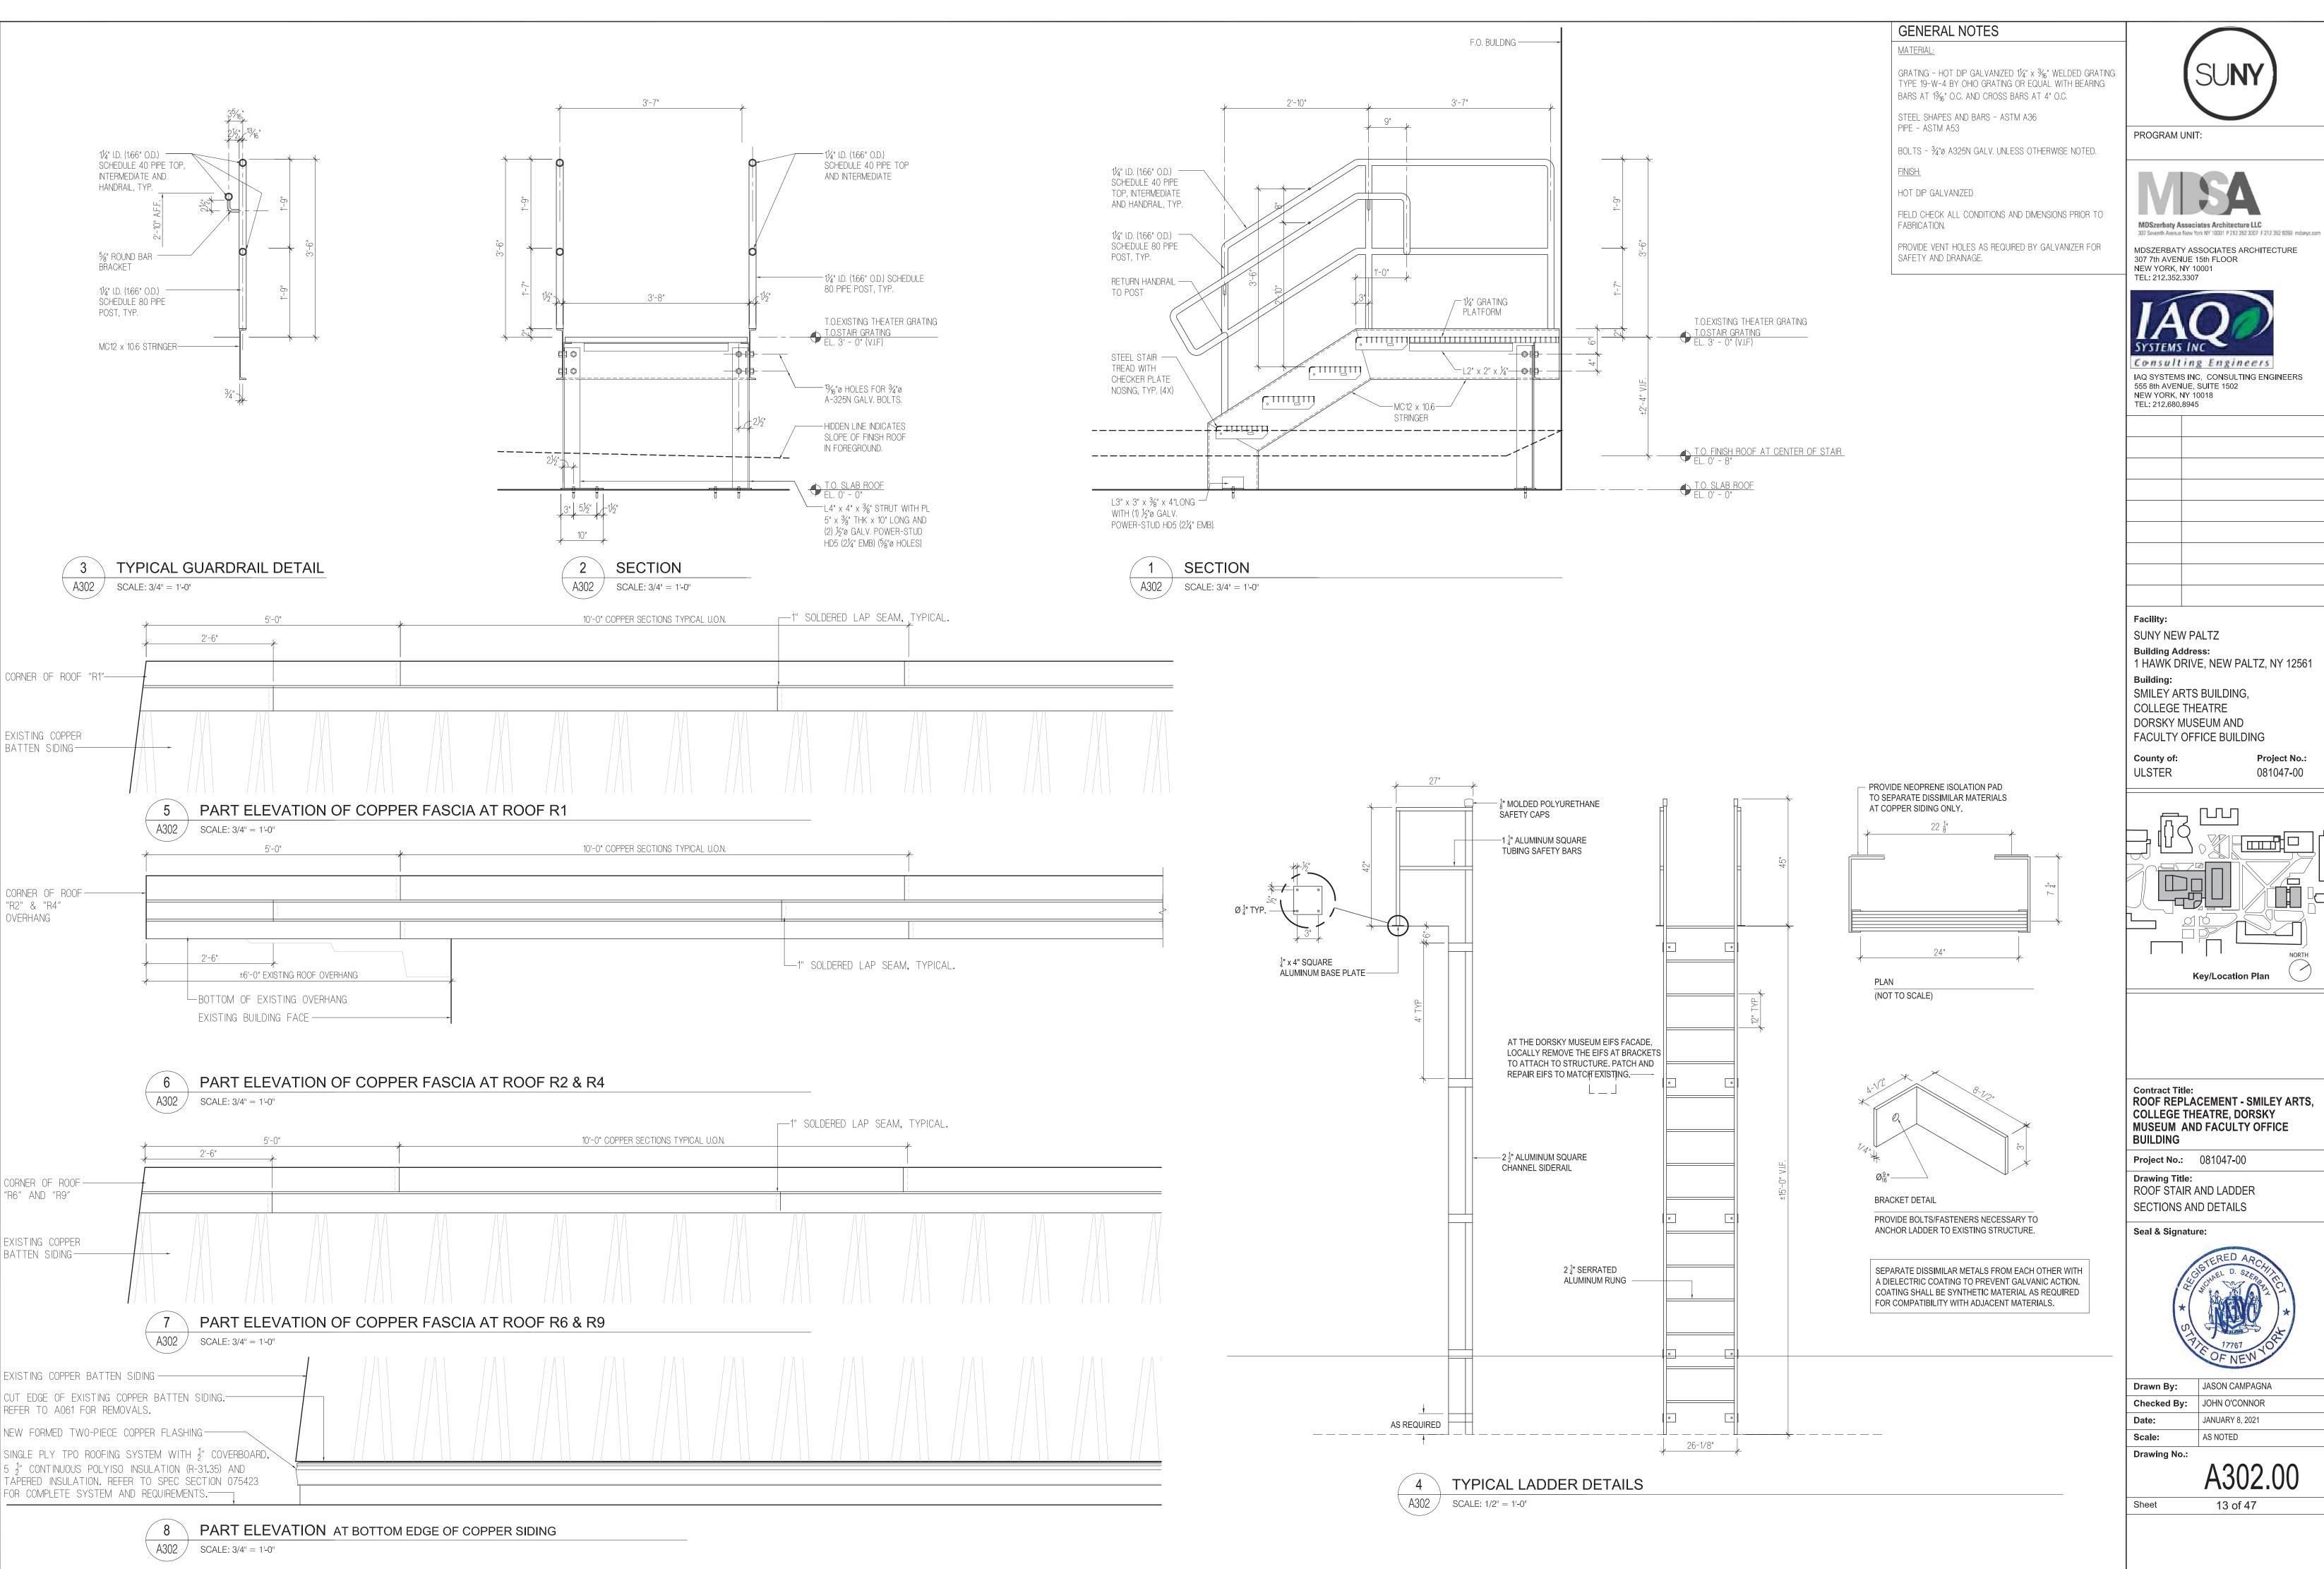

PROGRAM UNIT:

MDSzerbaty Associates Architecture LLC

MDSZERBATY ASSOCIATES ARCHITECTURE 307 7th AVENUE 15th FLOOR NEW YORK, NY 10001

Consulting Engineers IAQ SYSTEMS INC, CONSULTING ENGINEERS 555 8th AVENUE, SUITE 1502 NEW YORK, NY 10018 TEL: 212.680.8945

SUNY NEW PALTZ **Building Address:** 1 HAWK DRIVE, NEW PALTZ, NY 12561

SMILEY ARTS BUILDING, COLLEGE THEATRE DORSKY MUSEUM AND FACULTY OFFICE BUILDING

County of: ULSTER

Project No.: 081047-00

Key/Location Plan

Contract Title: ROOF REPLACEMENT - SMILEY ARTS, COLLEGE THEATRE, DORSKY MUSEUM AND FACULTY OFFICE


Project No.: 081047-00 Drawing Title: ROOF STAIR AND LADDER


Seal & Signature:



JASON CAMPAGNA Drawn By: JOHN O'CONNOR JANUARY 8, 2021 AS NOTED

Drawing No.:

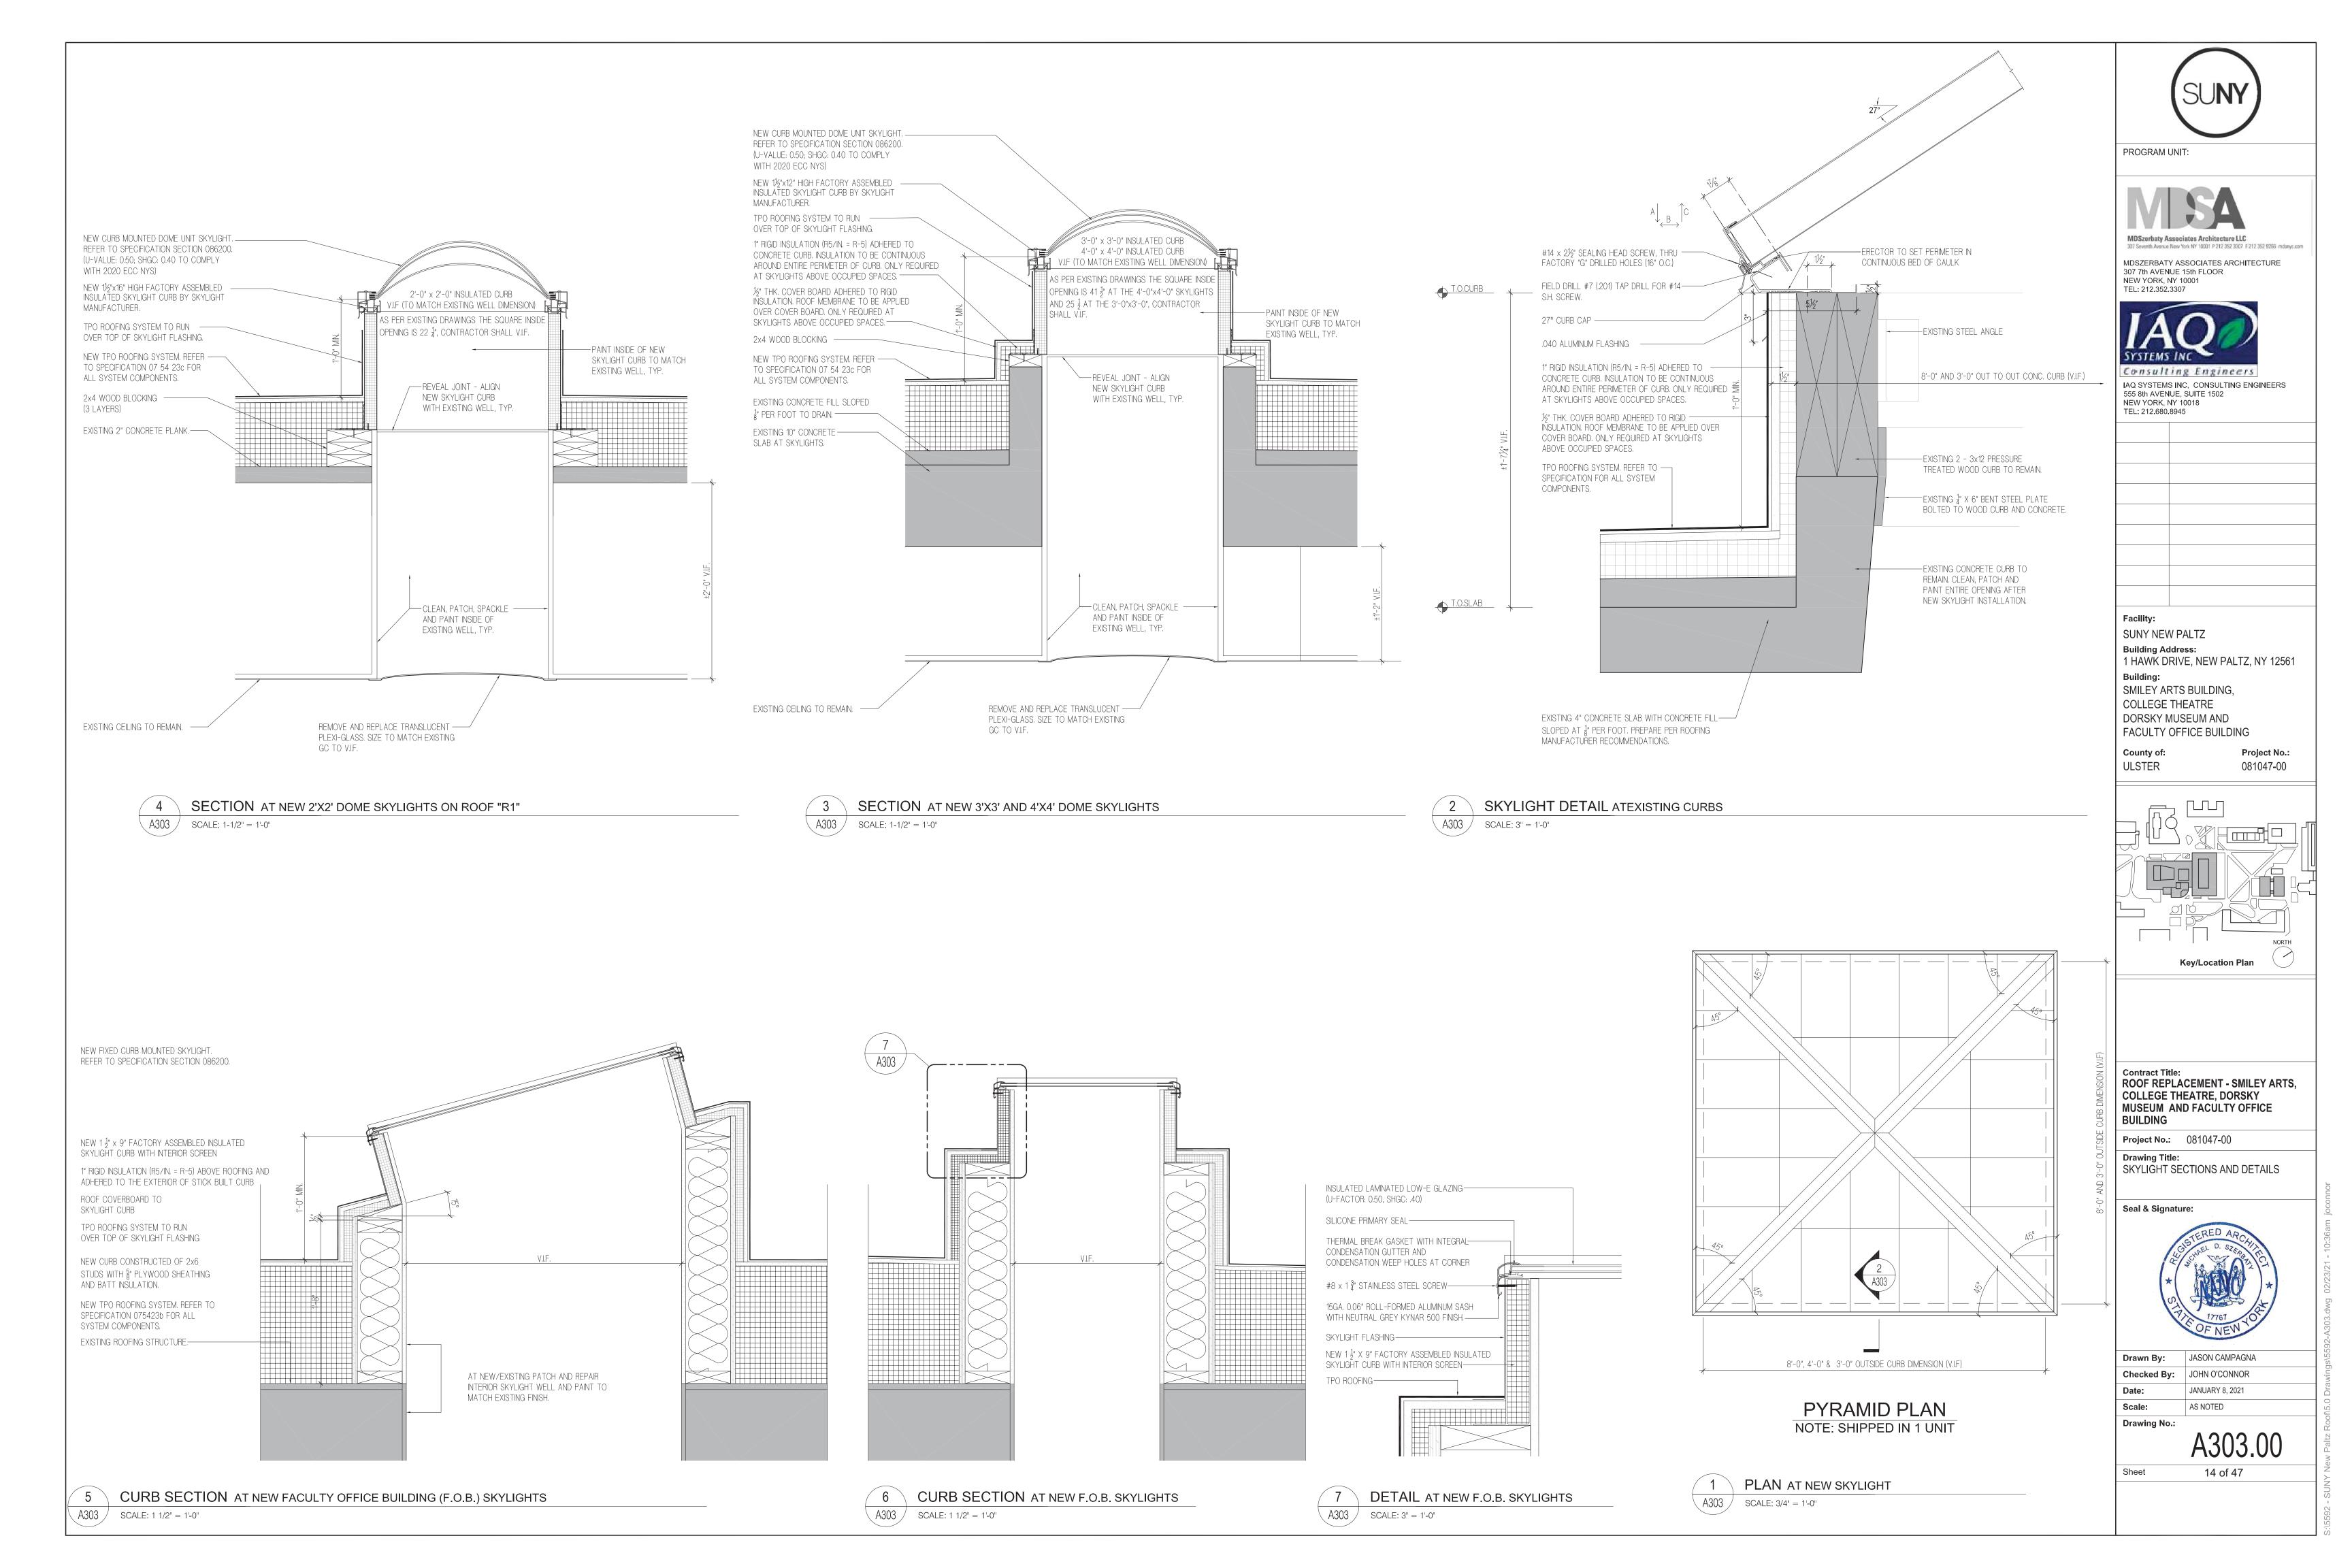

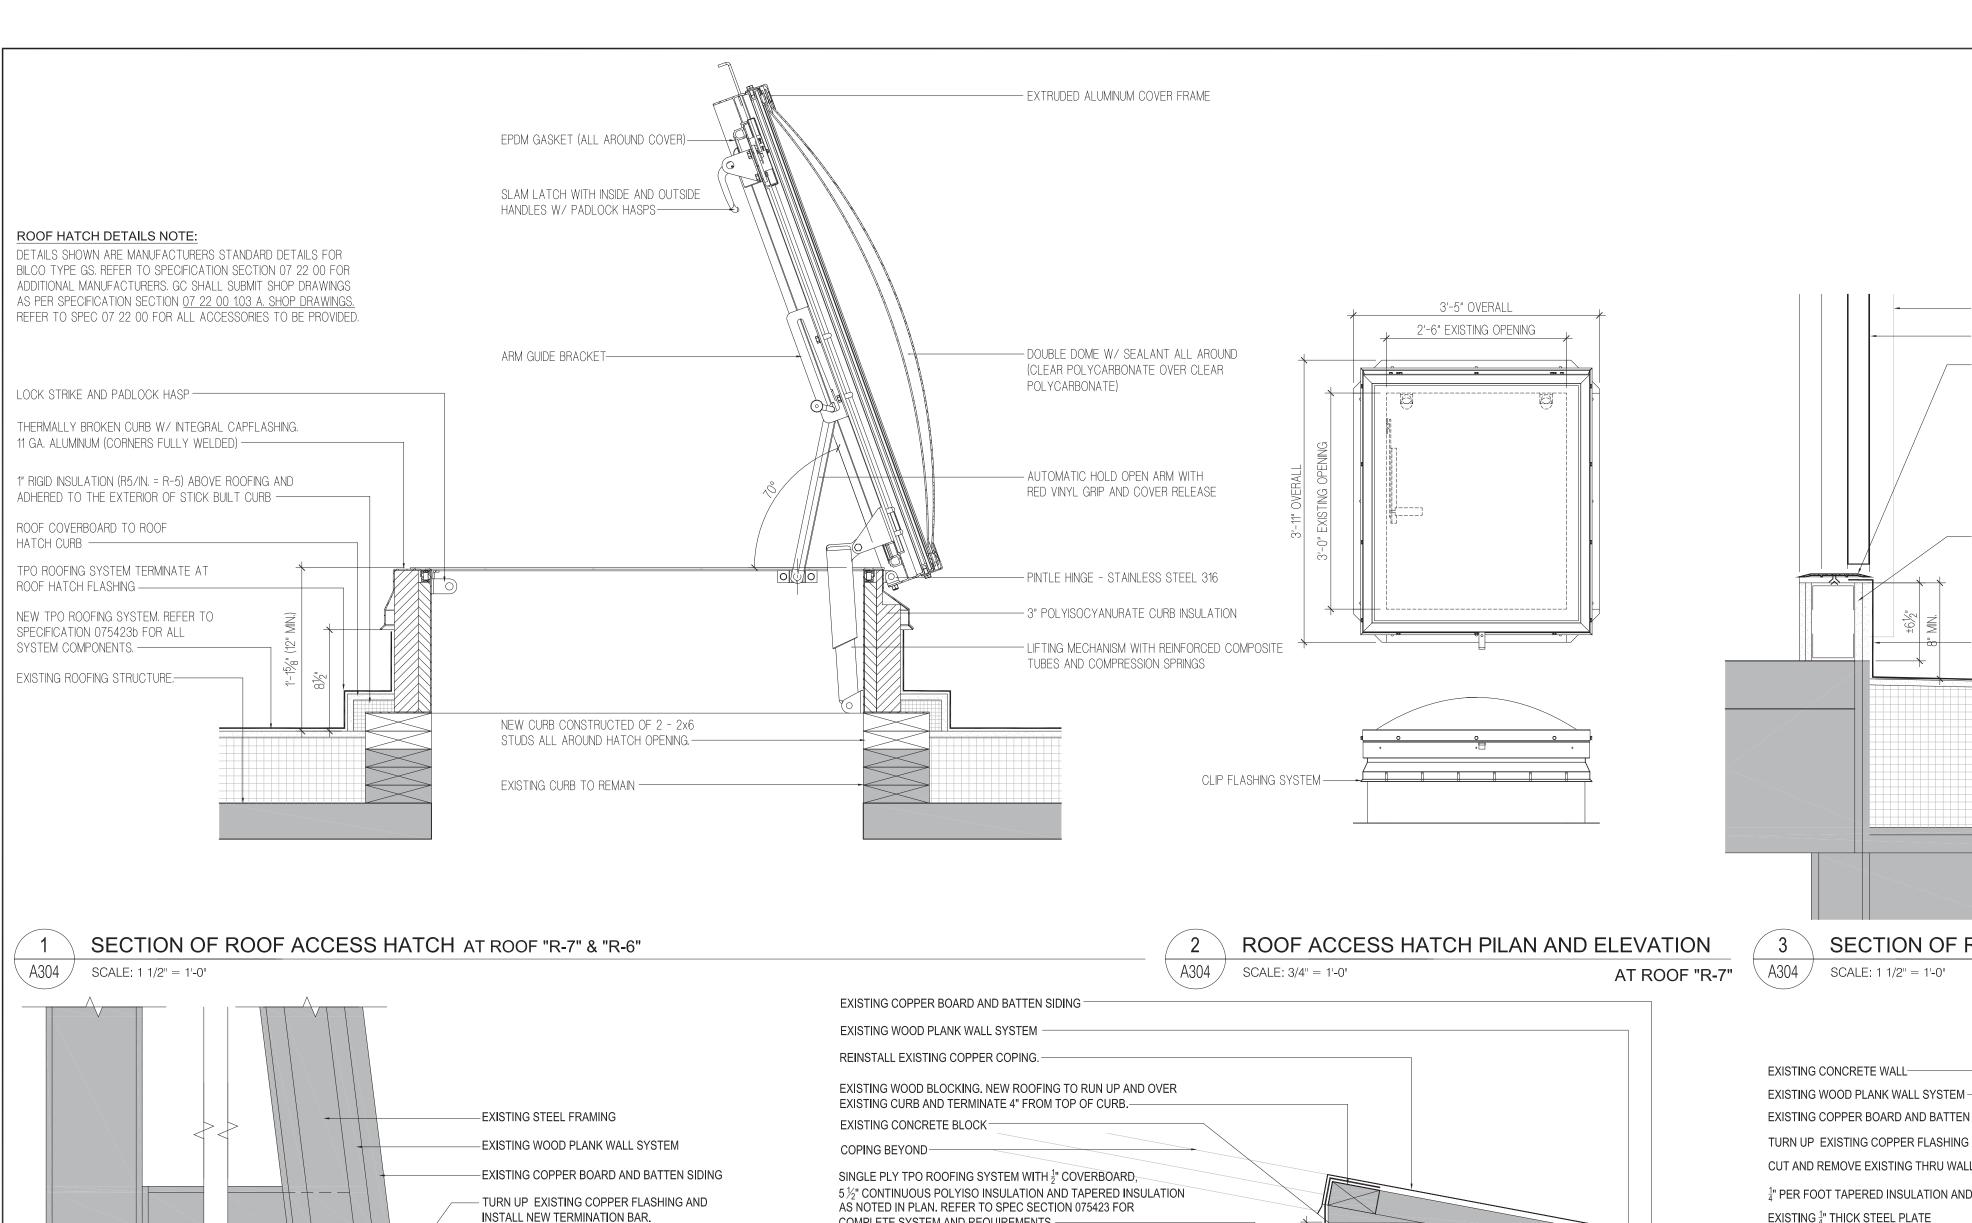

COMPLETE SYSTEM AND REQUIREMENTS.—

EXISTING 4" ACOUSTICAL CONCRETE PLANK —

ROOF HIGH POINT BEYOND AT ±10 ½"

NEW RETROFIT ROOF DRAIN.

REFER TO DETAIL 1/A420 —

EXISTING CONCRETE FILL -

-SINGLE PLY TPO ROOFING SYSTEM WITH 1" COVERBOARD,

INSULATION AS NOTED IN PLAN. REFER TO SPECIFICATION

TOP OF STEEL EL. +34'-5 1/4"


SECTION 075423 FOR COMPLETE SYSTEM AND REQUIREMENTS.

5½" CONTINUOUS POLYISO INSULATION AND TAPERED


- EXISTING 4" ACOUSTICAL CONCRETE PLANK

4 SECTIONS OF ROOF "R-7" AT TOP & BOTTOM OF SLOPED ROOF

A304 SCALE: 1 1/2" = 1'-0"

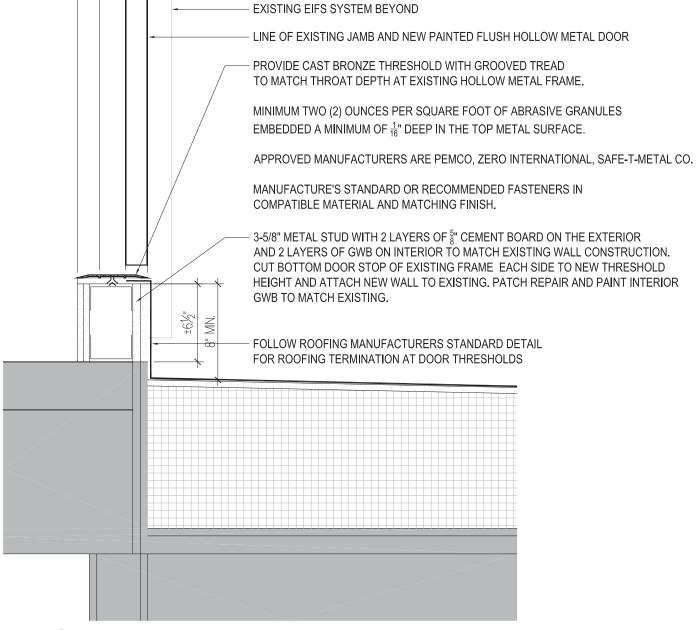

3 SECTION OF ROOF ACCESS DOOR THRESHOLD AT DORSKY MUSEUM

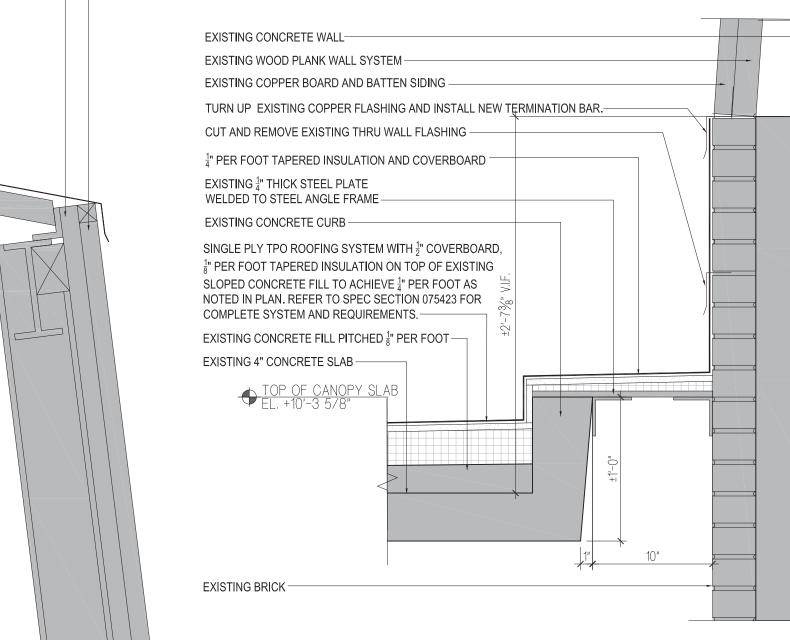

5 SECTION

\ A304 \ SCALE: 1 1/2" = 1'-0"

AT PHOTOCELL OPENING AT ROOF "R-5"

PROGRAM UNIT:

MDSZERBATY ASSOCIATES ARCHITECTURE 307 7th AVENUE 15th FLOOR NEW YORK, NY 10001 TEL: 212.352.3307

307 Seventh Avenue New York NY 10001 P 212 352 3307 F 212 352 9266 mdsnyc.com



Consulting Engineers IAQ SYSTEMS INC, CONSULTING ENGINEERS 555 8th AVENUE, SUITE 1502 NEW YORK, NY 10018 TEL: 212.680.8945


Facility:

SUNY NEW PALTZ **Building Address:** 1 HAWK DRIVE, NEW PALTZ, NY 12561 Building:

SMILEY ARTS BUILDING, COLLEGE THEATRE DORSKY MUSEUM AND FACULTY OFFICE BUILDING

County of: ULSTER

Project No.: 081047-00

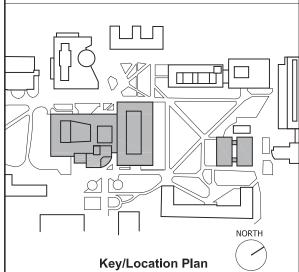

Contract Title: ROOF REPLACEMENT - SMILEY ARTS, COLLEGE THEATRE, DORSKY MUSEUM AND FACULTY OFFICE BUILDING


Project No.: 081047-00

MISCELLANEOUS SECTIONS AND DETAILS

Seal & Signature:



Drawn By:	JASON CAMPAGNA
Checked By:	JOHN O'CONNOR
Date:	JANUARY 8, 2021
Scale:	AS NOTED

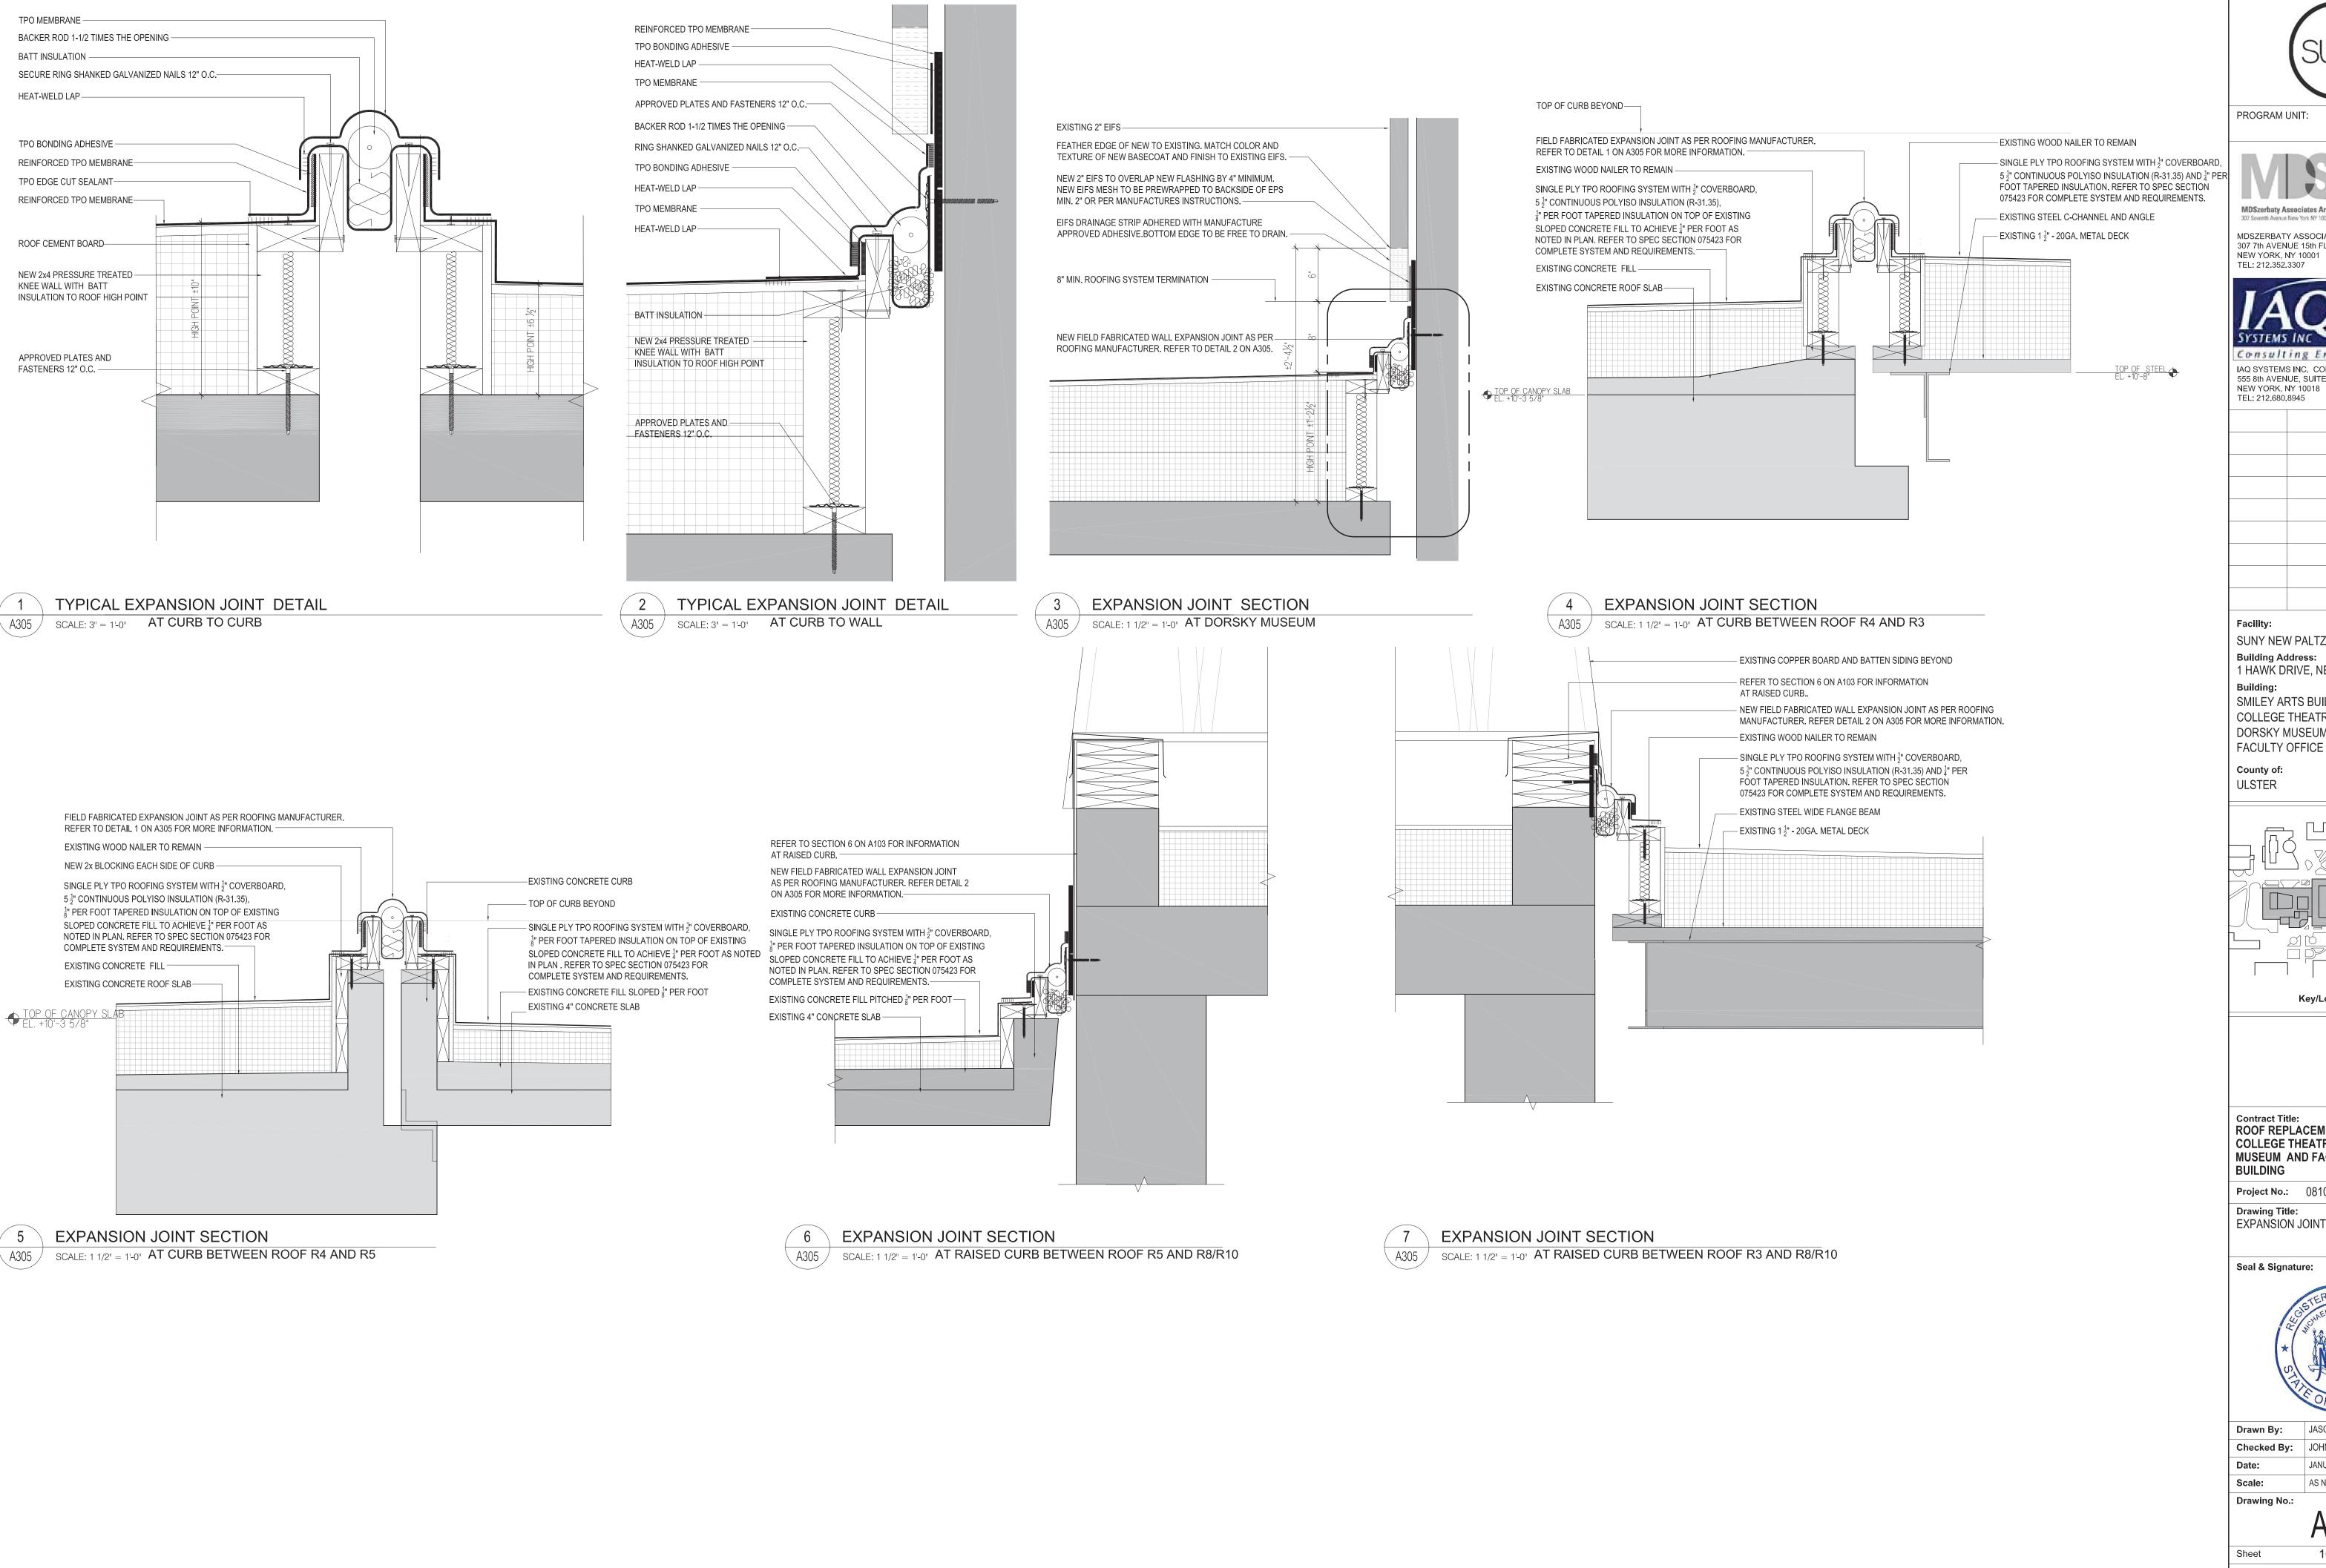

PROGRAM UNIT:

MDSzerbaty Associates Architecture LLC 307 Seventh Avenue New York NY 10001 P 212 352 3307 F 212 352 9266 mdsnyc.com

MDSZERBATY ASSOCIATES ARCHITECTURE 307 7th AVENUE 15th FLOOR NEW YORK, NY 10001




Consulting Engineers IAQ SYSTEMS INC, CONSULTING ENGINEERS 555 8th AVENUE, SUITE 1502

SUNY NEW PALTZ **Building Address:** 1 HAWK DRIVE, NEW PALTZ, NY 12561

SMILEY ARTS BUILDING, COLLEGE THEATRE DORSKY MUSEUM AND FACULTY OFFICE BUILDING

081047-00

Project No.:

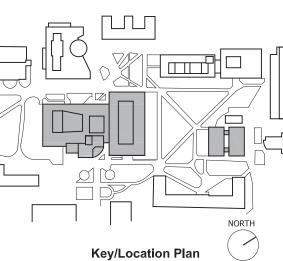

Contract Title: ROOF REPLACEMENT - SMILEY ARTS, COLLEGE THEATRE, DORSKY MUSEUM AND FACULTY OFFICE

Project No.: 081047-00

EXPANSION JOINT SECTIONS AND DETAILS


Seal & Signature:



JASON CAMPAGNA Drawn By: JOHN O'CONNOR Checked By: JANUARY 8, 2021 AS NOTED

- 1. MUST BE FASTENED VERTICALLY ON THE WALL A MINIMUM 10' (3.05 m) FROM ALL ENDS OR CORNERS OF WALL, THEN MAX 20' (6.10 m) THEREAFTER. DRILL-TEC FASTENERS SPACED 12" (305 mm) O.C.
- MAX PARAPET WALL HEIGHT NOT TO EXCEED THE WIDTH OF A 10' (3.05 m) SHEET. PARAPET WALL SHOULD BE NO TALLER THAN 9' (2.74 m) TO USE A FULL 10' (3.05 m) SHEET OF MEMBRANE AS FLASHING. APPLY TPO CUT EDGE SEALANT TO ALL CUT REINFORCED TPO EDGES.


TPO HIGH WALL FLASHING DETAIL

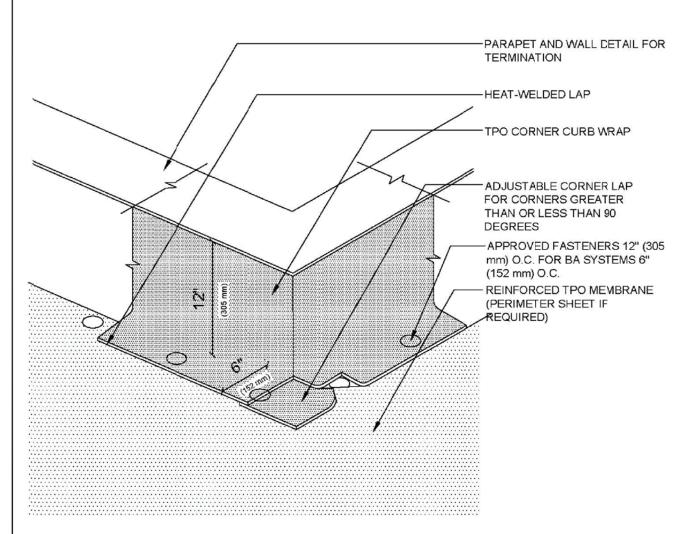

NOTES

- FOUR CORNER CURB WRAP PIECES ARE NEEDED TO COMPLETE. VARYING SIZES MAY BE NEEDED TO
- CORNER WRAP MAY BE ADHERED OR INSTALLED DRY. APPLY TPO CUT EDGE SEALANT TO ALL CUT REINFORCED TPO EDGES

TPO TERMINATION AT EXISTING R.T.U WITH COUNTERFLASHING

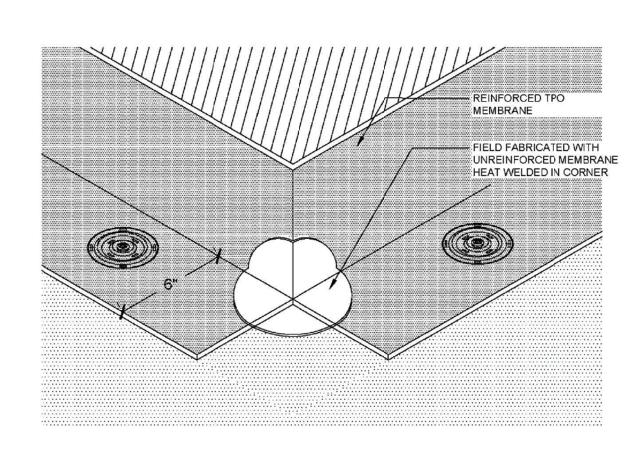


TPO OUTSIDE CORNER REINFORCEMENT - FIELD FABRICATION DETAIL

- 24 GAUGE CONTINOUS HOOK STRIP SECURED WITH APPROVED FASTENERS @ 12" (305 mm) O.C. 24 GAUGE METAL EDGE RING SHANK GALVANIZED NAIL @ 4" (102 mm) O.C. STAGGERED OR APPROVED SCREWS 12" (305 mm) O.C. AND 2" (52 mm) MINIMUM FROM OUTSIDE EDGE OF METAL. - WOOD NAILER, 5/4" (31.8 mm) x 4" (102 mm) MIN SECURED TO DECK -CONTINUOUS BEAD OF APPROVED CAULK GRADE SEALANT OR TPO CUT EDGE TPO COVER TAPE PRIME SURFACE UNDER TAPE WITH TPO PRIMER REINFORCED TPO MEMBRANE (PERIMETER SHEET IF REQUIRED) APPROVED ROOF INSULATION ROOF DECK/SUBSTRATE

- 1. CLEAN METAL AND MEMBRANE WITH TPO SEAM CLEANER AND ALLOW TO DRY BEFORE PRIMING. TPO COVER TAPE ONLY TO BE USED WITH TPO MEMBRANE SYSTEMS. FOR INSULATION THICKNESS GREATER THAN 8" (203 mm), A HARD BOARD IS REQUIRED ON MECHANICAL
- SYSTEMS ONLY. 4. APPROVED CAULK GRADE SEALANT SHOULD BE FEATHERED OUT. ENSURE PRIMER EXTENDS UNDER
- APPROVED CAULK GRADE SEALANT. 5. THIS DETAIL IS NOT TO BE USED ON SLOPES GREATER THAN 1:12.

TPO COVER TAPE AT ROOF EDGE DETAIL

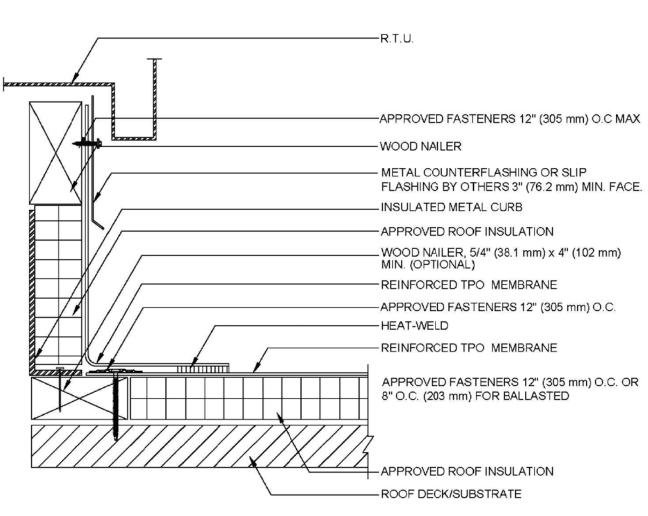

NOTES

- 1. FOR INSULATION THICKNESS GREATER THAN 8" (203 mm), A HARD BOARD IS REQUIRED.
- IF TPO MEMBRANE IS USED, BONDING ADHESIVE IS NOT NEEDED AND WALL MUST BE PRIMED. APPLY TPO CUT EDGE SEALANT TO ALL CUT REINFORCED TPO EDGES.

TPO CORNER CURB WRAP DETAIL

CLEAN AND PRIME METAL ONLY WITH TPO PRIMER AND LET DRY -GALV. ANGULAR SHANK ROOFING NAILS 4" (102 mm) O.C. STAGGERED OR APPROVED SCREWS 12" (305 mm) O.C. SHEET METAL GUTTER BY OTHERS - ANGULAR ROOFING NAILS 12" (305 mm) O.C. - REINFORCED TPO MEMBRANE OR PERIMETER SHEET IF REQ. ROOF DECK/SUBSTRATE -APPROVED ROOF INSULATION -WOOD NAILER, 5/4" (31.8 mm) X 4" (102 mm) MIN SECURED TO SUBSTRATE NOTES TPO COVER TAPE HEATWELD STRIP ONLY TO BE USED WITH TPO MEMBRANE SYSTEMS ONLY. PRIME THE METAL ONLY WITH TPO PRIMER. DO NOT SPILL PRIMER ON WELDED SEAM AREA.

TPO COVER TAPE HEATWELD STRIP


TPO CUT EDGE SEALANT

-METAL DRIP EDGE WITH HEMMED EDGE

- HEAT WELD THE MEMBRANE (NON-ADHESIVE SIDE ONLY) TO MEMBRANE AREA USING EITHER A ROBOTIC
- OR HAND WELDER TO SPEC 4. FOR INSULATION THICKNESS GREATER THAN 8" (203 mm), A HARD BOARD IS REQUIRED ON

MECHANICALLY FASTENED SYSTEMS ONLY.


TPO COVER TAPE HEAT-WELD STRIP AT GUTTER EDGE DETAIL

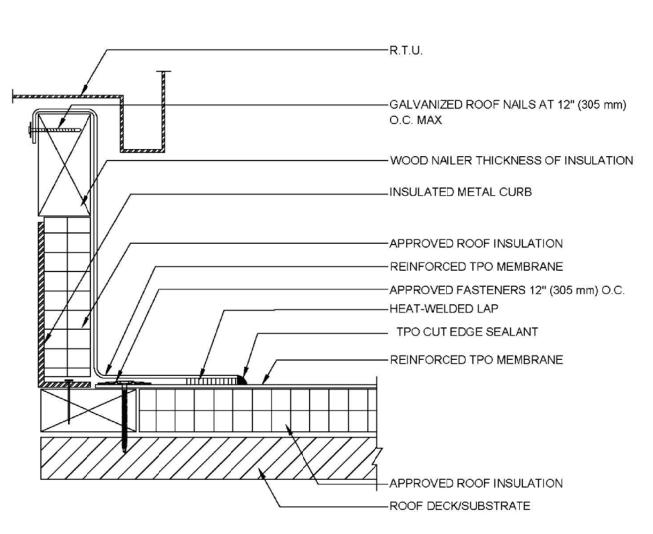


NOTES

- 1. FOR INSULATION THICKNESS GREATER THAN 8" (203 mm), A HARD BOARD IS REQUIRED ON MECHANICAL SYSTEMS ONLY.
- 2. IF TPO MEMBRANE IS USED, BONDING ADHESIVE IS NOT NEEDED AND WALL MUST BE PRIMED.
- 3. APPLY TPO CUT EDGE SEALANT TO ALL CUT REINFORCED TPO EDGES.

TPO TERMINATION AT R.T.U WITH WELDED LAP

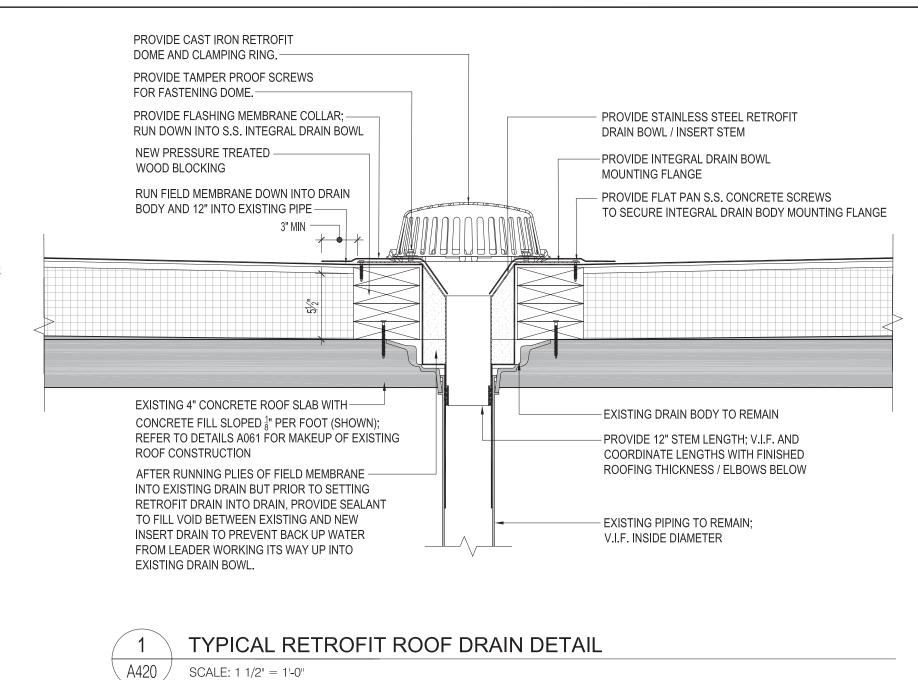

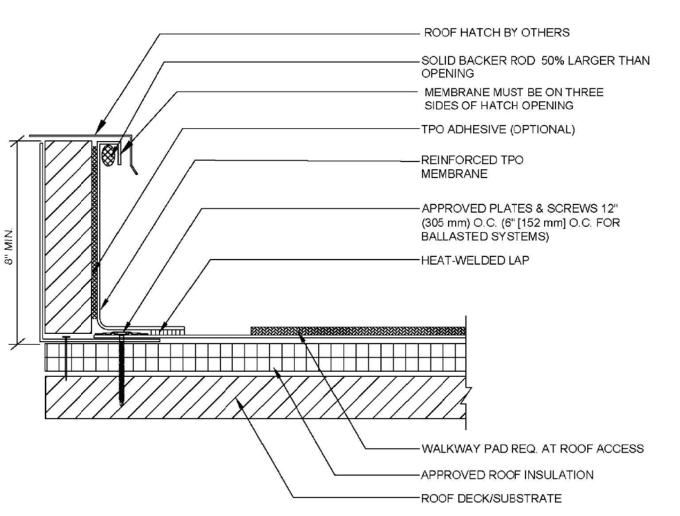

NOTES

- 1. FOR INSULATION THICKNESS GREATER THAN 8" (203 mm), A HARD BOARD IS REQUIRED ON
- MECHANICAL SYSTEMS ONLY. 2. IF TPO MEMBRANE IS USED, BONDING ADHESIVE IS NOT NEEDED AND WALL MUST BE PRIMED.
- 3. APPLY TPO CUT EDGE SEALANT TO ALL CUT REINFORCED TPO EDGES.

TPO ROOF HATCH DETAIL



PROGRAM UNIT:

MDSzerbaty Associates Architecture LLC

MDSZERBATY ASSOCIATES ARCHITECTURE 307 7th AVENUE 15th FLOOR NEW YORK, NY 10001 TEL: 212.352.3307




Consulting Engineers IAQ SYSTEMS INC, CONSULTING ENGINEERS 555 8th AVENUE, SUITE 1502 NEW YORK, NY 10018 TEL: 212.680.8945

Facility: SUNY NEW PALTZ **Building Address:** 1 HAWK DRIVE, NEW PALTZ, NY 12561

Building: SMILEY ARTS BUILDING, COLLEGE THEATRE DORSKY MUSEUM AND FACULTY OFFICE BUILDING

County of: ULSTER

Project No.: 081047-00

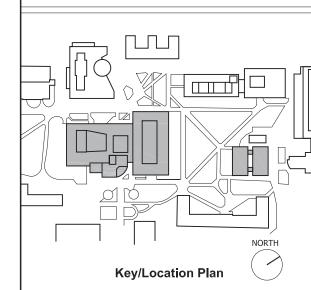

Contract Title: **ROOF REPLACEMENT - SMILEY ARTS,** COLLEGE THEATRE, DORSKY MUSEUM AND FACULTY OFFICE BUILDING

Project No.: 081047-00

Drawing Title: TYPICAL ROOF DETAILS

Seal & Signature:



Drawn By: JASON CAMPAGNA Checked By: JOHN O'CONNOR JANUARY 8, 2021

Scale: AS NOTED Drawing No.:

WORKERS

WORK AREA.

WASHROOM.

NYCRR PART 56-7.5.

THE SHOWERS ARE NOT IN USE.

SYSTEM ENCLOSURES.

SUFFICIENT QUANTITY OF CLEAN WASTE BAGS/CONTAINERS.

FRAMED AND HARD-WALL SHEATHED FOR SAFETY.

(5) EQUIPMENT/WASHROOM ALTERNATIVE. WHERE THERE IS ONLY ONE EXIT FROM THE

SHEETING SHALL BE USED FOR FLOORING PROTECTION OF THESE AREAS.

SYSTEM ENCLOSURE MAY BRANCH OFF FROM THE EQUIPMENT ROOM OF THE PERSONAL

REGULATED ABATEMENT WORK AREA, THE HOLDING AREA OF THE WASTE DECONTAMINATION

DECONTAMINATION SYSTEM ENCLOSURE. THE EQUIPMENT ROOM WILL ALSO BE USED AS A WASTE

(6) PLASTIC SHEETING. WASTE DECONTAMINATION SYSTEM ENCLOSURES CONSTRUCTED AT THE

WORK SITE SHALL USE AT LEAST ONE LAYER OF SIX MIL FIRE-RETARDANT PLASTIC SHEETING ON

WALLS AND CEILING. AT LEAST TWO LAYERS OF SIX MIL FIRE-RETARDANT REINFORCED PLASTIC

(7) ENCLOSURE SECURITY. THE WASTE DECONTAMINATION SYSTEM ENCLOSURE AND REGULATED

ENCLOSURE SYSTEMS LOCATED WITHIN 25 FEET OF AN AREA OF PUBLIC ACCESS SHALL BE FULLY

(8) DRAINS. THE WASTE WASHROOM SHALL BE EQUIPPED WITH A WASH BIN OF SUFFICIENT SIZE TO

PERFORM WASTE CONTAINER WASHING OPERATIONS AND SHALL HAVE A SUBMERSIBLE PUMP

FILTRATION SYSTEM WHERE IT SHALL BE FILTERED IN ACCORDANCE WITH PARAGRAPH (B)(9) OF

(9) SHOWER/WASHROOM ALTERNATIVE — SMALL ASBESTOS PROJECT. FOR SMALL ASBESTOS

PROJECTS WITH ONLY ONE EXIT FROM THE REGULATED ABATEMENT WORK AREA, THE SHOWER

ROOM MAY BE USED AS A WASTE WASHROOM. THE CLEAN ROOM SHALL NOT BE USED FOR WASTE

STORAGE, BUT SHALL BE USED FOR WASTE TRANSFER TO CARTS, WHICH SHALL BE IMMEDIATELY

REMOVED FROM THE ENCLOSURE. WASTE SHALL BE TRANSFERRED ONLY DURING TIMES WHEN

WHEN A REMOTE PERSONAL DECONTAMINATION SYSTEM ENCLOSURE IS ALLOWED AND UTILIZED

WASTE DECONTAMINATION SYSTEM ENCLOSURE — WHEN REMOTE PERSONAL IS ALLOWED.

FOR A REGULATED ABATEMENT WORK AREA, THE FOLLOWING REQUIREMENTS SHALL APPLY:

(1) MINOR SIZE REGULATED ABATEMENT WORK AREA. NO SPECIFIC WASTE DECONTAMINATION

SÝSTEM ENCLOSURE IS REQUIRED FOR MINOR SIZE REGULATED ABATEMENT WORK AREAS. THE

WASTE GENERATED SHALL BE IMMEDIATELY BAGGED/CONTAINERIZED WITHIN THE REGULATED

(I) WASHROOM. AN ADDITIONAL CHAMBER SHALL BE CONSTRUCTED WITHIN THE REGULATED

ABATEMENT WORK AREA, ATTACHED TO THE EXISTING AIRLOCK USED TO ACCESS THE WORK

EQUIPMENT/MATERIALS CONSISTENT WITH WASTE DECONTAMINATION SYSTEM ENCLOSURE

WASHROOM REQUIREMENTS FOR CONTIGUOUS PERSONAL AND WASTE DECONTAMINATION

(II) REMOVAL. THE WASHROOM CHAMBER SHALL BE REMOVED ONLY AFTER SATISFACTORY

AREA, THE WASHROOM/AIRLOCK COMBINATION SHALL BE UTILIZED AS THE CONTIGUOUS WASTE

DECONTAMINATION ENCLOSURE FOR WASTE BAGGING/CONTAINERIZATION AND WASTE TRANSFER

(2) SMALL AND LARGE SIZE REGULATED ABATEMENT WORK AREAS.

CLEARANCE AIR SAMPLING RESULTS HAVE BEEN ACHIEVED.


ACTIVITIES. THE WASHROOM SHALL BE CONSTRUCTED AND SUPPLIED WITH


ABATEMENT WORK AREA AIRLOCK(S) (WHEN REMOTE DECONTAMINATION SYSTEMS ARE USED)

SHALL BE CONSTRUCTED WITH LOCKABLE DOORS TO PREVENT UNAUTHORIZED ENTRY.

INSTALLED TO COLLECT WASTE WATER AND DELIVER IT TO THE SHOWER WASTEWATER

PERSONAL DECONTAMINATION ENCLOSURI LARGE SCALE

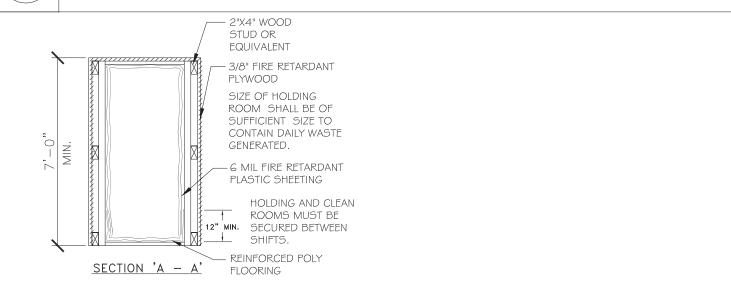

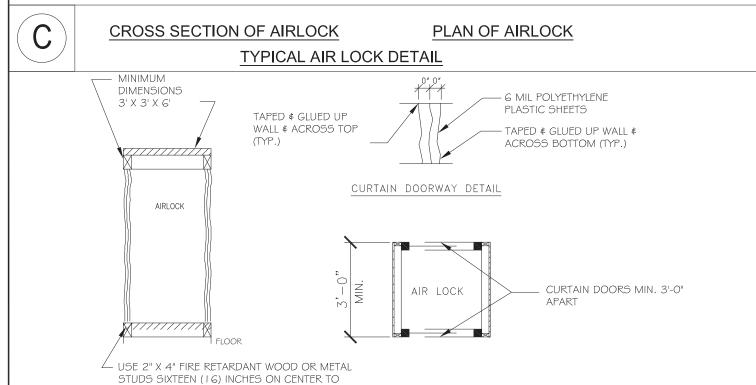

REMOTE PERSONAL DECONTAMINATION SYSTEM ENCLOSURE

CONSTRUCT AN AIR LOCK AND TENT SYSTEM.

IF A PERSONAL DECONTAMINATION SYSTEM CANNOT BE ATTACHED TO THE REGULATED ABATEMENT WORK AREA, DUE TO AVAILABLE SPACE RESTRICTIONS OR OTHER BUILDING AND FIRE CODE RESTRICTIONS, A REMOTE PERSONAL DECONTAMINATION SYSTEM ENCLOSURE MAY BE USED FOR LIMITED SPECIAL PROJECTS AS PER SUBPART 56-11 OF NYCRR PART 56, NEGATIVE PRESSURE TENT ENCLOSURE WORK AREAS WITH GLOVEBAG ONLY ABATEMENT, OR IF NON-FRIABLE ACM IS BEING REMOVED IN A MANNER WHICH WILL NOT RENDER THE ACM FRIABLE. IF IT IS FOUND DURING PHASE II B, THAT THE NON-FRIABLE ACM OR ASBESTOS MATERIAL WILL BECOME FRIABLE DURING THE REMOVAL PROCESS, AND IT IS LOGISTICALLY POSSIBLE TO ATTACH THE DECONTAMINATION SYSTEM ENCLOSURE, ABATEMENT WORK MUST STOP IMMEDIATELY WHILE THE REMOTE PERSONAL DECONTAMINATION SYSTEM IS RELOCATED TO BE ATTACHED AND CONTIGUOUS TO THE REGULATED ABATEMENT WORK AREA. THE FOLLOWING REQUIREMENTS APPLY FOR ALL REMOTE PERSONAL DECONTAMINATION SYSTEMS:

(1) PROTECTIVE CLOTHING. WORKERS SHALL DON TWO SETS OF DISPOSABLE PROTECTIVE CLOTHING AND A SUPPLY OF PROTECTIVE CLOTHING SHALL BE KEPT IN THE AIRLOCKS ATTACHED TO THE REGULATED ABATEMENT WORK AREA.

(2) LOCATION. THE REMOTE PERSONAL DECONTAMINATION SYSTEM SHALL BE CONSTRUCTED AS CLOSE TO THE REGULATED ABATEMENT WORK AREA AS PHYSICALLY POSSIBLE. IF THE REMOTE PERSONAL DECONTAMINATION SYSTEM MUST BE LOCATED AT THE EXTERIOR OF THE BUILDING/STRUCTURE DUE TO SPACE OR CODE RESTRICTIONS, IT SHALL BE CONSTRUCTED WITHIN 50 FEET OF THE BUILDING/STRUCTURE EXIT USED FOR ACCESS BY THE ASBESTOS ABATEMENT CONTRACTOR PERSONNEL. THE DECONTAMINATION UNIT SHALL BE CORDONED OFF AT A DISTANCE OF 25 FEET TO SEPARATE IT FROM PUBLIC AREAS.

(3) AIRLOCKS. AT A MINIMUM, TWO EXTRA AIRLOCKS AS DEFINED IN SECTION 56-2.1 OF NYCRR PART 56 SHALL BE CONSTRUCTED AS PER PARAGRAPH (B)(11) OF SECTION 56-7.5. ONE SHALL BE CONSTRUCTED AT THE ENTRANCE TO THE EQUIPMENT ROOM OR EQUIPMENT/WASHROOM. THE OTHER EXTRA AIRLOCK SHALL BE CONSTRUCTED AT THE ENTRANCE TO THE CONTAINMENT OR REGULATED ABATEMENT WORK AREA(S). THESE AIRLOCKS SHALL HAVE LOCKABLE DOORWAYS AT THE ENTRANCE TO THE AIRLOCK FROM UNCONTAMINATED AREAS. THESE AIRLOCKS SHALL BE CORDONED OFF AT A DISTANCE OF 25 FEET AND APPROPRIATELY SIGNED IN ACCORDANCE WITH SECTION 56-7.4(C) OF NYCRR PART 56. AIRLOCKS SHALL NOT BE USED AS A WASTE DECONTAMINATION AREA AND SHALL BE KEPT CLEAN AND FREE OF ASBESTOS CONTAINING


(4) DESIGNATED PATHWAY. THE WALKWAY FROM THE REGULATED ABATEMENT WORK AREA TO THE PERSONAL DECONTAMINATION SYSTEM OR NEXT REGULATED ABATEMENT WORK AREA SHALL BE CORDONED OFF AND SIGNAGE INSTALLED AS PER SECTION 56-7.4(C) OF NYCRR PART 56, TO DELINEATE IT FROM PUBLIC AREAS WHILE IN USE DURING PHASES II A THROUGH II D.

(5) TRAVEL THROUGH UNCONTAMINATED AREAS. IF AT ANY TIME A WORKER MUST TRAVEL THROUGH AN UNCONTAMINATED AREA TO ACCESS THE PERSONAL DECONTAMINATION AREA, THE WORKER SHALL HEPA-VACUUM AND/OR WET WIPE HIS/HER OUTER PROTECTIVE CLOTHING WHILE IN THE REGULATED ABATEMENT WORK AREA, THEN PROCEED INTO THE AIRLOCK, WHICH SERVES AS A CHANGING AREA, WHERE HE/SHE SHALL REMOVE THE OUTER CLOTHING AND DON A CLEAN SET OF PROTECTIVE CLOTHING. THE WORKER MAY THEN PROCEED TO THE PERSONAL DECONTAMINATION SYSTEM ENCLOSURE ONLY ALONG A DESIGNATED PATHWAY AS DESCRIBED ABOVE. TRAVEL IN ANY OTHER AREA SHALL NOT BE ALLOWED.

(6) REMOVAL. THE REMOTE PERSONAL DECONTAMINATION UNIT SHALL BE REMOVED ONLY AFTER SATISFACTORY CLEARANCE AIR SAMPLING RESULTS HAVE BEEN ACHIEVED.

WASTE DECONTAMINATION SYSTEM ENCLOSURE—LARGE AND SMALL ASBESTOS PROJECTS.

(1) ENCLOSURE—GENERAL. A WASTE DECONTAMINATION SYSTEM ENCLOSURE SHALL BE PROVIDED OUTSIDE THE REGULATED ABATEMENT WORK AREA AND SHALL BE ATTACHED TO THE REGULATED ABATEMENT WORK AREA. ONE WASTE DECONTAMINATION ENCLOSURE FOR EACH REGULATED ABATEMENT WORK AREA SHALL BE REQUIRED. THIS SYSTEM MAY UTILIZE ADEQUATE EXISTING LIGHTING SOURCES SEPARATE FROM THE DECONTAMINATION SYSTEM ENCLOSURE, OR SHALL BE SUPPLIED WITH A GFCI PROTECTED TEMPORARY LIGHTING SYSTEM. THE WASTE DECONTAMINATION SYSTEM ENCLOSURE SHALL BE SIZED TO ACCOMMODATE THE NUMBER OF WORKERS AND EQUIPMENT FOR THE INTENDED PURPOSE, SUCH SYSTEM MAY CONSIST OF EXISTING ATTACHED ROOMS OUTSIDE OF THE REGULATED ABATEMENT WORK AREA, IF THE LAYOUT IS APPROPRIATE, THAT CAN BE PLASTICIZED AND ARE ACCESSIBLE FROM THE REGULATED ABATEMENT WORK AREA. WHEN THIS SITUATION DOES NOT EXIST, ENCLOSURE SYSTEMS MAY BE CONSTRUCTED OF METAL, WOOD OR PLASTIC SUPPORTS COVERED WITH FIRE-RETARDANT PLASTIC SHEETING. A MINIMUM OF ONE LAYER OF SIX MIL FIRE-RETARDANT PLASTIC SHEETING SHALL BE INSTALLED ON THE CEILING, AND WALLS OF THE ENCLOSURE SYSTEM. AT LEAST TWO LAYERS OF SIX MIL FIRE-RETARDANT REINFORCED PLASTIC SHEETING SHALL BE USED FOR FLOORING PROTECTION OF THIS AREA. THIS SYSTEM MUST BE KEPT CLEAN, SANITARY AND CLIMATE CONTROLLED AT ALL TIMES IN CONFORMANCE TO ALL FEDERAL, STATE AND LOCAL GOVERNMENT REQUIREMENTS. THIS SYSTEM SHALL REMAIN AND BE USED UNTIL COMPLETION OF PHASE II C OF THE ASBESTOS PROJECT.

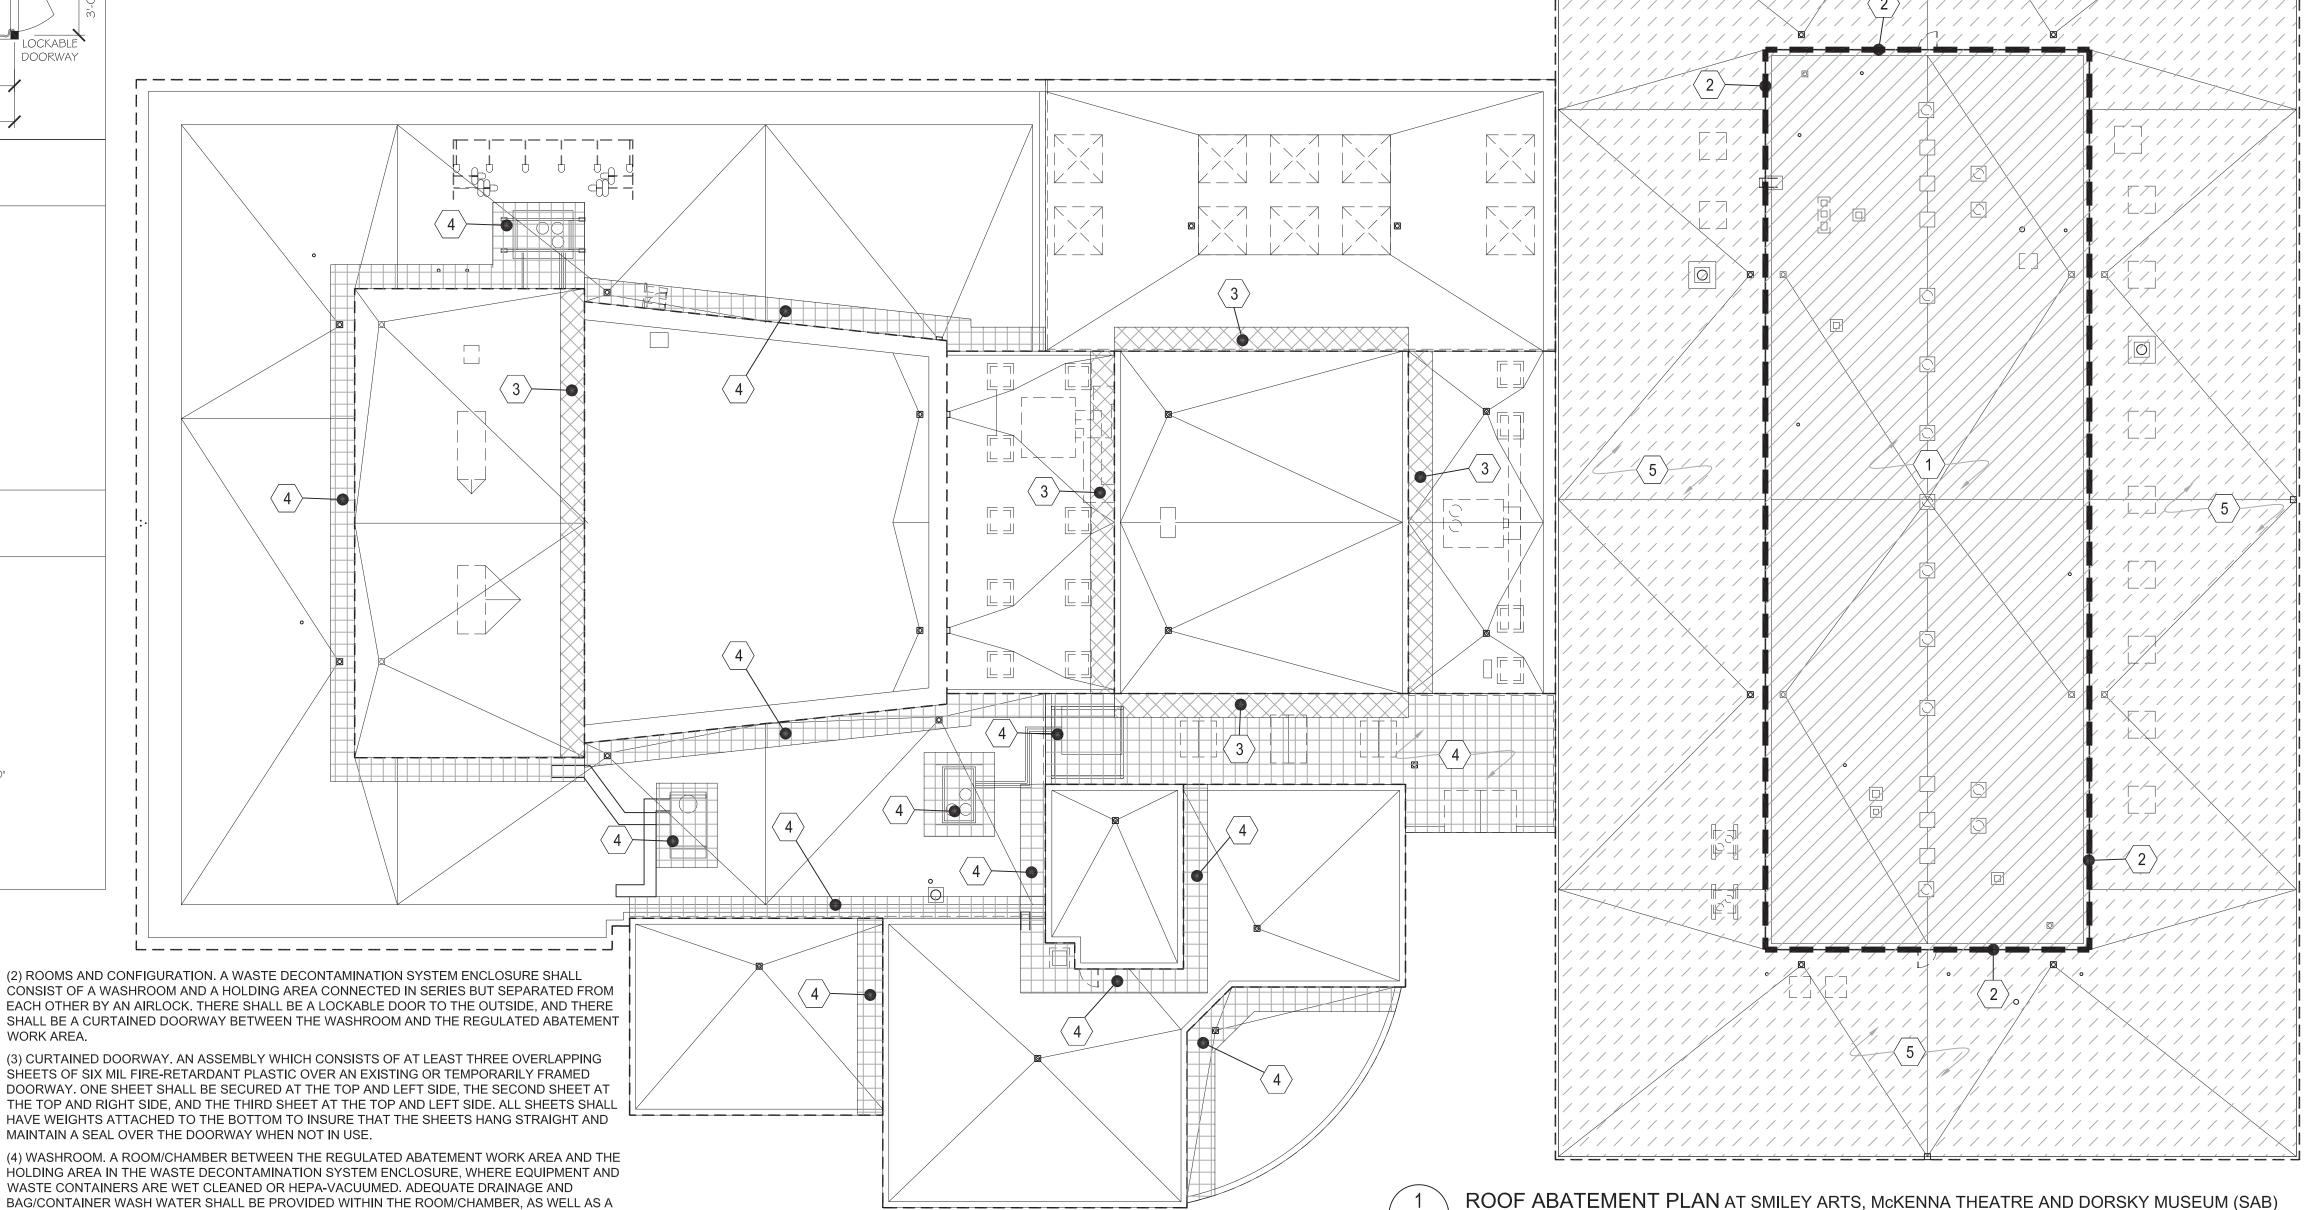

HAZARDOUS MATERIAL ABATEMENT KEYNOTES - FACULTY BUILDING

REMOVE AND DISPOSE OF TAR ON CURBS (SKYLIGHT & MECHANICAL EXHAUST UNITS)

 $\langle 2 \rangle$ REMOVE AND DISPOSE OF CAULKING ON VENTS & WINDOWS AT COPPER WALL

REMOVE AND DISPOSE OF TAR ON FLASHING ON COPPER WALL AND TAR ON WALL 4 > REMOVE AND DISPOSE OF TAR ON WALL SECTION & RTU CURBS

 \langle 5 angle REMOVE AND DISPOSE OF TAR ON SIDE WALL, CURBS & MECHANICAL EXHAUST UNITS)

HAZARDOUS MATERIAL QUANTITIES - ALL ROOFS

MATERIAL	TARS	CAULKING	
QTY.	1,610 SF	1,238 LF	

GENERAL ABATEMENT NOTES:

REGULATIONS DURING THE ENTIRE PROJECT.

THE ABATEMENT LEGEND LISTS APPROXIMATE QUANTITIES FOR REMOVAL, BUT THE CONTRACTOR IS ALONE RESPONSIBLE FOR DETERMINING THE ACTUAL ABATEMENT QUANTITIES.

ALL ASBESTOS ABATEMENT WORK SHALL BE PERFORMED IN ACCORDANCE WITH SPECIFICATION SECTION 028213. THIS FACILITY WILL BE OCCUPIED DURING CONSTRUCTION WORK.

SHUT DOWN AND ISOLATE EXISTING MECHANICAL EQUIPMENT SYSTEMS TO PREVENT CONTAMINATION AND

DISPERSAL TO OTHER AREAS IN THE BUILDING. COORDINATE WITH THE OWNER'S REPRESENTATIVE. ALL SCHEDULED ABATEMENT WORK SHALL BE COORDINATED WITH THE OWNER'S REPRESENTATIVE. FOLLOW ALL RULES AND REGULATIONS OF NYS ICR 56, EPA, OSHA AND OTHER APPLICABLE FEDERAL, STATE AND LOCAL

ATTEND THE PRE-WORK CONFERENCE AND PROVIDE A DETAILED ABATEMENT WORK PLAN FOR REVIEW.

BE RESPONSIBLE FOR ON-SITE SAFETY AND SECURITY OF EMPLOYEES DURING ALL HAZARDOUS REMOVAL ACTIVITIES. ASSUME RESPONSIBILITY FOR PROCEEDING WITH THE WORK IN A MANNER THAT OFFERS EMPLOYEES A WORKPLACE FREE FROM RECOGNIZED HAZARDS CAUSING SERIOUS HEALTH, HARM OR INJURY.

PROVIDE TO THE OWNER'S REPRESENTATIVE ALL WASTE TRANSPORTER PERMITS, WASTE DISPOSAL RECEIPTS AND THE CONTRACTORS POST ABATEMENT REPORT. SEE THE CLOSEOUT SUBMITTAL SECTION IN THE ABATEMENT SPEC SECTION FOR DETAILS.

VERIFY THAT LANDFILL ACCEPTS ALL TYPES OF HAZARDOUS MATERIALS WITHIN PROJECTS SCOPE OF WORK.

- 10. ANY REMOVAL WORK OR ANY OTHER WORK IN THESE AREAS SHALL COMMENCE ONLY AFTER THE HAZARDOUS MATERIAL REMOVAL WORK IS COMPLETED AND ONLY AFTER THE NECESSARY CLEARANCES ARE OBTAINED.
- UPON COMPLETION OF HAZARDOUS MATERIAL REMOVALS WORK, ANY EXISTING AREAS AND/OR FINISHES THAT HAVE BEEN DAMAGED THAT ARE NOT PART OF THE REMOVAL SCOPES OF WORK (INCLUDES AREAS AND/OR FINISHES AS A RESULT OF ANY TEMPORARY PARTITIONS AND WASTE DECON UNIT ENCLOSURES CONSTRUCTION) SHALL BE RESTORED TO ORIGINAL CONDITIONS BY THE CONTRACTOR AT CONTRACTOR'S EXPENSE. FINISH RESTORATION SHALL BE APPROVED BY THE OWNER'S REPRESENTATIVE.
- COORDINATE ABATEMENT WITH SCOPE INDICATED ON OTHER DRAWINGS AND PERFORMED BY OTHER TRADE CONTRACTS.
- 13. THE RESULTS OF THE TESTING FOR ACM & LEAD ARE LISTED IN THE BUILDING ASBESTOS SURVEY REPORT

ROGRAM UNIT:

7 Seventh Avenue New York NY 10001 P 212 352 3307 F 212 352 9266 mdsnyc.com

MDSZERBATY ASSOCIATES ARCHITECTURE 307 7th AVENUE 15th FLOOR NEW YORK, NY 10001 EL: 212.352.3307




AQ SYSTEMS INC, CONSULTING 555 8th AVENUE, SUITE 1502

NEW YORK, NY 10018

08/27/2020 | PRE-BID PHASE

SUNY NEW PALTZ Building Address: 1 HAWK DRIVE, NEW PALTZ, NY 12561 SMILEY ARTS BUILDING

County of: ULSTER

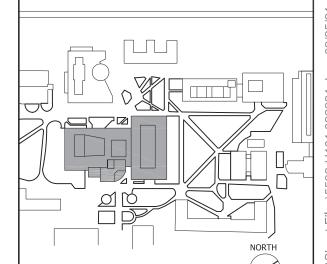

Project No.:

081047-00

Key/Location Plan



REPLACE ROOFS - SMILEY ARTS. COLLEGE THEATRE, DORSKY MUSEUM (SAB) AND FACULTY OFFICE BUILDING (FOB)

Project No.: 081047-00

Drawing Title:

SAB ROOF ABATEMENT PLAN


Seal & Signature:




Drawn By:	AEHA
Checked By:	JS
Date:	FEBRUARY 22, 2021
Scale:	AS NOTED


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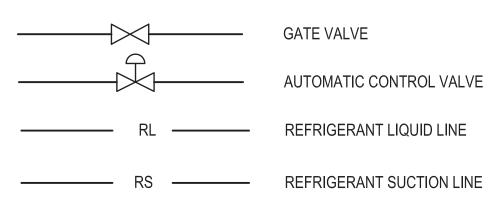
POINT OF CONNECTION

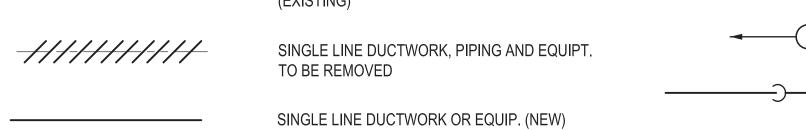


← POINT OF DISCONNECTION PIPE DROP



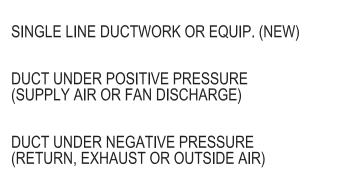

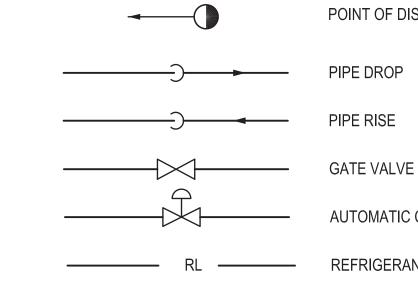


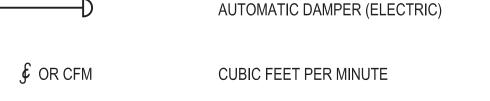

VOLUME DAMPER

∑ CD-A 400 § TYPE A CEILING DIFFUSER 400 CFM SUPPLY AIR 10x8 CR(CG) 300 §


10" BY 8" CEILING REGISTER (CEILING GRILLE) 300 CFM RETURN AIR

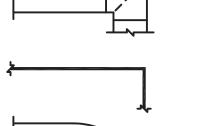


VANED ELBOW (SEE DETAIL)



VANED ELBOW (SEE DETAIL) OR RADIUS ELBOW

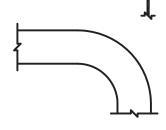

RADIUS ELBOW

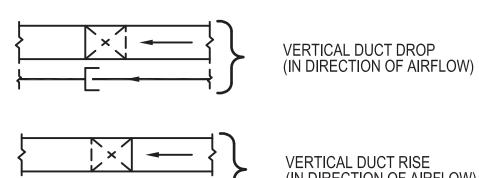

(IN DIRECTION OF AIRFLOW)

SMOKE DETECTOR / DUCT SMOKE DETECTOR

ABBI	REVIATIONS LIST			
Α	AMPERES	FT	FEET	RI
AC	AIR CONDITIONING	GPH	GALLONS PER HOUR	RF
ACC	AIR COOLED CONDENSER	GPM	GALLONS PER MINUTE	SA
ACCU	AIR COOLED CONDENSING UNIT	HF	HUMIDIFIER	SE
ACH	AIR CHANGES PER HOUR	HC	HEATING COIL	SE
AD	ACCESS DOOR	HD	HEAD	SF
AFF	ABOVE FINISHED FLOOR	HT	HEIGHT	SF
AS	AIR SEPARATOR	HZ	FREQUENCY	SF
BHP	BRAKE HORSEPOWER	IAT	INDOOR AIR TEMPERATURE	TEI
BMS	BUILDING MANAGEMENT SYSTEM	IN	INCH OR INCHES	TG
BTU	BRITISH THERMAL UNIT	KW	KILOWATT	TYI
BTUH	BTU PER HOUR	L	LENGTH	UO
°C	DEGREES CENTIGRADE (CELSIUS)	LAT	LEAVING AIR TEMPERATURE	٧
CD CD	CEILING DIFFUSER CONDENSATE DRAIN	LBS	POUNDS	VA
		LD3	LINEAR DIFFUSER	VF
CFM	CUBIC FEET PER MINUTE	LR	LINEAR RETURN	VIF
CG	CEILING GRILLE	LWT	LEAVING WATER TEMPERATURE	W
CLG	CEILING			W/
CO	CLEAN OUT	MAX	MAXIMUM	W/e
COMPR	COMPRESSOR	MBH	THOUSAND BTU PER HOUR	WE
COND	CONDENSATE	MCA	MINIMUM CIRCUIT AMPACITY	WM
CR	CEILING REGISTER	MIN	MINIMUM	
CU FT	CUBIC FEET	MOCP	MAXIMUM OVER CURRENT PROTECTION	
CU IN	CUBIC INCHES	NIC	NOT IN CONTRACT	
DD		NO.	NUMBER	
DB	DRY BULB	NYS	NEW YORK STATE	
DIAM	DIAMETER	O.C.	OFF CENTER	
DMPR	DAMPER	OA	OUTSIDE AIR	
DDC	DIRECT DIGITAL CONTROL	OAI	OUTSIDE AIR INTAKE	
DN	DOWN	OAT	OUTSIDE AIR TEMPERATURE	
DWG	DRAWING	PD	PRESSURE DROP	
EA	EXHAUST AIR	PD	PUMP DISCHARGE	
EAT	ENTERING AIR TEMPERATURE	PDE	24V POWER DISTRIBUTION ENCLOSURE	
EF	EXHAUST FAN	PF	PREFILTER	
EL	ELEVATION	PH	PHASE	
ELEC	ELECTRIC	PRV	PRESSURE REDUCING VALVE	
ELEV	ELEVATOR	PSI	POUNDS PER SQUARE INCH	
EQ	EQUAL	PSIA	PSI ABSOLUTE	
ESP	EXTERNAL STATIC PRESSURE	PSIG	PSI GAUGE	
EWT	ENTERING WATER TEMPERATURE	R	RISE	
EXH	EXHAUST	RA	RETURN AIR	

RETURN FAN

RELATIVE HUMIDITY

RUNNING LOAD AMPS

FILTER

FIRE DAMPER

FINISHED FLOOR

FINS PER INCH

FEET PER MINUTE

FEET PER SECOND

FULL LOAD AMPERES

FD

FIN FL

FLA

DEGREES FAHRENHEIT

ROOM REVOLUTIONS PER MINUTE SUPPLY AIR SMOKE DAMPER SEASONAL ENERGY EFFICIENCY RATIO SUPPLY FAN STATIC PRESSURE SPECIFICATION TEMPERATURE TOP GRILLE TYPICAL UNLESS OTHERWISE NOTED **VOLTS VENTILATION AIR** VARIABLE FREQUENCY DRIVE VERIFY IN FIELD WITHOUT

WET BULB

1/2" WIRE MESH SCREEN (BIRD SCREEN)

Key/Location Plan

1 HAWK DRIVE, NEW PALTZ, NY 12561

Project No.: 081047-00

PROGRAM UNIT:

MDSzerbaty Associates Architecture LLC

Consulting Engineers IAQ SYSTEMS INC, CONSULTING

ENGINEERS 555 8th AVENUE, SUITE 1502 NEW YORK, NY 10018

NEW YORK, NY 10001

TEL: 212.352.3307

SYSTEMS INC

Facility:

Building:

County of:

ULSTER

SUNY NEW PALTZ **Building Address:**

SMILEY ARTS BUILDING, COLLEGE THEATRE

DORSKY MUSEUM AND FACULTY OFFICE BUILDING

307 Seventh Avenue New York NY 10001 P 212 352 3307 F 212 352 9266 mdsnyc.com

MDSZERBATY ASSOCIATES ARCHITECTURE 307 7th AVENUE 15th FLOOR

Contract Title: ROOF REPLACEMENT - SMILEY ARTS, COLLEGE THEATRE, DORSKY MUSEUM AND FACULTY OFFICE BUILDING

Project No.: 081047-00

Drawing Title: HVAC SYMBOLS LIST & ABBREVIATION

Seal & Signature:



Drawn By: Checked By: JANUARY 8, 2021 AS NOTED

M001.00

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CERTIFICATION: "TO THE BEST OF MY KNOWLEDGE, BELIEF AND PROFESSIONAL JUDGEMENT, ALL PLANS AND APPLICATIONS ARE IN COMPLIANCE WITH THE NYSECC - NEW YORK STATE ENERGY CONSERVATION CODE 2020.

GENERAL NOTES (APPLICABLE TO ALL DRAWINGS)

- THE TERM "CONTRACTOR", "THIS CONTRACTOR" OR ANY TEXT AND DRAWINGS INCLUDED IN THIS CONTRACT DOCUMENT (WHICH INCLUDES DRAWINGS AND SPECIFICATIONS) SHALL BE MEANT AND DIRECTED TO THE CONTRACTOR PERFORMING THE HEATING, VENTILATING AND AIR CONDITIONING (HVAC) WORK IN THIS PROJECT.
- 2. THE ARCHTIECT/ENGINEER FOR THE PROJECT WHO WILL ALSO BE REFERRED TO AS THE ARCHTIECT/ENGINNEER OF RECORD WILL BE THE FIRM WHOSE NAME AND ADDRESS IS LISTED IN THE TITLE BLOCK OF THE DESIGN DOCUMENT.
- 3. ALL WORK SHOWN IN THE CONTRACT DRAWINGS AND INCLUDED IN THE SPECIFICATIONS SHALL BE CONSIDERED AS NEW WORK TO BE PROVIDED (DEFINED AS FURNISHED AND INSTALLED) BY THE CONTRACTOR. ONLY ITEM SPECIFICALLY INDICATED AS "EXISTING" SHALL BE EXCLUDED FROM THE WORK PROVIDED BY THE CONTRACTOR. SYMBOL LIST SHOWING DIFFERENT LINE THICKNESS FOR EXISTING AND NEW COMPONENTS ARE MEANT ONLY FOR CLARITY. UNLESS SPECIFICALLY INDICATED AS "EXISTING" ALL COMPONENTS SHALL BE CONSIDERED TO BE NEW TO BE PROVIDED BY THE CONTRACTOR.
- 4. THE SCOPE OF WORK TO BE PROVIDED BY THE CONTRACTOR SHALL INCLUDE SCOPE OF WORK AS INDICATED IN THE CONTRACT DOCUMENTS. THE CONTRACT DOCUMENTS SHALL INCLUDE CONTRACT DRAWINGS, CONTRACT SPECIFICATIONS, CONTRACT ADDENDUMS, ANY OTHER WRITTEN DESCRIPTION OR MEETING MINUTES PROVIDED BY THE ARHCITECT/ENGINEER OF RECORD FOR THE PROJECT TAKEN TOGETHER. IN THE CONTRACT DRAWINGS, THE CONTRACTOR SHALL INCLUDE ALL WORK INDICATED IN INCLUDING BUT NOT LIMITED TO THE LEGENDS, SYMBOLS, ABBREVIATIONS, SPECIFIC AND GENERAL NOTES, INDEXES, FLOOR PLANS, SECTIONS AND ELEVATIONS, SCHEMATIC DIAGRAMS, RISER DIAGRAMS, FLOW DIAGRAMS, CONTROL DIAGRAMS, ONE LINE DIAGRAMS, SCHEDULE SHEETS, DETAILS, DRAWINGS SPECIFICATION SHEETS, PHASING PLANS, ETC. TAKEN TOGETHER.
- 5. IT SHALL BE EXPRESSEDLY UNDERSTOOD THAT ALL ITEMS INCLUDED IN THE CONTRACT DOCUMENTS ISSUED BY THE ARCHTIECTS/ENGINEERS SHALL BE INCLUDED IN THE BID PRICE OF THE CONTRACTOR UNLESS OTHERWISE, SPECIFIC ADD ALTERNATES ARE LISTED BY THE ARCHTIECT/ENGINEER IN THE DOCUMENTS.
- IT SHALL BE THE RESPONSIBILITY OF THE CONTRACTOR TO ASCERTAIN IN WRITING THAT HE HAS ALL THE CONTRACT DOCUMENTS FOR THE PROJECT FROM THE ARCHTIECT/ENGINEER. NO CLAIMS FOR ANY MISSING DOCUMENTATION WILL BE ACCEPTABLE.
- WHERE INFORMATION IN DIFFERENT PARTS OF THE CONTRACT DOCUMENTS ARE INTERPRETED BY THE CONTRACTOR TO BE DUPLICATED, THE CONTRACTOR SHALL OBTAIN A WRITTEN APPROVAL OF HIS INTERPRETATION FROM THE OWNER BEFORE DELETING THE SCOPE OF WORK HE INTERPRETS AS BEING A DUPLICATION. IN THE ABSENCE OF SUCH WRITTEN APPROVAL, THE CONTRACTOR SHALL NOT EXCLUDE ANY ITEM SHOWN IN DIFFERENT PARTS OF THE CONTRACT.
- 8. FOR EITHER CONTRACTOR'S INTERPRETATION OF DUPLICATION OR CONTRADICTION AS INDICATED ABOVE, THE OWNER'S DETERMINATION SHALL BE FINAL AND SHALL NOT ENTITLE THE CONTRACTOR TO ANY ADDITIONAL COMPENSATION.
- 9. ALL WORK SHOWN ON THE CONTRACT DOCUMENTS ARE MEANT TO BE THE FINAL INTENT OF THE WORK. ANY WORK REQUIRED TO MEET THE FINAL INTENT OF THE DESIGN DOCUMENTS, INCLUDING BUT NOT LIMITED TO THE FOLLOWING SHALL BE PROVIDED BY THE CONTRACTOR AT NO ADDITIONAL COST TO THE OWNER:
- a. CUTTING AND PATCHING OF WALLS, FLOORS, CEILING, ROOFS, PARTITIONS;
 b. REMOVAL AND REPLACEMENT OF SUSPENDED CEILINGS, ACCESS PANELS, ACCESS DOORS;
- c. REMOVAL AND REPLACEMENT OF EXISTING ARCHITECTURAL, STRUCTURAL, PLUMBING, ELECTRICAL, FIRE PROTECTION TRADES AND, TELECOMMUNICATION, COMPUTER, SECURITY, PUBLIC ADDRESS, INTERCOM SYSTEMS WHICH INTERFERE WITH THE FINAL INTENT OF THE HVAC WORK.
- 2. DETERMINE AND COORDINATE LOCATIONS OF SYSTEMS AND COMPONENTS IN FIELD. RELOCATE EXISTING WORK THAT INTERFERES WITH WORK OF THIS CONTRACT ONLY WHEN RELOCATION OF EXISTING WORK WILL NOT IMPACT THE COST OF THE PROJECT. ANY ADDITIONAL WORK FOR RELOCATION OF EXISTING WORK OR ROUTING OF NEW WORK AROUND EXISTING WORK SHOULD BE COMPLETED BY THE CONTRACTOR AT NO COST TO THE OWNER. UNLESS AND UNTIL SPECIFIC ITEMS ARE SHOWN IN OTHER TRADE DRAWINGS FOR REMOVAL AND REPLACEMENT FOR THE AREA WHERE THE FINAL HVAC DESIGN INTENT IS SHOWN, ALL WORK REQUIRED FOR OTHER TRADES TO PERFORM THEIR WORK TO ENABLE THE HVAC WORK SHOWN ON THESE DRAWINGS SHALL BE INCLUDED IN THE CONTRACTOR'S BID.
- 13. ALL WORK SHOWN ON THE CONTRACT PLANS INCLUDING SCALED DRAWINGS ARE SCHEMATIC AND ARE INTENDED TO CONVEY GENERAL INFORMATION ON THE MAGNITUDE OF WORK AND TO PROVIDE GENERAL ARRANGEMENT OF EQUIPMENT. THE CONTRACT DRAWINGS ARE NOT MEANT TO CONVEY ALL THE FIELD CONDITIONS, ALL BENDS, OFFSETS, ELEVATIONS ACCURATELY AND SHALL NOT BE USED AS THE BASIS TO ESTIMATE THE QUANTITY OF HVAC WORK. THE CONTRACTOR MAY MAKE CHANGES IN THE FORM OF SHOP DRAWINGS IF AND WHEN APPROVED IN WRITING BY THE ARCHITECT/ENGINEER AT NO ADDITIONAL COST TO THE OWNER.
- 14. THE CONTRACTOR SHALL SEEK WRITTEN CLARIFICATIONS TO SCOPE OF WORK, VISIT AND CAREFULLY EXAMINE THE SITE OF THE PROPOSED WORK SO AS TO FAMILIARIZE HIMSELF OR HERSELF WITH EXISTING FIELD CONDITIONS, TO VERIFY DIMENSIONS AND TO VERIFY DIFFICULTIES THAT WILL BE ENCOUNTERED DURING THE EXECUTION OF THE WORK AND TO VERIFY EXACT EXTENT OF WORK REQUIRED, PRIOR TO SUBMITTING HIS PROPOSAL. ANY CHANGES RESULTING FROM CONDITIONS ARISING IN THE FIELD ARE TO BE MADE BY THIS CONTRACTOR AT NO ADDITIONAL COST TO THE OWNER.
- 15. NEITHER ACCURACY NOR COMPLETION OF SERVICES AND UTILITY LOCATIONS SHOWN ON DRAWINGS IS GUARANTEED. DETERMINE EXACT LOCATIONS OF EXISTING SERVICES AND UTILITIES IN FIELD, WHETHER OR NOT SHOWN ON

- DRAWINGS. EXERCISE CAUTION AND IDENTIFY LOCATIONS OF UNMARKED UTILITY LINES AS NECESSARY TO PERFORM WORK OF THIS SECTION.
- 16. GENERAL NOTES, SYMBOL LIST AND DETAILS ARE APPLICABLE TO ALL HVAC/MECHANICAL DRAWINGS.
- 17. DIMENSIONS SHOWN ON PLAN ARE HORIZONTAL. DIMENSIONS SHOWN IN ELEVATION ARE VERTICAL EXCEPT IN WAY OF STRUCTURAL STEEL, DIMENSIONS ARE MEASURED PERPENDICULAR TO FLANGE.
- 18. WHEREVER THE REQUIREMENTS AND REGULATIONS OF FEDERAL OR MUNICIPAL AUTHORITIES ARE MORE STRINGENT THAN THE REQUIREMENTS INDICATED ON THE DRAWINGS OR SPECIFICATIONS. THEN THESE MORE STRINGENT REQUIREMENTS SHALL TAKE PRECEDENCE OVER THE DRAWINGS OR SPECIFICATIONS AND SHALL BE MADE PART OF THE CONTRACT AT NO ADDITIONAL COST TO THE OWNER. HOWEVER, WHERE THE DRAWING OR SPECIFICATIONS ARE MORE STRINGENT THAN FEDERAL OF LOCAL AUTHORITY REQUIREMENTS AND REGULATIONS, THE MORE STRINGENT SHALL APPLY AND THE WORK SHALL BE INCLUDED IN THE CONTRACT.
- 19. THE CONTRACTOR SHALL PROVIDE PROTECTION FOR THE GENERAL PUBLIC AND CONSTRUCTION WORKERS IN AND AROUND THE CONSTRUCTION AREA. ADEQUATE BARRIERS SHALL BE PROVIDED TO EXERCISE CONTROL OF SAFE INGRESS AND EGRESS OF PREMISES. FIRE EXITS SHALL AT NO TIME BE BLOCKED.
- 20. ALL EXISTING CONSTRUCTION AND EQUIPMENT SHALL BE PROTECTED BY EACH CONTRACTOR DURING THE ENTIRE PERFORMANCE OF THEIR WORK. EXISTING AREAS DISTURBED OR DAMAGED BY CONTRACTORS SHALL BE REPAIRED OR REPLACED BY THE CONTRACTOR AT NO ADDITIONAL COST TO THE OWNER. EXISTING RTU AND EQUIPMENT ON ROOFTOP TO REMAIN SHALL BE PROTECTED FROM ANY DAMAGE DURING CONSTRUCTION.
- 21. COORDINATE ALL WORK WITH OTHER TRADES AND EXISTING CONDITIONS TO AVOID CONFLICTS.
- 22. SCHEDULE WORK OF THIS SECTION TO AVOID INTERFERING WITH EXISTING OPERATIONS IN THE FACILITY.
- 23. ALL UNUSED MATERIALS AND DEBRIS SHALL BE LEGALLY DISPOSED OF AWAY FROM THE PREMISES.
- 24. ALL COMPONENTS SHALL BE RUN AS HIGH AS POSSIBLE & AS CLOSE AS POSSIBLE TO EXISTING ROOF/ FLOOR STRUCTURE TO MAINTAIN EXISTING CEILING HEIGHTS SHOWN ON ARCHITECTURAL DRAWINGS AND TO MAINTAIN A MINIMUM OF 7'-6" HEADROOM IN ALL MECHANICAL EQUIPMENT ROOMS.
- 25. EQUIPMENT SIZE ARE BASED ON PRELIMINARY INFORMATION FROM THE SCHEDULED MANUFACTURER'S EQUIPMENT, VERIFICATION OF THIS SIZES WITH APPROVED SHOP DRAWINGS PRIOR TO INFORMING THE CONTRACTOR FOR GENERAL CONSTRUCTION OF THE FINAL PENETRATION SIZES AND BEFORE FABRICATING DUCTS
- 26. HOUSEKEEPING PAD AND SPACE ALLOCATIONS FOR MECHANICAL EQUIPMENT ARE BASED ON THE SCHEDULED MANUFACTURER'S PHYSICAL EQUIPMENT SIZES. THE CONTRACTOR SHALL BE RESPONSIBLE FOR CHECKING ANY SUBSTITUTED EQUIPMENT SIZES FROM CERTIFIED MANUFACTURER'S DRAWINGS AND SHALL MAKE MODIFICATIONS AT NO ADDITIONAL COST TO THE OWNER. THIS CONTRACTOR SHALL COORDINATE EQUIPMENT SUPPLIED BY GENERAL CONTRACTOR.
- 27. ELECTRICAL POWER PROVISIONS FOR MECHANICAL EQUIPMENT ARE BASED ON PRELIMINARY INFORMATION FROM THE SCHEDULED MANUFACTURER. THE CONTRACTOR SHALL BE RESPONSIBLE FOR CHECKING ELECTRICAL RATING FROM APPROVED SHOP DRAWINGS & SHALL MAKE ANY CIRCUIT DISTRIBUTION MODIFICATION REQUIRED WITHOUT ANY ADDITIONAL COST TO THE OWNER FOR SUBSTITUTED EQUIPMENT. THE CONTRACTOR SHALL SUBMIT A SCHEDULE OF SUCH CHANGE FOR ACCEPTANCE BY THE ENGINEER. ALL ACCEPTED CHANGES SHALL BE RECORDED ON "AS-BUILTS" DRAWINGS.
- 28. HVAC AND MECHANICAL SYSTEMS/SERVICES SHALL BE MAINTAINED FULLY OPERATIONAL IN AREAS/SPACES OUTSIDE OF AREA OF WORK DURING CONSTRUCTION. CONTRACTOR SHALL PROVIDE TEMPORARY COOLING, HEATING AND VENTILATION REQUIRED TO KEEP AREAS/SPACES IN OPERATION.
- 29. COORDINATE ACCESS DOOR LOCATIONS IN HUNG CEILINGS AND WALLS WITH THE OTHER TRADES. SEE ARCHITECTURAL DRAWINGS OR MECHANICAL SPECIFICATIONS FOR LOCATIONS REQUIRING FIRE RATED ACCESS IN SUCH PROVIDE 2 HR. RATED DOORS WITH MINIMUM 2" THICK FIRE RATED INSULATION.
- 30. COORDINATE ALL WORK WITH OTHER TRADES AND EXISTING CONDITIONS TO AVOID CONFLICTS.
- 31. ALL WORK SHALL BE IN COMPLIANCE WITH NEW YORK STATE CODE FOR NEW YORK STATE PROJECTS, OTHERWISE SHALL COMPLY WITH THE RESPECTIVE STATE CODES WHERE THE PROJECT IS LOCATED.
- 32. SCHEDULE WORK OF THIS SECTION TO AVOID INTERFERING WITH EXISTING OPERATIONS IN THE FACILITY.
- 33. PROVIDE 36" CLEARANCE IN FRONT OF ALL 208V OR LOWER ELECTRIC CONTROL AND POWER PANELS PER AND 42" CLEARANCE IN FRONT OF ALL 460V OR HIGHER ELECTRIC CONTROL AND POWER PANELS PER N.E.C. AND MANUFACTURER REQUIREMENTS.
- 34. MANUFACTURERS MODEL NUMBERS ARE SPECIFIED SOLELY TO ESTABLISH STANDARDS OF QUALITY FOR PERFORMANCE AND MATERIALS.
- 35. CONTRACTOR SHALL SUBMIT SEQUENCE OF INSTALLATION FOR EQUIPMENT THAT WAS REMOVED AND TO BE REINSTALLED.
- 36. CONTRACTOR SHALL SUBMIT FUNCTIONAL TESTING OF ROOFTOP UNITS, ACCU AND FANS AS PER SPECIFICATIONS.
- 37. CONTRACTOR SHALL ENSURE PROTECTION TO EXISTING INTERIOR DUCTWORK FROM DUST AND DEBRIS DUE TO CONSTRUCTION.

AIR SYSTEMS

- 1. DUCTS SHALL BE RUN AS HIGH AS POSSIBLE & AS CLOSE AS POSSIBLE TO EXISTING ROOF/ FLOOR STRUCTURE TO MAINTAIN EXISTING CEILING HEIGHTS SHOWN ON ARCHITECTURAL DRAWINGS.
- 2. DUCT TRANSITIONS SHALL BE FABRICATED WITH FLAT BOTTOMS UNLESS OTHERWISE NOTED.
- 3. SEAL ALL OPENINGS WHERE DUCTS PENETRATE NON RATED WALLS TO PREVENT AIR TRANSFER BETWEEN SPACES WITH CODE USE APPROVED FIRE STOPPING MATERIALS APPROVED PRODUCT. TO SEAL OPENINGS IN RATED WALLS. PROVIDE MINIMUM FLAME SPREAD RATING OF 25 AND SMOKE DEVELOPED RATING OF 50.
- 4. ALL DUCTWORK, PIPING, CONDUITS AND TUBING SHALL BE RUN CONCEALED IN FINISHED AREAS. COORDINATE LOCATIONS WITH GENERAL CONSTRUCTION AND WITH EXISTING COMPONENTS. ALL RUNS SHALL BE APPROVED BY OWNER. ANY MODIFICATION REQUIRED BY OWNER DUE TO FIELD CONFLICTS SHALL BE DONE AT NO ADDITIONAL COST.
- 5. DUCTWORK SHALL BE PROVIDED IN ACCORDANCE WITH SMACNA AND ASHRAE'S LATEST EDITION AS NECESSARY TO MEET THE PERFORMANCE REQUIREMENTS OF THE DESIGN.
- 6. ALL DUCTS SIZES INDICATED ARE INSIDE CLEAR DIMENSIONS. WHERE INTERNAL LINING OCCURS, INCREASE DUCT SIZES ACCORDINGLY BY THE LINING THICKNESS. REFER TO DETAILS FOR ACOUSTICAL LINING DETAILS.
- 7. ONE INCH THICK ACOUSTIC LINING SHALL BE PROVIDED MINIMUM 20'-0" OR LONGER IN DUCTWORK AS INDICATED ELSEWHERE IN THE CONTRACT DOCUMENTS DOWN STREAM OF EXHAUST FANS AND TWO INCHES THICK FOR SUPPLY AND RETURN DUCTWORK WHERE INDICATED ON FLOOR PLAN.
- 8. ALL OUTSIDE AIR INTAKE OPENINGS/LOUVERS SHALL BE LOCATED A MINIMUM OF 10'-0" (UNLESS OTHERWISE NOTED) FROM ANY AND ALL LOT LINES, ANY OTHER BUILDING IN THE SAME LOT, EXHAUST FANS/LOUVERS GRILLES, PARKING LOTS, LOADING DOCKS, CHIMNEYS/VENTS, PLUMBING VENTS AND ANY OTHER SIMILAR HAZARDOUS OR NOXIOUS CONTAMINANTS.
- 9. ALL DUCTWORK SHALL BE SEALED TO COMPLY WITH ASHRAE STANDARD 90.1 -2007 REQUIREMENTS FOR DUCT CLASS FOR 4 INS. SP.
- 10. PRIOR TO INSULATION OF DUCTWORK ALL DUCT SECTIONS INSTALLED IN THE PROJECT SHALL BE SUBJECTED TO LEAK TESTING IN PARTS AND IN TOTAL ACCORDANCE WITH THE SMACNA HVAC AIR DUCT LEAKAGE MANUAL. ONLY AFTER THE TEST RESULTS HAVE BEEN ACCEPTED BY THE OWNER SHALL THE CONTRACTOR PROCEED WITH INSULATION AND FINAL CONNECTIONS. CONTRACTOR SHALL PROVIDE REPORT OF TESTING TO OWNER.
- 11. ALL DUCTWORK RUN ON ROOF OR OUTDOORS SHALL BE RUN MAINTAINING A MINIMUM CLEARANCE OF 30" FROM ROOF OR GRADE UNLESS OTHERWISE SPECIALLY NOTED ON THE CONTRACT DOCUMENTS. PROVIDE ALL REQUIRED STRUCTURAL SUPPORTS FOR THIS ELEVATION OF DUCTWORK.
- 12. ALL CONDENSATE DRAIN TERMINATIONS ON ROOF OR EXTERIOR SHALL BE PROVIDED WITH A 24"X24"X6" CONCRETE SPLASH BLOCK SUCH THAT ALL DRIPS FROM DRAINS TERMINATE AT THE CENTER OF THE BLOCK.

SOUND TRAP NOTES

1. SOUND TRAP SHALL BE VIBRO ACOUSTICS MODEL RFL-MV-AC6 OR APPROVED EQUAL FOR RECTANGULAR DUCTS AND CFL-MV-AC6 FOR ROUND DUCTS OR APPROVED EQUAL, MINIMUM 5FT LONG, SIZED FOR MAXIMUM 0.03 STATIC PRESSURE DROP. MODIFY DUCTWORK TO ACCOMMODATE THE TRANSITIONS FOR TRAP

RIGGING NOTES

- 1. CONTRACTOR TO SUBMIT RIGGING PLAN TO SUCF FOR THEIR REVIEW AND APPROVAL PRIOR TO START OF WORK.
- 2. INVESTIGATE PATH THROUGH WHICH EQUIPMENT WILL BE MOVED FOR RIGGING. EQUIPMENT SHALL BE BROKEN DOWN IN SECTIONS AS NEEDED FOR MOVING THROUGH BUILDING SPACES.
- 3. ASCERTAIN FROM BUILDING MANAGEMENT AND COORDINATE THE RIGGING SCHEDULE.
- 4. MODIFY BUILDING ACCESS PATH AS REQUIRED TO RIG THE EQUIPMENT.PROVIDE ANY SUPPLEMENTARY TEMPORARY SUPPORTS REQUIRED TO RIG THE EQUIPMENT.
- 5. OBTAIN PERMISSION FORM OWNER IN WRITING AS TO THE RIGGING PROCESS AND THE ENTAILING MODIFICATIONS REQUIRED TO THE BUILDING COMPONENTS.
- 6. ALL RIGGINIG SCOPE SHALL BE ASCERTAINED PRIOR TO BIDDING. NO ADDITIONAL COMPENSATION SHALL BE PROVIDED TO THE CONTRACTOR FOR RIGGING.
- 7. CONTRACTOR SHALL LIMIT ANY TRANSPORTATION OF MATERIALS AND EQUIPMENT THROUGH THE INTERIOR OF THE BUILDING. ANY TRANSPORTATION OF MATERIALS AND EQUIPMENT THROUGH THE INTERIOR OF THE BUILDING SHALL BE COORDINATE WITH SUCF PRIOR TO ANY WORK.

CONSTRUCTION INDOOR ENVIRONMENT QUALITY (IEQ) NOTES

- 1. WHERE PROJECT SPACE IS PART OF THE BUILDING WHERE REST OF THE BUILDING IS OCCUPIED, THE CONTRACTOR SHALL PROVIDE A HIGH EFFICIENCY PARTICULATE AIR (HEPA) FILTERED NEGATIVE PRESSURE FAN SYSTEM TO MAINTAIN MINIMUM 0.01" WATER GAGE NEGATIVE PRESSURE IN THE CONSTRUCTION AREA IN RELATION TO THE NON-CONSTRUCTION AREAS. THE EQUIPMENT AND DUCTWORK SHALL BE SIZED FOR SUCH PRESSURE RELATIONSHIP AND SHALL OPERATE FOR THE ENTIRE DURATION OF CONSTRUCTION UNLESS THE OWNER PROVIDES SPECIFIC EXEMPTION WRITING.
- 2. ALL SUCH EXHAUSTS SHALL TERMINATE OUTSIDE THE BUILDING. WHERE THE BUILDING EXTERIOR IS NOT ACCESSIBLE TO THE PROJECT SPACE, THE CONTRACTOR SHALL OBTAIN PERMISSION IN WRITING FROM THE OWNER ON THE ALTERNATE TERMINATION LOCATION.
- 3. ALL CONSTRUCTION SPACES SHALL BE PROVIDED WITH ACOUSTIC TREATED PARTITIONS TO ISOLATE ANY CONSTRUCTION NOISE FROM REST OF THE BUILDING. CONTRACTOR SHALL ALSO COORDINATE DAY TO DAY CONSTRUCTION TIME WITH THE OWNER IN WRITING BEFORE BID TO ENSURE NO DISTURBANCE TO REST OF THE NON-CONSTRUCTION AREA OCCUPANTS OF THE BUILDING.
- 4. CONTRACTOR SHALL INSTALL A CONTINUOUS RUNNING AND TRACKING NOISE METER ON THE CONSTRUCTION PARTITION AT A LOCATION ACCEPTABLE TO OWNER TO ENSURE THAT EXCESSIVE NOISE IS NOT TRANSMITTED OUTSIDE THE CONSTRUCTION AREA. THE NOISE DATA SHALL BE STORED FOR A DURATION OF 30 DAYS AND HANDED OVER TO OWNER IN .AVI OR .MP3 FORMAT FOR RECORD KEEPING BEFORE THE NEXT CYCLE IS RECORDED.
- 5. CONTRACTOR SHALL NOT BE PROVIDED WITH ADDITIONAL COMPENSATION FOR TIME SCHEDULE RELATED COSTS DUE TO IEQ ISSUES.

SUSPENSION AND VIBRATION ISOLATION NOTES

- 1. ALL COMPONENTS INSTALLED IN THIS PROJECT SHALL BE PROVIDED WITH HANGERS AND SUPPORTS TO THE BUILDING STRUCTURE EITHER IN COMPLIANCE WITH THE TECHNICAL SPECIFICATIONS /DETAILS INCLUDED ELSEWHERE IN THE CONTRACT DOCUMENTS OR AS PER MANUFACTURER RECOMMENDATIONS OR AS PER CODES AND STANDARDS REQUIREMENTS, SUCH AS THOSE OF THE AUTHORITY HAVING JURISDICTION AND/OR NATIONAL PROFESSIONAL ENTITIES INCLUDING BUT NOT LIMITED TO SMACNA, OSHA, ASHRAE, NFPA, ETC., WHICHEVER IS MORE STRINGENT.
- 2. PROVIDE VIBRATION ISOLATORS SUCH AS FLEXIBLE CONNECTIONS, FLEXIBLE CONNECTORS, ETC. TO ISOLATE ALL MOVING COMPONENTS FROM REST OF THE SYSTEM COMPONENTS AS WELL AS THE BUILDING STRUCTURE.

EQUIPMENT AND COMPONENTS PROTECTION NOTES

- 1. ALL EQUIPMENT OR TRADE COMPONENTS THAT ARE REQUIRED TO BE REMOVED AND REINSTALLED WILL BE TESTED FIRST FOR THEIR OPERATIONAL CONDITION IN THE PRESENCE OF THE OWNER AND A REPORT SUBMITTED TO OWNER FOR RECORDS.
- THE CONTRACTOR WILL THEN REMOVE THE EXISTING EQUIPMENT OR TRADE COMPONENTS CAREFULLY AND SAFELY FOR THEIR REMOTE STORAGE.
- 3. THE CONTRACTOR WILL THEN STORE THE EXISTING EQUIPMENT OR TRADE COMPONENTS AT A WEATHERPROOF AND SECURE LOCATION TILL SUCH TIME AS TO BE REINSTALLED
- 4. THE CONTRACTOR WILL DO REINSTALLATION WORK CAREFULLY AND SAFELY WITHOUT ANY DAMAGE TO THE EQUIPMENT OR TRADE COMPONENT.
- 5. THE CONTRACTOR WILL THEN TEST THE OPERATIONAL CONDITION OF THE EQUIPMENT OR TRADE COMPONENT TO ITS ORIGINAL WORKING CONDITION AND DEMONSTRATE TO THE OWNER THE SAME.
- 6. CONTRACTOR WILL SUBMIT THE TESTING AND OPERATIONAL CONDITION RECORD TO THE OWNER FOR THEIR RECORDS.
 7. WHERE WORK INVOLVES EXISTING DUCTWORK CONTRACTOR SHALL INSPECT EXISTING DUCTWORK THAT AR
- 7. WHERE WORK INVOLVES EXISTING DUCTWORK, CONTRACTOR SHALL INSPECT EXISTING DUCTWORK THAT ARE REMAINING AT DISCONNECTION POINT. REMOVE ANY EXISTING DEBRIS THAT CAN BE VISIBLE FROM DISCONNECTION POINT PRIOR TO TEMPORARILY CAPPING DUCTWORK.
- 8. CONTRACTOR SHALL REPAIR, FIX AND/OR REPLACE ANY ANY EQUIPMENT OR COMPONENTS WHICH BECOME DAMAGED DURING CONSTRUCTION TO THEIR ORIGINAL CONDITION AT NO COST TO THE OWNER.



PROGRAM UNIT:

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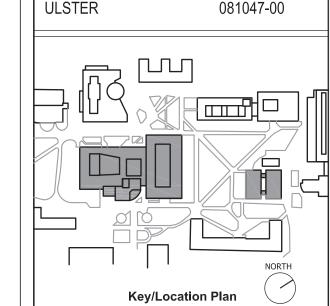
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Building:
SMILEY ARTS BUILDING,
COLLEGE THEATRE
DORSKY MUSEUM AND

FACULTY OFFICE BUILDING

County of:

Project No.: 081047-00



Contract Title:
ROOF REPLACEMENT - SMILEY ARTS,
COLLEGE THEATRE, DORSKY
MUSEUM AND FACULTY OFFICE

Project No.: 081047-00

Drawing Title: HVAC NOTES

BUILDING

Seal & Signature:



Drawn By:
Checked By:
Date: JANUARY 8, 2021
Scale: AS NOTED

Drawing No.: M002.00

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GENERAL NOTES (APPLICABLE TO ALL DRAWINGS)

PHASING

- 1. VERIFY AND CONFIRM WITH OWNER THE PHASING REQUIREMENTS OF THE PROJECT BEFORE BIDDING REGARDLESS OF WHETHER THE INFORMATION IS PRESENTED (OR OTHERWISE) IN THE CONTRACT DOCUMENTS.
- 2. ANY PHASING INFORMATION WHERE PROVIDED IN THE CONTRACT DOCUMENTS ARE TO PROVIDE THE INTENT OF PHASING WORK ONLY AND MAY NOT INCLUDE ALL INFORMATION REQUIRED TO MEET THE INTENT OF THE OWNERS REQUIREMENTS. IT IS THE CONTRACTORS RESPONSIBILITY TO VERIFY THE PHASING REQUIREMENTS, METHODOLOGY, SCHEDULE, COORDINATION WITH THE OWNER.
- 3. IN ALL ASPECTS OF PHASING WORK, ALL ITEMS SHALL BE IN FULL COMPLIANCE WITH THE CURRENT CODE AND STANDARDS.
- 4. ALL PHASES OF THE PROJECTS SHALL ENSURE STANDALONE FULLY FUNCTIONAL CODE COMPLIANT SYSTEM REQUIRED FOR AN OCCUPIED SPACE USE.
- 5. ALL PHASING COSTS SHALL BE INCLUDED IN THE PROJECT BID.

DEMOLITION NOTES

- ALL PIPING AND DUCTS IN WALLS AND FLOORS NOT TO BE REUSED SHALL BE PLUGGED OR CAPPED AND CUTTING AND PATCHING SHALL BE PERFORMED TO RESTORE SURFACE TO ORIGINAL CONDITION BY CONTRACTOR.
- ALL PIPING AND DUCTS IN WALLS AND FLOORS DISCONNECTED IN PORTIONS FOR FUTURE USE SHALL BE PROVIDED WITH TEMPORARY WEATHER TIGHT CAPS TILL SUCH TIME AS THEY ARE RECONNECTED AND REUSED.
- ALL WALL, ROOF, FLOOR OPENINGS CREATED DUE TO DEMOLITION WORK BY THIS TRADE SHALL BE PROVIDED WITH EITHER TEMPORARY WEATHER-TIGHT CAPS, WHERE SUCH OPENINGS ARE REUSED, OR PERMANENT WEATHER-TIGHT CAPS WHERE THE OPENS ARE NOT REUSED. NO OPENINGS CREATED BY THIS DEMOLITION SHALL REMAIN UNCAPPED AT ANY TIME.
- THE CONTRACTOR SHALL INCLUDE IN HIS PRICE ALL COSTS ASSOCIATED WITH REMOVALS AND RELOCATIONS OF HVAC WORK AS DESCRIBED ON THE DRAWINGS AND IN THE SPECIFICATIONS WITH ALLOWANCES FOR EXPECTED OR UNFORESEEN DIFFICULTIES WHEN

- CONCEALED WORK HAS BEEN OPENED. NO CLAIMS FOR ADDITIONAL WORK ASSOCIATED WITH DEMOLITION WILL BE ACCEPTED, EXCEPT IN CERTAIN CASES CONSIDERED JUSTIFIABLE BY THE OWNER/ENGINEER.
- THE CONTRACTOR SHALL PERFORM DEMOLITION AND REMOVAL WORK WITH MINIMUM INTERFERENCE WITH FUNCTIONING HVAC SYSTEMS.
- ALL AFFECTED SYSTEMS SHALL BE RECONNECTED AND RESTORED. DEMOLITION AND REMOVAL WORK SHALL BE PERFORMED IN A NEAT AND WORKMANLIKE MANNER. THE CONTRACTOR SHALL PATCH, REPAIR OR OTHERWISE RESTORE ANY DAMAGED INTERIOR OR EXTERIOR BUILDING SURFACE TO ITS ORIGINAL CONDITION.
- THE CONTRACTOR SHALL REMOVE ALL DUCT & PIPING SUPPORTS, ETC. FROM PARTITIONS THAT ARE TO BE REMOVED. WHERE THE REMOVAL OF THESE ITEMS DISRUPTS EXISTING PIPING AND/OR DUCTWORK THAT IS TO REMAIN, THE CONTRACTOR SHALL INSTALL AND PROVIDE BYPASS CONNECTIONS NECESSARY.
- PORTIONS OF PIPING AND/OR DUCTWORK TO BE REMOVED OR ABANDONED AS A RESULT OF DEMOLITION WORK, BUT WHICH ARE REQUIRED TO REMAIN ACTIVE, SHALL BE CUT AT CONVENIENT LOCATIONS, REROUTED AND RECONNECTED.

- THE CONTRACTOR SHALL NOTIFY THE OWNER AT THE APPROPRIATE TIME OF THE PROJECTED DEMOLITION AND PHASING SCHEDULE SO THAT REMOVAL OR RELOCATION OF AFFECTED UTILITIES MAY BE CARRIED OUT IN COORDINATION WITH THE PROJECT REQUIREMENTS.
- ALL EXISTING MATERIAL AND EQUIPMENT IN USABLE CONDITION. WHICH IS TO BE REMOVED UNDER THIS CONTRACT, SHALL REMAIN THE PROPERTY OF THE OWNER OR SHALL BE DISPOSED OF BY THE CONTRACTOR, AS DIRECTED BY THE OWNER AT NO ADDITIONAL COST TO OWNER.
- ARRANGE TO WORK CONTINUOUSLY, INCLUDING OVER TIME, IF REQUIRED, TO ASSURE THAT SYSTEMS WILL BE SHUT DOWN ONLY DURING THE TIME ACTUALLY REQUIRED TO MAKE THE NECESSARY CONNECTIONS TO THE EXISTING SYSTEMS.
- THE SHUTDOWN OF EXISTING BUILDING HVAC SERVICES SHALL BE COORDINATED WITH WITH THE OWNER.
- MAKE ARRANGEMENTS AT LEAST 5 BUSINESS DAYS PRIOR TO A SHUTDOWN. CONTRACTOR SHALL COMPLY WITH ALL FEDERAL STATE & LOCAL REQUIREMENTS REGARDING DISPOSAL OF REFRIGERANTS.

UTILITY TEMPORARY INTERRUPTION NOTES

- 1. ANY UTILITY INTERRUPTION OF HVAC SYSTEM, ELECTRICAL SYSTEM, FIRE ALARM SYSTEM ETC. DUE TO ANY WORK SHALL BE KEPT TO A MINIMUM.
- 2. CONTRACTOR SHALL NOTIFY SUCF AND REQUEST APPROVAL PRIOR TO ANY UTILITY INTERRUPTION.

	ROOFTOP UNIT SCHEDULE BASIS OF SELECTION: JOHNSON CONTROL															NTROL															
		GENERAL DA	TA			FAN DATA DX COOLING COIL DATA COMPRESSOR ELEC										ELECT	RICAL DA	λTA	PRE FI	LTER	FINAL	. FILTER									
LINIT				TOT		ESP.		MOTOR [DATA	E.A.T	.(°F)	L.A.T	Γ.(°F)	тот.	SENS.	NO	NO.1	NO.2	VOLT	PH H7	MCA	MOP					EER	IEER	WEIGHT	DIMENSIONS	REMARKS
UNIT NO.	SERVICE	LOCATION	MODEL NO.	TOT. CFM	CFM	IN. W.C.	B.H.P	RPM	DRIVE	DB	WB	DB	WB	TOT. CAP. (MBH)	SENS. CAP. (MBH)	NO.	RLA (A)	(A)	VOLI	111 112	(A)	(A)	QTY.	MERV	QTY.	MERV	LLIX	ILLIV	(LBS)	(INCHES)	NEWANO
RTU-1	DORSKY MUSEUM	ROOF	50HC-D17A2M5-6W0G0	4800	1360	1.4	4	750	BELT	79.2	65.5	55.1	53.0	179,680	125,110	2	25	25	208	3 60	71.6	90	3	8	3	13	12.2	13.7	2124	127.9Lx86.4Wx49.4H	SEE NOTE 1 TO 9
RTU-2	DORSKY MUSEUM	ROOF	50HC-D08A2M5-6W0A0	2450	850	1.4	3	750	BELT	79.2	65.5	54.9	53.6	87,720	64,290	2	13.6	13.6	208	3 60	41	50	2	8	2	13	12.2	12.9	983	88.1Lx59.5Wx49.4H	SEE NOTE 1 TO 8

- COOLING COIL TO BE SELECTED BASED ON CAPACITIES SHOWN.
- PROVIDE ECONOMIZER.
- HIGH STATIC BELT DRIVE BLOWER.
- 4. PROVIDE DISCONNECT SWITCH, POWERED CONVENIENCE OUTLET, VIBRATION ISOLATORS.
- CONNECT UNITS TO EXISTING BMS.
- PROVIDE 18" ROOF CURB.
- 7. THE CONTRACTOR SHALL PROVIDE EQUIPMENT THAT SHALL MATCH MATCH THE FOOTPRINT OF THE EXISTING RTU BEING REPLACED WITH MINIMAL
- MODIFICATIONS TO THE FOOTPRINT.
- PROVIDE VARIABLE FREQUENCY DRIVE.
- PROVIDE ROOF CURB ADAPTER FOR RTU-1

	FAN SCHEDULE (LOREN COOK AS STANDARD)														
		PERFORMANCE DATA			SELECTION DA		МС	TOR DATA							
TAG NO.	NO. LOCATION SYSTEM SERVED CFN		CFM	TOTAL SP INCH W.C.	TYPE	MODEL	DRIVE	VOLT	PH	BHP	HP	RPM	WEIGHT	REMARKS	
EX-1	ROOF	ART PAINTING ROOM	3000	0.4	CENTRIFUGAL ROOF	195ACEB	BELT	208	3	0.434	0.5	1725	128	SEE NOTES	

- 1. PROVIDE CURB EXTENDER.
- 2. PROVIDE VARIABLE SPEED CONTROL AND VFD. VFD MOUNTED IN THE SOUTH EAST FAN ROOM ON THE SAME FLOOR.
- 3. PROVIDE FACTORY MOUNTED DISCONNECT SWITCH AT FAN.
- 4. PROVIDE SPARK PROOF MOTOR FAN.
- 5. PROVIDE INTERMATIC 1125C OR APPROVED EQUAL PROGRAMMABLE TIME CLOCK WITH MANUAL OVERRIDE IN THE THIRD
- FLOOR 50 FT FROM THE FAN LOCATION AT A LOCATION AS DIRECTED BY OWNER.



PROGRAM UNIT:

MDSZERBATY ASSOCIATES ARCHITECTURE 307 7th AVENUE 15th FLOOR NEW YORK, NY 10001



IAQ SYSTEMS INC, CONSULTING ENGINEERS 555 8th AVENUE, SUITE 1502 NEW YORK, NY 10018


Facility: SUNY NEW PALTZ

Building Address: 1 HAWK DRIVE, NEW PALTZ, NY 12561

SMILEY ARTS BUILDING, COLLEGE THEATRE DORSKY MUSEUM AND FACULTY OFFICE BUILDING

County of: ULSTER

Project No.: 081047-00

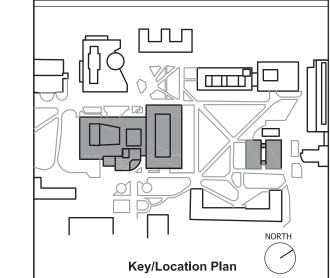

Contract Title: ROOF REPLACEMENT - SMILEY ARTS. COLLEGE THEATRE, DORSKY MUSEUM AND FACULTY OFFICE

BUILDING Project No.: 081047-00


Drawing Title: NOTE & SCHEDULES

Seal & Signature:



Drawn By: Checked By: AS NOTED Scale:

Drawing No.

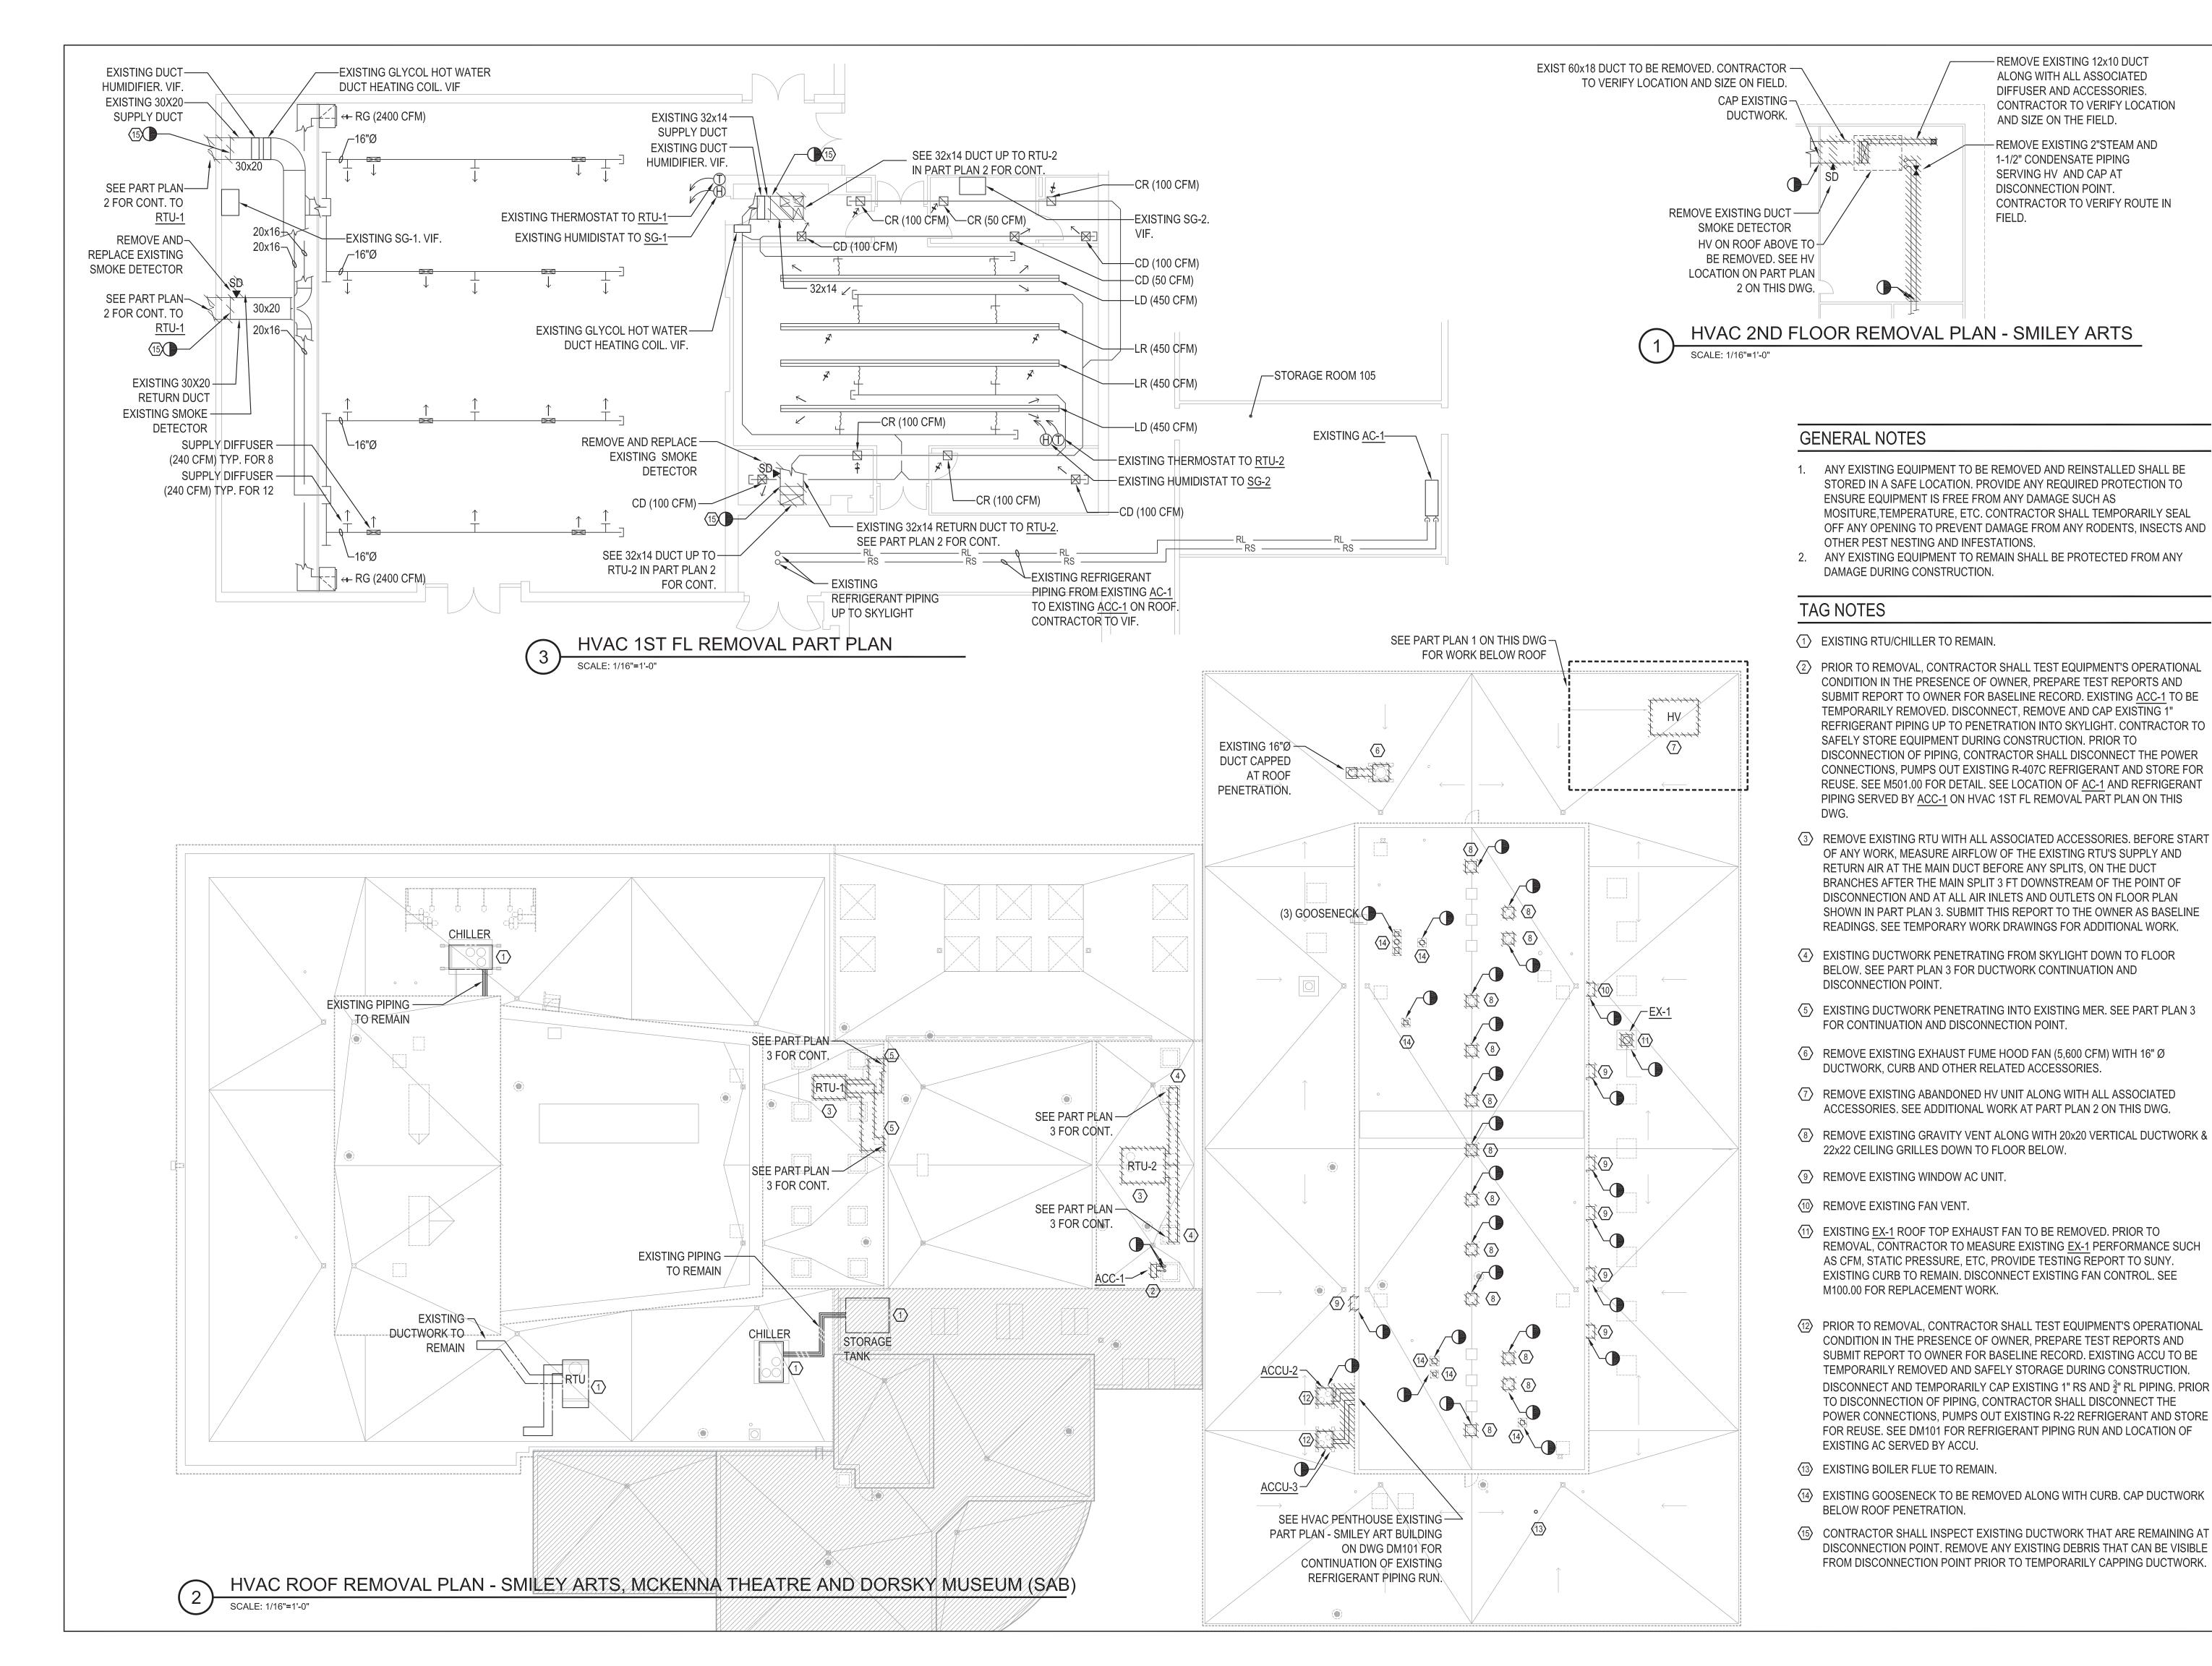



PROGRAM UNIT:

- REMOVE EXISTING 12x10 DUCT

ALONG WITH ALL ASSOCIATED

CONTRACTOR TO VERIFY LOCATION

- REMOVE EXISTING 2"STEAM AND

CONTRACTOR TO VERIFY ROUTE IN

DIFFUSER AND ACCESSORIES.

AND SIZE ON THE FIELD.

1-1/2" CONDENSATE PIPING

SERVING HV AND CAP AT

DISCONNECTION POINT.

307 Seventh Avenue New York NY 10001 P 212 352 3307 F 212 352 9266 indshyc.com

MDSZERBATY ASSOCIATES ARCHITECTURE 307 7th AVENUE 15th FLOOR NEW YORK, NY 10001 TEL: 212.352.3307



IAQ SYSTEMS INC, CONSULTING ENGINEERS 555 8th AVENUE, SUITE 1502

NEW YORK, NY 10018


Facility:

SUNY NEW PALTZ Building Address: 1 HAWK DRIVE, NEW PALTZ, NY 12561 SMILEY ARTS BUILDING,

COLLEGE THEATRE DORSKY MUSEUM AND FACULTY OFFICE BUILDING

County of: ULSTER

Project No.: 081047-00

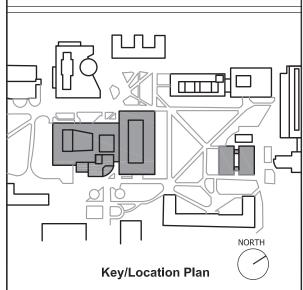

ROOF REPLACEMENT - SMILEY ARTS, COLLEGE THEATRE, DORSKY MUSEUM AND FACULTY OFFICE BUILDING

Project No.: 081047-00

Drawing Title:

VAC ROOF REMOVAL PLAN & 1ST FL PART PART PLAN -SMILEY ARTS, MCKENNA THEATRE AND DORSKY MUSEUM

Seal & Signature:




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Drawing No.

22 of 47

DM100.00

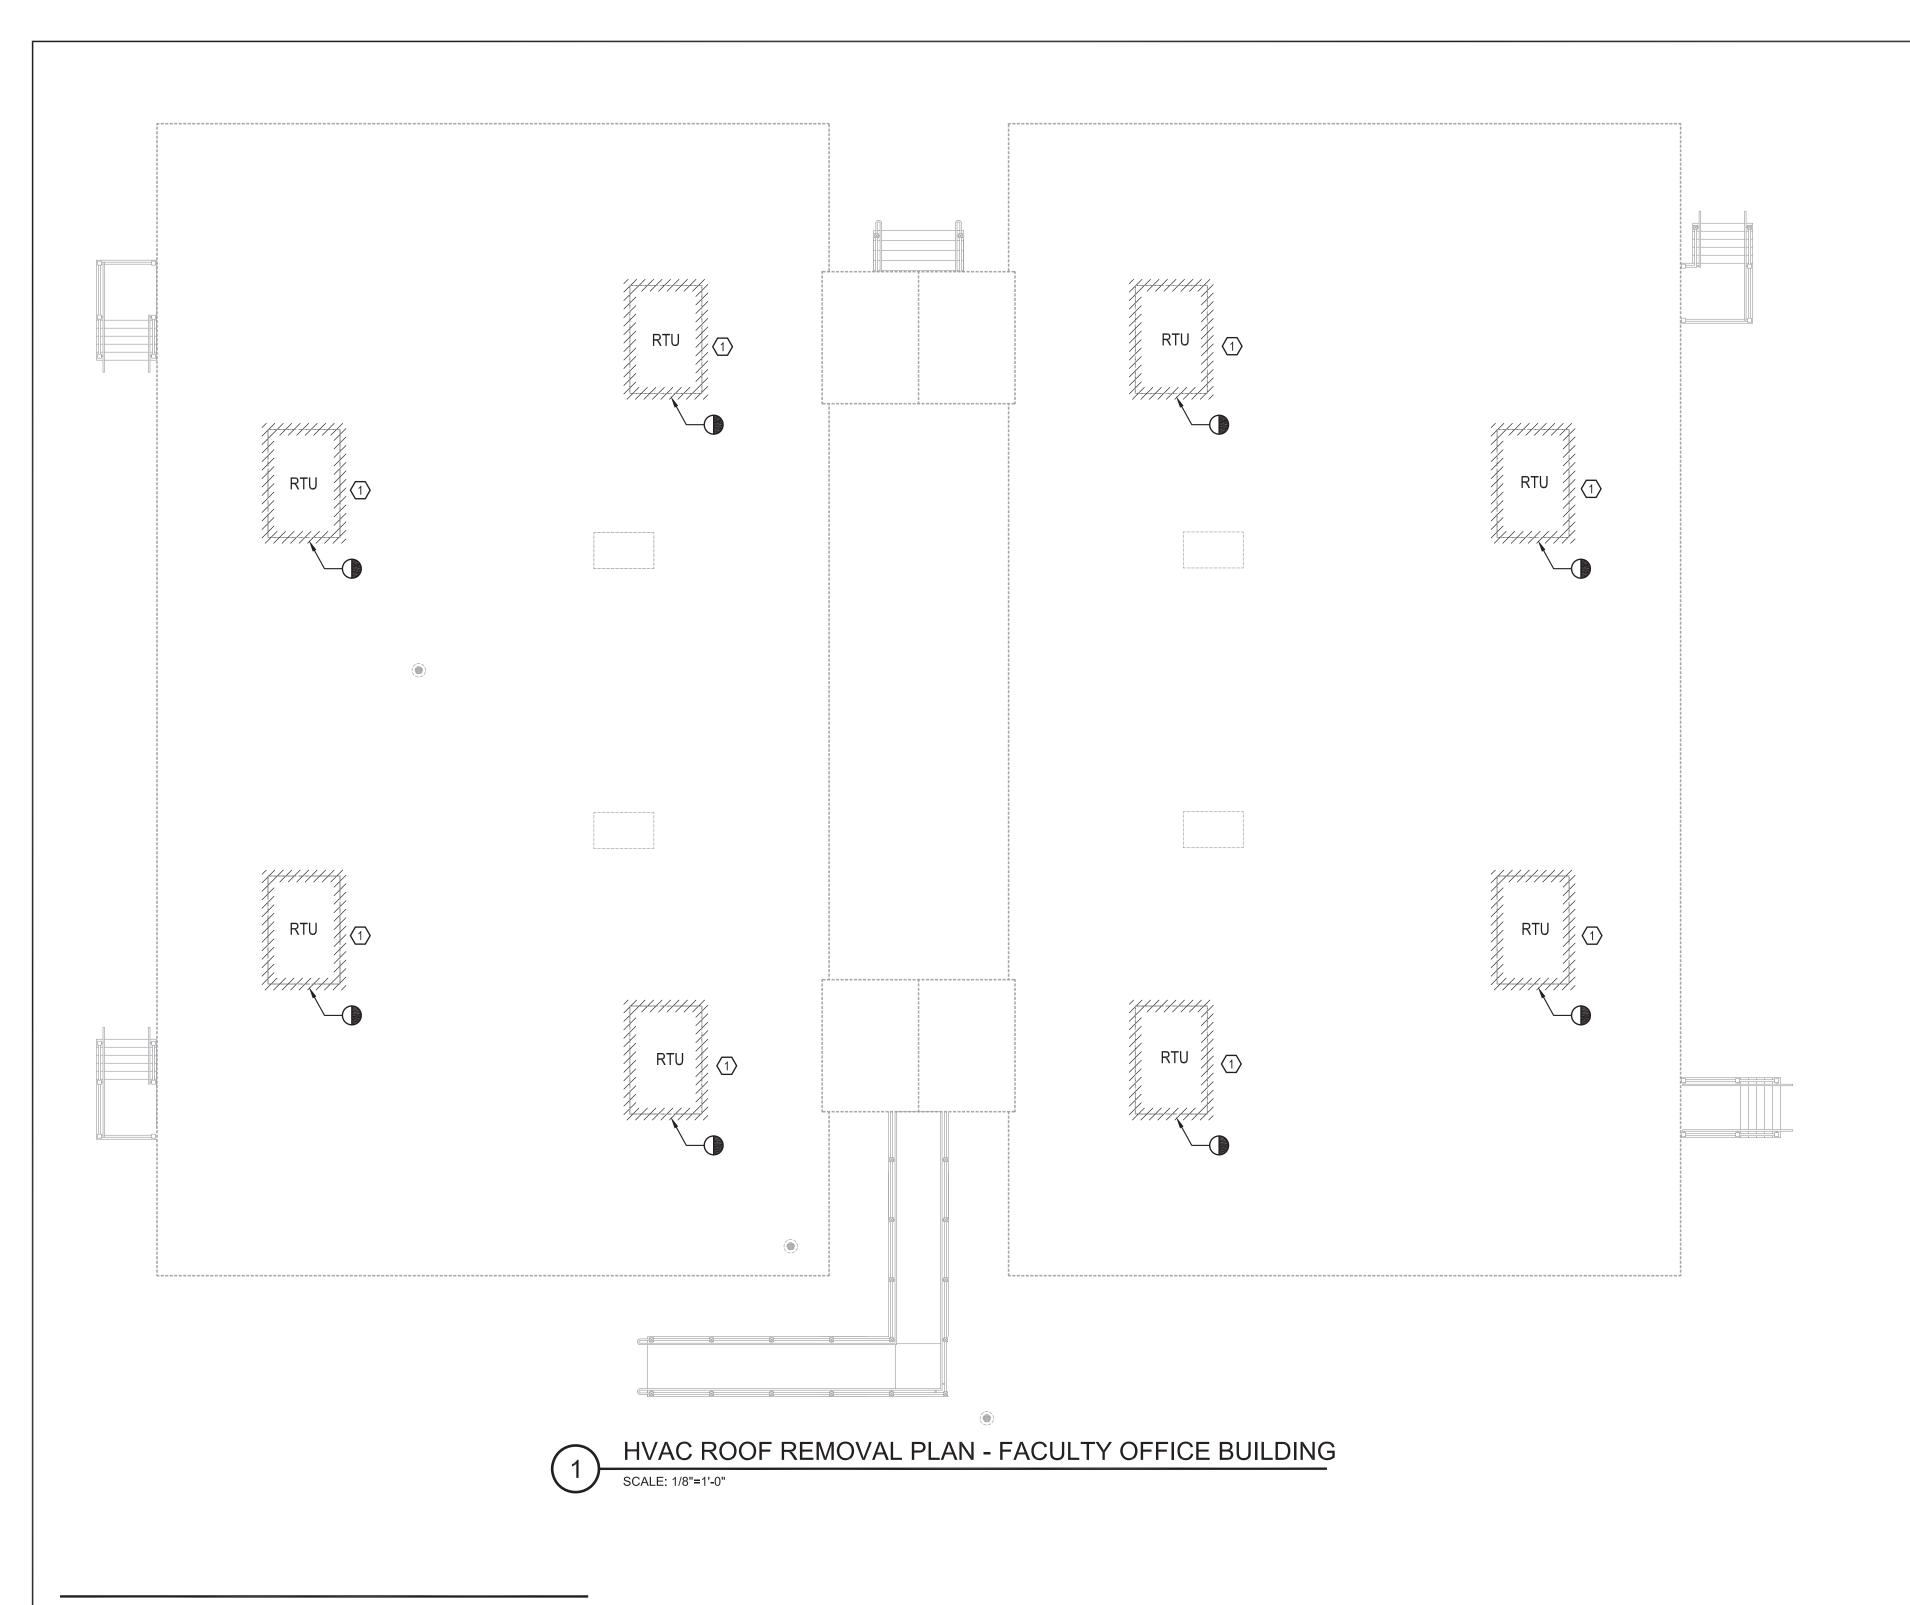


GENERAL NOTES

ANY EXISTING EQUIPMENT TO BE REMOVE AND REINSTALLED SHALL BE STORED IN A SAFE LOCATION. PROVIDE ANY REQUIRED PROTECTION TO ENSURE EQUIPMENT IS FREE FROM ANY DAMAGE SUCH AS MOSITURE, TEMPERATURE, ETC. CONTRACTOR SHALL TEMPORARILY SEAL OFF ANY OPENING TO PREVENT DAMAGE FROM ANY RODENTS, INSECTS AND OTHER PEST NESTING AND INFESTATIONS.


TAG NOTES

PRIOR TO REMOVAL, CONTRACTOR SHALL TEST EQUIPMENT'S OPERATIONAL CONDITION IN THE PRESENCE OF OWNER, MEASURE SUPPLY AND RETURN MAIN DUCT AIRFLOWS, SUPPLY DUCT STATIC PRESSURE, RETURN DUCT STATIC PRESSURE, MOTOR AMP READINGS. PREPARE TEST REPORTS AND SUBMIT REPORT TO OWNER FOR BASELINE RECORD. DISCONNECT POWER, CONTROL, GAS CONNECTIONS, REMOVE EXISTING RTU CAREFULLY. SAFELY STORE RTU DURING CONSTRUCTION. TEMPORARILY CAP EXISTING ROOF OPENING, EXISTING DUCTWORK DURING CONSTRUCTION. CONTRACTOR SHALL INSPECT EXISTING DUCTWORK THAT ARE REMAINING AT DISCONNECTION POINT. REMOVE ANY EXISTING DEBRIS THAT IS VISIBLE FROM DISCONNECTION POINT PRIOR TO TEMPORARILY CAPPING DUCTWORK. REMOVE EXISTING CURB SERVING RTU.

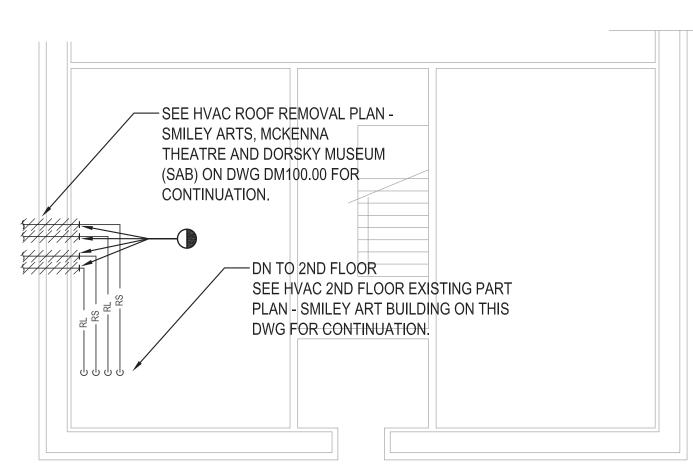

HVAC PENTHOUSE REMOVAL PART PLAN - SMILEY ART BUILDING

SCALE: 1/8"=1'-0"

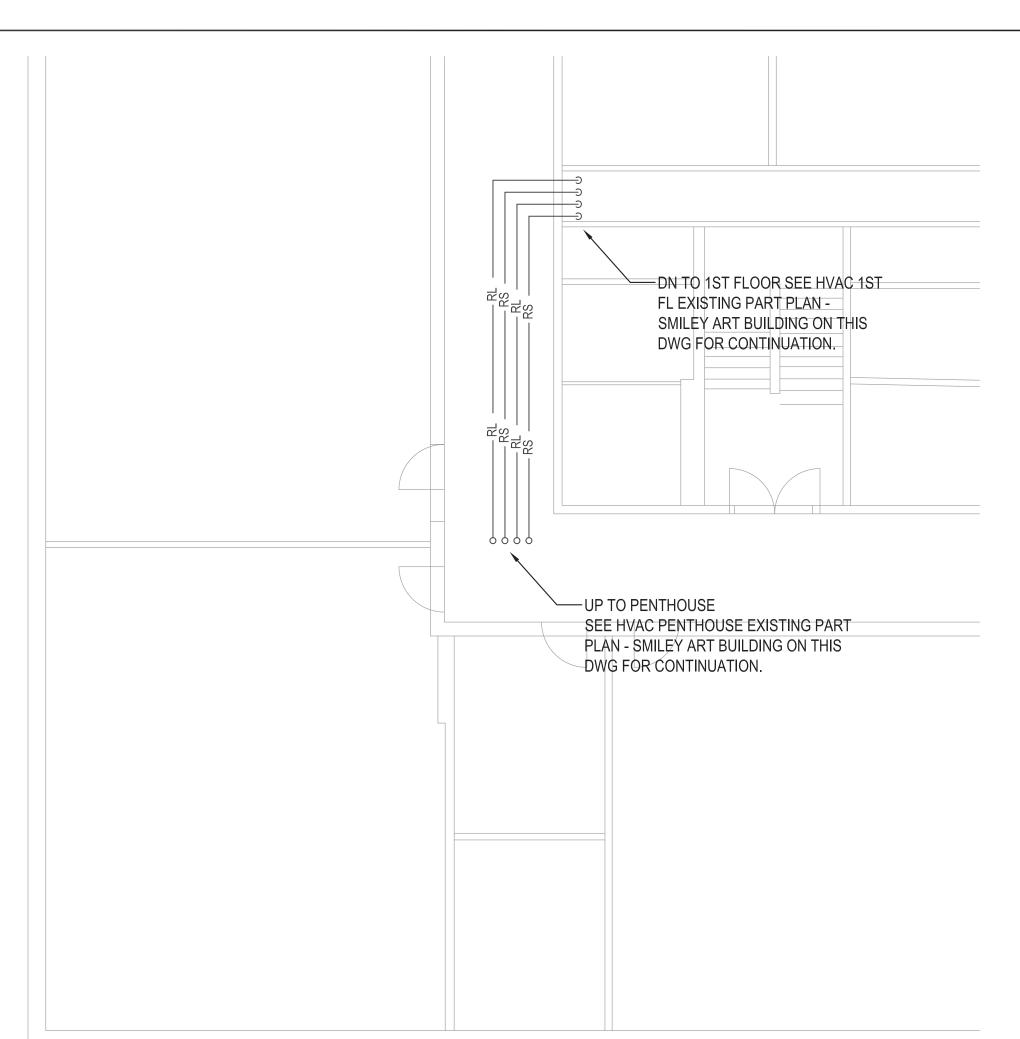

HVAC 2ND FLOOR EXISTING PART PLAN - SMILEY ART BUILDING

EXISTING <u>AC-3</u>— SERVED BY ACCU-3 -UP TO 2ND FLOOR SEE HVAC 2ND FL EXISTING PART PLAN - SMILEY ART BUILDING ON THIS DWG FOR CONTINUATION. EXISTING AC-2-SERVED BY

PROGRAM UNIT:

307 Seventh Avenue New York NY 10001 P 212 352 3307 F 212 352 9266 mdsnyc.com

MDSZERBATY ASSOCIATES ARCHITECTURE 307 7th AVENUE 15th FLOOR NEW YORK, NY 10001 TEL: 212.352.3307



Consulting Engineers IAQ SYSTEMS INC, CONSULTING ENGINEERS
555 8th AVENUE, SUITE 1502
NEW YORK, NY 10018


Facility:

SUNY NEW PALTZ **Building Address:** 1 HAWK DRIVE, NEW PALTZ, NY 12561 **Building:**

SMILEY ARTS BUILDING, COLLEGE THEATRE DORSKY MUSEUM AND FACULTY OFFICE BUILDING

County of: ULSTER

Project No.: 081047-00

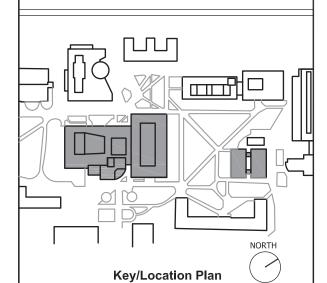

Contract Title: ROOF REPLACEMENT - SMILEY ARTS, COLLEGE THEATRE, DORSKY MUSEUM AND FACULTY OFFICE

Project No.: 081047-00

Drawing Title:

BUILDING

HVAC ROOF REMOVAL PAN - FACULTY OFFICE BUILDING HVAC EXISTING PENTHOUSE, 2ND FL & 1ST FLOOR PART PLAN - SMILEY ART BUILDING

Seal & Signature:




Drawn By: Checked By: JANUARY 8, 2021 AS NOTED Scale:

Drawing No. DM101.00

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SCALE: 1/8"=1'-0"

HVAC 1ST FLOOR EXISTING PART PLAN - SMILEY ART BUILDING



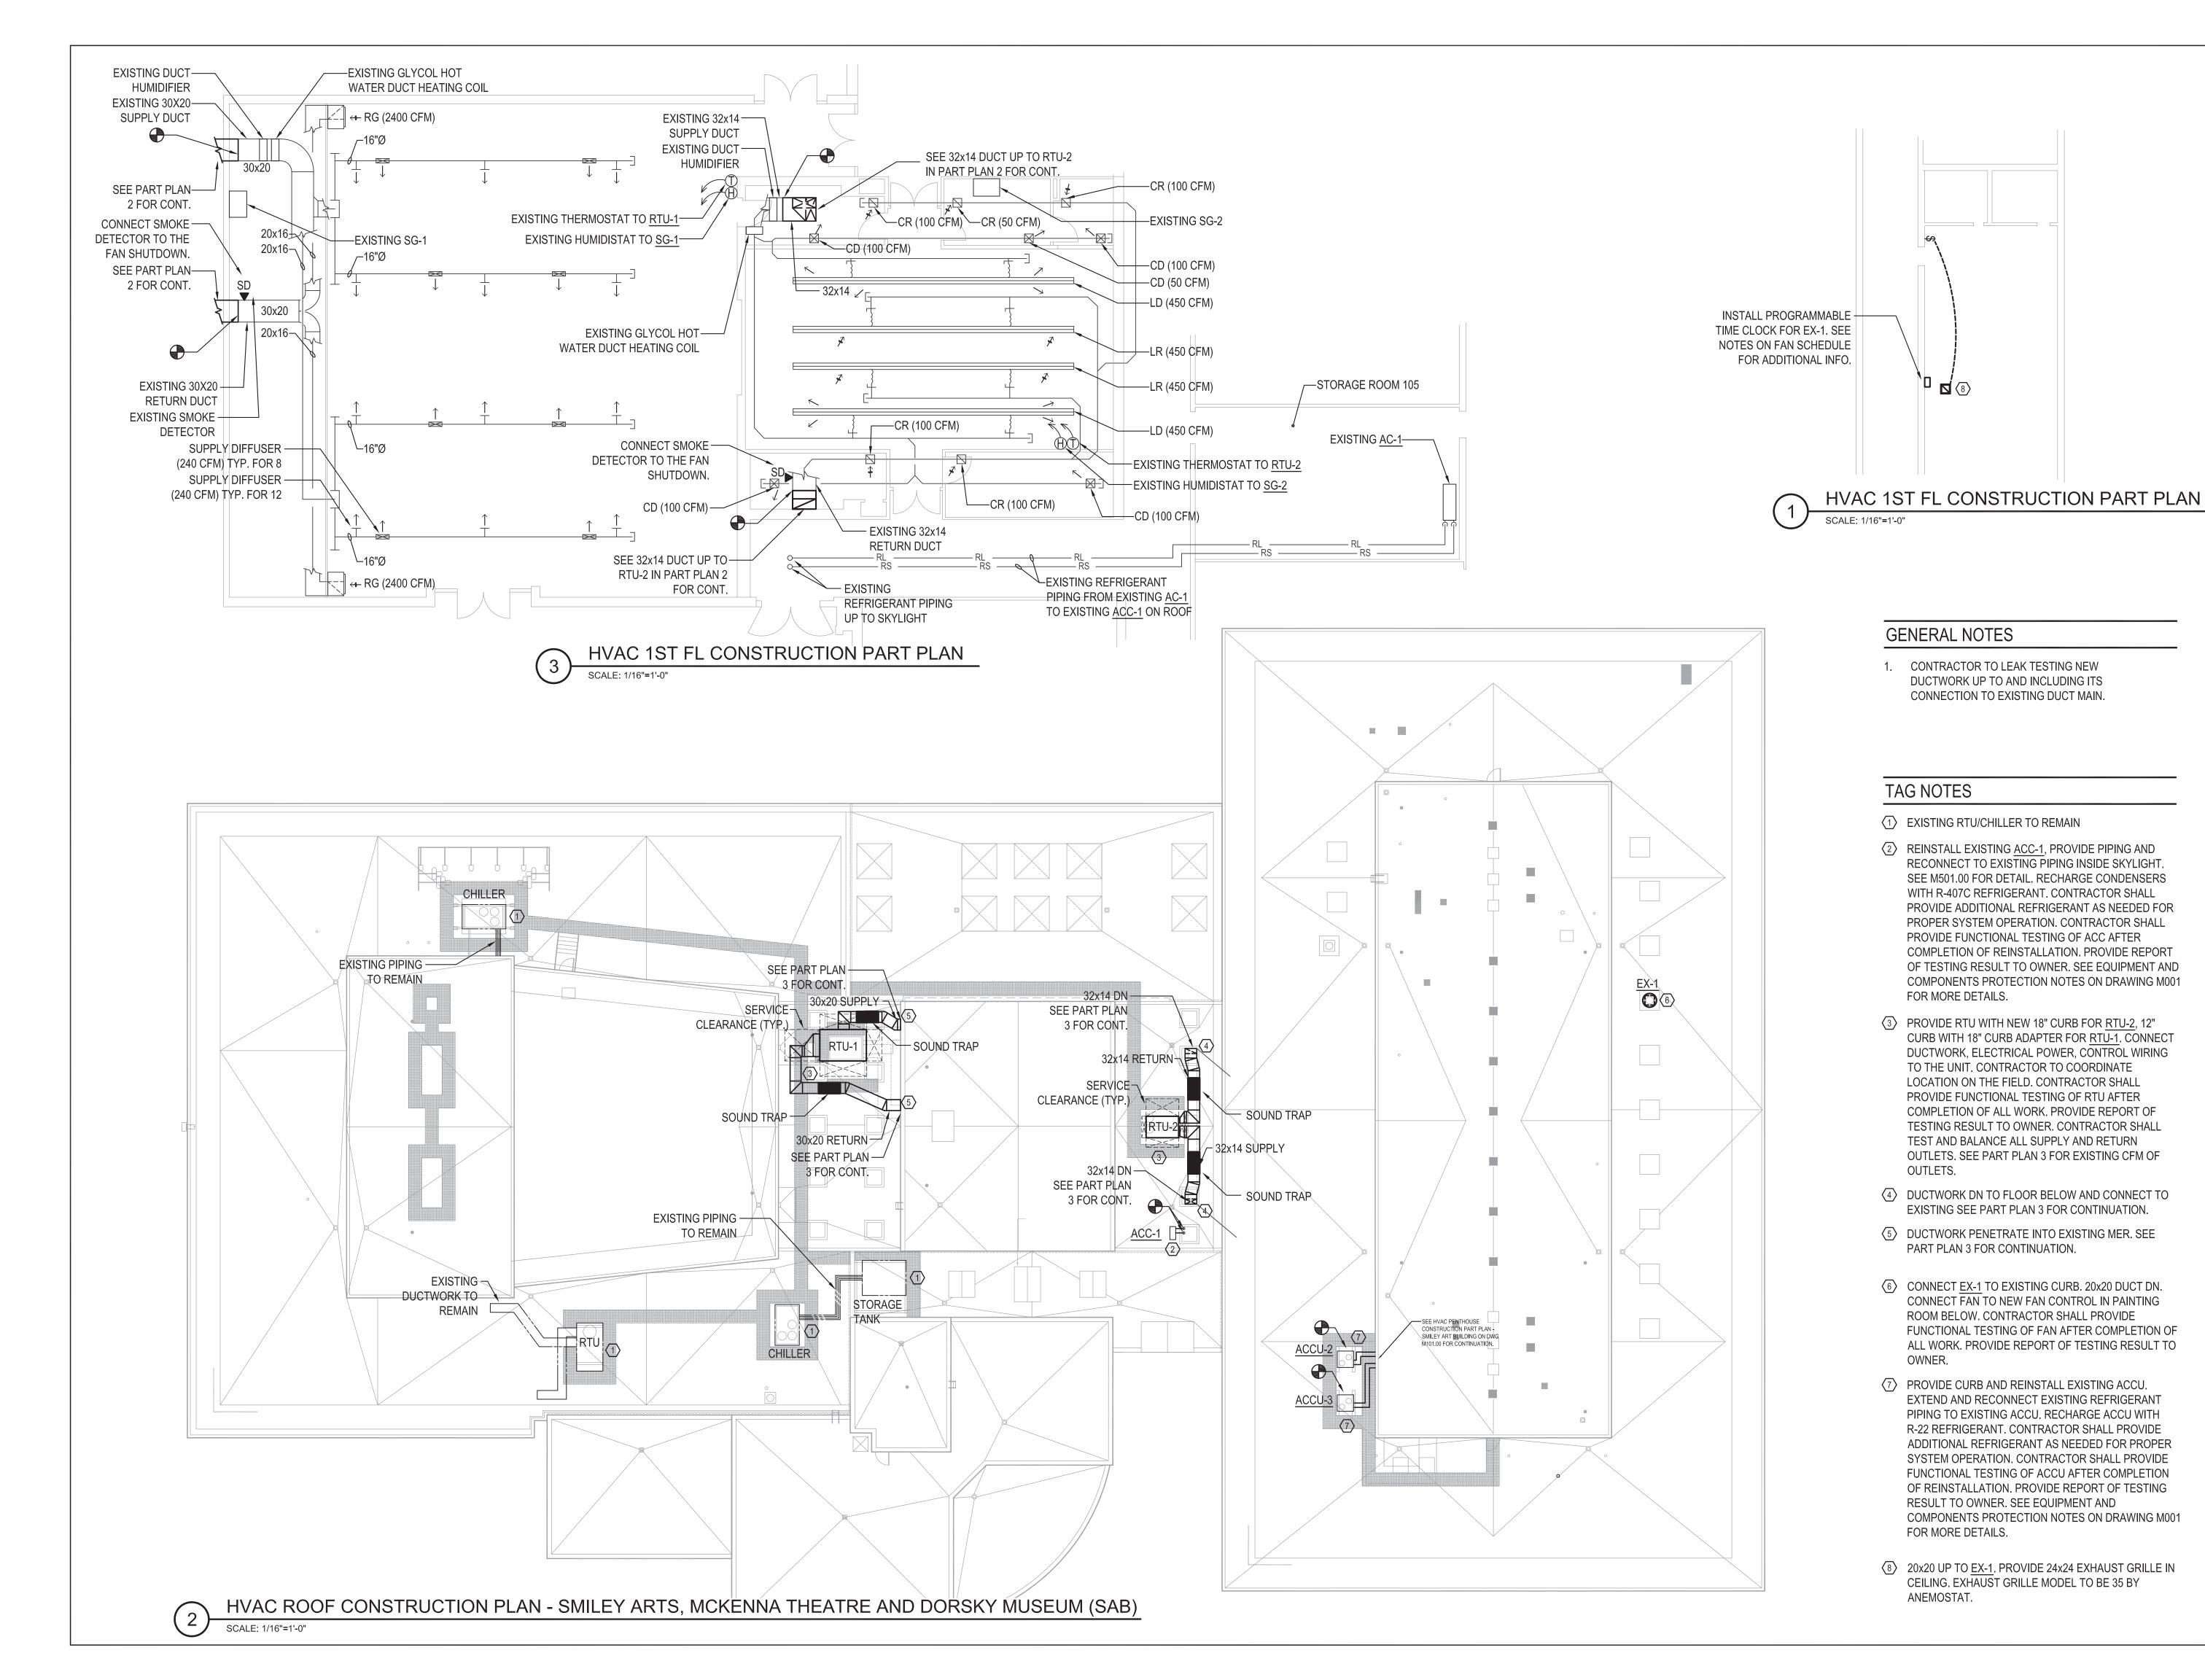

PROGRAM UNIT:

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TEL: 212.352.3307

Consulting Engineers IAQ SYSTEMS INC, CONSULTING ENGINEERS 555 8th AVENUE, SUITE 1502 NEW YORK, NY 10018

Facility:


SUNY NEW PALTZ **Building Address:** 1 HAWK DRIVE, NEW PALTZ, NY 12561 **Building:**

SMILEY ARTS BUILDING, COLLEGE THEATRE DORSKY MUSEUM AND FACULTY OFFICE BUILDING

County of: ULSTER

081047-00

Project No.:

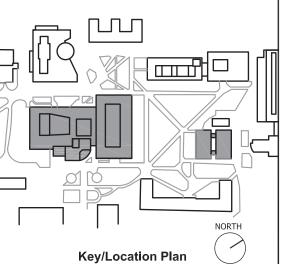

Contract Title: ROOF REPLACEMENT - SMILEY ARTS, COLLEGE THEATRE, DORSKY MUSEUM AND FACULTY OFFICE BUILDING

Project No.: 081047-00

Drawing Title: HVAC ROOF CONSTRUCTION PLAN - SMILEY ARTS, MCKENNA THEATRE AND DORSKY MUSEUM (SAB)

Seal & Signature:



Drawn By: Checked By: JANUARY 8, 2021 AS NOTED Scale:

Drawing No.


24 of 47

M100.00



TAG NOTES

1 PROVIDE CURB TO MATCH EXISTING CURB AND RECONNECT EXISTING RTU TO EXISTING DUCTWORK. EXISTING RTU MODEL: YCC060F1M0BH BY TRANE. CONTRACTOR SHALL PROVIDE FUNCTIONAL TESTING OF RTU AFTER COMPLETION OF ALL WORK. PROVIDE REPORT OF TESTING RESULT TO OWNER. SEE EQUIPMENT AND COMPONENTS PROTECTION NOTES ON DRAWING M001 FOR MORE DETAILS. SEE DETAIL 10 ON M501.00. CONNECT DUCT SMOKE DETECTORS TO THE ROOFTOP UNITS. REBALANCE AIRFLOWS TO BASELINE READINGS PERFORMED PRIOR TO REMOVAL AS INDICATED IN DWG DM101.00.

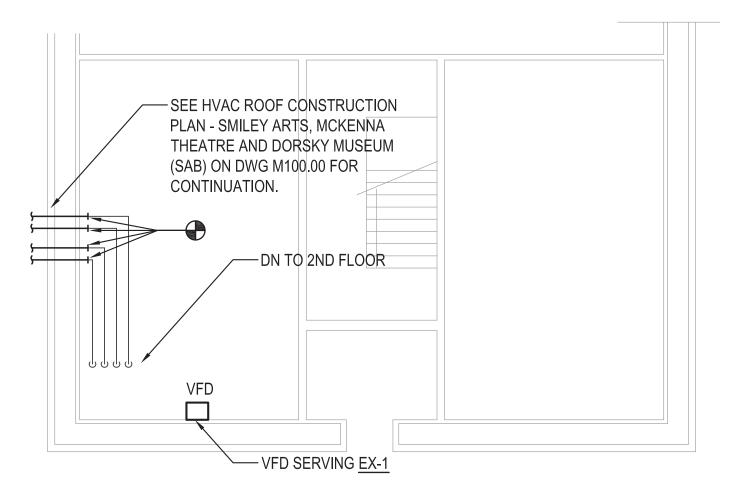

HVAC PENTHOUSE CONSTRUCTION PART PLAN - SMILEY ART BUILDING

PROGRAM UNIT:

MDSzerbaty Associates Architecture LLC 307 Seventh Avenue New York NY 10001 P 212 352 3307 F 212 352 9266 mdsnyc.com

MDSZERBATY ASSOCIATES ARCHITECTURE 307 7th AVENUE 15th FLOOR NEW YORK, NY 10001 TEL: 212.352.3307



IAQ SYSTEMS INC, CONSULTING ENGINEERS 555 8th AVENUE, SUITE 1502 NEW YORK, NY 10018 TEL: 212.680.8945


Facility: SUNY NEW PALTZ

Building Address: 1 HAWK DRIVE, NEW PALTZ, NY 12561

SMILEY ARTS BUILDING, COLLEGE THEATRE DORSKY MUSEUM AND FACULTY OFFICE BUILDING

County of: ULSTER

Project No.: 081047-00

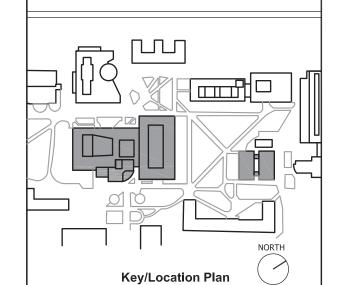

Contract Title: ROOF REPLACEMENT - SMILEY ARTS, COLLEGE THEATRE, DORSKY MUSEUM AND FACULTY OFFICE

Project No.: 081047-00

Drawing Title: HVAC ROOF CONSTRUCTION PLAN - FACULTY OFFICE BUILDING

BUILDING



Drawn By: Checked By: JANUARY 8, 2021 AS NOTED Scale:

M101.00

TEMPERATURE CONTROL LEGEND

TEMPER/	ATURE CONTROL LEGEND
Al	ANALOG INPUT (BMS)
AO	ANALOG OUTPUT (BMS)
BMS	BUILDING MANAGEMENT SYSTEM
C	COMMON
CO2	CARBON DIOXIDE SENSOR
CWRT	CONDENSER WATER RETURN TEMPERATURE
CWST	CONDENSER WATER SUPPLY TEMPERATURE
D	DAMPER
DA	DAMPER ACTUATOR
DCP	DIGITAL CONTROL PANEL
DDC	DIRECT DIGITAL CONTROL
DI	DIGITAL INPUT (BMS)
DO	DIGITAL OUTPUT (BMS)
D/N	DAY/NIGHT SIGNAL
DPI	DIFFERENTIAL PRESSURE INDICATOR
DPS	DIFFERENTIAL PRESSURE SWITCH
DPT	DIFFERENTIAL PRESSURE TRANSMITTER
FE	FLOW ELEMENT
FM	FLOW METER
FMSI	FACILITY MASTER SYSTEM INTEGRATOR
EP	ELECTRIC-TO-PNEUMATIC SWITCH
ES	END SWITCH, POSITION SWITCH
FS	FLOW SWITCH
Н	HUMIDITY SENSOR
HI	HUMIDITY INDICATOR
НМІ	HUMAN MACHINE INTERFACE
NC	NORMALLY CLOSED
NO	NORMALLY OPEN
OA	OUTDOOR AIR
OS	OCCUPANCY SENSOR
PI	PRESSURE INDICATOR, PULSE INPUT (BMS)
PSH	PRESSURE SWITCH HIGH
PSL	PRESSURE SWITCH LOW
RS	REFRIGERANT SENSOR
RWT	RETURN WATER TEMPERATURE
S	SWITCH
SD	SMOKE DETECTOR
SPS	STATIC PRESSURE SENSOR
S/W	SUMMER-WINTER SIGNAL
SWT	SUPPLY WATER TEMPERATURE
Т	THERMOSTAT
TS	TEMPERATURE SENSOR

TDR

THL

TLL

WB

WU

TIME DELAY RELAY

VALVE

WET BULB

WARM-UP SIGNAL

TEMPERATURE INDICATOR

TEMPERATURE HIGH LIMIT THERMOSTAT

TEMPERATURE LOW LIMIT THERMOSTAT

SYSTEM LEGEND/SYMBOL

FILTER PREHEAT COIL COOLING COIL

REHEAT COIL

ELECTRIC HEATING COIL

HEATING COIL

CARBON MONOXIDE SENSOR CO (TO BE PROVIDED BY MECHANICAL CONTRACTOR)

DIRECT EXPANSION COOLING COIL

CARBON DIOXIDE SENSOR OS OCCUPANCY SENSOR

HUMIDITY SENSOR


NATURAL GAS SENSOR NAT (TO BE PROVIDED BY MECHANICAL CONTRACTOR)

PSH PRESSURE SWITCH HIGH PSL PRESSURE SWITCH LOW


THERMOSTAT (LOW/HIGH VOLTAGE, OR AS REQ'D)

TEMPERATURE SENSOR

//// SD SMOKE DAMPER

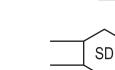

SMOKE DETECTOR

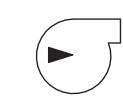

FAN/PUMP

SYSTEM LEGEND/SYMBOL (CONT'D)

BUTERFLY VALVE CHECK VALVE PRESSURE REGULATING VALVE MANUAL VALVE EXHAUST FAN IN.WC. INCHES WATER COLUMN GALLONS PER MINUTE MIXED AIR **OUTSIDE AIR** SUPPLY AIR SUPPLY FAN **RETURN AIR** RETURN FAN RETURN/EXHAUST FAN PUMP, PRESSURE STEAM SUPPLY ΚW KILOWATTS KILOWATT HOURS KWH LOW PRESSURE RETURN LOW PRESSURE STEAM INCHES WATER COLUMN HOT WATER SUPPLY HOT WATER RETURN CUBIC FEET PER MINUTE CHILLED WATER SUPPLY CHILLED WATER RETURN CWS CONDENSER WATER SUPPLY CWR CONDENSER WATER RETURN VFD VARIABLE FREQUENCY DRIVE

TEMPERATURE CONTROL SYMBOL

CONTROL VALVE, 2-WAY CONTROL VALVE, 3-WAY +++++ PARALLEL BLADE DAMPER \/\/\ OPPOSED BLADE DAMPER LON LON COMMUNICATION CONNECTION AIR FLOW STATION AVERAGING BULB SENSOR B - BULB SENSOR INDICATING DP SWITCH



PROGRAM UNIT:



307 Seventh Avenue New York NY 10001 P 212 352 3307 F 212 352 9266 mdsnyc.com MDSZERBATY ASSOCIATES ARCHITECTURE 307 7th AVENUE 15th FLOOR NEW YORK, NY 10001




IAQ SYSTEMS INC, CONSULTING ENGINEERS 555 8th AVENUE, SUITE 1502 NEW YORK, NY 10018

Facility: SUNY NEW PALTZ **Building Address:** 1 HAWK DRIVE, NEW PALTZ, NY 12561

Building: SMILEY ARTS BUILDING, COLLEGE THEATRE DORSKY MUSEUM AND FACULTY OFFICE BUILDING

County of: ULSTER

Project No.: 081047-00

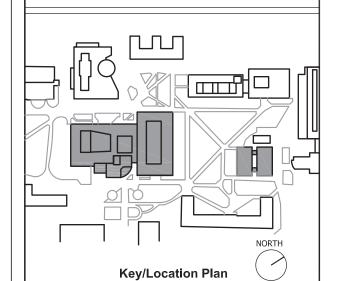

Contract Title: ROOF REPLACEMENT - SMILEY ARTS, COLLEGE THEATRE, DORSKY MUSEUM AND FACULTY OFFICE BUILDING

HVAC - CONTROLS SHEET 1 OF 3

Project No.: 081047-00 Drawing Title:

Seal & Signature:




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Drawing No.: M401.00

DI DIGITAL INPUT

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TYPICAL SYSTEM CONTROL DIAGRAM CONSTANT VOLUME

PACKAGED ROOFTOP UNIT

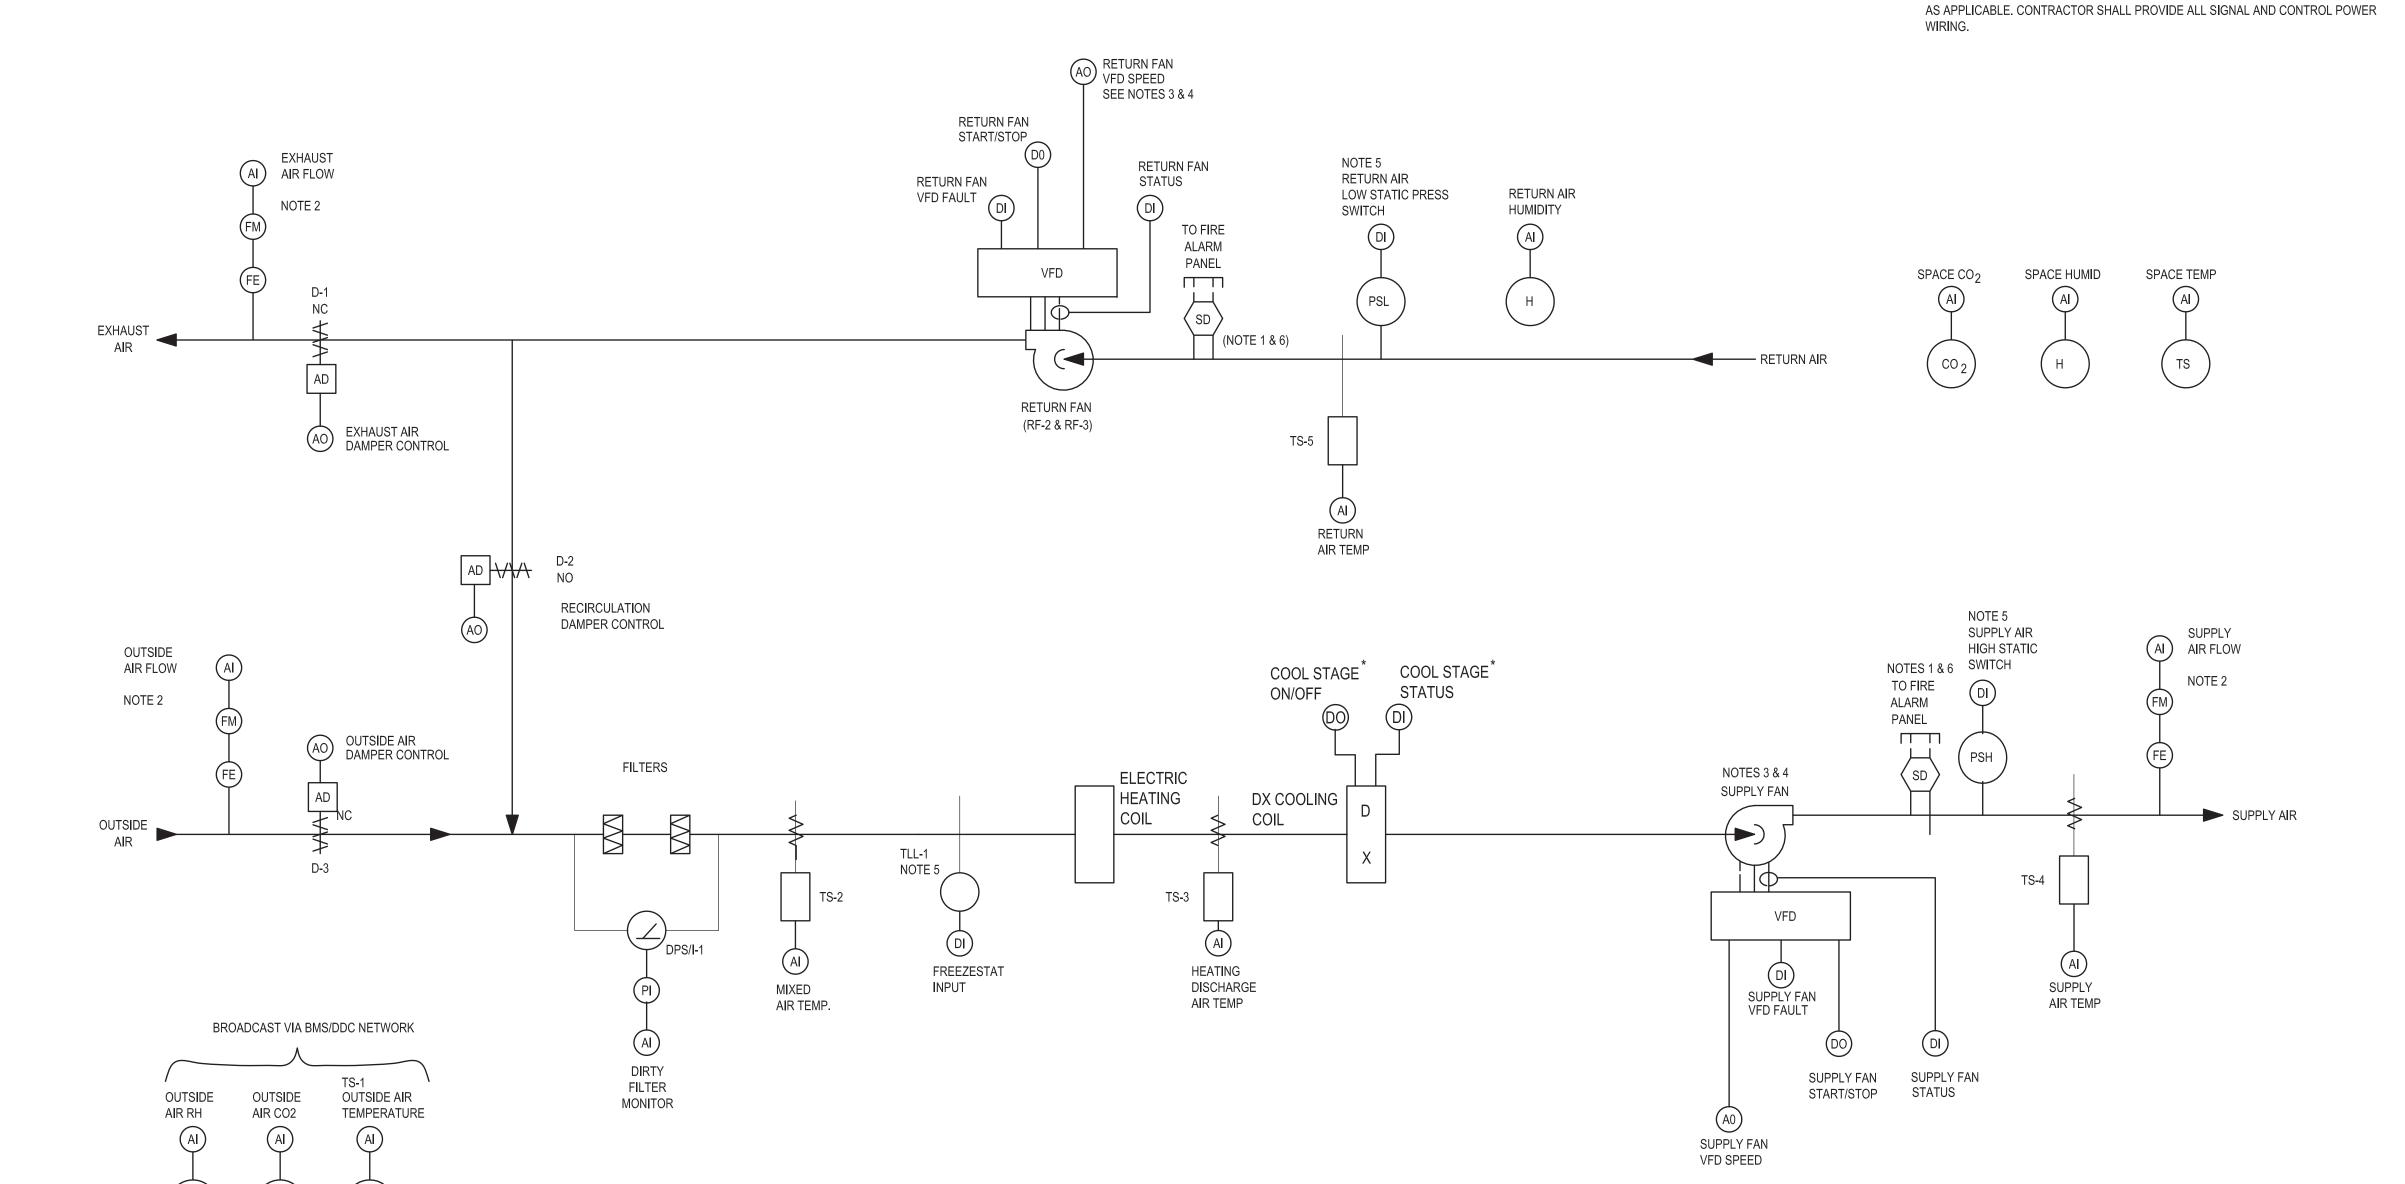

PROGRAM UNIT:

MSA

307 Seventh Avenue New York NY 10001 P 212 352 3307 F 212 352 9266 mdsnyc.com

MDSZERBATY ASSOCIATES ARCHITECTURE
307 7th AVENUE 15th FLOOR



NEW YORK, NY 10001

1. DUCT SMOKE DETECTORS SHALL BE PROVIDED IN MAIN SUPPLY AND RETURN DUCT

4. PROVIDE VARIABLE FREQUENCY DRIVE SUPPLY AND RETURN FANS FOR BALANCING

5. SAFETY SHUTDOWN DEVICES SHALL BE HARDWIRED TO THE FAN STARTER CIRCUIT IN

ADDITION TO THE DDC SYSTEM. COORDINATE WITH VFD VENDOR FOR SHUTDOWN

DETECTORS AND FURNISH THEM TO THE CENTRAL ROOFTOP UNIT OR CENTRAL AIR HANDLING UNIT MANUFACTURER FOR FACTORY INSTALLATION OR FOR FIELD DUCTWORK INSTALLATION FOR THE FLOOR RETURN/RISER RETURN CONNECTIONS

2. INTEGRATE AIR FLOW MEASURING APPARATUS INTO THE BMS/DDC NETWORK.

6. CONTRACTOR SHALL FURNISH FIRE ALARM SYSTEM COMPLIANT SMOKE

3. RETURN FAN VFD SPEED SHALL TRACK SUPPLY FAN VFD SPEED.

SYSTEMS OVER 15,000 CFM.

UNDER ALL MODES OF OPERATION.

FOR SYSTEMS OVER 2,000 CFM AND ALSO UPSTREAM OF EACH STORY RETURN DUCT/

RISER CONNECTION WHERE RETURN AIR RISERS SERVE TWO OR MORE STORIES FOR

IAQ SYSTEMS INC, CONSULTING ENGINEERS
555 8th AVENUE, SUITE 1502
NEW YORK, NY 10018
TEL: 212 690 8045

Facility:

SUNY NEW PALTZ


Building Address:
1 HAWK DRIVE, NEW PALTZ, NY 12561

Building:

SMILEY ARTS BUILDING, COLLEGE THEATRE DORSKY MUSEUM AND FACULTY OFFICE BUILDING

County of: ULSTER

Project No.: 081047-00

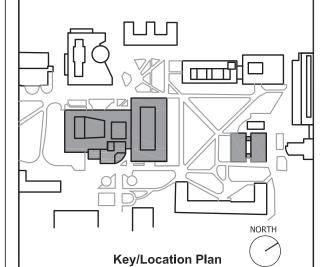

Contract Title:
ROOF REPLACEMENT - SMILEY ARTS,
COLLEGE THEATRE, DORSKY

BUILDING
Project No.: 081047-00

MUSEUM AND FACULTY OFFICE

Drawing Title:
HVAC - CONTROLS SHEET 2 OF 3

Seal & Signature:



	Drawn By:	-							
	Checked By:								
	Date:	JANUARY 8, 2021							
	Scale:	AS NOTED							

M402.00

27 of 47

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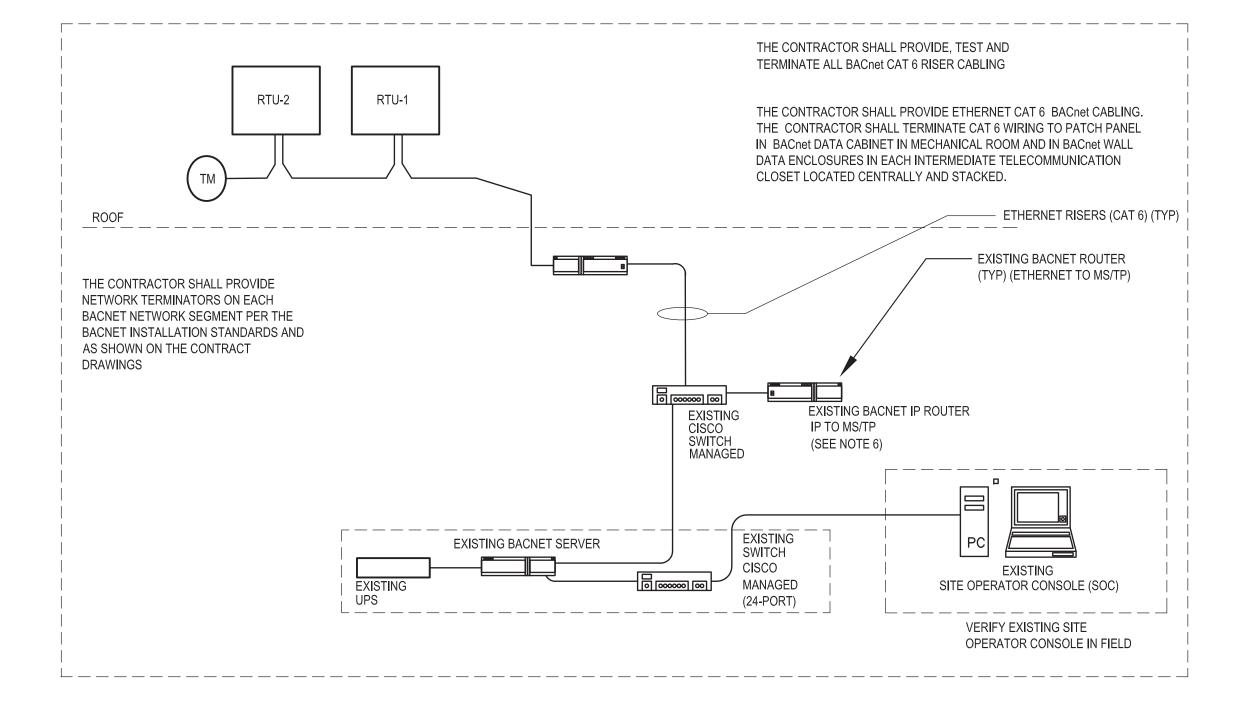
							INPU	JT/OUT	PUT (N	OTE 1)									SC	FTWARE/FIR	RMWARE FEA	ATURES (I	NOTE	Ξ 2, 3))			NOTES
	"CONSTANT VOLUME AIR HANDLING UNIT"		SEN	NSED				CALC	JLATED	1			CON	TROL		,	ALAR	MS A	ND A	DVISORIES (WITH INSTR	UCTIONS)	MI	ISC. FEA	ATURE	:s	
REFERENCE NO.	POINT NAME	ANALOG INPUT	ANALOG OUTPUT	DIGITAL INPUT	DIGITAL OUTPUT	RATE OF VARIABLE	TOTALIZE VARIABLE	TOTALIZED RUNTIME	DIFFERENTIAL CFM	DIFFERENTIAL CO2	OTHER CALCULATED	ANALOG CONTROL	DIGITAL CONTROL	SCHEDULED CONTROL	EVENT CONTROL	SUPERVISORY ALARM	CHANGE-OF-STATE	COS OFF-TO-ON	COS ON-TO-OFF	HIGH LIMIT ALARM	LOW LIMIT ALARM	RUNTIME LIMIT (HRS)	OTHER ALARM	MANUAL OVERRIDE	"DIRECT LON COMMUNICATION"	TRENDED VALUE	MISC. OTHER	NOTES
1	OUTSIDE AIR TEMP	В																					Г					
2	OUTSIDE AIR HUMIDITY	В																										
3	OUTSIDE AIR CO2	В								C1													Г					6
4	MIXED AIR TEMP	Х																			40.0F					Х		
5	HEATING COIL DISCH TEMP	Х																			40.0F					Х		
6	SUPPLY AIR TEMP	Х																								Х		
7	RETURN AIR TEMP	Х										Х									55.0F							
8	RETURN AIR HUMIDITY	Х										Х																
9	SPACE TEMP	Х										Х									45.0F					Х		
10	SPACE HUMIDITY	Х										Х								70.0%RH						Х		8
11	DIRTY FILTER MONITOR	Х															Х			per Mfr								
12	FREEZESTAT ALARM			Х													Х				39.0F							
13	SF HIGH STATIC PRESSURE			Х													Х			[TBD]			Г			П		5
14	RF LOW SUCTION PRESSURE			Х									Х				Х				[TBD]		Г			П		5
15	OUTSIDE AIR DAMPERS		X									Х																
16	RETURN AIR DAMPERS		X									Х														\prod		
17	SUPPLY AIR FLOW	Х				cfm	CCF					Х														X	\Box	NVO
18	COOLING COIL VALVE		X									Х			Х								\vdash			\Box	\top	
19	OUTSIDE AIR FLOW	Х				cfm	CCF					Х								SP-10%	SP+10%		\vdash			X	\top	4, NVO
20	SUPPLY FAN STATUS			X				Х								Х						1,000				\Box		
21	SUPPLY FAN VFD																						\Box		Х	\Box	\dashv	7
22	SUPPLY FAN VFD S/S				X									Х	Х	X		П					\Box			\prod	\dashv	
23	SUPPLY FAN VFD FAULT			X													Х									\prod	\top	
24	SUPPLY FAN VFD SPEED		X									Х						П								\prod	\top	
25	COMMON FIRE ALARM (ONE/BLDG.)			X													Х						\vdash			\Box	\dashv	
26	RETURN AIR FLOW	X				cfm	CCF					X											\vdash			X	\exists	NVO
27	HOA SWITCH NOT IN AUTO			X									Х										\vdash			\Box	\dashv	
28	EXHAUST AIR DAMPERS		$\frac{1}{x}$		T							Х						\Box					\vdash			H	\top	

LEGEND

- X = PROVIDE QUANTITY AS REQUIRED TO INCLUDE ALL INSTANCES OF THE INDICATED FEATURE. INCLUDE MULTIPLE POINTS WITHIN EACH MECHANICAL SYSTEM AS NECESSARY. COORDINATE WITH EQUIPMENT VENDOR.
- B = INFORMATION PROVIDED TO EACH SYSTEM VIA NETWORK BROADCAST.

NOTES:

- 1. THE POINT LISTED HEREIN ARE THE MINIMUM POINTS REQUIRED FOR THE CONTROL AND MONITORING OF THIS EQUIPMENT. THIS POINT LIST IS TYPICAL FOR EACH MECHANICAL/ELECTRICAL SYSTEM OF THIS TYPE. IF THE SEQUENCE OF OPERATION REQUIRES ADDITIONAL OR DIFFERING INFORMATION, IT MUST BE PROVIDED BY THE RESPECTIVE PROVIDER OF THE CONTROLS FOR THIS TYPE OF EQUIPMENT AS COORDINATED BY THE GENERAL AND MECHANICAL CONTRACTORS.
- 2. THE CONTRACTOR SHALL PROVIDE ALL DIGITAL ALARM LOGIC. ALL DIGITAL ALARMS SHALL BE PART OF THE LNS DATABASE.
- 3. PROVIDE MANUAL RESET DEVICE. NOTE THAT THIS DEVICE BOTH ALARMS IN THE BMS AND IS HARDWIRED TO THE VFDS FOR SHUTDOWN OF THE FANS IN ALL OPERATING CONDITIONS OF THE VFD.
- 4. PROVIDE BACNET COMMUNICATION CONNECTION TO THIS DEVICE MAPPING ALL REQUIRED POINTS INTO THE LNS DATABASE.
- 5. ALARM ONLY AFTER AN 8-HOUR CONSECUTIVE TIME PERIOD DURING WHICH THE RELATIVE HUMIDITY EXCEEDS ITS SETPOINT.





PROGRAM UNIT:

MSA

MDSZERBATY ASSOCIATES ARCHITECTURE 307 7th AVENUE 15th FLOOR NEW YORK, NY 10001 TEL: 212.352.3307

MDSzerbaty Associates Architecture LLC 307 Seventh Avenue New York NY 10001 P 212 352 3307 F 212 352 9266 mdsnyc.com




IAQ SYSTEMS INC, CONSULTING ENGINEERS 555 8th AVENUE, SUITE 1502 NEW YORK, NY 10018

Facility:
SUNY NEW PALTZ
Building Address:
1 HAWK DRIVE, NEW PALTZ, NY 12561

Building:
SMILEY ARTS BUILDING,
COLLEGE THEATRE
DORSKY MUSEUM AND
FACULTY OFFICE BUILDING

County of: ULSTER

Project No.: 081047-00

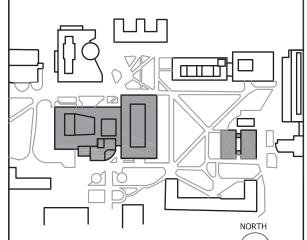

Key/Location Plan

Contract Title:
ROOF REPLACEMENT - SMILEY ARTS,
COLLEGE THEATRE, DORSKY
MUSEUM AND FACULTY OFFICE
BUILDING

Project No.: 081047-00

Drawing Title: HVAC - CONTROLS SHEET 3 OF 3

Seal & Signature:



Drawn By:

Checked By:

Date:


JANUARY 8, 2021

Scale:

AS NOTED

Drawing No.: M403.0

et 28 of 47

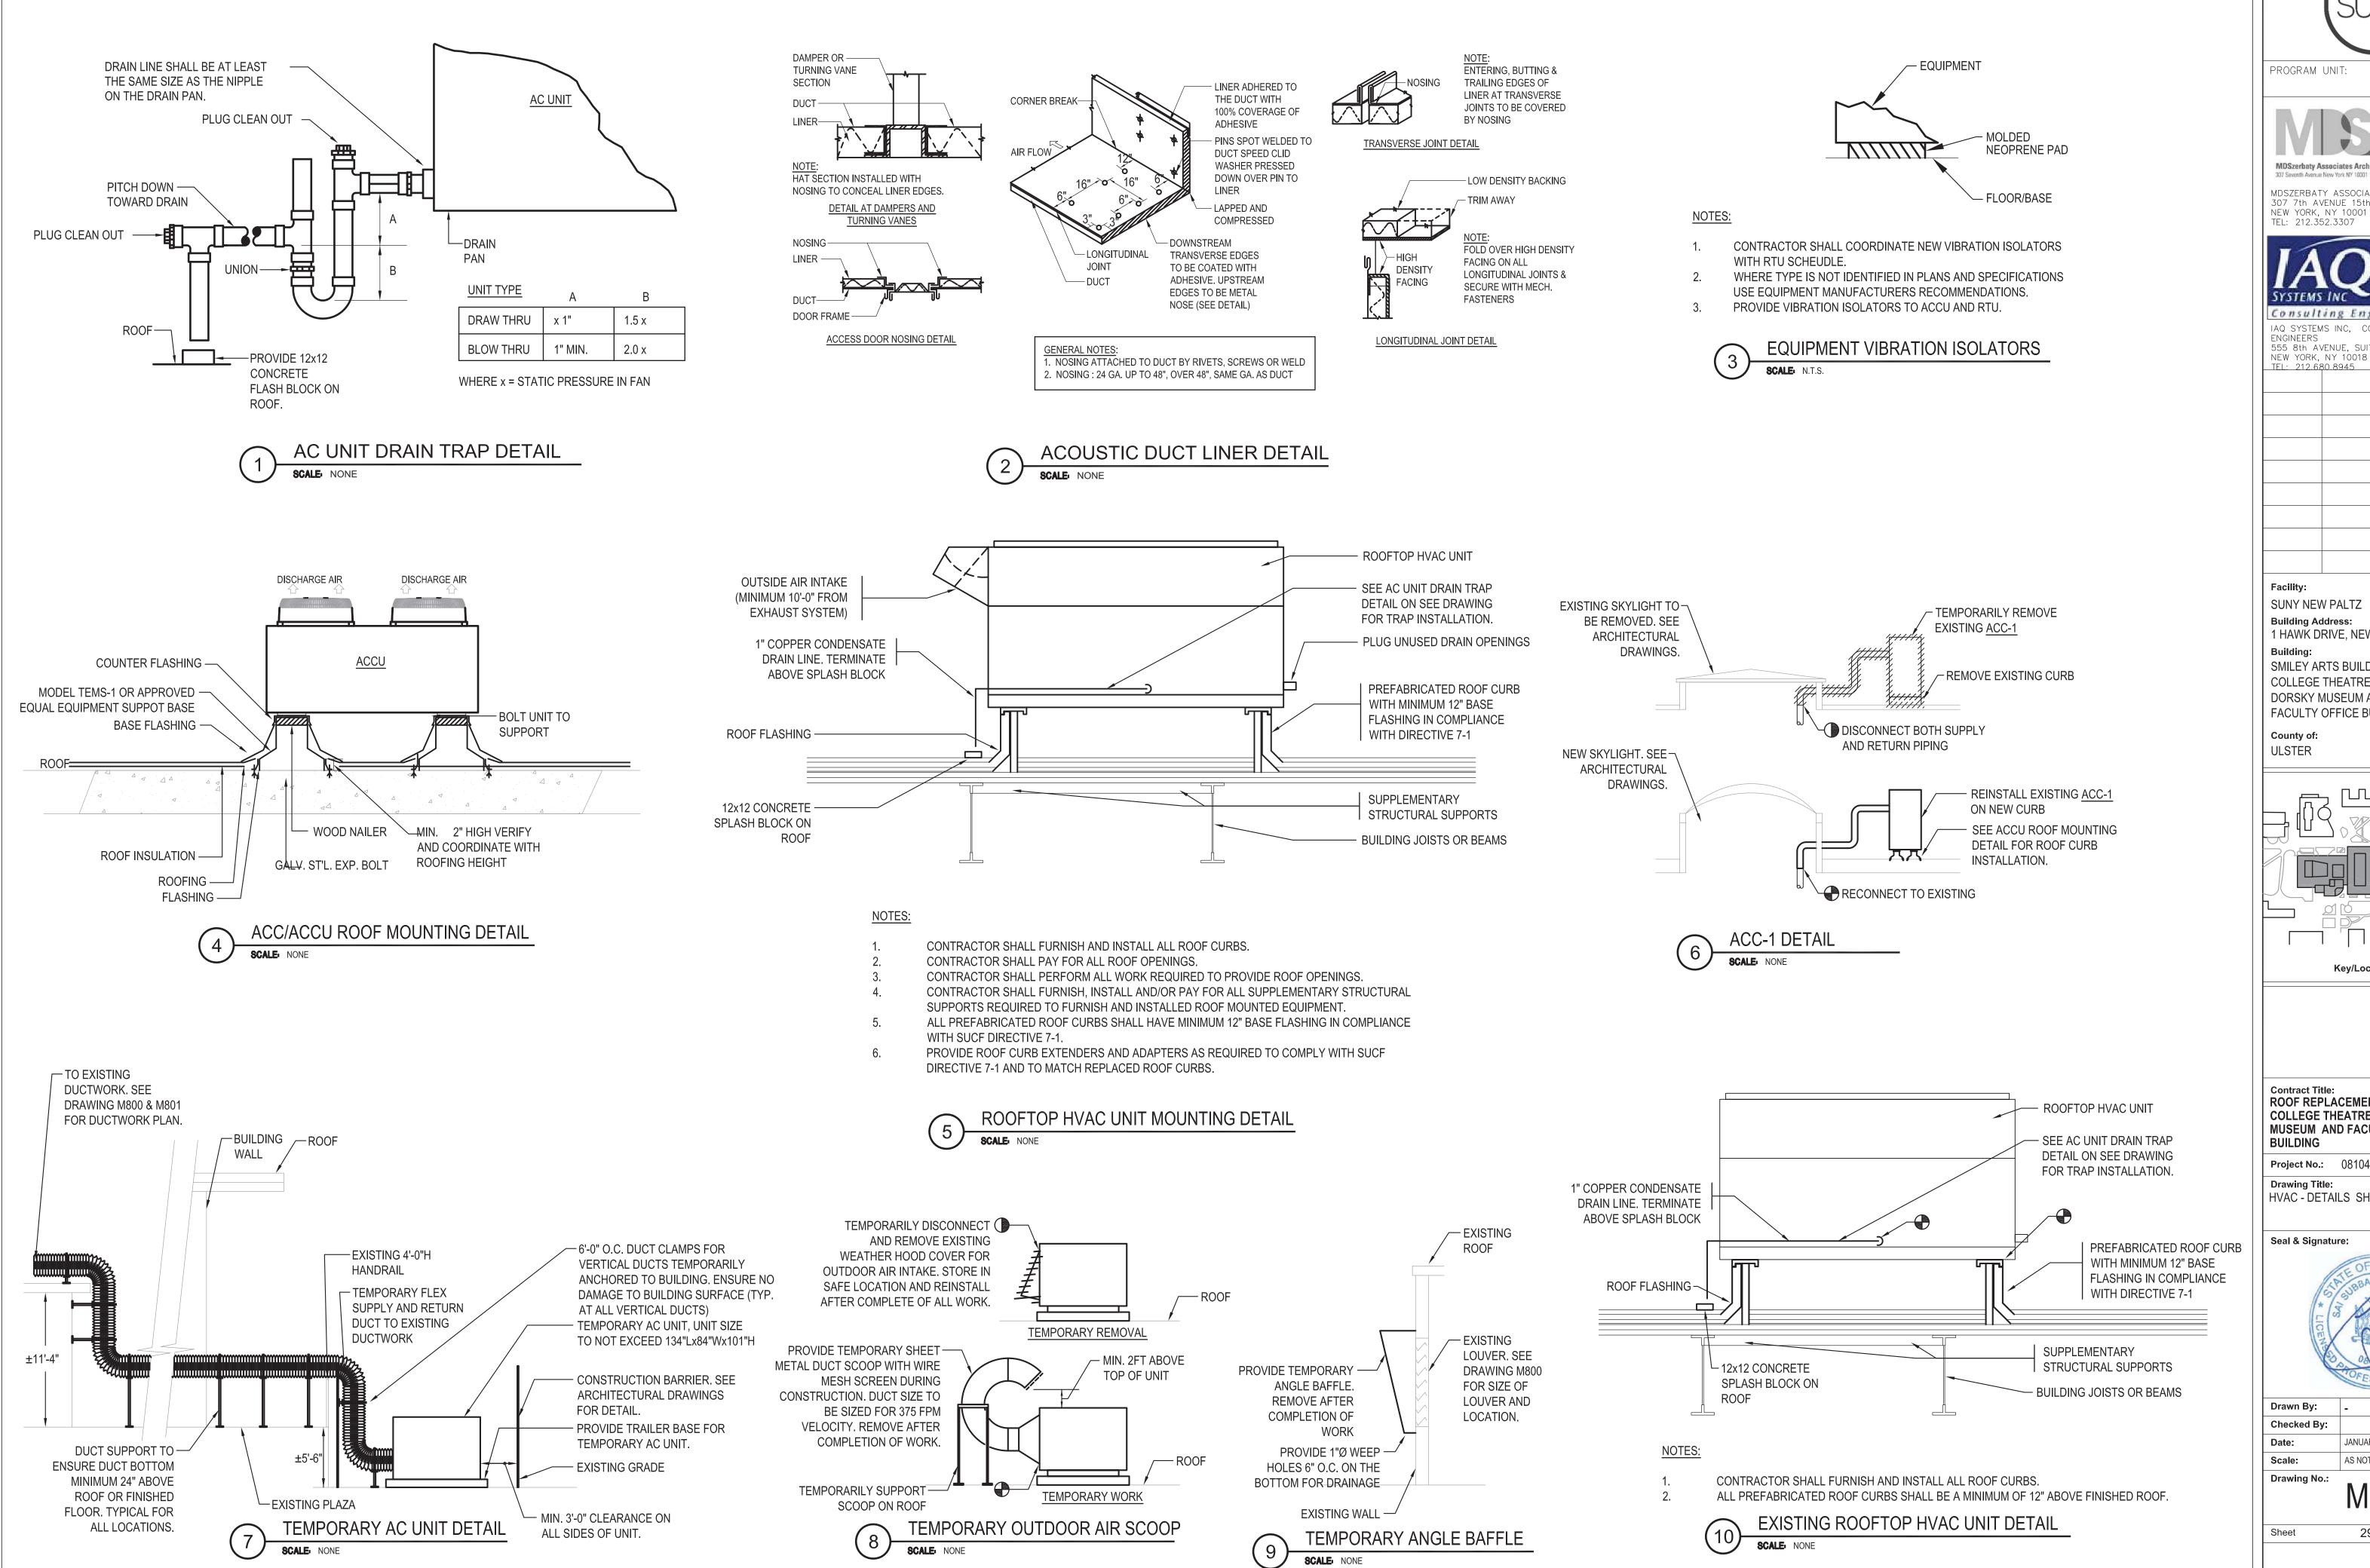

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TEL: 212.352.3307

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Facility: SUNY NEW PALTZ

Building Address: 1 HAWK DRIVE, NEW PALTZ, NY 12561 Building:

SMILEY ARTS BUILDING, COLLEGE THEATRE DORSKY MUSEUM AND FACULTY OFFICE BUILDING

County of:

Project No.: 081047-00

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Key/Location Plan

Contract Title: ROOF REPLACEMENT - SMILEY ARTS, COLLEGE THEATRE, DORSKY MUSEUM AND FACULTY OFFICE

Project No.: 081047-00


Drawing Title: HVAC - DETAILS SHEET 1 OF 2

Seal & Signature:



Drawn By: Checked By: JANUARY 8, 2021 AS NOTED

M501.00

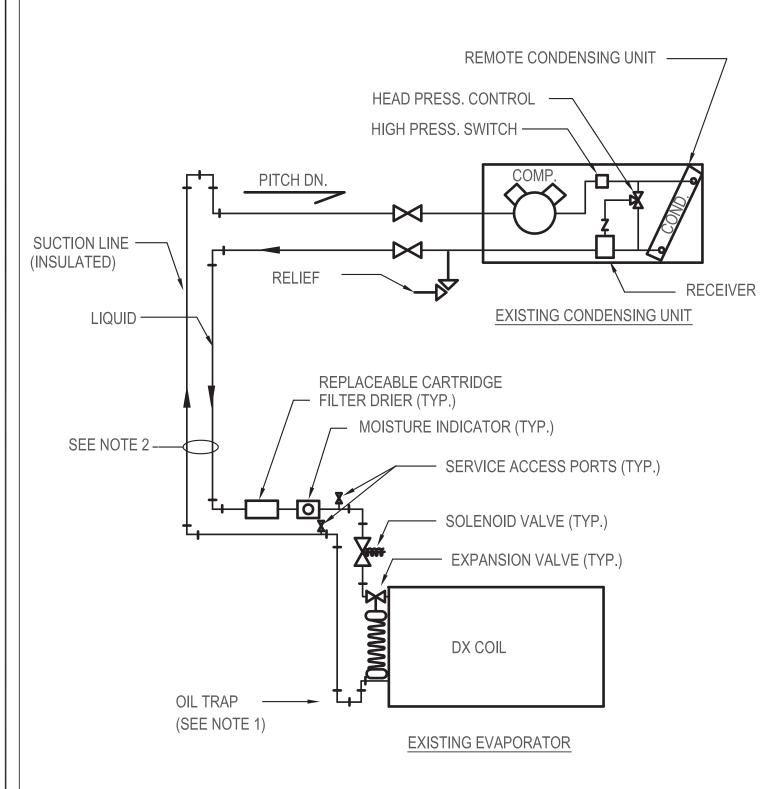


1. THE HORIZONTAL DIMENSION OF OIL TRAPS TO BE AS SHORT AS POSSIBLE.

2. CONSULT MANUFACTURER RECOMMENDATION FOR PIPE

RISER SIZING.

REFRIGERANT PIPING SCHEMATIC

SCALE: N.T.S.

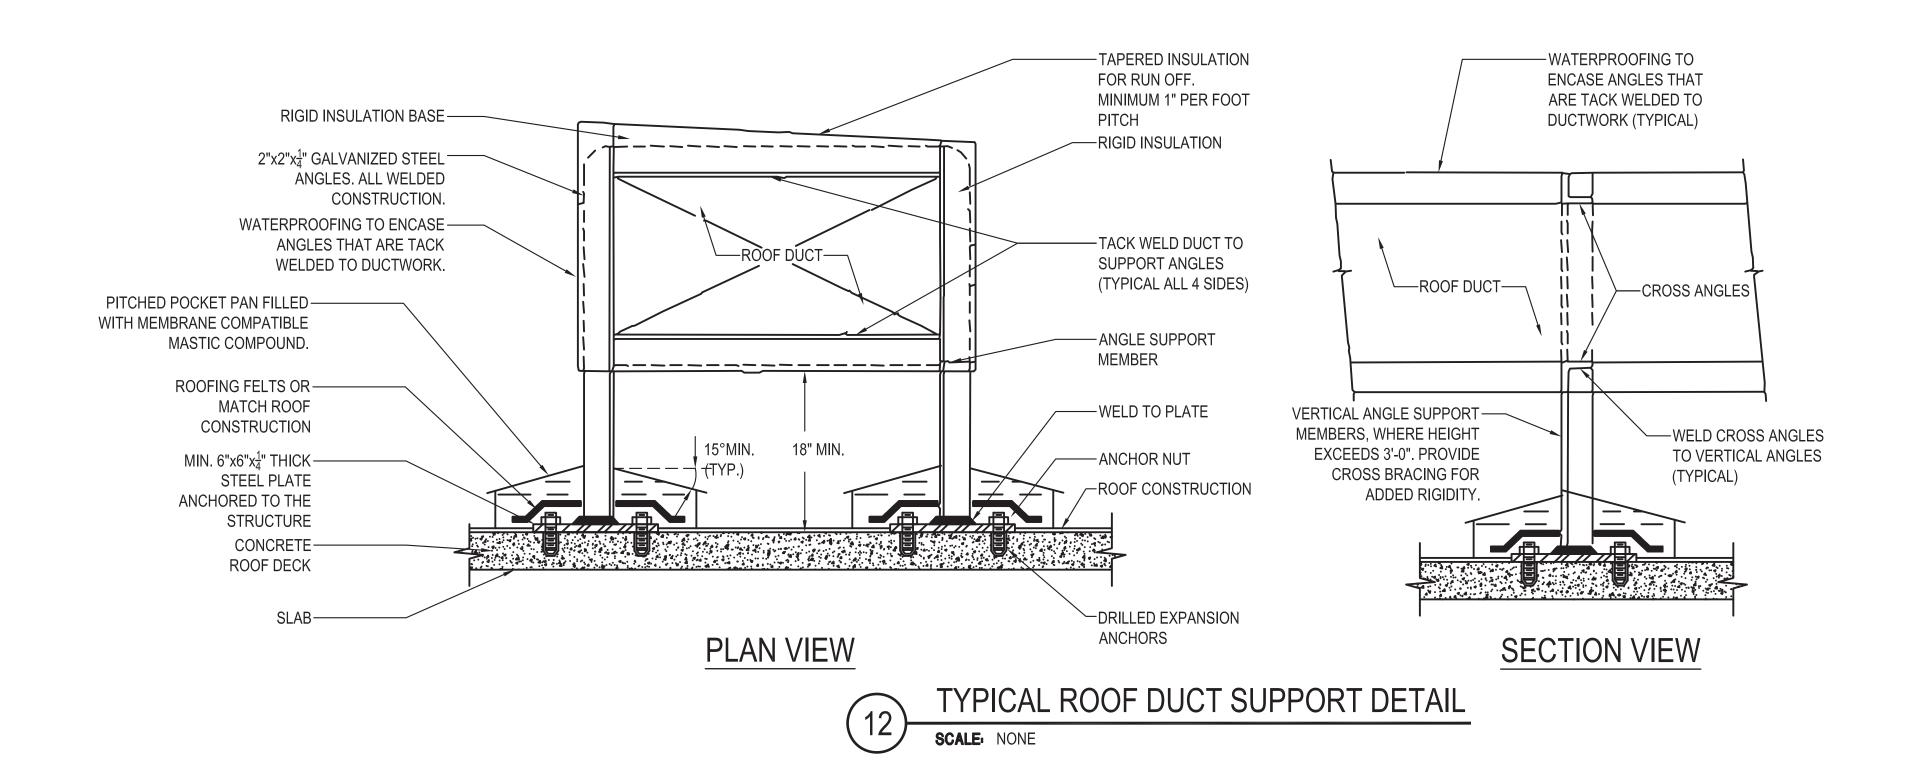



PROGRAM UNIT:

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NEW YORK, NY 10018
TEL: 212.680.8945


Facility:

SUNY NEW PALTZ **Building Address:** 1 HAWK DRIVE, NEW PALTZ, NY 12561

Building: SMILEY ARTS BUILDING, COLLEGE THEATRE DORSKY MUSEUM AND FACULTY OFFICE BUILDING

County of: ULSTER

Project No.: 081047-00

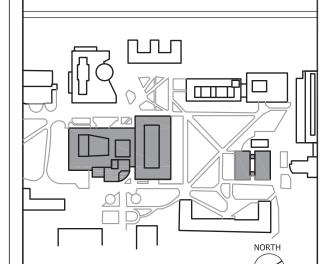

Key/Location Plan

Contract Title: ROOF REPLACEMENT - SMILEY ARTS,

Project No.: 081047-00


COLLEGE THEATRE, DORSKY MUSEUM AND FACULTY OFFICE

Drawing Title: HVAC - DETAILS SHEET 2 OF 2

Seal & Signature:



Drawn By: Checked By: AS NOTED

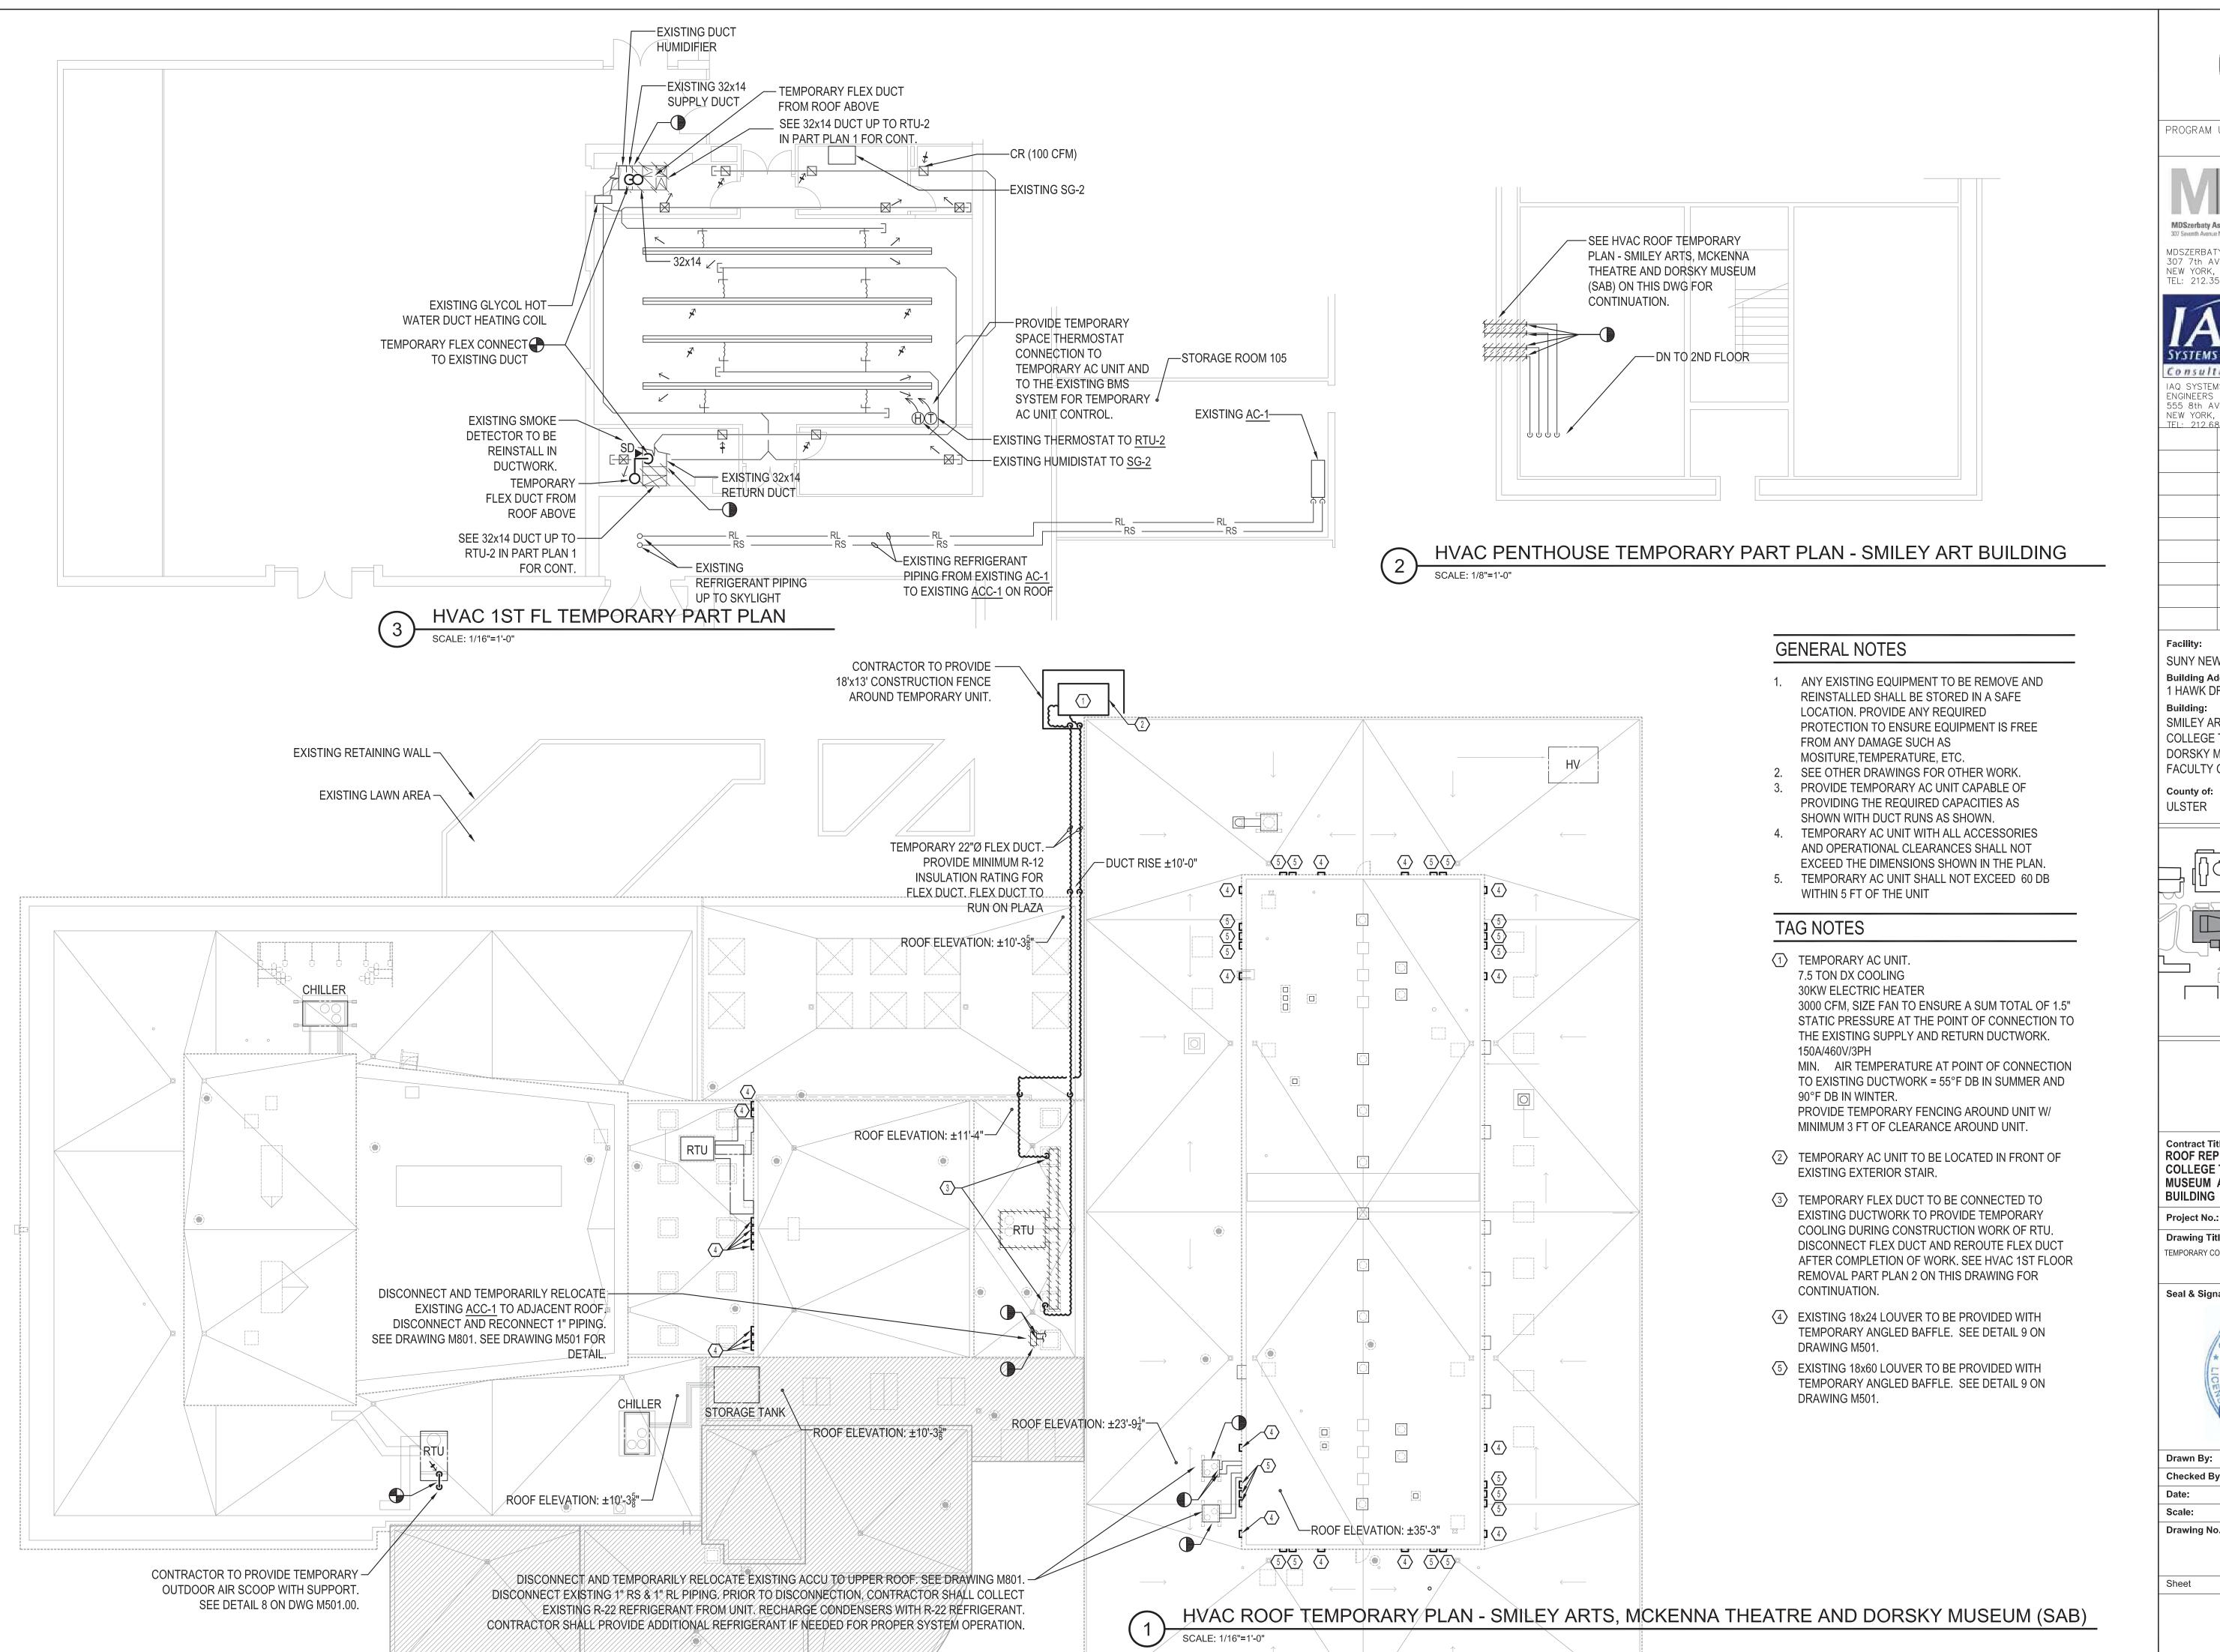



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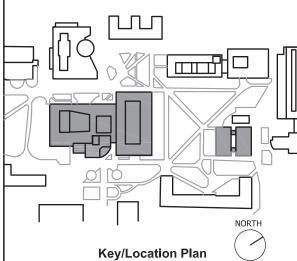
Facility:

SUNY NEW PALTZ Building Address: 1 HAWK DRIVE, NEW PALTZ, NY 12561

SMILEY ARTS BUILDING, COLLEGE THEATRE DORSKY MUSEUM AND FACULTY OFFICE BUILDING

County of: ULSTER

Project No.: 081047-00



Contract Title: ROOF REPLACEMENT - SMILEY ARTS, COLLEGE THEATRE, DORSKY MUSEUM AND FACULTY OFFICE

Project No.: 081047-00


Drawing Title: TEMPORARY CONSTRUCTION PLAN 1

Seal & Signature:



Drawn By: Checked By: JANUARY 8, 2021

AS NOTED Scale: Drawing No. M800.00

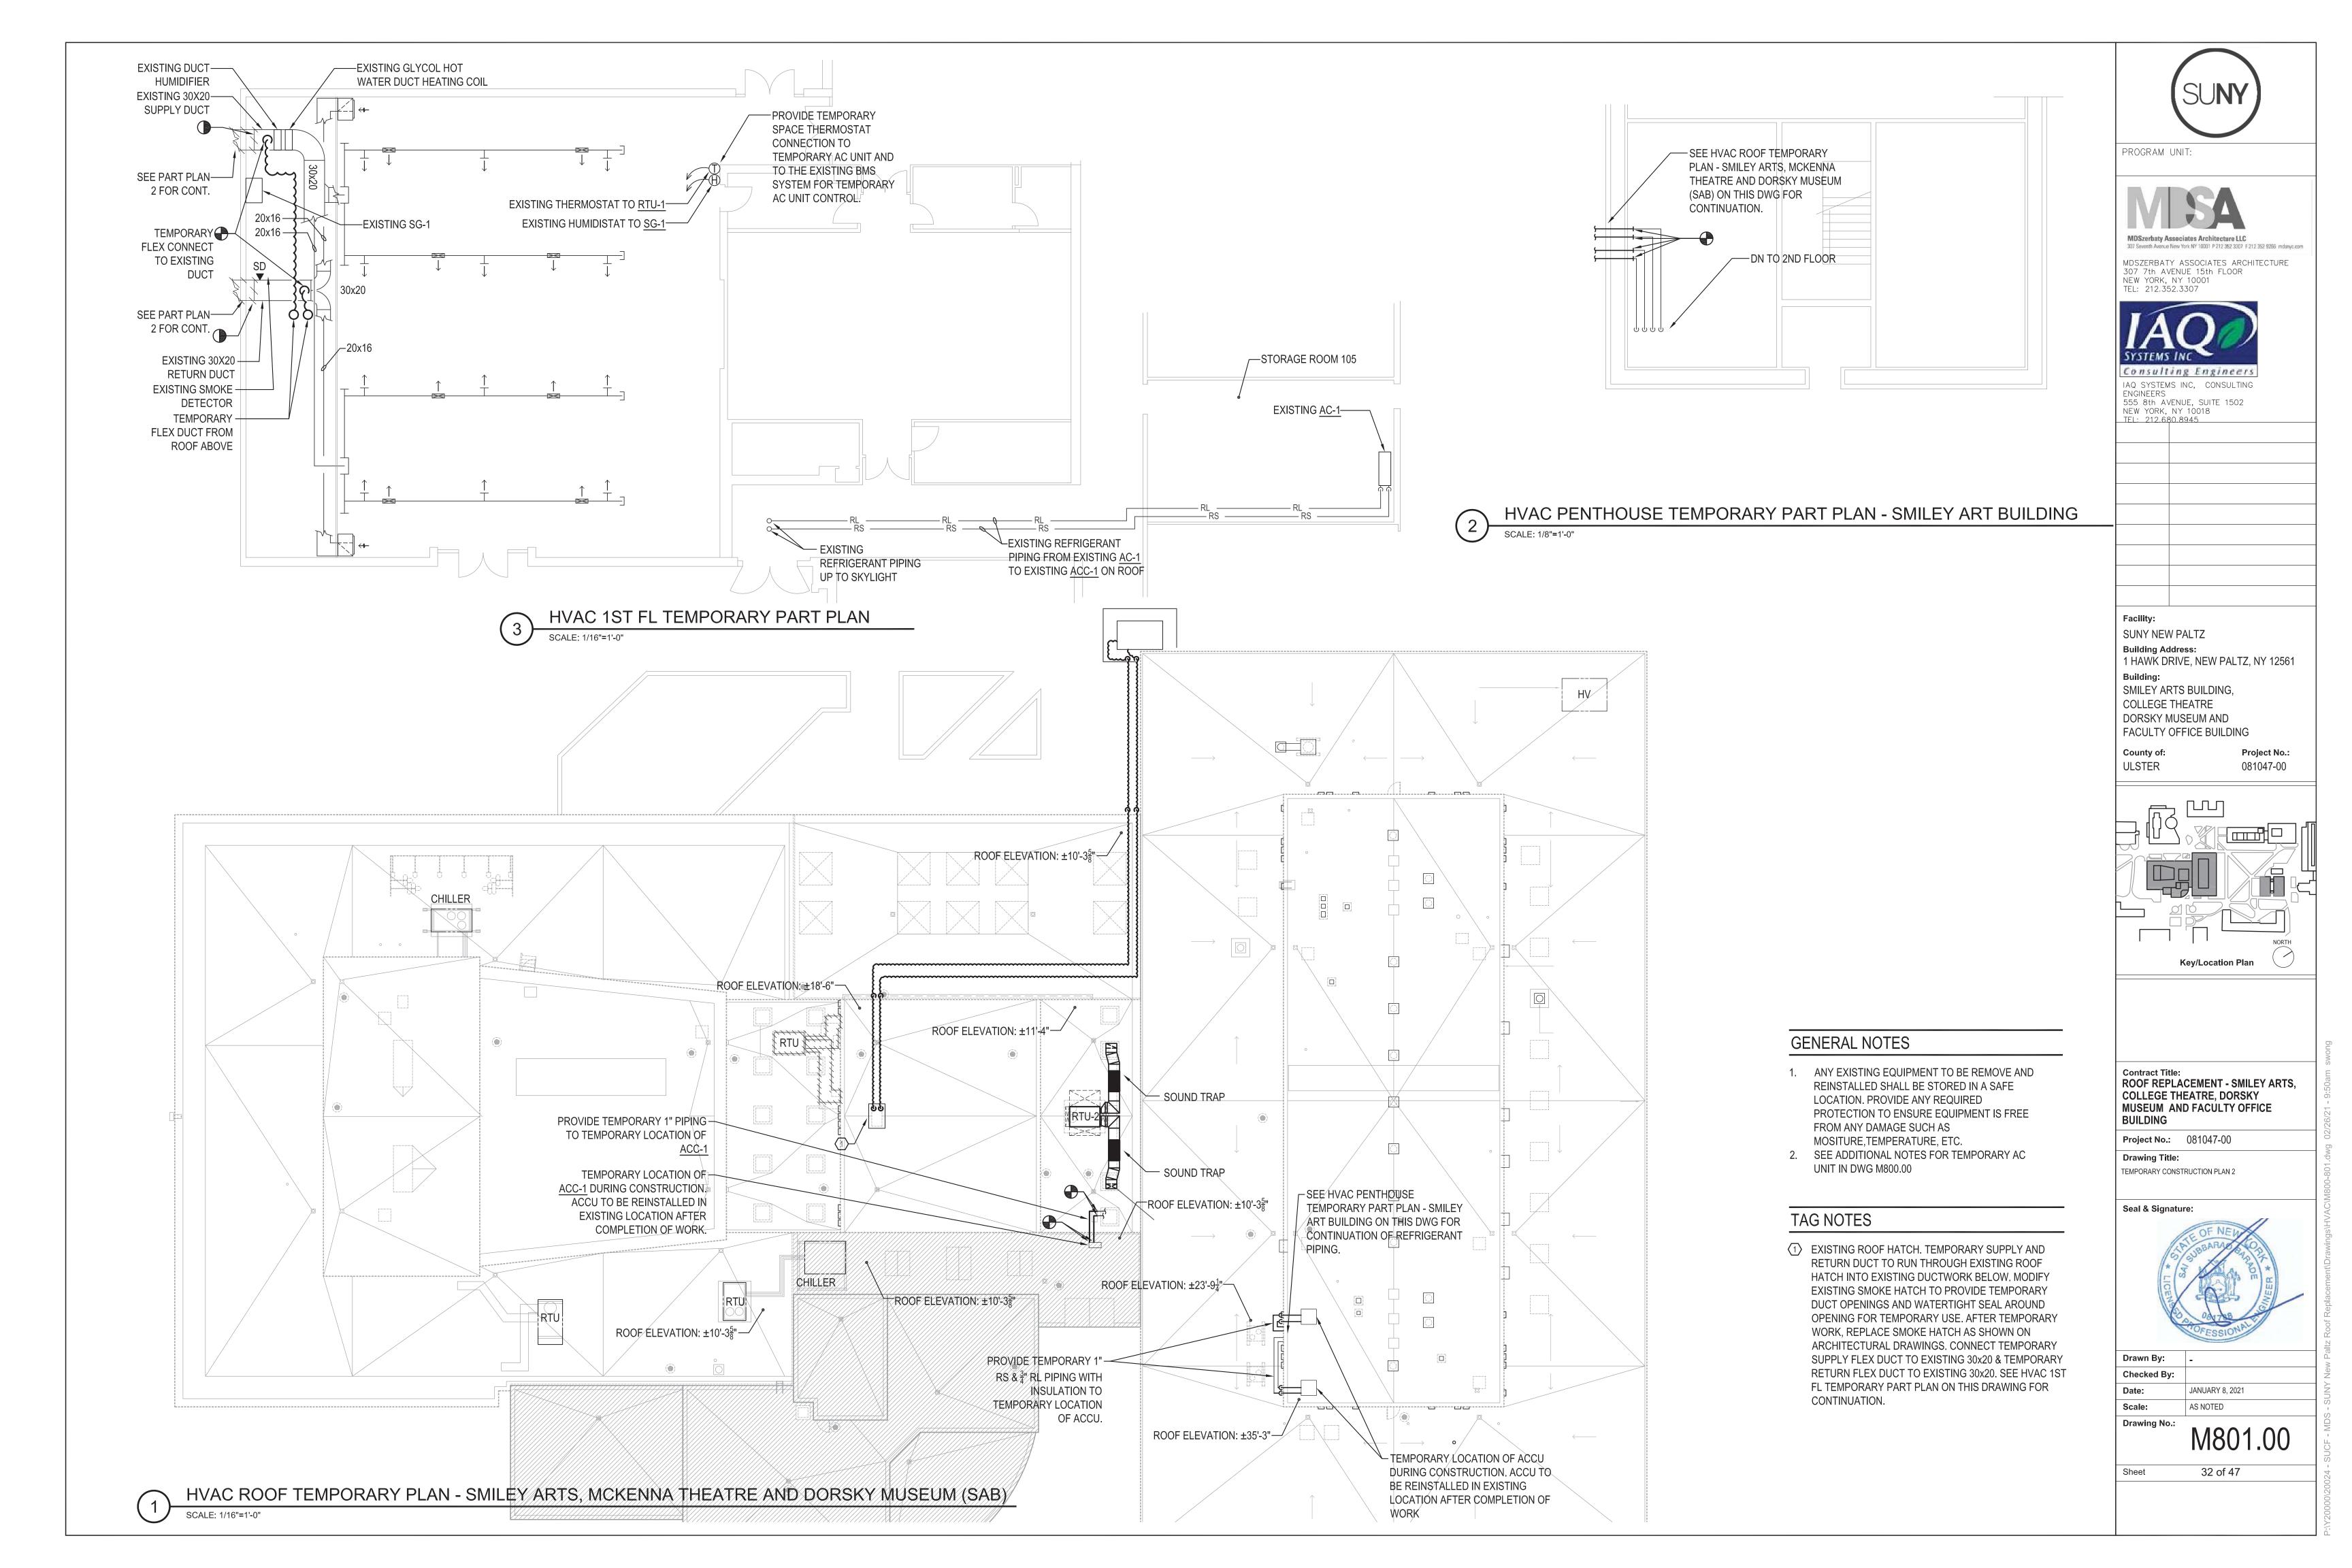

PLUMBING SYMBOLS & ABBF	REIVATIONS
SYMBOL	DESCRIPTION
	EXISTING PIPING
\times \times \times	REMOVED PIPING
ST	STORM PIPING
	CLEANOUT DECK PLATE
	DISCONNECT FROM EXISTING
	CONNECT TO EXISTING
1	CLEAN OUT/PLUGGED OUTLET
	TOP PIPE CONNECTION
C	PIPE DOWN/DROP
<u> </u>	PIPE RISE/UP
ABBREV.	ABBREVIATION
BLDG	BUILDING
СО	CLEANOUT
CODP	CLEANOUT DECK PLATE
DN	DOWN (PENETRATES FLOOR SLAB)
DWG	DRAWING
EL	ELEVATION
EX.	EXISTING
FL	FLOOR
FT	FEET
MAX	MAXIMUM
M.H.	MANHOLE
MIN	MINIMUM
NTS PSI	NOT TO SCALE
RD	POUNDS PER SQUARE INCH (GAUGE ROOF DRAIN
ND	NOOL DIVAIN

V.I.F.

STORM PIPING

VERIFY IN FIELD

PLUMBING GENERAL NOTES

- COORDINATE AND SCHEDULE ALL WORK TO MEET THE OVERALL DESIGN OBJECTIVE.
- ALL PLUMBING EQUIPMENT SHALL BE INSTALLED AND ADJUSTED IN ACCORDANCE WITH THE MANUFACTURER'S RECOMMENDATION UNLESS OTHERWISE SHOWN.
- NOTES ON ANY CONTRACT DRAWING SHALL ALSO APPLY TO ALL OTHER CONTRACT DRAWINGS UNLESS OTHERWISE SPECIFIED.
- 4. ALL BRACKETS, PLATES, CHANNELS, ETC. SHALL BE GALVANIZED UNLESS OTHERWISE SPECIFIED.
- ALL SANITARY AND STORM DRAIN PIPING AND VENT PIPES SHALL HAVE A MINIMUM SLOPE OF NOT LESS THAN 1/8" PER FOOT.
- CHANGES IN DIRECTION IN DRAINAGE PIPING SHALL BE MADE WITH APPROPRIATE USE OF 45 DEGREE WYES, LONG SWEEPS, QUARTER, SIXTH, EIGHTH, OR SIXTEENTH BENDS.
- PROVIDE CLEANOUTS ON DRAIN LINES AS SHOWN ON DRAWINGS AND AS REQUIRED BY 2020 NYS PLUMBING CODE SECTION 708.
- COORDINATE WORK SHOWN ON THESE DRAWINGS WITH OTHER DRAWINGS.
- PLUMBING CONTRACTOR SHALL COORDINATE WITH OTHER TRADES FOR EXCAVATION, BACKFILLING, CUTTING, PATCHING AND OTHER CONSTRUCTION RELATED ITEM NOT SHOWN IN THIS DRAWINGS BUT REQUIRED TO COMPLETE THE WORK.

PLUMBING DEMOLITION NOTES

- THE CONTRACTOR SHALL INCLUDE IN HIS PRICE ALL COSTS ASSOCIATED WITH REMOVALS AND RELOCATIONS OF PLUMBING WORK AS DESCRIBED ON THE DRAWINGS AND IN THE SPECIFICATIONS WITH ALLOWANCES FOR EXPECTED OR UNFORSEEN DIFFICULTIES WHEN CONCEALED WORK HAS BEEN OPENED. NO CLAIMS FOR ADDITIONAL WORK ASSOCIATED WITH DEMOLITION WILL BE ACCEPTED, EXCEPT IN CERTAIN CASES CONSIDERED JUSTIFIABLE BY THE ARCHITECT.
- THE CONTRACTOR SHALL REMOVE AND/OR RELOCATE ALL EXISTING PLUMBING WORK WHICH INTERFERES WITH THE NEW ARCHITECTURAL LAYOUTS. ALL SYSTEMS WHICH ARE NO LONGER REQUIRED TO FUNCTION SHALL BE REMOVED BACK TO ACTIVE LINES.
- THE CONTRACTOR SHALL PERFORM DEMOLITION AND REMOVAL WORK WITH MINIMUM INTERFERENCE WITH FUNCTIONING PLUMBING SYSTEMS. ALL AFFECTED SYSTEMS SHALL BE RECONNECTED AND RESTORED.
- DEMOLITION AND REMOVAL WORK SHALL BE PERFORMED IN A NEAT AND WORKMANLIKE MANNER. THE CONTRACTOR SHALL PATCH, REPAIR OR OTHERWISE RESTORE ANY DAMAGED INTERIOR OR EXTERIOR BUILDING SURFACE TO ITS ORIGINAL CONDITION.
- THE CONTRACTOR SHALL REMOVE ALL PIPING SUPPORTS, ETC. FROM PARTITIONS THAT ARE TO BE REMOVED. WHERE THE REMOVAL OF THESE ITEMS DISRUPTS EXISTING PIPING THAT IS TO REMAIN, THE CONTRACTOR SHALL INSTALL AND PROVIDE BYPASS CONNECTIONS NECESSARY.
- ALL PIPING WHICH BECOMES EXPOSED DURING THE ALTERATION WORK SHALL BE REMOVED AND REROUTED CONCEALED BEHIND FINISHED SURFACES.
- 7. PORTIONS OF MAINS TO BE REMOVED OR ABANDONED AS A RESULT OF DEMOLITION WORK, BUT WHICH ARE REQUIRED TO REMAIN ACTIVE, SHALL BE CUT AT CONVENIENT LOCATIONS, REROUTED AND RECONNECTED.
- THE CONTRACTOR SHALL NOTIFY THE OWNER AT THE APPROPRIATE TIME OF THE PROJECTED DEMOLITION AND PHASING SCHEDULE SO THAT REMOVAL OR RELOCATION OF AFFECTED UTILITIES MAY BE CARRIED OUT IN COORDINATION WITH THE PROJECT REQUIREMENTS.
- ALL EXISTING MATERIAL AND EQUIPMENT IN USABLE CONDITION, WHICH IS TO BE REMOVED UNDER THIS CONTRACT, SHALL REMAIN THE PROPERTY OF THE OWNER OR SHALL BE DISPOSED OF BY THE PLUMBING CONTRACTOR, AS DIRECTED BY THE OWNER.
- 10. ARRANGE TO WORK CONTINUOUSLY, INCLUDING OVER TIME, IF REQUIRED, TO ASSURE THAT SYSTEMS WILL BE SHUT DOWN ONLY DURING THE TIME ACTUALLY REQUIRED TO MAKE THE NECESSARY CONNECTIONS TO THE EXISTING SYSTEMS.
- 11. THE SHUTDOWN OF EXISTING BUILDING PLUMBING SERVICES SHALL BE COORDINATED WITH THE FACILITY. MAKE ARRANGEMENTS AT LEAST 5 BUSINESS DAYS PRIOR TO A SHUTDOWN.

PLUMBING BUILDING DEPT NOTES

ALL PLUMBING WORK SHALL MEET THE REQUIREMENTS OF THE 2020 NEW YORK STATE (NYS) UNIFORM FIRE PREVENTION AND BUILDING CODE AND 2020 NYS PLUMBING CODE.

- PROTECTION OF PIPING AS OUTLINED IN SECTION IPC 305 SHALL BE PROVIDED AS REQUIRED.
- ALL PIPING AND MATERIALS SHALL BE AS DIRECTED IN SECTIONS IPC 303 & IPC 702.
- PIPING JOINTS AND CONNECTIONS SHALL BE AS APPROVED IN SECTIONS IPC 605 & IPC 705.
- CONSTRUCTION AND SPACING OF HANGERS AND SUPPORTS SHALL BE AS DIRECTED IN SECTION IPC 308 AND IPC TABLE 308.5
- CLEANOUTS FOR SANITARY AND STORM DRAINAGE SHALL BE AS PER SECTION IPC 708.
- ALL PLUMBING WORK SHALL BE DONE BY OR UNDER THE DIRECT SUPERVISION OF A LICENSED MASTER PLUMBER.

SCOPE OF WORK

THE FOLLOWING IS A BRIEF DESCRIPTION OF THE SCOPE OF WORK AND SHALL NOT BE CONSIDERED TO BE COMPLETE. THE ACTUAL SCOPE OF WORK FOR THE CONTRACT SHALL INCLUDE ALL PORTION OF THE CONTRACT DOCUMENTS AND ANY SUPPLEMENTAL INFORMATION PROVIDED BY THE STATE UNIVERSITY OF NEW YORK THROUGH ANY OTHER WRITTEN DOCUMENTATION.

THE WORK SHALL BE AS INDICATED IN ALL OF THE CONTRACT DOCUMENTS AND SHALL INCLUDE, BUT NOT BE LIMITED TO, THE FOLLOWING GENERAL ITEMS OF WORK.

PLUMBING

- 1. CLEAN EXISTING (37) ROOF DRAIN BODY AND TAILPIECE IN SAB.
- 2. REPLACE (37) EXISTING ROOF DRAIN DOMES AND CLAMPS WITH ZURN RD2150 FOR NEW ROOFING INSULATION IN SAB.
- 3. REPLACE (4) EXISTING GUTTER DRAINS AND DOWNSPOUTS FOR FACULTY OFFICE BUILDING. CONNECT NEW DOWNSPOUT TO EXISTING STORM LEADER ON GRADE LEVEL.



PROGRAM UNIT:

MDSZERBATY ASSOCIATES ARCHITECTURE 307 7th AVENUE 15th FLOOR NEW YORK, NY 10001 TEL: 212.352.3307



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NEW YORK, NY 10018


Facility:

SUNY NEW PALTZ **Building Address:** 1 HAWK DRIVE, NEW PALTZ, NY 12561

Building: SMILEY ARTS BUILDING, COLLEGE THEATRE DORSKY MUSEUM AND FACULTY OFFICE BUILDING

County of: ULSTER

Project No.: 081047-00

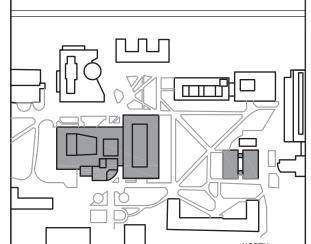

Key/Location Plan

Contract Title: ROOF REPLACEMENT - SMILEY ARTS. COLLEGE THEATRE, DORSKY MUSEUM AND FACULTY OFFICE BUILDING

Project No.: 081047-00

Drawing Title: PLUMBING - GENERAL NOTES

Seal & Signature:



Drawn By: **XUEZHI FENG** HON CHANG, P.E. JANUARY 8, 2021

AS NOTED **Drawing No.:**

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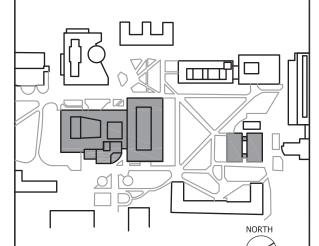
Facility: SUNY NEW PALTZ

Building Address: 1 HAWK DRIVE, NEW PALTZ, NY 12561 **Building:** SMILEY ARTS BUILDING,

COLLEGE THEATRE DORSKY MUSEUM AND FACULTY OFFICE BUILDING

County of: ULSTER

Project No.: 081047-00



Key/Location Plan

Contract Title:
ROOF REPLACEMENT - SMILEY ARTS,
COLLEGE THEATRE, DORSKY
MUSEUM AND FACULTY OFFICE

Project No.: 081047-00


Drawing Title: PLUMBING - SAB ROOF DEMOLITION



HON CHANG, P.E. JANUARY 8, 2021

AS NOTED Drawing No.:

P062.00

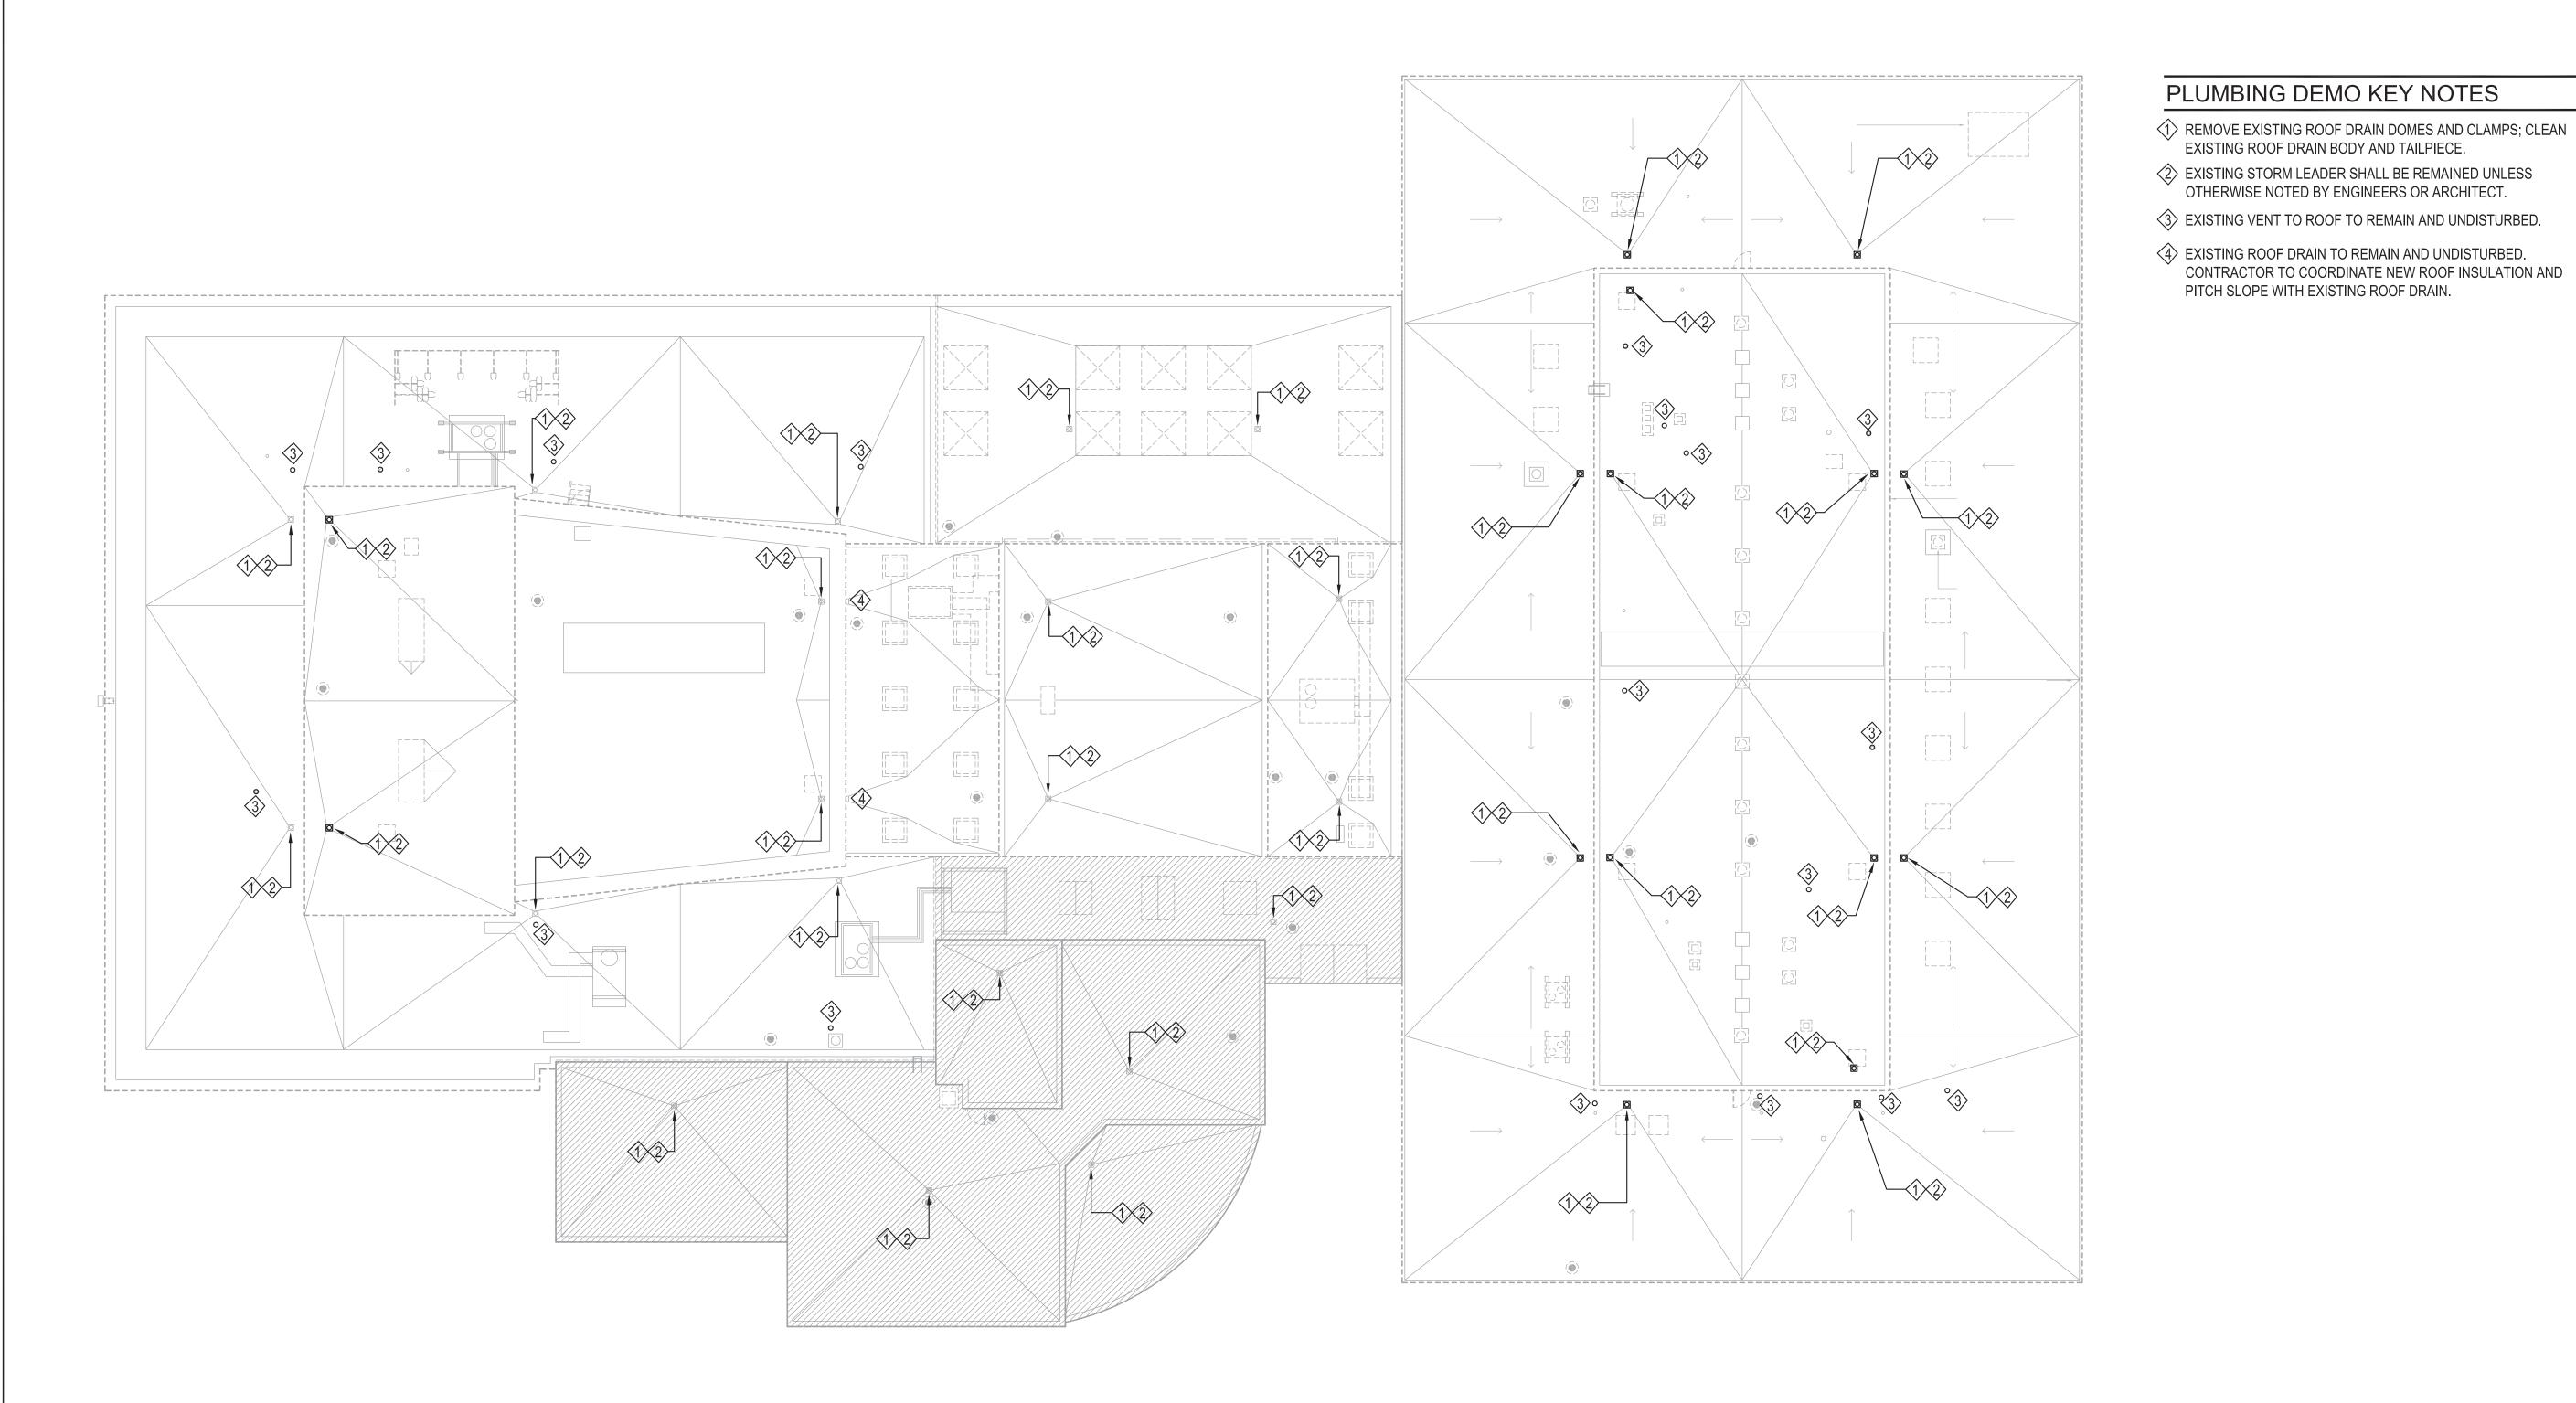



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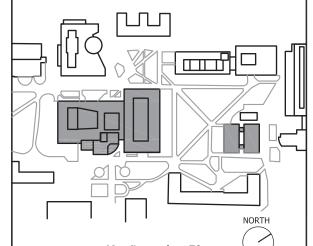
SUNY NEW PALTZ **Building Address:** 1 HAWK DRIVE, NEW PALTZ, NY 12561 **Building:**

SMILEY ARTS BUILDING, COLLEGE THEATRE DORSKY MUSEUM AND FACULTY OFFICE BUILDING

County of: ULSTER

Facility:

Project No.: 081047-00



Key/Location Plan

Contract Title: ROOF REPLACEMENT - SMILEY ARTS, COLLEGE THEATRE, DORSKY MUSEUM AND FACULTY OFFICE BUILDING

Project No.: 081047-00


Drawing Title: PLUMBING - FOB ROOF DEMOLITION PLAN



Drawn By: **XUEZHI FENG** HON CHANG, P.E. JANUARY 8, 2021 AS NOTED

Scale: Drawing No.:

> P064.00 35 of 47

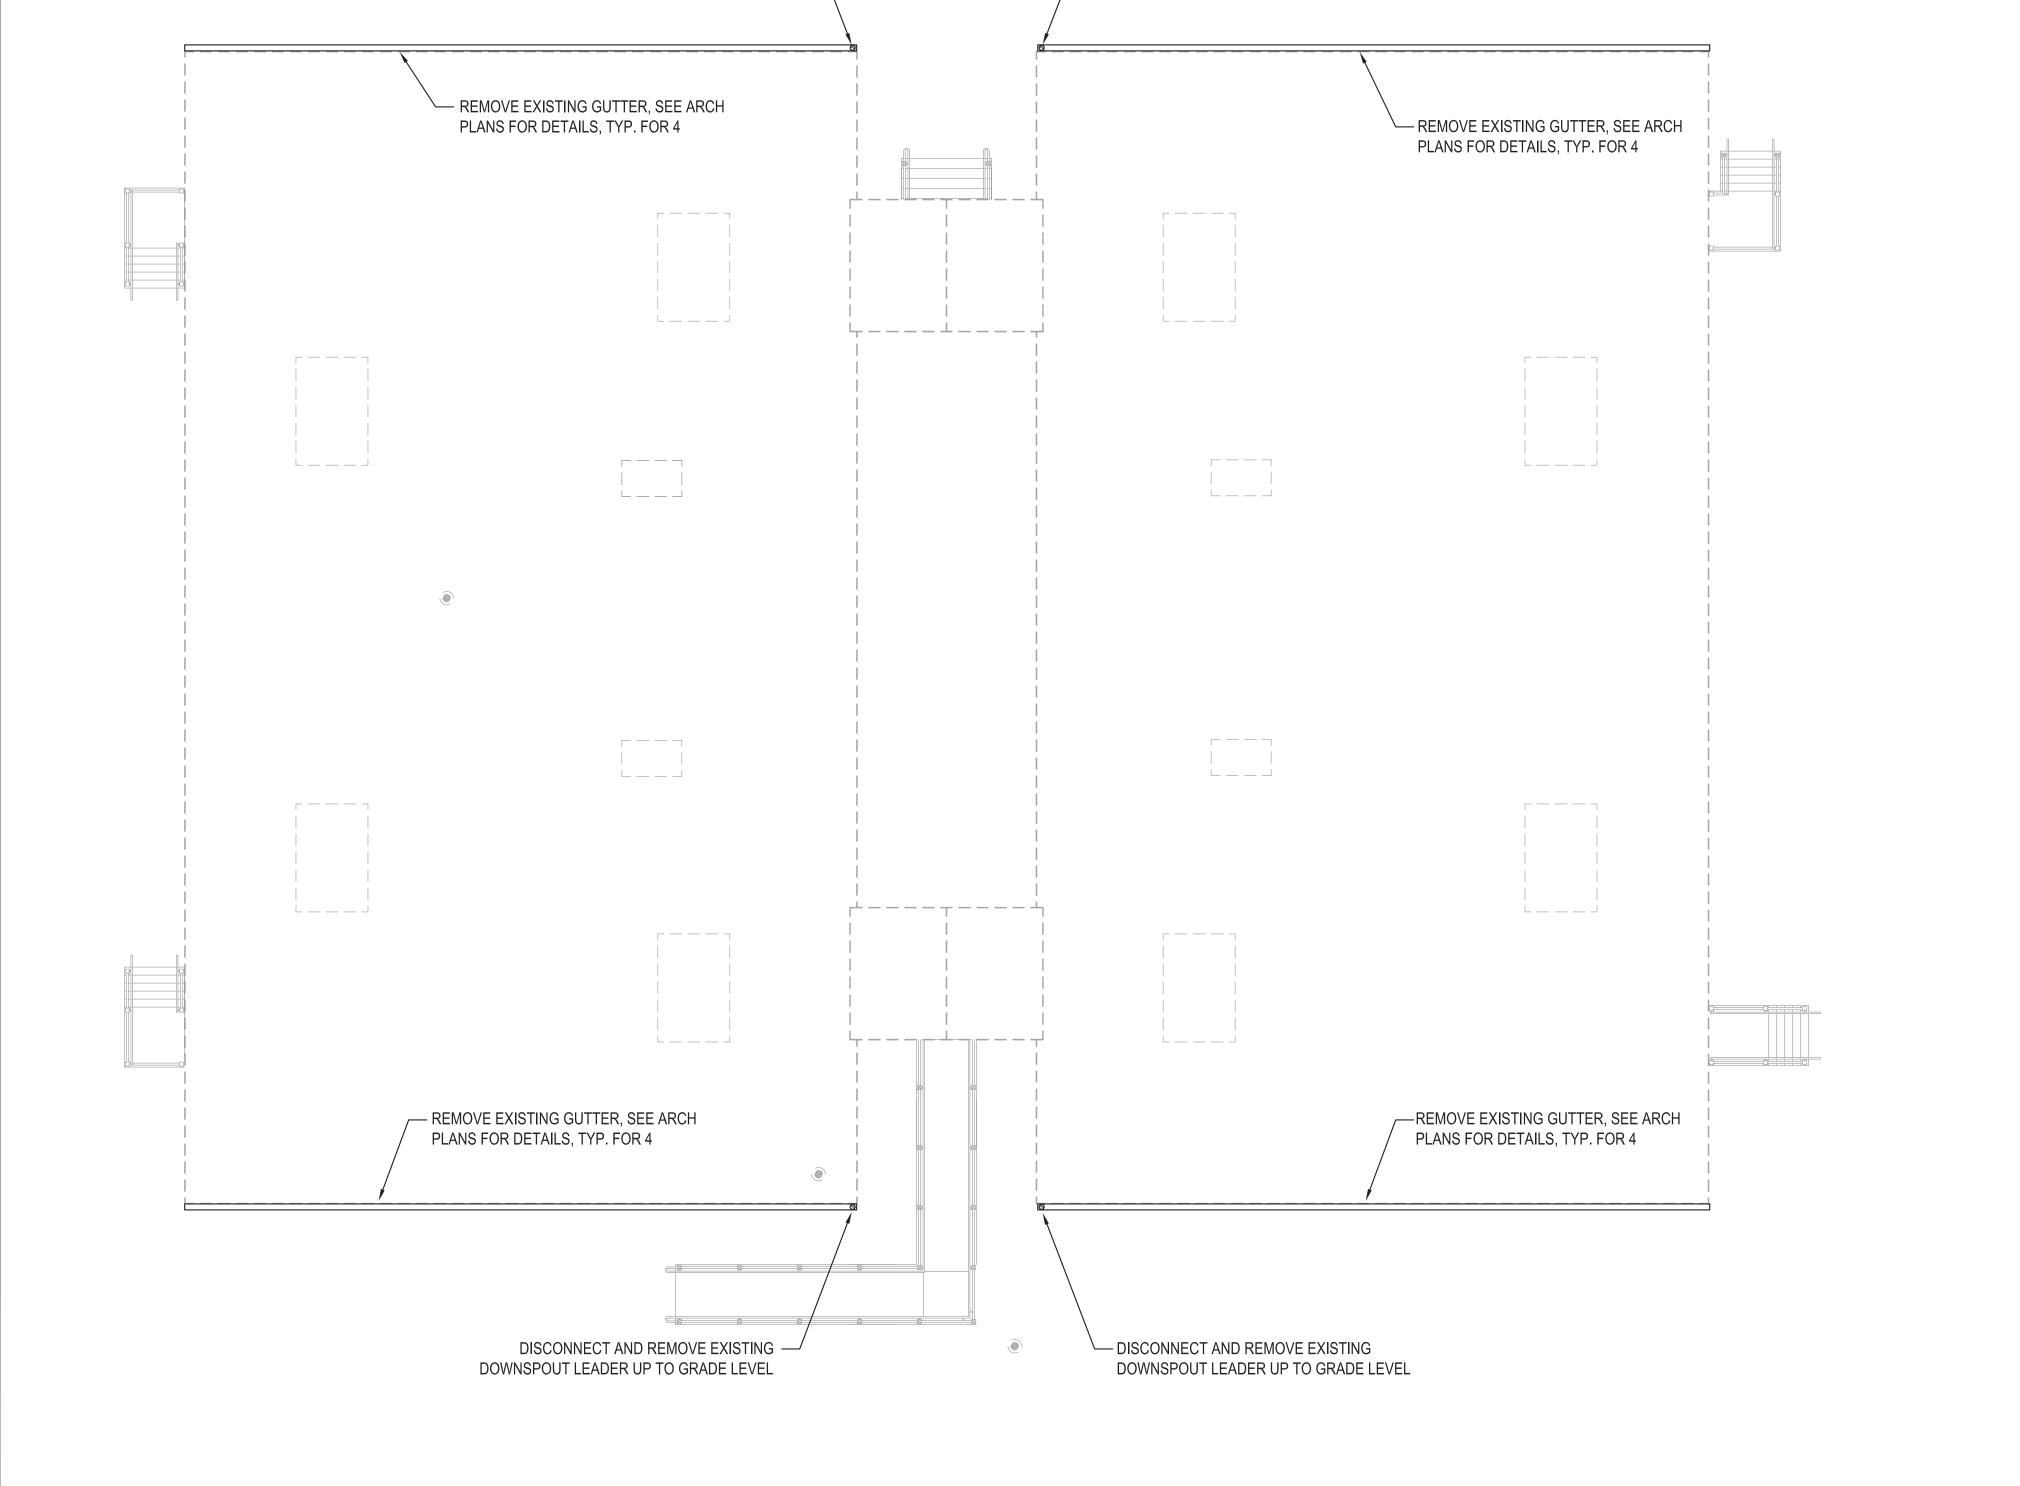

— DISCONNECT AND REMOVE EXISTING

DOWNSPOUT LEADER UP TO GRADE LEVEL

CONTRACTOR TO REPAIR ANY HOLES AND

DAMAGE LEFT BY REMOVAL OF EXISTING DOWNSPOUTS, AND AS COORDINATED WITH

ARCHITECTURAL DRAWINGS.

DISCONNECT AND REMOVE EXISTING —

DOWNSPOUT LEADER UP TO GRADE LEVEL



FACULTY OFFICE BUILDING (FOB) ROOF DEMO PLAN SCALE: 1/8"=1'-0"



PLUMBING KEY NOTES

- 1) INSTALL AND FURNISH ZURN RD2150 NEW ROOF DRAIN DOME AND CLAMP ON EXISTING ROOF DRAIN BODY. SEE ARCH 1/A-420 FOR INSTALLATION DETAILS.
- PROVIDE FALL PROTECTION AS PER NYS MC 304.11, REFER TO ARCH DWG FOR MORE DETAILS.
- ③ EXTEND EXISTING VENT TO MINIMUM OF 18" FROM NEW FINISHED ROOF.
- 4 EXISTING ROOF DRAIN TO REMAIN.
- (5) EXTEND EXISTING PLUMBING VENT ON ROOF TO MINIMUM OF 3 FT ABOVE TOP OF MECHANICAL AIR INTAKE. CONTRACTOR TO VERIFY EXACT LOCATION IN FIELD.

PROGRAM UNIT:

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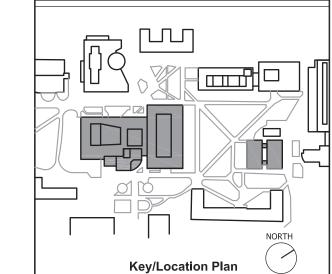
SUNY NEW PALTZ Building Address: 1 HAWK DRIVE, NEW PALTZ, NY 12561 **Building:**

SMILEY ARTS BUILDING, COLLEGE THEATRE DORSKY MUSEUM AND FACULTY OFFICE BUILDING

County of: ULSTER

Facility:

Project No.: 081047-00



Contract Title: ROOF REPLACEMENT - SMILEY ARTS, COLLEGE THEATRE, DORSKY MUSEUM AND FACULTY OFFICE

Project No.: 081047-00

PLUMBING - SAB ROOF CONSTRUCTION

Seal & Signature:



HON CHANG, P.E. JANUARY 8, 2021

AS NOTED Drawing No.:

P102.00 36 of 47

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NEW YORK, NY 10018


Facility:

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County of: ULSTER

Project No.: 081047-00



Contract Title: ROOF REPLACEMENT - SMILEY ARTS, COLLEGE THEATRE, DORSKY MUSEUM AND FACULTY OFFICE BUILDING

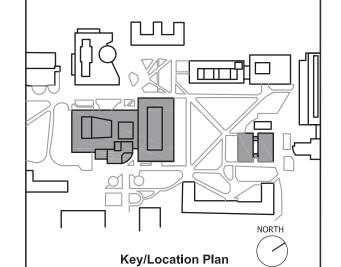Project No.: 081047-00

Drawing Title: PLUMBING - FOB ROOF CONSTRUCTION




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AS NOTED Scale: Drawing No.:

P104.00

37 of 47

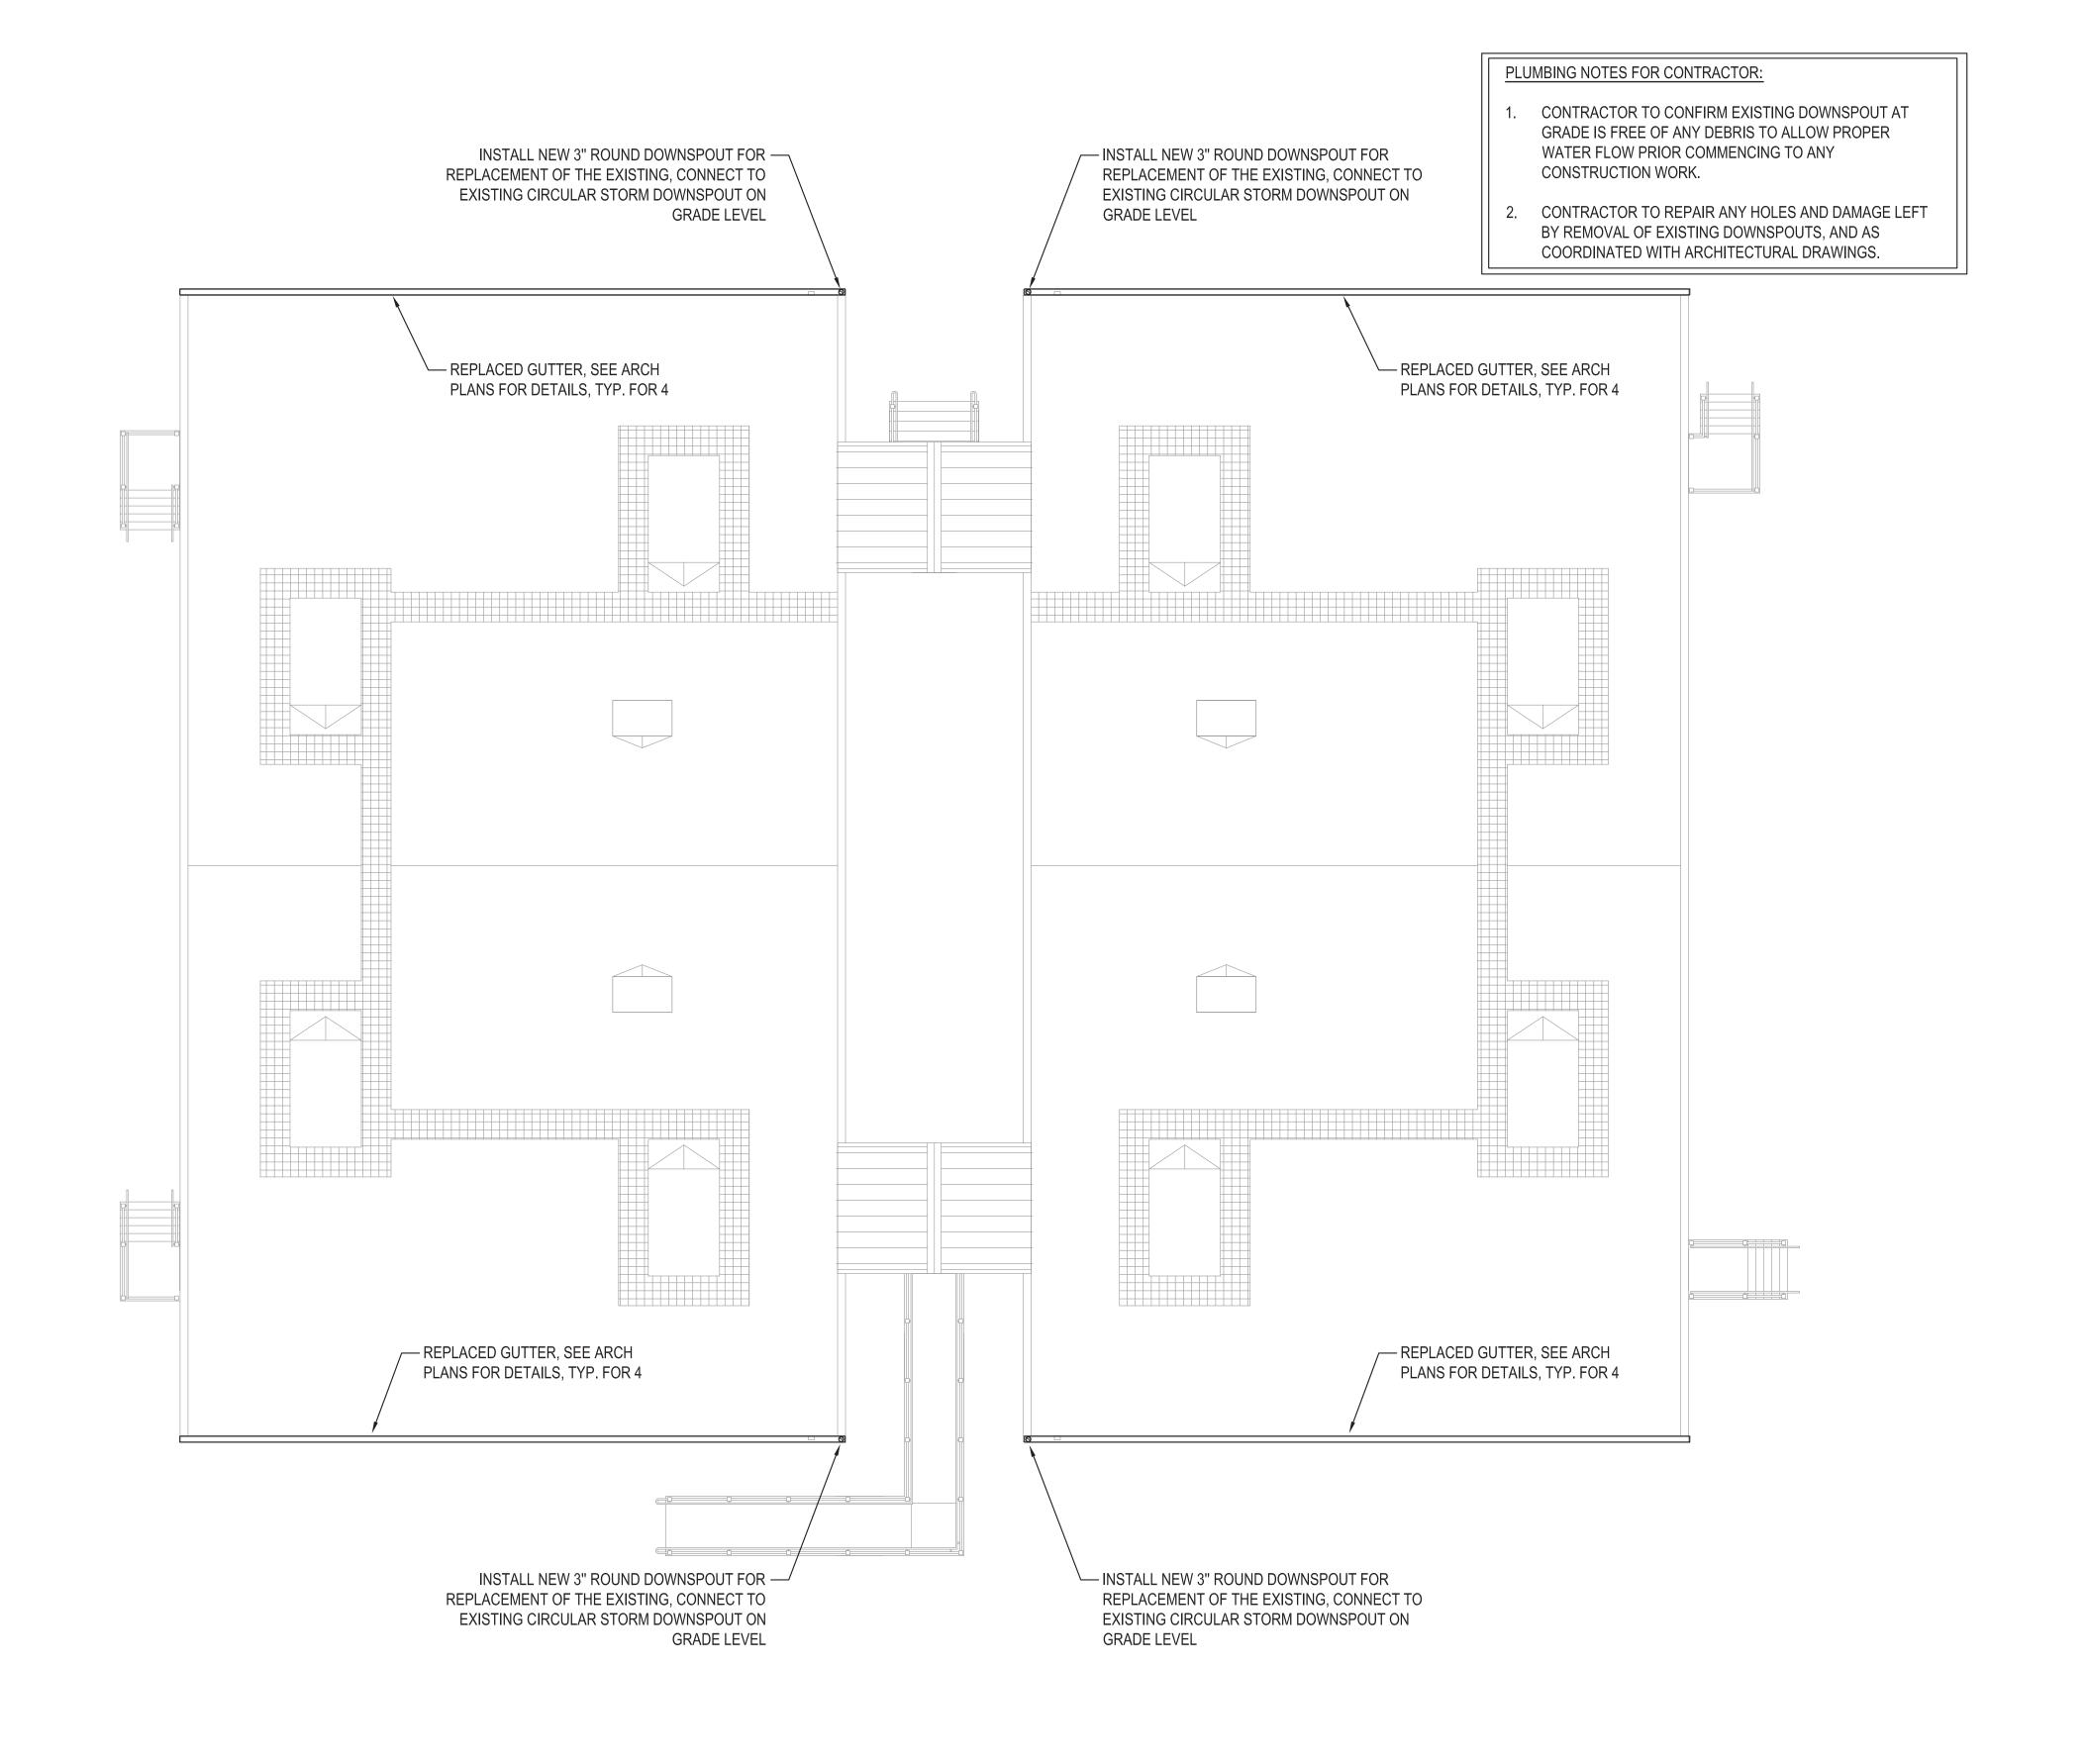

FACULTY OFFICE BUILDING (FOB) ROOF PLAN

SCALE: 1/8"=1'-0"

1ST FL

PARTIAL SAB ROOF STORM RISER DIAGRAM I SCALE: NONE

INSTALL NEW ROOF DRAIN DOME AND CLAMP ON TOP OF EXISTING ROOF DRAIN BODY, TYP. TO ALL ☐INSTALL NEW ROOF DRAIN DOME AND CLAMP ON TOP OF EXISTING ROOF DRAIN BODY, TYP. TO ALL EX. ROOF DRAIN — LEX. STORM TO REMAIN, BODY TO REMAIN, TYP. FOR ALL TYP. FOR ALL CONTINUE ON 1/P301 ROOF

1ST FL

EX. ROOF DRAIN-

BODY TO REMAIN, TYP. FOR ALL

LEX. STORM TO REMAIN,

TYP. FOR ALL

PARTIAL SAB ROOF STORM RISER DIAGRAM II SCALE: NONE



PROGRAM UNIT:

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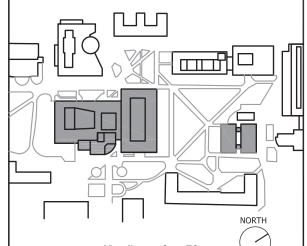
Facility: SUNY NEW PALTZ

Building Address: 1 HAWK DRIVE, NEW PALTZ, NY 12561 **Building:** SMILEY ARTS BUILDING,

COLLEGE THEATRE DORSKY MUSEUM AND FACULTY OFFICE BUILDING

County of: ULSTER

Project No.: 081047-00



Key/Location Plan

Contract Title: ROOF REPLACEMENT - SMILEY ARTS, COLLEGE THEATRE, DORSKY MUSEUM AND FACULTY OFFICE BUILDING

Project No.: 081047-00

Drawing Title: PLUMBING - RISER DIAGRAM I

Seal & Signature:



Drawn By: **XUEZHI FENG** HON CHANG, P.E. JANUARY 8, 2021 AS NOTED


Drawing No.:

1ST FL

SMILEY ART BUILDING ROOF STORM RISER DIAGRAM

TYP. FOR ALL

SCALE: NONE

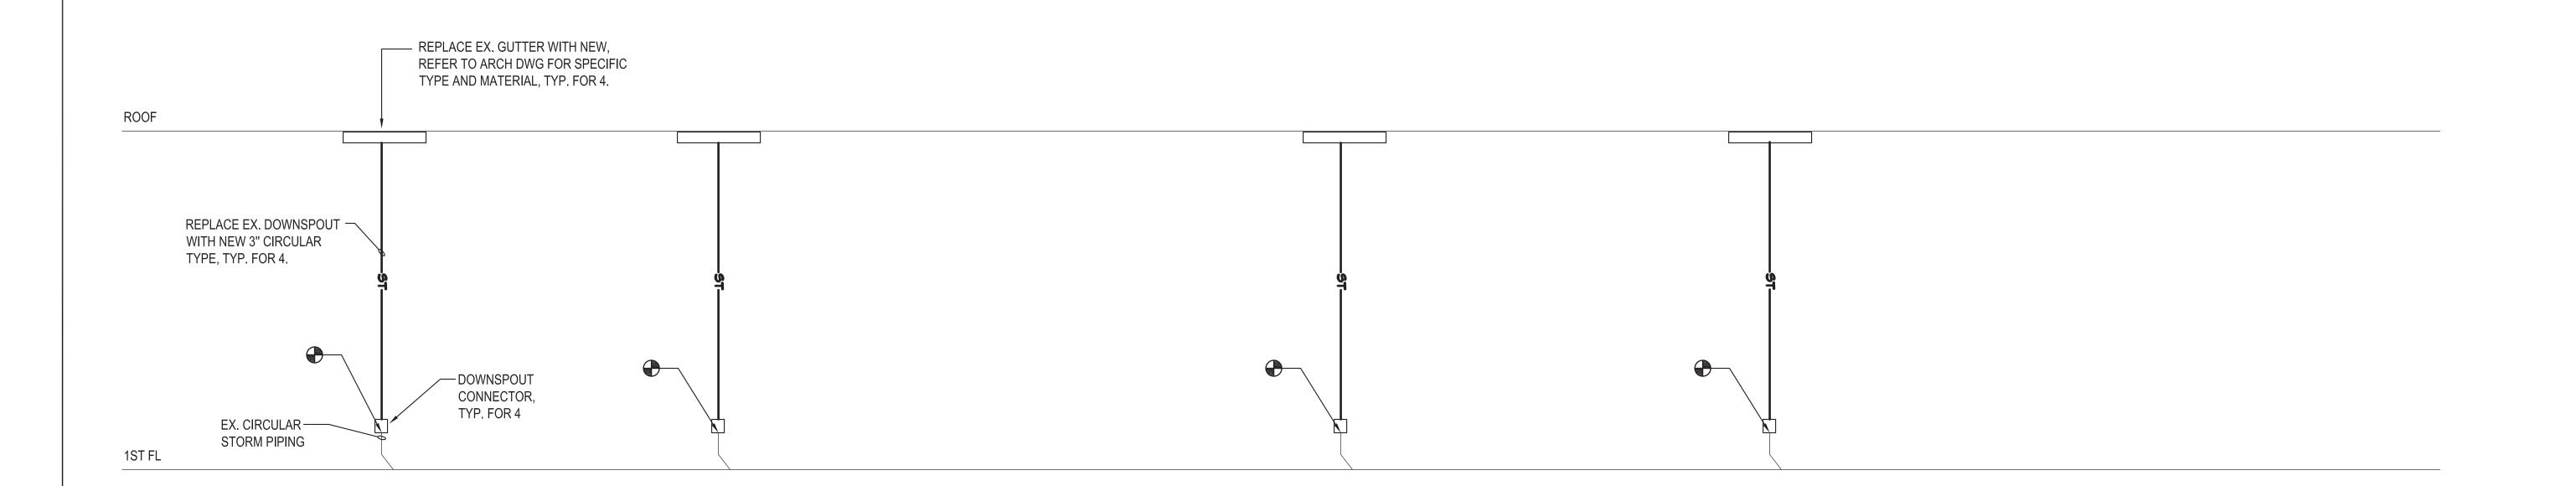

FOB STORM RISER DIAGRAM SCALE: NONE

PROGRAM UNIT:

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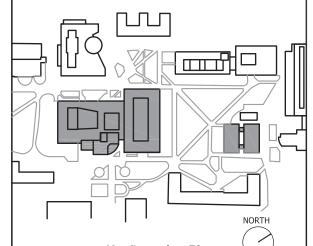
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Contract Title:
ROOF REPLACEMENT - SMILEY ARTS,
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MUSEUM AND FACULTY OFFICE BUILDING

Project No.: 081047-00

Drawing Title:

PLUMBING - RISER DIAGRAM II



Drawn By: Checked By: HON CHANG, P.E. JANUARY 8, 2021 Scale:

AS NOTED Drawing No.: P302.00

LIGHTING AND POWER SYMBOLS

SYMBOL	DESCRIPTION
LP-1,3	HOME RUN-NOTATION INDICATES PANEL AND CIRCUIT NUMBER, No. OF ARROWS DENOTES No. OF CIRCUITS. 2#12+1#12G-3/4"C. IS MINIMUM FEEDER TO BE PROVIDED. U.O.N. PROVIDE SEPARATE NEUTRAL FOR EACH CIRCUIT AND PROVIDE GROUND WIRE IN EACH HOME RUN. (1,3) DENOTES 2 POLE CIRCUIT, (1, 3, 5) DENOTES 3 POLE CIRCUIT
~	CONTINUATION OR WIRING & CONDUIT RUN CONCEALED IN CEILING, WALL OR FLOOR
0	RISER CONDUIT UP, WITH WIRING.
•	RISER CONDUIT DOWN, WITH WIRING.
J J	CEILING MOUNTED JUNCTION/SPLICE BOX, SIZE AS REQUIRED. SUBSCRIPT 'F' INDICATES FLOOR MOUNTED.
<u> </u>	GROUND
	LIGHTING AND POWER PANELBOARD, FLUSH MOUNTED IN WALL WITH COVER INDICATED.
	LIGHTING AND POWER PANELBOARD, SURFACE MOUNTED ON WALL.
—	CIRCUIT BREAKER.
\$ _a	SINGLE POLE TOGGLE SWITCH. SUBSCRIPT DENOTES FIXTURES CONTROLLED. 'K' INDICATES KEY OPERATED. '3' INDICATES THREE-WAY SWITCH.
GFI ①2	WALL MOUNTED DUPLEX THREE WIRE GROUNDED RECEPTACLE, 20A, 125V. MOUNTED 18"AFF SUBSCRIPT 'GFI' INDICATES WITH GROUND FAULT PROTECTION SUBSCRIPT 'WP' INDICATES WEATHER PROOF, S - DENOTES WITH SURGE SUPPRESSION. K - INDICATES SAFETY TYPE, NUMERAL INDICATES CIRCUIT NUMBER. GFI - GROUND FAULT INTERRUPTER TYPE
	SYMBOLS SHOWN WITH DARK SOLID LINES - INDICATES NEW WORK IN CONTRACT
	SYMBOLS SHOWN WITH LIGHT SOLID LINES - INDICATES EXISTING TO REMAIN
	SYMBOLS SHOWN WITH DASHED LINES - INDICATES TO BE REMOVED
	EXISTING PANELBOARD
5	MOTOR. HORSEPOWER INSCRIBED.
-	FUSED SWITCH, RATING AND FUSING INDICATED.
	UNFUSED SWITCH.
\$_	MOTOR STARTER TOGGLE SWITCH WITH THERMAL OVERLOAD
Р	PULL BOX
	UNFUSED DISCONNECT SWITCH, 30A/3P, U.O.N.
	RTU UNIT OR FAN AS INDICATED
H	REINSTALL EXISTING LIGHTING FIXTURE
HN	NEW LIGHTING FIXTURE

DEMOLITION SYMBOLS

EACH DEMOLITION SYMBOL DENOTES DEMO OF DEVICE. U.O.N, EXISTING HOMERUN POWER WIRING AND CONDUIT SHALL REMAIN UPTO NEAREST POINT INSIDE THE BUILDING BELOW ROOF.

SYMBOL	DESCRIPTION
L — — J	EXISTING UNIT TO BE REMOVED, OR REMOVED AND RELOCATED AS NOTED
+[]	DISCONNECT, REMOVE AND STORE EXISTING LIGHTING FIXTURE AND ASSOCIATED SUPPORTS FOR REINSTALLATION

ABBREVIATIONS

SYMBOL	DESCRIPTION	SYMBOL	DESCRIPTION
A, AMPS AC AIC AFF ARCH A/C B.O.E. C CAB CB CKT(S) CLG CONST. COL CORR CP DB DISC DIST DP D.R. DWG EC ECL	AMPERE ALTERNATING CURRENT AMPERES INTERRUPTING CAPACITY ABOVE FINISHED FLOOR ARCHITECTURAL AIR CONDITIONING BOARD OF EDUCATION CONDUIT CABINET CIRCUIT BREAKER CIRCUIT(S) CEILING CONSTRUCTION COLUMN CORRIDOR CONTROL PANEL DISTRIBUTION BOARD DISCONNECT DISTRIBUTION DISTRIBUTION PANEL DUPLEX RECEPTACLE DRAWING EMPTY CONDUIT ELECTRICAL CLOSET	FACP FL G, GND GFI IG JB KVW KWH LTG MDB MIN MLO MTD N P PB PNL RGS RM SP STD SW SWBD TEL TVSS TV TYP	FIRE ALARM CONTROL PANEL FLOOR GUARD GROUND GROUND FAULT INTERRUPTER ISOLATED GROUND JUNCTION BOX KILOVOLT AMPERE KILOWATT KILOWATT HOUR LIGHTING MAIN DISTRIBUTION BOARD MAIN CIRCUIT BREAKER MINIMUM MAIN LUGS ONLY MOUNTED NEUTRAL POLE(S) PULL BOX PANEL RIGID GALVANIZED STEEL CONDUIT ROOM SPARE STANDARD SWITCH SWITCHBOARD TELEPHONE TRANSIENT VOLTAGE SURGE SUPPRESSIO TELEVISION TYPICAL

GENERAL NOTES

- 1. ALL WORK SHALL BE PERFORMED IN STRICT ACCORDANCE WITH THE 2017 NATIONAL ELECTRICAL CODE, THE NFPA, THE 2018 INTERNATIONAL BUILDING CODE. AND ALL GOVERNING LOCAL CODES, LAWS, AND REGULATIONS.
- 2. THE CONTRACTOR SHALL, IN A WORKMANLIKE MANNER, PROVIDE A COMPLETE OPERABLE SYSTEM. OUTLINE DESCRIPTION AND EQUIPMENT DO NOT LIMIT CONTRACTOR LIABILITY FOR THE INSTALLATION OF A COMPLETE OPERABLE SYSTEM.
- 3. THE CONTRACTOR SHALL VISIT THE SITE AND BECOME FAMILIAR WITH ALL EXISTING CONDITIONS THAT MAY AFFECT HIS WORK AND SHALL NOT BE ENTITLED TO ADDITIONAL COMPENSATION FOR HIS FAILURE TO DO SO.
- 4. CONTRACTOR SHALL BEAR THE COST OF ALL ELECTRICAL PERMITS INSPECTIONS.
- 5. MINIMUM SIZE OF CONDUITS FOR BOTH LIGHTING AND POWER CIRCUITS SHALL BE 3/4"C, U.O.N.
- 6. UNLESS OTHERWISE NOTED, ALL WIRES SHALL BE OF TYPE THHN/THWN AND MINIMUM SIZE FOR LIGHTING AND POWER CIRCUITS SHALL BE #12 AWG.
- 7. FOR ALL BRANCH CIRCUIT RATED AT 120V, 15A OR 20A THAT RUNS OVER 100'-0", No. 10 WIRE SIZE SHALL BE USED TO COMPENSATE FOR VOLTAGE DROP.
- UNLESS OTHERWISE NOTED, PULL AND JUNCTION BOXES WHERE INDICATED ON DRAWINGS, SHALL BE CONSIDERED SHOWN AT THEIR APPROXIMATE LOCATION. THE CONTRACTOR SHALL LOCATE THEM AS FIELD CONDITIONS DICTATE. ADDITIONAL PULL AND JUNCTION BOXES NOT SHOWN ON DRAWINGS SHALL BE PROVIDED WHERE REQUIRED BY APPLICABLE CODE PROVISIONS OR FIELD CONDITIONS. PULL AND JUNCTION BOXES SHALL BE SURFACE TYPE IN UNFINISHED AREAS AND FLUSH TYPE IN FINISHED AREAS.
- 9. NO CONDUIT SHALL BE RUN IN ANY FLOOR IN CONTACT WITH THE EARTH UNLESS OTHERWISE DIRECTED ON THE PLAN. ALL EXTERIOR AND UNDERGROUND CONDUITS SHALL BE RIGID GALVANIZED STEEL.
- 10. ALL PENETRATIONS THROUGH FIRE RATED WALLS AND FLOORS SHALL BE SMOKE/FIRE STOPPED.
- 11. THIS CONTRACTOR SHALL PROVIDE SEPARATE RACEWAYS FOR CONDUCTORS ON NORMAL AND EMERGENCY CIRCUITS.
- 12. ALL WIRING AND CONDUIT LAYOUT ON DRAWINGS ARE SHOWN DIAGRAMMATIC. LOCATION OF EQUIPMENT AND RUNS MAY VARY DUE TO PHYSICAL CONDITIONS AT NO ADDITIONAL COST TO OWNER.
- 13. ALL EXPOSED NONCURRENT-CARRYING METAL PARTS OF ELECTRICAL EQUIPMENT AND RACEWAYS SHALL BE GROUNDED. THE CONTRACTOR SHALL ENSURE CONTINUITY OF THE GROUNDING CIRCUIT FROM THE SUPPLYING PANELBOARD GROUNDING BUS TO THE LOAD GROUND TERMINAL. THE RESISTANCE FROM THE SERVICE EQUIPMENT GROUNDBUS TO ANY LOAD GROUND TERMINAL SHALL NOT EXCEED ONE (1) OHM.
- 14. ALL ELECTRICAL EQUIPMENT AND ACCESSORIES INSTALLED OUTSIDE OR EXPOSED TO WEATHER SHALL HAVE NEMA 3R ENCLOSURES AND SHALL BE TIGHTLY GASKETED FOR A COMPLETE RAIN TIGHT INSTALLATION.
- 15. ALL EQUIPMENT SPECIFIED OR REQUIRED SHALL HAVE COPPER CURRENT CARRYING PARTS INCLUDING GROUND BUS AND TERMINALS.
- 16. CONTRACTOR SHALL BE RESPONSIBLE FOR ALL RESTORATIONS, SEALING, WATERPROOFING, PENETRATIONS, CUTTING, PATCHING, AND PAINTING FOR THE COMPLETE CONTRACT WORK INDICATED. ALL RESTORATION WORK PERFORMED BY CONTRACTOR SHALL RESTORE DISTURBED SURFACES TO THEIR ORIGINAL CONDITION.
- 17. WHEREVER EXISTING WIRING AND CONDUIT IS EXTENDED, EXTEND WITH THE SAME SIZE AS EXISTING WIRING AND CONDUIT. VERIFY EXISTING WIRING AND CONDUIT SIZES IN FIELD.
- 18. PAINT ALL EXPOSED CONDUITS IN FINISHED AREAS TO MATCH EXISTING ADJACENT SURFACES.
- 19. PROVIDE NEW SUPPORTS WHERE CONDUITS OR CABLES ARE TO BE REINSTALLED. CONTRACTOR SHALL TRACE ALL EXISTING CIRCUITS TO PANELS IMPACTED BY THIS WORK.
- 20. CONTRACTOR WILL PROVIDE MINIMUM 5 DAYS NOTICE FOR ANY POWER AND FIRE ALARM DISRUPTION.
- 21 ALL EXPOSED CONDUITS ON ROOF SHALL BE PAINTED TO MATCH THE ROOF COLOR.
- 22. THE CONTRACTOR SHALL CHECK / TRACE THE SOURCE OF POWER FOR ALL MECHANICAL EQUIPMENT TO BE REMOVED, REINSTALLED OR REPLACED IN THIS CONTRACT AND TAG ALL EQUIPMENT PROPERLY BEFORE REMOVAL.
- 23. ALL EQUIPMENT SHALL BE PROVIDED AS SPECIFIED OR APPROVED EQUAL.
- 24. PATCH AND PAINT AREAS WHERE EXISTING CONDUIT HAS BEEN REMOVED.
- 25. FOR THE UNITS TO BE REMOVED AND THE UNITS TO BE REMOVED AND REPLACED WITH NEW, DISCONNECT AND REMOVE EXISTING WIRING TO SOURCE. REMOVE EXISTING CONDUIT UP TO THE CEILING OF THE FLOOR BELOW ROOF. ABONDON THE REST OF EXISTING CONDUIT IN PLACE.



PROGRAM UNIT:

MSA





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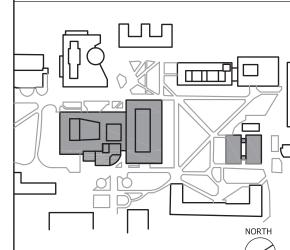
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Building Address:
1 HAWK DRIVE, NEW PALTZ, NY 12561
Building:

SMILEY ARTS BUILDING,
COLLEGE THEATRE
DORSKY MUSEUM AND
FACULTY OFFICE BUILDING

County of: ULSTER **Project No.:** 081047-00



Key/Location Plan

Contract Title:
ROOF REPLACEMENT - SMILEY ARTS,
COLLEGE THEATRE, DORSKY
MUSEUM AND FACULTY OFFICE
BUILDING

Project No.: 081047-00

Drawing Title:

ELECTRICAL SYMBOLS, NOTES & ABBREVIATIONS

Seal & Signature:



Drawn By: Checked By:

Date: JANUARY 8, 2021
Scale: AS NOTED

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DEMOLITION NOTES

- 1. PROVIDE ALL LABOR, EQUIPMENT AND MATERIALS AS REQUIRED FOR THE COMPLETE DEMOLITION AND REMOVAL AS NOTED.
- 2. THE DEMOLITION WORK SHALL BE CARRIED ON IN EVERY RESPECT IN A THOROUGH AND WORKMANLIKE MANNER.
- 3. ALL DEMOLITION, REMOVAL, AND DISPOSAL WORK SHALL BE IN COMPLIANCE WITH THE REQUIREMENTS OF THE PREVAILING FEDERAL AND STATE CODES AND REGULATIONS.
- 4. REMOVE ALL DEBRIS NOT EXPLICITLY DESIGNATED TO BE SALVAGED (TO REMAIN) FROM THE PREMISES AND LEGALLY DISPOSE OFF AWAY FROM PREMISES.
- 5. CAREFULLY REMOVE AND PROTECT ALL ITEMS TO BE SAVED AND REUSED AS INDICATED ON DRAWINGS. REPLACE ANY ITEMS THAT ARE DAMAGED BY REMOVAL AT YOUR OWN COST. NOTIFY THE AUTHORITY IN WRITING OF ANY ITEM THAT IS DAMAGED PRIOR TO REMOVAL SO THAT THEY MAY ASCERTAIN THE ITEM'S CONDITION
- 6. PROTECT BUILDING MATERIALS, SURFACES AND STRUCTURES, WHICH ARE TO REMAIN, FROM DAMAGE; IF DAMAGE OCCURS, REPAIR OR REPLACEMENT SHALL BE MADE BY THE CONTRACTOR, TO THE SATISFACTION OF THE AUTHORITY, AND AT THE EXPENSE OF THE CONTRACTOR. ALL DISTURBED AREAS SHALL BE FINISH TO MATCH EXISTING CONDITIONS.
- 7. VISIT AND EXAMINE CAREFULLY THE AREAS AFFECTED BY THIS WORK TO BECOME FAMILIAR WITH THE EXISTING CONDITIONS AND WITH THE DIFFICULTIES THAT ATTEND THE EXECUTION OF THIS WORK. LATER CLAIMS WILL NOT BE RECOGNIZED FOR EXTRA LABOR, EQUIPMENT, OR MATERIALS REQUIRED BECAUSE OF DIFFICULTIES ENCOUNTERED.
- 8. COORDINATE WITH SITE PERSONNEL TO MINIMIZE IMPACT OF OPERATION OF THE BUILDING DURING DEMOLITION AND CONSTRUCTION.
- WHEN POWER SHUTOFF IS REQUIRED, CONTRACTOR IS TO MAINTAIN CONTINUOUS SERVICE ON FEEDERS SERVING THE AREAS AFFECTED DURING ALL THE PERIOD THE AREA IS UNDER CONSTRUCTION. NO OUTAGES WILL BE PERMITTED IN THESE AREAS DUE TO THE CONSTRUCTION PHASE. ALL WORK REQUIRING TEMPORARY SHUTDOWN SHALL BE PERFORMED AT NO ADDITIONAL COST TO THE OWNER. ANY APPROVAL FOR POWER SHUTDOWNS SHOULD BE BROUGHT TO THE ATTENTION OF THE OWNER AND IT MUST BE NOTIFIED IN WRITING 5 DAYS IN ADVANCE.

FIRE ALARM NOTES

- 1. ALL NEW DEVICES SHALL MATCH EXISTING. IT IS THE RESPONSIBILITY OF THE CONTRACTOR TO CONTACT THE EXISTING BUILDING'S FIRE ALARM VENDOR FOR SYSTEM INFORMATION AS IT RELATES TO CONNECTION TO EXISTING SYSTEM (EDWARDS EST3). INCLUDING EXISTING FIRE ALARM SYSTEM RE-PROGRAMMING. ALL MATERIALS AND INSTALLATION SHALL COMPLY WITH NFPA 72, 101 ADA AND THE 2017 NATIONAL ELECTRICAL CODE.
- 2. FIRE ALARM WIRING SHALL MATCH EXISTING. CONTRACTOR SHALL COORDINATE ALL WIRING REQUIREMENTS WITH FIRE ALARM SYSTEM'S MANUFACTURER'S RECOMMENDATION.
- 3. CONTRACTOR SHALL FURNISH AND INSTALL ALL FIRE ALARM DEVICES, WIRING AND RELATED DEVICES, FINAL WIRING TERMINATION TO THE FACP SHALL BE PERFORMED BY THE BUILDING'S FIRE ALARM SYSTEM VENDOR APPROVED ELECTRICIAN UNDER THIS CONTRACT.
- 4. CONNECT ALL DEVICES TO NEAREST EXISTING FIRE ALARM LOOP SERVING THE AREA.
- 5. FLEXIBLE METAL CONDUIT WILL BE PERMITTED ONLY FOR FINAL CONNECTIONS TO SENSING OR ALARM DEVICES AND SHALL BE UNDERWRITERS LABELED AND OF LENGTHS NOT EXCEEDING 24" WHERE A RIGID CONNECTION CANNOT BE MADE.
- 6. ALL INSTALLATION SHALL BE PER NFPA 72 AND ADA REQUIREMENTS.
- 7. ALL DUCT SMOKE DETECTORS SHALL BE PHOTOELECTRIC TYPE. ALL EXISTING DUCT SMOKE DETECTORS ARE LOCATED AT THE FLOOR LEVEL BELOW ROOF.
- 8. CONTRACTOR SHALL PROVIDE FIRE WATCH DURING THE PERIOD WHEN FIRE ALARM SYSTEM IS DISABLED. PROVIDE FIVE DAYS NOTICE TO SUNY FOR ANY FIRE ALARM SYSTEM SHUTDOWN.
- 9. EXISTING FIRE ALARM SEQUENCE OF OPERATION SHALL BE MAINTAINED. NEW DEVICES SHALL WORK AS A PART OF EXISTING FIRE ALARM SYSTEM.
- 10. RETEST EXISTING FIRE ALARM SYSTEM FOR PROPER OPERATION AFTER RECONNECTION OF ALL NEW DEVICES AND EQUIPMENT.
- 11. VENDER OF FIRE ALARM SYSTEM IS FIRE SECURITY AND SOUND SYSTEM (TEL # 518-250-4364)

TEMPORARY LIGHTING AND POWER

- 1. PROVIDE TEMPORARY POWER AND LIGHTING FOR ALL TRADES DURING CONSTRUCTION.
- 2. CONTRACTOR WILL PROVIDE MINIMUM 5 DAYS NOTICE FOR ANY POWER AND FIRE ALARM DISRUPTION.
- 3. PROVIDE POWER TO TEMPORARY UNITS FOR COOLING AS REQUIRED. SEE DWG E-401.

PHASING

- 1. ANY PHASING INFORMATION WHERE PROVIDED IN THE CONTRACT DOCUMENTS ARE TO PROVIDE THE INTENT OF PHASING WORK ONLY AND MAY NOT INCLUDE ALL INFORMATION REQUIRED TO MEET THE INTENT OF THE OWNERS REQUIREMENTS. IT IS THE CONTRACTORS RESPONSIBILITY TO VERIFY THE PHASING REQUIREMENTS, METHODOLOGY, SCHEDULE, COORDINATION WITH THE OWNER.
- IN ALL ASPECTS OF PHASING WORK, ALL ITEMS SHALL BE IN FULL COMPLIANCE WITH THE CURRENT CODE AND STANDARDS.
- 3. ALL PHASES OF THE PROJECTS SHALL ENSURE STANDALONE FULLY FUNCTIONAL CODE COMPLIANT SYSTEM REQUIRED FOR AN OCCUPIED SPACE USE.
- 4. ALL PHASING COSTS SHALL BE INCLUDED IN THE PROJECT BID.
- 5. COORDINATE ALL WORK WITH ARCH PHASING PLAN. SEE DWG T002 FOR ARCH PHASING PLAN.

SPECIFIC NOTES

1. PRIOR TO COMMENCEMENT OF WORK, CONTRACTOR SHALL IN THE PRESENCE OF SUNNY REPRESENTATIVE, TEST THE FIRE ALARM SYSTEM TO DETERMINE WHETHER EACH DEVICE IS FULLY OPERATIONAL. THE RESULT OF THE TEST SHALL BE CLEARLY DOCUMENTED AND SIGNED BY ALL PRESENT. ANY DEVICES NOT FUNCTIONING MUST BE NOTED AND REPORTED TO SUNNY REPRESENTATIVE.

RAWING LIST	
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DRAWING NAME ELECTRICAL SYMBOLS, NOTES, AND ABBREVIATIONS ELECTRICAL NOTES AND DRAWING LIST	PAGE NUMBER 1 OF 8
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	THEATRE AND DORSKY MUSEUM (SAB) ELECTRICAL ROOF REMOVAL PAN - FACULTY OFFICE BUILDING ELECTRICAL ROOF CONSTRUCTION PLAN - SMILEY ARTS, MCKENNA THEATRE AND DORSKY MUSEUM (SAB) ELECTRICAL ROOF CONSTRUCTION PLAN - FACULTY OFFICE BUILDING ELECTRICAL POWER TO TEMPORARY AC UNIT



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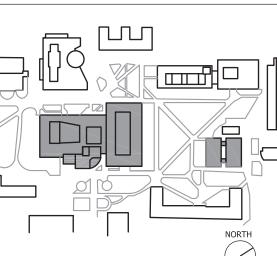
Building Address:

1 HAWK DRIVE, NEW PALTZ, NY 12561

Building:

SMILEY ARTS BUILDING,
COLLEGE THEATRE
DORSKY MUSEUM AND
FACULTY OFFICE BUILDING

County of: ULSTER **Project No.:** 081047-00



Key/Location Plan

Contract Title:
ROOF REPLACEMENT - SMILEY ARTS,
COLLEGE THEATRE, DORSKY
MUSEUM AND FACULTY OFFICE
BUILDING

Project No.: 081047-00

Drawing Title:

ELECTRICAL NOTES AND DRAWING LIST

Seal & Signature:



Checked By:

Date: JANUARY 8, 2021
Scale: AS NOTED

Drawing No.:

E002.00

ELECTRICAL ROOF REMOVAL PLAN - SMILEY ARTS, MCKENNA THEATRE AND DORSKY MUSEUM (SAB) SCALE: 1/16"=1'-0"

KEY NOTE (11)

REINSTALLED

KEY NOTE (12)

NOTES

- 1. SEE DWG E001.00 AND E002.00 FOR SYMBOLS, ABBREVIATIONS AND GENERAL NOTES.
- WHEREEVER THE CONDUITS ARE SHOWN TO BE REMOVED, CONDUITS / WIRING SHALL BE REMOVED UP TO THE NEAREST JUNCTION BOX INSIDE THE BUILDING.
- 3. THE CONTRACTOR SHALL TRACE THE POWER SOURCE FOR ALL ELECTRICAL EQUIPMENT IN FIELD.
- 4. DISCONNECT AND REMOVE EXISTING WIRING / CONDUITS ON ROOF IN THE WAY OF ROOF TO BE REPLACED.
- 5. CONTRACTOR WILL PROVIDE MINIMUM 5 DAYS NOTICE FOR ANY POWER AND FIRE ALARM DISRUPTION.
- FOR THE UNITS TO BE REMOVED AND THE UNITS TO BE REMOVED AND REPLACED WITH NEW, DISCONNECT AND REMOVE EXISTING WIRING TO SOURCE. REMOVE EXISTING CONDUIT UP TO THE CEILING OF THE FLOOR BELOW ROOF. ABONDON THE REST OF EXISTING CONDUIT IN PLACE.
- FOR EQUIPMENT TO BE REMOVED AND REINSTALLED, EXISTING HOMERUN WIRING AND CONDUIT SHALL REMAIN UPTO CEILING OF THE FLOOR BELOW ROOF.

KEY NOTES

- DISCONNECT EXISTING POWER WIRING AND CONDUIT AND FIRE ALARM WIRING AND CONDUIT FOR THE EXISTING SMOKE HATCH TO BE REMOVED UPTO THE NEAREST JUNCTION BOX INSIDE THE BUILDING. REMOVE POWER WIRING. CONDUIT TO PANEL SHALL REMAIN. REMOVE FIRE ALARM WIRING TO NEAREST FIRE ALARM DEVICE, CONDUIT SHALL REMAIN.
- EXISTING RTU / CHILLER TO REMAIN. PROTECT EXISTING POWER WIRING AND CONDUIT, PROVIDE TEMPORARY CONDUIT SUPPORTS AS REQUIRED.
- DISCONNECT AND REMOVE EXISTING POWER WIRING UPTO SOURCE IN ELECTRICAL ROOM AND CONDUIT FOR EXISTING RTU UPTO THE CEILING OF FLOOR BELOW. REMOVE ALL CONDUITS ON ROOF, ABONDON CONDUITS CONCEALED IN WALLS IN PLACE. PATCH AND PAINT AREAS WHERE CONDUIT HAS BEEN REMOVED. SEE NOTE # 6.
- GRAVITY VENT HAS NO POWER CONNECTION.
- DISCONNECT, REMOVE AND STORE EXISTING LIGHTING FIXTURE FOR REINSTALLATION. REMOVE EXISTING SUPPORTS ON ROOF AND STORE FOR REINSTALLATION. DISCONNECT AND REMOVE THE BRANCH CIRCUIT WIRING AND CONDUIT UP TO NEAREST JUNCTION BOX INSIDE THE BUILDING. HOMERUN WIRING CONDUIT SHALL REMAIN.
- LIGHTING FIXTURE IS MISSING AT THIS LOCATION. REMOVE EXISTING SUPPORTS ON ROOF AND STORE FOR REINSTALLATION. DISCONNECT AND REMOVE THE BRANCH CIRCUIT WIRING AND CONDUIT UP TO NEAREST JUNCTION BOX INSIDE THE BUILDING. HOMERUN WIRING CONDUIT SHALL
- FOR EXISTING HV UNIT TO BE REMOVED. DISCONNECT AND REMOVE POWER WIRING TO SOURCE IN ELECTRICAL ROOM AND CONDUIT TO THE CEILING OF FLOOR BELOW. ABONDON EXISTING BURRIED CONDUIT AND WIRING IN PLACE. DISCONNECT THE EXISTING DUCT SMOKE DETECTOR AT THE FLOOR BELOW. SEE NOTE # 6.
- DISCONNECT AND REMOVE POWER WIRING AND CONDUIT TO SOURCE IN MECHANICAL ROOM ON PENTHOUSE, FOR EXISTING EXHAUST FUME HOOD FAN TO BE REMOVED. ABONDON EXISTING BURRIED CONDUIT IN PLACE. SEE NOTE # 6.
- DISCONNECT AND REMOVE EXISTING POWER WIRING AND CONDUIT TO EXISTING EXHAUST FAN UPTO THE NEAREST JUNCTION BOX INSIDE THE BUILDING. HOMERUN WIRING AND CONDUIT TO PANEL SHALL REMAIN.
- DISCONNECT AND REMOVE EXISTING FIRE ALARM WIRING AND CONDUIT FOR DUCT SMOKE DETECTORS UP TO THE NEAREST JUNCTION BOX INSIDE THE BUILDING.
- DISCONNECT AND REMOVE EXISTING POWER WIRING AND CONDUIT FOR EXISTING CONDENSING UNIT UPTO THE NEAREST JUNCTION BOX INSIDE THE BUILDING. HOMERUN WIRING AND CONDUIT TO PANEL SHALL REMAIN.
- DISCONNECT AND REMOVE EXISTING POWER WIRING AND CONDUIT AND FIRE ALARM WIRING AND CONDUIT UPTO THE NEAREST JUNCTION BOX INSIDE THE BUILDING. POWER AND FIRE ALARM WIRING AND CONDUIT SHALL REMAIN.





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DORSKY MUSEUM AND


FACULTY OFFICE BUILDING

COLLEGE THEATRE

Building:

Project No.: County of: ULSTER 081047-00

1 HAWK DRIVE, NEW PALTZ, NY 12561

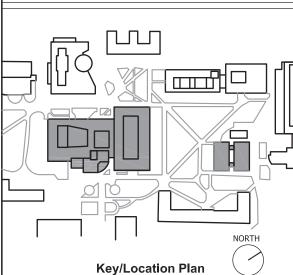

Contract Title: ROOF REPLACEMENT - SMILEY ARTS, COLLEGE THEATRE, DORSKY MUSEUM AND FACULTY OFFICE

Project No.: 081047-00

Drawing Title: ELECTRICAL ROOF REMOVAL PLAN - SMILEY ARTS, MCKENNA THEATRE AND DORSKY MUSEUM (SAB)


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BUILDING



Drawn By: Checked By: JANUARY 8, 2021 AS NOTED Scale:

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ELECTRICAL ROOF REMOVAL PLAN - FACULTY OFFICE BUILDING

NOTES

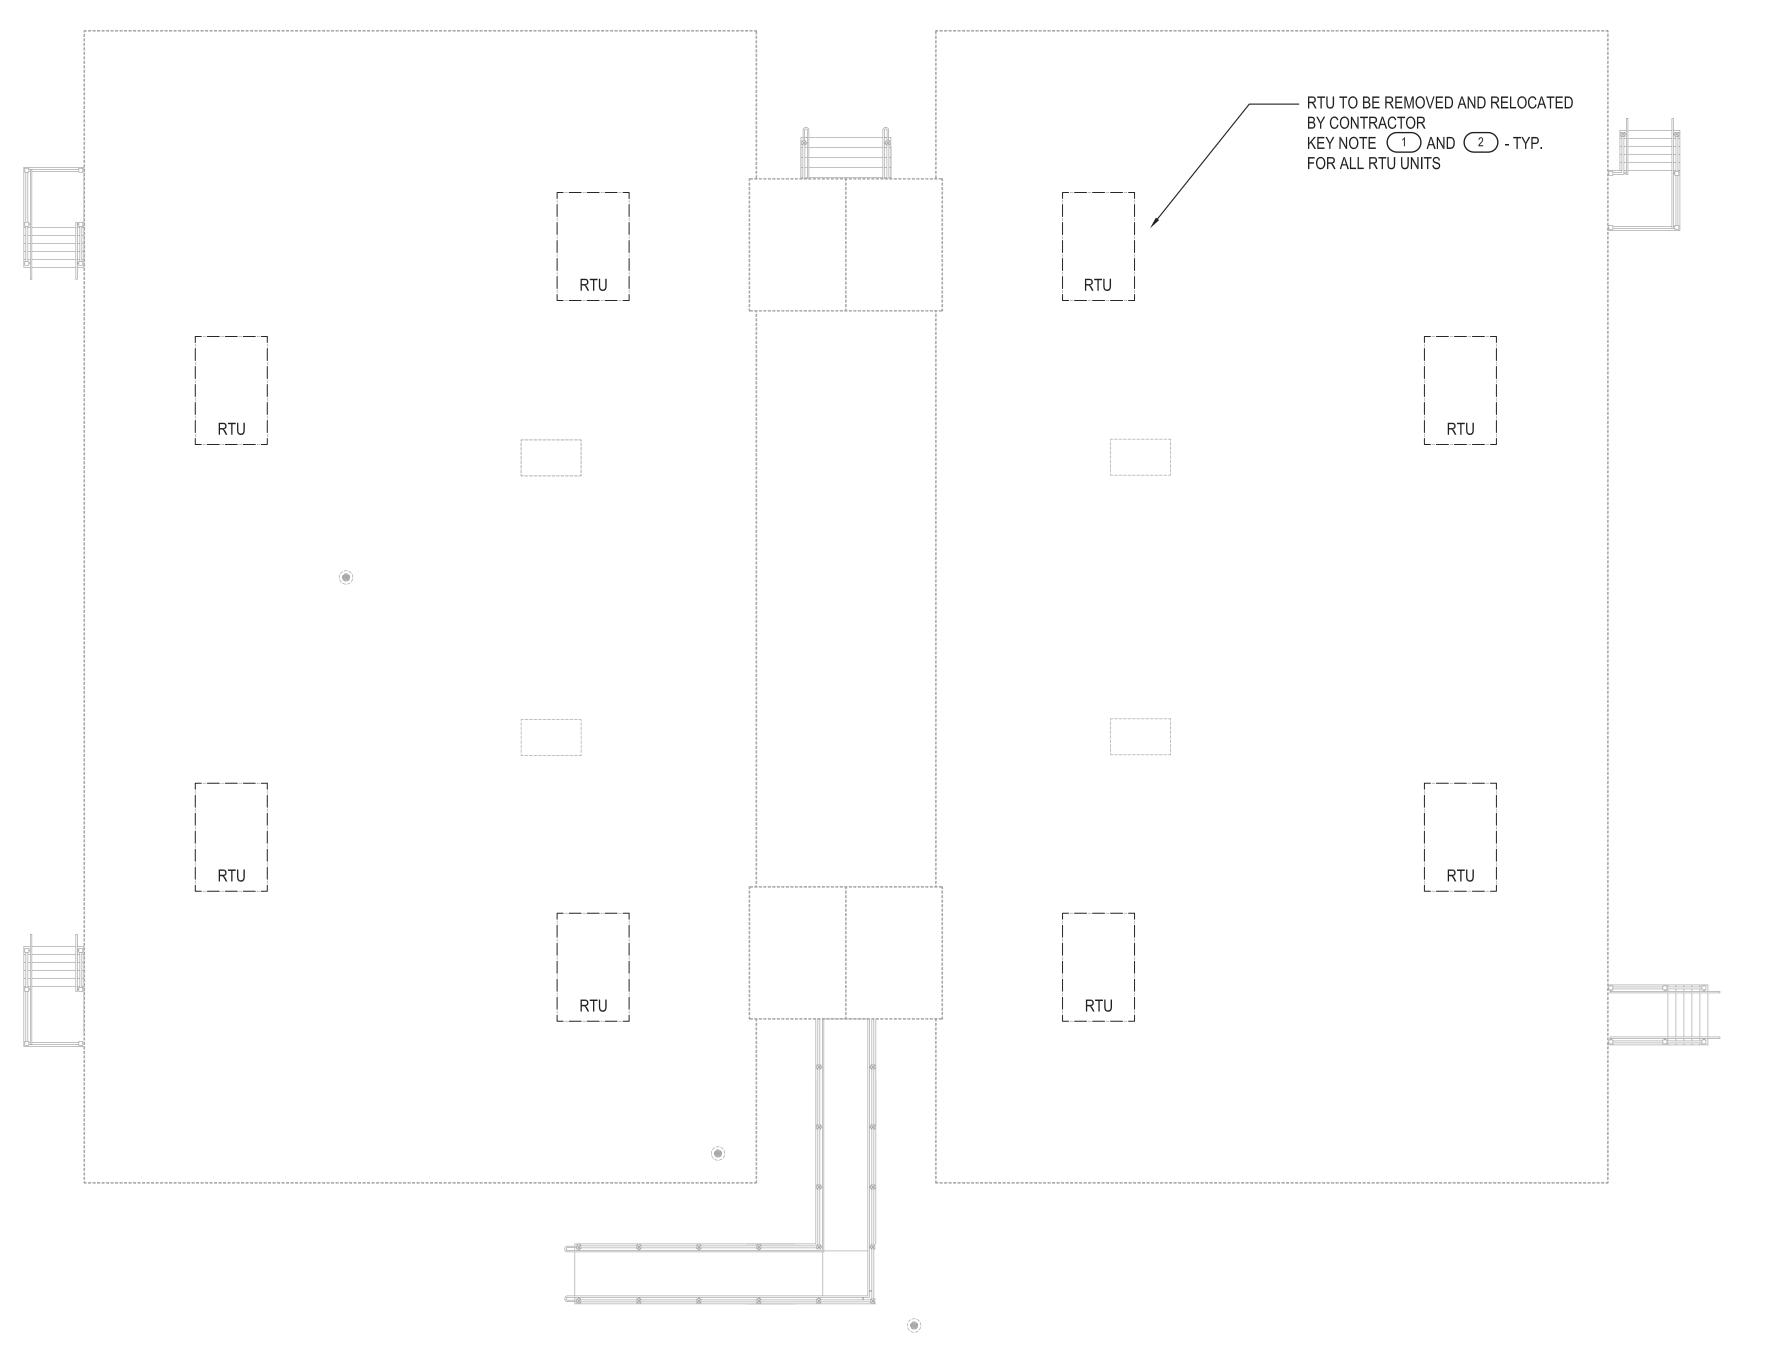- 1. SEE DWG E001.00 AND E002.00 FOR SYMBOLS, ABBREVIATIONS AND GENERAL NOTES.
- 2. WHEREEVER THE CONDUITS ARE SHOWN TO BE REMOVED, CONDUITS / WIRING SHALL BE REMOVED UP TO THE NEAREST JUNCTION BOX INSIDE THE BUILDING.
- 3. THE CONTRACTOR SHALL TRACE THE POWER SOURCE FOR ALL ELECTRICAL EQUIPMENT IN FIELD.
- 4. DISCONNECT AND REMOVE EXISTING WIRING / CONDUITS ON ROOF IN THE WAY OF ROOF TO BE REPLACED.
- 5. CONTRACTOR WILL PROVIDE MINIMUM 5 DAYS NOTICE FOR ANY POWER AND FIRE ALARM DISRUPTION.
- 6. FOR EQUIPMENT TO BE REMOVED AND REINSTALLED, EXISTING HOMERUN WIRING AND CONDUIT SHALL REMAIN UPTO CEILING OF THE FLOOR BELOW ROOF.

KEY NOTES

- 1 DISCONNECT AND REMOVE EXISTING POWER WIRING AND CONDUIT FOR EXISTING RTU UPTO THE NEAREST JUNCTION BOX INSIDE THE BUILDING. HOMERUN WIRING AND CONDUIT TO PANEL SHALL REMAIN.
- 2 DISCONNECT AND REMOVE EXISTING FIRE ALARM WIRING AND CONDUIT FOR DUCT SMOKE DETECTORS UP TO THE NEAREST JUNCTION BOX INSIDE THE BUILDING.



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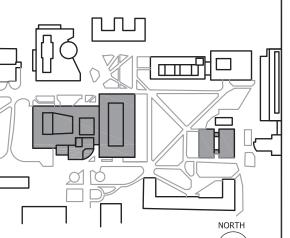
Facility:

SUNY NEW PALTZ **Building Address:** 1 HAWK DRIVE, NEW PALTZ, NY 12561 **Building:**

SMILEY ARTS BUILDING, COLLEGE THEATRE DORSKY MUSEUM AND FACULTY OFFICE BUILDING

County of: ULSTER

Project No.: 081047-00



Key/Location Plan

Contract Title: ROOF REPLACEMENT - SMILEY ARTS, COLLEGE THEATRE, DORSKY MUSEUM AND FACULTY OFFICE

Project No.: 081047-00

Drawing Title: ELECTRICAL ROOF REMOVAL PLAN - FACULTY OFFICE BUILDING

Seal & Signature:



Drawn By: Checked By: AS NOTED

43 of 47

SCALE: 1/8"=1'-0"

PART PLAN BASEMENT SAB BUILDING

SCALE: 1/16"=1'-0"

KEY NOTES

1 CONNECT NEW SMOKE HATCH TO NEW POWER WIRING AND CONDUIT AND FIRE ALARM WIRING AND CONDUIT. PROVIDE CONTROL MODULES AND RELAYS FOR FIRE ALARM CONNECTION. CONNECT TO NEAREST FIRE ALARM LOOP.

2 EXISTING POWER WIRING AND CONDUIT TO RTU UNITS TO REMAIN WILL REMAIN. SUPPORT EXISTING CONDUITS DURING ROOF REPLACEMENT. REINSTALL CONDUIT SUPPORTS AFTER ROOF REPLACEMENT.

RECONNECT CONDENSING UNIT TO EXISTING POWER WIRING AND CONDUIT EXTEND EXISTING POWER WIRING AND CONDUIT WITH THE SAME SIZE AS EXISTING AS REQUIRED.

GRAVITY VENT. NO POWER CONNECTION.

5 REINSTALL EXISTING LIGHTING FIXTURE. REINSTALL EXISTING SUPPORTS ON ROOF. EXTEND EXISTING WIRING AND CONDUIT WITH THE SAME SIZE AS EXISTING AS REQUIRED.

PROVIDE NEW LIGHTING FIXTURE (200 WATT LED FLOOD LIGHT WITH INTEGRAL PHOTOCELL CONTROL (LUMARK # LAS45-T3/200 W LED - PHOTOCELL OR APPROVED EQUAL BY COOPER LIGHTING, HUBBLE LIGHTING, PHILIPS LIGHTING) MATCHING EXISTING FIXTURES ON ROOF AND RECONNECT TO EXISTING WIRING AND CONDUIT WITH THE SAME SIZE AS EXISTING. REINSTALL EXISTING SUPPORTS ON ROOF.

PROVIDE NEW 100A/3P CIRCUIT BREAKER IN EXISTING
SPACES IN MAIN DISTRIBUTION PANEL IN ELECTRICAL ROOM
AND CONNECT TO RTU WITH 3 # 1 + 1 # 6G - 1 1/2"C.

8 RECONNECT EXHAUST FAN TO EXISTING POWER WIRING AND CONDUIT. EXTEND EXISTING POWER WIRING AND CONDUIT WITH THE SAME SIZE AS EXISTING AS REQUIRED WIRE THROUGH VFD. SEE MECHANICAL DWG FOR LOCATION OF VFD.

9 CONNECT RECEPTACLES TO 20A/1P CIRCUIT BREAKER IN THE NEAREST PANEL IN EACH BUILDING. SEE NOTE 9.

PROVIDE NEW DUCT SMOKE DETECTORS IN RTU UNIT AND RECONNECT TO EXISTING FIRE ALARM WIRING AND CONDUIT USING PROPER SPLICES PER CODE.

APPROXIMATE LOCATION OF EXISTING FIRE ALARM CONTROL PANEL (EDWARDS MODEL EST3) IN FIRST FLOOR CORRIDOR OF MCKENNA THEATRE.

APPROXIMATE LOCATION OF POWER PANEL PP1 IN MECHANICAL ROOM (PENTHOUSE) ON FIRST FLOOR OF DORSKY MUSEUM. PROVIDE NEW CIRCUIT BREAKERS IN EXISTING SPACES IN PANEL.

3 APPROXIMATE LOCATION OF POWER PANEL PP2 IN MECHANICAL ROOM AT ROOF LEVEL.

APPROXIMATE LOCATION OF EXISTING FIRE ALARM CONTROL PANEL (EDWARDS MODEL EST3) IN CELLAR MAIN ELECTRICAL ROOM.

PROVIDE 150 KVA TRANSFORMER IN NEMA 3R ENCLOSURE IN FENCED ENCLOSURE.

16 CONTRACTOR SHALL COORDINATE THE POWER REQUIREMENTS
FOR THE ACTUAL UNIT PROVIDED IN FIELD AND PROVIDE POWER
DISTRIBUTION FOR THE EQUIPMENT PROVIDED.

PROVIDE NEW 60A/3P CIRCUIT BREAKER IN EXISTING SPACES IN MAIN DISTRIBUTION PANEL IN ELECTRICAL ROOM AND CONNECT TO RTU WITH 3 # 4 + 1 # 8G - 1 1/4"C.

18 CONNECT REINSTALLED SMOKE HATCH TO EXISTING POWER WIRING AND CONDUIT AND EXISTING FIRE ALARM WIRING AND CONDUIT. EXTEND EXISTING POWER WIRING AND CONDUIT AND FIRE ALARM WIRING AND CONDUIT WITH THE SAME SIZE AS EXISTING AS REQUIRED.

NOTES

1. FOR GENERAL NOTES, ABBREVIATIONS AND SYMBOL LIST, REFER TO DRAWING E001.00 AND E002.00

2. UNLESS OTHERWISE NOTED ON THE DRAWING, CONDUIT USAGE SHALL BE AS FOLLOWS:

ALL UNDERGROUND AND OUTDOOR CONDUIT - RGS.
 FURRED OR SUSPENDED CEILING AND IN WALLS - EMT.

FOR MOTORS AND VIBRATING EQUIPMENT - LIQUID TIGHT FLEXIBLE METAL CONDUIT (MAX. 6' IN LENGHT).

3. ALL EQUIPMENT ON ROOF SHALL BE WEATHERPROOF AND SHALL BE INSTALLED IN NEMA 3R ENCLOSURE.

 PROVIDE PITCH POCKETS FOR CONDUIT PENETRATION THROUGH ROOF AS REQUIRED.


5. ALL NEW CONDUITS ON ROOF SHALL BE RGS. THE WIRING / CONDUITS SHALL BE REPLACED UP TO THE NEAREST JUNCTION BOX INSIDE THE BUILDING.

6. ALL WIRING / CONDUIT ON ROOF IN THE WAY OF ROOF REPLACEMENT SHALL BE REPLACED WITH NEW RGS CONDUITS. VERIFY LOCATION OF ALL CONDUITS ON ROOF IN FIELD.

7. CONTRACTOR WILL PROVIDE MINIMUM 5 DAYS NOTICE FOR ANY POWER AND FIRE ALARM DISRUPTION.


8. WHEREVER EXISTING WIRING AND CONDUIT IS NOTED TO BE EXTENDED EXTEND WITH THE SAME SIZE AS EXISTING WIRING AND CONDUIT.

9. NEW CIRCUIT NUMBERS FROM PANELS ARE SHOWN FOR IDENTIFICATION AND GROUPING PURPOSES ONLY. PROVIDE NEW CIRCUIT BREAKERS IN EXISTING SPACES IN PANELS.

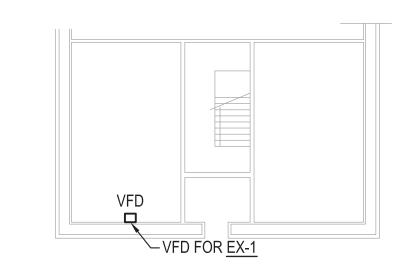

ELECTRICAL PENTHOUSE CONSTRUCTION PART PLAN - SMILEY ART BUILDING

SCALE: 1/16"=1'-0"

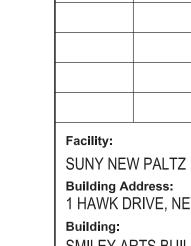

PROGRAM UNIT:

NEW YORK, NY 10001

TEL: 212.352.3307

SYSTEMS INC

ENGINEERS

Consulting Engineers

IAQ SYSTEMS INC, CONSULTING

555 8th AVENUE, SUITE 1502 NEW YORK, NY 10018

307 Seventh Avenue New York NY 10001 P 212 352 3307 F 212 352 9266 mdsnyc.com

MDSZERBATY ASSOCIATES ARCHITECTURE 307 7th AVENUE 15th FLOOR


1 HAWK DRIVE, NEW PALTZ, NY 12561 **Building:**SMILEY ARTS BUILDING,

COLLEGE THEATRE

COLLEGE THEATRE
DORSKY MUSEUM AND
FACULTY OFFICE BUILDING
County of: Pro

ULSTER

Project No.: 081047-00

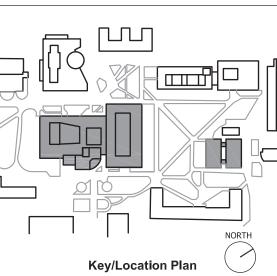

Contract Title:
ROOF REPLACEMENT - SMILEY ARTS,
COLLEGE THEATRE, DORSKY
MUSEUM AND FACULTY OFFICE

Project No.: 081047-00

Drawing Title:


ELECTRICAL ROOF CONSTRUCTION PLAN - SMILEY ARTS, MCKENNA THEATRE AND DORSKY MUSEUM (SAB)




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Drawn By:								
Checked By:								
Date:	JANUARY 8, 2021							
Scale:	AS NOTED							

E101.00

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ELECTRICAL ROOF CONSTRUCTION PLAN - SMILEY ARTS, MCKENNA THEATRE AND DORSKY MUSEUM (SAB)

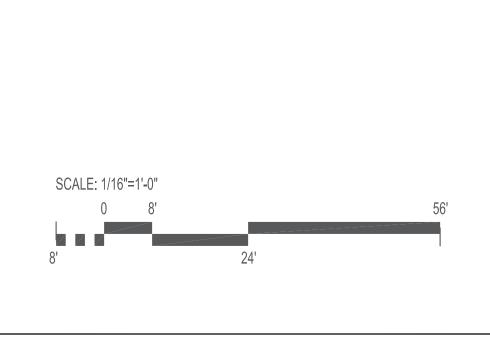ELECTRICAL ROOF CONSTRUCTION PLAN - FACULTY OFFICE BUILDING SCALE: 1/8"=1'-0"

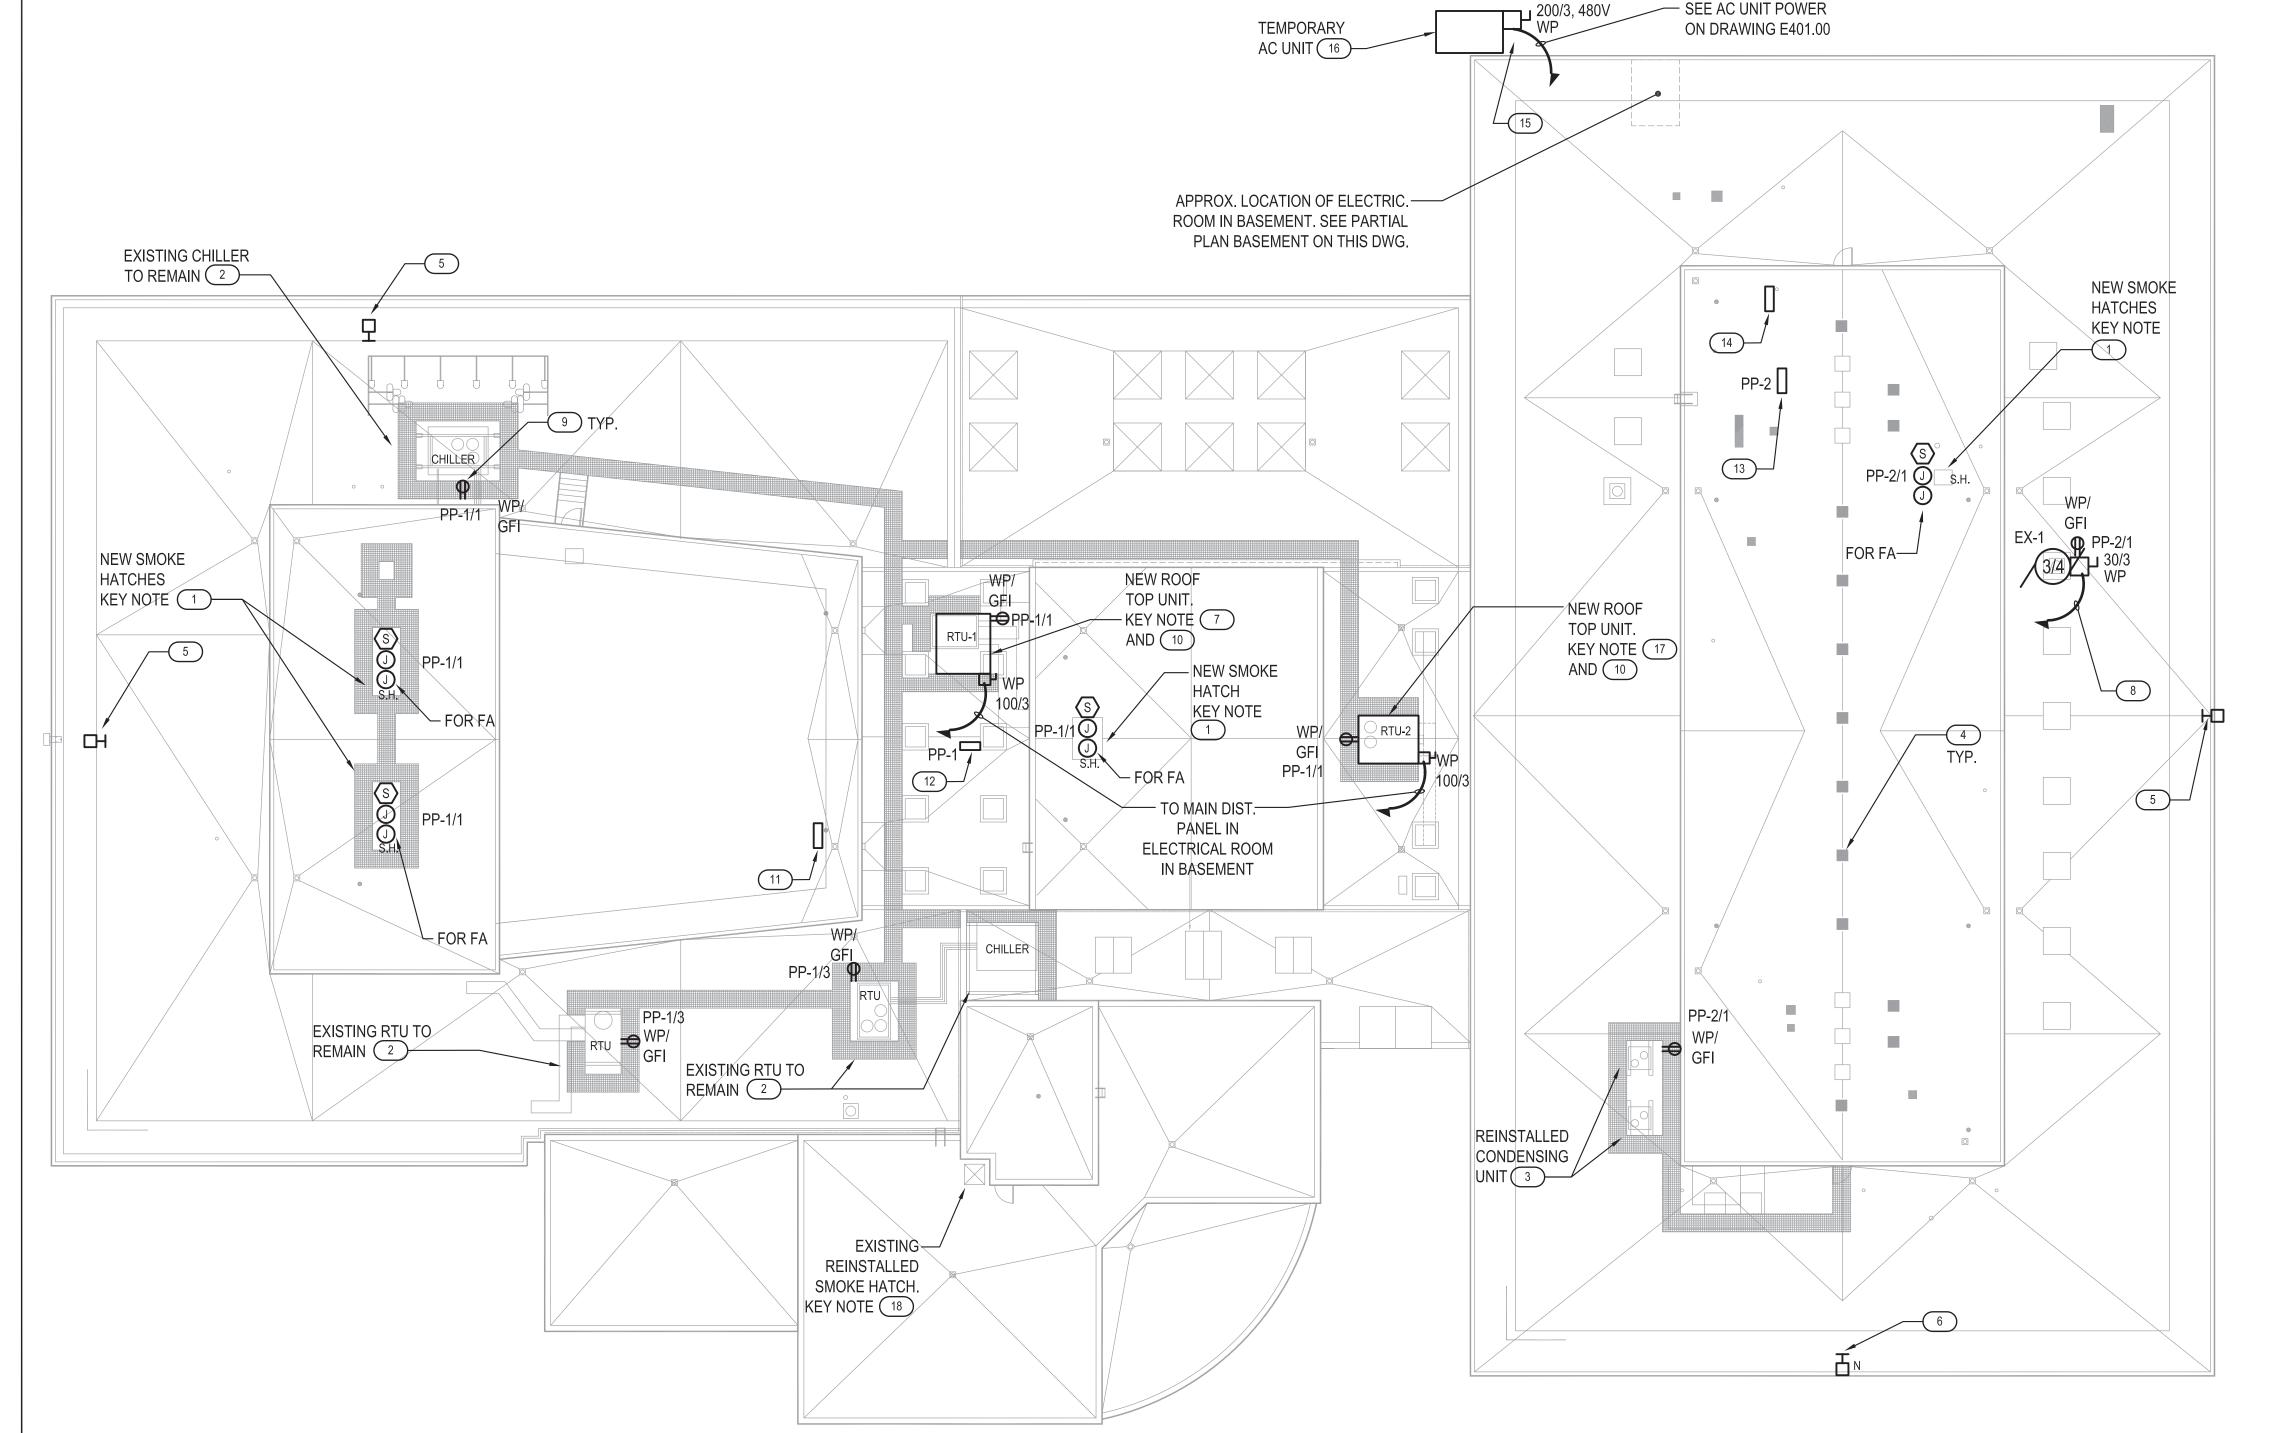NOTES

- 1. FOR GENERAL NOTES, ABBREVIATIONS AND SYMBOL LIST, REFER TO DRAWING E001.00 AND E002.00
- 2. UNLESS OTHERWISE NOTED ON THE DRAWING, CONDUIT USAGE SHALL BE AS FOLLOWS:
- ALL UNDERGROUND AND OUTDOOR CONDUIT RGS.
- FURRED OR SUSPENDED CEILING AND IN WALLS EMT. FOR MOTORS AND VIBRATING EQUIPMENT - LIQUID TIGHT

FLEXIBLE METAL CONDUIT (MAX. 6' IN LENGHT).

- 3. ALL EQUIPMENT ON ROOF SHALL BE WEATHERPROOF AND SHALL BE INSTALLED IN NEMA 3R ENCLOSURE.
- 4. PROVIDE PITCH POCKETS FOR CONDUIT PENETRATION THROUGH ROOF AS REQUIRED.
- 5. ALL NEW CONDUITS ON ROOF SHALL BE RGS. THE WIRING / CONDUITS SHALL BE REPLACED UP TO THE NEAREST JUNCTION BOX INSIDE THE BUILDING.
- 6. ALL WIRING / CONDUIT ON ROOF IN THE WAY OF ROOF REPLACEMENT SHALL BE REPLACED WITH NEW RGS CONDUITS. VERIFY LOCATION OF ALL CONDUITS ON ROOF IN FIELD.
- 7. CONTRACTOR WILL PROVIDE MINIMUM 5 DAYS NOTICE FOR ANY POWER AND FIRE ALARM DISRUPTION.
- 8. WHEREVER EXISTING WIRING AND CONDUIT IS NOTED TO BE EXTENDED EXTEND WITH THE SAME SIZE AS EXISTING WIRING AND CONDUIT.
- 9. NEW CIRCUIT NUMBERS FROM PANELS ARE SHOWN FOR IDENTIFICATION AND GROUPING PURPOSES ONLY. PROVIDE NEW CIRCUIT BREAKERS IN EXISTING SPACES IN PANELS.

KEY NOTES

- RECONNECT RTU TO EXISTING POWER WIRING AND CONDUIT. EXTEND EXISTING POWER WIRING AND CONDUIT WITH THE SAME SIZE AS EXISTING AS REQUIRED.
- CONNECT RECEPTACLES TO 20A/1P CIRCUIT BREAKER IN THE NEAREST PANEL IN EACH BUILDING. PROVIDE NEW CIRCUIT BREAKERS IN EXISTING SPACES IN PANELS.
- 4 APPROXIMATELY LOCATION OF POWER PANELS IN ELECTRICAL CLOSETS ON 1ST FLOOR.
- APPROXIMATELY LOCATION OF FIRE ALARM CONTROL PANEL (EDWARDS EST3) ON 1ST FLOOR.



PROGRAM UNIT:



TEL: 212.352.3307

307 Seventh Avenue New York NY 10001 P 212 352 3307 F 212 352 9266 mdsnyc.com MDSZERBATY ASSOCIATES ARCHITECTURE 307 7th AVENUE 15th FLOOR NEW YORK, NY 10001



Consulting Engineers IAQ SYSTEMS INC, CONSULTING ENGINEERS 555 8th AVENUE, SUITE 1502 NEW YORK, NY 10018


RECONNECT EXISTING FIRE ALARM WIRING AND CONDUIT FOR DUCT SMOKE DETECTORS TO REINSTALLED RTU UNIT. Facility:

SUNY NEW PALTZ **Building Address:** 1 HAWK DRIVE, NEW PALTZ, NY 12561

SMILEY ARTS BUILDING, COLLEGE THEATRE DORSKY MUSEUM AND FACULTY OFFICE BUILDING

County of: ULSTER

Project No.: 081047-00

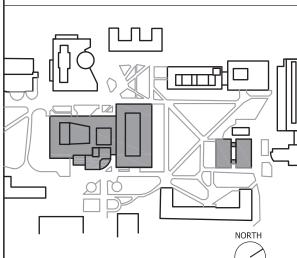

Key/Location Plan

Contract Title: ROOF REPLACEMENT - SMILEY ARTS, COLLEGE THEATRE, DORSKY MUSEUM AND FACULTY OFFICE

BUILDING Project No.: 081047-00

Drawing Title: ELECTRICAL ROOF CONSTRUCTION PLAN - FACULTY OFFICE BUILDING




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SCALE: 1/8"=1'-0"

500A/3P, 208V CB



MAIN ELECTRICAL ROOM (SMILEY ARTS BLDG)

KEY NOTES

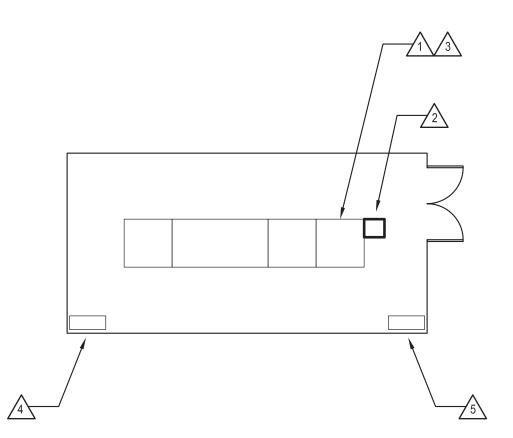1 TAP MAIN BUS OF EXISTING SWITCHBOARD WITH 2 SETS OF 3 - 250 MCM + 1 # 2G - 3"C FOR FEEDER TO TEMP. AC UNIT.

FEEDER SCHEDULE

- A 2 SETS OF 3 250 MCM + 1 # 2G 3"C
- B 3 # 4/0 + 1 # 4G 2 1/2"C

KEY NOTES

EXISTING 4000A, 208V, 3PH SWITCHBOARD.

NEW 500A / 3P, 208V, 3PH CB.

PROVIDE 1 - 100A/3P AND 1 - 60A/3P, 208V CIRCUIT BREAKERS IN EXISTING SPACES FOR POWER TO NEW RTU UNITS ON

EXISTING FIRE ALARM CONTROL PANEL EDWARDS EST3.

EXISTING ELECTRICAL PANEL.



PROGRAM UNIT:

MDSzerbaty Associates Architecture LLC 307 Seventh Avenue New York NY 10001 P 212 352 3307 F 212 352 9266 mdsryc.com

MDSZERBATY ASSOCIATES ARCHITECTURE 307 7th AVENUE 15th FLOOR NEW YORK, NY 10001 TEL: 212.352.3307



Consulting Engineers IAQ SYSTEMS INC, CONSULTING ENGINEERS 555 8th AVENUE, SUITE 1502 NEW YORK, NY 10018 TEL: 212.680.8945


Facility:

SUNY NEW PALTZ **Building Address:** 1 HAWK DRIVE, NEW PALTZ, NY 12561 **Building:**

SMILEY ARTS BUILDING, COLLEGE THEATRE DORSKY MUSEUM AND FACULTY OFFICE BUILDING

County of: ULSTER

Project No.: 081047-00

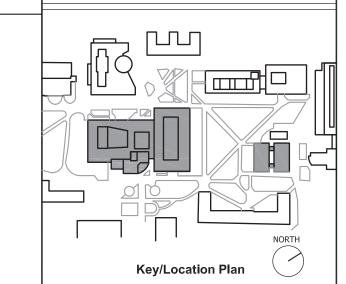

Contract Title: ROOF REPLACEMENT - SMILEY ARTS, COLLEGE THEATRE, DORSKY MUSEUM AND FACULTY OFFICE BUILDING

Project No.: 081047-00

Drawing Title:

ELECTRICAL POWER TO TEMPORARY AC UNIT

Seal & Signature:




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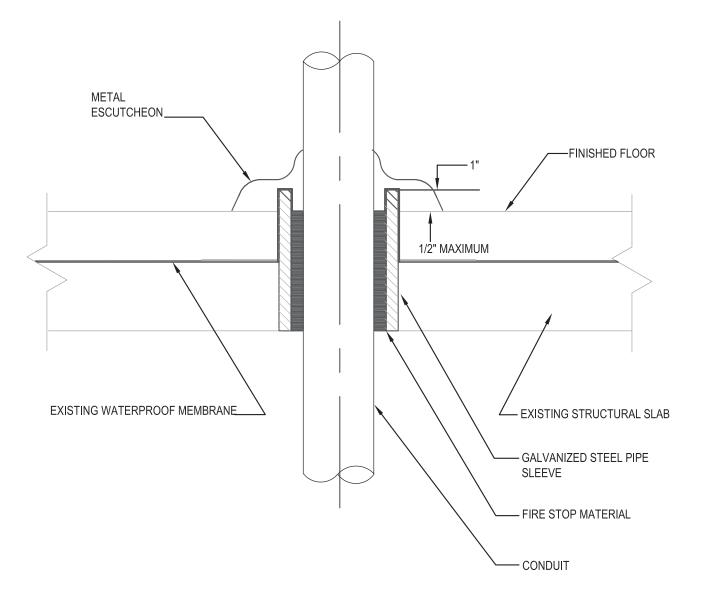
SCALE: 1/8"=1'-0"






CONDUIT PENETRATION DETAIL
THROUGH FIRE RATED SOLID WALL

SCALE: NTS

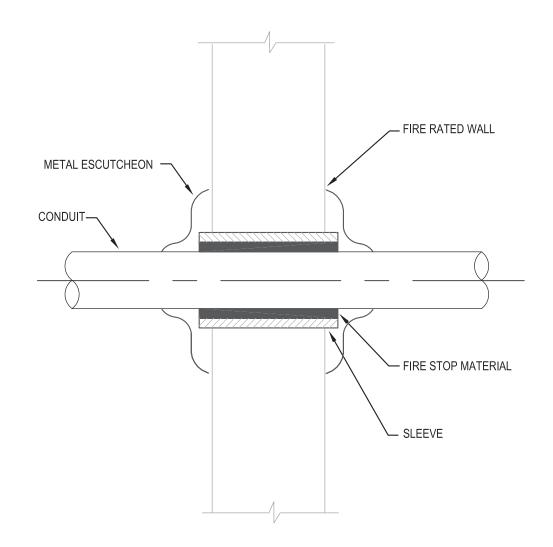


CONDUIT PENETRATION DETAIL THROUGH WATERPROOF SLAB

SCALE: NTS

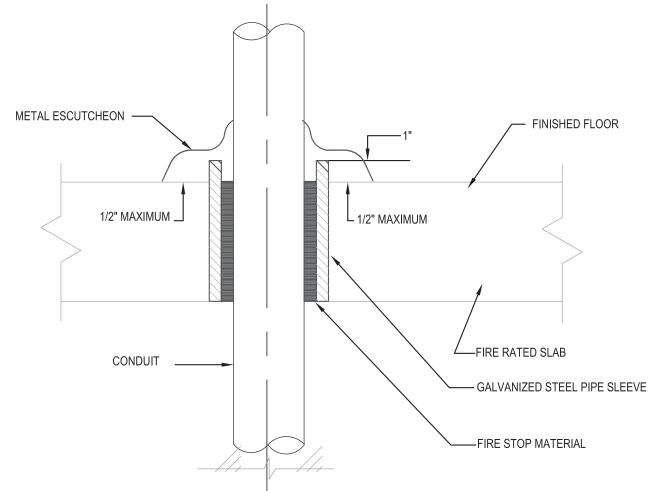

CONDUIT PENETRATION DETAIL
THROUGH FIRE RATED SLAB

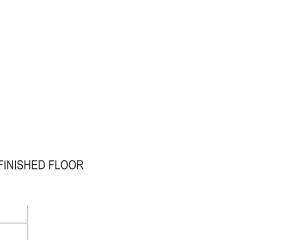

PROGRAM UNIT:

MDSzerbaty Associates Architecture LLC
307 Seventh Avenue New York NY 10001 P 212 352 3307 F 212 352 9266 mdsnyc.com

MDSZERBATY ASSOCIATES ARCHITECTURE 307 7th AVENUE 15th FLOOR NEW YORK, NY 10001 TEL: 212.352.3307



Consulting Engineers


IAQ SYSTEMS INC, CONSULTING
ENGINEERS
555 8th AVENUE, SUITE 1502
NEW YORK, NY 10018
TEL: 212.680.8945

Facility:
SUNY NEW PALTZ

Building Address:
1 HAWK DRIVE, NEW PALTZ, NY 12561
Building:

SMILEY ARTS BUILDING, COLLEGE THEATRE DORSKY MUSEUM AND FACULTY OFFICE BUILDING

County of: ULSTER **Project No.:** 081047-00

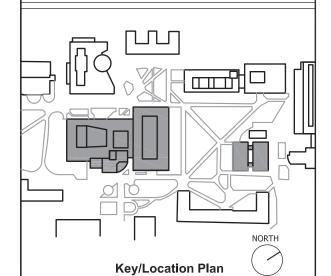

Contract Title:
ROOF REPLACEMENT - SMILEY ARTS,
COLLEGE THEATRE, DORSKY
MUSEUM AND FACULTY OFFICE

Project No.: 081047-00

Drawing Title:

BUILDING


ELECTRICAL DETAILS



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Checked By:
Date: JANUARY 8, 2021
Scale: AS NOTED

Drawing No.: **E701.00**

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CONDUIT SUPPORT DETAILS SUSPENDED- SINGLE CONDUIT

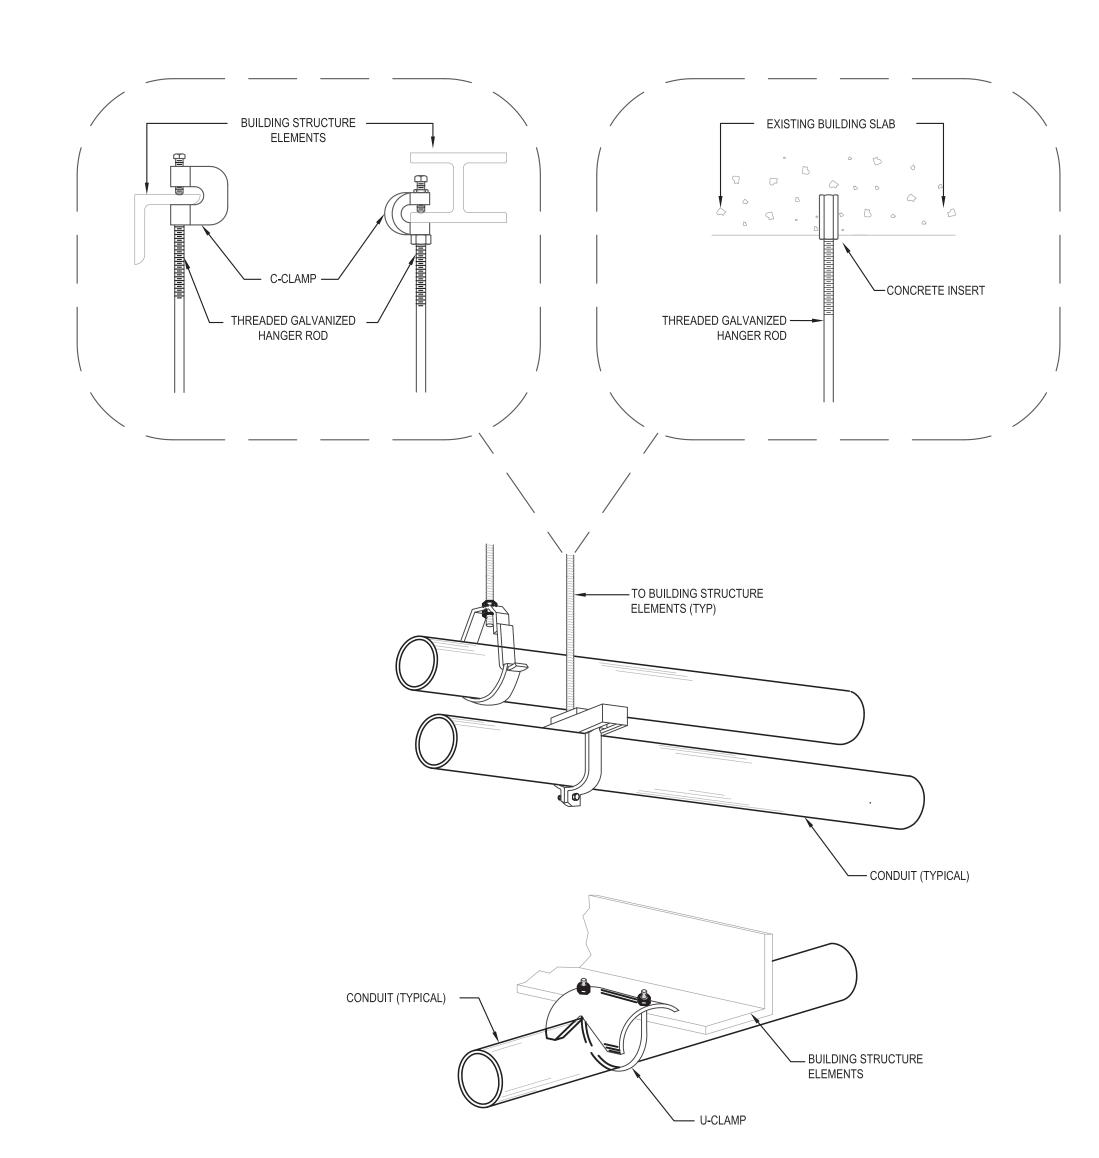SCALE: NTS

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