


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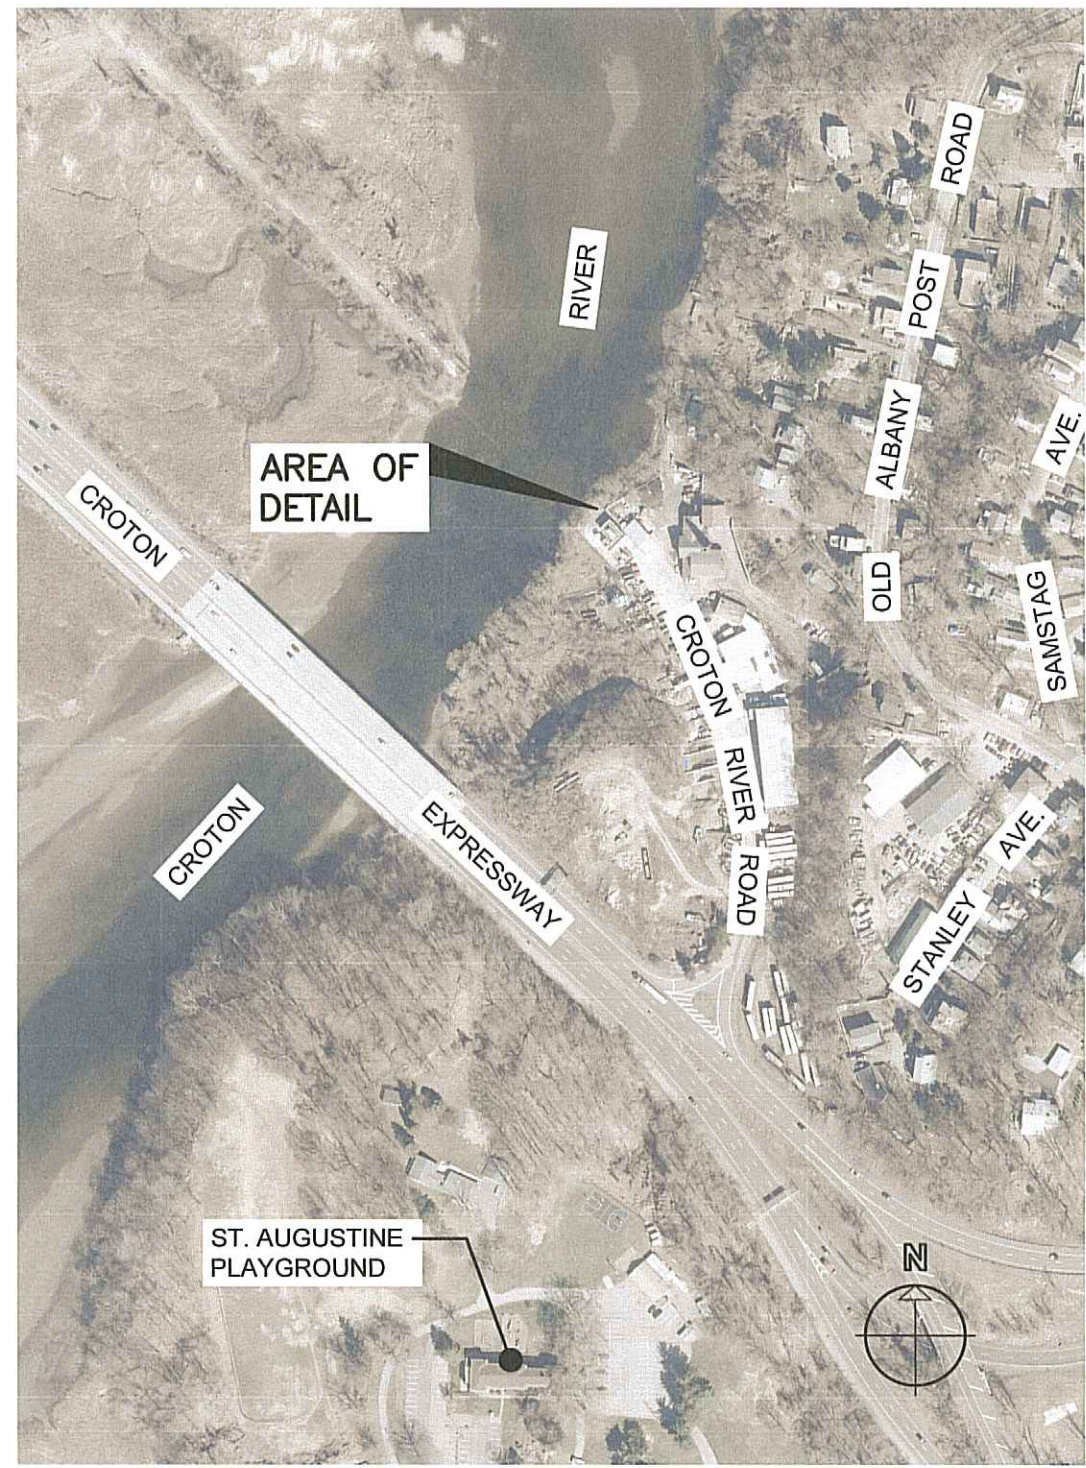


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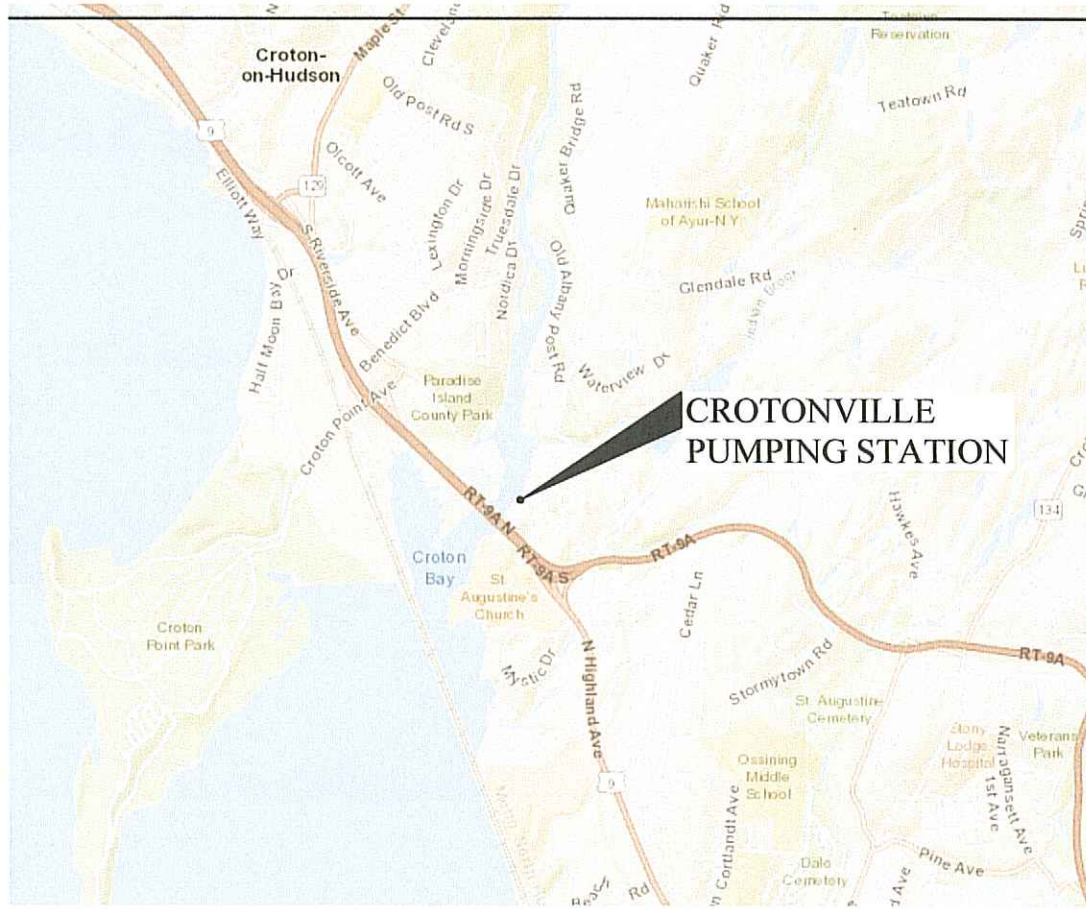
WESTCHESTER COUNTY, NEW YORK
DEPARTMENT OF PUBLIC WORKS AND TRANSPORTATION
DIVISION OF ENGINEERING

CONTRACT No. 17-529
PUMPING STATION REHABILITATION
CROTONVILLE PUMPING STATION
OSSINING SANITARY SEWER DISTRICT
OSSINING, NEW YORK

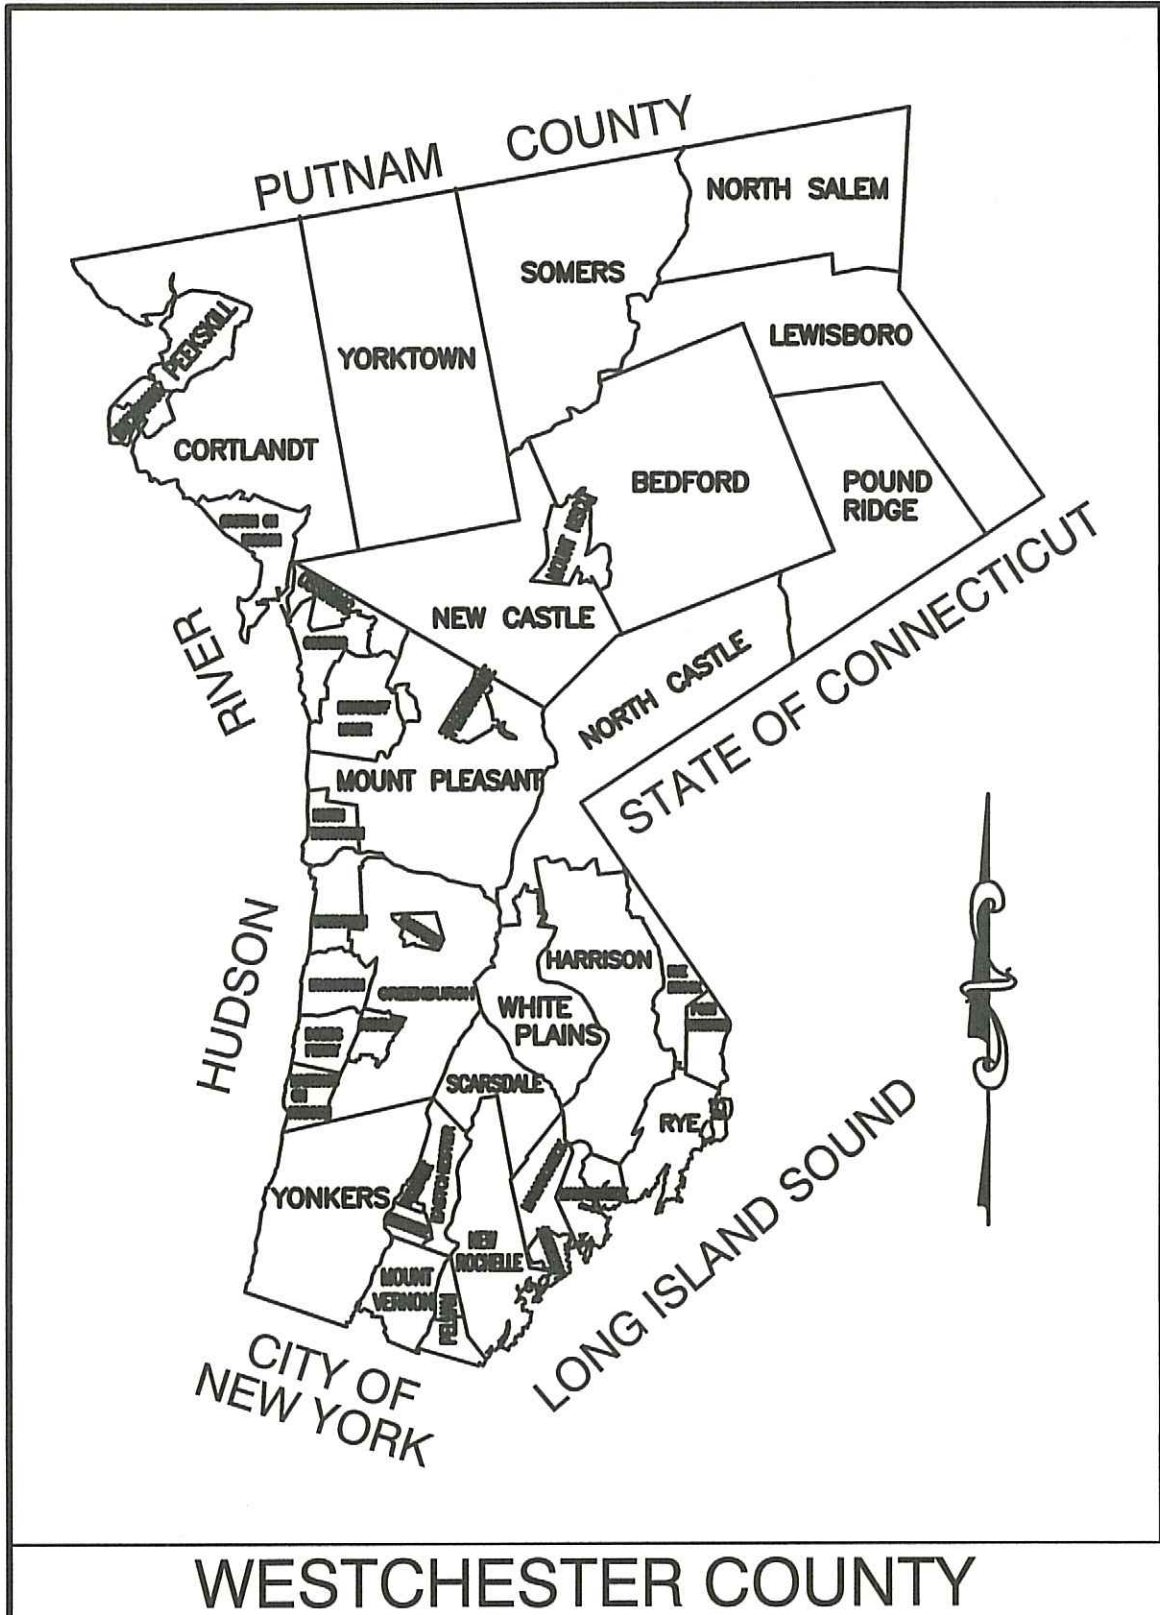

LOCATION MAP


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VICINITY MAP


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IN CHARGE OF R. GELL
CHECKED BY D. ROONEY
MADE BY T. LARAMAY



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SHEET NO.	SHEET TITLE	DPW FILE NO.	SHEET NO.	SHEET TITLE	DPW FILE NO.
T-001	TITLE SHEET	208-03-T-25-0	I-001	PROCESS CONTROL AND INSTRUMENTATION SYMBOLS	208-03-E-57-0
G-001	NOTES, SYMBOLS AND ABBREVIATIONS	208-03-G-26-0	I-002	P&ID PUMPING STATION	208-03-E-58-0
C-101	EXISTING SITE AND DEMOLITION PLAN	208-03-G-27-0	I-003	P&ID CHEMICAL SYSTEM	208-03-E-59-0
C-102	SITE PLAN	208-03-G-28-0	I-004	P&ID ANCILLARY	208-03-E-60-0
C-501	DETAILS	208-03-G-29-0	E-001	GENERAL NOTES, ABBREVIATIONS & SYMBOLS	208-03-E-61-0
C-502	DETAILS	208-03-G-30-0	E-101	DEMOLITION PLANS	208-03-E-62-0
S-001	GENERAL NOTES	208-03-S-31-0	E-102	DEMOLITION PLANS	208-03-E-63-0
S-101	MAIN FLOOR PLAN	208-03-S-32-0	E-103	POWER PLANS	208-03-E-64-0
S-102	ELECTRICAL SERVICE PLATFORM	208-03-S-33-0	E-104	POWER PLANS	208-03-E-65-0
S-103	PARTIAL EXISTING ROOF PLANS	208-03-S-34-0	E-105	LIGHTING PLANS	208-03-E-66-0
S-104	ELECTRICAL SERVICE PLATFORMS	208-03-S-35-0	E-106	LIGHTING PLANS	208-03-E-67-0
S-301	SECTIONS & DETAILS	208-03-S-36-0	E-501	ELECTRICAL DETAILS	208-03-E-68-0
S-302	SECTIONS & DETAILS	208-03-S-37-0	E-502	ELECTRICAL DETAILS	208-03-E-69-0
S-303	SECTIONS & DETAILS	208-03-S-38-0	E-601	ONE-LINE DIAGRAMS	208-03-E-70-0
S-501	TYPICAL DETAILS	208-03-S-39-0	E-602	ELEMENTARY DIAGRAMS	208-03-E-71-0
A-001	ABBREVIATIONS & SYMBOLS	208-03-A-40-0	E-603	ELEMENTARY DIAGRAMS	208-03-E-72-0
A-002	CODE ANALYSIS	208-03-A-41-0	E-604	SCHEDULES	208-03-E-73-0
A-101	PLANS	208-03-A-42-0	E-605	CONDUIT SCHEDULE	208-03-E-74-0
A-102	ROOF PLAN	208-03-A-43-0	H-101	MAIN LEVEL & ROOF PLANS	208-03-H-75-0
A-201	ELEVATION	208-03-A-44-0	H-102	MIDDLE LEVEL & LOWER LEVEL PLANS	208-03-H-76-0
A-301	SECTIONS	208-03-A-45-0	H-301	SECTIONS	208-03-H-77-0
A-302	SECTIONS AT FLOOD DOORS	208-03-A-46-0	H-302	SECTIONS	208-03-H-78-0
A-501	TRANSLUCENT PANEL DETAILS	208-03-A-47-0	H-501	DETAILS	208-03-H-79-0
A-601	SCHEDULES AND DETAILS	208-03-A-48-0	H-601	SCHEDULE	208-03-H-80-0
M-101	LOWER & MIDDLE LEVEL DEMOLITION PLANS	208-03-M-49-0	P-101	MAIN LEVEL PLUMBING DEMOLITION & INSTALLATION PLANS	208-03-P-81-0
M-102	MAIN LEVEL DEMOLITION PLAN & SECTION	208-03-M-50-0	P-102	MIDDLE LEVEL PLUMBING DEMOLITION & INSTALLATION PLANS	208-03-P-82-0
M-103	LOWER & MIDDLE LEVEL PLANS	208-03-M-51-0	P-103	LOWER LEVEL PLUMBING DEMOLITION & INSTALLATION PLANS	208-03-P-83-0
M-104	MAIN LEVEL PLAN	208-03-M-52-0	P-701	ISOMETRIC, DETAIL & SCHEDULE	208-03-P-84-0
M-301	SECTIONS	208-03-M-53-0			
M-302	SECTIONS	208-03-M-54-0			
M-501	TYPICAL DETAILS	208-03-M-55-0			
M-502	TYPICAL DETAILS	208-03-M-56-0			

CONSULTANT INFORMATION				 O'BRIEN & GERE ENGINEERS, INC. 50 MAIN ST., 10TH FLOOR, SUITE 1000 WHITE PLAINS, NEW YORK 10606			
REVISION NUMBER				DATE			
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CONTRACTOR				PROJECT COORDINATOR			
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WESTCHESTER COUNTY, NEW YORK							
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TITLE SHEET							
CONTRACT NUMBER				SHEET NUMBER			
17-529				T-001			
SHEET NO. 1				OF 60			
SCALE: N.T.S.				DATE: 12/21/2018			
DPW FILE NO.				REV. NO.			
208-03-T-25-0				0			

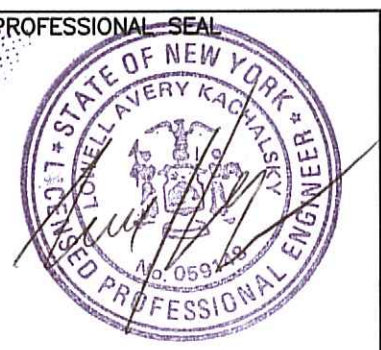GENERAL DEMOLITION NOTES:

- SEE ARCHITECTURAL, HVAC, PLUMBING AND ELECTRICAL DRAWINGS FOR RELATED REMOVALS AND DEMOLITION TO BE PERFORMED UNDER THIS PROJECT.
- ALL WALL, FLOOR AND ROOF OPENINGS RESULTING FROM DEMOLITION WORK SHALL BE SEALED AS SPECIFIED. FIREWALL PENETRATIONS SHALL BE SEALED TO MAINTAIN APPROPRIATE FIRE RATING. BELOW GRADE AND WET AREA PENETRATIONS SHALL BE SEALED WATERTIGHT. SEE STRUCTURAL DRAWINGS FOR TYPICAL DETAILS FOR REPAIR OF WALL, FLOOR AND ROOF OPENINGS RESULTING FROM DEMOLITION WORK.
- UNLESS OTHERWISE NOTED OR SPECIFIED IN CONTRACT DOCUMENTS, ALL MATERIALS REMOVED OR DEMOLISHED UNDER THIS PROJECT SHALL BE LEGALLY DISPOSED OF OFF-SITE BY CONTRACTOR. WHERE SPECIFICALLY NOTED, CERTAIN ITEMS OF EQUIPMENT SHALL BE TURNED OVER TO OWNER.
- SCHEDULE AND SEQUENCE OF REMOVAL AND DEMOLITION WORK SHALL BE IN ACCORDANCE WITH CONSTRAINTS STIPULATED ON CONTRACT DRAWINGS AND AS SPECIFIED.
- UNLESS OTHERWISE NOTED, FOR EXISTING MECHANICAL EQUIPMENT INDICATED FOR REMOVAL, REMOVAL SHALL INCLUDE DEMOLITION OF EXISTING ANCHOR BOLTS, CONCRETE BASE PAD, AND REPAIR OF CONCRETE FLOOR TO MATCH CONDITION OF SURROUNDING FLOOR.
- UNLESS OTHERWISE NOTED, REMOVAL OF EXISTING INTERIOR PIPING SYSTEMS SHALL INCLUDE REMOVAL OF INSULATION, HANGERS, SUPPORTS, ANCHORS, FIXTURES AND ACCESSORIES. ANY EMBEDDED HARDWARE OR ANCHORS SHALL BE CUT FLUSH WITH WALL, FLOOR OR SLAB SURFACE AND PATCHED AS SPECIFIED.
- PROVIDE NEW GASKETS AND HARDWARE AT ALL CONNECTIONS BETWEEN NEW AND EXISTING PIPING, AND WHERE EXISTING PIPING IS DISASSEMBLED.
- OWNER WILL IDENTIFY EQUIPMENT TO BE SALVAGED. CONTRACTOR SHALL REMOVE AND PROTECT EQUIPMENT TO BE SALVAGED AND DELIVER TO OWNER AS SPECIFIED. CONTRACTOR SHALL SECURE AND STORE EQUIPMENT UNTIL OWNER CAN TAKE DELIVERY.
- FOR CLARITY, EXISTING FACILITIES AND PIPING ARE GENERALLY SHOWN LIGHT. NEW FACILITIES AND PIPING ARE GENERALLY SHOWN HEAVY.
- CONTRACTOR SHALL COORDINATE ALL WORK AFFECTING UTILITIES WITH RESPECTIVE UTILITY OWNERS. ALL DETAILS OF CONSTRUCTION AND/OR RELOCATION OF AFFECTED UTILITIES SHALL BE APPROVED BY UTILITY OWNER APPROVING AGENCIES.

GENERAL NOTES:

- SITE BASE MAPPING IS BASED ON A TOPOGRAPHIC SURVEY PREPARED BY WARD CARPENTER DATED JULY 2017 AND HISTORICAL RECORDS (CHARLES R VELZY ASSOCIATES, INC., 1975, "CROTON & CROTONVILLE PUMPING STATIONS"). ALL ELEVATIONS REFER TO THE 1988 NORTH AMERICAN VERTICAL DATUM (NAVD88).
- FLOOD DESIGN ELEVATION IS 12.5' BASED ON THE 1988 NORTH AMERICAN VERTICAL DATUM (NAVD88).
- CONTRACTOR SHALL NOTIFY DIG SAFELY NEW YORK 72 HOURS PRIOR TO WORK REQUIRING EXCAVATION.
- CONTRACTOR SHALL NOTIFY OWNER AND ENGINEER A MINIMUM OF SEVEN DAYS PRIOR TO COMMENCEMENT OF ON-SITE CONSTRUCTION, INCLUDING ANY DEMOLITION WORK.
- EXISTING LOCATIONS AND ELEVATIONS ARE APPROXIMATE ONLY. CONDUCT ALL CONSTRUCTION AND CONTROL SURVEYS AND VERIFY ALL DIMENSIONS PERTINENT TO WORK OF THIS CONTRACT IN FIELD PRIOR TO SUBMITTAL OF SHOP DRAWINGS.
- PROVIDE ALL NECESSARY VEHICLE TRAFFIC CONTROL DURING CONSTRUCTION AS REQUIRED.
- RESTORE ALL DAMAGED FACILITIES AND DISTURBED SURFACES TO ORIGINAL OR BETTER CONDITION INCLUDING TOPSOIL, SEED, FERTILIZER AND MULCH IN ACCORDANCE WITH SPECIFICATIONS.
- PROTECT ALL EXISTING FACILITIES NO SCHEDULED FOR DEMOLITION DURING WORK OF THIS CONTRACT.
- COMPLY WITH ALL REGULATORY APPROVAL PERMIT CONDITIONS.
- PROVIDE EROSION AND SEDIMENT CONTROLS AS SHOWN OR REQUIRED. A SWPPP HAS NOT BEEN PREPARED FOR THIS PROJECT AS THE AREA OF DISTURBANCE IS LESS THAN ONE ACRE.
- SCHEDULE AND PERFORM WORK IN ACCORDANCE WITH SEQUENCE AND SCHEDULE CONSTRAINTS SPECIFIED.
- COUNTY PERSONNEL SHALL OPERATE ALL EXISTING VALVES AND EQUIPMENT. CONTRACTOR SHALL COORDINATE OPERATION OF EXISTING FACILITIES WITH COUNTY TO COINCIDE WITH SCHEDULED WORK ACTIVITIES.
- CONTRACTOR SHALL COORDINATE WITH AND OBTAIN APPROVAL FROM OWNER FOR LOCATION OF FIELD OFFICE TRAILERS, CONSTRUCTION EQUIPMENT, TEMPORARY PARKING AND STAGING AREAS.
- CONTRACTOR IS PERMITTED TO STORE/STAGE EQUIPMENT AND MATERIALS WITHIN OWNER APPROVED CONSTRUCTION STAGING AREAS AT CONTRACTOR'S OWN RISK. CONTRACTOR SHALL BE RESPONSIBLE FOR DEVELOPMENT OF SITE IN A FASHION THAT WILL PERMIT ADEQUATE STAGING.
- REFER TO APPLICABLE PIPE SCHEDULES, VALVE SCHEDULE AND TECHNICAL SPECIFICATIONS FOR MATERIALS AND INSTALLATION REQUIREMENTS. PIPE SCHEDULES AND VALVE SCHEDULE ARE LOCATED IN THE TECHNICAL SPECIFICATIONS.
- FLEXIBLE COUPLINGS SHOWN ON THE CONTRACT DRAWINGS ARE REQUIRED FOR REMOVAL OF EQUIPMENT AND PIPING BY THE OWNER AFTER COMPLETION OF THE WORK. ADDITIONAL COUPLINGS MAY BE REQUIRED TO FACILITATE INSTALLATION BY THE CONTRACTOR - NO ADDITIONAL PAYMENT WILL BE MADE THEREFOR.
- PROVIDE HARNESSING FOR ALL FLEXIBLE COUPLINGS INSTALLED INSIDE STRUCTURES, UNLESS OTHERWISE INDICATED.
- IN GENERAL, SMALL DIAMETER PIPING (I.E., 2-1/2" AND SMALLER) IS SHOWN FOR GENERAL LAYOUT PURPOSES ONLY, AND IS NOT INTENDED TO SHOW EXACT ALIGNMENT, NUMBER OF FITTINGS, VALVES AND APPURTENANCES. ALL PIPING, FITTINGS AND APPURTENANCES SHALL BE PROVIDED AS SPECIFIED ON THE INSTRUMENTAL DRAWINGS OR SHOWN IN APPLICABLE SCHEMATIC DIAGRAMS, AND AS REQUIRED FOR A COMPLETE INSTALLATION. ACTUAL PIPE ROUTING SHALL BE DETERMINED BY THE CONTRACTOR SUBJECT TO REVIEW BY THE ENGINEER, AND SHALL BE COORDINATED TO AVOID CONFLICTS WITH EXISTING AND NEW WORK OF ELECTRICAL, HVAC AND PLUMBING SYSTEMS, AND SO AS NOT TO INTERFERE WITH ACCESS TO OR OPERATION OF ANY OTHER PIPE, VALVE OR EQUIPMENT. SMALL DIAMETER PIPING SYSTEMS SHALL BE LAID OUT AND INSTALLED IN AN ORGANIZED, NEAT AND WORKMANLIKE MANNER.
- PIPE SIZES SHOWN MAY NOT BE THE SAME AS SIZES OF CONNECTIONS TO THE EQUIPMENT SUPPLIED. PROVIDE ALL NECESSARY REDUCERS, BUSHINGS AND APPURTENANCES REQUIRED TO MAKE EQUIPMENT CONNECTIONS.
- REPAIR INTERIOR AND EXTERIOR PIPE COATINGS DAMAGED DURING INSTALLATION.
- CONTRACTOR SHALL COORDINATE WALL HANGER LOCATIONS, ALLOWABLE LOADS, AND ATTACHMENT METHODS WITH MANUFACTURER OF WALL BRACKET AND OBTAIN APPROVAL OF THE ENGINEER.
- SEE INSTRUMENTATION DRAWINGS FOR INSTRUMENT PIPING CONNECTION DETAILS.

EROSION & SEDIMENT CONTROL NOTES:

- WATER FROM DEWATERING OPERATIONS SHALL BE PRETREATED IN ACCORDANCE WITH MOST CURRENT NYSDEC STORMWATER GENERAL PERMIT CONDITIONS PRIOR TO DISCHARGE TO SURFACE WATERS.
- THE STABILIZED CONSTRUCTION ENTRANCE SHALL BE MAINTAINED AS DETAILED PRIOR TO USE BY CONSTRUCTION VEHICLES AND EQUIPMENT.
- EROSION AND SEDIMENT CONTROL FACILITIES SHALL BE INSTALLED AND MAINTAINED BY CONTRACTOR IN ACCORDANCE WITH NEW YORK STATE STANDARDS FOR EROSION & SEDIMENT CONTROL.
- PERIODIC CLEANING AND INSPECTION OF TEMPORARY EROSION AND SEDIMENT CONTROL DEVICES SHALL BE NECESSARY. ANY DEFICIENCIES SHALL BE RESOLVED WITHIN 24 HOURS.
- SILT FENCES INSTALLED FOR THE PURPOSE OF SLOWING OVERLAND (SHEET) FLOW SHALL BE ARRANGED PERPENDICULAR TO THE DIRECTION OF THE SHEET FLOW. SUCH INSTALLATION MAY REQUIRE SHORT, STAGGERED SEGMENTS OF FENCE IN ORDER TO BE LOCATED WHOLLY WITHIN THE DESIGNATED CONSTRUCTION LIMITS.
- CONTRACTOR SHALL TAKE ALL NECESSARY PRECAUTIONS TO PRECLUDE CONTAMINATION OF ANY WATERWAYS BY SUSPENDED SOLIDS, SEDIMENTS, FUELS, SOLVENTS, LUBRICANTS, EPOXY COATINGS, PAINT, CONCRETE, LEACHATE, OR ANY OTHER ENVIRONMENTALLY DELETERIOUS MATERIALS ASSOCIATED WITH THE PROJECT WORK.
- EROSION AND SEDIMENT CONTROL DEVICES (E.G. SILT FENCING, ETC.) SHALL BE INSPECTED AND MAINTAINED IN EFFECTIVE CONDITION BY CONTRACTOR UNTIL FINAL COMPLETION AND ACCEPTANCE BY OWNER.

RESTORATION NOTES:

- WHEN RESTORING LAWN AREAS, ON-SITE MATERIAL MAY BE USED TO BACKFILL AREA WITHIN FOUR INCHES OF FINISHED SURFACE. FINISHED SURFACE SHALL MATCH EXISTING ELEVATIONS AND GRADES UNLESS OTHERWISE NOTED. ON-SITE MATERIAL SHALL BE THOROUGHLY COMPACTED AND FREE OF GRASS CLUMPS, TREE ROOTS, PIECES OF ASPHALT AND OTHER EXTRANEIOUS MATERIALS, AND STONES LARGER THAN ONE INCH IN SIZE.
- ALL DISTURBED NON-PAVED AREAS SHALL RECEIVE FOUR INCHES OF TOPSOIL, SEED AND MULCH AND SHALL BE WATERED BY CONTRACTOR UNTIL A HEALTHY STAND OF GRASS IS OBTAINED.
- ANY ADJACENT AREAS DISTURBED OR DAMAGED DURING CONSTRUCTION SHALL BE RESTORED TO PRE-CONSTRUCTION CONDITIONS TO THE SATISFACTION OF OWNER AT CONTRACTOR'S EXPENSE.

START UP AND COMMISSIONING NOTES:

- UPON COMPLETION AND PRIOR TO USE, TWO (2) SETS OF AS-BUILT PLANS MUST BE SUBMITTED TOGETHER WITH P.E. CERTIFICATION OF CONSTRUCTION AND ACCEPTABLE LEAKAGE TEST AND PUMP TEST RESULTS.

LEGEND

	EXISTING CONTOUR
	EXISTING CHAIN LINK FENCE
	EXISTING PROPERTY LINE
	APPROXIMATE EXISTING MUNICIPAL BOUNDARY
	EXISTING POWER POLE
	EXISTING OVERHEAD ELECTRIC
	EXISTING WATER MAIN

	EXISTING PIPING, EQUIPMENT AND FEATURES TO BE REMOVED
--	---

	EXISTING PIPING TO BE ABANDONED IN-PLACE
--	--

	NEW PIPING, EQUIPMENT AND FEATURES
--	------------------------------------

	NEW SILT FENCE
--	----------------

	NEW CHAIN LINK FENCE
--	----------------------

	SECTION NUMBER OR DETAIL LETTER REFERENCE
	SHEET NUMBER REFERENCE (INDICATES SHEET NUMBER ON WHICH SECTION WAS CUT OR IS SHOWN)

	POINT OF DISCONNECTION
	POINT OF CONNECTION

TYPICAL VALVE IDENTIFICATION

--

TYPICAL PIPING IDENTIFICATION

--

ABBREVIATIONS

PIPING SERVICE IDENTIFICATION

CW	COLD WATER, POTABLE
D/W	DRAINWASTE
FM	FORCEMAIN
HW	HOT WATER, POTABLE
IW	INSTRUMENT WATER
O/F	OVERFLOW
PD	PROCESS DRAIN
PW	PLANT WATER (NON-POTABLE)
RW	RAW WATER
SAN	SANITARY SEWER
SAW	SAMPLE WATER
ST	STORM SEWER
TW	TEMPERED WATER
V	VENT
W	WATER (GENERAL)

PIPE MATERIALS

CI	CAST IRON
CPVC	CHLORINATED POLYVINYL CHLORIDE
CS	CARBON STEEL
CU	COPPER
DI	DUCTILE IRON
GS	GALVANIZED STEEL
HDPE	HIGH DENSITY POLYETHYLENE
PVC	POLYVINYL CHLORIDE
SS	STAINLESS STEEL


VALVES


AVV	AIR/VACUUM VALVE
ARV	AIR RELEASE VALVE
BV	BALL VALVE
BFV	BUTTERFLY VALVE
CV	CHECK VALVE
GLV	GLOBE VALVE
GV	GATE VALVE
SCV	SURGE CONTROL VALVE

MISCELLANEOUS

ALUM	ALUMINUM
B/	BOTTOM OF
B	SURVEY BASELINE
BM	BENCHMARK
BOL	BOLLARD
C	CENTERLINE
CLR	CLEAR
CMU	CONCRETE MASONRY UNIT
CONC.	CONCRETE
CORP.	CORPORATION STOP
DR	DIMENSIONAL RATIO
EL	ELEVATION
EOP	EDGE OF PAVEMENT
ELEC.	ELECTRIC
E&SC	EROSION & SEDIMENT CONTROL
EXIST.	EXISTING
FF	FINISHED FLOOR
FLG.	FLANGE
FPOST	FENCE POST
HP	HIGH POINT
INV.	INVERT
LF	LINEAR FEET
LP	LOW POINT
MJ	MECHANICAL JOINT
NO	NORMALLY OPEN
OC	ON CENTER
OHE	OVERHEAD ELECTRIC
OPNG.	OPENING
PE	PLAIN END
PERF.	PERFORATED
PO	PUSH ON
PS	PUMPING STATION
RED.	REDUCER
SDR	STANDARD DIMENSIONAL RATIO
SF	SILT FENCE
ST. STL.	STAINLESS STEEL (OTHER THAN PIPING)
SWPPP	STORM WATER POLLUTION PREVENTION PLAN
TJ	TOP OF
TYP.	TYPICAL
VFD	VARIABLE FREQUENCY DRIVE
W	WITH
WW	EXISTING WATER VALVE
WW	WASTEWATER

		IN ACCORDANCE WITH TITLE VIII, ARTICLE 145, SECTION 7209 (2) OF THE NEW YORK STATE EDUCATION LAW, IT IS A VIOLATION OF LAW FOR ANY PERSON UNLESS ACTING UNDER THE DIRECTION OF A LICENSED ENGINEER TO ALTER THIS DOCUMENT.			
IN CHARGE OF <u>R. GELL</u>		CHECKED BY <u>D. ROONEY</u>			
MADE BY <u>T. LARAMAY</u>				O'BRIEN & GERE ENGINEERS, INC.	
				50 MAIN ST., 10TH FLOOR, SUITE 1000 WHITE PLAINS, NEW YORK 10606	
REVISION NUMBER	DATE	MADE BY	APP'D BY	REVISION	
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WESTCHESTER COUNTY, NEW YORK DEPARTMENT OF PUBLIC WORKS AND TRANSPORTATION DIVISION OF ENGINEERING				CONTRACT NUMBER 17-529	SHEET NUMBER G-001
				SHEET NO. 2 OF 60	
CROTONVILLE PUMPING STATION REHABILITATION OSSINING SANITARY SEWER DISTRICT OSSINING, NEW YORK INDEX TO DRAWINGS, NOTES, SYMBOLS & ABBREVIATIONS				SCALE: N.T.S. DATE: 12/21/2018 DPW FILE NO. 208-03-G-26-0	REV. NO. 0

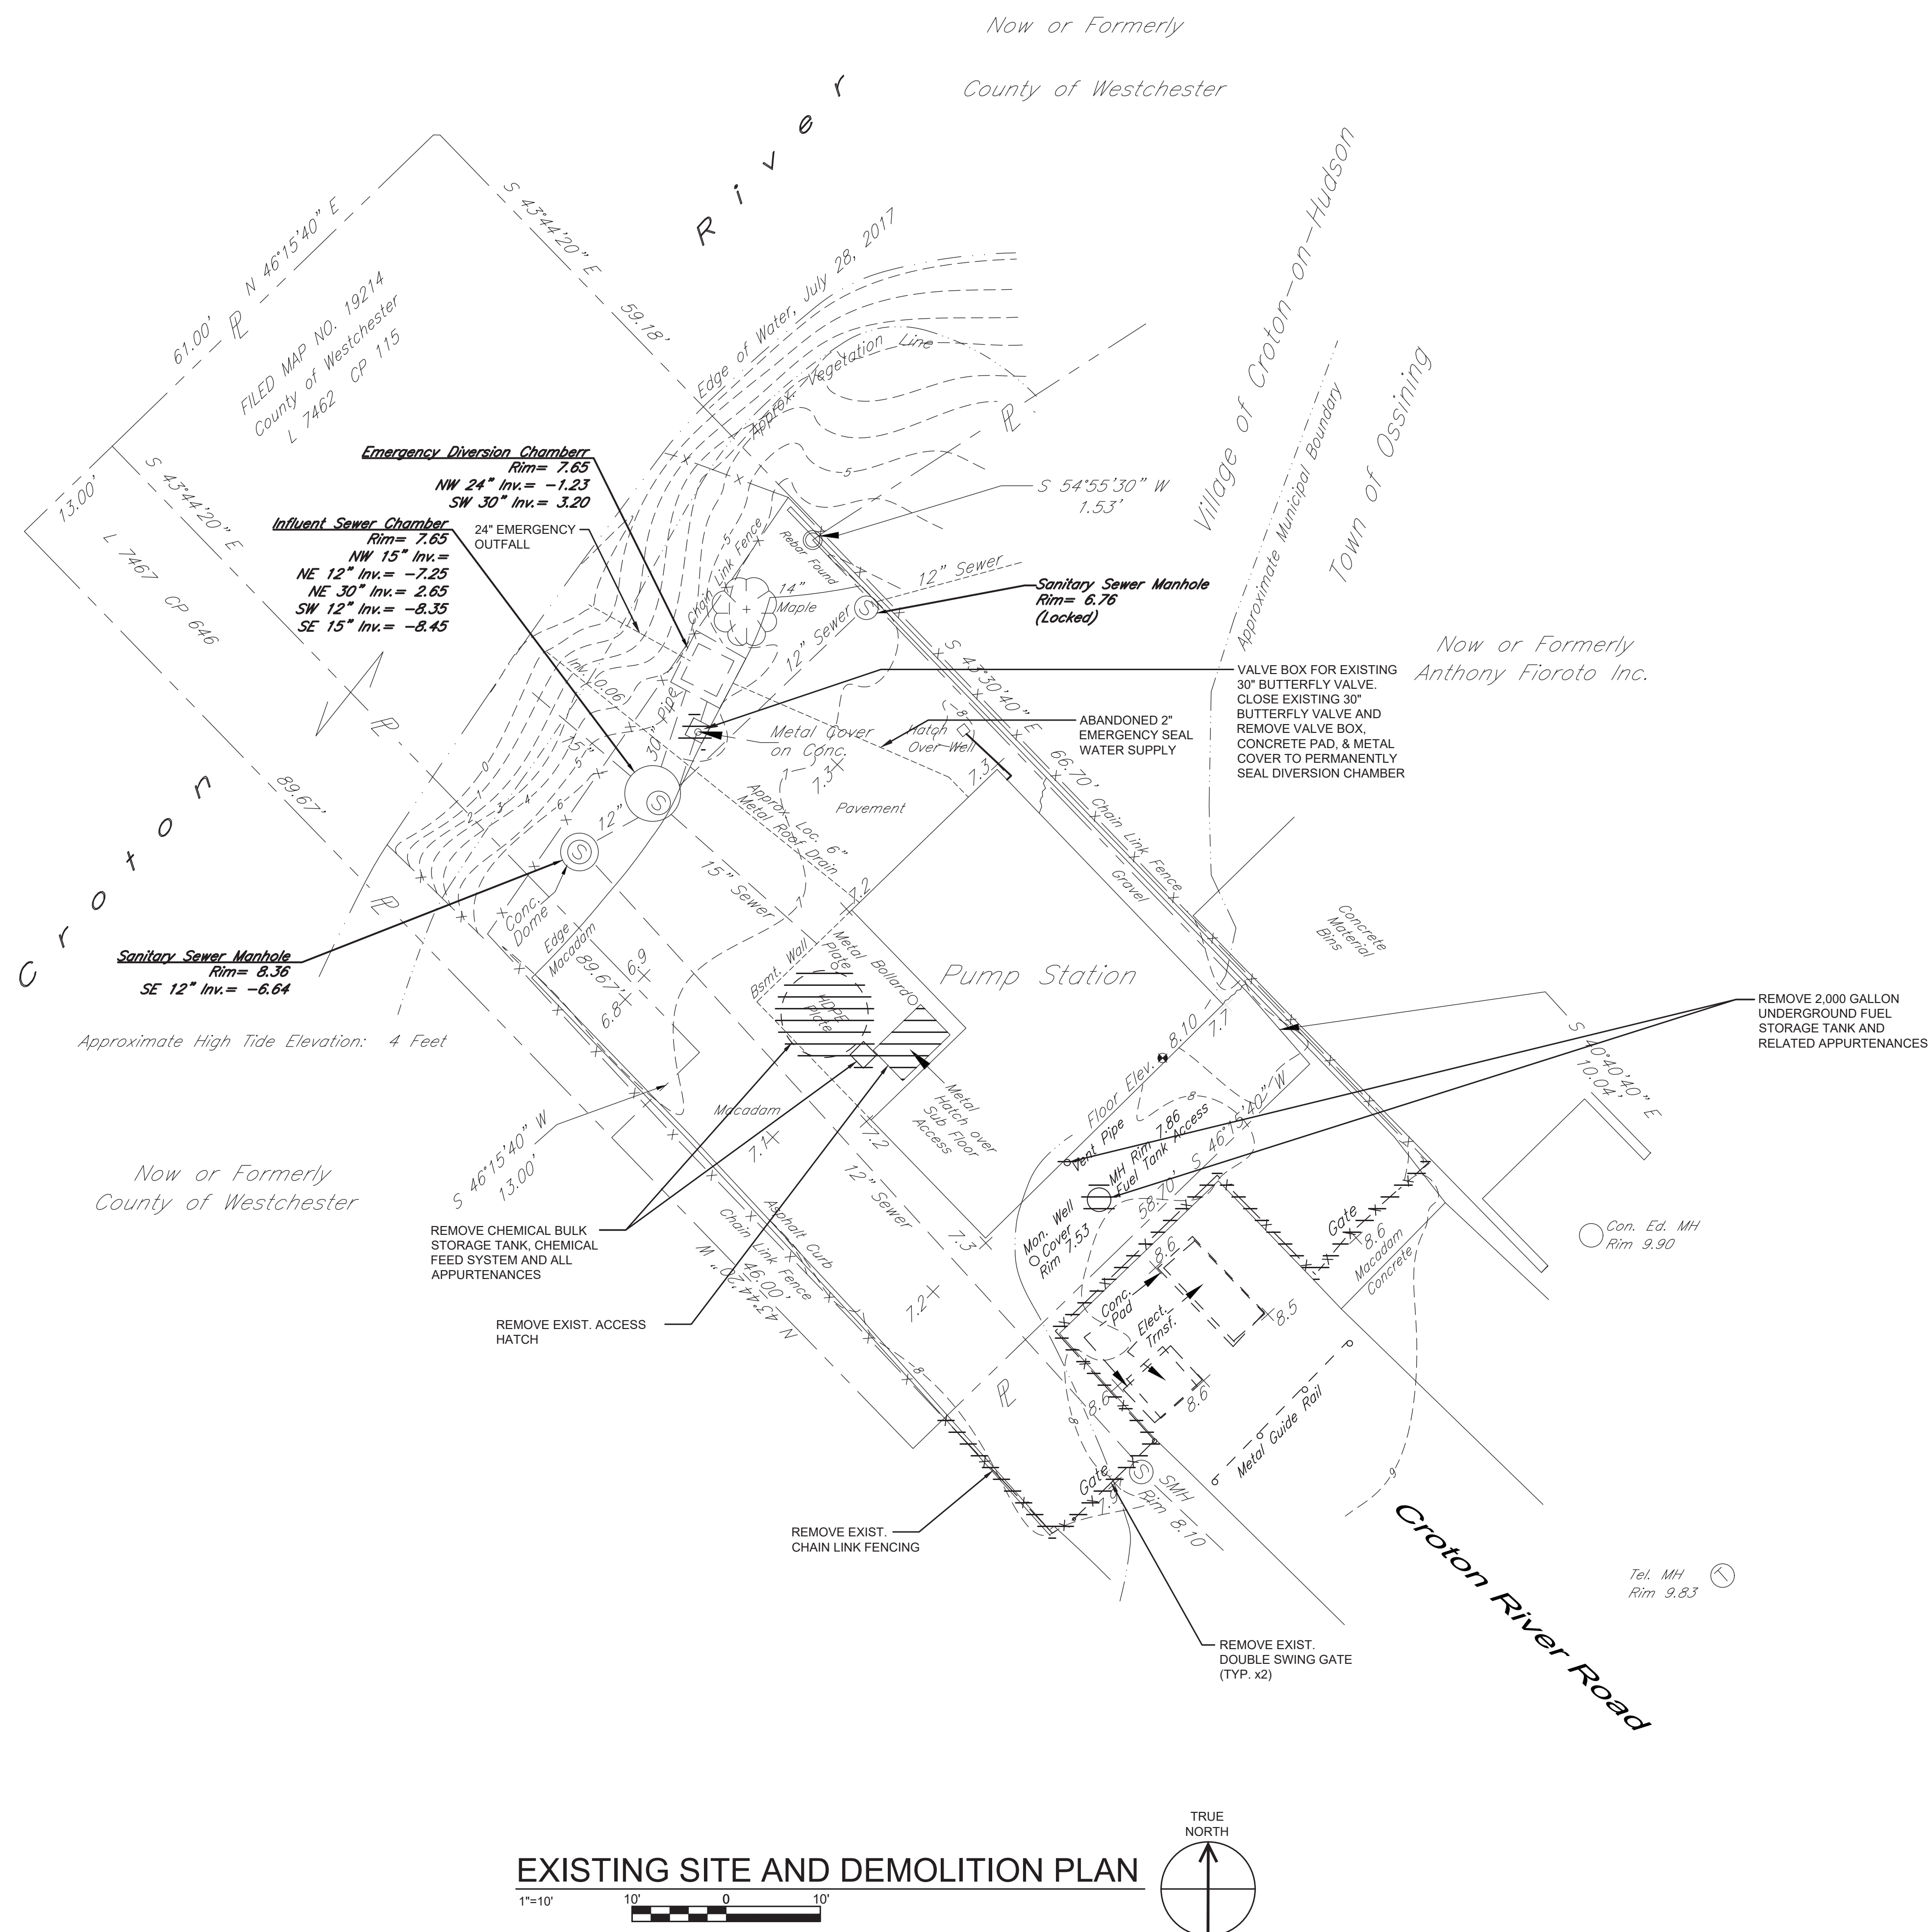

			IN ACCORDANCE WITH TITLE VIII, ARTICLE 14B, SECTION 7209 (2) OF THE NEW YORK STATE EDUCATION LAW, IT IS A VIOLATION OF LAW FOR ANY PERSON UNLESS ACTING UNDER THE DIRECTION OF A LICENSED ENGINEER TO ALTER THIS DOCUMENT.		
			O'BRIEN & GERE ENGINEERS, INC. 50 MAIN ST., 10TH FLOOR, SUITE 1000 WHITE PLAINS, NEW YORK 10606		
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WESTCHESTER COUNTY, NEW YORK DEPARTMENT OF PUBLIC WORKS AND TRANSPORTATION DIVISION OF ENGINEERING					
CROTONVILLE PUMPING STATION REHABILITATION OSSINING SANITARY SEWER DISTRICT OSSINING, NEW YORK EXISTING SITE AND DEMOLITION PLAN				CONTRACT NUMBER 17-529	SHEET NUMBER C-101
				SHEET NO. 3 OF 60	
				SCALE: 1" = 10' DATE: 12/21/2018 DPW FILE NO. 208-03-G-27-0	
				REV. NO.: 0	

1.1 TEMPORARY BYPASS PERFORMANCE REQUIREMENTS:

- A. EXTENDED DURATION BYPASS PUMPING OF CROTONVILLE PUMPING STATION DURING CONSTRUCTION:
- DURATION: AS REQUIRED TO SUBSTANTIALLY COMPLETE CONSTRUCTION AND RENOVATION OF CROTONVILLE PUMPING STATION AND PLACE NEW PUMPING EQUIPMENT INTO RELIABLE SERVICE.
 - DESIGN PEAK CAPACITY: 3,300 GAL/MIN. AT 203 FEET TDH (BASED ON 2012 HISTORICAL DATA).
 - AVERAGE FLOW: 530 GAL/MIN. (BASED ON 2012 HISTORICAL DATA).
- B. PROVIDE SPARE PUMPING CAPACITY EQUAL TO THE CAPACITY OF THE LARGEST SINGLE BYPASS PUMP, AVAILABLE ON-SITE FOR USE IN EVENT OF EQUIPMENT FAILURE.
- C. SIZE SUCTION AND DISCHARGE PIPING TO ACHIEVE VELOCITY NO HIGHER THAN 12 FEET/SECOND AT SPECIFIED DESIGN PEAK PUMPING CAPACITY.


1.2 GENERAL:

- A. BYPASS PUMPING SYSTEM SHALL UTILIZE EXISTING INFLUENT SEWER CHAMBER, 24" FORCEMAIN, AND NEW BYPASS SEWER CONNECTION PIPING, AS SHOWN ON THE CONTRACT DRAWINGS.
- B. PRIMARY BYPASS PUMPS SHALL BE ELECTRIC, SELF-PRIMING TYPE (GODWIN DRI-PRIME ®, OR EQUAL), OPERATED AUTOMATICALLY BY LIQUID LEVEL CONTROLS. BYPASS PUMPING SYSTEM SHALL MEET PERFORMANCE REQUIREMENTS SPECIFIED HEREIN.
- C. ADDITIONAL REDUNDANT BYPASS PUMP(S) SHALL BE CRITICALLY SILENCED DIESEL ENGINE-DRIVEN, SELF-PRIMING TYPE (GODWIN DRI-PRIME ®, OR EQUAL), OPERATED AUTOMATICALLY BY LIQUID LEVEL CONTROLS. BYPASS PUMPING SYSTEM SHALL MEET PERFORMANCE REQUIREMENTS SPECIFIED HEREIN. DIESEL-ENGINE DRIVEN PUMP(S) SHALL SERVE AS BACKUP IN THE EVENT OF AN ELECTRICAL POWER FAILURE.
- D. INFLUENT SLUICE GATE SHALL BE CLOSED AND BYPASS PUMPING SYSTEM SHALL DRAW SUCTION FROM EXISTING INFLUENT SEWER CHAMBER AS SHOWN ON THE CONTRACT DRAWINGS.
- E. BYPASS PUMPING SYSTEM SHALL DISCHARGE TO NEW BYPASS SEWER CONNECTION ON EXISTING FORCEMAIN AS SHOWN ON THE CONTRACT DRAWINGS. CONTRACTOR MAY PROPOSE AN ALTERNATIVE BYPASS PUMPING SYSTEM FOR REVIEW BY THE ENGINEER. ALTERNATIVE BYPASS PUMPING FACILITIES SHALL MEET THE PERFORMANCE REQUIREMENTS SPECIFIED.

1.3 EXECUTION:


- A. CONSTRUCT AND TEST FORCEMAIN BYPASS CONNECTION PIPING PRIOR TO NEED FOR TEMPORARY BYPASS PUMPING; MAINTAIN CONNECTION TO EXISTING PUMPING STATION DISCHARGE PIPING UNTIL PERMANENT DISCHARGE PIPING HAS BEEN INSTALLED.
- B. INSTALL AND TEST TEMPORARY LINE STOP ON EXISTING FORCEMAIN AND TEMPORARY TAP AND DRAIN VALVE ON DISCHARGE PIPE INSIDE PUMPING STATION. REMOVE EXISTING PIPE WITH TEMPORARY DRAIN BETWEEN THE HOURS OF MIDNIGHT TO 6:00 AM AND INSTALL NEW PERMANENT 16" TEE, 6" DRAIN VALVE, 16" DISCHARGE ISOLATION GATE VALVE, AND A TEMPORARY TEST FLANGE. TEST COMPLETION PLUG AND REMOVE LINE STOP AFTER TESTING OF 16" DISCHARGE ISOLATION GATE VALVE. COLLECT DRAINAGE AND PUMP SEWAGE TO ACCEPTABLE STORAGE OR DISPOSAL LOCATION THROUGHOUT INSTALLATION AND REMOVAL OF TEMPORARY LINE STOP. PROVIDE PERMANENT BLIND FLANGE ON DRAIN VALVE AND LEAVE TEMPORARY TEST FLANGE ON 16" GATE VALVE UNTIL REMAINDER OF NEW DISCHARGE PIPING IS TO BE ASSEMBLED.
- C. CLOSE INFLUENT SLUICE GATE AND IMPLEMENT TEMPORARY BYPASS PUMPING BEFORE INITIATING DEMOLITION OR REMOVAL WORK; MAINTAIN CONTINUOUS BYPASS PUMPING UNTIL STRUCTURAL, MECHANICAL, HVAC AND ELECTRICAL WORK IS SUBSTANTIALLY COMPLETE AND RELIABLE SYSTEM PERFORMANCE IS DEMONSTRATED.

SITE PLAN


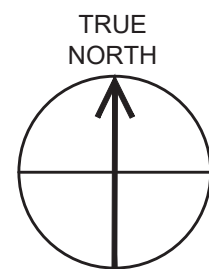


DRAWING NOTES:

- DO NOT LOCATED BOLLARDS DIRECTLY IN FRONT OF ELECTRICAL PANELS OR DOORS. COORDINATION FINAL LOCATIONS WITH EQUIPMENT PROVIDED AND ENGINEER
- PERFORM THE FOLLOWING MEASURES TO PERMIT INSTALLATION OF FORCEMAIN BYPASS CONNECTION AS SHOWN:
 - OWNER WILL STOP PUMPING OPERATIONS AND CLOSE GATE AT INFLUENT CHANNEL.
 - DRAIN 24-INCH FORCEMAIN BACK TO PUMPING STATION. PUMP WASTEWATER DRAINED FROM FORCEMAIN, AS WELL AS INFLUENT WASTEWATER ENTERING PUMPING STATION FOR DURATION OF BYPASS CONNECTION WORK, INTO APPROPRIATE WASTEWATER COLLECTION/TRANSPORT VEHICLES UNTIL BYPASS CONNECTION PIPING IS COMPLETE AND SECURED. DISCHARGE COLLECTED WASTEWATER IN ACCORDANCE WITH ALL APPLICABLE REGULATIONS. NO DISCHARGE FEES WILL BE IMPOSED BY OWNER.
 - OWNER WILL RESUME NORMAL OPERATION OF CROTONVILLE PUMPING STATION AFTER BYPASS PUMPING CONNECTION IS COMPLETE AND SECURED.
- PEAK BYPASS PUMPING CAPACITY: 3,300 GPM AT 203 FEET TDH.

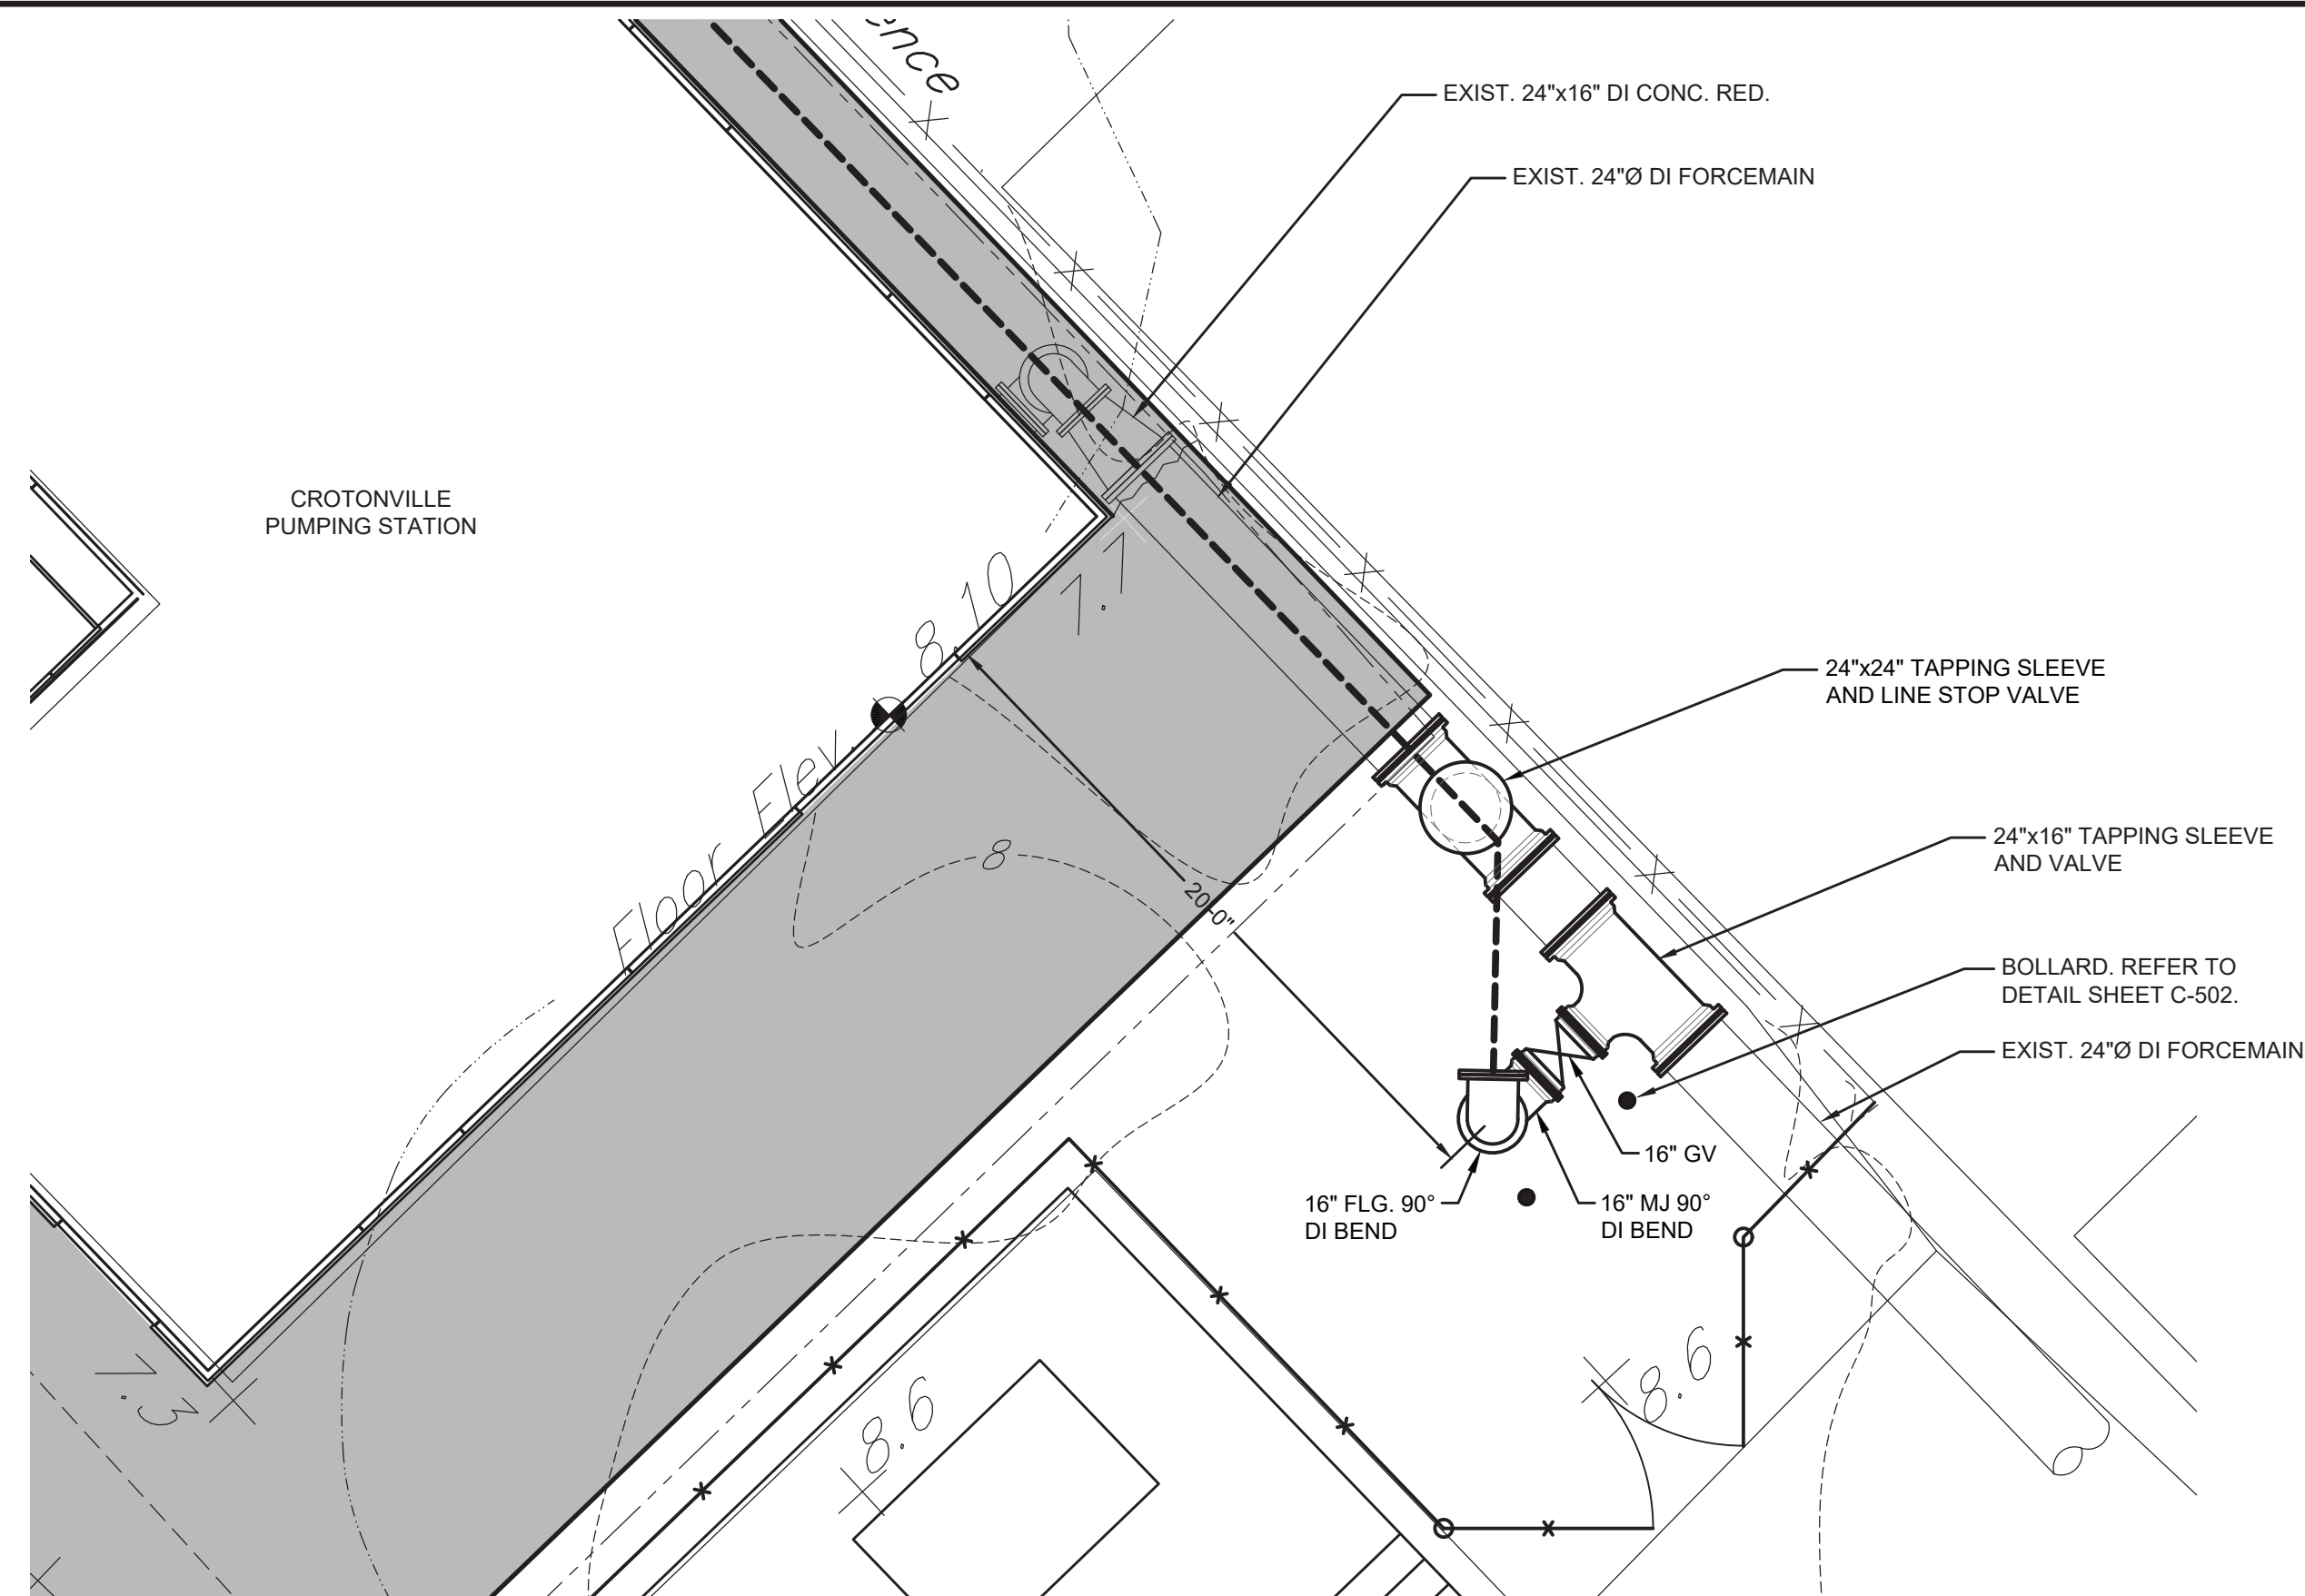

PARTIAL SITE PLAN

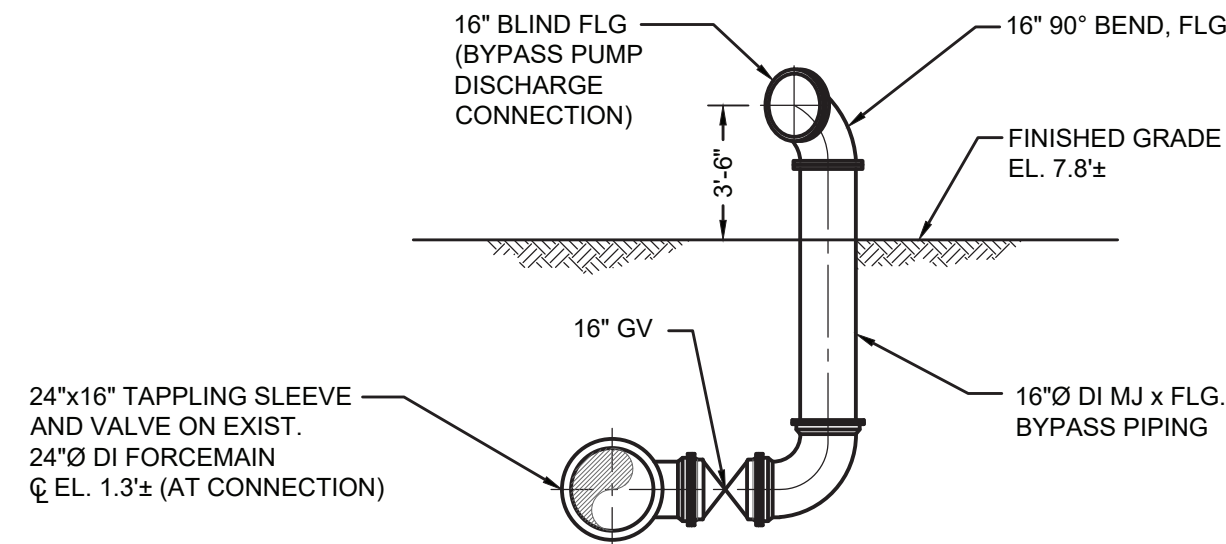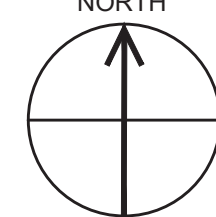

BYPASS CONNECTION DETAIL



IN ACCORDANCE WITH TITLE VIII, ARTICLE 145, SECTION 7209 (2) OF THE NEW YORK STATE EDUCATION LAW, IT IS A VIOLATION OF LAW FOR ANY PERSON UNLESS ACTING UNDER THE DIRECTION OF A LICENSED ENGINEER TO ALTER THIS DOCUMENT.

IN CHARGE OF R. GELL
CHECKED BY D. ROONEY
MADE BY T. LARAMAY




O'BRIEN & GERE ENGINEERS, INC.
50 MAIN ST., 10TH FLOOR, SUITE 1000
WHITE PLAINS, NEW YORK 10606


RECORD DRAWING CERTIFICATION

- ☐ AS BUILT - CHANGES AS NOTED
☐ AS BUILT - NO CHANGES

CONTRACTOR		PROJECT COORDINATOR	
NAME		NAME	
SIGNATURE		SIGNATURE	
TITLE	DATE	TITLE	DATE
WESTCHESTER COUNTY, NEW YORK			
DEPARTMENT OF PUBLIC WORKS AND TRANSPORTATION			
DIVISION OF ENGINEERING			
CROTONVILLE PUMPING STATION REHABILITATION		SCALE: AS NOTED	
OSSINING SANITARY SEWER DISTRICT		DATE: 12/21/2018	
OSSINING, NEW YORK		DPW FILE NO.	
SITE PLAN		208-03-G-28-0	
		REV. NO.	
		0	

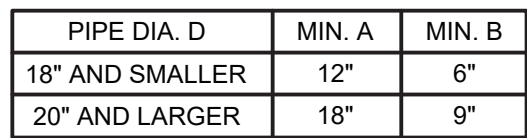

1. DIMENSIONS REFLECT COMPACTED THICKNESS.
2. EXCAVATED MATERIAL MAY BE USED AS BACKFILL ONLY WHERE APPROVED BY CONSULTANT IN NON-PAVED AREAS.
3. BEDDING AND BACKFILL PLACED ADJACENT TO AND UP TO 12 INCHES OVER PIPE SHALL BE PLACED IN LOOSE LIFTS NOT EXCEEDING 8 INCHES, AND SHALL BE COMPACTED TO 95% MAXIMUM DENSITY (MODIFIED PROCTOR) IN A MANNER THAT WILL NOT DAMAGE THE PIPE.
4. BACKFILL PLACED IN EXCESS OF 12 INCHES OVER TOP OF PIPE SHALL BE COMPACTED TO 95% MAXIMUM DRY DENSITY IN PAVEMENT AREAS AND STRUCTURAL AREAS, AND 90% OF THE MAXIMUM DRY DENSITY IN NON-PAVED AREAS. HORIZONTAL LIFTS SHALL NOT EXCEED 8 INCHES.
5. BEDDING MATERIAL SHALL BE PLACED AND COMPACTED AT A MOISTURE CONTENT WITHIN +2% OF ITS OPTIMUM MOISTURE CONTENT.
6. PAYMENT LIMITS SHOWN ARE MAXIMUM ALLOWED. MINIMUM TRENCH WIDTH SHALL EXTEND 12 INCHES EACH SIDE OF PIPE.
7. CONTRACTOR SHALL RESTORE EXISTING UNPAVED SURFACES WITH TOPSOIL AND SEED TO ESTABLISH SPECIFIED GRADE.

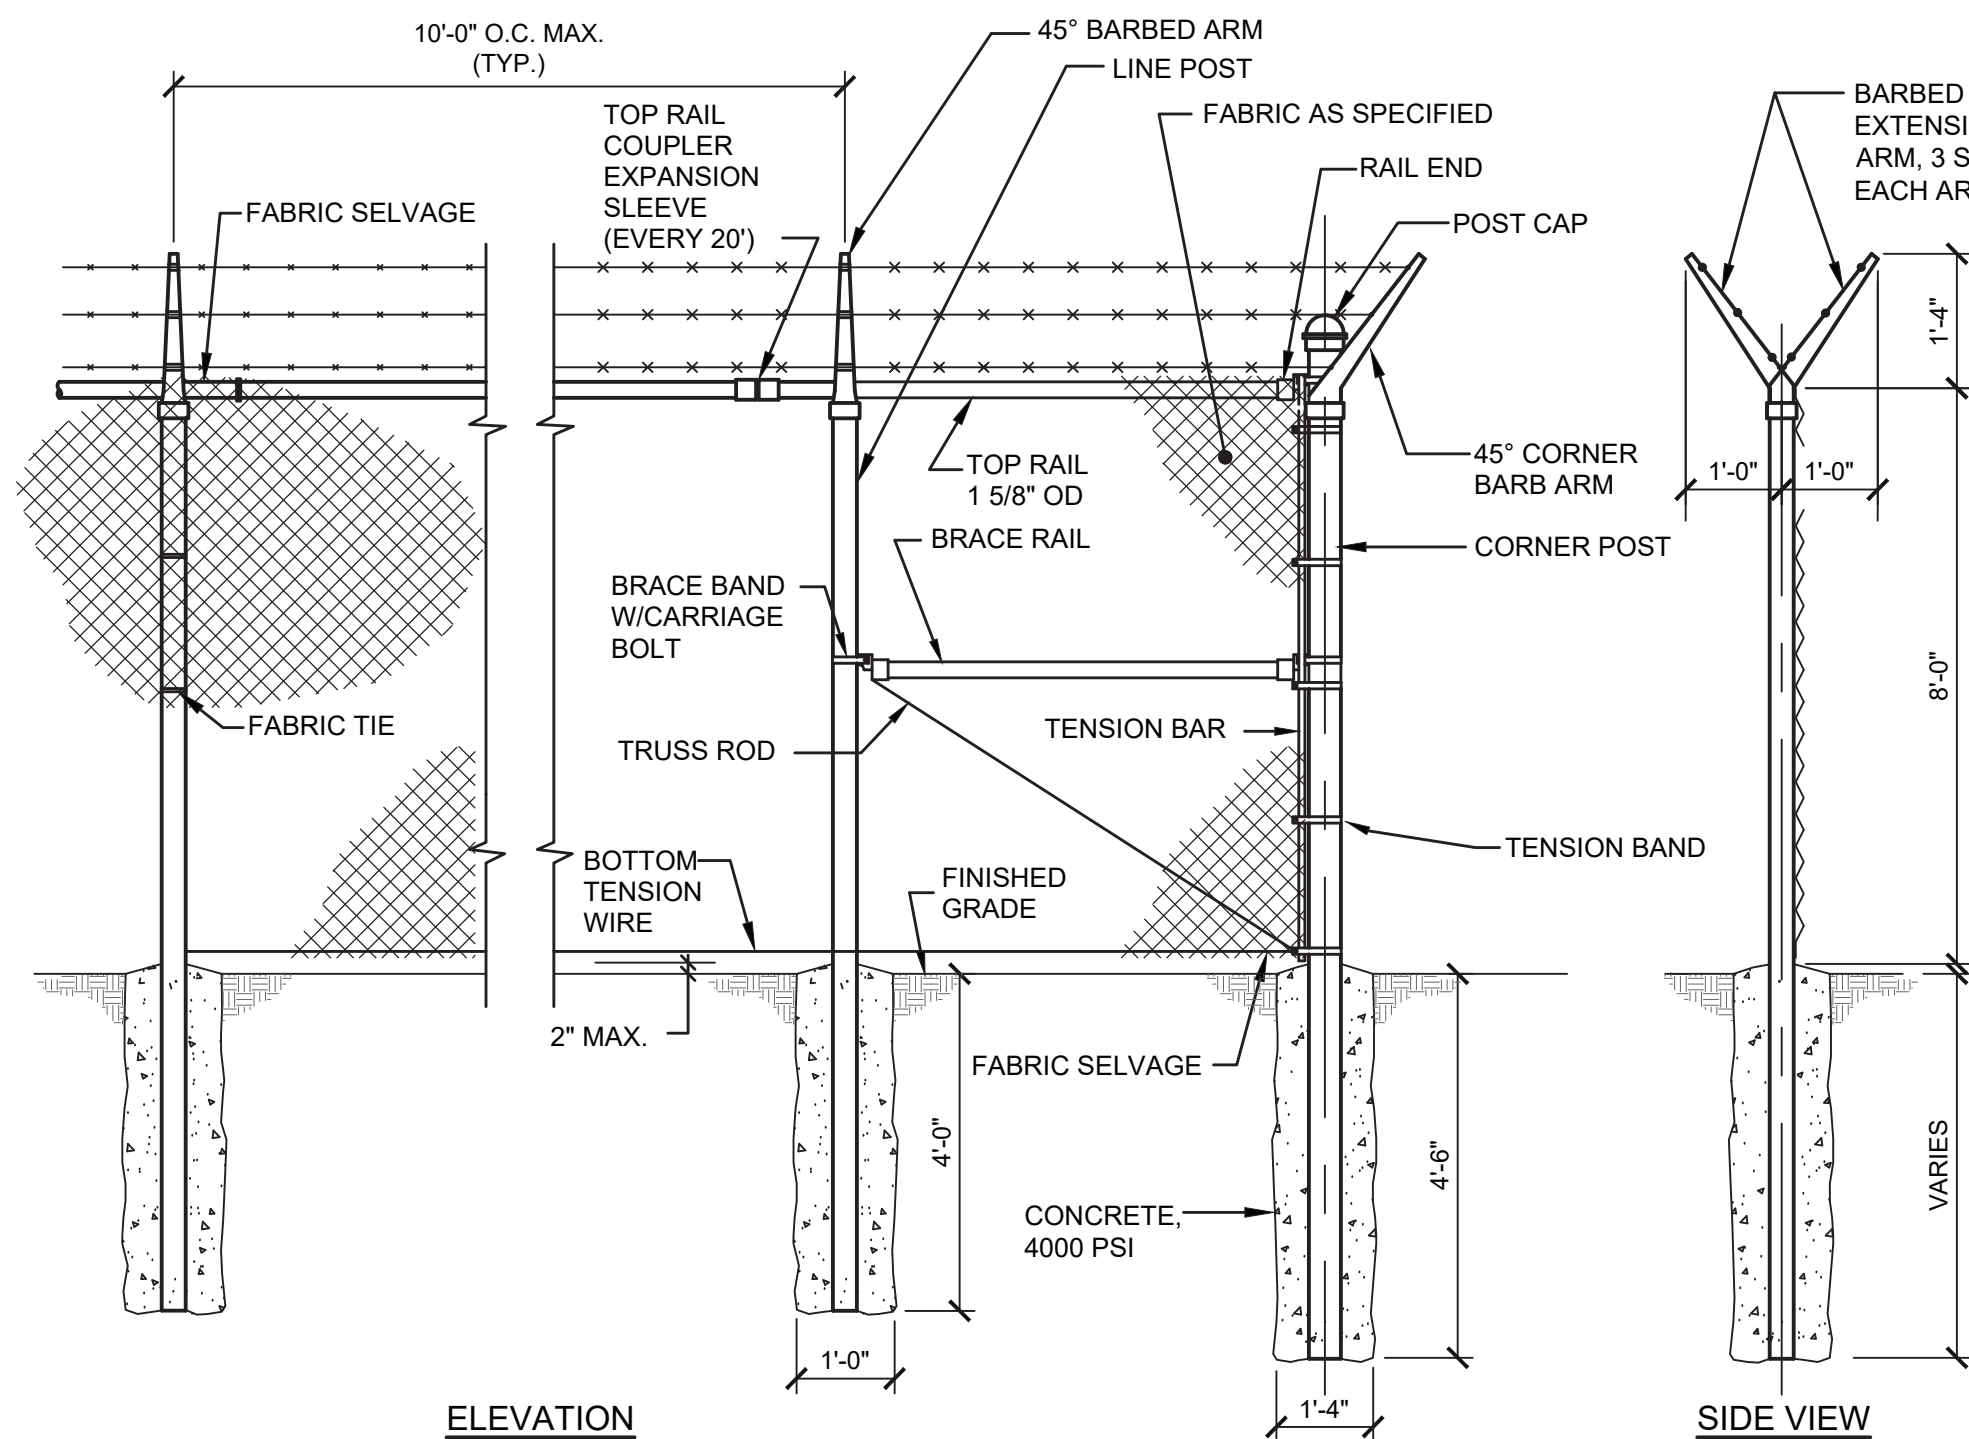

1. BRACE GATES SIMILAR TO CORNER POSTS.
2. CONFORM BOTTOM OF FENCE TO FINISHED GRADE.
3. SEE SITE PLANS REGARDING USE OF EXISTING POSTS/FOUNDATIONS.
4. BRACE RAILS SHALL BE ON THE INSIDE OF THE FENCE WITH NO FOOTHOLDS ON THE OUTSIDE OF THE FENCE.

NOT TO SCALE


1. WOVEN WIRE FENCE TO BE FASTENED SECURELY TO FENCE POSTS WITH WIRE TIES OR STAPLES.
2. FILTER CLOTH TO BE FASTENED SECURELY TO WOVEN WIRE FENCE WITH TIES SPACED EVERY 24" AT TOP AND MID SECTION.
3. WHEN TWO SECTIONS OF FILTER CLOTH ADJOIN EACH OTHER THEY SHALL BE OVERLAPPED BY SIX INCHES AND FOLDED.
4. MAINTENANCE SHALL BE PERFORMED AS NEEDED AND MATERIAL REMOVED WHEN "BULGES" DEVELOP IN THE SILT FENCE.
5. THE LOCATION OF SILT FENCE SHALL BE AS INDICATED ON SHEET G-101. SILT FENCING ASSOCIATED WITH THE CONSTRUCTION STAGING AREAS IS NOT REQUIRED IF THE GRASS IS RETAINED WITHIN THE CONSTRUCTION STAGING AREA.

NOT TO SCALE

NOT TO SCALE


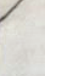
1. FIELD LOCATE WITH CONSULTANT. PROVIDE MINIMUM OF 6.
2. TYPICAL LOCATION IS 2'-0" OFF FACE OF STRUCTURE OR FACE OF CURB, UNLESS OTHERWISE NOTED.


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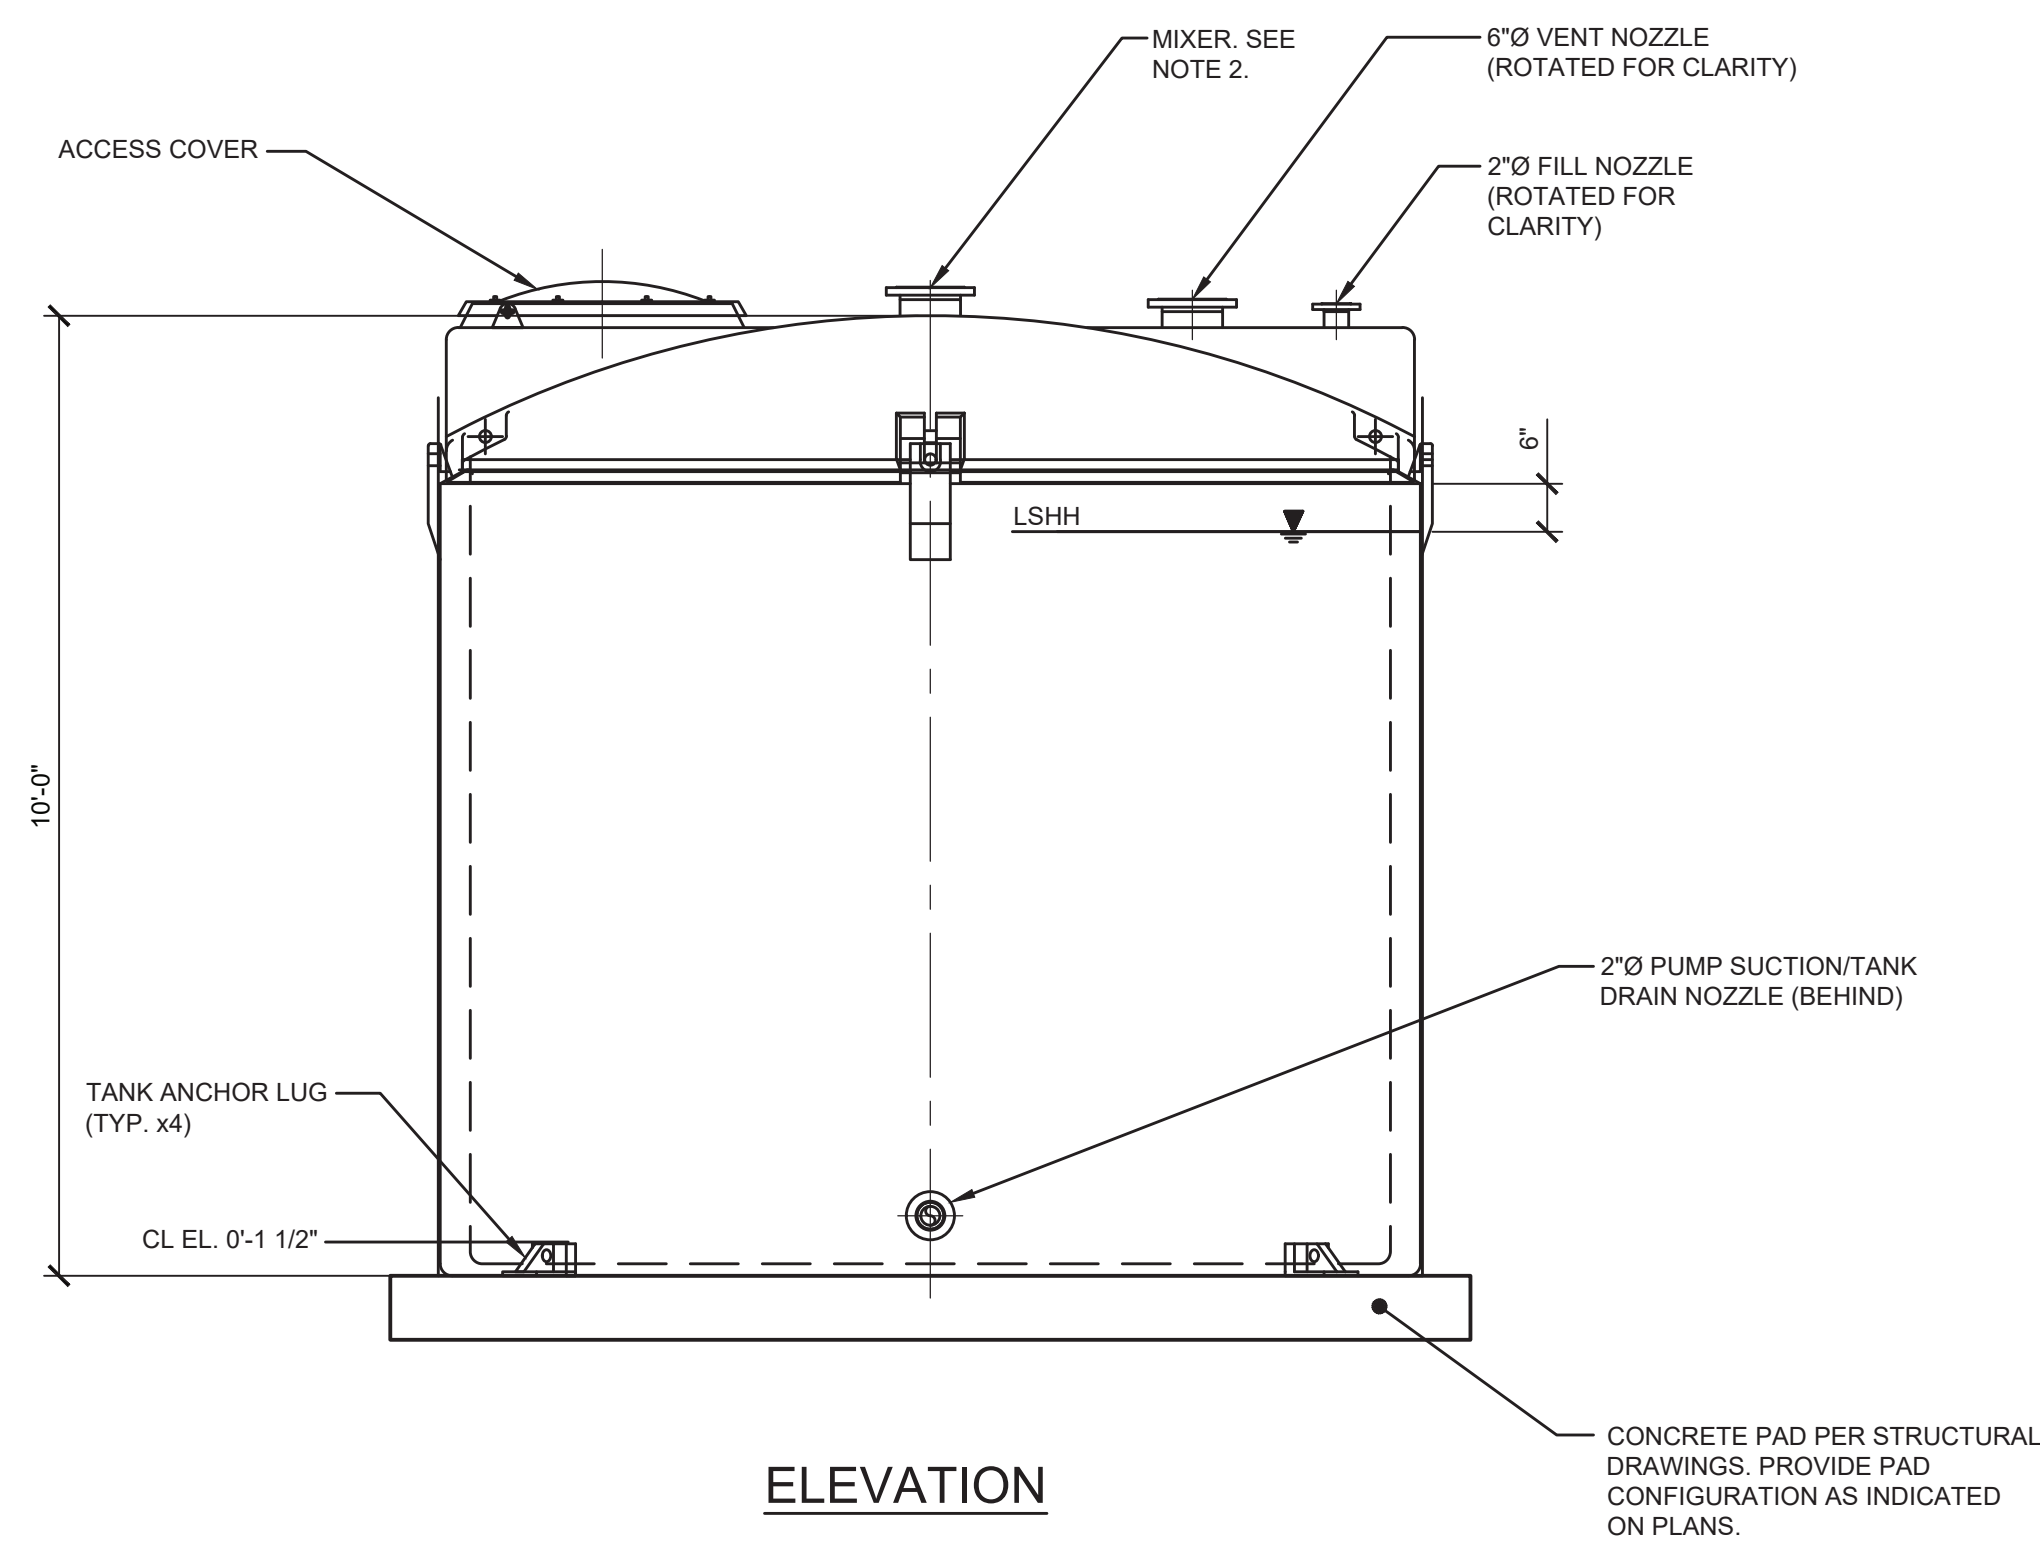
1. PROVIDE MISCELLANEOUS HARDWARE SIMILAR TO THAT USED IN LINE OF FENCE
2. PROVIDE MECHANICAL KEEPER AT FULL OPEN POSITION FOR EACH GATE LEAF. SET IN CONCRETE EQUIVALENT TO FENCE POST DETAIL.
3. LOCK WILL BE SUPPLIED BY OWNER.
4. SUBMIT SHOP DRAWINGS FOR APPROVAL.

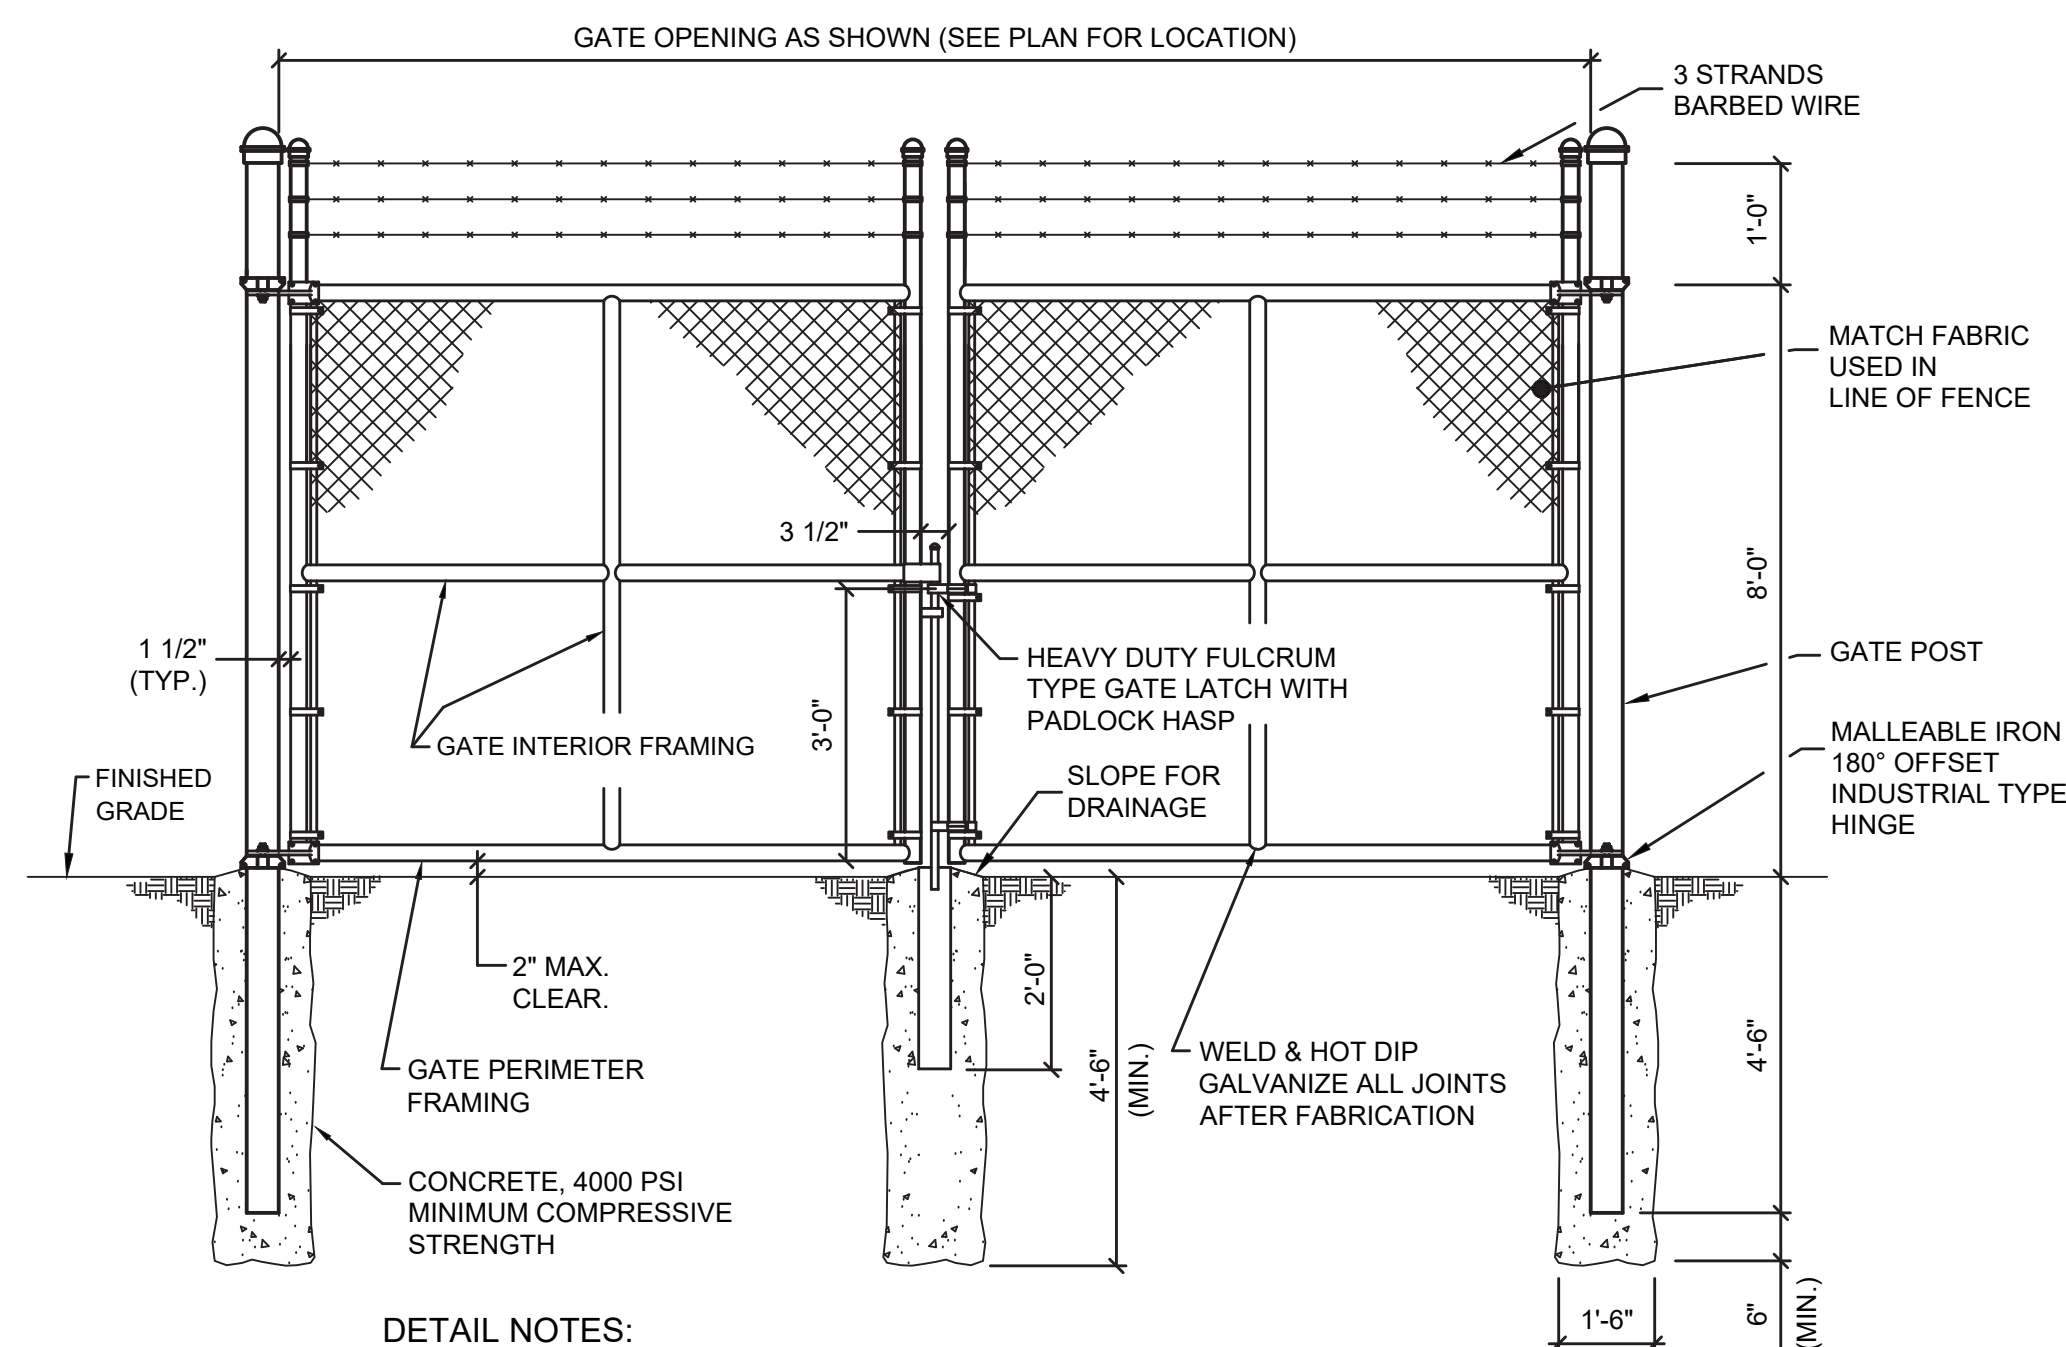NOT TO SCALE

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	IN CHARGE OF <u>R. GELL</u>		
	CHECKED BY <u>D. ROONEY</u>		
	MADE BY <u>T. LARAMAY</u>		
<i>DocuSign</i>			
REVISION NUMBER	DATE	MADE BY	APPD BY
		REVISION	
RECORD DRAWING CERTIFICATION			
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CONTRACTOR NAME _____ SIGNATURE _____ TITLE _____ DATE _____		PROJECT COORDINATOR NAME _____ SIGNATURE _____ TITLE _____ DATE _____	
WESTCHESTER COUNTY, NEW YORK		DEPARTMENT OF PUBLIC WORKS AND TRANSPORTATION	
DIVISION OF ENGINEERING			
CROTONVILLE PUMPING STATION REHABILITATION OSSISING SANITARY SEWER DISTRICT OSSISING, NEW YORK DETAILS		CONTRACT NUMBER 17-529	SHEET NUMBER C-501
		SHEET NO. 5 OF 60	
		SCALE: AS NOTED DATE: 12/21/2018	
		DPW FILE NO. 208-03-G-29-0	REV. NO.: 0



PLAN

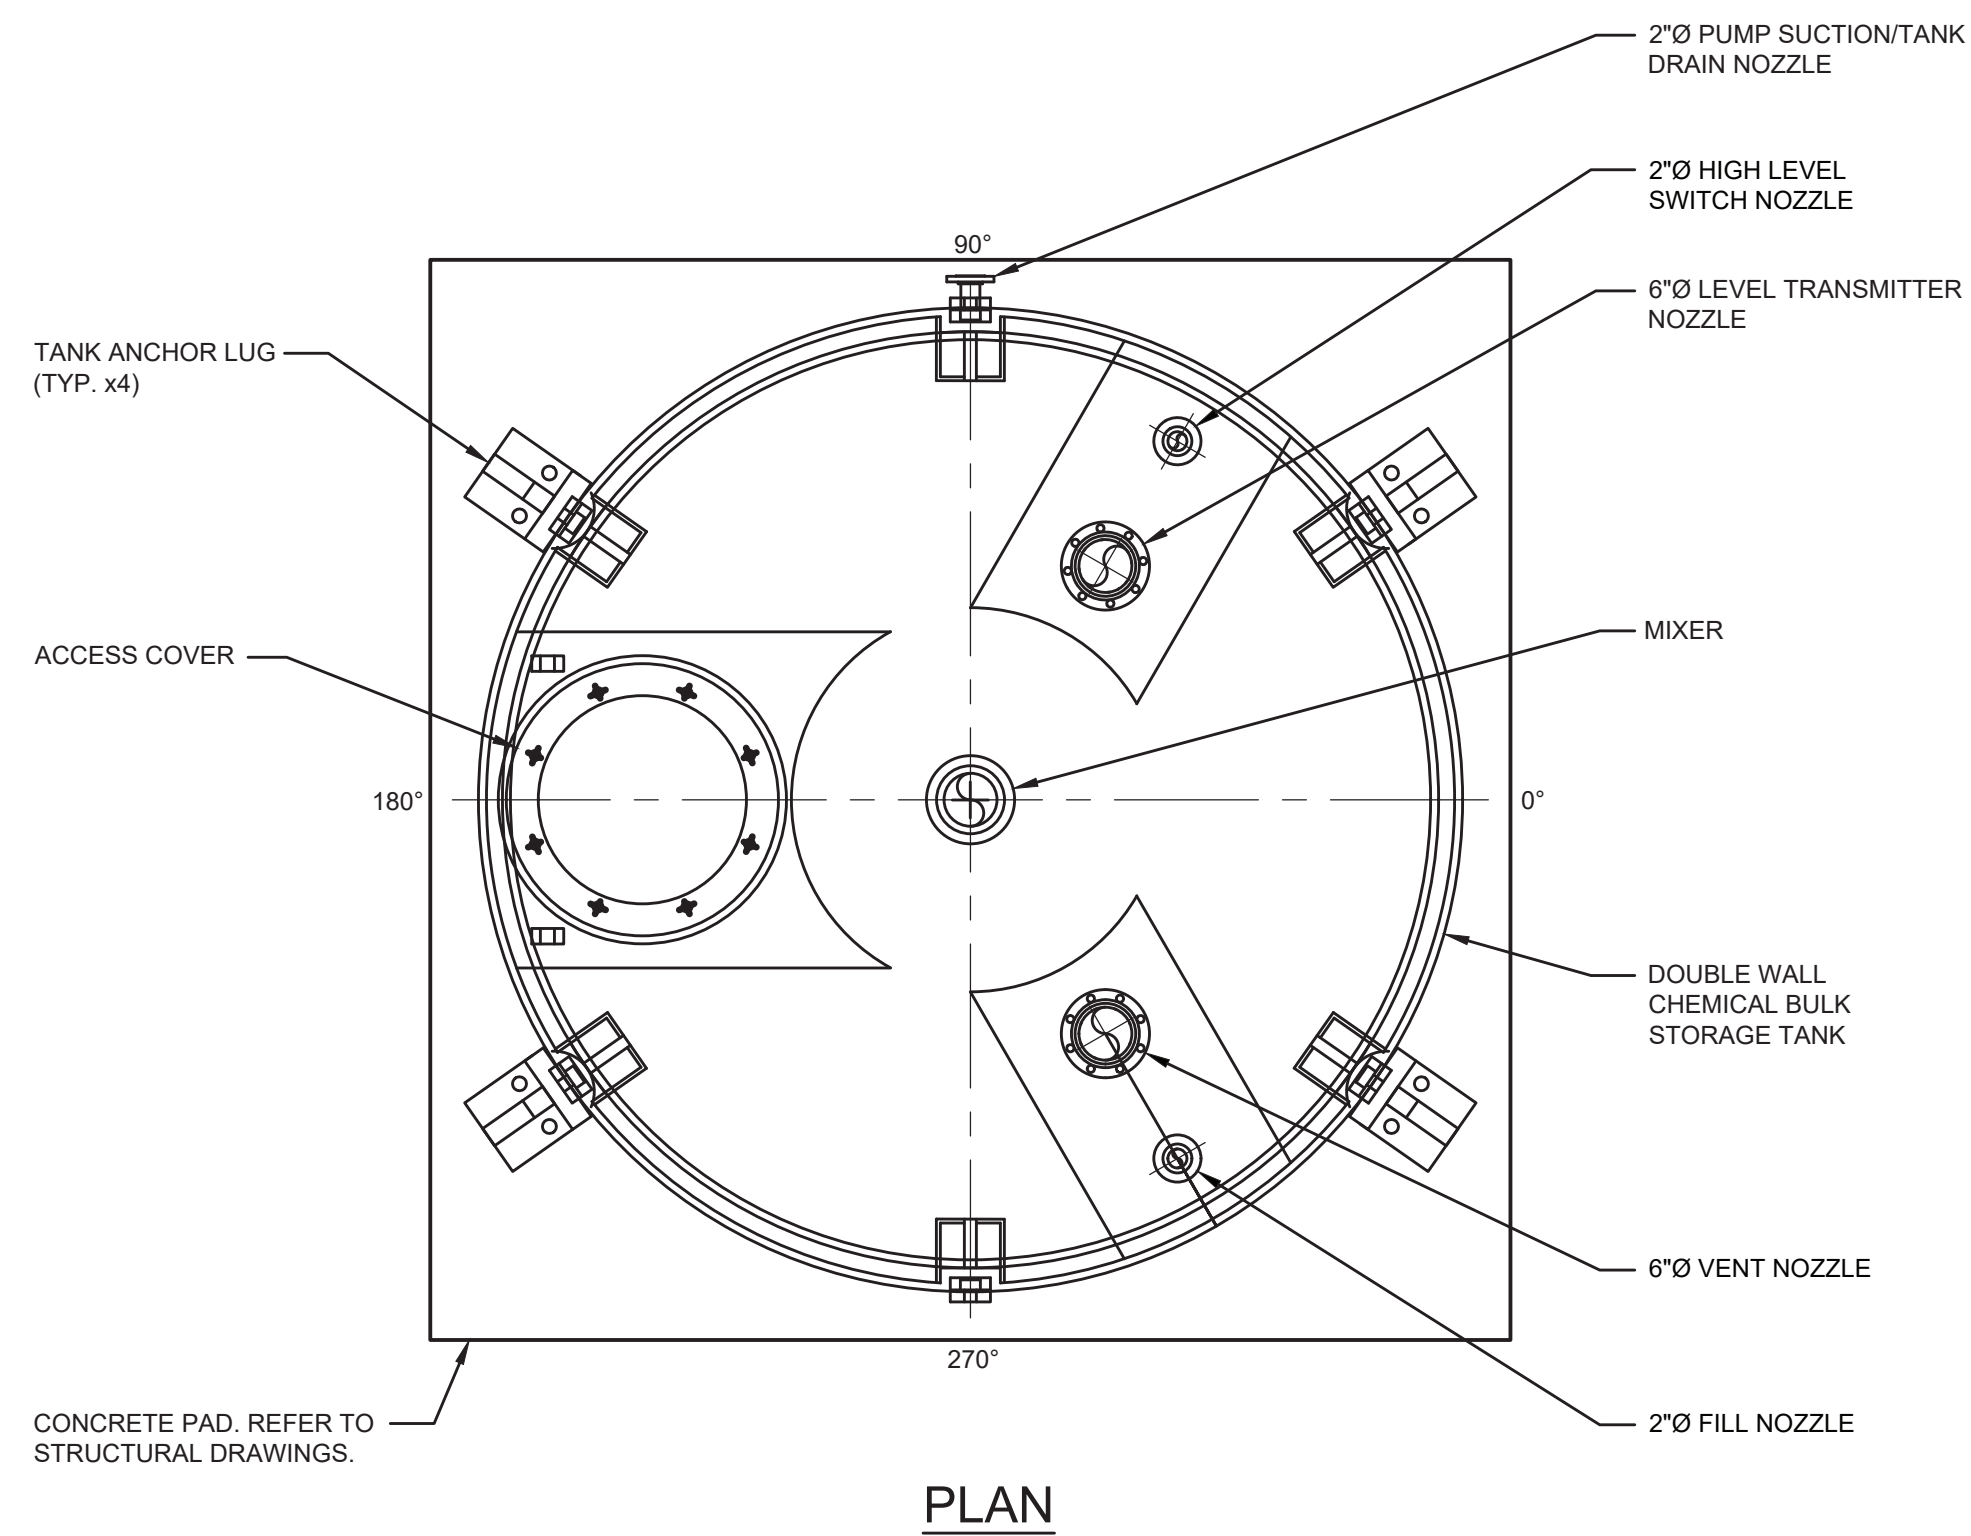
ELEVATION

DETAIL NOTES:

1. PROVIDE FLEXIBLE CONNECTION (FITTINGS SUPPLIED BY TANK MANUFACTURER) AT PUMP SUCTION/TANK DRAIN.
2. COORDINATE MIXER MOUNTING CONFIGURATION AND SIZE WITH MIXER MANUFACTURER.


CHEMICAL BULK STORAGE TANK DETAIL

NOT TO SCALE

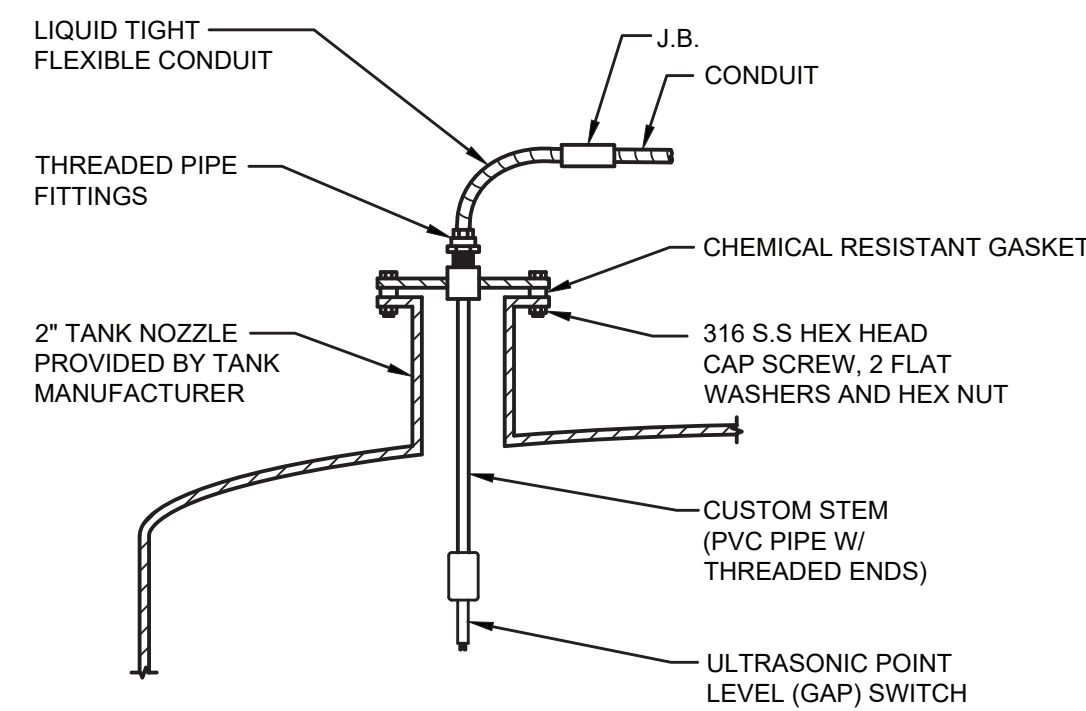

CHEMICAL TANK HIGH LEVEL SWITCH DETAIL

NOT TO SCALE

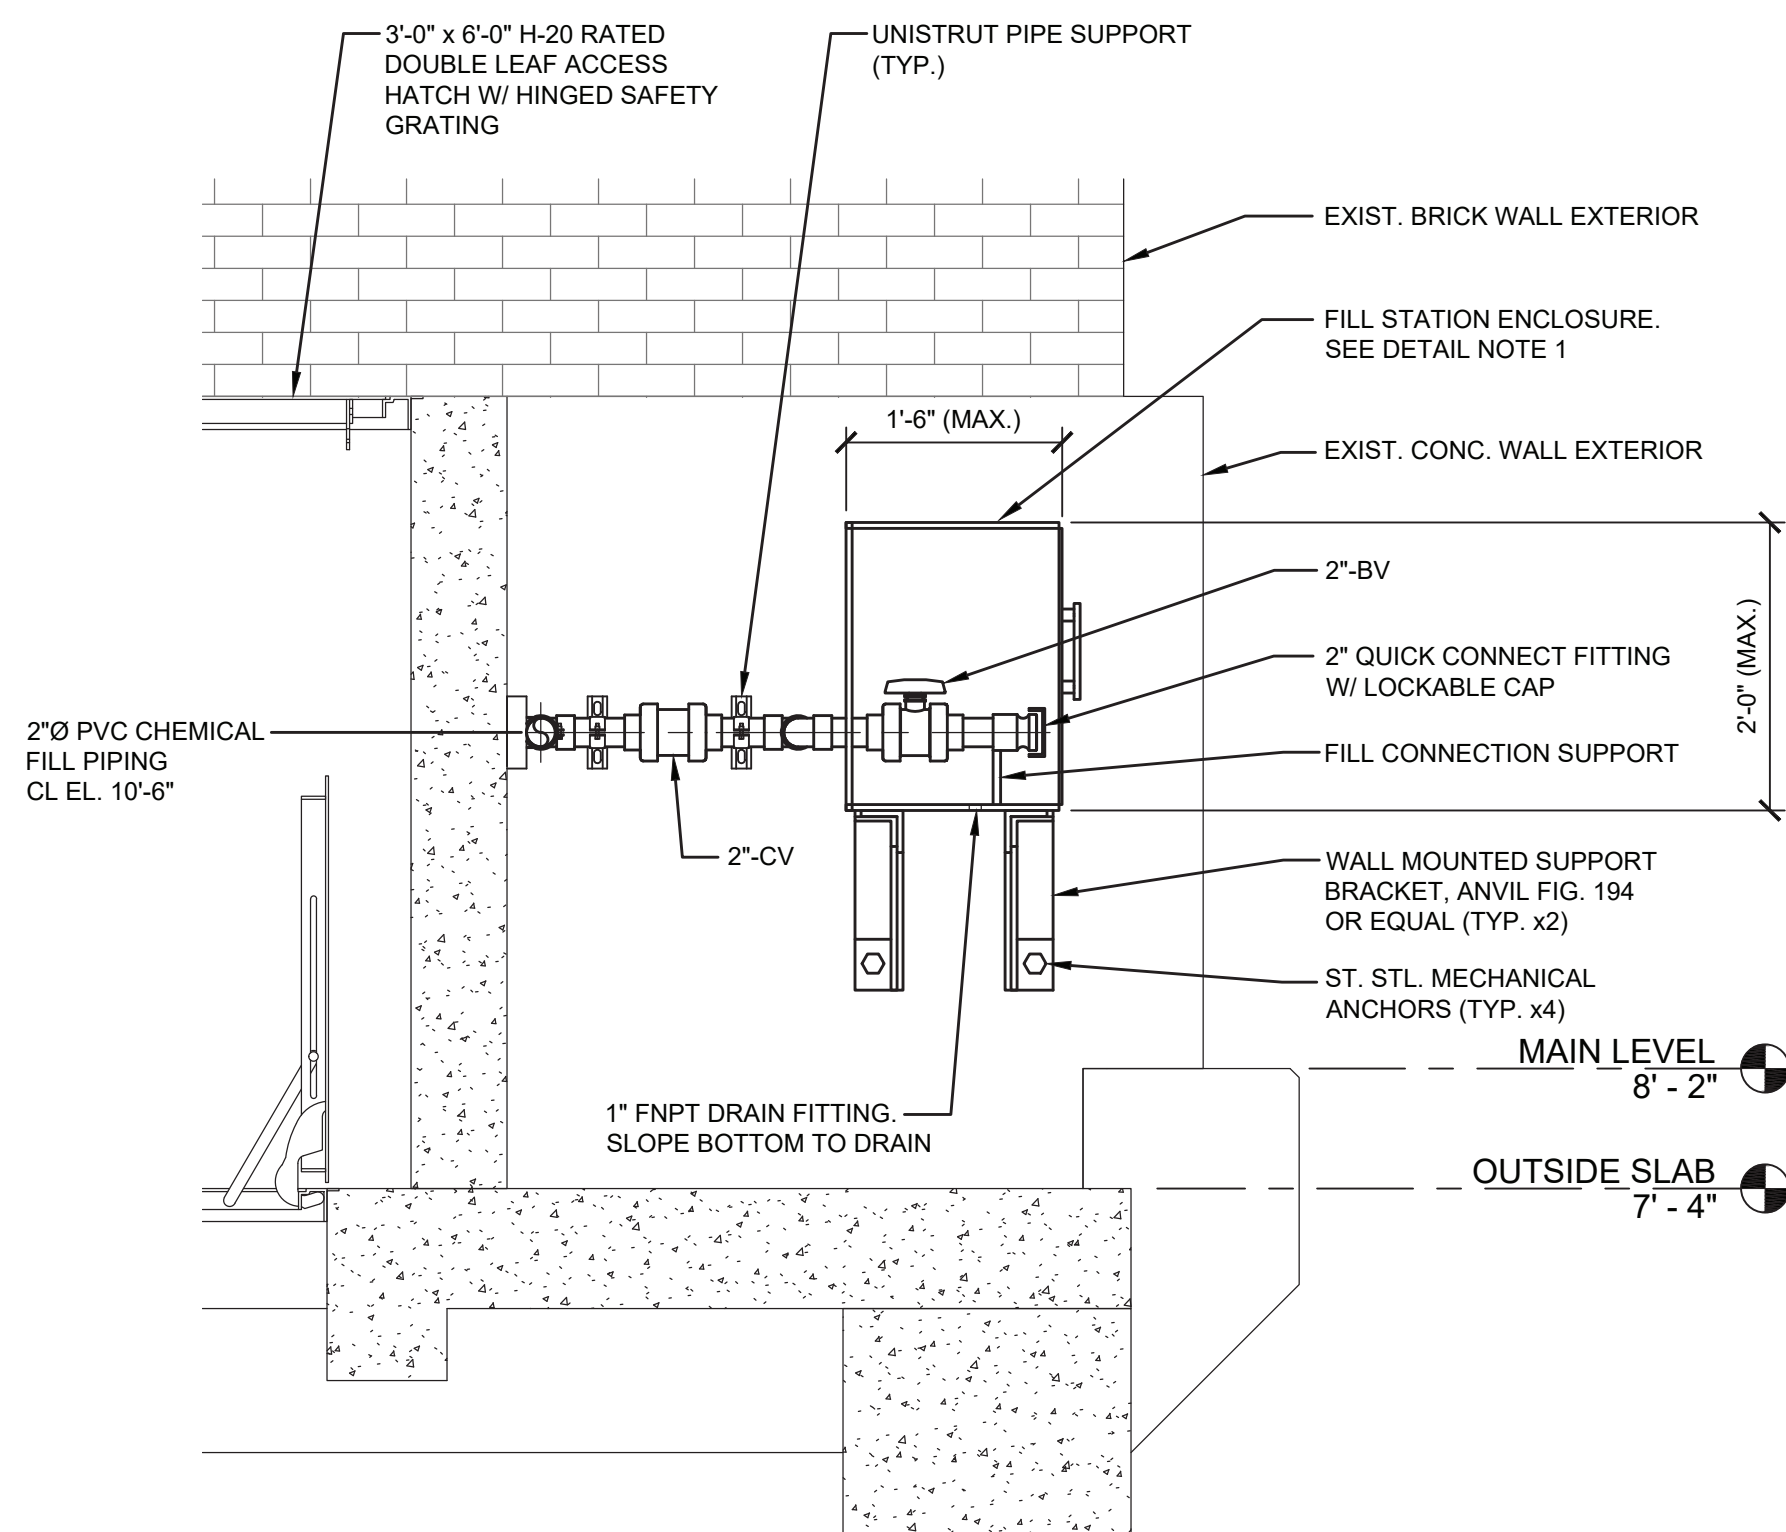


DETAIL NOTES:

1. FABRICATE ENCLOSURE (APPROX. 2'-0" HIGH X 2'-0" WIDE X 1'-6" DEEP) IN SHOP OF 1/2"-INCH THICK GRAY PVC SHEET WITH SOLVENT WELDED JOINTS. SLOPE BOTTOM OF ENCLOSURE FOUR WAYS TO DRAIN CONNECTION. PROVIDE LATCHING DOOR WITH POLYPROPYLENE PIANO HINGE AND STAINLESS STEEL FASTENERS AND HARDWARE. SUBMIT SHOP DRAWING FOR REVIEW PRIOR TO FABRICATION. ATTACH TO SUPPORTS WITH STAINLESS STEEL HARDWARE.


CHEMICAL FILL STATION DETAIL

NOT TO SCALE

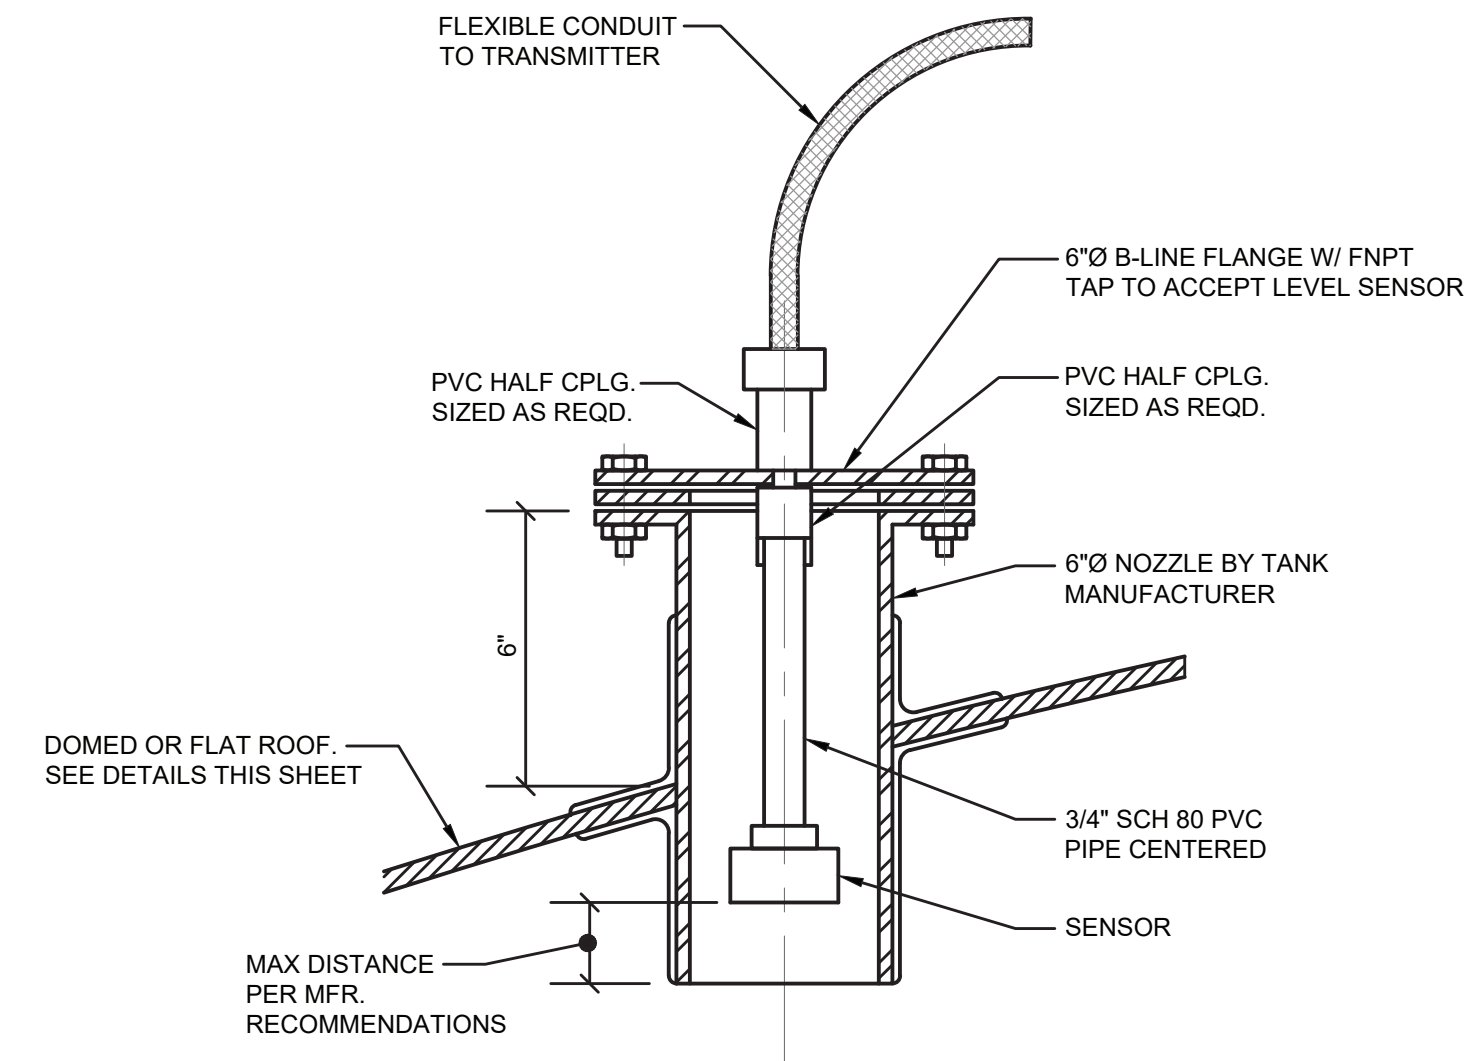

CHEMICAL TANK ULTRASONIC LEVEL SENSOR

NOT TO SCALE

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	IN CHARGE OF <u> R. GELL </u>				
	CHECKED BY <u> D. ROONEY </u>				
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REVISION NUMBER	DATE	MADE BY	APPD BY	REVISION	
RECORD DRAWING CERTIFICATION					
<input type="checkbox"/> AS BUILT - CHANGES AS NOTED <input type="checkbox"/> AS BUILT - NO CHANGES					
CONTRACTOR NAME _____ SIGNATURE _____ TITLE _____ DATE _____			PROJECT COORDINATOR NAME _____ SIGNATURE _____ TITLE _____ DATE _____		
WESTCHESTER COUNTY, NEW YORK DEPARTMENT OF PUBLIC WORKS AND TRANSPORTATION DIVISION OF ENGINEERING			CONTRACT NUMBER 17-529	SHEET NUMBER C-502	SHEET NO. 6 OF 60
CROTONVILLE PUMPING STATION REHABILITATION OSSISING SANITARY SEWER DISTRICT OSSISING, NEW YORK DETAILS			SCALE: AS NOTED DATE: 12/21/2018 DPW FILE NO. 208-03-G-30-0 REV. NO. 0		

STRUCTURAL GENERAL NOTES

1. WORK SHALL COMPLY WITH THE NEW YORK STATE UNIFORM FIRE PREVENTION AND BUILDING CODE (BASED ON IBC 2015).
2. THE CONTRACTOR SHALL COORDINATE SPECIAL INSPECTIONS WITH OWNER.
3. SECTIONS AND DETAILS SHOWN ON DRAWINGS ARE TYPICAL. USE SIMILAR CONSTRUCTION AT LOCATIONS NOT SPECIFICALLY DETAILLED OR NOT STATED.
4. EXAMINE AND COMPARE STRUCTURAL DRAWINGS WITH ARCHITECTURAL, MECHANICAL, PLUMBING, SITE, ELECTRICAL, AND PROCESS DRAWINGS. VERIFY LOCATIONS AND DIMENSIONS OF CHASES, INSERTS, OPENINGS, SLEEVES, DEPRESSIONS, AND OTHER PROJECT REQUIREMENTS NOT SHOWN ON THE STRUCTURAL DRAWINGS.
5. VERIFY LOCATION OF EXISTING UNDERGROUND SITE UTILITIES PRIOR TO THE START OF WORK AND COORDINATE LOCATION WITH STRUCTURAL DRAWINGS. NOTIFY THE ENGINEER OF ANY CONFLICTS IN WRITING. DO NOT PROCEED WITH AFFECTED WORK UNTIL CONFLICTS HAVE BEEN RESOLVED.
6. ADEQUATE TEMPORARY BRACING OF CONSTRUCTION ELEMENTS SHALL BE PROVIDED FOR FOUNDATIONS, ABOVE GRADE WALLS, STRUCTURAL STEEL, AND OTHER STRUCTURAL SYSTEMS FOR WIND AND/OR CONSTRUCTION LOADS. BRACING SHALL BE MAINTAINED AT ALL TIMES DURING CONSTRUCTION OPERATIONS PRIOR TO STRUCTURAL ELEMENTS REACHING THEIR SPECIFIED DESIGN STRENGTH AND/OR REACHING THEIR COMPLETED LOCATION SHOWN ON THE QUALITY ASSURANCE DESIGN AND MAINTENANCE OF SAID BRACING SHALL BE THE SOLE RESPONSIBILITY OF THE CONTRACTOR.
7. VERIFY IN FIELD EXISTING CONDITIONS AND DIMENSIONS PRIOR TO THE START OF WORK. NOTIFY THE ENGINEER OF RECORD OF ANY DISCREPANCIES IN WRITING. DO NOT PROCEED WITH AFFECTED WORK UNTIL DISCREPANCIES HAVE BEEN RESOLVED.
8. PRIOR TO EXCAVATION ADJACENT TO EXISTING STRUCTURES, DOCUMENT EXISTING DISTRESS TO THE EXISTING STRUCTURES INCLUDING PHOTOGRAPHIC LOCATIONS, AND DETAILED DESCRIPTIONS OF DISTRESS NOTED. SUBMIT DOCUMENTATION OF EXISTING DISTRESS, FOR RECORD PURPOSES, PRIOR TO PROCEEDING WITH EXCAVATION WORK.

STRUCTURAL FOUNDATION NOTES

1. FOUNDATION DESIGNS ARE BASED ON PRESUMPTIVE SOIL TYPES AND BEARING PRESSURES AS NOTED IN THE STRUCTURAL DESIGN CRITERIA. IF DURING EXCAVATION SOIL PROPERTIES APPEAR DIFFERENT THAN PRESUMED, CONTRACTOR SHALL NOTIFY ENGINEER OF RECORD BEFORE PROCEEDING WITH WORK.
2. GROUND WATER LEVELS SHALL BE LOWERED TO A MINIMUM OF 3 FEET BELOW MAXIMUM EXCAVATION DEPTH. LOWERING OF GROUND WATER SHALL BE CONTINUOUS DURING CONSTRUCTION AND SHALL BE MAINTAINED UNTIL BACKFILL IS PLACED TO AT LEAST 2 FEET ABOVE THE HIGHEST GROUND WATER ELEVATION. DESIGN AND MAINTENANCE OF SYSTEM TO LOWER GROUND WATER SHALL BE THE SOLE RESPONSIBILITY OF THE CONTRACTOR.
3. FOUNDATIONS OR SLABS SHALL NOT BE PLACED IN WATER, OR SATURATED SUBGRADES, NOR ON FROZEN SUBGRADES. IN PLACE FOUNDATIONS AND SLABS SHALL BE PROTECTED FROM FROST PENETRATION UNTIL FROST IS COMPLETE.
4. PLACE FOUNDATIONS ON 12 INCH THICKNESS OF CRUSHED STONE SUBBASE. COMPACT EXISTING SUBGRADE PRIOR TO PLACEMENT OF FOUNDATIONS.
5. COMPACTED STRUCTURAL BACKFILL: STRUCTURAL BACKFILL SHALL BE USED FOR BACKFILL BEHIND PERMANENT WALLS AND WHEREVER LOAD-BEARING CAPABILITY IS REQUIRED INCLUDING UNDER STRUCTURES, PAVEMENTS, AND SIDEWALKS. STRUCTURAL FILL SHALL CONSIST OF WELL-GRADED SAND, GRAVEL, CRUSHED ROCK, RECYCLED CONCRETE AGGREGATE, OR A MIXTURE OF THESE CONTAINING NO ORGANIC MATTER OR DELETERIOUS MATERIALS, WITH LIMITING MAXIMUM PARTICLE SIZE TO 3 INCHES, AND LIMITING FINES CONTENT TO LESS THAN 10% PASSING THE NO. 200 SIEVE. STRUCTURAL BACKFILL SHALL BE COMPACTED TO NOT LESS THAN 95% OF MAXIMUM DENSITY ACCORDING TO ASTM D1557. PLACE BACKFILL AND FILL MATERIALS IN LAYERS NOT MORE THAN 8 INCHES IN LOOSE DEPTH.
6. BACKFILL TO TOP OF FOOTINGS AS SOON AS POSSIBLE AFTER PLACING CONCRETE.
7. "POPSOIL, ORGANIC MATERIAL, AND ANY NATURAL OR MAN-MADE DEBRIS SHALL BE STRIPPED FROM THE SITE TO THE DEPTHS REQUIRED OR NOTED. THESE AND OTHER DELETERIOUS MATERIAL SHALL NOT BE USED AS BACKFILL UNDER ANY STRUCTURAL AREA AND SHALL BE REMOVED FROM THE SITE.
8. UNSUITABLE SUBGRADE, IF ENCOUNTERED, WILL BE UNDERCUT AND REPLACED WITH LEAN CONCRETE OR SELECT GRANULAR MATERIAL AS ORDERED BY THE GEOTECHNICAL ENGINEER.
9. ALL FILL MATERIAL SHALL BE CENTERED IN EACH DIRECTION UNDER SUPPORTED STRUCTURAL MEMBERS. UNLESS NOTED OTHERWISE ON THE DRAWINGS, MINIMUM FOOTING PROJECTION SHALL BE 6 INCHES ADEQUATE, UNLESS OTHERWISE NOTED.
10. THE CONTRACTOR SHALL PROVIDE SUPPORTS, WHETHER SHEETING, SHORING, OR BRACING SUCH THAT NO HORIZONTAL MOVEMENT OR VERTICAL SETTLEMENT OCCURS TO EXISTING STRUCTURES, STREETS OR UTILITIES ADJACENT TO OR ON THE PROJECT SITE.
11. THE CONTRACTOR SHALL BRACE ALL EXISTING WALLS AND BOTTOM OF EXCAVATION DURING CONSTRUCTION BY SHORES, SLOPES, OR BENCHED SIDES. THE DESIGN AND INSTALLATION OF THE EXCAVATION BRACING SHALL BE IN ACCORDANCE WITH OSHA SHORING PRACTICES AND BE THE SOLE RESPONSIBILITY OF THE CONTRACTOR.

STRUCTURAL CONCRETE NOTES

1. CONCRETE WORK SHALL CONFORM TO REQUIREMENTS OF ACI 301, "SPECIFICATIONS FOR STRUCTURAL CONCRETE," ACI 318, "BUILDING CODE REQUIREMENTS FOR REINFORCED CONCRETE."
2. THE MANUFACTURER OF THE CONCRETE SHALL FURNISH TO THE PURCHASER AND ENGINEER OF RECORD EACH BATCH OF CONCRETE BEFORE UNLOADING AT THE SITE, A DELIVERY TICKET WITH INFORMATION CONCERNING SAID CONCRETE IN ACCORDANCE WITH ASTM C94.
3. PRIOR TO MANUFACTURING, THE MANUFACTURER OF THE CONCRETE SHALL SUBMIT TO THE ENGINEER OF RECORD THE REQUIRED SUBMITTALS AS OUTLINED IN ACI 301.
4. CONCRETE SHALL BE NORMAL WEIGHT (145 PCF) WITH MIXES DESIGNED TO MEET THE FOLLOWING CRITERIA:

<u>ITEM</u>	<u>MIN STRENGTH</u> <u>@28 DAYS</u> <u>(f'c) (P.S.I.)</u>	<u>MAX</u> <u>W/Cm</u> <u>RATIO</u>	<u>TOTAL</u> <u>AIR CONTENT</u> <u>(+ / - 1%)</u>	<u>MAX</u> <u>SLUMP</u>	<u>EXPOSURE</u> <u>CLASSES</u>
A. INTERIOR CONCRETE	4000	.45	1%	4"	F0,S0,W0,C0
B. EXTERIOR CONCRETE	4500	.42	6%	4"	F2,S0,W1,C0

5. PORTLAND CEMENT USED FOR CONCRETE WORK SHALL COMPLY WITH ASTM C-150 FOR TYPE III CEMENT.
6. NORMAL WEIGHT CONCRETE SHALL CONTAIN FINE AND COARSE AGGREGATES COMPLYING WITH ASTM C-33. THE MAXIMUM SIZE OF COARSE AGGREGATES SHALL BE OF SIZES SUITABLE FOR PLACEMENT IN STRUCTURAL ELEMENTS CONSIDERING THEIR SIZE AND REINFORCEMENT CONFIGURATION.
7. CONCRETE EXPOSED TO WEATHER CONDITIONS SHALL CONFORM WITH ALL REQUIREMENTS OF ACI 308.1. STANDARD SPECIFICATION FOR WEATHER-RESISTANT CONCRETE THAT MAY BE EXPOSED TO SUBSEQUENT MOISTURE AND FREEZING CONDITIONS PRIOR TO REACHING DESIGN COMPRESSIVE STRENGTH OR EXTERIOR CONCRETE WORK EXPOSED TO FREEZE / THAW CYCLING SHALL BE AIR-ENTRAINED AS SHOWN IN THE TABLE ABOVE. HOWEVER, SLAB FLATWORK TO RECEIVE A HARD-TROWEL FINISH SHALL NOT BE AIR ENTRAINED.
8. CONCRETE PLACED UNDER HOT WEATHER CONDITIONS SHALL CONFORM TO ALL REQUIREMENTS OF ACI 305.1. SPECIFICATION FOR HOT WEATHER CONCRETE.
9. EXPOSED CORNERS OF CONCRETE 3/4" CH.
10. CAST INTO CONCRETE ACCESSORIES REQUIRED BY ARCHITECTURAL FINISHES AND MECHANICAL EQUIPMENT. COORDINATE LOCATION AND QUANTITY WITH ARCHITECTURAL AND MECHANICAL DRAWINGS.

DESIGN CRITERIA

FLOOR LIVE LOAD	
EQUIPMENT AREAS:	250 P.S.F. OR 3 KIPS CONCENTRATED
OFFICE & PERSONNEL ASSEMBLY AREAS:	100 P.S.F. OR 2 KIPS CONCENTRATED
STAIRS & EXITS	100 P.S.F. OR 0.3 KIPS CONCENTRATED
WALKWAYS & ELEVATED PLATFORMS: 60 P.S.F.	
WIND LOAD	
BASIC WIND SPEED:	124 MPH
WIND IMPORTANCE:	III
WIND EXPOSURE:	D
EARTHQUAKE	
SEISMIC IMPORTANCE FACTOR, Ie:	1.10
OCCUPANCY CATEGORY:	III
Ss:	0.292
SI:	0.061
SITE CLASS:	D
Sds:	0.305
SD1:	0.098
SEISMIC DESIGN CATEGORY:	B
EQUIPMENT LOADS	
EMERGENCY POWER GENERATOR:	22.0 KIPS
TRANSFORMER:	8.2 KIPS
SWITCHGEAR:	5.0 KIPS
MOBILE GENERATOR CONNECTION CABINET:	5.0 KIPS
FLOOD DESIGN	
DESIGN FLOOD ELEVATION:	12'-6" ABOVE SEA LEVEL

STRUCTURAL CONCRETE NOTES (CONTINUED)

11. ADHESIVE ANCHORS SHALL NOT BE INSTALLED PRIOR TO CONCRETE HAVING REACHED A MINIMUM AGE OF 21 DAYS AND $f_c = 2,500$ PSI, VERIFIED THROUGH TESTING.
12. POST-INSTALLED ADHESIVE ANCHORS SHALL BE INSTALLED IN ACCORDANCE WITH THE MANUFACTURER'S PRINTED INSTALLATION INSTRUCTIONS.
 - A. ANCHORS SHALL BE INSTALLED BY QUALIFIED PERSONNEL THAT ARE TRAINED TO INSTALL ADHESIVE ANCHORS. INSTALLERS SHALL BE CERTIFIED BY AN APPLICABLE CERTIFICATION PROGRAM WITHIN THE PAST FIVE YEARS. CERTIFICATION SHALL INCLUDE WRITTEN AND PERFORMANCE TESTS IN ACCORDANCE WITH THE ACI/CRS ADHESIVE ANCHOR INSTALLER CERTIFICATION PROGRAM, OR EQUIVALENT.
 - B. CONTINUOUS MONITORING OF INSTALLATION SHALL BE PERFORMED AS PART OF SPECIAL INSPECTIONS.
13. CURING OF CONCRETE SHALL COMMENCE AS SOON AS FREE WATER HAS DISAPPEARED FROM CONCRETE SURFACE AFTER PLACING AND FINISHING. CURING MATERIALS AND PROCEDURES ARE AS FOLLOWS:
 - A. SLABS/MATS: COVER CONCRETE SURFACES WITH MOISTURE-RETAINING COVER MEETING ASTM C171, EITHER POLYETHYLENE FILM OR WHITE BURLAP-POLYETHYLENE SHEET. PLACE IN WIDEST PRACTICAL WIDTH WITH SIDES AND ENDS LAPPED A MINIMUM OF 3 INCHES AND SEALED BY WATERPROOF TAPE OR ADHESIVE. IMMEDIATELY REPAIR ANY HOLES OR TEARS DURING CURING PERIOD USING COVER MATERIAL AND WATERPROOF TAPE. KEEP SURFACES CONTINUOUSLY WET FOR NOT LESS THAN 7 DAYS.
 - B. FOUNDATIONS/WALLS: FOLLOWING COMPOUNDS MAY BE USED. CURING COMPOUND SHALL BE A CLEAR, WATERBORNE, MEMBRANE-FORMING COMPOUND; ASTM C309, TYPE 1, CLASS B, WITH 18 TO 25 PERCENT SOLIDS, NON-DISSIPATING. FOLLOW MANUFACTURER'S RECOMMENDED PROCEDURES.

STRUCTURAL REINFORCING NOTES

1. REINFORCEMENT WORK OF DETAILING, FABRICATION, AND ERECTION SHALL CONFORM TO ACI 318, "BUILDING CODE REQUIREMENTS FOR REINFORCED CONCRETE," ACI SP-66 "ACI DETAILING MANUAL," "CRSI MANUAL OF STANDARD PRACTICE," AND AWS D1.4 "STRUCTURAL WELDING CODE - REINFORCING STEEL."
2. STEEL REINFORCEMENT, UNLESS NOTED OTHERWISE, SHALL CONFORM TO THE FOLLOWING:
 - A. BARS, TIES AND STIRRUPS: ASTM A615 GRADE 60 ($F_y = 60$ KSI)
 - B. REINFORCING TO BE WELDED SHALL CONFORM TO ASTM A706 ($F_y = 60$ KSI) OR MILL TEST REPORTS SHALL BE SUBMITTED SHOWING CARBON EQUIVALENT.
3. MINIMUM CONCRETE PROTECTIVE COVER FOR REINFORCEMENT OF NON-ENVIRONMENTAL ENGINEERING CONCRETE SHALL BE AS FOLLOWS, UNLESS OTHERWISE NOTED:

A. UNIFORM SURFACES CAST AGAINST AND PERMANENTLY IN CONTACT WITH EARTH:	3.0"
B. BUILDING SURFACES FORMED IN CONTACT WITH EARTH OR EXPOSED TO WEATHER: #6 THROUGH #18 BARS: #5 BARS AND SMALLER:	2.0" 1.5"
C. BUILDING SURFACES NOT IN CONTACT WITH OR EXPOSED TO WEATHER (WALLS AND SLABS): #14 AND #18 BARS: #11 BARS AND SMALLER:	0.75" 1.5"
D. BUILDING BEAMS, GIRDERS, AND COLUMNS: PRINCIPAL REINFORCEMENT, TIES, STIRRUPS AND SPIRALS:	1.5"
4. WHERE CONTINUOUS REINFORCEMENT IS CALLED FOR, REINFORCEMENT SHALL BE EXTENDED CONTINUOUSLY AROUND CORNERS AND LAPPED AT NECESSARY SPLICES OR HOOKED AT DISCONTINUOUS ENDS.
5. LAPS SHALL BE CLASS "B" TENSION LAP SPLICES, UNLESS NOTED OTHERWISE.
6. EXTEND DOWELS TO THE 1/4-POINT OF SLAB SPAN, UNLESS OTHERWISE NOTED.
7. WHERE REINFORCEMENT IS SHOWN IN SECTION, REINFORCEMENT IS CONSIDERED TYPICAL WHEREVER THE SECTION APPLIES.
8. REINFORCEMENT SHALL BE CONTINUOUS THROUGH CONSTRUCTION JOINTS UNLESS OTHERWISE SHOWN.
9. REINFORCEMENT SHALL NOT BE TACK WELDED OR HEATED FOR BENDING.
10. INSTALLATION OF REINFORCEMENT SHALL BE COMPLETED AT LEAST 24 HOURS PRIOR TO THE SCHEDULED CONCRETE PLACEMENT. NOTIFY ENGINEER OF RECORD AND INSPECTOR OF COMPLETION AT LEAST 24 HOURS PRIOR TO THE SCHEDULED COMPLETION OF THE INSTALLATION OF REINFORCEMENT.
11. WELDING OF REINFORCEMENT SHALL CONFORM TO AWS D1.1 INCLUDING PREHEAT REQUIREMENTS). ONLY BARS INDICATED ON DRAWINGS TO BE WELDED SHALL BE WELDED.

STRUCTURAL STEEL NOTES

1. FABRICATE AND ERECT STRUCTURAL STEEL IN ACCORDANCE WITH AISC 360, "SPECIFICATIONS FOR STRUCTURAL STEEL BUILDINGS"; AND AISC 303, "CODE OF STANDARD PRACTICE FOR STEEL BUILDINGS AND BRIDGES".
2. STEEL MEMBERS HAVE BEEN PROPORTIONED UTILIZING ALLOWABLE STRESS DESIGN (ASD) METHODS AS PRESCRIBED BY AISC.
3. STRUCTURAL STEEL SHALL BE DETAILED IN ACCORDANCE WITH "DETAILING FOR STEEL CONSTRUCTION (AISC)" AND WHERE REQUIRED, DESIGNED IN ACCORDANCE WITH CITED REFERENCES.
4. STRUCTURAL STEEL AND ACCESSORIES SHALL BE NEW AND CONFORM TO:
- | | | |
|---|-------------------------|----------------|
| A. UNLESS OTHERWISE NOTED: | ASTM A992 | (Fy = 50 KSI) |
| B. HOLLOW STRUCTURAL SECTIONS: | | |
| ROUND: | ASTM A500 GRADE B | (Fy = 42 KSI) |
| SQUARE OR RECTANGULAR: | ASTM A500 GRADE B | (Fy = 46 KSI) |
| C. MISCELLANEOUS STRUCTURAL SHAPES AND CONNECTIONS: | ASTM A36 | (Fy = 36 KSI) |
| D. ANCHOR BOLTS: | ASTM F1554 GRADE 36 | (Fy = 36 KSI) |
| E. HIGH STRENGTH BOLTS: | ASTM F3125 GRADE A325-N | (Fy = 120 KSI) |
5. WELDING SHALL CONFORM TO THE REQUIREMENTS OF AWS D1.1, AND SHALL BE PERFORMED BY APPROVED, CERTIFIED PERSONS.
6. WELDED CONNECTIONS SHALL UTILIZE E70XX ELECTRODES.
7. WELDS SHALL DEVELOP FULL STRENGTH OF THE MATERIALS BEING WELDED, UNLESS OTHERWISE NOTED, EXCEPT THAT FILLET WELDS SHALL BE A MINIMUM OF 1/4" UNLESS OTHERWISE NOTED.
8. ANCHOR BOLTS, LEVELING PLATES, OR BEARING PLATES SHALL BE LOCATED AND BUILT INTO CONNECTING WORK, PRESET BY TEMPLATES, AND SET IN FULL BEDS OF NON-SHRINK GROUT.
9. PRINCIPAL STRUCTURAL BOLTED CONNECTIONS (BEAM-BEAM, BEAM-GIRDER, BEAM OR GIRDER TO COLUMN) SHALL BE MADE USING MINIMUM 3/4" DIAMETER ASTM F3125 GRADE A325 BOLTS IN BEARING CONNECTIONS.
10. BEAM CONNECTIONS SHALL PROVIDE CONNECTION CAPACITY BY ALLOWABLE STRESS DESIGN (ASD) METHODS. WHERE BEAM REACTIONS ARE NOT INDICATED ON THE PLANS, CONNECTION CAPACITY SHALL BE DETERMINED AS FOLLOWS:
- A. NON-COMPOSITE BEAMS: SUPPORT A REACTION "R" EQUAL TO 1/2 THE TOTAL UNIFORM LOAD CAPACITY OF THE BEAM FOR A GIVEN SPAN, SPAN, AND GRADE OF STEEL PER "ALLOWABLE LOADS ON BEAMS" PART 3, AISC "MANUAL OF STEEL CONSTRUCTION".
- B. "R" OR "R" BEAM: THE TOTAL REACTIONS OF MEMBERS SUPPORTED BY THE BEAM NEAR SUPPORTS AND / OR THE VERTICAL COMPONENTS OF FORCE IN DIAGONAL BRACING MEMBERS FRAMING INTO BEAM.
11. A MINIMUM OF TWO (2) BOLTS SHALL BE UTILIZED AT CONNECTIONS.
12. BOLTS SHALL BE INSTALLED SNUG TIGHT AND PRETENSIONED BY TURN-OF-NUT PRETENSIONING IN ACCORDANCE WITH AISC 308.
13. ENDS OF COLUMNS AT SPLICES AND AT OTHER BEARING CONNECTIONS SHALL BE "FINISHED TO BEAR" TO COMPLETE TRUE BEARING.
14. PROVIDE STIFFENERS "FINISHED TO BEAR" UNDER LOAD CONCENTRATIONS ON SUPPORTING MEMBERS, OVER COLUMNS, AND WHERE SHOWN ON DRAWINGS.
15. PROVIDE TEMPORARY BRACING AND SUPPORTS TO HOLD STRUCTURAL STEEL FRAMING SECURELY IN POSITION. SUCH TEMPORARY BRACING AND SUPPORTS SHALL NOT BE REMOVED UNTIL PERMANENT BRACING HAS BEEN INSTALLED AND CONCRETE HAS ATTAINED 75% OF SPECIFIED CONCRETE STRENGTH.
16. STRUCTURAL FRAMING SHALL BE TRUE AND PLUMB BEFORE CONNECTIONS ARE FINALLY BOLTED OR WELDED. WHERE STEEL SHELF ANGLE OR FACE SADDLE SUPPORT ARE PRESENT, TOP OF SHELF ANGLE ON SUCCESSIVE FLOORS WILL BE IN SAME VERTICALS.
17. FIELD CUTTING OF STRUCTURAL FRAMING AND / OR FIELD MODIFICATIONS OF STRUCTURAL FRAMING SHALL NOT BE MADE WITHOUT PRIOR WRITTEN APPROVAL BY ENGINEER OF RECORD FOR EACH SPECIFIC CASE.
18. UNLESS OTHERWISE SHOWN, COLUMNS SHALL BE EXTENDED TO TOPS OF BEAMS AND FRAMED CONNECTIONS.
19. THE CONTRACTOR SHALL FURNISH AND INSTALL ALL PLATES, CLIP ANGLES, CONNECTION MATERIALS, ETC. AS REQUIRED FOR COMPLETION OF THE STRUCTURE, EVEN IF SUCH ITEMS ARE NOT SPECIFICALLY SHOWN ON THE STRUCTURAL DRAWINGS.

STEEL RAILING NOTES



1. STEEL RAILINGS SHALL MEET THE FOLLOWING SPECIFICATIONS:
- | | | |
|---------------------------------|---|---------------------|
| A. GUARDRAIL TOP RAIL: | NOMINAL 1 1/2" SCHED 40 PIPE (1.90" OD) | 42" TOP OF RAIL AFF |
| B. GUARDRAIL INTERMEDIATE RAIL: | NOMINAL 1 1/2" SCHED 40 PIPE (1.90" OD) | 21" TOP OF RAIL AFF |
| C. GUARDRAIL TOE PLATE: | PL 1/4"x4" | 1/4" GAP AFF MAX |
| D. HANDRAIL: | NOMINAL 1 1/2" SCHED 40 PIPE (1.90" OD) | 36" TOP OF RAIL AFF |
| E. POSTS: | NOMINAL 1 1/2" SCHED 80 PIPE (1.90" OD) | 6' - 0" MAX SPACING |
2. GUARDRAIL AND HANDRAIL SYSTEMS SHALL BE DESIGNED TO WITHSTAND A CONCENTRATED LOAD OF 200 POUNDS OR A UNIFORM LOAD OF 50 POUNDS PER FOOT APPLIED IN ANY DIRECTION AT ANY POINT ON THE SYSTEM.
3. SEE TYPICAL DETAILS FOR RAILING DETAILS.
4. STEEL RAILINGS SHALL BE SMOOTH AND CONFORM TO ASTM A53 GRADE B (Fy = 35 KSI), UNLESS OTHERWISE NOTED.
5. JOINTS SHALL NOT INTERRUPT THE CONTINUATION OF THE TOP RAIL AT ANY POINT ALONG THE RAILING, INCLUDING CORNERS AND END TERMINATIONS. THE TOP SURFACE OF THE TOP RAILING SHALL BE SMOOTH AND SHALL NOT BE INTERRUPTED BY PROJECTED FITTINGS.
6. USE FULLY WELDED JOINTS FOR PERMANENTLY CONNECTING RAILING COMPONENTS. WELDS SHALL BE SMOOTH AND BURR FREE.
7. PRIOR TO FABRICATION AND INSTALLATION OF RAILINGS, DRAWINGS AND STRUCTURAL CALCULATIONS FOR THE RAILINGS SHALL BE SUBMITTED TO THE ENGINEER OF RECORD FOR REVIEW. DRAWINGS AND CALCULATIONS SHALL BE SIGNED AND SEALED BY THE PROFESSIONAL ENGINEER (LICENSED IN NEW YORK) RESPONSIBLE FOR THEIR PREPARATION.


ABBREVIATIONS

AA	AT	LBS	POUNDS
AB	THE ALUMINUM ASSOCIATION	LL	LIVE LOAD
ABC	ANCHOR BOLT	LLH	LONG LEG HORIZONTAL
ABG	AGGREGATE BASE COURSE	LLO	LONG LEG OUTSTANDING
ACI	AMERICAN CONCRETE INSTITUTE	LLV	LONG LEG VERTICAL
ADDL	ADDITIONAL	LONG	LONGITUDINAL
AFB	ABOVE FINISHED FLOOR	LPT	LOW POINT
AFS	ABOVE FINISHED GRADE	LRFD	LOAD AND RESISTANCE FACTOR DESIGN
AFG	ABOVE FINISHED SLAB	LW	LIGHTWEIGHT
AGG	AGGREGATE	MATL	MATERIAL
AISC	AMERICAN INSTITUTE OF STEEL CONSTRUCTION	MAX	MAXIMUM
ALUM	ALUMINUM	MECH	MECHANICAL
ALT	ALTERNATE	MEZZ	MEZZANINE
ANSI	AMERICAN NATIONAL STANDARD INSTITUTE	MFR	MANUFACTURER
APPROX	APPROVED	MD	MID DECK
APPROX	APPROXIMATE	MH	MANHOLE
AR	AS REQUIRED	MIL	ONE THOUSANDTH OF AN INCH
ARCH	ARCHITECT, ARCHITECTURAL	MIN	MINIMUM
ASCE	AMERICAN SOCIETY OF CIVIL ENGINEERS	MISC	MISCELLANEOUS
ASD	AMERICAN STRESS DESIGN	MS	MANUFACTRY LINGE (STEEL)
ASTM	AMERICAN SOCIETY FOR TESTING AND MATERIALS	MTL	METAL
AWS	AMERICAN WELDING SOCIETY	MO	MASONRY OPENING
B PL	BASE PLATE	MPII	MANUFACTURER'S PRINTED
BE	BOTTOM ELEVATION	N	NOTHING
BF	BOTH FACES	NF	NEAR FACE
BFF	BELOW FINISHED FLOOR	NIC	NOT IN CONTRACT
BLDG	BUILDING	NO	NUMBER
BM	BEAM	#	NUMBER SYMBOL FOR REBAR SIZE
BOS	BOTTOM OF STEEL	NS	NEAR SIDE
BOT	BOTTOM	NTS	NOT TO SCALE
BRCG	BRACING	OC	ON CENTER
BRG	BEARING	OD	OUTSIDE DIAMETER
BSMT	BASEMENT	OF	OUTSIDE FACE
BW	BOTH WAYS	OH	OPPOSITE HAND
(C)	COMPRESSION	OPNG	OPENING
C	CHANNEL	OPP	OPPOSITE
CFMF	COLD FORMED METAL FRAMING	OSHA	OCCUPATIONAL SAFETY AND HEALTH
CHEM	CHEMICAL		ADMINISTRATION
CHFR	CHAMFER	P/C OR PCP	PRECAST PLANK
CJP	CAST-IN-PLACE	PCP	PRECAST CONCRETE
CL	CONTROL JOINT, CONSTRUCTION JOINT	PH	PENTHOUSE
CLL	CENTER LINE	PL	PLATE
CL	COLUMN LINE	PREFAB	PREFABRICATED
CLG	CEILING	PSF	POUNDS PER SQUARE FOOT
CLR	CLEAR	PSI	POUNDS PER SQUARE INCH
CLSM	CONTROLLED LOW-STRENGTH MATERIAL	PVC	POLYVINYL CHLORINE
CMU	CONCRETE MASONRY UNIT	R	RADIUS OR RISER
COL	COLUMN	RD	ROOF DRAIN
CONC	CONCRETE	REBAR	REINFORCING STEEL BAR
CONN	CONNECTION	REF	REFERENCE
CONSTR	CONSTRUCTION	REINF	REINFORCED
CONT	CONTINUE, CONTINUOUS	REQD	REQUIRED
CONTR	CONTRACTOR	REV	REVISION
COORD	COORDINATE	RM	ROOM
CRSI	CONCRETE REINFORCING STEEL INSTITUTE	S	SOUTH
CUB	CUBIC YARDS	SCG	SELF-CONSOLIDATING GROUT
D	PENNY (NAIL SIZE)	SCHED	SCHEDULE
DEMO.	DEMOLISH, DEMOLITION	SE	STRUCTURAL ENGINEER
DET	DETAIL	SECT	SECTION
DFT	DRY FILM THICKNESS	SF	SQUARE FEET
DIA	DIAMETER	SIM	SIMILAR
DIAG	DIAGONAL	SQ	SQUARE
DIM	DIMENSION	SS	STANDING SEAM (ROOF)
DL	DEAD LOAD	SSR	STANDING SEAM ROOFING
DOT	DEPARTMENT OF TRANSPORTATION	SST	STAINLESS STEEL
DWG	DRAWING	STD	STANDARD
DWL	DOWEL	STIFF	STIFFENER
E	EAST	STIR	STIRRUP
EA	EACH	STL	STEEL
EF	EACH FACE	STRUCT	STRUCTURAL
EJ	EXPANSION JOINT	SYMM	SYMMETRICAL
ELEV	ELEVATION	(T)	TENSION
ELEC	ELECTRIC, ELECTRICAL	T	TREAD, TOP
EMBED	EMBEDMENT	T&B	TOP AND BOTTOM
ENGR	ENGINEER	T&G	TONGUE & GROOVE
EOR	ENGINEER OF RECORD	TE	TOP ELEVATION
EOS	EDGE OF SLAB	TEMP	TEMPERATURE, TEMPORARY
EQ	EQUAL	TFF	TOP OF FINISH FLOOR
EQUIP	EQUIPMENT	TO	TOP OF
EQUIV	EQUIVALENT	TOB	TOP OF BEAM
EW	EACH WAY	TOC	TOP OF CONCRETE
EX OR EXST	EXISTING	TOP	TOP OF FOOTING
EXP	EXPANSION	TOS	TOP OF SLAB, TOP OF STEEL
EXT	EXTERIOR	TOW	TOP OF WALL
fc	SPECIFIED COMPRESSIVE STRENGTH OF CONCRETE	TPER	THERMOPLASTIC ELASTOMERIC RUBBER
FD	FLOOR DRAIN	TYP	TYPICAL
FIN	FINISH	UN	UNLESS NOTED
fm	SPECIFIED COMPRESSIVE STRENGTH OF CONCRETE MASONRY	UNO	UNLESS NOTED OTHERWISE
FRC	FIBER REINFORCED CONCRETE	UON	UNLESS OTHERWISE NOTED
FRP	FIBERGLASS REINFORCED PLASTIC	VERT	VERTICAL
FS	FAR SIDE	VIF	VERIFY IN FIELD
FT	FEET	VRFY	VERIFY
FTG	FOOTING	W	WEST
Fy	MINIMUM YIELD STRESS	W/	WITH
GA	GAGE	WF	WIDE FLANGE
GALV	GALVANIZED	WF BM	WIDE FLANGE BEAM
GR BM	GRADE BEAM	W/O	WITHOUT
GRTG	GRATING	WP	WORKING POINT
		WS	WATERSTOP
		XBRA	CROSSBRACING

SYMBOLS

	ALUMINUM
	BOARD INSULATION
	BRICK
	COMPACTED GRANULAR BASE
	COMPACTED STONE FILL
	CONCRETE
	CONCRETE MASONRY UNITS
	DECK SPAN
	FINAL GRADE
	GRATING
	GROUT
	REINFORCING STEEL IN CONCRETE
	SAND
	SLOPE
	STEEL
	UNDISTURBED EARTH
	UNDISTURBED ROCK

	IN ACCORDANCE WITH TITLE VIII, ARTICLE 145, SECTION 7209 (2) OF THE NEW YORK STATE EDUCATION LAW, IT IS A VIOLATION OF LAW FOR ANY PERSON UNLESS ACTING UNDER THE DIRECTION OF A LICENSED ENGINEER TO ALTER THIS DOCUMENT.													
IN CHARGE OF <u>L. WOODS</u>		O'BRIEN & GERE ENGINEERS, INC. 50 MAIN ST., 10TH FLOOR SUITE 1000, WHITE PLAINS, NEW YORK 10606												
CHECKED BY <u>T. KIVISTO</u>														
MADE BY <u>R. EGAN</u>														
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RECORD DRAWING CERTIFICATION														
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NAME _____ SIGNATURE _____ TITLE _____ DATE _____		PROJECT COORDINATOR NAME _____ SIGNATURE _____ TITLE _____ DATE _____												
WESTCHESTER COUNTY, NEW YORK DEPARTMENT OF PUBLIC WORKS AND TRANSPORTATION DIVISION OF ENGINEERING		CONTRACT NUMBER 17-529	SHEET NUMBER S-001	SHEET NO. 7 OF 60										
CROTONVILLE PUMPING STATION REHABILITATION OSSINGEN SEWER DISTRICT OSSINGEN, NEW YORK GENERAL NOTES		SCALE: DATE: 12/21/18 DPW FILE NO. 208-03-S-31-0												
		REV. NO. 0												

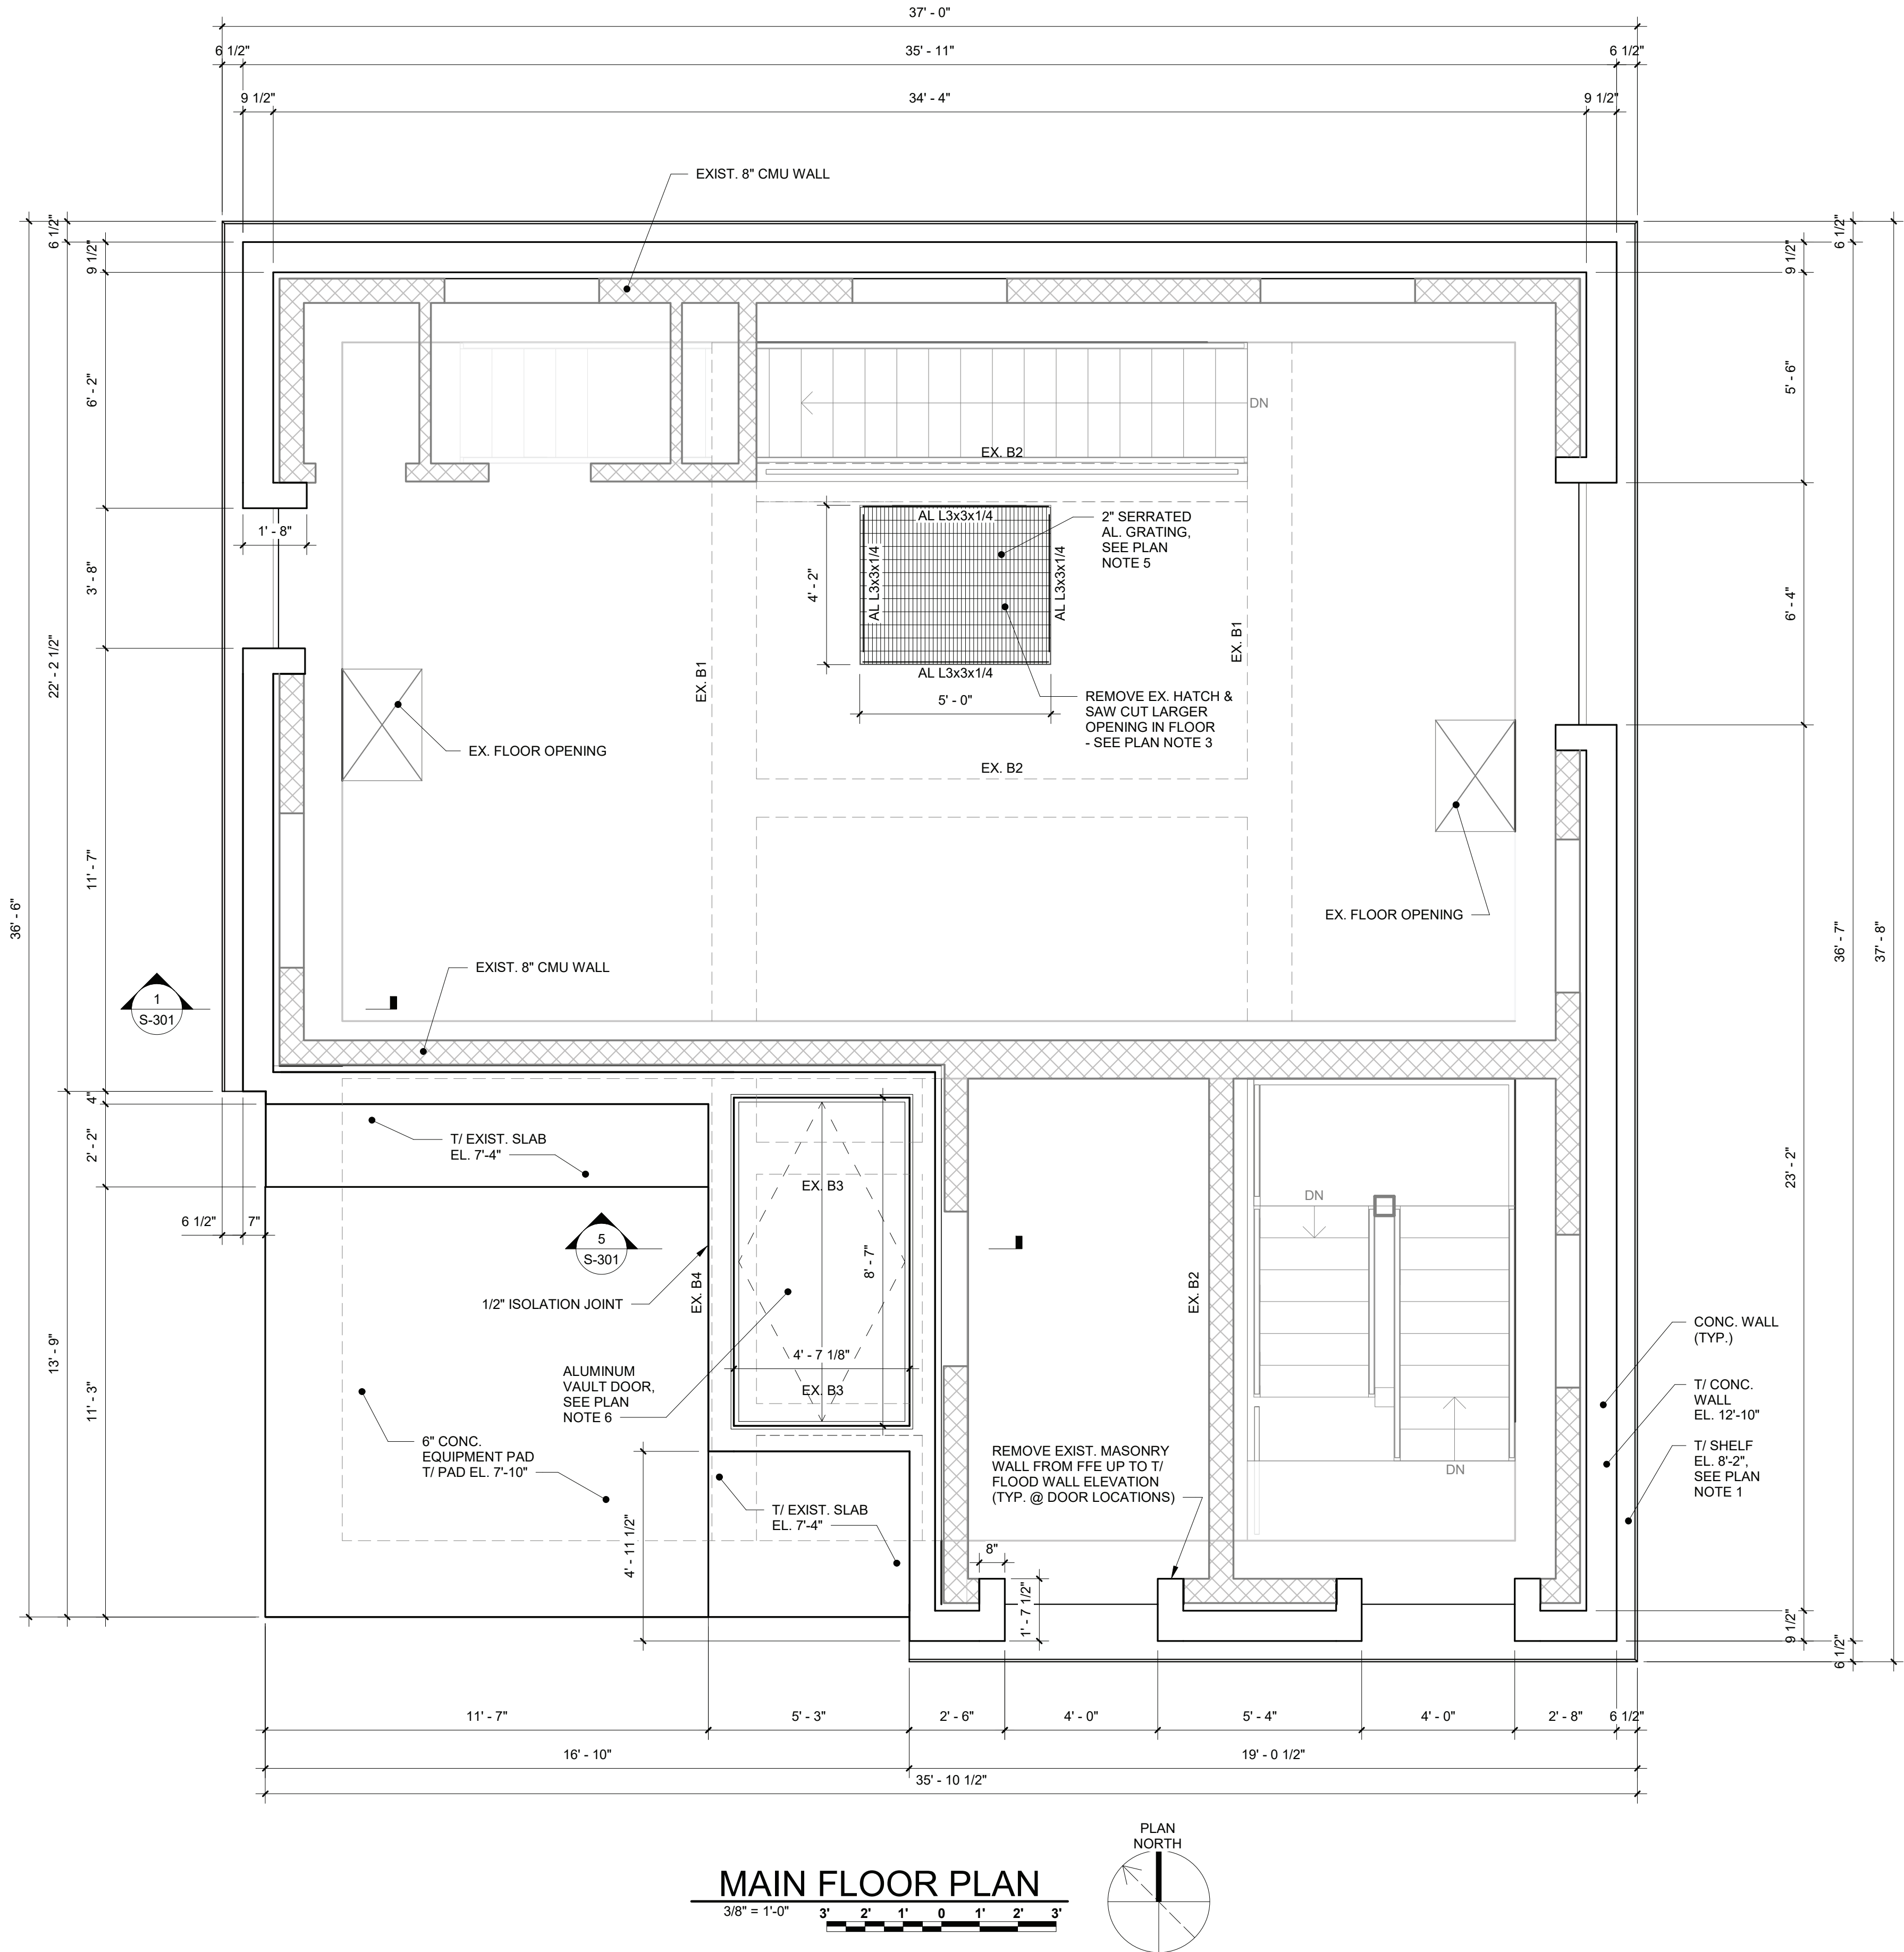

- PLAN NOTES:
1. FIELD VERIFY TOP OF EXISTING SLAB ELEVATION, TOP OF SHELF ELEVATION TO MATCH.
 2. COORDINATE SIZE AND LOCATION OF WALL PENETRATIONS WITH ARCHITECTURAL, PLUMBING, HVAC, ELECTRICAL AND MECHANICAL DRAWINGS AND EQUIPMENT MANUFACTURER.
 3. REMOVE EX. HATCH AND ENLARGE FLOOR OPENING AND COVER WITH GRATING ON MID FLOOR LEVEL SIMILAR TO DETAILS SHOWN ON THIS LEVEL.
 4. CONSTRUCTION AND CONTROL JOINTS SHALL BE LOCATED BY THE CONTRACTOR BASED ON PLANS, DETAILS AND SPACING LIMITATIONS SHOWN ON THE CONTRACT DOCUMENTS. SHOP DRAWINGS SHOWING CONTRACTORS PROPOSED LOCATION OF CONSTRUCTION AND CONTROL JOINTS AND CONCRETE PLACEMENT SEQUENCING SHALL BE SUBMITTED TO THE ENGINEER FOR REVIEW PRIOR TO THE PREPARATION OF THE REINFORCEMENT SHOP DRAWINGS AND PLACEMENT OF CONCRETE.
 5. PROVIDE SERRATED ALUMINUM BAR GRATING WITH 2"x3/16" BEARING BARS AT 1 3/16" SPACING, AND CROSS BARS AT 4" SPACING. SECURE GRATING WITH STAINLESS STEEL HOLD-DOWN HARDWARE.
 6. ALUMINUM VAULT DOOR SHALL BE WATER TIGHT AND RATED FOR A LIVE LOAD OF 60 PSF.



07/09/21

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IN CHARGE OF **L. WOODS**
CHECKED BY **T. KIVISTO**
MADE BY **R. EGAN**




O'BRIEN & GERE ENGINEERS, INC.
50 MAIN ST., 10TH FLOOR SUITE 1000,
WHITE PLAINS, NEW YORK 10606

REVISION NUMBER	DATE	MADE BY	APP'D BY	REVISION
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RECORD DRAWING CERTIFICATION

- ☐ AS BUILT - CHANGES AS NOTED
☐ AS BUILT - NO CHANGES

CONTRACTOR		PROJECT COORDINATOR	
NAME		NAME	
SIGNATURE		SIGNATURE	
TITLE		TITLE	
DATE		DATE	
WESTCHESTER COUNTY, NEW YORK		CONTRACT NUMBER	SHEET NUMBER
DEPARTMENT OF PUBLIC WORKS AND TRANSPORTATION		17-529	S-101
DIVISION OF ENGINEERING		SHEET NO. 8	OF 60
CROTONVILLE PUMPING STATION REHABILITATION		SCALE:	
OSSINING SEWER DISTRICT		DATE: 12/21/18	
OSSINING, NEW YORK		DPW FILE NO.	
MAIN FLOOR PLAN		208-03-S-32-0	REV. NO. 0


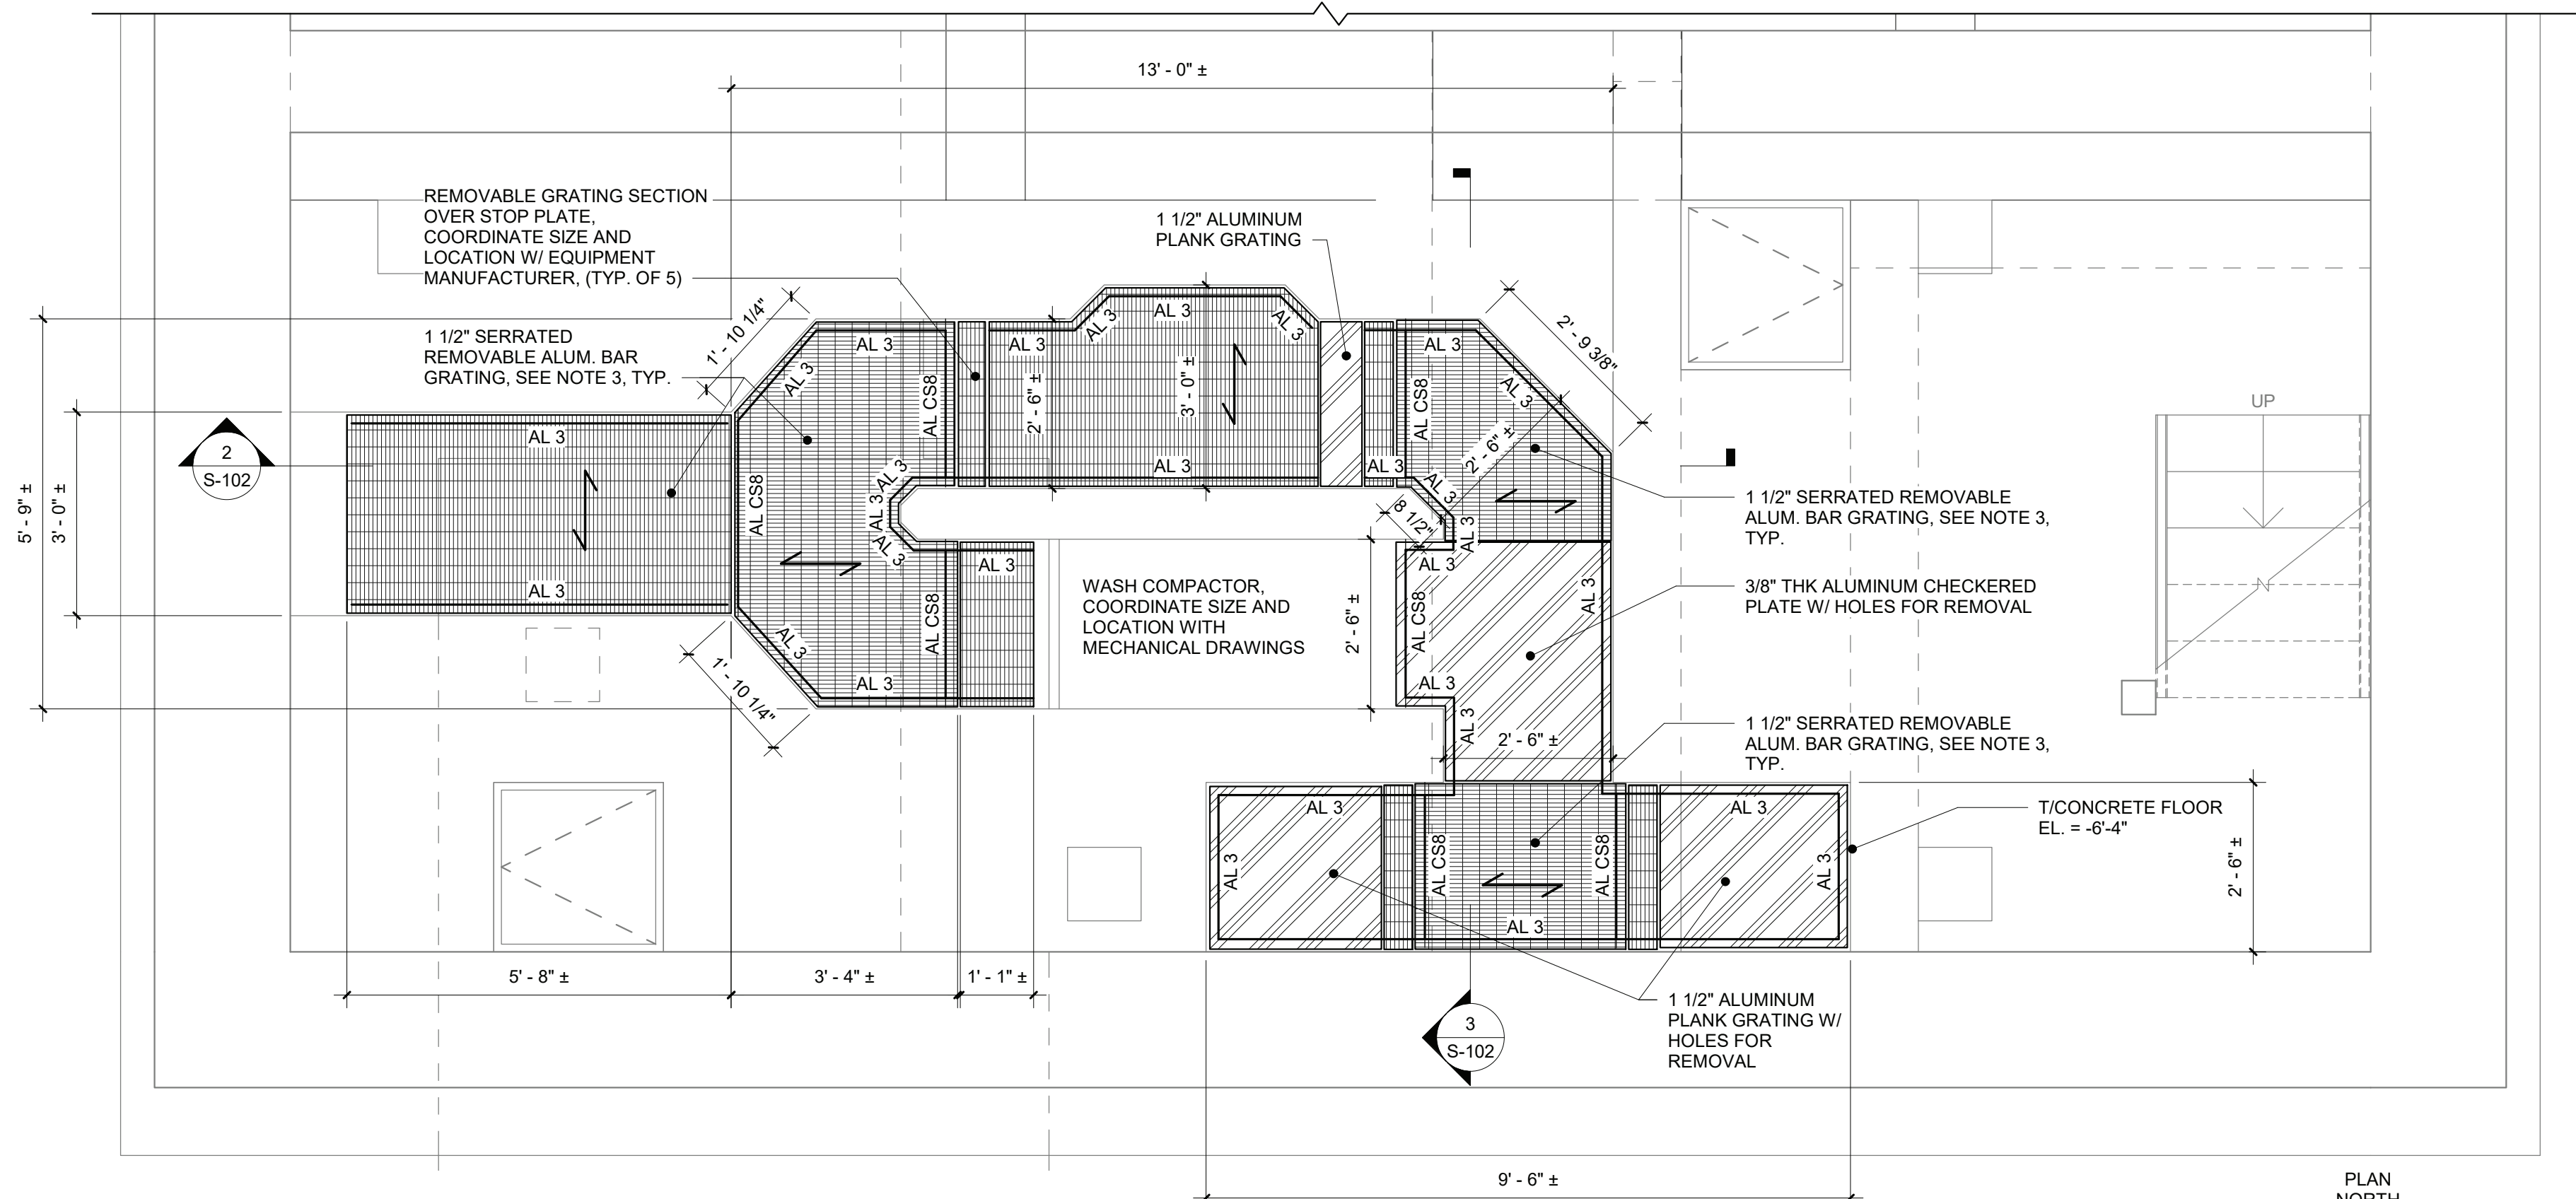


SCREEN ROOM FLOOR GRATING AND FRAMING PLAN

1/2" = 1'-0"

- PLAN NOTES:
1. FIELD VERIFY TOP OF EXISTING SLAB ELEVATION AND CHANNEL GEOMETRY.
 2. COORDINATE SIZE AND LOCATION OF GRATING PENETRATIONS WITH MECHANICAL DRAWINGS AND EQUIPMENT MANUFACTURER.
 3. PROVIDE SERRATED ALUMINUM BAR GRATING WITH 1 1/2" x 3/16" BEARING BARS AT 1 3/16" SPACING, AND CROSS BARS AT 4" SPACING. SECURE GRATING WITH STAINLESS STEEL HOLD-DOWN HARDWARE. LIMIT INDIVIDUAL REMOVABLE GRATING PANEL WEIGHT TO 75 lbs.
 4. SEE ALUMINUM GRATING SUPPORT DETAIL ON SHEET S-501. GRATING SHALL BE SUPPORTED AT THE PERIMETER.
 5. AL CS8 DENOTES ALUMINUM CS8x5.79.
 6. AL 3 DENOTES ALUMINUM L3x3x1/4". SEE AL GRATING SUPPORT DETAIL ON S-501.


2' 1' 0 1' 2'

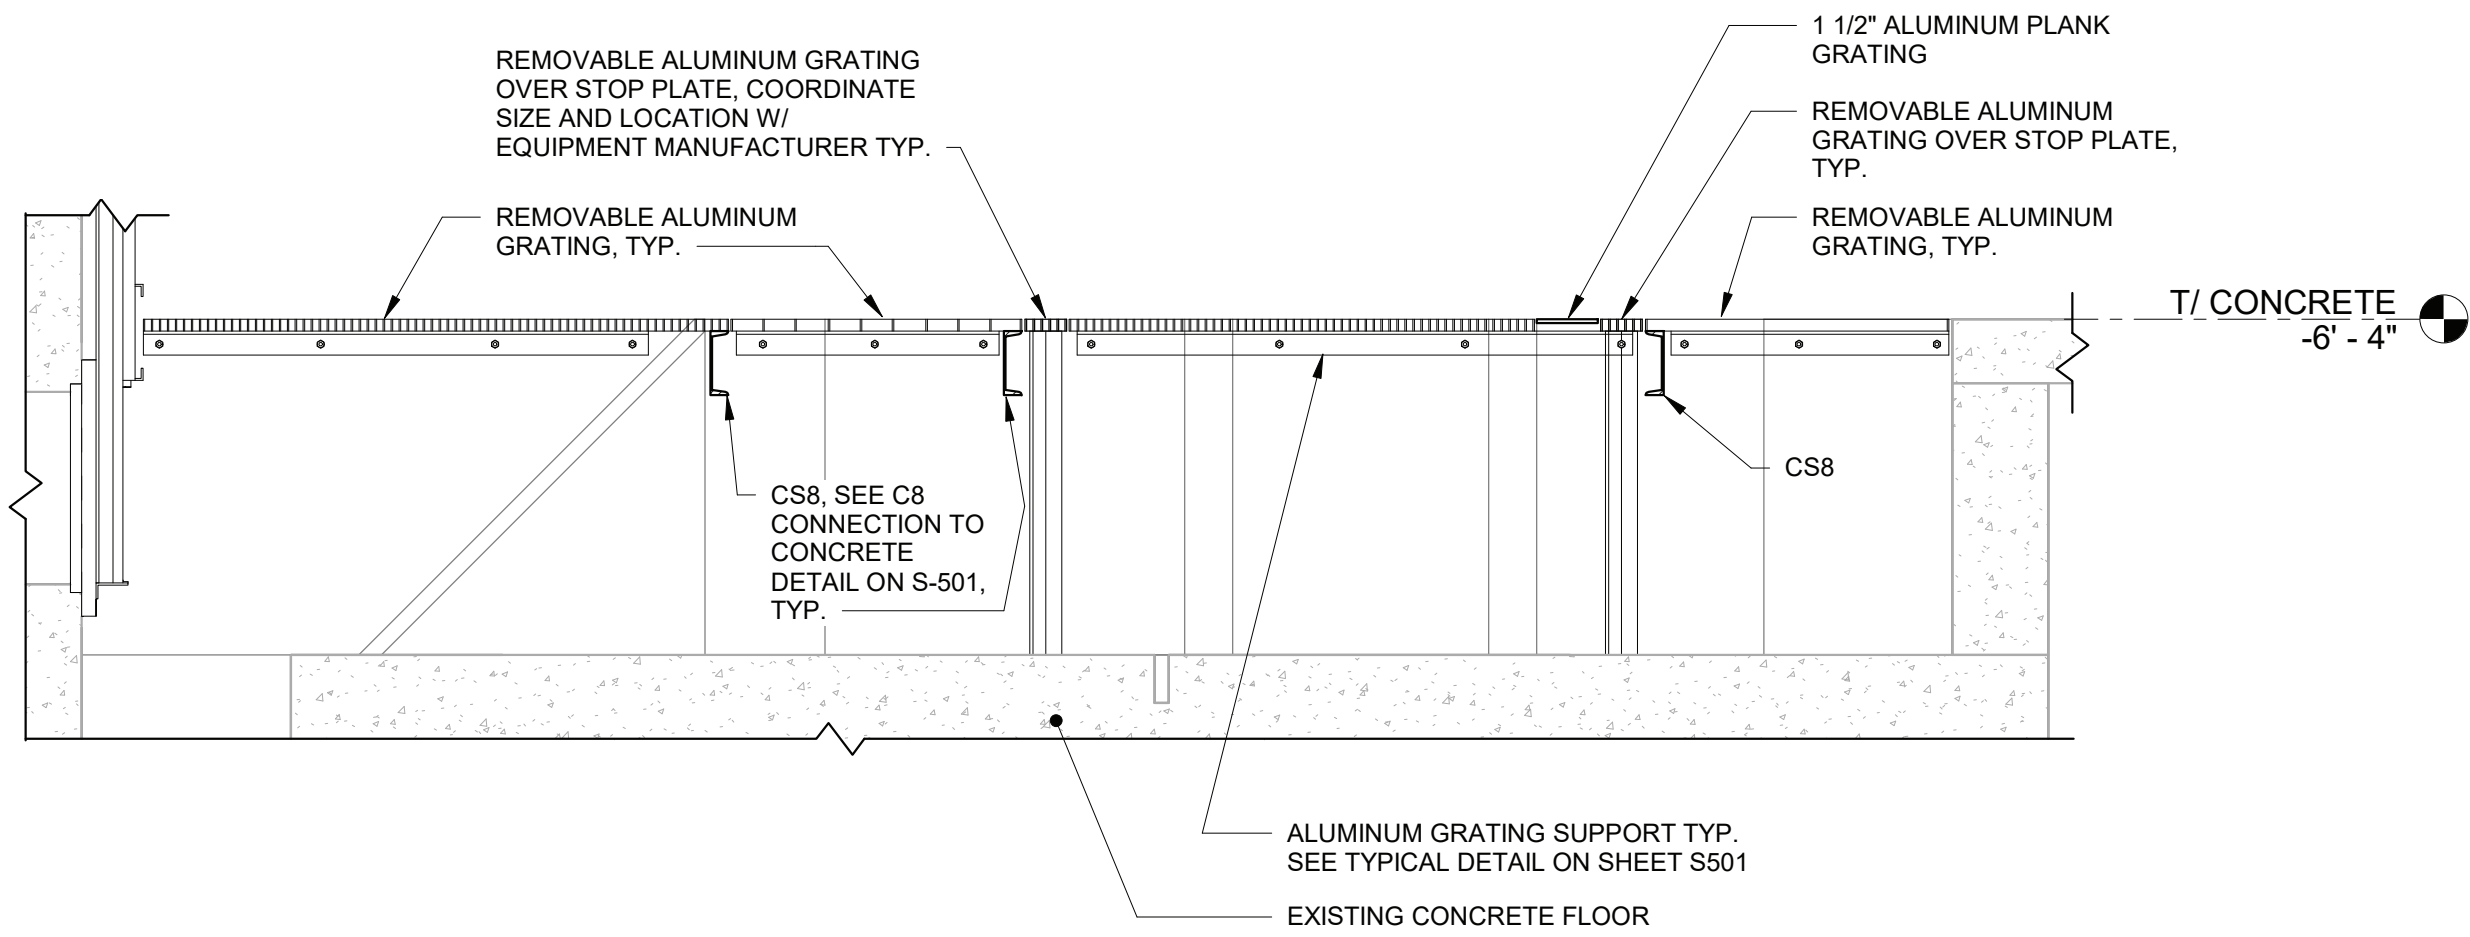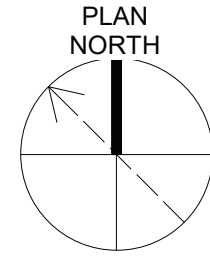

2 SECTION

1/2" = 1'-0"

2' 1' 0 1' 2'

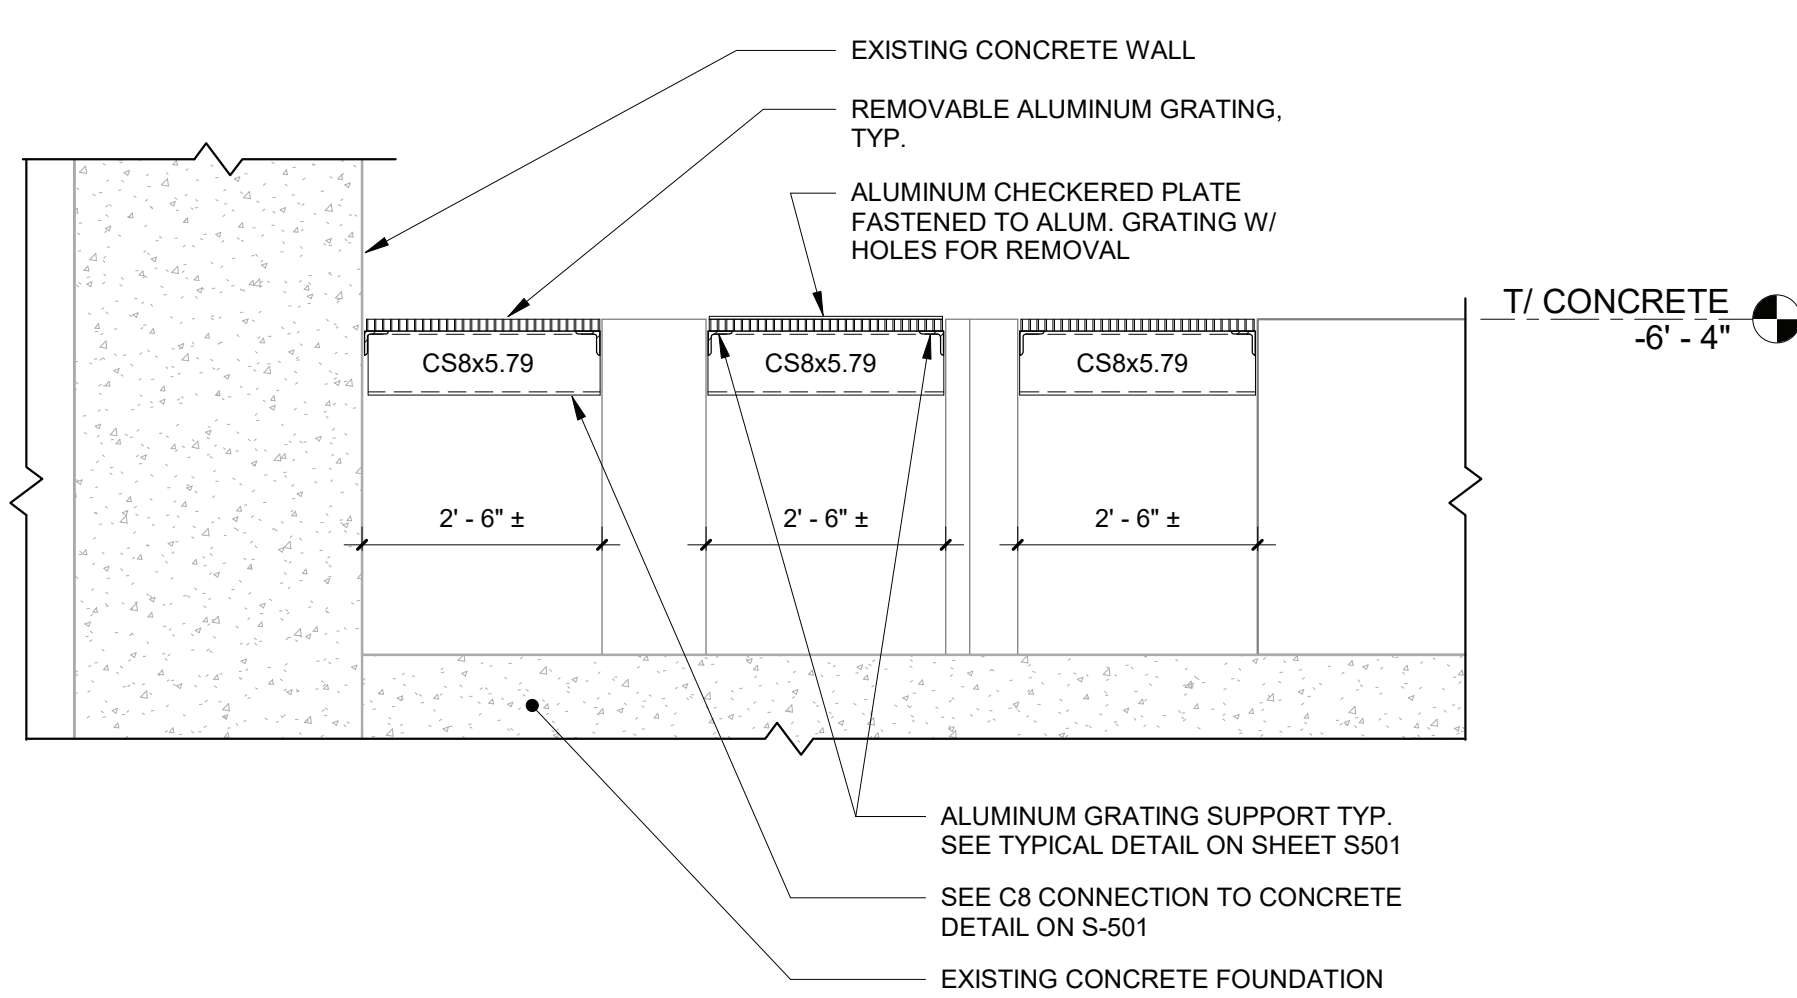

3 SECTION

1/2" = 1'-0"

2' 1' 0 1' 2'



07/09/21


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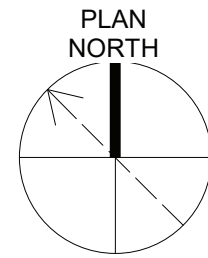
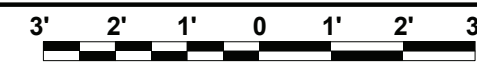


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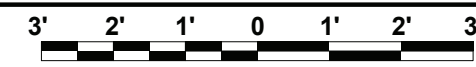
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DIVISION OF ENGINEERING		SHEET NO.	9	OF 60
CROTONVILLE PUMPING STATION REHABILITATION		SCALE:		
OSSINING SEWER DISTRICT		DATE: 11/19/19		
OSSINING, NEW YORK		DPW FILE NO.	208-03-S-33-0	REV. NO. 0
PARTIAL FLOOR GRATING INFILL FRAMING PLAN				





3/8" = 1'-0"

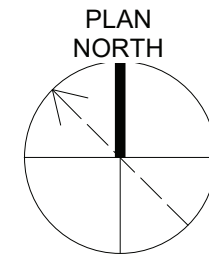

3/8" = 1'-0"



	IN ACCORDANCE WITH TITLE VIII, ARTICLE 145, SECTION 7209 (2) OF THE NEW YORK STATE EDUCATION LAW, IT IS A VIOLATION OF LAW FOR ANY PERSON UNLESS ACTING UNDER THE DIRECTION OF A LICENSED ENGINEER TO ALTER THIS DOCUMENT.	
07/09/21	IN CHARGE OF <u>L. WOODS</u> CHECKED BY <u>T. KIVISTO</u> MADE BY <u>T. HOLLIS</u>	O'BRIEN & GERE ENGINEERS, INC 50 MAIN ST., 10TH FLOOR SUITE 1000, WHITE PLAINS, NEW YORK 10606
REVISION NUMBER	DATE	MADE BY
APPD' BY	REVISION	
RECORD DRAWING CERTIFICATION		
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NAME _____ SIGNATURE _____ TITLE _____ DATE _____	PROJECT COORDINATOR NAME _____ SIGNATURE _____ TITLE _____ DATE _____	
WESTCHESTER COUNTY, NEW YORK DEPARTMENT OF PUBLIC WORKS AND TRANSPORTATION DIVISION OF ENGINEERING		
CROTONVILLE PUMPING STATION REHABILITATION OSSINING SEWER DISTRICT OSSINING, NEW YORK PARTIAL EXISTING ROOF PLANS	CONTRACT NUMBER 17-529	SHEET NUMBER S-103
SHEET NO. 10 OF 60		SCALE: DATE: 11/19/19 DPW FILE NO. 208-03-S-34-0
		REV. NO. 0





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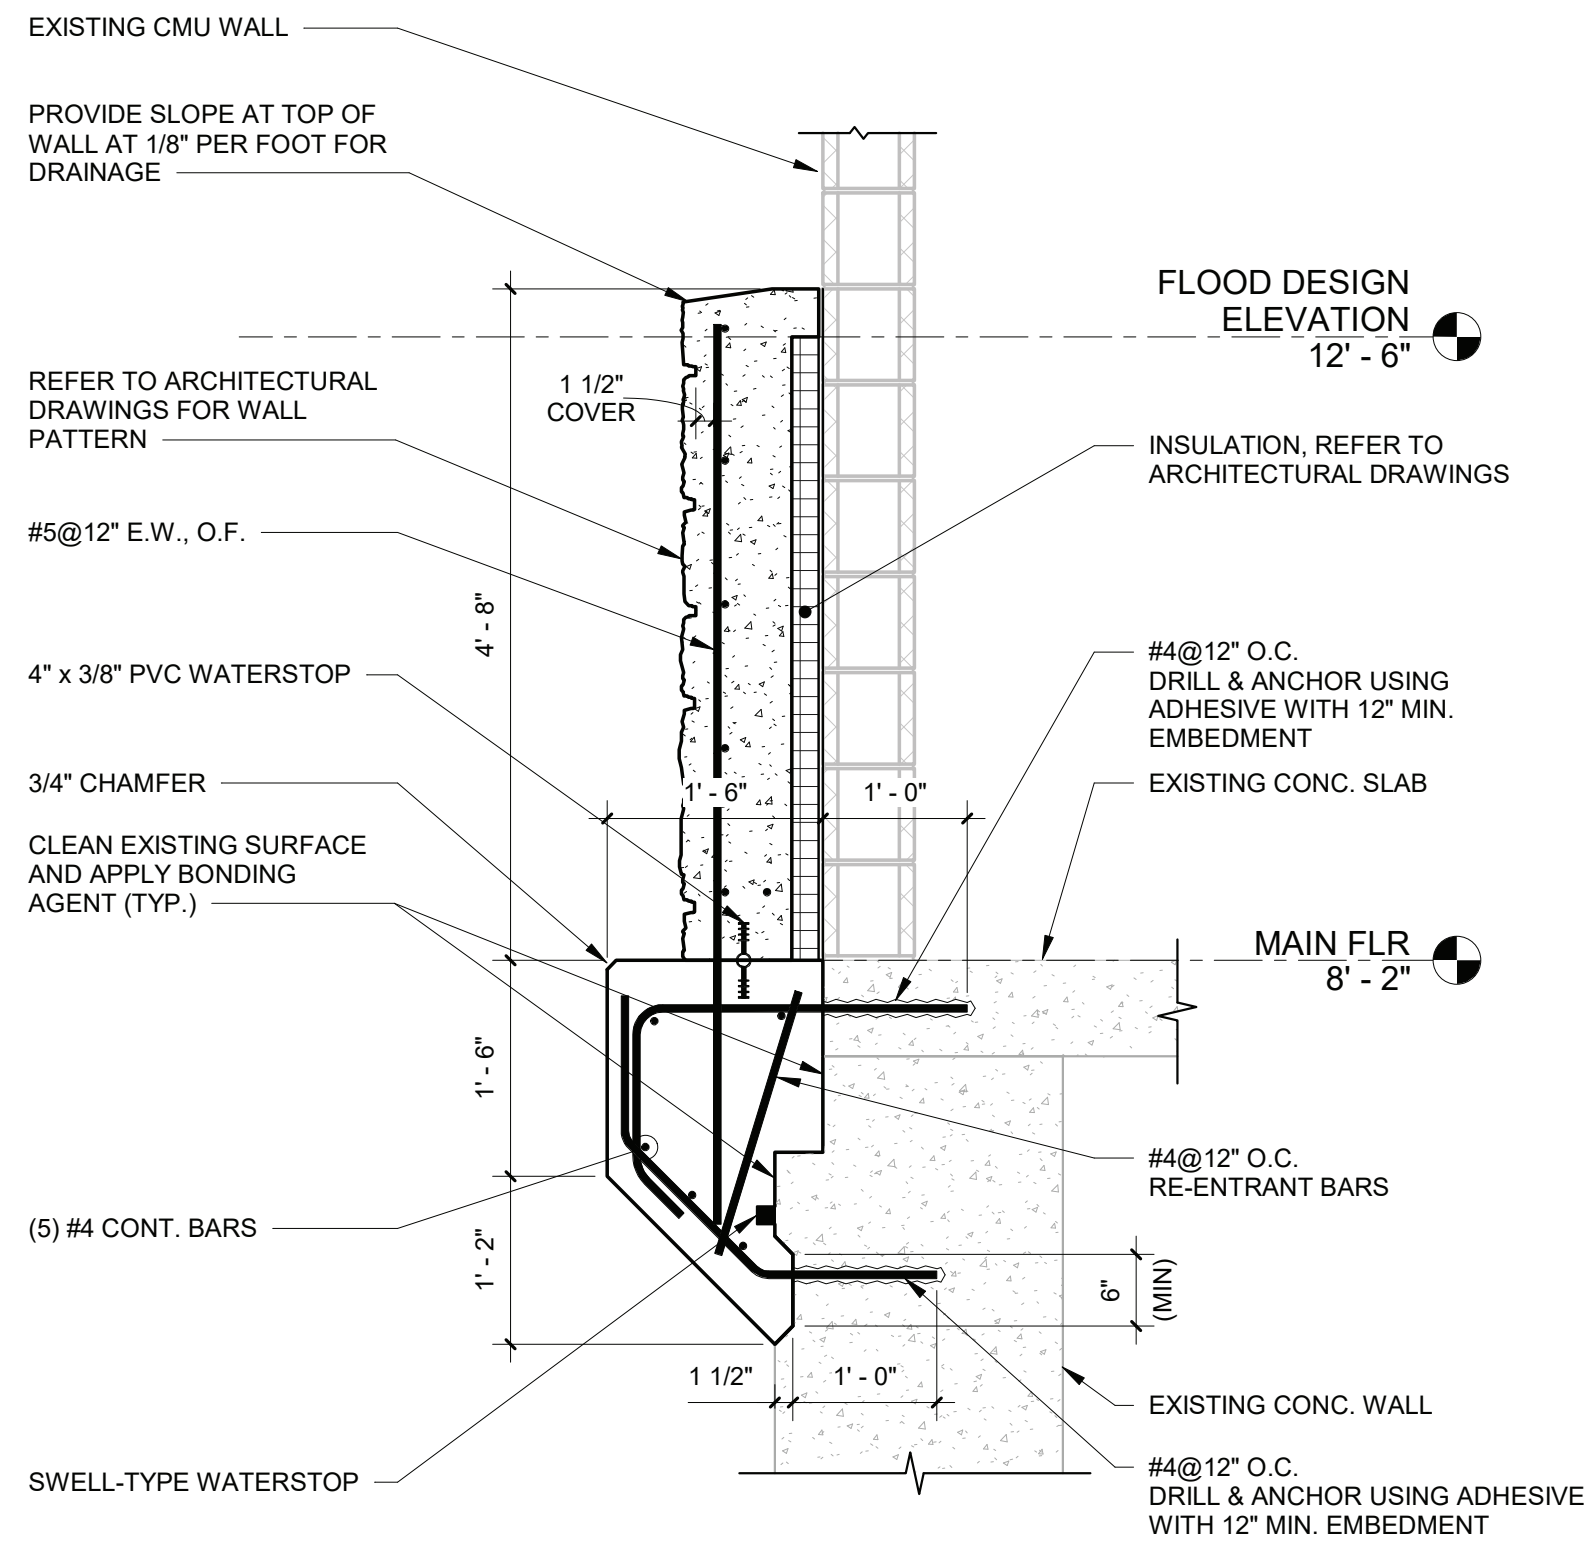
1. COORDINATE GENERATOR SIZES AND LOCATIONS WITH EQUIPMENT MANUFACTURER PRIOR TO FABRICATION.
2. HOT-DIP GALVANIZED STRUCTURAL STEEL AND ACCESSORIES.
3. T/STEEL ELEVATION = 12'-8" UNLESS NOTED (+/- 0.00") THEREFROM.
4. FIBER REINFORCEMENT SHALL BE BLENDED POLYPROPYLENE POLYETHYLENE MACRO-MONIFILAMENT FIBERS AND POLYPROPYLENE MICRO-SYNTHETIC FIBERS SUCH AS NOVOMESH 950 BY FIBERMESH CONCRETE SOLUTIONS BY SIKKA, WITH A DOSAGE OF 5 LBS/C.Y. OR AS RECOMMENDED BY THE FIBER MANUFACTURER.



PLAN NOTES:


1. COORDINATE TRANSFORMER AND SWITCHGEAR SIZES AND LOCATIONS WITH EQUIPMENT MANUFACTURER PRIOR TO FABRICATION.
2. HOT-DIP GALVANIZED STRUCTURAL STEEL AND ACCESSORIES.
3. T/SLT ELEVATION = 12'-6" UNLESS NOTED (+/- 0'-0") THEREFROM.
4. REINFORCEMENT SHALL BE BLENDED POLYPROPYLENE/POLYETHYLENE MACROFIBERCONCREMENT FIBERS AND POLYPROPYLENE MICRO-SYNTHETIC FIBERS SUCH AS NOVOMESH 950 BY FIBERMESH CONCRETE SOLUTIONS BY SIKKA, WITH A DOSAGE OF 5 LBS/CY. OR AS RECOMMENDED BY THE FIBER MANUFACTURER.

	IN ACCORDANCE WITH TITLE VIII, ARTICLE 145, SECTION 7309 (2) OF THE NEW YORK STATE EDUCATION LAW, IT IS A VIOLATION OF LAW FOR ANY PERSON UNLESS ACTING UNDER THE DIRECTION OF A LICENSED ENGINEER TO ALTER THIS DOCUMENT.	
07/09/21	IN CHARGE OF <u>L. WOODS</u> CHECKED BY <u>T. KIVISTO</u> MADE BY <u>R. EGAN</u>	O'BRIEN & GERE ENGINEERS, INC. 50 MAIN ST., 10TH FLOOR SUITE 1000, WHITE PLAINS, NEW YORK 10606
REVISION NUMBER	DATE	MADE BY
		APP'D BY
		REVISION
RECORD DRAWING CERTIFICATION		
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WESTCHESTER COUNTY, NEW YORK DEPARTMENT OF PUBLIC WORKS AND TRANSPORTATION DIVISION OF ENGINEERING		
CROTONVILLE PUMPING STATION REHABILITATION OSSINING SEWER DISTRICT OSSINING, NEW YORK ELECTRICAL SERVICE PLATFORMS	CONTRACT NUMBER 17-529	SHEET NUMBER S-104
SHEET NO. 11 OF 60		SCALE: DATE: 12/21/18
DPW FILE NO.		REV. NO.
208-03-S-35-0		0




1 FLOOD WALL SECTION

3/4" = 1'-0" 6" 3" 0 1' 2'

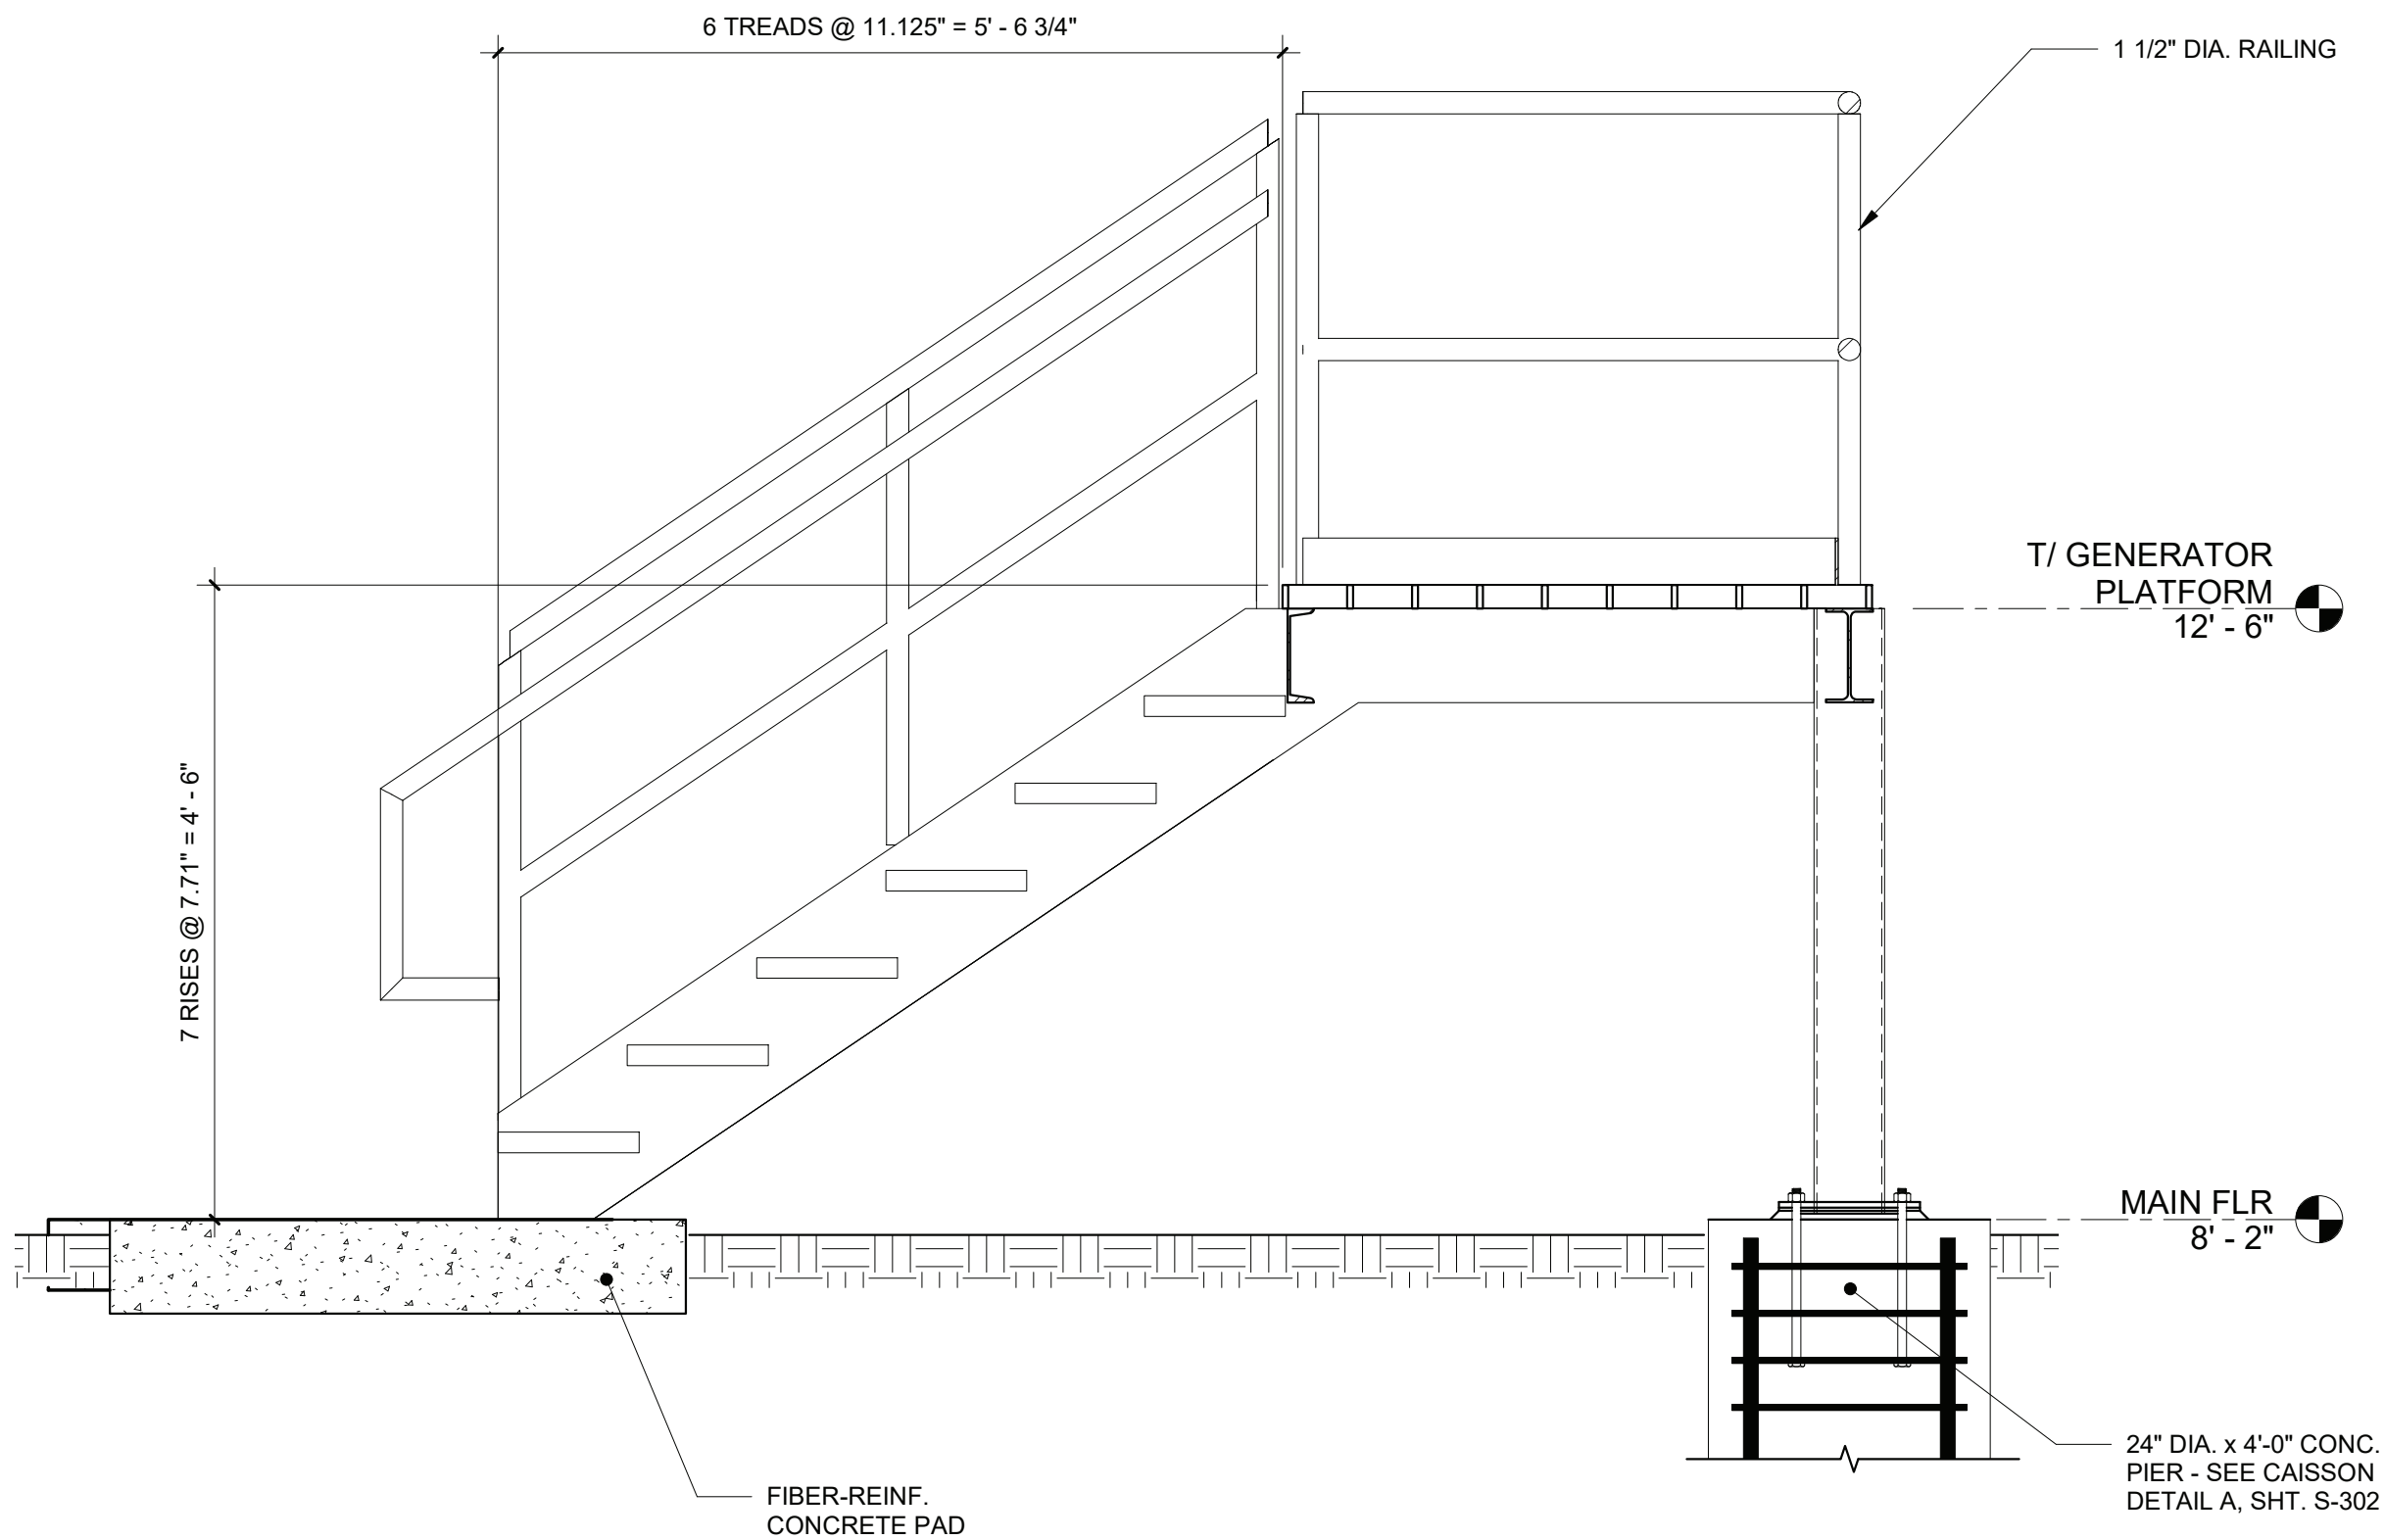


4 SECTION

3/4" = 1'-0" 6" 3" 0 1' 2'

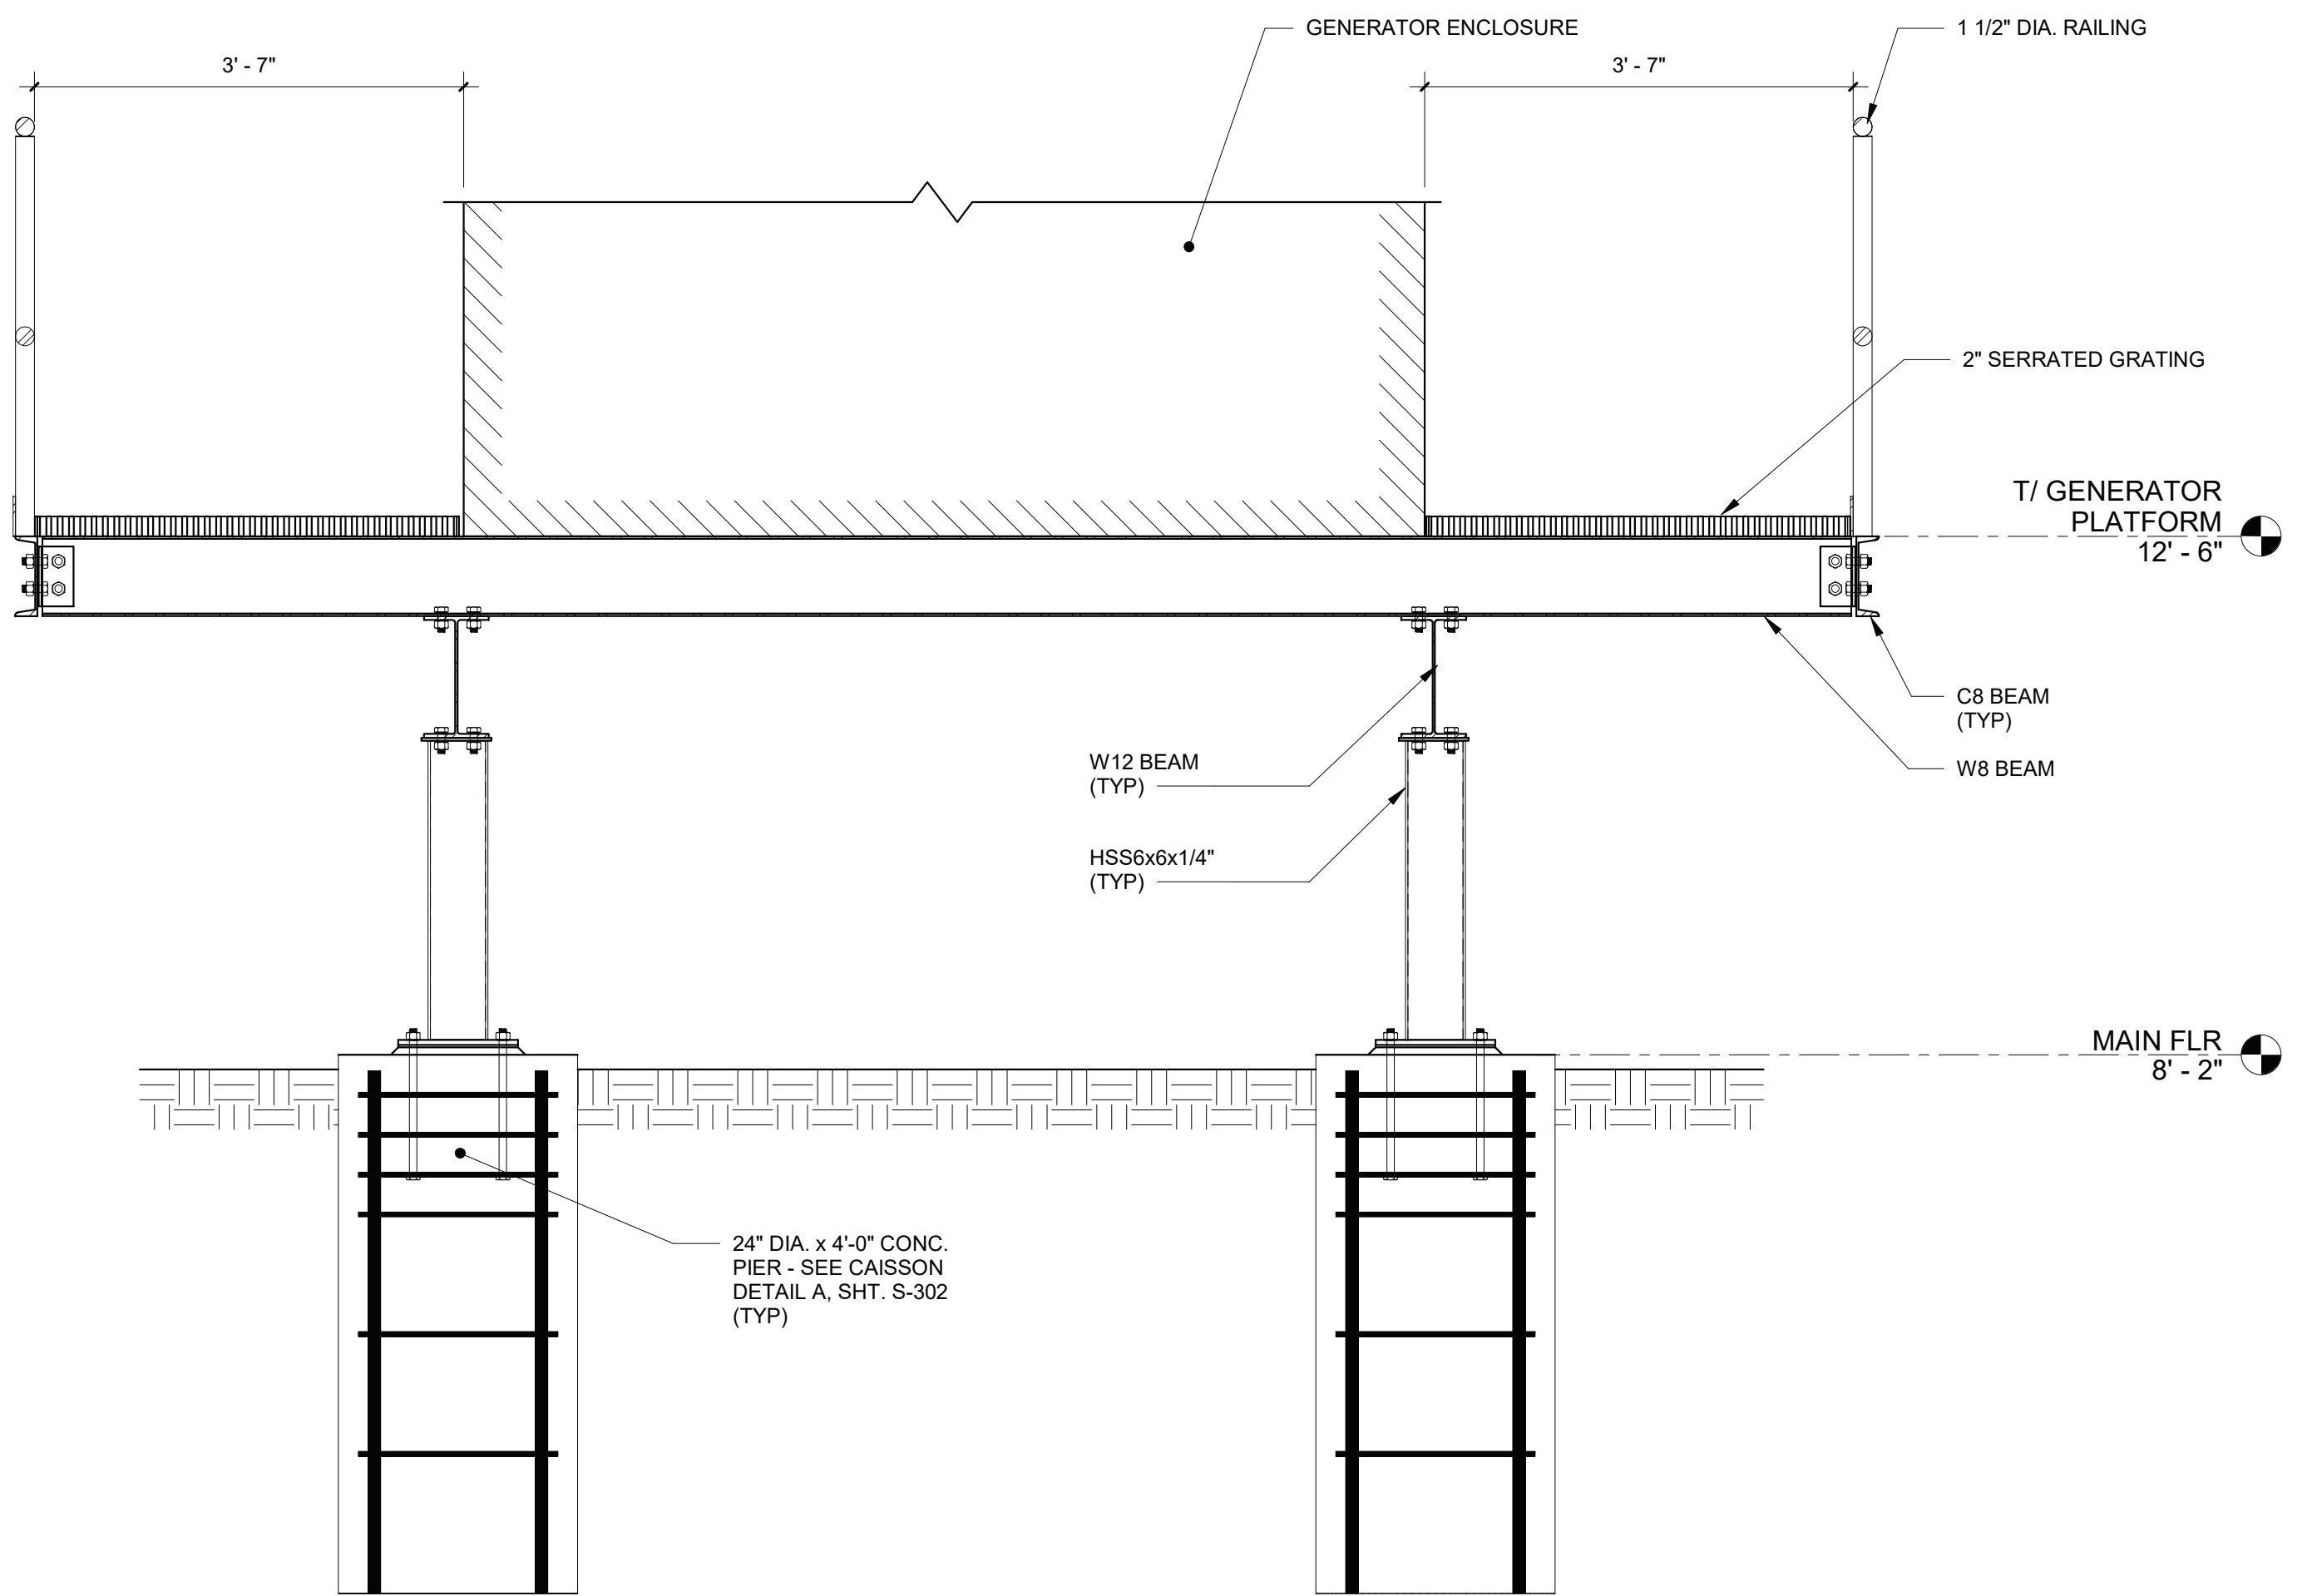

3 SECTION


3/4" = 1'-0" 6" 3" 0 1' 2'

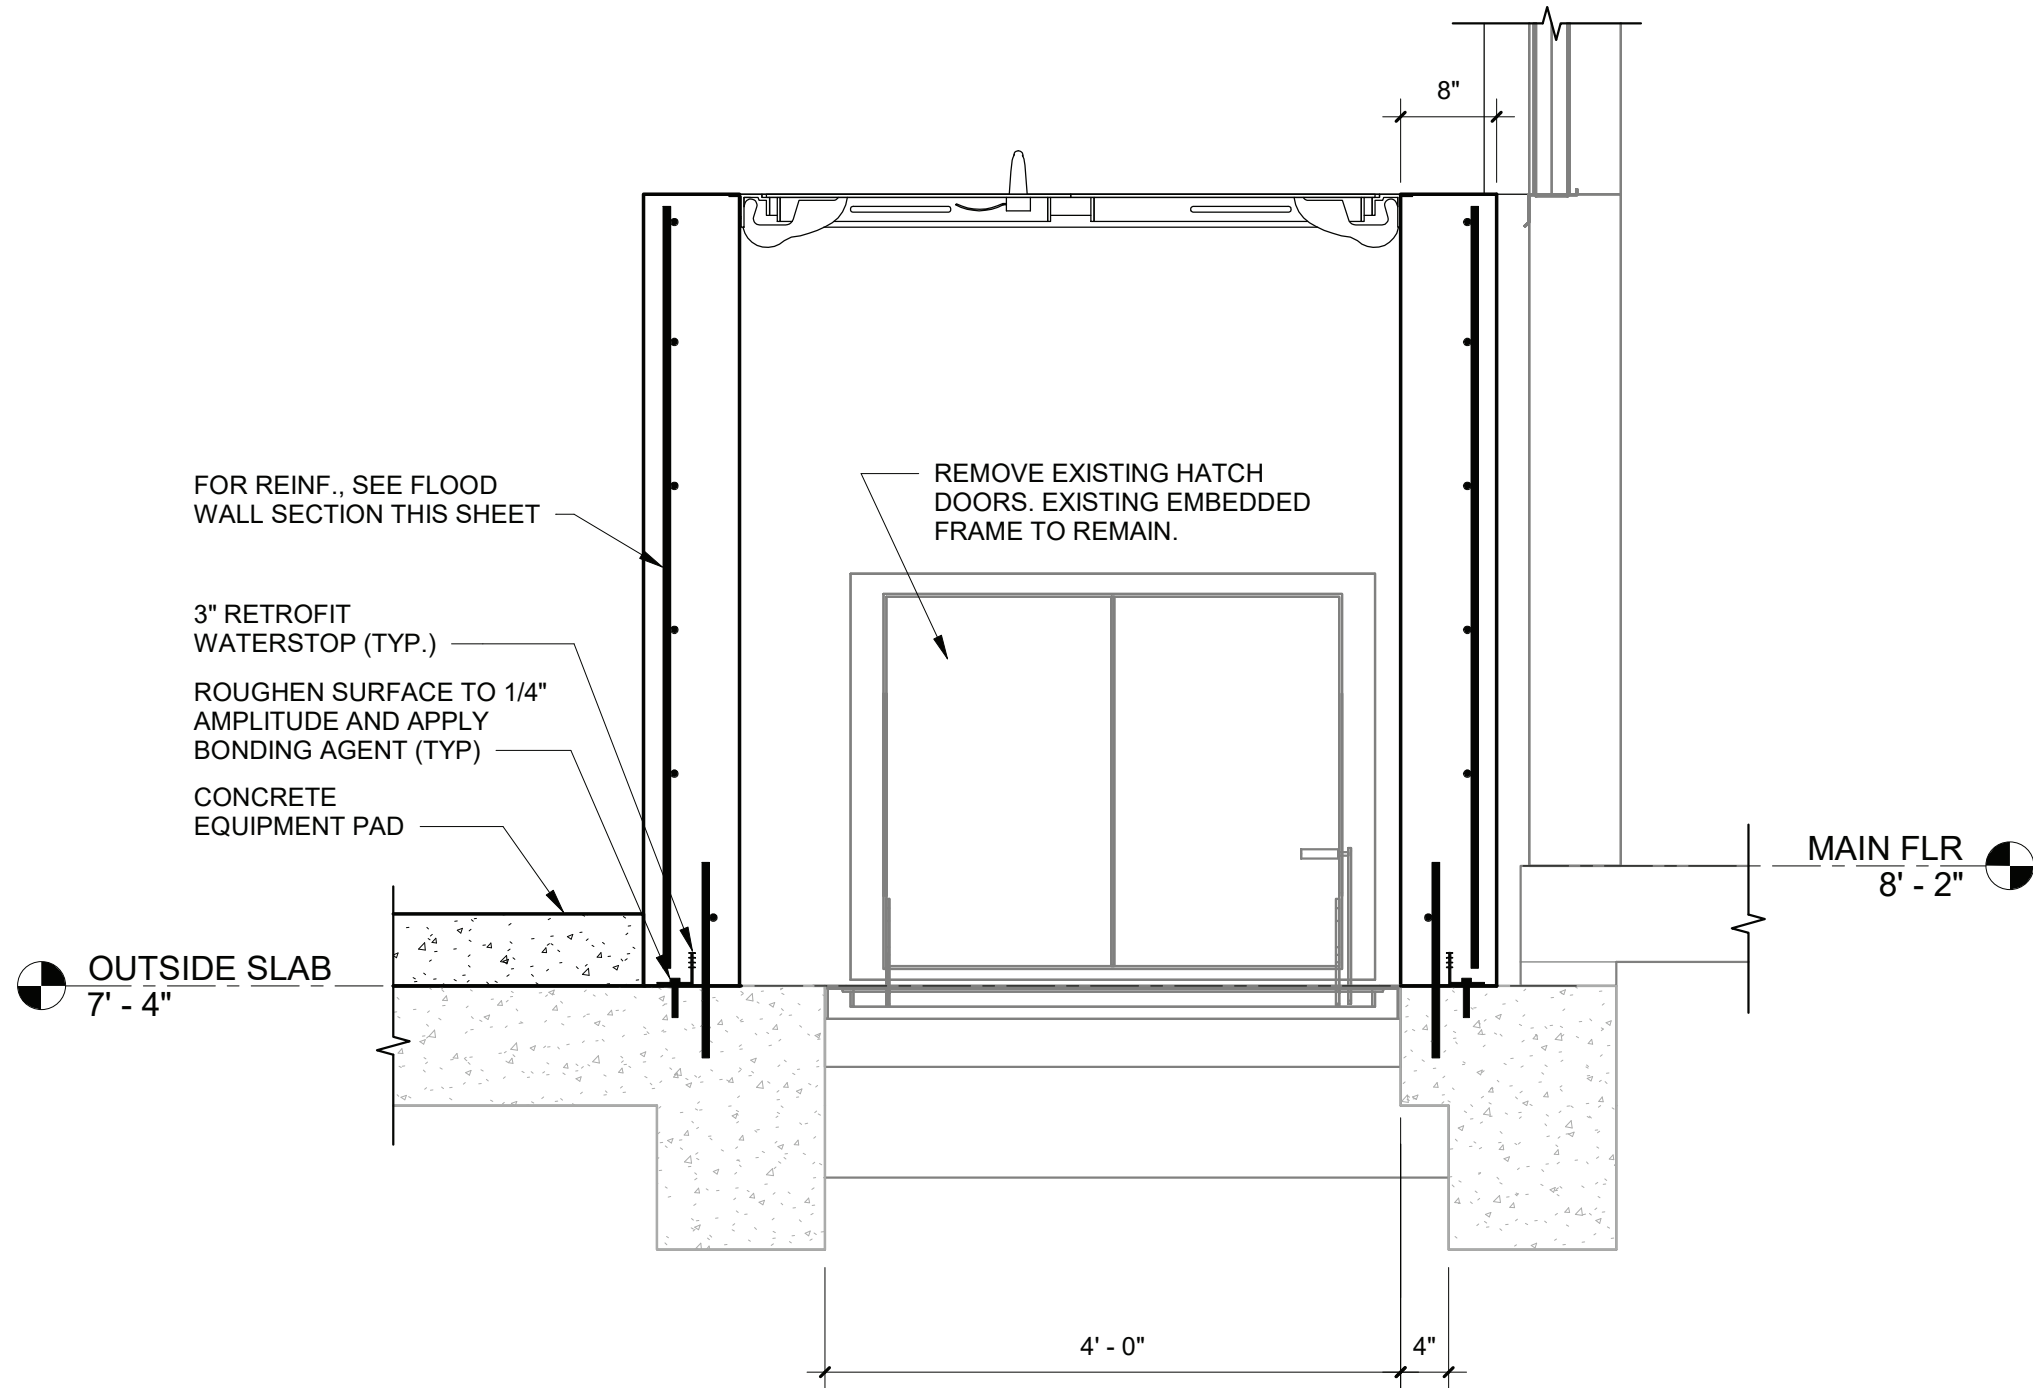


5 SECTION

3/4" = 1'-0" 6" 3" 0 1' 2'


		IN ACCORDANCE WITH TITLE VIII, ARTICLE 145, SECTION 7209 (2) OF THE NEW YORK STATE EDUCATION LAW, IT IS A VIOLATION OF LAW FOR ANY PERSON UNLESS ACTING UNDER THE DIRECTION OF A LICENSED ENGINEER TO ALTER THIS DOCUMENT.			
IN CHARGE OF L. WOODS		CHECKED BY T. KIVISTO		MADE BY R. EGAN	
07/09/21					
REVISION NUMBER	DATE	MADE BY	APP'D BY	REVISION	
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NAME			NAME		
SIGNATURE			SIGNATURE		
TITLE			TITLE		
WESTCHESTER COUNTY, NEW YORK			CONTRACT NUMBER	SHEET NUMBER	
DEPARTMENT OF PUBLIC WORKS AND TRANSPORTATION			17-529	S-301	
DIVISION OF ENGINEERING			SHEET NO.	12	OF 60
CROTONVILLE PUMPING STATION REHABILITATION			SCALE: DATE: 12/21/18		
OSSINING SEWER DISTRICT			DPW FILE NO.		
OSSINING, NEW YORK			208-03-S-36-0		
SECTIONS AND DETAILS			REV. NO. 0		

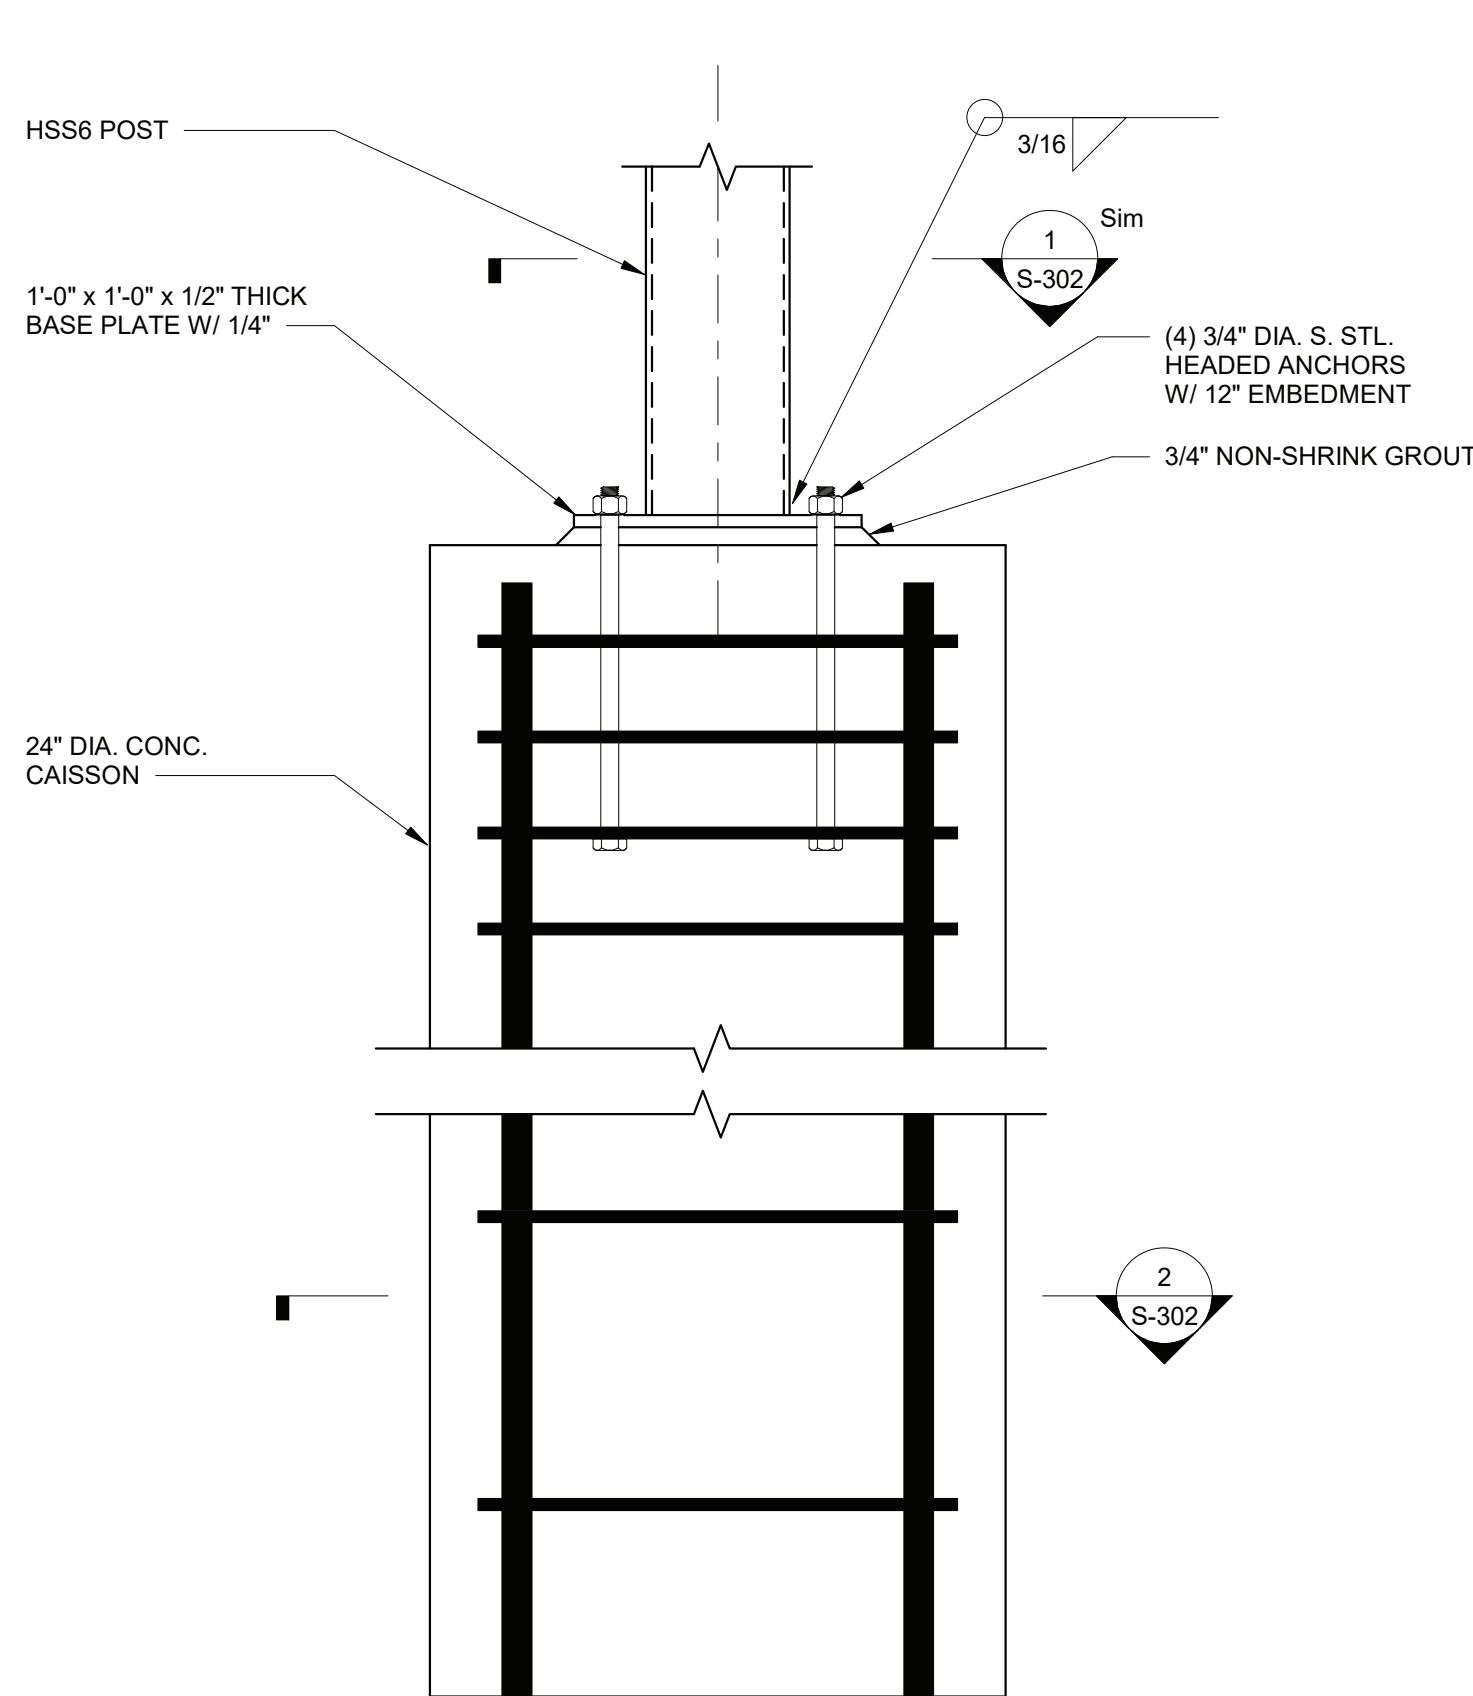


A CAISSON DETAIL
1 1/2" = 1'-0"
4" 2" 0 1'

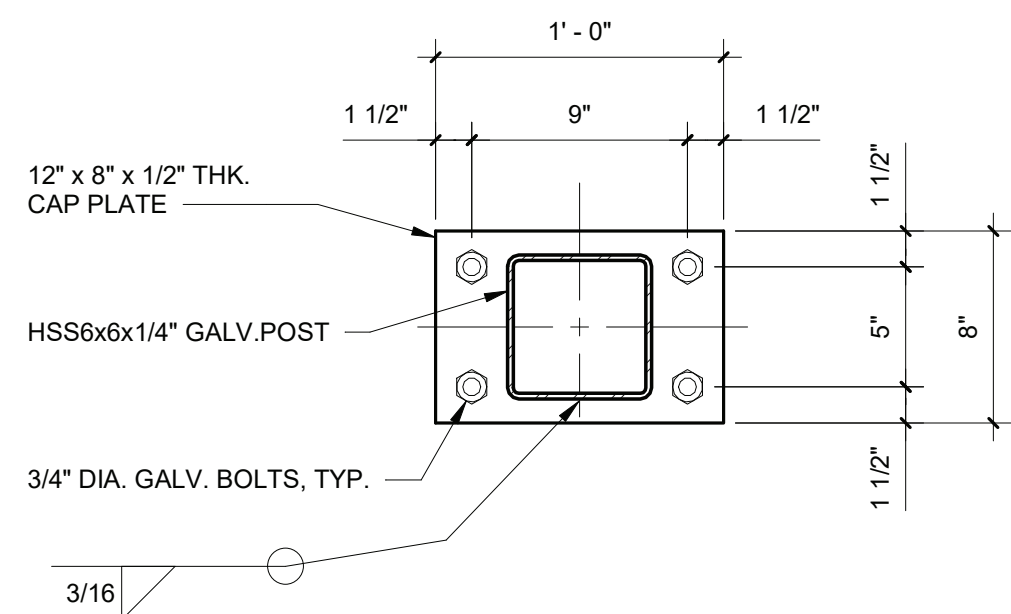


B CAP PLATE DETAIL
1 1/2" = 1'-0"
4" 2" 0 1'

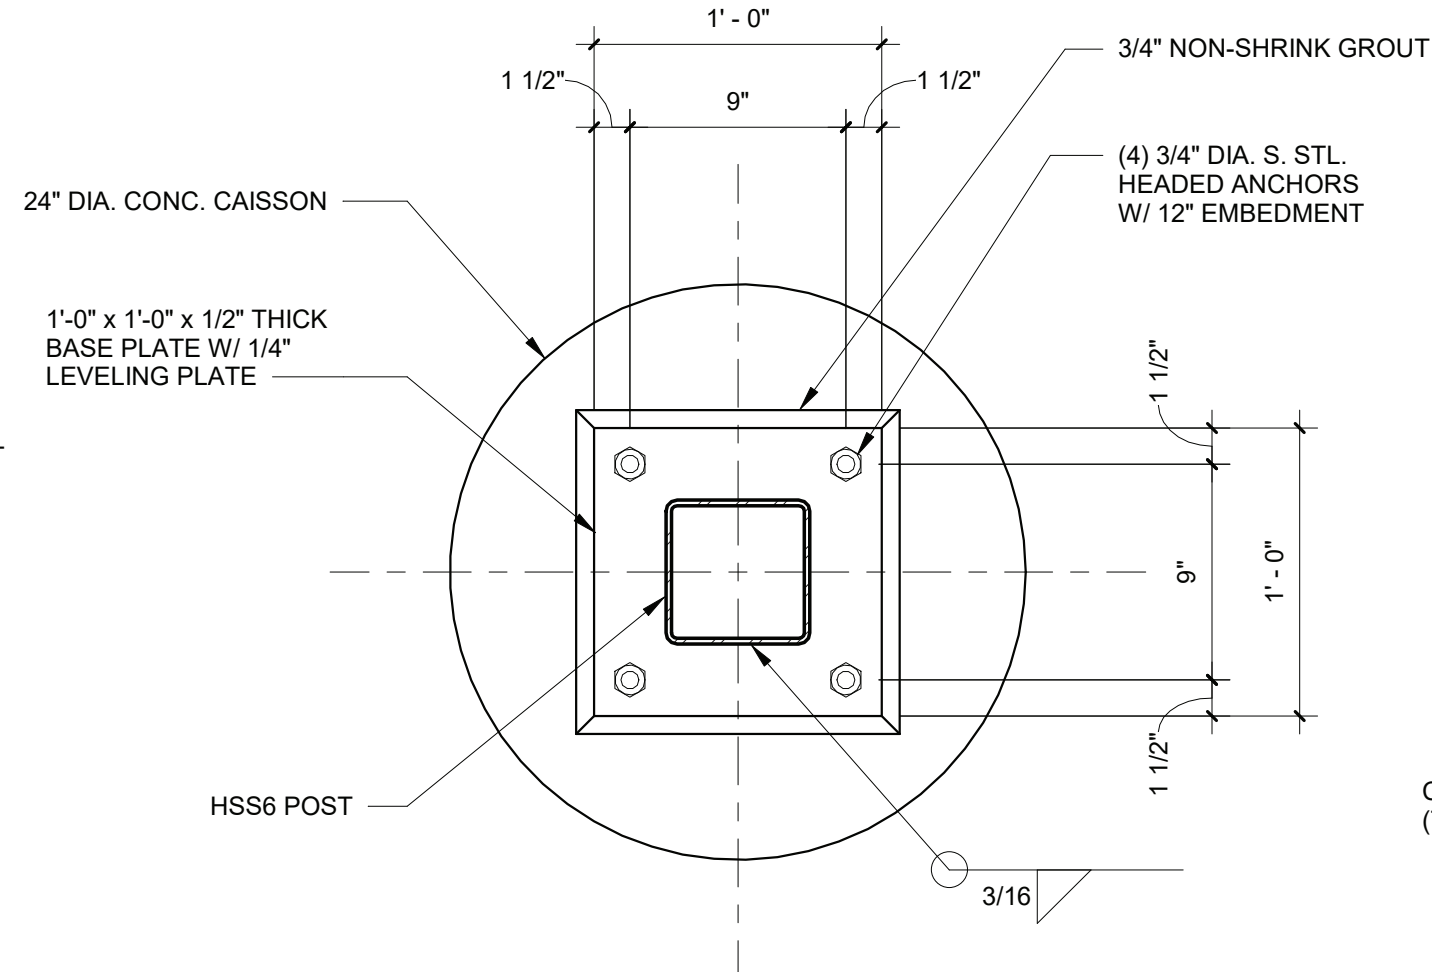

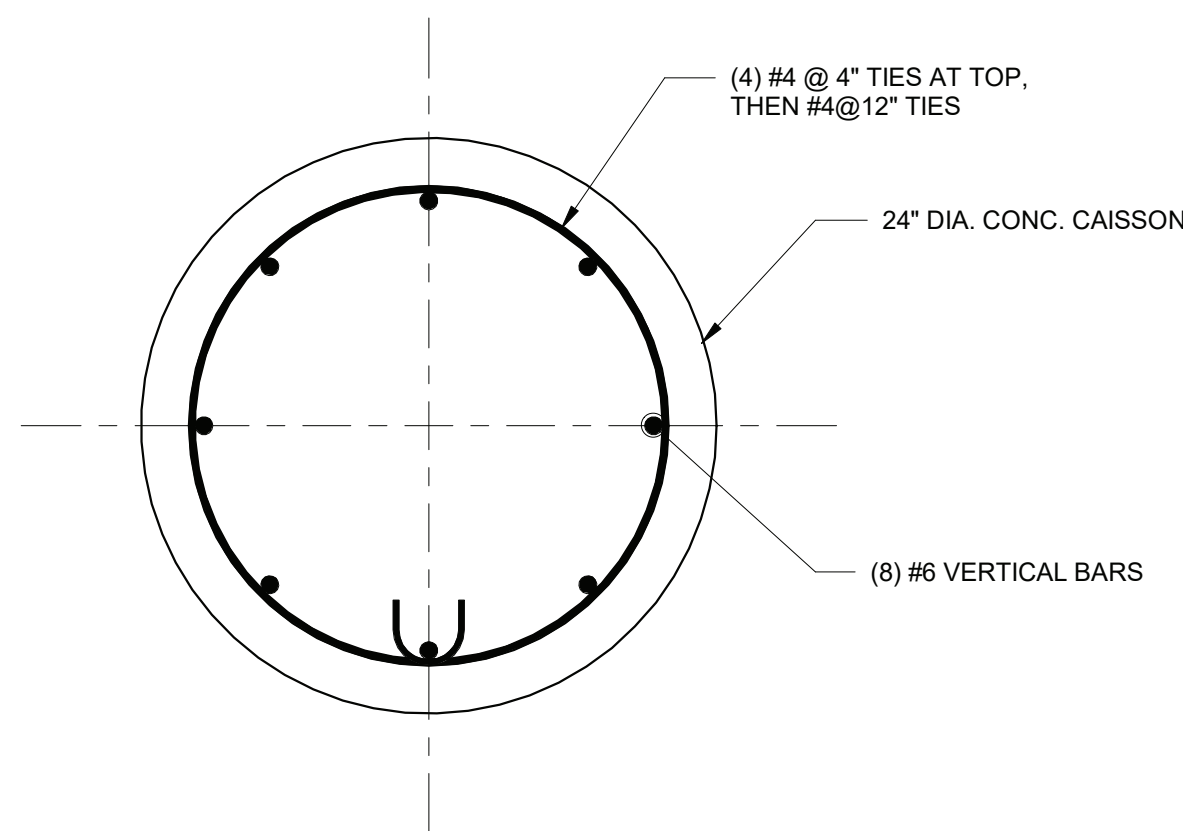

1 BASE PLATE SECTION
1 1/2" = 1'-0"
4" 2" 0 1'


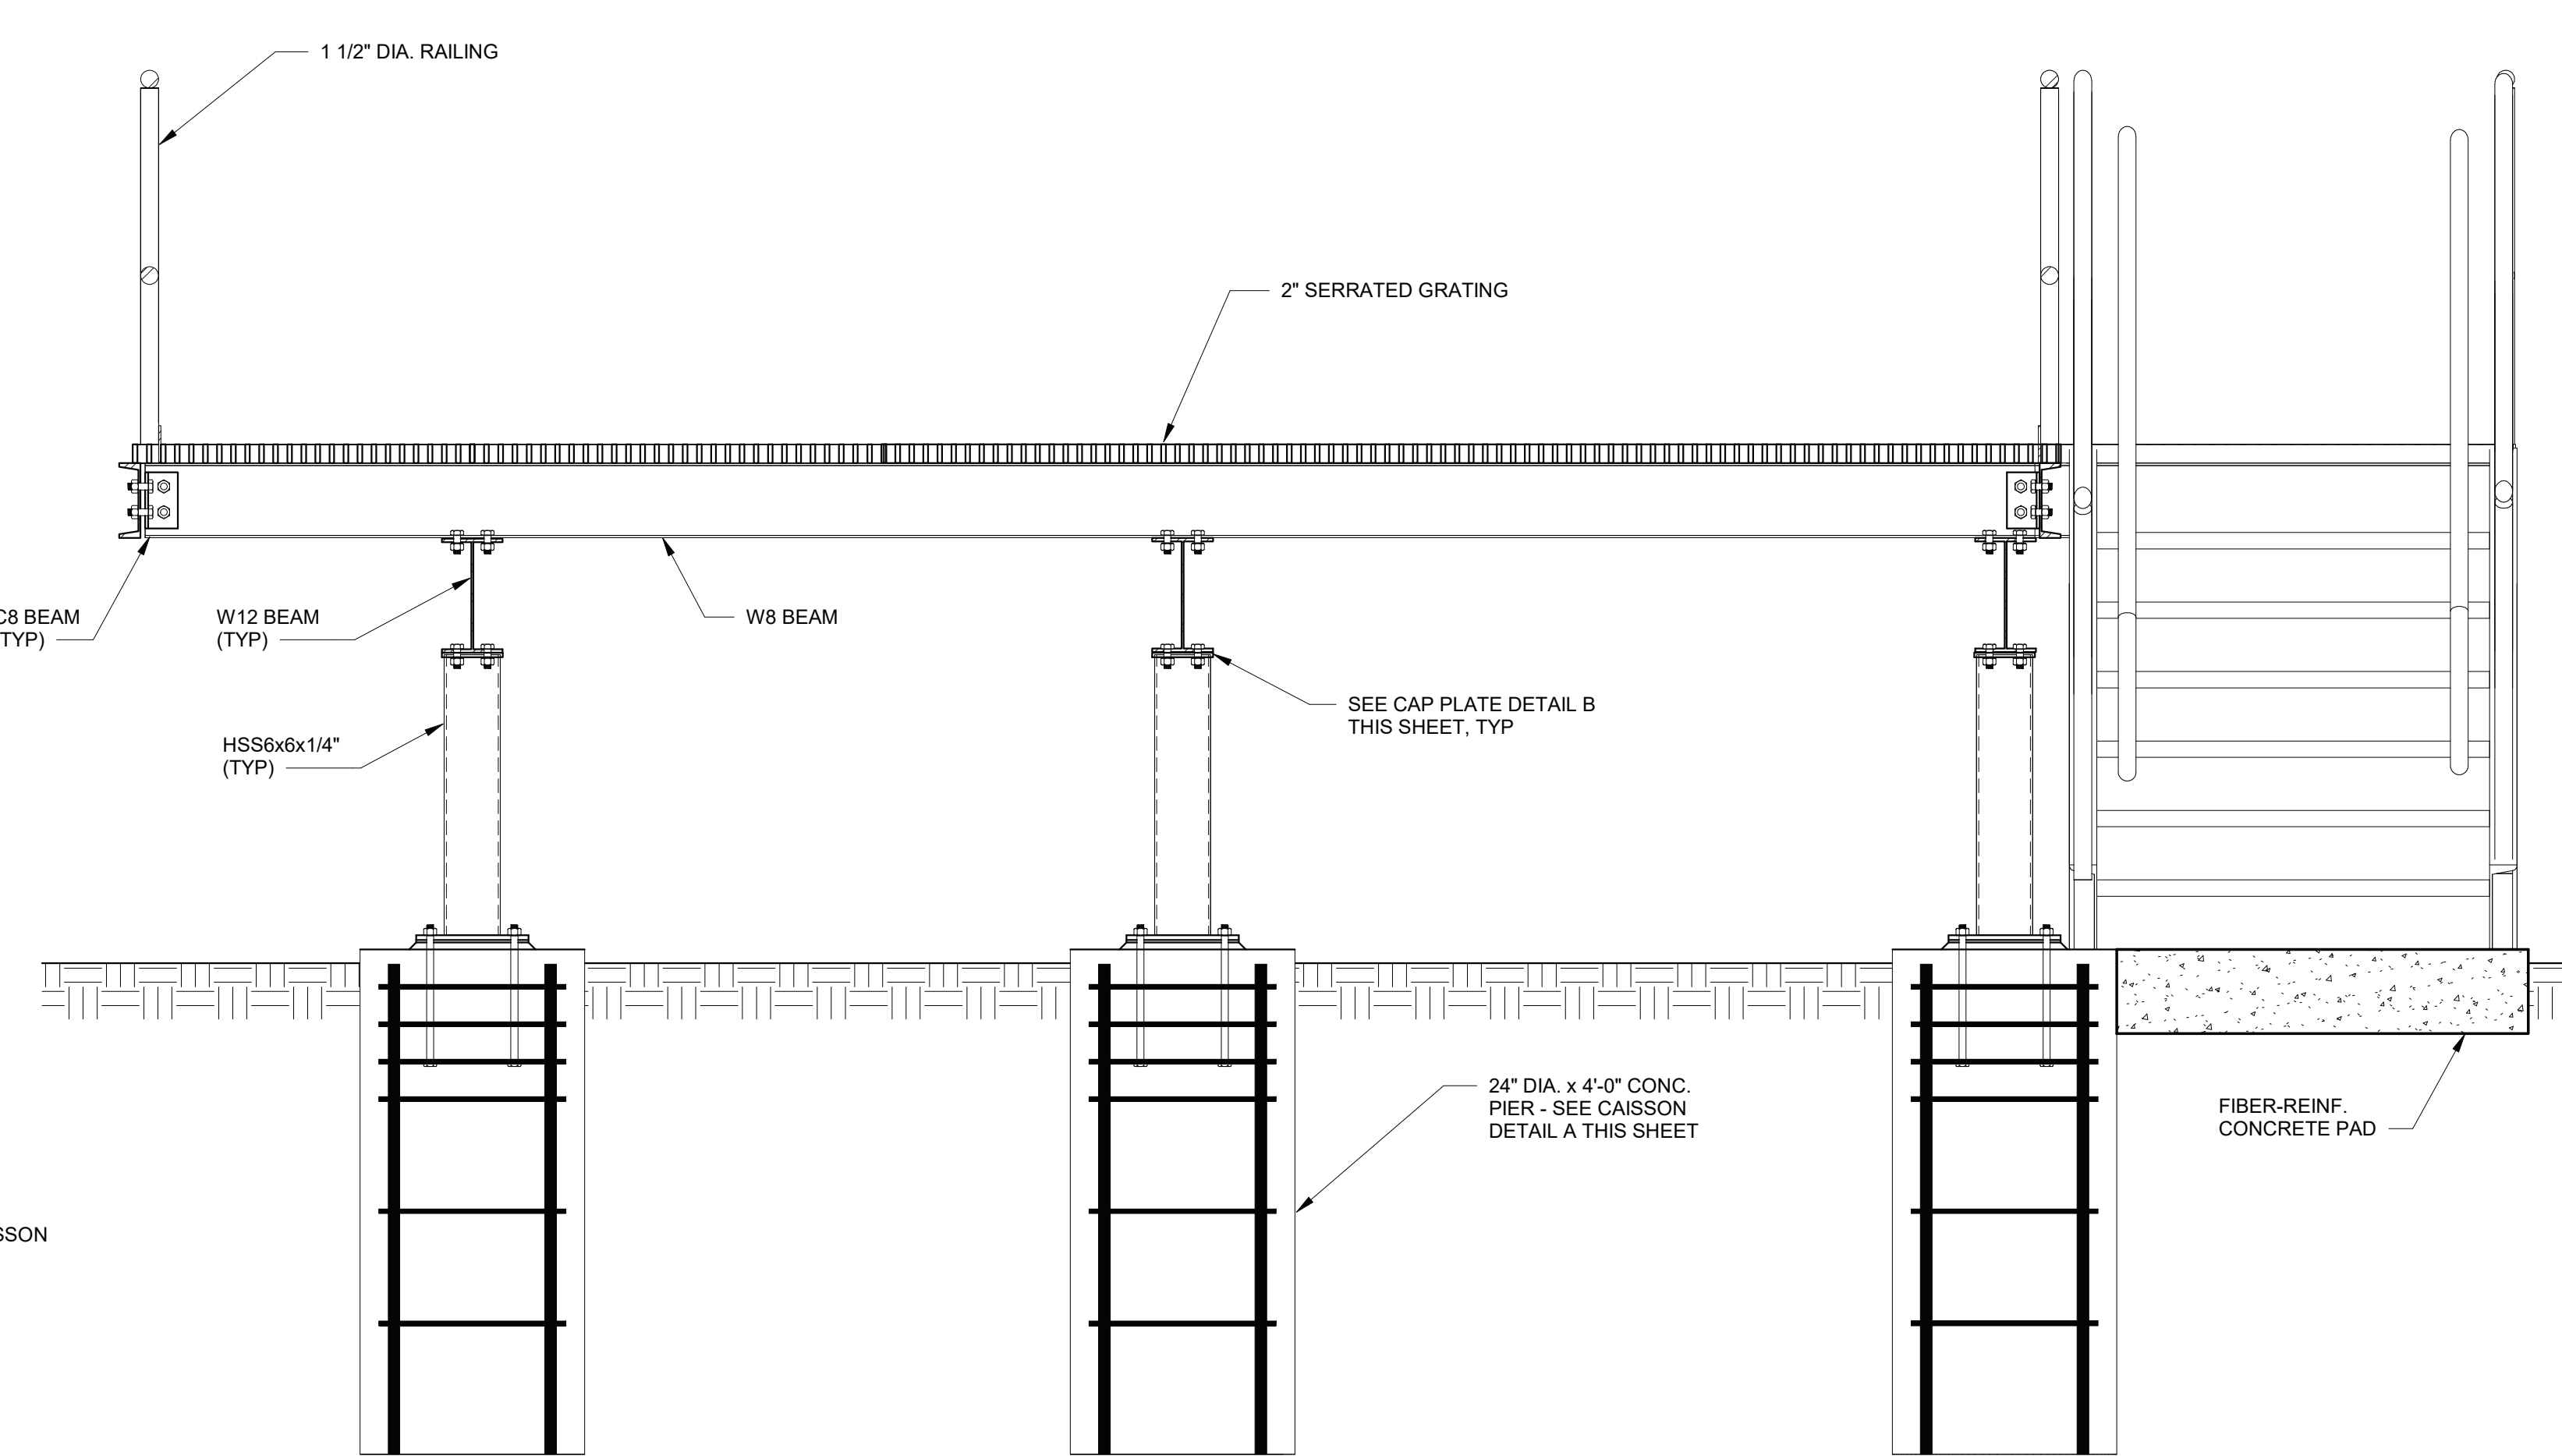


2 CAISSON SECTION
1 1/2" = 1'-0"
4" 2" 0 1'




3 SECTION
3/4" = 1'-0"
4" 2" 0 1'

 07/09/21	IN ACCORDANCE WITH TITLE VIII, ARTICLE 145, SECTION 7209 (2) OF THE NEW YORK STATE EDUCATION LAW, IT IS A VIOLATION OF LAW FOR ANY PERSON UNLESS ACTING UNDER THE DIRECTION OF A LICENSED ENGINEER TO ALTER THIS DOCUMENT.	 O'BRIEN & GERE ENGINEERS, INC. 50 MAIN ST., 10TH FLOOR SUITE 1000, WHITE PLAINS, NEW YORK 10606																									
	IN CHARGE OF <u>L. WOODS</u> CHECKED BY <u>T. KIVISTO</u> MADE BY <u>R. EGAN</u>																										
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SIGNATURE _____	SIGNATURE _____	SIGNATURE _____																									
TITLE _____	TITLE _____	TITLE _____																									
WESTCHESTER COUNTY, NEW YORK DEPARTMENT OF PUBLIC WORKS AND TRANSPORTATION DIVISION OF ENGINEERING		CONTRACT NUMBER 17-529 SHEET NUMBER S-302																									
CROTONVILLE PUMPING STATION REHABILITATION OSSINING SEWER DISTRICT OSSINING, NEW YORK SECTIONS AND DETAILS		SCALE: DATE: 12/21/18 DPW FILE NO. 208-03-S-37-0 REV. NO. 0																									

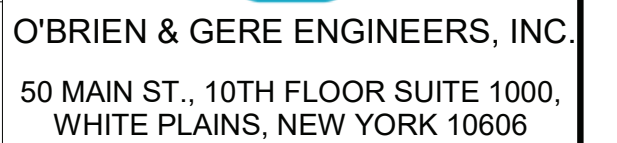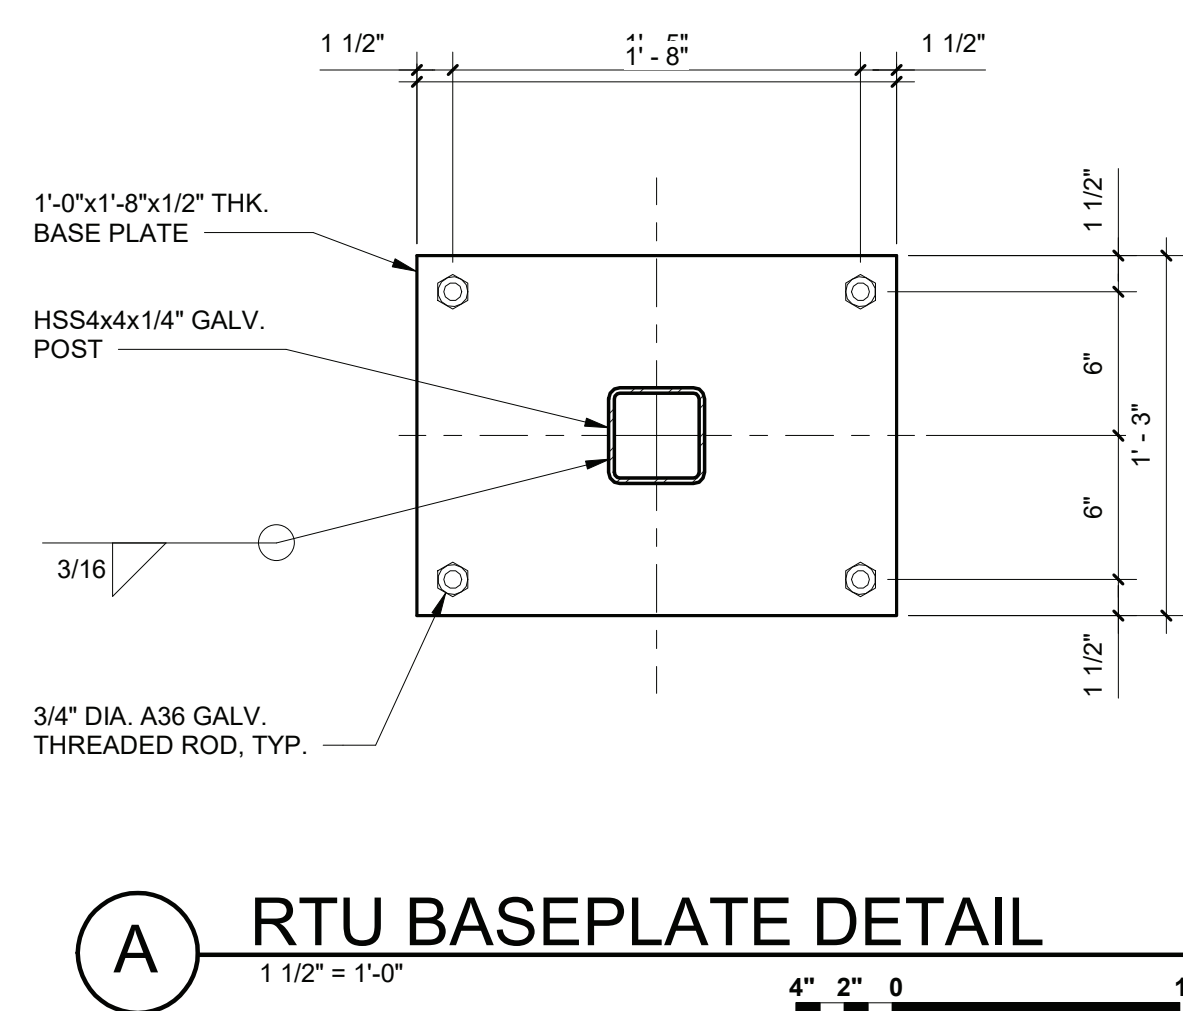


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CONTRACTOR			PROJECT COORDINATOR	
NAME _____			NAME _____	
SIGNATURE _____			SIGNATURE _____	
TITLE _____ DATE _____			TITLE _____ DATE _____	
WESTCHESTER COUNTY, NEW YORK				CONTRACT NUMBER 17-529
DEPARTMENT OF PUBLIC WORKS AND TRANSPORTATION				SHEET NUMBER S-303
DIVISION OF ENGINEERING				SHEET NO. 14 OF 60
CROTONVILLE PUMPING STATION REHABILITATION				SCALE: DATE: 11/19/19
OSSINING SEWER DISTRICT				DPW FILE NO.
OSSINING, NEW YORK				208-03-S-38-0
SECTIONS AND DETAILS				REV. NO. 0

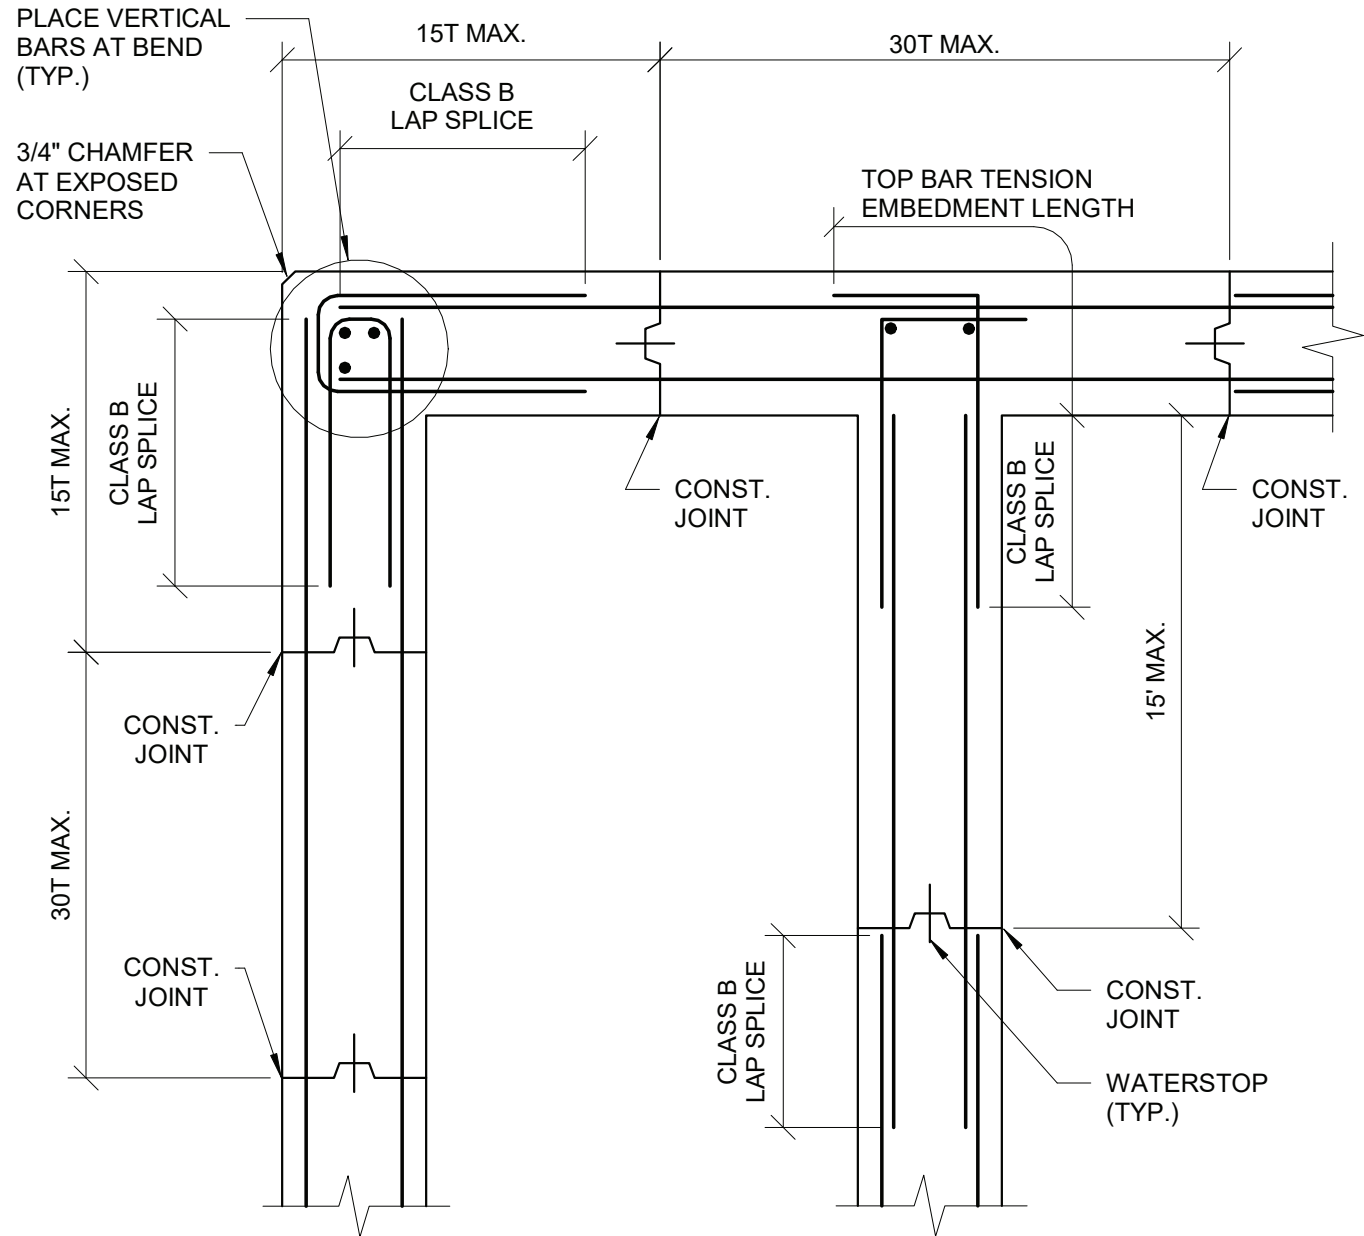

SCHEMATIC HORIZ. WALL REINF. & JOINT LOCATION DETAIL AT LIQUID RETAINING STRUCTURE


NOT TO SCALE

- DETAIL NOTES:
- CORNER AND INTERSECTION REINF. BARS SHALL BE SAME SIZE AND SPACING AS HORIZONTAL WALL REINFORCING U.O.N. WHERE REINFORCING IS NOT THE SAME IN EACH WALL, THE HEAVIER REINFORCING SHALL BE USED AT THE CORNER.
 - LAP SPLICE - CLASS B TOP BAR LAP SPLICE.
 - JOINT TYPE AS NOTED ON THE PLANS.
 - STAGGER WALL AND FOOTING JOINTS 4'-0" MINIMUM.

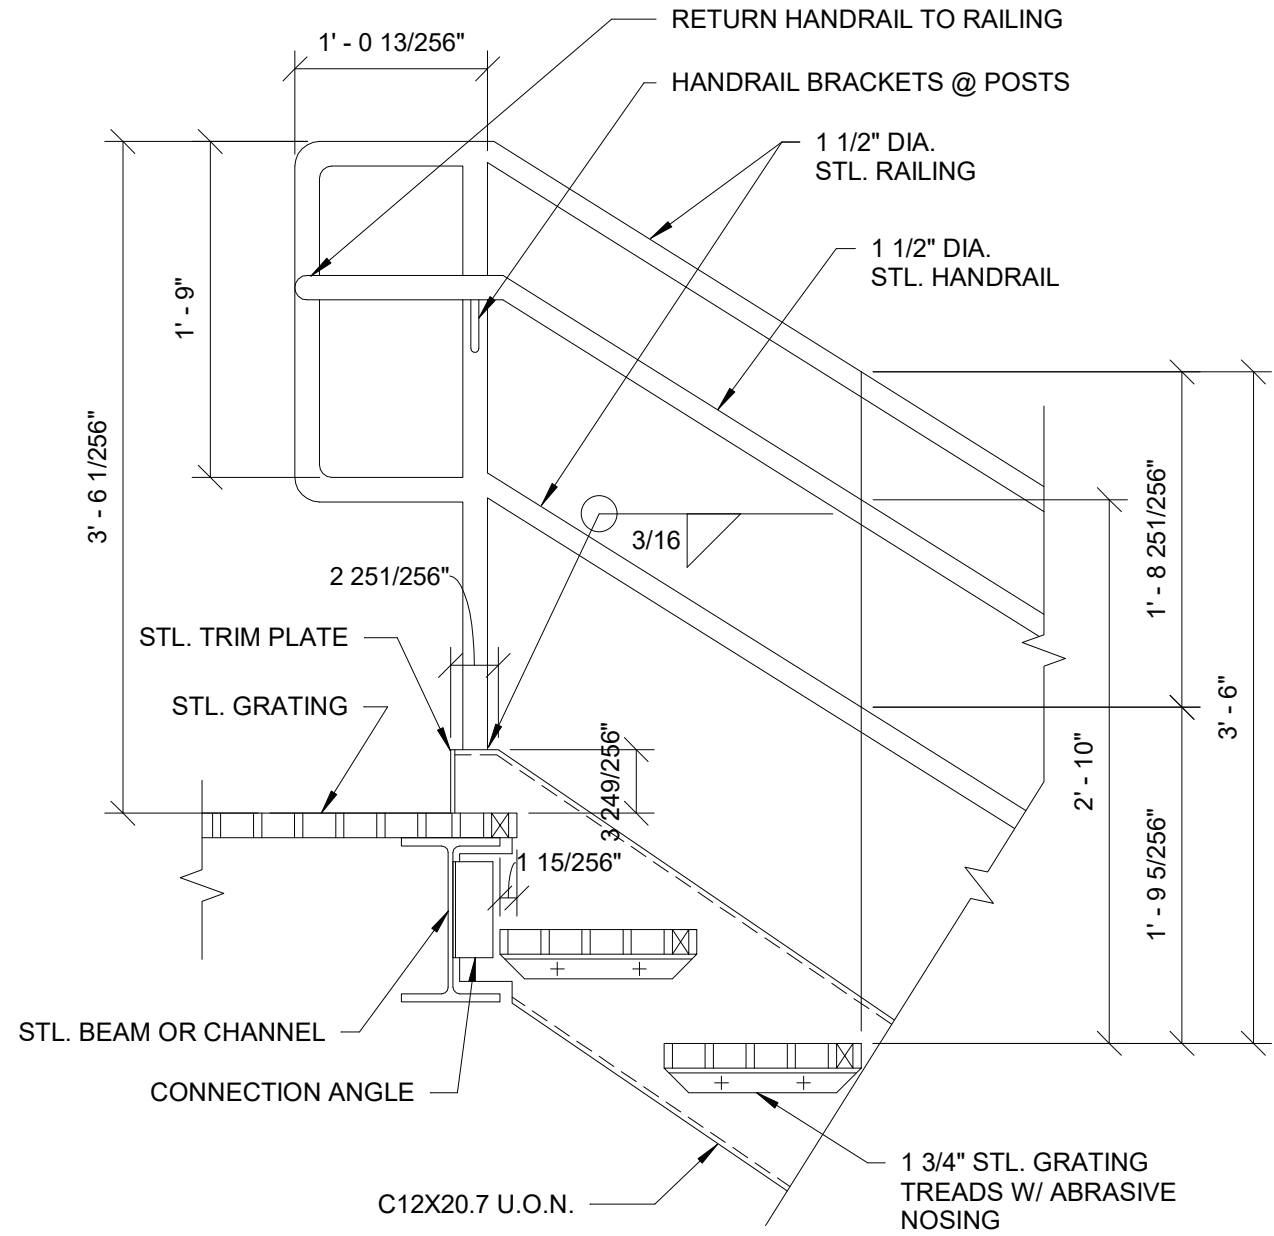

STAIR HEAD DETAIL AT PLATFORM


NOT TO SCALE

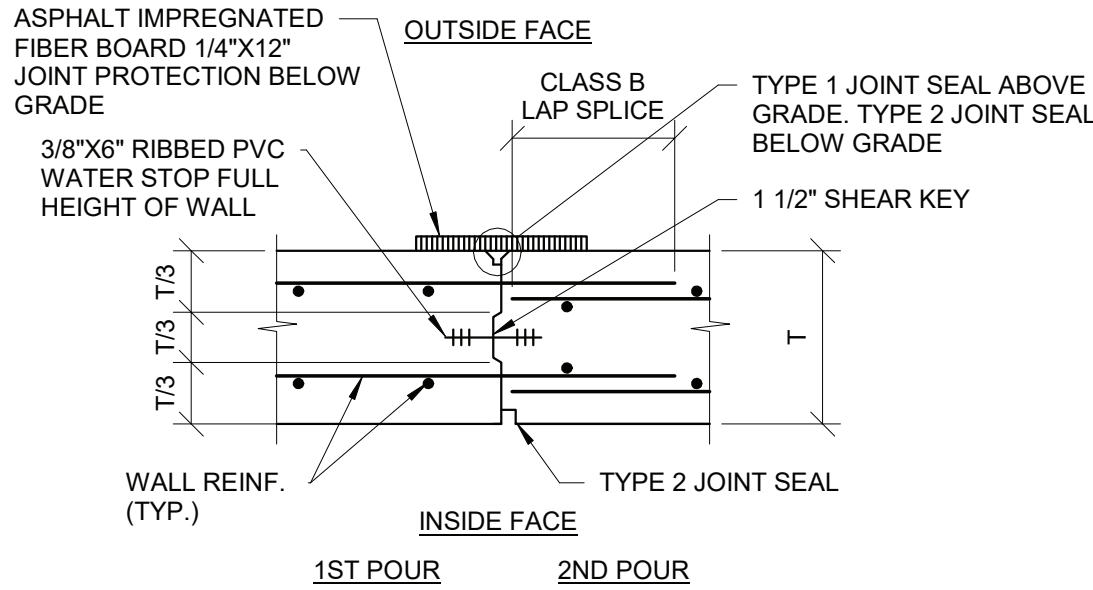

CONST. JOINT DETAIL AT LIQUID RETAINING STRUCTURE WALL


NOT TO SCALE

- DETAIL NOTES:
- MAXIMUM SPACING BETWEEN JOINTS, 30T NOT TO EXCEED 60 FEET FOR WALLS UP TO 24 INCHES THICK. FOR WALLS THAT ARE GREATER THAN 24 INCHES THICK, MAXIMUM SPACING BETWEEN JOINTS SHALL NOT EXCEED 72 FEET.
 - DETAILING OF CONCRETE REINFORCING SHALL NOT BEGIN UNTIL THE CONTRACTOR PROVIDES THE REBAR FABRICATOR WITH A FINALIZED JOINT LAYOUT THAT HAS BEEN REVIEWED BY THE ENGINEER.
 - STAGGER WALL AND SLAB CONSTRUCTION JOINTS 4'-0" MINIMUM.

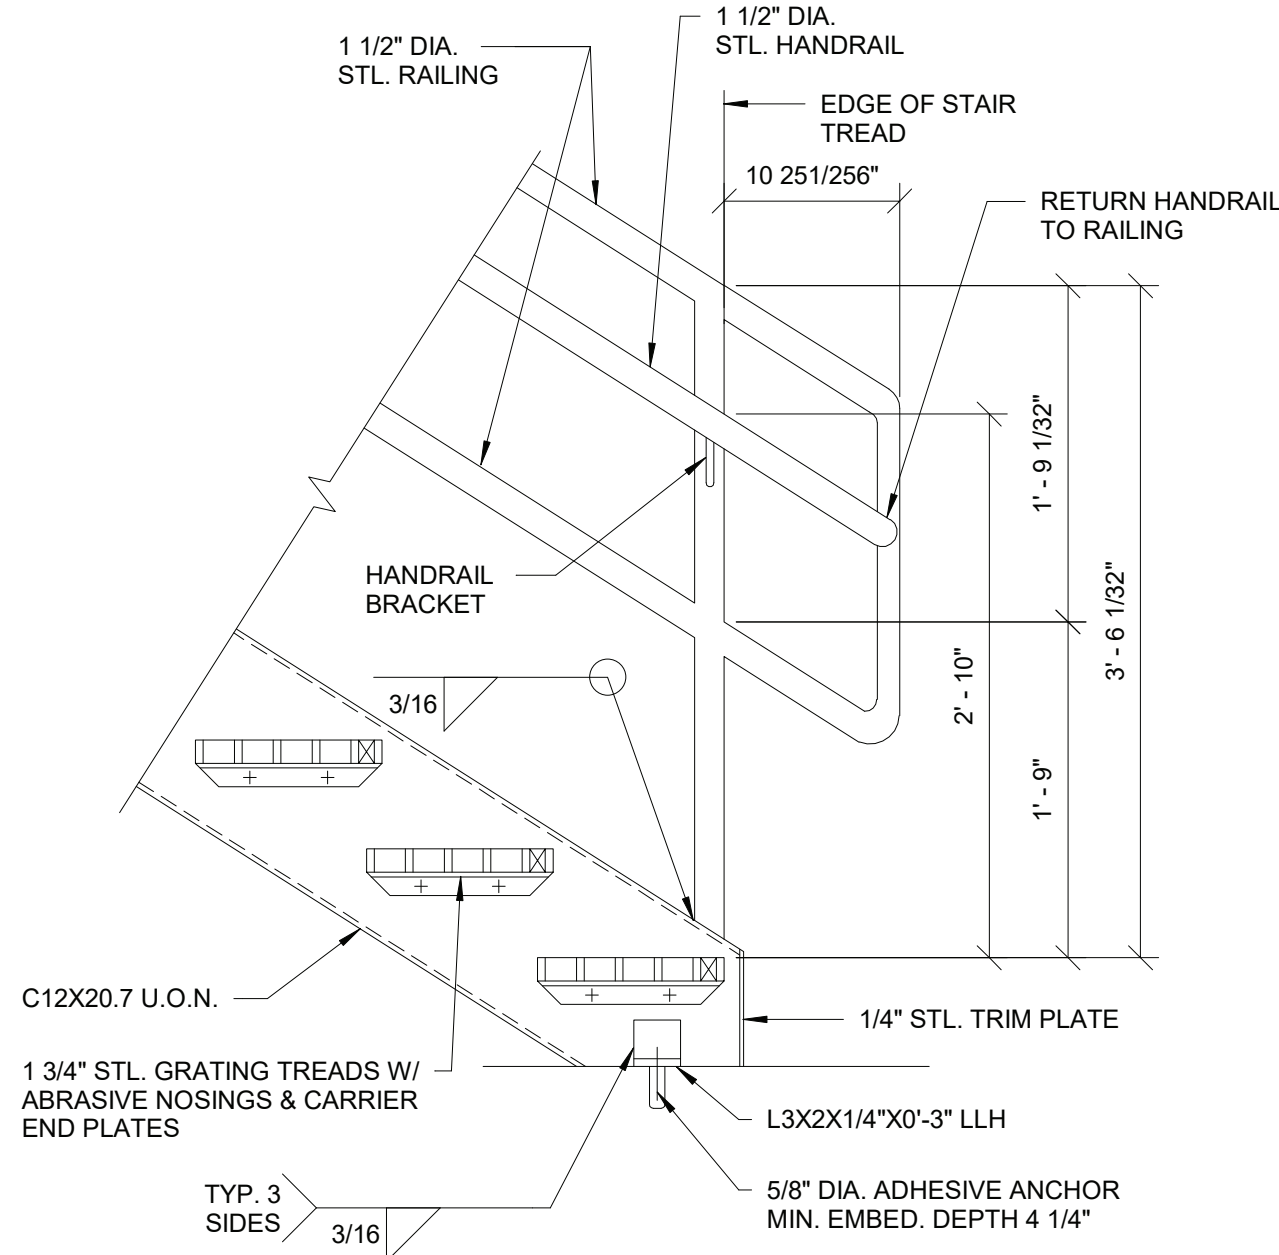

STAIR BASE DETAIL


NOT TO SCALE

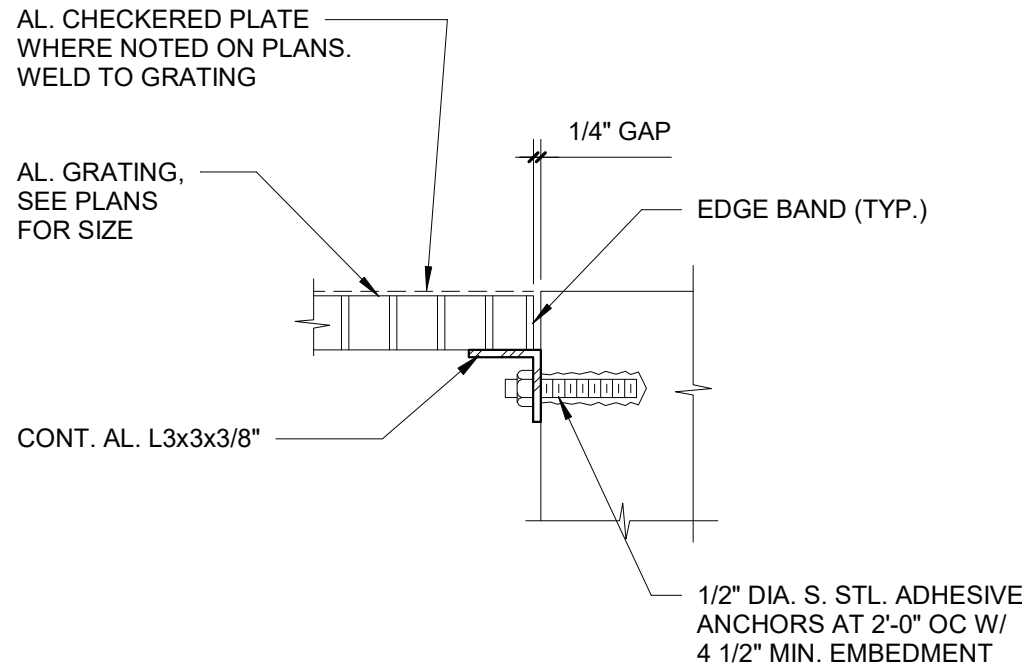

AL. GRATING SUPPORT DETAIL


NOT TO SCALE

- DETAIL NOTES:
- BACK PAINT ALUMINUM SURFACES THAT WILL BE IN CONTACT W/ CONCRETE.
 - WHERE INDICATED ON THE PLANS SECURE GRATING THAT HAS A COVER PLATE TO SUPPORT FRAMING USING SELF-TAPPING S. STL. SCREWS.
 - WHERE INDICATED ON THE PLANS SECURE GRATING THAT DOES NOT HAVE A COVER PLATE TO SUPPORT FRAMING USING S. STL. HAT CLIPS.

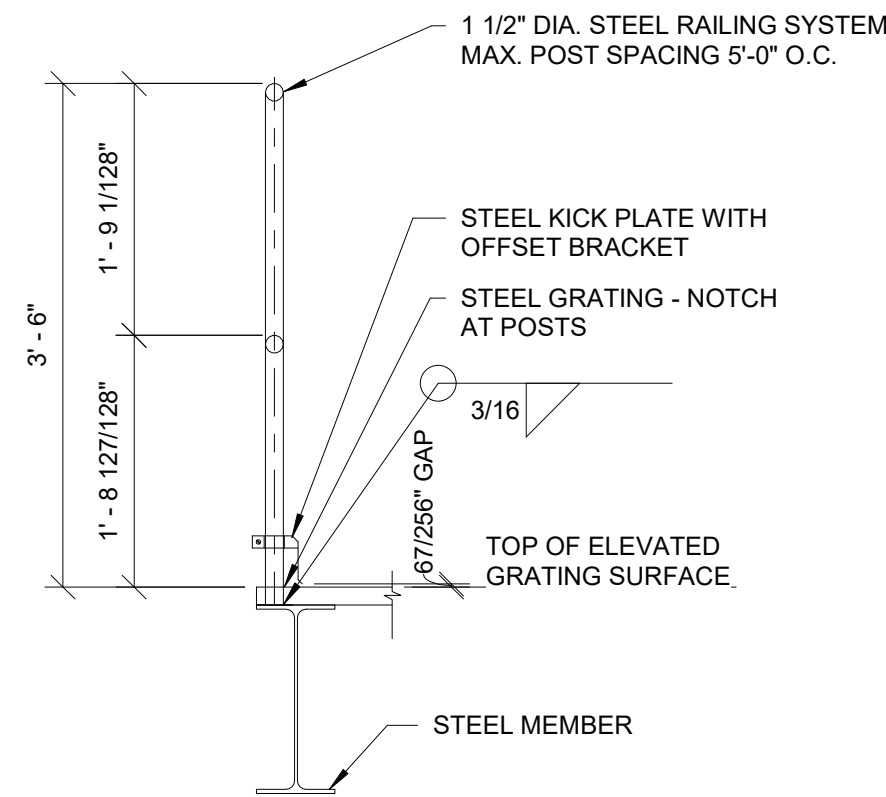

FIXED STEEL RAILING DETAIL


NOT TO SCALE

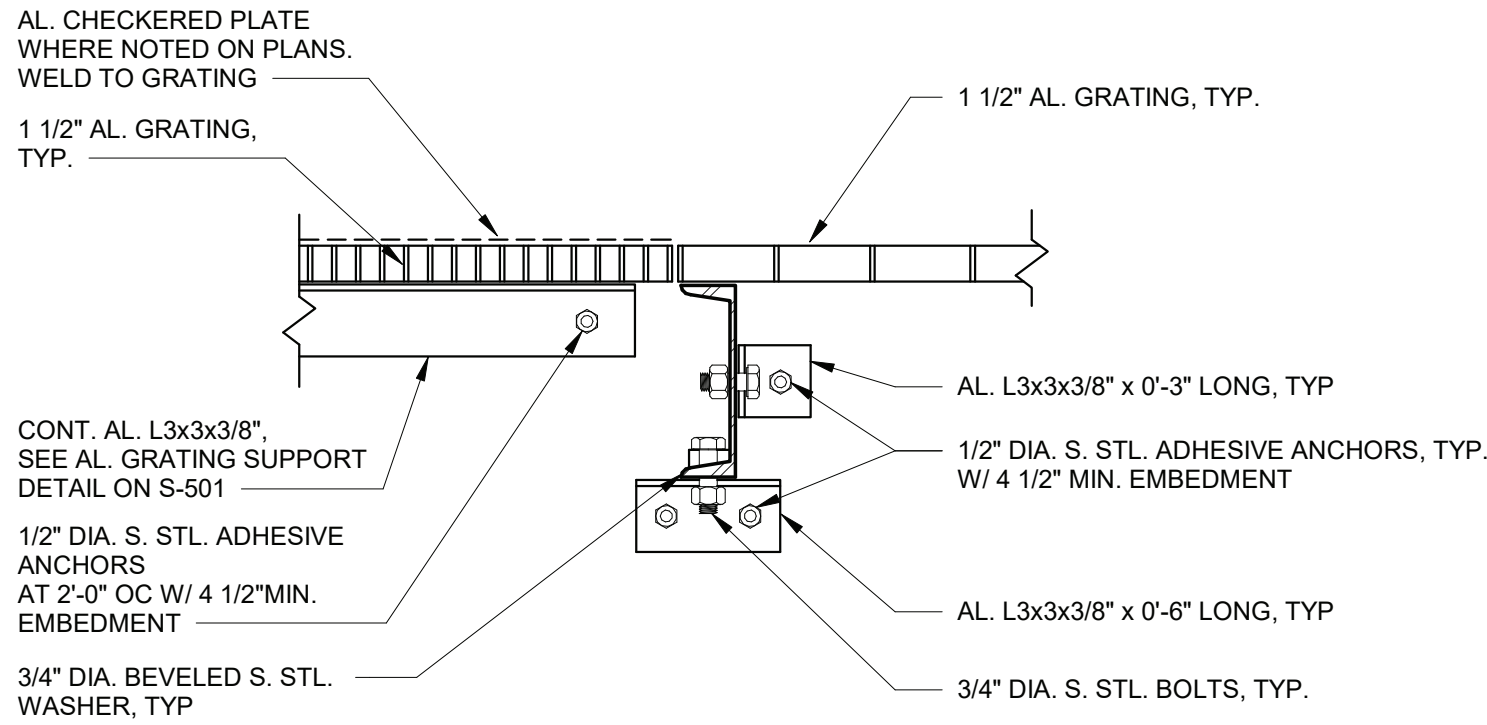

AL. C8 CONNECTION TO CONCRETE DETAIL

1 1/2" = 1'-0"

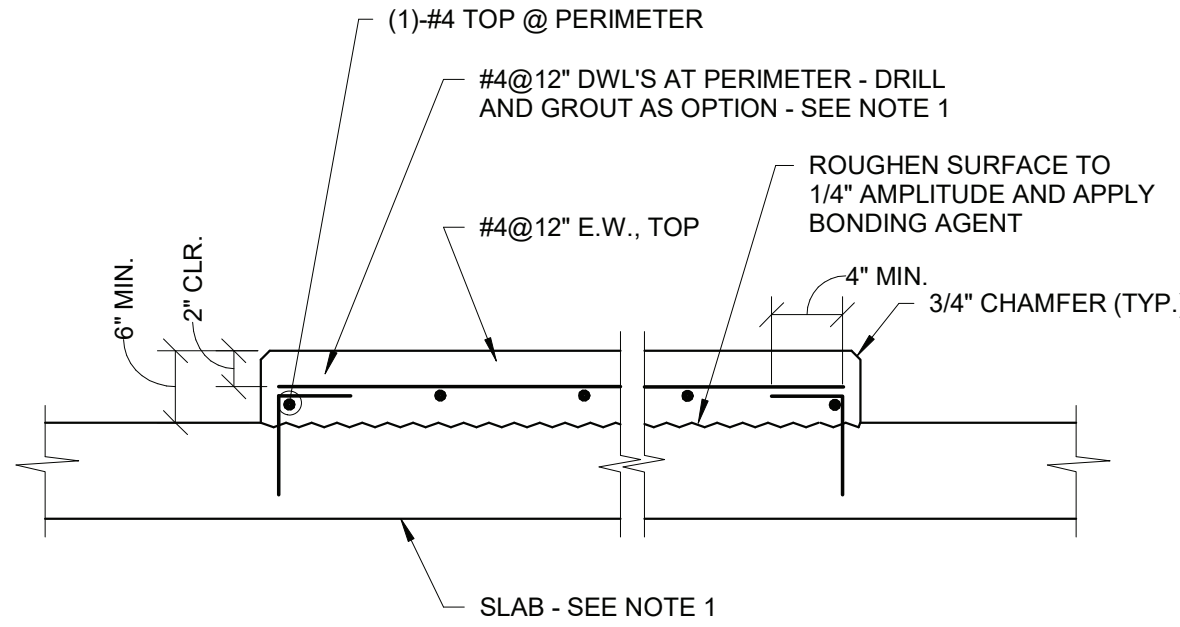

- DETAIL NOTES:
- BACK PAINT ALUMINUM SURFACES THAT WILL BE IN CONTACT W/ CONCRETE.
 - WHERE INDICATED ON THE PLANS SECURE GRATING THAT HAS A COVER PLATE TO SUPPORT FRAMING USING SELF-TAPPING S. STL. SCREWS.
 - WHERE INDICATED ON THE PLANS SECURE GRATING THAT DOES NOT HAVE A COVER PLATE TO SUPPORT FRAMING USING S. STL. HAT CLIPS.



- DETAIL NOTES:
- COORDINATE EQUIPMENT PAD SIZE & ANCHOR LOCATIONS WITH MECHANICAL DRAWINGS & EQUIPMENT MFR.

EQUIPMENT PAD DETAIL ON CONC. SLAB

NOT TO SCALE

	IN ACCORDANCE WITH TITLE VIII, ARTICLE 145, SECTION 7209 (2) OF THE NEW YORK STATE EDUCATION LAW, IT IS A VIOLATION OF LAW FOR ANY PERSON UNLESS ACTING UNDER THE DIRECTION OF A LICENSED ENGINEER TO ALTER THIS DOCUMENT.	 O'BRIEN & GERE ENGINEERS, INC. 50 MAIN ST., 10TH FLOOR SUITE 1000, WHITE PLAINS, NEW YORK 10606																									
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WESTCHESTER COUNTY, NEW YORK DEPARTMENT OF PUBLIC WORKS AND TRANSPORTATION DIVISION OF ENGINEERING		CONTRACT NUMBER 17-529 SHEET NUMBER S-501																									
CROTONVILLE PUMPING STATION REHABILITATION OSSINING SEWER DISTRICT OSSINING, NEW YORK TYPICAL DETAILS		SCALE: DATE: 12/21/18 DPW FILE NO. 208-03-S-39-0 REV. NO. 0																									

ARCHITECTURAL ABBREVIATIONS

"A"		"F"		"N"		"U"	
&	AND	FAC	FACORY	N	NORTH	UNO	UNLESS NOTED OTHERWISE
@	AT	FD	FLOOR DRAIN	N/A	NOT APPLICABLE	UIS	UNDERSIDE
AB	ANCHOR BOLTS	FDN	FOUNDATION	NC	NON COMBUSTIBLE		
ABR	ABRASIVE	FE	FIRE EXTINGUISHER	NF	NEAR FACE	"V"	
ACT	ACOUSTICAL CEILING TILE	FF	FACORY FINISH	NIC	NOT IN CONTRACT	VCT	VINYL COMPOSITION TILE
ADD'L	ADDITIONAL	FFE	FINISH FLOOR ELEVATION	NO. OR #	NUMBER	VERT	VERTICAL
ADJ	ADJUSTABLE	FR	FRAME	NOM	NOMINAL		
AFF	ABOVE FINISHED FLOOR	FFL	FINISHED FLOOR	NS	NEAR SIDE	"W"	
ALT	ALTERNATE	FIXT	FIXTURE	NTS	NOT TO SCALE	W/O	WITHOUT
ALUM	ALUMINUM	FIN	FINISH			W/	WITH
APPD	APPROVED	FLR	FLOOR	"O"		W	WEST
APPROX	APPROXIMATE	FR	FRAME	OC	ON CENTER	WD	WOOD
ARCH	ARCHITECTURAL	FRT	FIRE RETARDANT TREATED	O.F.	OUTSIDE FACE	WF	WATER FOUNTAIN
ASPH	ASPHALT	FT	FEET	OPNG	OPENING	WLD	WELD / WELDED
		FTG	FOOTING	OPF	OPPOSITE	WP	WATER PROOFING
		FV	FIELD VERIFY			WT	WEIGHT
"B"		"G"		"P"			
B OR BOT	BOTTOM	GA	GAGE / GAUGE				
B/ OR BO	BOTTOM OF	GALV	GALVANIZED	PAR	PARALLEL		
BD	BOARD	GB	GRADE BEAM / GRAB BAR	PART.	PARTITION		
BFF	BELOW FINISHED FLOOR	GL	GLASS	PERF	PERFORATED		
BIT	BITUMINOUS	GR	GRADE	PL	PLATE		
BLDG	BUILDING	GRD	GROUND	PLWD	PLYWOOD		
BLK	BLOCK / BLOCKING	GS	GALVANIZED STEEL	PLUMB.	PLUMBING		
BM	BEAM	GVL	GRAVEL	PNL	PANEL		
BOD	BOTTOM OF DUCT	GWB	GYPSUM WALL BOARD	PR	PAIR		
BOL	BOTTOM OF LOUVER			PRE	POWER ROOF EXHAUSTER		
BOP	BOTTOM OF PIPE			PREFAB	PREFABRICATED		
BRG	BEARING			PREFIN	PRE FINISHED		
		"H"		PRMLD	PRE MOLDED		
"C"		HB	HOSE BIBB	P.T.	PRESSURE TREATED		
CJ	CONTROL JOINT	HD	HEAD	P.T.	PAIN / PAINTED		
CANT	CANTILEVER	HGT	HEIGHT	PVC	POLYVINYL CHLORIDE		
CEM	CEMENT	HM	HOLLOW METAL	PVT	PAVEMENT		
CHAN	CHANNEL	HMD	HOLLOW METAL DOOR	PWE	POWER WALL EXHAUSTER		
CHEM	CHEMICAL RESISTANT	HMF	HOLLOW METAL FRAME				
CL	FINISH CENTERLINE	HORIZ	HORIZONTAL				
CLG	CEILING	HP	HIGH POINT				
CLR	CLEAR	HVAC	HEATING, VENTILATING AND				
CMU	CONCRETE MASONRY UNIT		AIR CONDITIONING	"Q"			
COL	COLUMN			QUAL	QUALITY		
COMBO	COMBINATION	"I"		QTY	QUANTITY		
CONC	CONCRETE	I.F.	INSIDE FACE				
CONST	CONSTRUCTION	IND	INCLUDED / INCLUDING	"R"			
CONST JT	CONSTRUCTION JOINT	IND	INDUSTRIAL	RAD	RADIUS		
CONT	CONTINUOUS	INFO	INFORMATION	RB	ROOF BEAM		
CONT'D	CONTINUED	INSUL	INSULATION / INSULATED	RD	ROOF DRAIN		
CONTR	CONTRACT / CONTRACTOR	INT	INTERIOR	RECT	RECTANGLE / RECTANGULAR		
COORD	COORDINATE	INV	INVERT	REF	REFERENCE		
CORR	CORRIDOR			REIN	REINFORCE		
CORRUG	CORRUGATED			REQ'D	REQUIRED		
CSK	COUNTERSINK			REV	REVISION / REVISED		
CSKSCR	COUNTERSUNK SCREW			RFG	ROOFING		
CTR	CENTER			RM	ROOM		
				RO	ROUGH OPENING		
"D"		"J"		"S"			
DEG	DEGREE	JST	JOIST	S	SOUTH		
DET	DETAIL	JT	JOINT	S/C	SITE/CIVIL		
DEMO	DEMOLISH / DEMOLITION			SCH	SCHEDULE		
DIA	DIAMETER	KD	KNOCK DOWN	SEC	SECOND		
DIA	DIAGONAL / DIAGRAM	KFS	KIPS PER SQUARE FOOT	SECT	SECTION		
DIM	DIMENSION	KFT	KIP FOOT	SF	SQUARE FOOT		
DIV	DIVISION	KP	KICK PLATE	SIM	SIMILAR		
DL	DEAD LOAD			SHT	SHEET		
DN	DOWN			SIM REV	SIMILAR REVERSED		
DR	DOOR			SJ	STEEL JOIST		
DWG	DRAWING			SPEC	SPECIFICATION		
DWL	DOWEL			SQ	SQUARE		
		"L"		SS	STAINLESS STEEL		
"E"		L	ANGLE	STA	STATION		
EJ	EXPANSION JOINT	LAM	LAMINATE	STD	STANDARD		
EA	EACH	LB	POUND	STIFF	STIFFENER		
EF	EACH FACE	LBS	POUNDS	STL	STEEL		
ELEV	ELEVATION	LF	LINEAR FEET	STOR	STORAGE		
ELEC	ELECTRIC / ELECTRICAL	LG	LENGTH / LONG	STRUCT	STRUCTURE / STRUCTURAL		
ENGR	ENGINEER	LLH	LONG LEG HORIZONTAL	SUSP	SUSPEND / SUSPENDED		
EQ	EQUAL	LLV	LONG LEG VERTICAL	SYM	SYMMETRICAL / SYMMETRICALLY		
EQUIP	EQUIPMENT	LP	LOW POINT				
EQUIV	EQUIVALENT	LV	LOUVER				
EXP	EXPOSED	"M"					
EW	EACH WAY	MAN.	MANUAL				
EXC	EXCAVATION	MATL	MATERIAL	"T"			
EXH	EXHAUST	MAX	MAXIMUM	T	TOP		
EXST	EXISTING	MCP	METAL CLAD PANEL	T/ OR T.O.	TOP OF		
EXT	EXTERIOR	MD	METAL DECK	TBD	TO BE DETERMINED		
		MECH	MECHANICAL	TEMP	TEMPERATURE		
		MFG	MANUFACTURING	TH	THICK		
		MFR	MANUFACTURER	THRD	THREAD / THREADED		
		MIN	MINIMUM	TOB	TOP OF BLOCK		
		MISC	MISCELLANEOUS	TOD	TOP OF DUCT		
		MOD	MODIFICATION	TOF	TOP OF FOOTING		
		MP	METAL PANEL	TOL	TOP OF LOUVER		
		MS	METAL STUD	TOS	TOP OF SLAB / TOP OF STEEL		
		MTD	MOUNTED	TOT	TOTAL		
		MTL	METAL	TOW	TOP OF WALL		
				TYP	TYPICAL		

ARCHITECTURAL GRAPHIC CONVENTIONS

	BACKFILL
	BATT INSULATION
	BRICK
	CELL VENT/WEEP VENT
	CONCRETE, CAST STONE, AND/OR PRECAST CONCRETE
	CONC. MASONRY UNIT (CMU)
	GRAVEL
	GROUT OR MORTAR
	GYPSUM WALL BOARD
	MORTAR NET
	PLYWOOD
	RIGID BOARD INSULATION
	SHIM
	STEEL
	WOOD BLOCKING

ARCHITECTURAL SYMBOLS

	PLAN NORTH
	NEW DOOR SYMBOL
	EXTERIOR WINDOW TYPE DESIGNATION
	ROOM NAME AND ROOM NUMBER DESIGNATION
	SLOPE
	DATUM
	LOUVER DESIGNATION
	INTERIOR ROOM AND WALL ELEVATIONS WITH LOCATION SHEET DESIGNATOR
	FIRE EXTINGUISHER
	DETAIL INDICATOR
	STRUCTURAL COLUMN GRID LINES AND INDICATOR

METHOD OF SECTIONING


THE DRAWING UPON WHICH A SECTION, VIEW OR DETAIL HAS BEEN TAKEN AND THE DRAWING UPON WHICH THE SECTION, VIEW OR DETAIL HAS BEEN SHOWN IS CROSS-REFERENCED WITH SYMBOLS AS FOLLOWS:

DRAWING WHERE SECTION IS TAKEN



THE NUMBER IN THE UPPER HALF OF THE CIRCLE IS THE SECTION NUMBER. THE BOTTOM NUMBER REFERS TO THE DRAWING NUMBER ON WHICH THE SECTION CAN BE FOUND.

DRAWING WHERE SECTION IS SHOWN

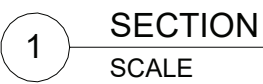

SECTION

SCALE

THIS IS SHOWN UNDER EACH SECTION. THE NUMBER IS THE SECTION NUMBER ON THE SHEET.

SCALE BAR LOCATION



07/09/21

IN ACCORDANCE WITH TITLE VIII, ARTICLE 145, SECTION 7209 (2) OF THE NEW YORK STATE EDUCATION LAW, IT IS A VIOLATION OF LAW FOR ANY PERSON UNLESS ACTING UNDER THE DIRECTION OF A LICENSED ENGINEER TO ALTER THIS DOCUMENT.

IN CHARGE OF LWW

CHECKED BY WEC

MADE BY LER



O'BRIEN & GERE ENGINEERS, INC.
50 MAIN ST., 10TH FLOOR SUITE 1000,
WHITE PLAINS, NEW YORK 10606

REVISION NUMBER DATE MADE BY APP'D BY REVISION

RECORD DRAWING CERTIFICATION


☐ AS BUILT - CHANGES AS NOTED
☐ AS BUILT - NO CHANGES

CONTRACTOR			PROJECT COORDINATOR		
NAME _____			NAME _____		
SIGNATURE _____			SIGNATURE _____		
TITLE _____		DATE _____	TITLE _____		DATE _____
WESTCHESTER COUNTY, NEW YORK DEPARTMENT OF PUBLIC WORKS AND TRANSPORTATION DIVISION OF ENGINEERING			CONTRACT NUMBER 17-529	SHEET NUMBER A-001	
			SHEET NO. 16 OF 60		
			SCALE: AS NOTED DATE: 12/21/18		
CROTONVILLE PUMPING STATION REHABILITATION			DPW FILE NO. 208-03-A-40-0		
OSSINING, NEW YORK ABBREVIATIONS AND SYMBOLS			REV. NO. 0		


ARCHITECTURAL BUILDING CODE ANALYSIS:		
APPLICABLE BUILDING CODE: NEW YORK STATE UNIFORM FIRE PREVENTION AND BUILDING CODE (UNIFORM CODE) WITH 2017 UNIFORM CODE SUPPLEMENT		
CODE REFERENCE	REQUIREMENT	PROVIDED
CLASSIFICATION OF WORK / NYSEBC-CHAPTER 5	ALTERATION - LEVEL 2	ALTERATION - LEVEL 2
NYSEBC CHAPTER 7 - ALTERATIONS - LEVEL 1 LEVEL 1 ALTERATIONS INCLUDE THE REMOVAL AND REPLACEMENT OR THE COVERING OF EXISTING MATERIALS, ELEMENTS, EQUIPMENT, OR FIXTURES USING NEW MATERIALS, ELEMENTS, OR FIXTURES THAT SERVE THE SAME PURPOSE.		
FIRE PROTECTION GENERAL NYSEBC-703.1	ALTERATIONS SHALL BE DONE IN A MANNER THAT MAINTAINS THE LEVEL OF FIRE PROTECTION PROVIDED	IN COMPLIANCE
MEANS OF EGRESS GENERAL NYSEBC-704.1	ALTERATIONS SHALL BE DONE IN A MANNER THAT MAINTAINS THE LEVEL OF PROTECTION PROVIDED FOR THE MEANS OF EGRESS	IN COMPLIANCE
NYSEBC-CHAPTER 8 - ALTERATIONS - LEVEL 2 LEVEL 2 ALTERATIONS INCLUDE THE RECONFIGURATION OF SPACE, THE ADDITION OR ELIMINATION OF ANY DOOR OR WINDOW, THE RECONFIGURATION OR EXTENSION OF ANY SYSTEM, OR THE INSTALLATION OF ANY ADDITIONAL EQUIPMENT.	SHALL COMPLY WITH THE PROVISIONS OF CHAPTERS 7 FOR LEVEL 1 ALTERATIONS AS WELL AS THE PROVISIONS OF CHAPTER 8.	IN COMPLIANCE
FIRE PROTECTION SCOPE NYSEBC-804.1	THE REQUIREMENTS OF THIS SECTION SHALL BE LIMITED TO WORK AREAS IN WHICH LEVEL 2 ALTERATIONS ARE BEING PERFORMED, AND WHERE SPECIFIED THEY SHALL APPLY THROUGHOUT THE FLOOR ON WHICH THE WORK AREAS ARE LOCATED OR OTHERWISE BEYOND THE WORK AREA.	IN COMPLIANCE
MEANS OF EGRESS SCOPE NYSEBC-805.1	THE REQUIREMENTS OF THIS SECTION SHALL BE LIMITED TO WORK AREAS THAT INCLUDE EXITS OR CORRIDORS SHARED BY MORE THAN ONE TENANT WITHIN THE <i>WORK AREA</i> IN WHICH LEVEL 2 <i>ALTERATIONS</i> ARE BEING PERFORMED, AND WHERE SPECIFIED THEY SHALL APPLY THROUGHOUT THE FLOOR ON WHICH THE <i>WORK AREAS</i> ARE LOCATED OR OTHERWISE BEYOND THE <i>WORK AREA</i> .	IN COMPLIANCE
GENERAL NYSEBC-805.2	THE MEANS OF EGRESS SHALL COMPLY WITH THE REQUIREMENTS OF THIS SECTION.	IN COMPLIANCE

APPLICABLE ENERGY CODE: 2015 INTERNATIONAL ENERGY CONSERVATION CODE (IECC)		
CODE REFERENCE	REQUIREMENT	PROVIDED
CLIMATE ZONES, DESIGN CONDITIONS, MATERIALS, EQUIPMENT AND SYSTEMS/ NYSECC-CHAPTER 3		
CLIMATE ZONES BY COUNTY, ALL ZONES ARE CATEGORY "A" OR MOIST DESIGNATIONS NYSECC-TABLE C301.1	CLIMATE ZONE 4A WESTCHESTER COUNTY	CLIMATE ZONE 4A WESTCHESTER COUNTY
COMMERCIAL ENERGY EFFICIENCY/ NYSECC-CHAPTER 4		
BUILDING ENVELOPE REQUIREMENTS-OPAQUE ASSEMBLIES NYSECC-TABLE 402.1.3	ROOFS INSULATION ENTIRELY ABOVE ROOF DECK = R-30ci WALLS, ABOVE GRADE MASS = R-9.5ci WALLS, BELOW GRADE MASS = EXISTING CONDITIONS SLAB-ON GRADE FLOORS UNHEATED SLABS=EXISTING CONDITIONS	ROOFS INSULATION ENTIRELY ABOVE ROOF DECK = R-30ci WALLS, ABOVE GRADE MASS = R-9.5ci WALLS, BELOW GRADE MASS = EXISTING CONDITIONS SLAB-ON GRADE FLOORS UNHEATED SLABS=EXISTING CONDITIONS


NOTE: TO THE BEST OF THE LICENSED PROFESSIONAL'S KNOWLEDGE, BELIEF AND PROFESSIONAL JUDGEMENT, SUCH PLANS AND SPECIFICATIONS ARE IN COMPLIANCE WITH THIS CODE

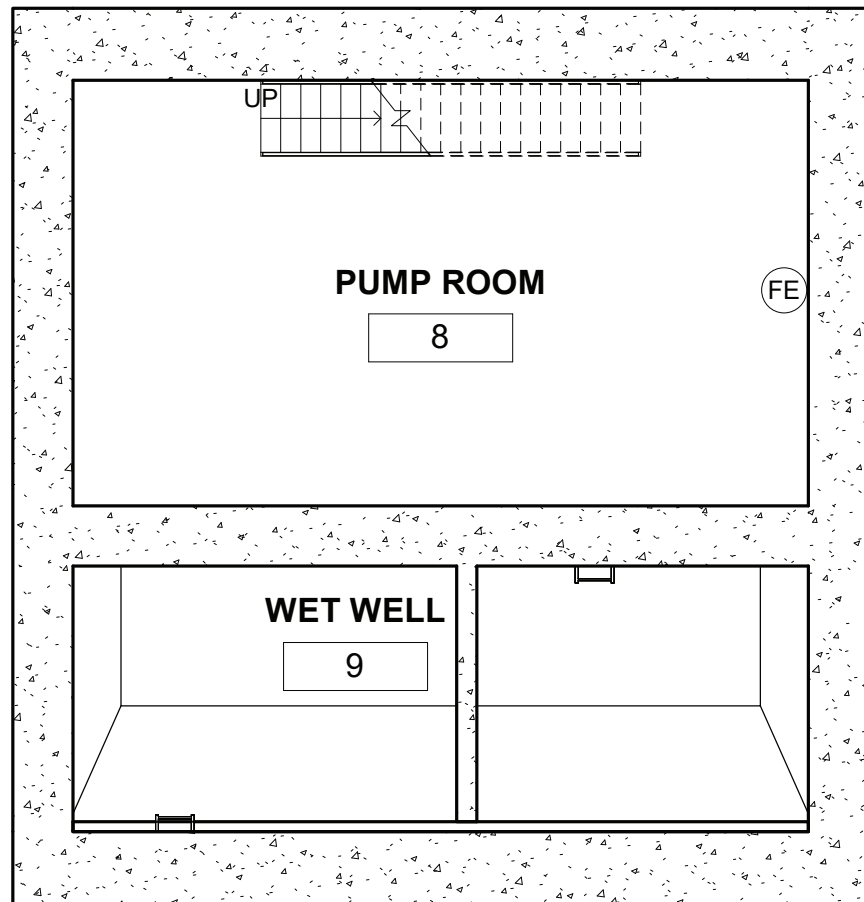

1
LIFE SAFETY PLAN
LOWER LEVEL
1/8" = 1'-0"
8' 4' 0 8'
PLAN NORTH

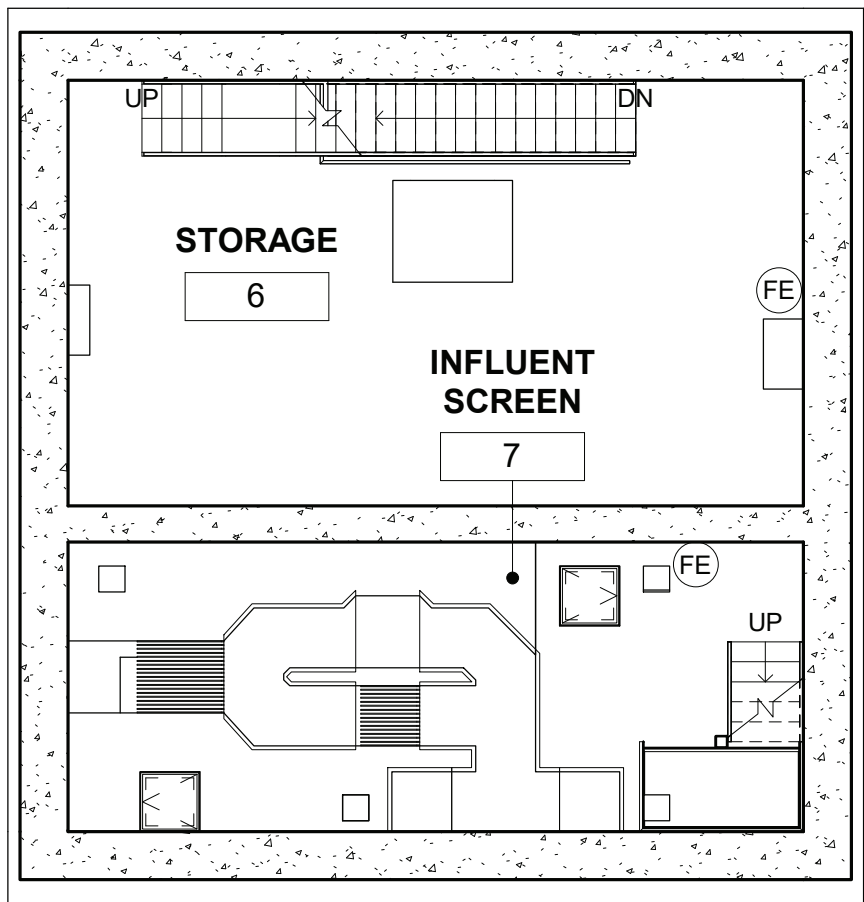

2
LIFE SAFETY PLAN
MID LEVEL
1/8" = 1'-0"
8' 4' 0 8'
PLAN NORTH

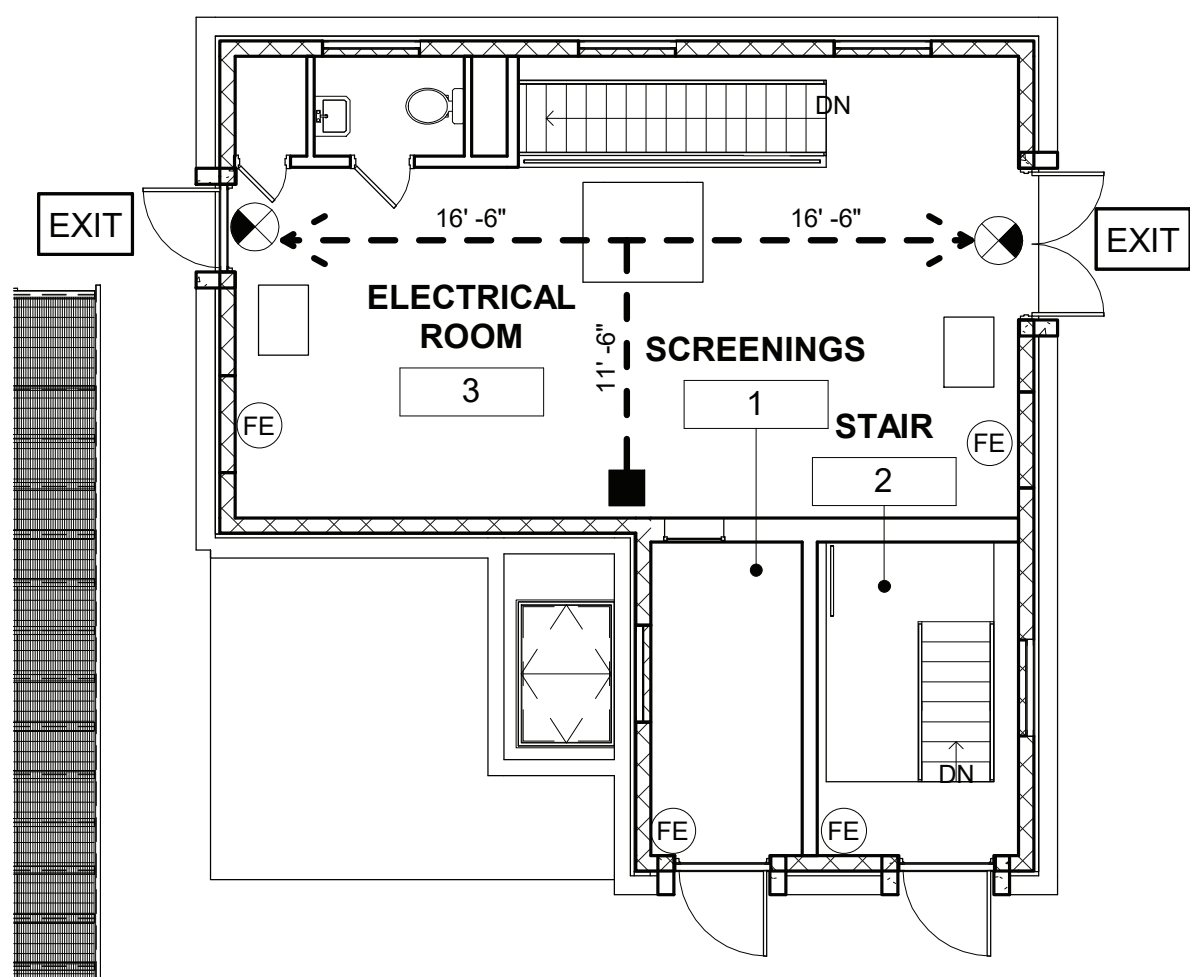

3
LIFE SAFETY PLAN
MAIN FLOOR
1/8" = 1'-0"
8' 4' 0 8'
PLAN NORTH

ARCHITECTURAL BUILDING CODE ANALYSIS:		
APPLICABLE BUILDING CODE: NEW YORK STATE UNIFORM FIRE PREVENTION AND BUILDING CODE (UNIFORM CODE) WITH 2017 UNIFORM CODE SUPPLEMENT		
CODE REFERENCE	REQUIREMENT	PROVIDED
USE AND OCCUPANCY CLASSIFICATION/ NYSBC CHAPTER 3		
OCCUPANCY CLASSIFICATION SECTION-302		MODERATE-HAZARD FACTORY INDUSTRIAL, GROUP F-1
GENERAL BUILDING HEIGHTS AND AREAS NYSBC-CHAPTER 5		
ALLOWABLE HEIGHT AND BUILDING AREA - NYSBC-TABLES 504.3, 504.4, 506.2	F-1 = 62,000 SF ALLOWABLE FLOOR AREA (3) STORIES/ 75'-0" MAX HEIGHT	F-1 = 940 SF (1) STORY @ 15'-4"
TYPES OF CONSTRUCTION / NYSBC-CHAPTER 6		
TYPE OF CONSTRUCTION NYSBC-TABLE 601	TYPE 2B - NONCOMBUSTIBLE	TYPE 2B - NONCOMBUSTIBLE
STRUCTURAL FRAME INCLUDING COLUMNS, GIRDERS, TRUSSES	FIRE RESISTANCE	FIRE RESISTANCE
BEARING WALLS	(0) HOURS	(0) HOURS
INTERIOR	(0) HOURS	(0) HOURS
EXTERIOR	(0) HOURS	(0) HOURS
NONBEARING WALLS AND PARTITIONS	(0) HOURS	(0) HOURS
EXTERIOR	(0) HOURS	(0) HOURS
INTERIOR	(0) HOURS	(0) HOURS
FLOOR CONSTRUCTION	(0) HOURS	(0) HOURS
ROOF CONSTRUCTION	(0) HOURS	(0) HOURS
MEANS OF EGRESS / NYSBC-CHAPTER 10		
OCCUPANT LOAD NYSBC-TABLE 1004.1.2	F-1 OCCUPANCY	
BUSINESS AND INDUSTRIAL AREA @ 100 SF PER PERSON	940 SF/ 100 SF PER PERSON = 10 OCC	
EGRESS WIDTH PER OCCUPANT SERVED NYSBC-TABLE 1005.1	10 X .2" = 2" MIN REQ'D (1) 36" EXIT REQUIRED	IN COMPLIANCE (1) 44" EXIT PROVIDED (1) 68" EXIT PROVIDED
EXIT ACCESS TRAVEL DISTANCE NYSBC-TABLE 1017.2	F-1 WITHOUT SPRINKLER = 200 FT	F-1 = 28 FT
ACCESSIBILITY / NYSBC-CHAPTER 11		
EMPLOYEE WORK AREAS NYSBC - 1103.2.2	NOT REQUIRED	NOT REQUIRED
EQUIPMENT SPACES NYSBC - 1103.2.9		
SPACES FREQUENTED ONLY BY PERSONNEL FOR MAINTENANCE, REPAIR OR MONITORING OF EQUIPMENT ARE NOT REQUIRED TO BE ACCESSIBLE. SUCH SPACES INCLUDE, BUT NOT LIMITED TO, ELEVATOR PITS, ELEVATOR PENTHOUSES, MECHANICAL, ELECTRICAL OR COMMUNICATIONS EQUIPMENT ROOMS, PIPING OR EQUIPMENT CATWALKS, WATER OR SEWAGE TREATMENT PUMP ROOMS AND STATIONS, ELECTRIC SUBSTATIONS AND TRANSFORMER VAULTS, AND HIGHWAY AND TUNNEL FACILITIES.		

CODE REFERENCE	REQUIREMENT	PROVIDED
CLIMATE ZONES, DESIGN CONDITIONS, MATERIALS, EQUIPMENT AND SYSTEMS/ NYSECC-CHAPTER 3		
CLIMATE ZONES BY COUNTY, ALL ZONES ARE CATEGORY "A" OR MOIST DESIGNATIONS NYSECC-TABLE C301.1	CLIMATE ZONE 4A WESTCHESTER COUNTY	CLIMATE ZONE 4A WESTCHESTER COUNTY
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LIFE SAFETY SYMBOL LEGEND

- PATH OF EXIT TRAVEL CUMULATIVE (DIMENSIONS SHOWN INDICATES LENGTH OF TRAVEL DISTANCE FROM STARTING POINT INDICATED TO THE EXIT DISCHARGE)
- STARTING POINT FOR TRAVEL DISTANCE
- DIRECTION OF TRAVEL FOR APPROACH
- EXIT EXTERIOR DOOR AS EXIT DISCHARGE
- EXIT SIGN
- FE BRACKET MOUNTED FIRE EXTINGUISHER LOCATIONS SEE GENERAL NOTES

FIRE CLASSIFICATIONS

CLASS A FIRES: FIRES IN ORDINARY COMBUSTIBLE MATERIALS, SUCH AS WOOD, CLOTH, PAPER AND MANY PLASTICS.

CLASS B FIRES: FIRES IN FLAMMABLE LIQUIDS, COMBUSTIBLE LIQUIDS, PETROLEUM GREASES, TARS, OILS, OIL-BASED PAINTS, SOLVENTS, LACQUERS, ALCOHOLS, AND FLAMMABLE GASES.

CLASS C FIRES: FIRES THAT INVOLVE ENERGIZED ELECTRICAL EQUIPMENT WHERE THE ELECTRICAL NONCONDUCTIVITY OF THE EXTINGUISHING MEDIA IS OF IMPORTANCE. (WHEN ELECTRICAL EQUIPMENT IS DE-ENERGIZED, FIRE EXTINGUISHERS FOR CLASS A OR B FIRES CAN BE USED SAFELY.


CLASS D FIRES: FIRES IN COMBUSTIBLE METALS, SUCH AS MAGNESIUM, TITANIUM, ZIRCONIUM, SODIUM, LITHIUM, AND POTASSIUM.

CLASS K FIRES: FIRES IN COOKING APPLIANCES THAT INVOLVE COMBUSTIBLE COOKING MEDIA (VEGETABLE OR ANIMAL OILS AND FATS). NOT APPLICABLE FOR THIS FACILITY.

RECOMMENDED MARKING SYSTEM

- ORDINARY
COMBUSTIBLES
EXTINGUISHERS SUITABLE FOR CLASS A FIRES SHOULD BE IDENTIFIED BY A TRIANGLE CONTAINING THE LETTER "A". IF COLORED, THE TRIANGLE IS COLORED GREEN.
- FLAMMABLE
LIQUIDS
EXTINGUISHERS SUITABLE FOR CLASS B FIRES SHOULD BE IDENTIFIED BY A SQUARE CONTAINING THE LETTER "B". IF COLORED, THE SQUARE IS COLORED RED.
- ELECTRICAL
EQUIPMENT
EXTINGUISHERS SUITABLE FOR CLASS C FIRES SHOULD BE IDENTIFIED BY A CIRCLE CONTAINING THE LETTER "C". IF COLORED, THE CIRCLE IS COLORED BLUE.
- COMBUSTIBLE
METALS
EXTINGUISHERS SUITABLE FOR FOR FIRES INVOLVING METALS SHOULD BE IDENTIFIED BY A FIVE POINTED STAR CONTAINING THE LETTER "D". IF COLORED, THE STAR IS COLORED YELLOW.


	IN ACCORDANCE WITH TITLE VIII, ARTICLE 145, SECTION 7209 (2) OF THE NEW YORK STATE EDUCATION LAW, IT IS A VIOLATION OF LAW FOR ANY PERSON UNLESS ACTING UNDER THE DIRECTION OF A LICENSED ENGINEER TO ALTER THIS DOCUMENT.	
07/09/21	IN CHARGE OF <u>LWW</u> CHECKED BY <u>WEC</u> MADE BY <u>LER</u>	O'BRIEN & GERE ENGINEERS, INC. 50 MAIN ST., 10TH FLOOR SUITE 1000, WHITE PLAINS, NEW YORK 10606
REVISION NUMBER	DATE	MADE BY
APP'D BY	REVISION	
RECORD DRAWING CERTIFICATION		
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CONTRACTOR		PROJECT COORDINATOR
NAME	SIGNATURE	NAME
TITLE	DATE	TITLE
WESTCHESTER COUNTY, NEW YORK DEPARTMENT OF PUBLIC WORKS AND TRANSPORTATION DIVISION OF ENGINEERING		CONTRACT NUMBER 17-529 SHEET NUMBER A-002
CROTONVILLE PUMPING STATION REHABILITATION		SCALE: AS NOTED DATE: 12/21/18 DPW FILE NO. 208-03-A-41-0
OSSINING, NEW YORK CODE ANALYSIS		REV. NO. 0

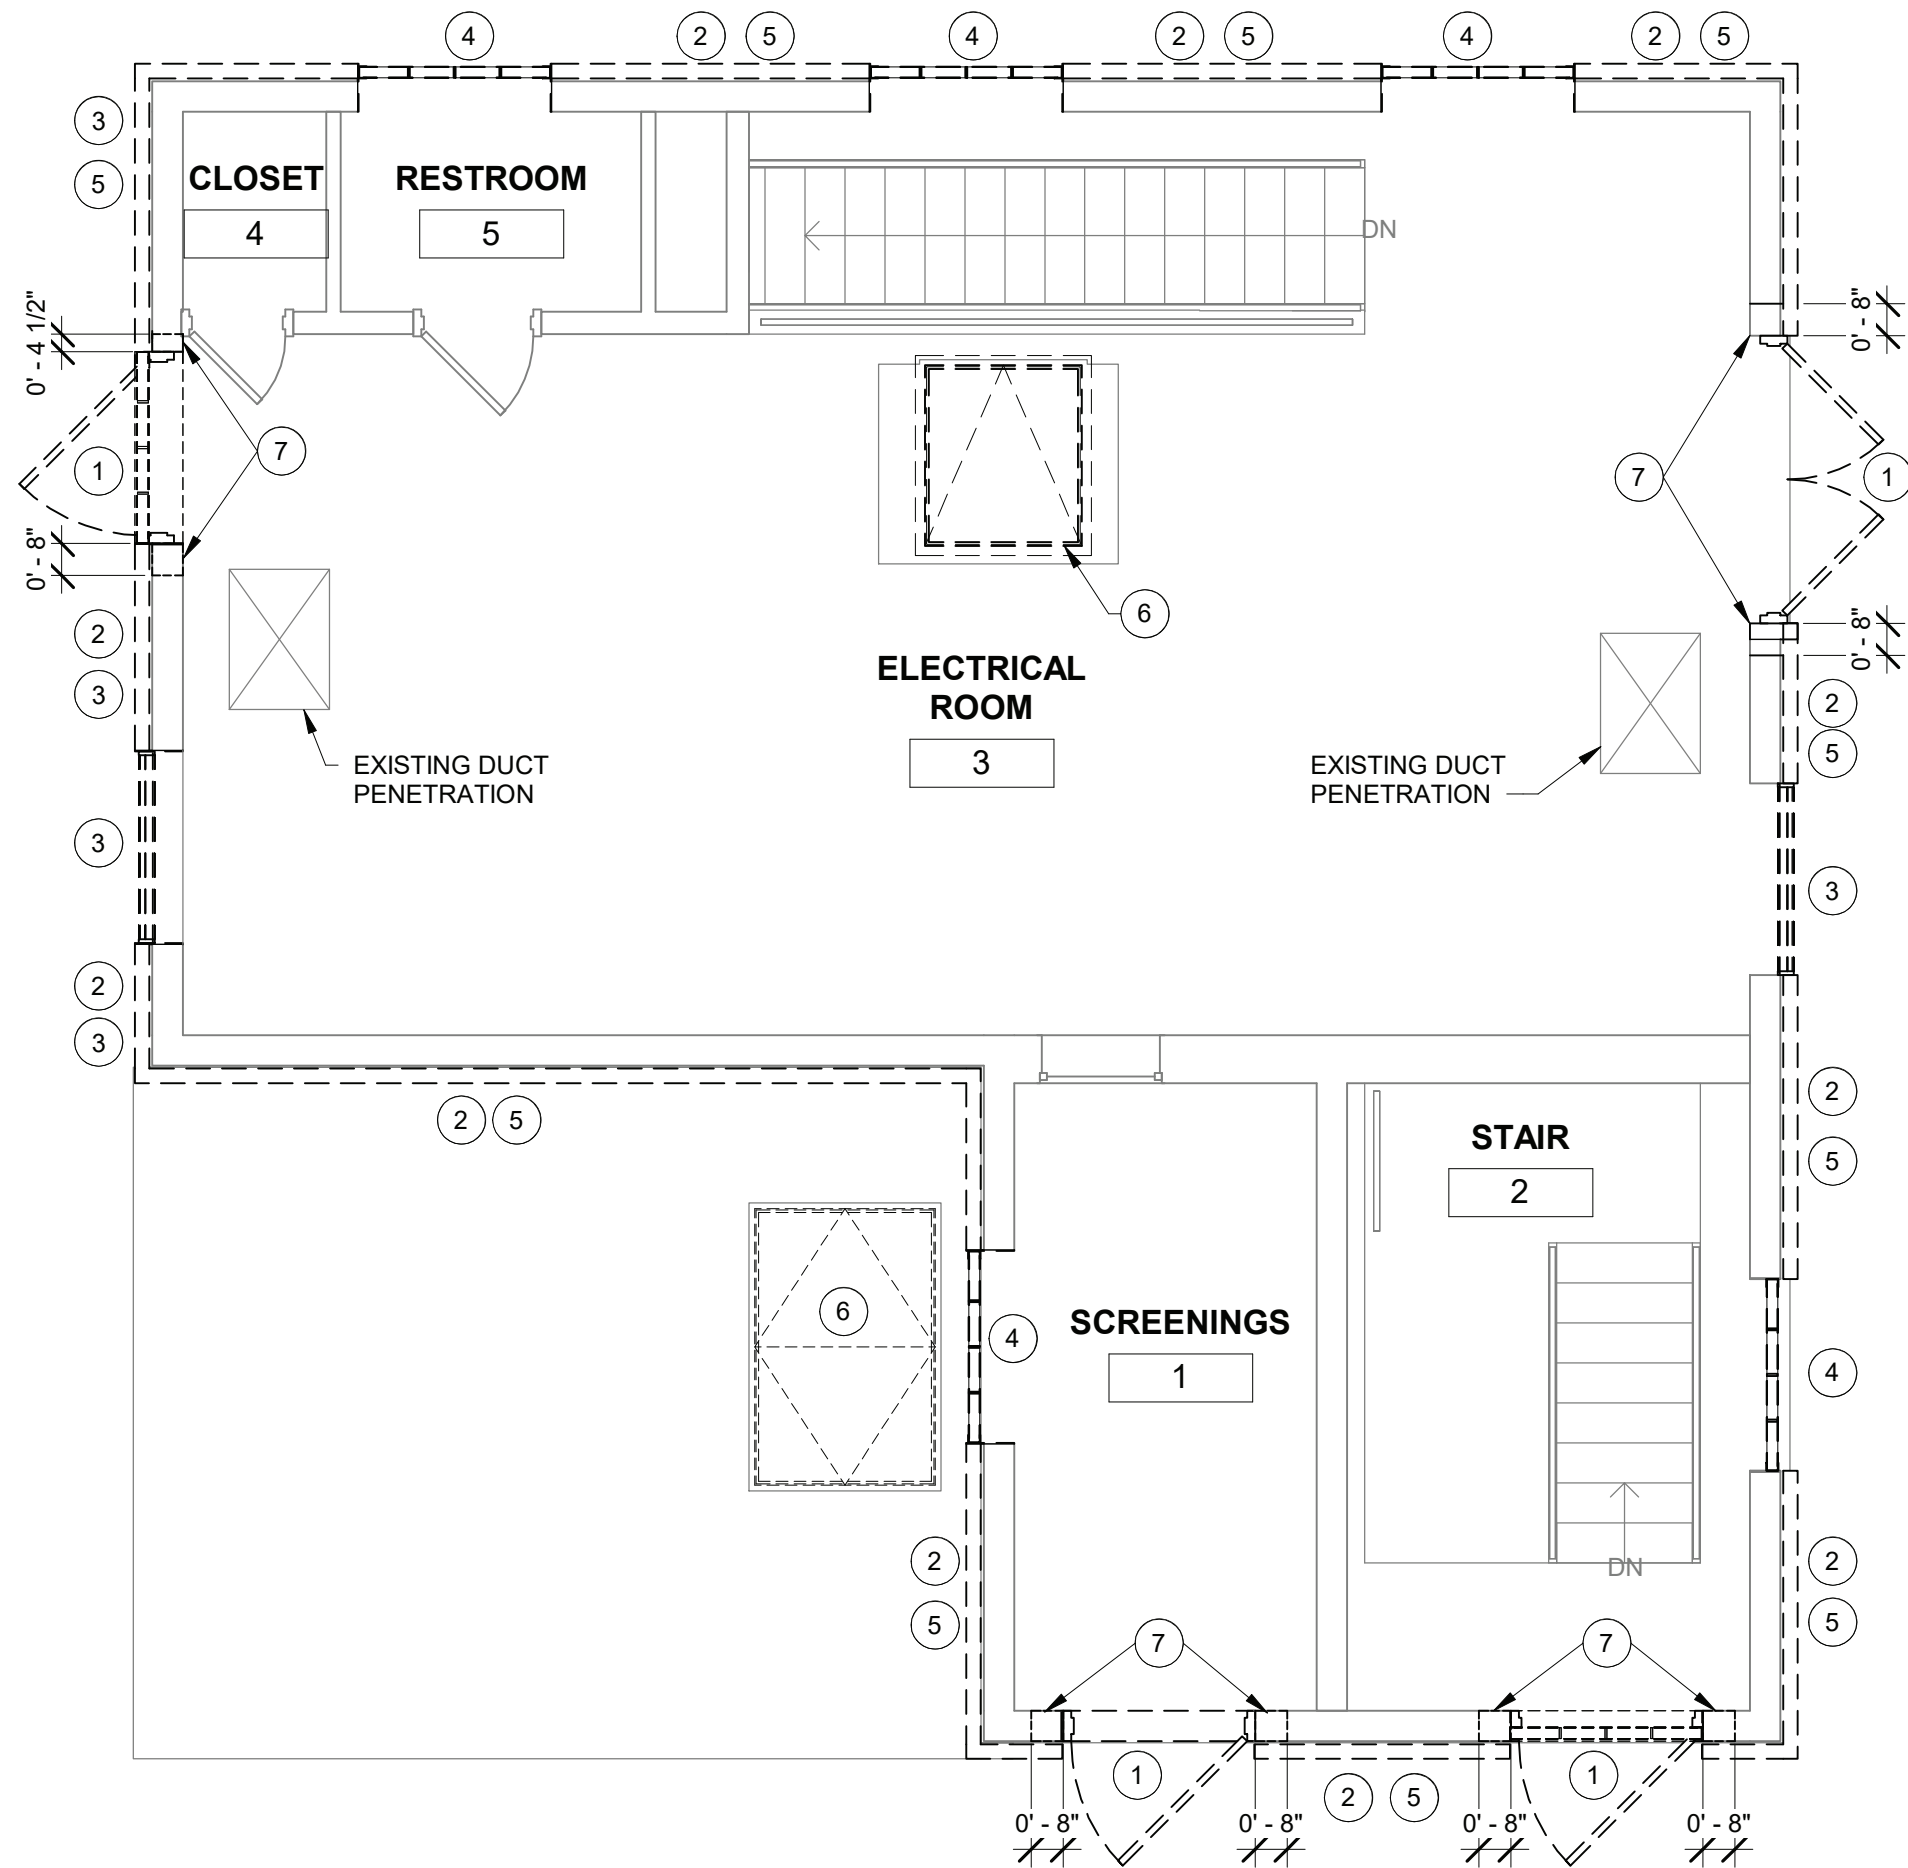

1 MAIN FLOOR - DEMOLITION
1/4" = 1'-0"

DEMOLITION KEYED NOTES

- 1 REMOVE EXISTING HOLLOW METAL DOORS AND FRAMES AND PREP OPENING FOR INSTALLATION OF FLOOD PROOF DOORS AND FRAMES.
- 2 PREP EXISTING WALL SURFACE FOR INSTALLATION OF THIN BRICK VENEER AND CONCRETE FLOOD WALL.
- 3 REMOVE EXISTING LOUVER AND PREPARE MASONRY OPENING TO BE INFILLED.
- 4 REMOVE EXISTING TRANSLUCENT PANEL COMPLETELY. PREP OPENING TO RECEIVE NEW TRANSLUCENT PANEL.
- 5 REMOVE EXISTING BRICK VENEER IN IT'S ENTIRETY FROM TOP OF FOUNDATION TO 12'-0" ABOVE MAIN FLOOR LEVEL.
- 6 REMOVE EXISTING HATCH DOORS.
- 7 REMOVE EXISTING 8" CMU EACH SIDE OF DOOR UP TO 4'-8" AFF DIMENSIONS INDICATED. CMU FROM 4'-8" AFF TO HEIGHT OF DOOR TO REMAIN. PROVIDE STRUCTURAL SHORING AS NECESSARY TO SUPPORT WALL ABOVE PRIOR TO REMOVING 8" CMU AT EACH SIDE OF DOOR.

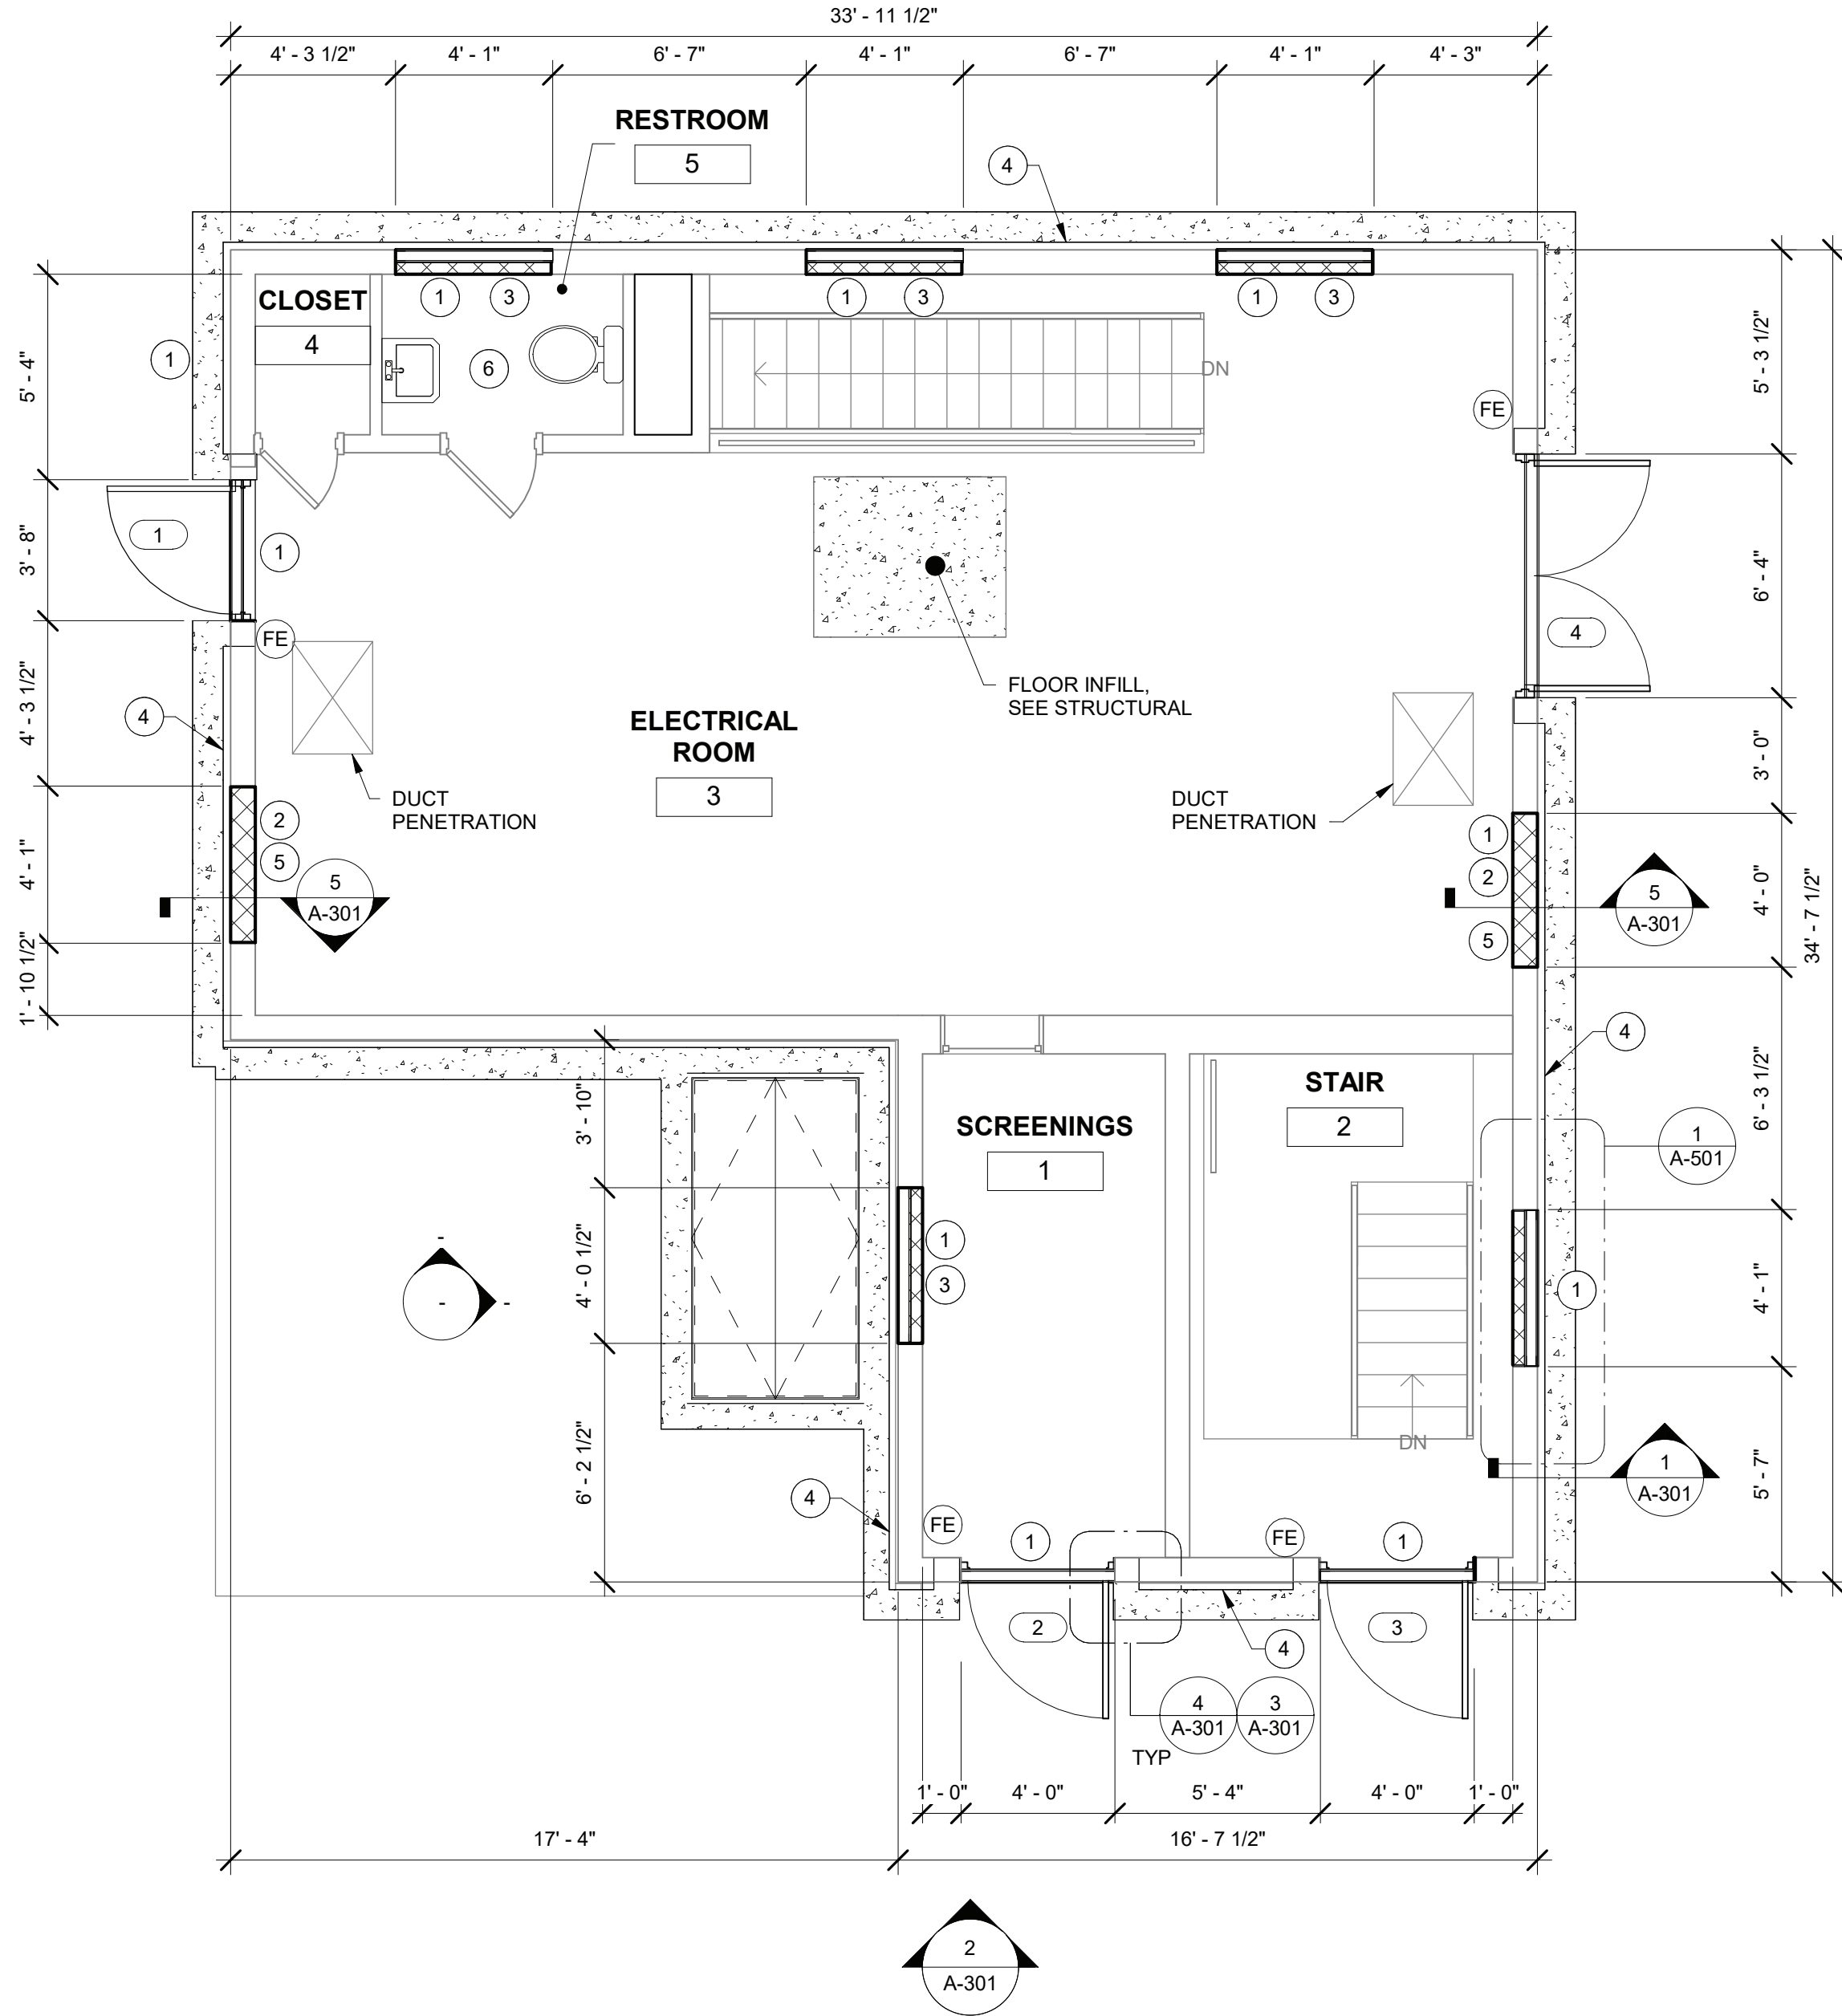

2 MAIN FLOOR - INSTALLATION
1/4" = 1'-0"

INSTALLATION KEYED NOTES

- 1 PROVIDE AND INSTALL TRANSLUCENT PANELS. COORDINATE FINAL DIMENSIONS WITH INSTALLATION OF THIN BRICK VENEER SYSTEM.
- 2 INFILL OPENING TO MATCH EXISTING CMU WALL AND THIN BRICK VENEER SYSTEM.
- 3 INFILL WALL BELOW TRANSLUCENT PANEL WITH 8" CMU.
- 4 INSTALL THIN BRICK VENEER SYSTEM TO MATCH EXISTING BRICK.
- 5 PRIME AND PAINT INTERIOR WALLS AT WALL INFILL LOCATIONS. REFER TO SPECIFICATION SECTION 099900 FIELD PAINT SPEC FOR PAINT SYSTEM.
- 6 PROVIDE TOILET ACCESSORIES. LOCATE NEW ACCESSORIES IN SAME LOCATIONS AS EXISTING, UNLESS OTHERWISE DIRECTED.

NOTES

- 1. CONTRACTOR SHALL FIELD VERIFY ALL DIMENSIONS IN FIELD.



07/09/21


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IN CHARGE OF LWW
CHECKED BY WEC
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O'BRIEN & GERE ENGINEERS, INC.
50 MAIN ST., 10TH FLOOR SUITE 1000,
WHITE PLAINS, NEW YORK 10606


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CONTRACTOR			PROJECT COORDINATOR	
NAME			NAME	
SIGNATURE			SIGNATURE	
TITLE	DATE		TITLE	DATE
WESTCHESTER COUNTY, NEW YORK			CONTRACT NUMBER	SHEET NUMBER
DEPARTMENT OF PUBLIC WORKS AND TRANSPORTATION			17-529	A-101
DIVISION OF ENGINEERING			SHEET NO. 18	OF 60
CROTONVILLE PUMPING STATION REHABILITATION			SCALE: AS NOTED	
OSSINING, NEW YORK			DATE: 12/21/18	
PLANS			DPW FILE NO.	REV. NO.
			208-03-A-42-0	0



1 ROOF PLAN - DEMOLITION


1/8" = 1'-0"

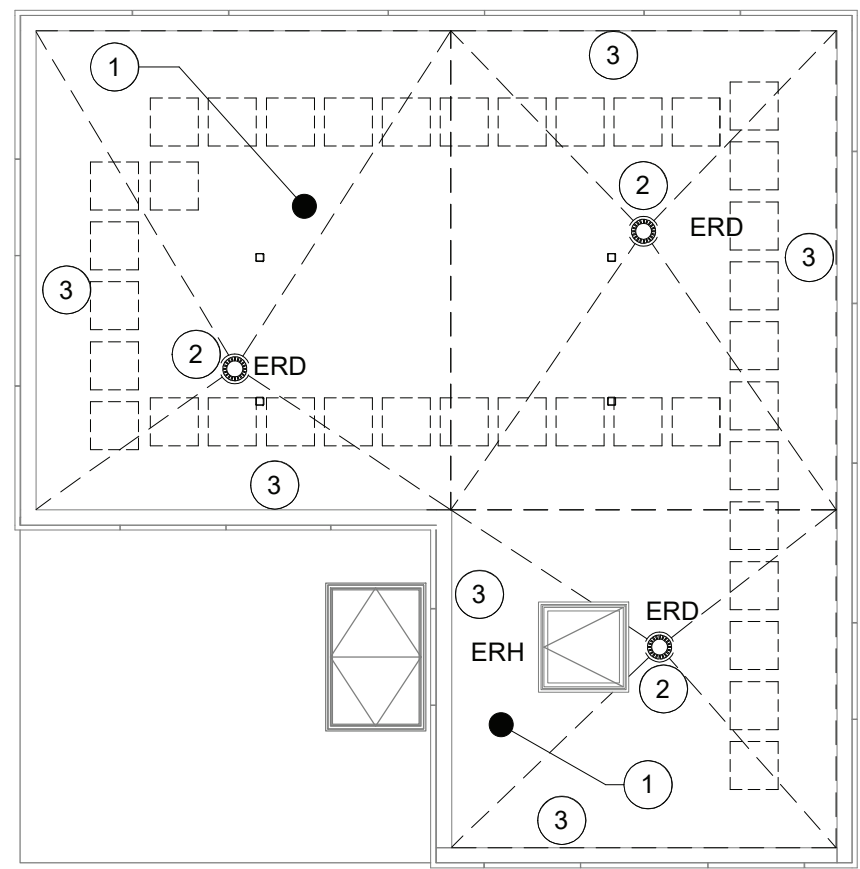8' 4' 0' 8'

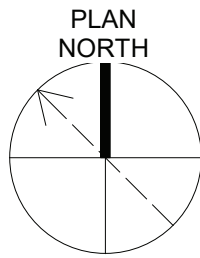

DEMOLITION KEYED NOTES


- 1 REMOVE EXISTING ROOFING MEMBRANE SYSTEM, FLASHING AND ETC. DOWN TO EXISTING CONCRETE PLANK AND PREP FOR INSTALLATION OF NEW ROOFING SYSTEM.
- 2 REMOVE EXISTING ROOF DRAIN STRAINERS AND CLAMP RING AND PREP FOR INSTALLATION OF NEW ROOF MEMBRANE. REPAIR OR REPLACE DRAIN HUB IF DAMAGED DURING CLAMP RING REMOVAL.
- 3 REMOVE EXISTING REGLET FLASHING AND REMOVE EXISTING ROOFING SYSTEM FLASHING AND PREPARE WALL SURFACE AND JOINT AS NEEDED FOR INSTALLATIONS.

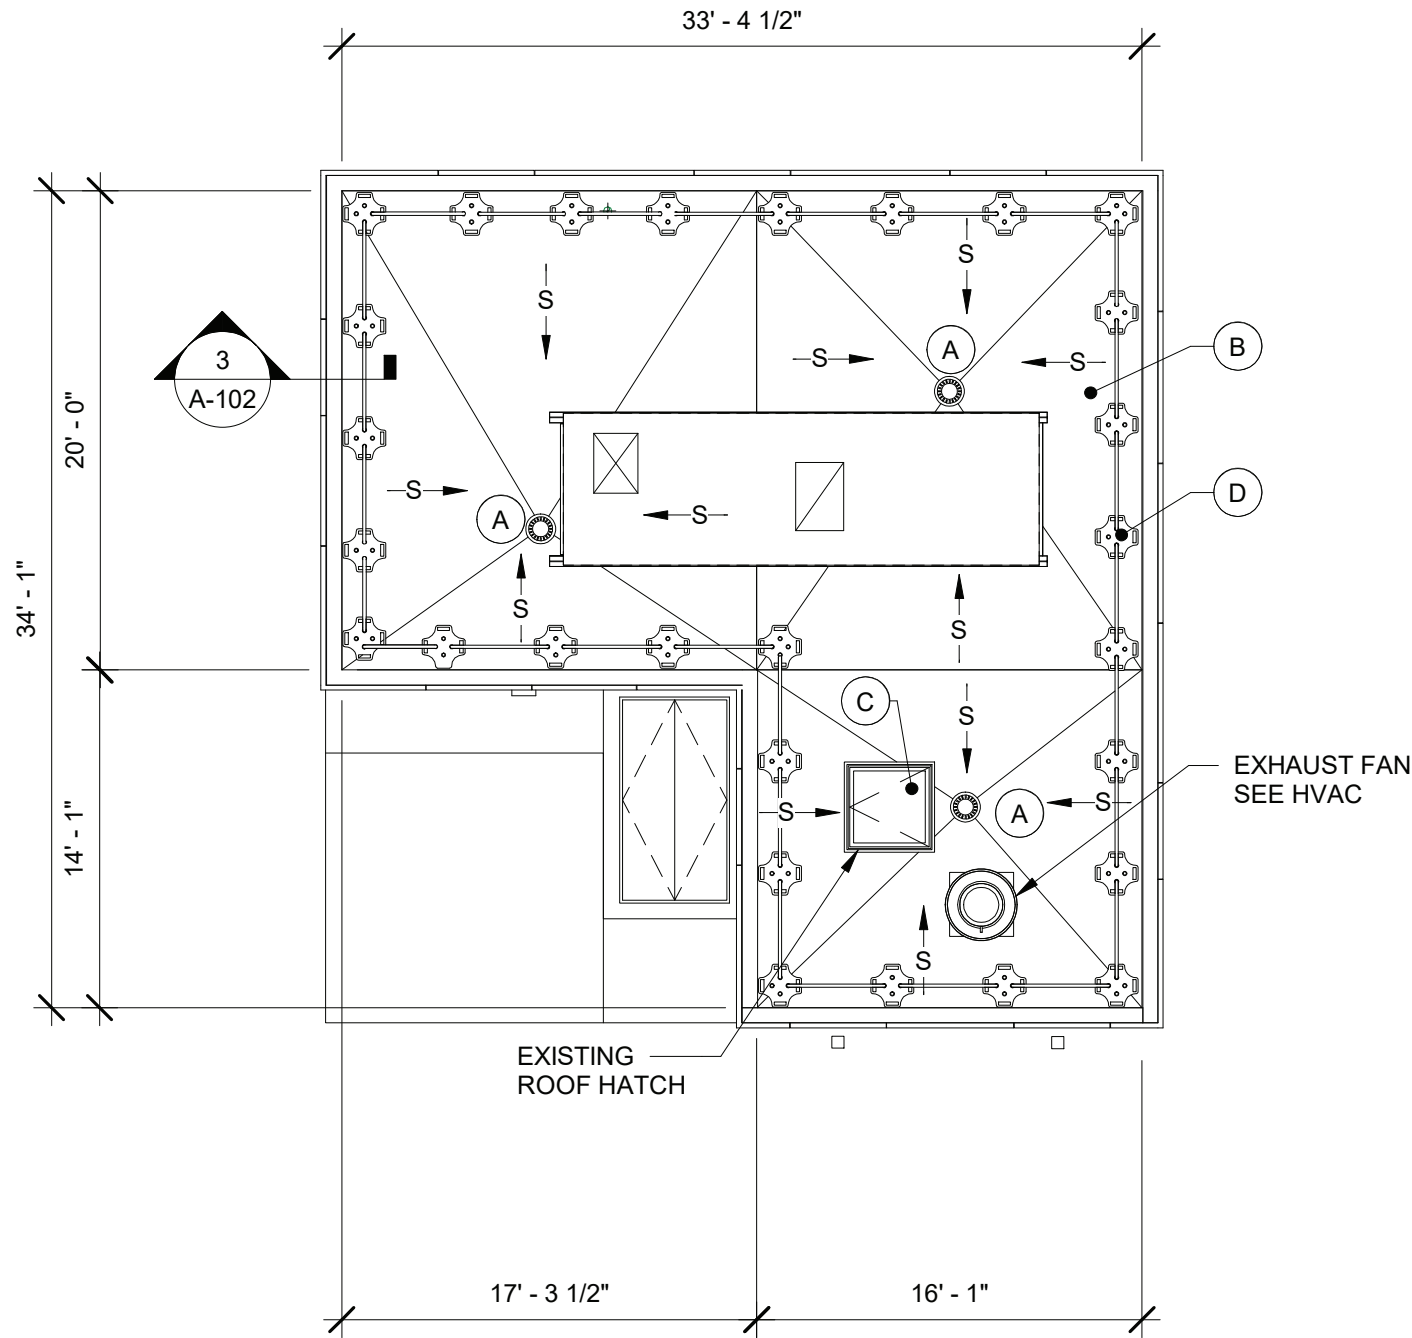

2 ROOF PLAN - INSTALLATION


1/8" = 1'-0"

8' 4' 0' 8'

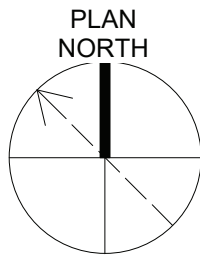

INSTALLATION KEYED NOTES


- A CLAMPING RING ROOF DRAIN. FIELD VERIFY LOCATION.
- B TEXTURED MEMBRANE ROOF SYSTEM.
- C FLASH EXISTING HATCH AS REQUIRED.
- D 42" HIGH BALLASTED GUARDRAIL FALL PROTECTION SYSTEM.

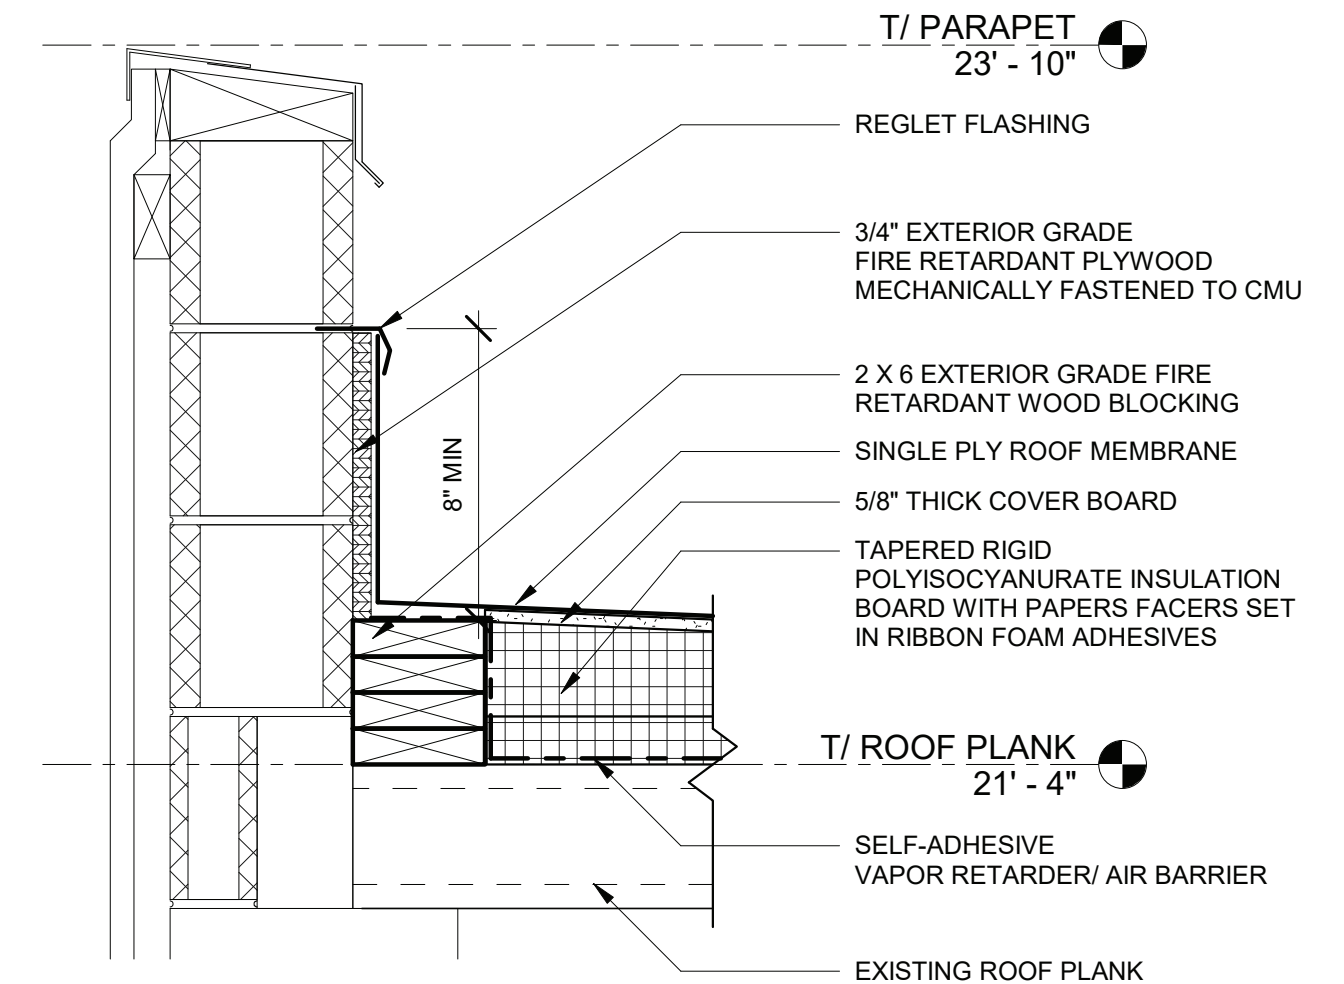

3 SECTION DETAIL AT ROOF

1 1/2" = 1'-0"


4' 2' 0' 1'

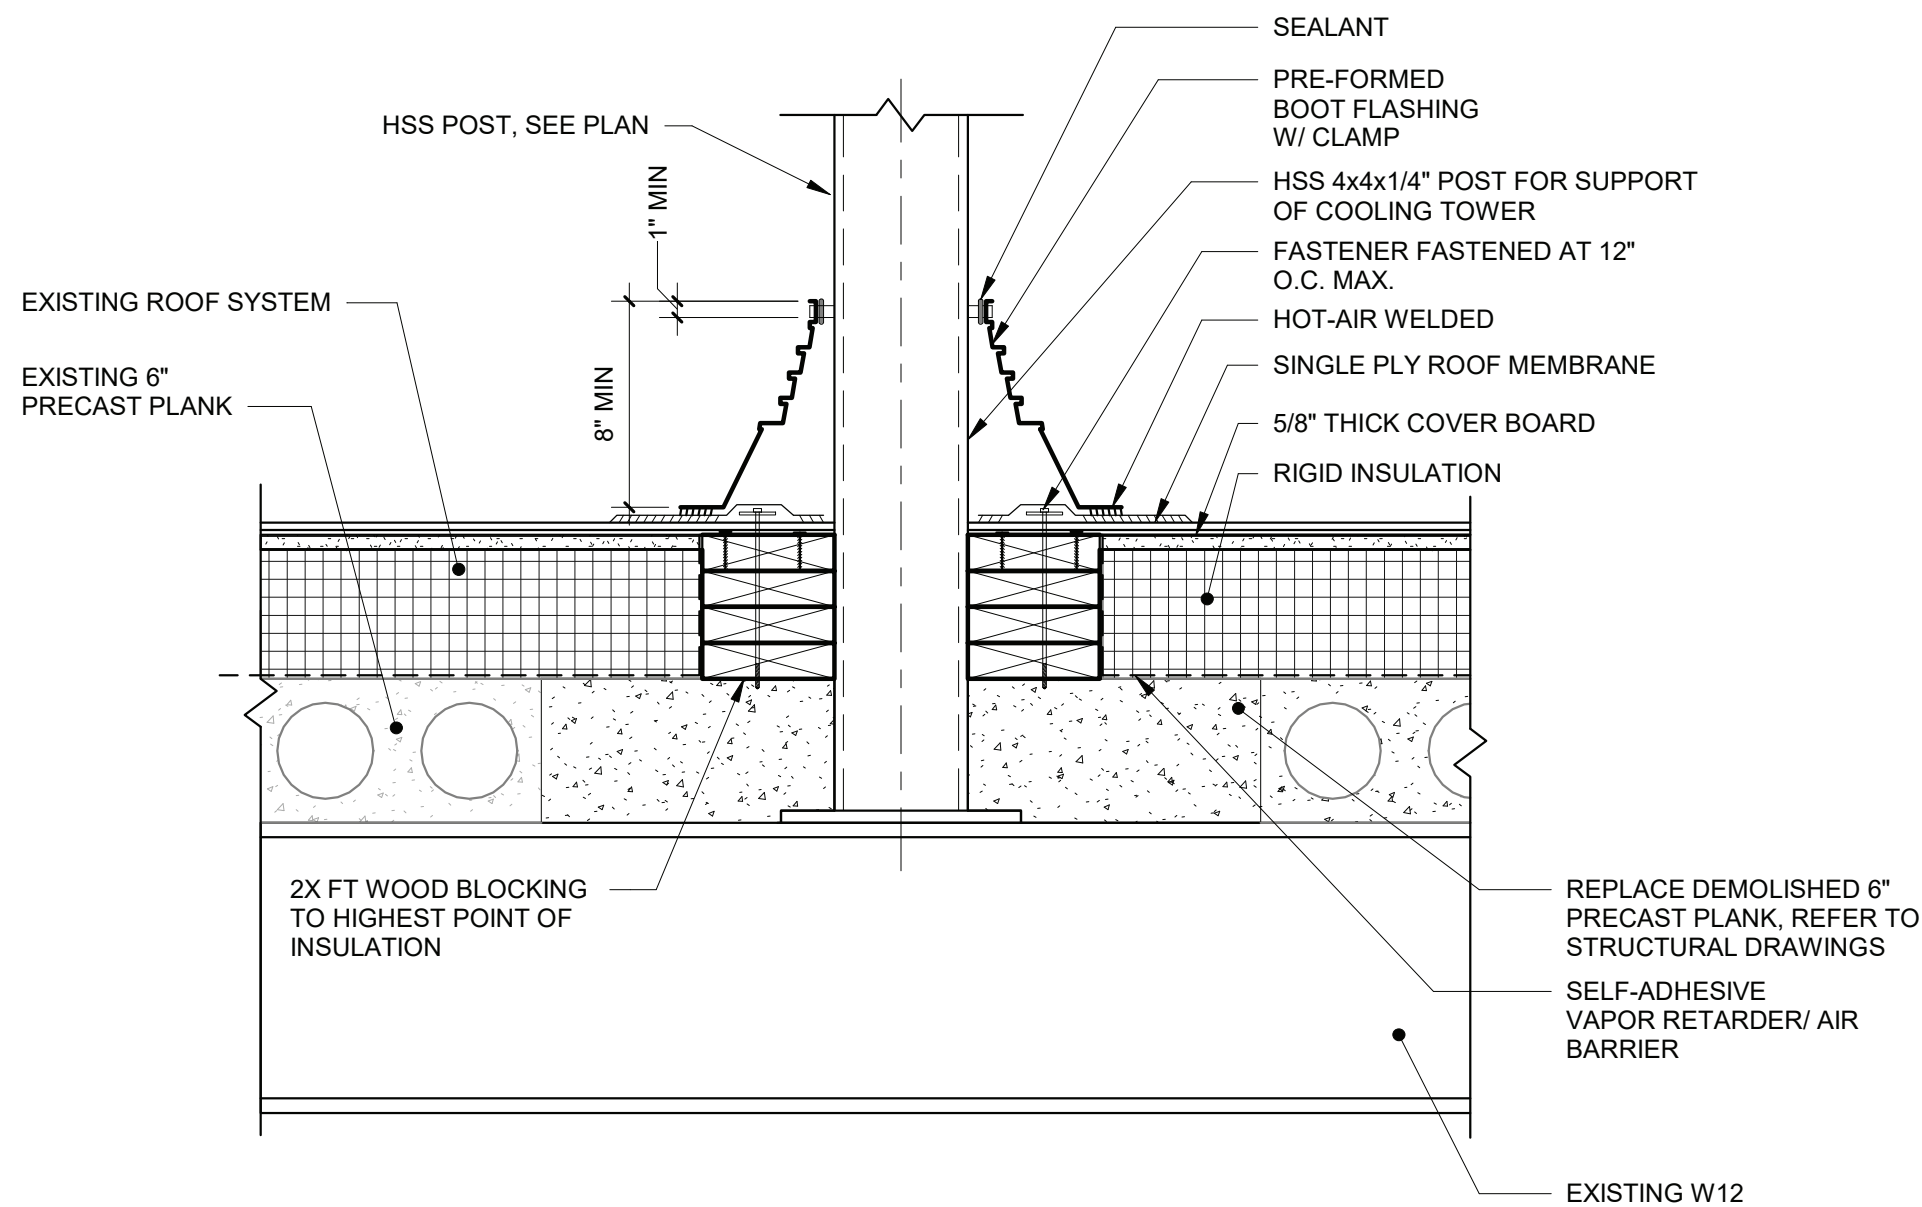

4 RTU FRAME FLASHING DETAIL

1 1/2" = 1'-0"

4' 2' 0' 1'

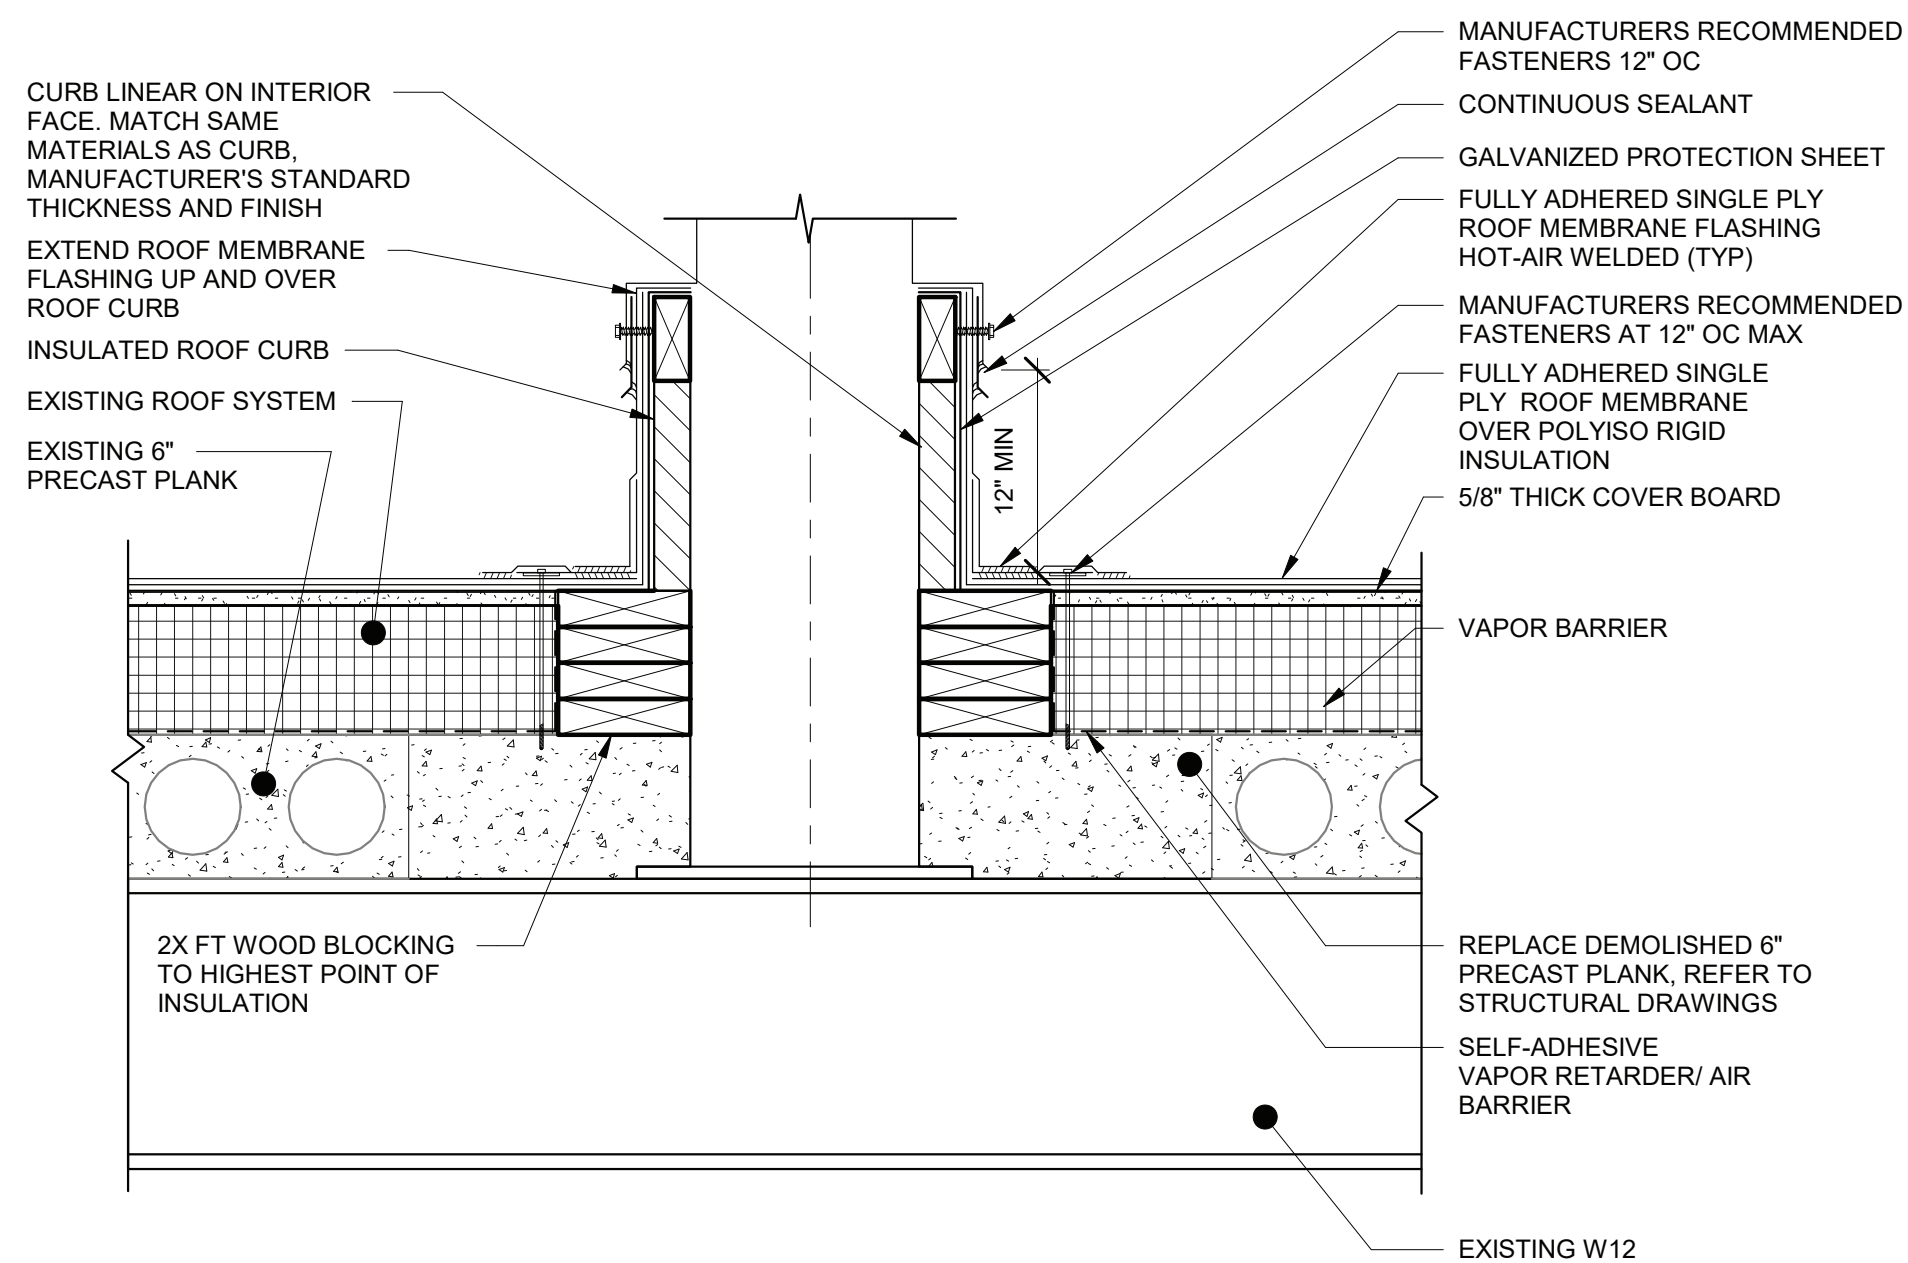


5 ROOF CURB DETAIL

1 1/2" = 1'-0"




4' 2' 0' 1'

	IN ACCORDANCE WITH TITLE VIII, ARTICLE 145, SECTION 7209 (2) OF THE NEW YORK STATE EDUCATION LAW, IT IS A VIOLATION OF LAW FOR ANY PERSON UNLESS ACTING UNDER THE DIRECTION OF A LICENSED ENGINEER TO ALTER THIS DOCUMENT.																										
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	MADE BY <u>LER</u>	50 MAIN ST., 10TH FLOOR SUITE 1000, WHITE PLAINS, NEW YORK 10606																									
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CONTRACTOR		PROJECT COORDINATOR																									
NAME	SIGNATURE	NAME	SIGNATURE	DATE																							
TITLE	DATE	TITLE	DATE	DATE																							
WESTCHESTER COUNTY, NEW YORK		CONTRACT NUMBER 17-529																									
DEPARTMENT OF PUBLIC WORKS AND TRANSPORTATION		SHEET NUMBER A-102																									
DIVISION OF ENGINEERING		SHEET NO. 19 OF 60																									
CROTONVILLE PUMPING STATION REHABILITATION		SCALE: AS NOTED																									
OSSINING, NEW YORK		DATE: 12/21/18																									
ROOF PLANS		DPW FILE NO. 208-03-A-43-0																									
		REV. NO. 0																									

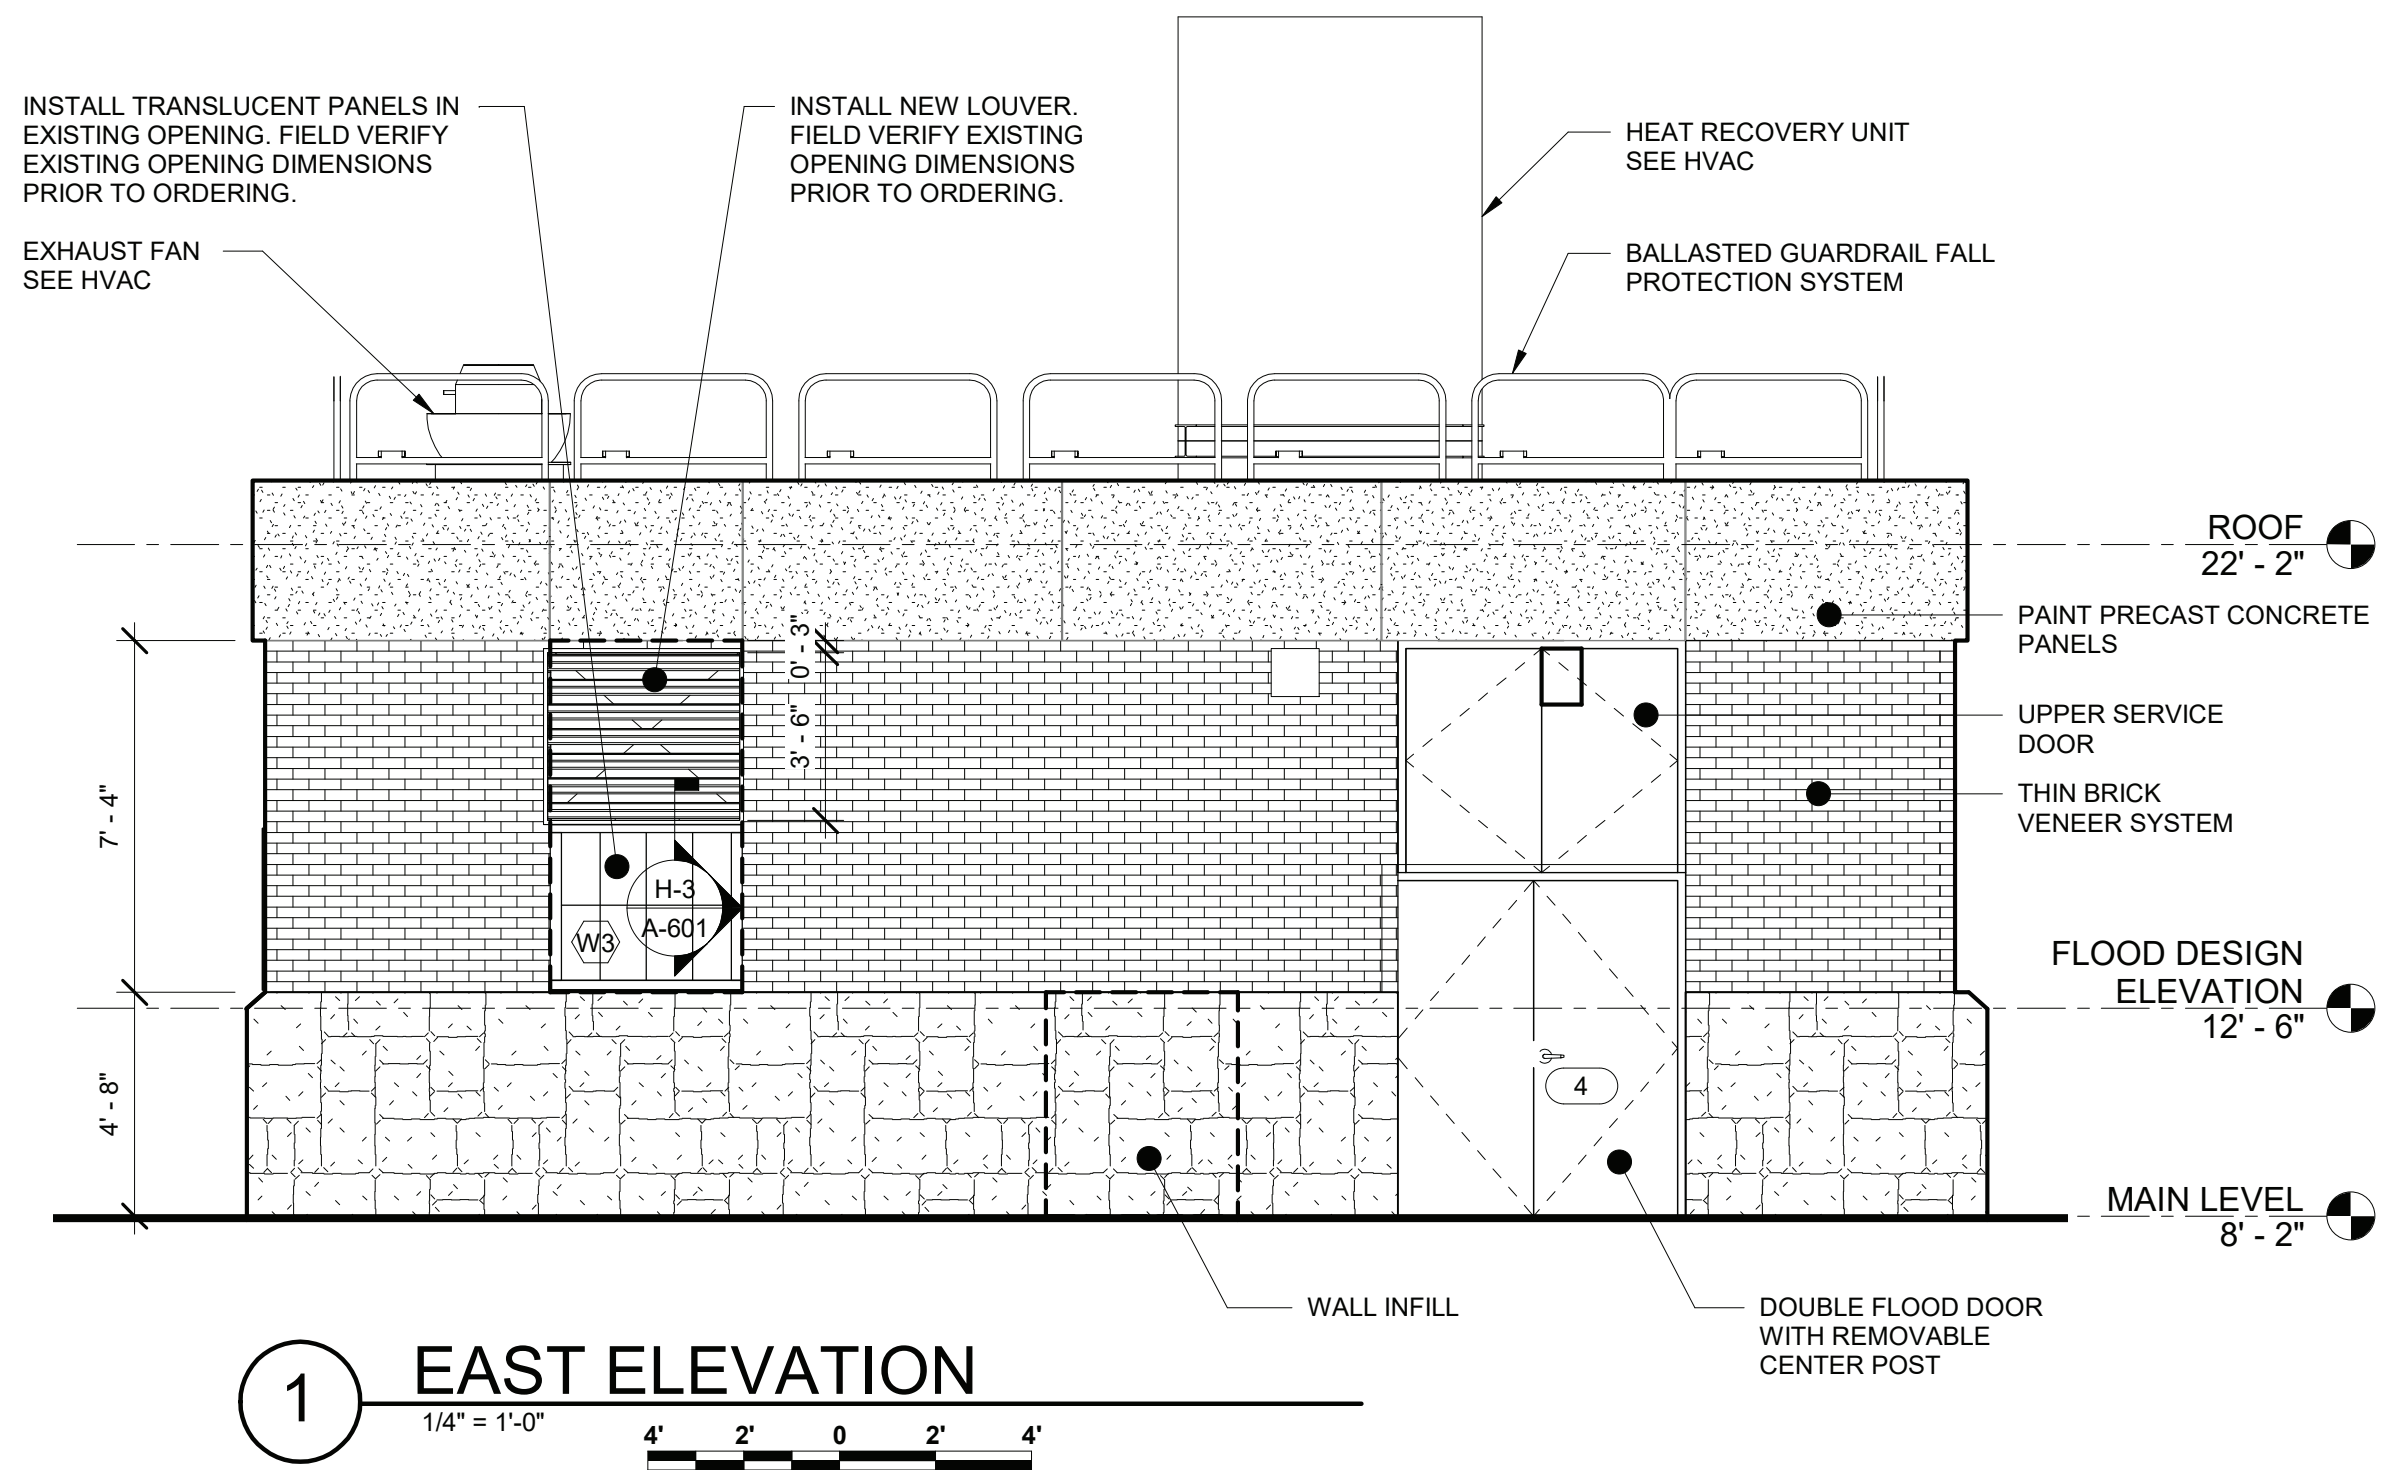

PAINT NOTES:

- 1 EXISTING PRECAST CONCRETE PANELS TO BE PAINTED.
- 2 PAINT COLOR: SHERWIN WILLIAMS (SW 7070 SITE WHITE OR APPROVED EQUAL) FINAL APPROVAL BY OWNER
- 3 SEE FIELD PAINTING SPECIFICATION FOR APPLICABLE PAINT SYSTEM

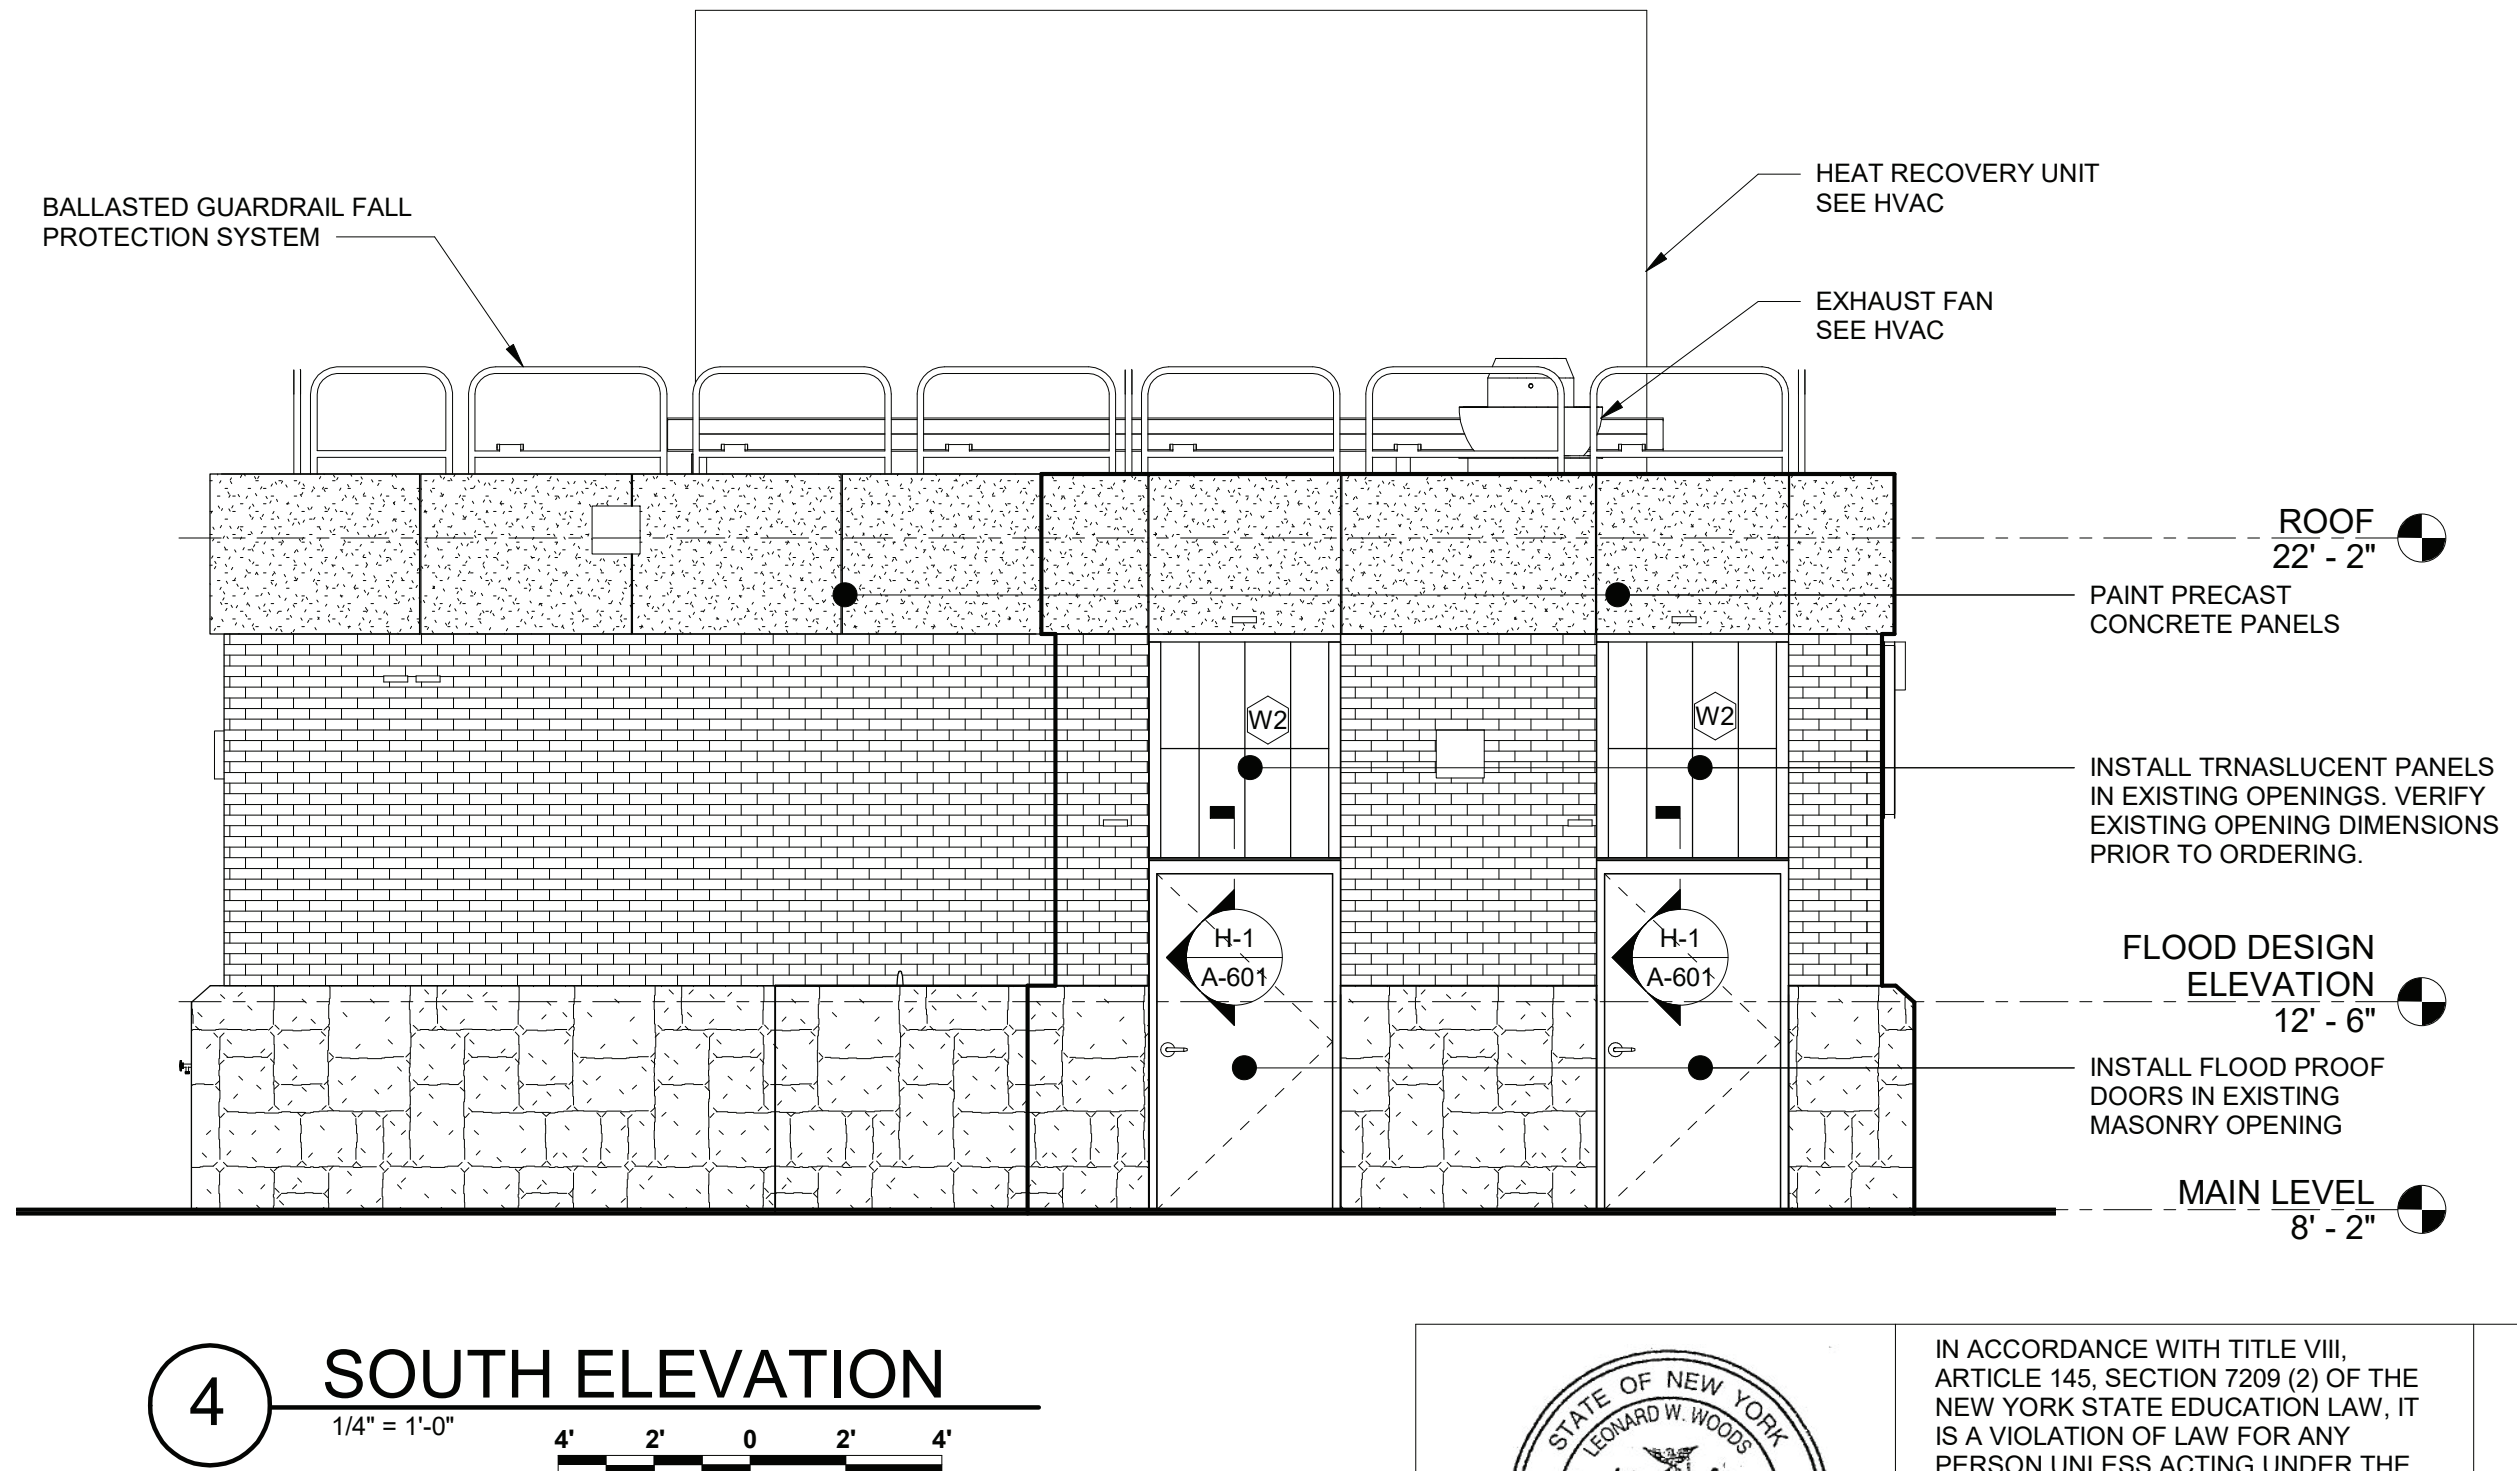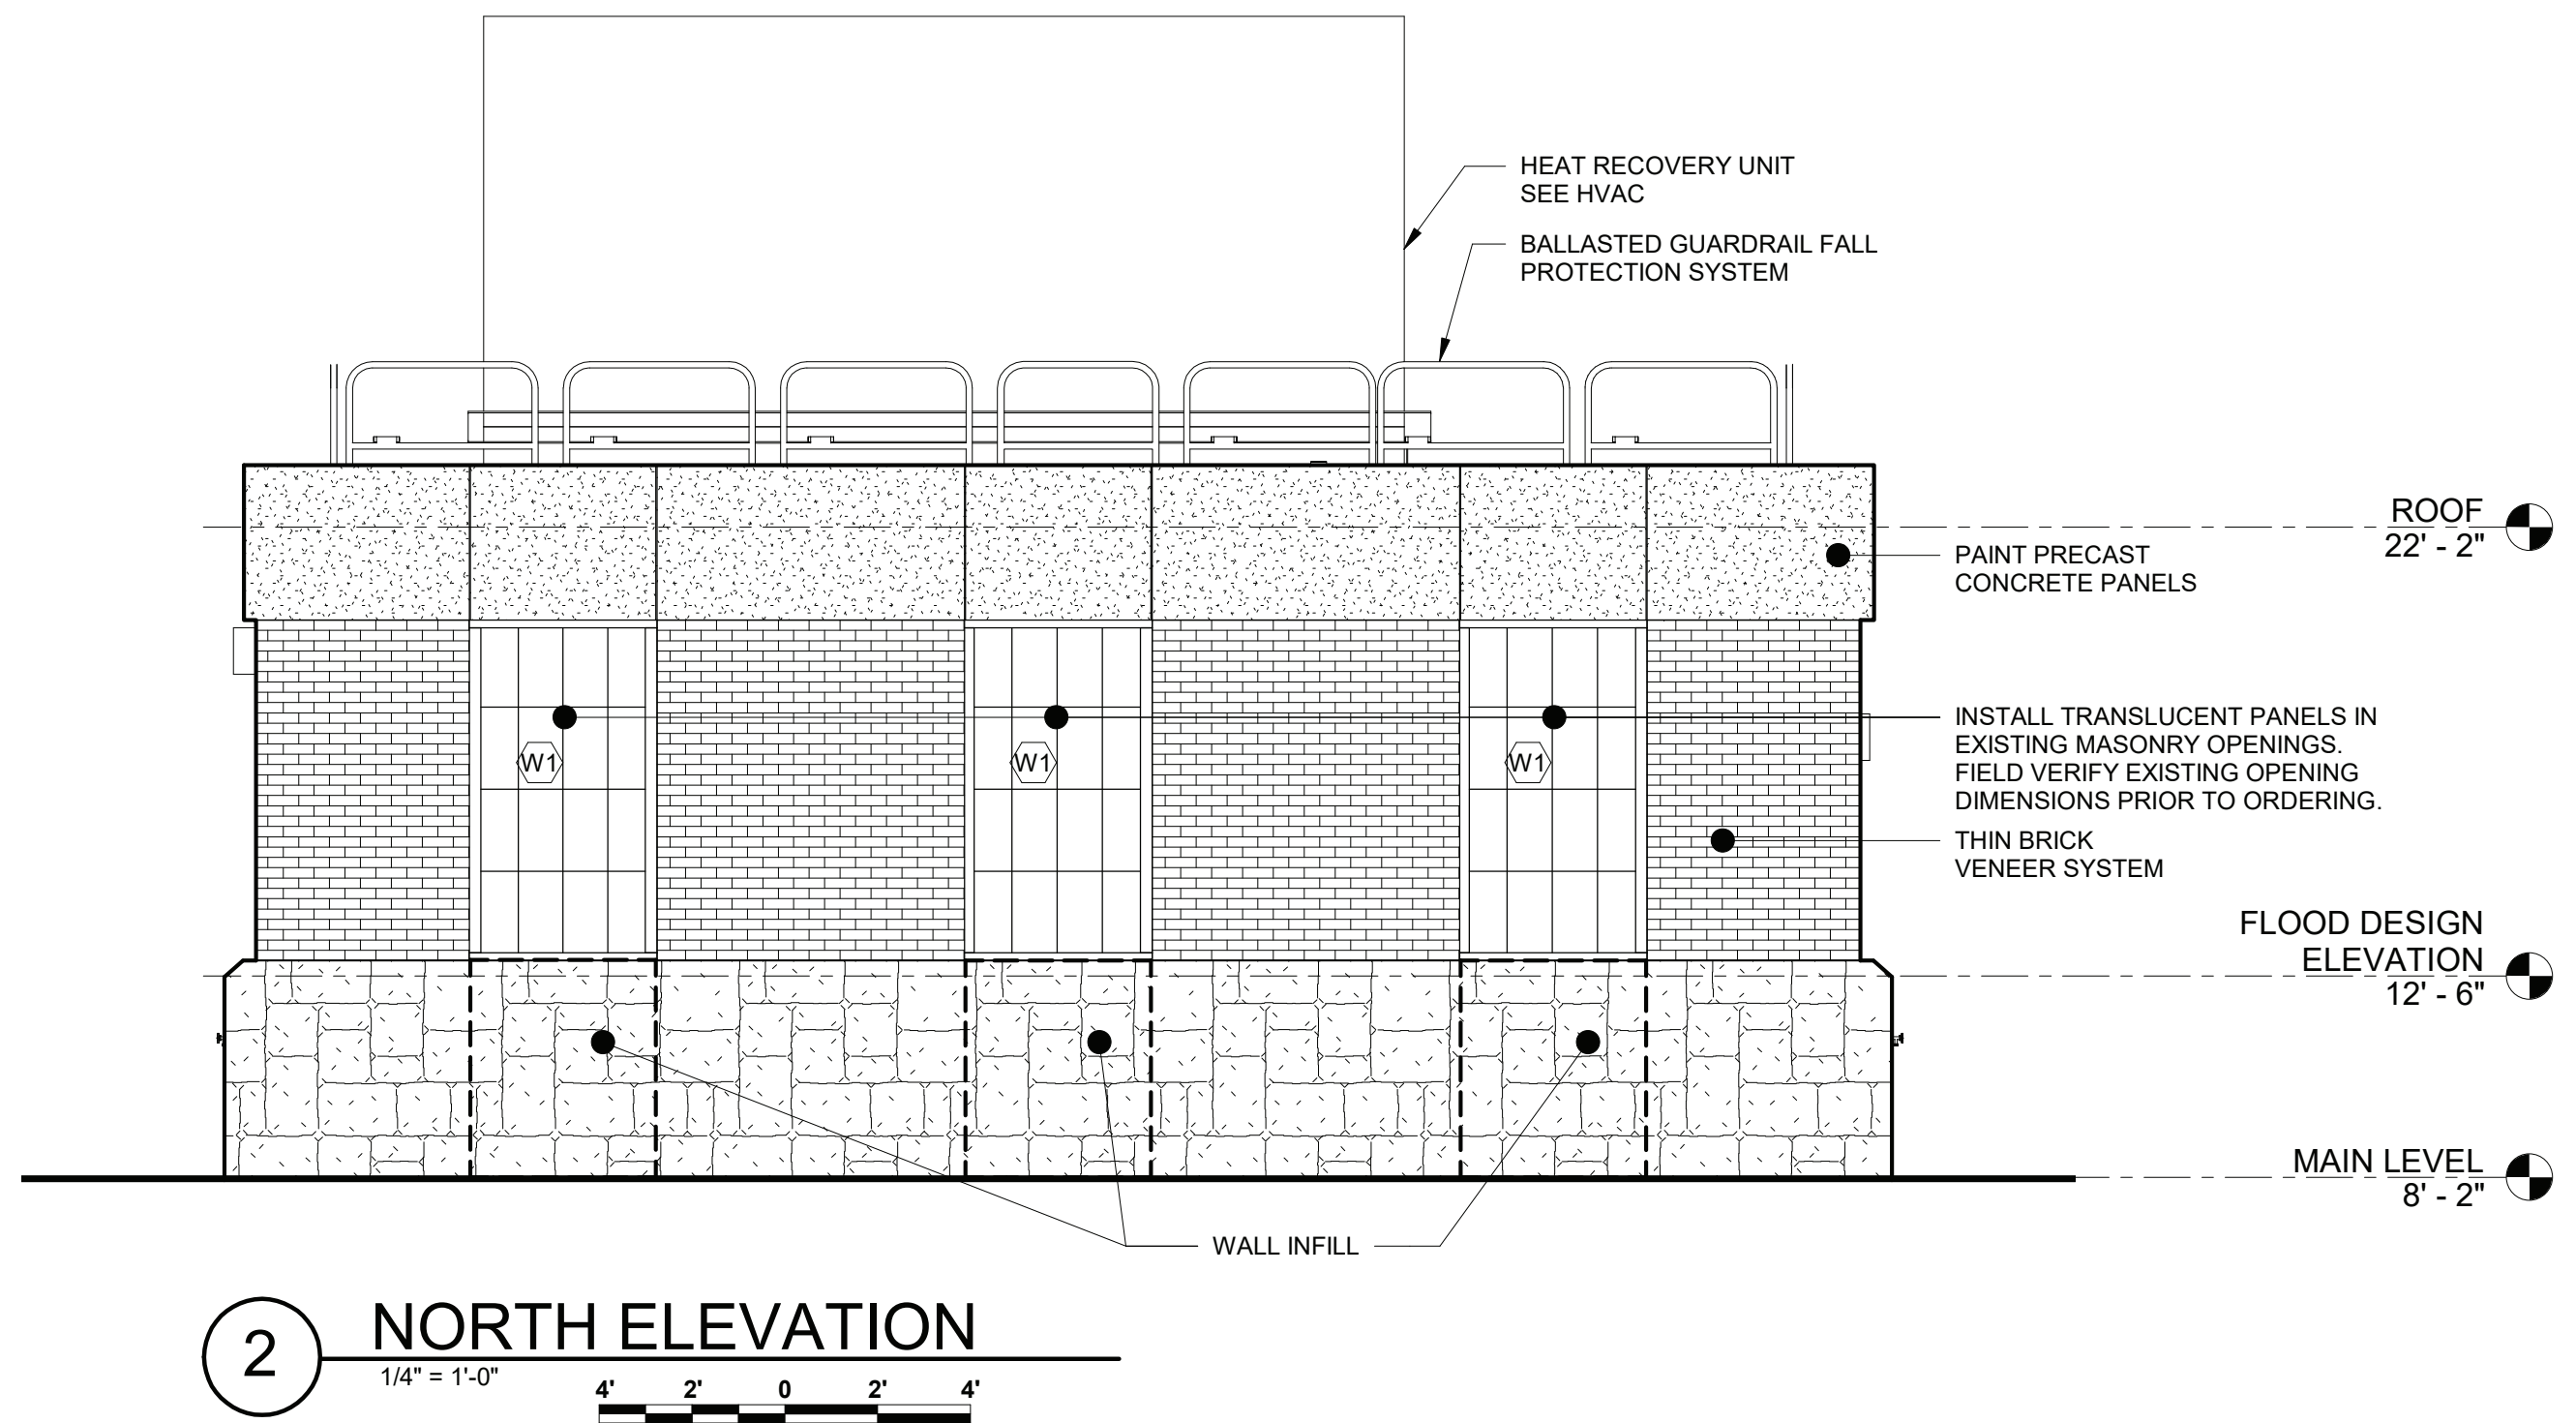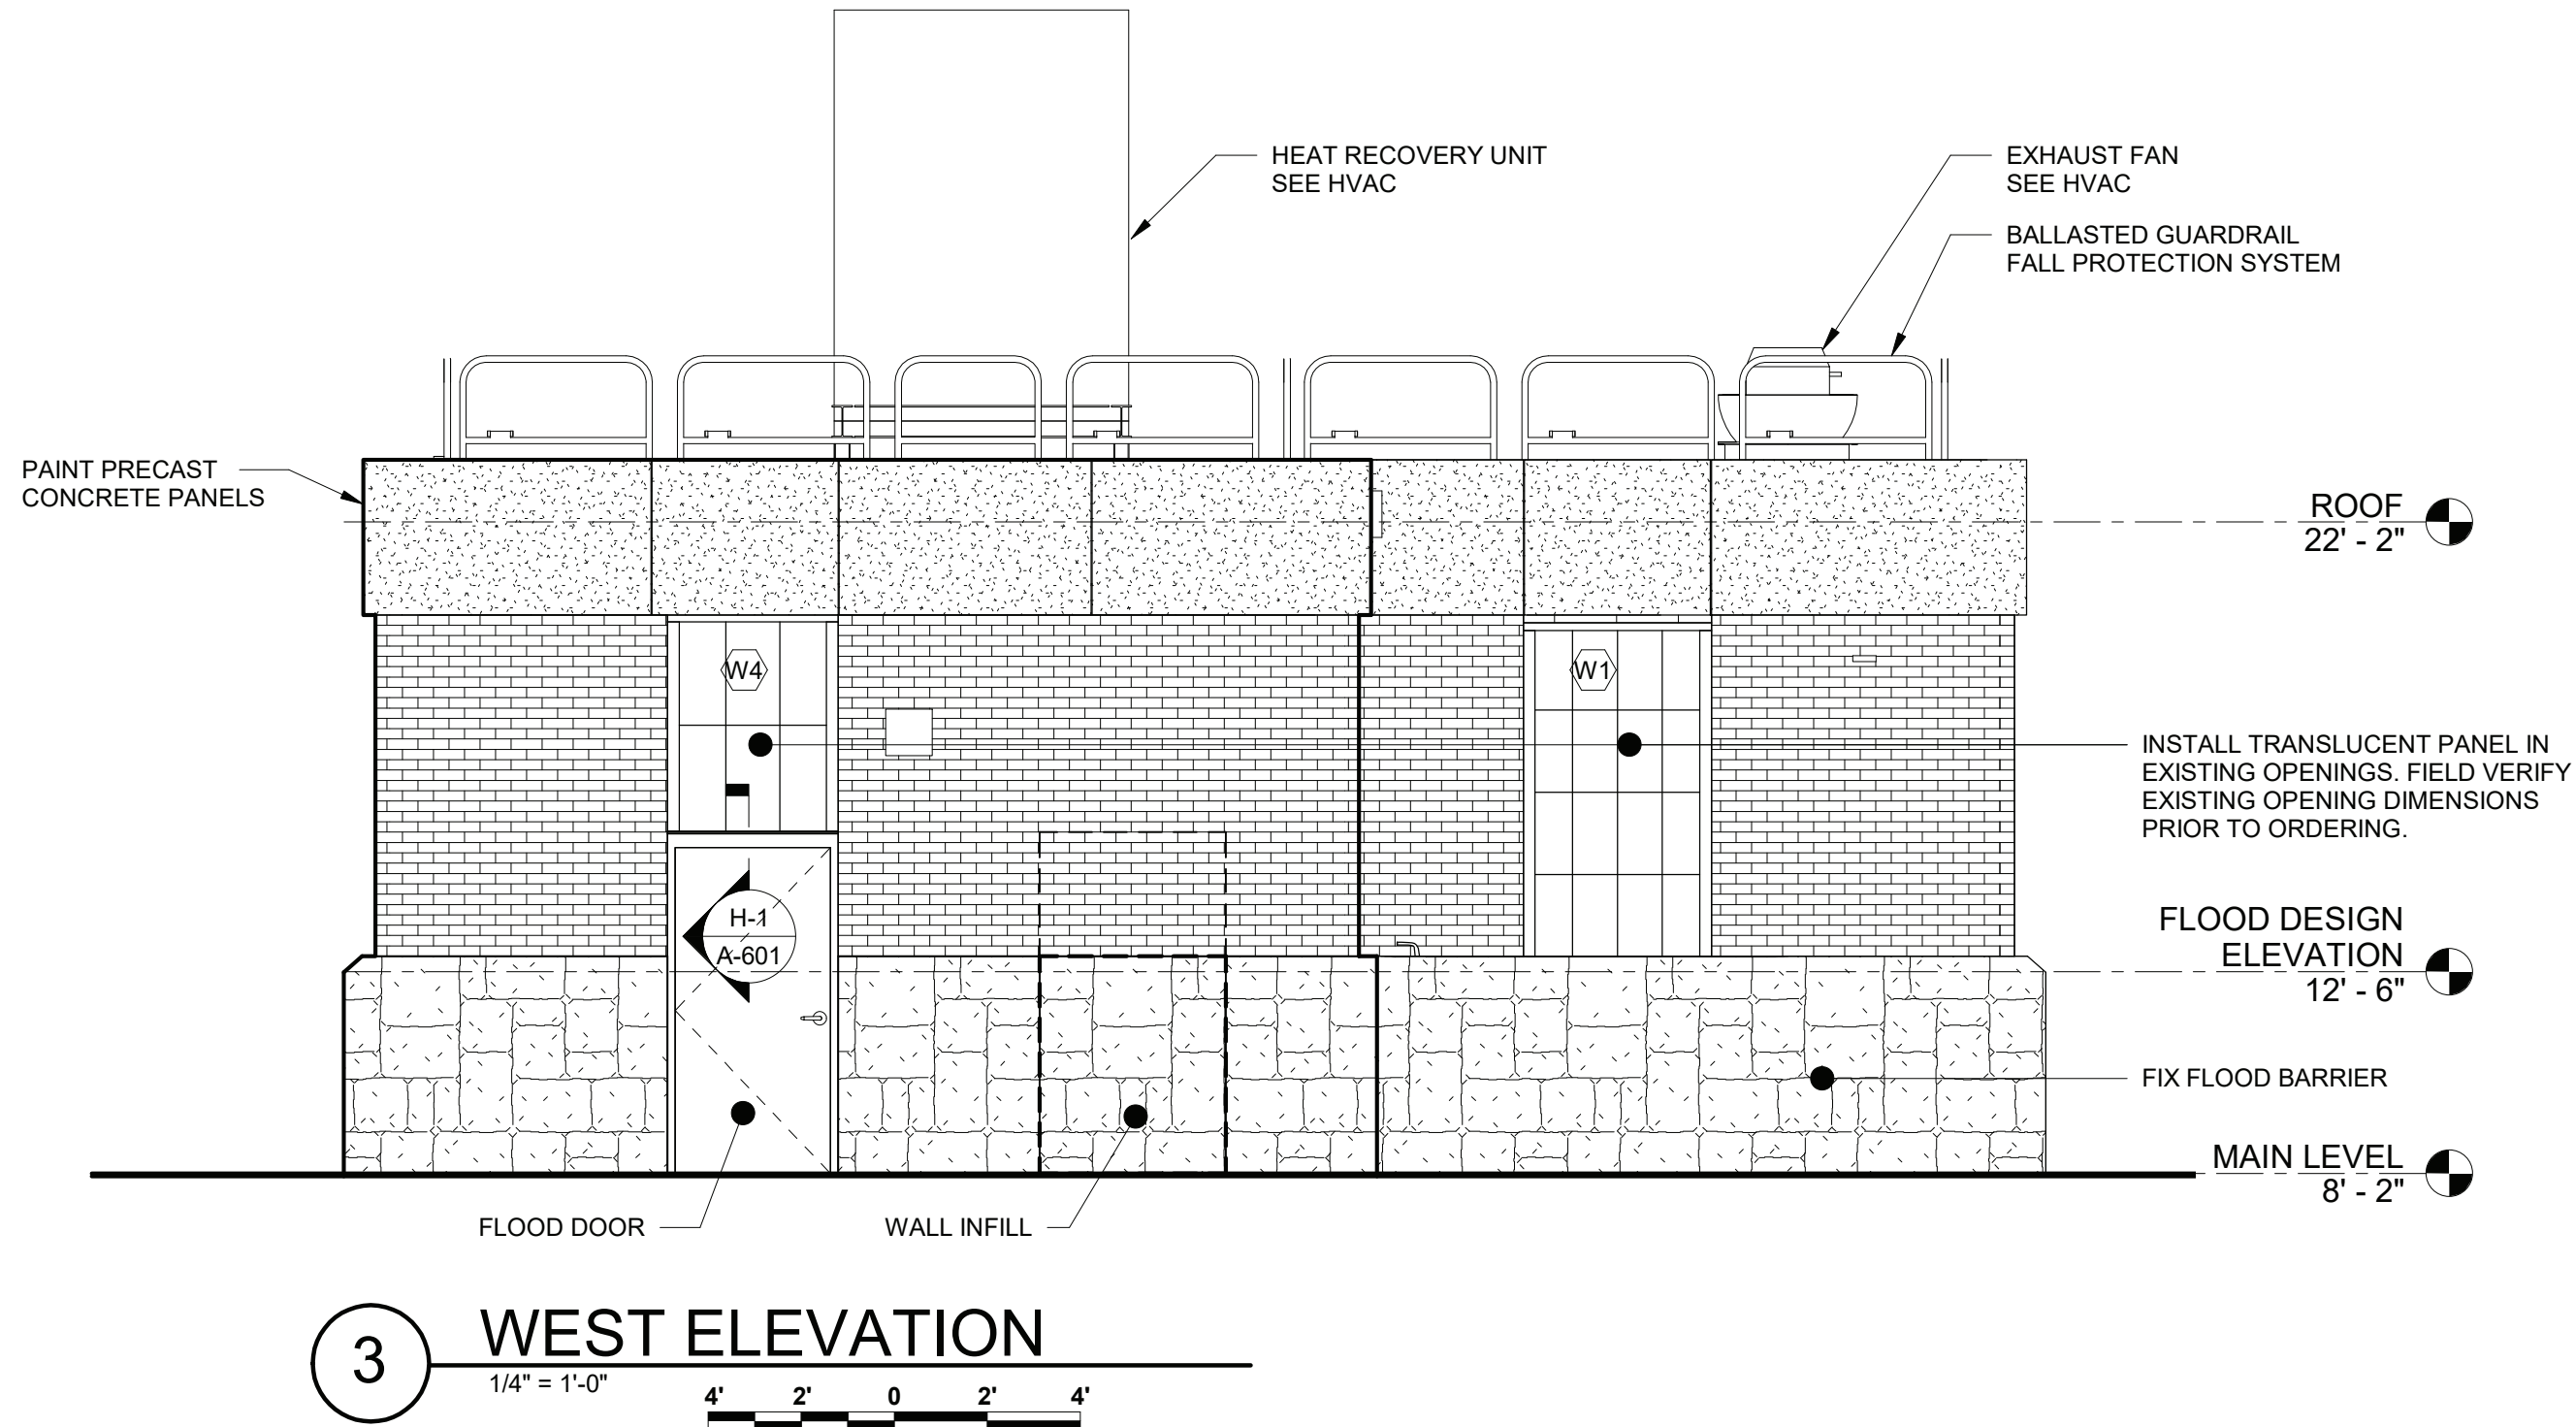

07/09/21

IN ACCORDANCE WITH TITLE VIII, ARTICLE 145, SECTION 7209 (2) OF THE NEW YORK STATE EDUCATION LAW, IT IS A VIOLATION OF LAW FOR ANY PERSON UNLESS ACTING UNDER THE DIRECTION OF A LICENSED ENGINEER TO ALTER THIS DOCUMENT.


IN CHARGE OF LWW
CHECKED BY WEC
MADE BY LER




O'BRIEN & GERE ENGINEERS, INC.
50 MAIN ST., 10TH FLOOR SUITE 1000,
WHITE PLAINS, NEW YORK 10606

REVISION NUMBER	DATE	MADE BY	APP'D BY	REVISION


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CONTRACTOR		PROJECT COORDINATOR	
NAME	NAME	DATE	DATE
SIGNATURE	SIGNATURE		
TITLE	TITLE		
WESTCHESTER COUNTY, NEW YORK		CONTRACT NUMBER	SHEET NUMBER
DEPARTMENT OF PUBLIC WORKS AND TRANSPORTATION		17-529	A-201
DIVISION OF ENGINEERING		SHEET NO. 20 OF 60	SCALE: AS NOTED
CROTONVILLE PUMPING STATION REHABILITATION		DATE: 12/21/18	DPW FILE NO.
OSSINING, NEW YORK		208-03-A-44-0	REV. NO. 0
ELEVATIONS			

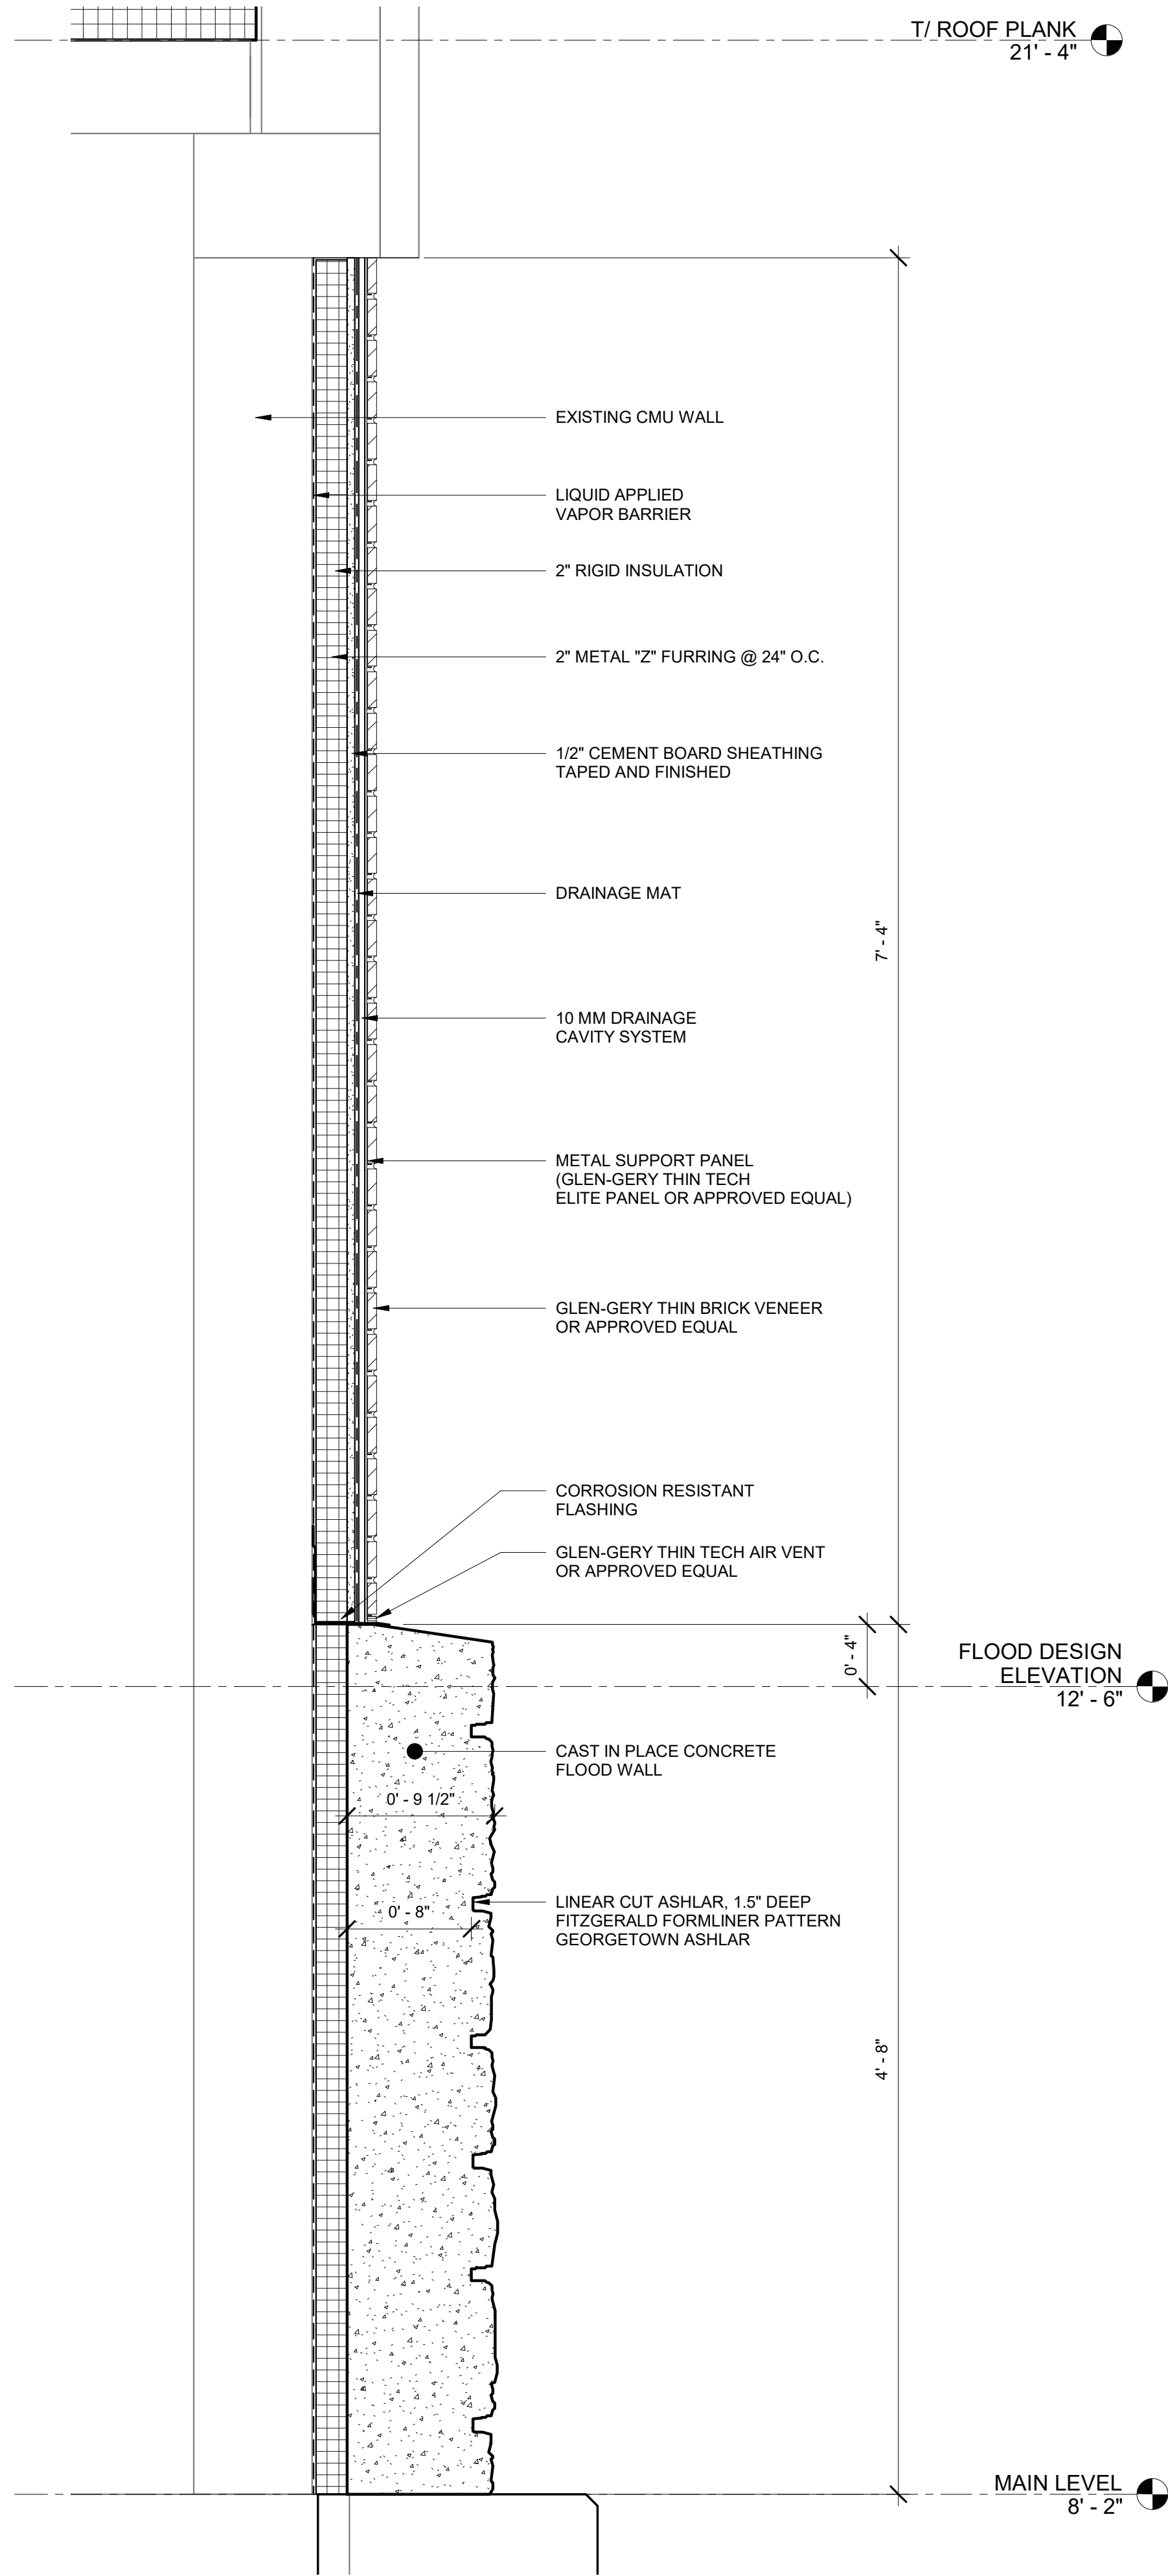


1 TYPICAL WALL SECTION AT FLOOD WALL LOCATIONS
1 1/2" = 1'-0" 4" 2" 0 1"

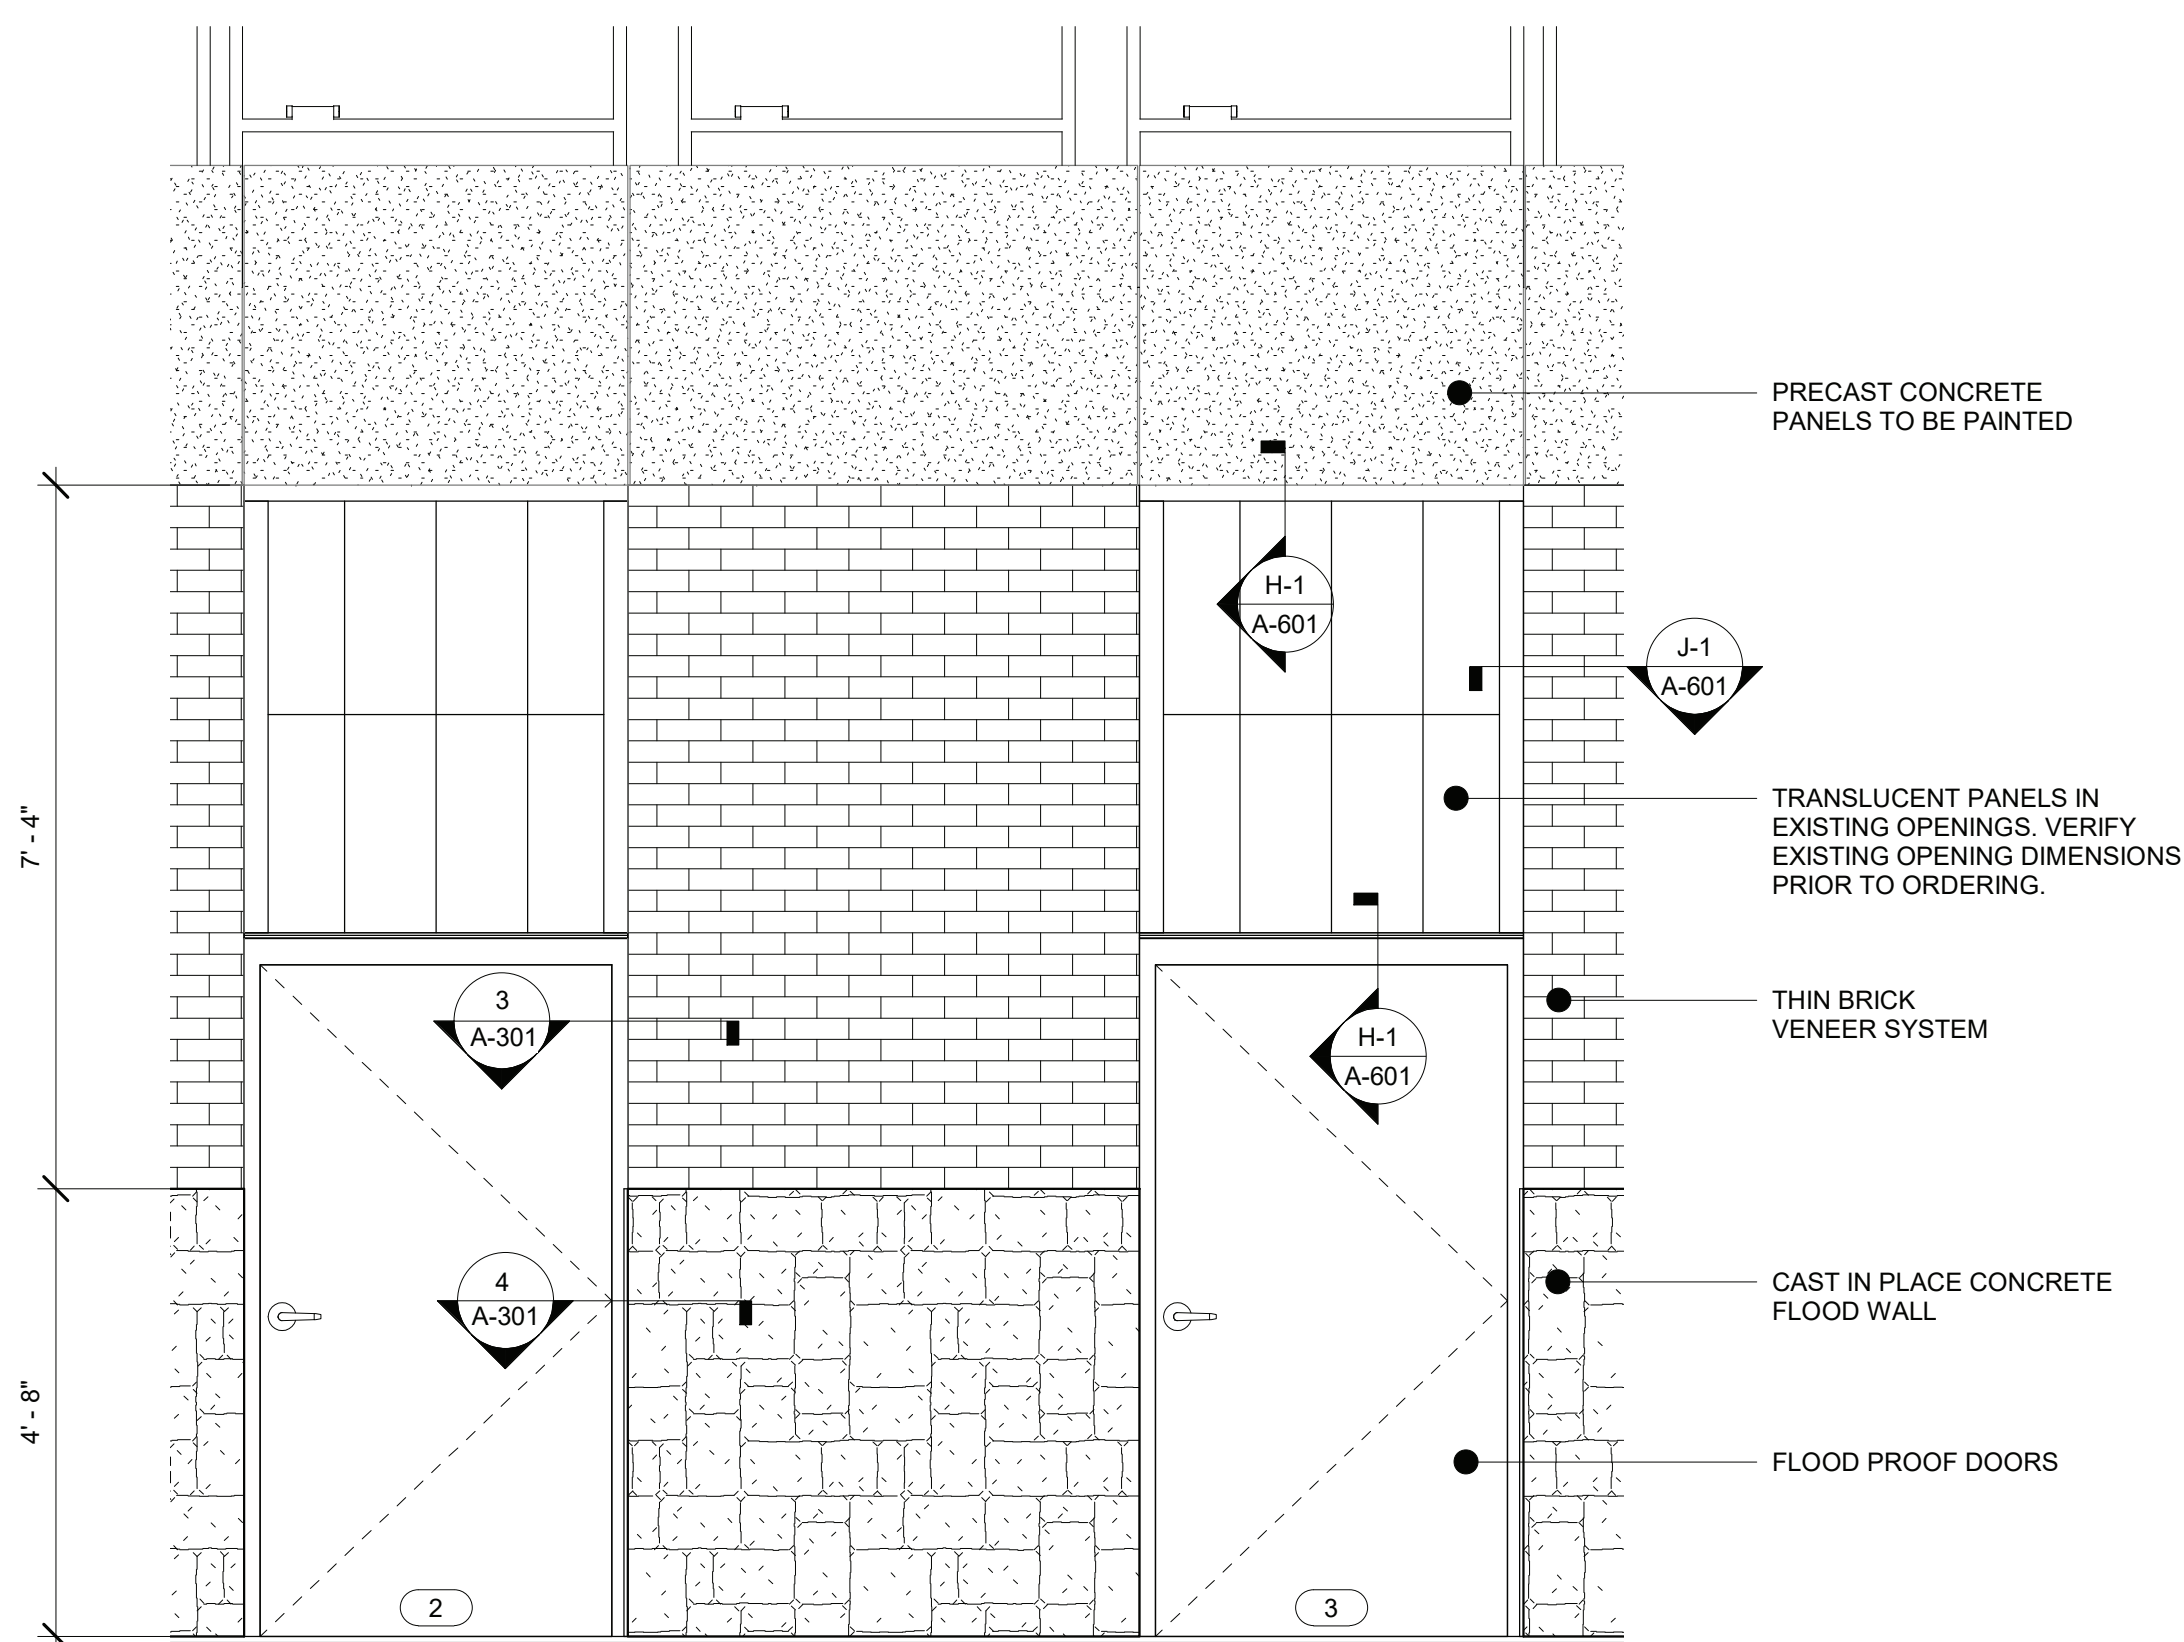


2 ENLARGED SOUTH ELEVATION
1/2" = 1'-0" 2' 1' 0 1' 2'

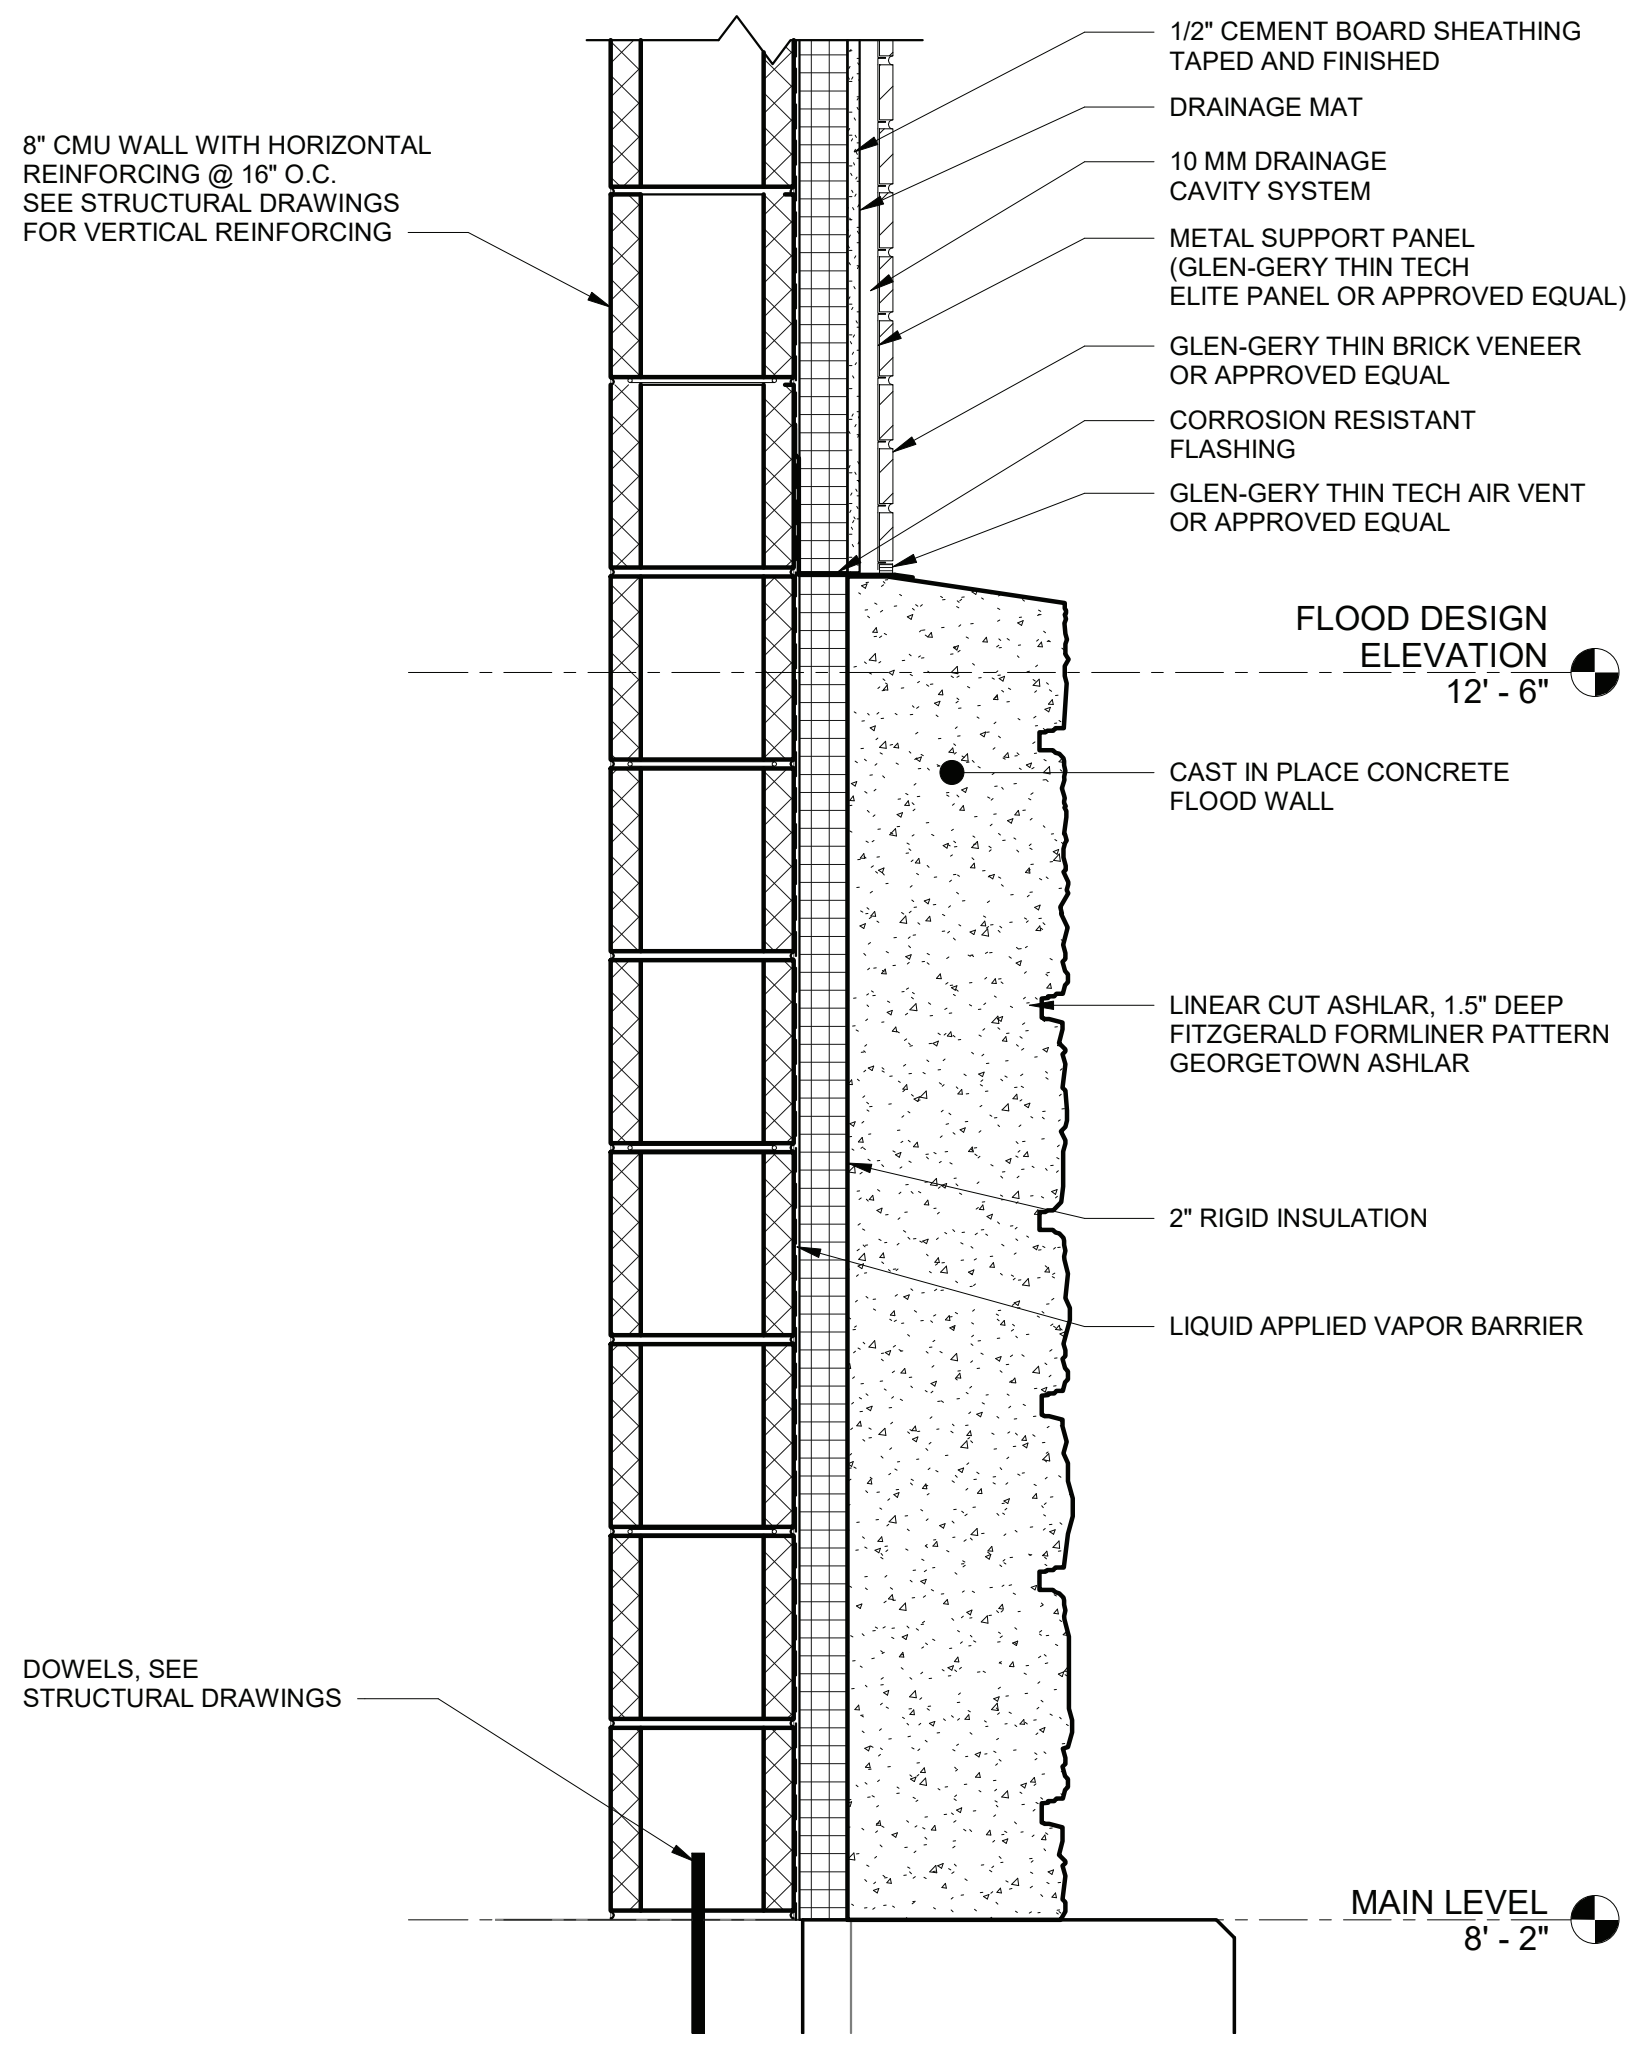

5 TYPICAL WALL SECTION AT INFILLED WALL
1 1/2" = 1'-0" 4" 2" 0 1"

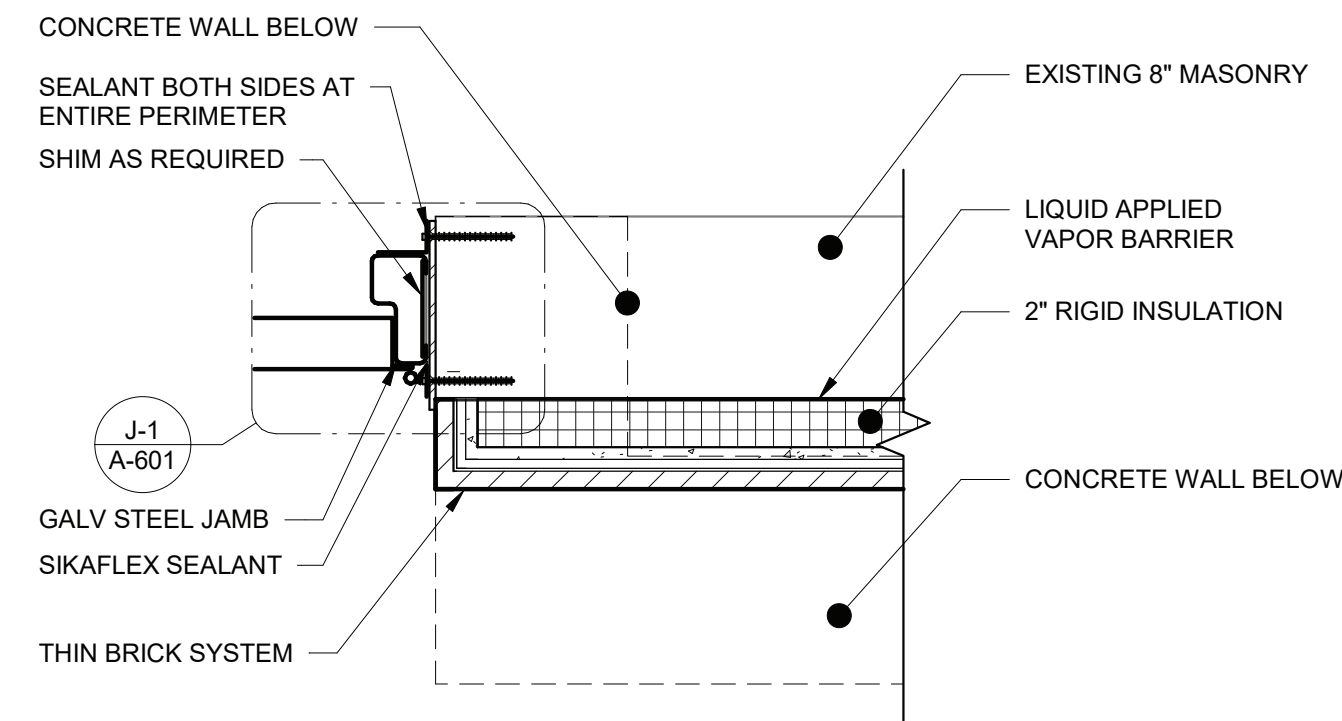


3 DETAIL AT CMU WALL
1 1/2" = 1'-0" 4" 2" 0 1"

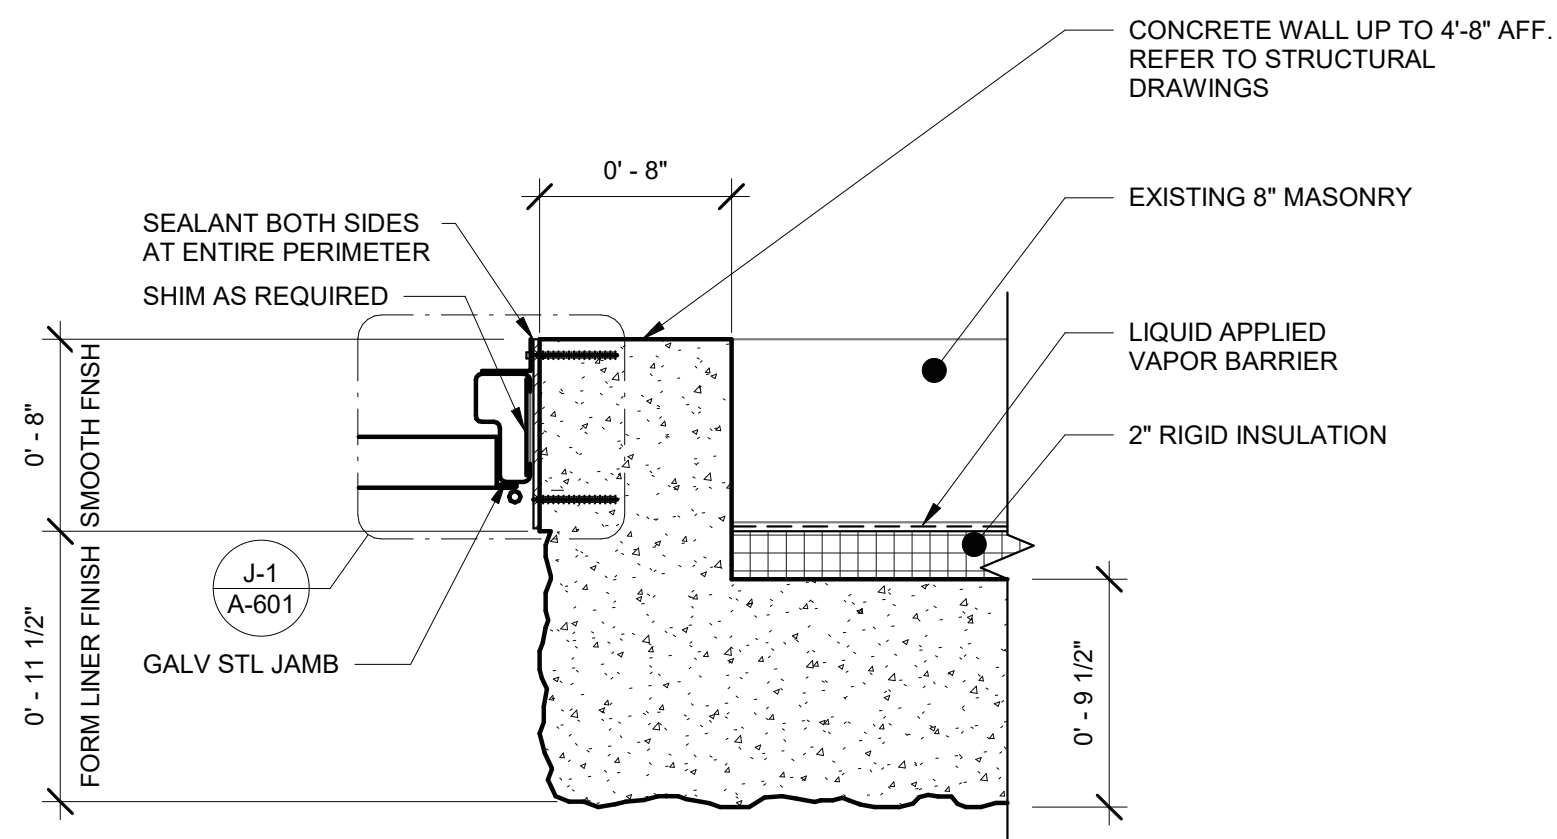


4 DETAIL AT CONCRETE WALL
1 1/2" = 1'-0" 4" 2" 0 1"


		IN ACCORDANCE WITH TITLE VIII, ARTICLE 145, SECTION 7209 (2) OF THE NEW YORK STATE EDUCATION LAW, IT IS A VIOLATION OF LAW FOR ANY PERSON UNLESS ACTING UNDER THE DIRECTION OF A LICENSED ENGINEER TO ALTER THIS DOCUMENT.				
07/09/21		IN CHARGE OF <u>LWW</u> CHECKED BY <u>WEC</u> MADE BY <u>LER</u>		O'BRIEN & GERE ENGINEERS, INC. 50 MAIN ST., 10TH FLOOR SUITE 1000, WHITE PLAINS, NEW YORK 10606		
REVISION NUMBER	DATE	MADE BY	APP'D BY	REVISION		
RECORD DRAWING CERTIFICATION						
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CONTRACTOR			PROJECT COORDINATOR			
NAME	SIGNATURE		DATE	NAME	SIGNATURE	
TITLE			TITLE			
WESTCHESTER COUNTY, NEW YORK DEPARTMENT OF PUBLIC WORKS AND TRANSPORTATION DIVISION OF ENGINEERING				CONTRACT NUMBER 17-529	SHEET NUMBER A-301	
CROTONVILLE PUMPING STATION REHABILITATION				SCALE: AS NOTED DATE: 12/21/18		
OSSINING, NEW YORK SECTIONS				DPW FILE NO. 208-03-A-45-0	REV. NO. 0	

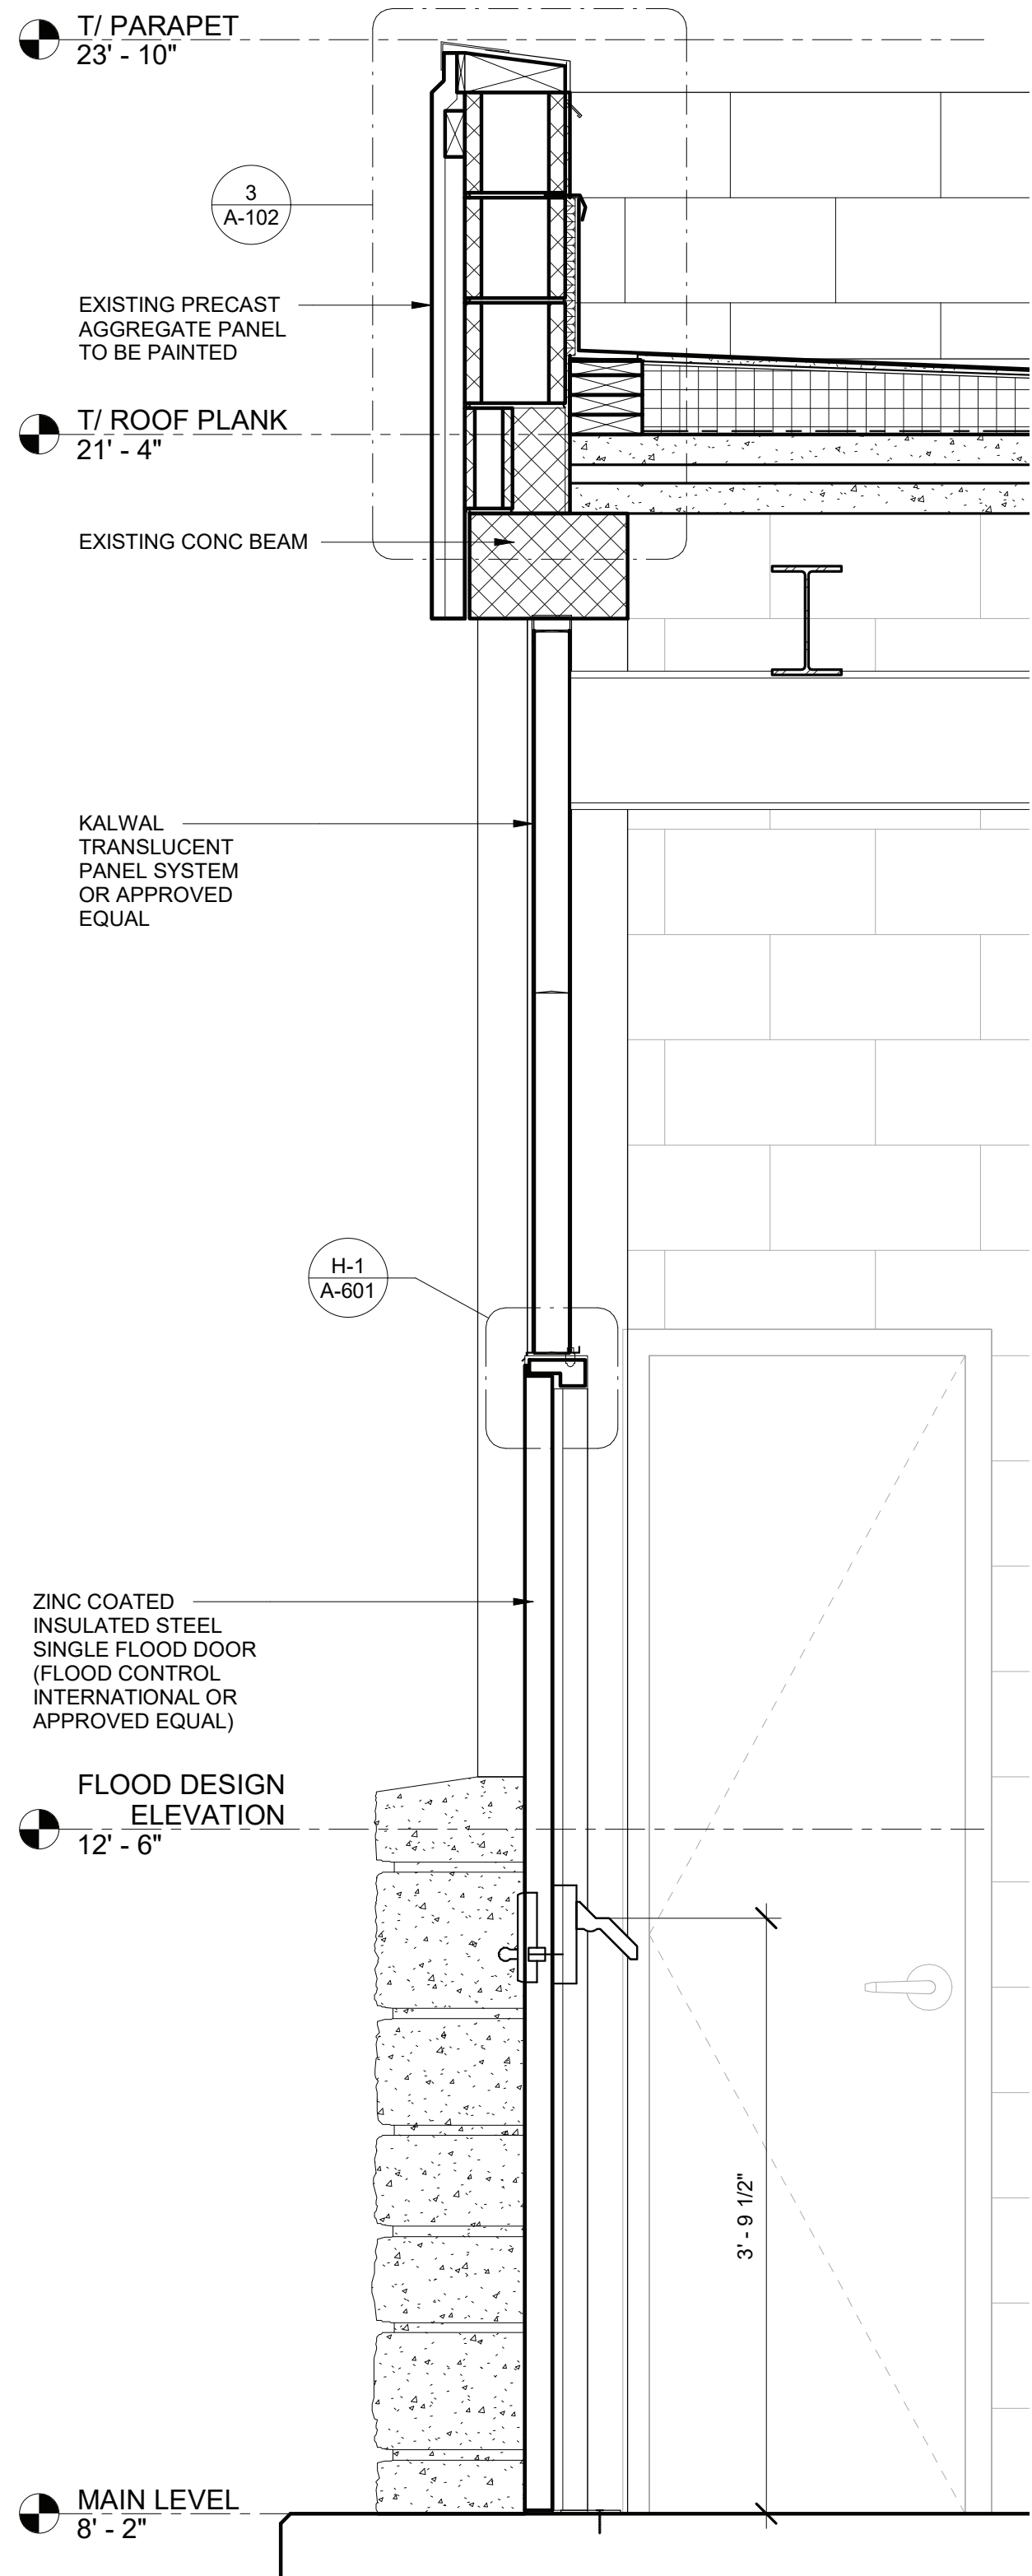

3 SECTION AT WEST WALL FLOOD DOOR
1" = 1'-0"

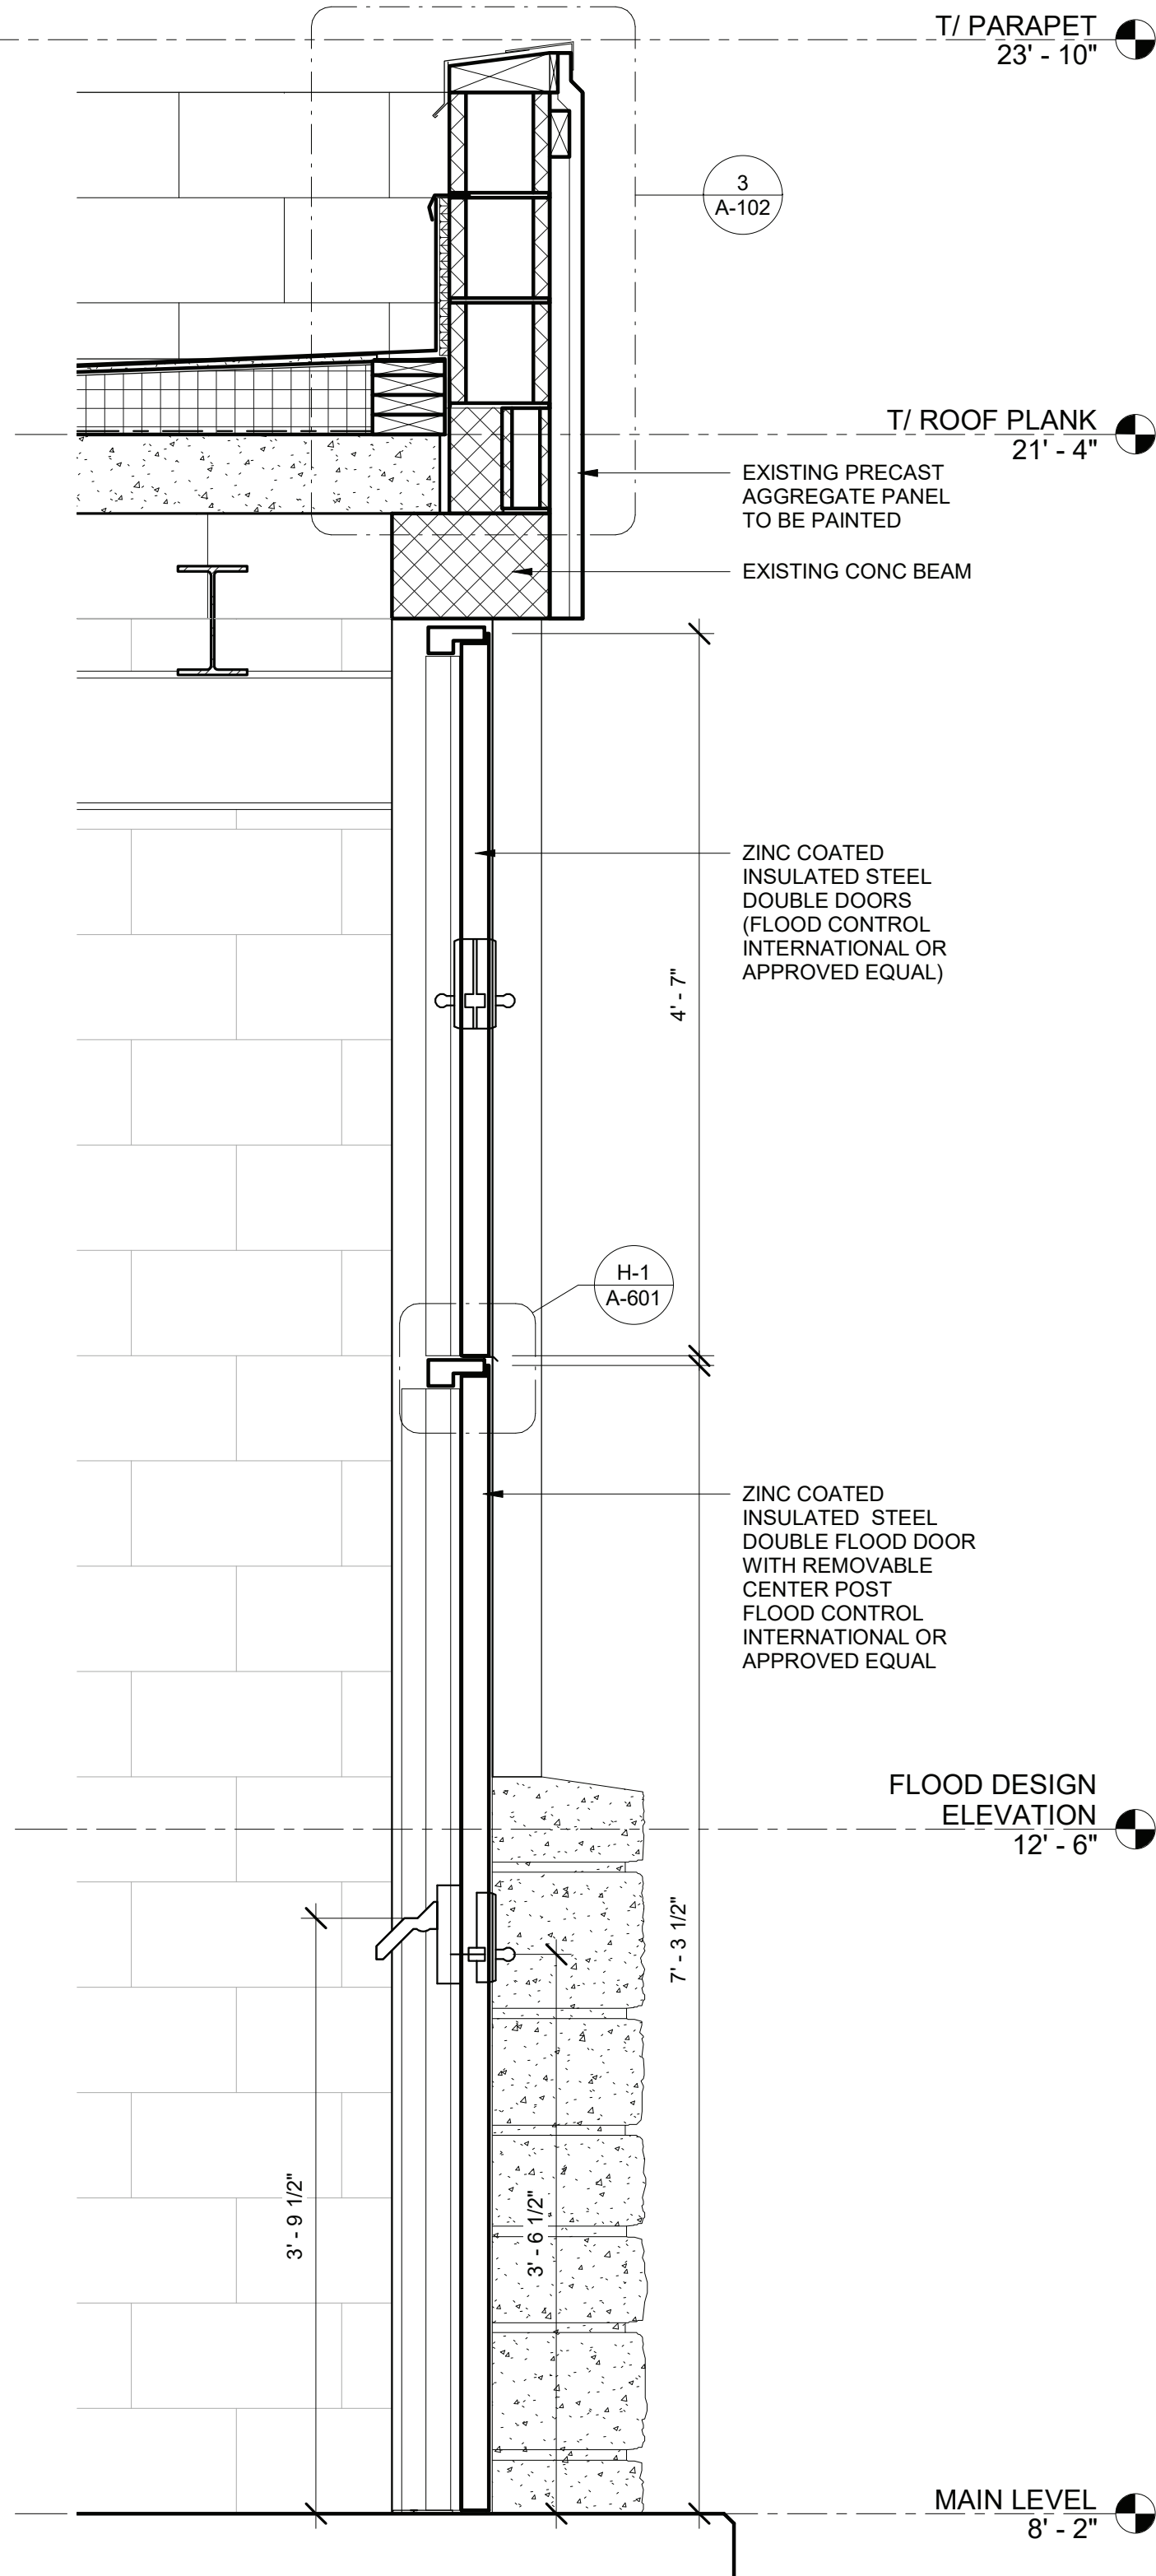


2 SECTION AT DOUBLE FLOOD DOOR
1" = 1'-0"

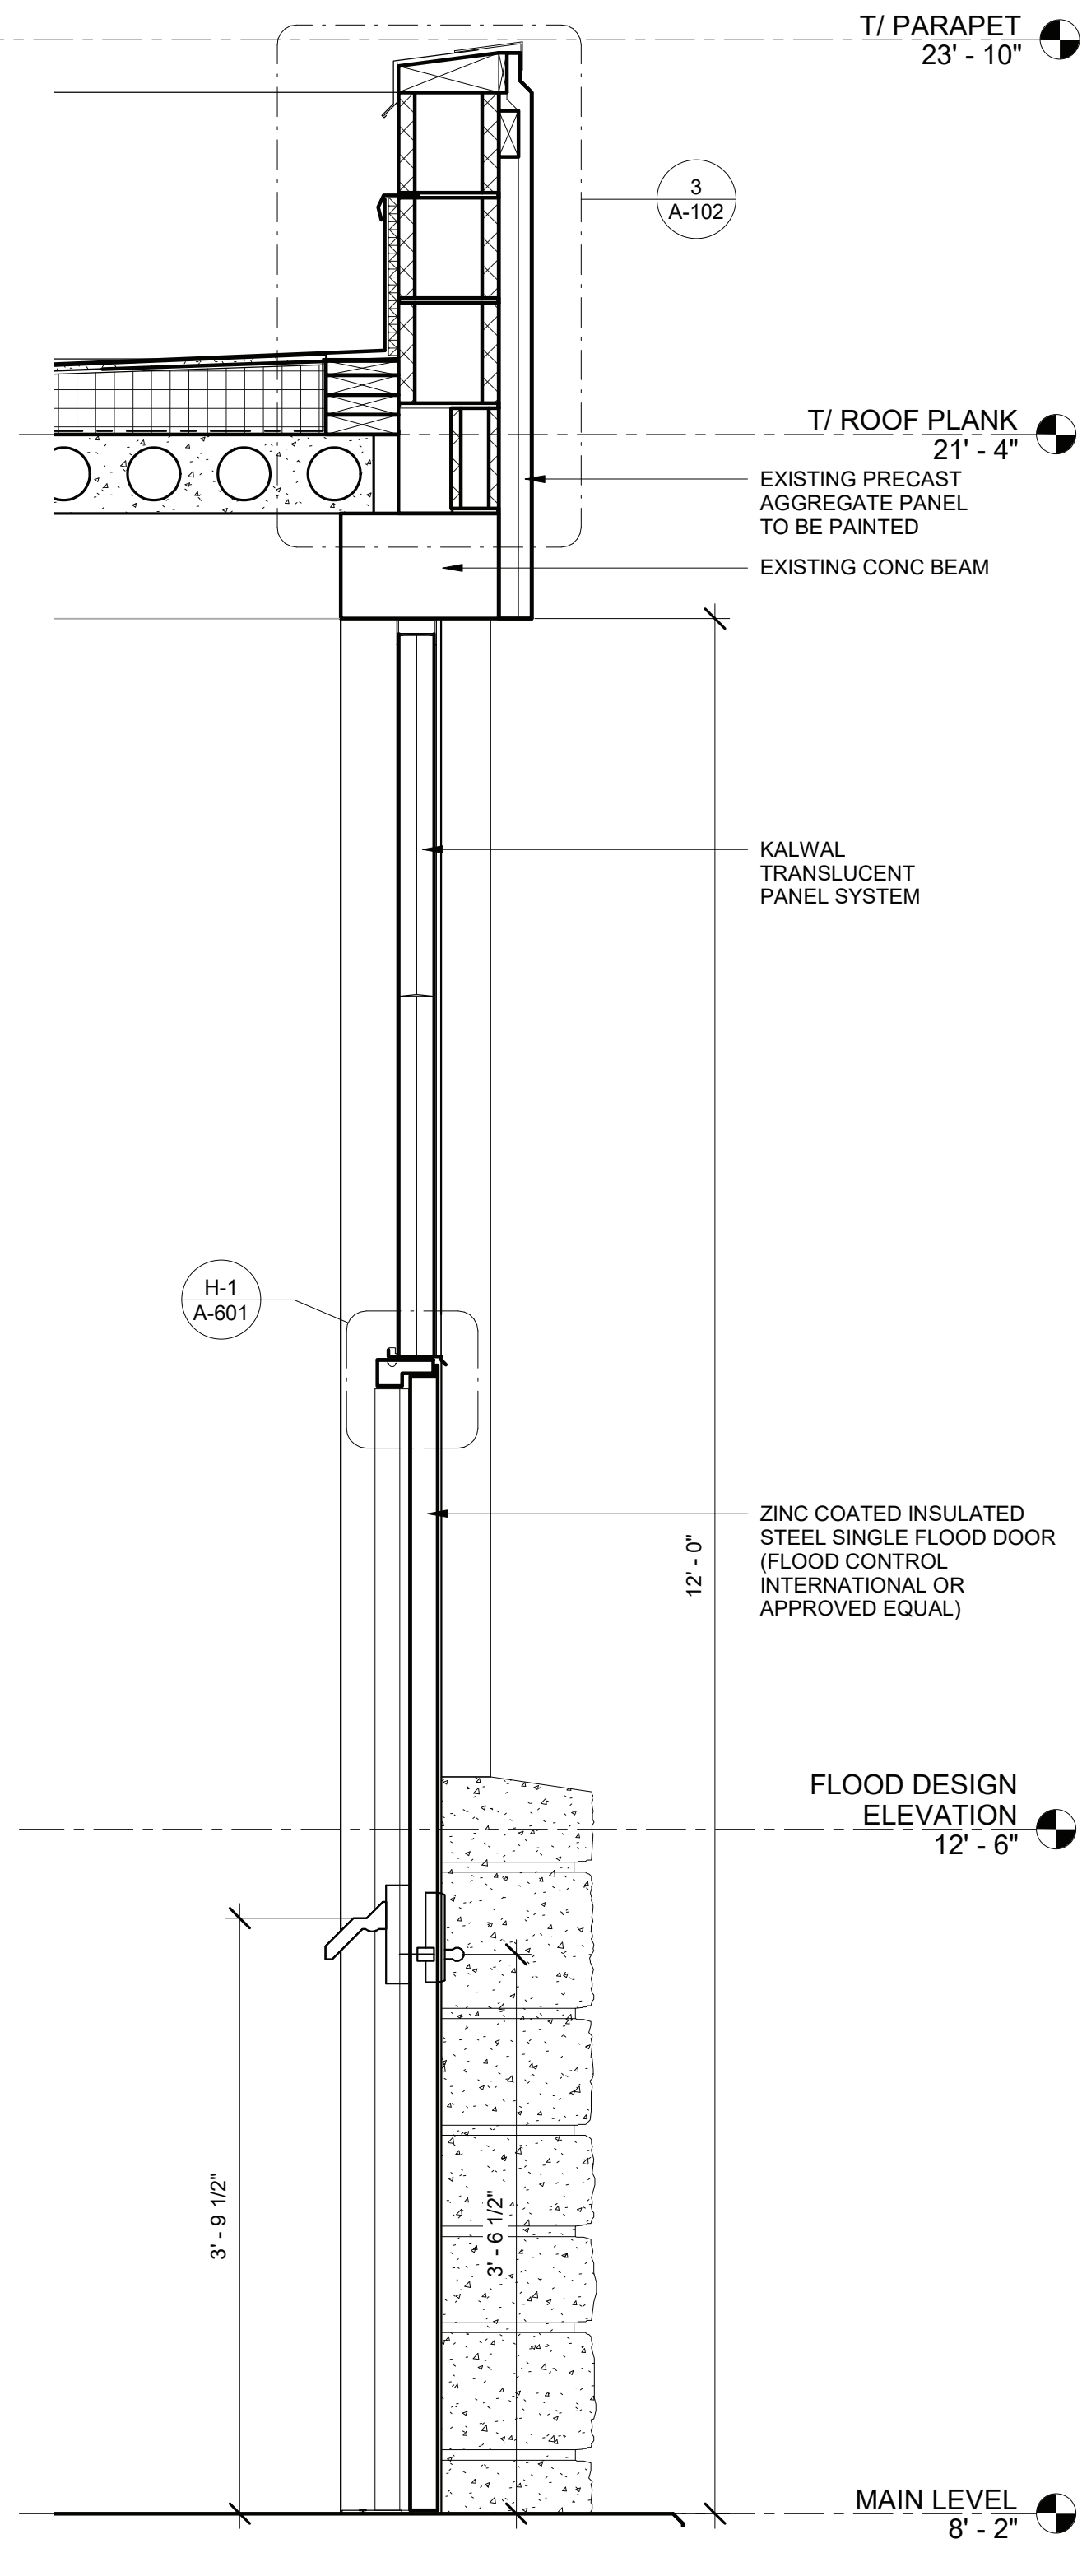


1 SECTION AT SOUTH WALL FLOOD DOOR
1" = 1'-0"

		IN ACCORDANCE WITH TITLE VIII, ARTICLE 145, SECTION 7209 (2) OF THE NEW YORK STATE EDUCATION LAW, IT IS A VIOLATION OF LAW FOR ANY PERSON UNLESS ACTING UNDER THE DIRECTION OF A LICENSED ENGINEER TO ALTER THIS DOCUMENT.																												
07/09/21		IN CHARGE OF <u>LWW</u>		O'BRIEN & GERE ENGINEERS, INC.																										
		CHECKED BY <u>WEC</u>		50 MAIN ST., 10TH FLOOR SUITE 1000,																										
		MADE BY <u>LER</u>		WHITE PLAINS, NEW YORK 10606																										
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CONTRACT NUMBER 17-529			SHEET NUMBER A-302																											
WESTCHESTER COUNTY, NEW YORK DEPARTMENT OF PUBLIC WORKS AND TRANSPORTATION DIVISION OF ENGINEERING			SHEET NO. 22 OF 60																											
CROTONVILLE PUMPING STATION REHABILITATION			SCALE: AS NOTED DATE: 12/21/18																											
OSSINING, NEW YORK SECTIONS AT FLOOD DOORS			DPW FILE NO. 208-03-A-46-0																											
			REV. NO. 0																											

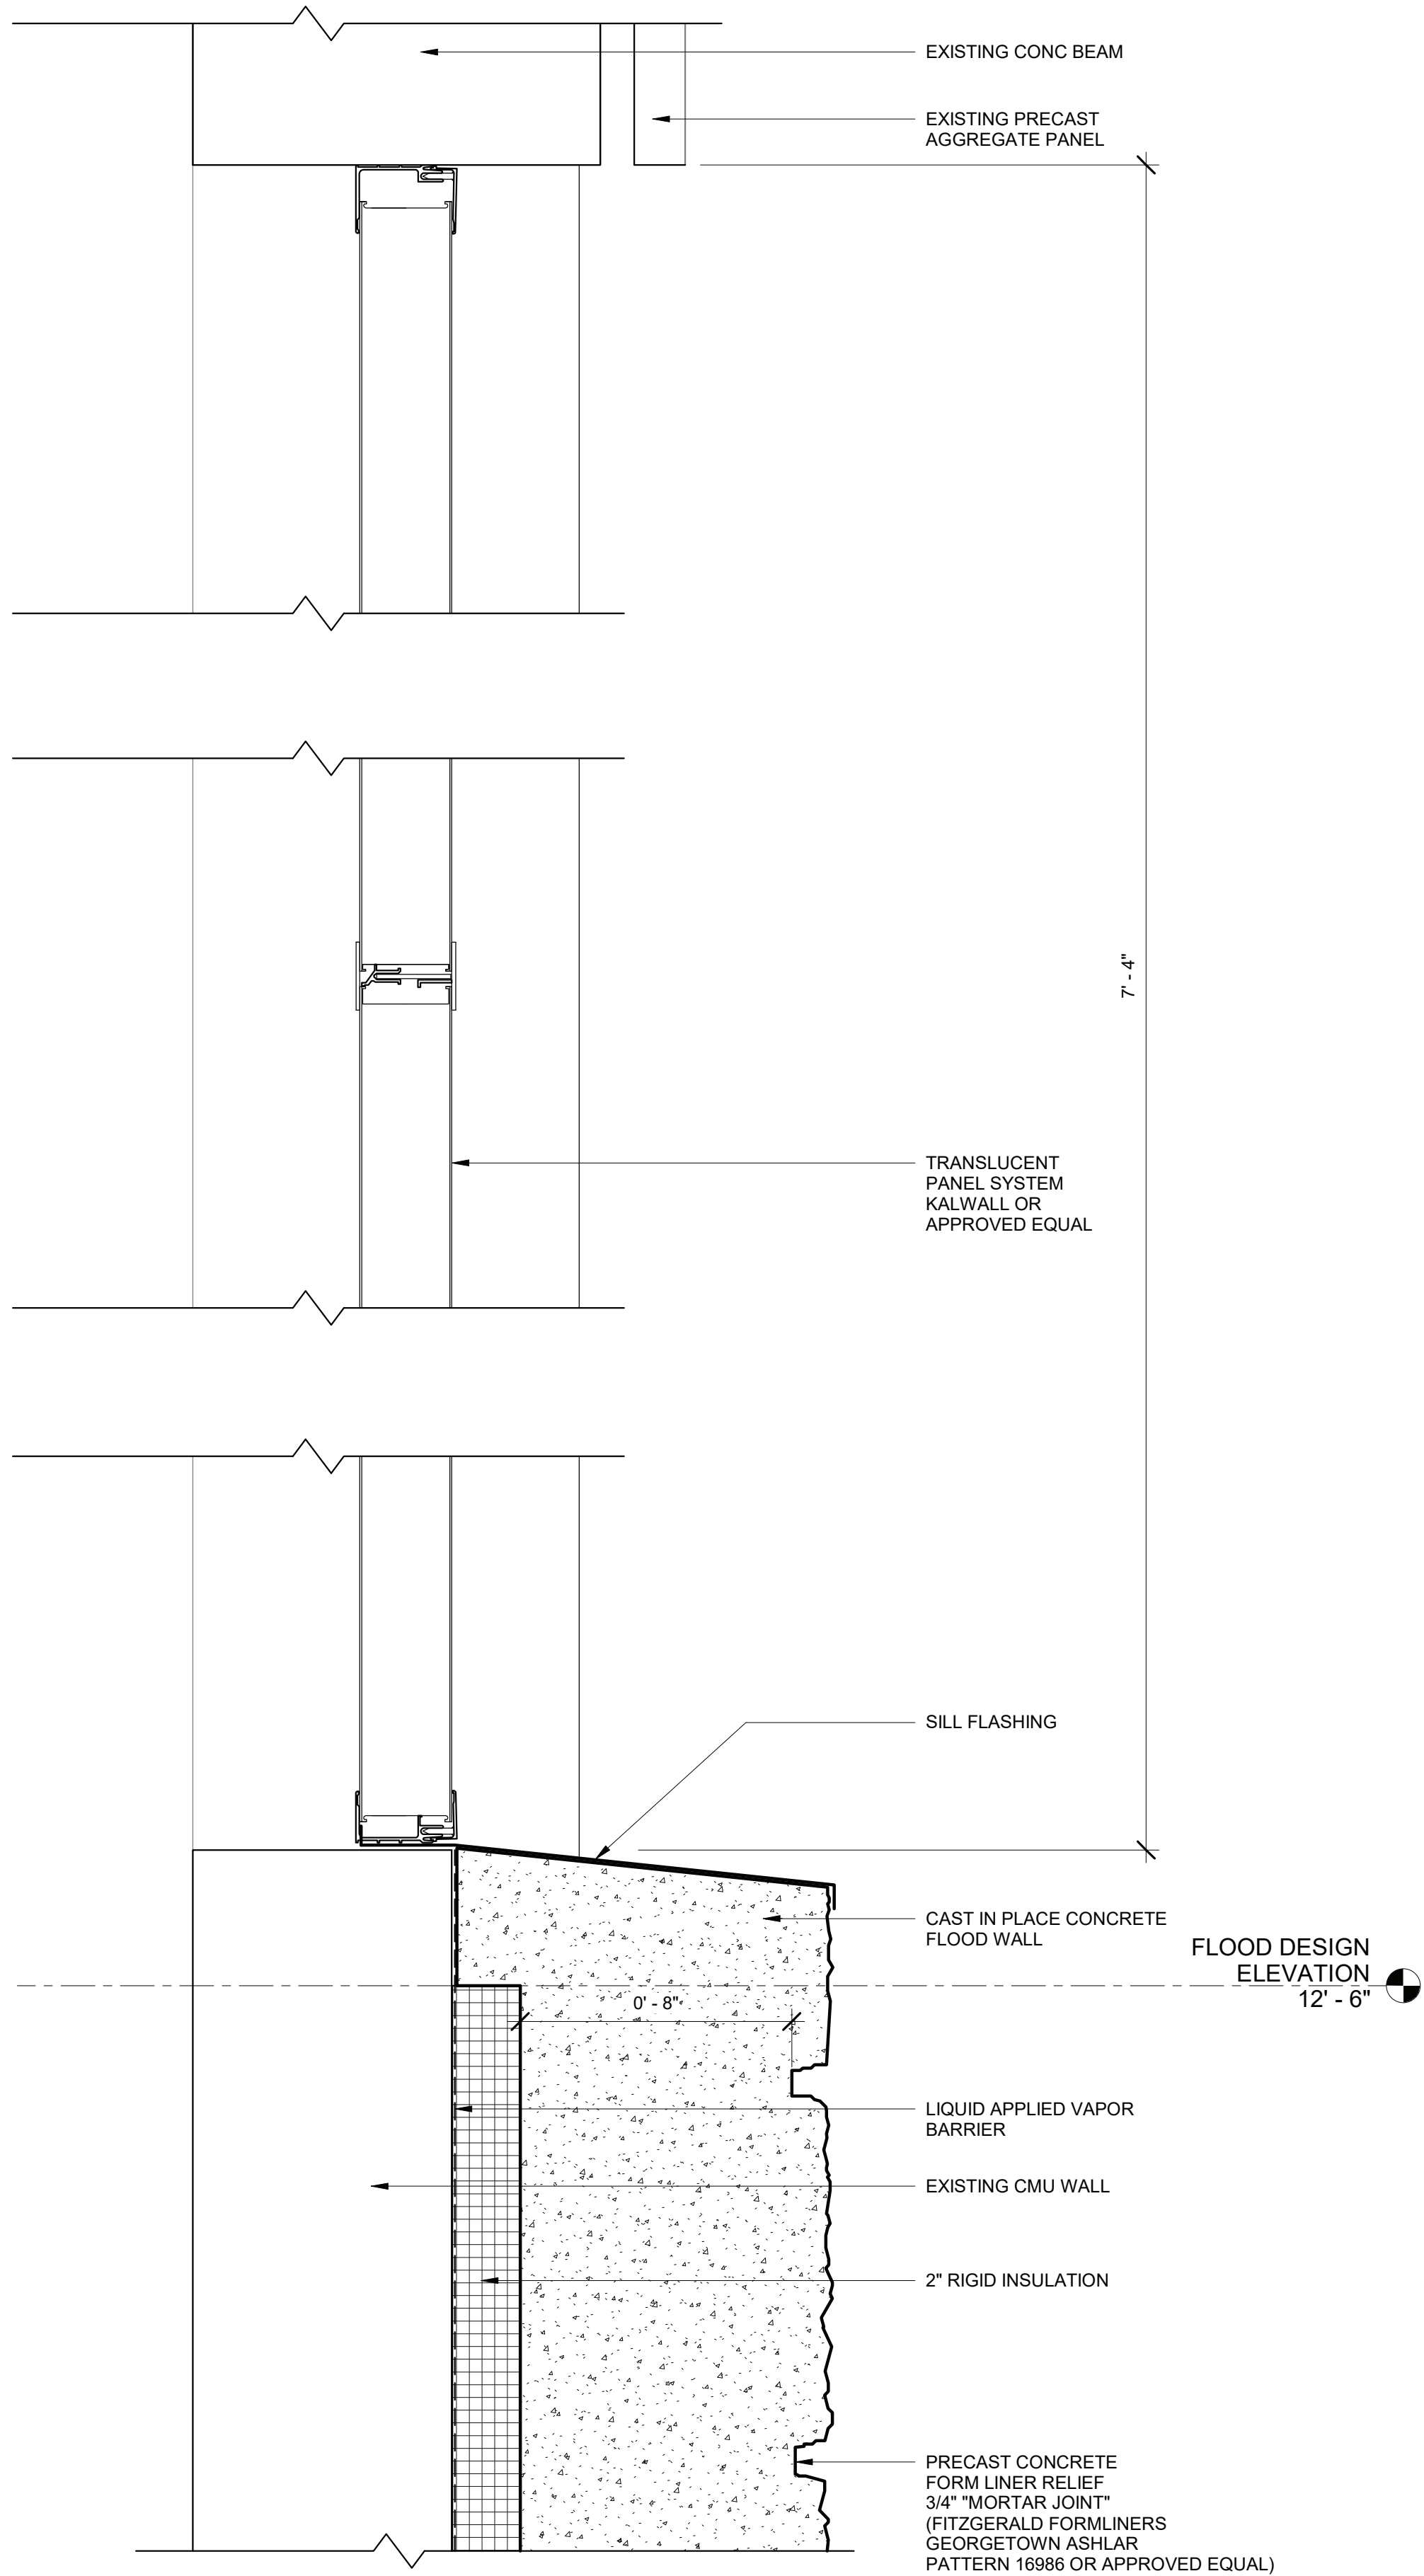

2 SECTION AT TRANSLUCENT PANEL SYSTEM
3" = 1'-0"
2" 1" 0 3" 6"

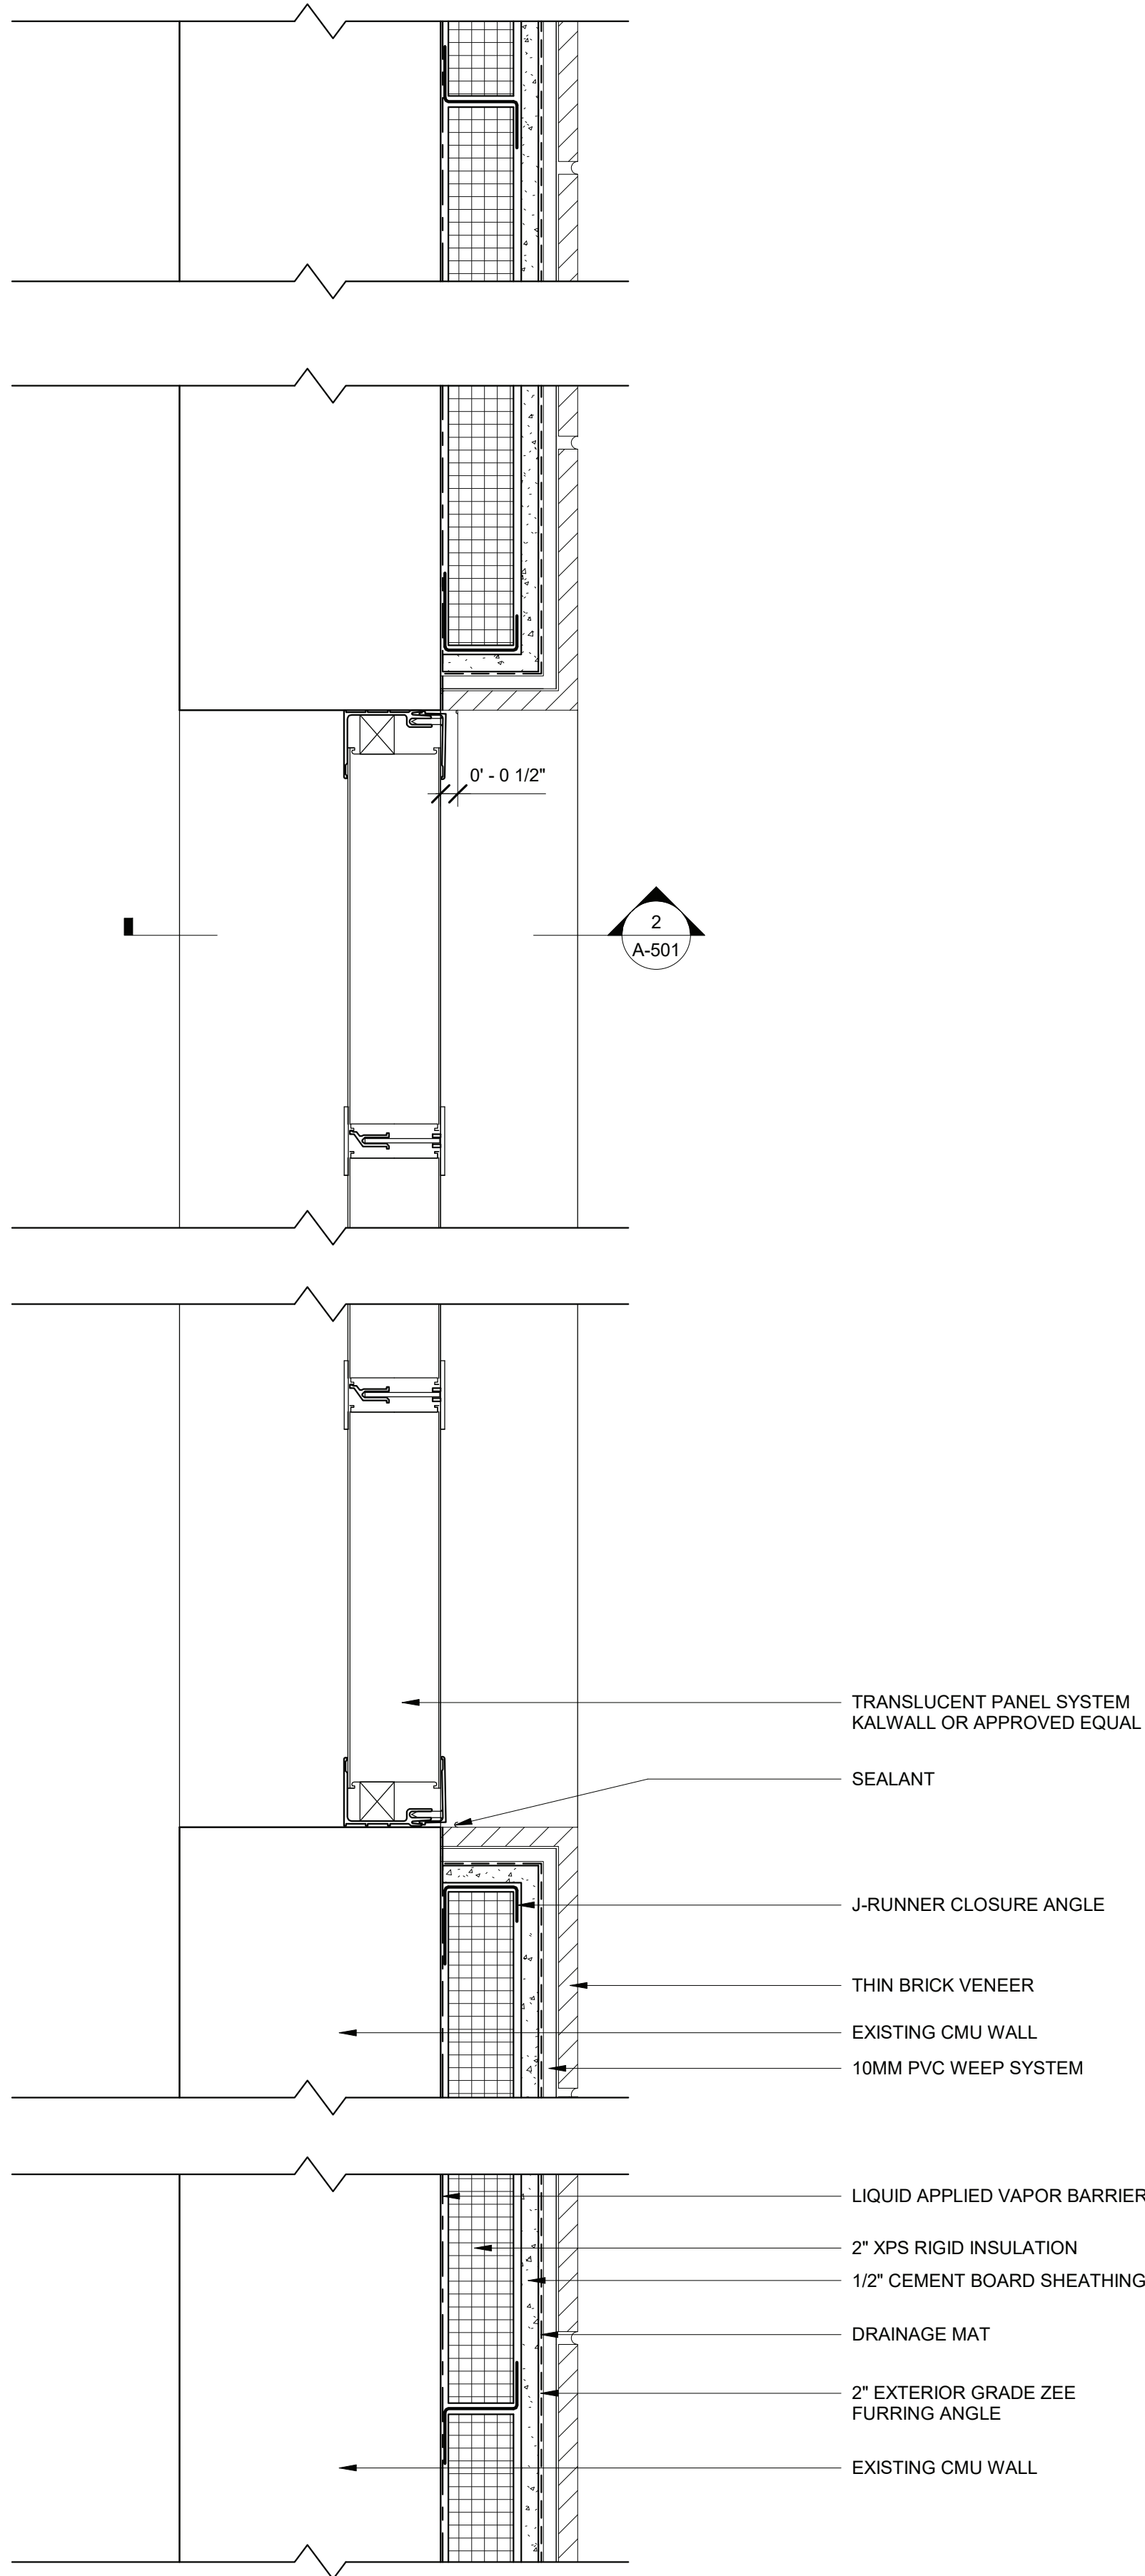

1 PLAN DETAIL AT TRANSLUCENT PANEL
3" = 1'-0"
2" 1" 0 3" 6"



07/09/21

IN ACCORDANCE WITH TITLE VIII, ARTICLE 145, SECTION 7209 (2) OF THE NEW YORK STATE EDUCATION LAW, IT IS A VIOLATION OF LAW FOR ANY PERSON UNLESS ACTING UNDER THE DIRECTION OF A LICENSED ENGINEER TO ALTER THIS DOCUMENT.


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CHECKED BY WEC
MADE BY LER




O'BRIEN & GERE ENGINEERS, INC.
50 MAIN ST., 10TH FLOOR SUITE 1000,
WHITE PLAINS, NEW YORK 10606

REVISION NUMBER	DATE	MADE BY	APP'D BY	REVISION
RECORD DRAWING CERTIFICATION				
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CONTRACTOR			PROJECT COORDINATOR	
NAME		NAME		
SIGNATURE		SIGNATURE		
TITLE		TITLE		
DATE		DATE		
WESTCHESTER COUNTY, NEW YORK			CONTRACT NUMBER	SHEET NUMBER
DEPARTMENT OF PUBLIC WORKS AND TRANSPORTATION			17-529	A-501
DIVISION OF ENGINEERING			SHEET NO. 23	OF 60
CROTONVILLE PUMPING STATION REHABILITATION			SCALE: AS NOTED	
OSSINING, NEW YORK			DATE: 12/21/18	
TRANSLUCENT PANEL DETAILS			DPW FILE NO.	REV. NO.
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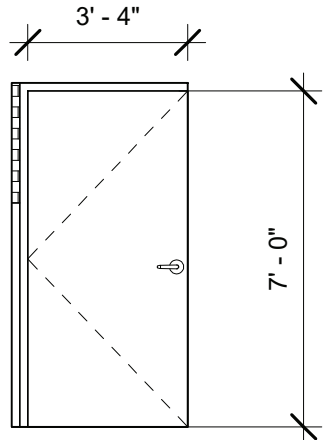
DOOR SCHEDULE																
DOOR NUMBER	ROOM NAME	DOOR					FRAME					FIRE RATING	HARDWARE GROUP	COMMENTS	DOOR NUMBER	
		TYPE	MATERIAL	WIDTH	HEIGHT	FINISH	TYPE	MATERIAL	HEAD	JAMB	SILL					FINISH
1	ELECTRICAL ROOM	D-3	GALV STL	3' - 4"	7' - 0"	MANUFACTURED POWDER COAT FINISH	F-2	GALV STL	H-1	J-1	S-1	MANUFACTURED POWDER COAT FINISH	-		FLOOD DOOR	1
2	SCREENINGS	D-2	GALV STL	3' - 8"	7' - 0"	MANUFACTURED POWDER COAT FINISH	F-2	GALV STL	H-1	J-1	S-1	MANUFACTURED POWDER COAT FINISH	-		FLOOD DOOR	2
3	STAIR	D-2	GALV STL	3' - 8"	7' - 0"	MANUFACTURED POWDER COAT FINISH	F-2	GALV STL	H-1	J-1	S-1	MANUFACTURED POWDER COAT FINISH	-		FLOOD DOOR	3
4	ELECTRICAL ROOM	D-1	GALV STL	6' - 0"	7' - 0"	MANUFACTURED POWDER COAT FINISH	F-1	GALV STL	H-2	J-1	S-1	MANUFACTURED POWDER COAT FINISH	-		FLOOD DOOR	4

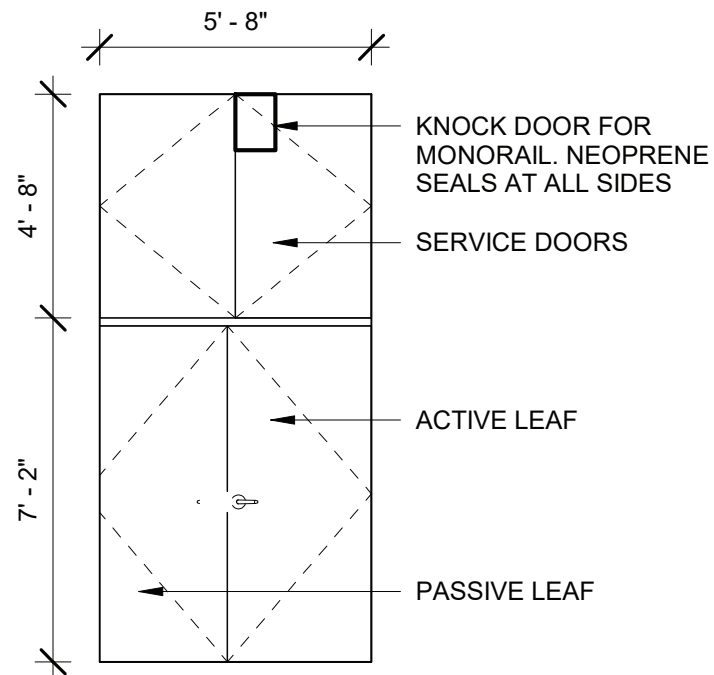


D-1
1/4" = 1'-0"

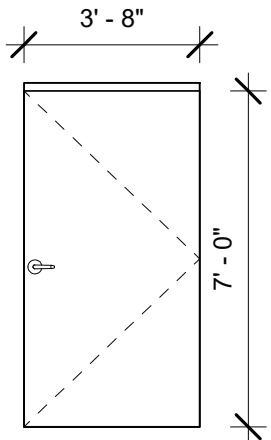


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1/4" = 1'-0"




D-3
1/4" = 1'-0"

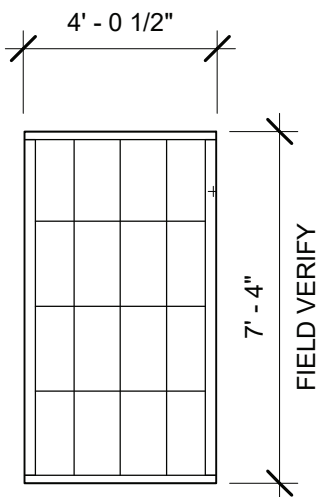


W1
1/4" = 1'-0"

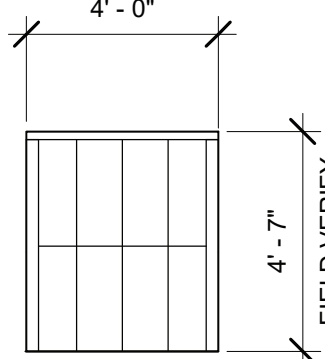


W2
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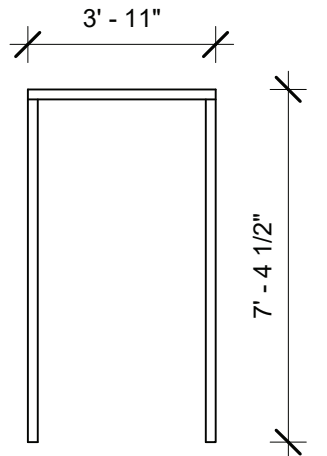
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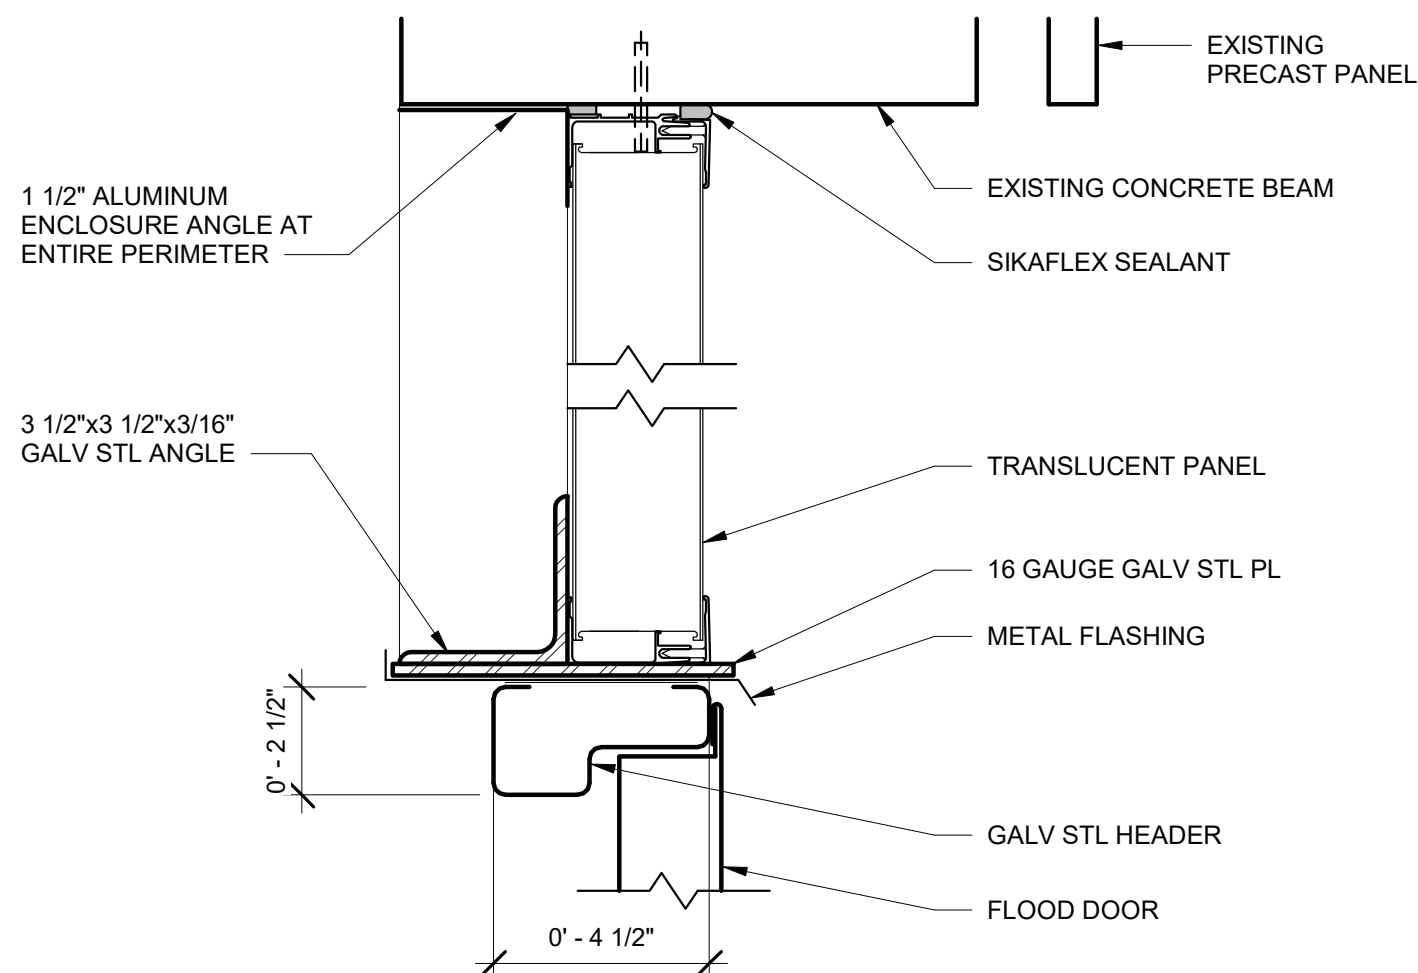
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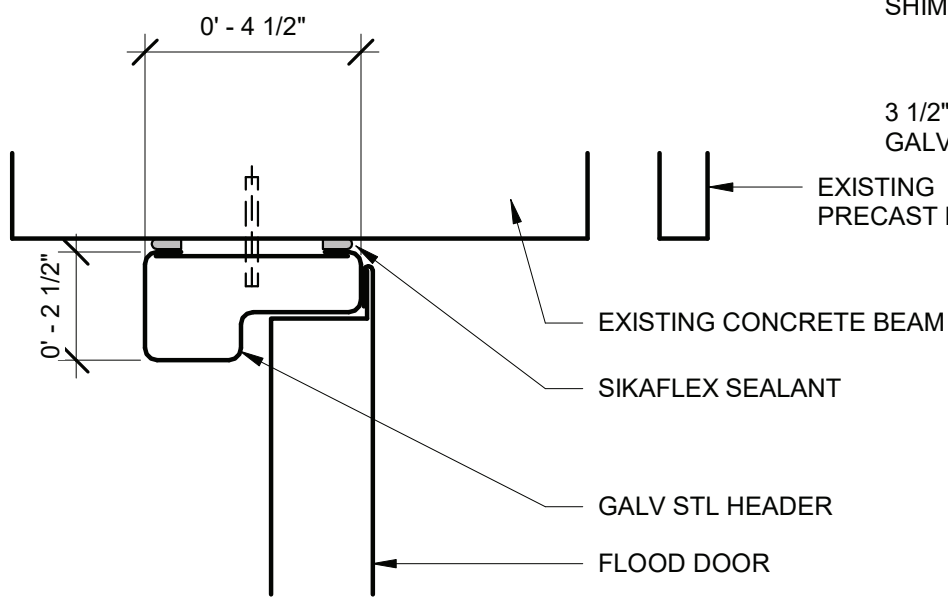
F-1
1/4" = 1'-0"

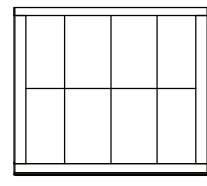


F-2
1/4" = 1'-0"

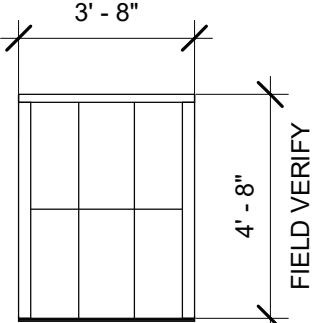


H-1
3" = 1'-0"

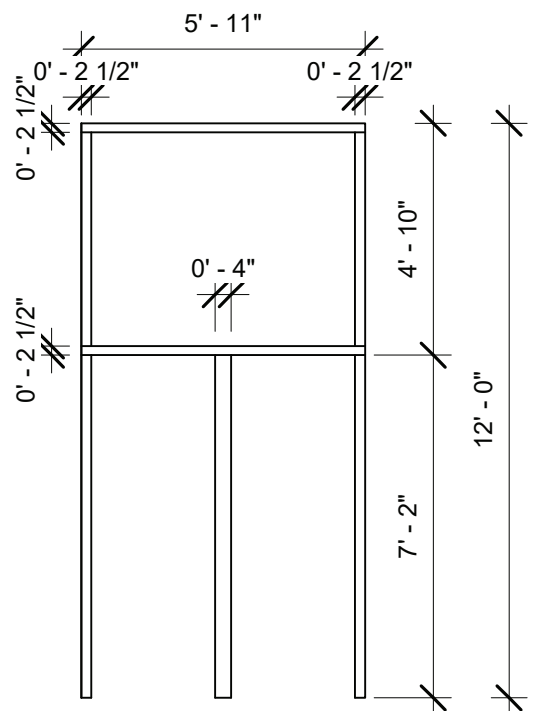


H-2
3" = 1'-0"

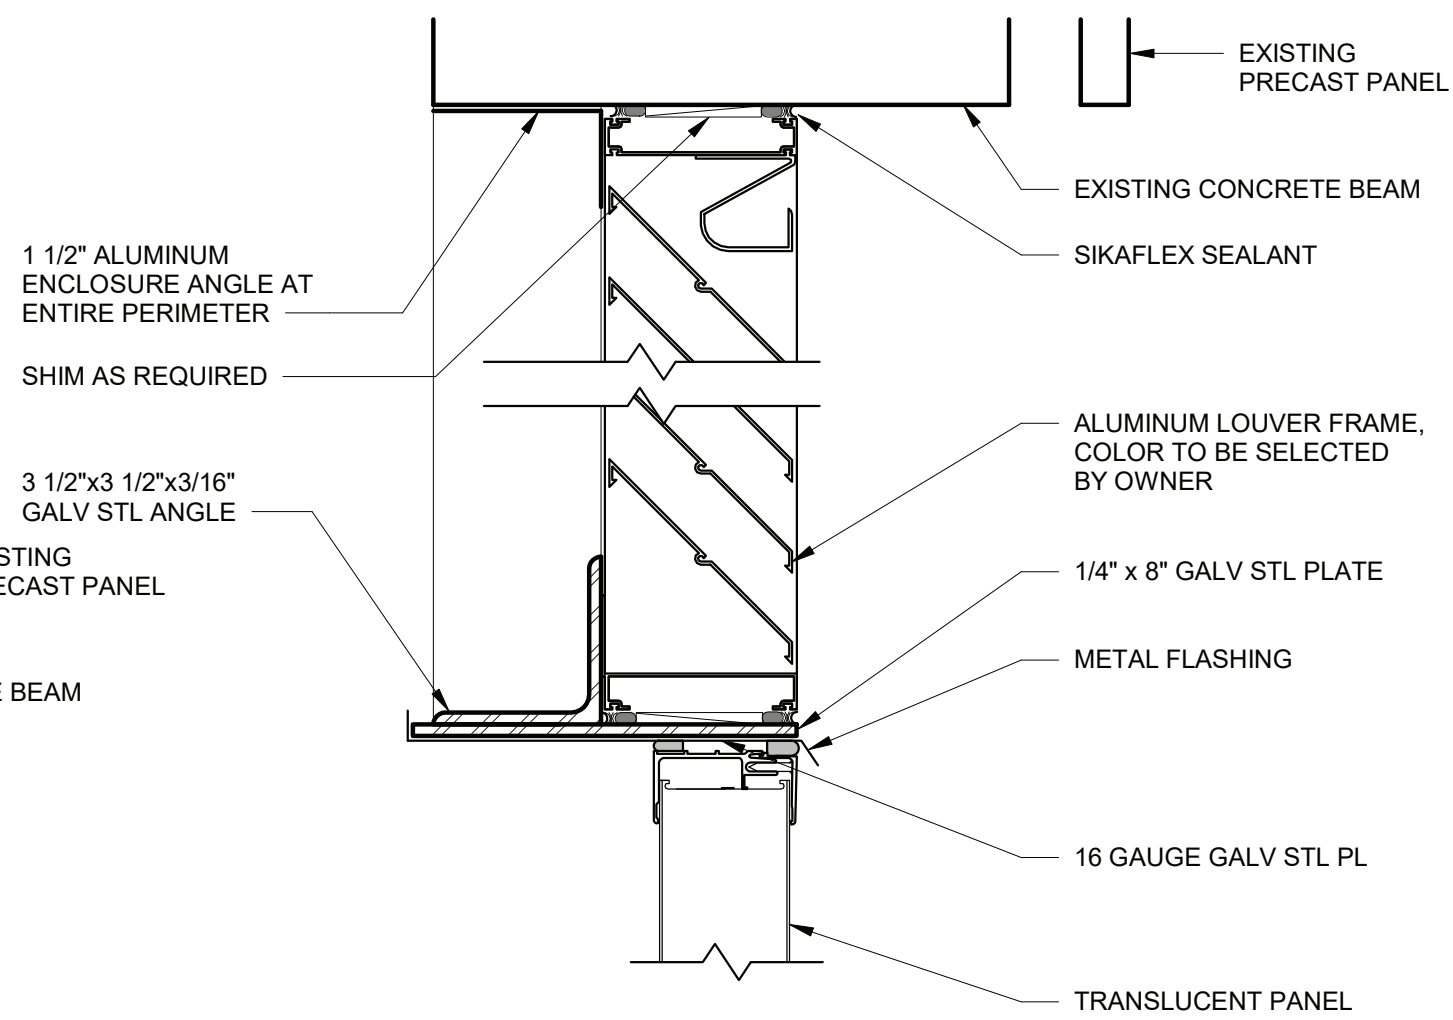

H-3
3" = 1'-0"

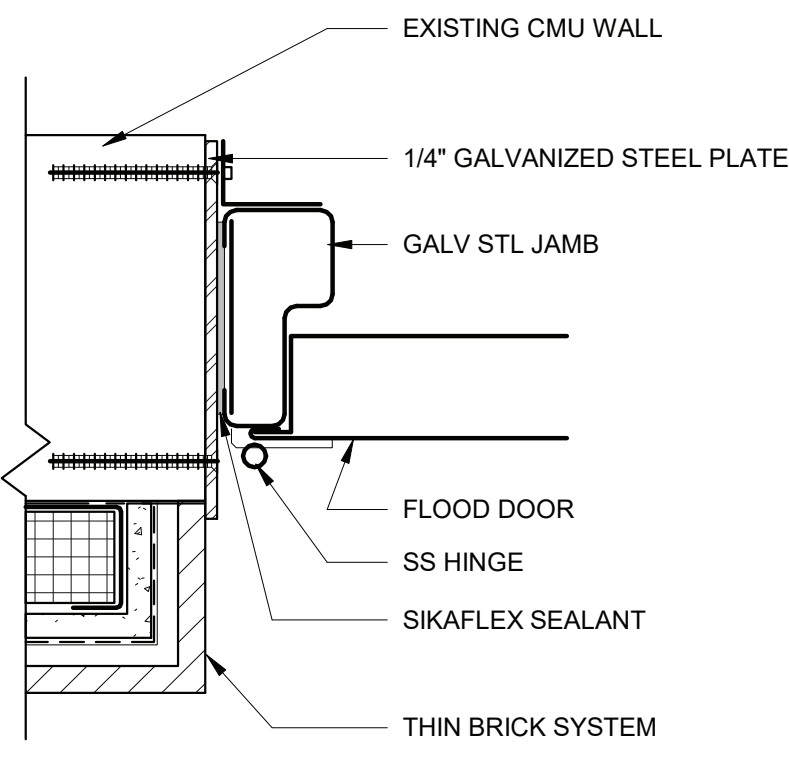

J-1
3" = 1'-0"

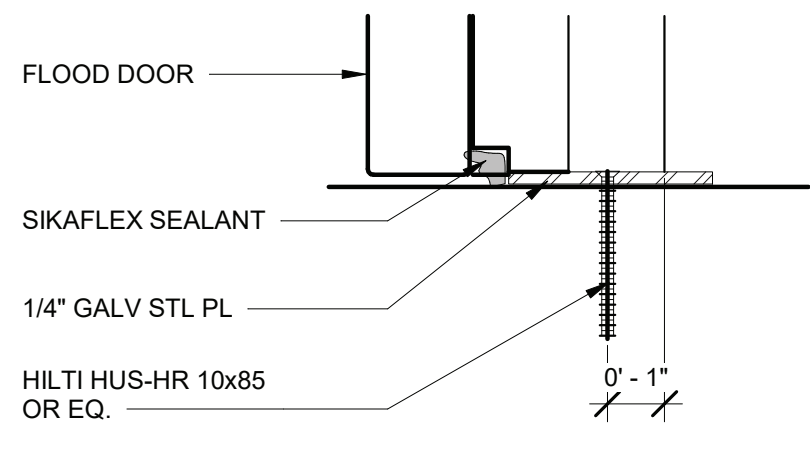

S-1
3" = 1'-0"

NOTE:
SEE SHEET A-501 FOR
TRANSLUCENT PANEL DETAILS



SIGNAGE
3" = 1'-0"

WHITE BACKGROUND WITH
BLACK LETTERING

SIGN DIMENSIONS: 10" W X 14" H

PROVIDE (1) MINIMUM SIGN AT ALL
NON-POTABLE WATER TAPS, HOSE
BIBS, WALL HYDRANTS, ETC.



PIPE MARKER
6" = 1'-0"

SELF ADHESIVE PIPE MARKER (6 1/2" X 1")
GREEN WITH WHITE LETTERING
PROVIDE AT 9'-0" INTERVALS
COORDINATE LOCATION WITH PLUMBING
CONTRACTOR



07/09/21

IN ACCORDANCE WITH TITLE VIII,
ARTICLE 145, SECTION 7209 (2) OF THE
NEW YORK STATE EDUCATION LAW, IT
IS A VIOLATION OF LAW FOR ANY
PERSON UNLESS ACTING UNDER THE
DIRECTION OF A LICENSED ENGINEER
TO ALTER THIS DOCUMENT.

IN CHARGE OF LWW


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MADE BY LER






O'BRIEN & GERE ENGINEERS, INC.
50 MAIN ST., 10TH FLOOR SUITE 1000,
WHITE PLAINS, NEW YORK 10606

REVISION NUMBER	DATE	MADE BY	APP'D BY	REVISION
RECORD DRAWING CERTIFICATION				
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CONTRACTOR		PROJECT COORDINATOR		
NAME	SIGNATURE	NAME	SIGNATURE	DATE
WESTCHESTER COUNTY, NEW YORK		DEPARTMENT OF PUBLIC WORKS AND TRANSPORTATION		
DIVISION OF ENGINEERING		SHEET NO. 24 OF 60		
CROTONVILLE PUMPING STATION REHABILITATION		SCALE: AS NOTED DATE: 12/21/18		
OSSINING, NEW YORK SCHEDULES AND DETAILS		DPW FILE NO. 208-03-A-48-0 REV. NO. 0		

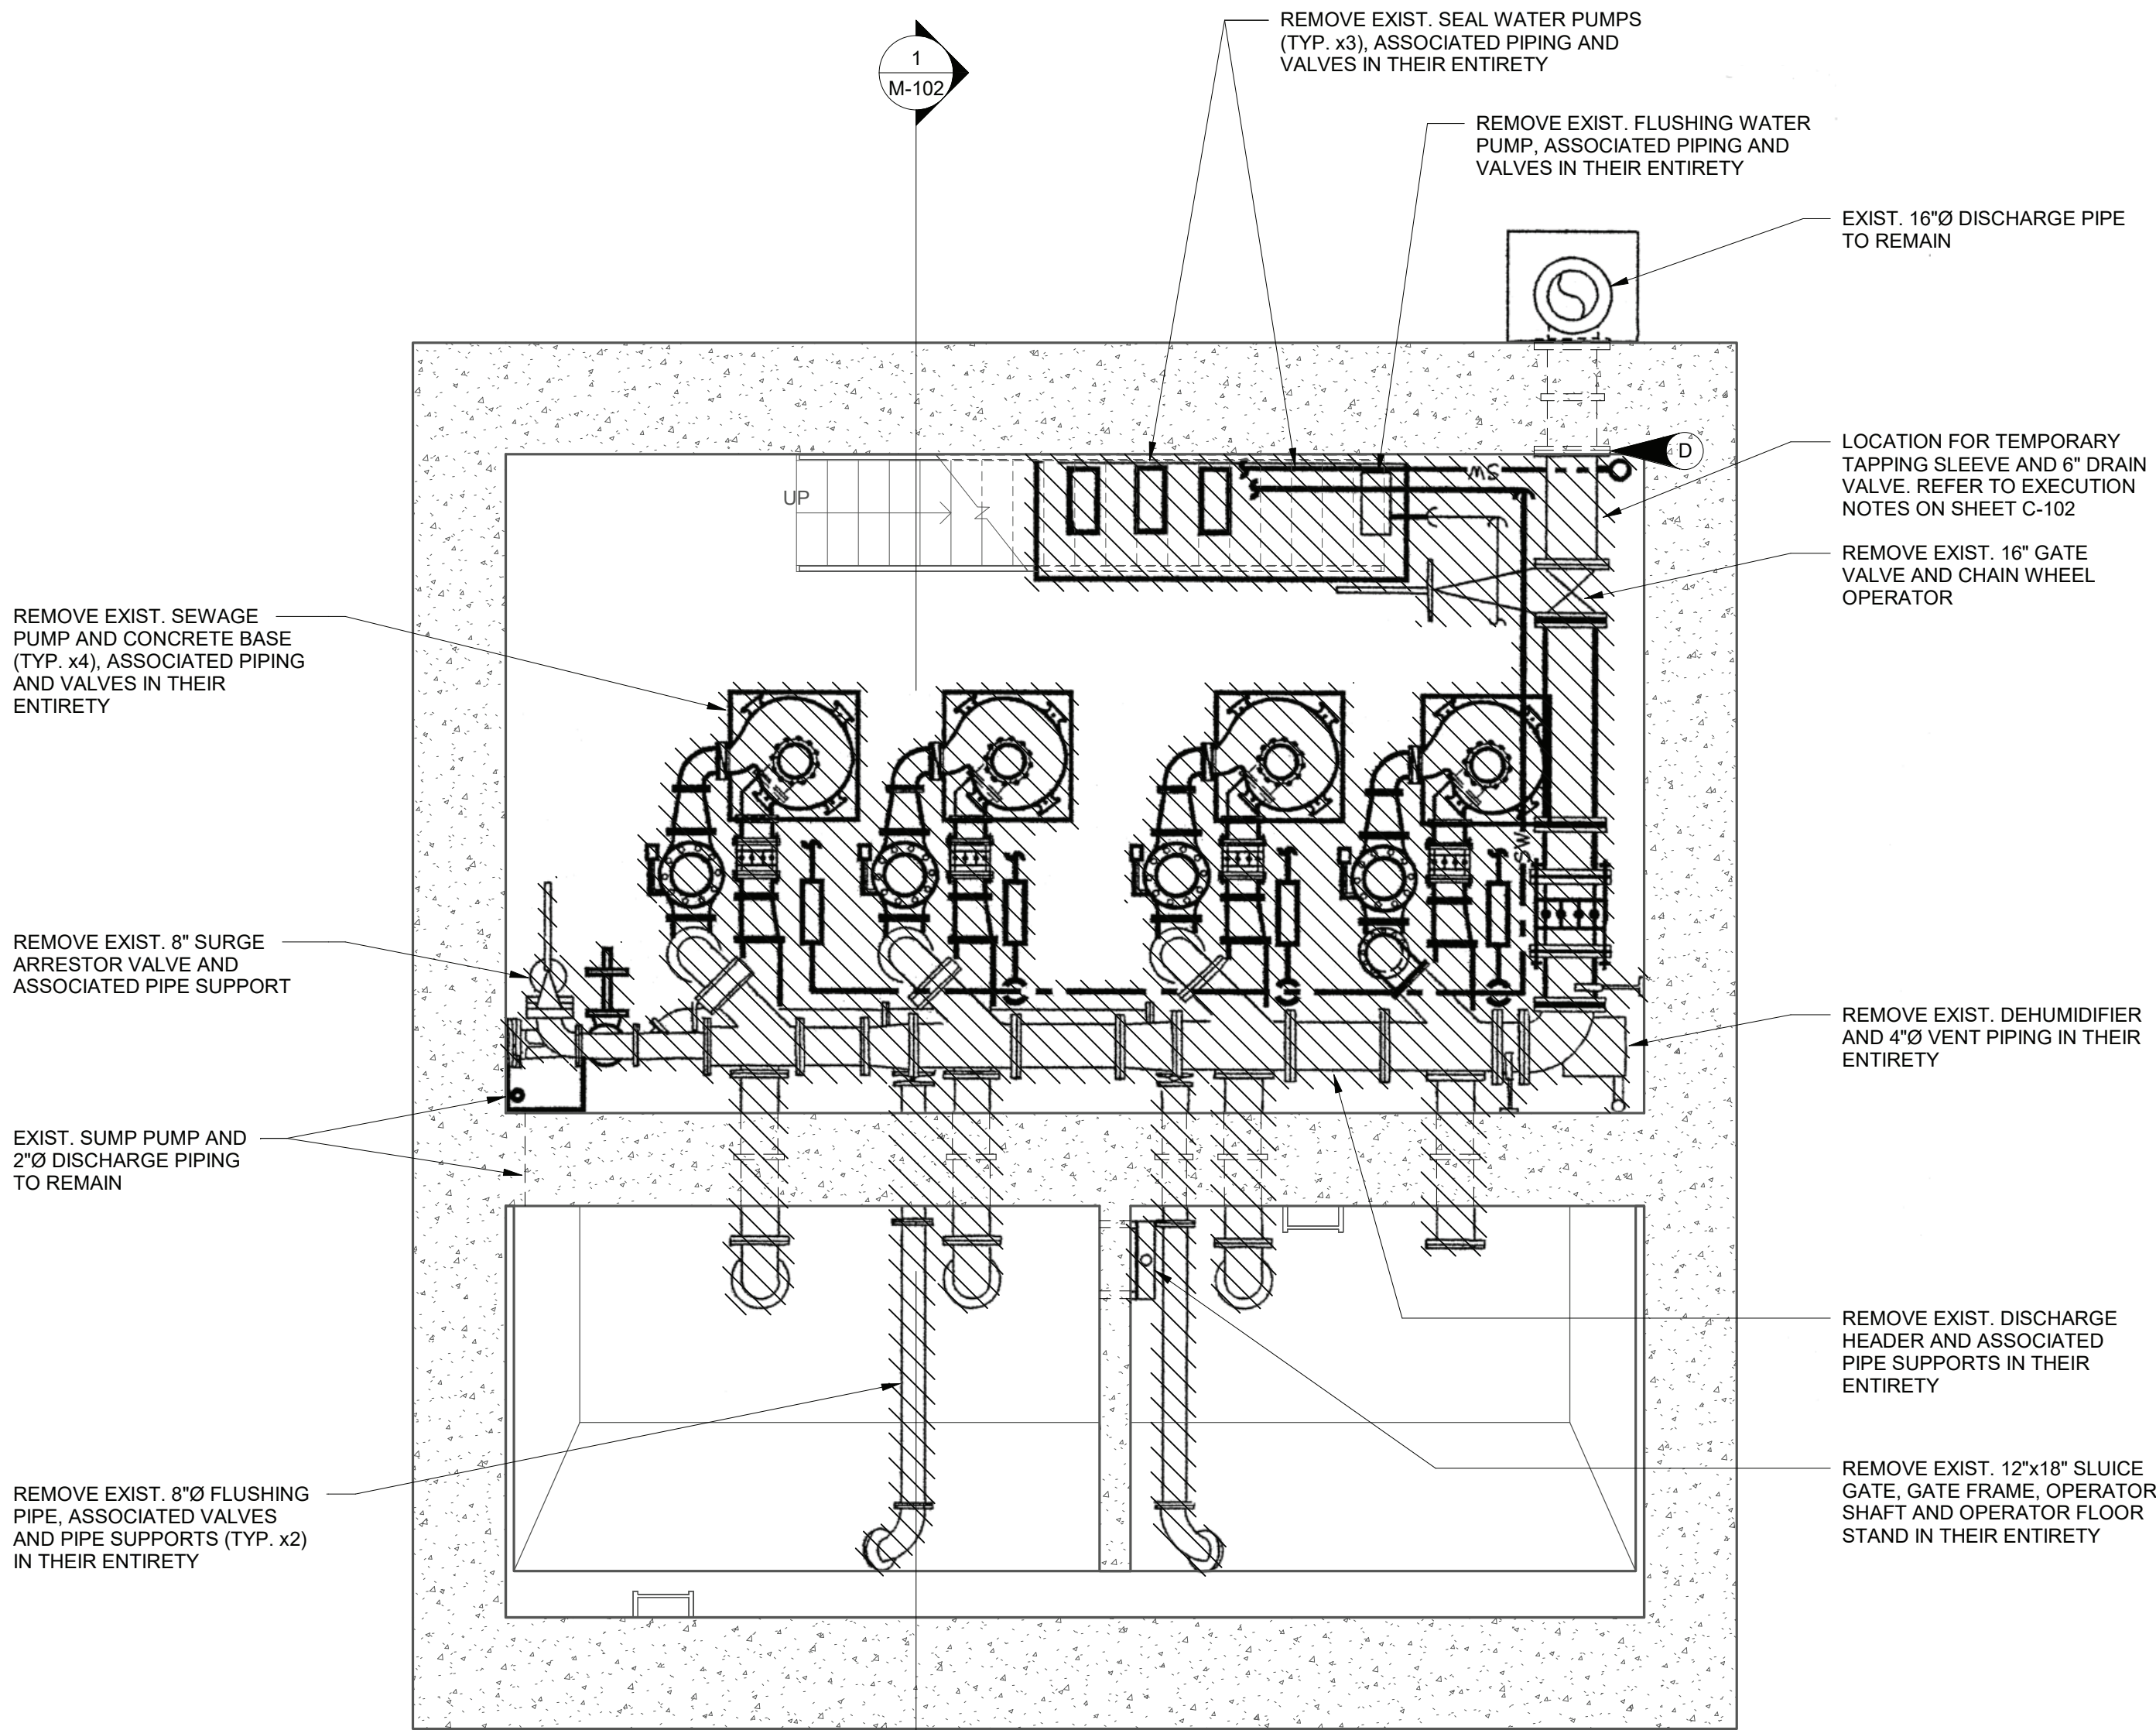



LOWER LEVEL DEMOLITON PLAN

1/4" = 1'-0"

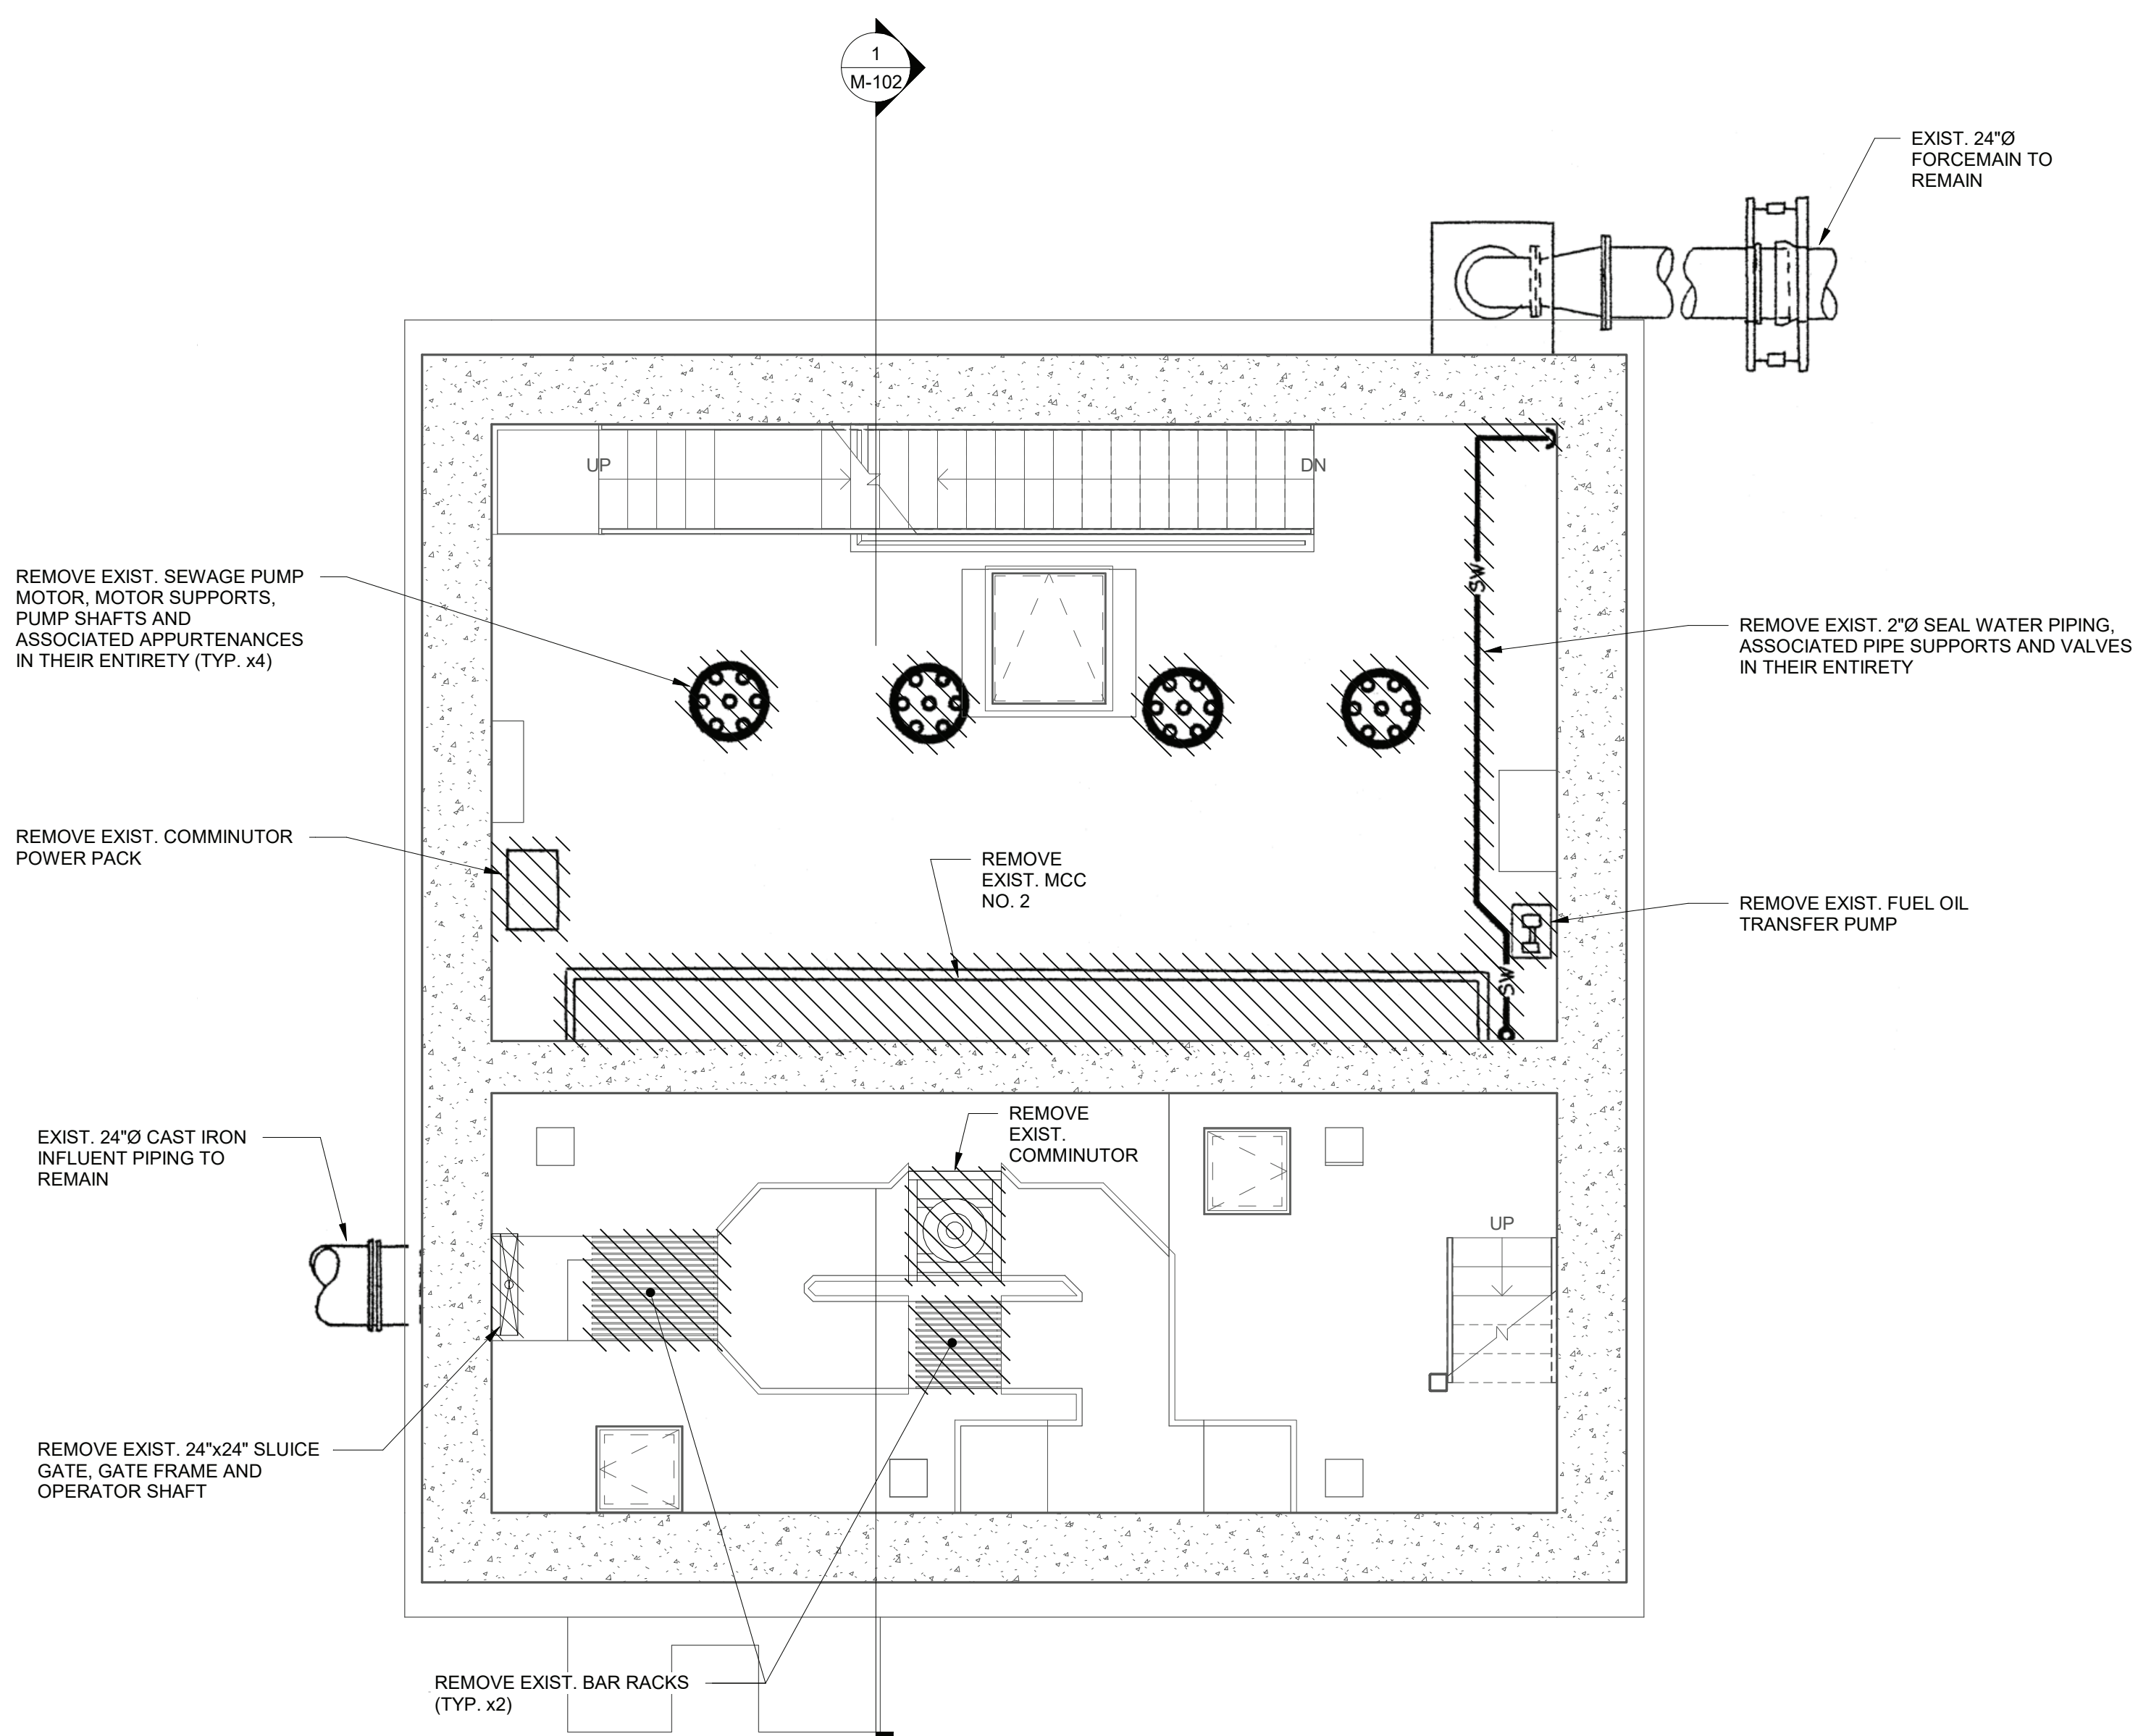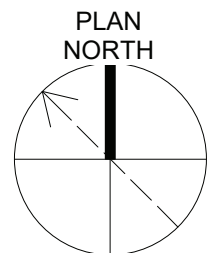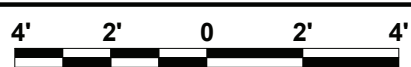

MIDDLE LEVEL DEMOLITION PLAN

1/4" = 1'-0"

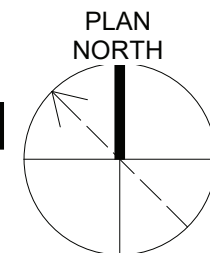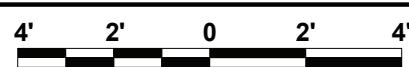

NOTES:

- EXISTING DIMENSIONS, ELEVATIONS AND SIZES HAVE BEEN TAKEN FROM THE FOLLOWING DRAWINGS: "CROTONVILLE PUMP STATION REHABILITATION PROGRAM, PLANS AND SECTIONS, FOR WESTCHESTER COUNTY DEPARTMENT OF PUBLIC WORKS, DIVISION OF ENGINEERING, WESTCHESTER COUNTY, N.Y. BY LYNCH ENGINEERING, PC, PLEASANTVILLE, N.Y. DATED APRIL 26, 1996". ALL SITE MEASUREMENTS, DIMENSIONS, ELEVATIONS AND SIZES ARE TO BE CONSIDERED APPROXIMATE AND FIELD VERIFIED BY THE CONTRACTOR.
- REFER TO ARCHITECTURAL, STRUCTURAL, ELECTRICAL, HVAC AND PLUMBING DRAWINGS FOR RELATED DEMOLITIONS TO BE PERFORMED UNDER THIS PROJECT.
- ALL WALL, FLOOR AND ROOF OPENINGS RESULTING FROM DEMOLITION WORK SHALL BE SEALED AS SPECIFIED. BELOW GRADE AND WET WELL AREA PENETRATIONS SHALL BE SEALED WATERTIGHT.
- UNLESS OTHERWISE NOTED OR SPECIFIED IN THE CONTRACT DOCUMENTS, ALL MATERIALS REMOVED OR DEMOLISHED UNDER THIS PROJECT SHALL BE PROPERLY DISPOSED OF OFF-SITE BY THE CONTRACTOR, AT A LOCATION PROPERLY LICENSED FOR SUCH DISPOSAL.
- UNLESS OTHERWISE NOTED OR SPECIFIED IN THE CONTRACT DOCUMENTS, EXISTING ITEMS SHALL REMAIN. CONTRACTOR SHALL PROTECT EXISTING ITEMS FROM DAMAGE AND DUST DURING WORK. ANY DAMAGED ITEMS SHALL BE REPAIRED OR REPLACED BY THE CONTRACTOR AT NO ADDITIONAL COST TO THE OWNER.
- REMOVE EXISTING PIPE SUPPORTS. PATCH ANY HOLES TO MATCH EXISTING SURFACES.



DocuSign

IN ACCORDANCE WITH TITLE VIII, ARTICLE 145, SECTION 7209 (2) OF THE NEW YORK STATE EDUCATION LAW, IT IS A VIOLATION OF LAW FOR ANY PERSON UNLESS ACTING UNDER THE DIRECTION OF A LICENSED ENGINEER TO ALTER THIS DOCUMENT.

IN CHARGE OF R. GELL
CHECKED BY D. ROONEY
MADE BY T. LARAMAY





O'BRIEN & GERE ENGINEERS, INC.
50 MAIN ST., 10TH FLOOR SUITE 1000,
WHITE PLAINS, NEW YORK 10606



REVISION NUMBER	DATE	MADE BY	APP'D BY	REVISION


RECORD DRAWING CERTIFICATION

- ☐ AS BUILT - CHANGES AS NOTED
☐ AS BUILT - NO CHANGES

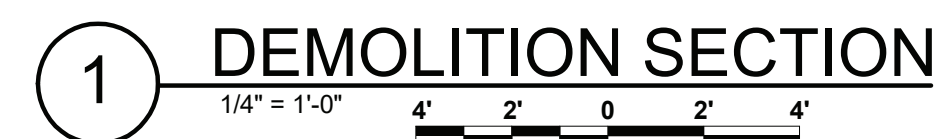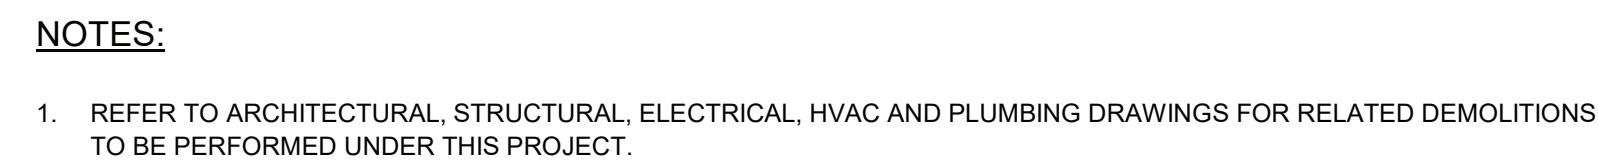CONTRACTOR			PROJECT COORDINATOR		
NAME			NAME		
SIGNATURE			SIGNATURE		
TITLE	DATE		TITLE	DATE	
WESTCHESTER COUNTY, NEW YORK			CONTRACT NUMBER	SHEET NUMBER	
DEPARTMENT OF PUBLIC WORKS AND TRANSPORTATION			17-529	17-529	M-101
DIVISION OF ENGINEERING			SHEET NO. 25 OF 60		
CROTONVILLE PUMPING STATION REHABILITATION			SCALE: 1/4"=1'-0"		
OSSINING SEWER DISTRICT			DATE: 12/21/2018		
OSSINING, NEW YORK			DPW FILE NO.		
LOWER & MIDDLE LEVEL DEMOLITION PLANS			208-03-M-49-0		
			REV. NO. 0		



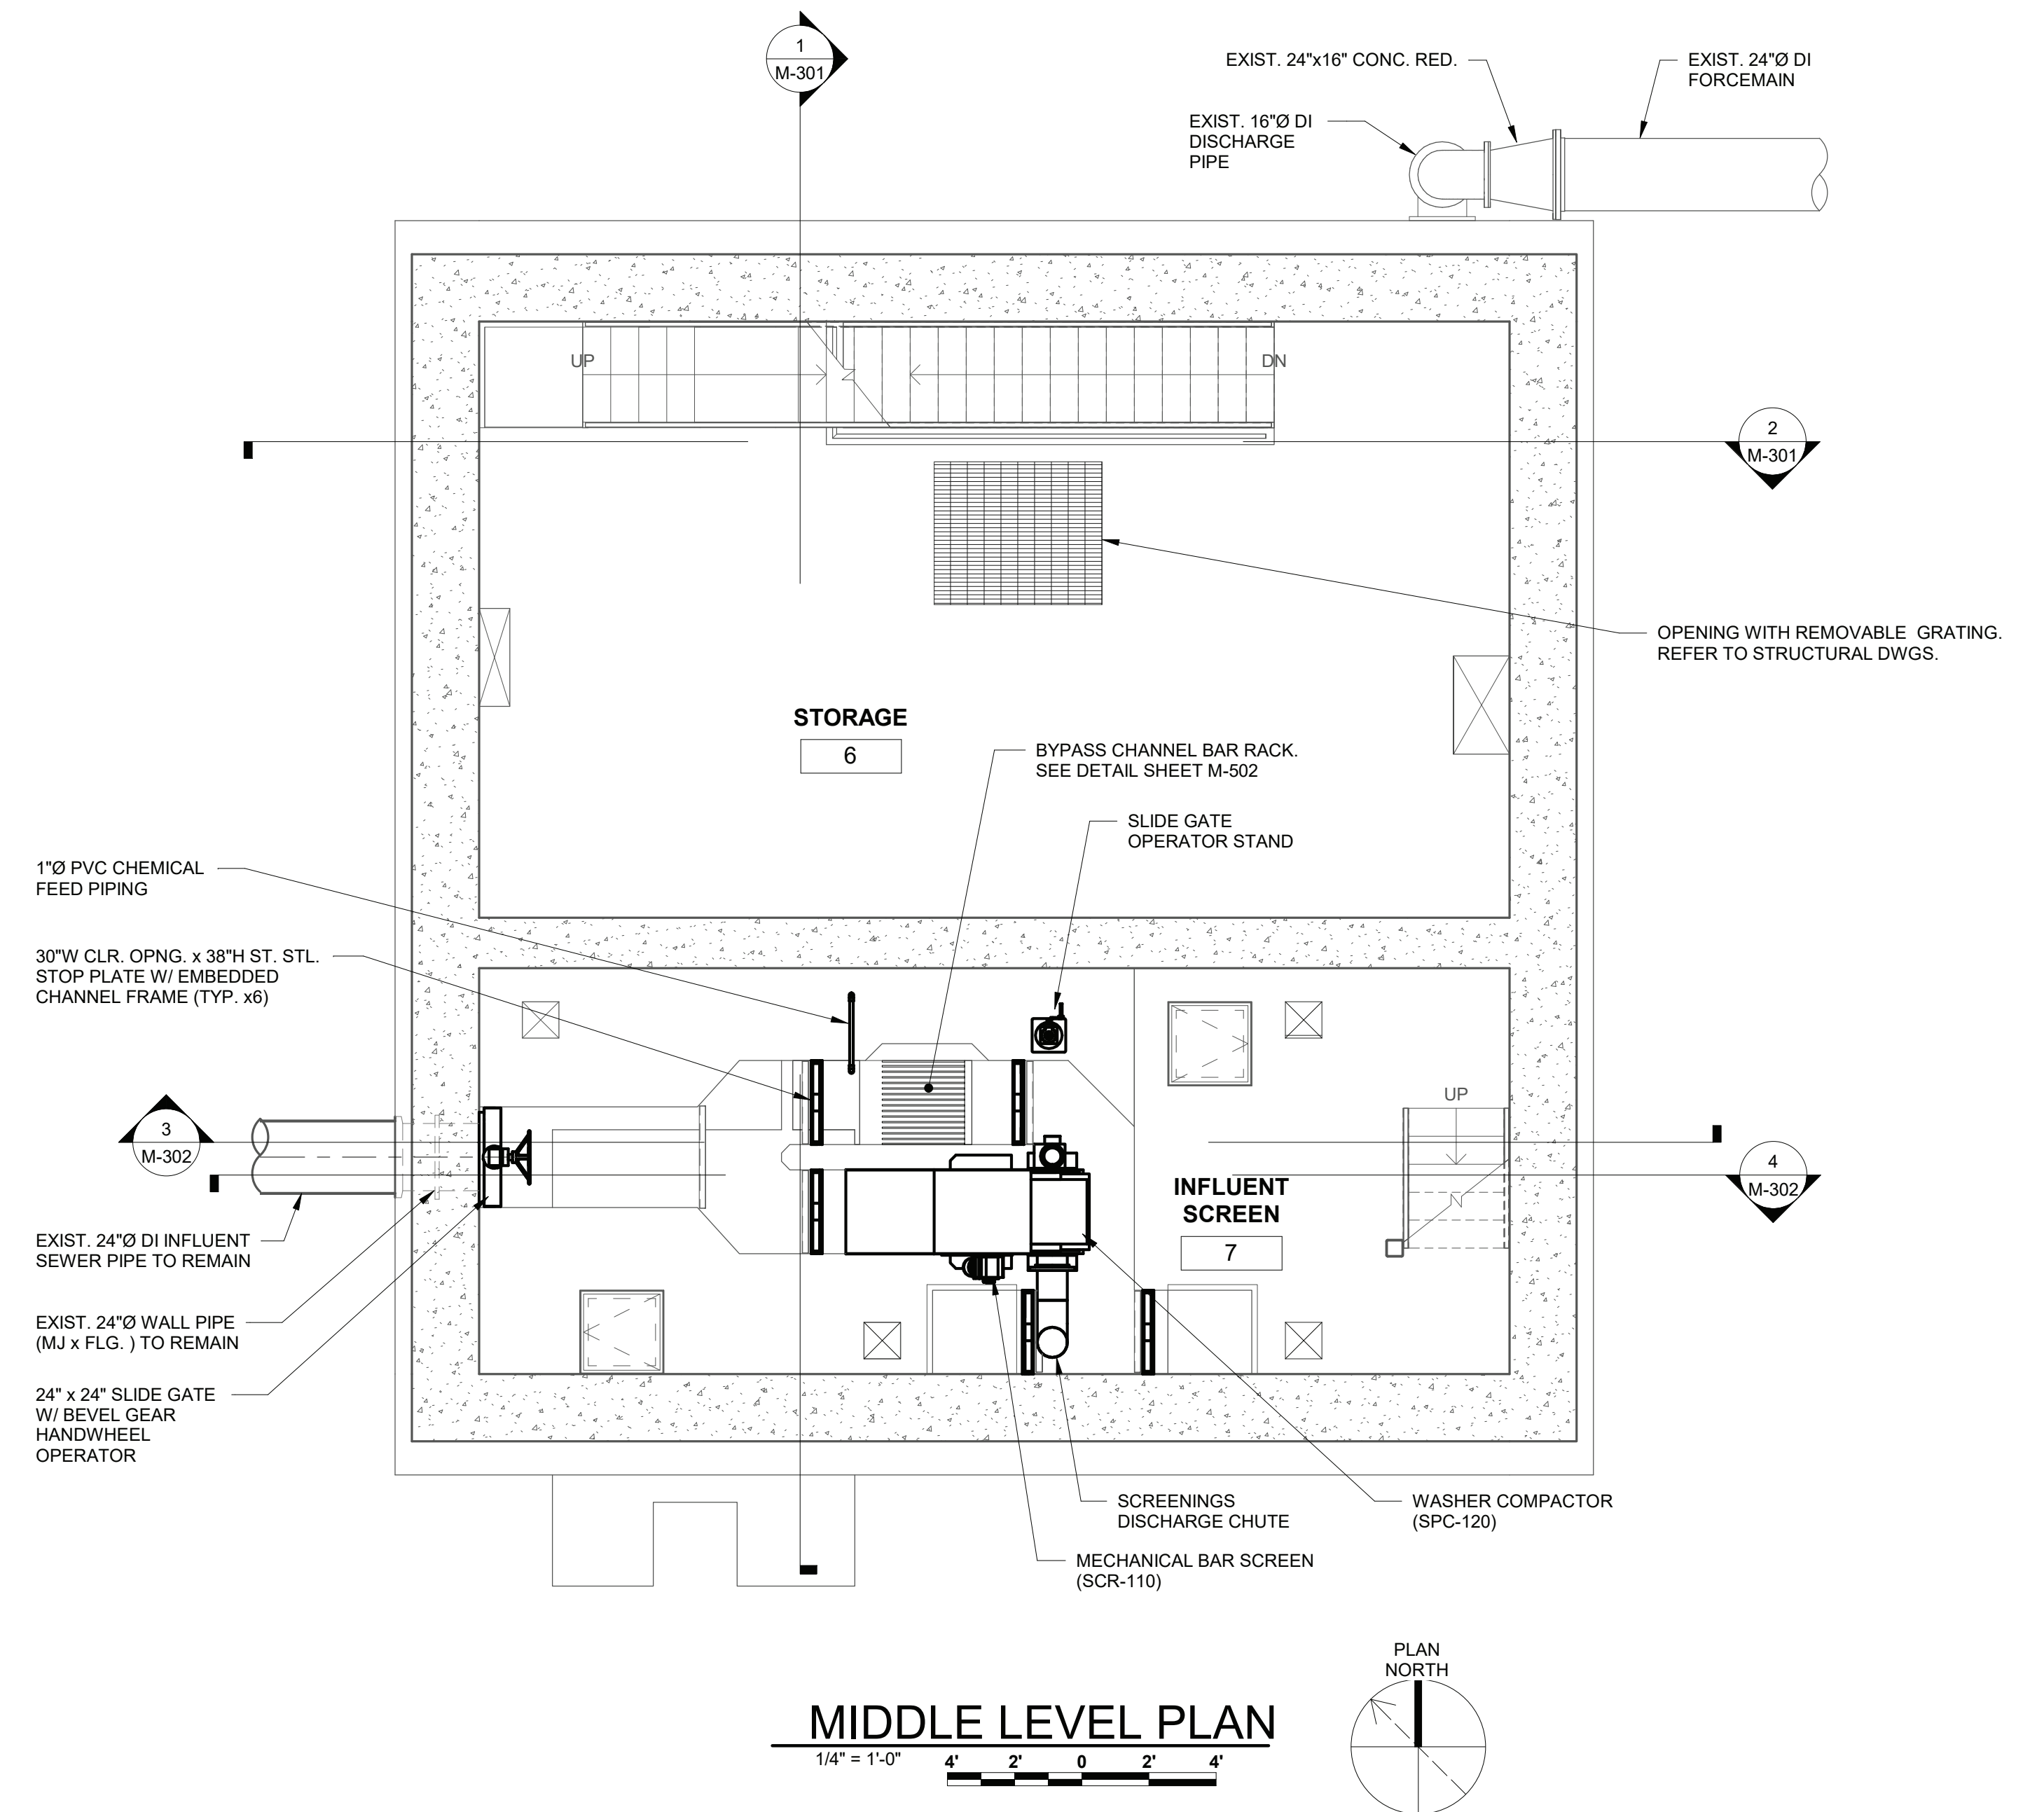

	IN ACCORDANCE WITH TITLE VIII, ARTICLE 145, SECTION 7209 (2) OF THE NEW YORK STATE EDUCATION LAW, IT IS A VIOLATION OF LAW FOR ANY PERSON UNLESS ACTING UNDER THE DIRECTION OF A LICENSED ENGINEER TO ALTER THIS DOCUMENT.											
IN CHARGE OF <u>R. GELL</u> CHECKED BY <u>D. ROONEY</u> MADE BY <u>T. LARAMAY</u>		O'BRIEN & GERE ENGINEERS, INC. 50 MAIN ST., 10TH FLOOR SUITE 1000, WHITE PLAINS, NEW YORK 10606										
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<input type="checkbox"/> AS BUILT - CHANGES AS NOTED <input type="checkbox"/> AS BUILT - NO CHANGES												
CONTRACTOR NAME _____ SIGNATURE _____ TITLE _____ DATE _____	PROJECT COORDINATOR NAME _____ SIGNATURE _____ TITLE _____ DATE _____											
WESTCHESTER COUNTY, NEW YORK DEPARTMENT OF PUBLIC WORKS AND TRANSPORTATION DIVISION OF ENGINEERING		<table border="1" style="width: 100%; border-collapse: collapse;"> <tr> <td style="width: 50%; text-align: center;"> CONTRACT NUMBER 17-529 </td> <td style="width: 50%; text-align: center;"> SHEET NUMBER M-102 </td> </tr> <tr> <td colspan="2" style="text-align: center;"> SHEET NO. 26 OF 60 </td> </tr> <tr> <td colspan="2" style="padding: 5px;"> SCALE: 1/4"=1'-0" DATE: 12/21/2018 </td> </tr> <tr> <td style="padding: 5px;"> DPW FILE NO. </td> <td style="padding: 5px;"> REV. NO. </td> </tr> <tr> <td style="text-align: center; padding: 5px;"> 208-03-M-50-0 </td> <td style="text-align: center; padding: 5px;"> 0 </td> </tr> </table>	CONTRACT NUMBER 17-529	SHEET NUMBER M-102	SHEET NO. 26 OF 60		SCALE: 1/4"=1'-0" DATE: 12/21/2018		DPW FILE NO.	REV. NO.	208-03-M-50-0	0
CONTRACT NUMBER 17-529	SHEET NUMBER M-102											
SHEET NO. 26 OF 60												
SCALE: 1/4"=1'-0" DATE: 12/21/2018												
DPW FILE NO.	REV. NO.											
208-03-M-50-0	0											
CROTONVILLE PUMPING STATION REHABILITATION OSSINING SEWER DISTRICT OSSINING, NEW YORK MAIN LEVEL DEMOLITION PLAN & SECTION												




EQUIPMENT SCHEDULE								
EQUIPMENT NAME	TAG NUMBER	LOCATION	BASIS OF DESIGN MANUFACTURER	MODEL	DESIGN CAPACITY	TDH	HORSE POWER	CLEAR BAR SPACING
PUMP NO. 1, NO. 2, NO. 3	PU-131, PU-132, PU-133	PUMP ROOM	ABS (SULZER)	XFP-250M-CH2	3,000 GPM	200 FEET	250 HP	NA
MECHANICAL BAR SCREEN	SCR-110	INFLUENT SCREEN ROOM	DUPERON	FLEX-RAKE	6.5 MGD	NA	NA	1 INCH
WASHER COMPACTOR	SPC-120	INFLUENT SCREEN ROOM	DUPERON	DUAL AUGER	3,000 GPM	NA	NA	NA


DRAWING NOTES:

1. PUMPS TO BE TESTED IN THE FACTORY FOR HYDROSTATIC PRESSURE AND PERFORMANCE BY THE MANUFACTURER.
2. PUMP OPERATION CYCLING IS PUMP NO. 1-2-3, 2-3-1, AND 3-1-2, 1-2-3, ETC. PUMPS CYCLE AFTER EACH START.
3. PIPING TO BE TESTED IN ACCORDANCE WITH AWWA C600.


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		O'BRIEN & GERE ENGINEERS, INC. 50 MAIN ST., 10TH FLOOR SUITE 1000, WHITE PLAINS, NEW YORK 10606	
		IN CHARGE OF R. GELL _____	
		CHECKED BY D. ROONEY _____	
		MADE BY T. LARAMAY _____	
			
REVISION NUMBER		DATE	MADE BY APP'D BY REVISION
RECORD DRAWING CERTIFICATION			
<input type="checkbox"/> AS BUILT - CHANGES AS NOTED			
<input type="checkbox"/> AS BUILT - NO CHANGES			
CONTRACTOR		PROJECT COORDINATOR	
NAME _____		NAME _____	
SIGNATURE _____		SIGNATURE _____	
TITLE _____ DATE _____		DATE _____	
WESTCHESTER COUNTY, NEW YORK DEPARTMENT OF PUBLIC WORKS AND TRANSPORTATION DIVISION OF ENGINEERING			
CROTONVILLE PUMPING STATION REHABILITATION		CONTRACT NUMBER 17-529	SHEET NUMBER M-103
OSSINING SEWER DISTRICT		SHEET NO. 27 OF 60	
OSSINING, NEW YORK		SCALE: 1/4"=1'-0"	
LOWER & MIDDLE LEVEL PLANS		DATE: 12/21/2018	
		DPW FILE NO. 208-03-M-51-0	REV. NO.: 0

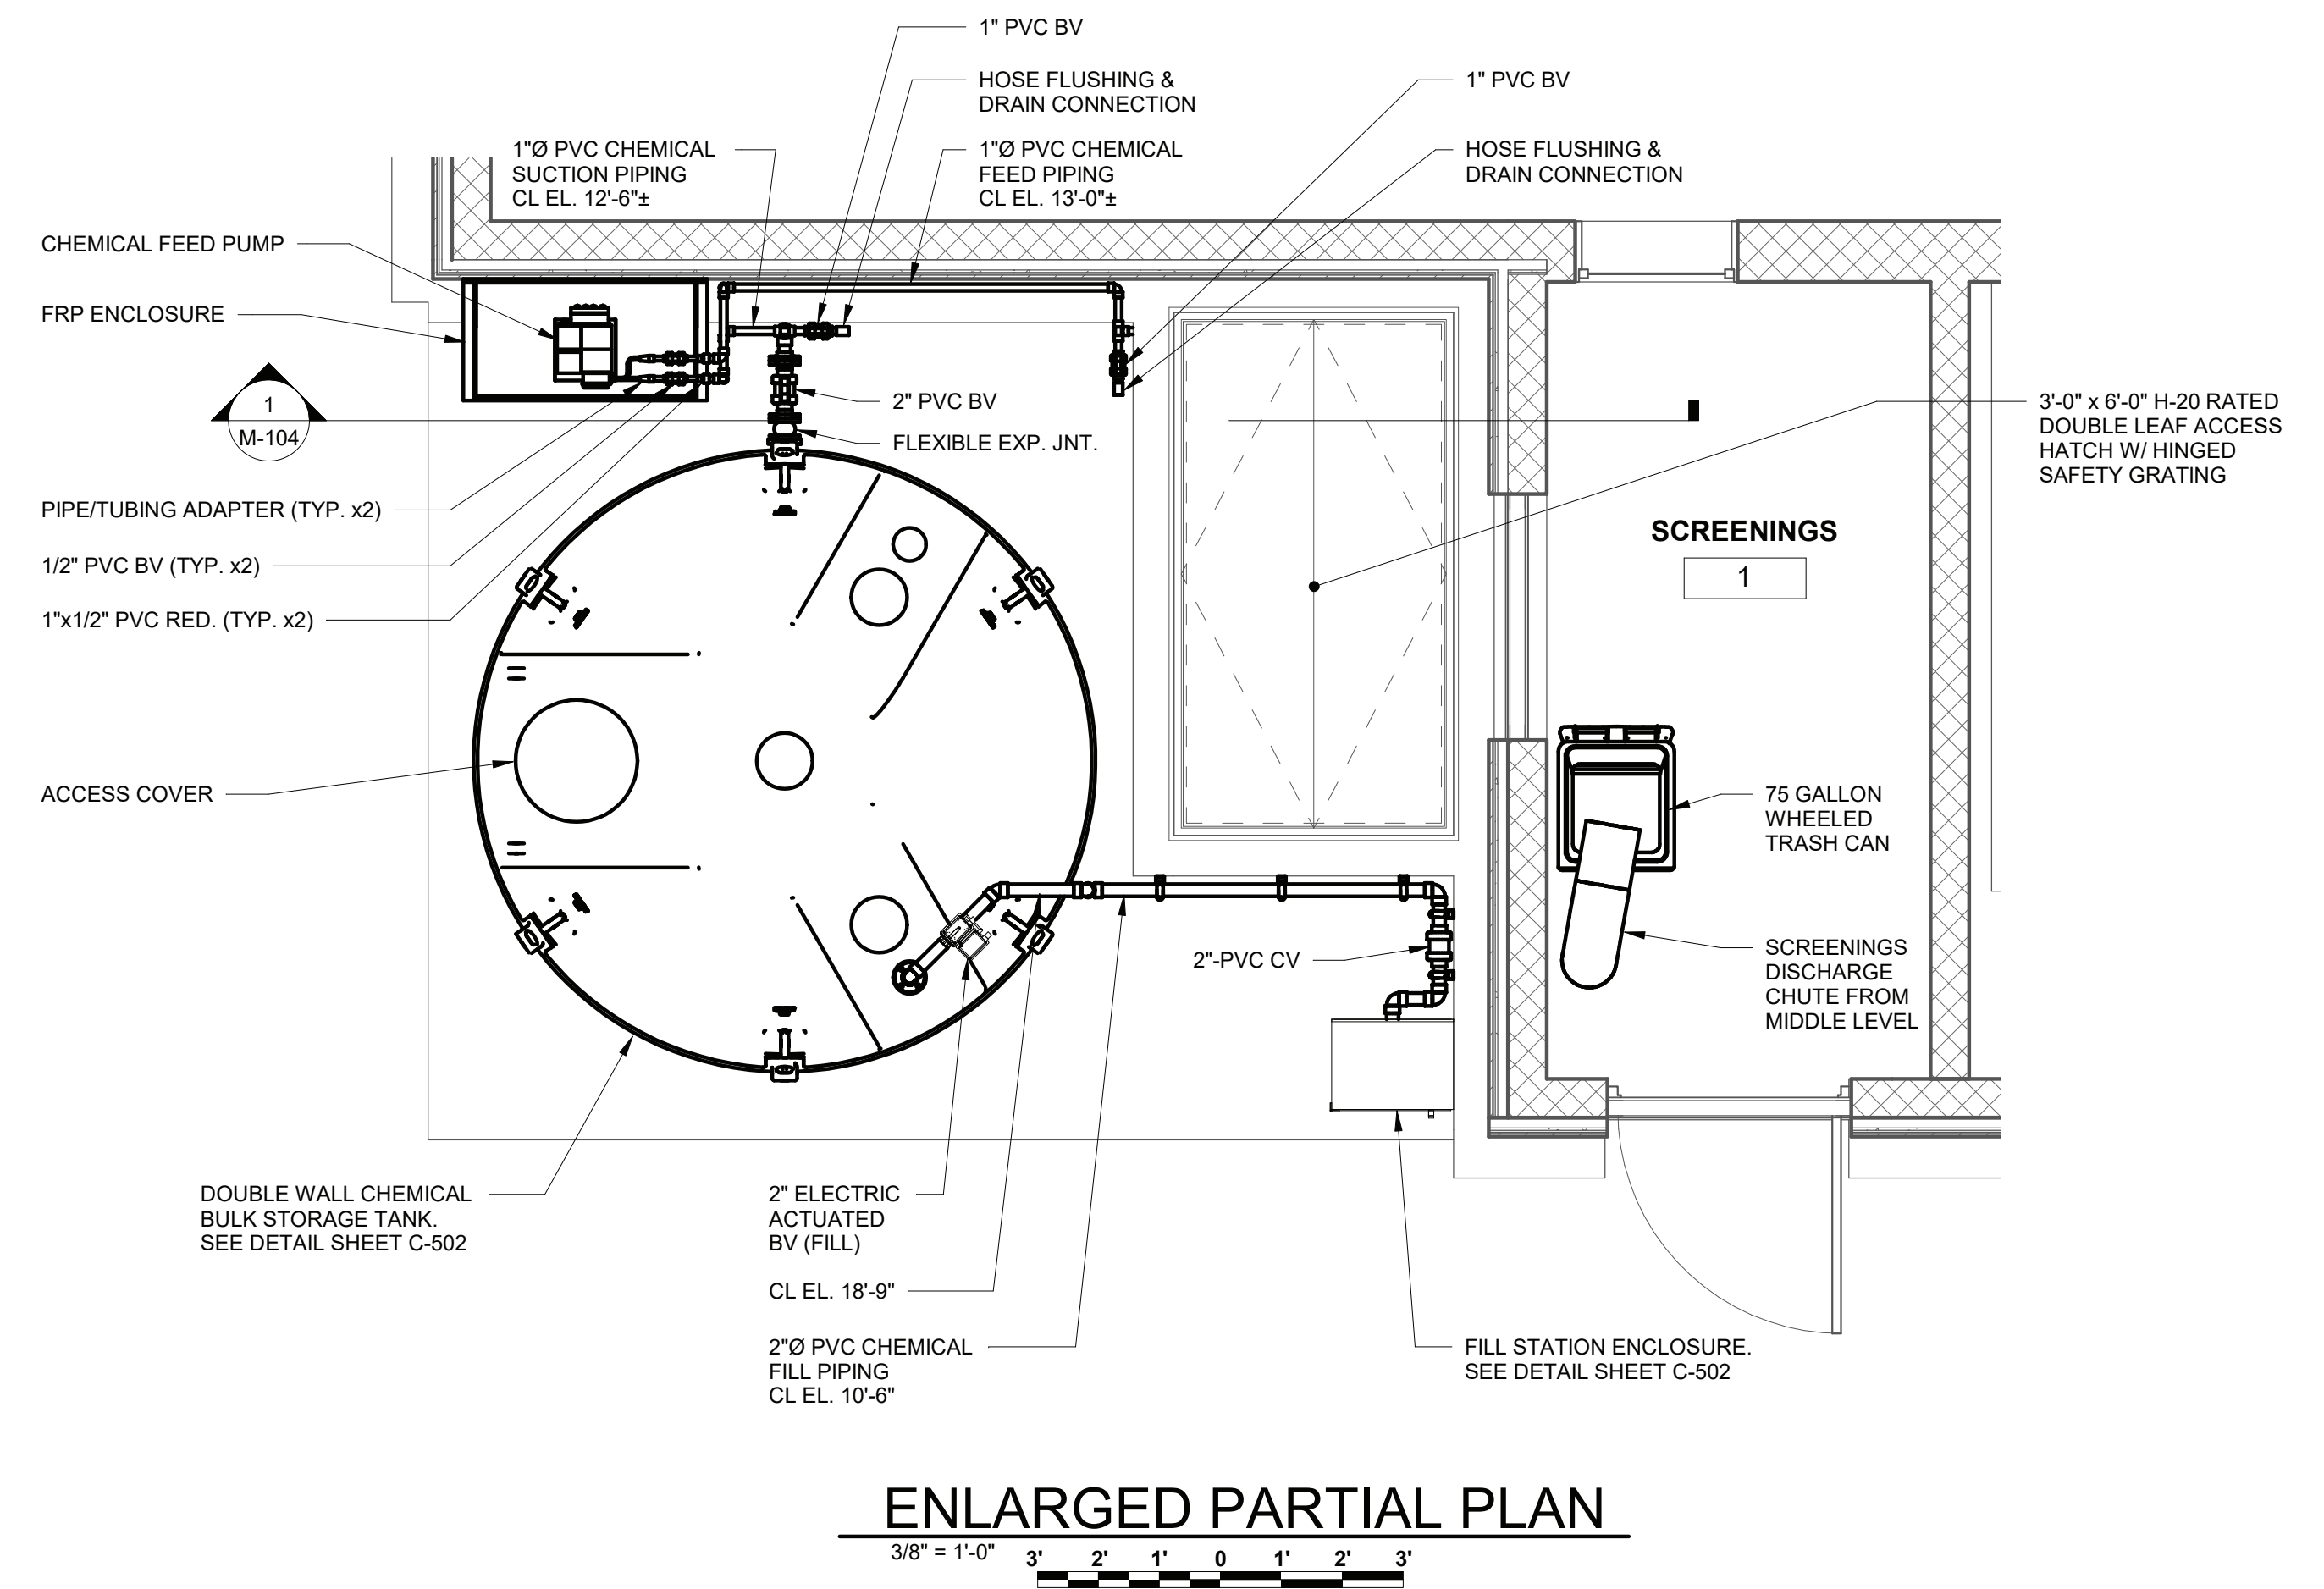


1/4" = 1'-0" 4' 2' 0 2' 4'

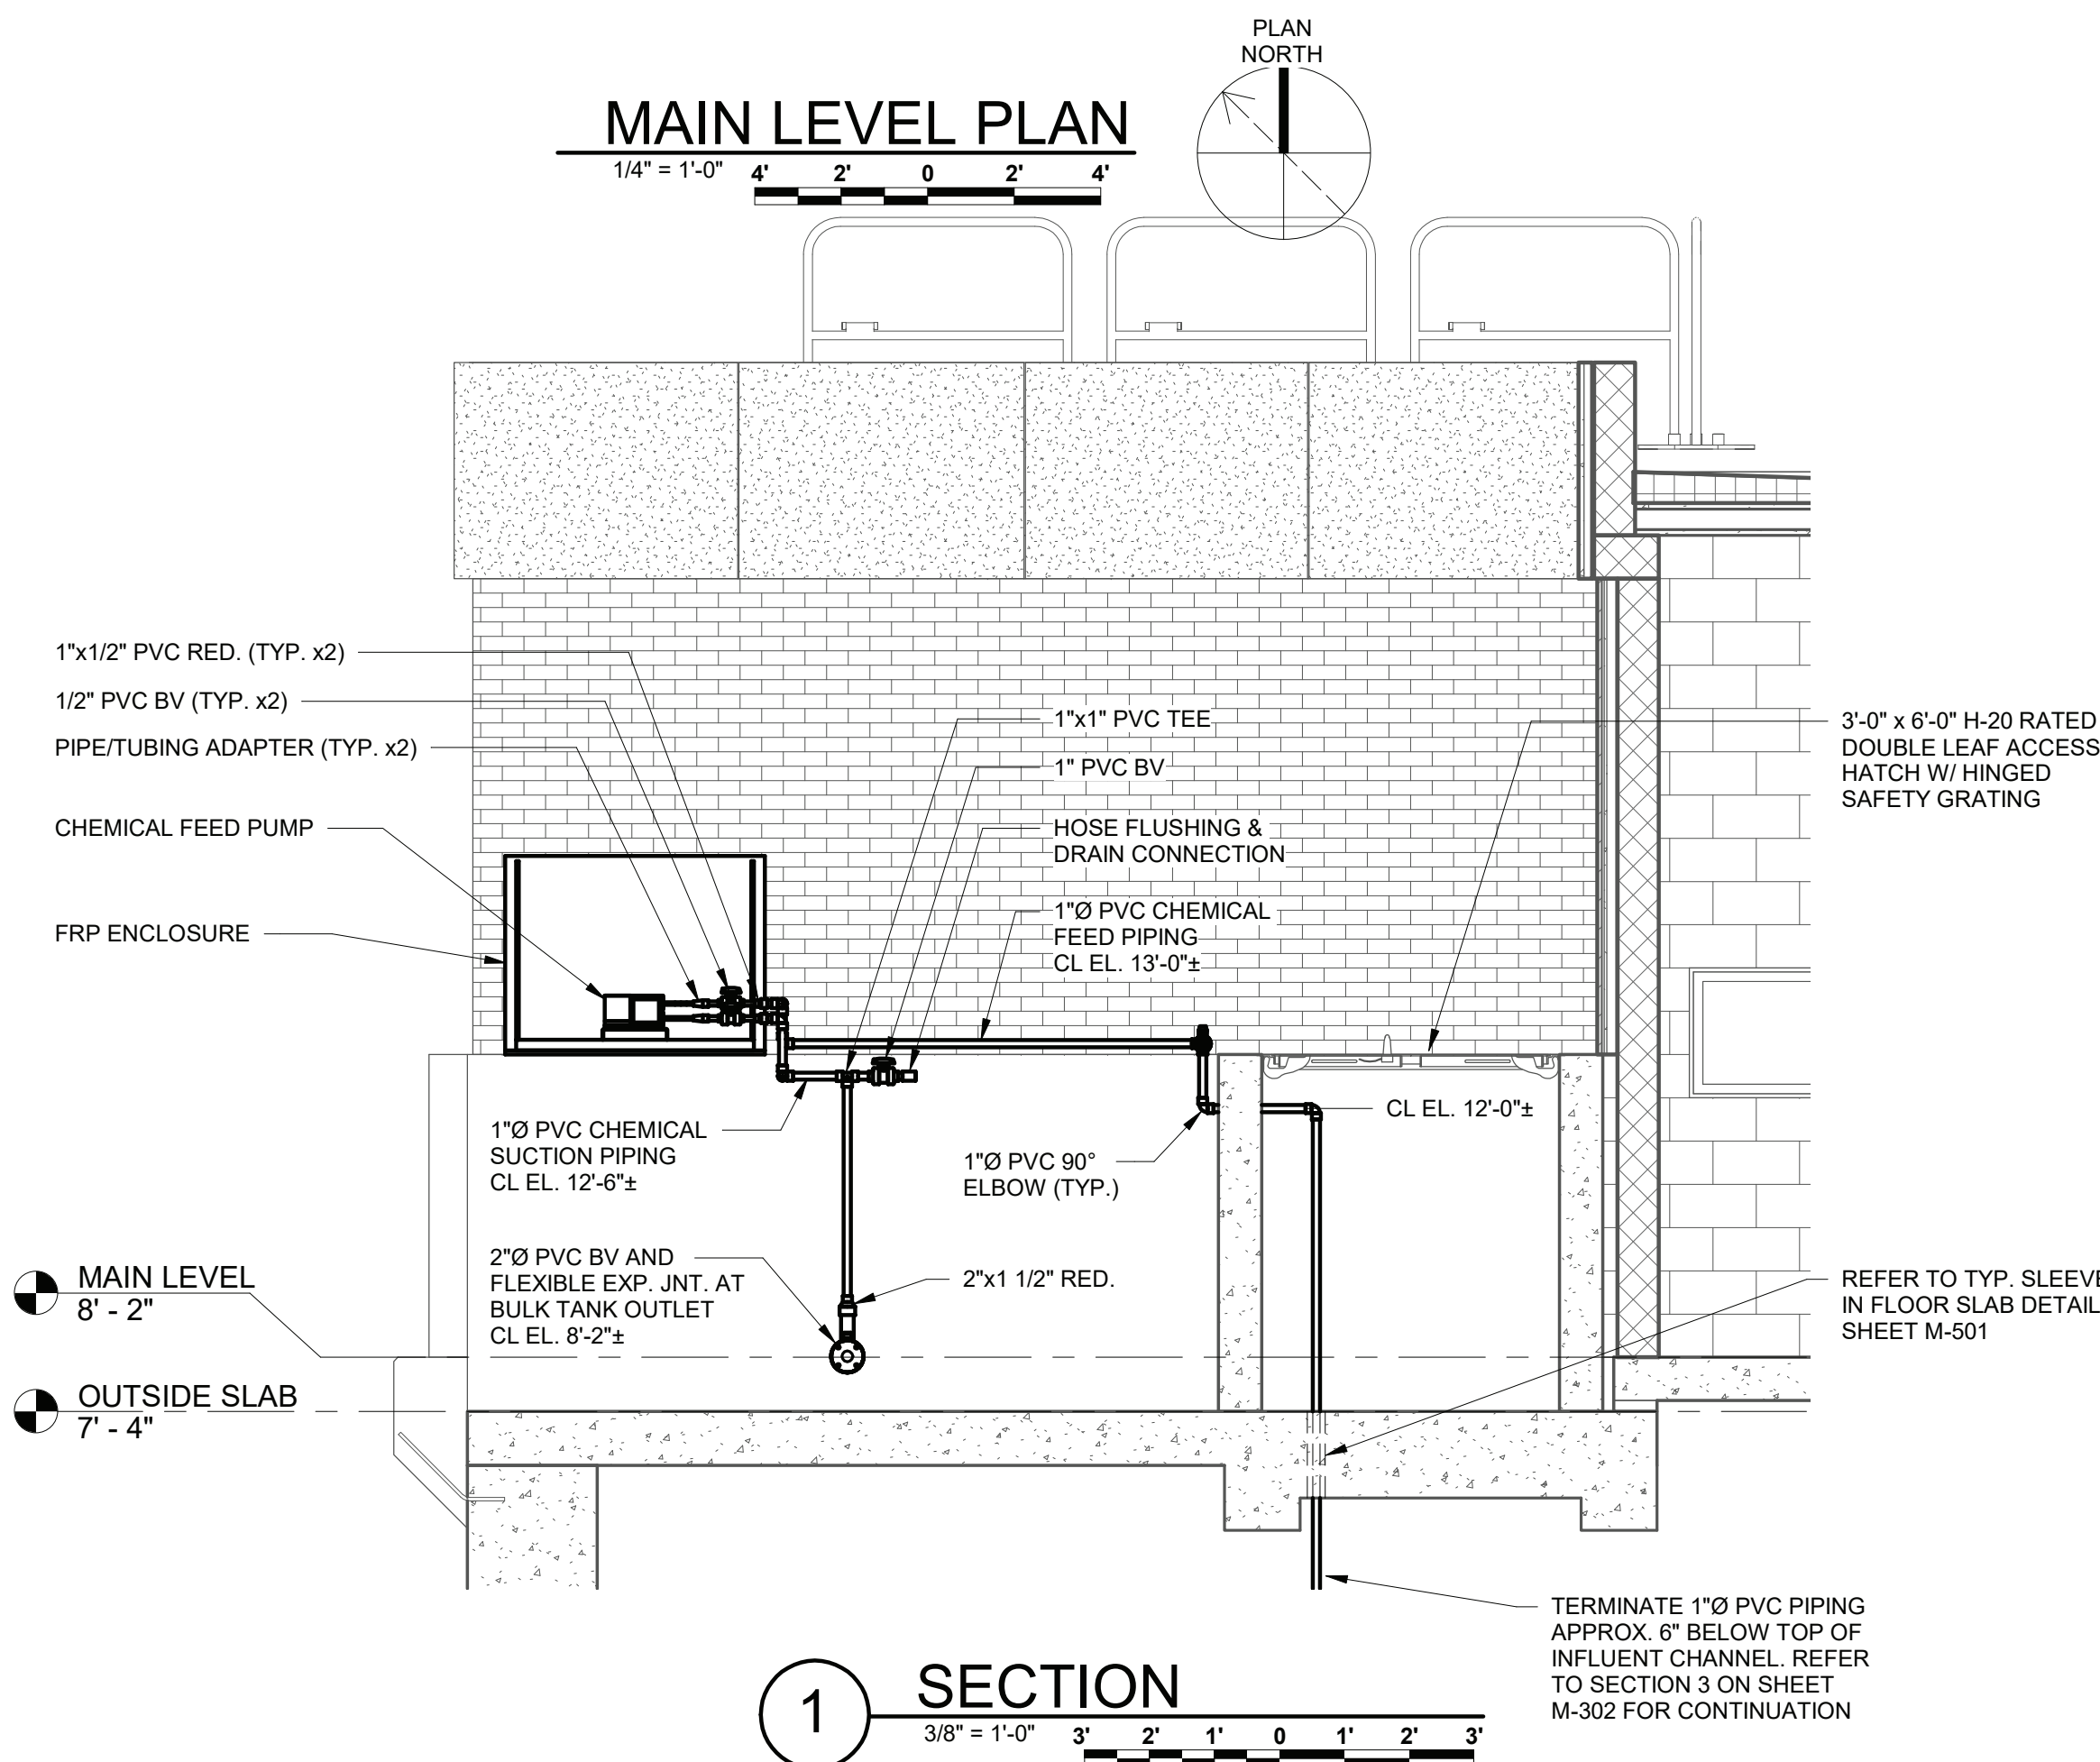

1. FABRICATE CHEMICAL FILL STATION ENCLOSURE IN SHOP OF 1/2" THICK GRAY PVC SHEET WITH SOLVENT WELDED JOINTS. SLOPE BOTTOM OF ENCLOSURE FOUR WAYS TO DRAIN CONNECTION. PROVIDE LATCHING DOOR WITH POLYPROPYLENE PIANO HINGE AND STAINLESS STEEL FASTENERS AND HARDWARE. SUBMIT SHOP DRAWING FOR REVIEW PRIOR TO FABRICATION. ATTACH TO SUPPORTS WITH STAINLESS STEEL HARDWARE.


	<p>IN ACCORDANCE WITH TITLE VIII, ARTICLE 145, SECTION 7209 (2) OF THE NEW YORK STATE EDUCATION LAW, IT IS A VIOLATION OF LAW FOR ANY PERSON UNLESS ACTING UNDER THE DIRECTION OF A LICENSED ENGINEER TO ALTER THIS DOCUMENT.</p>					
<p>IN CHARGE OF <u>R. GELL</u></p> <p>CHECKED BY <u>D. ROONEY</u></p> <p>MADE BY <u>T. LARAMAY</u></p>		<p>O'BRIEN & GERE ENGINEERS, INC.</p> <p>50 MAIN ST., 10TH FLOOR SUITE 1000, WHITE PLAINS, NEW YORK 10606</p>				
REVISION NUMBER	DATE	MADE BY APP'D BY REVISION				
<p>RECORD DRAWING CERTIFICATION</p> <p><input type="checkbox"/> AS BUILT - CHANGES AS NOTED</p> <p><input type="checkbox"/> AS BUILT - NO CHANGES</p>						
<p style="text-align: center;">CONTRACTOR</p> <p>NAME _____</p> <p>SIGNATURE _____</p> <p>TITLE _____ DATE _____</p>		<p style="text-align: center;">PROJECT COORDINATOR</p> <p>NAME _____</p> <p>SIGNATURE _____</p> <p>TITLE _____ DATE _____</p>				
<p>WESTCHESTER COUNTY, NEW YORK</p> <p>DEPARTMENT OF PUBLIC WORKS AND TRANSPORTATION</p> <p>DIVISION OF ENGINEERING</p>		<table border="1" style="width: 100%; border-collapse: collapse;"> <tr> <td style="width: 50%; padding: 5px;"> <p>CONTRACT NUMBER</p> <p style="text-align: center;">17-529</p> </td> <td style="width: 50%; padding: 5px;"> <p>SHEET NUMBER</p> <p style="text-align: center;">M-104</p> </td> </tr> <tr> <td colspan="2" style="padding: 5px;"> <p>SHEET NO. 28 OF 60</p> </td> </tr> </table>	<p>CONTRACT NUMBER</p> <p style="text-align: center;">17-529</p>	<p>SHEET NUMBER</p> <p style="text-align: center;">M-104</p>	<p>SHEET NO. 28 OF 60</p>	
<p>CONTRACT NUMBER</p> <p style="text-align: center;">17-529</p>	<p>SHEET NUMBER</p> <p style="text-align: center;">M-104</p>					
<p>SHEET NO. 28 OF 60</p>						
<p style="text-align: center;">CROTONVILLE PUMPING STATION REHABILITATION</p> <p style="text-align: center;">OSSINING SEWER DISTRICT</p> <p style="text-align: center;">OSSINING, NEW YORK</p> <p style="text-align: center;">MAIN LEVEL PLAN, ENLARGED PARTIAL PLAN & SECTION</p>		<p>SCALE: 1/4"=1'-0"</p> <p>DATE: 12/21/2018</p> <p>DPW FILE NO.</p> <p style="text-align: center;">208-03-M-52-0</p>				
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	<p>REV. NO.</p> <p style="text-align: center;">0</p>					

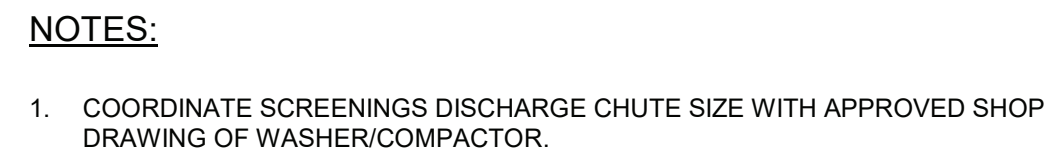

DESCRIPTION	ACTUAL ELEVATION	ELEVATION ABOVE LOWER LEVEL
HIGH WATER LEVEL ALARM	-13'-6"	6'-8"
LAG PUMP NO. 2 ON	-13'-10"	6'-4"
LAG PUMP NO. 1 ON	-14'-4"	5'-6"
LEAD PUMP ON	-15'-0"	4'-6"
LAG PUMP NO. 2 OFF	-17'-0"	3'-0"
LAG PUMP NO. 1 OFF	-17'-8"	3'-0"
LEAD PUMP OFF	-18'-0"	3'-0"
LOW WATER LEVEL ALARM	-18'-4"	2'-0"
LOW WATER LEVEL	-20'-4"	0'-0"


EQUIPMENT TABLE								
EQUIPMENT NAME	TAG NUMBER	LOCATION	BASIS OF DESIGN MANUFACTURER	MODEL	DESIGN CAPACITY	TDH	HORSEPOWER	CLEAR BAR SPACING
CHEMICAL FEED PUMP	NA	OUTDOORS	WATSON MARLOW	530	12 GPH	30 PSI	NA	NA
MANUAL BAR SCREEN	BR-111	INFLUENT SCREEN ROOM	NA	NA	6.5 MGD	NA	NA	1.5"
MAGNETIC FLOW METER	FE-160	PUMP ROOM	ENDRESS + HAUSER	PROMAG 400	10 MGD	NA	NA	NA
MAGNESIUM HYDROXIDE STORAGE TANK	NA	OUTDOORS	POLYPROCESSING COMPANY	DOUBLE WALL	4,400 GALLONS	NA	NA	NA


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MECHANICAL SCREEN SCHEDULE	
ITEM	REQUIREMENT
BASIS OF DESIGN MANUFACTURER	DUPERON
MODEL	FLEX-RAKE
PEAK DESIGN CAPACITY (TOTAL)	6.5 MGD
NO. OF UNITS	1
CLEAR BAR SPACING	1 - INCH
TYPE	FLEXIBLE RAKE, FULL PENETRATION
CHANNEL WIDTH	2'-6"
CHANNEL DEPTH	3'-6"
ANGLE OF INCLINE	30 DEGREES FROM VERTICAL
OPERATING FLOOR HEIGHT ABOVE CHANNEL INVERT	3'-6"
DISCHARGE HEIGHT ABOVE OPERATING FLOOR	3'-6"
MAXIMUM HEADLOSS AT PEAK FLOW (CLEAN)	1.5 - INCHES ±
MAXIMUM HEADLOSS AT PEAK FLOW (25% BLINDED)	2.5 - INCHES ±
MATERIALS OF CONSTRUCTION	TYPE 316 STAINLESS STEEL
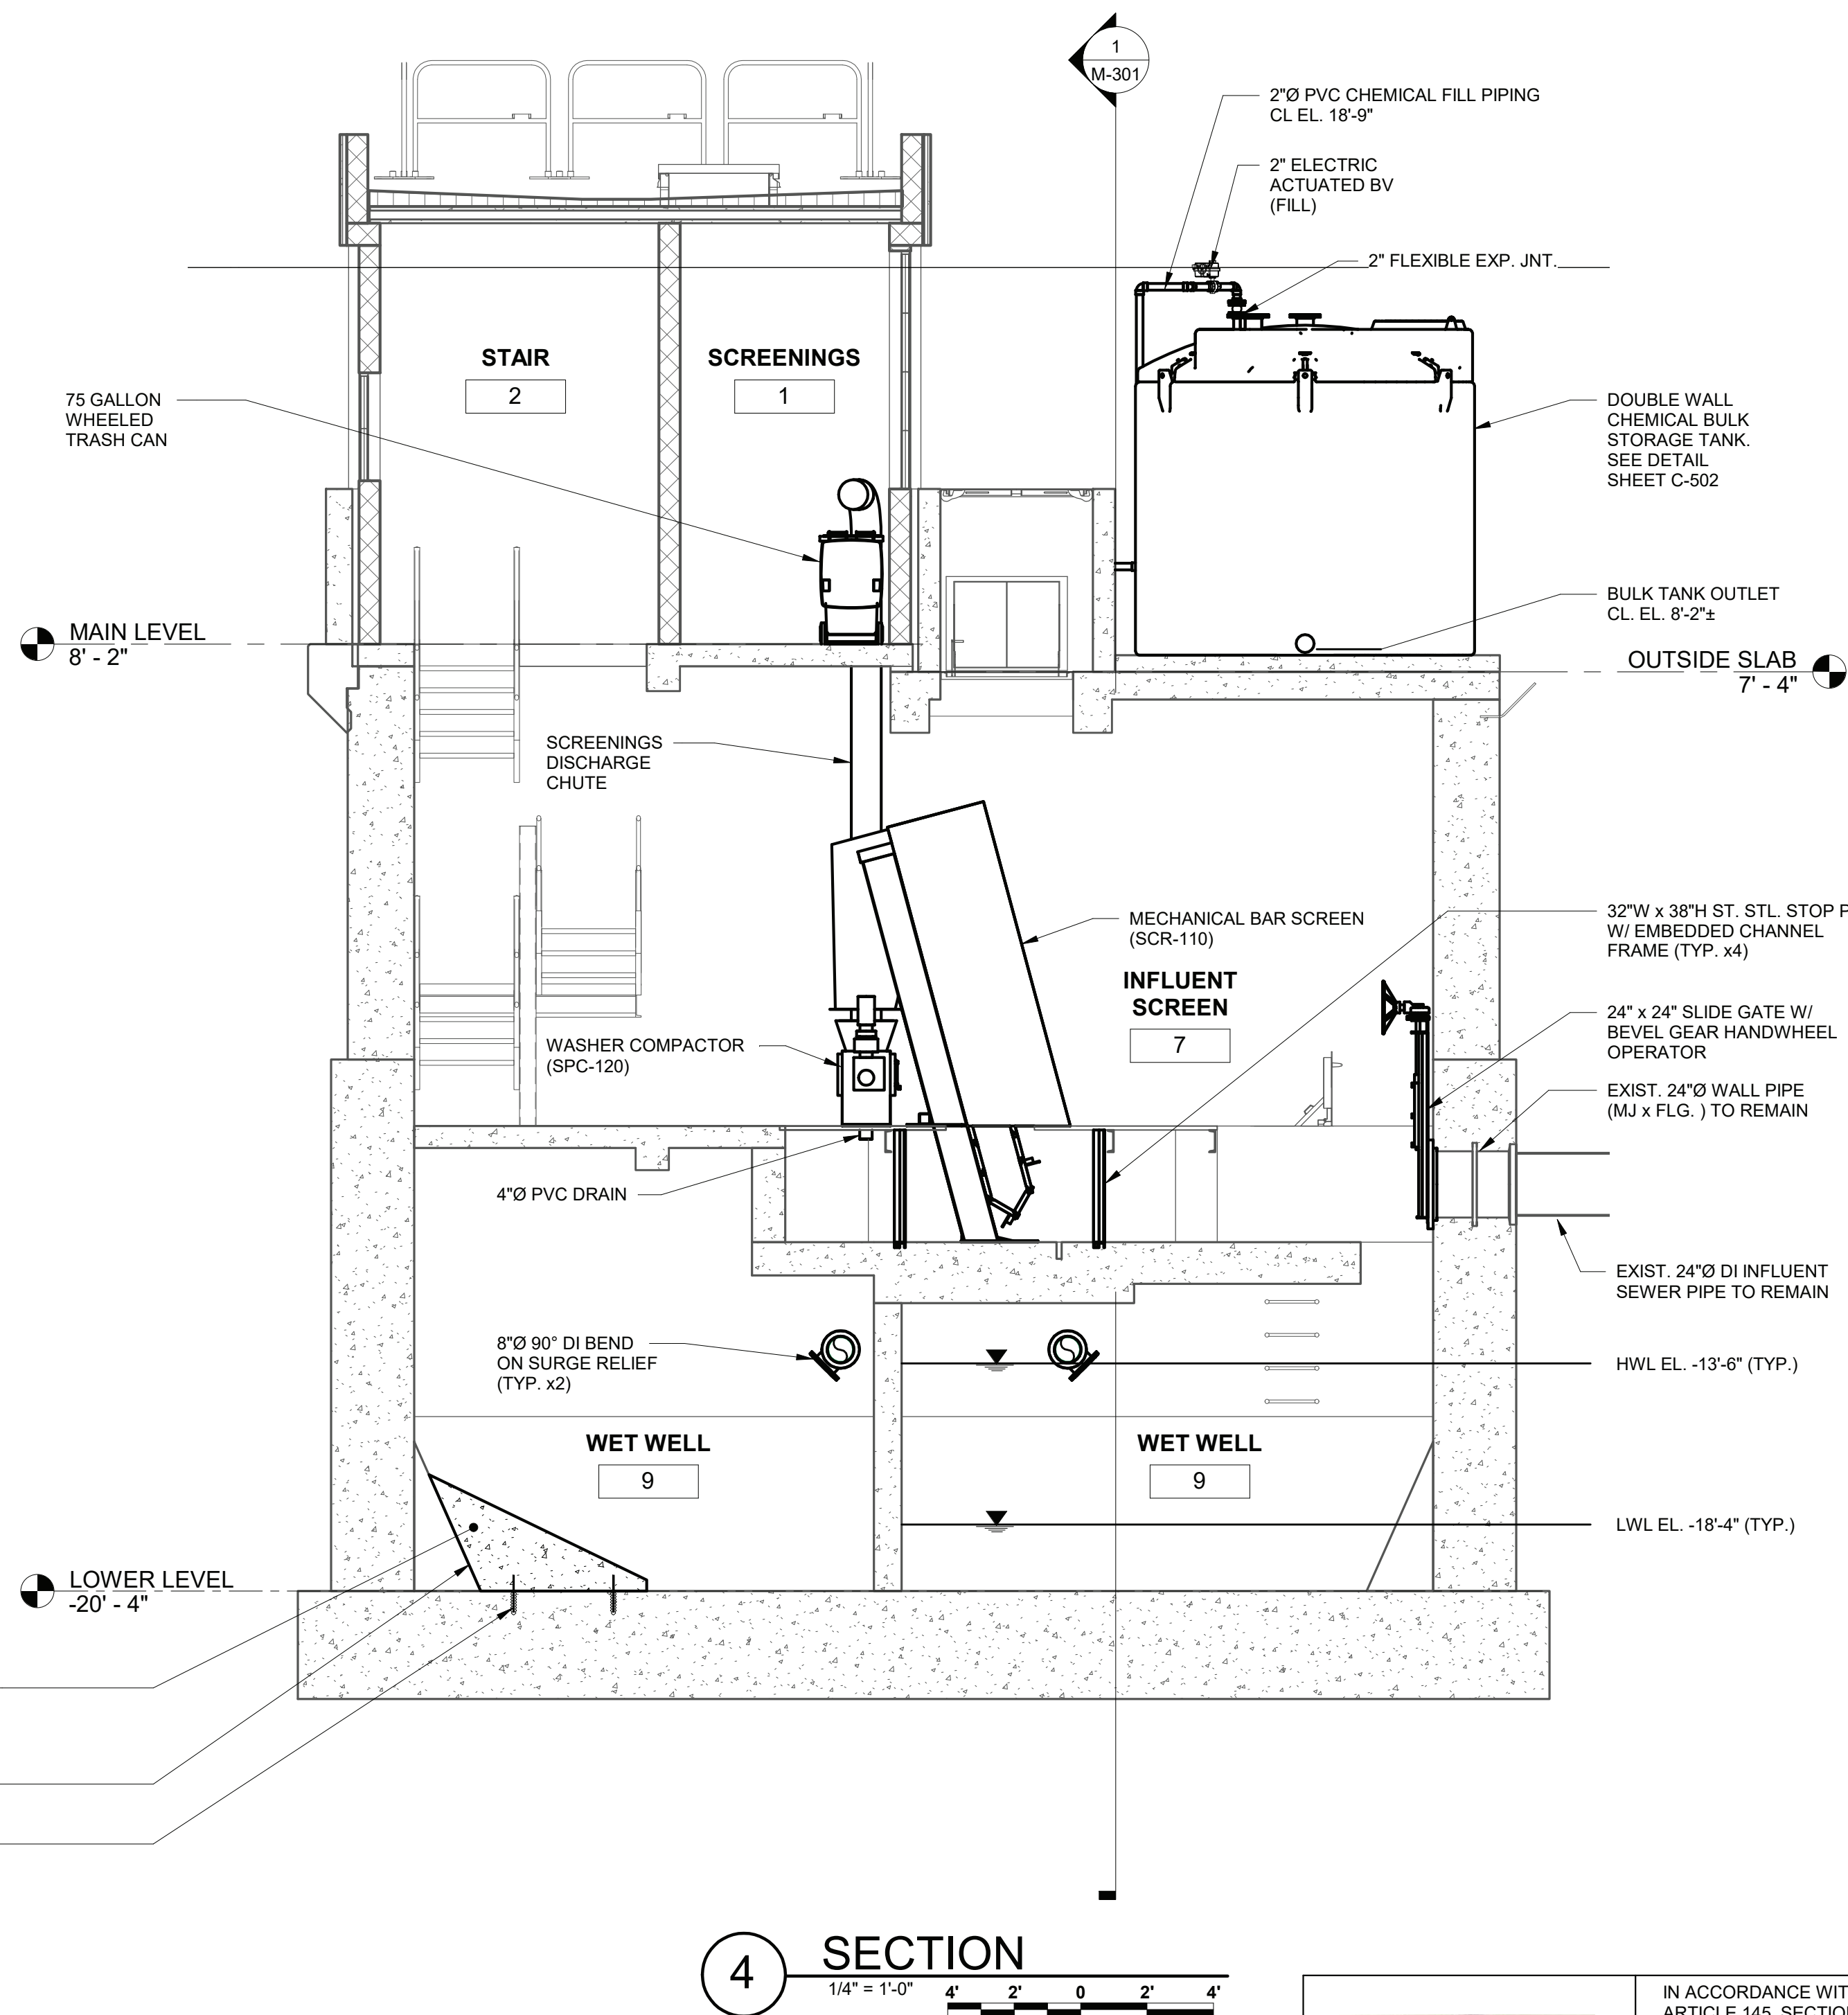
<u>WASHER COMPACTOR SCHEDULE</u>	
ITEM	REQUIREMENT
BASIS OF DESIGN MANUFACTURER	DUPERON
MODEL	DUAL AUGER
NO. OF UNITS	1
PEAK CAPACITY (INTERMITTENT OPERATION)	10 cf / HOUR
AVERAGE CAPACITY (CONTINUOUS OPERATION)	6 cf / HOUR
HOPPER HEIGHT ABOVE OPERATING FLOOR	38 - INCHES
HOPPER LENGTH	43 - INCHES
DISCHARGE HEIGHT ABOVE OPERATING FLOOR	20'-0"
VOLUME REDUCTION (MIN.)	70%
WASH WATER USAGE	3 - 10 GAL./MIN.
WASH WATER PRESSURE (MIN.)	40 - 60 PSI
MATERIALS OF CONSTRUCTION	TYPE 316 STAINLESS STEEL

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WESTCHESTER COUNTY, NEW YORK DEPARTMENT OF PUBLIC WORKS AND TRANSPORTATION DIVISION OF ENGINEERING												CONTRACT NUMBER 17-529 SHEET NUMBER M-302 SHEET NO. 30 OF 60																	
CROTONVILLE PUMPING STATION REHABILITATION OSSISING SEWER DISTRICT OSSISING, NEW YORK SECTIONS												SCALE: 1/4"=1'-0" DATE: 12/21/2018 DPW FILE NO. 208-03-M-54-0 REV. NO. 0																	




DETAIL NOTES:

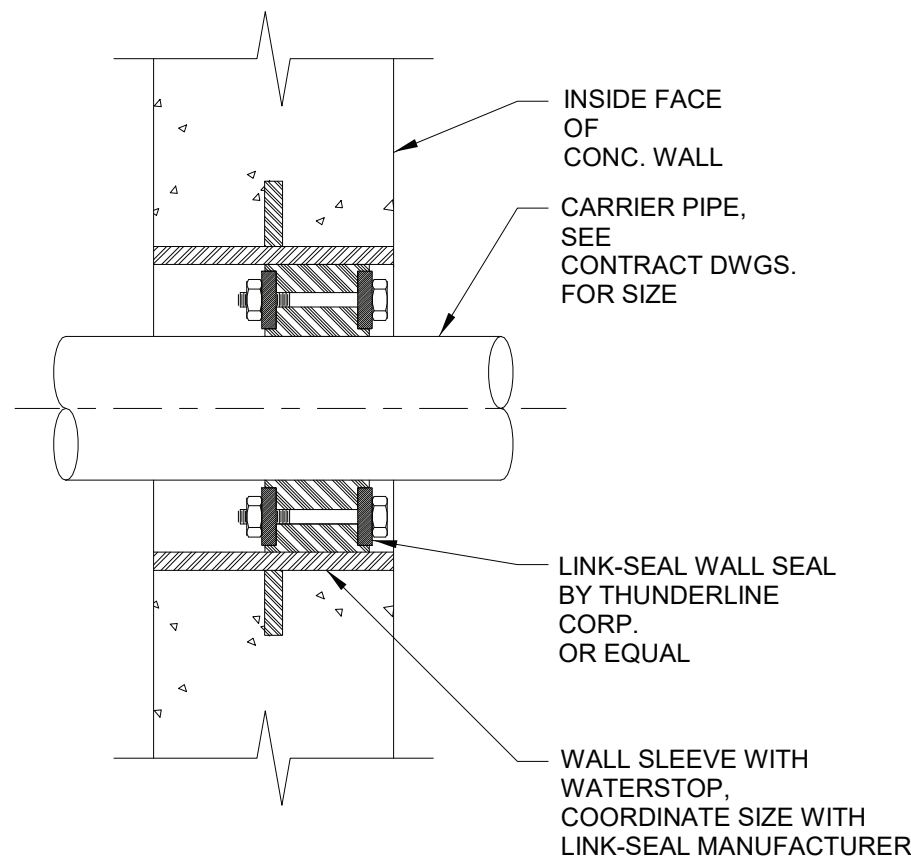1. LINK SEALS ARE REQUIRED ON BOTH FACES FOR ALL EXTERIOR PENETRATIONS.
2. PROVIDE STAINLESS STEEL HARDWARE.

MODULAR LINK SEAL WITH WALL SLEEVE DETAIL

NOT TO SCALE

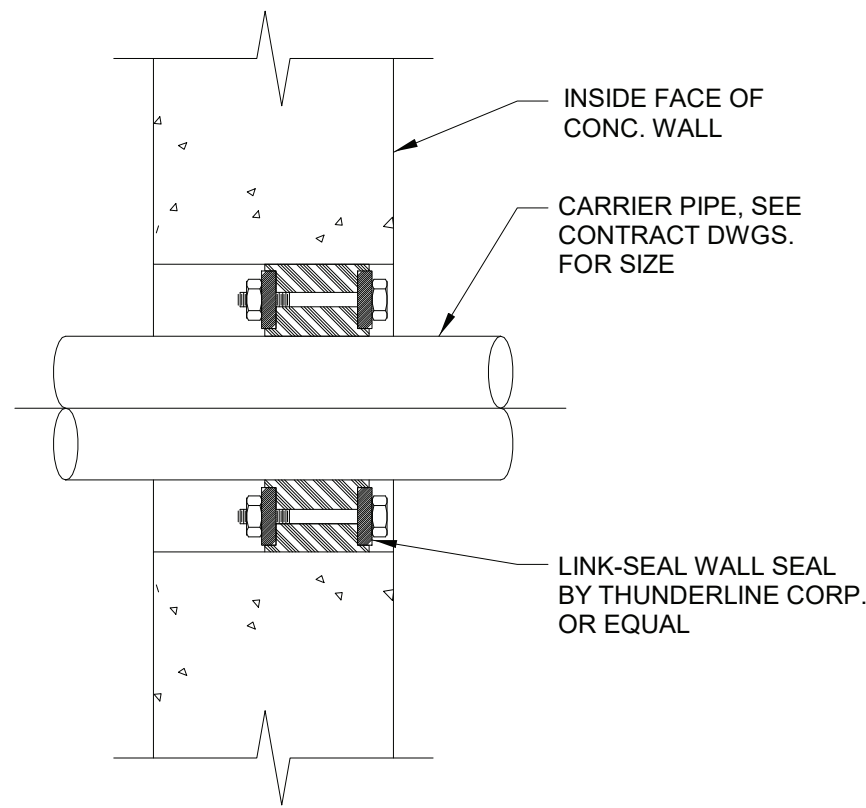


DETAIL NOTES:

1. LINK SEALS ARE REQUIRED ON BOTH FACES FOR ALL EXTERIOR PENETRATIONS, AND WALL DIVIDING WET WELL & DRY WELL.
2. COORDINATE CORE SIZE REQUIRED FOR PIPE PENETRATION WITH LINK SEAL MANUFACTURER.
3. PROVIDE STAINLESS STEEL HARDWARE.


MODULAR LINK SEAL WITH CORED PENETRATION DETAIL

NOT TO SCALE

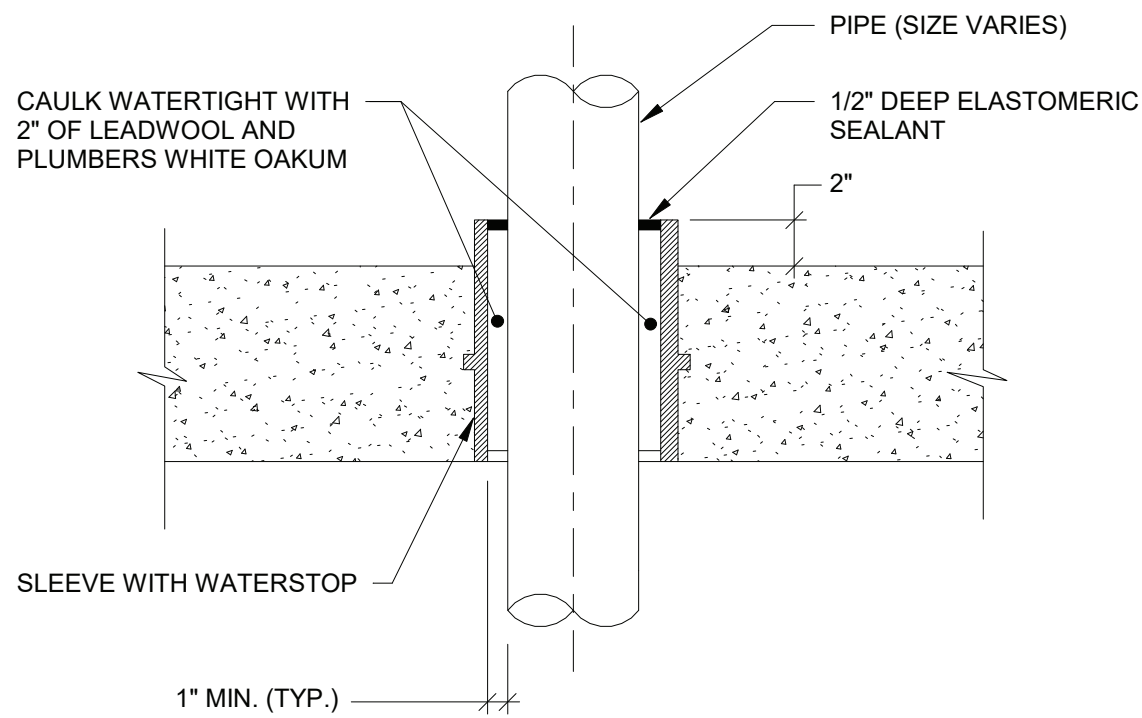

TYPICAL SLEEVE IN FLOOR SLAB DETAIL

NOT TO SCALE

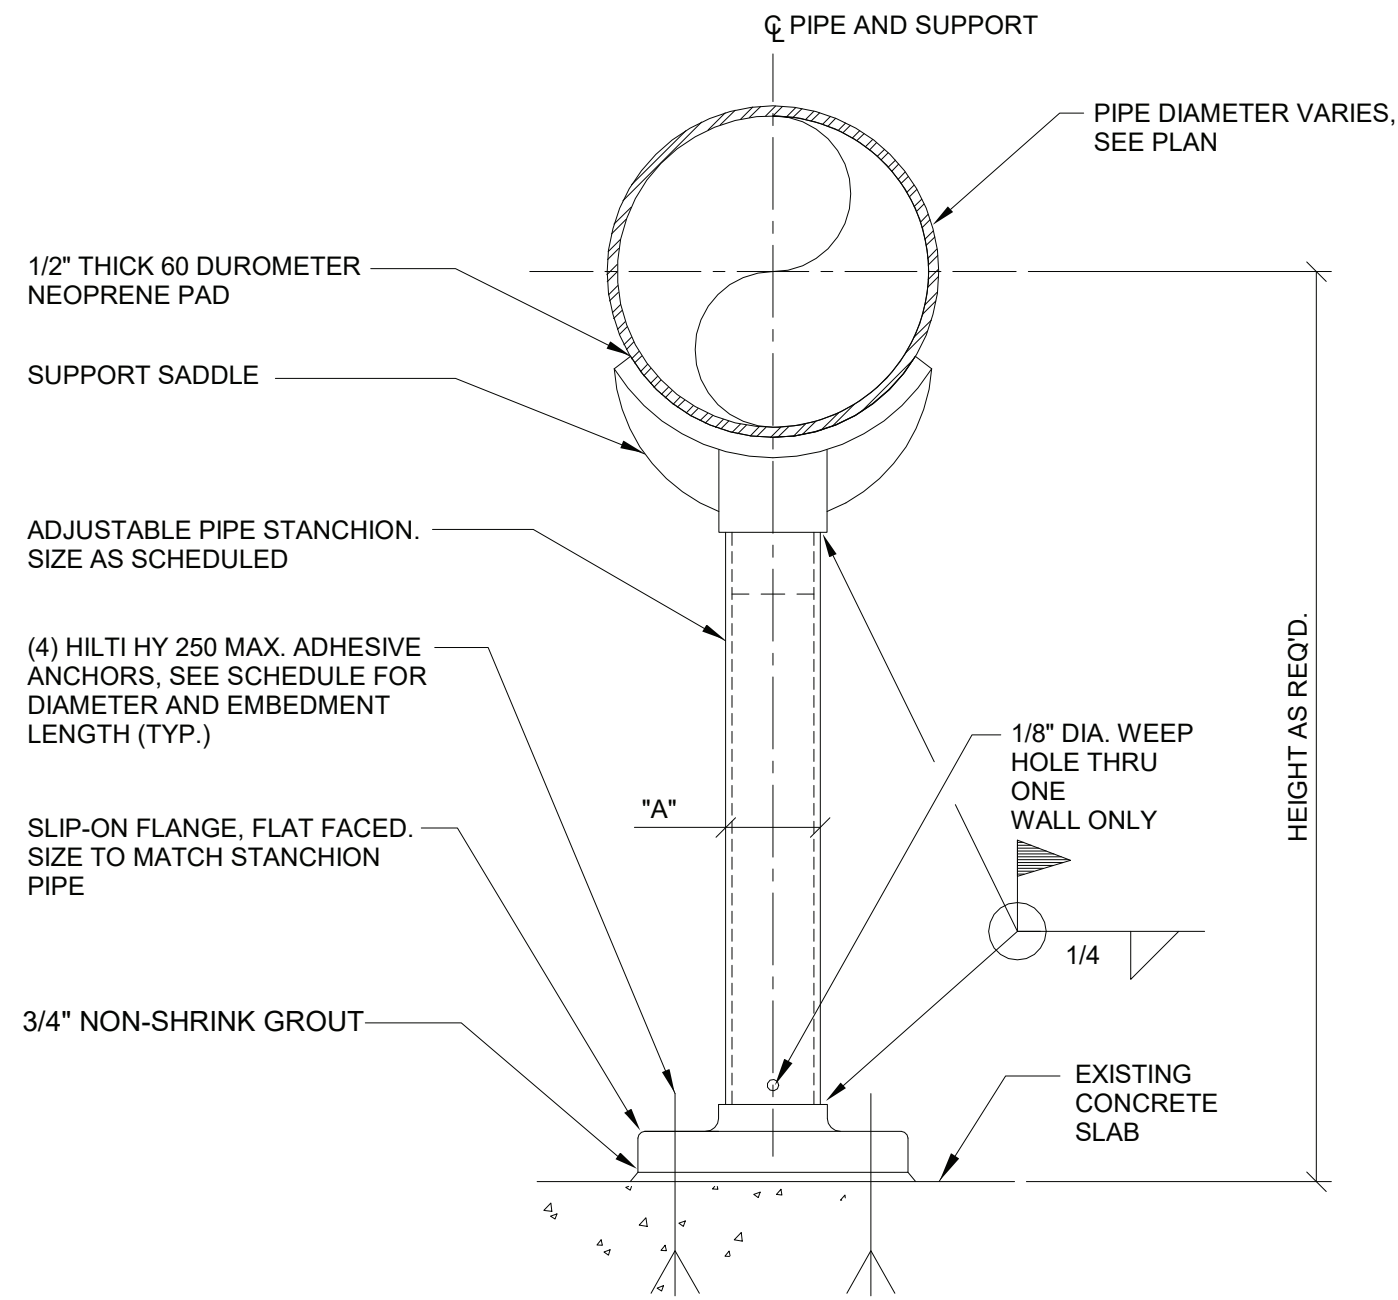


NOMINAL PIPE SIZE	'A'	ANCHOR SIZE	EMBEDMENT LENGTH
2.5 - 3.5	2.50	5/8"	5"
4 - 12	3.00	5/8"	5"

DETAIL NOTES:


1. SEE SPECIFICATIONS FOR MATERIAL REQUIREMENTS IN PARTICULAR LOCATIONS AND PIPE SUPPORT SPACING.

TYPICAL PIPE STANCHION DETAIL (2 1/2" - 12"Ø)

NOT TO SCALE

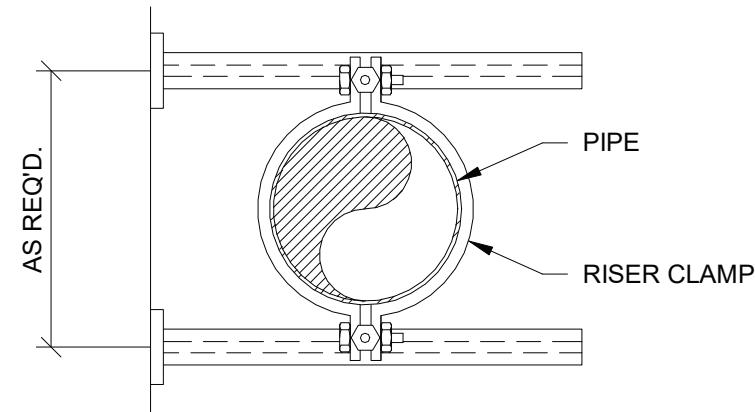

PLAN

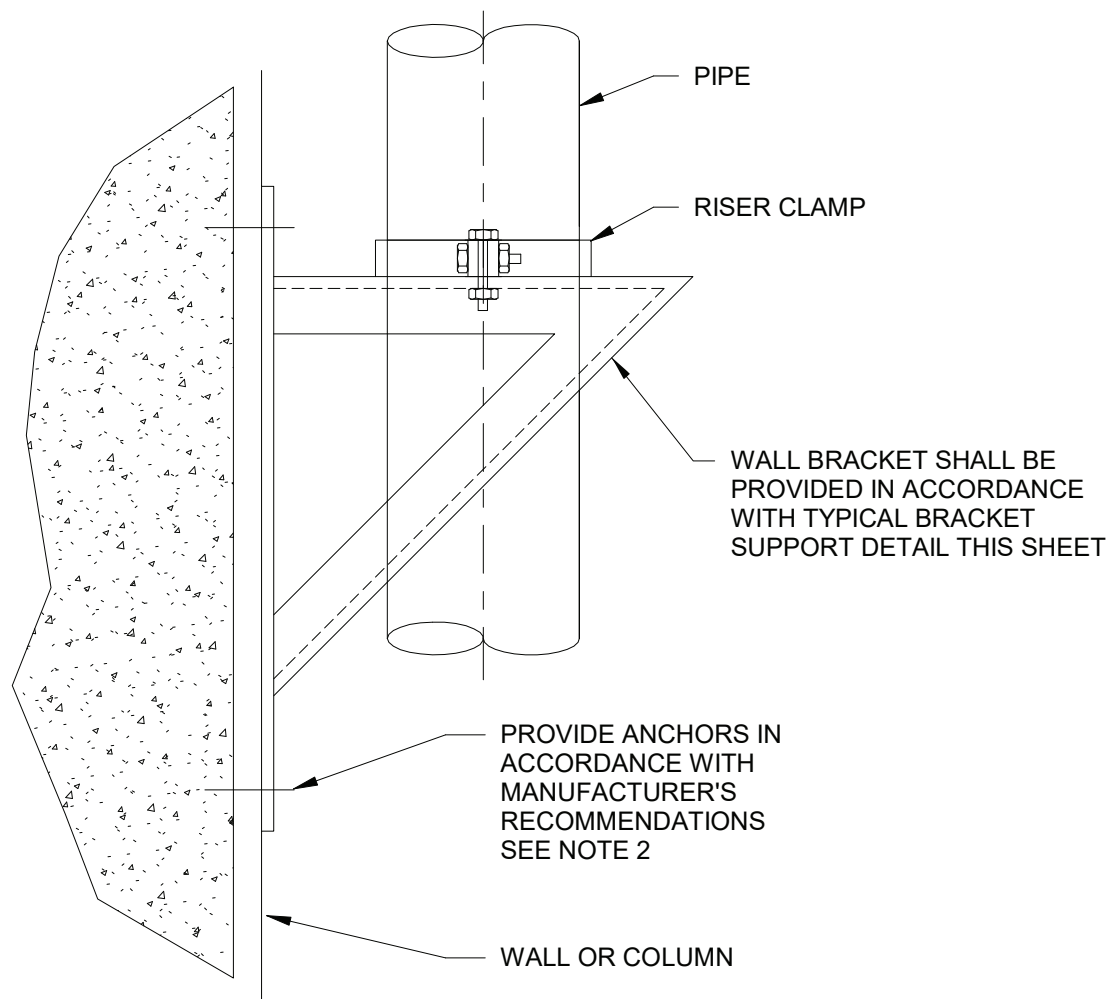


ELEVATION

DETAIL NOTES:

1. CONTRACTOR SHALL COORDINATE ATTACHMENT METHOD, INCLUDING ANCHOR SIZE, TYPE AND SPACING WITH BRACKET MANUFACTURER AND OBTAIN ENGINEER'S APPROVAL.

TYPICAL VERTICAL PIPE SUPPORT DETAIL

NOT TO SCALE

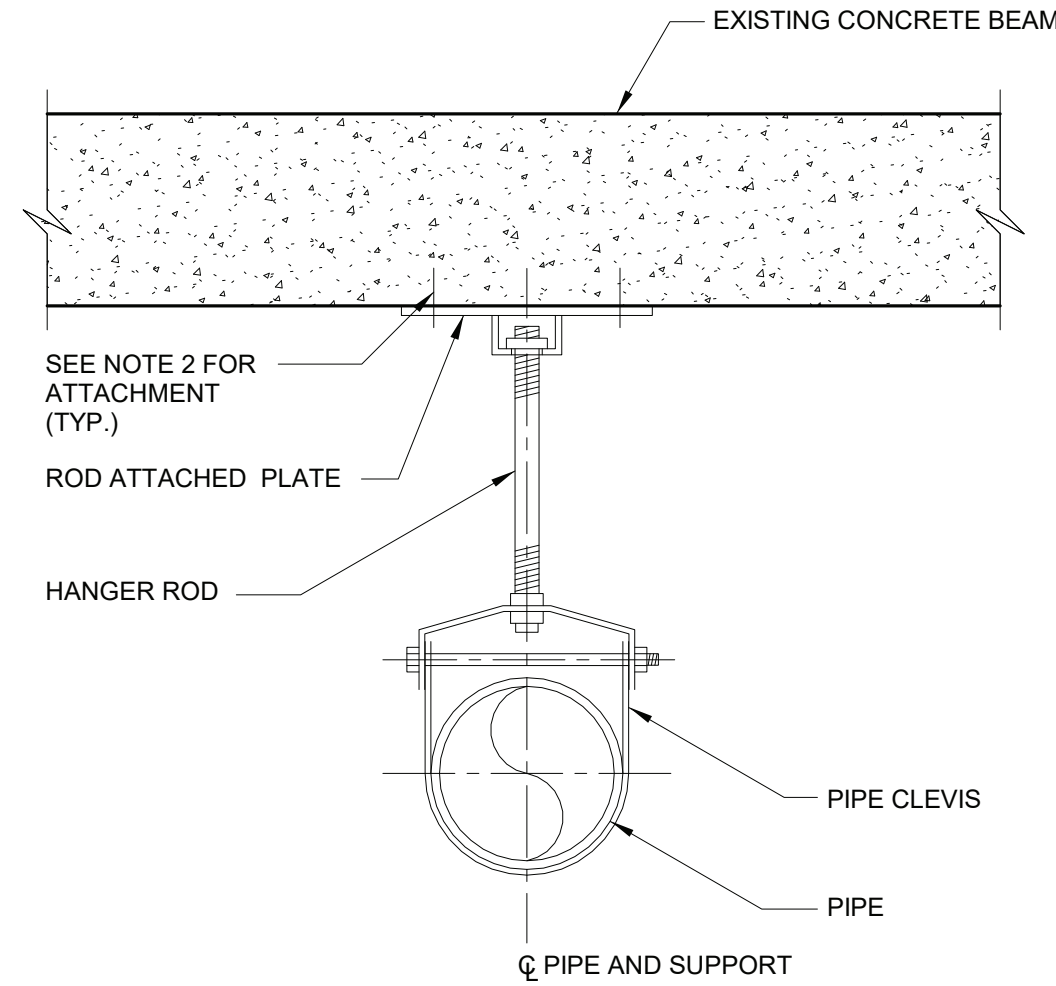


DETAIL NOTES:

1. SEE SPECIFICATIONS FOR HANGER ROD SIZING, PIPE SUPPORT SPACING AND MATERIAL REQUIREMENTS FOR SPECIFIC LOCATIONS.
2. ATTACH TO CONCRETE USING (4) HILTI HDI-P 3/8" DROP-IN ANCHORS. USE OF CONCRETE INSERTS OR CHANNEL SECTIONS IS ACCEPTABLE.

TYPICAL PIPE CLEVIS DETAIL

NOT TO SCALE

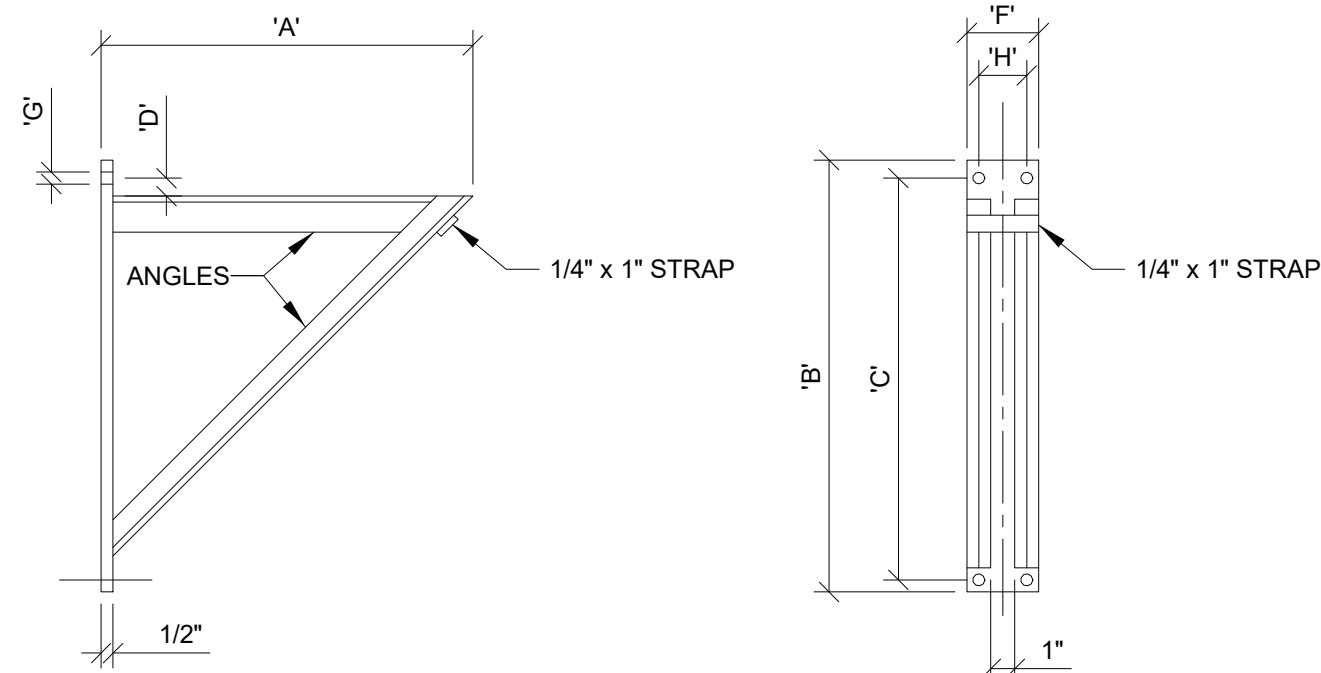


PIPE SIZE	'A'	'B'	'C'	'D'	'E'	'G'	'H'
8" AND SM.	*	18"	15 1/4"	1 1/4"	4"	13/16"	0"
10" TO 12"	*	30"	27 1/2"	1 1/2"	5"	1 1/16"	2 1/2"
14" TO 20"	*	36"	33 1/2"	1 1/2"	5"	1 1/16"	2 1/2"

DETAIL NOTES:

1. LOAD NOT TO EXCEED 3,000 LBS. ANGLE SIZE TO BE DETERMINED BY THE CONTRACTOR AND APPROVED BY THE CONSULTING ENGINEER.
2. * AS REQUIRED.
3. SEE SPECIFICATIONS FOR MATERIAL REQUIREMENTS IN PARTICULAR LOCATIONS.

TYPICAL BRACKET SUPPORT DETAIL

NOT TO SCALE

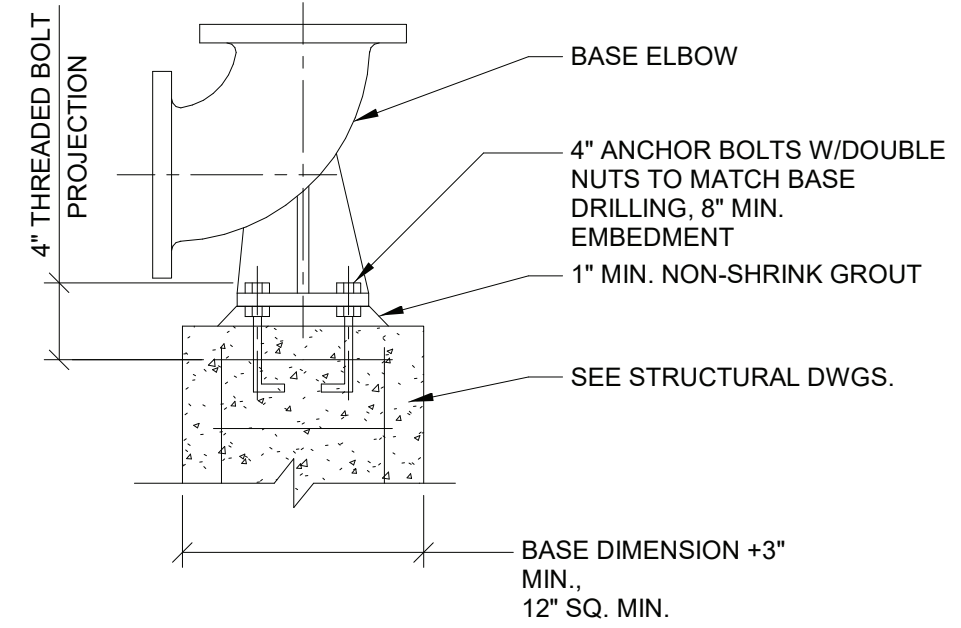


DETAIL NOTES:

1. DETAIL TO BE USED FOR SUPPORT OF VERTICAL TEE OR CROSS.

TYPICAL BASE ELBOW DETAIL


NOT TO SCALE

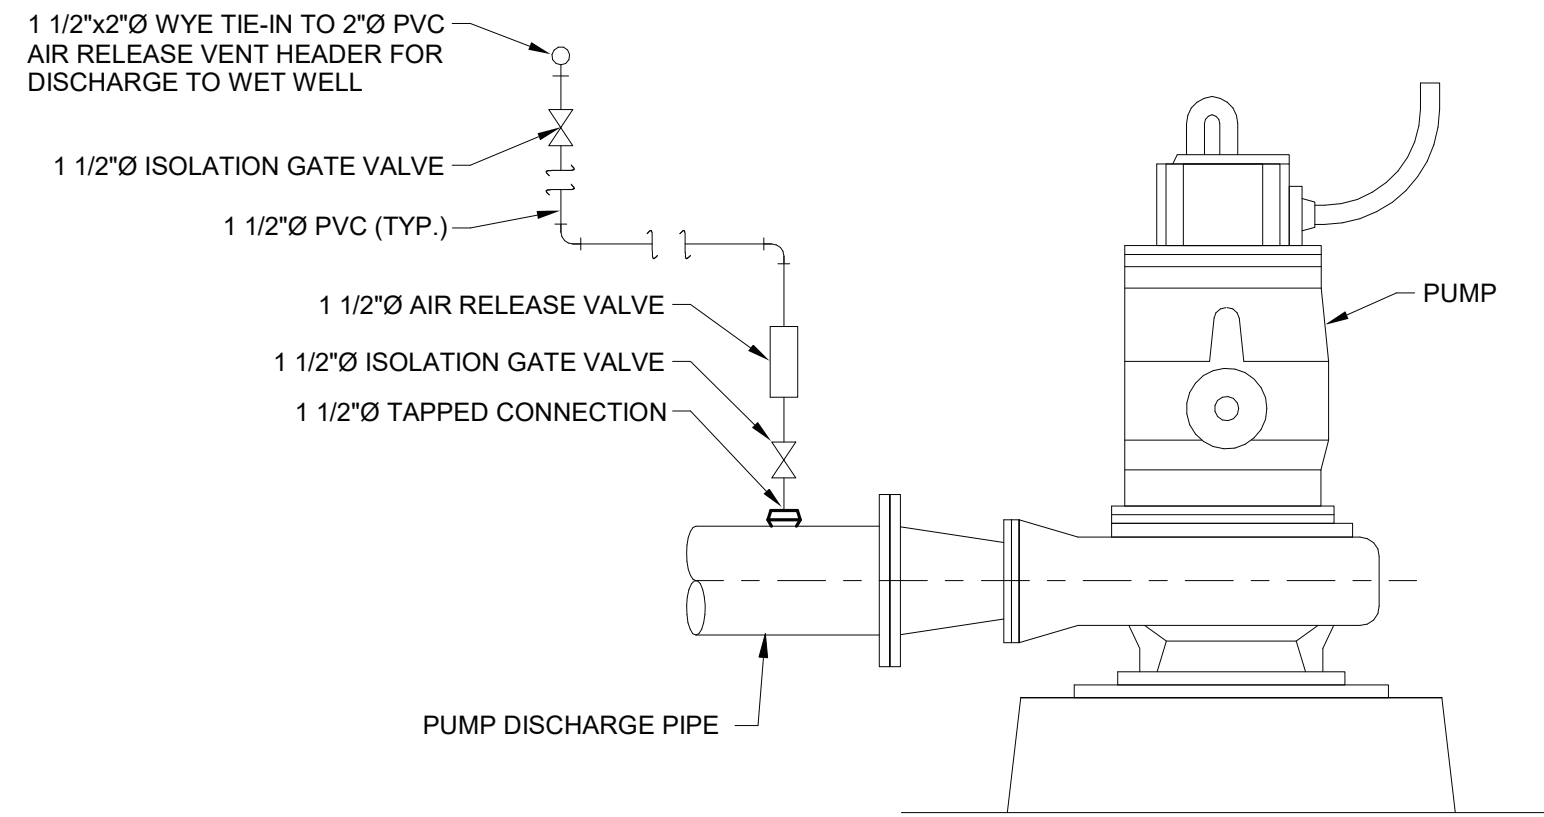

TYPICAL PUMP AIR RELEASE DETAIL

NOT TO SCALE

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O'BRIEN & GERE ENGINEERS, INC.		50 MAIN ST., 10TH FLOOR SUITE 1000, WHITE PLAINS, NEW YORK 10606																																	
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DEPARTMENT OF PUBLIC WORKS AND TRANSPORTATION			SHEET NUMBER M-501																																
DIVISION OF ENGINEERING			SHEET NO. 31 OF 60																																
CROTONVILLE PUMPING STATION REHABILITATION			SCALE: AS NOTED																																
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TYPICAL DETAILS			REV. NO. 0																																

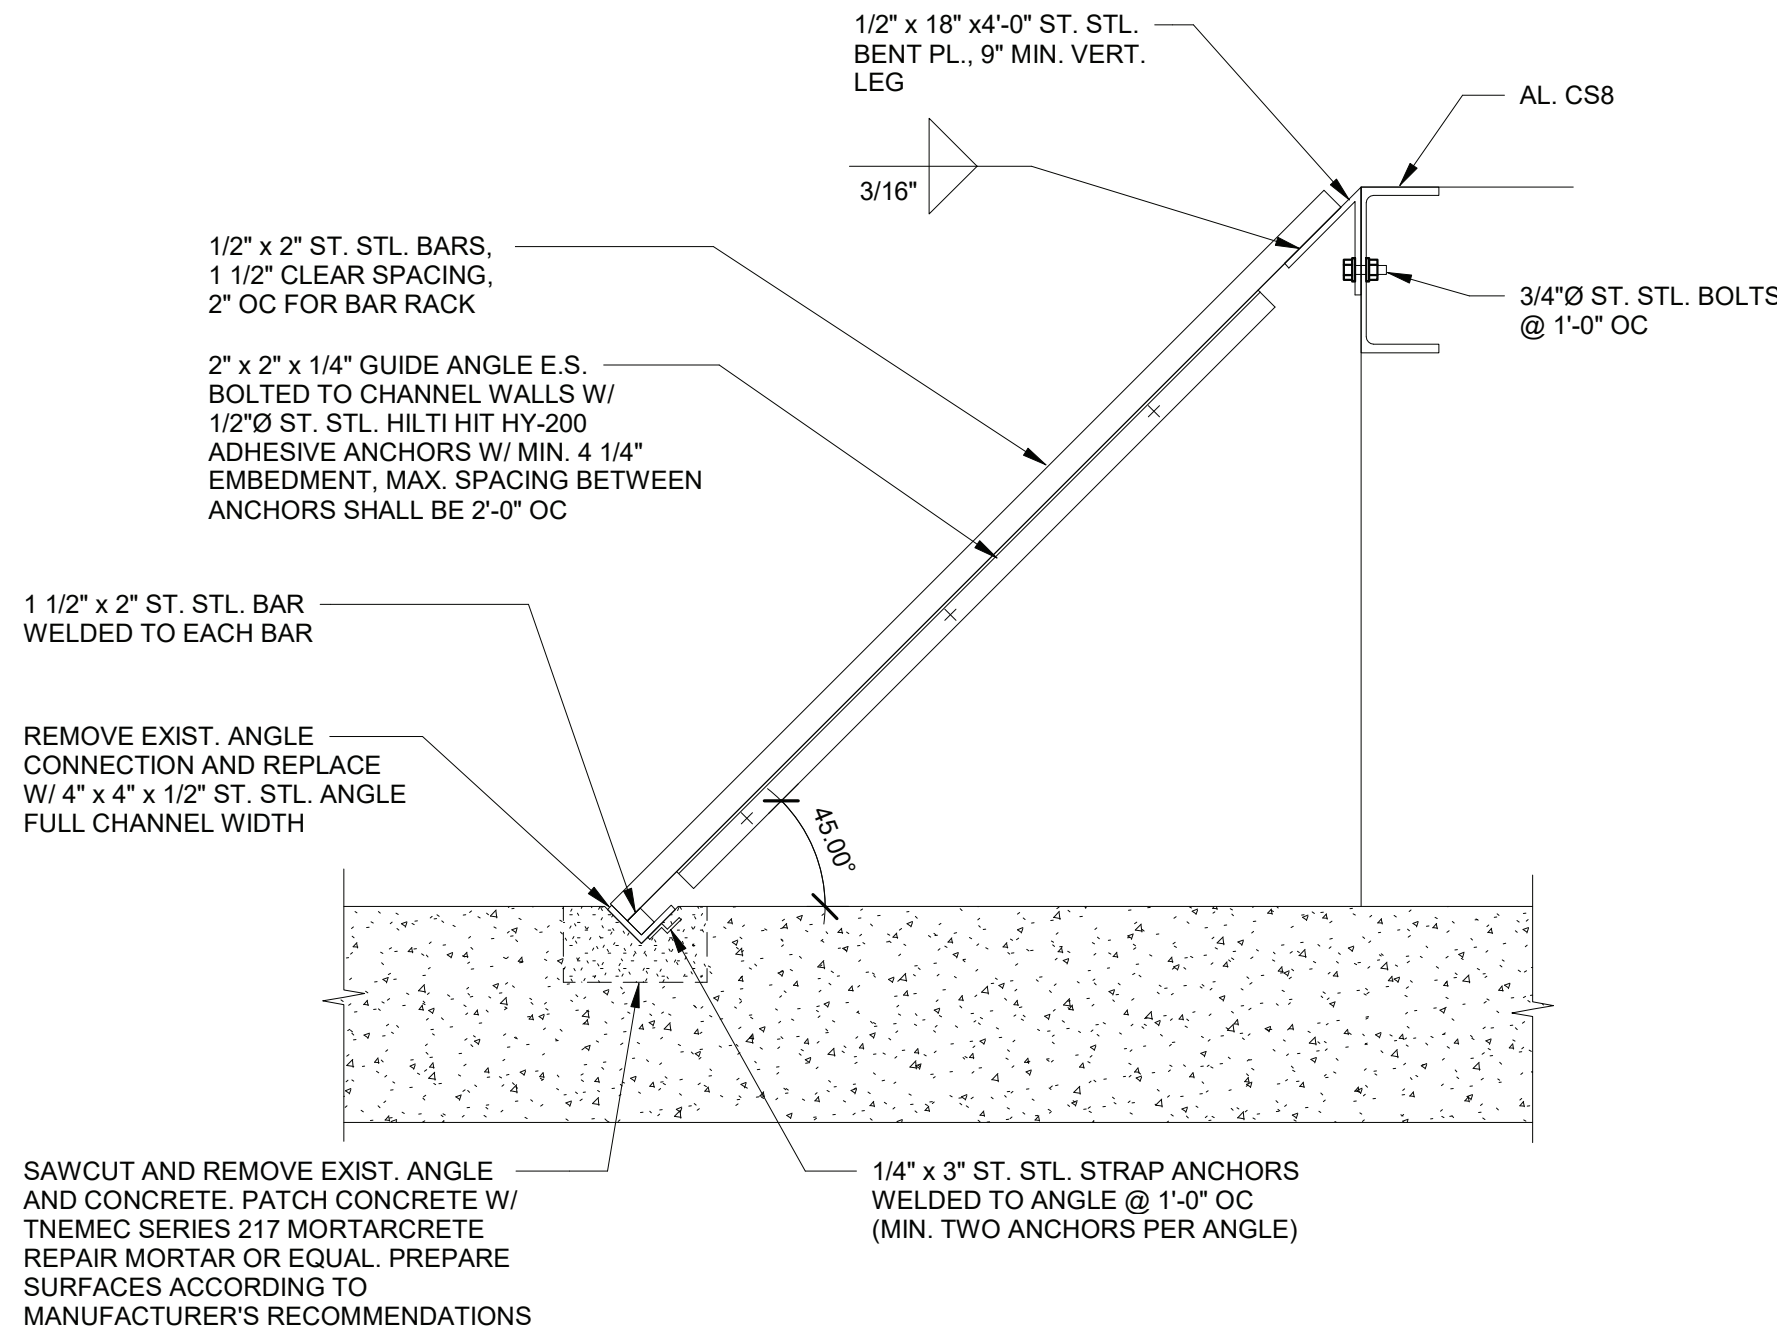


- DETAIL NOTES:**
- HARDWARE AND FRAMING SHALL BE TYPE 316 STAINLESS STEEL.
 - BAR RACKS SHALL BE FABRICATED TO SUIT EXIST. STRUCTURE.

BYPASS CHANNEL BAR RACK DETAIL

3/4" = 1'-0"


6" 3" 0 1' 2'

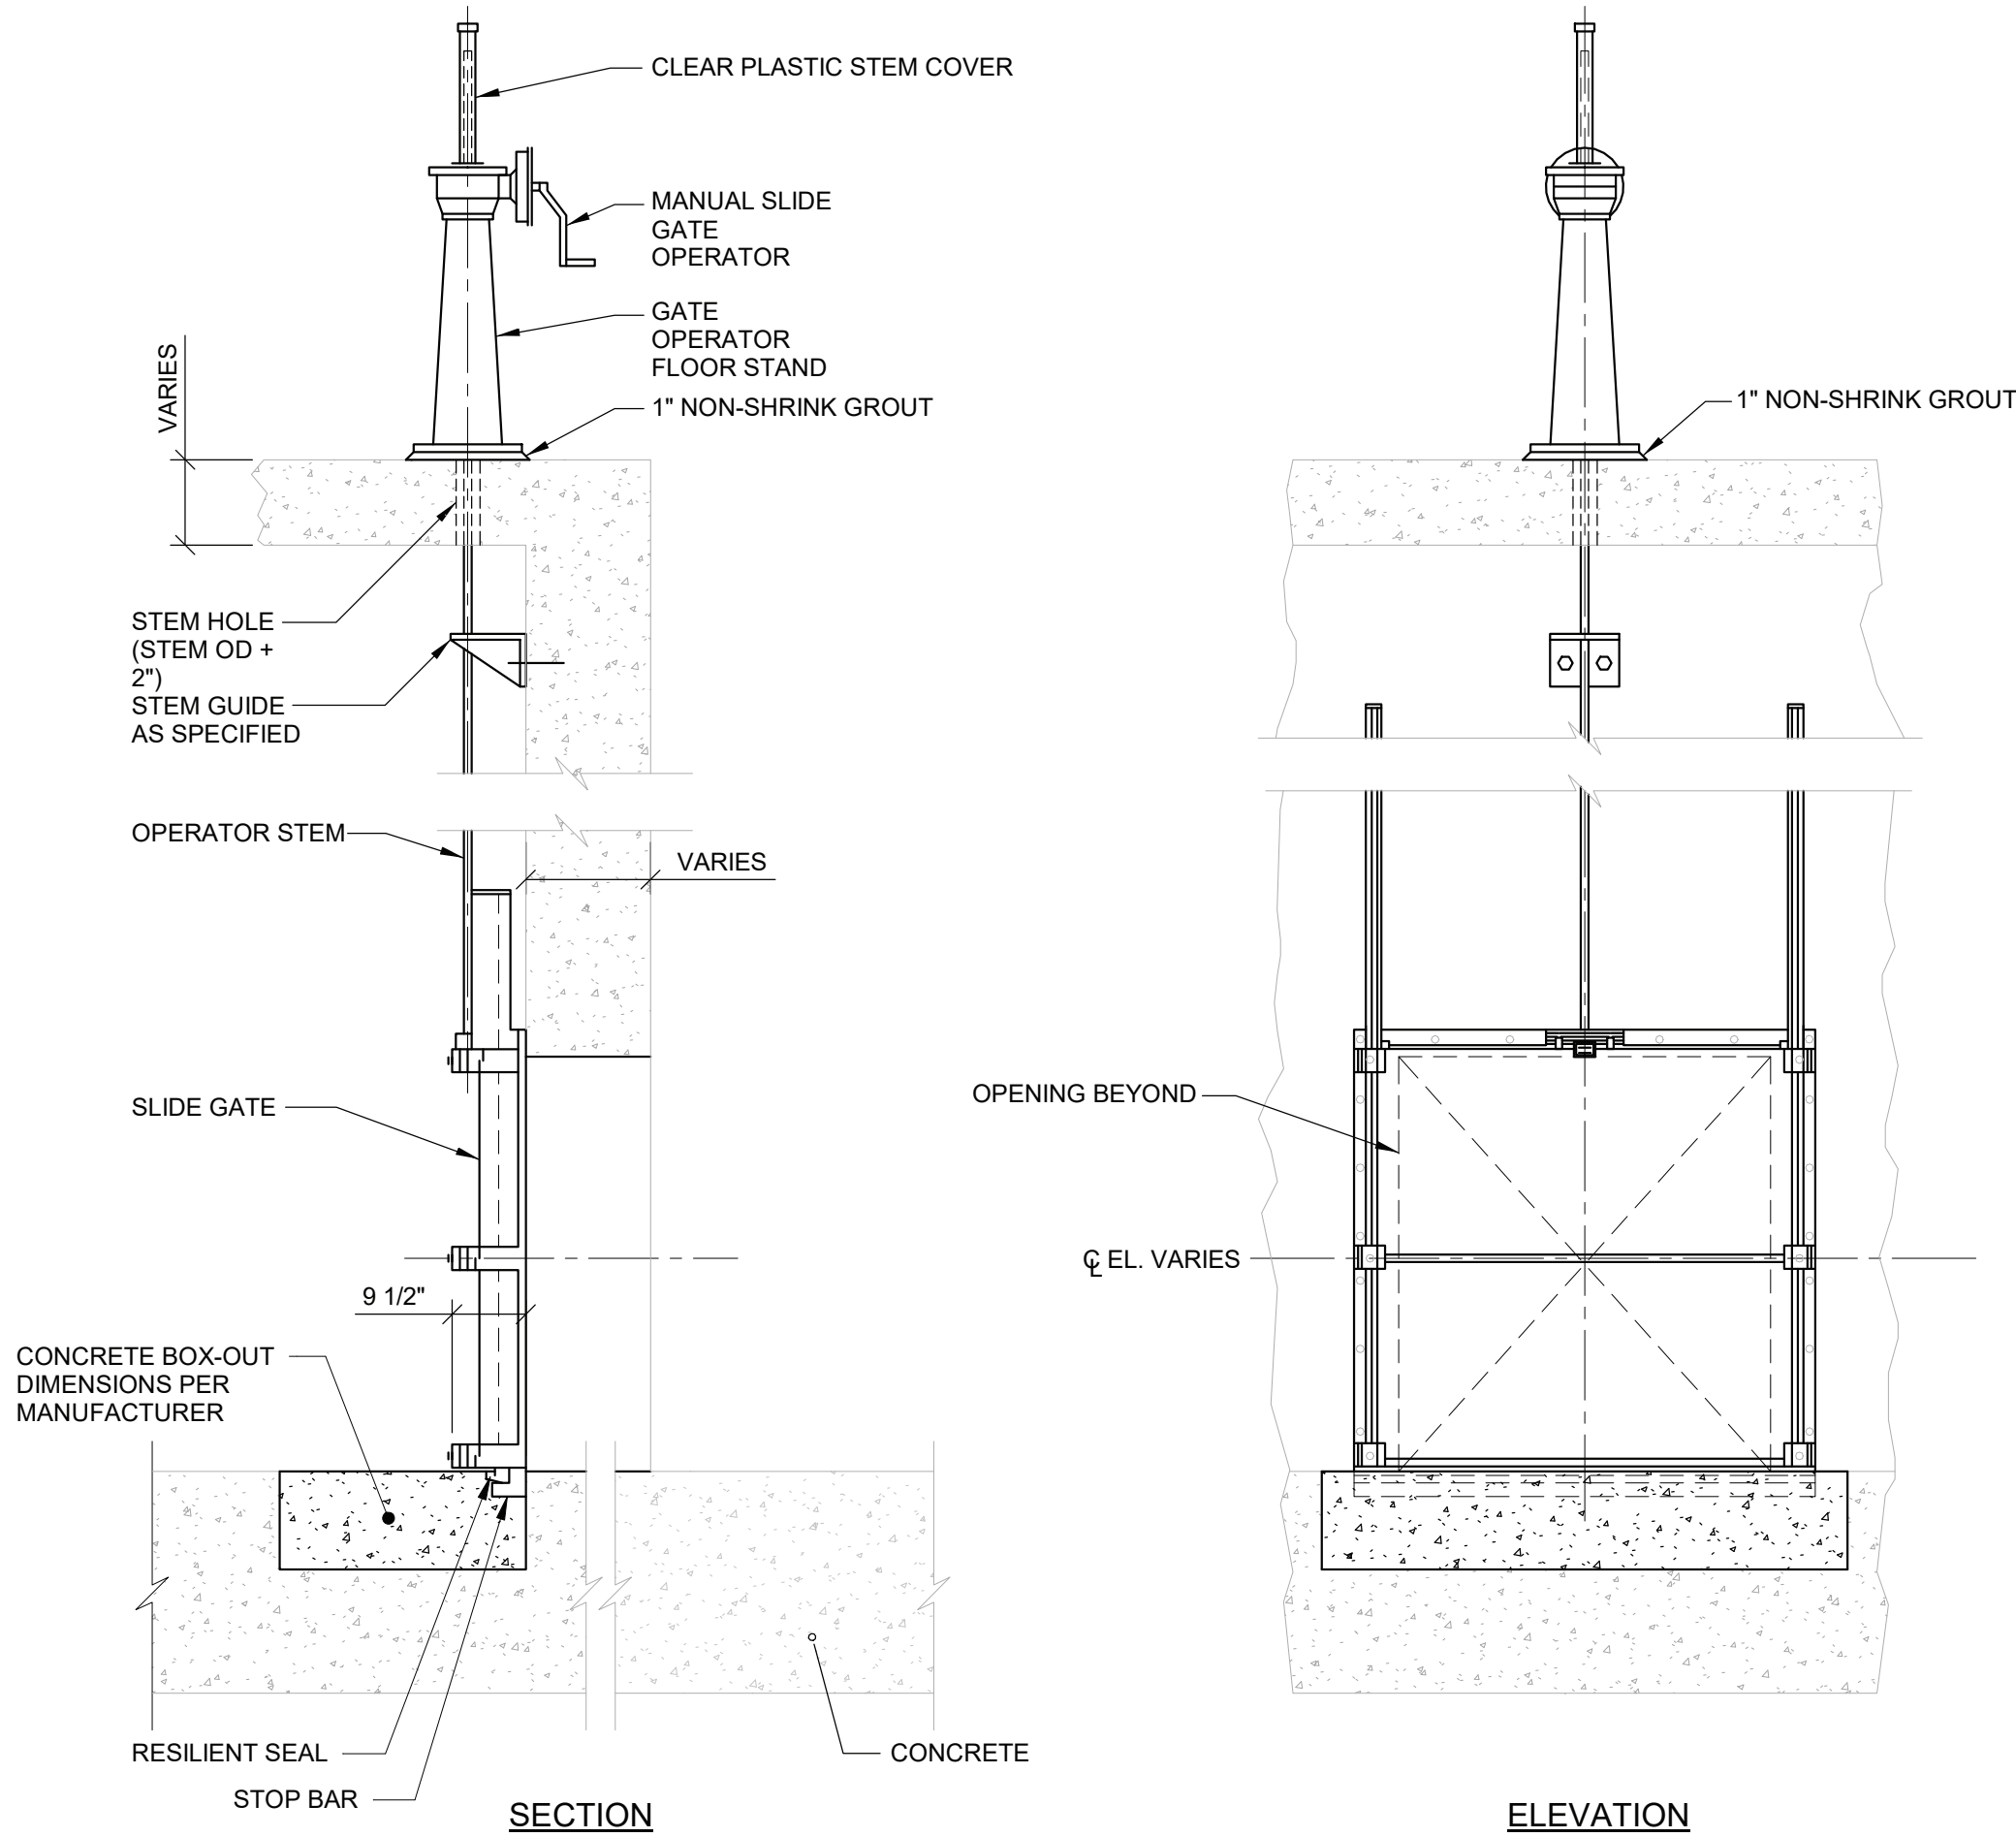

- DETAIL NOTES:**
- COORDINATE GATE MOUNTING WITH MANUFACTURER'S RECOMMENDATIONS.
 - OPERATOR SHOWN IS REPRESENTATIVE ONLY. REFER TO SECTION 40 05 59.

SLIDE GATE MOUNTING DETAIL

NOT TO SCALE

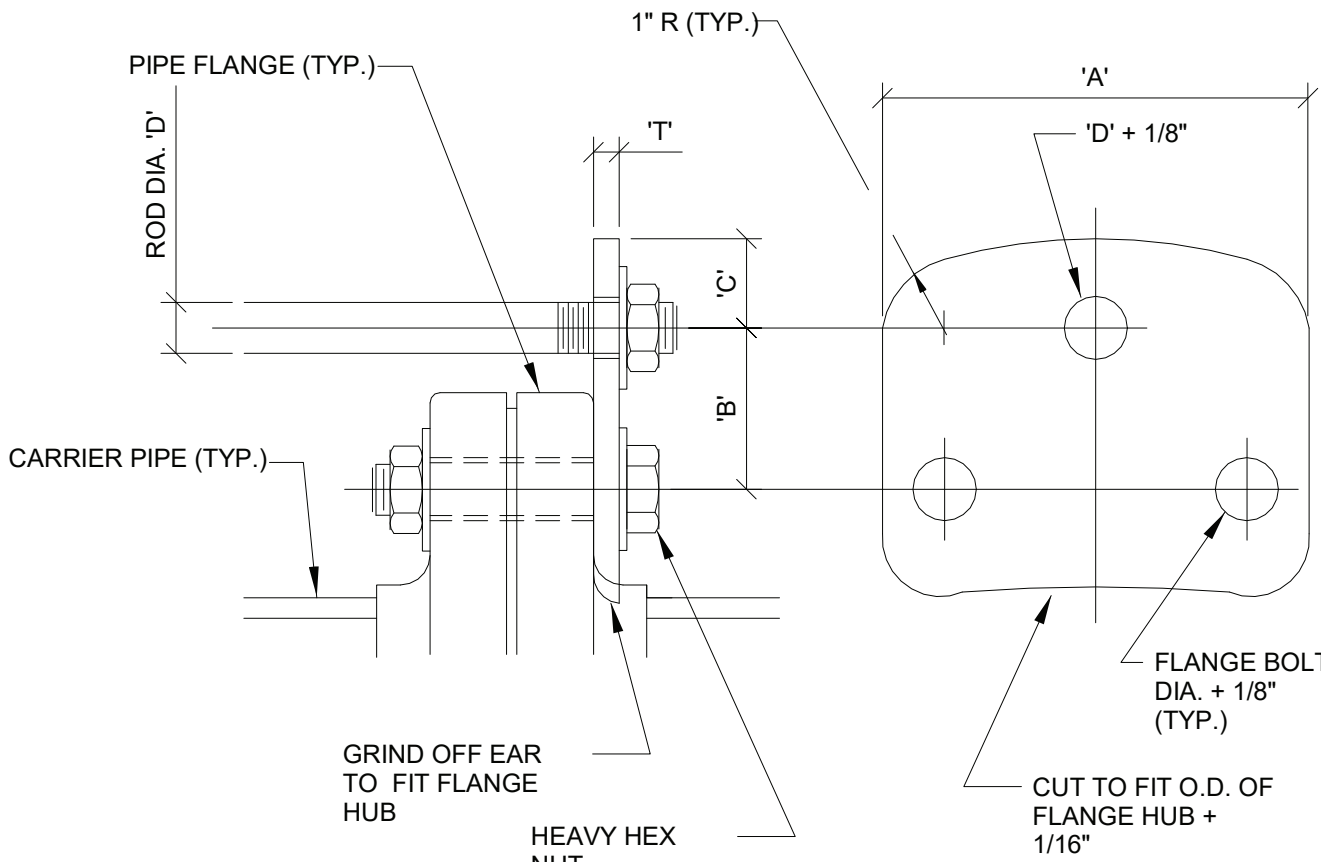

DETAIL NOTES:

- ALL DIMENSIONS GIVEN IN HARNESS EAR SCHEDULE ARE IN INCHES.
- HARNESS EAR MATERIAL SHALL CONFORM TO ASTM A36.
- HARNESSING ROD SHALL CONFORM TO ASTM A449.

TYPICAL HARNESSING EAR DETAIL

NOT TO SCALE

HARNESS EAR DIMENSION SCHEDULE					
ROD DIA. 'D'	PIPE SIZES	'A'	'B'	'C'	'T'
5/8	4, 6	7	2 1/2	1 1/4	1
	8, 10, 12	7 1/2	2 1/2		
	16, 20	8	3		
	14, 18	8 1/2	3		
3/4	6	7	2 1/2	1 1/2	1 1/8
	8, 10, 12	7 1/2	2 1/2		
	16, 20	8	3		
	14, 18	8 1/2	3		
	24, 30	9	3		
1	10	7 1/2	2 1/2	1 1/2	1 1/2
	16, 20	8	3		
	14, 18	8 1/2	3		
	24, 30, 36	9	3		
	42, 48	9 1/2	3 1/2		


ALLOWABLE TEST PRESSURE (PSIG) FOR VARIOUS PIPE SIZES AND No./DIA. OF HARNESS RODS														
PIPE SIZE \ NO. & DIA. OF RODS	(2) 5/8"	(2) 3/4"	(2) 1"	(2) 1 1/4"	(2) 1 1/2"	(4) 5/8"	(4) 3/4"	(4) 1"	(4) 1 1/4"	(4) 1 1/2"	(6) 1 1/2"	(8) 1 1/2"	(8) 2"	
4"	0-250													
6"		0-250												
8"		0-250												
10"		0-250												
12"		0-232	0-250			162-250	233-250							
14"		0-170	0-250			119-237	171-250							
16"		0-131	0-232			92-181	132-250	233-250						
18"		0-103	0-183			73-143	104-206	184-250						
20"		0-84	0-149	0-203		59-116	85-167	150-250	204-250					
24"		0-58	0-103	0-141			59-116	104-206	142-250					
30"		0-37	0-66	0-90	0-130		38-74	67-132	91-180	131-250				
36"			0-46	0-63	0-90			47-92	64-125	91-180	181-250			
42"			0-36	0-46	0-66			35-67	47-92	67-133	134-199	200-250		
48"			0-34	0-26	0-51			27-52	36-70	52-102	103-152	153-203		
54"					0-40					41-80	81-120	121-160		
60"					0-32					33-65	66-97	98-130	131-180	

NOTE:

- HARNESSING ROD SHALL CONFORM TO ASTM A449.

TYPICAL HARNESS ROD SCHEDULE

NOT TO SCALE

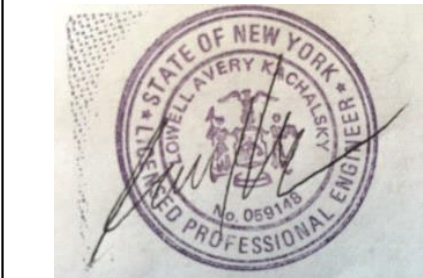

IN ACCORDANCE WITH TITLE VIII, ARTICLE 145, SECTION 7209 (2) OF THE NEW YORK STATE EDUCATION LAW, IT IS A VIOLATION OF LAW FOR ANY PERSON UNLESS ACTING UNDER THE DIRECTION OF A LICENSED ENGINEER TO ALTER THIS DOCUMENT.

IN CHARGE OF R. GELL
CHECKED BY D. ROONEY
MADE BY T. LARAMAY



O'BRIEN & GERE ENGINEERS, INC.
50 MAIN ST., 10TH FLOOR SUITE 1000,
WHITE PLAINS, NEW YORK 10606

DocuSign

REVISION NUMBER DATE MADE BY APP'D BY REVISION

RECORD DRAWING CERTIFICATION




- ☐ AS BUILT - CHANGES AS NOTED
☐ AS BUILT - NO CHANGES

CONTRACTOR			PROJECT COORDINATOR		
NAME _____			NAME _____		
SIGNATURE _____			SIGNATURE _____		
TITLE _____		DATE _____	TITLE _____		DATE _____
WESTCHESTER COUNTY, NEW YORK DEPARTMENT OF PUBLIC WORKS AND TRANSPORTATION DIVISION OF ENGINEERING			CONTRACT NUMBER 17-529	SHEET NUMBER M-502	
			SHEET NO. 32 OF 60		
			SCALE: AS NOTED DATE: 12/21/2018		
CROTONVILLE PUMPING STATION REHABILITATION OSSINING SEWER DISTRICT OSSINING, NEW YORK TYPICAL DETAILS			DPW FILE NO. 208-03-M-56-0		REV. NO. 0

SYMBOL DEFINITIONS & FUNCTIONS TABLE			LOCATION & ACCESSIBILITY
CONTROLLER	DISCRETE	PILOT LIGHT	
			<ul style="list-style-type: none">LOCATED IN FIELDNOT IN PANEL, CABINET OR CONSOLE MOUNTEDVISIBLE AT FIELD LOCATIONNORMALLY OPERATOR ACCESSIBLE
			<ul style="list-style-type: none">LOCATED IN OR ON FRONT OF CENTRAL OR MAIN PANEL OR CONSOLEVISIBLE ON FRONT OF PANEL OR ON VIDEO DISPLAYNORMALLY OPERATOR ACCESSIBLE AT PANEL OR CONSOLE
			<ul style="list-style-type: none">LOCATED IN REAR OF CENTRAL OR MAIN PANELLOCATED IN CABINET BEHIND PANELNOT VISIBLE ON FRONT OF PANEL OR ON VIDEO DISPLAYNOT NORMALLY OPERATOR ACCESSIBLE AT PANEL OR CONSOLE
			<ul style="list-style-type: none">LOCATED IN OR ON FRONT OF SECONDARY OR LOCAL PANEL OR CONSOLEVISIBLE ON FRONT OF PANEL OR ON VIDEO DISPLAYNORMALLY OPERATOR ACCESSIBLE AT PANEL FRONT OR CONSOLE
			<ul style="list-style-type: none">LOCATED IN OR ON FRONT OF SECONDARY OR LOCAL PANELLOCATED IN FIELD CABINETNOT VISIBLE ON FRONT OF PANEL OR ON VIDEO DISPLAYNOT NORMALLY OPERATOR ACCESSIBLE AT PANEL OR CONSOLE

DEVICE NOTATION TABLE			
ANALYSIS			
AIR	- EXCESS AIR	H2O	- WATER
CO	- CARBON DIOXIDE	H2S	- HYDROGEN SULFIDE
CL2	- CHLORINE RESIDUAL	IR	- INFRARED
COMB	- COMBUSTIBLES	MOIST	- MOISTURE
COND	- ELEC. CONDUCTIVITY	NH4	- AMMONIA
DEN	- DENSITY	NO3	- NITRATE
DO	- DISSOLVED OXYGEN	O2	- OXYGEN
ORP	- OXIDATION REDUCTION POTENTIAL	pH	- HYDROGEN ION
		TC	- THERMAL CONDUCTIVITY
		TURB	- TURBIDITY
		UV	- ULTRAVIOLET
		VISC	- VISCOSITY
FLOW			
CONE	- CONE	MAG	- MAGNETIC
COR	- CORIOLIS	OP	- ORIFICE PLATE
DOP	- DOPPLER	PD	- POSITIVE DISPLACEMENT
DSON	- DOPPLER SONIC	PT	- PITOT TUBE
FLN	- FLOW NOZZLE	PV	- PITOT VENTURI
FLT	- FLOW TUBE	SNR	- SONAR
LAM	- LAMINAR	SON	- SONIC
THER	- THERMAL	TTS	- TRANSIT TIME SONIC
TUR	- TURBINE	ULTRASONIC	- ULTRASONIC
VENT	- VENTURI	VOR	- VORTEX SHEDDING
WDG	- WEDGE		
LEVEL			
CAP	- CAPACITANCE	LSR	- LASER
DP	- DIFFERENTIAL PRESSURE	MAG	- MAGNETIC
DI	- DIELECTRIC CONSTANT	NUC	- NUCLEAR
GWR	- GUIDED WAVE RADAR	RAD	- RADAR
RES	- RESISTANCE	SONIC	- SONIC
US	- ULTRASONIC	VIB	- VIBRATION
PRESSURE			
ABS	- ABSOLUTE	MAN	- MANOMETER
AVG	- AVERAGE	P-V	- PRESSURE-VACUUM
DRF	- DRAFT	SG	- STRAIN GAUGE
VAC	- VACUUM		
TEMPERATURE			
BM	- BI-METALLIC	TC	- THERMOCOUPLE
IR	- INFRARED	TCK	- THERMOCOUPLE TYPE K
RAD	- RADIATION	TCT	- THERMOCOUPLE TYPE T
RTD	- RES TEMP DETECTOR	TCE	- THERMOCOUPLE TYPE E
TCJ	- THERMOCOUPLE TYPE J	THERM	- THERMISTOR
TRANS	- TRANSISTOR		
MISCELLANEOUS			
BURNER, COMBUSTION		POSITION	SPEED
FR	- FLAME ROD	CAP	- CAPACITANCE
IGN	- IGNITER	IR	- INFRARED
IR	- INFRARED	LAS	- LASER
TV	- TELEVISION	MAG	- MAGNETIC
		MECH	- MECHANICAL
		OPT	- OPTICAL
WEIGHT, FORCE		MOTOR CONTROL	
LC	- LOAD CELL	FVR	- FULL VOLTAGE REVERSING
SG	- STRAIN GAUGE	FVNR	- FULL VOLTAGE NON-REV
WS	- WEIGHT SCALE	RVS	- REDUCED VOLTAGE
		RVAT	- REDUCED VOLTAGE AUTO-TRANSFORMER
SST	- SOLID STATE (SOFT START)	VFC	- VARIABLE FREQUENCY CONTROLLER (AC)
VFD	- VARIABLE FREQ DRIVE (DC)		
YSD	- VARIABLE SPEED DRIVE		

NOTE: NOTATIONS MAY BE USED IF A GRAPHIC SYMBOL DOES NOT EXIST.

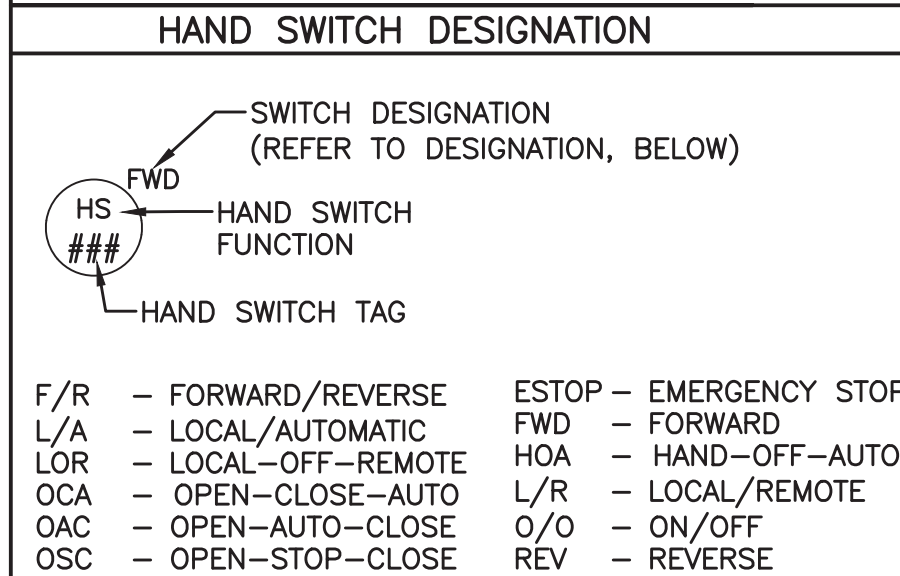
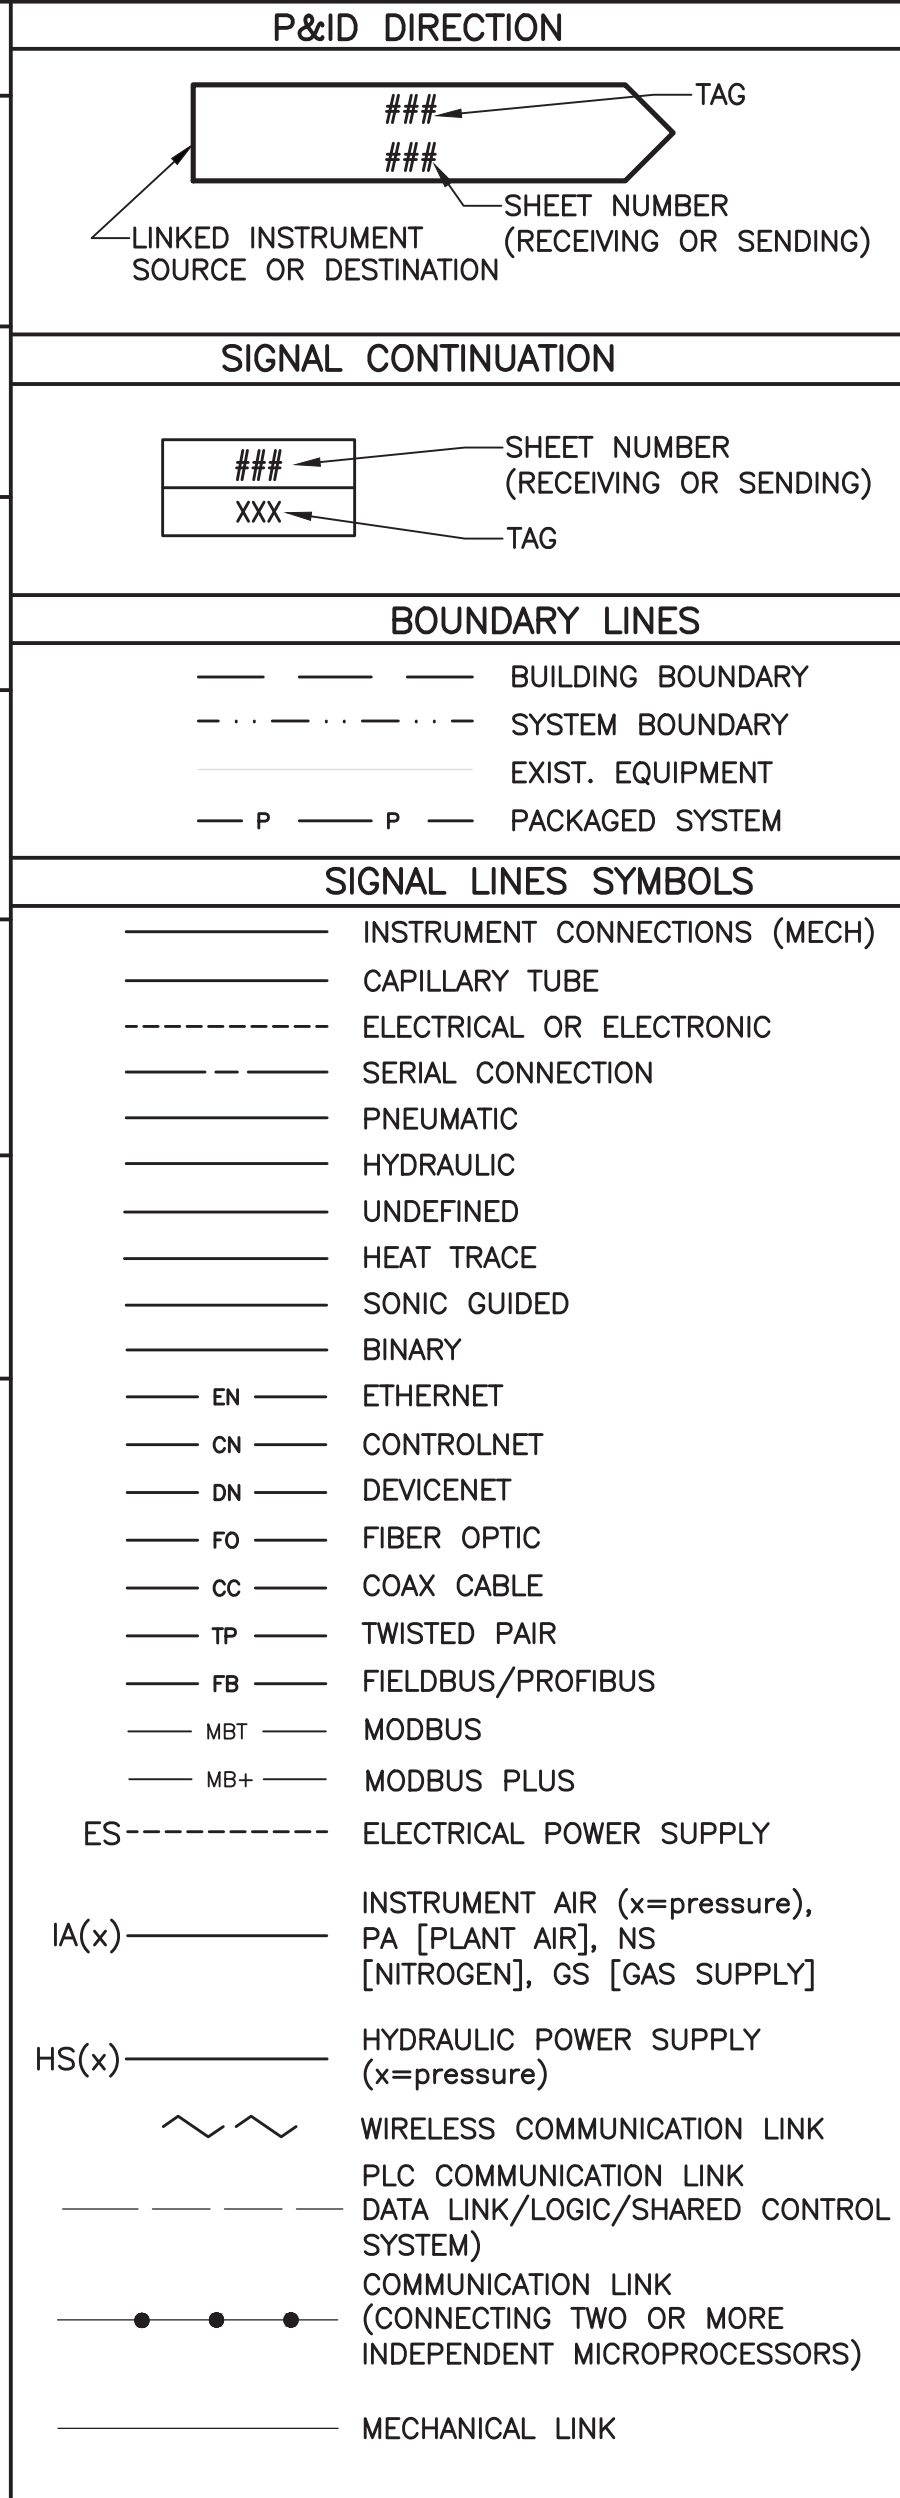
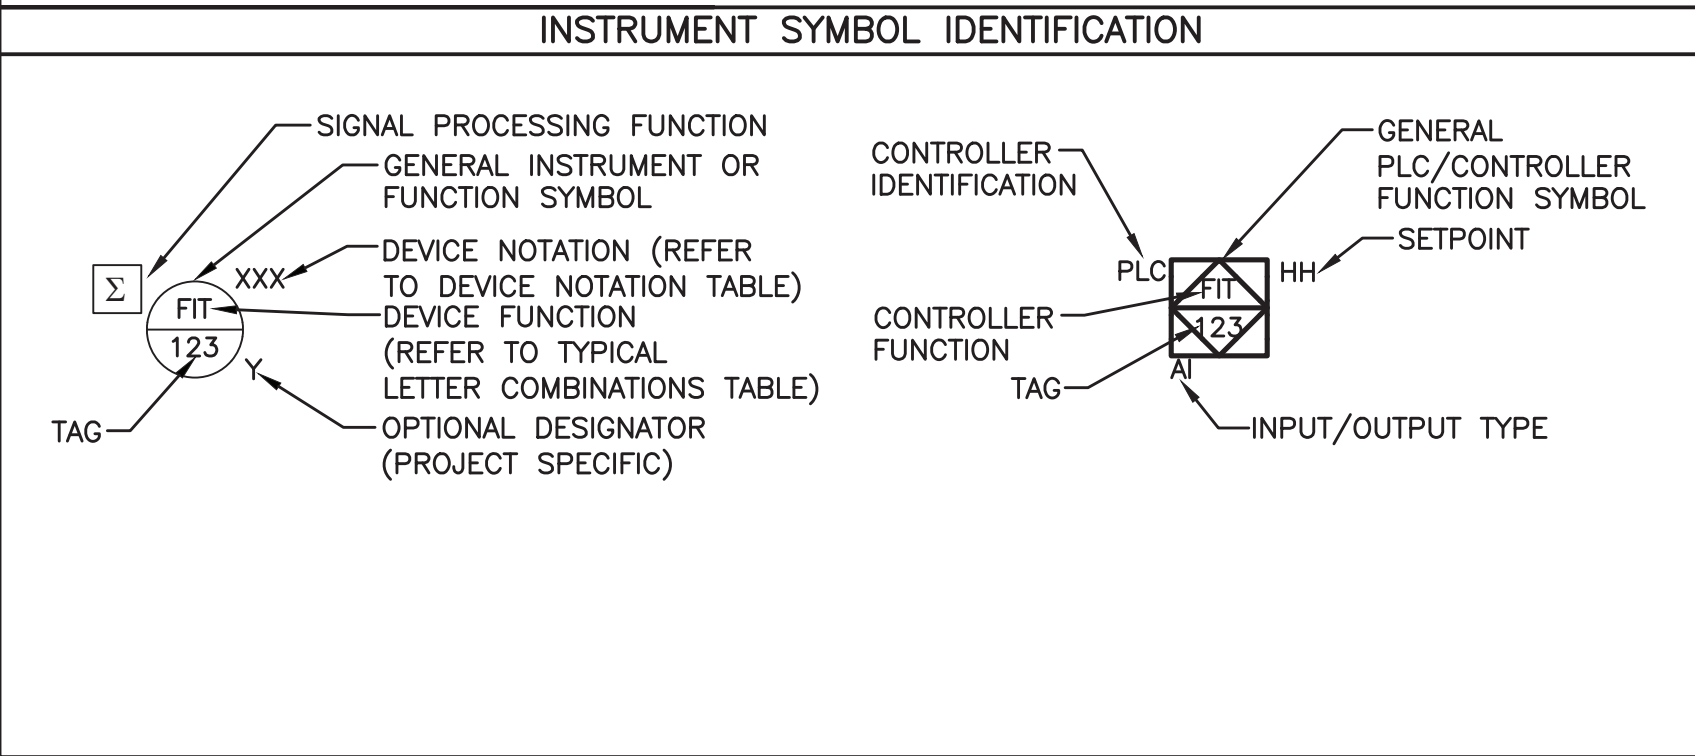


SETPOINT & I/O TYPES	
AI	- ANALOG INPUT
AO	- ANALOG OUTPUT
DI	- DISCRETE INPUT
DO	- DISCRETE OUTPUT
DO	- DISCRETE OUTPUT
H	- HIGH
HH	- HIGH HIGH
L	- LOW
LL	- LOW LOW

PIPING MATERIAL	
BS	- BLACK STEEL
CI	- CAST IRON
CPVC	- CHLORINATED POLYVINYL CHLORIDE
DIP	- DUCTILE IRON PIPE
FRP	- FIBER REINFORCED PIPE
GCS	- GALVANIZED CARBON STEEL
HDPE	- HIGH DENSITY POLYETHYLENE
PVC	- POLYVINYL CHLORIDE
RCP	- REINFORCED CONCRETE PIPE
SS	- STAINLESS STEEL

NOTE

INFORMATION ON THIS DRAWING IS BASED ON THE INTERNATIONAL SOCIETY OF AUTOMATION (ISA) STANDARDS "ANSI/ISA-5.1-2009 INSTRUMENTATION SYMBOLS AND IDENTIFICATION" AND "ANSI/ISA-5.3-1983 GRAPHIC SYMBOLS FOR DISTRIBUTED CONTROL/SHARED DISPLAY INSTRUMENTATION, LOGIC AND COMPUTER SYSTEMS". REFER TO ANSI/ISA FOR FURTHER INFORMATION.

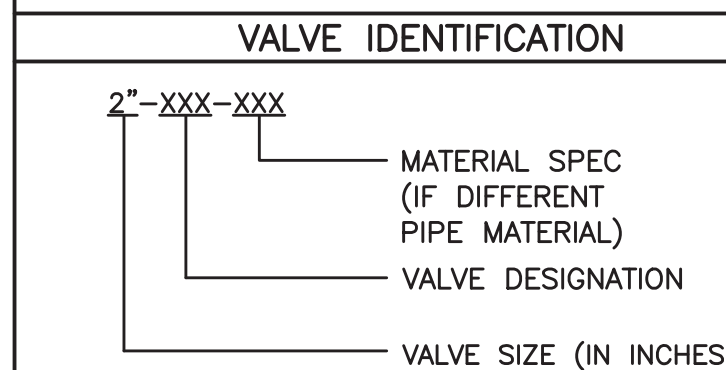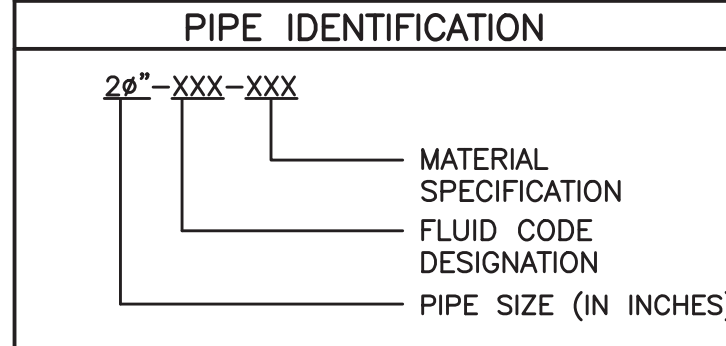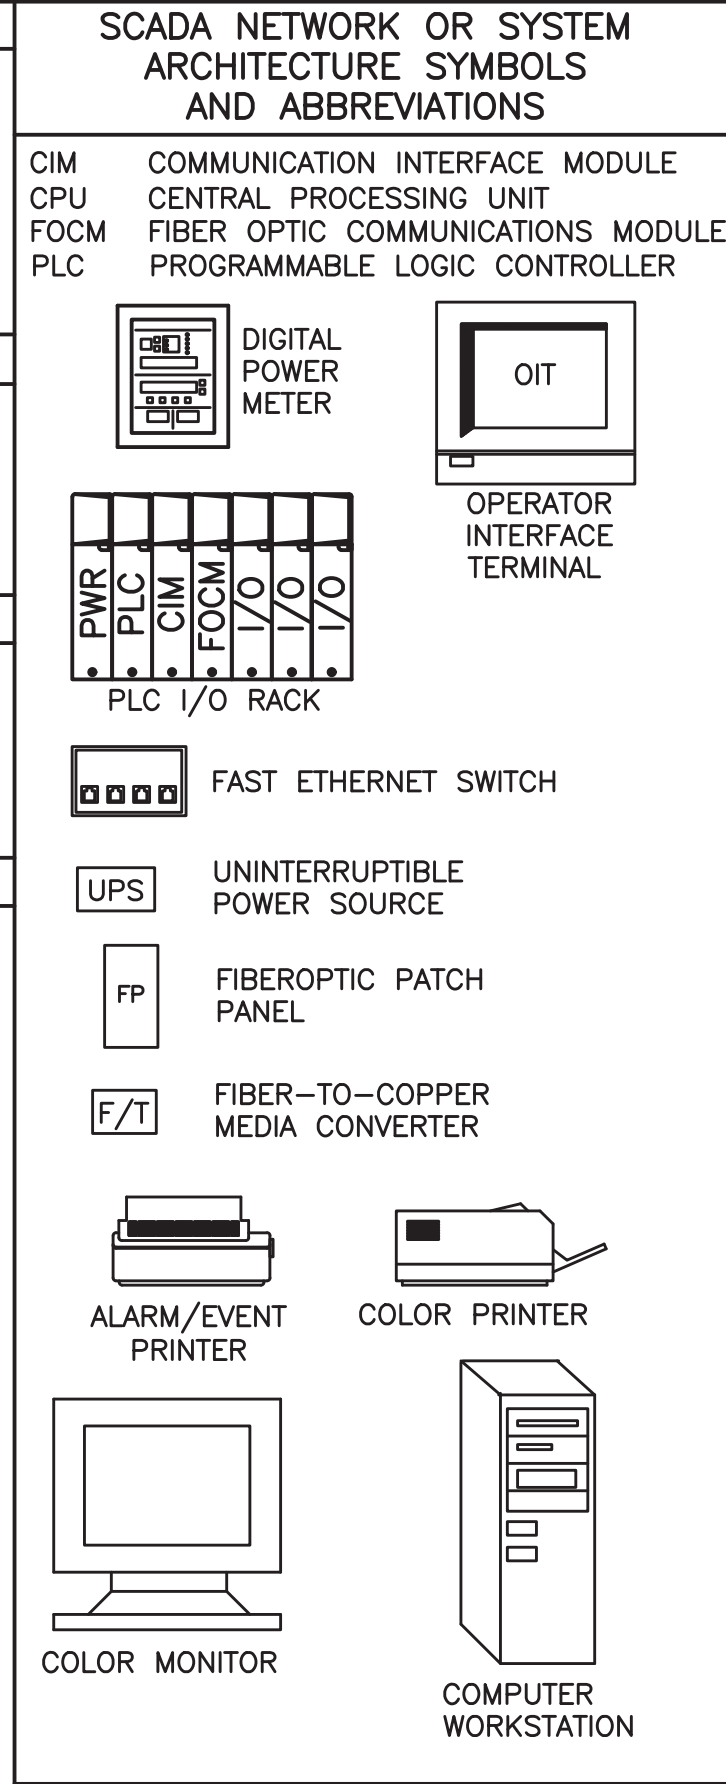

FLUID CODE	
ALUM	- ALUMINUM SULFATE
EFF	- (PLANT) EFFLUENT
FINW	- FINISHED WATER
FLTW	- FILTERED WATER
FM	- FORCEMAIN (PUMPED SANITARY)
INF	- INFILUENT
NAOCL	- SODIUM HYPOCHLORITE
O/F	- OVERFLOW
POLY	- POLYMER
SAN	- SANITARY SEWER
SUP	- SUPERNATANT
THS	- THICKENED SLUDGE
WAS	- WASTE ACTIVATED SLUDGE


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TYPICAL LETTER COMBINATIONS																				
FIRST LETTERS	INITIATING OR MEASURED VARIABLES	CONTROLLERS				READOUT DEVICES		SWITCHES AND ALARM DEVICES*			TRANSMITTERS			SOLENOIDS, RELAYS, COMPUTING DEVICES	PRIMARY ELEMENT	TEST POINT	WELL OR PROBE	VIEWING DEVICES, GLASS	SAFETY DEVICE	FINAL ELEMENT
		RECORD CONTROL	INDICATE CONTROL	CONTROL	CONTROL VALVES	RECORDING	INDICATING	HIGH**	LOW	COMB	RECORDING	INDICATING	BLIND							
A	ANALYSIS	ARC	AIC	AC		AR	AI	ASH	ASL	ASHL	ART	AIT	AT	AY	AE	AP	AW			AV
B	BURNER/COMBUSTION	BRC	BIC	BC		BR	BI	BSH	BSL	BSHL	BRT	BIT	BT	BY	BE		BW	BG		BZ
C	USER'S CHOICE																			
D	USER'S CHOICE																			
E	VOLTAGE	ERC	EIC	EC		ER	EI	ESH	ESL	ESHL	ERT	EIT	ET	EY	EE					EZ
F	FLOW, FLOW RATE	FRC	FIC	FC	FCV,FICV	FR	FI	FSH	FSL	FSHL	FRT	FIT	FT	FY	FE	FP		FG		FV
FQ	FLOW TOTAL	FQRC	FQIC	FQC	FQCV	FQR	FQI	FQSH	FQSL			FQIT	FQT	FQY	FQE					FQV
FF	FLOW RATIO	FFRC	FFIC	FFC	FFK	FFR	FFI	FPSH	FFSL						FE					FFV
G	USER'S CHOICE																			
H	HAND	HRC	HIC	HC	HCV					HS									HSS	HV
I	CURRENT	IRC	IIC	IC		IR	II	ISH	ISL	ISHL	IRT	IIT	IT	IY	IE					IZ
J	POWER	JRC	JIC	JC	JK	JR	JI	JSH	JSL	JSHL	JRT	JIT	JT	JY	JE					JV
K	TIME	KRC	KIC	KC	KCV	KR	KI	KSH	KSL	KSHL	KRT	KIT	KT	KY	KE					KV
L	LEVEL	LRC	LIC	LC	LCV	LR	LI	LSH	LSL	LSHL	LRT	LIT	LT	LY	LE		LW	LG		LV
M	USER'S CHOICE																			
N	USER'S CHOICE																			
O	USER'S CHOICE																			
P	PRESSURE/VACUUM	PRC	PIC	PC	PCV	PR	PI	PSH	PSL	PSHL	PRT	PIT	PT	PY	PE	PP			PSV, PSE	PV
PD	PRESSURE/DIFFERENTIAL	PDR	PDIC	PDC	PDCV	PDR	PDI	PDSH	PDSL		PDR	PDIT	PDT	PDY	PDE	PDP				PDV
Q	QUANTITY	QRC	QIC	QC		QR	QI	QSH	QSL	QSHL	QRT	QIT	QT	QY	QE					QZ
R	RADIATION	RRC	RIC	RC		RR	RI	RSH	RSL	RSHL	RRT	RIT	RT	RY	RE		RW			RZ
S	SPEED/FREQUENCY	SRC	SIC	SC	SCV	SR	SI	SSH	SSL	SSL	SRT	SIT	ST	SY	SE					SV
T	TEMPERATURE	TRC	TIC	TC	TCV	TR	TI	TSH	TSL	TSHL	TRT	TIT	TT	TY	TE	TP	TW		TSE	TV
TD	TEMPERATURE/DIFFERENTIAL	TDR	TDIC	TDC	TDCV	TDR	TDI	TDSH	TDSL		TDR	TDIT	TDI	TDY	TE	TP	TW			TDV
U	MULTIVARIABLE	URC	UIC	UC		UR	UI							UY						UV
V	VIBRATION/MACHINERY ANALYSIS	VRC	VIC	VC		VR	VI	VSH	VSL	VSHL	VRT	VIT	VT	VY	VE					VZ
W	WEIGHT/FORCE	WRC	WIC	WC	WCV	WR	WI	WSH	WSL	WSHL	WRT	WIT	WT	WY	WE					WZ
WD	WEIGHT/FORCE DIFFERENTIAL	WDR	WDIC	WDC	WDCV	WDR	WDI	WDSH	WDSL		WDR	WDIT	WDT	WDY	WE					WDZ
X	UNCLASSIFIED	XRC	XIC	XC																
Y	EVENT/STATE/PRESENCE	YC	YIC	YC		YR	YI	YSH	YSL				YT	YY	YE					YZ
Z	POSITION/DIMENSION	ZRC	ZIC	ZC	ZCV	ZR	ZI	ZSH	ZSL	ZSHL	ZRT	ZIT	ZT	ZY	ZE					ZV
ZD	GAUGING/DEVIATION	ZDR	ZDIC	ZDC	ZDCV	ZDR	ZDI	ZDSH	ZSL		ZDR	ZDIT	ZDT	ZDY	ZDE					ZDV


NOTE: THIS TABLE IS NOT ALL-INCLUSIVE
*A, ALARM, THE ANNUNCIATING DEVICE, MAY BE USED IN THE SAME FASHION AS (S) SWITCH, THE ACTUATING DEVICE.
** THE LETTERS H AND L MAY BE OMITTED IN THE UNDEFINED CASE.

***OTHER POSSIBLE COMBINATIONS:
KQI (RUNNING TIME INDICATOR)
HSS (HAND SAFETY SWITCH)
ZZS (ZERO POSITION SWITCH)


ZIC (POSITION INDICATION - CLOSED)
ZIO (POSITION INDICATION - OPEN)
ZSC (POSITION SWITCH - CLOSED)
ZSO (POSITION SWITCH - OPEN)



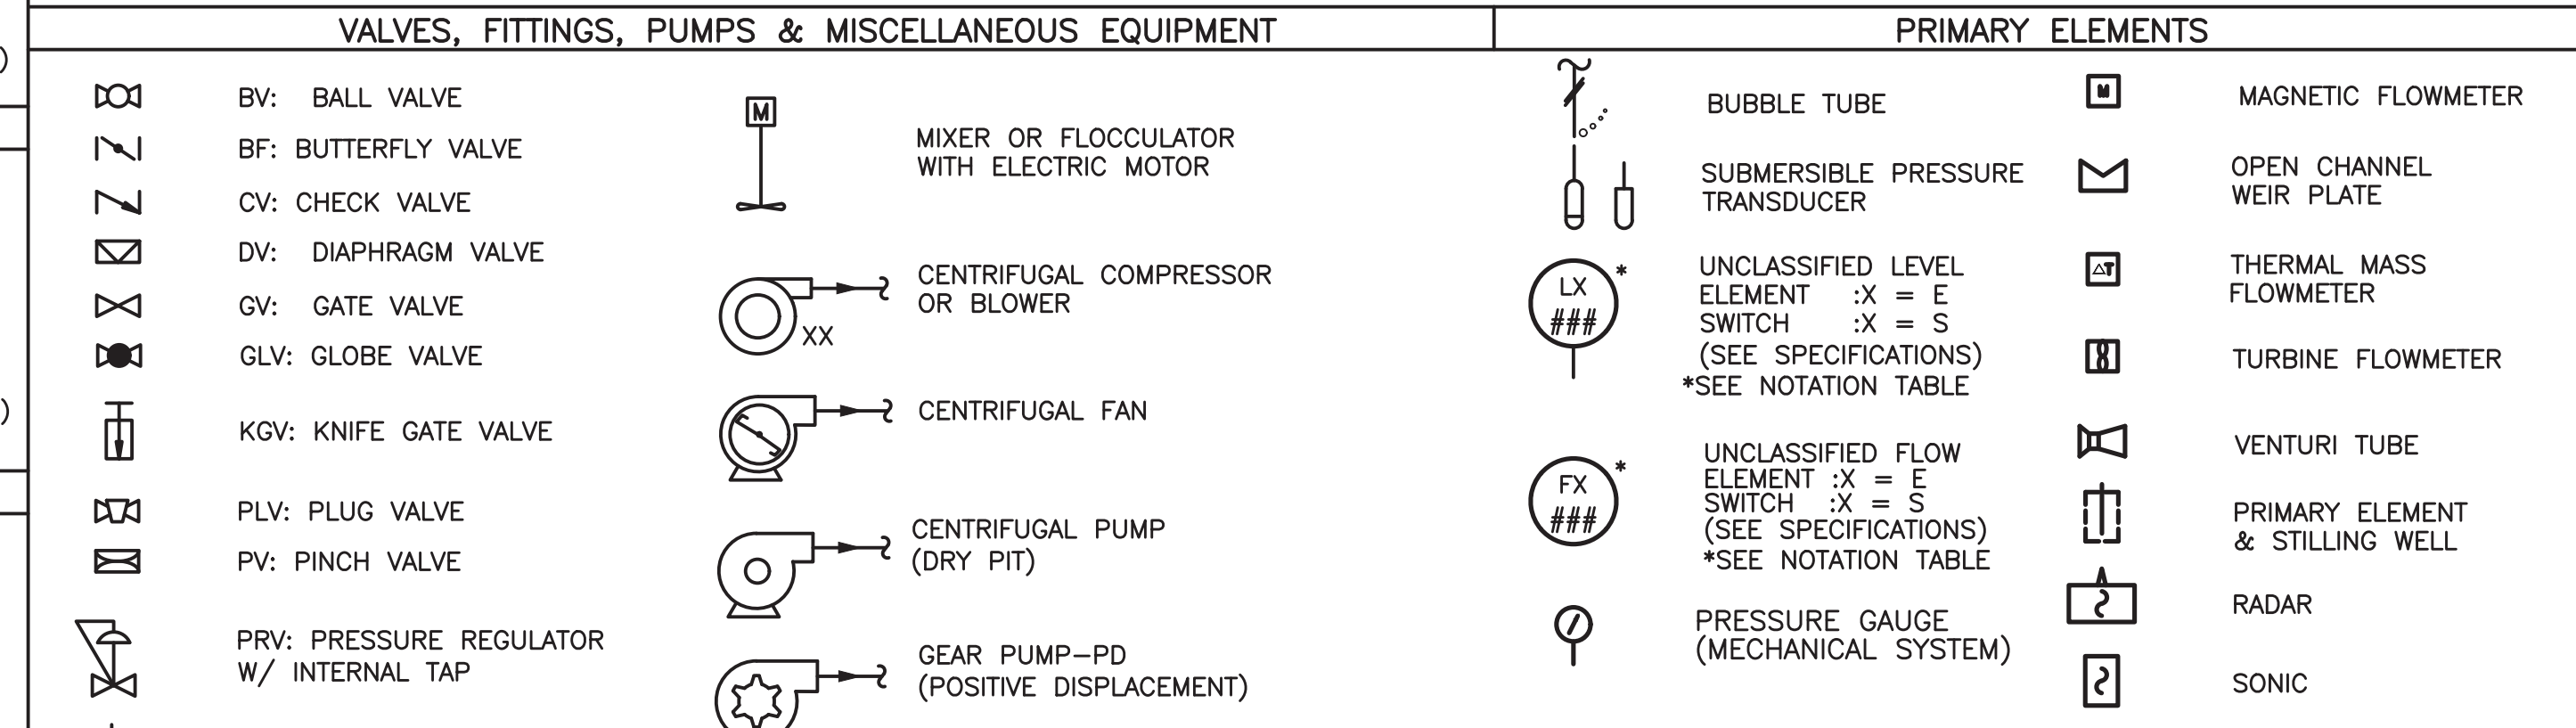
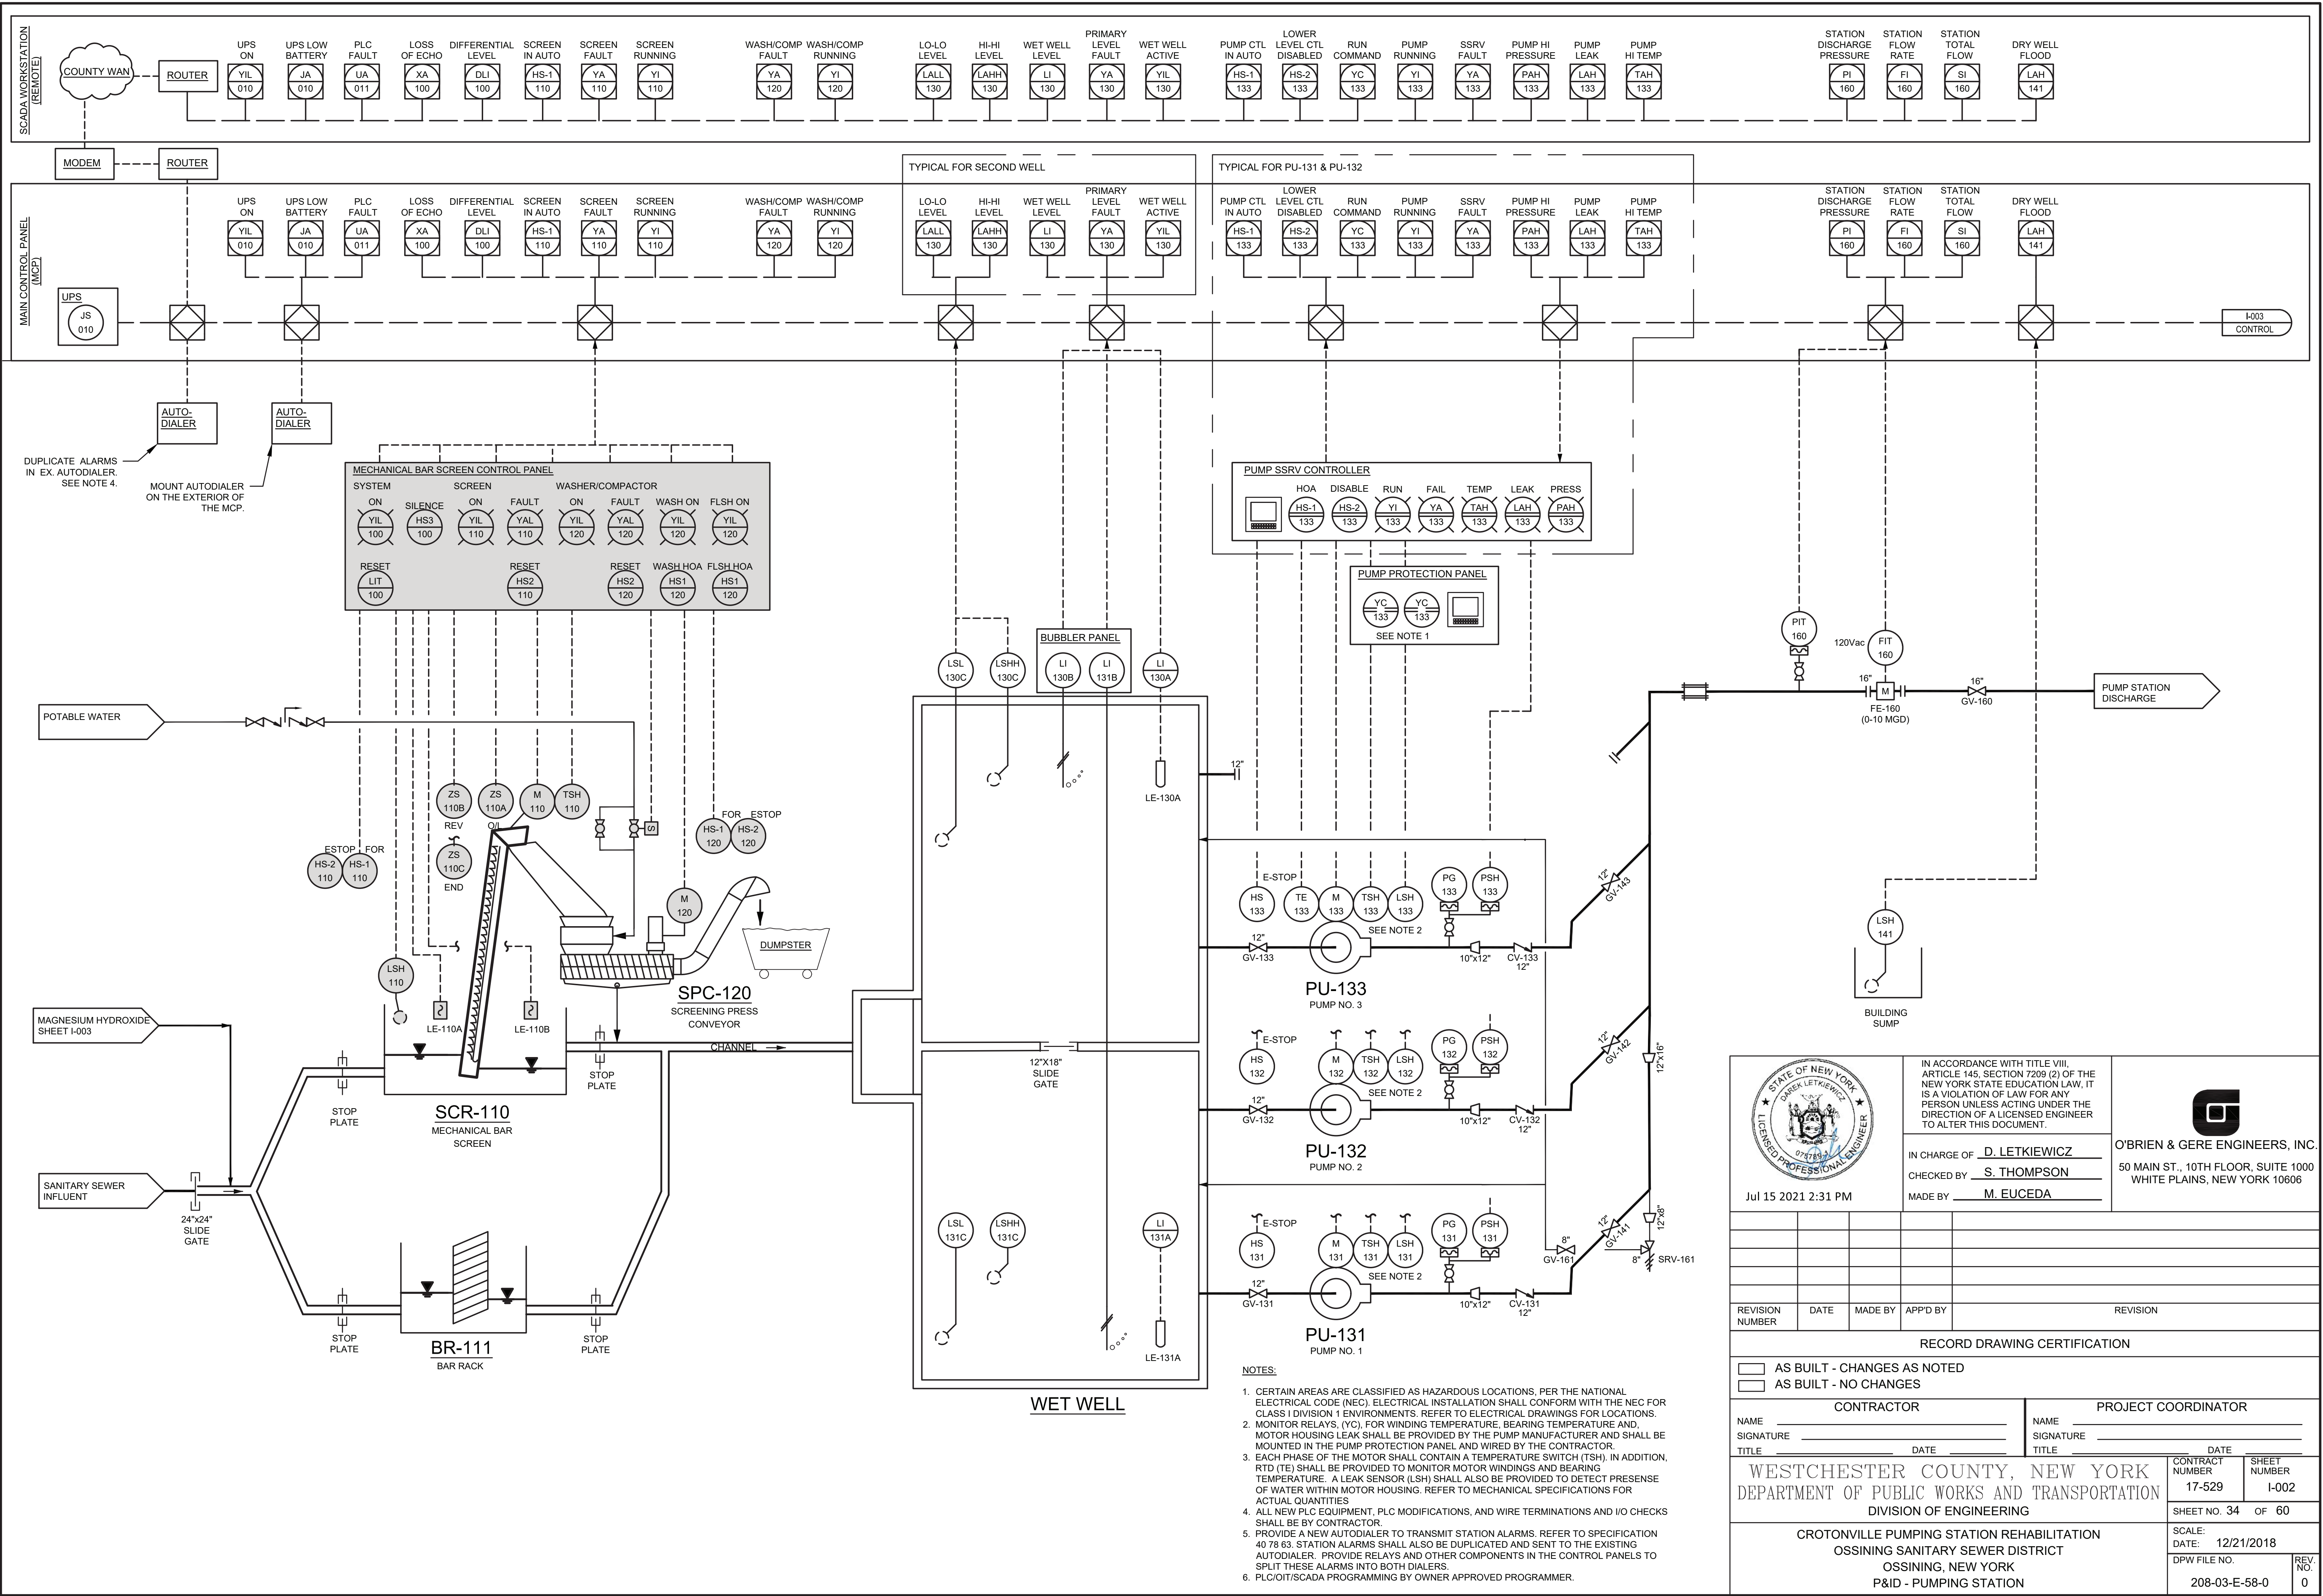
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DATE _____			DATE _____		
WESTCHESTER COUNTY, NEW YORK			CONTRACT NUMBER 17-529		
DEPARTMENT OF PUBLIC WORKS AND TRANSPORTATION			SHEET NUMBER I-001		
DIVISION OF ENGINEERING			SHEET NO. 33 OF 60		
CROTONVILLE PUMPING STATION REHABILITATION			SCALE: DATE: 12/21/2018		
OSSINING SANITARY SEWER DISTRICT			DPW FILE NO. 208-03-E-57-0		
OSSINING, NEW YORK			REV. NO. 0		
PROCESS CONTROL & INSTRUMENTATION SYMBOLS					

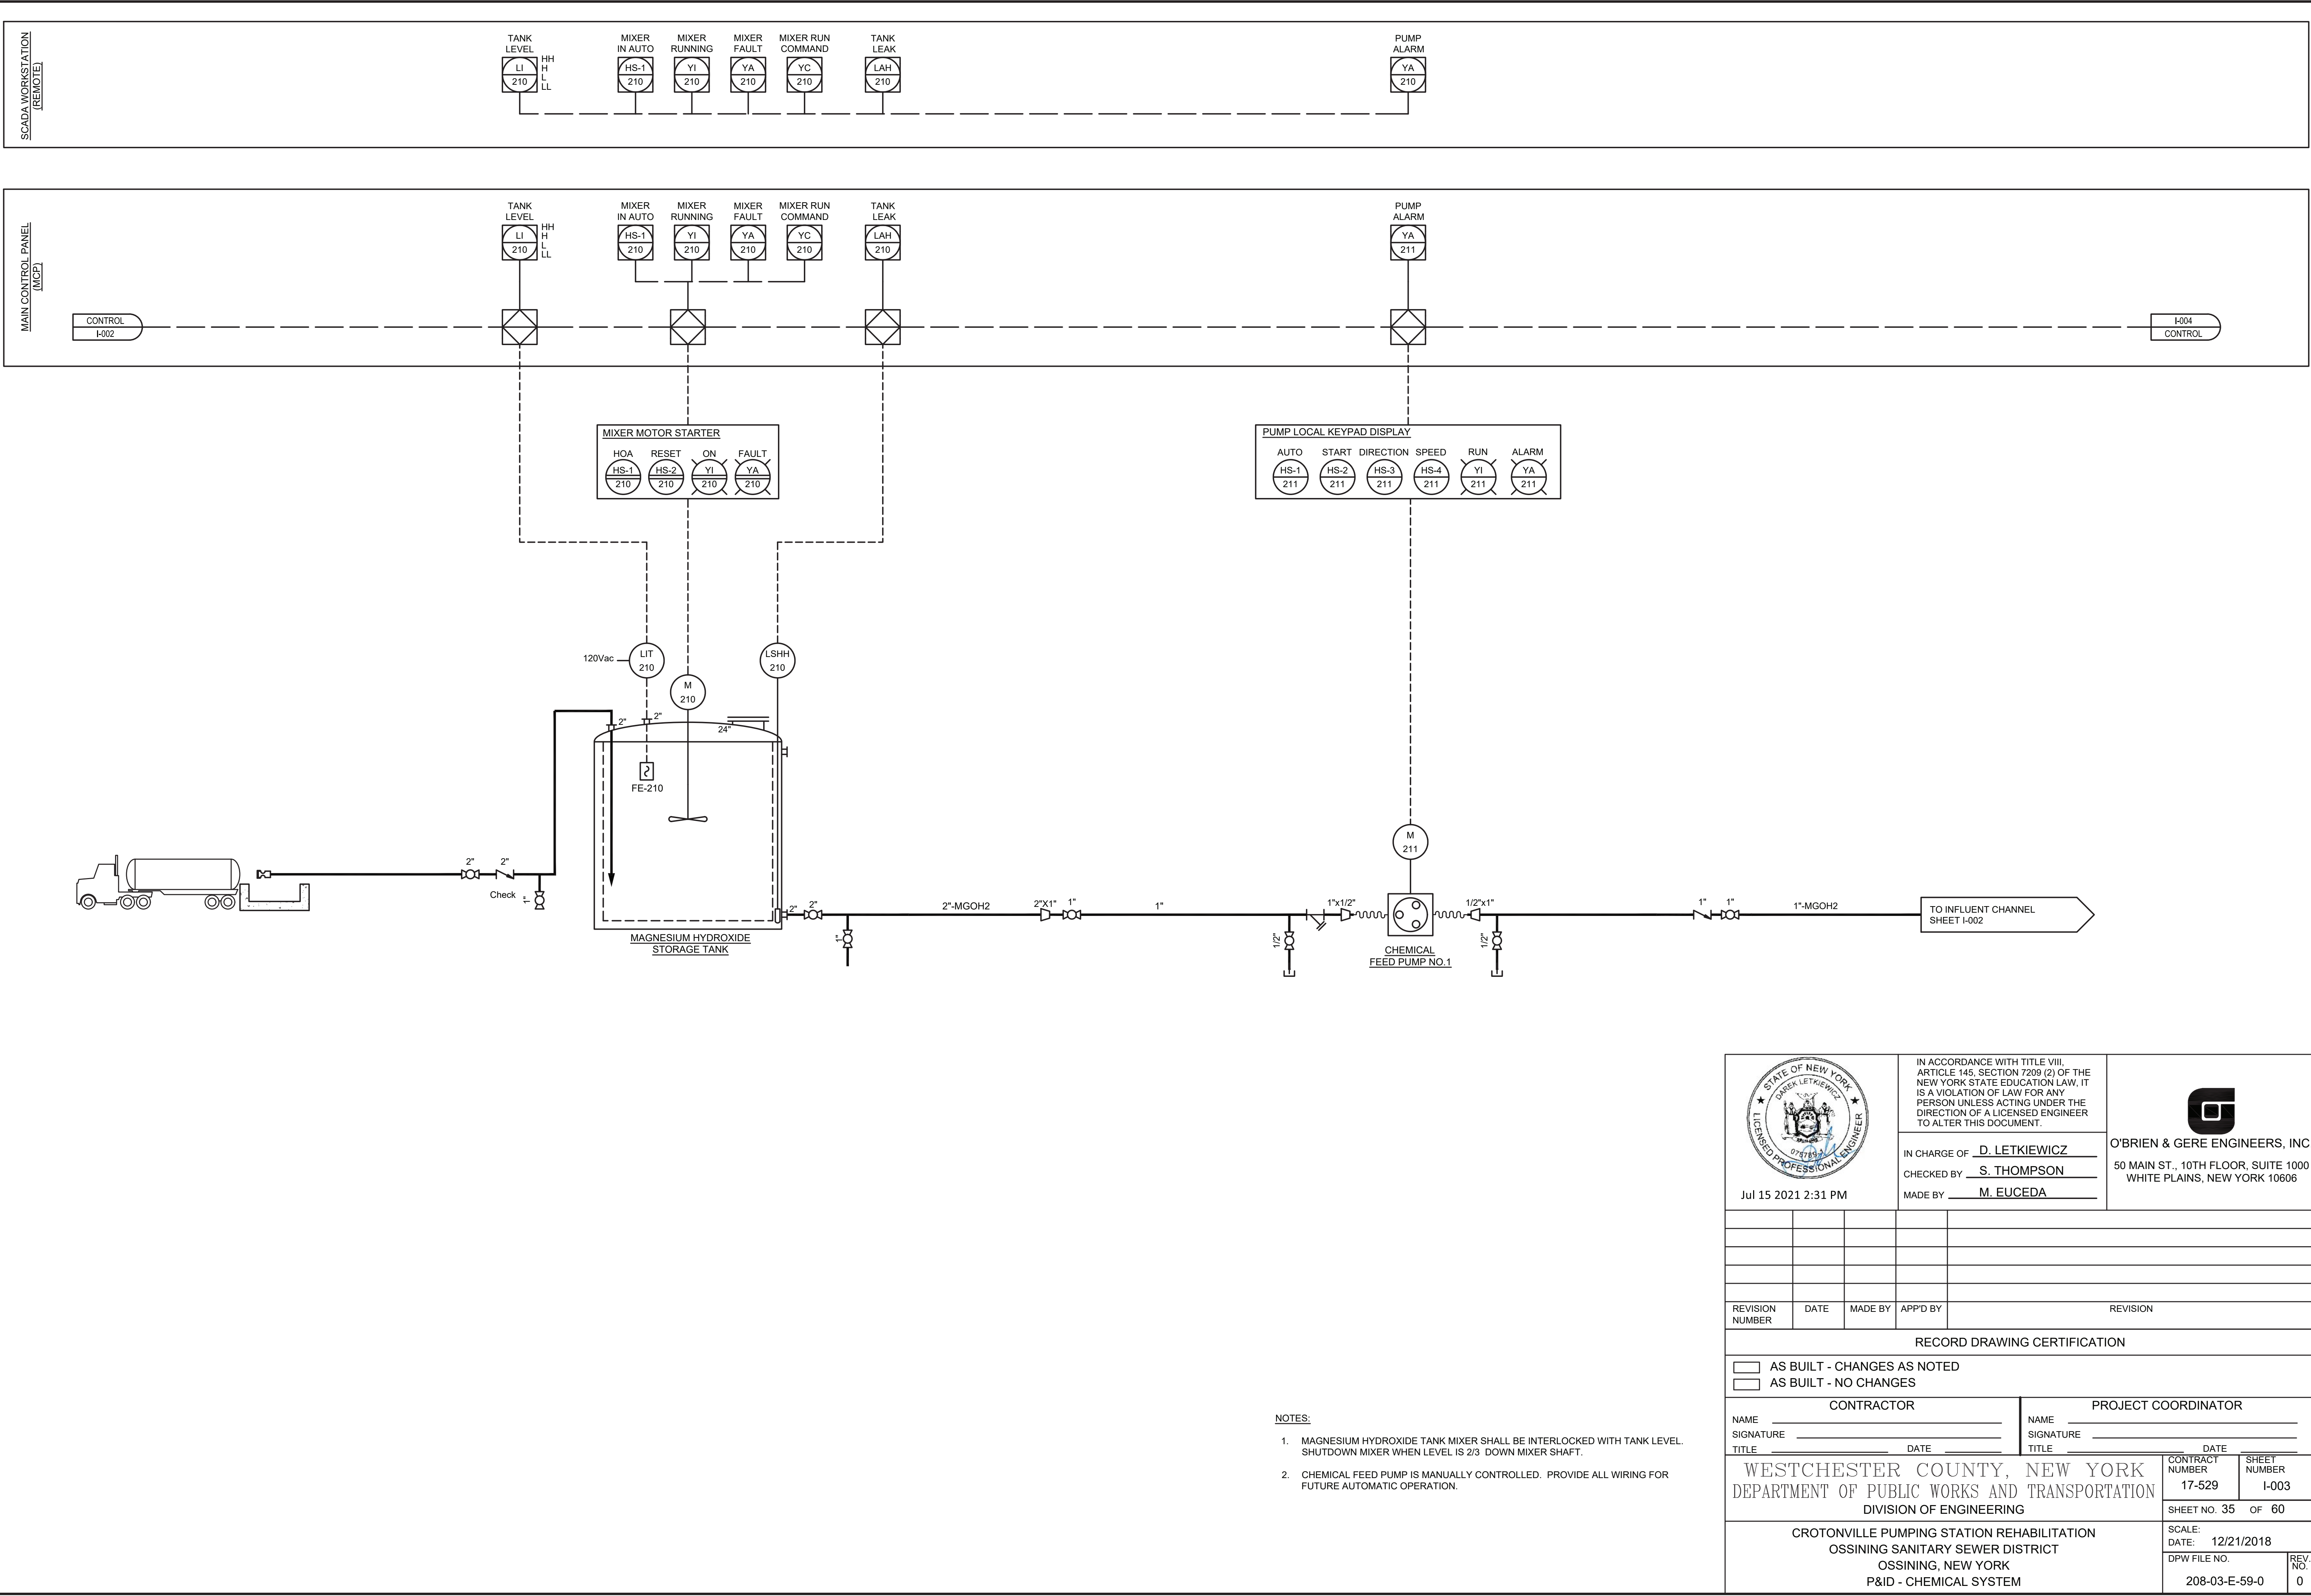


		IN ACCORDANCE WITH TITLE VIII, ARTICLE 145, SECTION 7209 (2) OF THE NEW YORK STATE EDUCATION LAW, IT IS A VIOLATION OF LAW FOR ANY PERSON UNLESS ACTING UNDER THE DIRECTION OF A LICENSED ENGINEER TO ALTER THIS DOCUMENT.																												
Jul 15 2021 2:31 PM		IN CHARGE OF <u>D. LETKIEWICZ</u> CHECKED BY <u>S. THOMPSON</u> MADE BY <u>M. EUCEDA</u>		O'BRIEN & GERE ENGINEERS, INC. 50 MAIN ST., 10TH FLOOR, SUITE 1000 WHITE PLAINS, NEW YORK 10606																										
<table><tr><td>REVISION NUMBER</td><td>DATE</td><td>MADE BY</td><td>APP'D BY</td><td>REVISION</td></tr><tr><td> </td><td> </td><td> </td><td> </td><td> </td></tr><tr><td> </td><td> </td><td> </td><td> </td><td> </td></tr><tr><td> </td><td> </td><td> </td><td> </td><td> </td></tr><tr><td> </td><td> </td><td> </td><td> </td><td> </td></tr></table>						REVISION NUMBER	DATE	MADE BY	APP'D BY	REVISION																				
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- NOTES:
- MAGNESIUM HYDROXIDE TANK MIXER SHALL BE INTERLOCKED WITH TANK LEVEL. SHUTDOWN MIXER WHEN LEVEL IS 2/3 DOWN MIXER SHAFT.
 - CHEMICAL FEED PUMP IS MANUALLY CONTROLLED. PROVIDE ALL WIRING FOR FUTURE AUTOMATIC OPERATION.

 Jul 15 2021 2:31 PM	IN ACCORDANCE WITH TITLE VIII, ARTICLE 145, SECTION 7209 (2) OF THE NEW YORK STATE EDUCATION LAW, IT IS A VIOLATION OF LAW FOR ANY PERSON UNLESS ACTING UNDER THE DIRECTION OF A LICENSED ENGINEER TO ALTER THIS DOCUMENT. IN CHARGE OF <u>D. LETKIEWICZ</u> CHECKED BY <u>S. THOMPSON</u> MADE BY <u>M. EUCEDA</u>	 O'BRIEN & GERE ENGINEERS, INC. 50 MAIN ST., 10TH FLOOR, SUITE 1000 WHITE PLAINS, NEW YORK 10606		
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WESTCHESTER COUNTY, NEW YORK DEPARTMENT OF PUBLIC WORKS AND TRANSPORTATION DIVISION OF ENGINEERING				CONTRACT NUMBER 17-529 SHEET NUMBER I-003 SHEET NO. 35 OF 60
CROTONVILLE PUMPING STATION REHABILITATION OSSINING SANITARY SEWER DISTRICT OSSINING, NEW YORK P&ID - CHEMICAL SYSTEM				SCALE: DATE: 12/21/2018 DPW FILE NO. 208-03-E-59-0 REV. NO. 0



INFLUENT SCREENS ROOM:

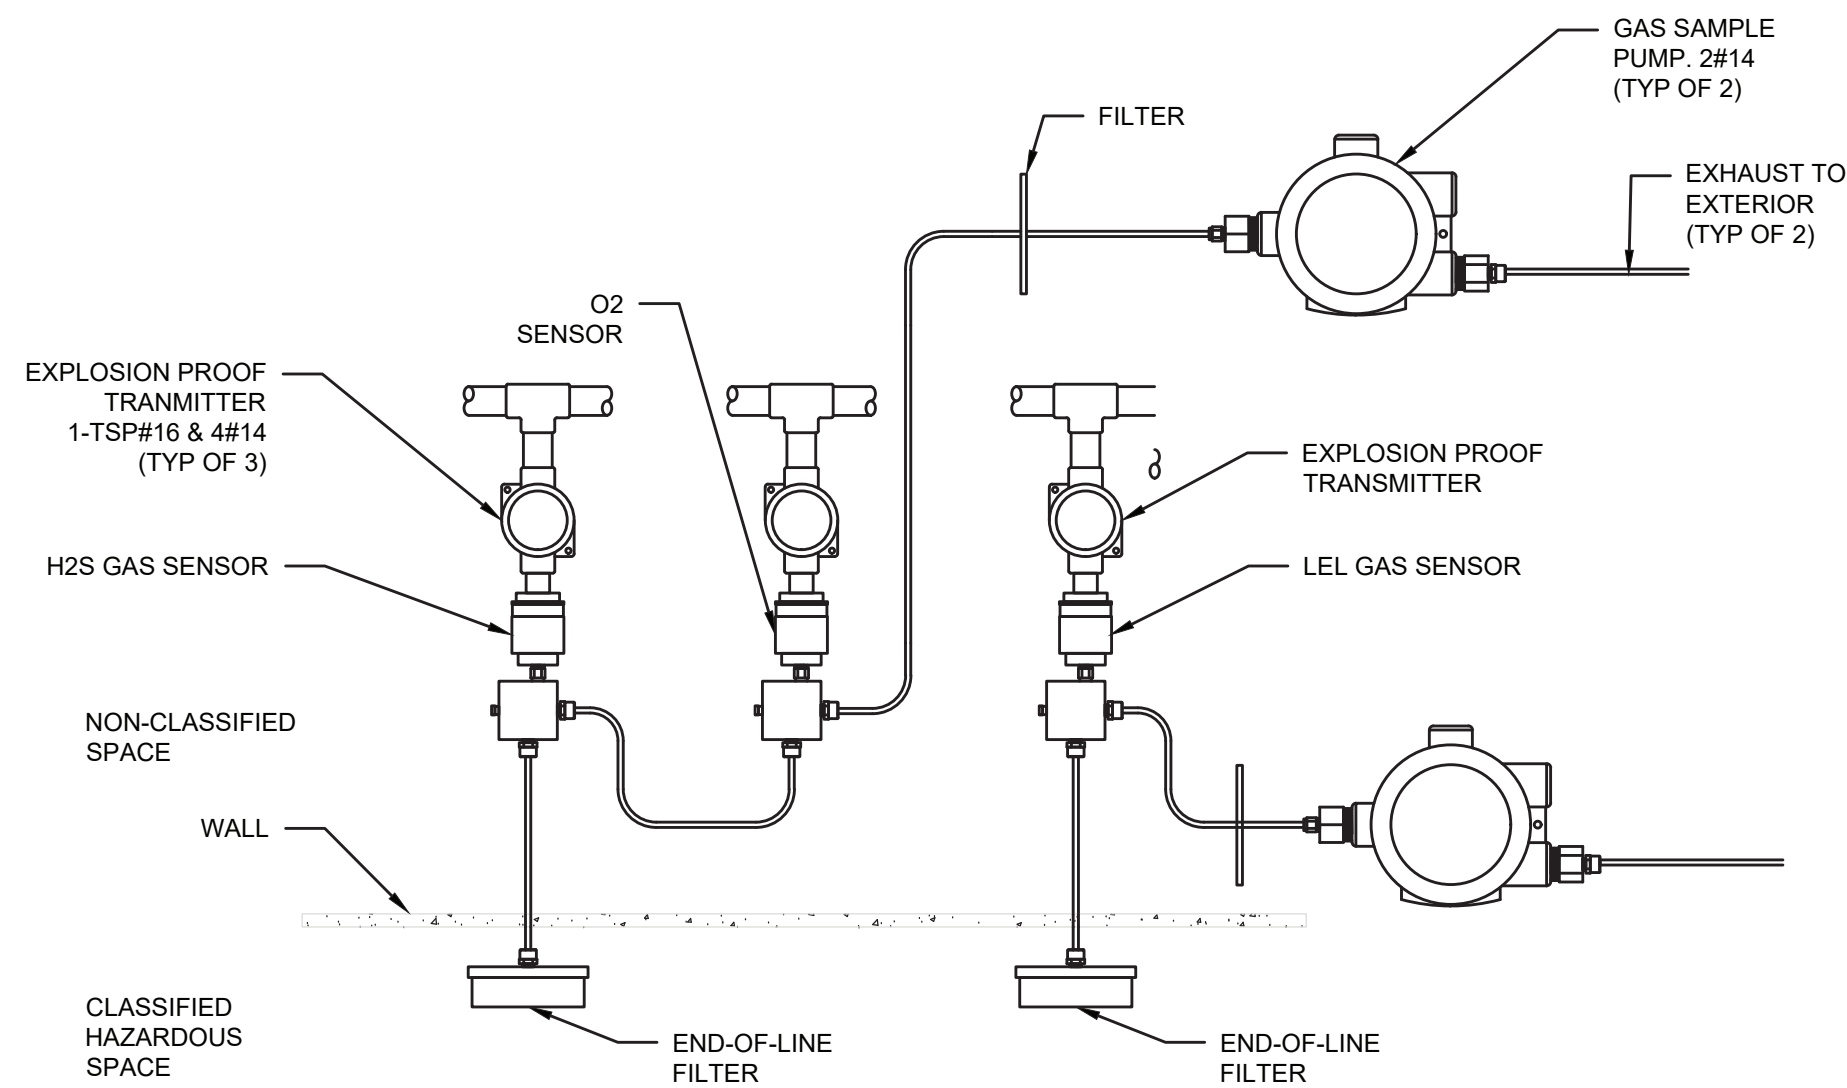

1. PROVIDE GAS SAMPLING PANEL WITH SAMPLE PUMP, GAS SENSORS, TRANSMITTERS, FLOW CONTROLLER, FILTERS, VALVES AND TUBING.
2. INSTALL END-OF-LINE FILTERS IN THE HAZARDOUS AREA WITH THE SAMPLE PUMP. ALL THE COMPONENTS NECESSARY FOR FULLY FUNCTIONING SYSTEM SHALL BE MOUNTED AT A HEIGHT WITHIN HAZARDOUS AREA TUBING SHALL NOT EXCEED 100 FEET OR AS NOTED BY MANUFACTURER.
3. GAS SAMPLING PANEL SHALL BE INSTALLED IN THE STORAGE ROOM. VENT SAMPLING LINES TO THE EXTERIOR, AS RECOMMENDED BY THE MANUFACTURER.
4. IF ACCEPTABLE BY MANUFACTURER, THE USE OF A SINGLE TUBING AND SAMPLE PUMP MAY BE USED TO SAMPLE THE THREE GASES.
5. PROVIDE ALL THE COMPONENTS NECESSARY FOR FULLY FUNCTIONING SYSTEM. REFER TO SPECIFICATION 40 76 00 FOR ADDITIONAL DETAILS.

SCREENINGS ROOM:

1. PROVIDE GAS SENSORS AND TRANSMITTERS AS SPECIFIED.
2. GAS SENSOR SHALL BE MOUNTED AT A HEIGHTS RECOMMENDED BY MANUFACTURER. (LEL - 18" BELOW OF CEILING, H2S - NO MORE THAN 24" ABOVE FLOOR, O2 - 5 FOOT ABOVE FLOOR).
3. PROVIDE ALL THE COMPONENTS NECESSARY FOR FULLY FUNCTIONING SYSTEM. REFER TO SPECIFICATION 40 76 00 FOR ADDITIONAL DETAILS.

NOTES:

1. CERTAIN AREAS ARE CLASSIFIED AS HAZARDOUS LOCATIONS, PER THE NATIONAL ELECTRICAL CODE (NEC). ELECTRICAL INSTALLATION SHALL CONFORM WITH THE NEC FOR CLASS 1 DIVISION 1 ENVIRONMENTS. REFER TO ELECTRICAL DRAWINGS FOR LOCATIONS.
2. ALL NEW PLC EQUIPMENT, PLC MODIFICATIONS, AND WIRE TERMINATIONS AND I/O CHECKS SHALL BE BY CONTRACTOR.
3. PLC I/O/SCADA PROGRAMMING BY OWNER APPROVED PROGRAMMER.
4. PET WET VENTILATION IS INTERMITTENT. PROGRAMMER SHALL PROVIDE LOGIC TO ALARM WHEN THE GAS LEVEL EXCEED SETPOINT ONLY WHEN THE VENTILATION SYSTEM IS ACTIVE.

	IN ACCORDANCE WITH TITLE VIII, ARTICLE 145, SECTION 7209 (2) OF THE NEW YORK STATE EDUCATION LAW, IT IS A VIOLATION OF LAW FOR ANY PERSON UNLESS ACTING UNDER THE DIRECTION OF A LICENSED ENGINEER TO ALTER THIS DOCUMENT.											
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MADE BY <u> M. EUCEDA </u>			O'BRIEN & GERE ENGINEERS, INC. 50 MAIN ST., 10TH FLOOR, SUITE 1000 WHITE PLAINS, NEW YORK 10606									
<div style="display: flex; justify-content: space-between; padding: 5px;"> Jul 15 2021 2:31 PM </div>												
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CROTONVILLE PUMPING STATION REHABILITATION OSSISING SANITARY SEWER DISTRICT OSSISING, NEW YORK P&ID - ANCILLIARY			<table border="1" style="width: 100%; border-collapse: collapse;"> <tr> <td style="width: 50%; padding: 5px;"> CONTRACT NUMBER 17-529 </td> <td style="width: 50%; padding: 5px;"> SHEET NUMBER I-004 </td> </tr> <tr> <td colspan="2" style="padding: 5px;"> SHEET NO. 36 OF 60 </td> </tr> <tr> <td colspan="2" style="padding: 5px;"> SCALE: DATE: 12/21/2018 </td> </tr> <tr> <td style="padding: 5px;"> DPW FILE NO. 208-03-E-60-0 </td> <td style="padding: 5px;"> REV. NO. 0 </td> </tr> </table>		CONTRACT NUMBER 17-529	SHEET NUMBER I-004	SHEET NO. 36 OF 60		SCALE: DATE: 12/21/2018		DPW FILE NO. 208-03-E-60-0	REV. NO. 0
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SHEET NO. 36 OF 60												
SCALE: DATE: 12/21/2018												
DPW FILE NO. 208-03-E-60-0	REV. NO. 0											

ABBREVIATIONS

A			L		
AFF	ABOVE FINISHED FLOOR		LSH	LEVEL SWITCH HIGH	
AC	ALTERNATING CURRENT		LSHH	LEVEL SWITCH HIGH - HIGH	
A	AMPS		LSLL	LEVEL SWITCH LOW - LOW	
AF	AMP FRAME		LT	LEVEL TRANSMITTER	
A.I.C.	AMPS INTERRUPTING CAPACITY		LS	LIMIT SWITCH	
AT	AMPS TRIP		LCP	LOCAL CONTROL PANEL	
ATS	AUTOMATIC TRANSFER SWITCH		LED	LIGHT EMITTING DIODE	
B			LTG	LIGHTING	
BKR	BREAKER		LP	LIGHTING PANEL	
C			LP - ()	LIGHTING PANEL CIRCUIT (CKT NO.)	
CUH	CABINET UNIT HEATER		L	LINE CONDUCTOR	
CL	CENTERLINE		LAN	LOCAL AREA NETWORK	
CKT	CIRCUIT		M		
CC - ()	CONTROL CONDUIT-(ID)		MCB	MAIN CIRCUIT BREAKER	
CP	CONTROL PANEL		MF - ()	MAIN FEEDER - (ID)	
CPT	CONTROL POWER TRANSFORMER		MLO	MAIN LUGS ONLY	
CR - ()	CONTROL RELAY-(ID)		MUAU	MAKE UP AIR UNIT	
CT	CURRENT TRANSFORMER		MCOV	MAXIMUM CONTINUOUS OPERATING VOLTAGE	
D			MV	MEDIUM VOLTAGE	
DIA.	DIAMETER		mA	MILLIAMPERES	
DP	DIFFERENTIAL PRESSURE		MGD	MILLION GALLONS PER DAY	
DI	DIGITAL INPUT		M - ()	MOTOR - (ID)	
DO	DIGITAL OUTPUT		MCP	MAIN CONTROL PANEL	
DPM	DIGITAL POWER MONITOR		MCC	MOTOR CONTROL CENTER	
DC	DIRECT CURRENT		MCCP	MOLDED CASE CIRCUIT PROTECTOR	
DDC	DIRECT DIGITAL CONTROL		M	MOTOR STARTER CONTACTOR	
DISC SW	DISCONNECT SWITCH		MCM	THOUSAND CIRCULAR MILS	
DP - ()	DISTRIBUTION PANEL-(ID)		MTD	MOUNTED	
DP - () / ()	DISTRIBUTION PANEL CIRCUIT (PANEL NO.)(CIRCUIT NO.)		MTS	MANUAL TRANSFER SWITCH	
DPDT	DOUBLE POLE, DOUBLE THROW		(N) / C	MULTICONDUCTOR CABLE (N = NUMBER OF CONDUCTORS)	
DB - (ID)	DUCT BANK - (ID)		N		
E			NEC	NATIONAL ELECTRICAL CODE	
EUH	ELECTRIC UNIT HEATER		N	NEUTRAL CONDUCTOR	
EWH	ELECTRIC WATER HEATER		N.C.	NORMALLY CLOSED	
EL	ELEVATION		N.O.	NORMALLY OPEN	
EMF - ()	EMERGENCY MAIN FEEDER - (ID)		NO.	NUMBER	
EF	EXHAUST FAN		O		
EXIST.	EXISTING		OL	OVERLOAD	
F			P		
FT	FEET		Ø or PH	PHASE	
FIN FLR	FINISHED FLOOR		PVC	POLYVINYL CHLORIDE CONDUIT	
FIT	FLOW INDICATING TRANSMITTER		PT	POTENTIAL TRANSFORMER	
FE	FLOW PRIMARY ELEMENT		PC - ()	POWER & CONTROL CONDUIT - (ID)	
FSL	FLOW SWITCH LOW		PP	POWER PANEL	
G			PB	PULLBOX	
GPM	GALLONS PER MINUTE		P - ()	POWER CONDUIT-(ID)	
G	GREEN		PP - ()	POWER PANEL - (CKT NO.)	
GRD	GROUND		() P	(QTY) POLES	
GFI	GROUND FAULT INTERRUPTER		PRESS SW	PRESSURE SWITCH	
H			PCS ()	PROCESS CONTROL SYSTEM CABINET (ID)	
HOA	HAND-OFF-AUTOMATIC		PLC	PROGRAMMABLE LOGIC CONTROLLER	
HS	HAND SWITCH		Q		
HZ	HERTZ		QTY	QUANTITY	
HP	HORSEPOWER		R		
I			RECPT	RECEPTACLE	
ID	IDENTIFICATION NUMBER		R	RED	
I/O	INPUT/OUTPUT		RMS	ROOT MEAN SQUARE	
J			S		
JB	JUNCTION BOX		SPDT	SINGLE POLE, DOUBLE THROW	
K			S/S	START/STOP	
K	DEGREES KELVIN		SCADA	SUPERVISORY CONTROL AND DATA AQUISITION	
KVA	KILOVOLT AMPERE		SPD	SURGE PROTECTIVE DEVICE	
KV	KILOVOLT		SW	SWITCH	
KW	KILOWATT		SSRV	SOLID STATE REDUCED VOLTAGE STARTER	
			SWBD	SWITCHBOARD	
			SYMM	SYMMETRICAL	

ONE-LINE AND ELEMENTARY DIAGRAM SYMBOLS

NOTE: UNLESS OTHERWISE NOTED, ALL SWITCHES AND CONTACTS ARE SHOWN WITH ACTUATING DEVICES IN THE DE-ENERGIZED, OR NON-OPERATED POSITION.			
	PUSHBUTTON (MOMENTARY, SPRING RETURN, NORMALLY OPEN CIRCUIT, CLOSE UPON ACTUATION)		NON-FUSED DISCONNECT SWITCH
	PUSHBUTTON (MOMENTARY, SPRING RETURN, NORMALLY CLOSED CIRCUIT, OPEN UPON ACTUATION)		POLE
	MAINTAINED CONTACT PUSHBUTTON WITH MUSHROOM HEAD OPERATOR		TRANSFORMER
	MULTI-POSITION SELECTOR SWITCH X = CONTACT CLOSED * = SWITCH POSITIONS AS NOTED		UNGROUND WYE WINDING
	LIMIT SWITCH (NORMALLY OPEN)		GROUND WYE WINDING
	LEVEL ACTUATED SWITCH (CLOSE ON RISING LEVEL)		DELTA WINDING
	TEMPERATURE ACTUATED SWITCH (CLOSE ON RISING TEMPERATURE)		MOTOR (* = HORSEPOWER)
	TEMPERATURE ACTUATED SWITCH (OPEN ON RISING TEMPERATURE)		GROUND
	TIME DELAY CONTACT (NORMALLY OPEN, TIME DELAY CLOSE)		CURRENT TRANSFORMER
	TIME DELAY CONTACT (NORMALLY OPEN, TIME DELAY OPEN)		VOLTAGE TRANSFORMER
	TIME DELAY CONTACT (NORMALLY CLOSED, TIME DELAY OPEN)		EQUIPMENT WIRING TERMINAL
	TIME DELAY CONTACT (NORMALLY CLOSED, TIME DELAY CLOSE)		LIGHTNING ARRESTER
	CONTACT (NORMALLY CLOSED)		DIGITAL POWER MONITOR
	CONTACT (NORMALLY OPEN)	LIGHTING SYMBOLS	
	INDICATING LIGHT (NON-PUSH-TO-TEST)		EXIT SIGN (SHADED SEGMENTS = SIGN FACES)
	RELAY OR CONTACTOR COIL		SINGLE POLE WALL SWITCH (UNLESS OTHERWISE INDICATED)
	MANUAL MOTOR STARTING SWITCH		3-WAY WALL SWITCH
	CIRCUIT BREAKER OR MCCP		SINGLE POLE WALL SWITCH WITH OCCUPANCY SENSOR
	FUSE		FIXTURE SWITCHING CONNECTION
	WIRING ROUTED FROM		
	WIRING ROUTED TO		
	RESISTANCE HEATING ELEMENT		
	LOAD INTERRUPTOR SWITCH		

GENERAL ELECTRICAL SYMBOLS

	EQUIPMENT OR WIRING TO BE REMOVED
	WIRING CONTINUATION
	JUNCTION BOX
	CONTROL STATION OR CONTROL DEVICE (TYPE AS NOTED)
	INSTRUMENT (TYPE OR TAG NO. AS NOTED)
	ELECTRICAL CONNECTION
	NON-FUSED DISCONNECT SWITCH
	HOMERUN TO PANELBOARD WITH CIRCUIT NUMBER AS SHOWN
	MANUAL MOTOR STARTING SWITCH
	DUPLEX GFCI RECEPTACLE
	DUPLEX GFCI RECEPTACLE WITH WEATHERPROOF COVER
	THERMOSTAT
	DIRECT BURIED CONDUIT
	SMOKE DETECTOR - CEILING MOUNTED


COMMUNICATIONS SYSTEM SYMBOLS

	TELEPHONE
	TELEPHONE OUTLET

GENERAL NOTES:

- ALL ELECTRICAL EQUIPMENT AND WIRING IS NEW UNLESS OTHERWISE NOTED.
- WHERE EXISTING EQUIPMENT AND WIRING IS SHOWN TO BE MODIFIED OR REMOVED, FIELD VERIFY EXISTING LOCATIONS, CONNECTIONS AND WIRING TO ENSURE ACTUAL FEATURES ARE AS SHOWN OR NOTED.
- FIELD VERIFY EXISTING FEATURES AS NECESSARY TO COORDINATE EXECUTION OF THE WORK SHOWN.
- ELECTRICAL EQUIPMENT SHALL BE MOUNTED WITH OPERATING CONTROLS BETWEEN APPROXIMATELY 4'-0" AND 6'-0" ABOVE FINISHED FLOOR UNLESS OTHERWISE SHOWN OR SPECIFIED.

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IN CHARGE OF <u>Eric Miles</u>					
CHECKED BY <u>Jim Crosier</u>					
MADE BY <u>J. Clark</u>					
O'BRIEN & GERE ENGINEERS, INC. 50 MAIN ST., 10TH FLOOR SUITE 1000, WHITE PLAINS, NEW YORK 10606					
REVISION NUMBER	DATE	MADE BY	APP'D BY		
REVISION					
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WESTCHESTER COUNTY, NEW YORK DEPARTMENT OF PUBLIC WORKS AND TRANSPORTATION DIVISION OF ENGINEERING		CONTRACT NUMBER	SHEET NUMBER		
			E-001		
CROTONVILLE PUMPING STATION REHABILITATION		SHEET NO. 37	OF 60		
OSSINING, NEW YORK GENERAL NOTES, ABBREVIATION & SYMBOLS		SCALE: DATE: 12/21/2018 DPW FILE NO. 208-03-E-61-0	REV. NO. 0		

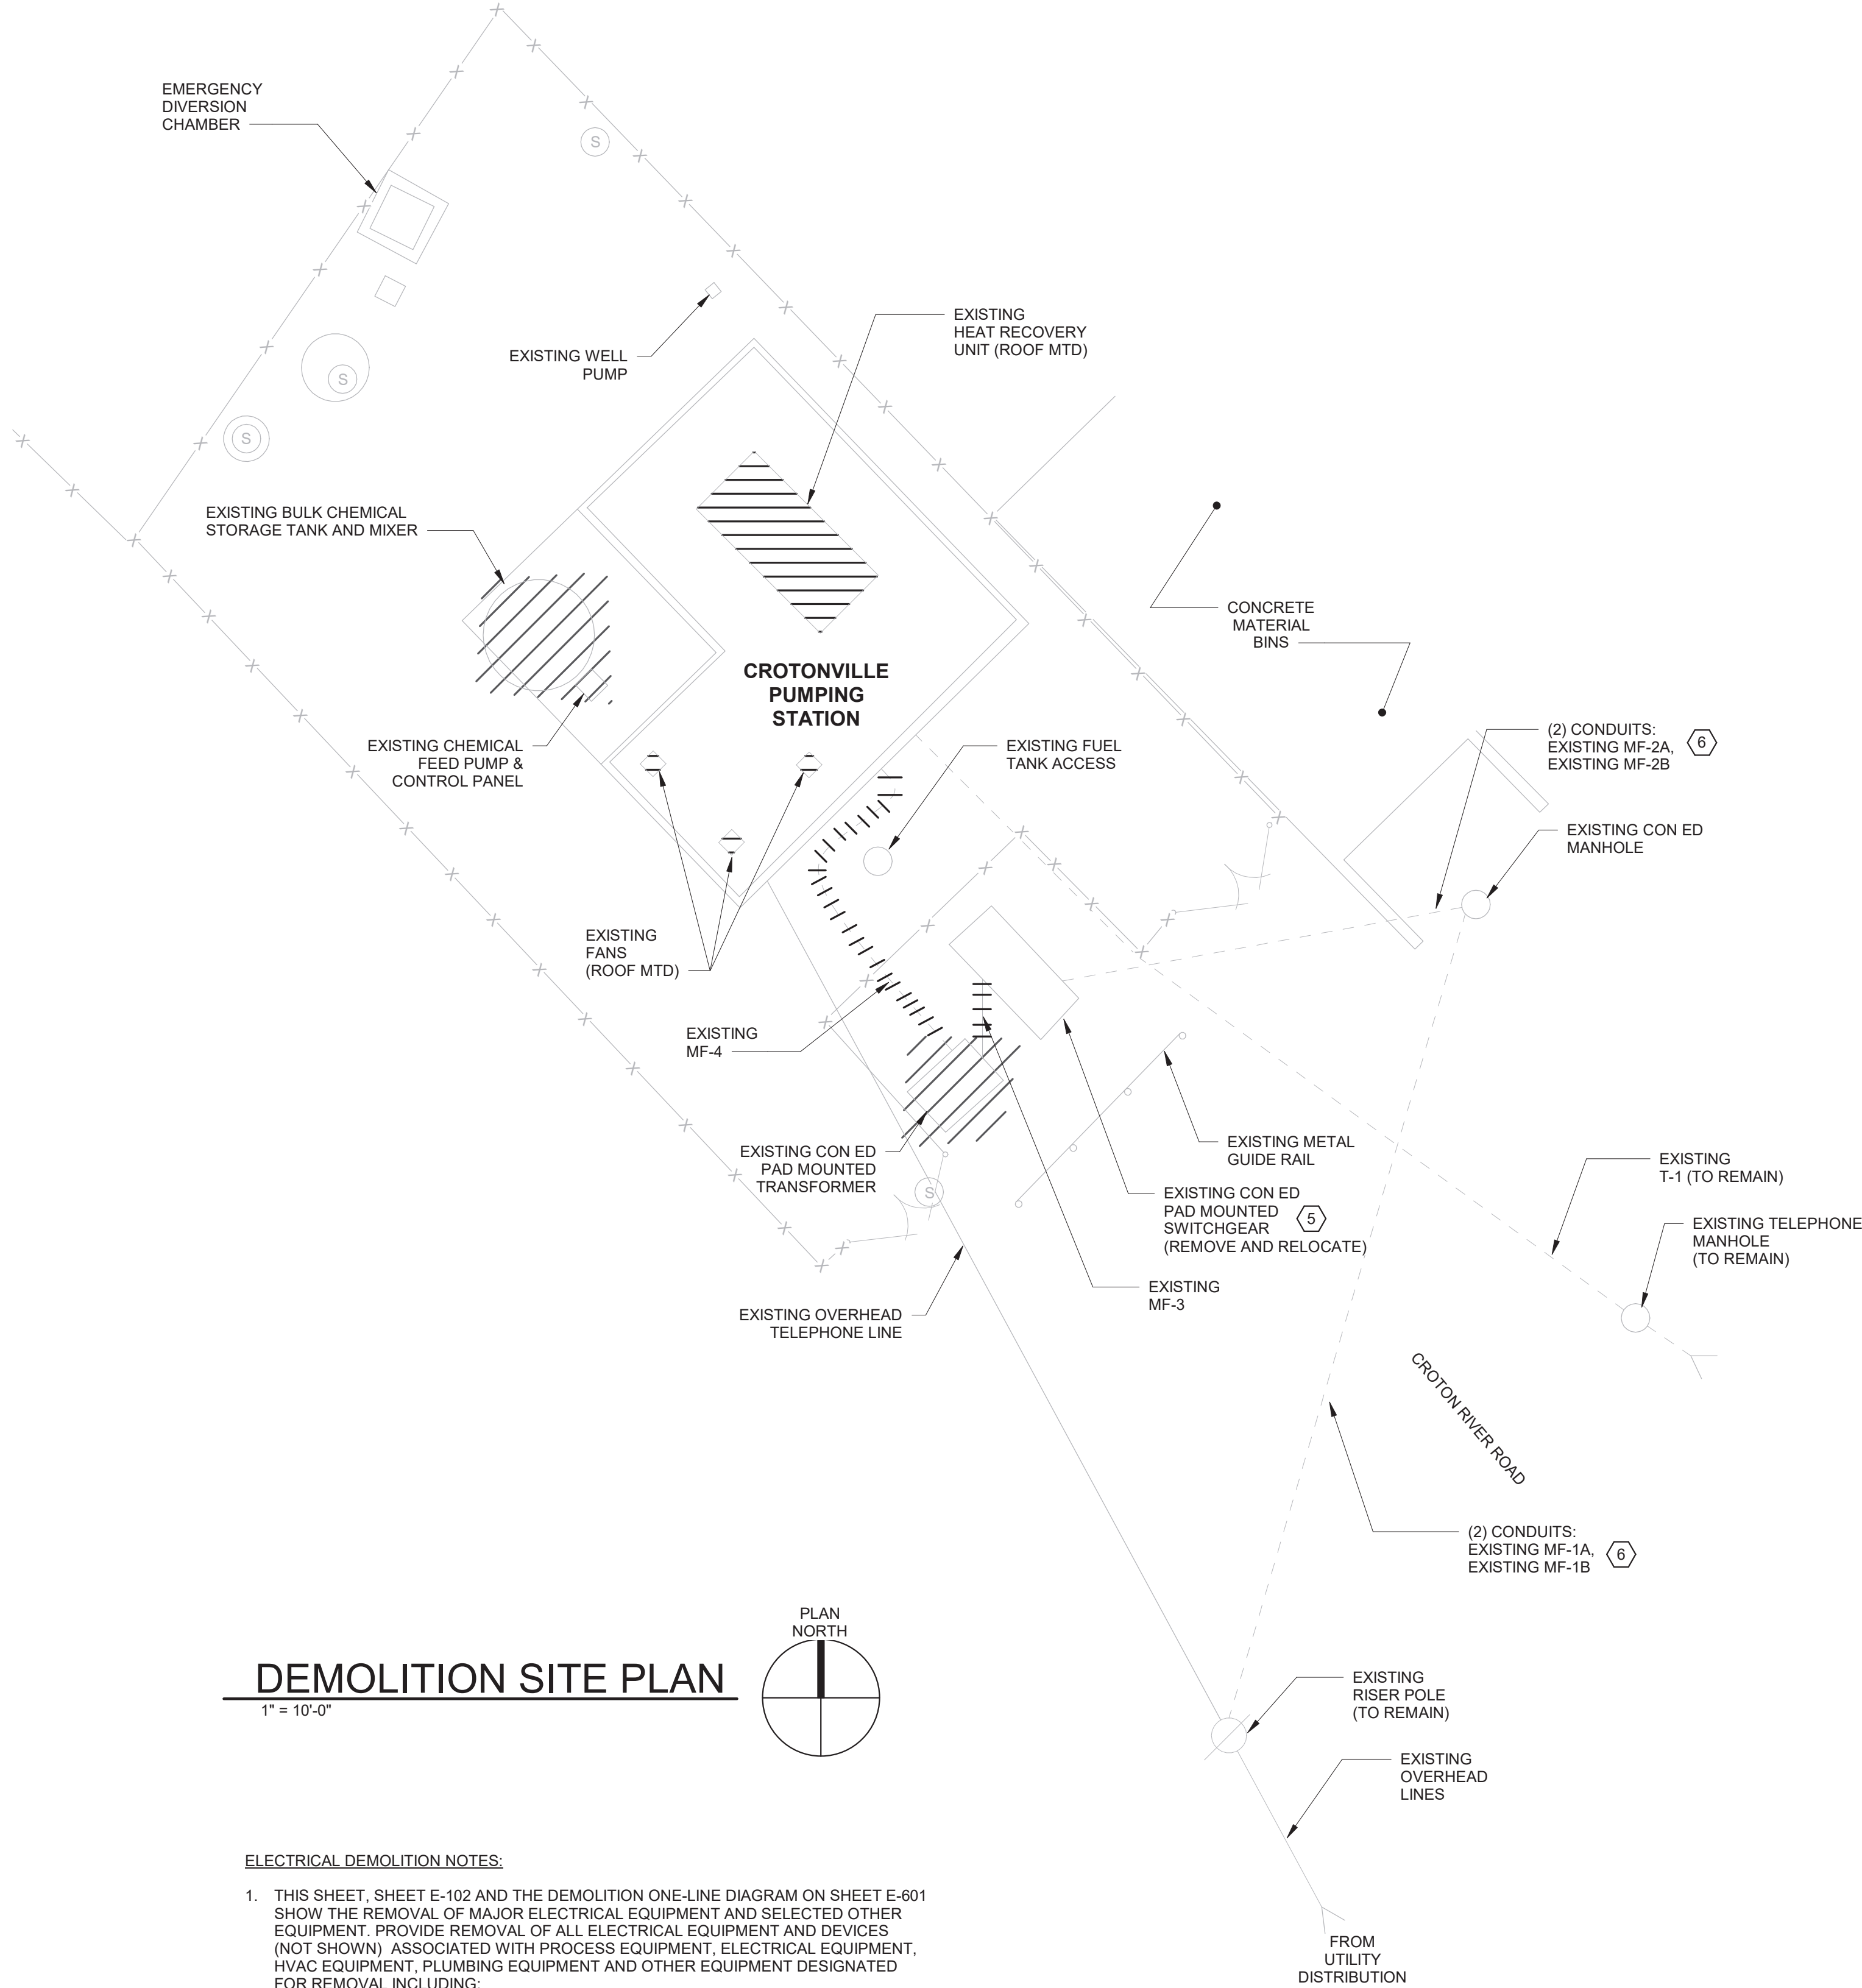

DEMOLITION SITE PLAN

1" = 10'-0"

ELECTRICAL DEMOLITION NOTES:


- THIS SHEET, SHEET E-102 AND THE DEMOLITION ONE-LINE DIAGRAM ON SHEET E-601 SHOW THE REMOVAL OF MAJOR ELECTRICAL EQUIPMENT AND SELECTED OTHER EQUIPMENT. PROVIDE REMOVAL OF ALL ELECTRICAL EQUIPMENT AND DEVICES (NOT SHOWN) ASSOCIATED WITH PROCESS EQUIPMENT, ELECTRICAL EQUIPMENT, HVAC EQUIPMENT, PLUMBING EQUIPMENT AND OTHER EQUIPMENT DESIGNATED FOR REMOVAL INCLUDING:
 - DISCONNECT SWITCHES
 - MOTOR CONTROLLERS
 - CONTROL DEVICES
 - CONTROL PANELS
 - CONTROL STATIONS
 - THERMOSTATS
- PROVIDE REMOVAL OF THE FOLLOWING ELECTRICAL SYSTEMS AND EQUIPMENT (NOT SHOWN):
 - TRANSFORMERS
 - INSTRUMENTATION
 - DATA COMMUNICATION DEVICES (RETURN TO COUNTY)
 - CARBON MONOXIDE ALARM
 - FUEL TANK MONITORING EQUIPMENT (RETURN TO COUNTY)
 - DOOR SWITCHES
 - INTERIOR LIGHTING FIXTURES
 - EXTERIOR LIGHTING FIXTURES
 - LIGHTING CONTROLS
 - RECEPTACLES
 - WIRING
 - GROUNDING
- WIRING REMOVALS SHALL INCLUDE CONDUCTORS, CABLES, EXPOSED CONDUITS, PULL BOXES, WIREWAYS, JUNCTION BOXES, SURFACE MOUNTED OUTLET BOXES, CONDUIT FITTINGS AND TELEPHONE JACKS UNLESS OTHERWISE INDICATED. CONCEALED AND UNDERGROUND CONDUITS MAY BE ABANDONED IN-PLACE UNLESS INTERFERING WITH NEW CONSTRUCTION. PORTIONS OF CONCEALED AND UNDERGROUND CONDUITS INTERFERING WITH NEW CONSTRUCTION SHALL BE REMOVED. RECESSED OUTLET BOXES MAY REMAIN IN-PLACE. PROVIDE BLANK COVERS ON REMAINING RECESSED OUTLET BOXES.

ELECTRICAL DEMOLITION NOTES CONTINUED:

- WHERE WIRING REMOVALS INCLUDE UNDERGROUND CONDUITS ENTERING THE PUMPING STATION, REMOVE INTERIOR PORTION OF CONDUIT TO WITHIN 6" OF INTERIOR WALL SURFACE. SEAL INTERIOR OF REMAINING CONDUIT INTERIOR WITH CONDUIT SEALANT AND CAP.
- PROVIDE REMOVAL OF ALL HARDWARE, SUPPORTS, BRACKETS AND FASTENERS ASSOCIATED WITH ELECTRICAL ITEMS DESIGNATED FOR REMOVAL.
- PROVIDE RESTORATION OF SURFACES REQUIRING REPAIR AS A RESULT OF ELECTRICAL REMOVALS. THIS SHALL INCLUDE SEALING WALL, FLOOR, ROOF AND EQUIPMENT ENCLOSURE PENETRATIONS AND FILLING HOLES REMAINING FROM FASTENER REMOVALS. RESTORED SURFACES SHALL EQUAL ADJACENT UNDISTURBED SURFACES.
- COORDINATE ELECTRICAL REMOVALS TO MAINTAIN OPERATION OF PROCESS EQUIPMENT, HVAC EQUIPMENT AND PLUMBING EQUIPMENT UNTIL THEIR DECOMMISSIONING INCLUDING ANY INSTRUMENTATION, LIGHTING OR BUILDING SYSTEMS NECESSARY FOR OPERATION OF THE EQUIPMENT.
- REMOVED ELECTRICAL EQUIPMENT AND MATERIALS SHALL BE DISPOSED OF OFF-SITE UNLESS OTHERWISE INDICATED.
- COORDINATE REMOVAL OF UTILITY OWNED EQUIPMENT AND WIRING WITH THE SERVICE PROVIDERS.

KEYED NOTES:


- STANDBY GENERATOR REMOVALS SHALL INCLUDE FUEL PUMPS, DAY TANK, FUEL PIPING, VENT PIPING, BATTERIES, BATTERY CHARGER, AIR PLENUM AND EXHAUST SYSTEM. BATTERY CHARGER SHALL BE RETURNED TO COUNTY.
- PROVIDE REMOVAL OF PANELBOARD LP-8 COVER AND INTERIOR. RECESSED PANELBOARD BOX SHALL REMAIN IN-PLACE. PROVIDE A 12 GAUGE GALVANIZED STEEL PLATE SIZED AS NECESSARY TO COVER THE REMAINING RECESSED BOX. FASTEN PLATE SECURELY TO WALL.
- PROVIDE REMOVAL/REINSTALLATION OF THE TELEPHONE SYSTEM COMPONENTS INDICATED. SEE SHEETS E-103 AND E-104 FOR LOCATIONS OF REINSTALLED COMPONENTS.
- RETURN TO COUNTY AFTER REMOVAL.
- PROVIDE REMOVAL / REINSTALLATION OF CON ED PAD MOUNTED SWITCHGEAR. REINSTALLATION SHALL BE ON ELEVATED PLATFORM AS SHOWN ON SHEET E-103.
- REMOVE CONDUCTORS. EXISTING 4" CONDUITS SHALL REMAIN FOR REUSE.
- COUNTY WILL REMOVE SELECTED COMPONENTS PRIOR TO EQUIPMENT DISPOSAL BY CONTRACTOR.

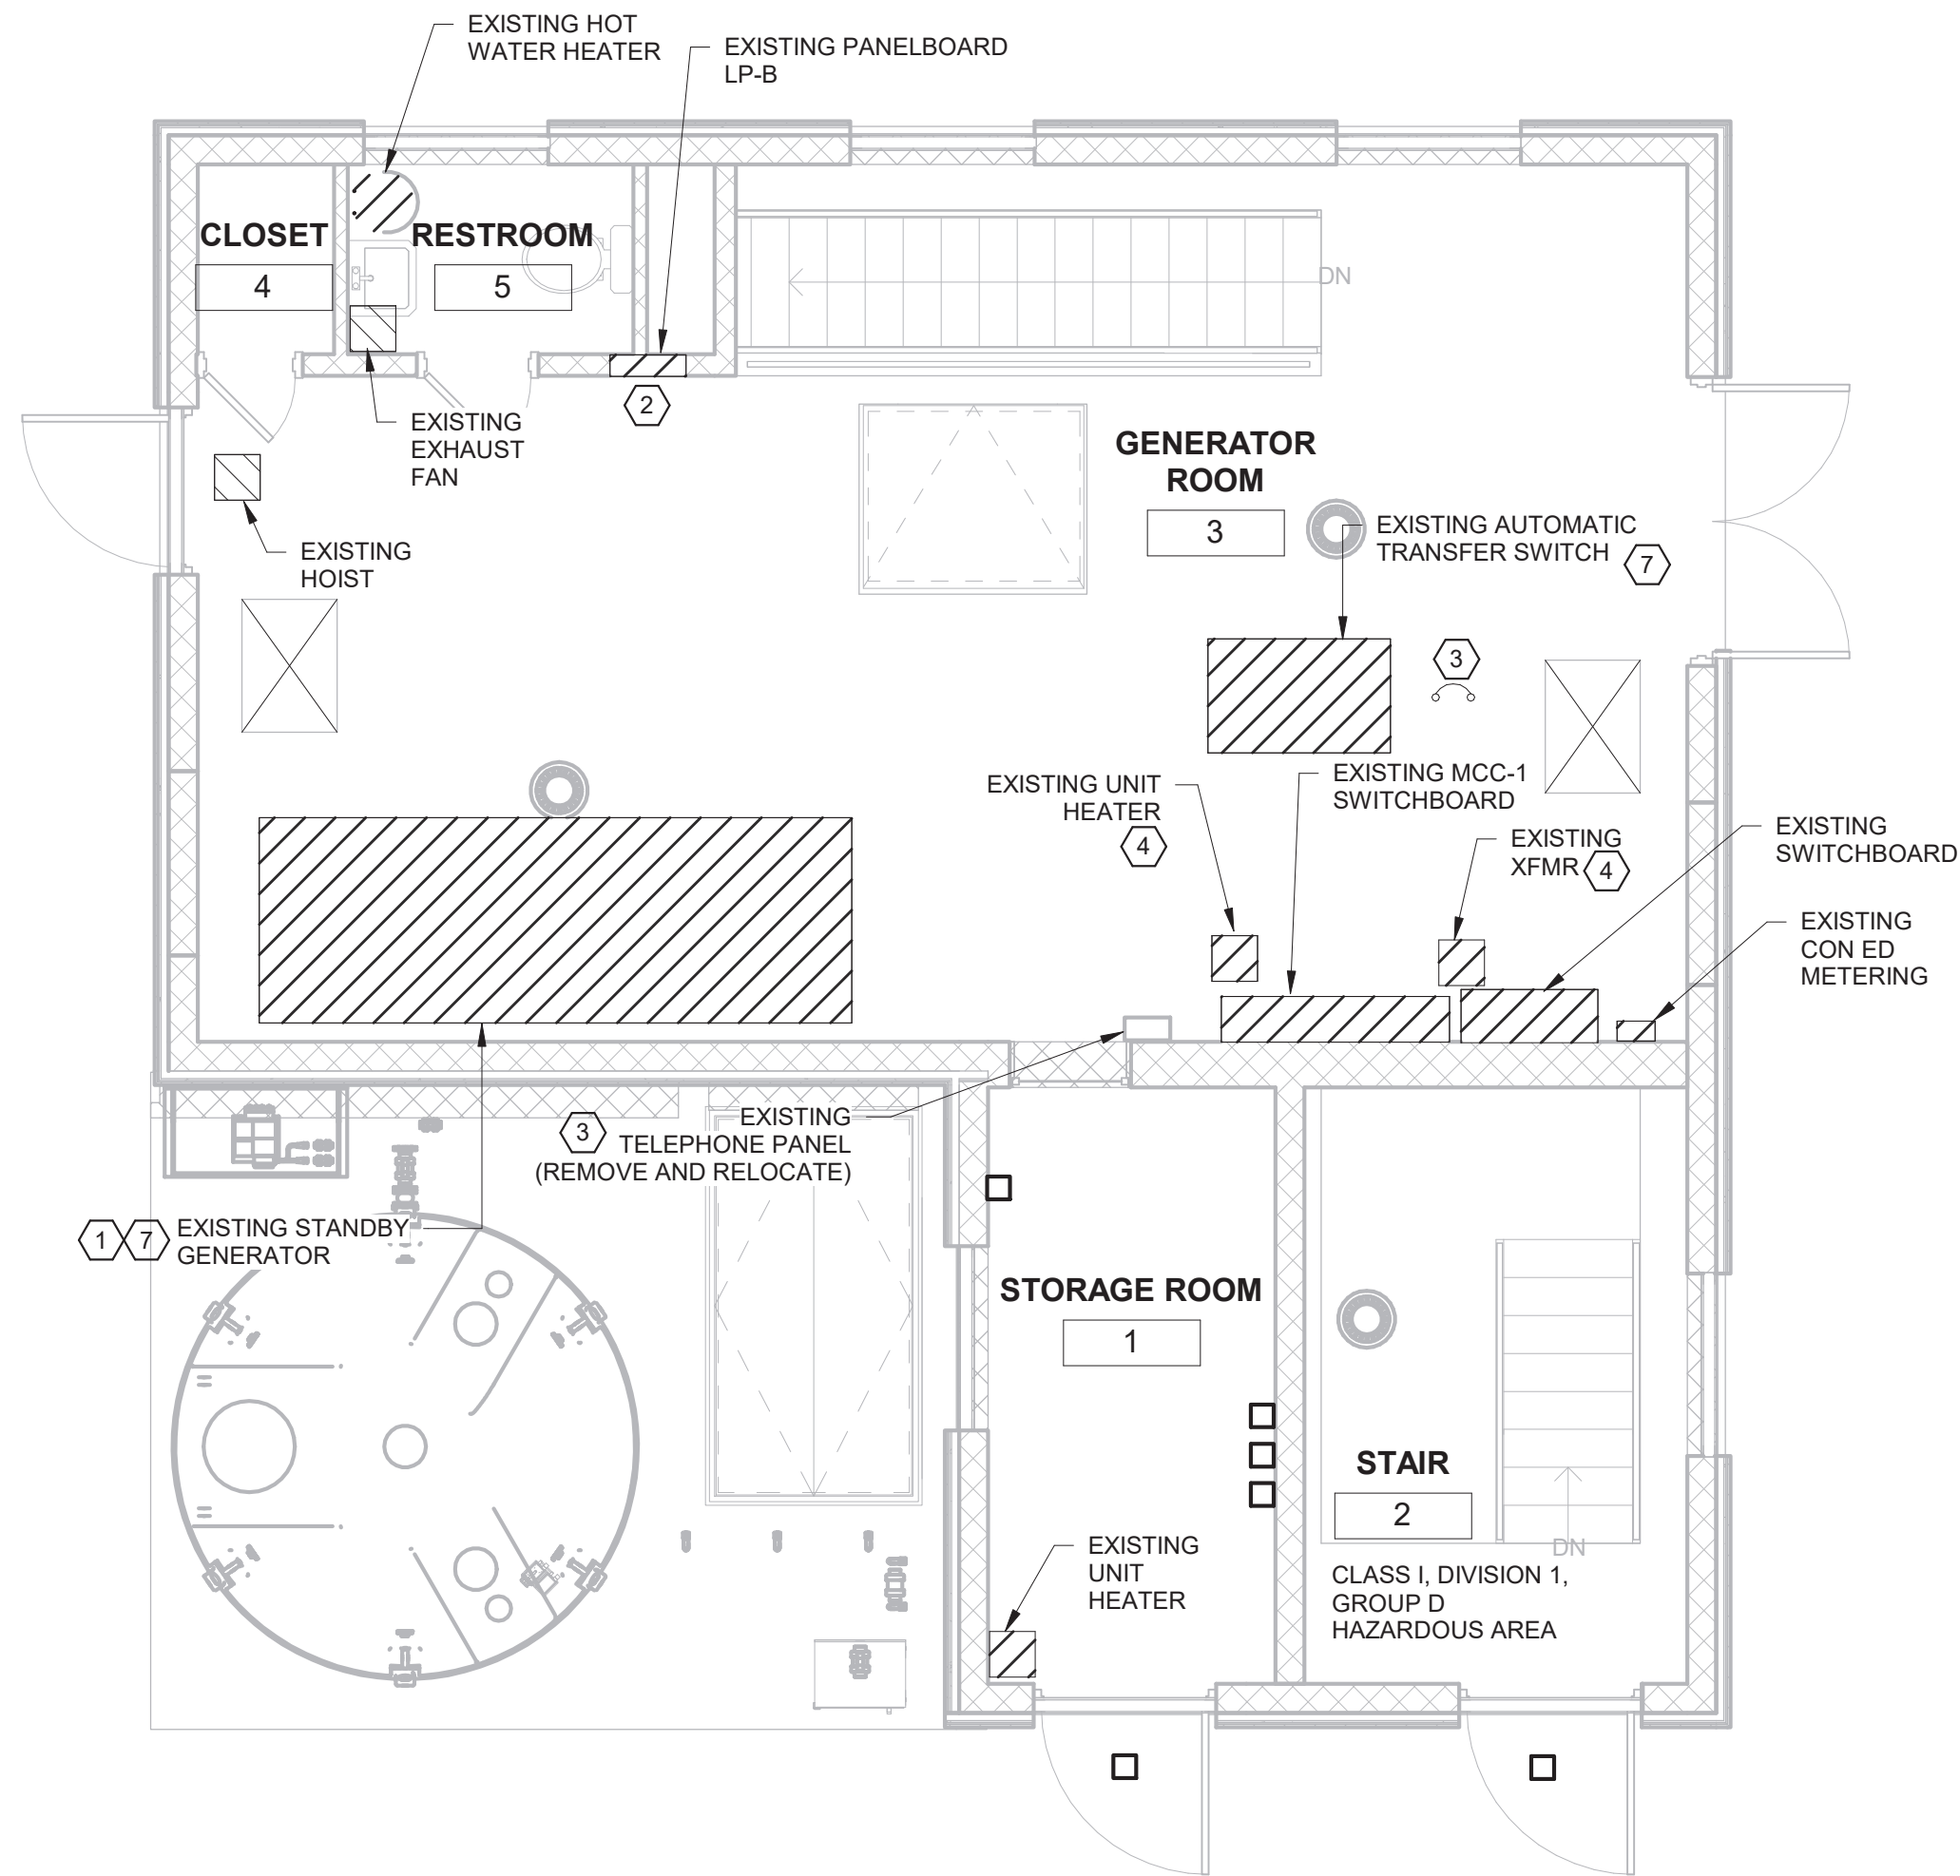

MAIN LEVEL DEMOLITION PLAN

1/4" = 1'-0"

4' 2' 0' 2' 4'

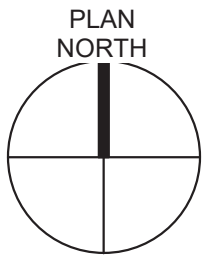

2021-07-15

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IN CHARGE OF **Eric Miles**
CHECKED BY **Jim Crosier**
MADE BY **Joseph LaGoy**




O'BRIEN & GERE ENGINEERS, INC.
50 MAIN ST., 10TH FLOOR SUITE 1000,
WHITE PLAINS, NEW YORK 10606

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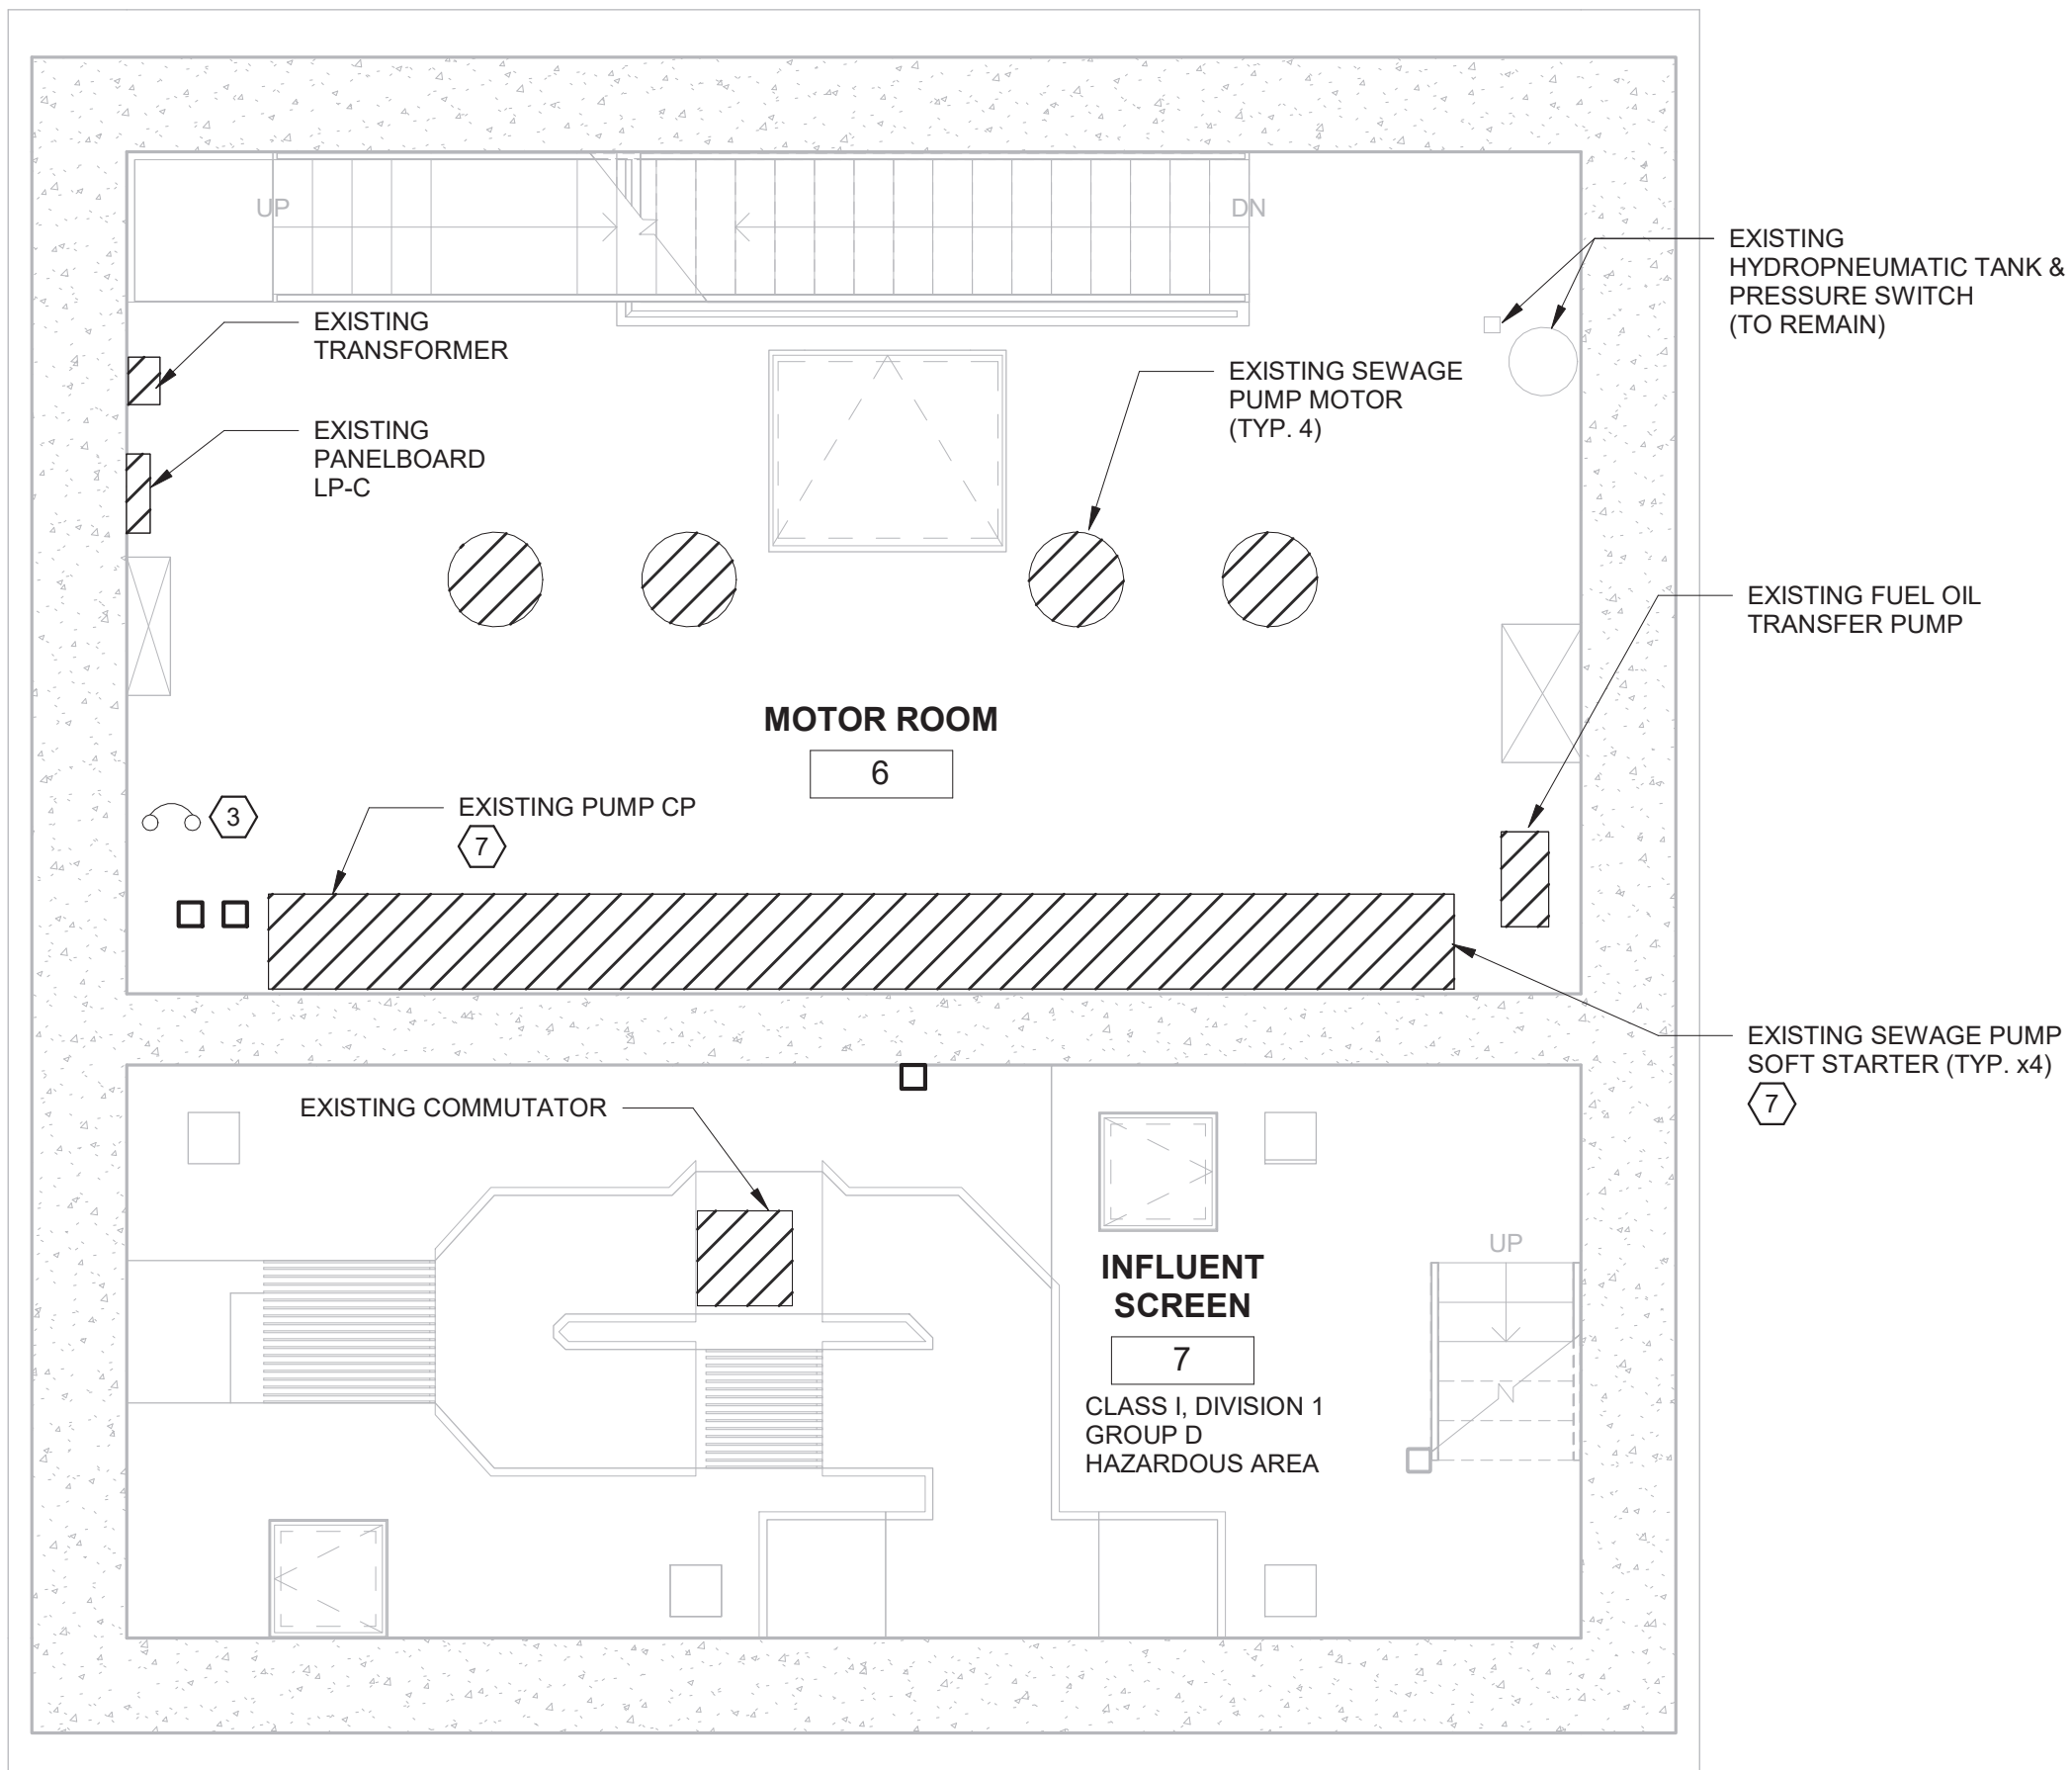
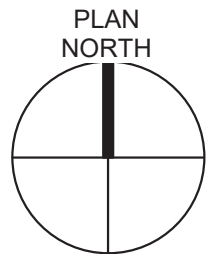
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WESTCHESTER COUNTY, NEW YORK		CONTRACT NUMBER	
DEPARTMENT OF PUBLIC WORKS AND TRANSPORTATION		SHEET NUMBER	
DIVISION OF ENGINEERING		E-101	
CROTONVILLE PUMPING STATION REHABILITATION		SHEET NO. 38 OF 60	
OSSINING, NEW YORK		SCALE:	
DEMOLITION PLANS		DATE: 12/21/2018	
		DPW FILE NO.	
		208-03-E-62-0	
		REV. NO.	
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LOWER LEVEL DEMOLITION PLAN

1/4" = 1'-0"

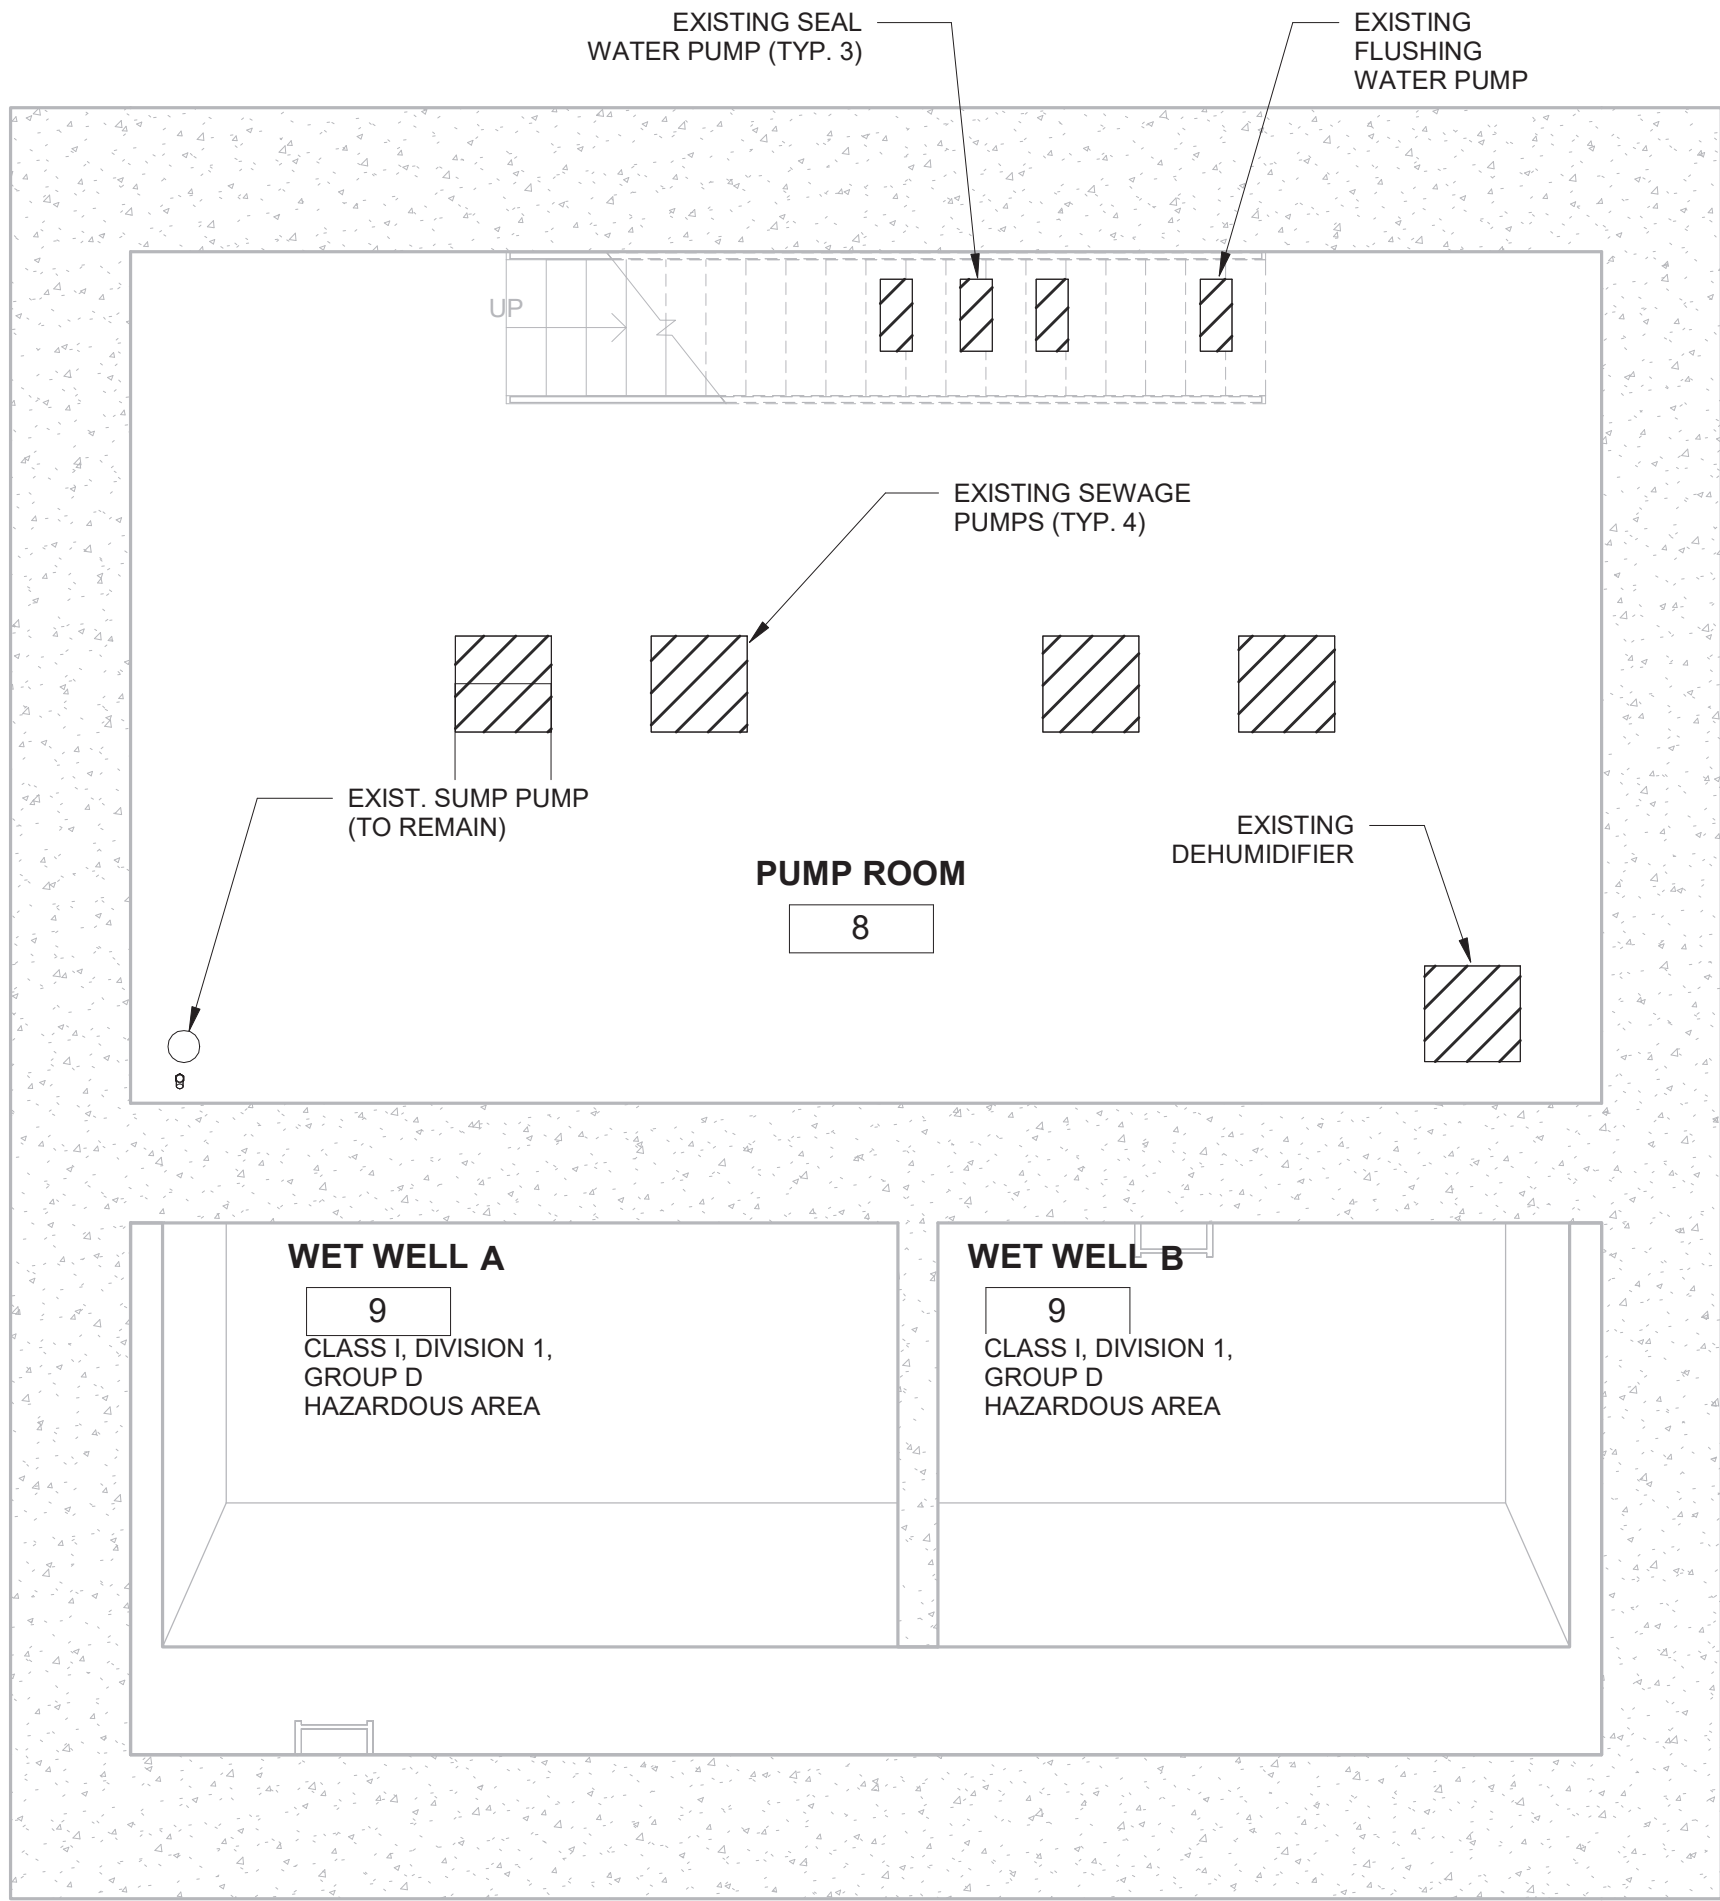


DETAIL NOTES:

- SEE SHEET E-101 FOR KEYED NOT DESCRIPTIONS.

MIDDLE LEVEL DEMOLITION PLAN


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

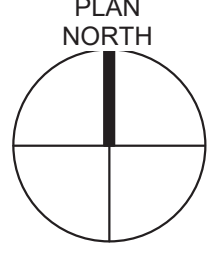


DRAWING NOTES:

- SEE ELECTRICAL DEMOLITION NOTES SHEET E-101.

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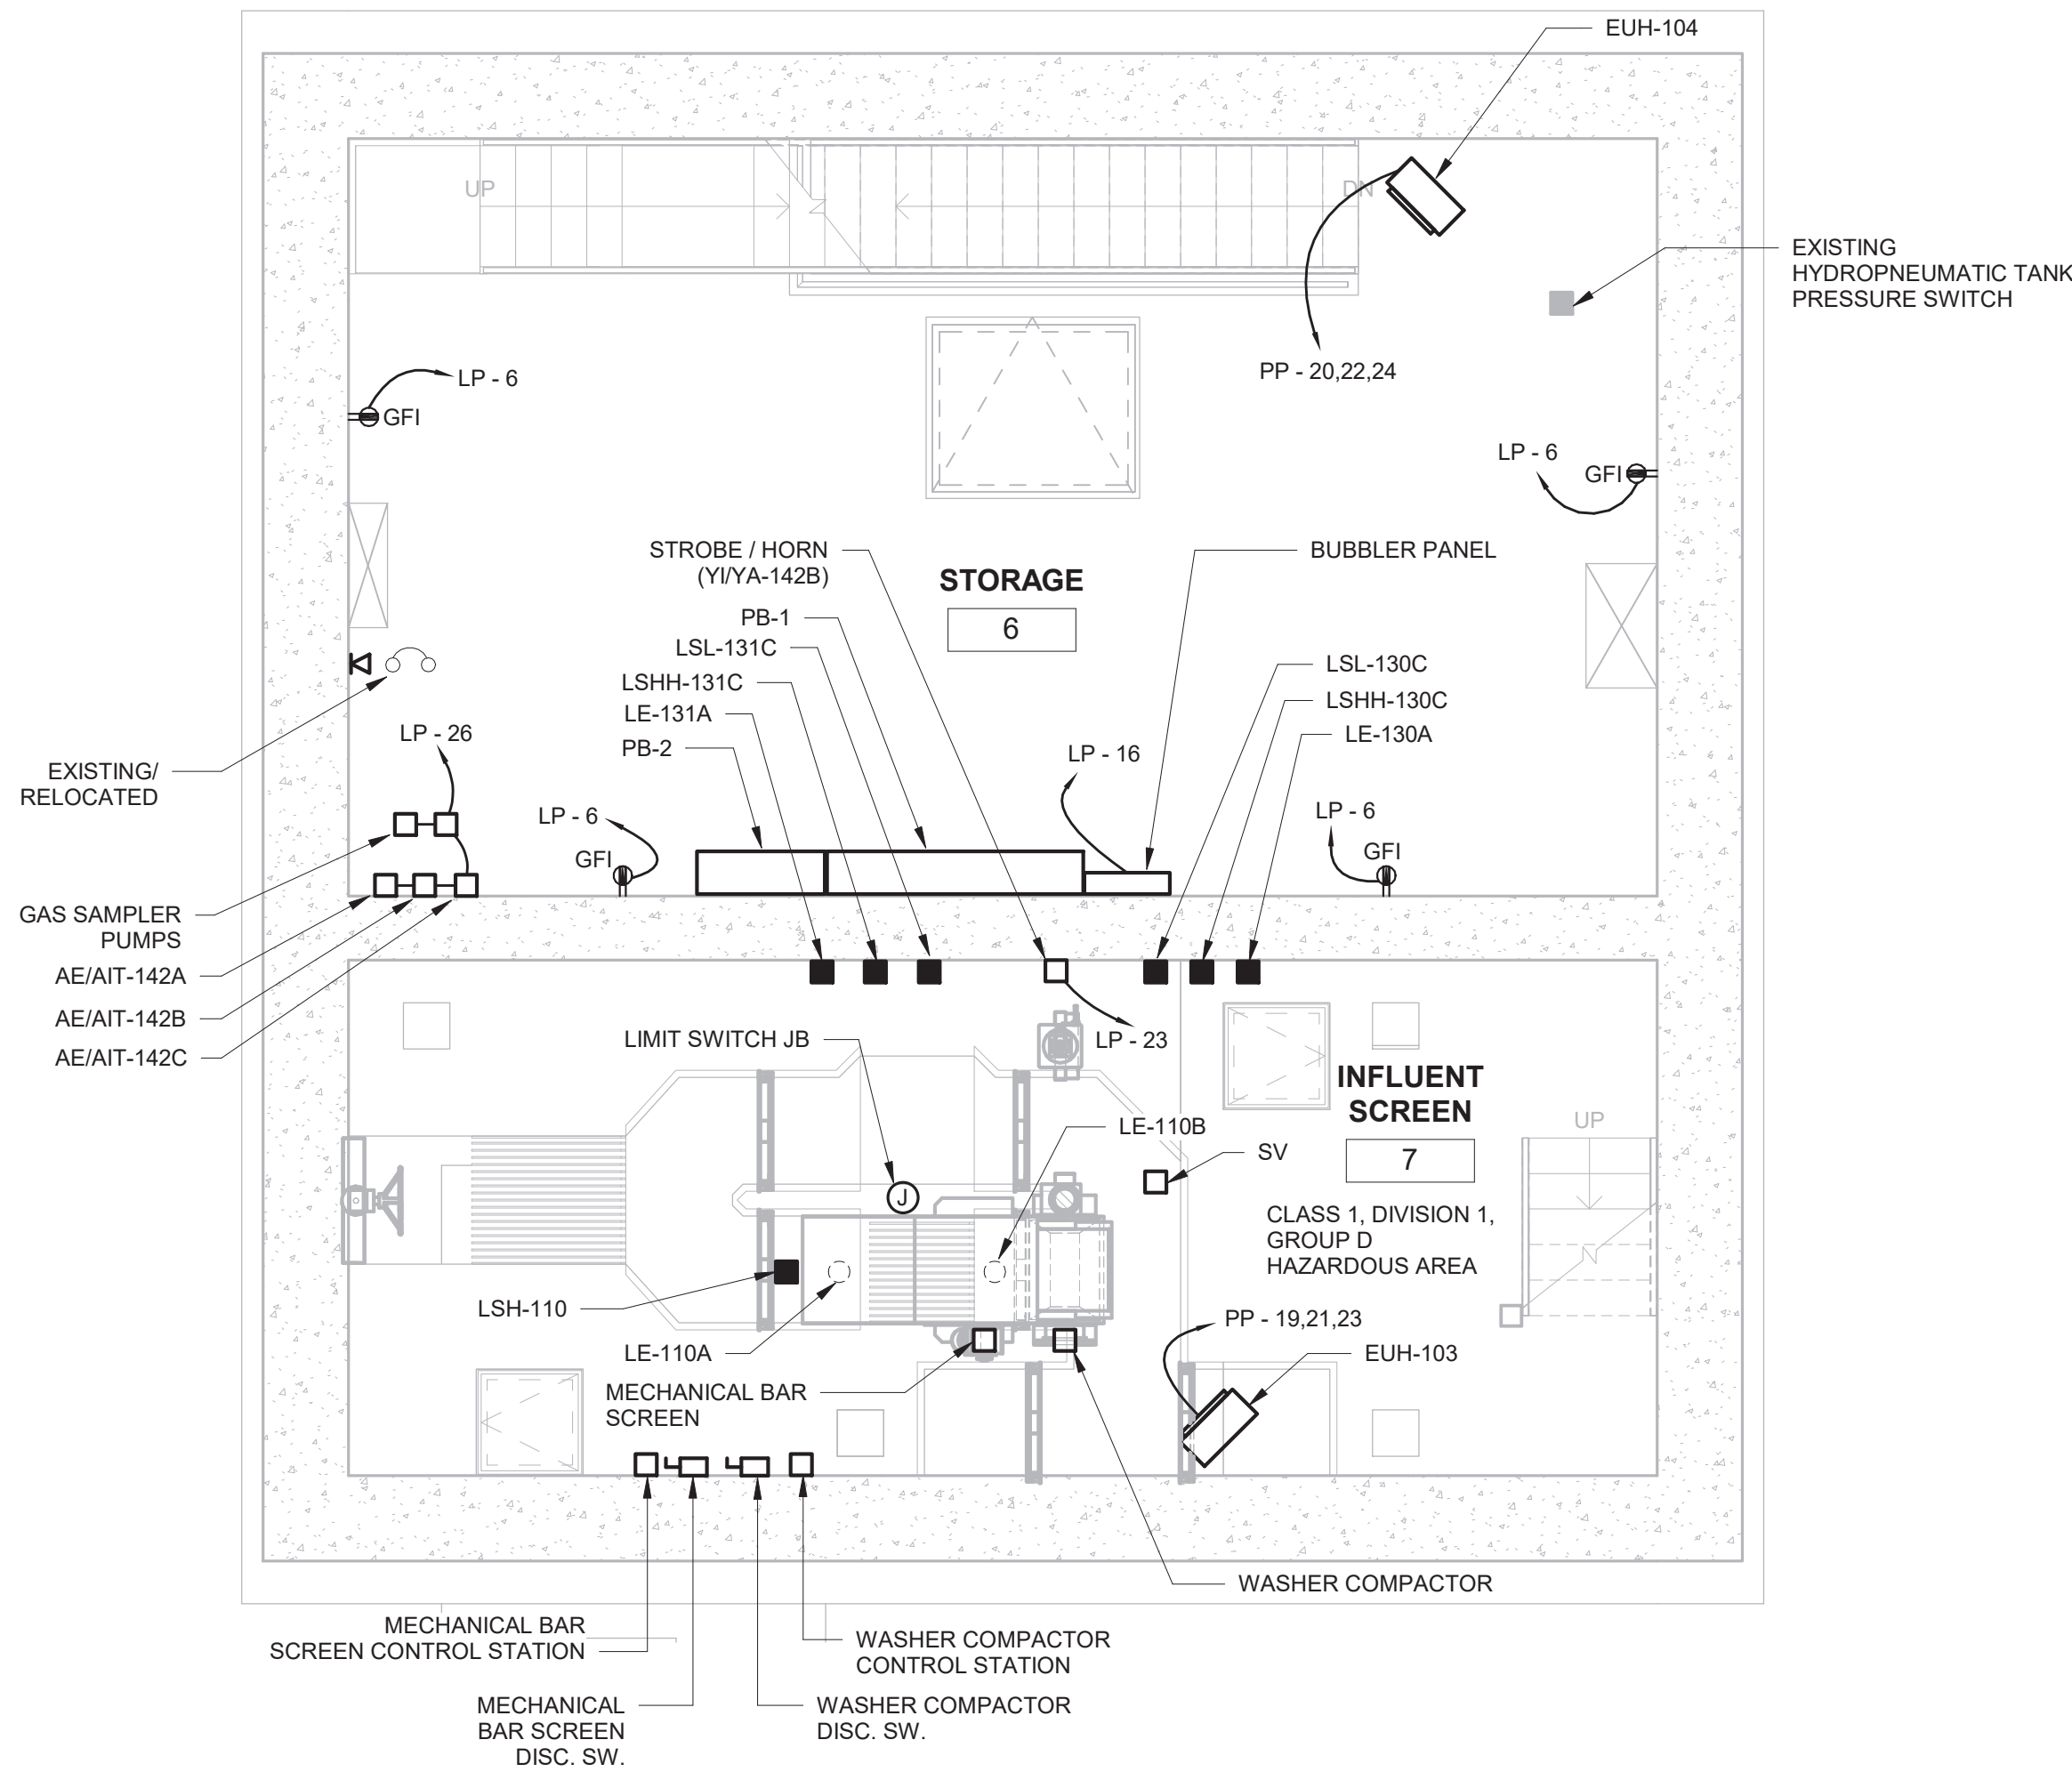
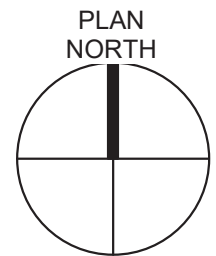

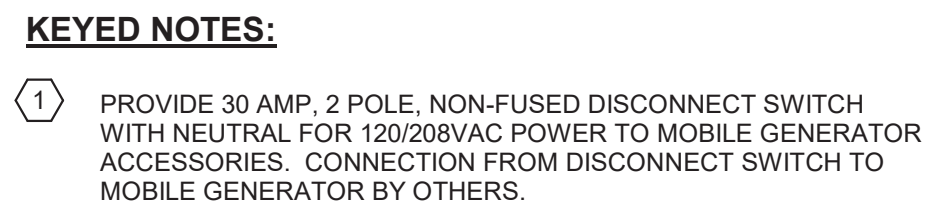
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WESTCHESTER COUNTY, NEW YORK DEPARTMENT OF PUBLIC WORKS AND TRANSPORTATION DIVISION OF ENGINEERING		CONTRACT NUMBER	SHEET NUMBER E-103	SHEET NO. 40 OF 60
CROTONVILLE PUMPING STATION REHABILITATION		SCALE: DATE: 12/21/2018		DPW FILE NO. 208-03-E-64-0
OSSINGEN, NEW YORK POWER PLANS		REV. NO. 0		

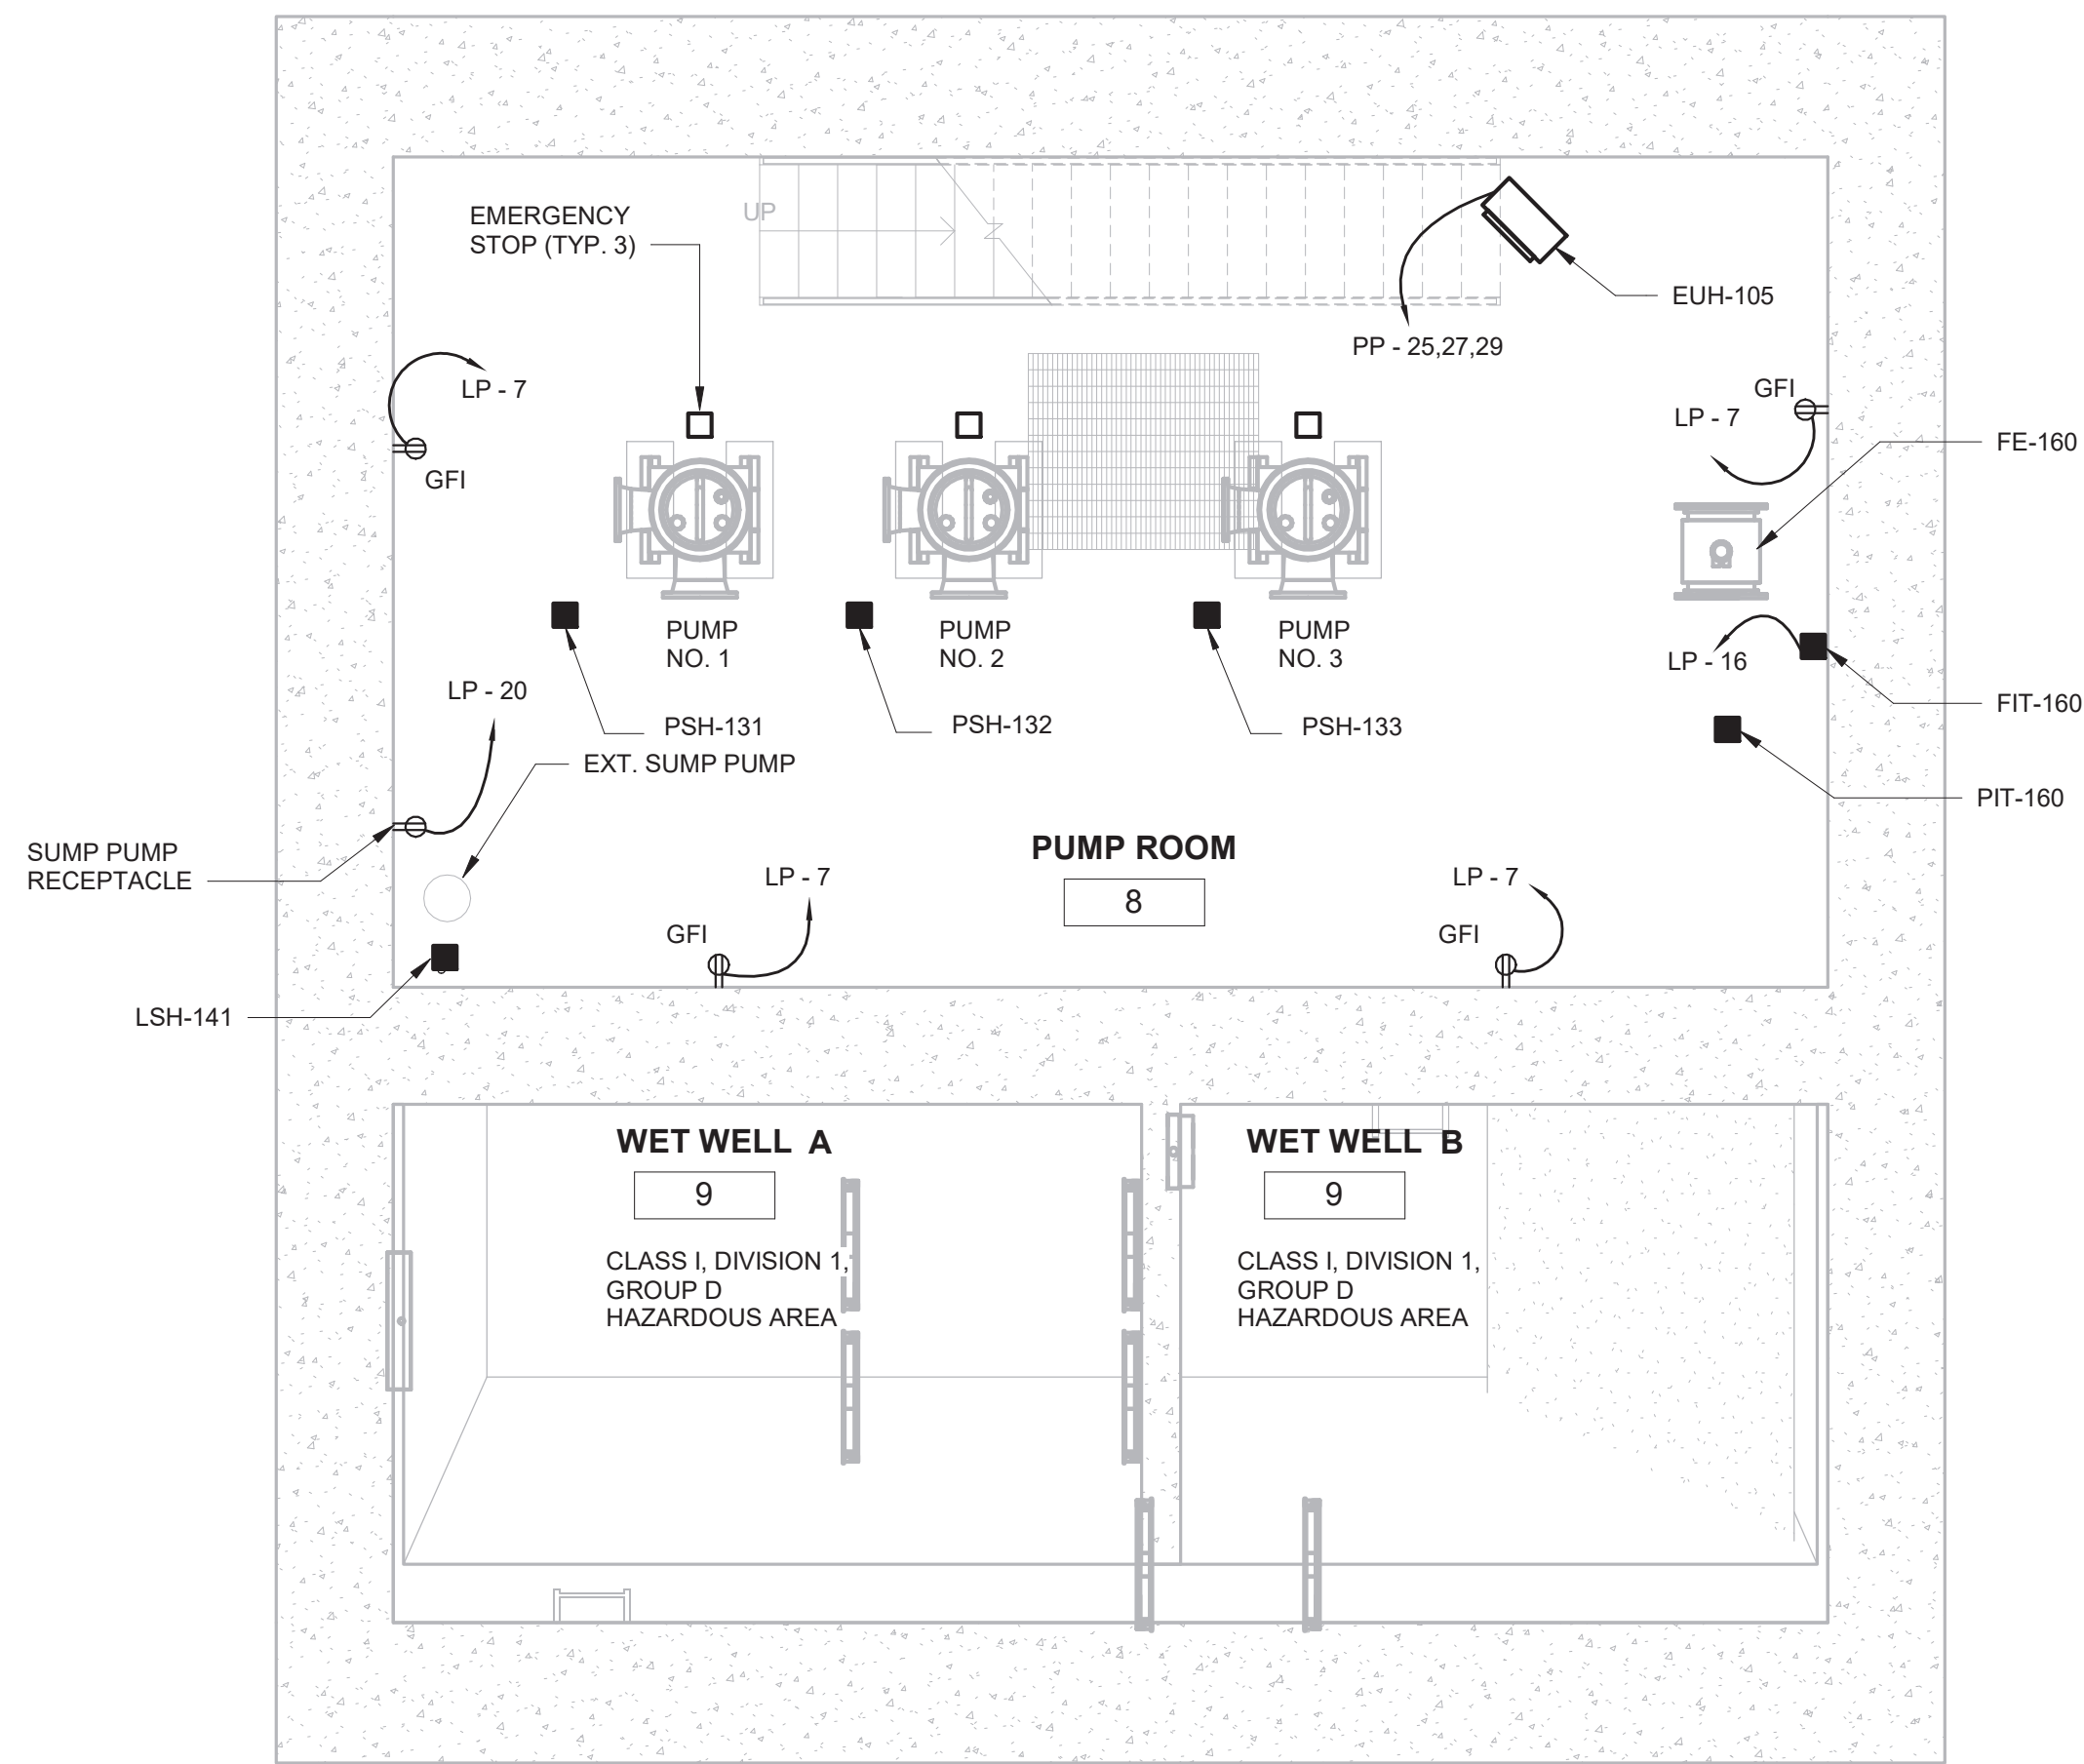


LOWER LEVEL POWER PLAN

1/4" = 1'-0"



MIDDLE LEVEL POWER PLAN

1/4" = 1'-0"

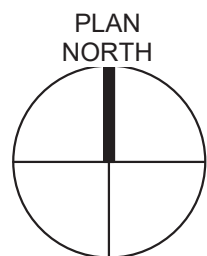

DRAWING NOTES:

- MECHANICAL BAR SCREEN AND WASHER COMPACTOR DISCONNECT SWITCHES SHALL BE 30 AMP, 3 POLE, NON-FUSED TYPE.
- PROVIDE PUMP NO. 1, NO. 2, AND NO. 3 POWER AND CONTROL CABLE INSTALLATION AS FOLLOWS: ROUTE CONDUITS P-131 FROM MCC AND CC-131A FROM PUMP PROTECTION PANEL TO A LOCATION DIRECTLY ABOVE PUMP NO. 1. INSTALL PUMP CABLES AS OPEN WIRING FROM THIS LOCATION TO THE PUMP. PROVIDE 10' ADDITIONAL LENGTH OF EACH CABLE. (TYPICAL PUMP NO. 2 WITH CONDUITS P-132 AND CC-132A AND PUMP NO. 3 WITH CONDUITS P-133 AND CC-133A).



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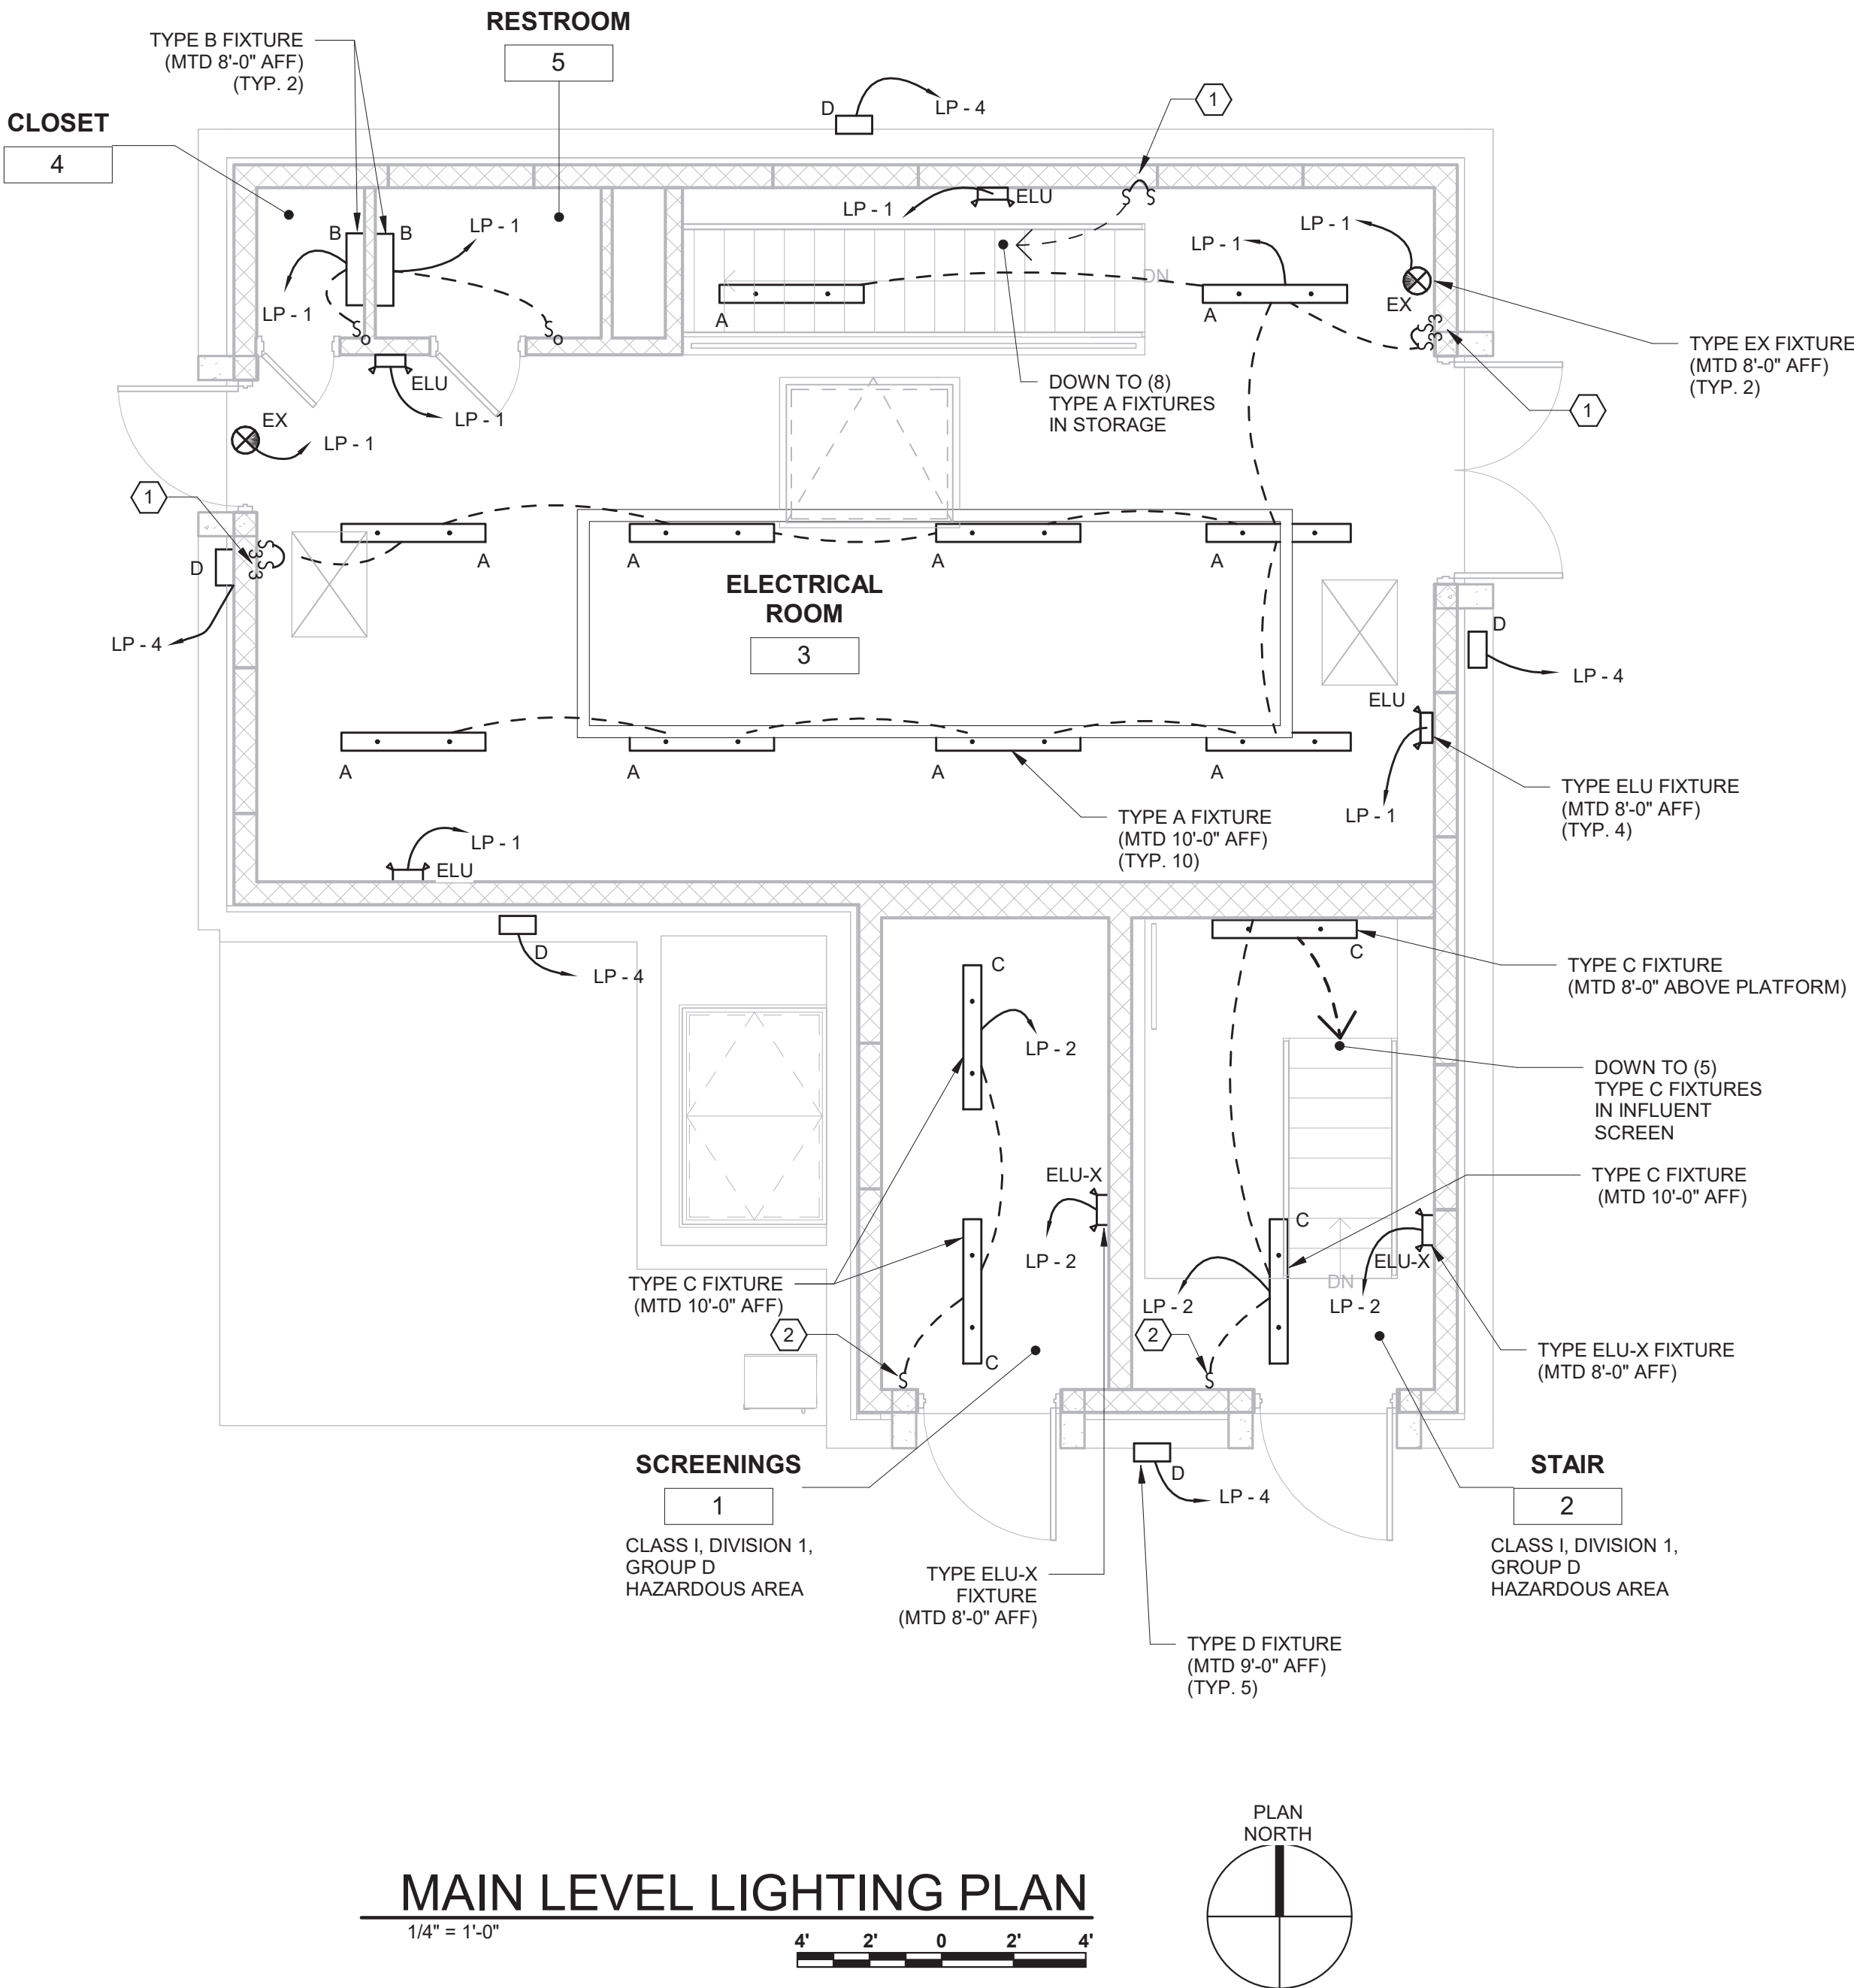


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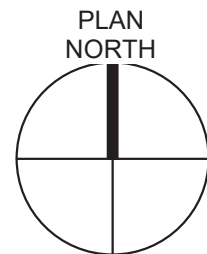
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POWER PLANS				
CONTRACT NUMBER	SHEET NUMBER	SHEET NO. 41 OF 60		
SCALE: DATE: 12/21/2018				
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LIGHTING FIXTURE SCHEDULE				
TYPE	DESCRIPTION	LAMP	VOLTAGE	MANUFACTURER
A	4 FOOT PENDANT MOUNTED STRIP, FULL FROST LENS, STEP DIMMING DRIVER, WHITE FINISH	43 WATT LED 4958 LUMENS, 3500K, 80 CRI	120 VAC	METALUX SNLED SERIES OR EQUAL
B	2 FOOT, ENCLOSED, WALL MOUNTED ACRYLIC FROSTED LENS, WHITE FINISH	19 WATT LED 1600 LUMENS, 3500K, 85 CRI	120 VAC	METALUX BCLED SERIES OR EQUAL
C	4 FOOT PENDANT AND WALL MOUNTED EXPLOSION PROOF, RATED CLASS I, DIVISION 1, GROUP D	(2) 28 WATT LED 7000 LUMENS, 4500K, 80 CRI	120 VAC	LARSON ELECTRONICS PART NO. EPL-48-2L-LED OR EQUAL
D	EXTERIOR WALL MOUNTED FORWARD THROW DISTRIBUTION, EMERGENCY BATTERY BACKUP, DARK BRONZE FINISH, INTEGRAL PHOTOCELL	50 WATT LED 6000 LUMENS 3000K, 70 CRI	120 VAC	LITHONIA WST SERIES LED OR EQUAL
ELU	TWO HEAD, SURFACE MOUNTED EMERGENCY LIGHTING UNIT, SELF DIAGNOSTICS, WHITE FINISH	(2) 5.4 WATT LED'S	120 VAC	LITHONIA ELMLT SERIES OR EQUAL
ELU-X	TWO HEAD, SURFACE MOUNTED EXPLOSION PROOF, EMERGENCY LIGHTING UNIT, RATED CLASS I, DIVISION 1, GROUP D	(2) 10 WATT LED'S	120 VAC	LARSON ELECTRONICS PART NO. EXP-EMG-12W-2L OR EQUAL
EX	SINGLE FACED, SURFACE MOUNTED EXIT SIGN, WHITE HOUSING, RED LETTERS, EMERGENCY BATTERY BACKUP	1 WATT LED	120 VAC	LITHONIA LQM SERIES OR EQUAL



MAIN LEVEL LIGHTING PLAN


1/4" = 1'-0"



KEYED NOTES:


- ① PROVIDE TWO WALL SWITCHES FOR STEP DIMMING CONTROL OF THE CONNECTED LIGHTING FIXTURES. PROVIDE ENGRAVED NAMEPLATES AT EACH SWITCH INDICATING THE ROOM CONTROLLED AND "HIGH" OR "LOW" ACCORDINGLY.
- ② 2 POLE WALL SWITCH . SEE SAF-101 ELEMENTARY SHEET E-603 FOR CONNECTIONS.

	IN ACCORDANCE WITH TITLE VIII, ARTICLE 145, SECTION 7209 (2) OF THE NEW YORK STATE EDUCATION LAW, IT IS A VIOLATION OF LAW FOR ANY PERSON UNLESS ACTING UNDER THE DIRECTION OF A LICENSED ENGINEER TO ALTER THIS DOCUMENT.	
	IN CHARGE OF <u>Eric Miles</u> CHECKED BY <u>Jim Crosier</u> MADE BY <u>Joseph LaGoy</u>	
2021-07-15		50 MAIN ST., 10TH FLOOR SUITE 1000, WHITE PLAINS, NEW YORK 10606
REVISION NUMBER	DATE	MADE BY
		APP'D BY
REVISION		
RECORD DRAWING CERTIFICATION		
<input type="checkbox"/> AS BUILT - CHANGES AS NOTED <input type="checkbox"/> AS BUILT - NO CHANGES		
CONTRACTOR		PROJECT COORDINATOR
NAME _____	NAME _____	
SIGNATURE _____	SIGNATURE _____	
TITLE _____	TITLE _____	
DATE _____	DATE _____	
WESTCHESTER COUNTY, NEW YORK DEPARTMENT OF PUBLIC WORKS AND TRANSPORTATION DIVISION OF ENGINEERING		CONTRACT NUMBER SHEET NUMBER E-105
CROTONVILLE PUMPING STATION REHABILITATION		SHEET NO. 42 OF 60
OSSINING, NEW YORK LIGHTING PLANS		SCALE: DATE: 12/21/2018 DPW FILE NO. 208-03-E-66-0 REV. NO. 0

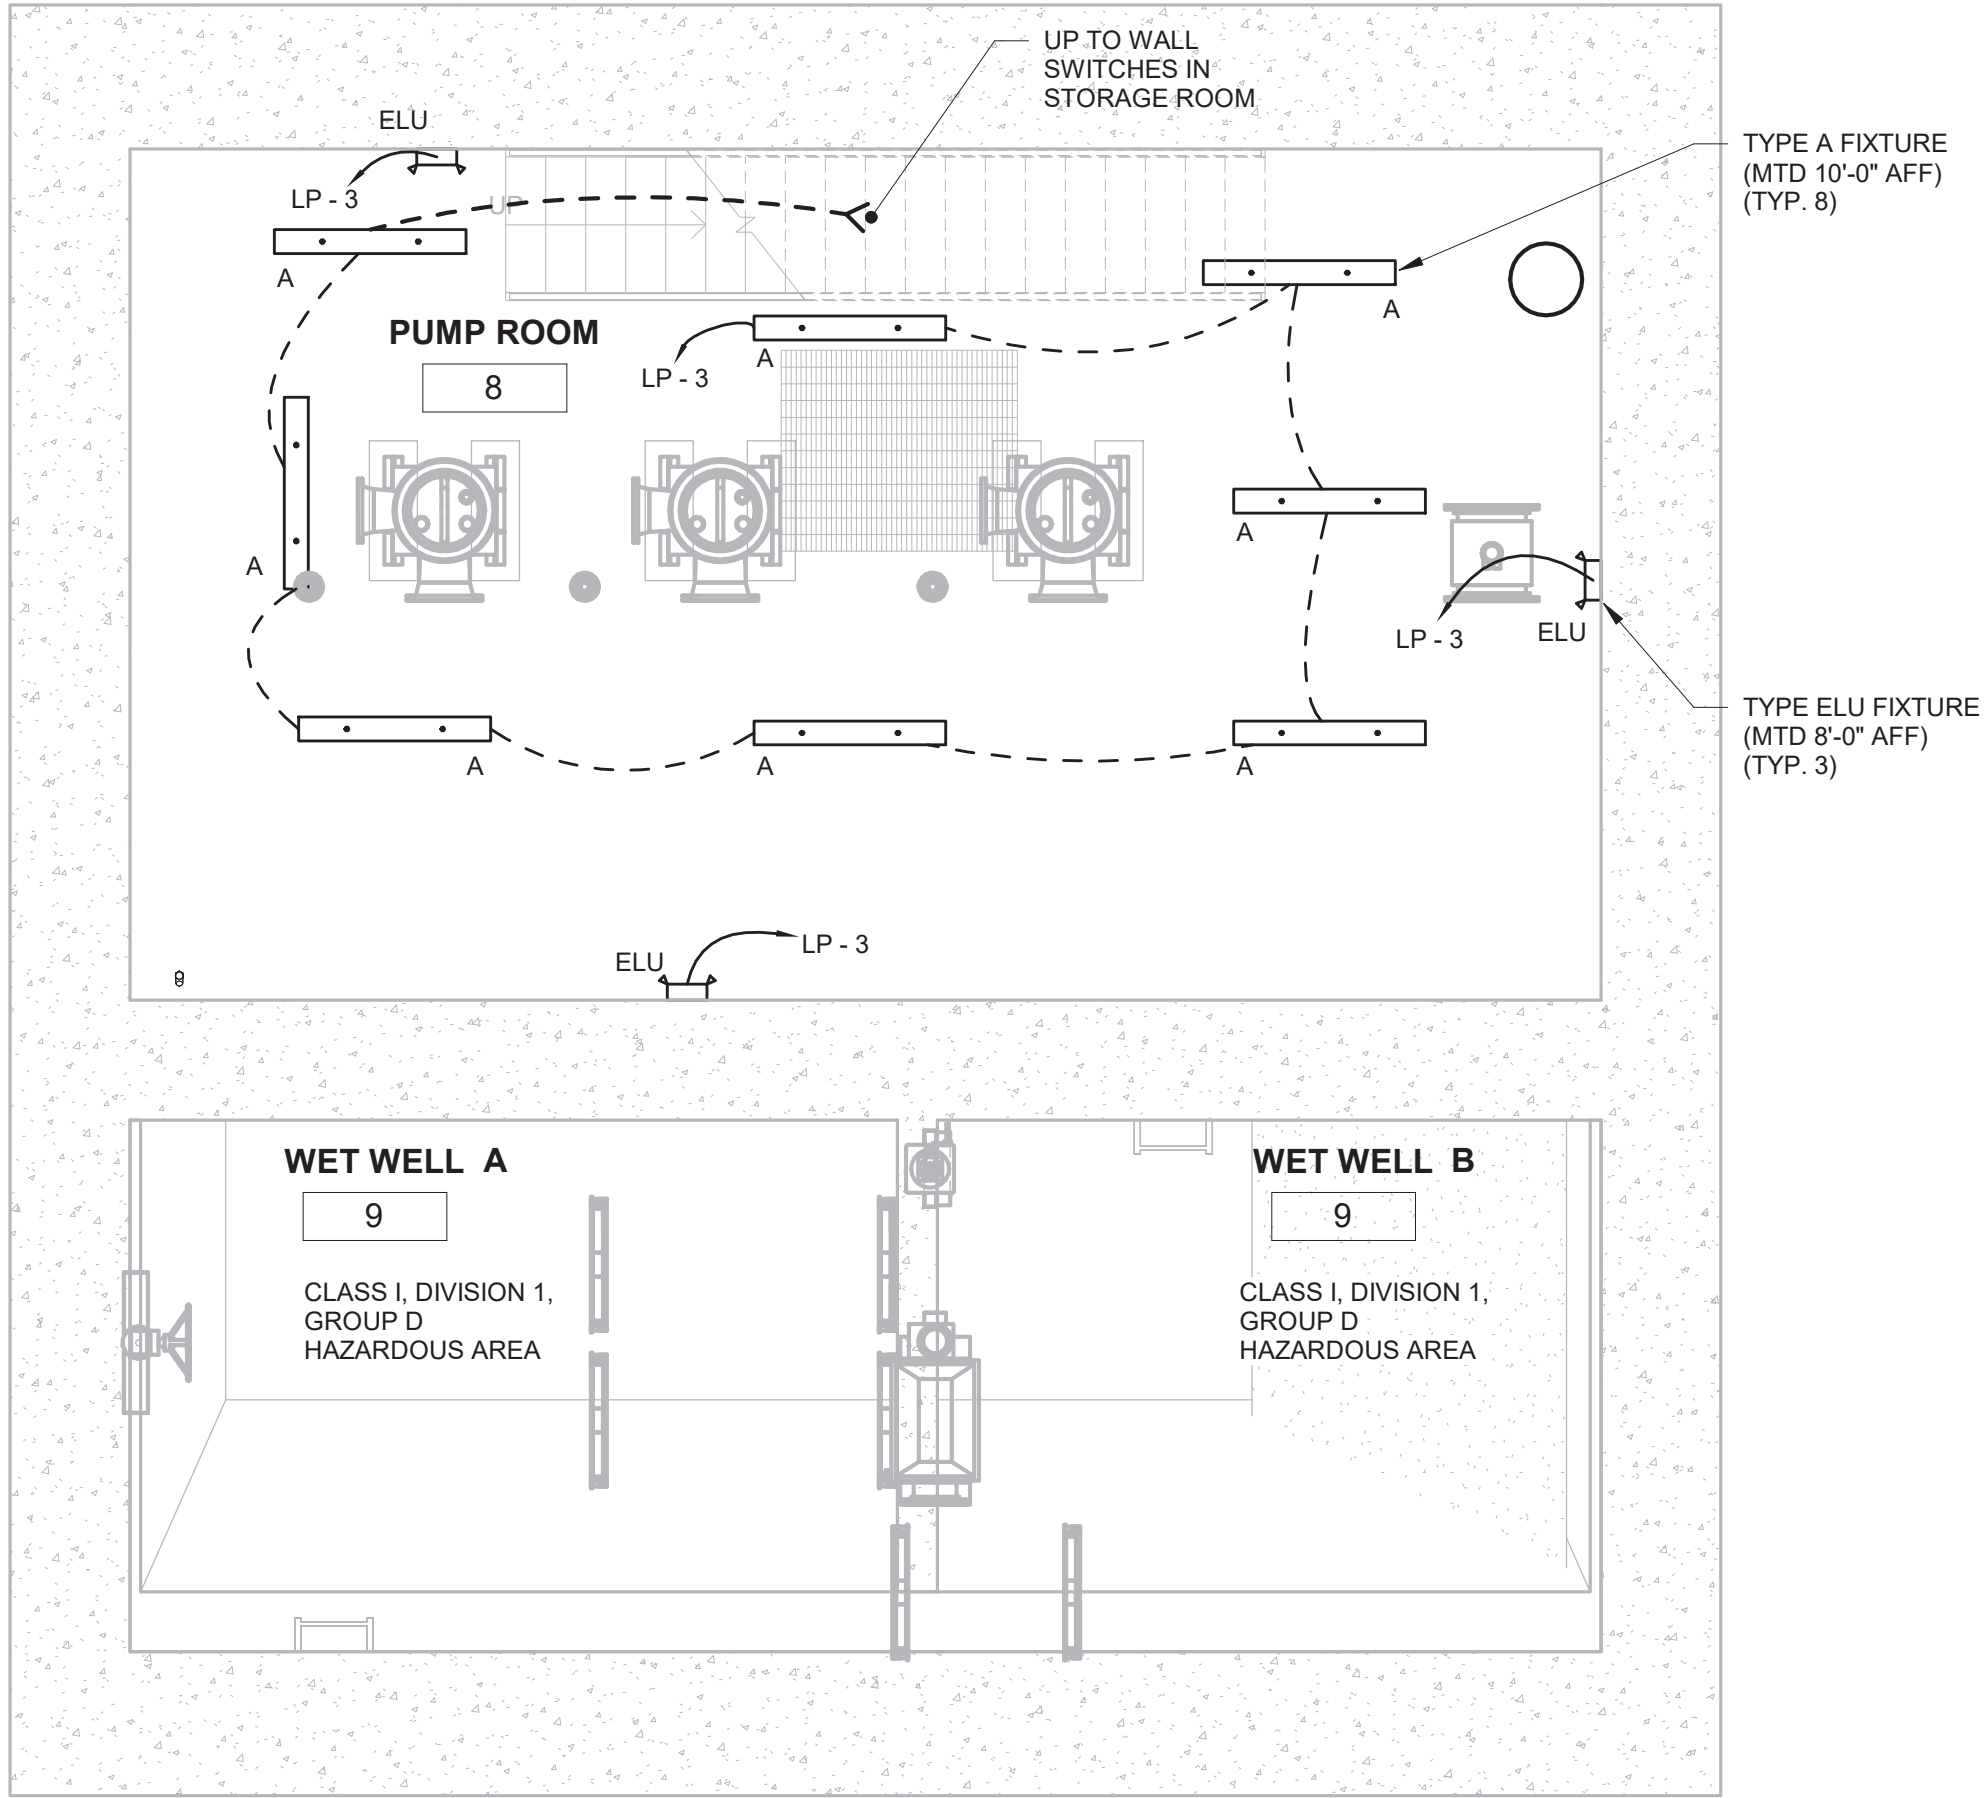


LOWER LEVEL LIGHTING PLAN

1/4" = 1'-0"

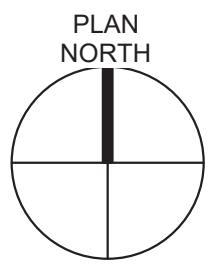


KEYED NOTES:

- 1 PROVIDE TWO WALL SWITCHES FOR STEP DIMMING CONTROL OF THE CONNECTED LIGHTING FIXTURES. PROVIDE ENGRAVED NAMEPLATES AT EACH SWITCH INDICATING THE ROOM CONTROLLED AND "HIGH" OR "LOW" ACCORDINGLY.

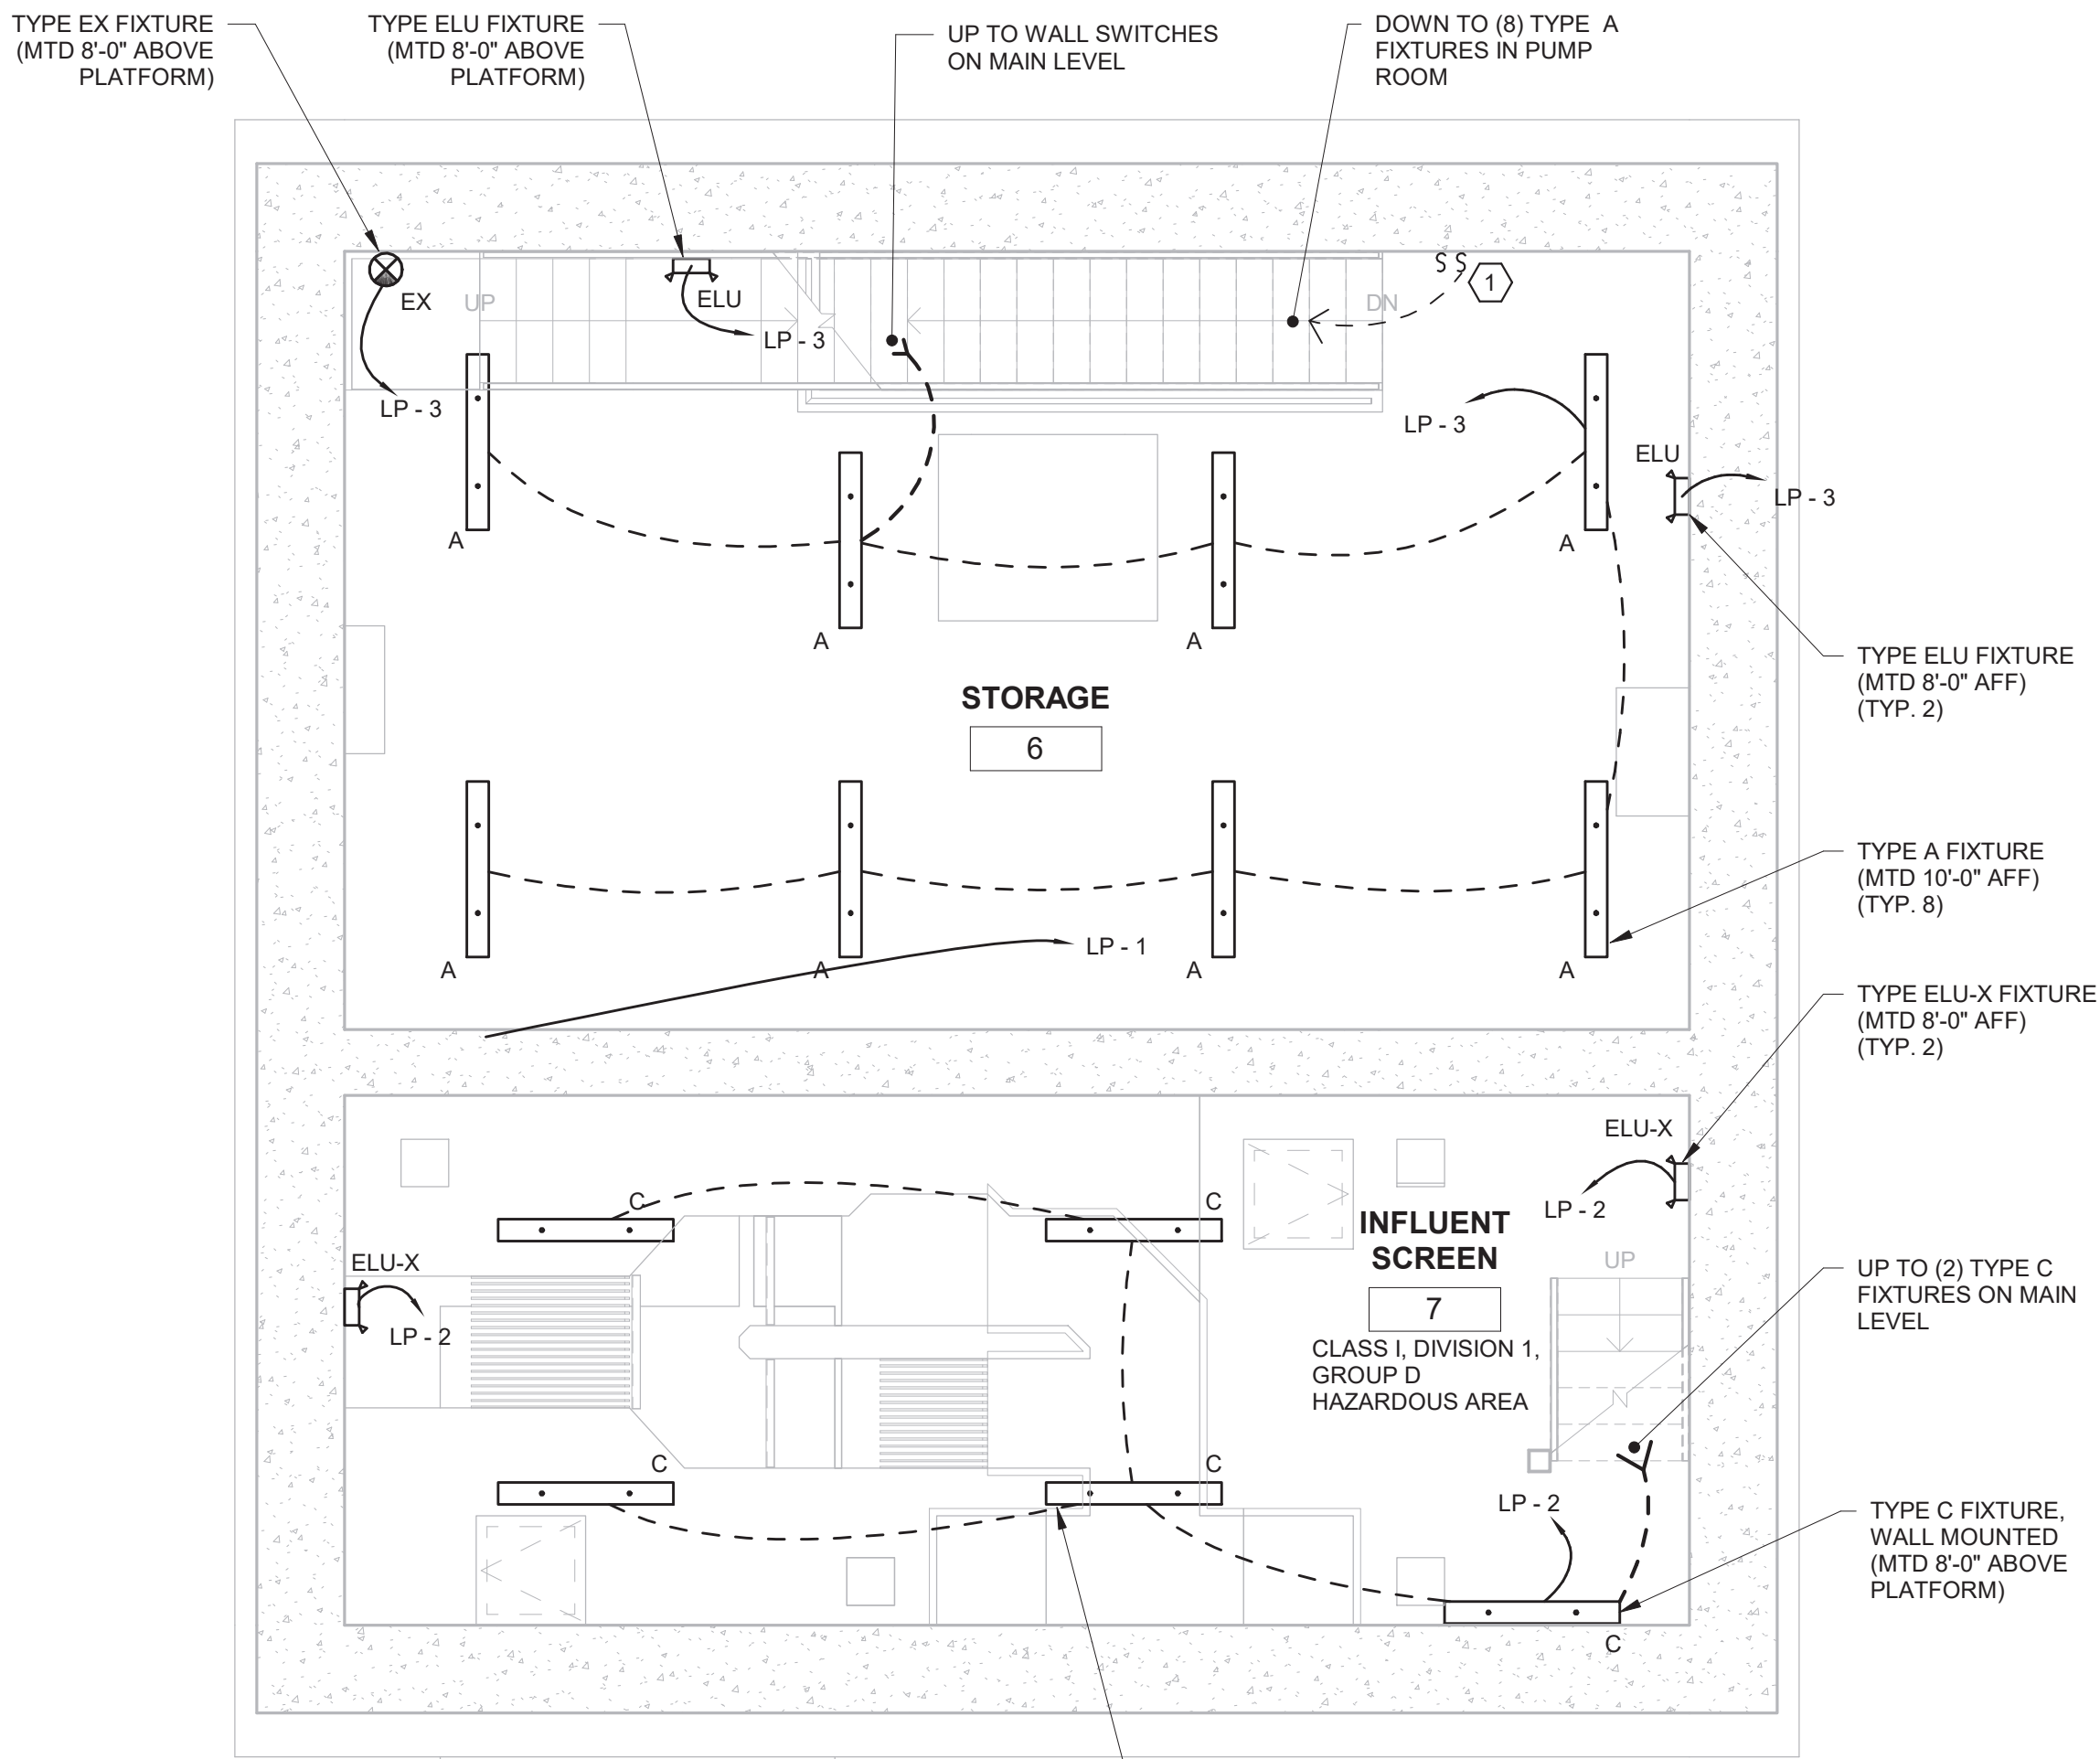

MIDDLE LEVEL LIGHTING PLAN

1/4" = 1'-0"

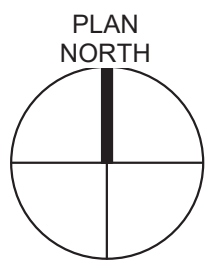

2021-07-15

IN ACCORDANCE WITH TITLE VIII, ARTICLE 145, SECTION 7209 (2) OF THE NEW YORK STATE EDUCATION LAW, IT IS A VIOLATION OF LAW FOR ANY PERSON UNLESS ACTING UNDER THE DIRECTION OF A LICENSED ENGINEER TO ALTER THIS DOCUMENT.

IN CHARGE OF Eric Miles

CHECKED BY Jim Crosier


MADE BY Joseph LaGoy




O'BRIEN & GERE ENGINEERS, INC.

50 MAIN ST., 10TH FLOOR SUITE 1000,
WHITE PLAINS, NEW YORK 10606

REVISION NUMBER	DATE	MADE BY	APP'D BY	REVISION
RECORD DRAWING CERTIFICATION				
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CONTRACTOR		PROJECT COORDINATOR		
NAME	SIGNATURE	NAME	SIGNATURE	DATE
TITLE	DATE	TITLE	DATE	DATE
WESTCHESTER COUNTY, NEW YORK DEPARTMENT OF PUBLIC WORKS AND TRANSPORTATION DIVISION OF ENGINEERING				CONTRACT NUMBER SHEET NUMBER E-106
CROTONVILLE PUMPING STATION REHABILITATION				SHEET NO. 43 OF 60
OSSINING, NEW YORK LIGHTING PLANS				SCALE: DATE: 12/21/2018 DPW FILE NO. 208-03-E-67-0 REV. NO. 0

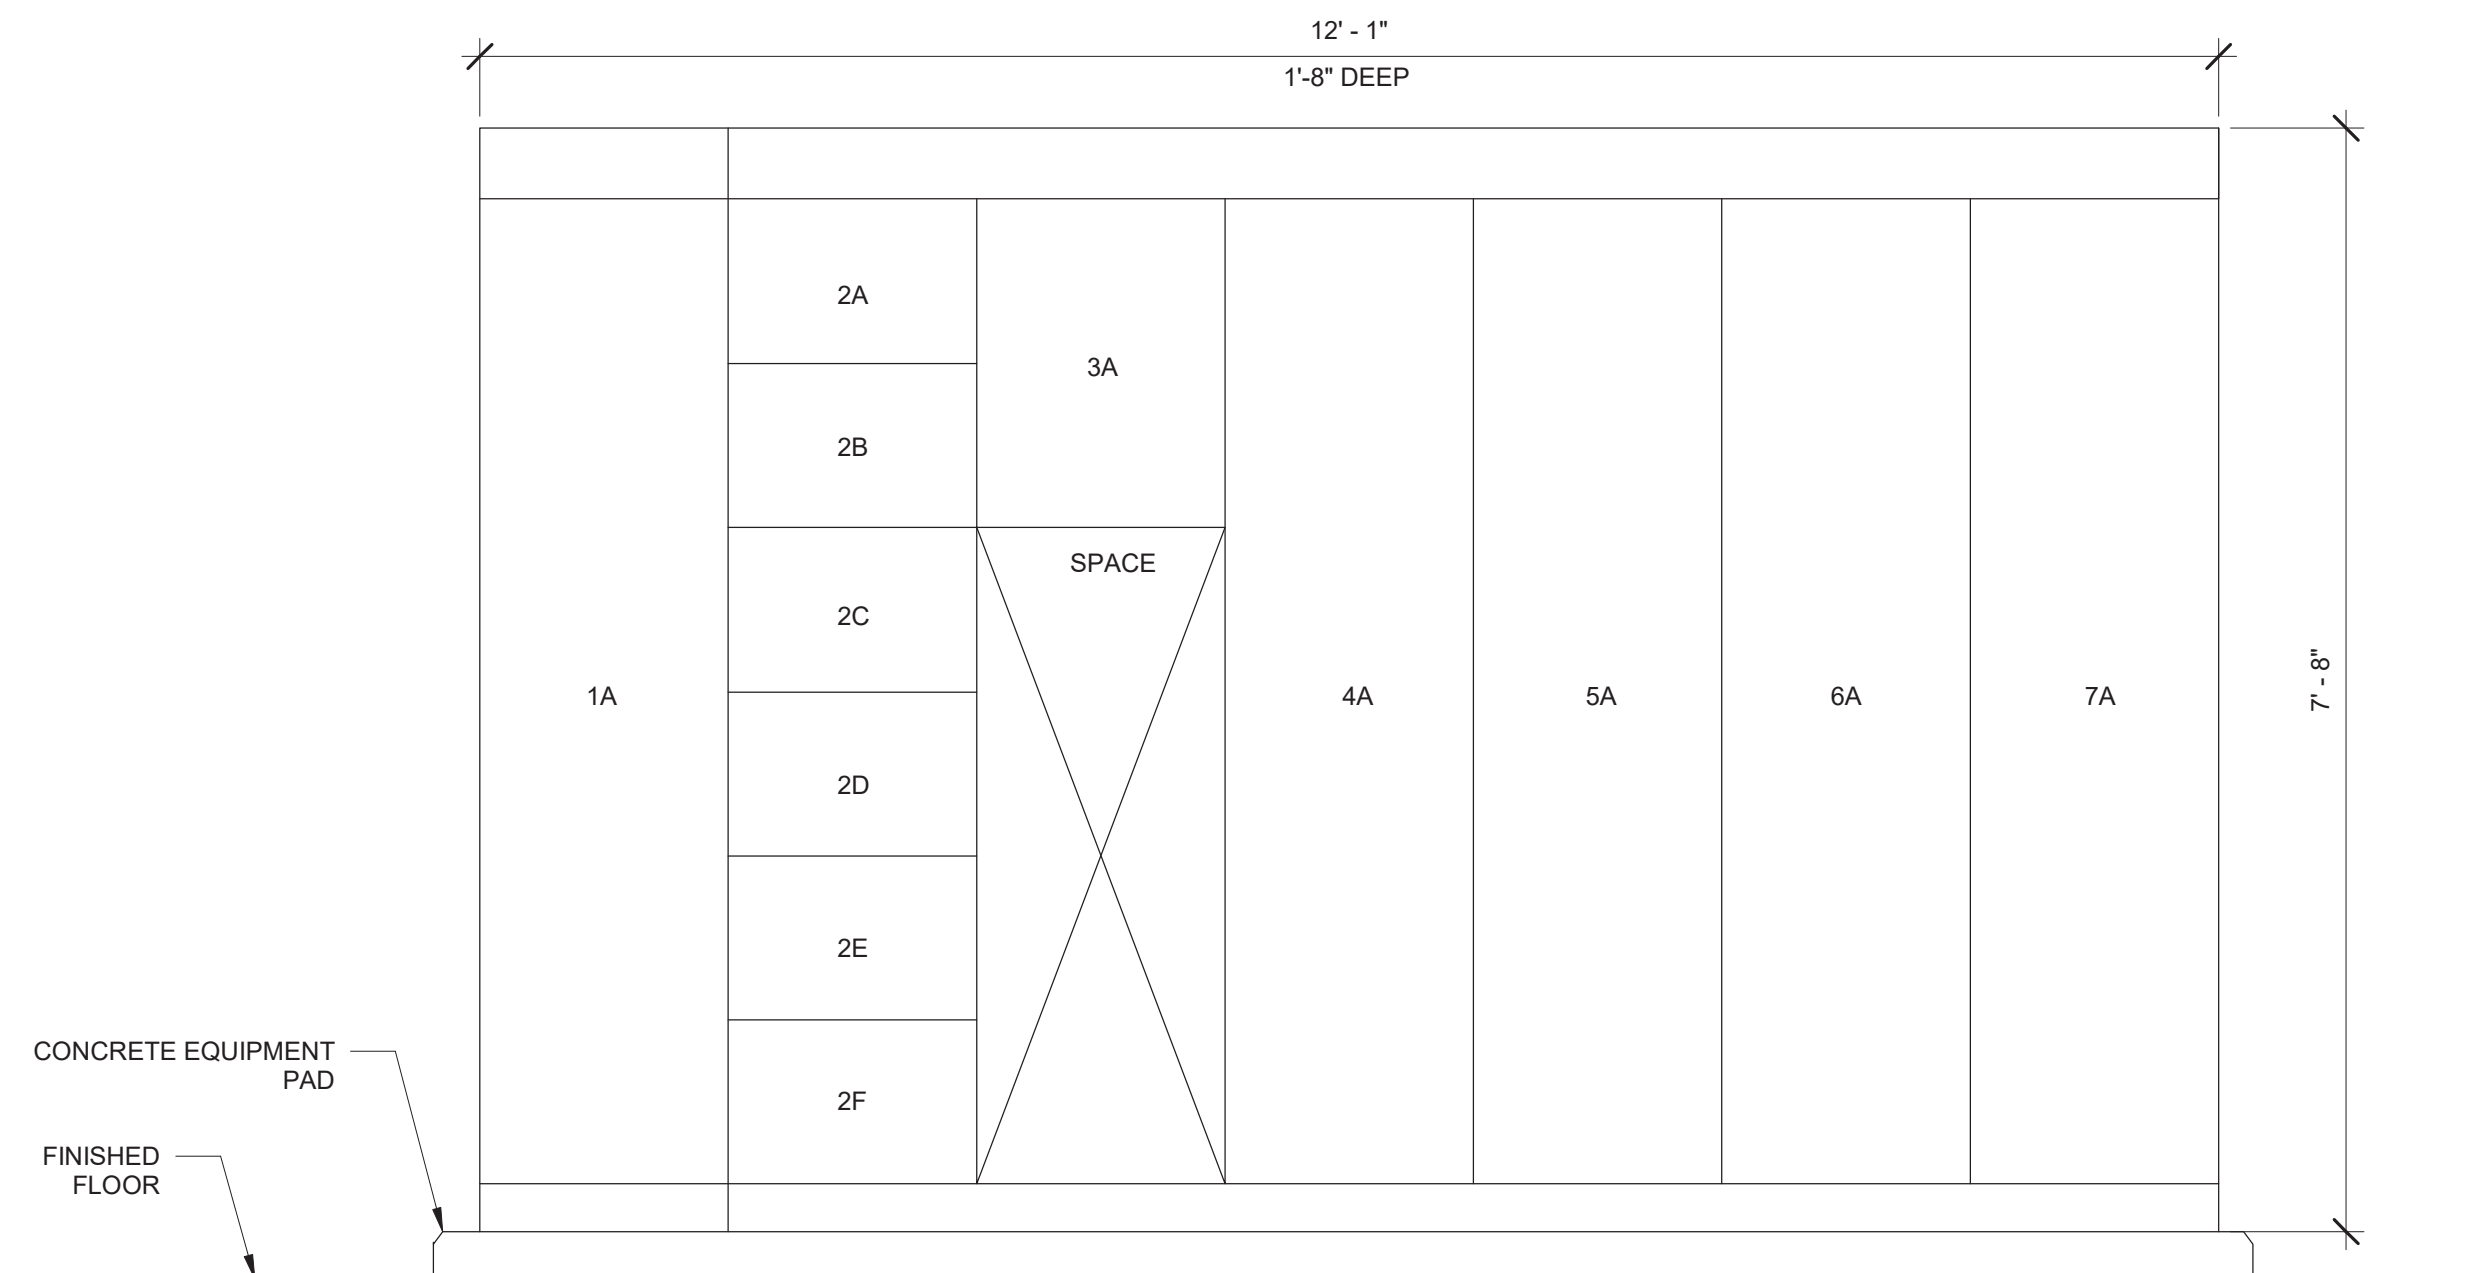

MCC ELEVATION
NOT TO SCALE

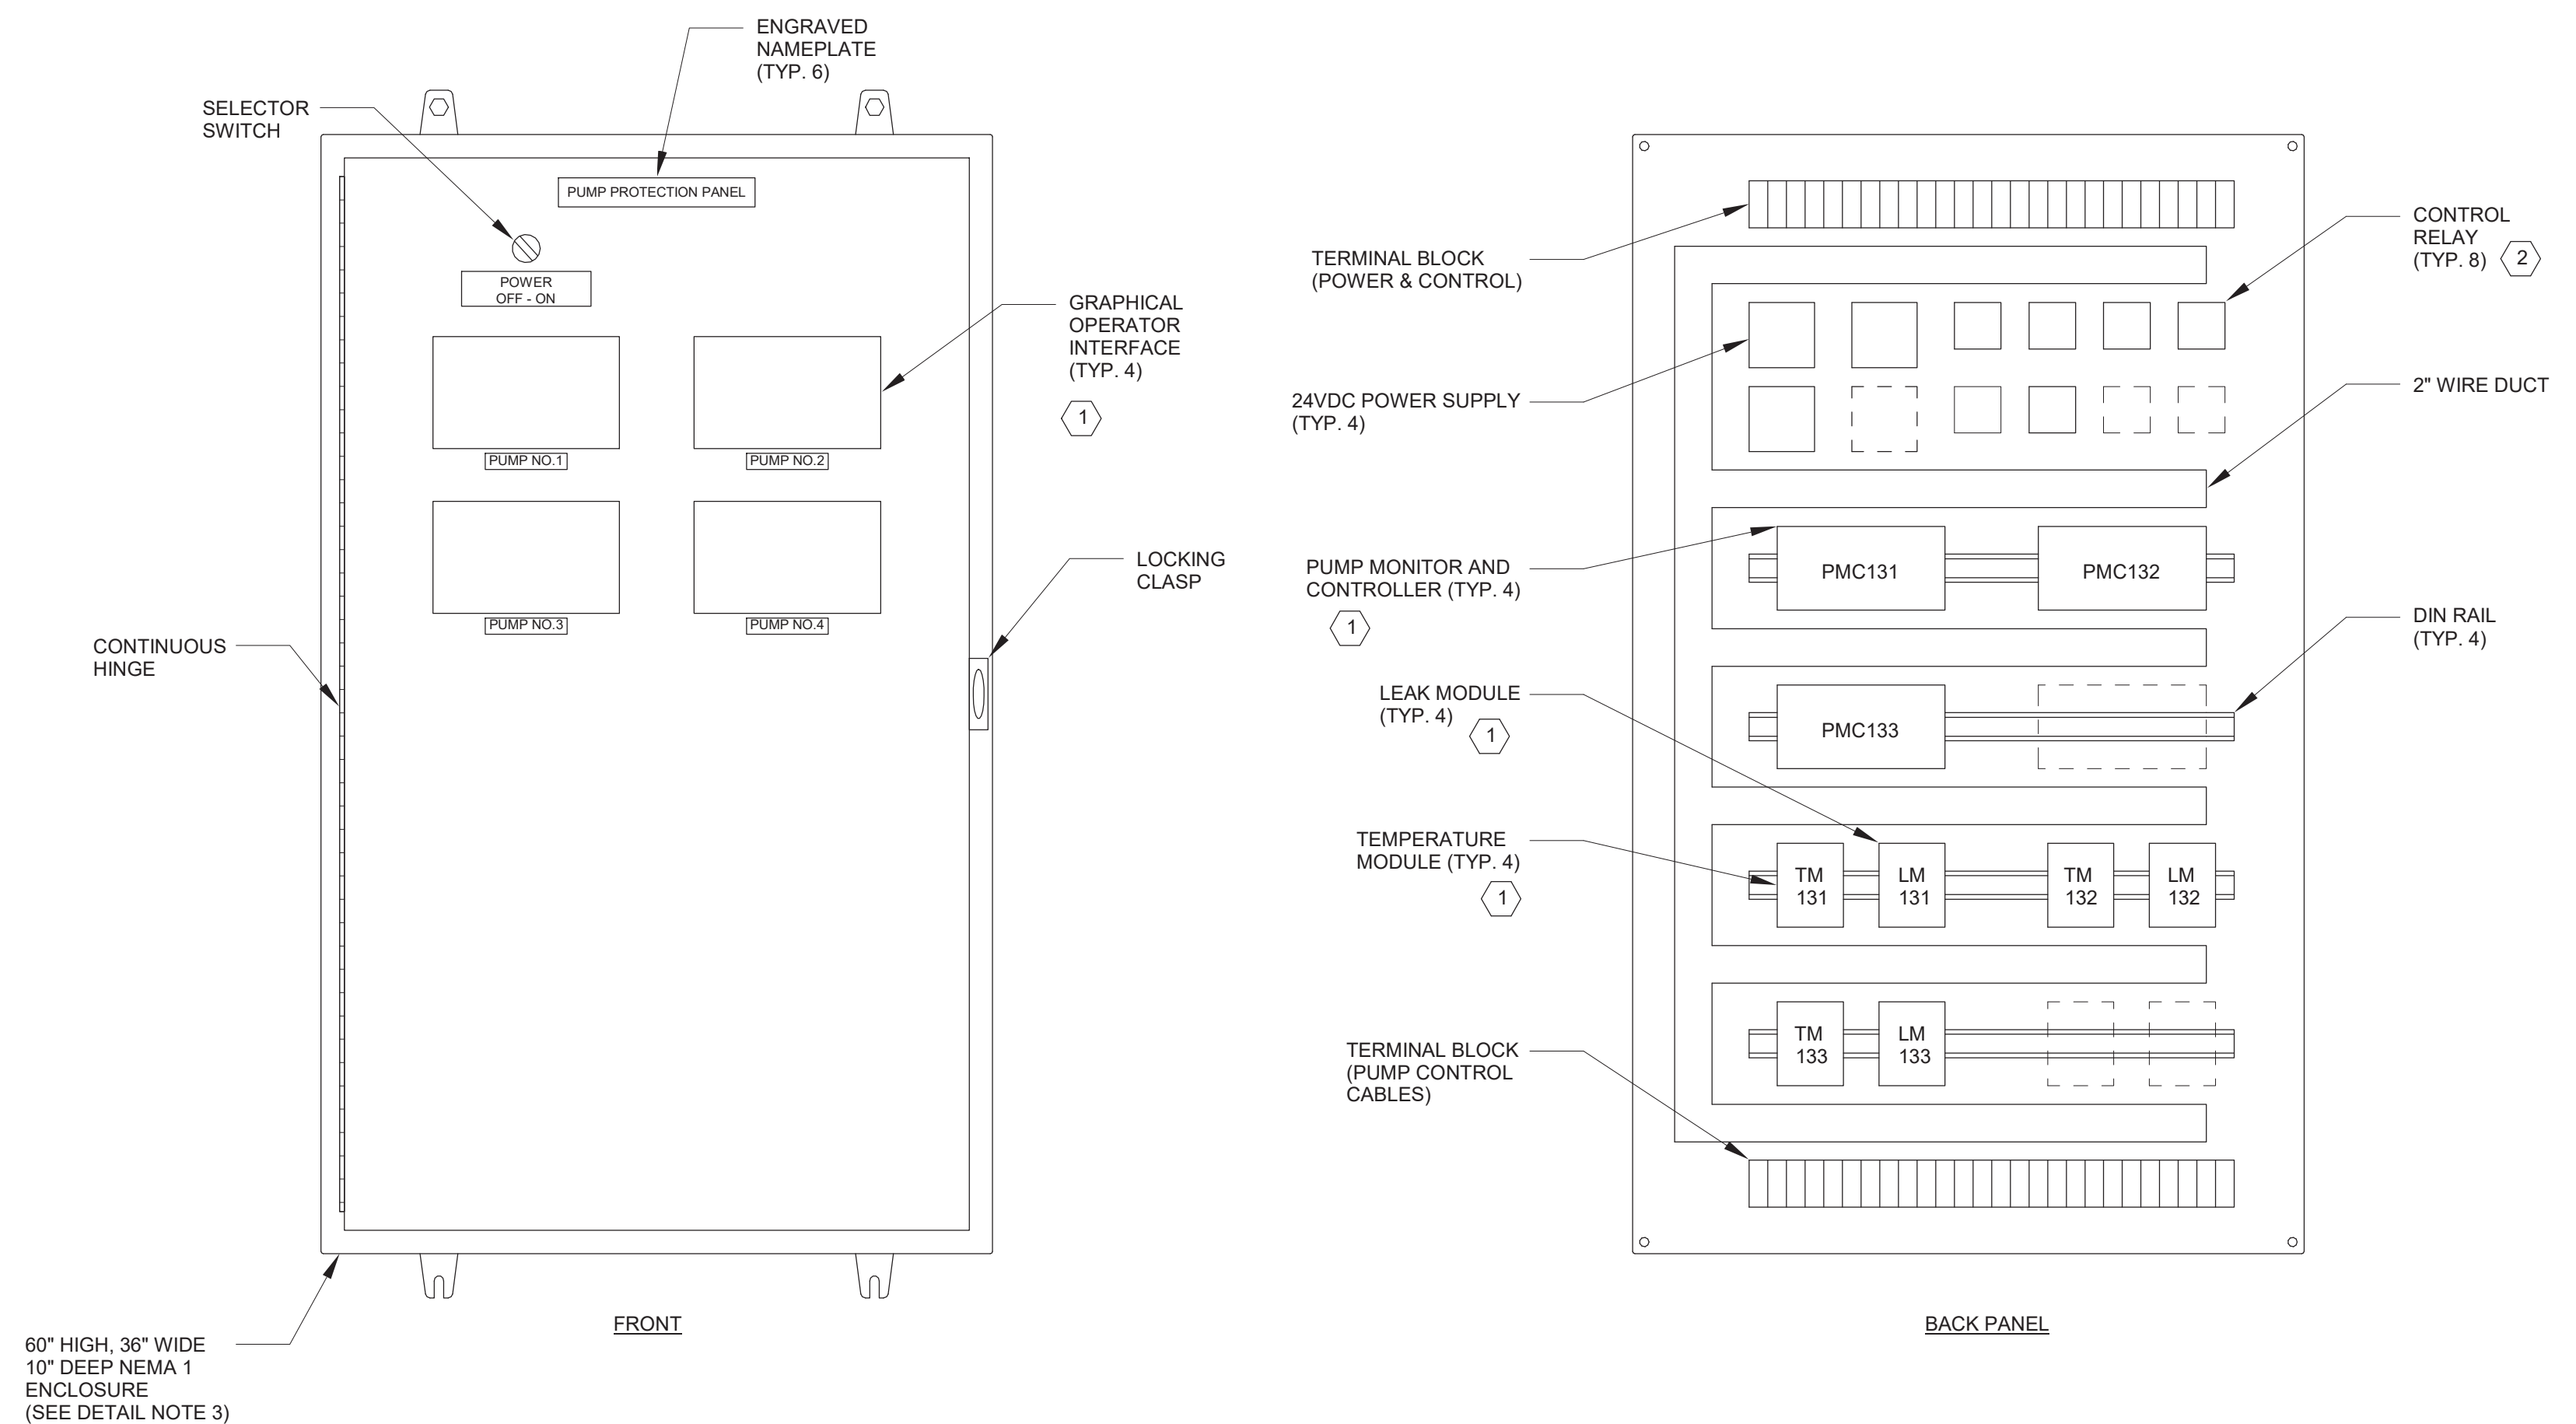


DETAIL NOTES:

1. DASHED LINES INDICATE FUTURE DEVICES BY OTHERS. PROVIDE SPACE ONLY.
2. EACH TERMINAL BLOCK SHALL BE PROVIDED WITH SPARES FOR FUTURE PUMP NO. 4. (QUANTITIES EQUAL TO INSTALLED PUMPS).
3. ENCLOSURE DIMENSIONS SHOWN SHALL BE MINIMUM. PROVIDE LARGER ENCLOSURE IF NECESSARY TO HOUSE THE REQUIRED COMPONENTS AS ACTUALLY FURNISHED WITH RESPECT TO COMPONENT DIMENSIONS, COMPONENT MANUFACTURERS RECOMMENDED CLEARANCES, AND MAINTENANCE.

KEYED NOTES:


- 1 FURNISHED WITH PUMP.
- 2 CONTROL RELAYS: CR131H, CR131I, CR132H, CR132I, CR133H, CR133I.

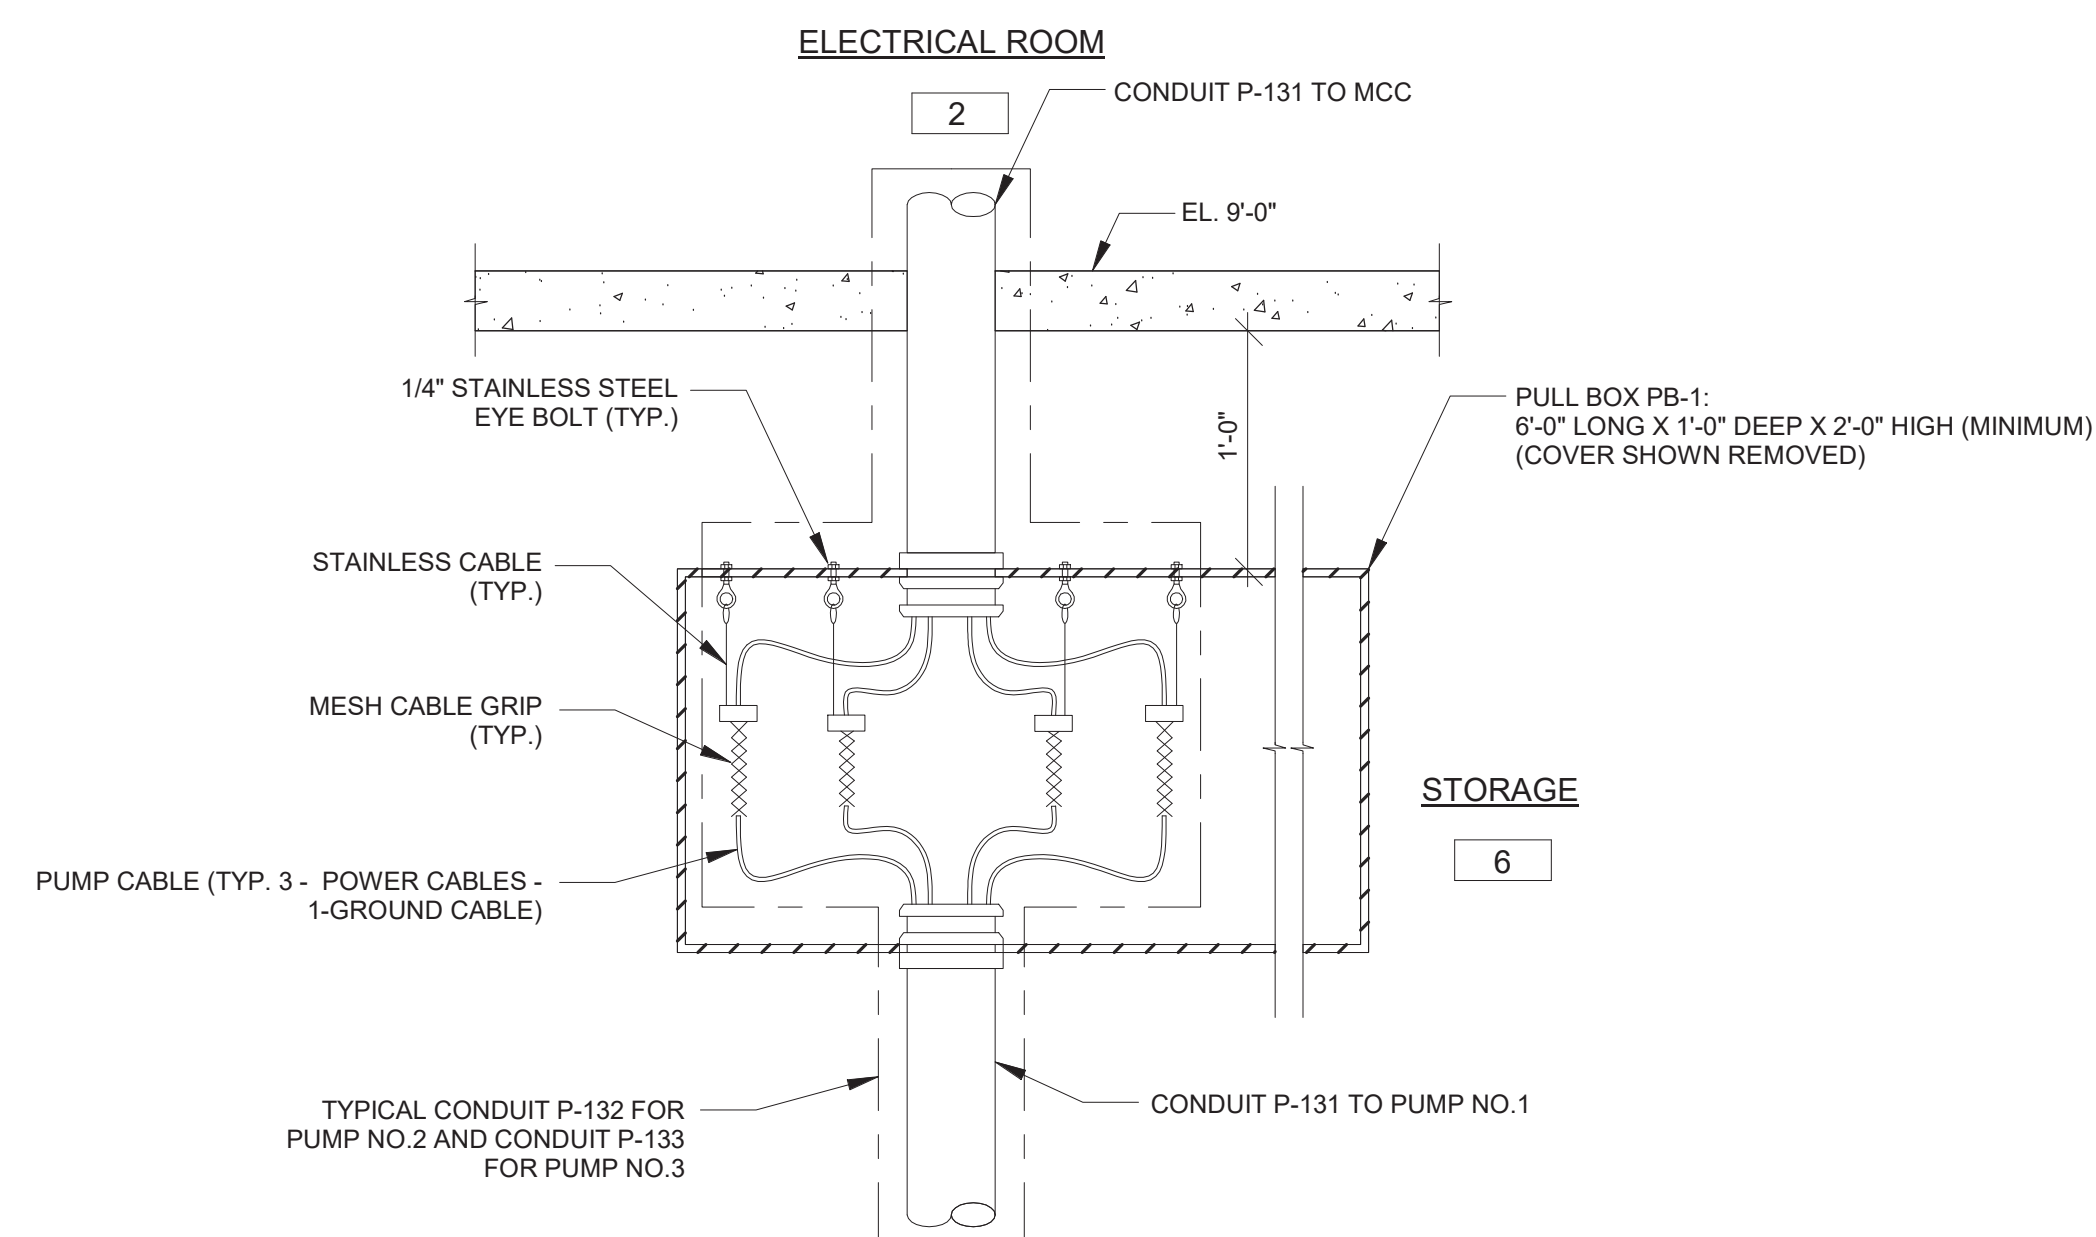


DETAIL NOTES:


1. DETAIL SHALL BE SIMILAR FOR PULL BOX PB-2 SERVING THE PUMP PROTECTION PANEL WITH CONDUITS CC-131A CC-132A AND CC-133A. (PUMP NO.1, 2, AND 3 CONTROL CABLES RESPECTIVELY)
2. PULL BOX PB-2 SHALL BE 3'-0" LONG X 1'-0" DEEP X 2'-0" HIGH (MINIMUM).

PULL BOX PB-1 DETAIL

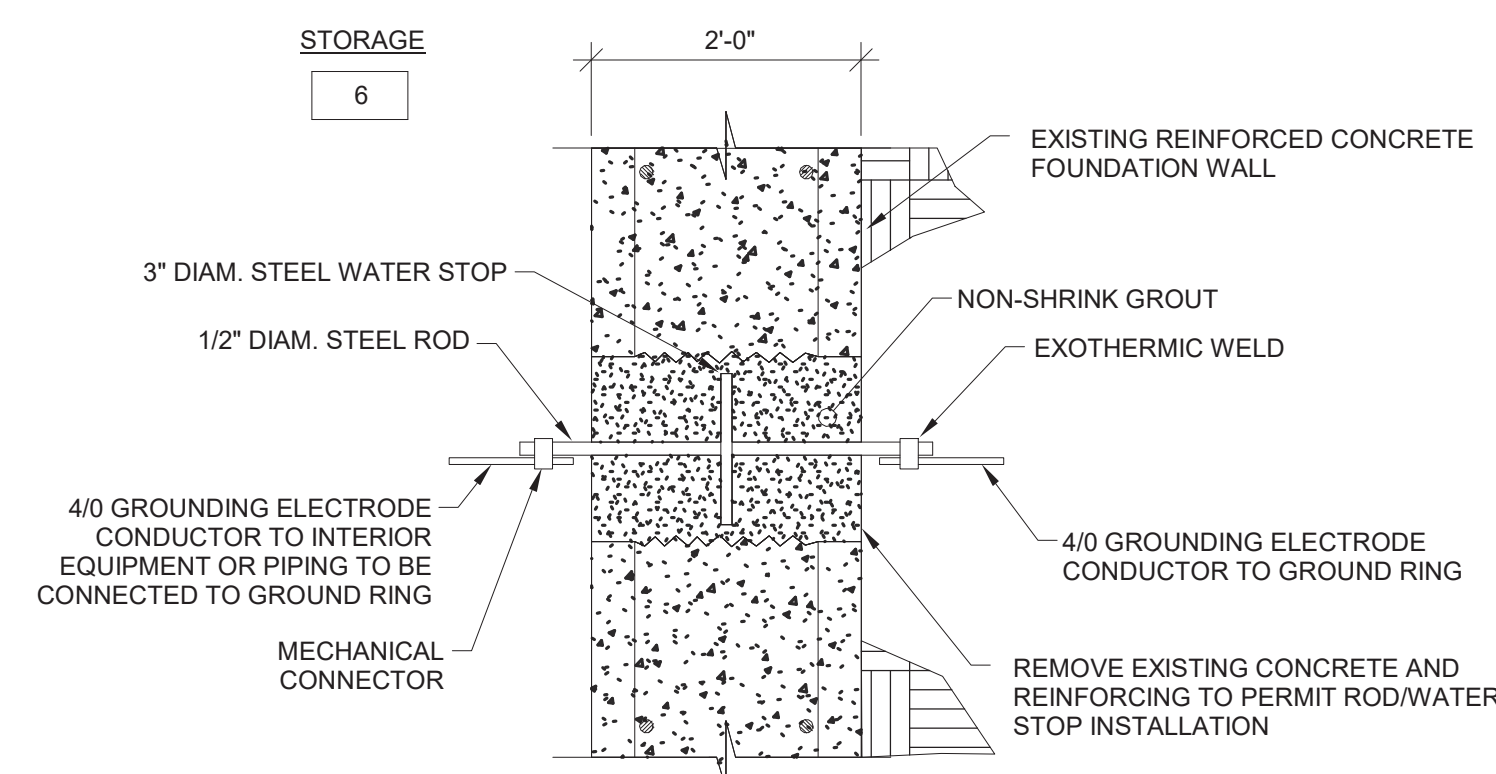

TYPICAL GROUNDING ELECTRODE CONDUCTOR FOUNDATION WALL PENETRATION DETAIL

	IN ACCORDANCE WITH TITLE VIII, ARTICLE 145, SECTION 7209 (2) OF THE NEW YORK STATE EDUCATION LAW, IT IS A VIOLATION OF LAW FOR ANY PERSON UNLESS ACTING UNDER THE DIRECTION OF A LICENSED ENGINEER TO ALTER THIS DOCUMENT.	
	O'BRIEN & GERE ENGINEERS, INC. 50 MAIN ST., 10TH FLOOR SUITE 1000, WHITE PLAINS, NEW YORK 10606	
2021-07-15	IN CHARGE OF <u>Eric Miles</u> CHECKED BY <u>Jim Crosier</u> MADE BY <u>Joseph LaGoy</u>	
REVISION NUMBER	DATE	MADE BY APP'D BY REVISION
RECORD DRAWING CERTIFICATION		
<input type="checkbox"/> AS BUILT - CHANGES AS NOTED <input type="checkbox"/> AS BUILT - NO CHANGES		
CONTRACTOR		PROJECT COORDINATOR
NAME _____ SIGNATURE _____ TITLE _____ DATE _____		NAME _____ SIGNATURE _____ TITLE _____ DATE _____
WESTCHESTER COUNTY, NEW YORK DEPARTMENT OF PUBLIC WORKS AND TRANSPORTATION DIVISION OF ENGINEERING		CONTRACT NUMBER SHEET NUMBER E-501
CROTONVILLE PUMPING STATION REHABILITATION		SHEET NO. 44 OF 60 SCALE: DATE: 12/21/2018 DPW FILE NO. 208-03-E-68-0
OSSISING, NEW YORK ELECTRICAL DETAILS		REV. NO. 0

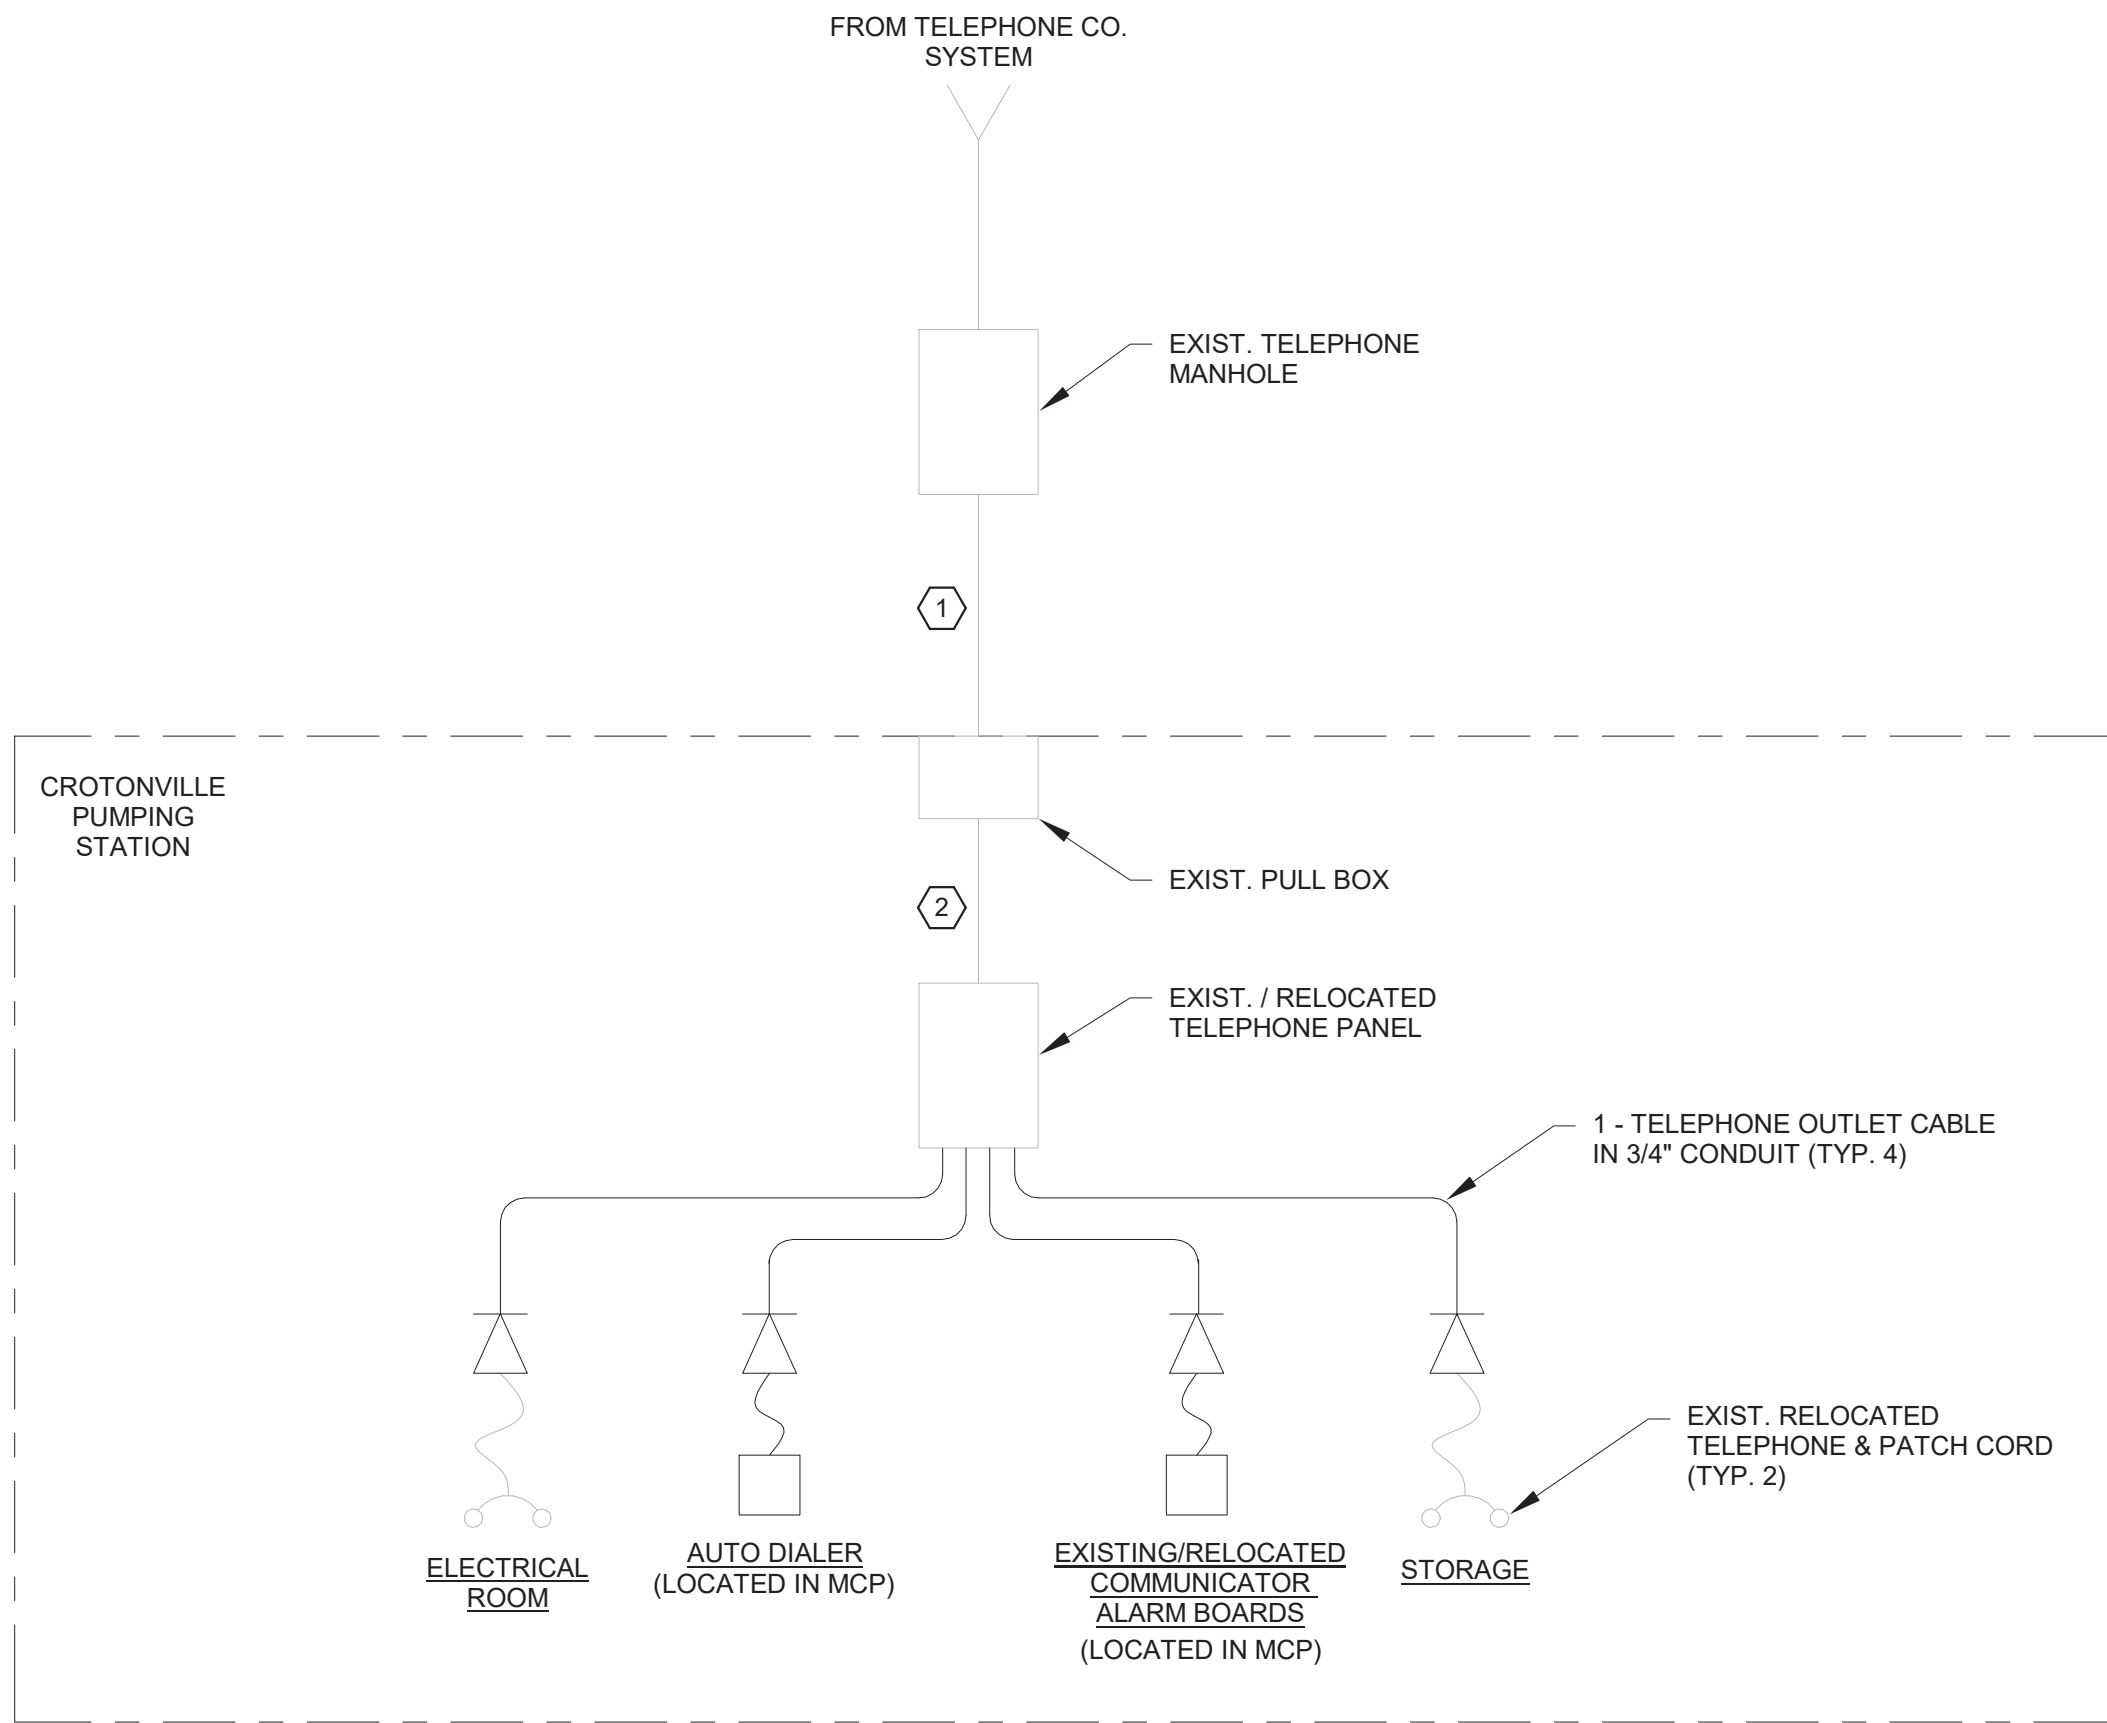

KEYED NOTES:


- 1 EXISTING CONDUIT WITH EXISTING TELEPHONE SERVICE CABLE.
- 2 DISCONNECT EXISTING TELEPHONE SERVICE CABLE FROM EXISTING TELEPHONE PANEL IN ITS PRESENT LOCATION. REINSTALL EXISTING TELEPHONE SERVICE CABLE IN NEW 2" CONDUIT ROUTED TO EXISTING / RELOCATED TELEPHONE PANEL.

DETAIL NOTES:

COORDINATE WITH THE TELEPHONE SERVICE PROVIDER AS NECESSARY TO FACILITATE RELOCATION OF TELEPHONE CO. EQUIPMENT AND WIRING. COMPLY WITH ALL APPLICABLE SERVICE PROVIDER STANDARDS. PROVIDE ANY ADDITIONAL MATERIALS OR LABOR REQUIRED BY THE SERVICE PROVIDER.

TELEPHONE SYSTEM SCHEMATIC

NOT TO SCALE

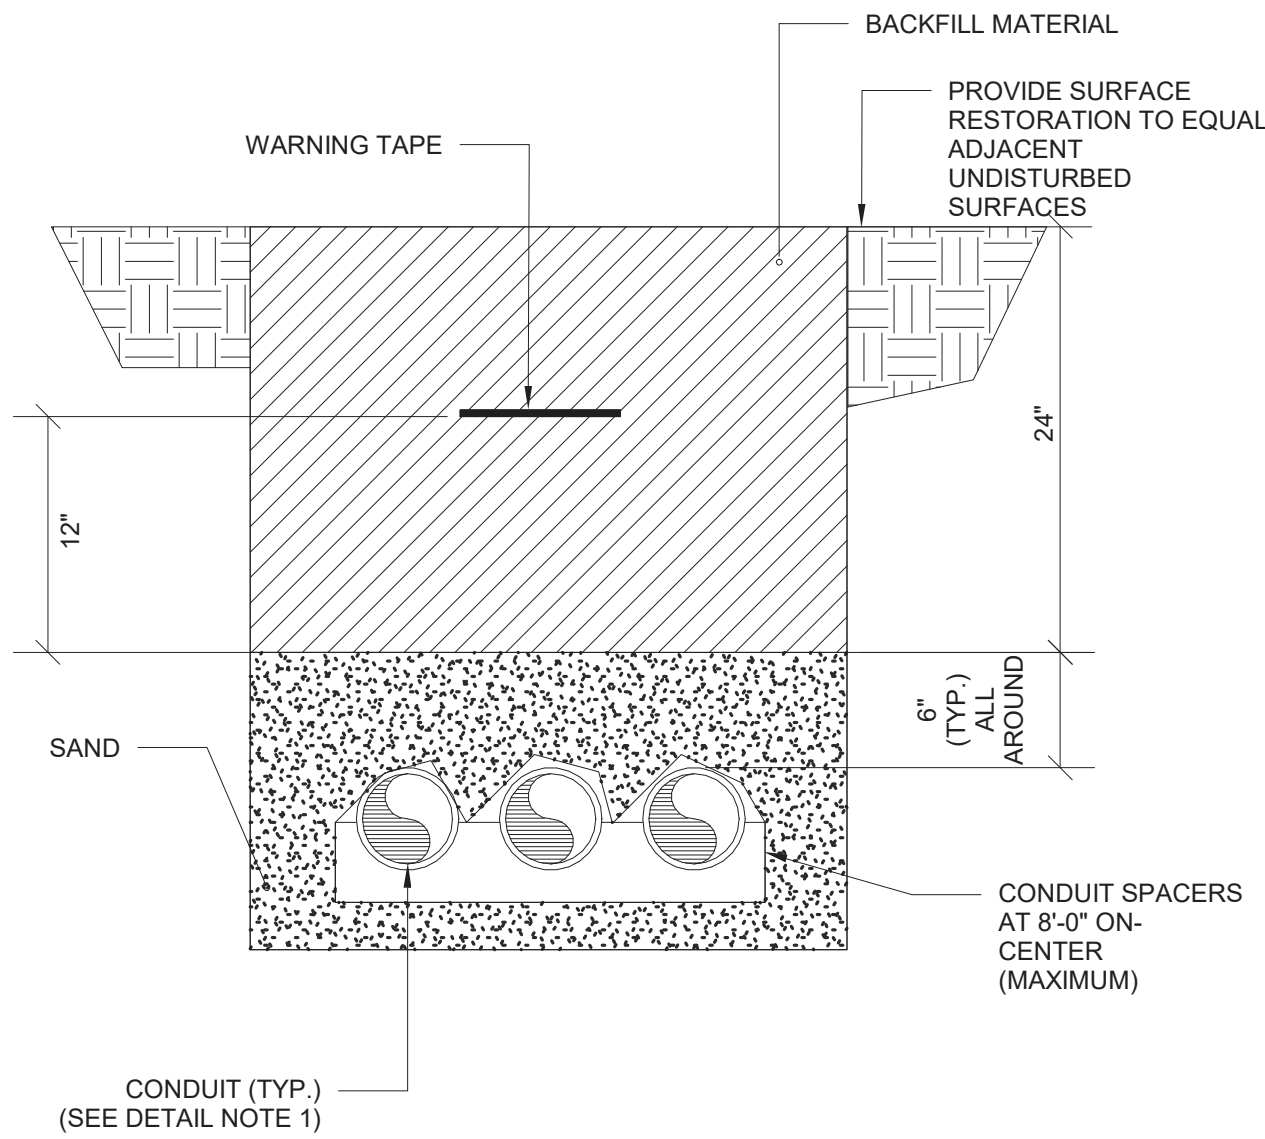



DETAIL NOTE:

1. REFER TO SITE PLANS, NOTES, AND CONDUIT SCHEDULES FOR CONDUIT GROUPINGS AND CONDUIT SIZES.

TYPICAL DIRECT BURIED CONDUIT DETAIL

NOT TO SCALE

 <p>2021-07-15</p>	<p>IN ACCORDANCE WITH TITLE VIII, ARTICLE 145, SECTION 7209 (2) OF THE NEW YORK STATE EDUCATION LAW, IT IS A VIOLATION OF LAW FOR ANY PERSON UNLESS ACTING UNDER THE DIRECTION OF A LICENSED ENGINEER TO ALTER THIS DOCUMENT.</p> <p>IN CHARGE OF <u>Eric Miles</u></p> <p>CHECKED BY <u>Jim Crosier</u></p> <p>MADE BY <u>Joseph LaGoy</u></p>	 <p>O'BRIEN & GERE ENGINEERS, INC. 50 MAIN ST., 10TH FLOOR SUITE 1000, WHITE PLAINS, NEW YORK 10606</p>																														
<table><tr><td>REVISION NUMBER</td><td>DATE</td><td>MADE BY</td><td>APP'D BY</td><td>REVISION</td></tr><tr><td> </td><td> </td><td> </td><td> </td><td> </td></tr><tr><td> </td><td> </td><td> </td><td> </td><td> </td></tr><tr><td> </td><td> </td><td> </td><td> </td><td> </td></tr><tr><td> </td><td> </td><td> </td><td> </td><td> </td></tr><tr><td> </td><td> </td><td> </td><td> </td><td> </td></tr></table>			REVISION NUMBER	DATE	MADE BY	APP'D BY	REVISION																									
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CONTRACTOR		PROJECT COORDINATOR																														
NAME _____	NAME _____																															
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DATE _____	DATE _____																															
WESTCHESTER COUNTY, NEW YORK DEPARTMENT OF PUBLIC WORKS AND TRANSPORTATION DIVISION OF ENGINEERING		CONTRACT NUMBER SHEET NUMBER E-502																														
CROTONVILLE PUMPING STATION REHABILITATION		SHEET NO. 45 OF 60																														
OSSINING, NEW YORK ELECTRICAL DETAILS		SCALE: DATE: 12/21/2018 DPW FILE NO. 208-03-E-69-0 REV. NO. 0																														




- CROTONVILLE
PUMPING STATION




1. SEE ELECTRICAL DEMOLITION NOTES, SHEET E-101.

NOT TO SCALE

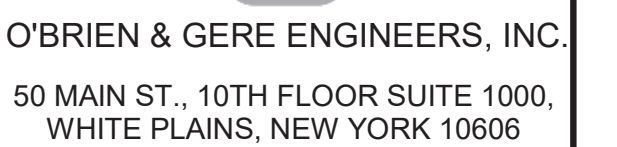

REVISION NUMBER	DATE	MADE BY	APPROVED BY	REVISION
RECORD DRAWING CERTIFICATION				
<input type="checkbox"/> AS BUILT - CHANGES AS NOTED <input type="checkbox"/> AS BUILT - NO CHANGES				
CONTRACTOR			PROJECT COORDINATOR	
NAME _____			NAME _____	
SIGNATURE _____			SIGNATURE _____	
TITLE _____ DATE _____			TITLE _____ DATE _____	
WESTCHESTER COUNTY, NEW YORK DEPARTMENT OF PUBLIC WORKS AND TRANSPORTATION DIVISION OF ENGINEERING			CONTRACT NUMBER	SHEET NUMBER E-601
CROTONVILLE PUMPING STATION REHABILITATION			SHEET NO. 46 OF 60 SCALE: DATE: 12/21/2018 DPW FILE NO.	
OSSINING, NEW YORK ONE-LINE DIAGRAMS			208-03-E-70-0	REV. NO.: 0

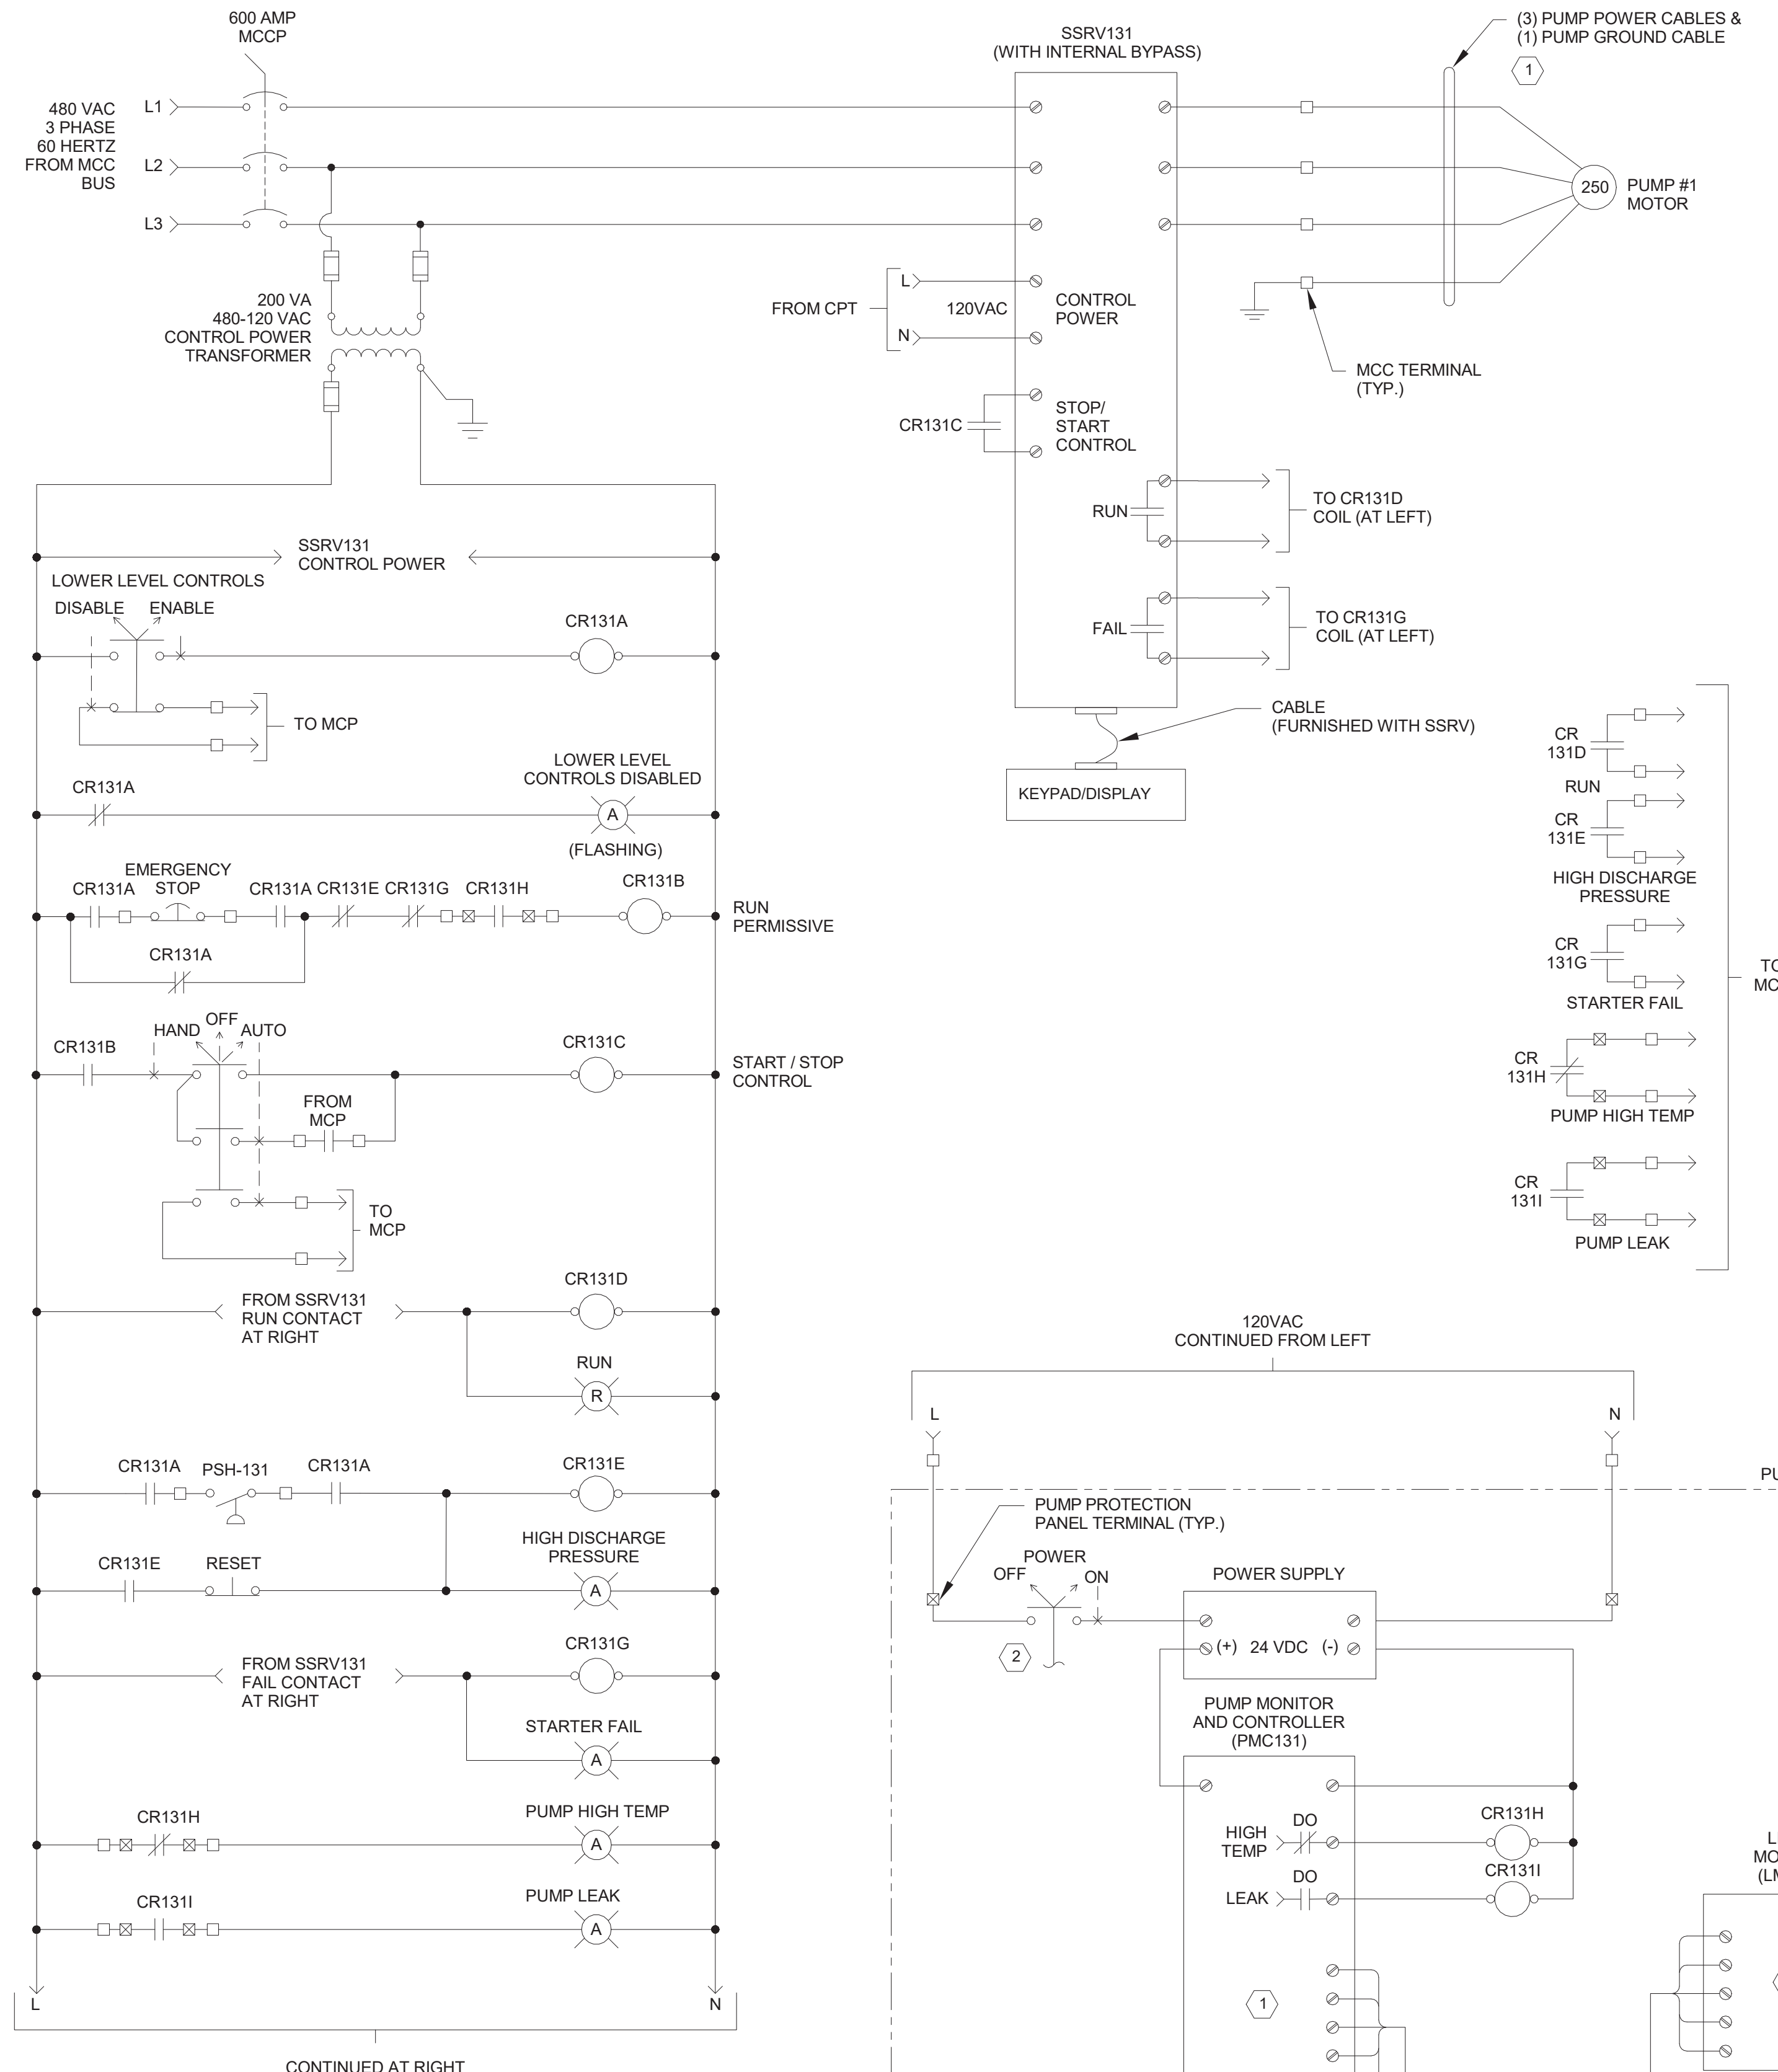

KEYED NOTES:

1 FURNISHED WITH PUMP.

2 PUMP PROTECTION PANEL POWER OFF-ON SELECTOR SWITCH SHALL BE 4 POLE. EACH POLE SHALL SIMULTANEOUSLY PROVIDE OFF-ON CONTROL OF INCOMING 120VAC POWER FROM PUMP NO.1, NO.2 AND NO.3 CONTROL CIRCUITS PLUS A SPARE POLE FOR FUTURE PUMP NO.4.

DETAIL NOTES:



1. DEVICE TAG NUMBERS SHOWN ARE FOR PUMP NO.1 USING LOOP NO. 131. DEVICE TAG NUMBERS FOR PUMP NO.2 SHALL USE LOOP NO. 132. DEVICE TAG NUMBERS FOR PUMP NO.3 SHALL USE LOOP NO.133. DEVICE TAG NUMBERS FOR PUMP NO.4 SHALL USE LOOP NO.134.

2. PUMP NO.4: PROVIDE MCC MOUNTED COMPONENTS ONLY.

TYPICAL: PUMP NO.2
PUMP NO.3
PUMP NO.4 (EXCEPT AS NOTED)


PUMP ELEMENTARY

NOT TO SCALE

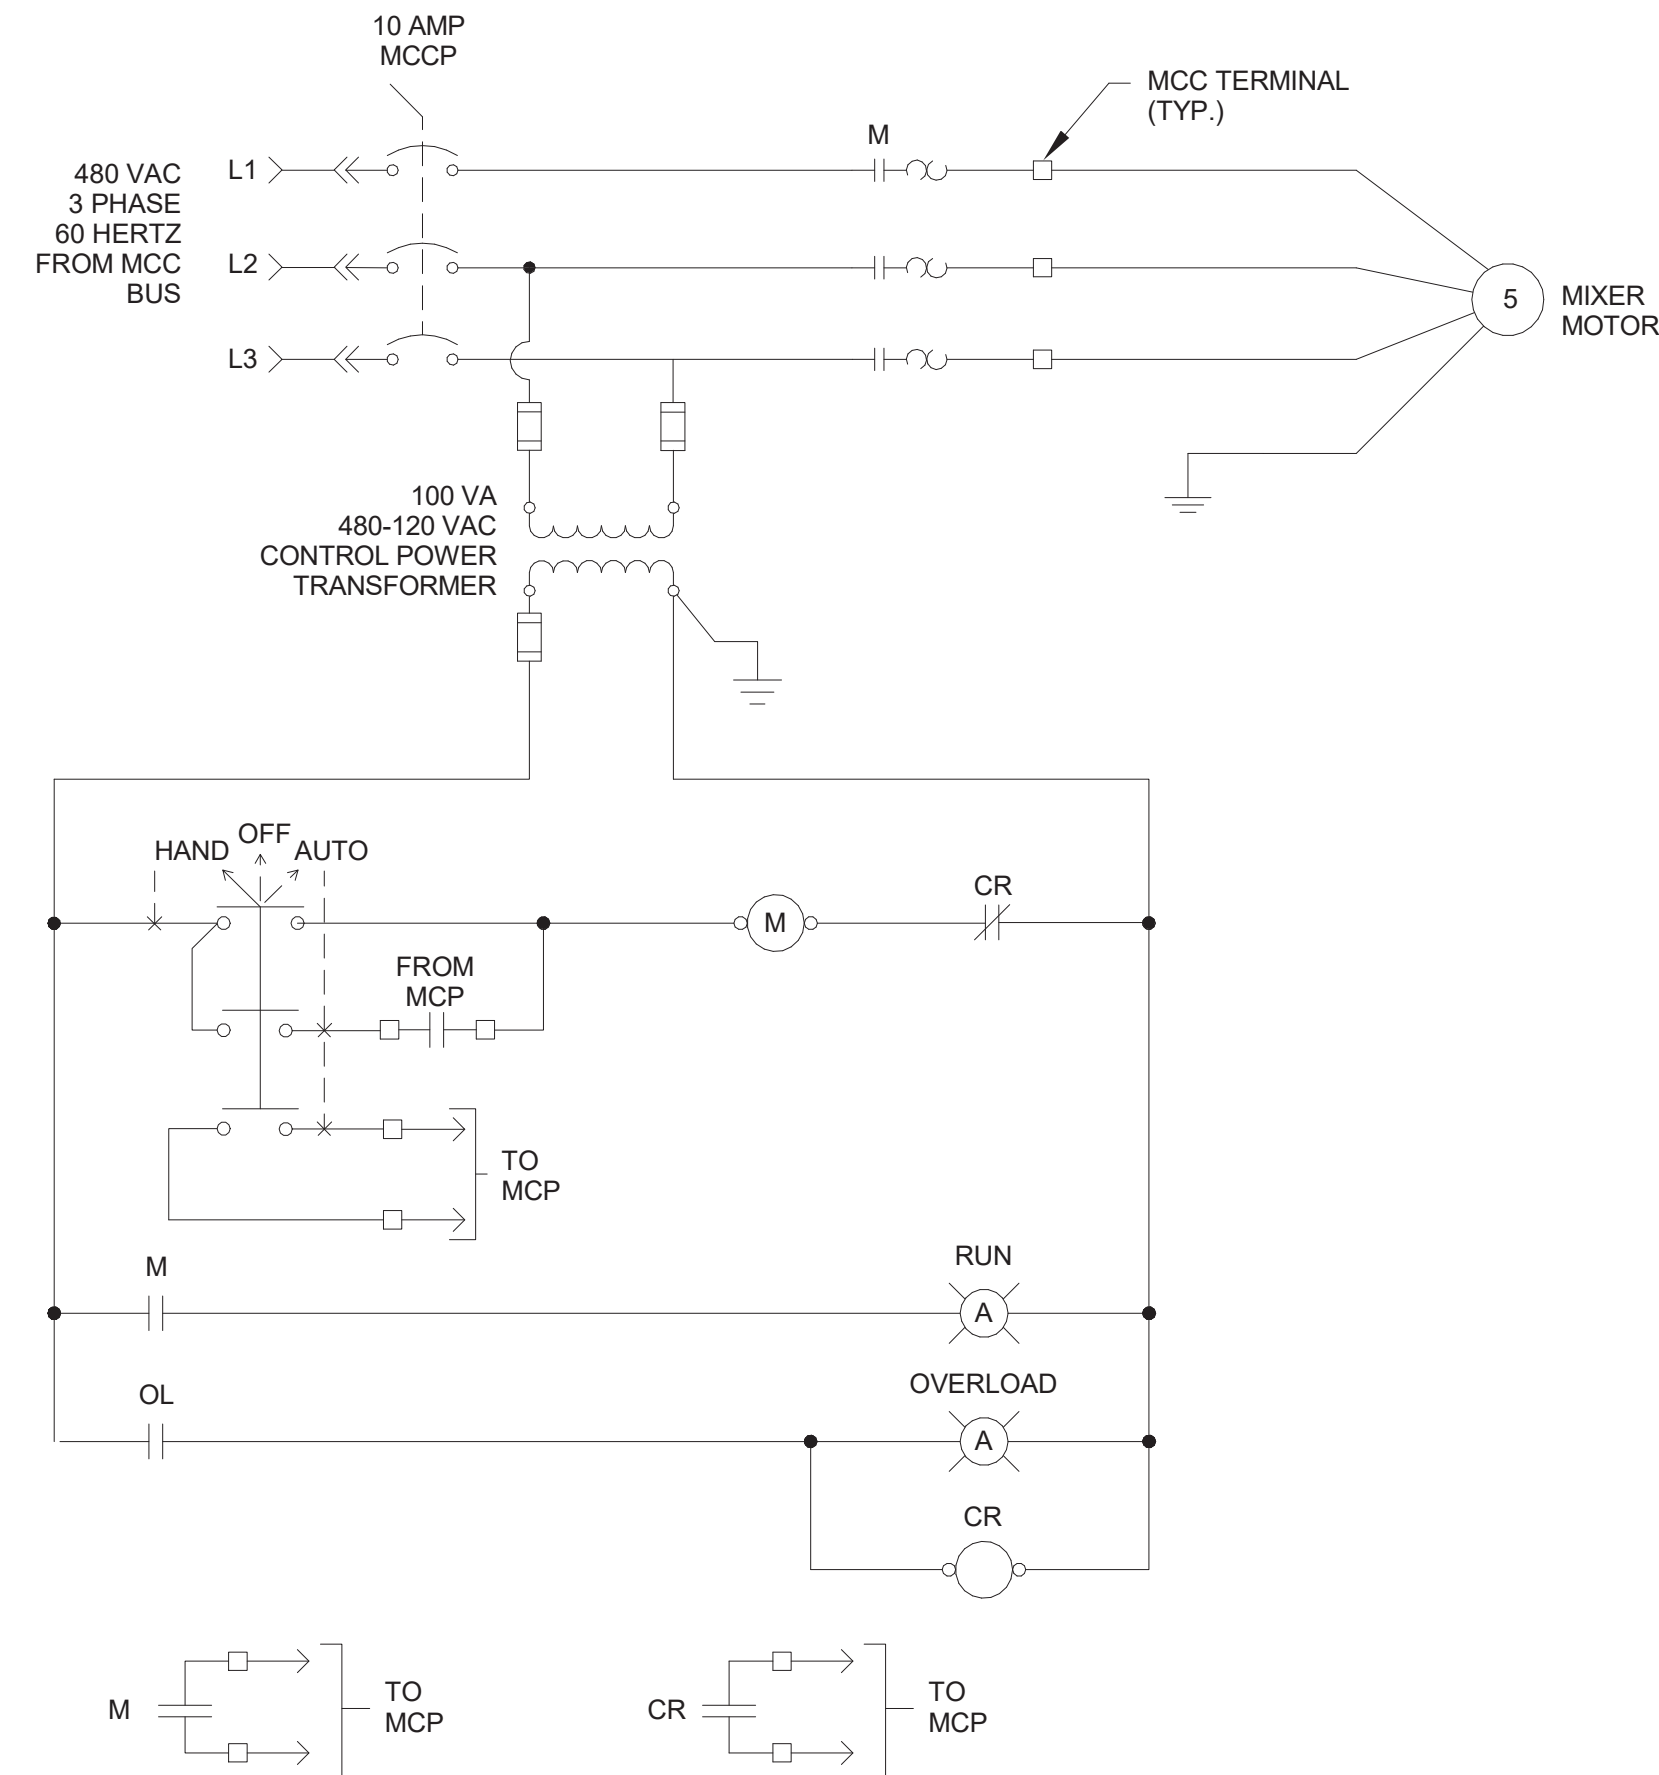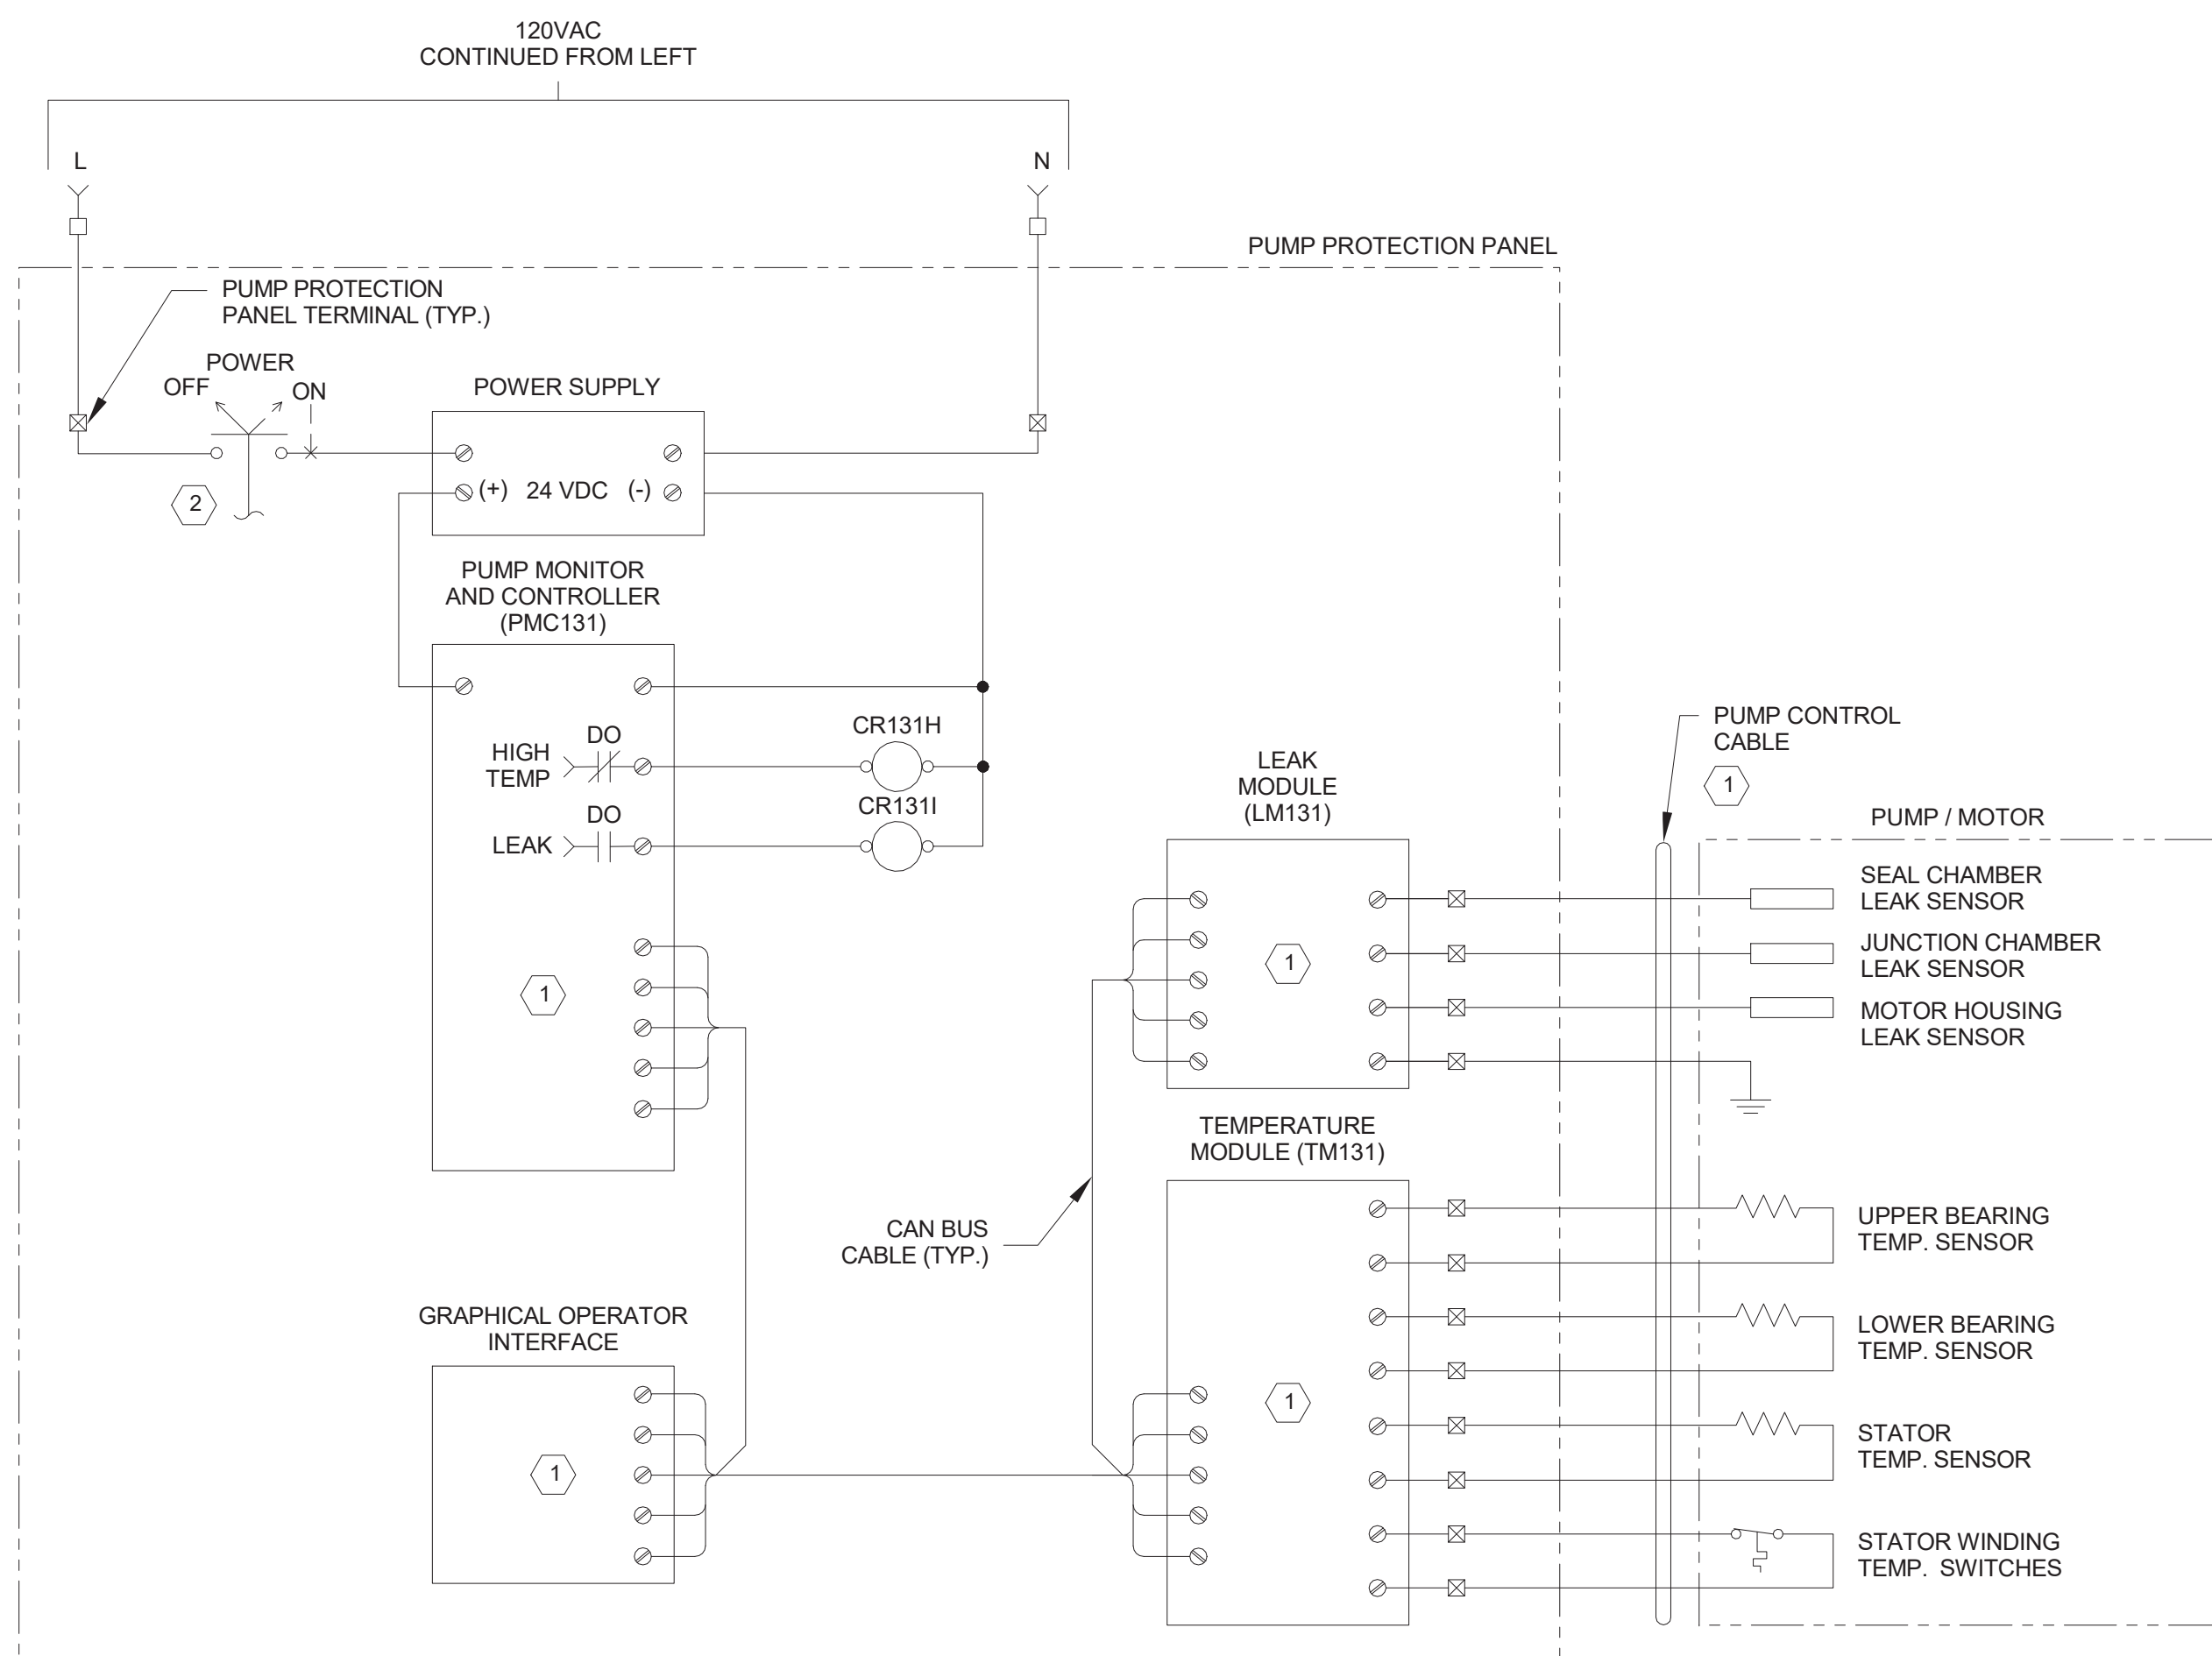

MIXER ELEMENTARY



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CHEMICAL FEED PUMP ELEMENTARY

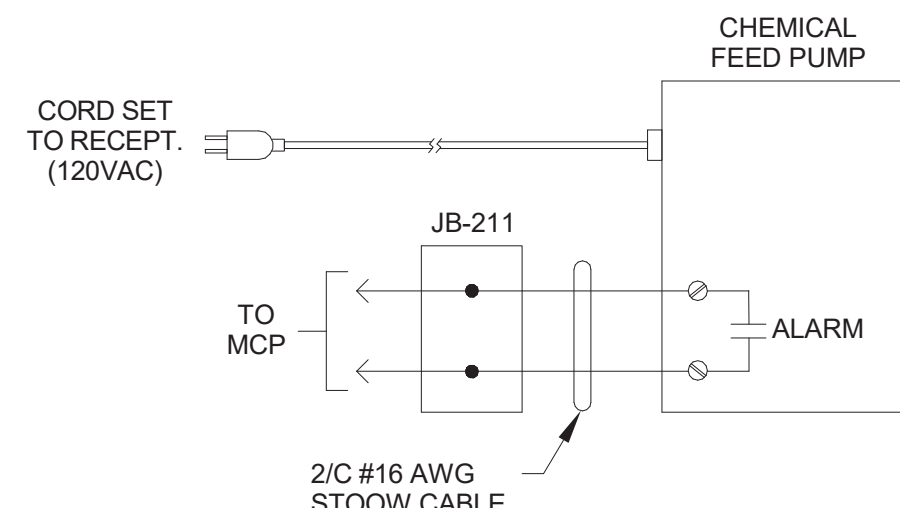NOT TO SCALE


		IN ACCORDANCE WITH TITLE VIII, ARTICLE 145, SECTION 7209 (2) OF THE NEW YORK STATE EDUCATION LAW, IT IS A VIOLATION OF LAW FOR ANY PERSON UNLESS ACTING UNDER THE DIRECTION OF A LICENSED ENGINEER TO ALTER THIS DOCUMENT.			
IN CHARGE OF <u>Eric Miles</u>		CHECKED BY <u>Jim Crosier</u>		MADE BY <u>Joseph LaGoy</u>	
2021-07-15				O'BRIEN & GERE ENGINEERS, INC. 50 MAIN ST., 10TH FLOOR SUITE 1000, WHITE PLAINS, NEW YORK 10606	
REVISION NUMBER	DATE	MADE BY	APP'D BY	REVISION	
RECORD DRAWING CERTIFICATION					
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CONTRACTOR			PROJECT COORDINATOR		
NAME	SIGNATURE	DATE	NAME	SIGNATURE	DATE
TITLE	TITLE	TITLE	TITLE	TITLE	TITLE
WESTCHESTER COUNTY, NEW YORK DEPARTMENT OF PUBLIC WORKS AND TRANSPORTATION DIVISION OF ENGINEERING			CONTRACT NUMBER	SHEET NUMBER	
CROTONVILLE PUMPING STATION REHABILITATION			47	E-602	OF 60
OSSINING, NEW YORK ELEMENTARY DIAGRAMS			SCALE: DATE: 12/21/2018 DPW FILE NO. 208-03-E-71-0	REV. NO. 0	



- DETAIL NOTES:**
1. MOBILE GENERATOR AUTO START/STOP TERMINAL BOX SHALL BE A 6"x6"x4" DEEP SURFACE MOUNTED, STAINLESS STEEL, NEMA 4 ENCLOSURE WITH HINGED DOOR AND PAD LOCKING HASP. BOX SHALL INCLUDE A TERMINAL BLOCK SUITABLE FOR CONNECTION FOR TWO INCOMING AND OUTGOING 14 AWG THROUGH 10 AWG CONDUCTOS. PROVIDE A 2" DIAMETER HOLE ON THE ENCLOSURE BOTTOM SEALED WITH A REMOVABLE AND REPLACEABLE KNOCKOUT FOR ENTRY OF MOBILE GENERATOR CONTROL CABLE.

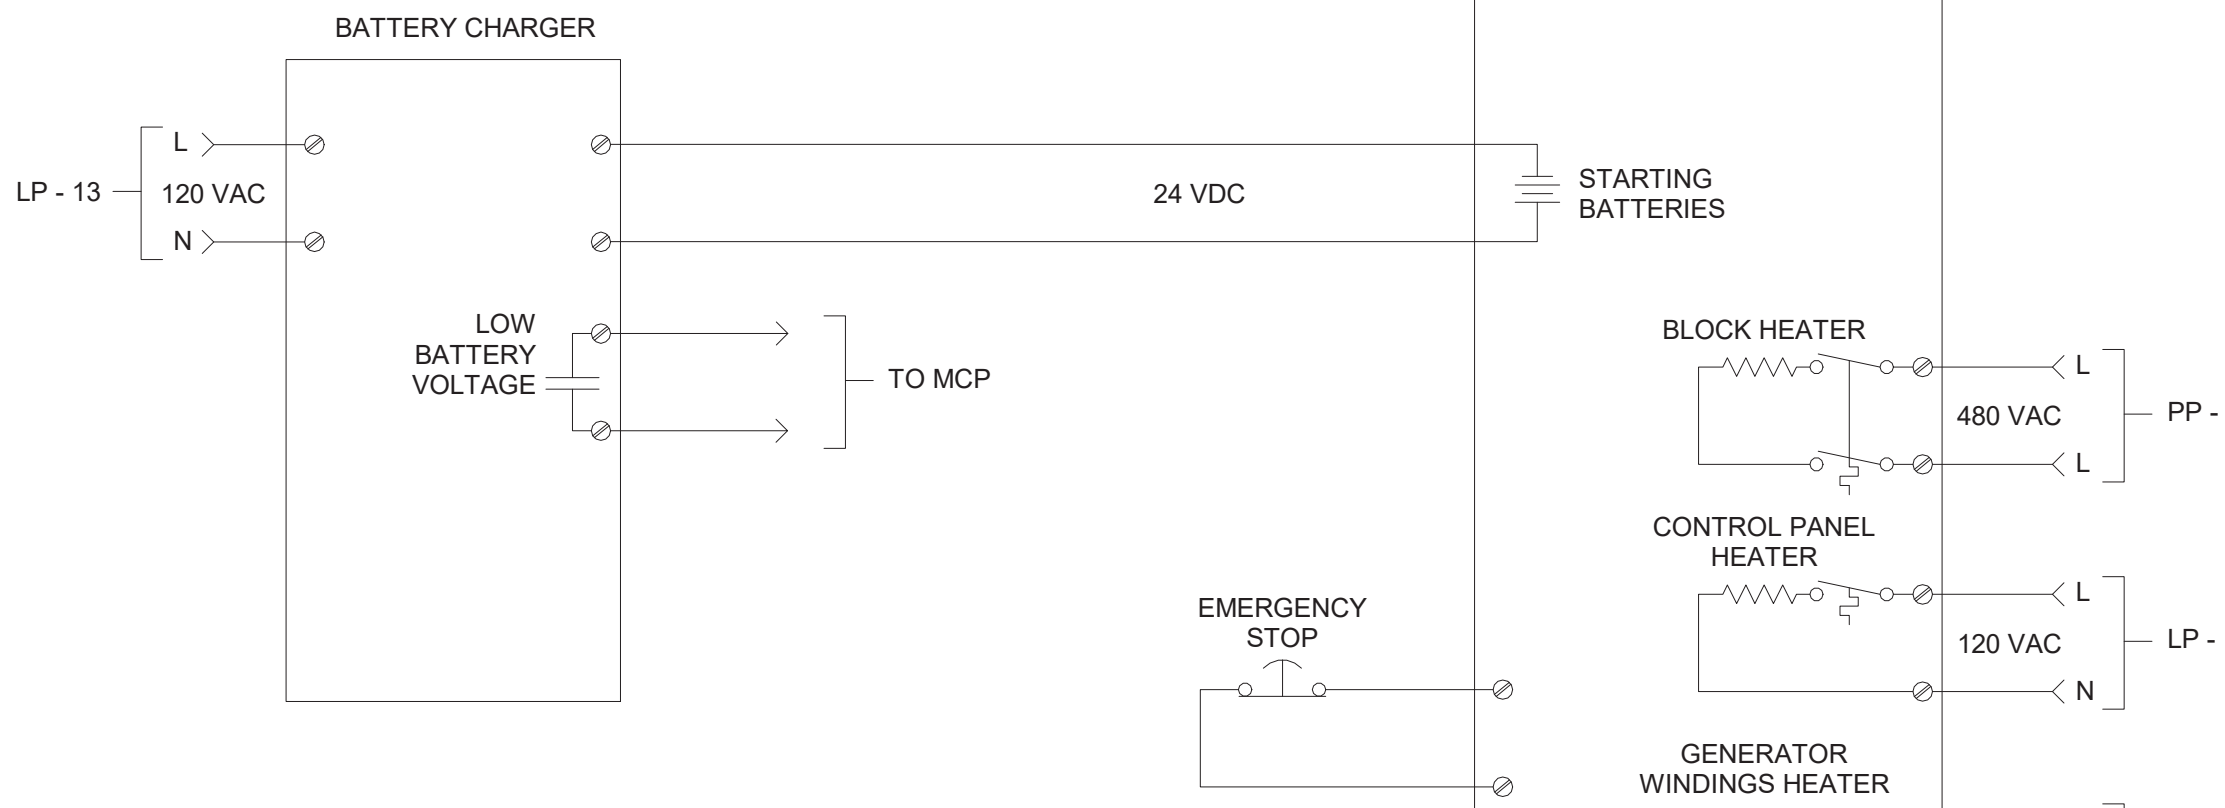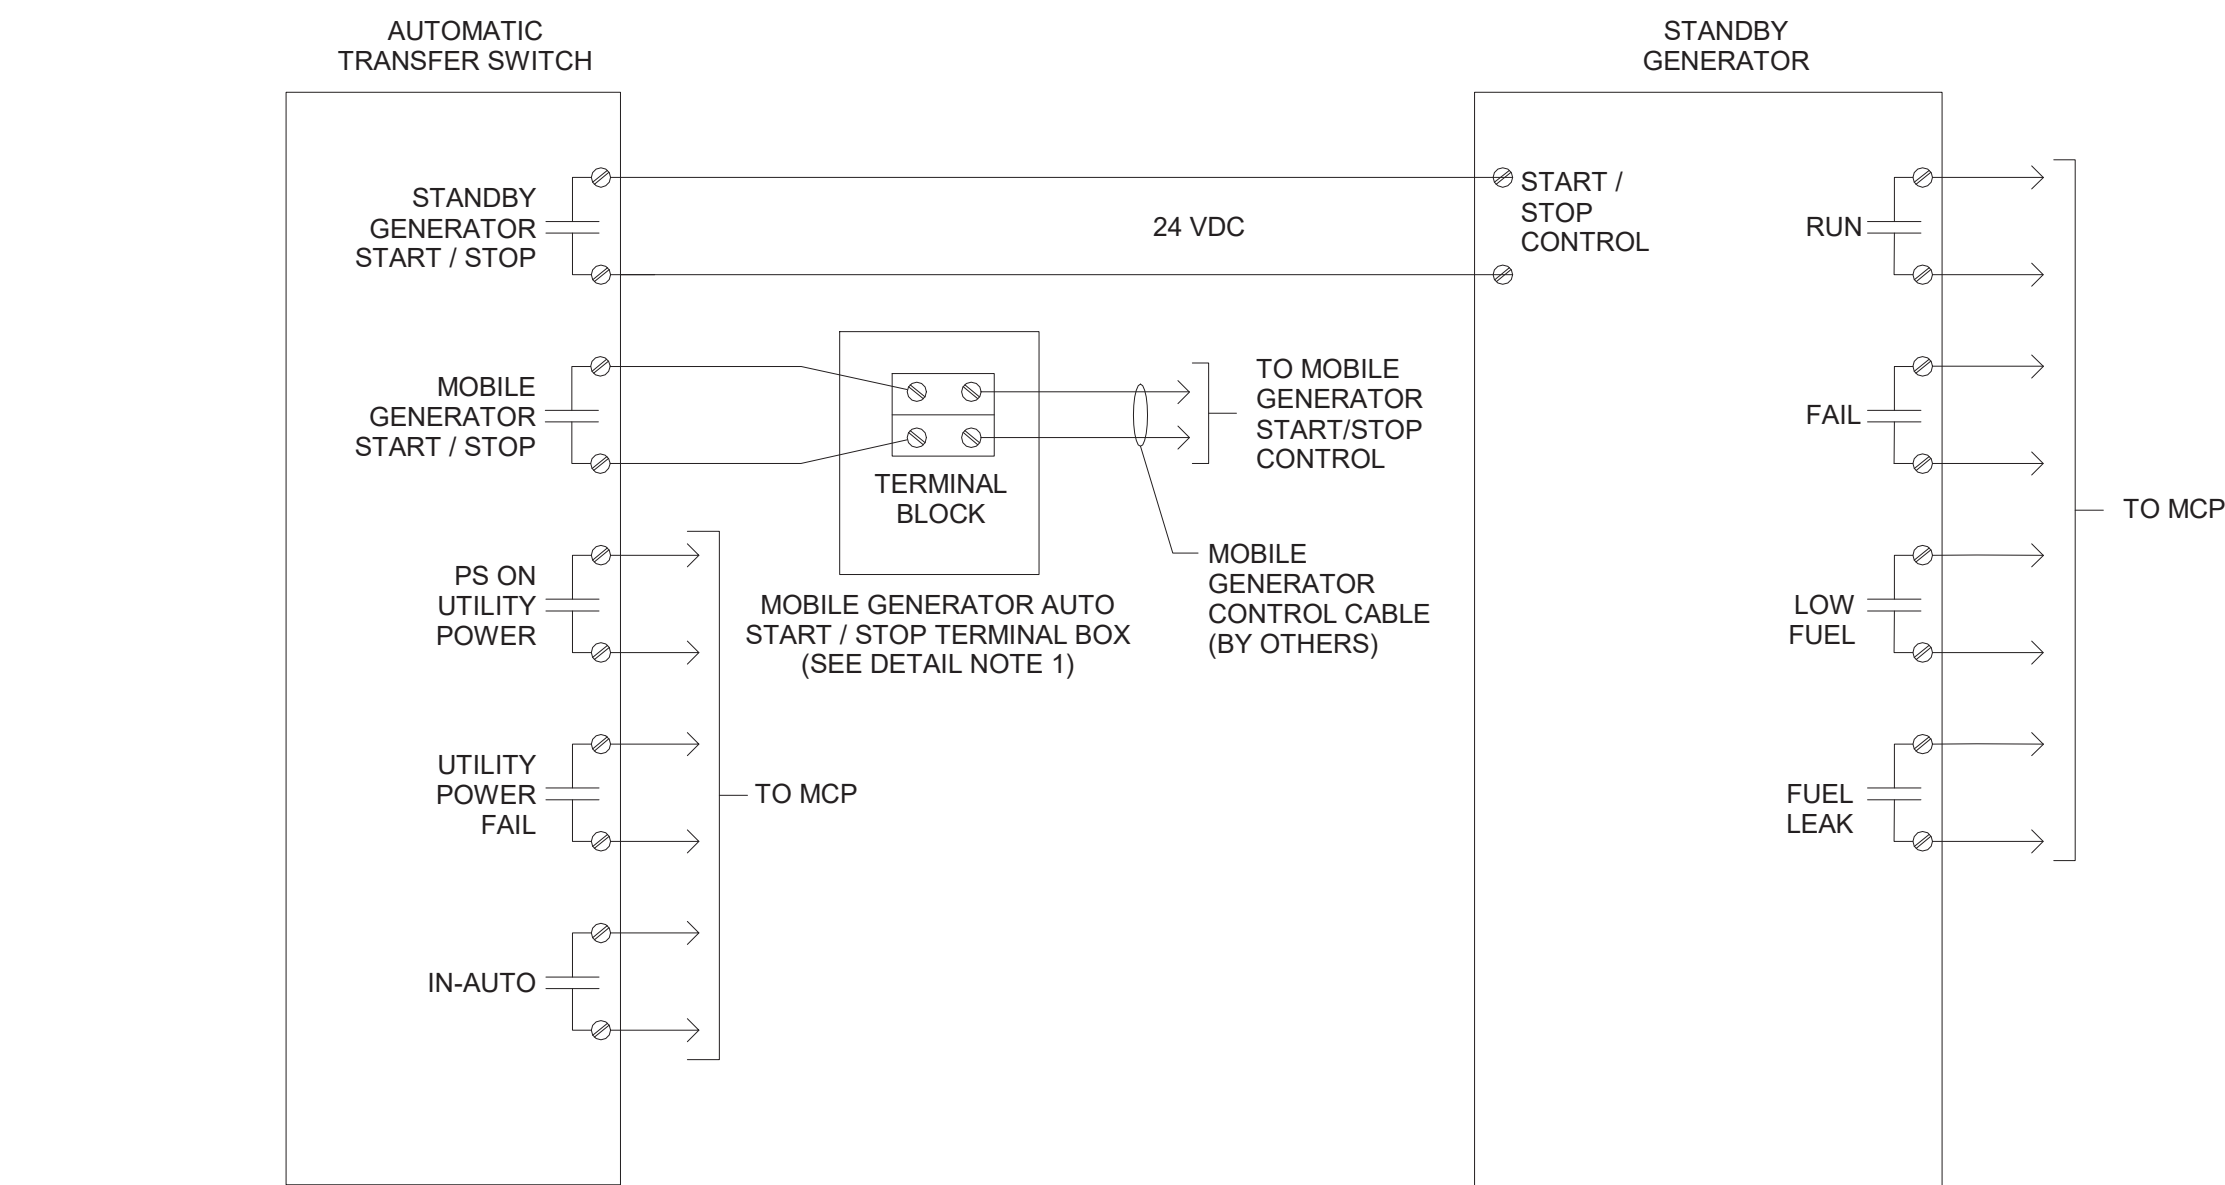
STANDBY GENERATOR ELEMENTARY

NOT TO SCALE

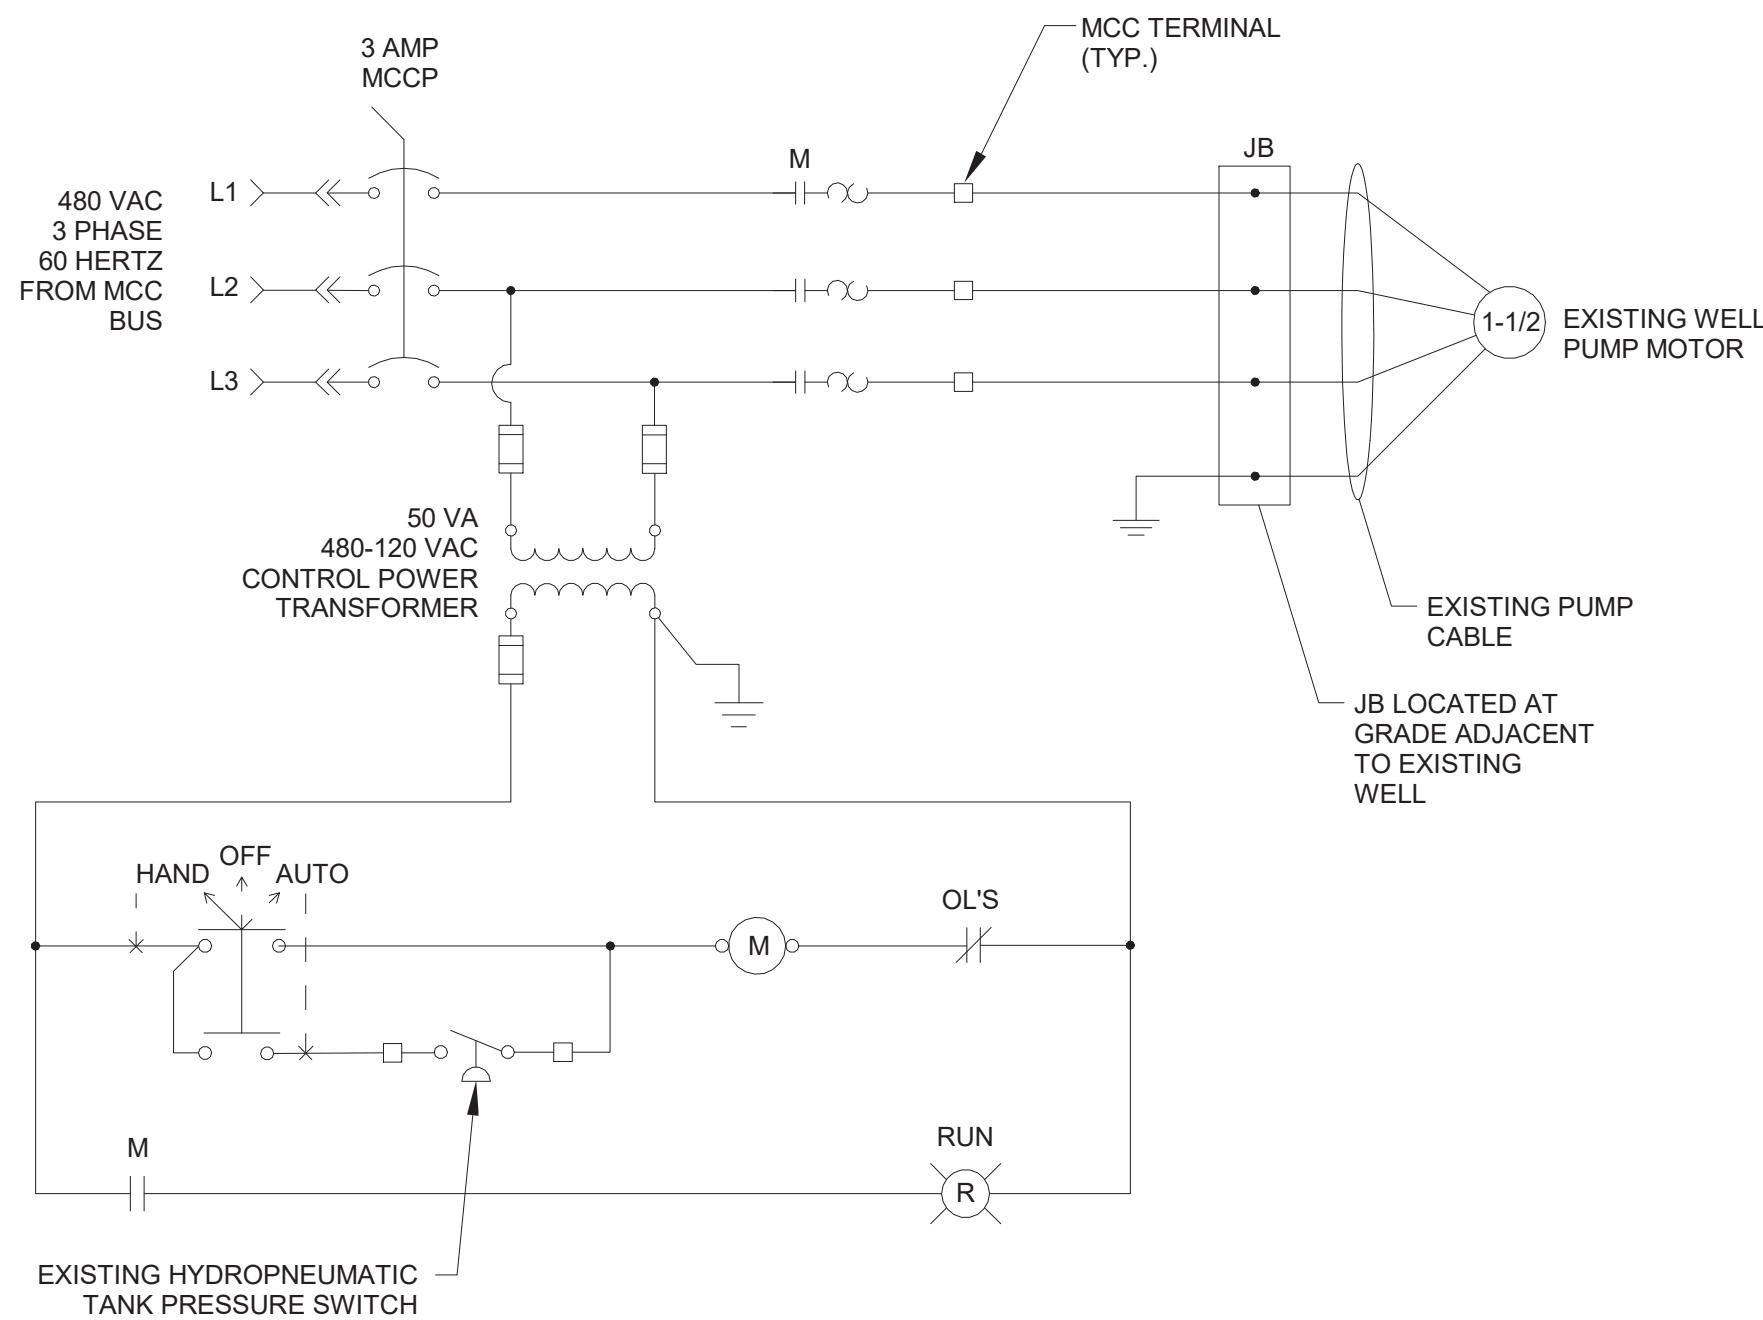


WELL PUMP ELEMENTARY

NOT TO SCALE

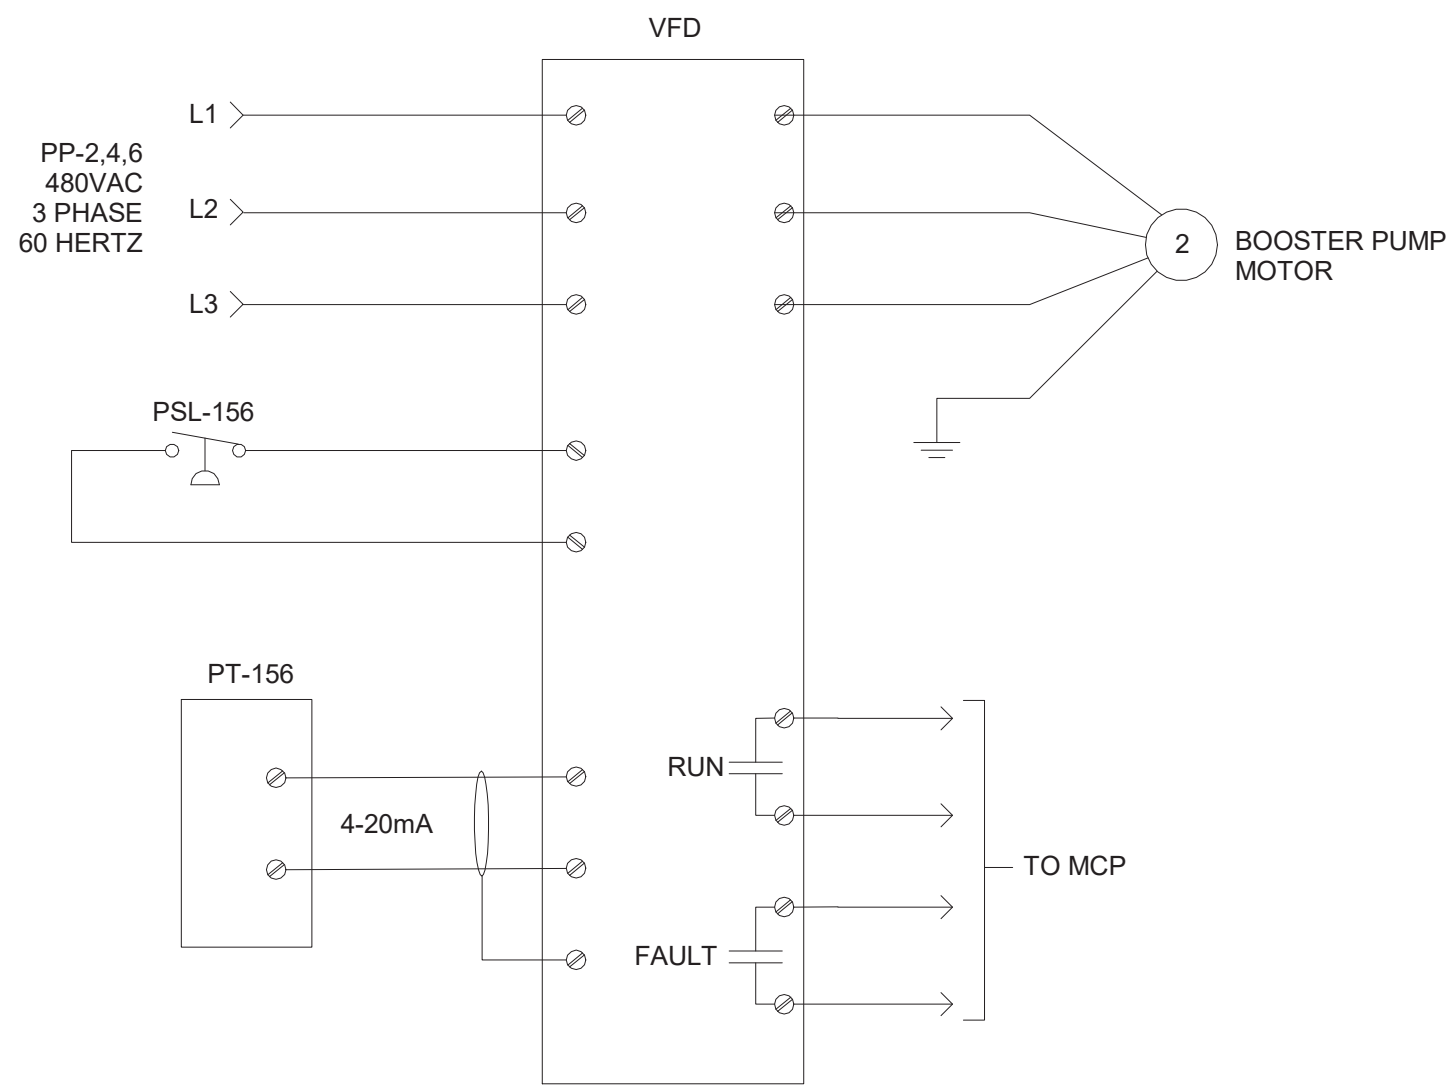

BOOSTER PUMP ELEMENTARY


NOT TO SCALE

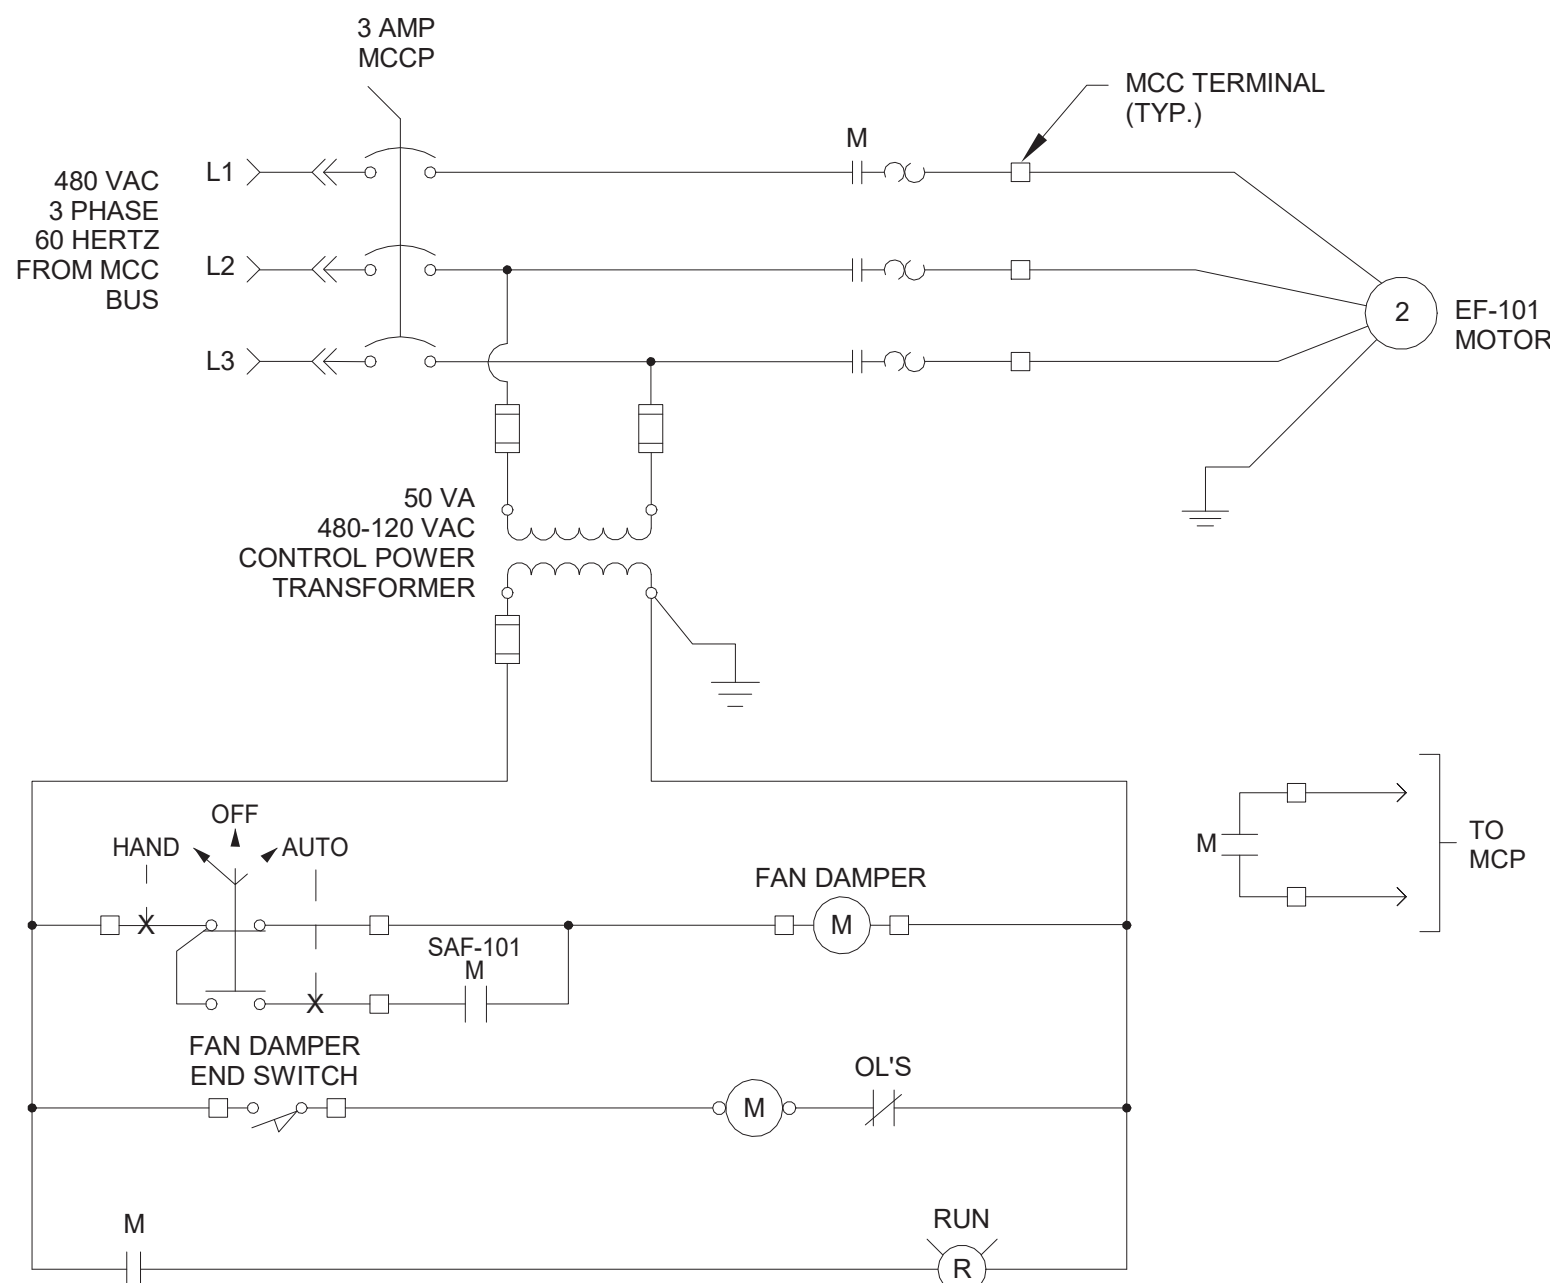

TYPICAL: EF-101 WITH 3 AMP MCCP AND 2HP MOTOR.

EF-101 ELEMENTARY

NOT TO SCALE

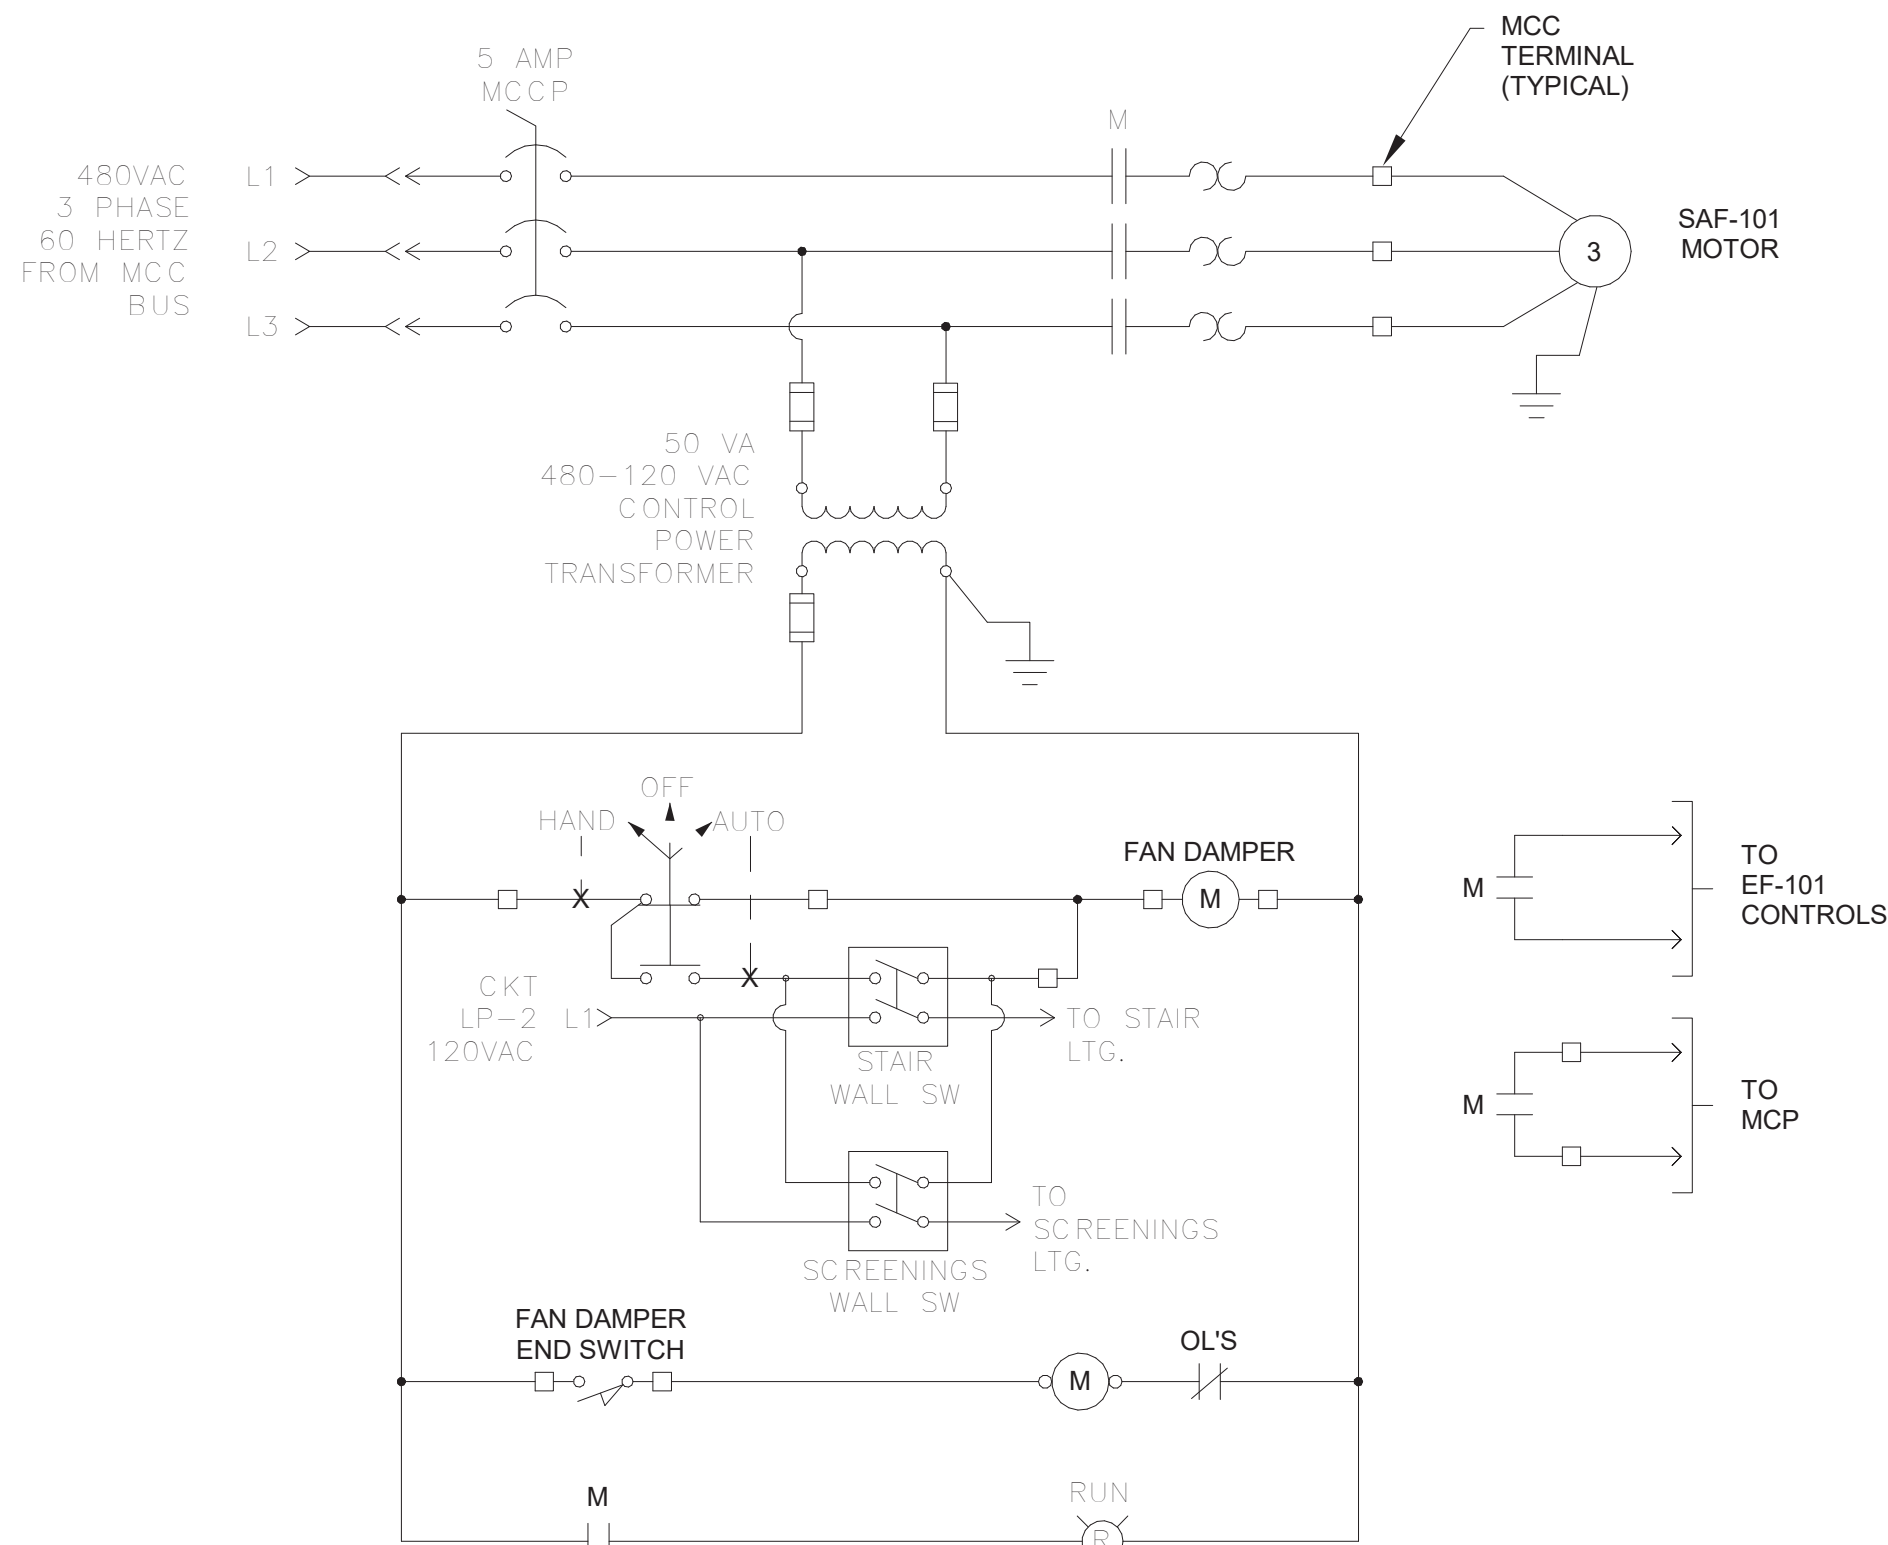

SAF-101 ELEMENTARY

NOT TO SCALE

		IN ACCORDANCE WITH TITLE VIII, ARTICLE 145, SECTION 7209 (2) OF THE NEW YORK STATE EDUCATION LAW, IT IS A VIOLATION OF LAW FOR ANY PERSON UNLESS ACTING UNDER THE DIRECTION OF A LICENSED ENGINEER TO ALTER THIS DOCUMENT.			
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CONTRACT NUMBER		PROJECT COORDINATOR		SHEET NUMBER	
NAME		NAME		E-603	
SIGNATURE		SIGNATURE		DATE	
TITLE		TITLE		SHEET NO. 48 OF 60	
WESTCHESTER COUNTY, NEW YORK					
DEPARTMENT OF PUBLIC WORKS AND TRANSPORTATION					
DIVISION OF ENGINEERING					
CROTONVILLE PUMPING STATION REHABILITATION					
SCALE: 12/21/2018					
DATE: 208-03-E-72-0					
DPW FILE NO.					
OSSINING, NEW YORK					
ELEMENTARY DIAGRAMS					
REV. NO. 0					

POWER PANEL: PP												
LOCATION: ELECTRICAL ROOM				VOLTS: 480/277 WYE				A.I.C. RATING: 42,000				
				PHASES: 3				MAINS TYPE: MLO				
MOUNTING: SURFACE				WIRES 4				MCB RATING: 200 A				
ENCLOSURE: TYPE 1				CONNECTED LOAD: 124.93 KVA								
CKT	Circuit Description	Trip	Poles	KVA A	KVA B	KVA C	Poles	Trip	Circuit Description	CKT		
1	MECHANICAL BAR SCREEN CP	20 A	3	0.66	0.94		3	20 A	BOOSTER PUMP	2		
					0.66	0.94					4	
						0.66				0.94		6
3	HOIST	20 A	3	4.43	22.54		3	110 A	HRU-101	8		
5						4.43				22.54		10
7						4.43				22.54		12
9	EUH-101	20 A	3	1.67	1.67		3	20 A	EUH-102	14		
11						1.67				1.67		16
13											1.67	1.67
15	EUH-103	20 A	3	1.67	1.67		3	20 A	EUH-104	20		
17						1.67				1.67		22
19											1.67	1.67
21	EUH-105	20 A	3	1.00	3.00		3	20 A	EWH-1	26		
23						1.00				3.00		28
25											1.00	3.00
27	SPARE	20 A	3	0.00	6.50		2	40 A	GENERATOR BLOCK HEATER	32		
29						0.00				6.50		34
31											0.00	0.00
33	SPARE	20 A	3	0.00	0.00		3	20 A	SPARE	38		
35						0.00				0.00		40
37											0.00	0.00
39	TOTAL LOAD:			44.45 KVA	44.45 KVA	37.99 KVA						
41	TOTAL AMPS:			164 A	164 A	137 A						

LIGHTING PANEL: LP															
LOCATION: ELECTRICAL ROOM						VOLTS: 120/208 WYE				A.I.C. RATING: 10,000					
						PHASES: 3				MAINS TYPE: MCB					
MOUNTING: SURFACE						WIRES 4				MCB RATING: 100 A					
ENCLOSURE: TYPE 1						CONNECTED LOAD: 18.16 kVA								PANEL RATING: 100 A	
CKT	Circuit Description	Trip	Poles	KVA A	KVA B	KVA C	Poles	Trip	Circuit Description	CKT					
1	ELEC RM, CLOSET, RESTROOM LTG	20 A	1	0.47	0.56			1	20 A SCREENING, STAIR, INFL SCREEN LTG	2					
3	STORAGE, PUMP ROOM LTG	20 A	1		0.69	0.25		1	20 A EXTERIOR LTG	4					
5	ELEC. RM, RESTROOM RECPTS	20 A	1			0.90	0.72	1	20 A STORAGE RECPTS	6					
7	PUMP ROOM RECPTS	20 A	1	0.72	2.50			2	30 A MOBILE GEN ACCESS. DISC SW	8					
9	MOBILE GEN ACCESSORY RECPT	20 A	1		0.18	2.50				10					
11	STANDBY GEN PLATFORM RECPT	20 A	1			0.36	0.20	1	20 A STANDBY GEN HEATERS	12					
13	STANDBY GEN. BATTERY CHARGER	20 A	1	0.50	0.36			1	20 A CHEM FEED PUMP RECPT	14					
15	MAIN CONTROL PANEL	20 A	1		1.00	0.20		1	20 A BUBBLER PANEL, FIT-160	16					
17	LIT-210	20 A	1			0.10	2.00	1	30 A CUH-101	18					
19	NETWORK PANEL	20 A	1	0.10	0.70			1	20 A SUMP PUMP RECPT.	20					
21	MOBILE GEN. ACCESSORY RECEPT.	20 A	1		0.18	0.00		1	20 A SPARE	22					
23	HORN / STROBES	15 A	1			1.00	0.18	1	20 A EXTERIOR GFI RECEPT.	24					
25	SCREENINGS GAS MONITORING	20 A	1	1.50	1.25			1	20 A INFL. SCREEN GAS MONITORING	26					
27	HAND DRYER	★ 20 A	1		1.15	0.00		--	SPACE	28					
29	SPACE	--	--			0.00	0.00	--	SPACE	30					
31	SPACE	--	--	0.00	0.00			--	SPACE	32					
33	SPACE	--	--		0.00	0.00		--	SPACE	34					
35	SPACE	--	--			0.00	0.00	--	SPACE	36					
37	SPACE	--	--	0.00	0.00			--	SPACE	38					
39	SPACE	--	--		0.00	0.00		--	SPACE	40					
41	SPACE	--	--			0.00	0.00	--	SPACE	42					
TOTAL LOAD:				8.62 kVA	6.11 kVA	5.20 kVA									
TOTAL AMPS:				73 A	52 A	43 A									

★ GFI CIRCUIT BREAKER

DRAWING NOTES:

1.

POWER PANELBOARD AND LIGHTING PANELBOARD HOMERUN WIRING SHALL BE AS FOLLOWS:

CIRCUIT BREAKER	CONDUCTORS	CONDUIT
15AMP/1POLE	2-#14, 1-#14 GRD	3/4"
20AMP/1POLE	2-#12, 1-#12 GRD	3/4"
20AMP/3POLE	3-#12, 1-#12 GRD	3/4"
30AMP/1POLE	2-#10, 1-#10 GRD	3/4"
30AMP/2POLE	3-#10, 1-#10 GRD	3/4"
40AMP/2POLE	2-#8, 1-#10 GRD	3/4"
110AMP/3POLE	3-#2, 1-#6 GRD	1 1/4"
2.

CONDUITS FOR POWER PANELBOARD AND LIGHTING PANELBOARD HOMERUNS SHALL BE PERMITTED TO BE CONSOLIDATED. SIZE AND DERATE CONDUCTOR. DEDICATED NEUTRAL FOR EACH CIRCUIT REQUIRING A NEUTRAL.



<div><div><div><div>STATE OF NEW YORK</div><div>ERIC J. MILES</div><div>090895</div><div>REGISTERED PROFESSIONAL ENGINEER</div></div></div><div>2021-07-15</div></div>	<div>IN ACCORDANCE WITH TITLE VIII, ARTICLE 145, SECTION 7209 (2) OF THE NEW YORK STATE EDUCATION LAW, IT IS A VIOLATION OF LAW FOR ANY PERSON UNLESS ACTING UNDER THE DIRECTION OF A LICENSED ENGINEER TO ALTER THIS DOCUMENT.</div> <div>IN CHARGE OF Eric Miles</div> <div>CHECKED BY Jim Crosier</div> <div>MADE BY Joseph LaGoy</div>	<div><div><div>O</div></div><div>O'BRIEN & GERE ENGINEERS, INC.</div><div>50 MAIN ST., 10TH FLOOR SUITE 1000, WHITE PLAINS, NEW YORK 10606</div></div>		
REVISION NUMBER	DATE	MADE BY	APP'D BY	REVISION
RECORD DRAWING CERTIFICATION				
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NAME		NAME		
SIGNATURE		SIGNATURE		
TITLE	DATE	TITLE	DATE	
WESTCHESTER COUNTY, NEW YORK				CONTRACT NUMBER
DEPARTMENT OF PUBLIC WORKS AND TRANSPORTATION				SHEET NUMBER
DIVISION OF ENGINEERING				E-604
CROTONVILLE PUMPING STATION REHABILITATION				SHEET NO. 49 OF 60
OSSINING, NEW YORK				SCALE: DATE: 12/21/2018
SCHEDULES				DPW FILE NO. 208-03-E-73-0
				REV. NO. 0

CONDUIT SCHEDULE					
DESIGNATION	FROM	TO	CONDUIT SIZE	CONDUCTORS QTY / SIZE	REMARKS
MF-1A	EXISTING RISER POLE	EXISTING CON ED MANHOLE	EXIST. 4"	3 - #2 15KV MV CONDUCTORS	
MF-1B	EXISTING RISER POLE	EXISTING CON ED MANHOLE	EXIST. 4"	3 - #2 15KV MV CONDUCTORS	
MF-2A	EXISTING CON ED MANHOLE	EXISTING / RELOCATED CON ED SWITCHGEAR	*	3 - #2 15KV MV CONDUCTORS	* SEE KEYED NOTE 4, SHEET E-601
MF-2B	EXISTING CON ED MANHOLE	EXISTING / RELOCATED CON ED SWITCHGEAR	*	3 - #2 15KV MV CONDUCTORS	* SEE KEYED NOTE 4, SHEET E-601
MF-3	EXISTING / RELOCATED CON ED SWITCHGEAR	CON ED TRANSFORMER	4"	3 - #2 15KV MV CONDUCTORS	
MF-4	CON ED TRANSFORMER	SWBD	(4) 4"	32 - 250 MCM 4 - 4/0 GRD	
MF-5	SWBD	ATS	(4) 4"	32 - 250 MCM 4 - 4/0 GRD	
MF-6	ATS	MCC	(4) 4"	32 - 250 MCM 4 - 4/0 GRD	
EMF-1	STANDBY GENERATOR	MTS	(3) 4"	24 - 250 MCM 3 - 3/0 GRD	
EMF-2	MOBILE GENERATOR CONNECTION CABINET	MTS	(3) 4"	24 - 250 MCM 3 - 3/0 GRD	
EMF-3	MTS	ATS	(3) 4"	24 - 250 MCM 3 - 3/0 GRD	
P-1	MCC	WELL PUMP JB	3/4"	3 - #12, 1 - #12 GRD	
PC-1	MCC	SAF-101, HOA, DAMPER	3/4"	3 - #12, 1 - #12 GRD 7 - #14	
PC-2	MCC	EF-101, HOA, DAMPER	3/4"	3 - #12, #12 GRD 7 - #14	
P-2	MCC	PANEL PP	2"	4 - #3/0, 1 - #6 GRD	
P-3	MCC	30kVA TRANSFORMER	1"	3 - #6, 1 - #10GRD	
P-4	30kVA TRANSFORMER	LIGHTING PANELBOARD LP	1-1/2"	4 - #1, 1 - #8 GRD	
P-5	BATTERY CHARGER	STANDBY GENERATOR STARTING BATTERIES	3/4"	2 - #10	
P-6	BOOSTER PUMP VFD	BOOSTER PUMP	3/4"	3 - #12, 1 - #12 GRD	
P - 131	MCC	PUMP NO. 1	3"	3 - PUMP POWER CABLES 1 - PUMP GRD CABLE	CABLES FURNISHED WITH PUMP
P - 132	MCC	PUMP NO. 2	3"	3 - PUMP POWER CABLES 1 - PUMP GRD CABLE	CABLES FURNISHED WITH PUMP
P - 133	MCC	PUMP NO. 3	3"	3 - PUMP POWER CABLES 1 - PUMP GRD CABLE	CABLES FURNISHED WITH PUMP
P - 210	MCC	MIXER	3/4"	3-#12, 1-#12 GRD	
PC-110	MECHANICAL BAR SCREEN CP	MECHANICAL BAR SCREEN MOTOR	3/4"	3 - #12, 1 - #12 GRD, 2 - #14	

CONDUIT SCHEDULE CONT.					
DESIGNATION	FROM	TO	CONDUIT SIZE	CONDUCTORS QTY / SIZE	REMARKS
PC-120	MECHANICAL BAR SCREEN CP	WASHER / COMPACTOR MOTOR	3/4"	3 - #12, 1 - #12 GRD, 2 - #14	
CC - 1	ATS	STANDBY GENERATOR	3/4"	2 - #14	
CC - 2	ATS	MOBILE GENERATOR AUTO START / STOP TERMINAL BOX	3/4"	2 - #14	
CC - 3	MCP	ATS	3/4"	6 - #14	
CC - 4	MCP	STANDBY GENERATOR, BATTERY CHARGER	3/4"	10 - #14	
CC - 5	STANDBY GENERATOR	EMERGENCY STOP	3/4"	2 - #14	
CC - 6	MCP	PUMP PROTECTION PANEL	1-1/2"	30 - #14	
CC - 7	MCP	MCC	1-1/2"	70 - #14	INCLUDES 10 SPARES
CC - 8	MCP	NETWORK PANEL	3/4"	1 - FIBER-OPTIC CABLE	
CC - 9	SAF-101 HOA	STAIR AND SCREENINGS WALL SWS	3/4"	2 - #14	
CC - 10	HRU-101	DISCHARGE TEMP. SENSOR	3/4"	4 - #14	
CC - 11	HRU-101	HRU-101 REMOTE CP	3/4"	16 - #14	
CC - 12	MCC	EXISTING HYDROPNEUMATIC TANK PRESSURE SW	3/4"	16 - #14	
CC-100A	MCP	MECHANICAL BAR SCREEN CP	3/4"	1 - #16 TSP	
CC-100B	MCP	MECHANICAL BAR SCREEN CP	3/4"	12 - #14	
CC-110A	MECHANICAL BAR SCREEN CP	LE-110A, LE-110B	3/4"	2 - #16 TSP	
CC-110B	MECHANICAL BAR SCREEN CP	LIMIT SWITCH JB, SV	3/4"	8 - #14	
CC-110C	MECHANICAL BAR SCREEN CP	LSH-110	3/4"	2 - #14	
CC-110D	MECHANICAL BAR SCREEN CP	MECHANICAL BAR SCREEN & WASHER COMP. CONTROL STATIONS	3/4"	16 - #14 1 - #14 GRD	
CC-130A	MCP	LE-130A, LE-131A	3/4"	2 - #16 TSP	
CC-130B	MCP	LSL-130C, LSHH-130C, LSL-131C, LSHH-131C	3/4"	8 - #14	
CC-130C	MCP	BUBBLER PANEL	3/4"	2 - #16 TSP	
CC - 131A	PUMP PROTECTION PANEL	PUMP NO. 1	1-1/2"	1 - PUMP CONTROL CABLE	CABLE FURNISHED WITH PUMP
CC-131B	MCC	PUMP NO.1 E-STOP, PSH-131	3/4"	4 - #14	
CC - 132A	PUMP PROTECTION PANEL	PUMP NO. 2	1-1/2"	1 - PUMP CONTROL CABLE	CABLE FURNISHED WITH PUMP
CC-132B	MCC	PUMP NO.2 E-STOP, PSH-132	3/4"	4 - #14	
CC - 133A	PUMP PROTECTION PANEL	PUMP NO. 3	1-1/2"	1 - PUMP CONTROL CABLE	CABLE FURNISHED WITH PUMP
CC-133B	MCC	PUMP NO.3 E-STOP, PSH-133	3/4"	4 - #14	

CONDUIT CONT.					
DESIGNATION	FROM	TO	CONDUIT SIZE	CONDUCTORS QTY / SIZE	REMARKS
CC-140	MCP	STROBE / HORNS	3/4"	8 - #14	
CC-140A	MCP	AE/AIT-140A, AE/AIT-140B, AE/AIT-140C	1"	3 - #16 TSP	
CC-140B	MCP	AE/AIT-140A, AE/AIT-140B, AE/AIT-140C	3/4"	12 - #14	
CC-141	MCP	LSH-141	3/4"	2 - #14	
CC-142A	MCP	AE/AIT-142A, AE/AIT-142B, AE/AIT-142C	1"	3 - #16 TSP	
CC-142B	MCP	AE/AIT-142A, AE/AIT-142B, AE/AIT-142C	3/4"	16 - #14	
CC-144	MCP	SMOKE DETECTOR, FSL-150	3/4"	6 - #14	
CC-151	MCP	FSL-151, FSL-152, ZS-154-2, ZS-154-3	3/4"	8 - #14	
CC-154A	MCP	ZS-154-1	3/4"	2 - #14	
CC-154B	MCP	ZS-154-4, ZS-154-5	3/4"	4 - #14	
CC-156A	BOOSTER PUMP VFD	PSL-156	3/4"	2 - #14	
CC-156B	BOOSTER PUMP VFD	PT-156	3/4"	1 - #16 TSP	
CC-156C	MCP	BOOSTER PUMP VFD	3/4"	4 - #14	
CC-160A	FIT-160	FE-160	1"	FLOWMETER CABLE	CABLE FURNISHED WITH FLOWMETER
CC-160B	MCP	FIT-160, PIT-160	3/4"	2 - #16 TSP	
CC-210A	LE-210	FIT-210	3/4"	1 - #16 TSP	
CC-210B	MCP	FIT-210	3/4"	1 - #16 TSP	
CC-210C	MCP	LSHH-210	3/4"	2 - #14	
CC-211	MCP	JB-211	3/4"	2 - #14	

<div><div><div><div><div><div></div><div>STATE OF NEW YORK</div></div><div><div></div><div>ERIC J. MILES</div></div><div><div></div><div>090895</div></div><div><div></div><div>REGISTERED PROFESSIONAL ENGINEER</div></div></div></div><div>2021-07-15</div></div></div>	<div>IN ACCORDANCE WITH TITLE VIII, ARTICLE 145, SECTION 7209 (2) OF THE NEW YORK STATE EDUCATION LAW, IT IS A VIOLATION OF LAW FOR ANY PERSON UNLESS ACTING UNDER THE DIRECTION OF A LICENSED ENGINEER TO ALTER THIS DOCUMENT.</div> <div>IN CHARGE OF <u>Eric Miles</u></div> <div>CHECKED BY <u>Jim Crosier</u></div> <div>MADE BY <u>Joseph LaGoy</u></div>	<div><div><div><div></div></div><div>O'BRIEN & GERE ENGINEERS, INC.</div></div><div>50 MAIN ST., 10TH FLOOR SUITE 1000, WHITE PLAINS, NEW YORK 10606</div></div>		
REVISION NUMBER	DATE	MADE BY	APP'D BY	REVISION
RECORD DRAWING CERTIFICATION				
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CONTRACTOR		PROJECT COORDINATOR		
NAME _____	NAME _____	DATE _____		
SIGNATURE _____	SIGNATURE _____	DATE _____		
TITLE _____	TITLE _____	DATE _____		
WESTCHESTER COUNTY, NEW YORK				CONTRACT NUMBER
DEPARTMENT OF PUBLIC WORKS AND TRANSPORTATION				SHEET NUMBER
DIVISION OF ENGINEERING				E-605
CROTONVILLE PUMPING STATION REHABILITATION				SHEET NO. 50 OF 60
OSSINING, NEW YORK				SCALE:
CONDUIT SCHEDULE				DATE: 12/21/2018
				DPW FILE NO.
				208-03-E-74-0
				REV. NO.
				0

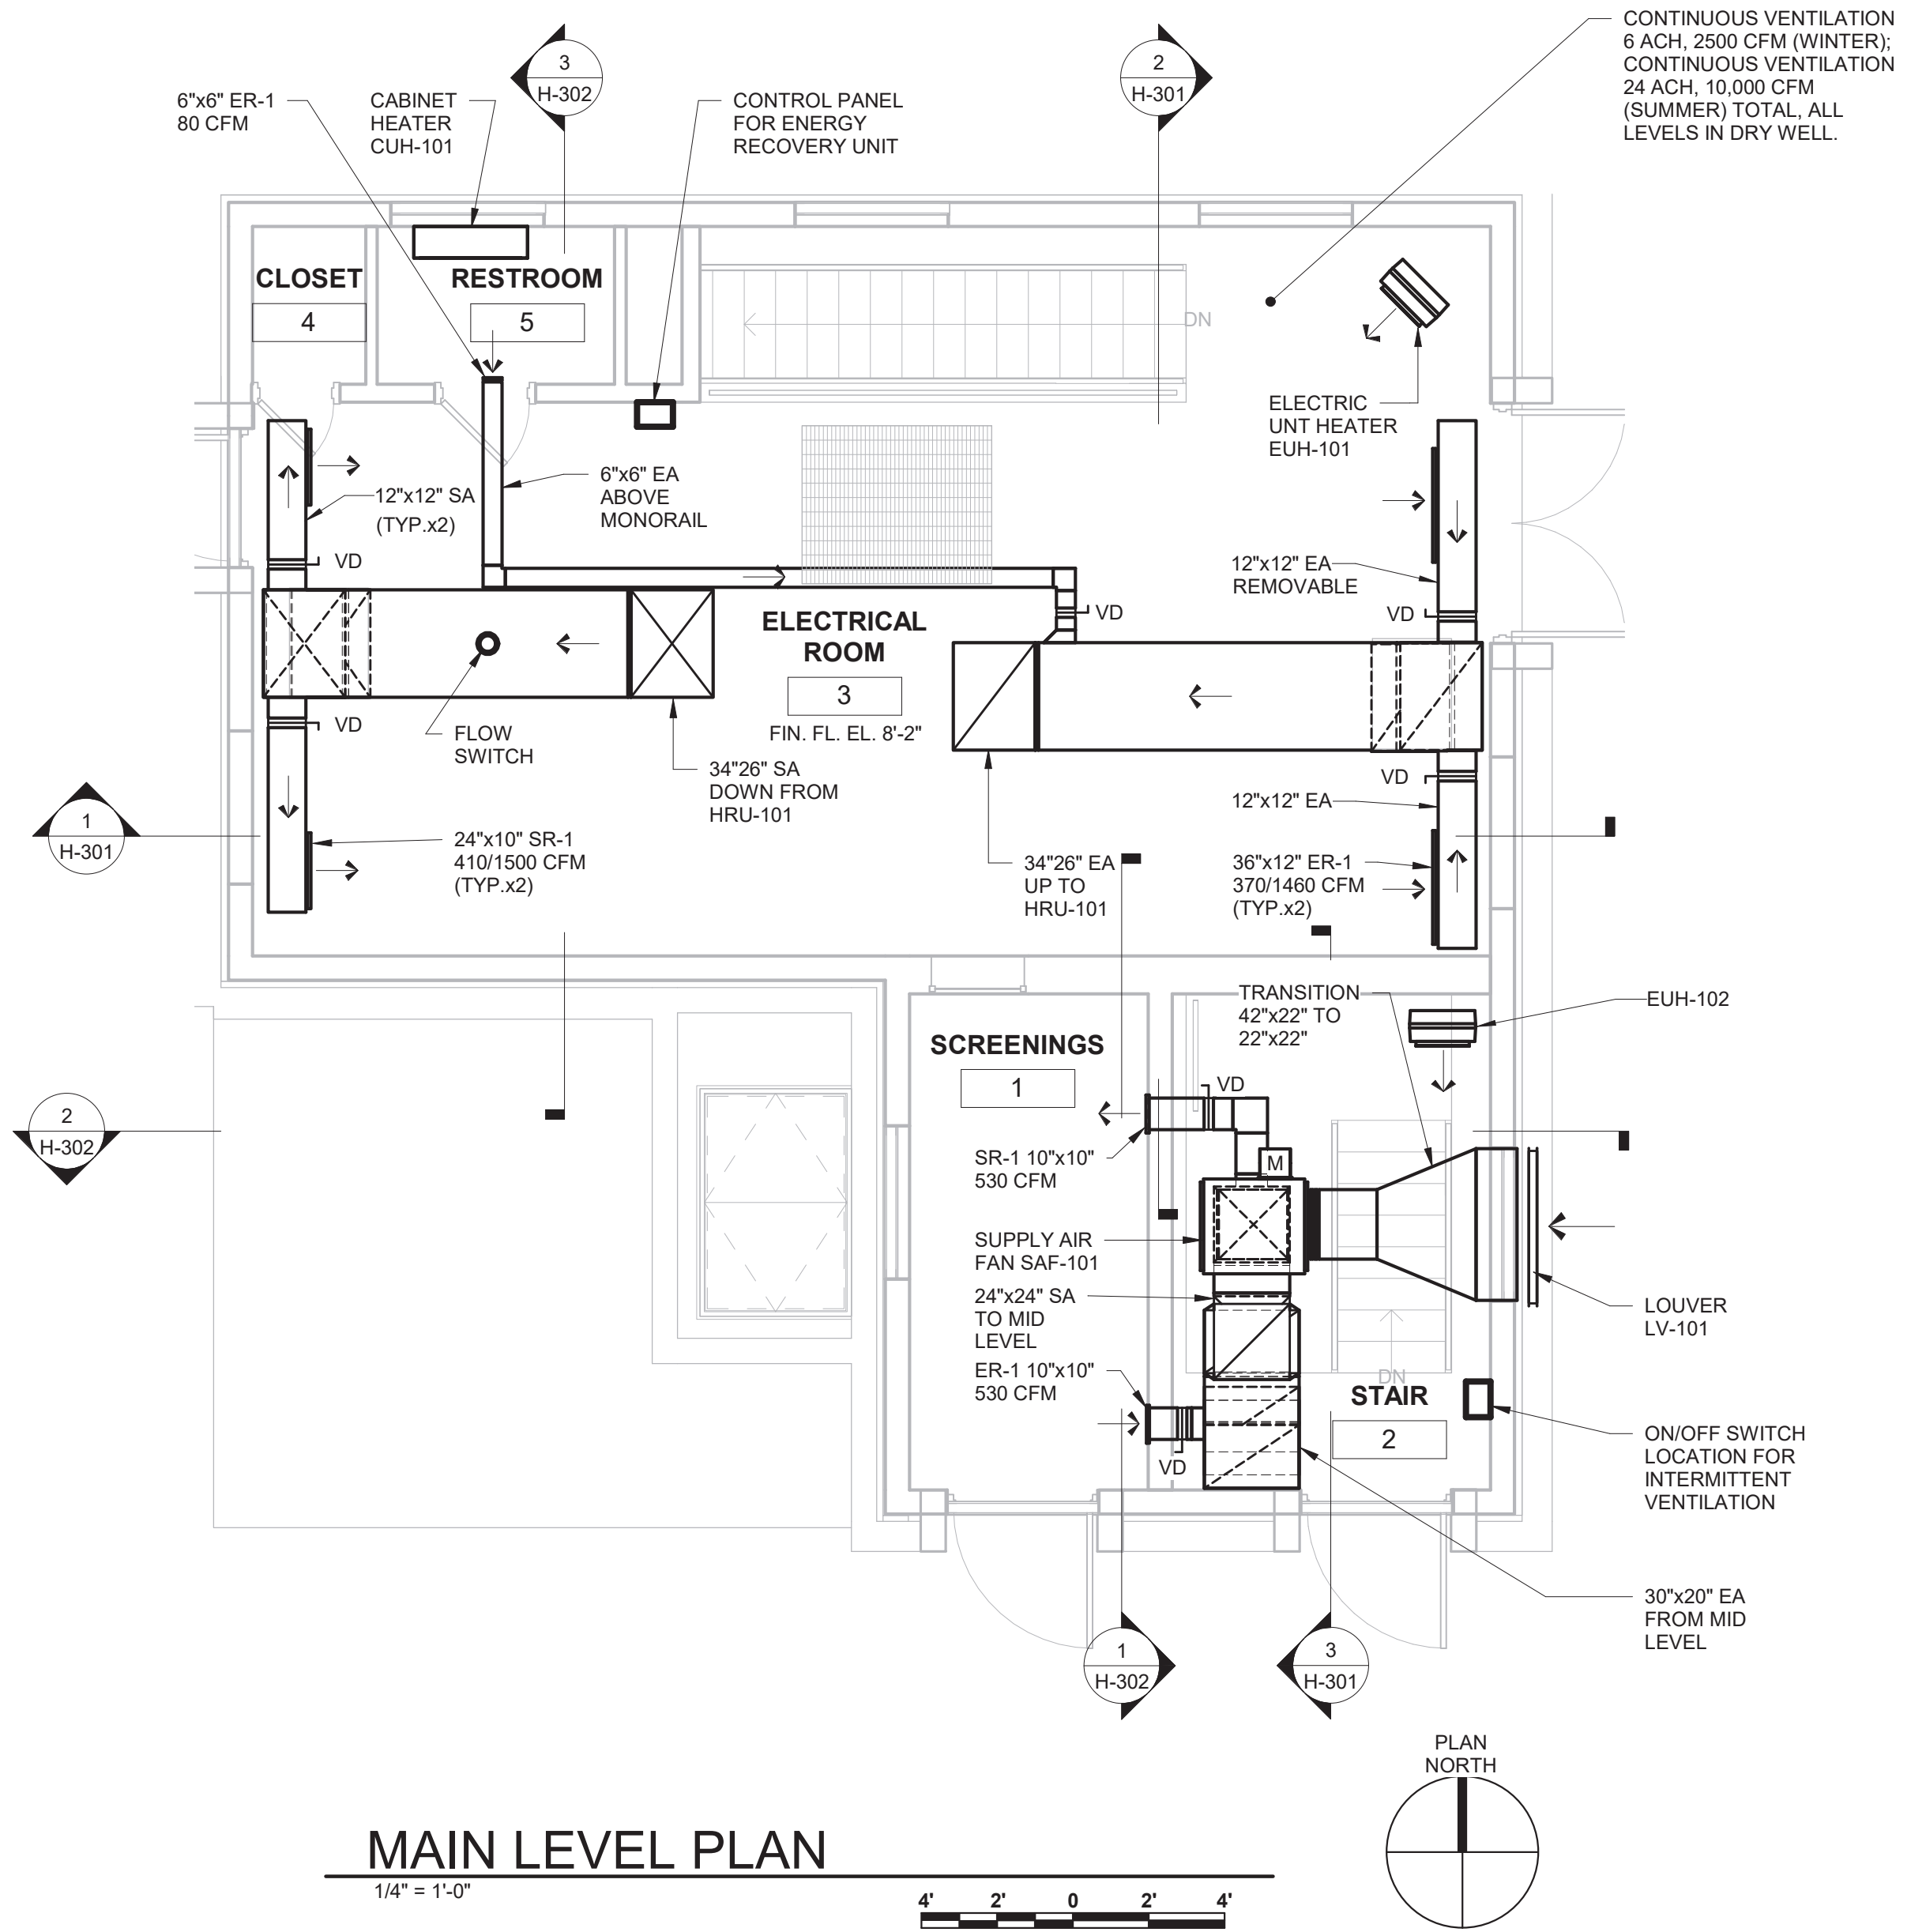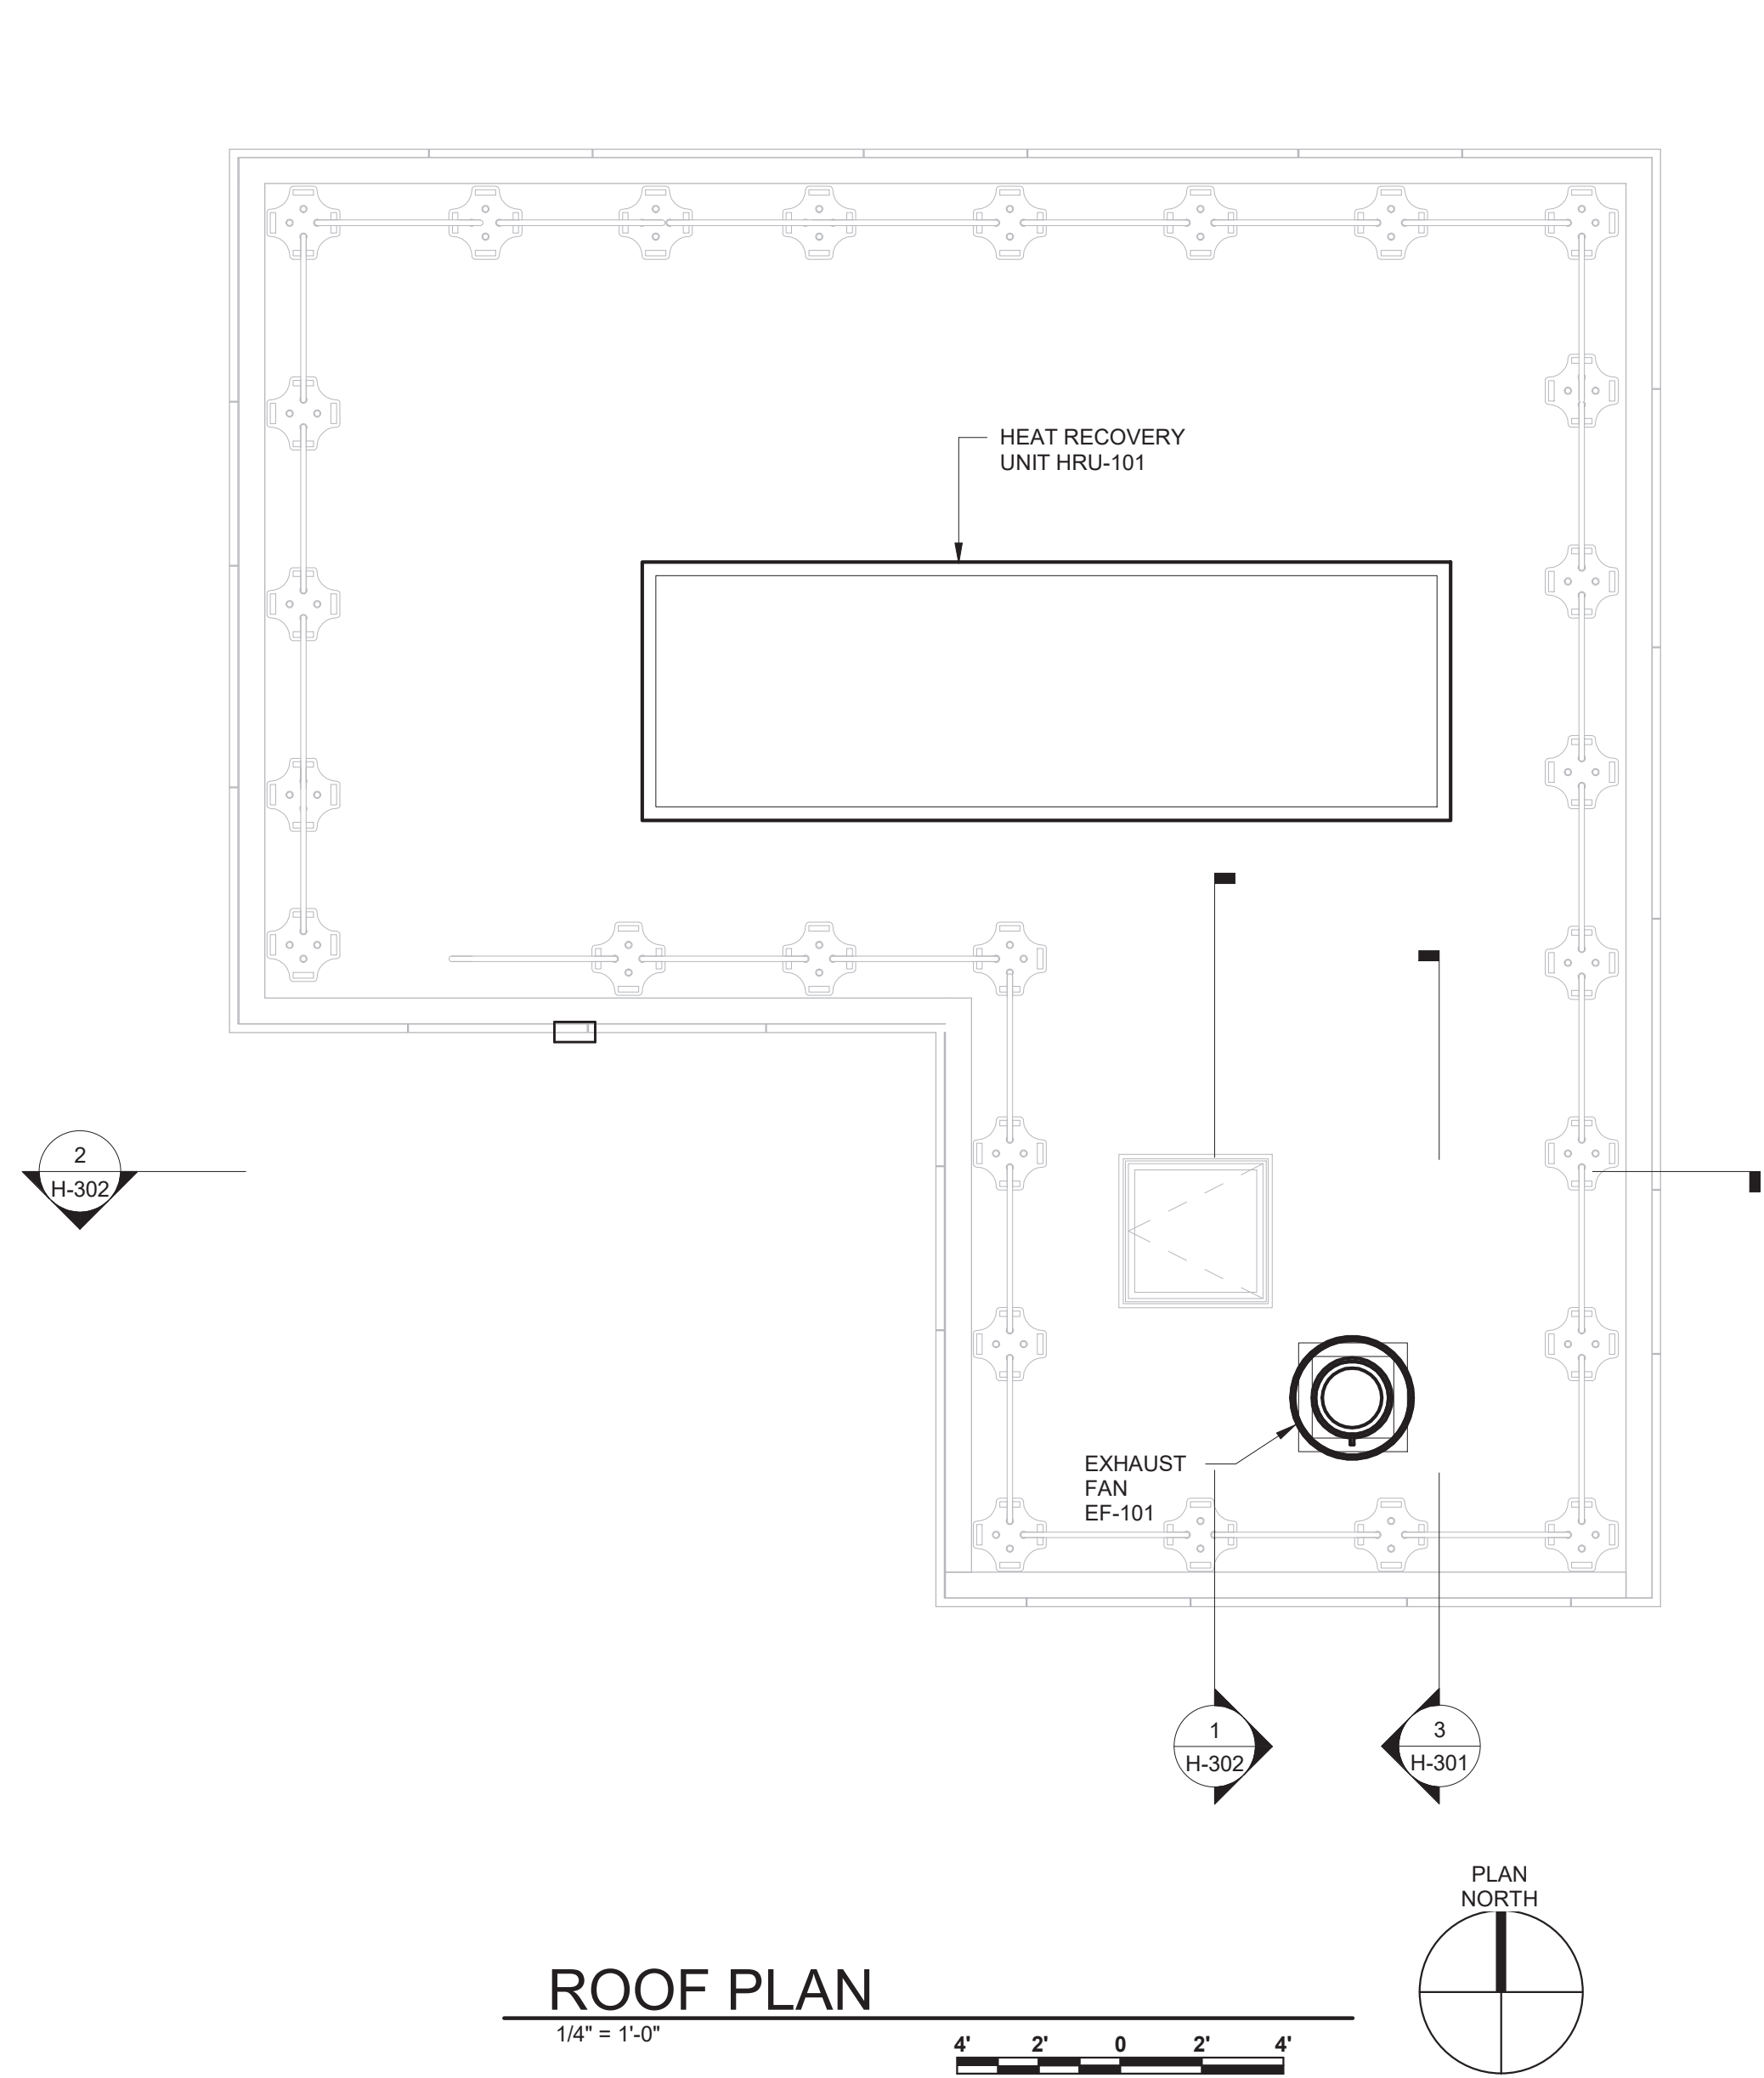

CONTROL SEQUENCE FOR INTERMITTENT VENTILATION IN WET WELL, SCREEN ROOM, AND SCREENING ROOM (SAF-101, EF-101):

PROVIDE SIGNAGE ABOVE SWITCHES, "INTERMITTENT VENTILATION SWITCH". INTERMITTENT VENTILATION WILL BE ACTIVATED WHEN SCREENING ROOM LIGHT IS TURNED ON OR WHEN STAIR LIGHT IS TURNED ON.

OFF: SYSTEM IS DE-ENERGIZED, FAN DAMPERS ARE CLOSED.

ON: SYSTEM DAMPERS OPEN, SAF-101 AND EF-101 MOTORS ARE ENERGIZED.

CONTROL SEQUENCE FOR CONTINUOUS VENTILATION IN DRY WELL: (HRU-101, LOW AIRFLOW SWITCH, DISCHARGE AIR TEMPERATURE SENSOR, INTEGRAL DAMPERS, CONTROL PANEL WITH ON-OFF-HAND SWITCH AND VISUAL AND AUDIBLE ALARMS):

PROVIDE SIGNAGE ABOVE CONTROL PANEL, "HRU-101 VENTILATION CONTROL PANEL".

OFF: SYSTEM IS DE-ENERGIZED, HRU-101 DAMPERS ARE CLOSED.

ON-(WINTER): HRU-101 DAMPERS OPEN, HRU-101 OPERATES AT 2500 CFM SUPPLY AND 2500 CFM EXHAUST.

HAND-(SUMMER): HRU-101 DAMPERS OPEN, HRU-101 OPERATES AT 10000 CFM EXHAUST MODULATE HEATING SECTION VIA SCR CONTROL TO 55F LEAVING AIR TEMPERATURE.



ALARMS (AUDIBLE AND VISUAL). SHOW AT PANEL ON WALL WITH SWITCH (ON-OFF-HAND SWITCH): LOW TEMPERATURE, LOW AIRFLOW SWITCH.


ABBREVIATIONS

AFF. ABOVE FINISHED FLOOR
CUH CABINET UNIT HEATER
EA EXHAUST AIR
EF EXHAUST FAN
ER EXHAUST REGISTER
EUH ELECTRIC UNIT HEATER
LV LOUVER
ERU ENERGY RECOVERY UNIT
SA SUPPLY AIR
SAF SUPPLY AIR FAN
SR SUPPLY REGISTER
RA RETURN AIR
VD VOLUME DAMPER

GENERAL NOTES



1. REFER TO SPECIFICATIONS FOR REGISTER SCHEDULE.

 Jul 16 2021 3:16 PM		IN ACCORDANCE WITH TITLE VIII, ARTICLE 145, SECTION 7209 (2) OF THE NEW YORK STATE EDUCATION LAW, IT IS A VIOLATION OF LAW FOR ANY PERSON UNLESS ACTING UNDER THE DIRECTION OF A LICENSED ENGINEER TO ALTER THIS DOCUMENT.		 O'BRIEN & GERE ENGINEERS, INC. 50 MAIN ST., 10TH FLOOR, SUITE 1000 WHITE PLAINS, NEW YORK 10606	
IN CHARGE OF T. ERWIN		CHECKED BY K. RADEMACHER			
MADE BY K. LABENSKI					
REVISION					
REVISION NUMBER	DATE	MADE BY	APP'D BY	REVISION	
RECORD DRAWING CERTIFICATION					
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CONTRACTOR			PROJECT COORDINATOR		
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SIGNATURE _____			SIGNATURE _____		
TITLE _____			TITLE _____		
DATE _____			DATE _____		
CONTRACT NUMBER 17-534			SHEET NUMBER H-101		
WESTCHESTER COUNTY, NEW YORK			SHEET NO. 51 OF 60		
DEPARTMENT OF PUBLIC WORKS AND TRANSPORTATION			SCALE: 1/4"=1'-0"		
DIVISION OF ENGINEERING			DATE: 12/21/2018		
CROTONVILLE PUMPING STATION REHABILITATION			DPW FILE NO.		
OSSINING SANITARY SEWER DISTRICT			208-03-H-75-0		
OSSINING, NEW YORK			REV. NO. 0		
MAIN LEVEL & ROOF PLANS					

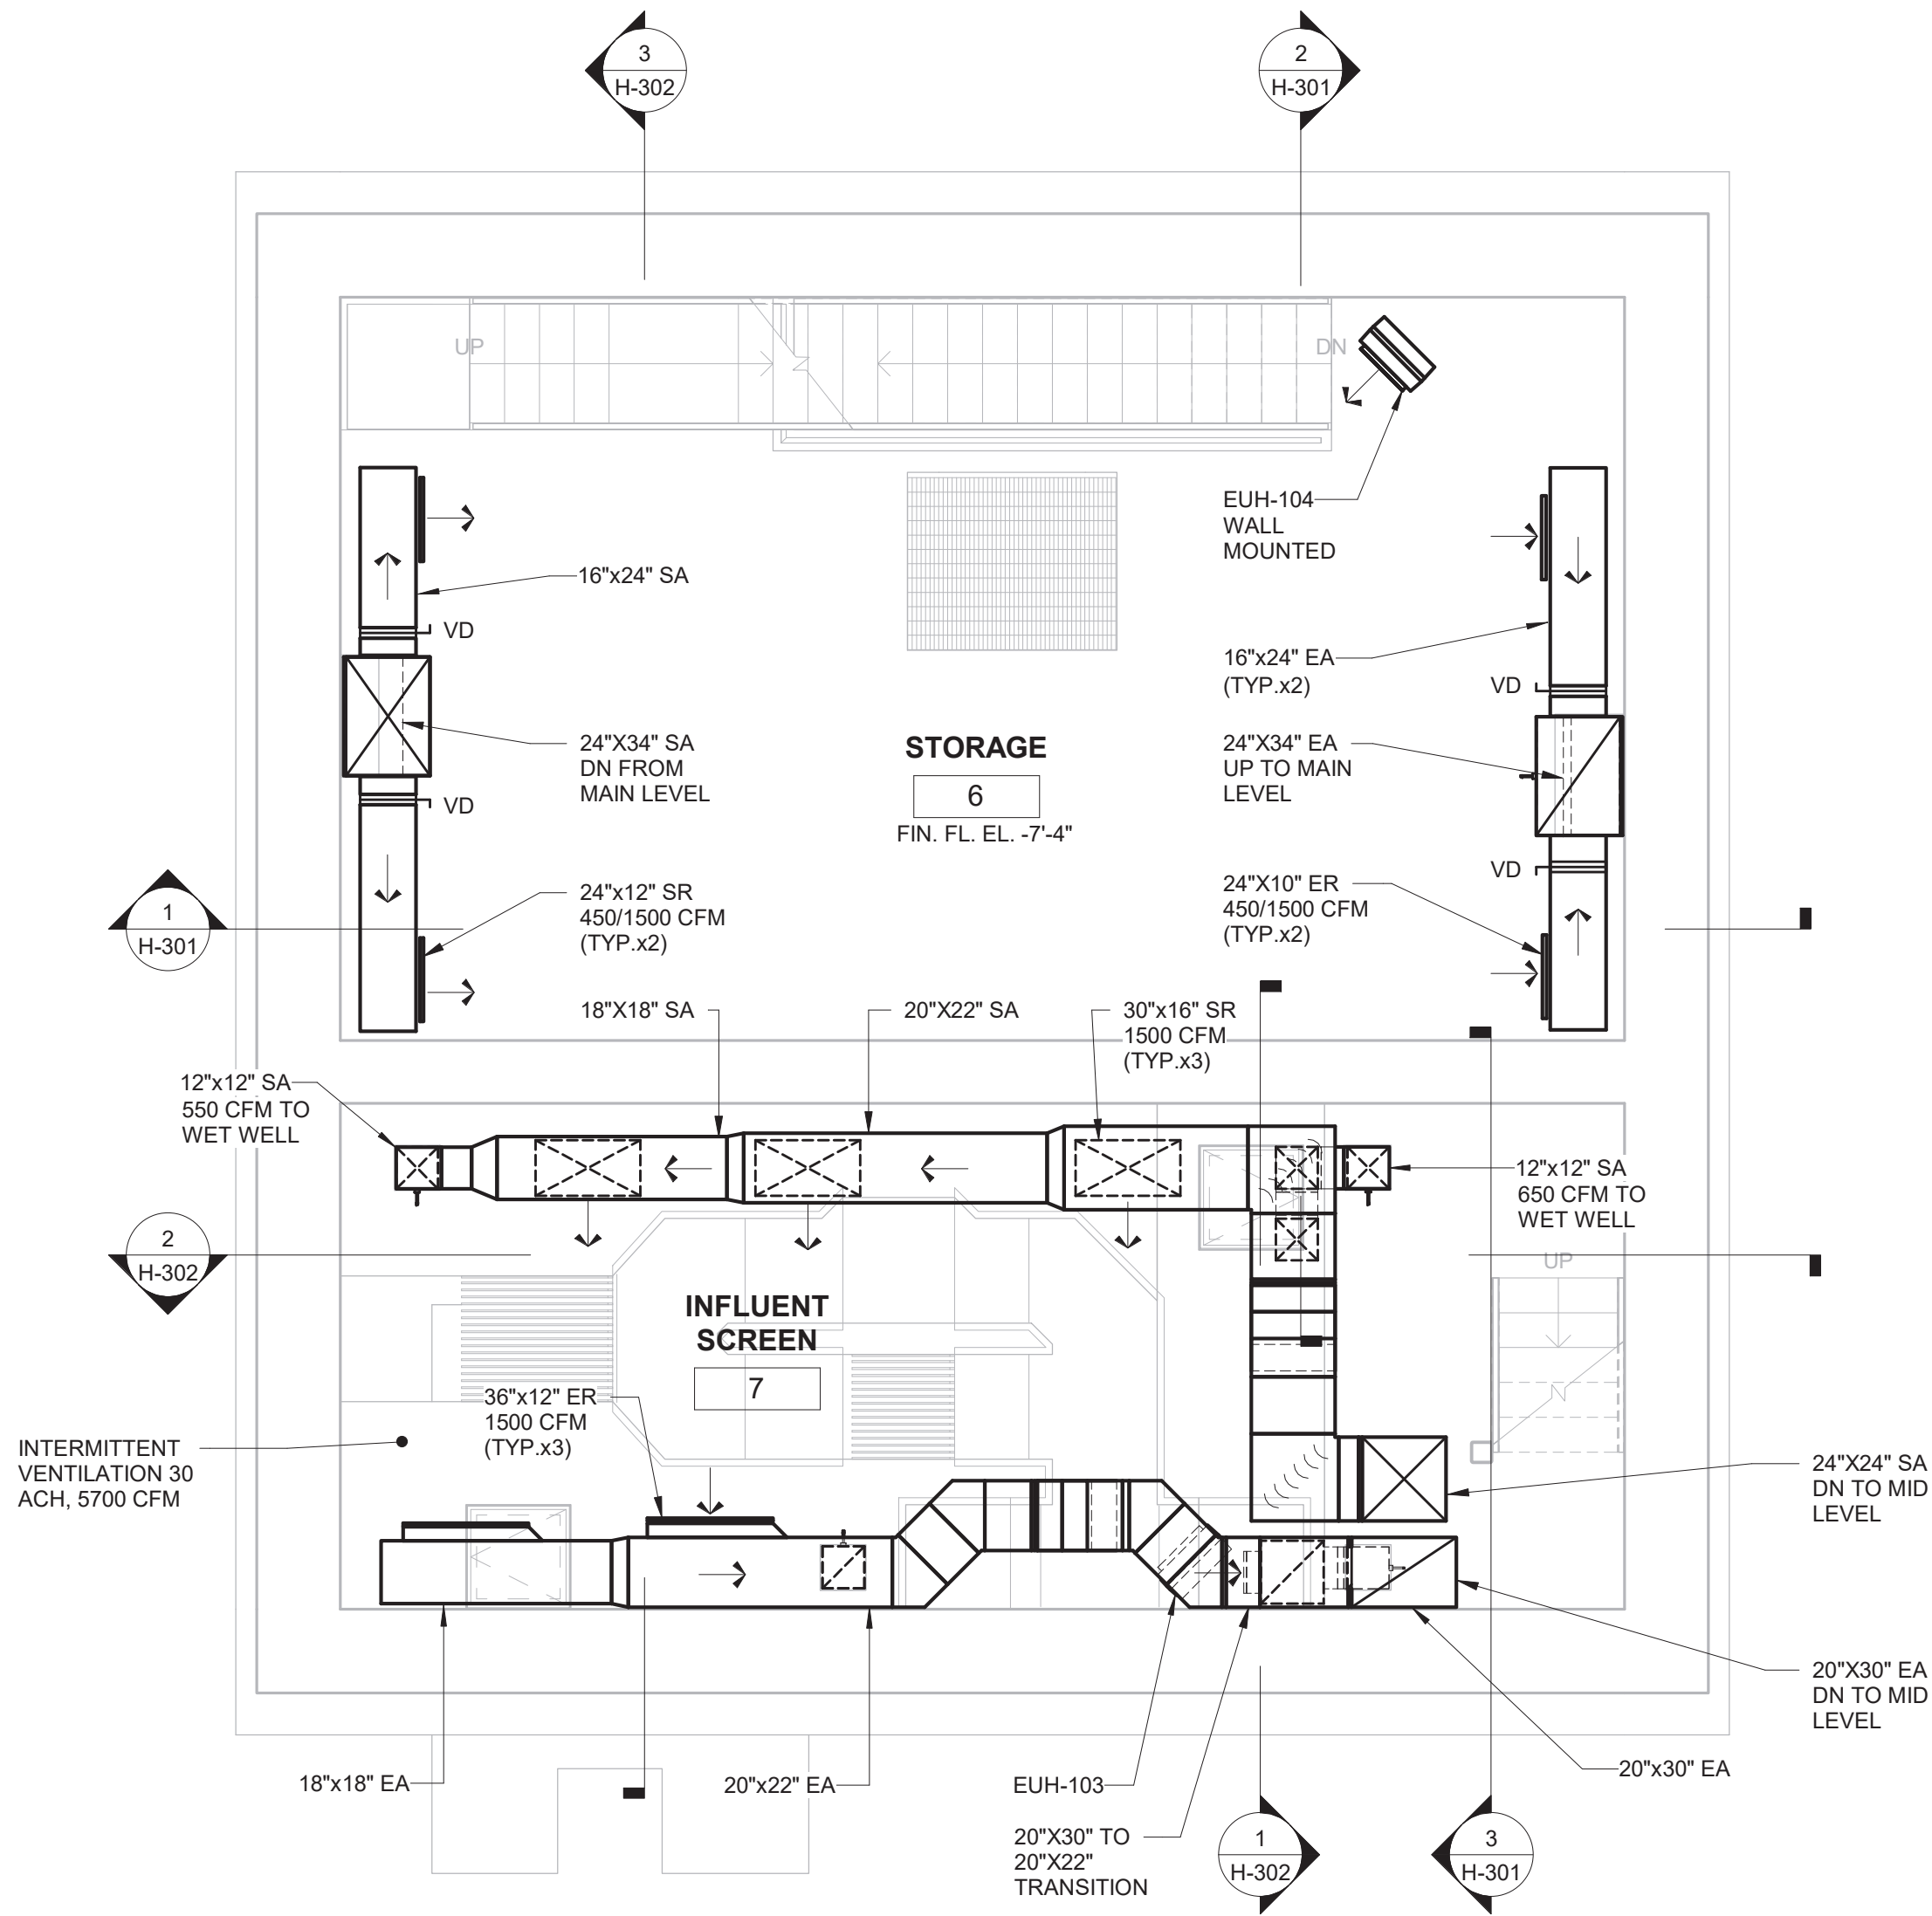



MIDDLE LEVEL FLOOR PLAN

1/4" = 1'-0"

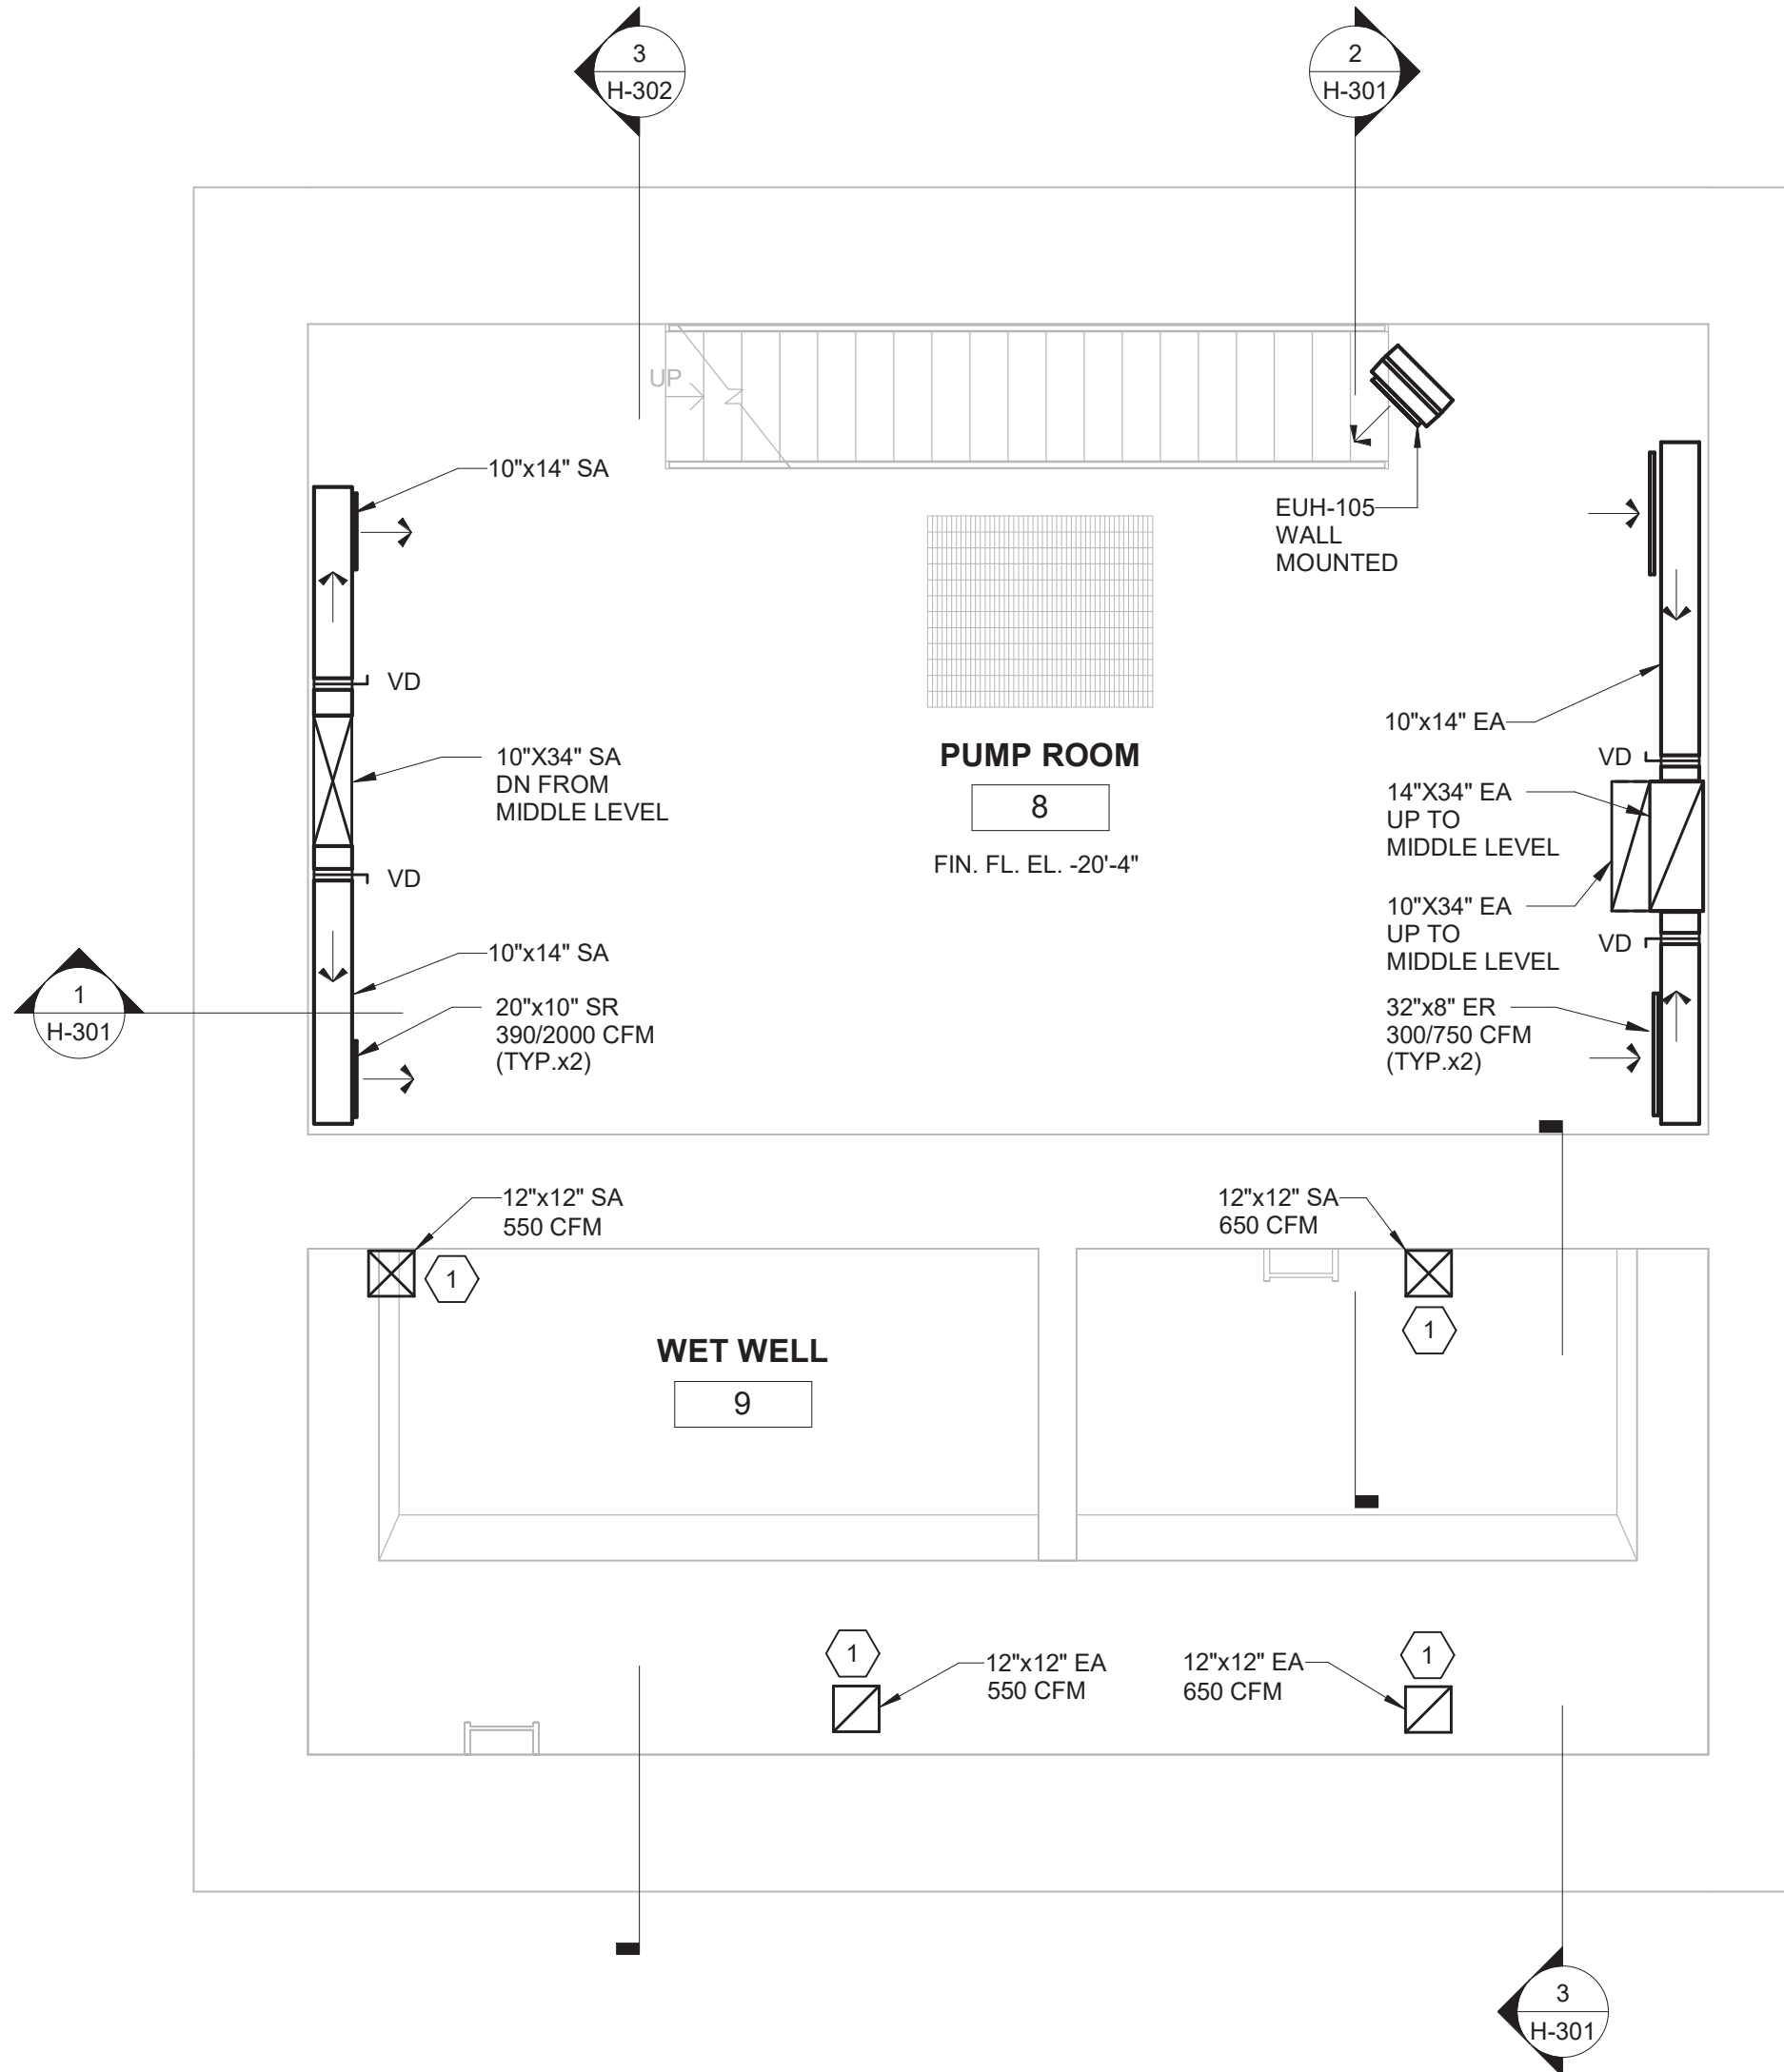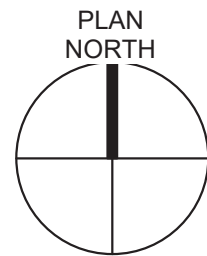

LOWER LEVEL FLOOR PLAN

1/4" = 1'-0"

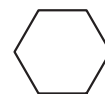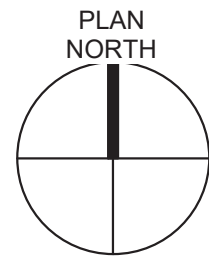

KEYED NOTES:

1. INSTALL WIRE MESH SCREEN AT TERMINATION OF DUCTWORK.



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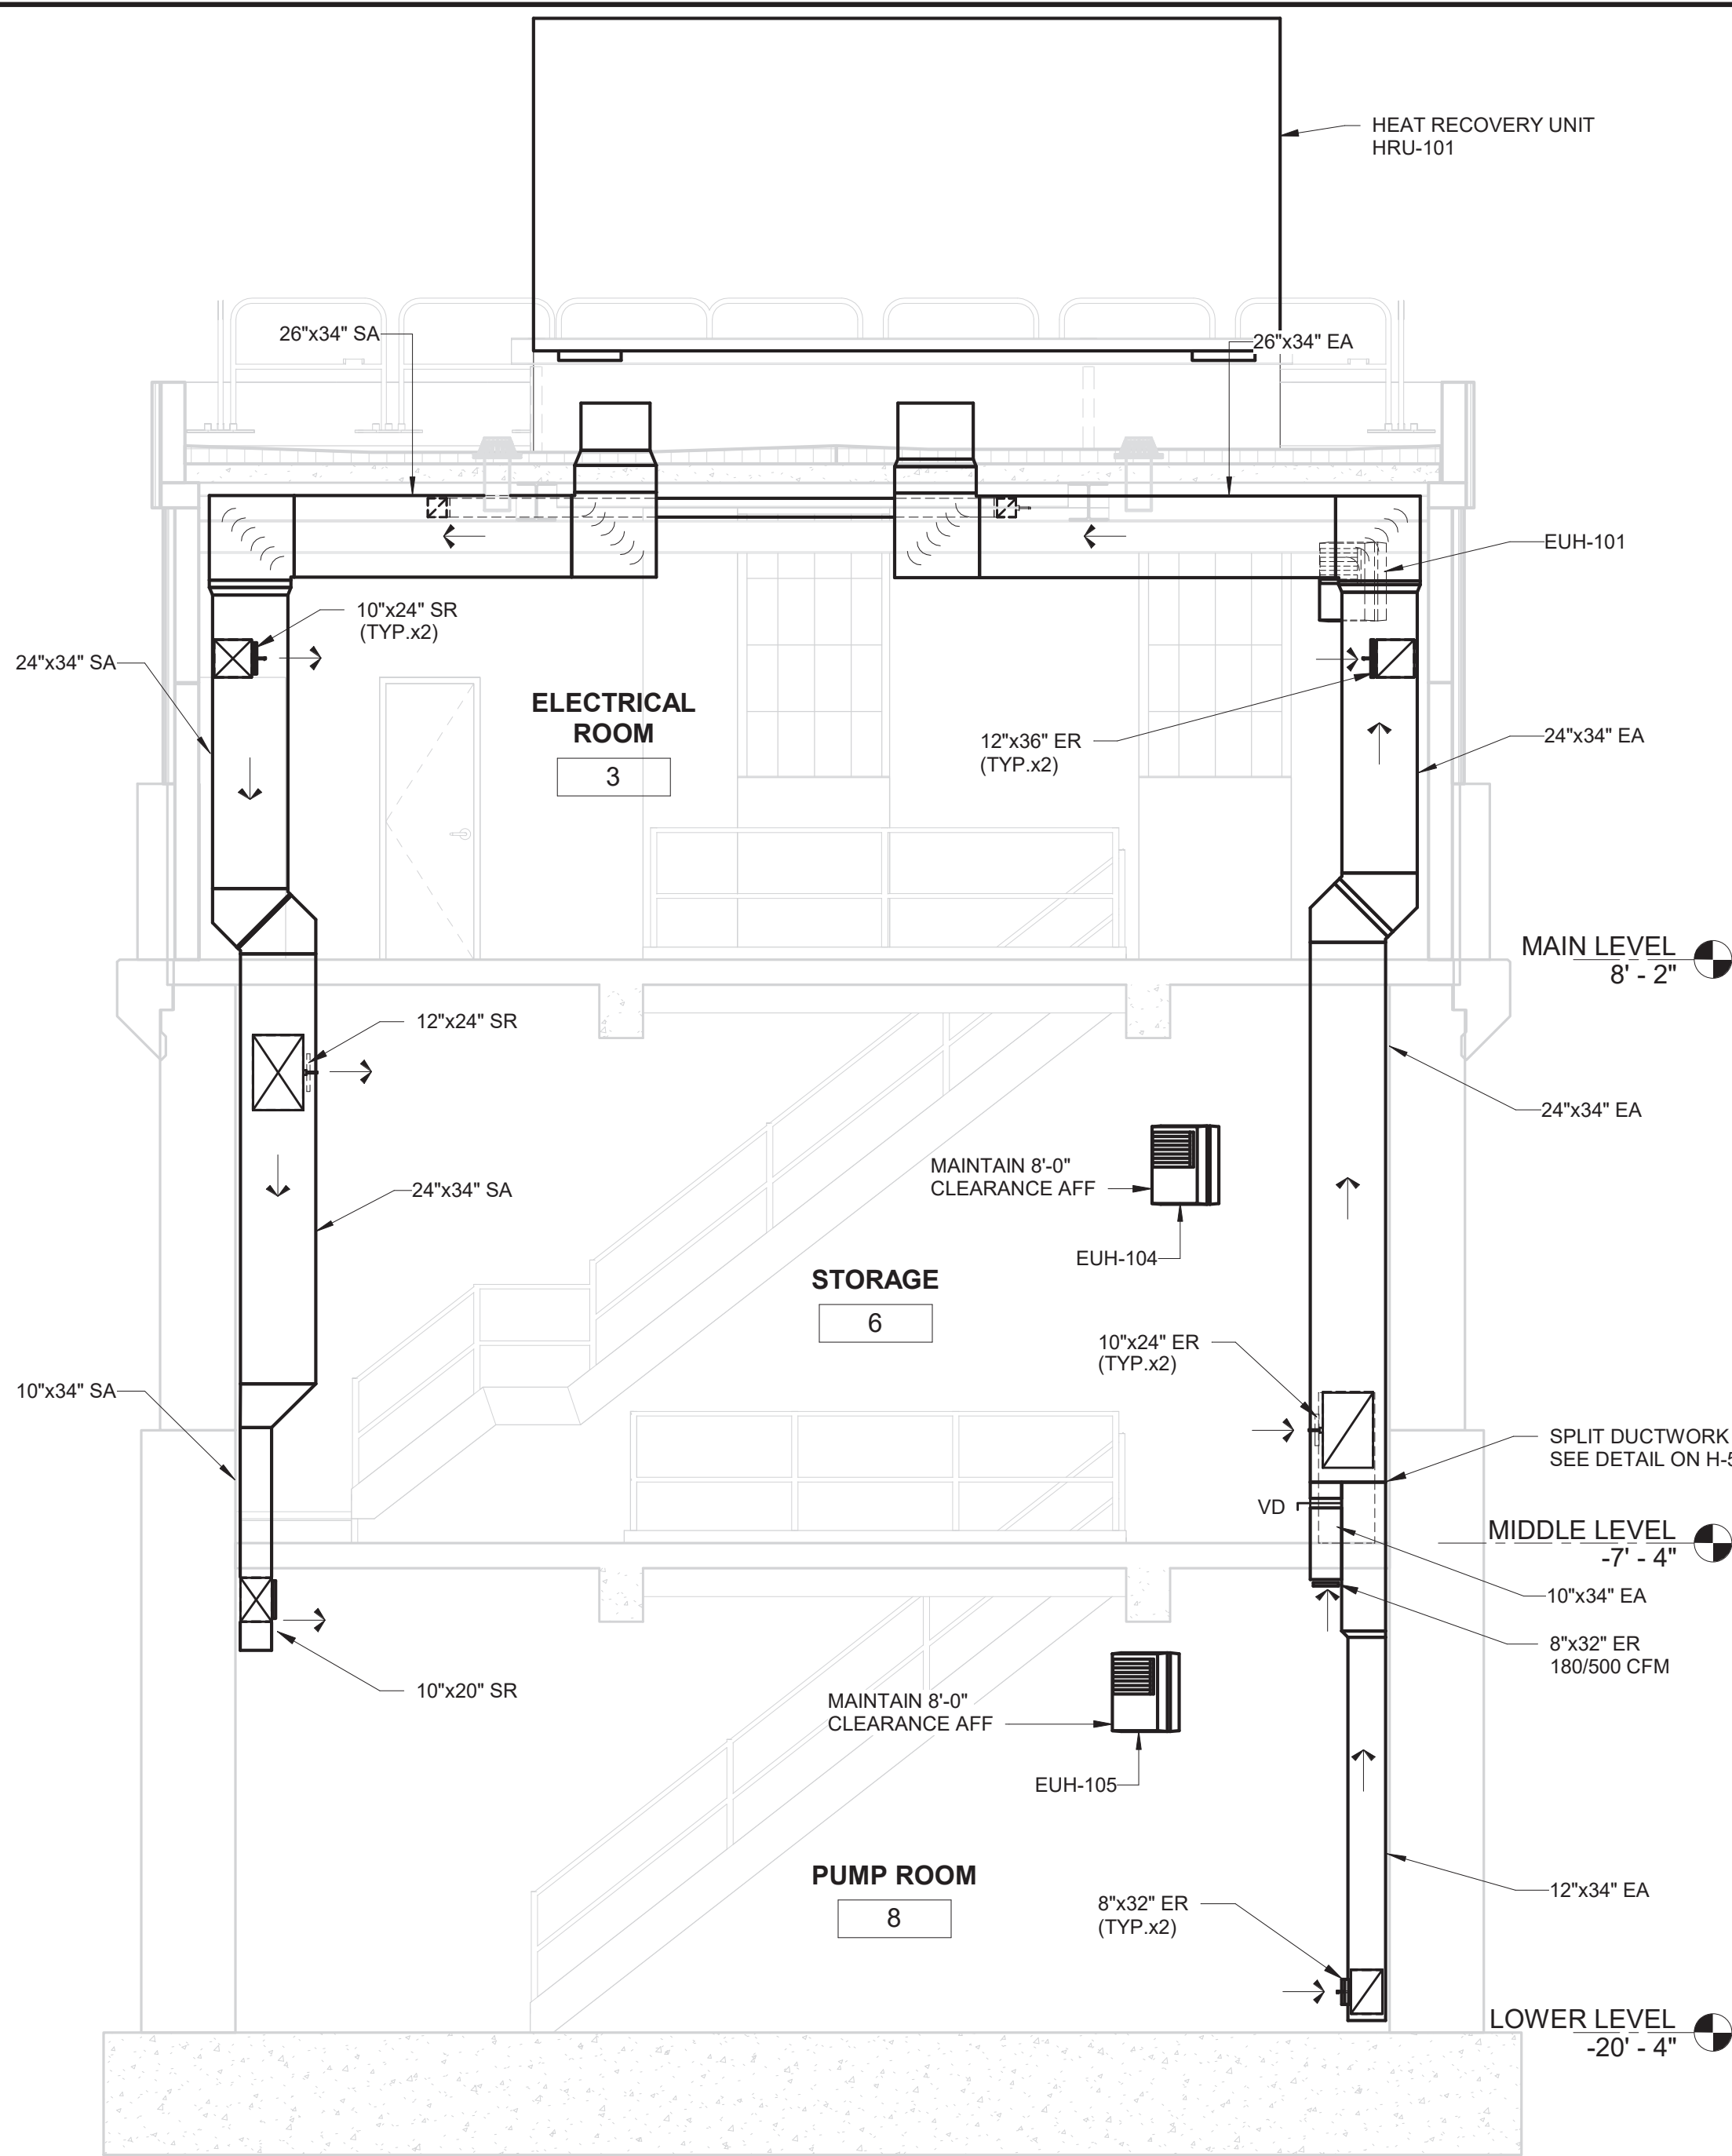
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MADE BY **K. LABENSKI**




O'BRIEN & GERE ENGINEERS, INC.
50 MAIN ST., 10TH FLOOR, SUITE 1000
WHITE PLAINS, NEW YORK 10606


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CONTRACTOR		PROJECT COORDINATOR		
NAME	SIGNATURE	NAME	SIGNATURE	DATE
TITLE		TITLE		
WESTCHESTER COUNTY, NEW YORK DEPARTMENT OF PUBLIC WORKS AND TRANSPORTATION DIVISION OF ENGINEERING				
CONTRACT NUMBER 17-534		SHEET NUMBER H-102		SHEET NO. 52 OF 60
CROTONVILLE PUMPING STATION REHABILITATION OSSINING SANITARY SEWER DISTRICT OSSINING, NEW YORK MIDDLE LEVEL & LOWER LEVEL PLANS		SCALE: 1/4"=1'-0" DATE: 12/21/2018 DPW FILE NO. 208-03-H-76-0		REV. NO. 0



1 SECTION
1/4" = 1'-0"

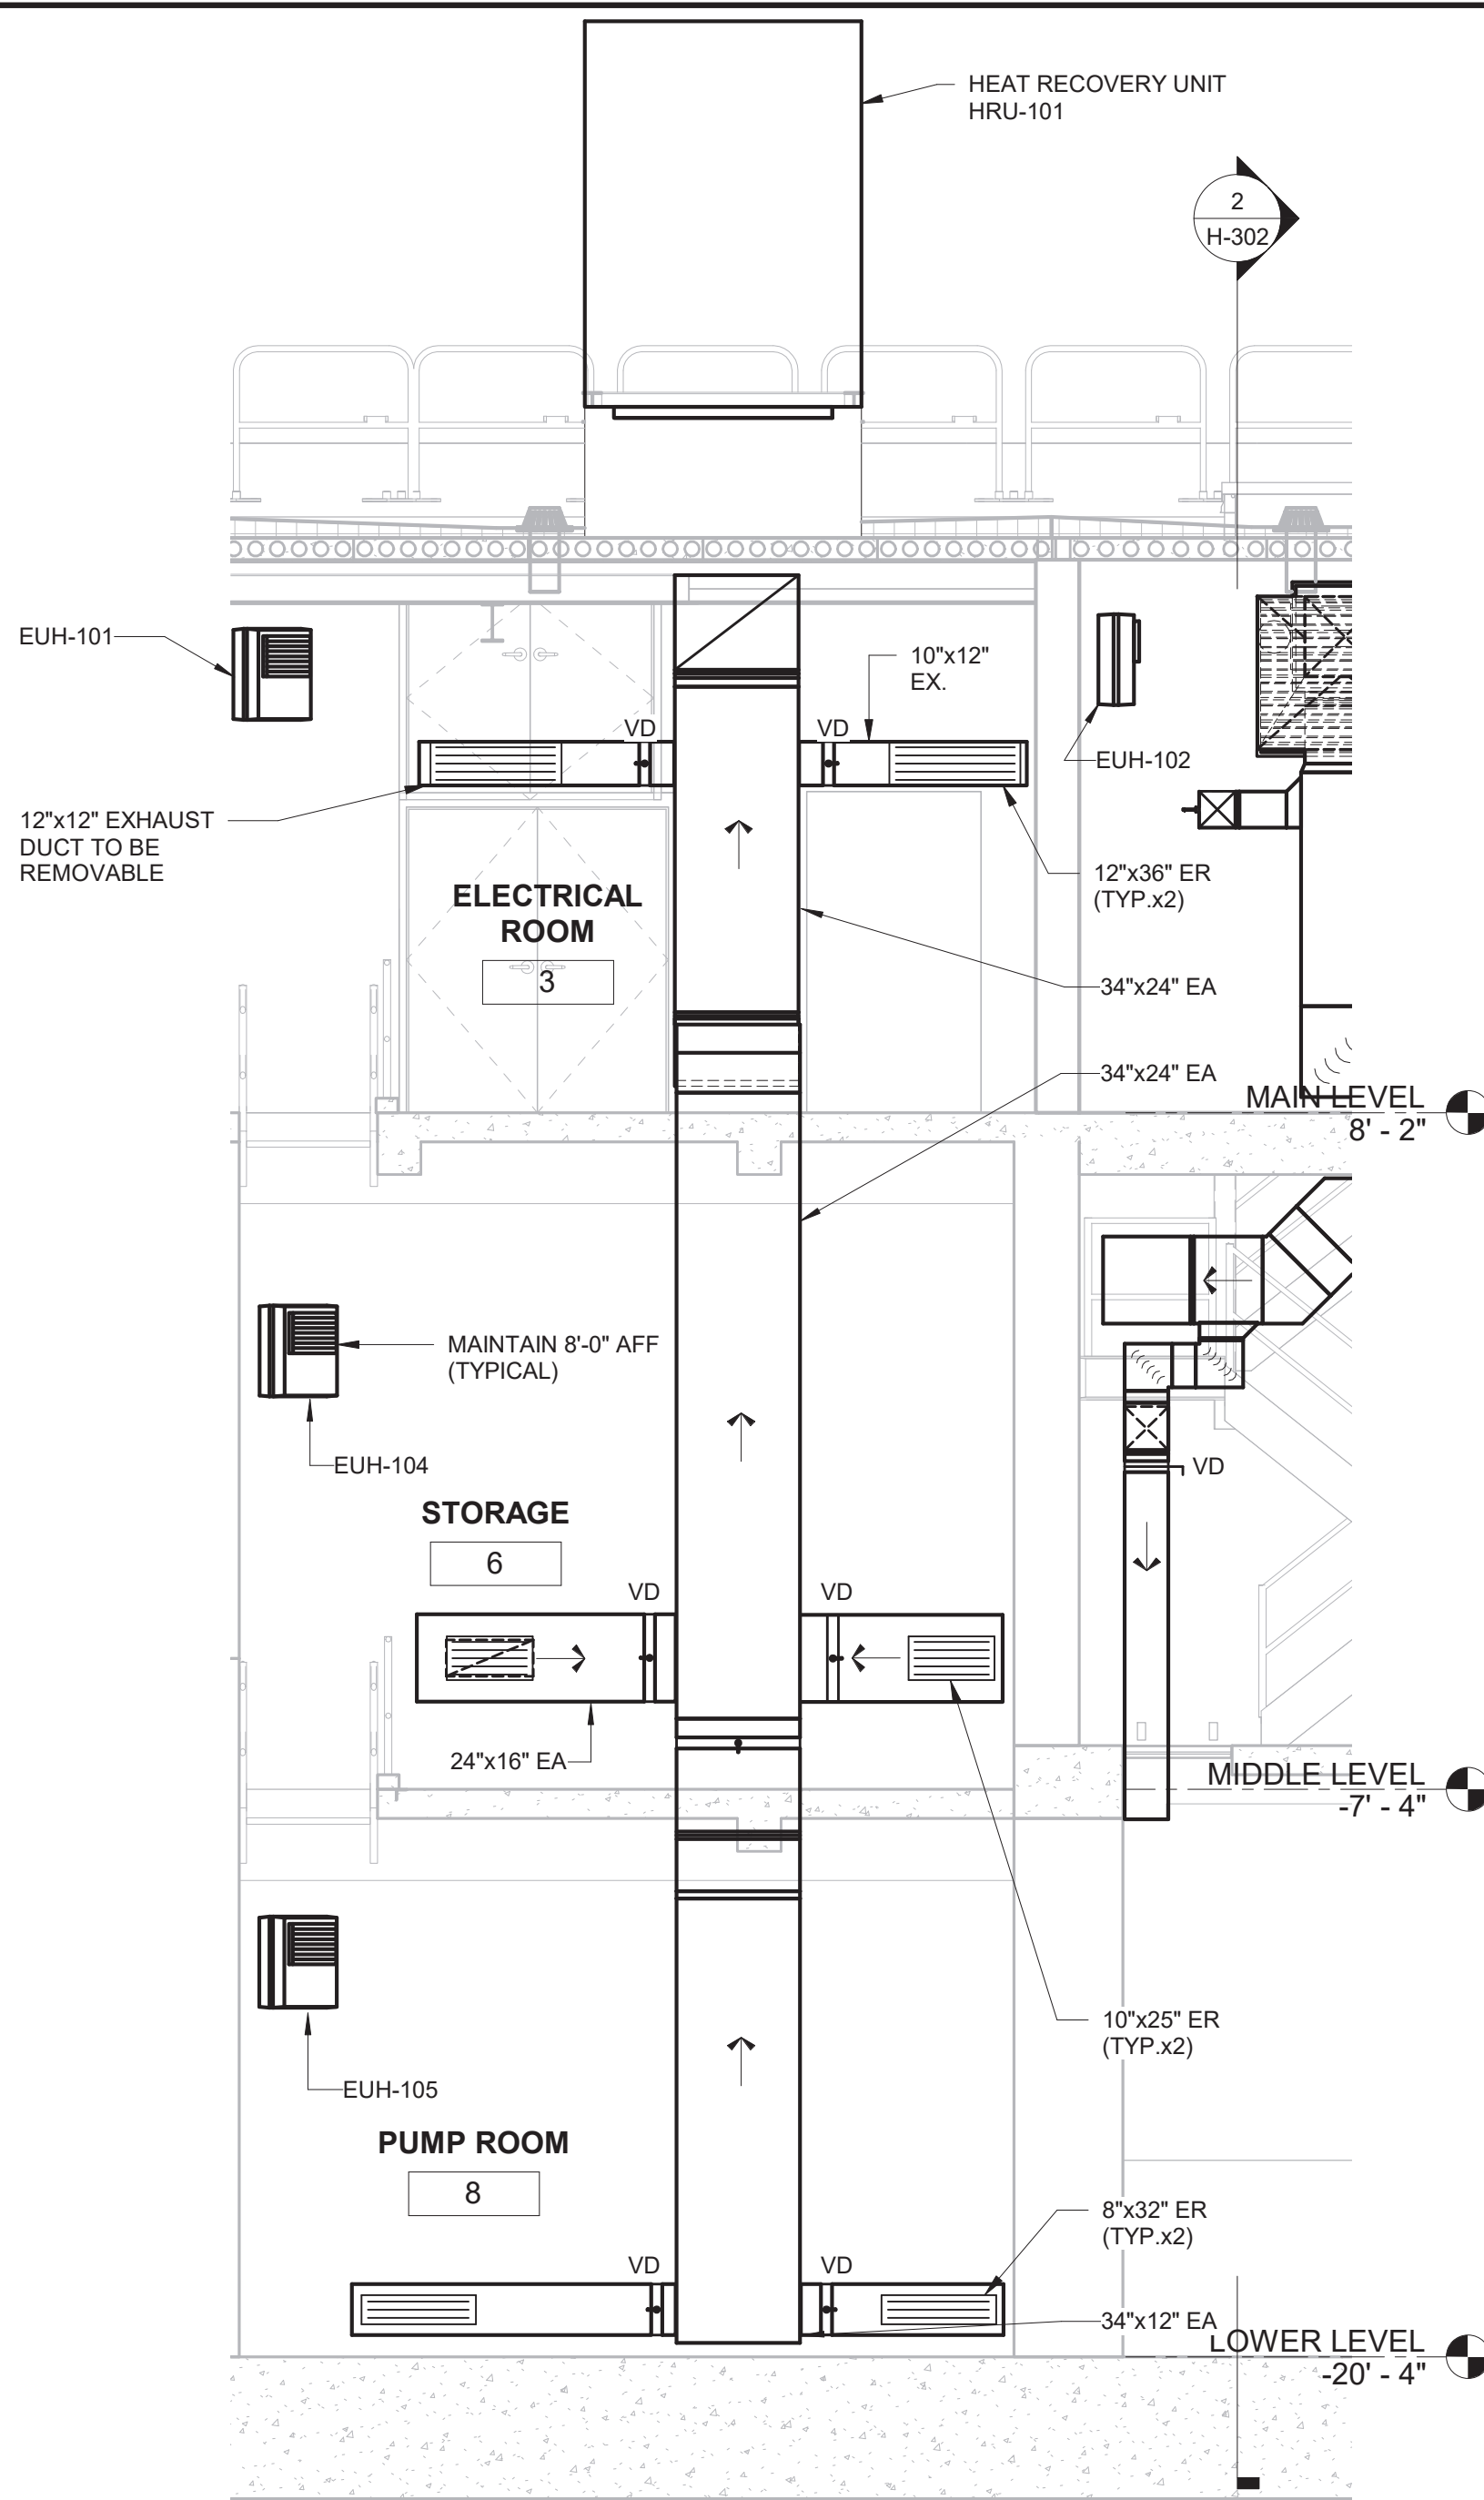

2 SECTION
1/4" = 1'-0"

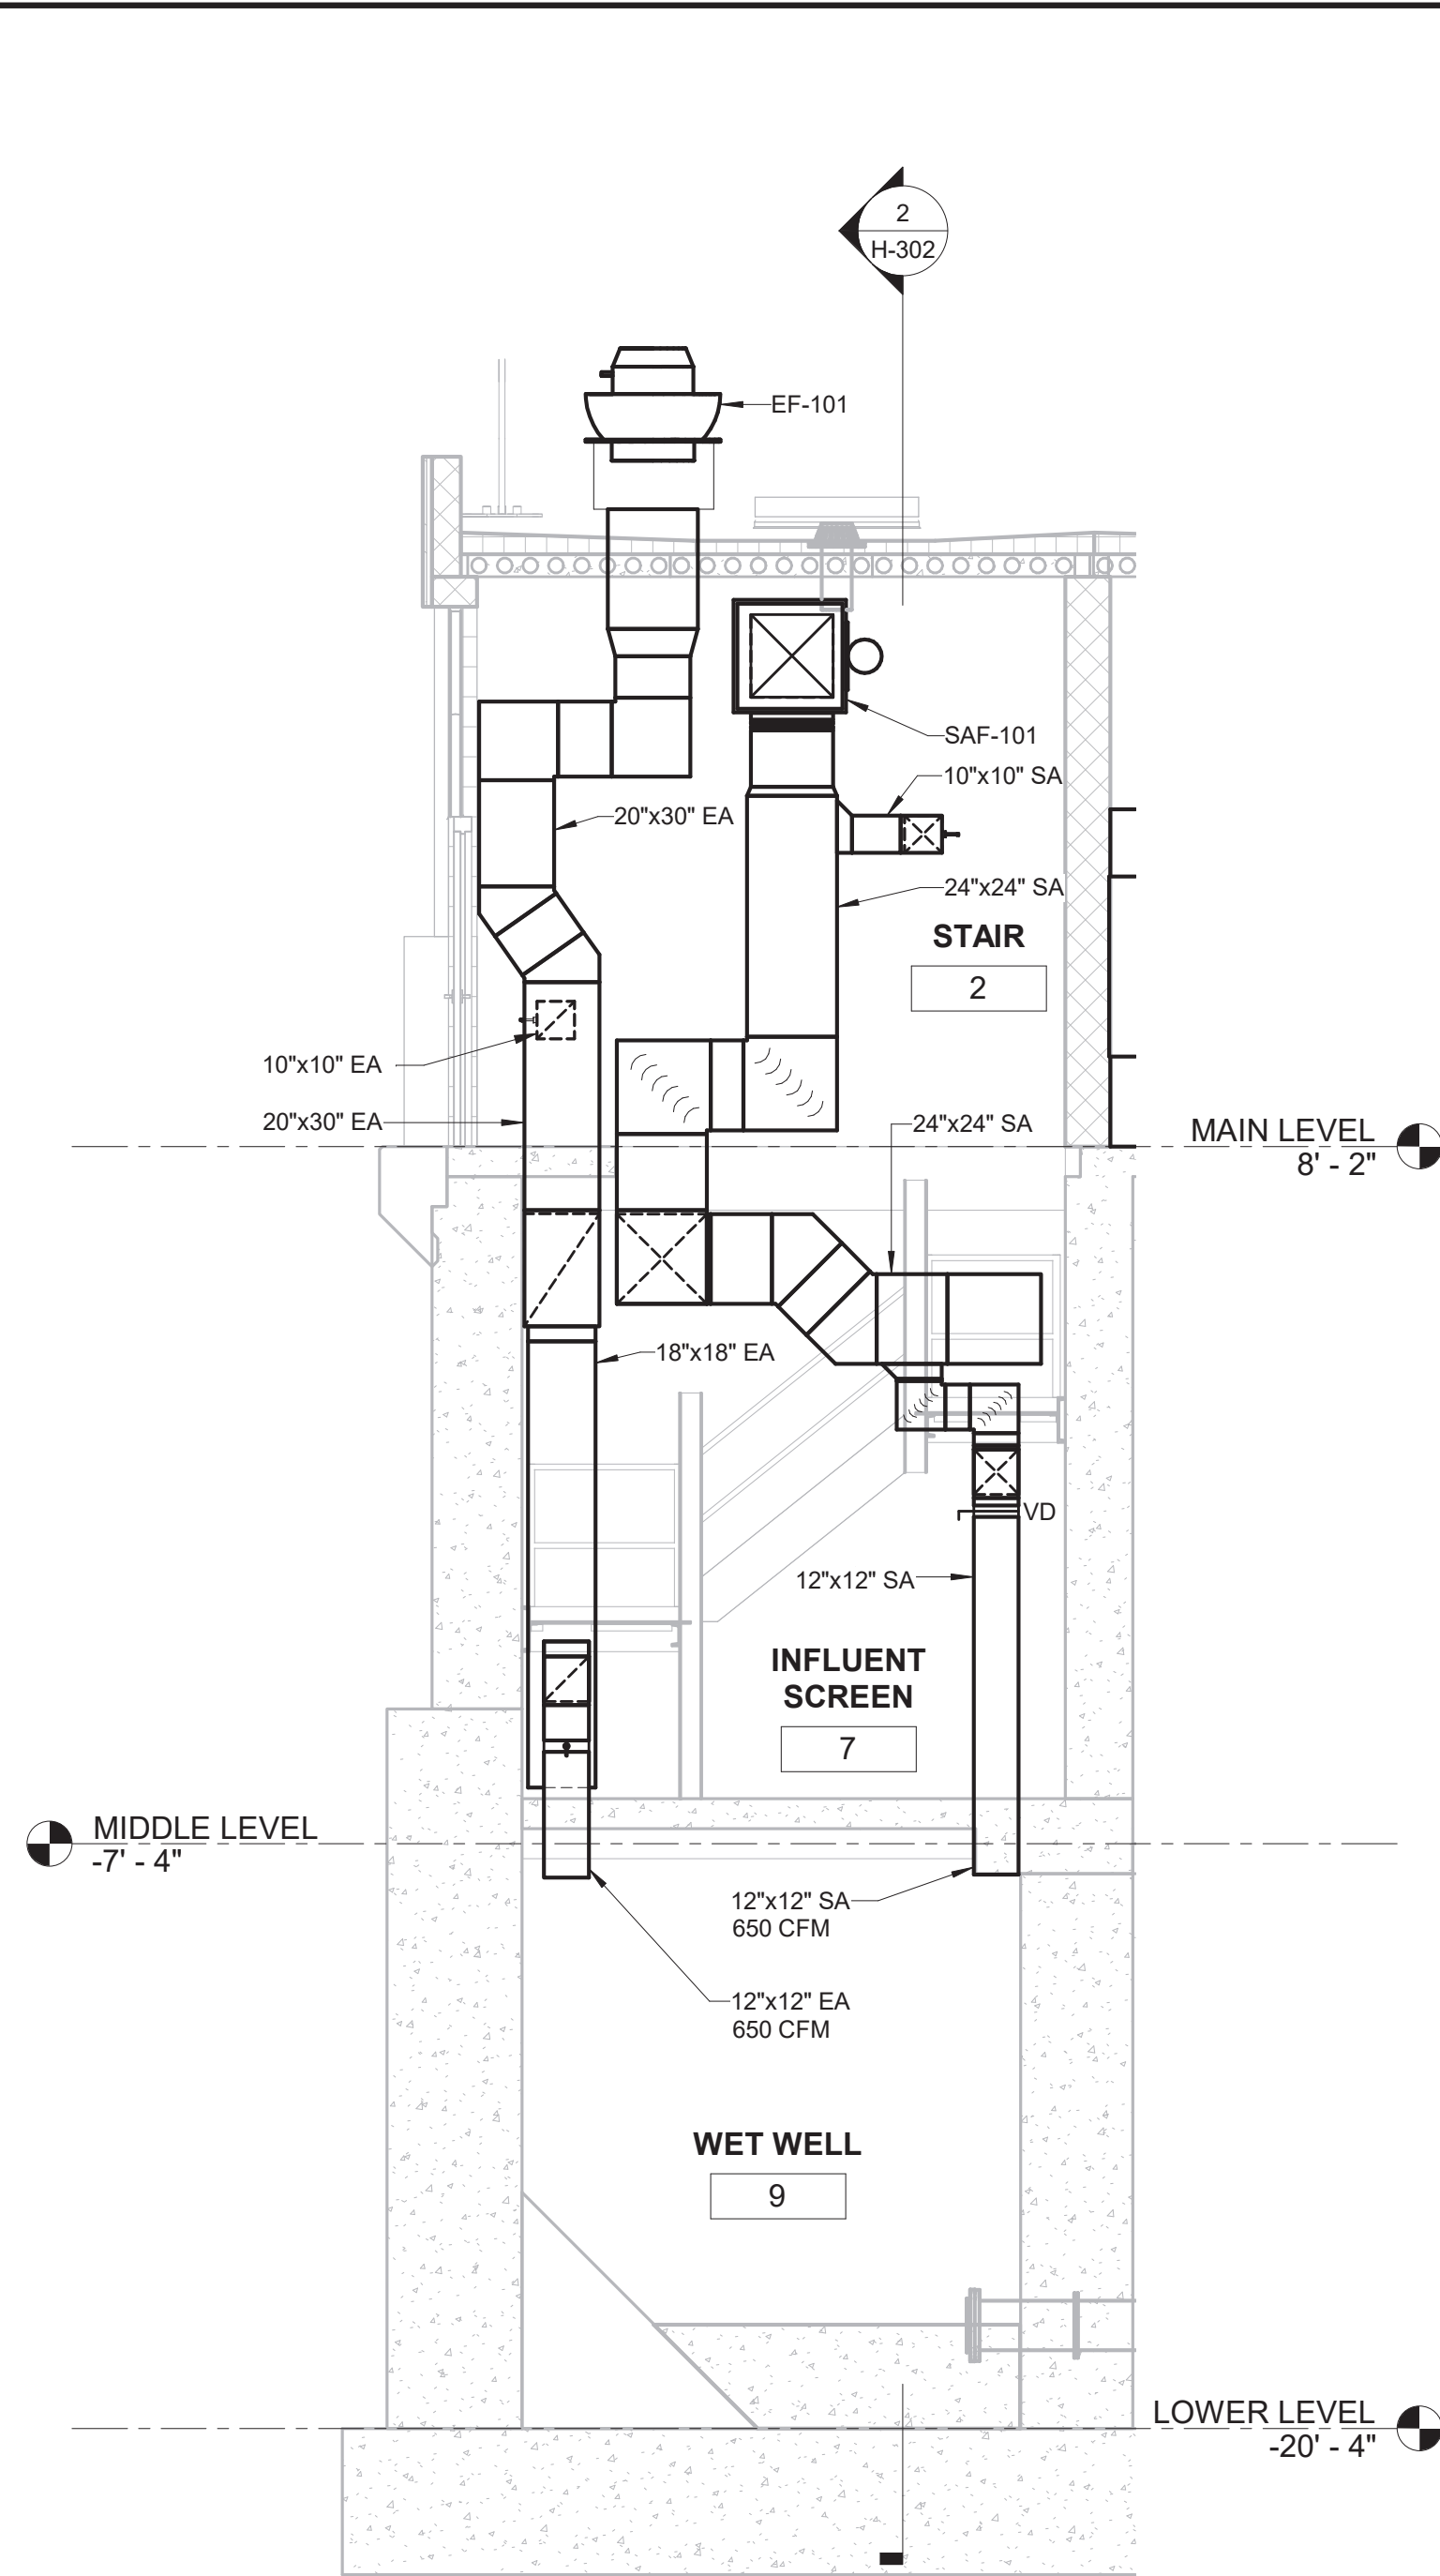

3 SECTION
1/4" = 1'-0"



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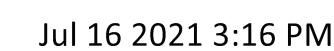
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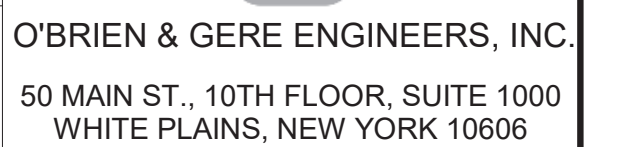


O'BRIEN & GERE ENGINEERS, INC.
50 MAIN ST., 10TH FLOOR, SUITE 1000
WHITE PLAINS, NEW YORK 10606


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CONTRACTOR					PROJECT COORDINATOR				
NAME _____					NAME _____				
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TITLE _____ DATE _____					TITLE _____ DATE _____				
WESTCHESTER COUNTY, NEW YORK									
DEPARTMENT OF PUBLIC WORKS AND TRANSPORTATION									
DIVISION OF ENGINEERING									
						CONTRACT NUMBER	17-534	SHEET NUMBER	H-301
						SHEET NO. 53 OF 60			
CROTONVILLE PUMPING STATION REHABILITATION OSSINING SANITARY SEWER DISTRICT OSSINING, NEW YORK SECTIONS						SCALE: 1/4"=1'-0"			
						DATE: 12/21/2018			
						DPW FILE NO.			
						208-03-H-77-0			
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

IN CHARGE OF T. ERWIN
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MADE BY K. LABENSKI



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TITLE _____ DATE _____			TITLE _____ DATE _____	
WESTCHESTER COUNTY, NEW YORK				CONTRACT NUMBER 17-534
DEPARTMENT OF PUBLIC WORKS AND TRANSPORTATION				SHEET NUMBER H-302
DIVISION OF ENGINEERING				SHEET NO. 54 OF 60
CROTONVILLE PUMPING STATION REHABILITATION				SCALE: 1/4"=1'-0"
OSSINSING SANITARY SEWER DISTRICT				DATE: 12/21/2018
OSSINSING, NEW YORK				DPW FILE NO.
SECTIONS				208-03-H-78-0
				REV. NO. 0

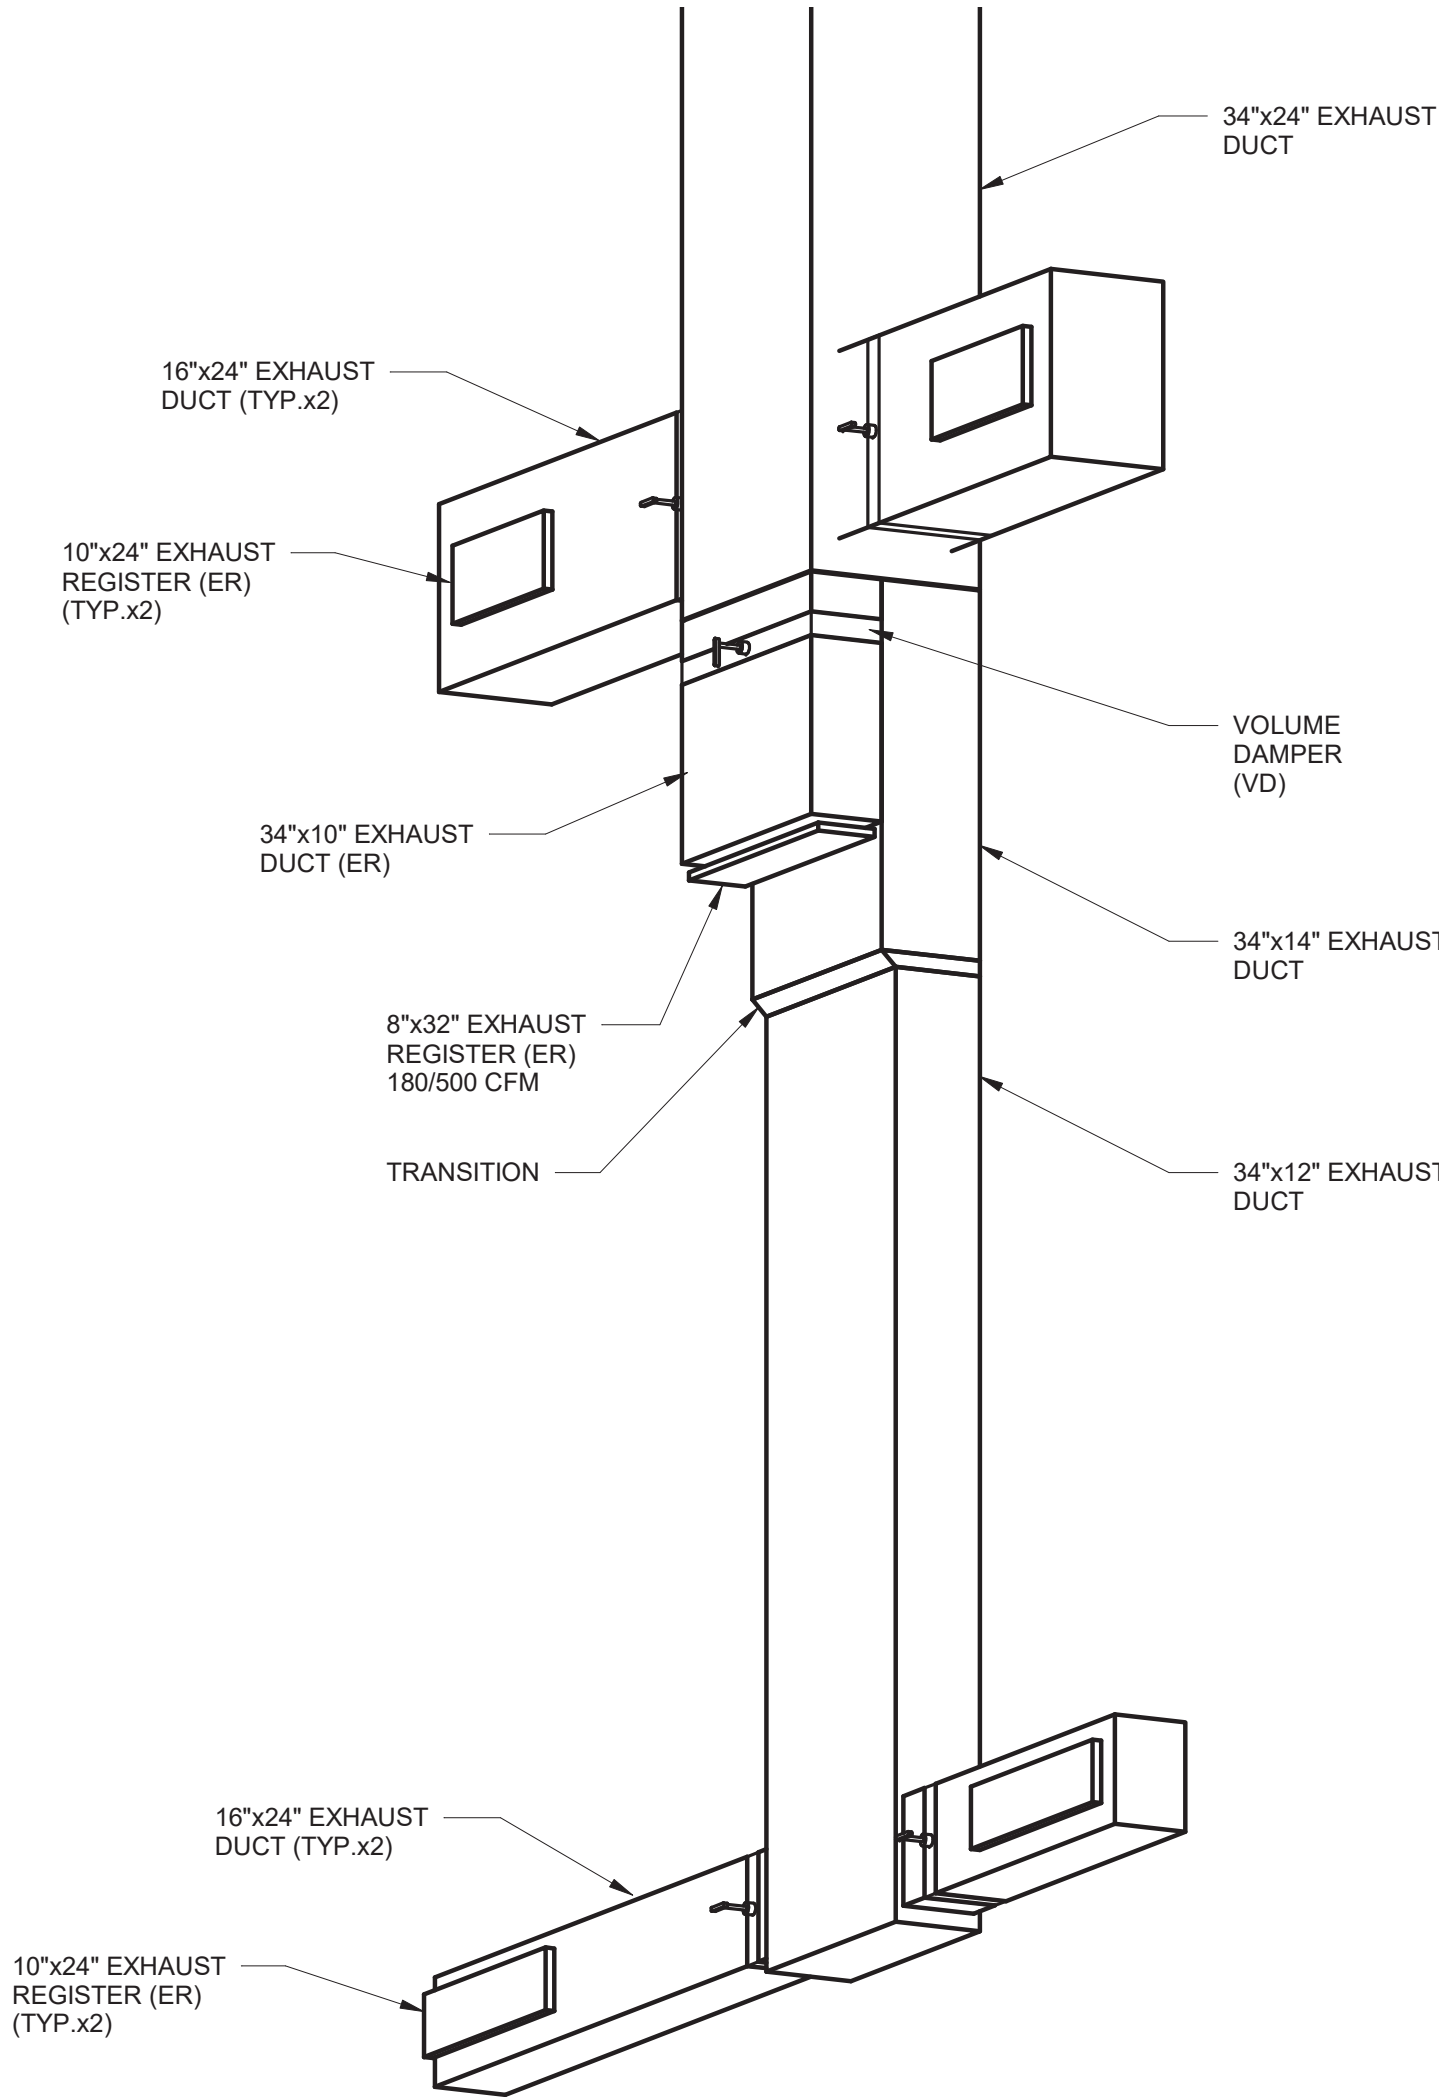

SPLIT DUCTWORK DETAIL
NOT TO SCALE

 Jul 16 2021 3:16 PM	IN ACCORDANCE WITH TITLE VIII, ARTICLE 145, SECTION 7209 (2) OF THE NEW YORK STATE EDUCATION LAW, IT IS A VIOLATION OF LAW FOR ANY PERSON UNLESS ACTING UNDER THE DIRECTION OF A LICENSED ENGINEER TO ALTER THIS DOCUMENT.		 O'BRIEN & GERE ENGINEERS, INC. 50 MAIN ST., 10TH FLOOR, SUITE 1000 WHITE PLAINS, NEW YORK 10606	
	IN CHARGE OF <u>T. ERWIN</u>			
	CHECKED BY <u>K. RADEMACHER</u>			
	MADE BY <u>K. LABENSKI</u>			
REVISION NUMBER	DATE	MADE BY	APP'D BY	REVISION
RECORD DRAWING CERTIFICATION				
<input type="checkbox"/> AS BUILT - CHANGES AS NOTED				
<input type="checkbox"/> AS BUILT - NO CHANGES				
CONTRACTOR			PROJECT COORDINATOR	
NAME _____			NAME _____	
SIGNATURE _____			SIGNATURE _____	
TITLE _____ DATE _____			TITLE _____ DATE _____	
WESTCHESTER COUNTY, NEW YORK DEPARTMENT OF PUBLIC WORKS AND TRANSPORTATION DIVISION OF ENGINEERING				CONTRACT NUMBER 17-534
				SHEET NUMBER H-501
CROTONVILLE PUMPING STATION REHABILITATION OSSINING SANITARY SEWER DISTRICT OSSINING, NEW YORK DETAILS				SHEET NO. 55 OF 60 SCALE: N.T.S. DATE: 12/21/2018 DPW FILE NO. 208-03-H-79-0
				REV. NO. 0

HEAT RECOVERY UNIT (HRU) SCHEDULE												
NO.	LOCATION	HEATING DATA			EXTERNAL STATIC (IN WC)	TOTAL STATIC (IN WC)	SUPPLY FAN		EXHAUST FAN		VOLTS/ PHASE	REMARKS
		ELECTRIC COIL					CFM	HP	CFM	HP		
		MN FACE AREA FT SQ	NOMINAL CAP (KW)	V/M/PH								
HRU-101	ROOF	6.43	55	460/60/3	0.75	1.5	SEE REMARK 1, 2	(2) 5	SEE REMARK 1, 2	(2) 5	460/3	1, 2, 3, 4, 5

REMARKS:

1. HRU TO SUPPLY 10,000 CFM IN SUMMER.
2. HRU TO SUPPLY 2,500 CFM IN WINTER.
3. SINGLE POINT OF ELECTRICAL CONNECTION.
4. PROVIDE WITH DISCHARGE AIR TEMPERATURE SENSORS, INTEGRAL DAMPERS, CONTROL PANEL FOR CONTROLS INCLUDING VISUAL AND AUDIBLE ALARMING IN ACCORDANCE WITH SEQUENCE OF OPERATION. ON-AUTO-OFF SWITCH FOR SUMMER, WINTER, OFF OPERATION.
5. PROVIDE WITH MANUFACTURER SUPPLIED VFDFOR SUPPLY AND EXHAUST FANS, INTEGRAL TO HRU CABINET WITH SINGLE POINT CONNECTION .

SUPPLY AIR FAN (SAF) SCHEDULE							
NO.	BUILDING	LOCATION	AIR FLOW (CFM)	S.P. (IN WC)	FAN MOTOR		REMARKS
					HP	VOLTS/PHASE	
SAF-101	WET WELL	ROOF	6,230	1.0	3	460/3	1,2,3

REMARKS:

1. NEMA 7 EXPLOSION PROOF MOTOR.
2. ALUMINUM CONSTRUCTION.
3. PROVIDE WITH INTEGRAL NEMA 7 EXPLOSION PROOF DAMPER. DAMPER SHALL BE 120V, POWER OPEN / SPRING CLOSE, AND INCLUDE AN END SWITCH.

EXHAUST FAN (EF) SCHEDULE							
NO.	LOCATION	AIR FLOW (CFM)	S.P. (IN WC)	HP	VOLTS/PHASE	DRIVE	REMARKS
EF-101	ROOF, WET WELL	6,230	1.0	2	460/3	BELT	1,2,3

REMARKS:

1. NEMA 7 EXPLOSION PROOF MOTOR.
2. TYPE B SPARK RESISTANT PER AMCA STANDARD 99-0401.
3. PROVIDE WITH INTEGRAL NEMA 7 EXPLOSION PROOF DAMPER. DAMPER SHALL BE 120V, POWER OPEN / SPRING CLOSE, AND INCLUDE AN END SWITCH.

FACILITY VENTILATION RATE SCHEDULE		
ROOM OR AREA	VENTILATION TYPE	MINIMUM AIR CHANGES PER HOUR (ACH)
WET WELL	INTERMITTENT	30
SCREENINGS ROOM	INTERMITTENT	30
INFLUENT SCREENINGS ROOM	INTERMITTENT	30
STAIR	INTERMITTENT	30
DRY WELL	CONTINUOUS	6
ELECTRIC ROOM	CONTINUOUS	6

LOUVER (LV) SCHEDULE									
NO.	DIMENSIONS		TYPE	DUTY	MAKE	MODEL	FREE AREA	SCREEN TYPE	REMARKS
	WIDTH	HEIGHT							
LV-101	4'-0"	3'-6"	INTAKE	FIXED	CONSTRUCTION SPECIALTIES	A6177	57.6%	BIRDSCREEN	1



REMARKS:


1. PROVIDE WITH PHENOLIC HERESITE COATING.

ELECTRIC UNIT HEATER (EUH) SCHEDULE					
NO.	LOCATION	MINIMUM HEATING CAPACITY (KW)	VOLTS/PHASE	MOUNTING HEIGHT	REMARKS
EUH-101	ELECTRICAL ROOM, MAIN LEVEL	5	460/3	9'-0"	1,4,5,6
EUH-102	STAIR, MAIN LEVEL	5	460/3	9'-4"	1,2,3,4,5,6
EUH-103	INFLUENT SCREEN, MIDDLE LEVEL	5	460/3	8'-0"	1,2,3,4,5,6
EUH-104	STORAGE, MIDDLE LEVEL	3	460/3	9'-0"	1,4,5,6
EUH-105	PUMP ROOM, LOWER LEVEL	3	460/3	8'-0"	1,4,5,6
CUH-101	REST ROOM, MAIN LEVEL	2	120/1	0'-2"	4,5,7

REMARKS:

1. INSTALL WITH HORIZONTAL DISCHARGE.
2. NEMA 7 EXPLOSION PROOF MOTOR.
3. TYPE B SPARK RESISTANT PER AMCA 99-0401 STD.
4. INTEGRAL THERMOSTAT.
5. ELEVATION FROM THE FINISHED FLOOR TO THE BOTTOM OF THE UNIT.
6. WALL MOUNTED.
7. SEMI-RECESSED, WALL MOUNTED.

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REVISION NUMBER	DATE	MADE BY	APP'D BY	REVISION
RECORD DRAWING CERTIFICATION				
<input type="checkbox"/> AS BUILT - CHANGES AS NOTED <input type="checkbox"/> AS BUILT - NO CHANGES				
CONTRACTOR		PROJECT COORDINATOR		
NAME _____	NAME _____			
SIGNATURE _____	SIGNATURE _____			
TITLE _____	TITLE _____	DATE _____		
WESTCHESTER COUNTY, NEW YORK DEPARTMENT OF PUBLIC WORKS AND TRANSPORTATION DIVISION OF ENGINEERING		CONTRACT NUMBER 17-534	SHEET NUMBER H-601	
CROTONVILLE PUMPING STATION REHABILITATION OSSINING SANITARY SEWER DISTRICT OSSINING, NEW YORK SCHEDULES		SCALE: N.T.S. DATE: 12/21/2018 DPW FILE NO. 208-03-H-80-0		
		SHEET NO. 56 OF 60		REV. NO. 0

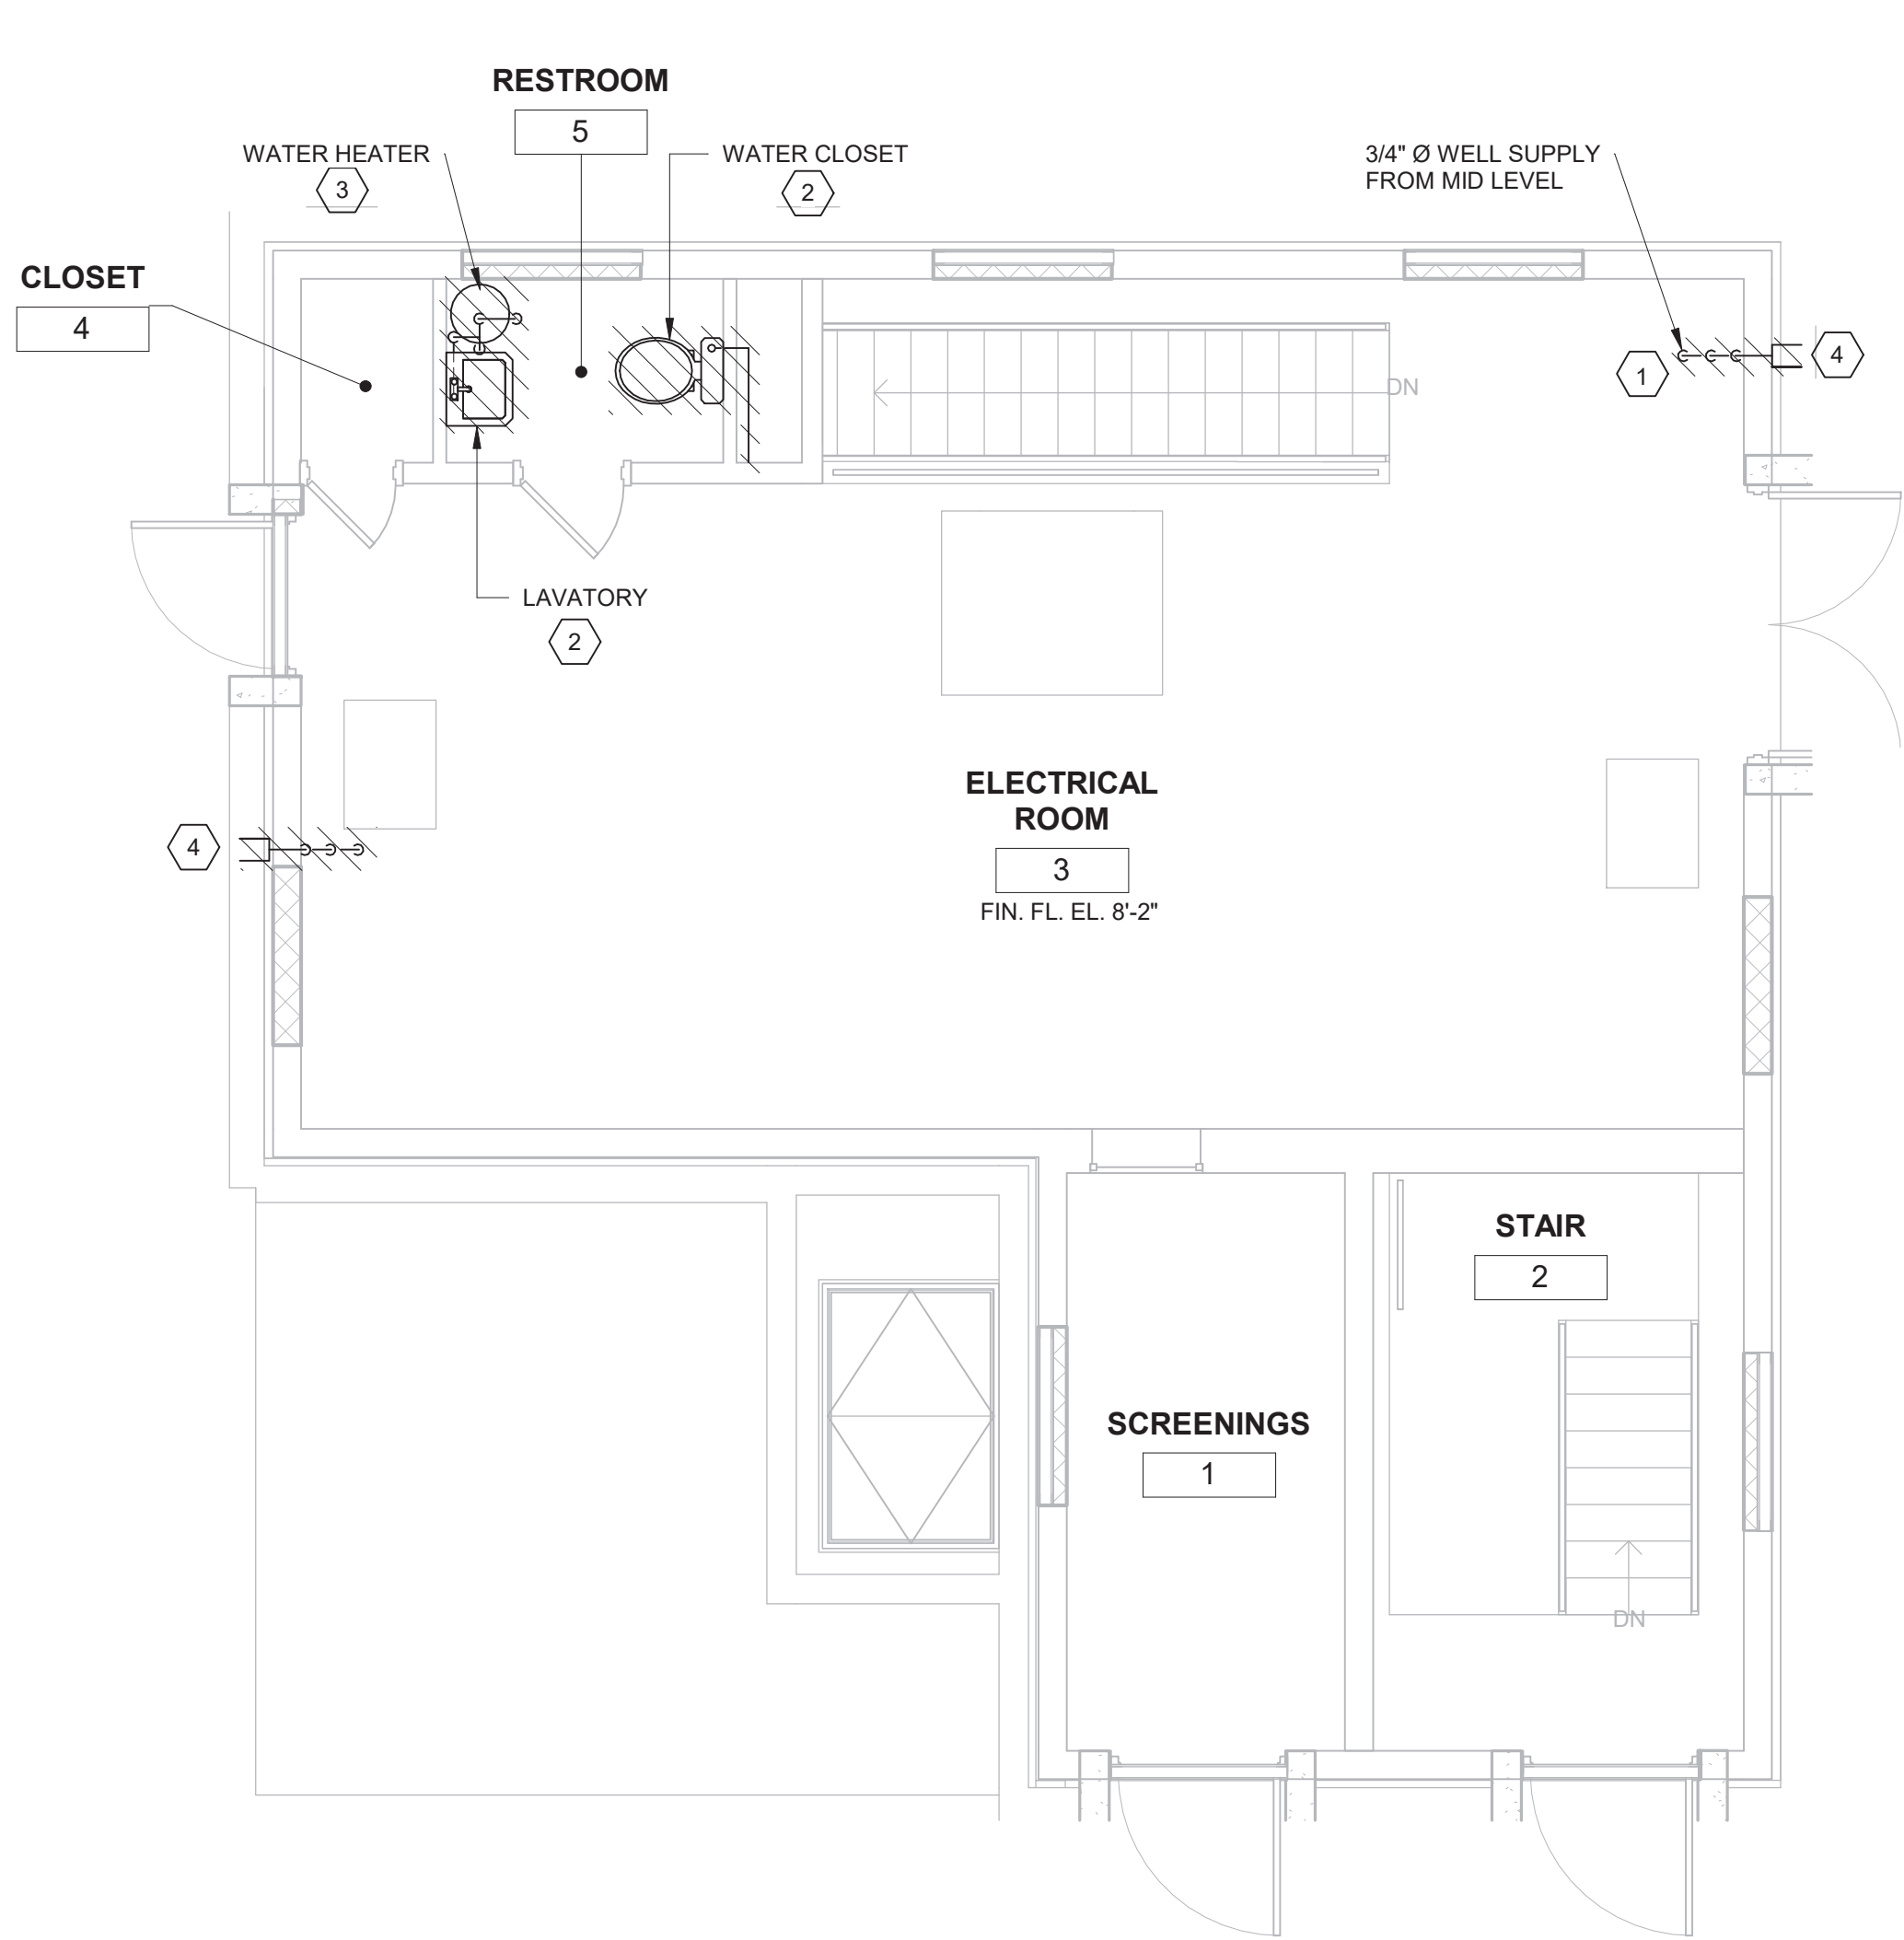

1 MAIN LEVEL - DEMOLITION PLAN
1/4" = 1'-0"


4' 2' 0 2' 4'

PLAN NORTH



KEYED NOTES:

1. DEMOLISH PIPING DOWN TO MIDDLE LEVEL. SEE P-102 FOR CONTINUATION.
2. DEMOLISH WATER CLOSET, LAVATORY AND PIPING DOWN TO MIDDLE LEVEL. SEE P-102 FOR CONTINUATION.
3. DEMOLISH ELECTRIC WATER HEATER AND PIPING DOWN TO MIDDLE LEVEL. SEE P-102 FOR CONTINUATION.
4. DEMOLISH NON-FREEZE WALL HYDRANT AND PIPING. SEE P-102 FOR CONTINUATION.

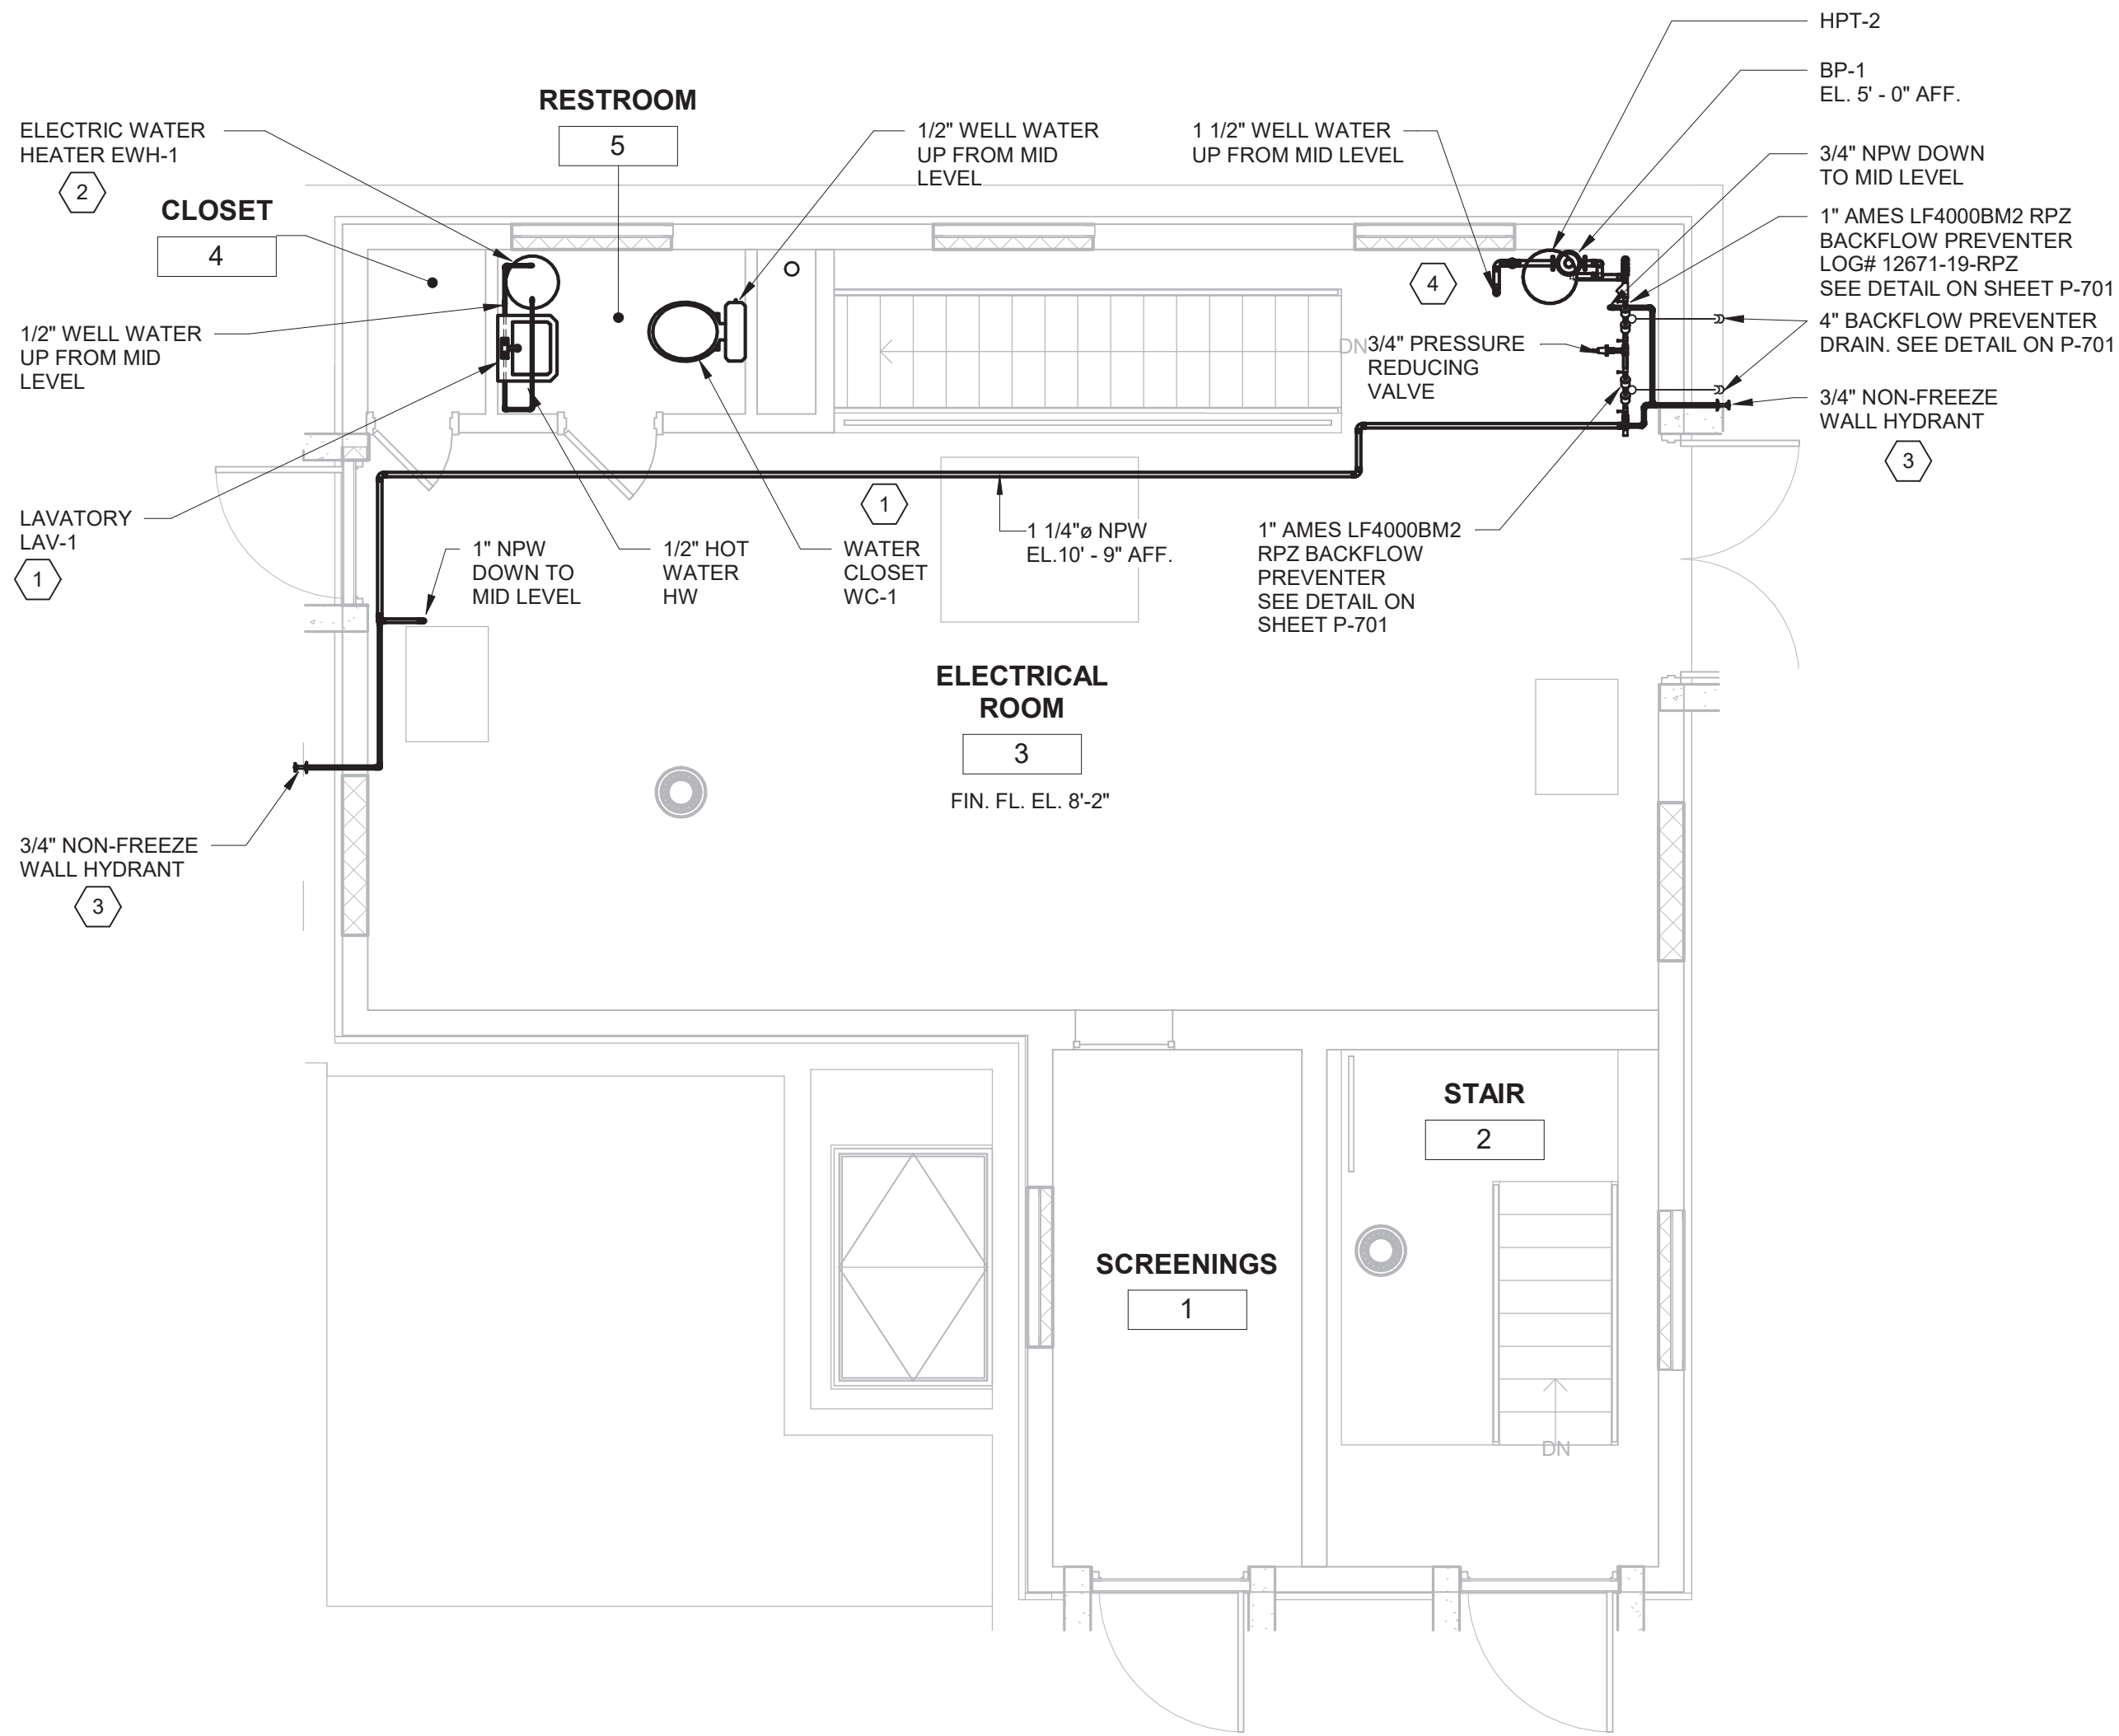

2 MAIN LEVEL - INSTALLATION PLAN
1/4" = 1'-0"

4' 2' 0 2' 4'

PLAN NORTH



KEYED NOTES:

1. PROVIDE TANK TYPE WATER CLOSET, LAVATORY AND PIPING.
2. PROVIDE ELECTRIC WATER HEATER AND PIPING.
3. PROVIDE NON-FREEZE WALL HYDRANT AND PIPING.
4. EXPOSED PIPING BETWEEN 2" INCOMING WELL WATER CONNECTION AND PRIMARY RPZ SHALL BE STENCILED "FEED LINE TO BACKFLOW PREVENTER - DO NOT TAP" AT 5'-0" INTERVALS.



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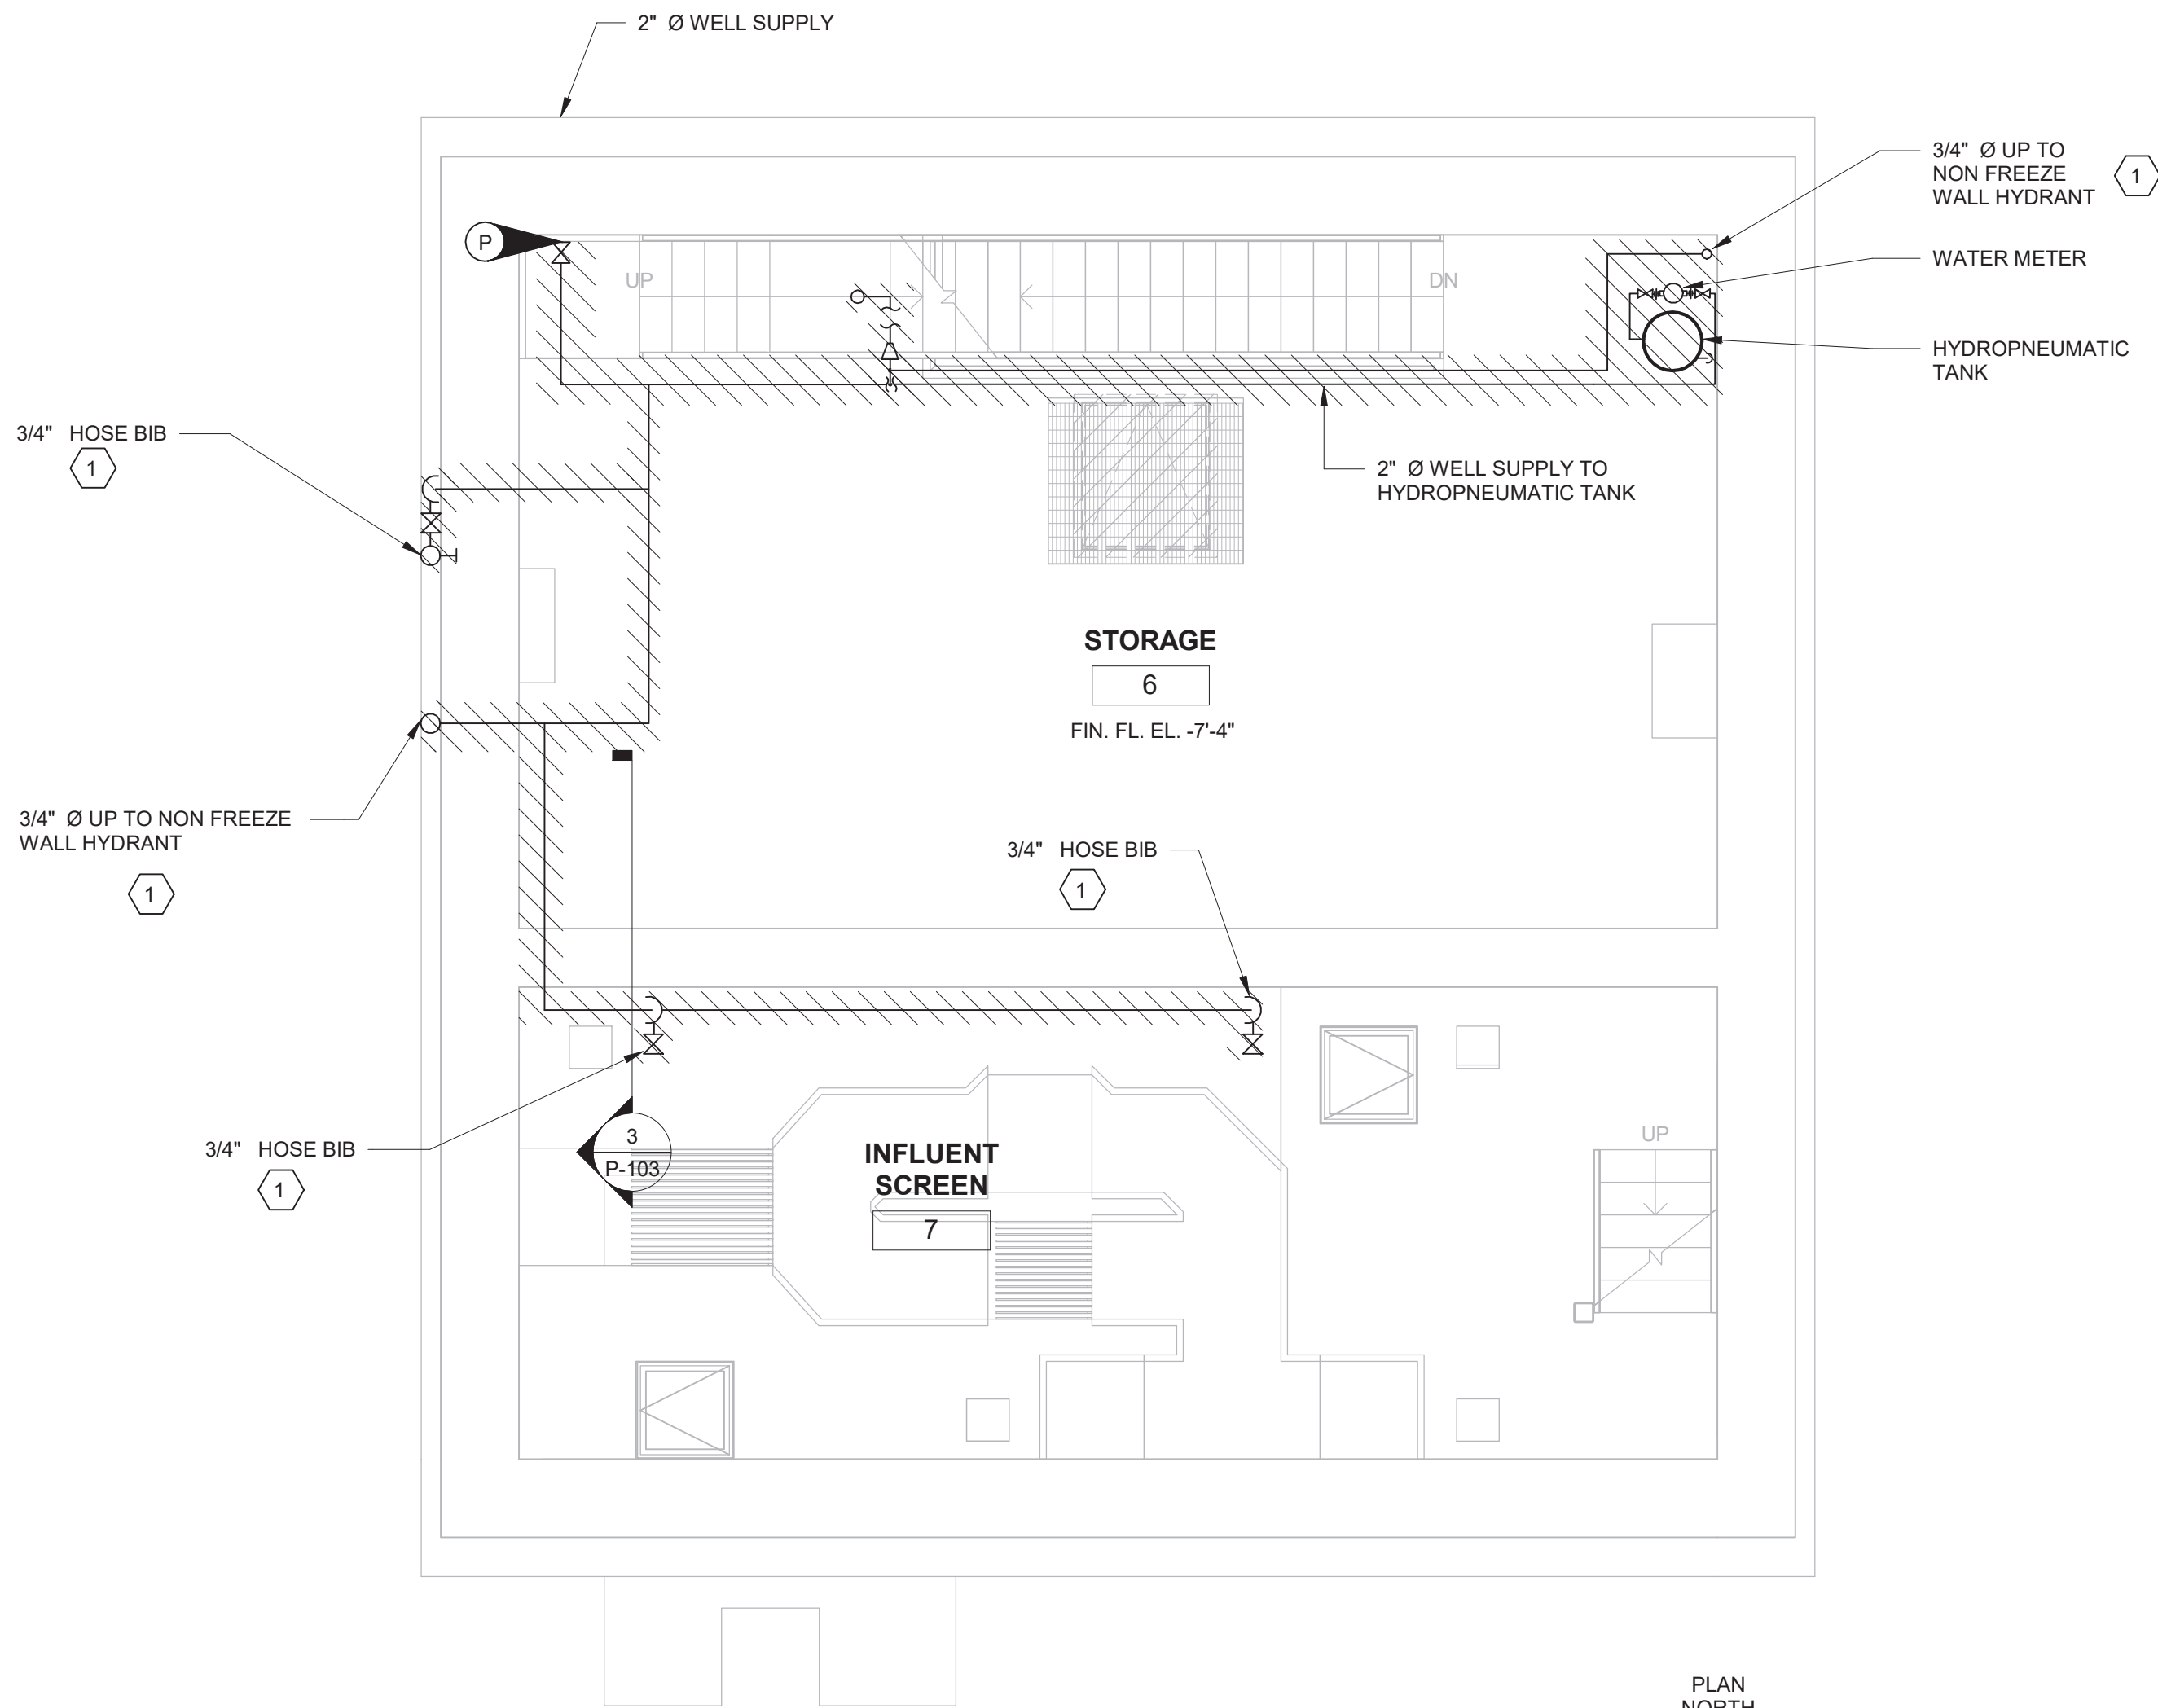
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IN CHARGE OF **T. ERWIN**
CHECKED BY **K. RADEMACHER**
MADE BY **K. LABENSKI**




O'BRIEN & GERE ENGINEERS, INC.
50 MAIN ST., 10TH FLOOR, SUITE 1000
WHITE PLAINS, NEW YORK 10606

REVISION NUMBER	DATE	MADE BY	APP'D BY	REVISION
RECORD DRAWING CERTIFICATION				
<input type="checkbox"/> AS BUILT - CHANGES AS NOTED <input type="checkbox"/> AS BUILT - NO CHANGES				
CONTRACTOR		PROJECT COORDINATOR		
NAME	SIGNATURE	NAME	SIGNATURE	DATE
TITLE		TITLE		
WESTCHESTER COUNTY, NEW YORK		CONTRACT NUMBER 17-534		
DEPARTMENT OF PUBLIC WORKS AND TRANSPORTATION		SHEET NUMBER P-101		
DIVISION OF ENGINEERING		SHEET NO. 57 OF 60		
CROTONVILLE PUMPING STATION REHABILITATION		SCALE: 1/4"=1'-0"		
OSSINING SANITARY SEWER DISTRICT		DATE: 12/21/2018		
OSSINING, NEW YORK		DPW FILE NO.		
MAIN LEVEL PLUMBING DEMOLITION & INSTALLATION PLANS		208-03-P-81-0		
		REV. NO. 0		



1 MIDDLE LEVEL DEMOLITION PLAN
1/4" = 1'-0"

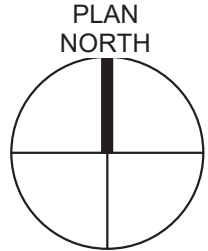


KEYED NOTES:


1. REMOVE EQUIPMENT AND ASSOCIATED PIPING.

GENERAL NOTES:

1. HOSE BIBBS TO BE INSTALLED AT A HEIGHT OF 3'-0" UNLESS OTHERWISE NOTED.

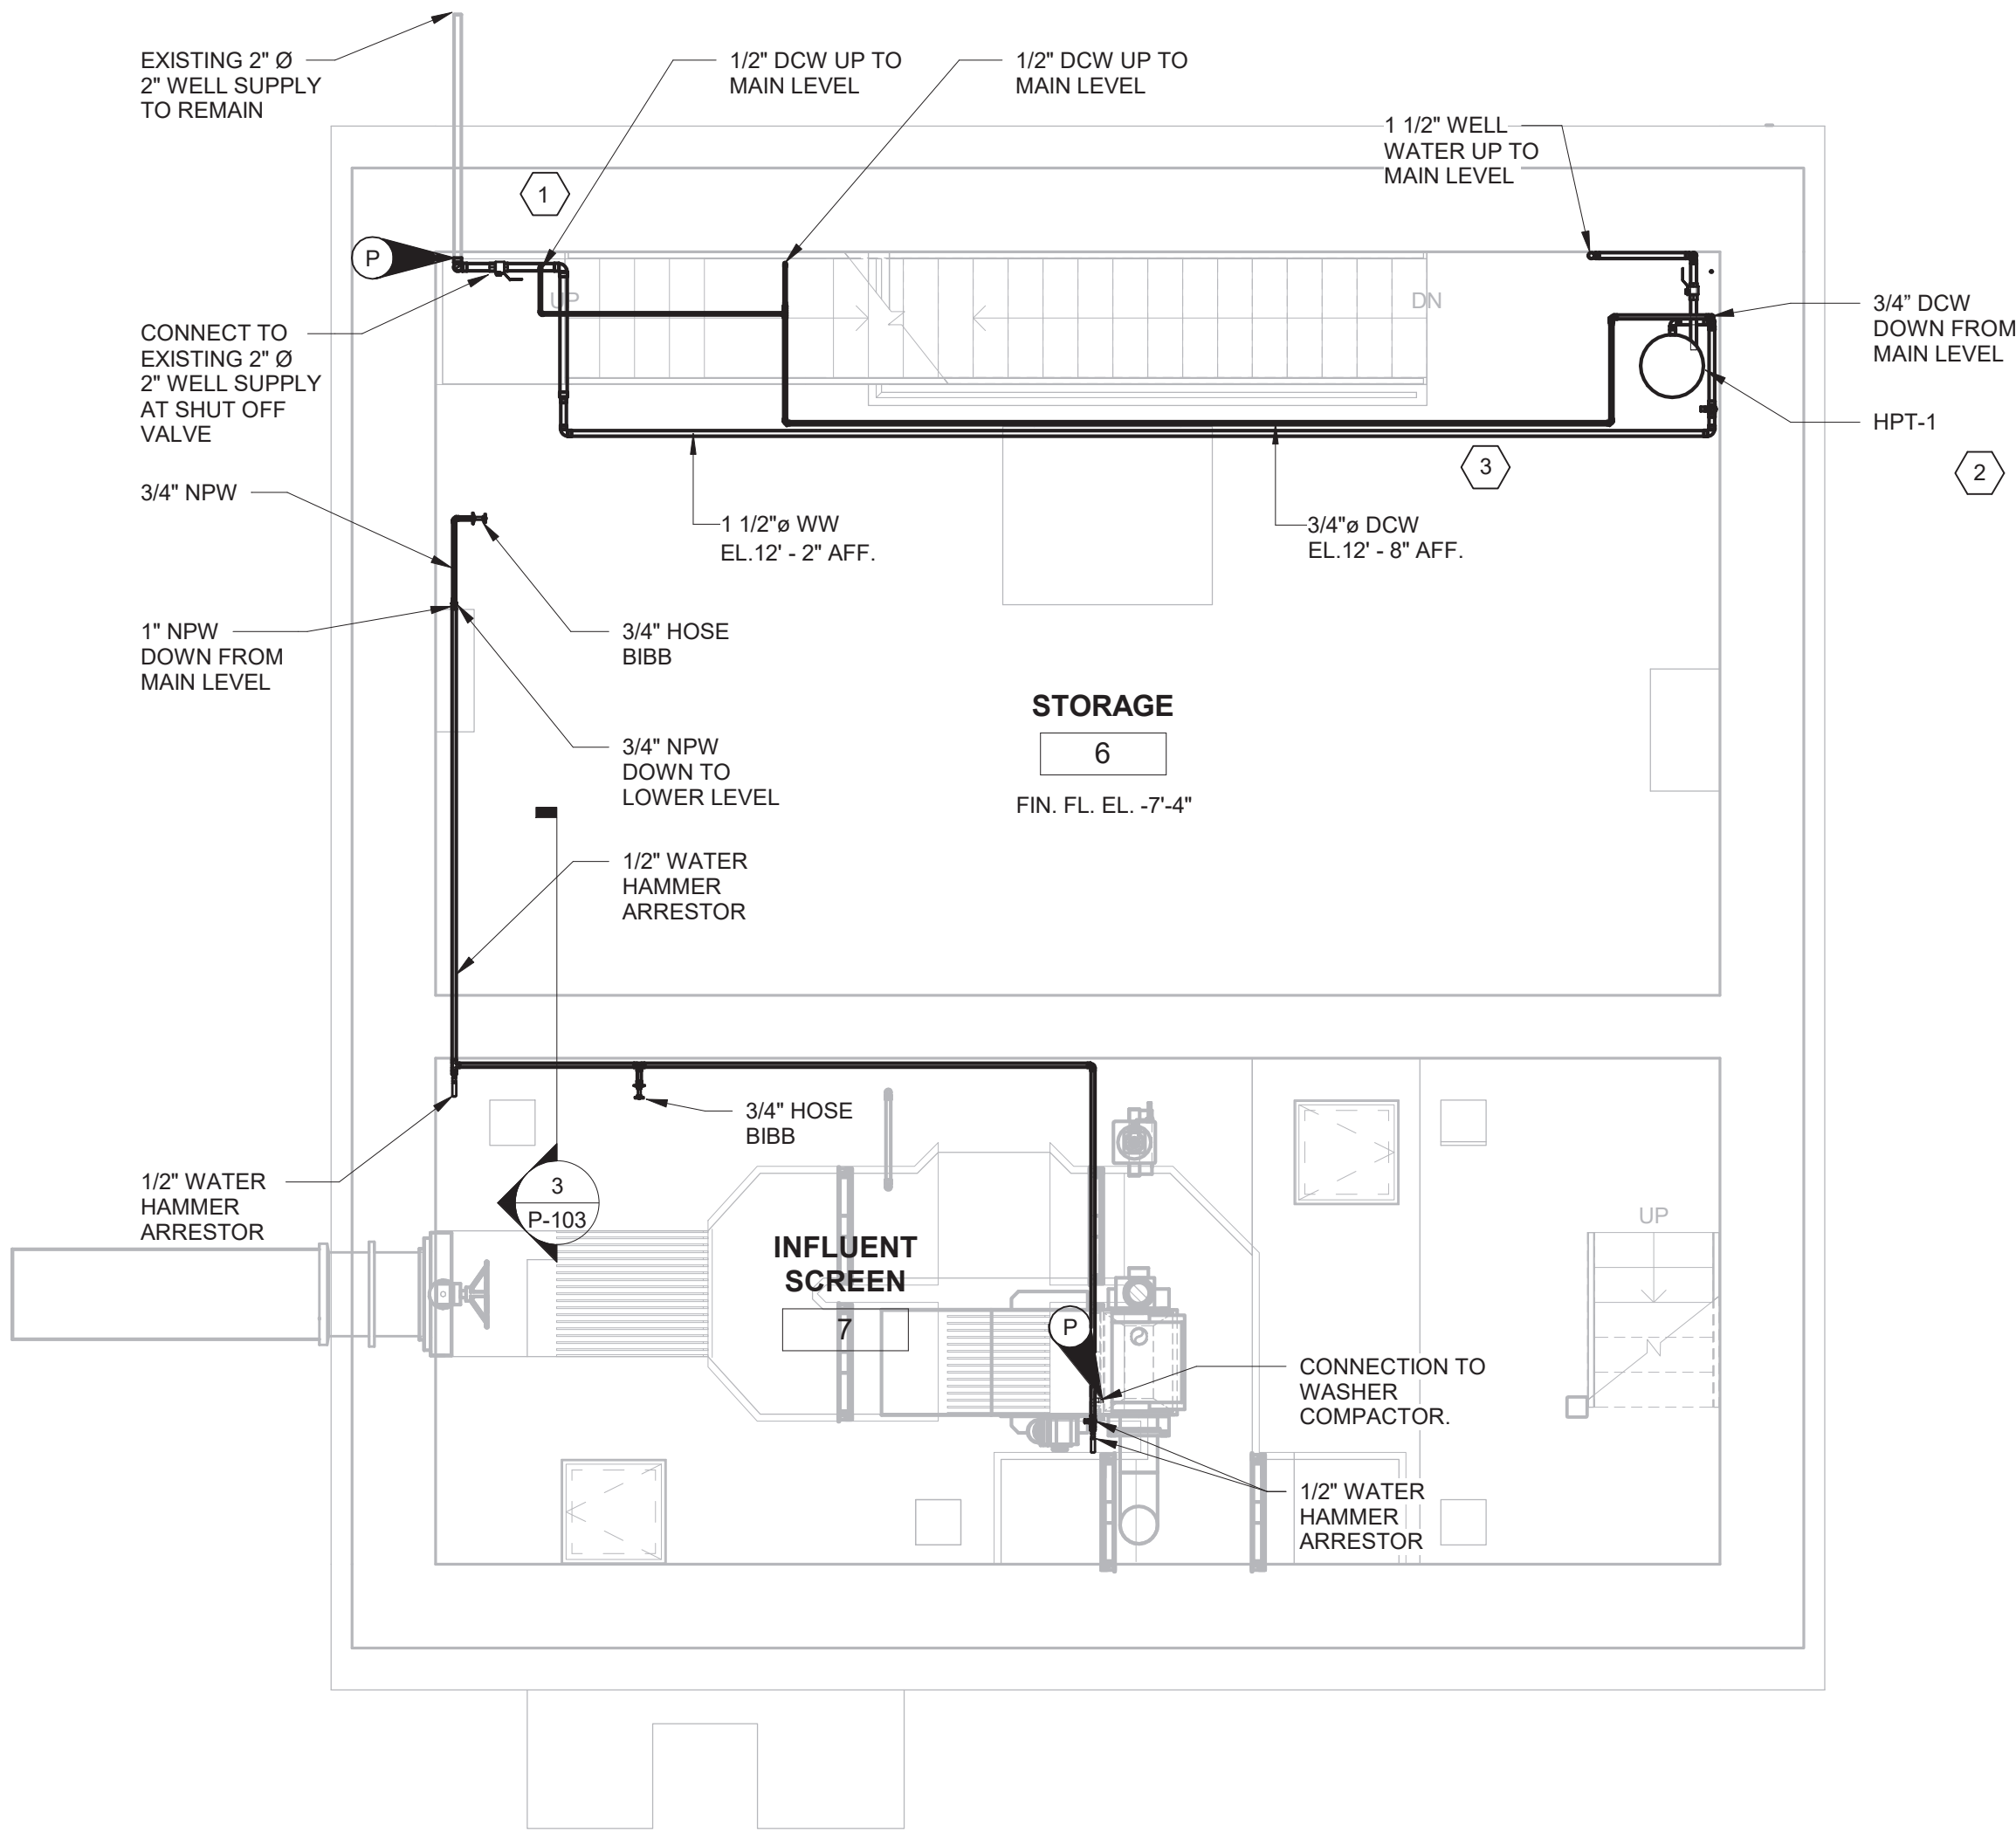

2 MIDDLE LEVEL INSTALLATION PLAN
1/4" = 1'-0"

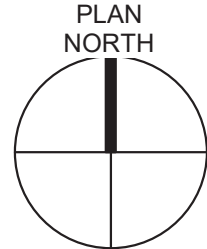

KEYED NOTES:

1. EXISTING 2" Ø WELL WATER SUPPLY. CONNECT TO VALVE FOR THE INSTALLATION OF WELL WATER SUPPLY PIPING.
2. INSTALL HYDROPNEUMATIC TANK AND PIPING.
3. EXPOSED PIPING BETWEEN 2" INCOMING WELL WATER CONNECTION AND PRIMARY RPZ SHALL BE STENCILED "FEED LINE TO BACKFLOW PREVENTER - DO NOT TAP" AT 5'-0" INTERVALS.



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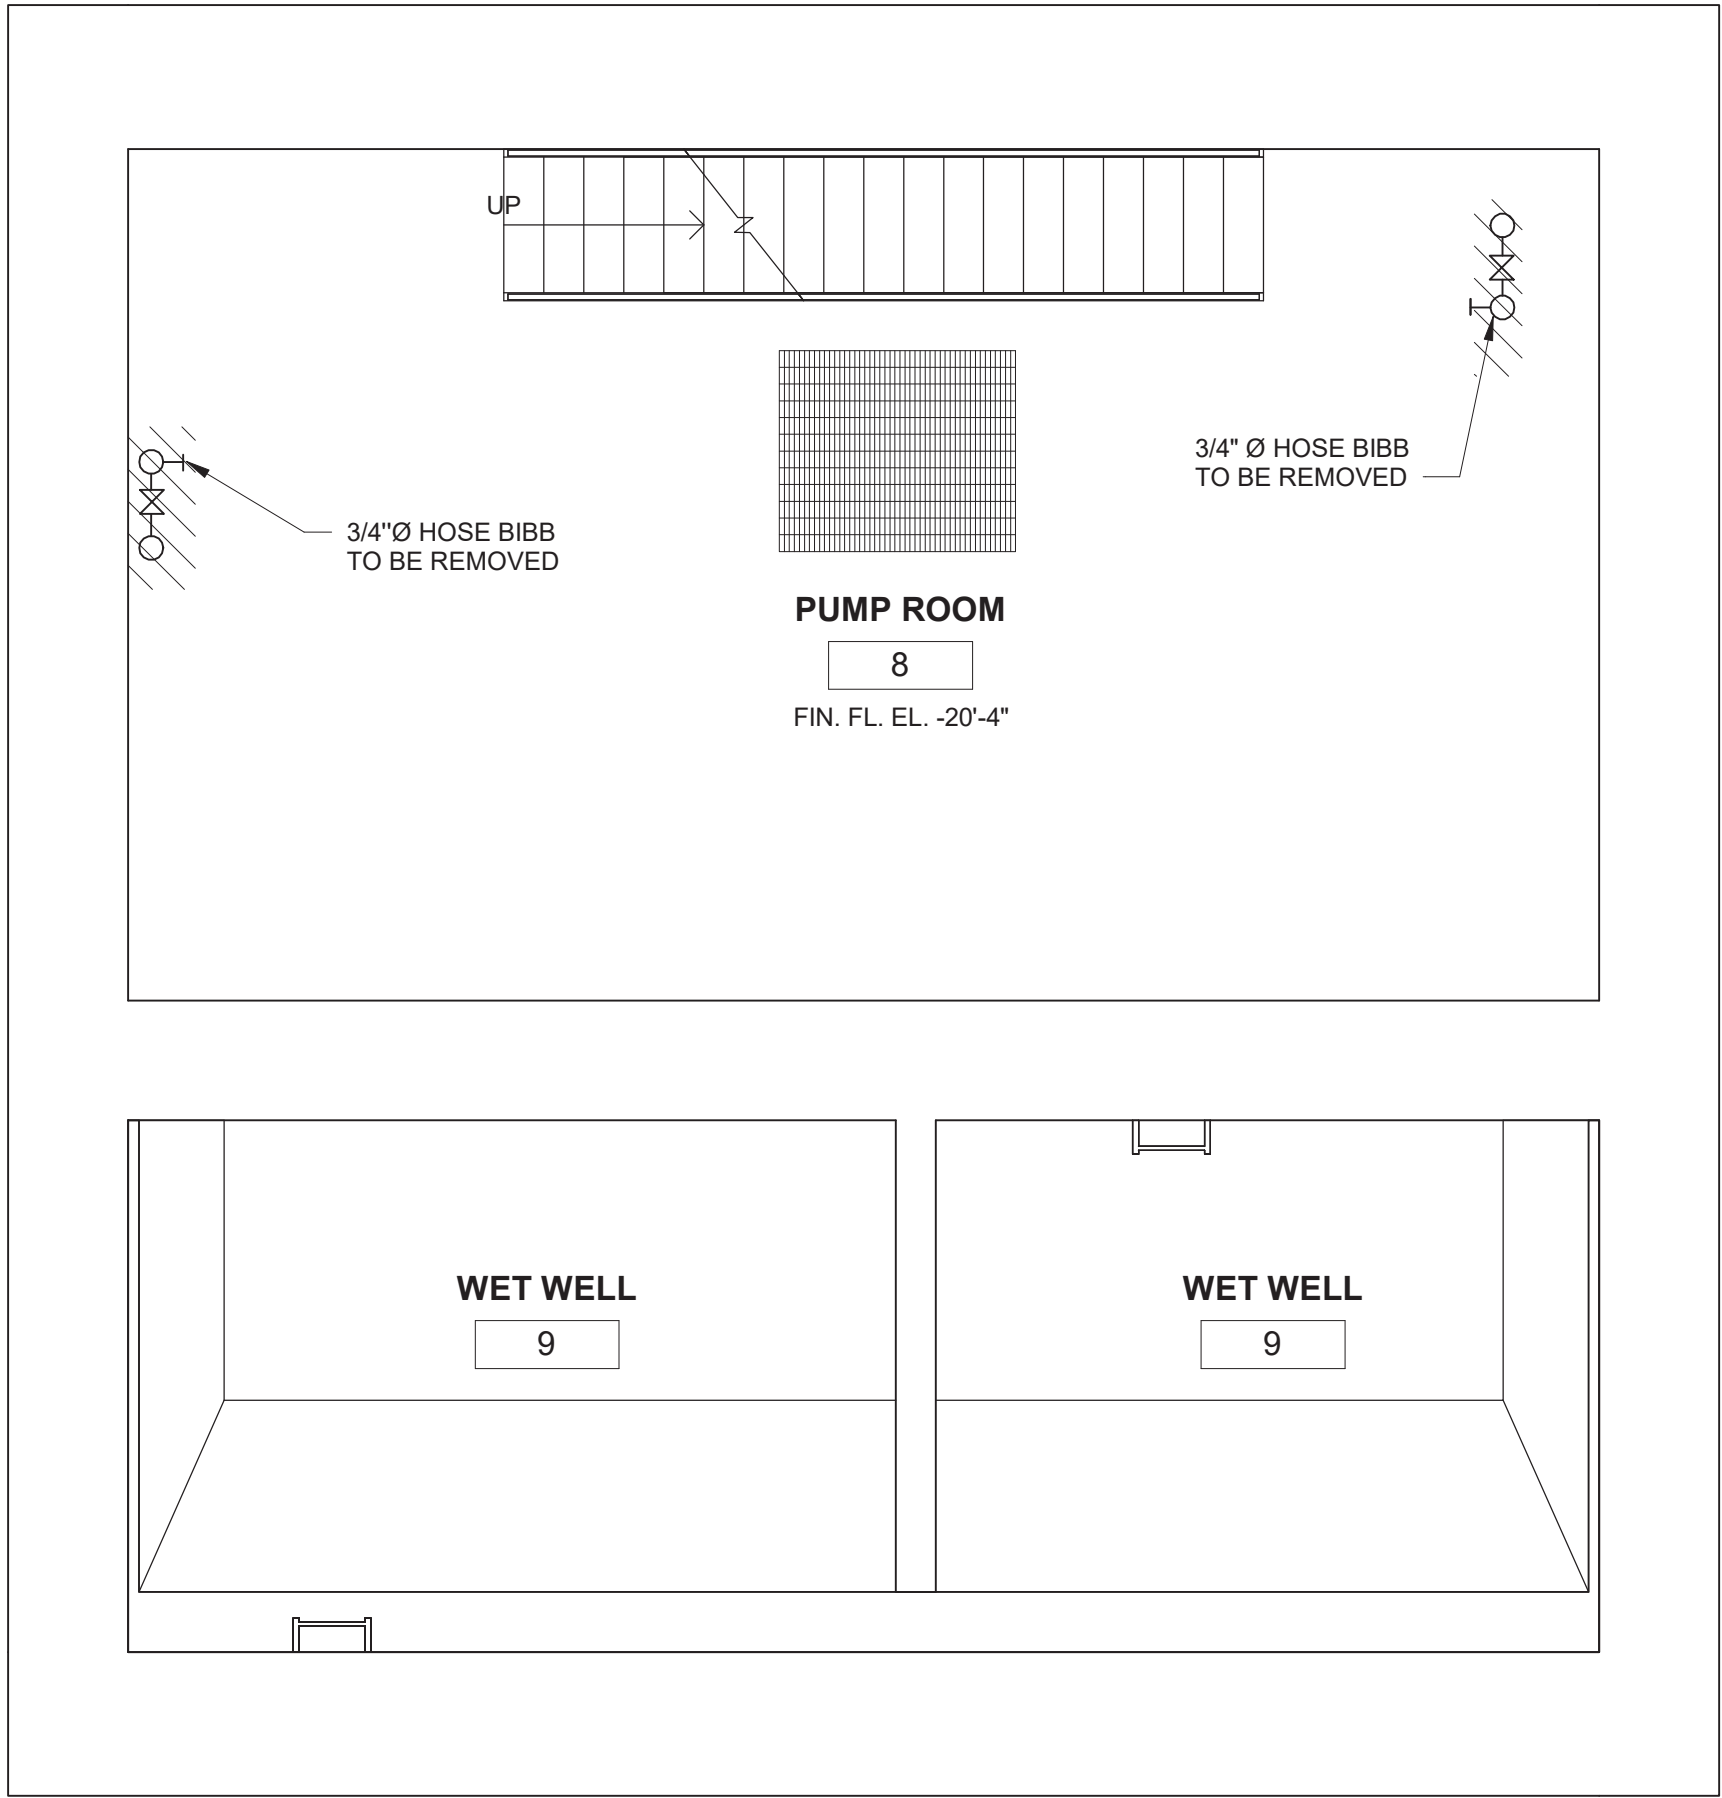
O'BRIEN & GERE ENGINEERS, INC.
50 MAIN ST., 10TH FLOOR, SUITE 1000
WHITE PLAINS, NEW YORK 10606

REVISION NUMBER DATE MADE BY APP'D BY REVISION



RECORD DRAWING CERTIFICATION

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☐ AS BUILT - NO CHANGES

CONTRACTOR		PROJECT COORDINATOR	
NAME	SIGNATURE	NAME	SIGNATURE
TITLE	DATE	TITLE	DATE
WESTCHESTER COUNTY, NEW YORK DEPARTMENT OF PUBLIC WORKS AND TRANSPORTATION DIVISION OF ENGINEERING		CONTRACT NUMBER 17-534	SHEET NUMBER P-102
CROTONVILLE PUMPING STATION REHABILITATION OSSINING SANITARY SEWER DISTRICT OSSINING, NEW YORK MIDDLE LEVEL PLUMBING DEMOLITION & INSTALLATION PLANS		SHEET NO. 58 OF 60 SCALE: 1/4"=1'-0" DATE: 12/21/2018 DPW FILE NO. 208-03-P-82-0	REV. NO. 0



1 LOWER LEVEL DEMOLITION PLAN
1/4" = 1'-0"

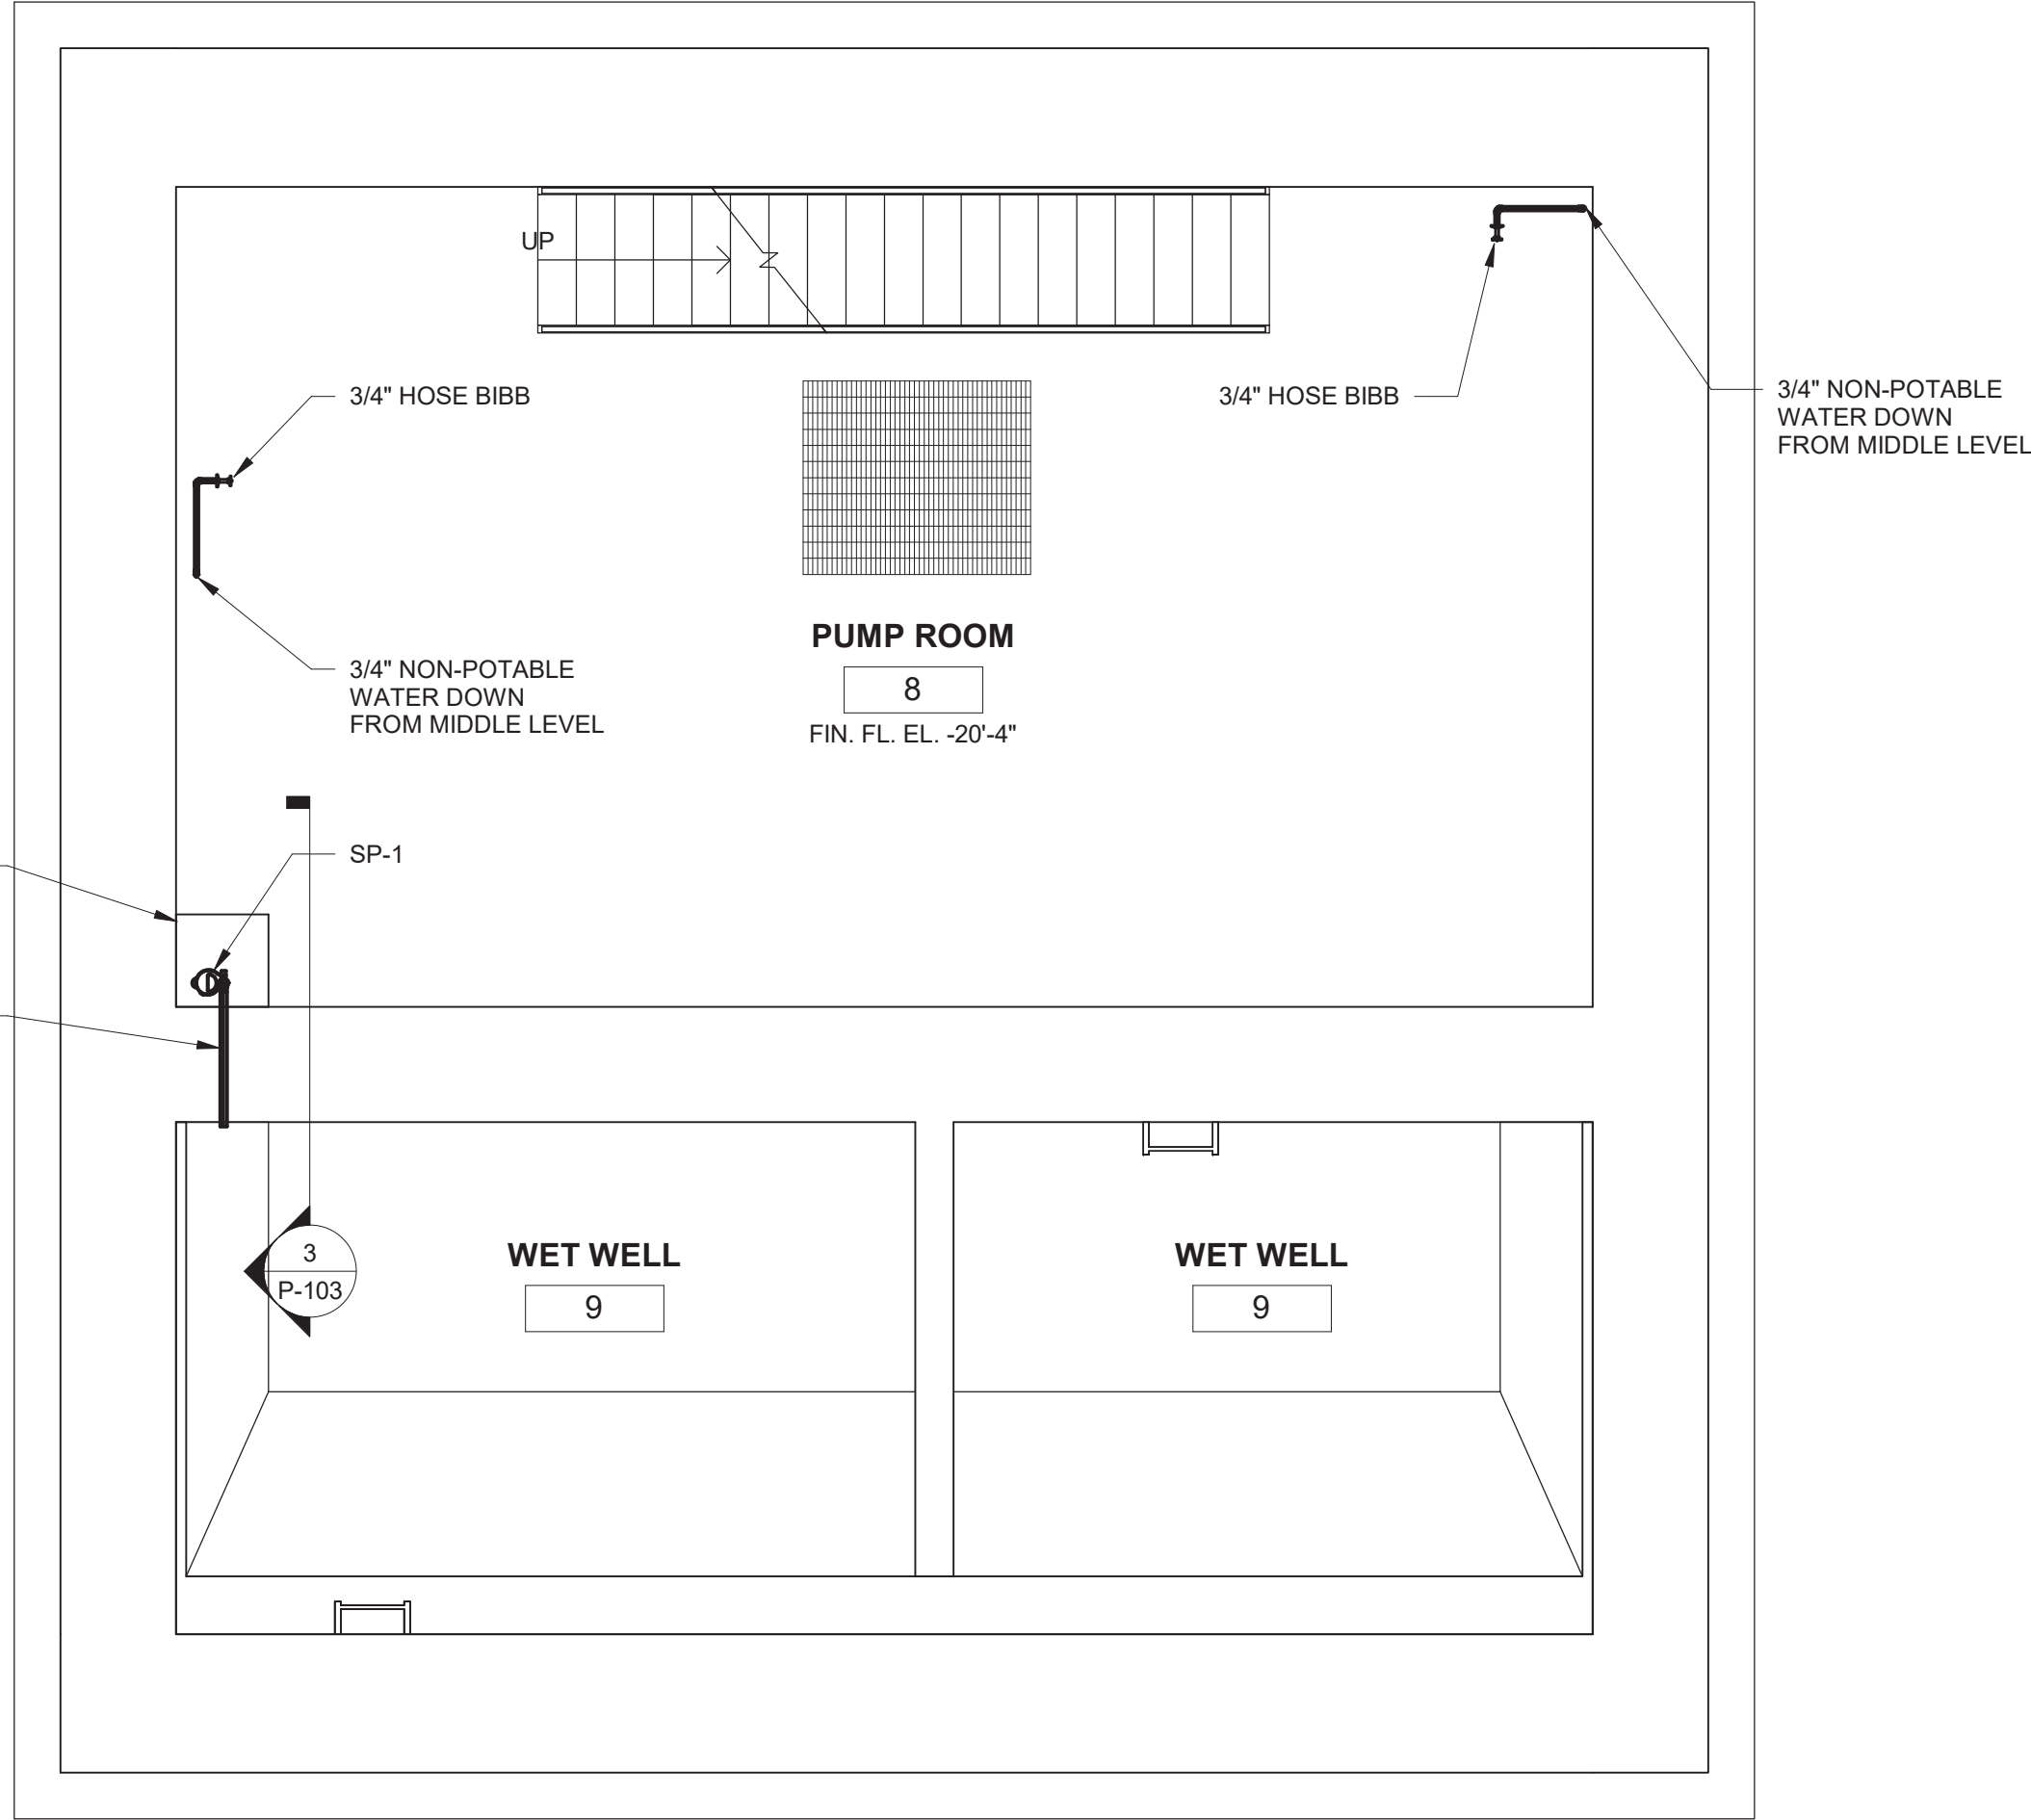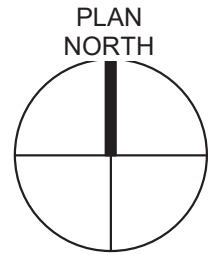


2 LOWER LEVEL INSTALLATION PLAN
1/4" = 1'-0"



GENERAL NOTES:

1. HOSE BIBBS TO BE INSTALLED AT A HEIGHT OF 3'-0" UNLESS OTHERWISE NOTED.

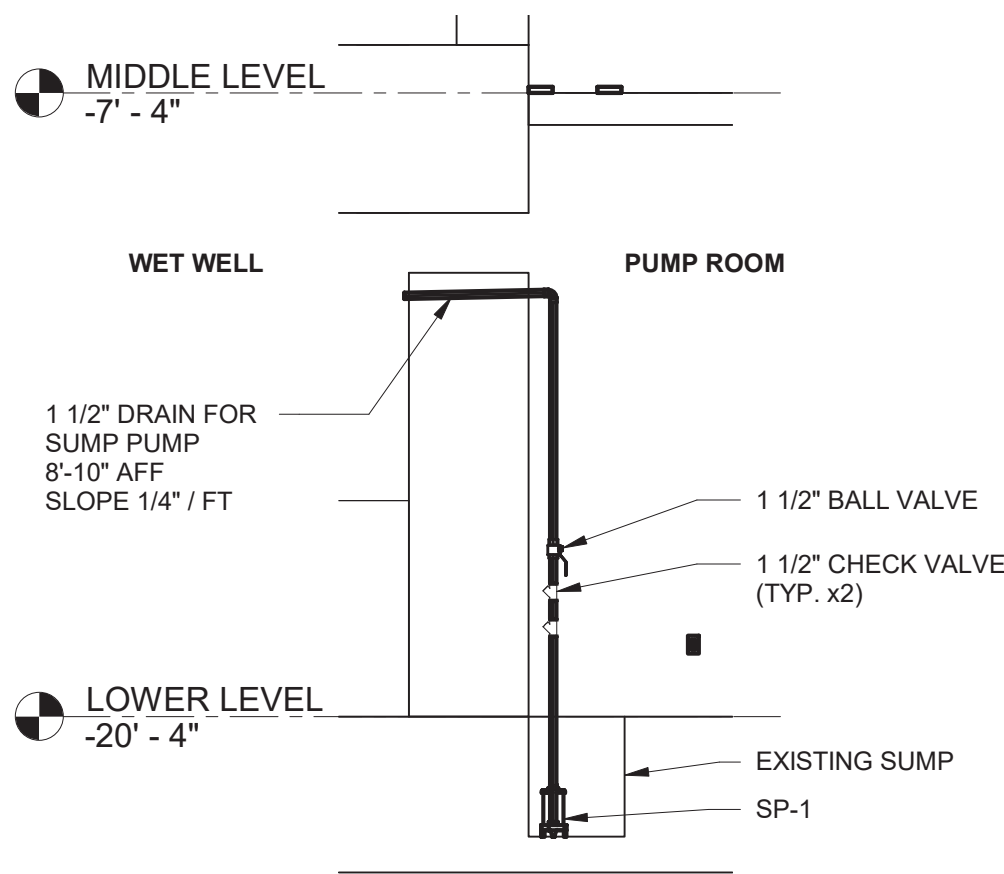

3 SUMP PUMP SECTION VIEW
1/4" = 1'-0"

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CONTRACTOR		PROJECT COORDINATOR			
NAME	SIGNATURE	DATE	TITLE		
WESTCHESTER COUNTY, NEW YORK		CONTRACT NUMBER		SHEET NUMBER	
DEPARTMENT OF PUBLIC WORKS AND TRANSPORTATION		17-534		P-103	
DIVISION OF ENGINEERING		SHEET NO. 59 OF 60		SCALE: 1/4"=1'-0"	
CROTONVILLE PUMPING STATION REHABILITATION		DATE: 12/21/2018		REV. NO. 0	
OSSINING SANITARY SEWER DISTRICT		DPW FILE NO.		208-03-P-83-0	
OSSINING, NEW YORK		208-03-P-83-0		0	
LOWER LEVEL PLUMBING DEMOLITION & INSTALLATION		208-03-P-83-0		0	



NOT TO SCALE



- ## INLINE PUMP PIPING DETAIL

INLINE PUMP PIPING DETAIL

NOT TO SCALE

BP	BOOSTER PUMP
DCW	DOMESTIC COLD WATER
EWB	ELECTRIC WATER HEATER
HPT	HYDRO-PNEUMATIC TANK
NPW	NON-POTABLE WATER
PS	PRESSURE SENSOR
PT	PRESSURE TRANSMITTER

PLUMBING FIXTURE SCHEDULE

SUMP PUMP (SP) SCHEDULE

REMARKS

1. PUMP SHALL BE POWERED BY CONVENIENCE OUTLET LOCATED NEAR EXISTING SUMP.

BOOSTER PUMP (BP) SCHEDULE

REMARKS:

1. PUMPED FLUID: WELL WATER
2. BASE MOUNTED.
3. IN-LINE.
4. LOW PRESSURE CUT-OFF SWITCH SET TO 10 PSI.

ELECTRIC WATER HEATER (EWH) SCHEDULE


REMARKS:

1. WALL MOUNTED.

HYDRO-PNEUMATIC TANK (HPT) SCHEDULE



NOT TO SCALE

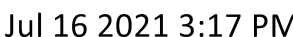

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50 MAIN ST., 10TH FLOOR, SUITE 1000
WHITE PLAINS, NEW YORK 10606

RECORD DRAWING CERTIFICATION

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NAME _____

SIGNATURE _____

TITLE _____

PROJECT COORDINATOR _____

DATE _____

WESTCHESTER COUNTY, NEW YORK
DEPARTMENT OF PUBLIC WORKS AND TRANSPORTATION
DIVISION OF ENGINEERING

CROTONVILLE PUMPING STATION REHABILITATION
OSSINING SANITARY SEWER DISTRICT
OSSINING, NEW YORK
ISOMETRIC, DETAIL & SCHEDULE

CONTRACT NUMBER	SHEET NUMBER
17-534	P-701

SCALE: N.T.S.	
DATE: 12/21/2018	
DPW FILE NO.	F
208-03-P-84-0	