





- 1. DEMOLISH PIPING DOWN TO MIDDLE LEVEL. SEE P-102 FOR CONTINUATION.
- 2. DEMOLISH WATER CLOSET, LAVATORY AND PIPING DOWN TO MIDDLE LEVEL. SEE P-102 FOR CONTINUATION.
- 3. DEMOLISH ELECTRIC WATER HEATER AND PIPING DOWN TO MIDDLE LEVEL. SEE P-102 FOR CONTINUATION.
- 4. DEMOLISH NON-FREEZE WALL HYDRANT AND PIPING. SEE P-102 FOR CONTINUATION.



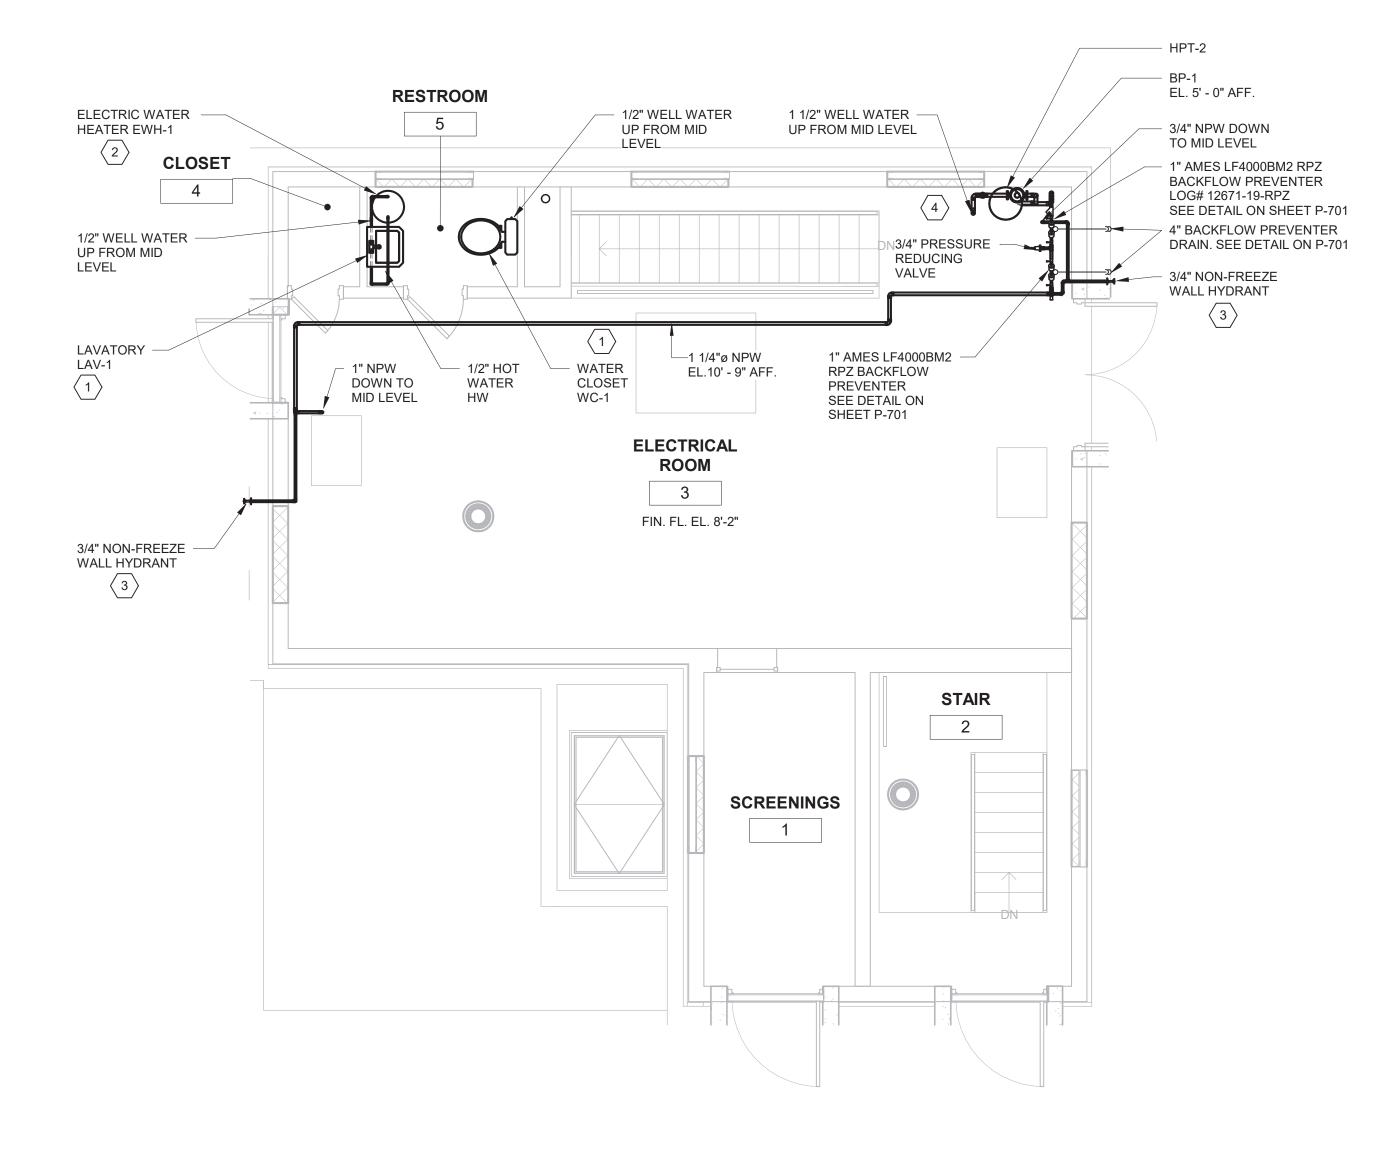


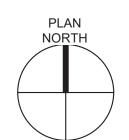

NAME \_\_\_\_



- 1. PROVIDE TANK TYPE WATER CLOSET, LAVATORY AND PIPING.
- 2. PROVIDE ELECTRIC WATER HEATER AND PIPING.
- 3. PROVIDE NON-FREEZE WALL HYDRANT AND PIPING.
- 4. EXPOSED PIPING BETWEEN 2" INCOMING WELL WATER CONNECTION AND PRIMARY RPZ SHALL BE STENCILED "FEED LINE TO BACKFLOW PREVENTER - DO NOT TAP" AT 5'-0" INTERVALS.

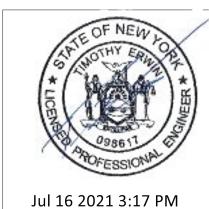

IN ACCORDANCE WITH TITLE VIII, ARTICLE 145, SECTION 7209 (2) OF THE NEW YORK STATE EDUCATION LAW, IT IS A VIOLATION OF LAW FOR ANY PERSON UNLESS ACTING UNDER THE DIRECTION OF A LICENSED ENGINEER TO ALTER THIS DOCUMENT.

O'BRIEN & GERE ENGINEERS, INC.

CHECKED BY K. RADEMACHER MADE BY K. LABENSKI

IN CHARGE OF T. ERWIN 50 MAIN ST., 10TH FLOOR, SUITE 1000 WHITE PLAINS, NEW YORK 10606

REVISION DATE MADE BY APP'D BY REVISION NUMBER RECORD DRAWING CERTIFICATION

NAME

AS BUILT - CHANGES AS NOTED AS BUILT - NO CHANGES

CONTRACTOR

SIGNATURE SIGNATURE DATE WESTCHESTER COUNTY, NEW YORK

DEPARTMENT OF PUBLIC WORKS AND TRANSPORTATION DIVISION OF ENGINEERING SHEET NO. 57 OF 60 SCALE: 1/4"=1'-0"

CROTONVILLE PUMPING STATION REHABILITATION OSSINING SANITARY SEWER DISTRICT OSSINING, NEW YORK

MAIN LEVEL PLUMBING DEMOLITION & INSTALLATION PLANS

DATE: 12/21/2018 DPW FILE NO. 208-03-P-81-0

CONTRACT SHEET


NUMBER

P-101

NUMBER

17-534

PROJECT COORDINATOR

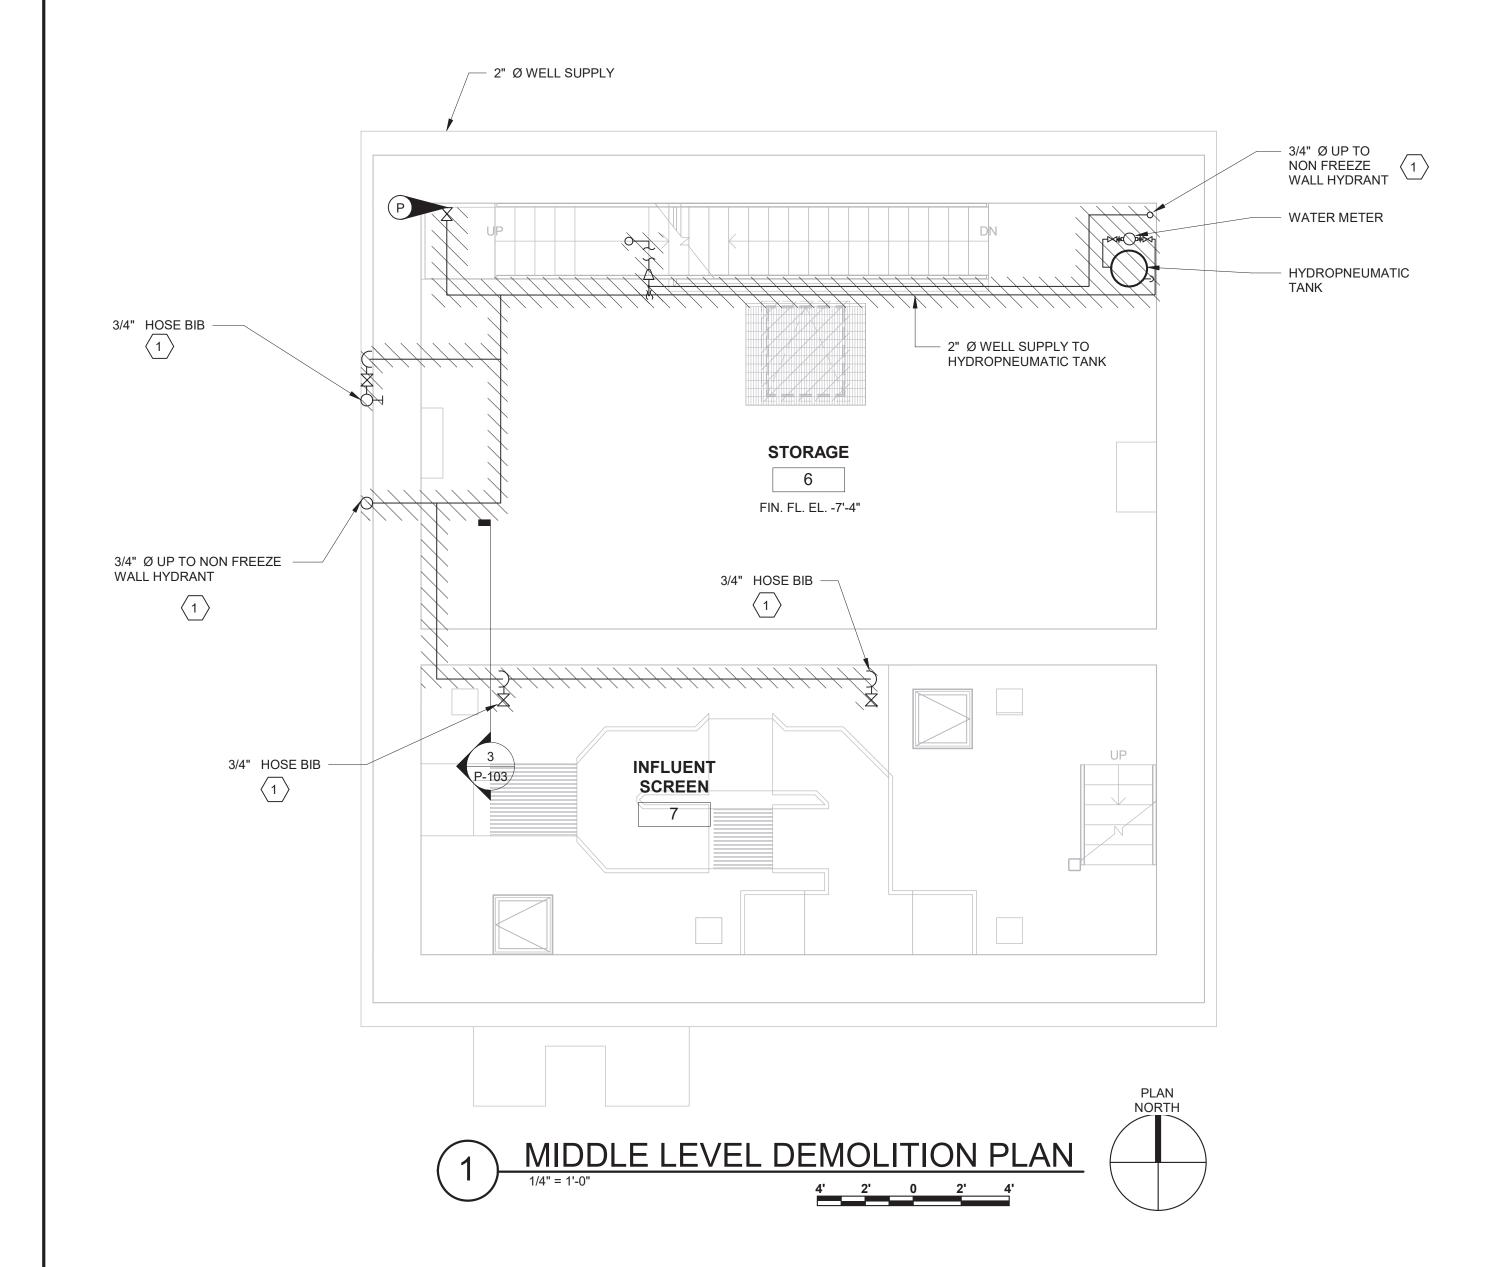

**KEYED NOTES:** 

1. REMOVE EQUIPMENT AND ASSOCIATED PIPING.



1/2" DCW UP TO

MAIN LEVEL

\_\_\_1 1/2"ø WW

\_\_\_\_ 3/4" HOSE

INFLUENT

- 3/4" HOSE

- 3/4" NPW

DOWN TO

1/2" WATER

ARRESTOR

HAMMER

LOWER LEVEL

BIBB

EL.12' - 2" AFF.

- 1/2" DCW UP TO MAIN LEVEL

STORAGE

6

FIN. FL. EL. -7'-4"

—1 1/2" WELL—— WATER UP TO MAIN LEVEL

\_\_\_3/4"ø DCW


EL.12' - 8" AFF.

CONNECTION TO WASHER COMPACTOR.

1/2" WATER HAMMER ARRESTOR - 3/4" DCW DOWN FROM

MAIN LEVEL

 $\langle 2 \rangle$ 

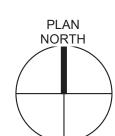

NAME



EXISTING 2" Ø — 2" WELL SUPPLY

TO REMAIN

CONNECT TO

EXISTING 2" Ø

3/4" NPW ----

VALVE

1" NPW -

DOWN FROM


MAIN LEVEL

1/2" WATER HAMMER

ARRESTOR

2" WELL SUPPLY AT SHUT OFF

- 1. EXISTING 2" Ø WELL WATER SUPPLY. CONNECT TO VALVE FOR THE INSTALLATION OF WELL WATER SUPPLY PIPING.
- 2. INSTALL HYDROPNEUMATIC TANK AND PIPING.
- 3. EXPOSED PIPING BETWEEN 2" INCOMING WELL WATER CONNECTION AND PRIMARY RPZ SHALL BE STENCILED "FEED LINE TO BACKFLOW PREVENTER - DO NOT TAP" AT 5'-0" INTERVALS.

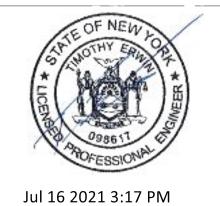

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O'BRIEN & GERE ENGINEERS, INC

PROJECT COORDINATOR

CONTRACT SHEET

SHEET NO. 58 OF 60

SCALE: 1/4"=1'-0"

DPW FILE NO.

DATE: 12/21/2018

208-03-P-82-0

NUMBER

P-102

NUMBER

CHECKED BY K. RADEMACHER MADE BY K. LABENSKI

IN CHARGE OF T. ERWIN 50 MAIN ST., 10TH FLOOR, SUITE 1000 WHITE PLAINS, NEW YORK 10606

REVISION DATE MADE BY APP'D BY REVISION NUMBER RECORD DRAWING CERTIFICATION

NAME

AS BUILT - CHANGES AS NOTED

AS BUILT - NO CHANGES CONTRACTOR

SIGNATURE SIGNATURE DATE WESTCHESTER COUNTY, NEW YORK


DEPARTMENT OF PUBLIC WORKS AND TRANSPORTATION DIVISION OF ENGINEERING CROTONVILLE PUMPING STATION REHABILITATION


OSSINING SANITARY SEWER DISTRICT OSSINING, NEW YORK MIDDLE LEVEL PLUMBING DEMOLITION & INSTALLATION PLANS

## **GENERAL NOTES:**


1. HOSE BIBBS TO BE INSTALLED AT A HEIGHT OF 3'-0" UNLESS OTHERWISE NOTED.



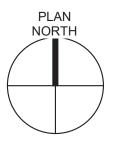

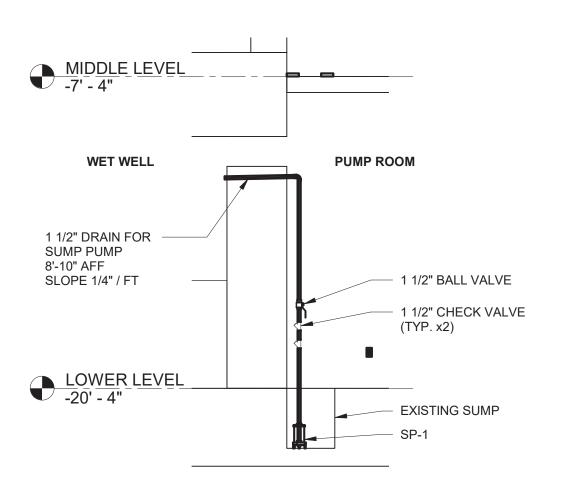

3 SUMP PUMP SECTION VIEW

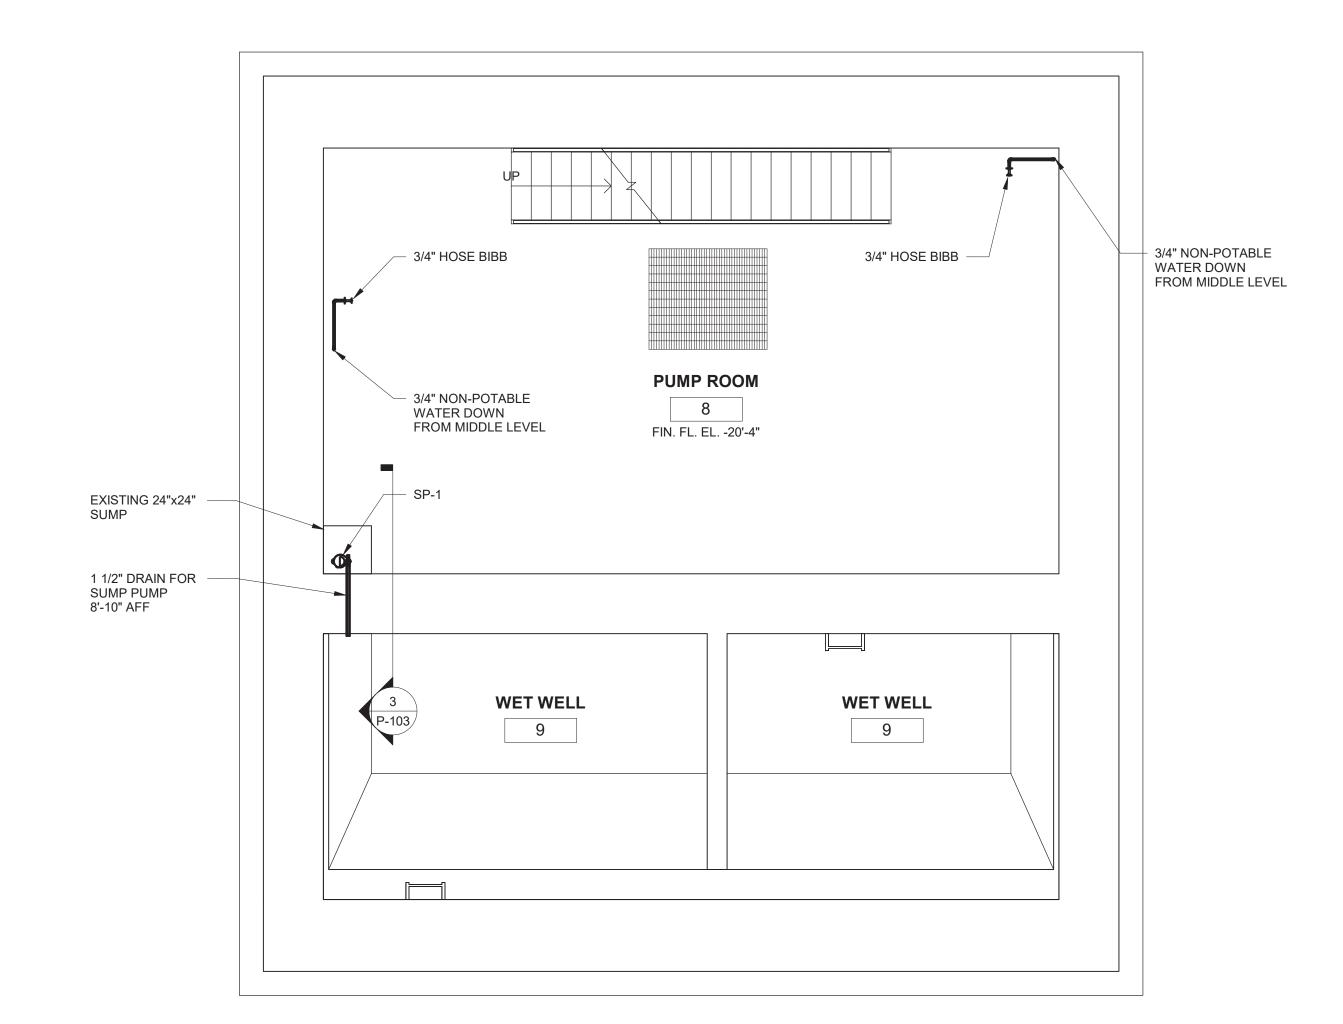






#### **GENERAL NOTES:**


1. HOSE BIBBS TO BE INSTALLED AT A HEIGHT OF 3'-0" UNLESS OTHERWISE NOTED.

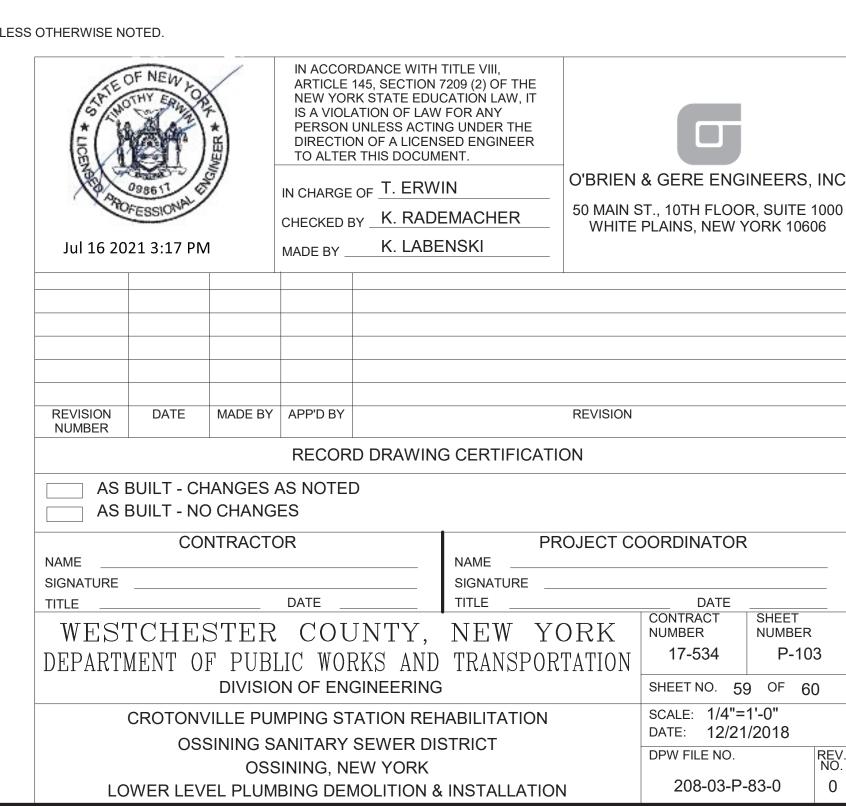

# **ABBREVIATIONS**

**BOOSTER PUMP** DOMESTIC COLD WATER ELECTRIC WATER HEATER HYDRO-PNEUMATIC TANK NON-POTABLE WATER PRESSURE SENSOR

PRESSURE TRANSMITTER

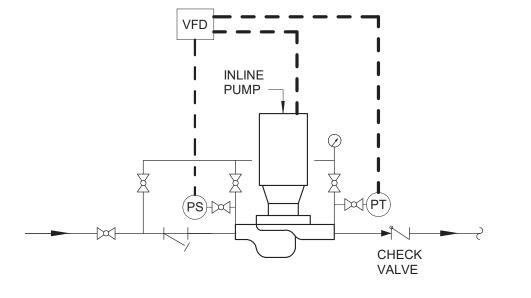

#### NOTES:

- 1. VALVES SHALL BE SAME SIZE AS PIPE.
- 2. FOR PUMPS OVER 1 HP: PUMP & PIPE WITHIN 20' SHALL HAVE SPRING ISOLATOR
- 3. INSTALLATION SHALL BE IN ACCORDANCE WITH MANUFACTURER'S INSTRUCTIONS.

### INLINE PUMP PIPING DETAIL

	PLUMBING FIXTURE SCHEDULE										
FIXTURE NAME	DESCRIPTION		HW	VENT	SANITARY	REMARKS					
WC-1	WATER CLOSET	1/2"	-	2"	3"	TANK TYPE STANDARD					
LAV-1	LAVATORY	1/2"	1/2"	1 1/4"	1 1/4"	WALL HUNG					

	SUMP PUMP (SP) SCHEDULE										
NO.	LOCATION	GPM	THD HEAD (FT)	RPM	MOTOR DATA  HP VOLTS /PHASE		MANUFACTURER/ MODEL	REMARKS			
SP-1	SUMP IN DRY WELL LOWER LEVEL	32	26	3450	3/4	115 V	BELL & GOSSETT/ SS0711	1			

#### REMARKS:

1. PUMP SHALL BE POWERED BY CONVENIENCE OUTLET LOCATED NEAR EXISTING SUMP.

	BOOSTER P	UMF	P (BP	) SCH	EDULE				
		PUMP					MOTOR		
NO.	SERVICE	FLOW GPM	HEAD (FT)	MIN. PUMP EFFICIENCY	CONTROL	HP	RPM	VOLT/PHASE	REMARKS
BP-1	DCW, NPW	20	157	63	VFD, CONSTANT PRESSURE	2	3500	460V/3 PH	1,2,3,4
DEMVDK6.									

#### REMARKS:

- 1. PUMPED FLUID: WELL WATER
- 2. BASE MOUNTED.
- IN-LINE.
- 4. LOW PRESSURE CUT-OFF SWITCH SET TO 10 PSI.

ELECTRIC WATER HEATER (EWH) SCHEDULE										
NO.	BUILDING	LOCATION	TANK CAPACITY (GALLONS)	INPUT RATING (KW)	VOLTAGE (V)	PHASE (PH)	SET TEMPERATURE	REMARKS		
EWH-1	PUMP STATION	REST ROOM	10	1.65	120	1	120°F	1		

REMARKS:

1. WALL MOUNTED.

HYDRO-PNEUMATIC TANK (HPT) SCHEDULE										
NO.	BUILDING	LOCATION	TANK CAPACITY (GALLONS)	SERVICE	TYPE	SIZE	CONNECTION SIZE	REMARKS		
HT-1	PUMP STATION	MIDDLE LEVEL	211	WELL WATER	CLOSED	91" x 30" ø	1"	-		
HT-2	PUMP STATION	MAIN LEVEL	18	DCW	CLOSED	31-1/4" x 16-1/4" ø	2"	-		

