

WESTCHESTER COUNTY



WESTCHESTER COUNTY, NEW YORK DEPARTMENT OF PUBLIC WORKS AND TRANSPORTATION DIVISION OF ENGINEERING

CONTRACT No. 18-515 ROOF REPLACEMENT PROGRAM MAMARONECK WATER RESOURCE RECOVERY FACILITY PEEKSKILL WATER RESOURCE RECOVERY FACILITY MAMARONECK AND PEEKSKILL, NEW YORK

GENERAL NOTES

BEGINNING WORK IF ANY DISCREPANCIES ARE FOUND

- DISTURB ONLY THOSE AREAS OF THE FACILITY AFFECTED BY DEMOLITION, UNLESS NOTED OTHERWISE, PROTECT ALL OTHER AREAS. ALL WORK SHALL COMPLY WITH ALL APPLICABLE CODES, LAWS,
- AGENCIES HAVING JURISDICTION, AND STATUTES AS REQUIRED. VERIFY ALL CHANGES TO THE WORK IN WRITING WITH THE ARCHITECT AND OWNER BEFORE BEGINNING RELATED WORK.
- REVIEW ALL DRAWINGS CONTAINED IN THIS SET. SO AS TO BECOME FAMILIAR WITH THE WORK REQUIRED UNDER THE CONTRACT. VERIFY AND ADJUST APPROXIMATE DIMENSIONS (+/-) IN THE FIELD.
- VERIFY WITH ARCHITECT PRIOR TO CONSTRUCTION. PROTECT ALL ADJACENT EXISTING CONSTRUCTION. PATCH, REPAIR AND/OR REPLACE, AND REFINISH AS REQUIRED TO RESTORE AREAS
- DAMAGED DURING DEMOLITION, AND CONSTRUCTION. THE OWNER RESERVES THE RIGHT AT ALL TIMES TO DELIVER. PLACE AND INSTALL EQUIPMENT AND FURNISHINGS AS THE WORK PROGRESSES SO LONG AS THERE IS NOT A CONFLICT WITH THE
- CONTRACTOR. MAINTAIN AT THE SITE ONE RECORD COPY OF ALL DRAWINGS, SPECIFICATIONS AND APPROVED SHOP DRAWINGS AND APPROVED SAMPLES MARKED CURRENTLY TO RECORD ALL CHANGES DURING CONSTRUCTION.
- ANY CHANGES TO THE SCOPE OF WORK OR IN THE CONSTRUCTION DETAILS, WHETHER DUE TO FIELD CONDITIONS OR OMISSION SHALL BE DOCUMENTED BY THE ARCHITECT PRIOR TO EXECUTION. ANY INCREASE OR DECREASE IN THE CONTRACT PRICE MUST BE APPROVED IN WRITING PRIOR TO EXECUTION.
- GENERAL SAFETY AND SECURITY STANDARDS FOR CONSTRUCTION
- 15.1. ALL CONSTRUCTION MATERIALS SHALL BE STORED IN A SAFE AND
- 15.2. FENCES AROUND CONSTRUCTION SUPPLIES OR DEBRIS SHALL BE MAINTAINED. 15.3. ALL FENCING SHALL BE PROVIDED WITH SECURITY SCREENING.
- 16. SEPARATION OF CONSTRUCTION AREAS FROM OCCUPIED SPACES. CONSTRUCTION AREAS WHICH ARE UNDER THE CONTROL OF A CONTRACTOR AND THEREFORE NOT OCCUPIED BY COUNTY STAFF SHALL BE SEPARATED FROM OCCUPIED AREAS. PROVISIONS SHALL BE MADE TO PREVENT THE PASSAGE OF DUST AND CONTAMINANTS INTO OCCUPIED PARTS OF THE BUILDING/SITE. PERIODIC INSPECTION AND REPAIRS OF THE CONTAINMENT BARRIERS MUST BE MADE TO PREVENT **EXPOSURE TO DUST AND CONTAMINANTS.**
- CONSTRUCTION AND MAINTENANCE OPERATIONS SHALL NOT PRODUCE NOISE IN EXCESS OF 60 dba IN OCCUPIED OR ACOUSTICAL ABATEMENT MEASURES SHALL BE TAKEN.

- JRIENTED TO UTILIZE A MINIMUM OF SPACE AND SHALL BE CONFIRMEI BY THE CONTRACTOR WITH THE OWNER BEFORE MOBILIZATION AT A
- PRE-CONSTRUCTION MEETING. WHEN SETTING UP STAGING AND WORK AREAS, CONTRACTORS MUST TAKE CARE NOT TO DISRUPT ANY ENTRANCES, WALKWAYS, DRIVEWAYS OR ANY FEATURES WHICH MAY BE IN USE DURING THE DURATION OF THE PROJECT. RESTORE EACH AREA UPON COMPLETION
- OF THE WORK IN THAT AREA. 23. AT THE END OF EACH WORK DAY, REMOVE ALL DEBRIS, INCLUDING BUT NOT LIMITED TO NAILS AND ROOFING MATERIALS, FROM THE WORK AREA AND PLACE IN THE DUMPSTERS PROVIDED BY THE CONTRACTOR.
- 24. ALL EXITS MUST BE KEPT CLEAR OF CONSTRUCTION OPERATION AND DEBRIS AT ALL TIMES.
- 25. PERFORM ALL WORK AND COORDINATE ALL ASPECTS OF CONSTRUCTION TO KEEP THE CONSTRUCTION DURATION AND DISTURBANCE OF FACILITY TO A MINIMUM.
- 26. DOCUMENT, THROUGH DIGITAL PHOTOGRAPHS, THE CONDITION OF THE SITE, BUILDING AND SURROUNDING CONDITIONS PRIOR TO DEMOLITION. NOTIFY ARCHITECT OF ANY DAMAGED AREAS PRIOR TO MOBILIZATION. OVER DEMOLITION SHALL BE ALLOWED PROVIDED THAT ALL SURFACES SHALL BE REBUILT TO MATCH MATERIALS, STRUCTURAL INTEGRITY AND APPEARANCE OF THOSE WHICH WERE REMOVED AND IN CONFORMANCE WITH CONTRACT DOCUMENTS AND AT NO ADDITIONAL COST TO THE OWNER. IF AT THE END OF THE PROJECT THERE ARE DAMAGES TO THE SITE, BUILDING OR SURROUNDING CONDITIONS, THE CONTRACTOR IS RESPONSIBLE TO RESTORE AS BUILT CONDITIONS AT NO ADDITIONAL COST TO THE OWNER.
- MAINTAIN WATER-TIGHT WEATHER PROTECTION THROUGHOUT ALL WORK AREAS AND EXISTING AREAS IMMEDIATELY ADJACENT TO THOSE WORK AREAS FOR THE ENTIRE DURATION OF THE PROJECT. AS SUCH, THE CONTRACTOR MAY ONLY REMOVE WHAT CAN BE REINSTALLED ON ANY WORK DAY TO MAINTAIN A WATER-TIGHT ENCLOSURE.
- 28. COORDINATE ALL DEMOLITION AND CONSTRUCTION OPERATIONS WITH THE COUNTY, FACILITY STAFF AND ANY OTHER CONTRACTS WORKING
- 29. CONTRACTOR PARKING AREAS SHALL BE LOCATED ONLY IN AREAS APPROVED AND AUTHORIZED BY THE OWNER. THERE SHALL BE NO PARKING AVAILABLE ON SITE AT MAMARONECK WRRF.

SHEET NO. SHEET TITLE

1.0	COVER SHEET & GENERAL NOTES	205-01-T-455-0
IF1.0	GENERAL NOTES, LEGENDS AND LOCATION PLANS	205-01-G-456-0
SB1.0	ASBESTOS ABATEMENT ROOF PLANS, NOTES AND LEGEND	205-01-AB-457-0
1.0	MAMARONECK: DEMOLITION ROOF PLAN (BUILDING AREA 'I')	205-01-A-458-0
1.1	MAMARONECK: DEMOLITION ROOF PLAN (BUILDING AREA 'II')	205-01-A-459-0
1.2	MAMARONECK: ROOF PLAN (BUILDING AREA 'I')	205-01-A-460-0
1.3	MAMARONECK: ROOF PLAN (BUILDING AREA 'II')	205-01-A-461-0
2.0	PEEKSKILL: DEMOLITION ROOF PLANS	209-01-A-397-0
2.1	PEEKSKILL: ROOF PLANS	209-01-A-398-0
3.0	ROOF DETAILS	205-01-A-462-0
3.1	ROOF DETAILS	205-01-A-463-0

DPW FILE NO.

205-01-A-463-0

(118) Bedford Hills Chappaqua Briarcliff Rye Brook Dobbs Ferry Palisades Eastchester Interstate Park Tuckahoe (125) Marnaroneck Bronxville **MAMARONECK** Yonkers WATER RESOURCE RECOVERY FACILITY -Mt Vernon New Rochelle SCALE: N.T.S **ALL SITES** engineers 538 Broad Hollow Road 4th Floor East Melville, NY 11747 P: (631) 756-8000 F: (631) 694-4122 | DATE | BY MADE APP'D REVISION | REVISION NUMBER RECORD DRAWING CERTIFICATION AS BUILT - CHANGES AS NOTED AS BUILT - NO CHANGES CONTRACTOR PROJECT COORDINATOR NAME NAME SIGNATURE WESTCHESTER COUNTY, NEW YORK NUMBER NUMBER 18-515 T1.0 DEPARTMENT OF PUBLIC WORKS AND TRANSPORTATION DIVISION OF ENGINEERING SHEET NO. 1 OF 11 SCALE: AS SHOWN ROOF REPLACEMENT PROGRAM DATE: AUGUST 2021 MAMARONECK & PEEKSKILL DPW FILE NO. WATER RESOURCE RECOVERY FACILITIES 205-01-T-455-0|# COVER SHEET & GENERAL NOTES

IT IS A VIOLATION OF NYS LAW FOR ANY PERSON TO ALTER THIS DOCUMENT IN ANY WAY, UNLESS ACTING UNDER THE DIRECTION OF A LICENSED PROFESSIONAL ENGINEER. IF A DOCUMENT BEARING THE SEAL ON AN ENGINEER IS ALTERED, THE ALTERING ENGINEER SHALL AFFIX TO THE DOCUMENT THEIR SEAL AND THE NOTATION "ALTERED BY" FOLLOWED BY THEIR SIGNATURE AND THE DATE OF SUCH ALTERATION, AND A SPECIFIC DESCRIPTION OF THE

RECOMMENDED FOR DESIGN

FACILITIES

JOSEPH GIBNEY, P.E. DIRECTOR OF WASTEWATER TREATMENT DEPARTMENT OF ENVIRONMENTAL

RECOMMENDED FOR CONSTRUCTION

LEAH RADKO, P.E. DIRECTOR OF DESIGN COORDINATION DEPARTMENT OF PUBLIC WORKS AND TRANSPORTATION

RECOMMENDED FOR CONSTRUCTION

GAYLE M. KATZMAN, P.E. FIRST DEPUTY COMMISSIONER DEPARTMENT OF PUBLIC WORKS AND TRANSPORTATION

VINCENT F. KOPICKI, P.E. COMMISSIONER

FACILITIES


APPROVED FOR CONSTRUCTION

DEPARTMENT OF ENVIRONMENTAL

HUGH J. GREECHAN, JR., P.E. COMMISSIONER DEPARTMENT OF PUBLIC WORKS AND TRANSPORTATION

APPROVED FOR CONSTRUCTION



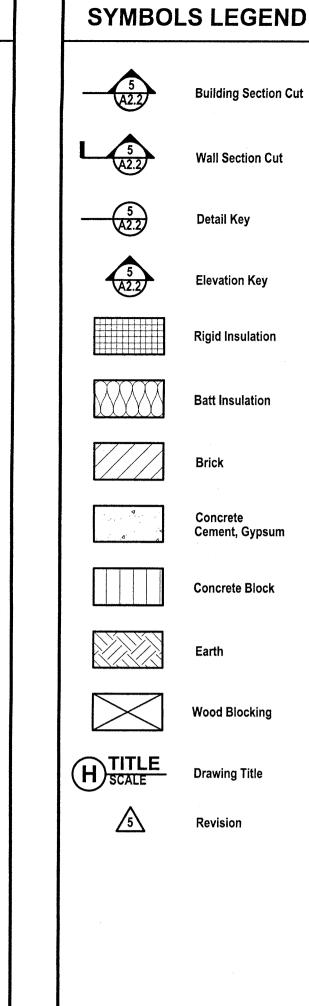

GENERAL DEMOLITION NOTES:


THE INTENDED DEMOLITION SCOPE OF WORK INCLUDES BUT IS NOT LIMITED TO THE FOLLOWING:

- PROJECT INVOLVES REMOVAL AND DISPOSAL (ABATEMENT) OF ASBESTOS CONTAINING MATERIAL AS LISTED IN THE ENVIRONMENTAL REPORT INCLUDED IN THE PROJECT MANUAL AS APPENDIX. REFER TO ASBESTOS REPORT FOR ACM MATERIALS AND LOCATIONS.
- REMOVAL AND DISPOSAL OF ALL EXISTING ROOFING MATERIALS DOWN TO SUBSTRATE, INCLUDING ALL ASSOCIATED ROOF BALLAST, ROOF FLASHING, INSULATION, CAULKING AND MASTIC.
- 3. THE CONTRACTOR IS RESPONSIBLE FOR ALL DAMAGES TO THE INTERIOR AND EXTERIOR OF THE BUILDING THAT RESULTED FROM AND DURING DEMOLITION WORK AND INCLUDES BUT IS NOT LIMITED TO ADHESIVE DRIPPINGS, CEILING TILES, WATER LEAKS, ETC.
- OVER-DEMOLITION SHALL BE ALLOWED PROVIDED THAT ALL SURFACES SHALL BE REBUILT TO MATCH MATERIALS, STRUCTURAL INTEGRITY AND APPEARANCE OF THOSE WHICH WERE REMOVED AND IN CONFORMANCE WITH CONTRACT DOCUMENTS AND AT NO ADDITIONAL COST TO
- 5. COORDINATE THE WORK OF THE DEMOLITION DRAWING WITH ALL CONSTRUCTION DRAWINGS AND DOCUMENTS.
- 6. THE CONTRACTOR SHALL VERIFY THE LOCATIONS, SIZES AND HEIGHTS OF ALL EXISTING ROOF PENETRATIONS, MECHANICAL EQUIPMENT MECHANICAL DUCTWORK & MECHANICAL CURBS. THE CONTRACTOR SHALL PROTECT AT ALL TIMES ALL ROOF MOUNTED EQUIPMENT, ROOF MOUNTED DUCTWORK, DUCTWORK INSULATION AND VENT STACKS. ANY DAMAGED ITEMS SHALL BE REPLACED AT NO ADDITIONAL COST TO
- 7. ALL EXISTING PENETRATIONS AND ROOF TOP EQUIPMENT ARE TO BE MODIFIED AS REQUIRED TO ACCOMMODATE THE NEW INSULATION &
- 8. PERFORM ALL DEMOLITION AS REQUIRED TO COMPLETE WORK.
- 9. THE CONTRACTOR IS RESPONSIBLE TO PROTECT ALL FINISHES IN ALL AREAS AFFECTED BY DEMOLITION AND CONSTRUCTION.
- 10. THE CONTRACTOR SHALL PROVIDE ADEQUATE TEMPORARY DRAINAGE FOR ALL PORTIONS OF THE ROOF, THROUGHOUT THE ENTIRE DURATION OF THE PROJECT.
- 11. OBEY ALL STATUTES, CODES AND LAWS AS APPLICABLE TO DEMOLITION WORK IN AN OCCUPIED BUILDING AND FOR REMOVAL OF MATERIALS SAFELY TO THE STREET, INCLUDING ALL OSHA REGULATIONS.
- 12. DISPOSE OF ALL UNWANTED MATERIALS AND OTHER DEMOLITION DEBRIS OFF SITE IN ACCORDANCE WITH CONTRACT REQUIREMENTS AND APPLICABLE LAWS AND REGULATIONS.
- 13. REMOVE ALL ITEMS THAT WILL BE ABANDONED AS A RESULT OF THE WORK BEING PERFORMED.
- 14. COORDINATE THE EXACT LOCATIONS OF ALL DUMPSTERS, AND MATERIALS STORED AT GRADE WITH THE ARCHITECT AND THE OWNER.
- 15. ALL DEBRIS IS TO BE REMOVED IN A WAY THAT DOES NOT CONFLICT WITH THE OWNER'S OPERATIONS.
- 16. UPON REMOVAL OF DEMOLITION ITEMS, CONTRACTOR IS RESPONSIBLE TO INSPECT CONDITION OF EXISTING DECKING AND REPORT FINDINGS
- 17. CONTRACTOR SHALL NOT REMOVE MORE ROOFING THAN CAN BE REPLACED IN ONE WORK DAY.

BLOWER

BUILDING


- 18. THE DEMOLITION PLANS REPRESENT A GENERAL LIST OF DEMOLITION ITEMS AND IS NOT EVERY ITEM REQUIRED FOR DEMOLITION. CONTRACTOR SHALL PROVIDE ALL DEMOLITION REQUIRED TO PERFORM ALL WORK INDICATED WITHIN THE PROJECT DRAWINGS AND SPECIFICATIONS AND TO PREPARE ALL AREAS FOR THE CONSTRUCTION WORK.
- 19. CONTRACTOR SHALL BE RESPONSIBLE TO MODIFY/REMOVE AND REINSTALL EXISTING DUCTWORK AS REQUIRED TO COMPLETE DEMOLITION
- 20. CONTRACTOR SHALL TEMPORARILY PROTECT EXISTING INTAKE WALL LOUVERS AS REQUIRED DURING DEMOLITION. COORDINATE (AT MAMARONECK) WITH OWNER'S OPERATION.

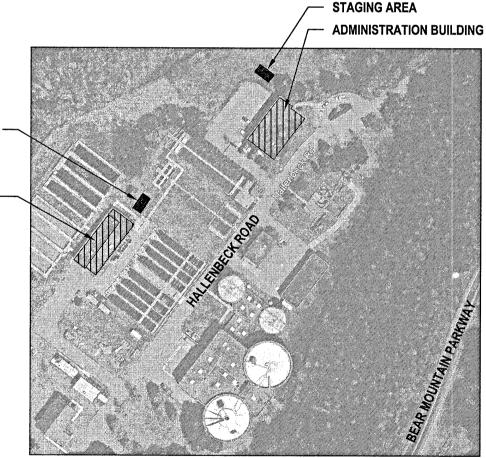

(ALTERNATE

PRIOR COMMENCEMENT OF WORK

SECTION 1508: ROOF INSULATION

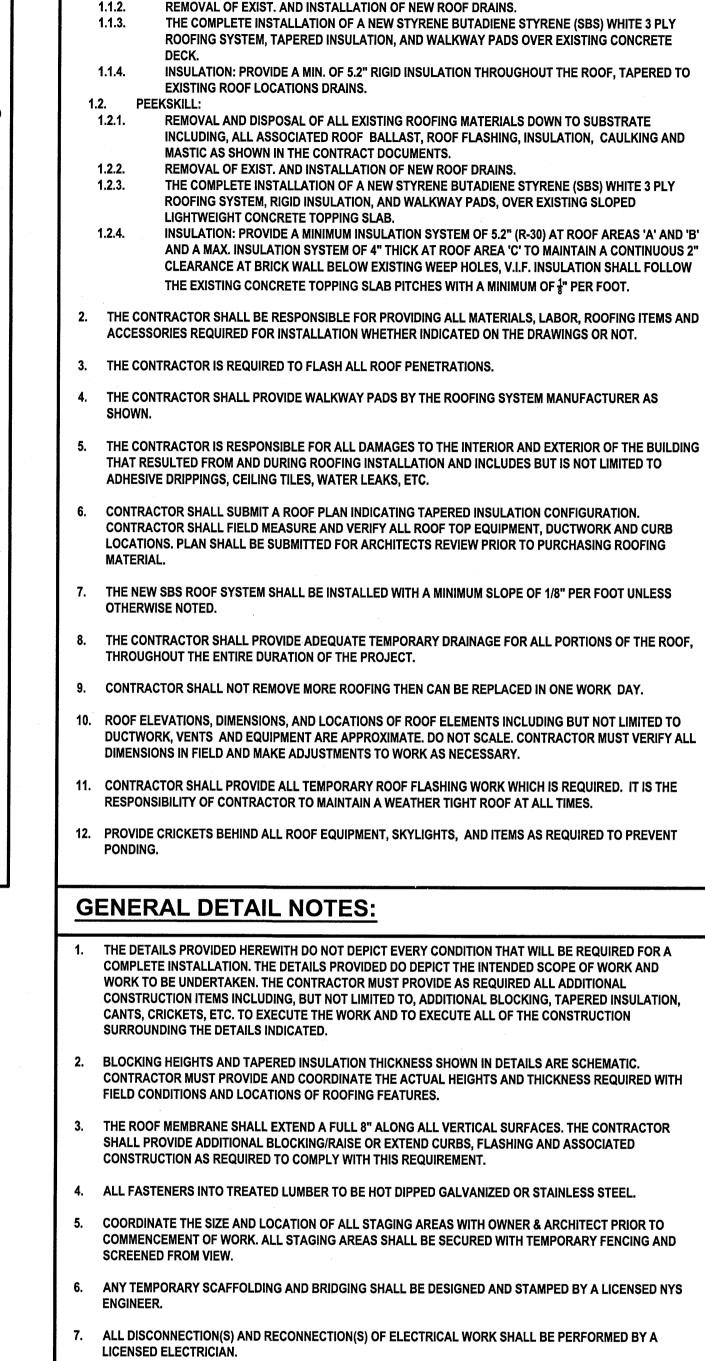

GENERAL ROOFING NOTES:

1.1. MAMARONECK:

1.1.1.

THE INTENDED SCOPE OF WORK INCLUDES BUT IS NOT LIMITED TO THE FOLLOWING:

CAULKING AND MASTIC AS SHOWN IN THE CONTRACT DOCUMENTS.

REMOVAL AND DISPOSAL OF ALL EXISTING ROOFING MATERIALS DOWN TO SUBSTRATE

INCLUDING, ALL ASSOCIATED ROOF BALLAST, ROOF FLASHING, TAPERED INSULATION,

SYMBOL DESCRIPTION AREA OF EXISTING ROOF SYSTEM TO BE REMOVED AND DISPOSED OF DOWN TO EXISTING DECK AREA OF STYRENE BUTADIENE STYRENE (SBS) ROOFING SYSTEM, INCLUDING BUT NOT LIMITED TO VAPOR BARRIER, TAPERED INSULATION (AT MAMARONECK) AND NON-TAPERED INSULATION (AT PEEKSKILL) (MIN. R-30) U.O.N. AREA OF STYRENE BUTADIENE STYRENE (SBS) ROOFING SYSTEM AT ROOF AREA "C' (PEEKSKILL), PROVIDE MINIMUM 4" INSULATION. REFER TO ROOFING NOTE 1.2.4. AND DEMOLITION NOTES FOR ADDITIONAL INFORMATION EXISTING CURB MOUNTED EQUIPMENT TO REMAIN. EXTEND EXISTING CURB, REMOVE AND REINSTALL EXISTING **EQUIPMENT AS REQUIRED TO ACCOMMODATE NEW ROOFING** SYSTEM AND INSULATION. EXISTING SKYLIGHT & CURB TO BE REMOVED AND DISPOSED OF, PREPARE EXISTING OPENING TO RECEIVE **NEW CURB & SKYLIGHT** SKYLIGHT WITH CURB AT EXISTING DECK OPENING, REFER TO DETAIL 3 ON A3.0 **EXISTING VENT STACK TO REMAIN - SEE DETAILS FOR NEW** PENETRATION FLASHING. EXTEND AS REQUIRED FOR NEW ROOF INSULATION AND FLASHING. FURNISH AND INSTALL FLASHING AT ROOF PENETRATIONS AS SHOWN, TYPICAL. EXISTING ELECTRICAL CONDUIT AND SUPPORTS TO BE TEMPORARILY RELOCATED AS NEEDED FOR THE INSTALLATION OF THE NEW ROOFING SYSTEM, U.O.N.. PROVIDE PIPE SUPPORTS AS SPECIFIED. EXISTING DRAIN LOCATION; REMOVE AND DISPOSE OF EXISTING DRAIN AND ALL ASSOCIATED CONSTRUCTION, PREPARE AREA AS REQUIRED TO RECEIVE NEW CONSTRUCTION. EXISTING PIPING TO BE EXTENDED AS REQUIRED TO ACCOMMODATE ROOF INSULATION THICKNESS. FURNISH AND INSTALL ROOF DRAIN AT **EXISTING DRAIN LOCATION, TYP. EXISTING BUILDING ACCESS POINT - PROVIDE** TEMPORARY SCAFFOLDING AND PROTECTION AT ALL LOCATIONS TO MAINTAIN ACCESS THROUGHOUT DEMOLITION AND CONSTRUCTION ACTIVITIES. LINE INDICATES EXISTING PRE-CAST CONCRETE WALL PANELS. COMPONENTS AND CONNECTIONS TO BE TEMPORARILY REMOVED, MODIFIED & RE-INSTALLED AS REQUIRED FOR THE INSTALLATION OF NEW ROOFING SYSTEM, INSULATION AND FLASHINGS. REFER TO ROOF PLAN AND DETAILS FOR ADDITIONAL INFORMATION. REMOVE AND DISPOSE OF EXISTING PITCH POCKET, PREPARE AREA FOR NEW CONSTRUCTION - SEE DETAIL 6 ON A3.1 FOR ADDITIONAL INFORMATION. FURNISH AND INSTALL PITCH POCKET AT ROOF PENETRATIONS AS SHOWN, TYPICAL FOR ALL. INDICATES SLOPE DIRECTION OF ROOF, PROVIDE MIN. 1/8" SLOPE TOWARDS ROOF DRAINS. CRICKET, PROVIDE MIN. 1/2" SLOPE TOWARDS ROOF DRAINS PROVIDE 2x2 WALKWAY PADS - FINAL LAYOUT TO BE COORDINATED IN FIELD WITH OWNER/ARCHITECT (PROVIDE WALKWAY PADS UNDER ALL PIPING & DUCT SUPPORTS) EXISTING HATCH TO BE REMOVED AND DISPOSED OF. PREPARE EXISTING OPENING FOR NEW HATCH AS SPECIFIED. REFER TO DETAIL 4 ON A3.1 L=====>

ROOF ACCESS HATCH & CURB - SEE DETAIL 4 ON A3.1


REVISION

PROJECT COORDINATOR

NUMBER

205-01-G-456-0

LEGEND:

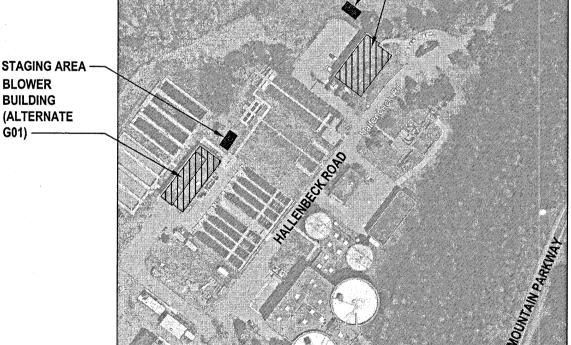

Peekskill Location Plan

SCALE: Not to Scale

ALL STAGING AREA TO BE COORDINATED WITH FACILITY

CODE ANALYSIS SUMMARY: BUILDING TYPE: EXISTING BUILDING

PROJECT TYPE: ROOF REPLACEMENT 2020 EXISTING BUILDING CODE OF NEW YORK STATE (EBCNYS)

Mamaroneck Location Plan

ALL STAGING AREAS TO BE COORDINATED WITH FACILITY

PRIOR COMMENCEMENT OF WORK

ALTERATION LEVEL 1

STAGING AREAS -

INFLUENT PRIMARY

SITE AREA BEING USED

CONSTRUCTION UNDER

EFFLUENT AND

BUILDING AREA

BY OTHERS - NOT

AVAILABLE FOR

DEMOLITION OR

THIS CONTRACT -

SECTION 705 REROOFING: MATERIALS AND METHODS OF APPLICATION USED FOR RECOVERING OR REPLACING AN **EXISTING ROOF COVERING SHALL COMPLY WITH THE** REQUIREMENTS OF CHAPTER 15 OF THE BUILDING CODE OF NEW YORK STATE.

SECTION 706: STRUCTURAL

SECTION 707: ENERGY CONSERVATION - COMPLY WITH THE REQUIREMENTS OF THE ENERGY CONSERVATION CONSTRUCTION CODE OF NEW YORK STATE (ECCCNYS).

2020 ENERGY CONSERVATION CONSTRUCTION CODE OF NEW YORK STATE (ECCCNYS)

C301 CLIMATE ZONE - WESTCHESTER ZONE 4A

C402.1.3 INSULATION ENTIRELY ABOVE ROOF DECK MINIMUM REQUIRED CONTINUOUS INSULATION R = 30. DUE TO EXISTING ROOF CONFIGURATION ROOF AREA "C" AT PEEKSKILL

BLOWER BUILDING THE MINIMUM INSULATION THICKNESS OF 4" 1505.2 CLASS A ROOF ASSEMBLIES' EXEMPTION 1: CLASS A WILL PROVIDE AN R VALUE OF 22. AS PER C 503 ALTERATIONS ROOF ASSEMBLIES INCLUDE THOSE WITH COVERINGS OF THE BUILDING WILL NOT BE LESS CONFORMING THAN EXISTING BRICK, MASONRY OR AN EXPOSED CONCRETE DECK. CONDITIONS.

2020 BUILDING CODE OF NEW YORK STATE (BCNYS) **CHAPTER 15: ROOF ASSEMBLIES AND ROOFTOP STRUCTURES**

SECTION 1502 ROOF DRAINAGE: EXISTING TO REMAIN. SECONDARY (EMERGENCY OVERFLOW) DRAINS EXEMPT **UNDER EBCNYS SECTION 705.1 ITEM 2.**


SECTION 1504 PERFORMANCE REQUIREMENTS:


DESIGN CODE: ASCE 7, METHOD 2 FOR COMPONENTS AND CLADDING CATEGORY IV **BUILDING WITH AN IMPORTANCE FACTOR OF: 1.5** WIND SPEED: 125MPH **EXPOSURE CATEGORY: D ROOF PITCH: 0.125 INCH PER FOOT ROOF AREA DESIGN UPLIFT PRESSURES:** a. CORNER UPLIFT PRESSURE 76.8 LBF/SQ. FT. b. PERIMETER UPLIFT PRESSURE: 51 LBF/ SQ. FT. c. FIELD-OF-ROOF UPLIFT PRESSURE: 30.4 LBF/ SQ. FT.

SECTION 1505: FIRE CLASSIFICATION

SECTION 1507: REQUIREMENTS FOR ROOF COVERINGS - APPLY IN ACCORDANCE WITH THE MANUFACTURER'S INSTALLATION INSTRUCTIONS.

HIGH DENSITY POLYISOCYANURATE BOARD TO COMPLY WITH ASTM C1289 TYPE II, CLASS 4.

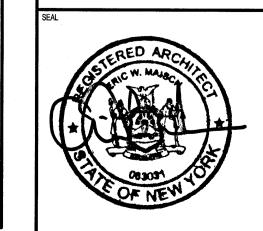

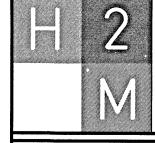

8 Broad Hollow Road

Melville, NY 11747

P:(631)756-8000

F:(631)694-4122

ALL DISCONNECTION(S) AND RECONNECTION(S) OF PLUMBING WORK SHALL BE PERFORMED BY A

Melville, NY 11747 Albany, NY 12205 White Plains, NY 10604 New City, NY 10956

Parsippany, NJ 07054

Howell, NJ 07731

architects engineers

REVISION DATE

NUMBER

MADE | APP'D

AS BUILT - CHANGES AS NOTED

CONTRACTOR


AS BUILT - NO CHANGES


NAME __ SIGNATURE SIGNATURE DATE WESTCHESTER COUNTY, NEW YORK 18-515 | **INF1.0** DEPARTMENT OF PUBLIC WORKS AND TRANSPORTATION DIVISION OF ENGINEERING SHEET NO. 2 OF 11 SCALE: AS NOTED ROOF REPLACEMENT PROGRAM DATE: AUGUST 2021 MAMARONECK AND PEEKSKILL DPW FILE NO. WATER RESOURCE RECOVERY FACILITIES


GENERAL NOTES, LEGENDS AND LOCATION PLANS


RECORD DRAWING CERTIFICATION


IN CHARGE OF _____ CHECKED BY _____

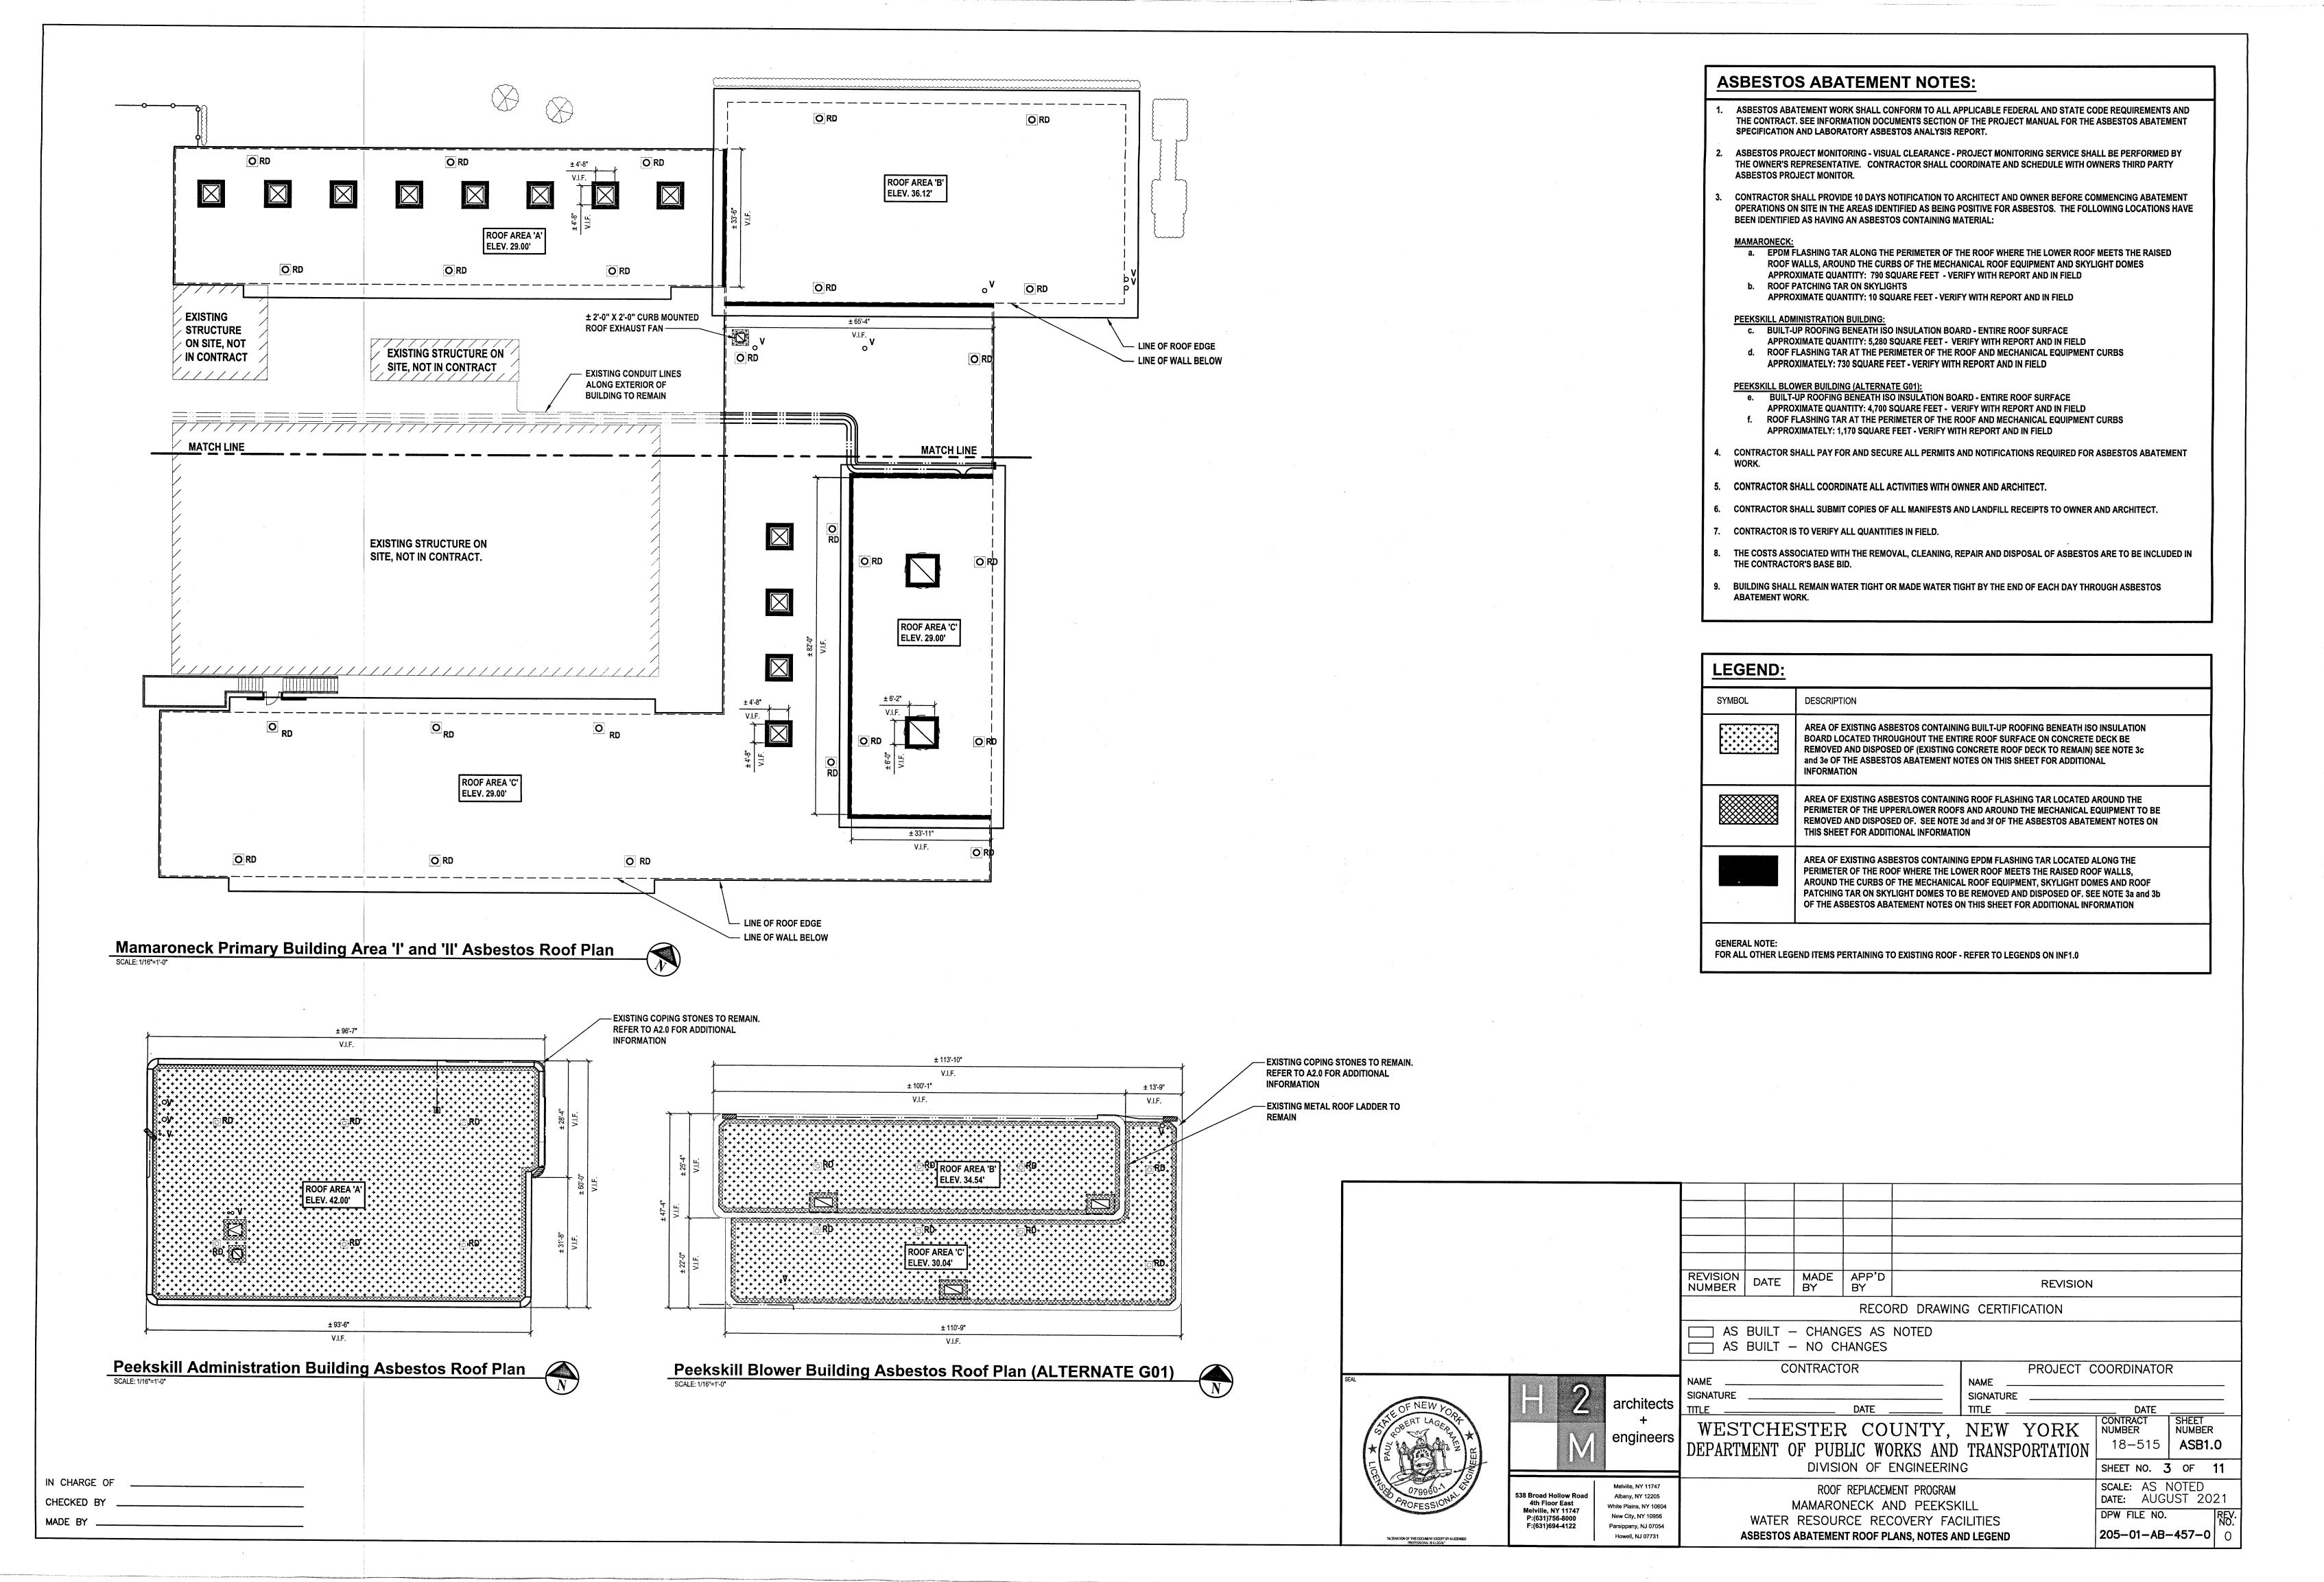


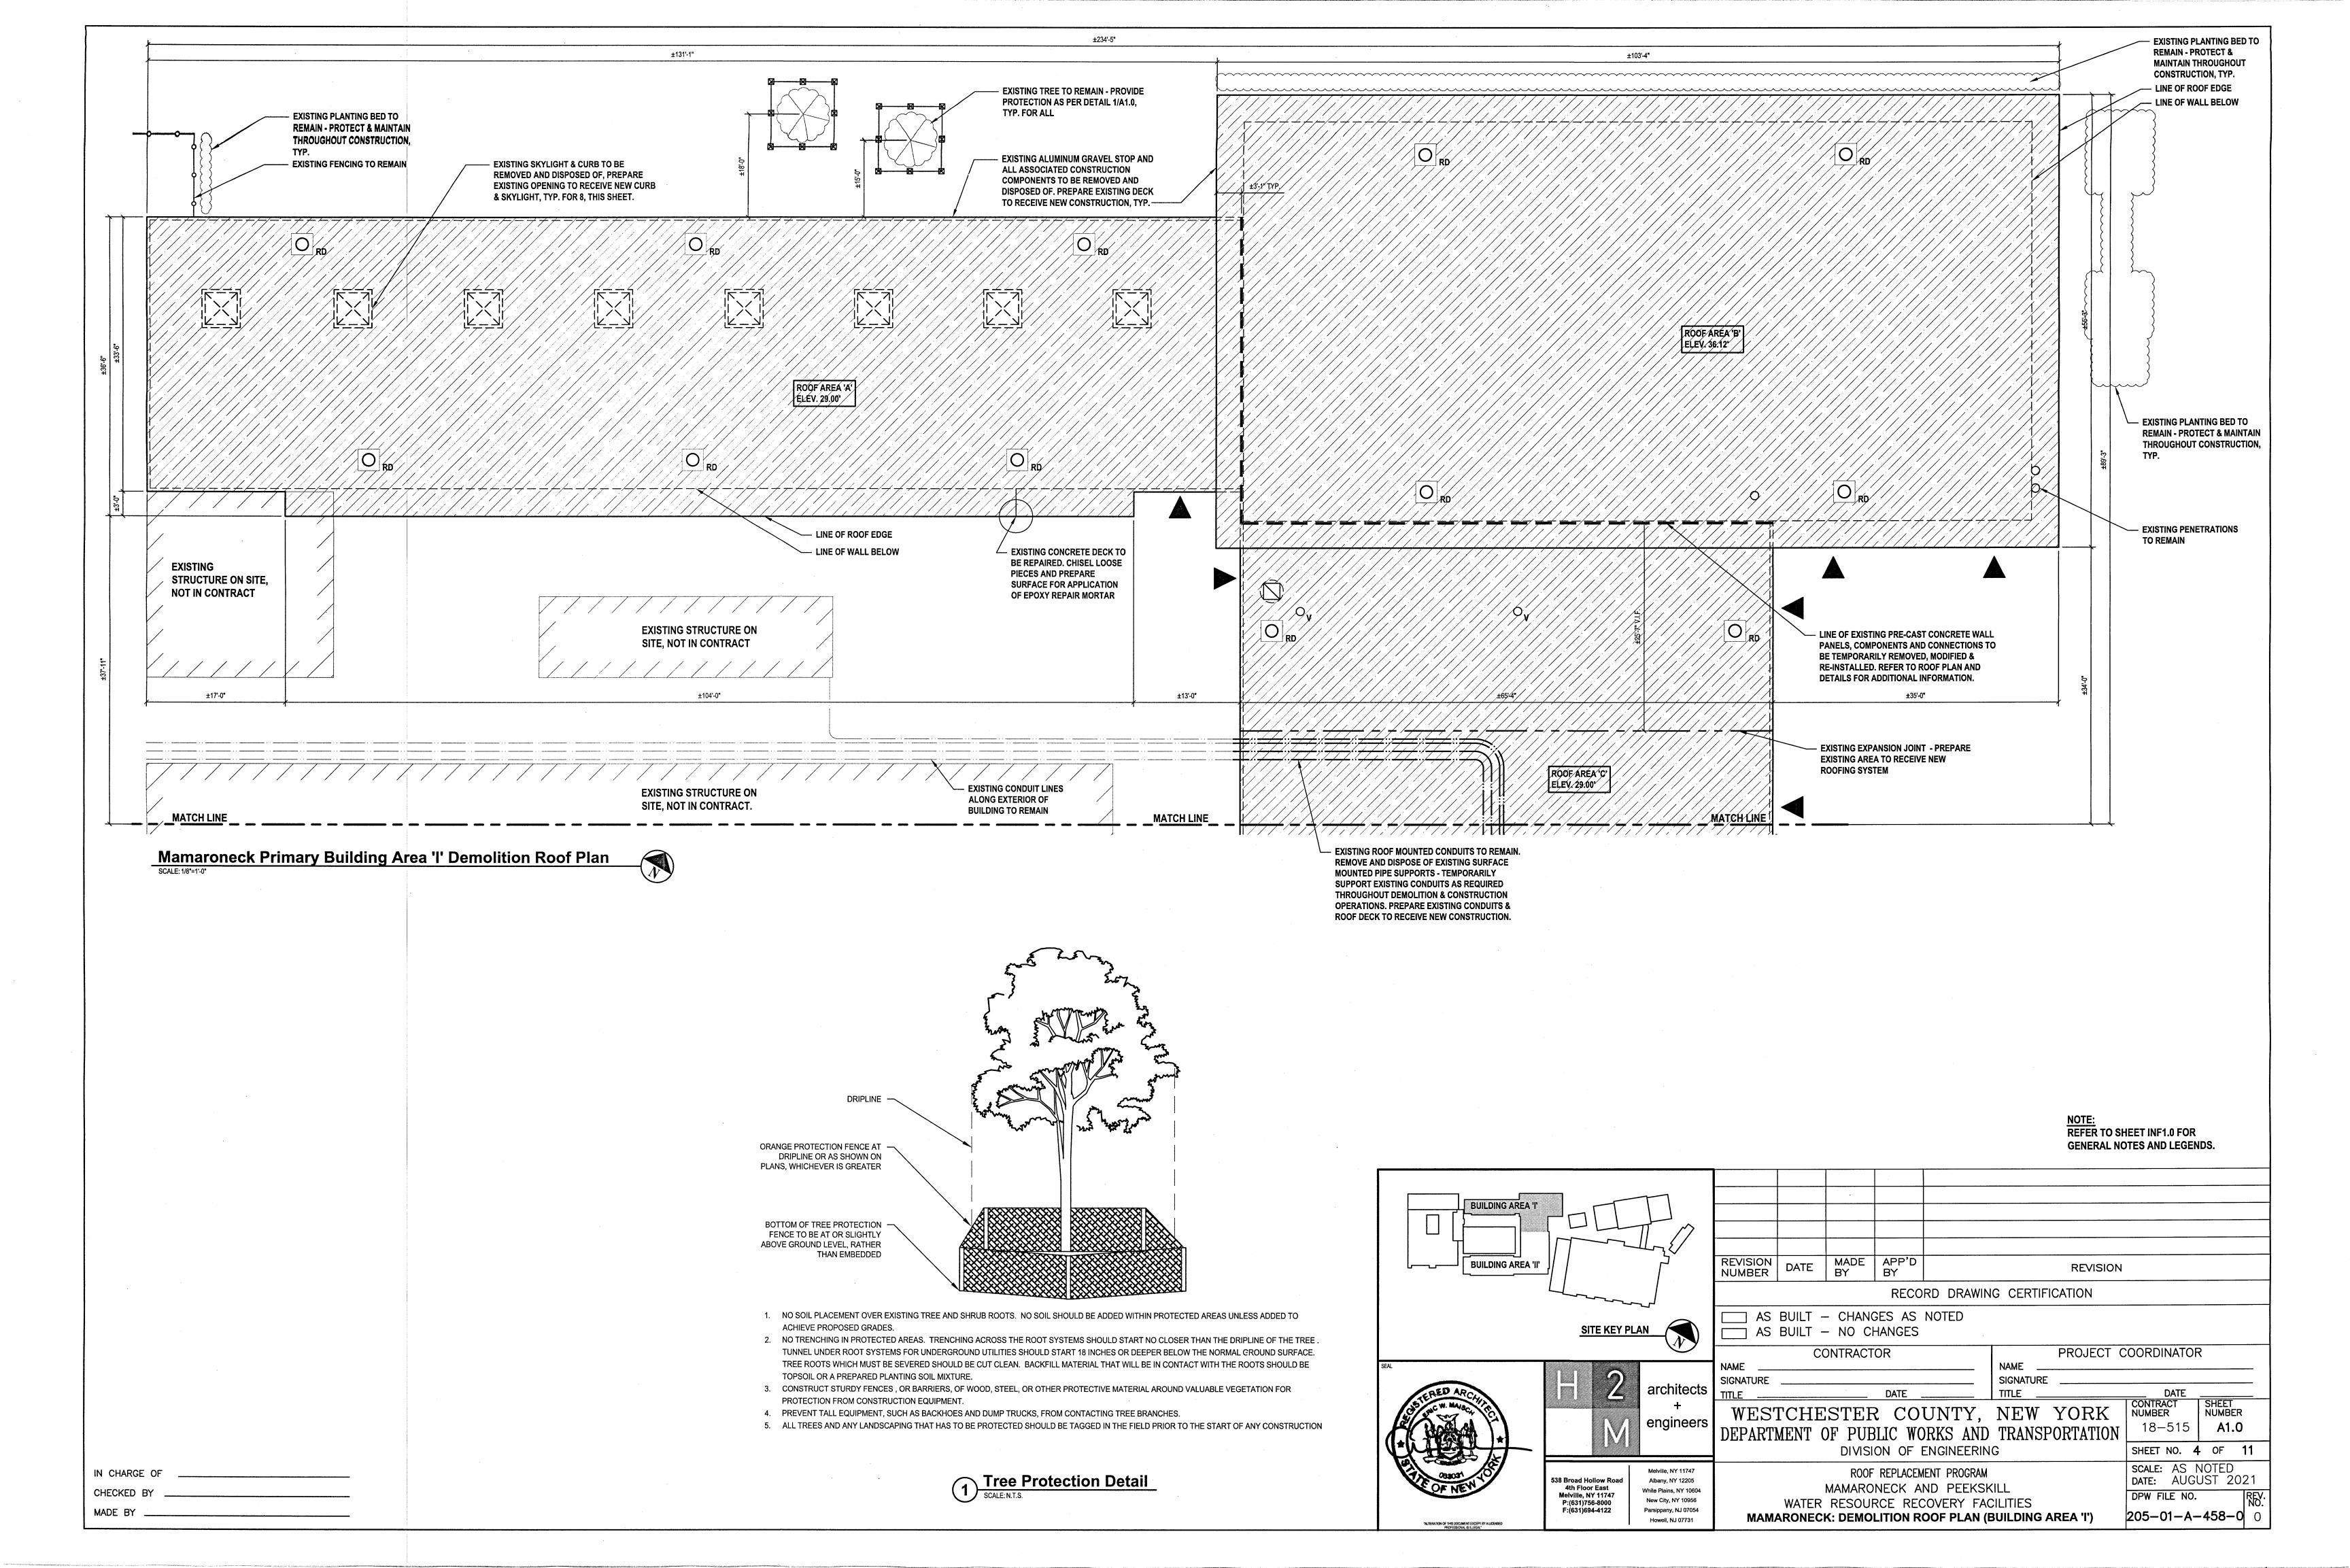


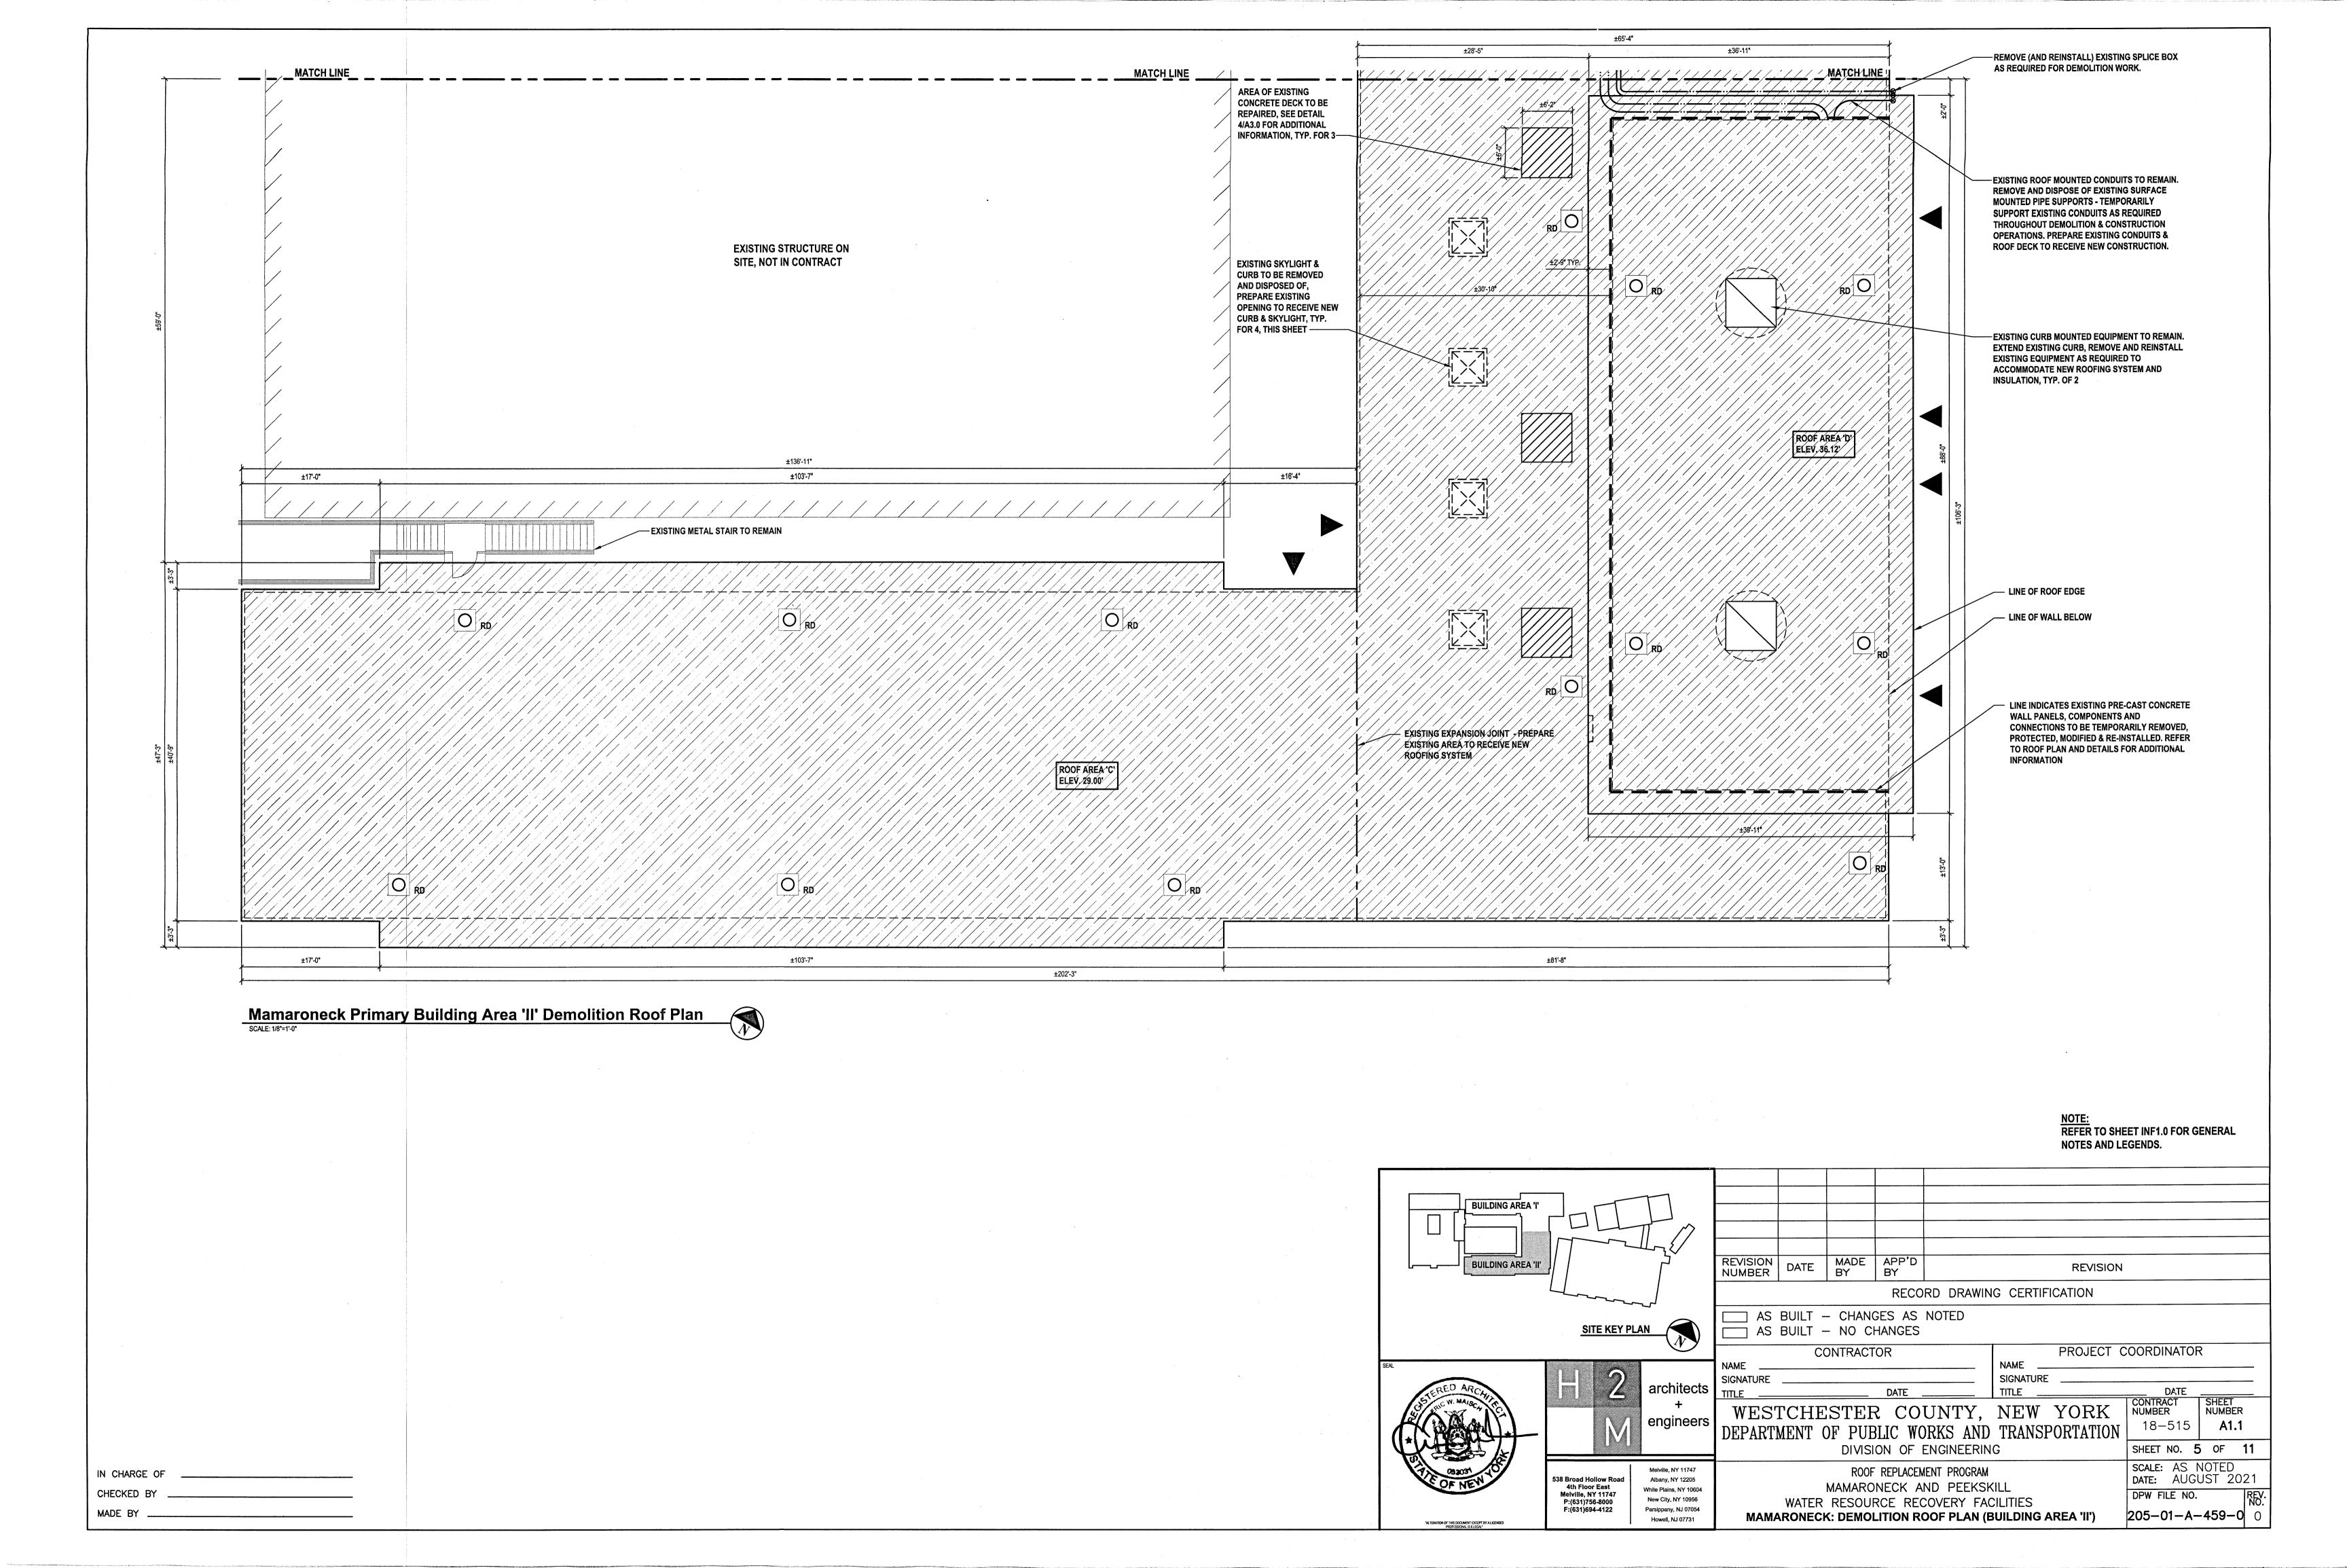

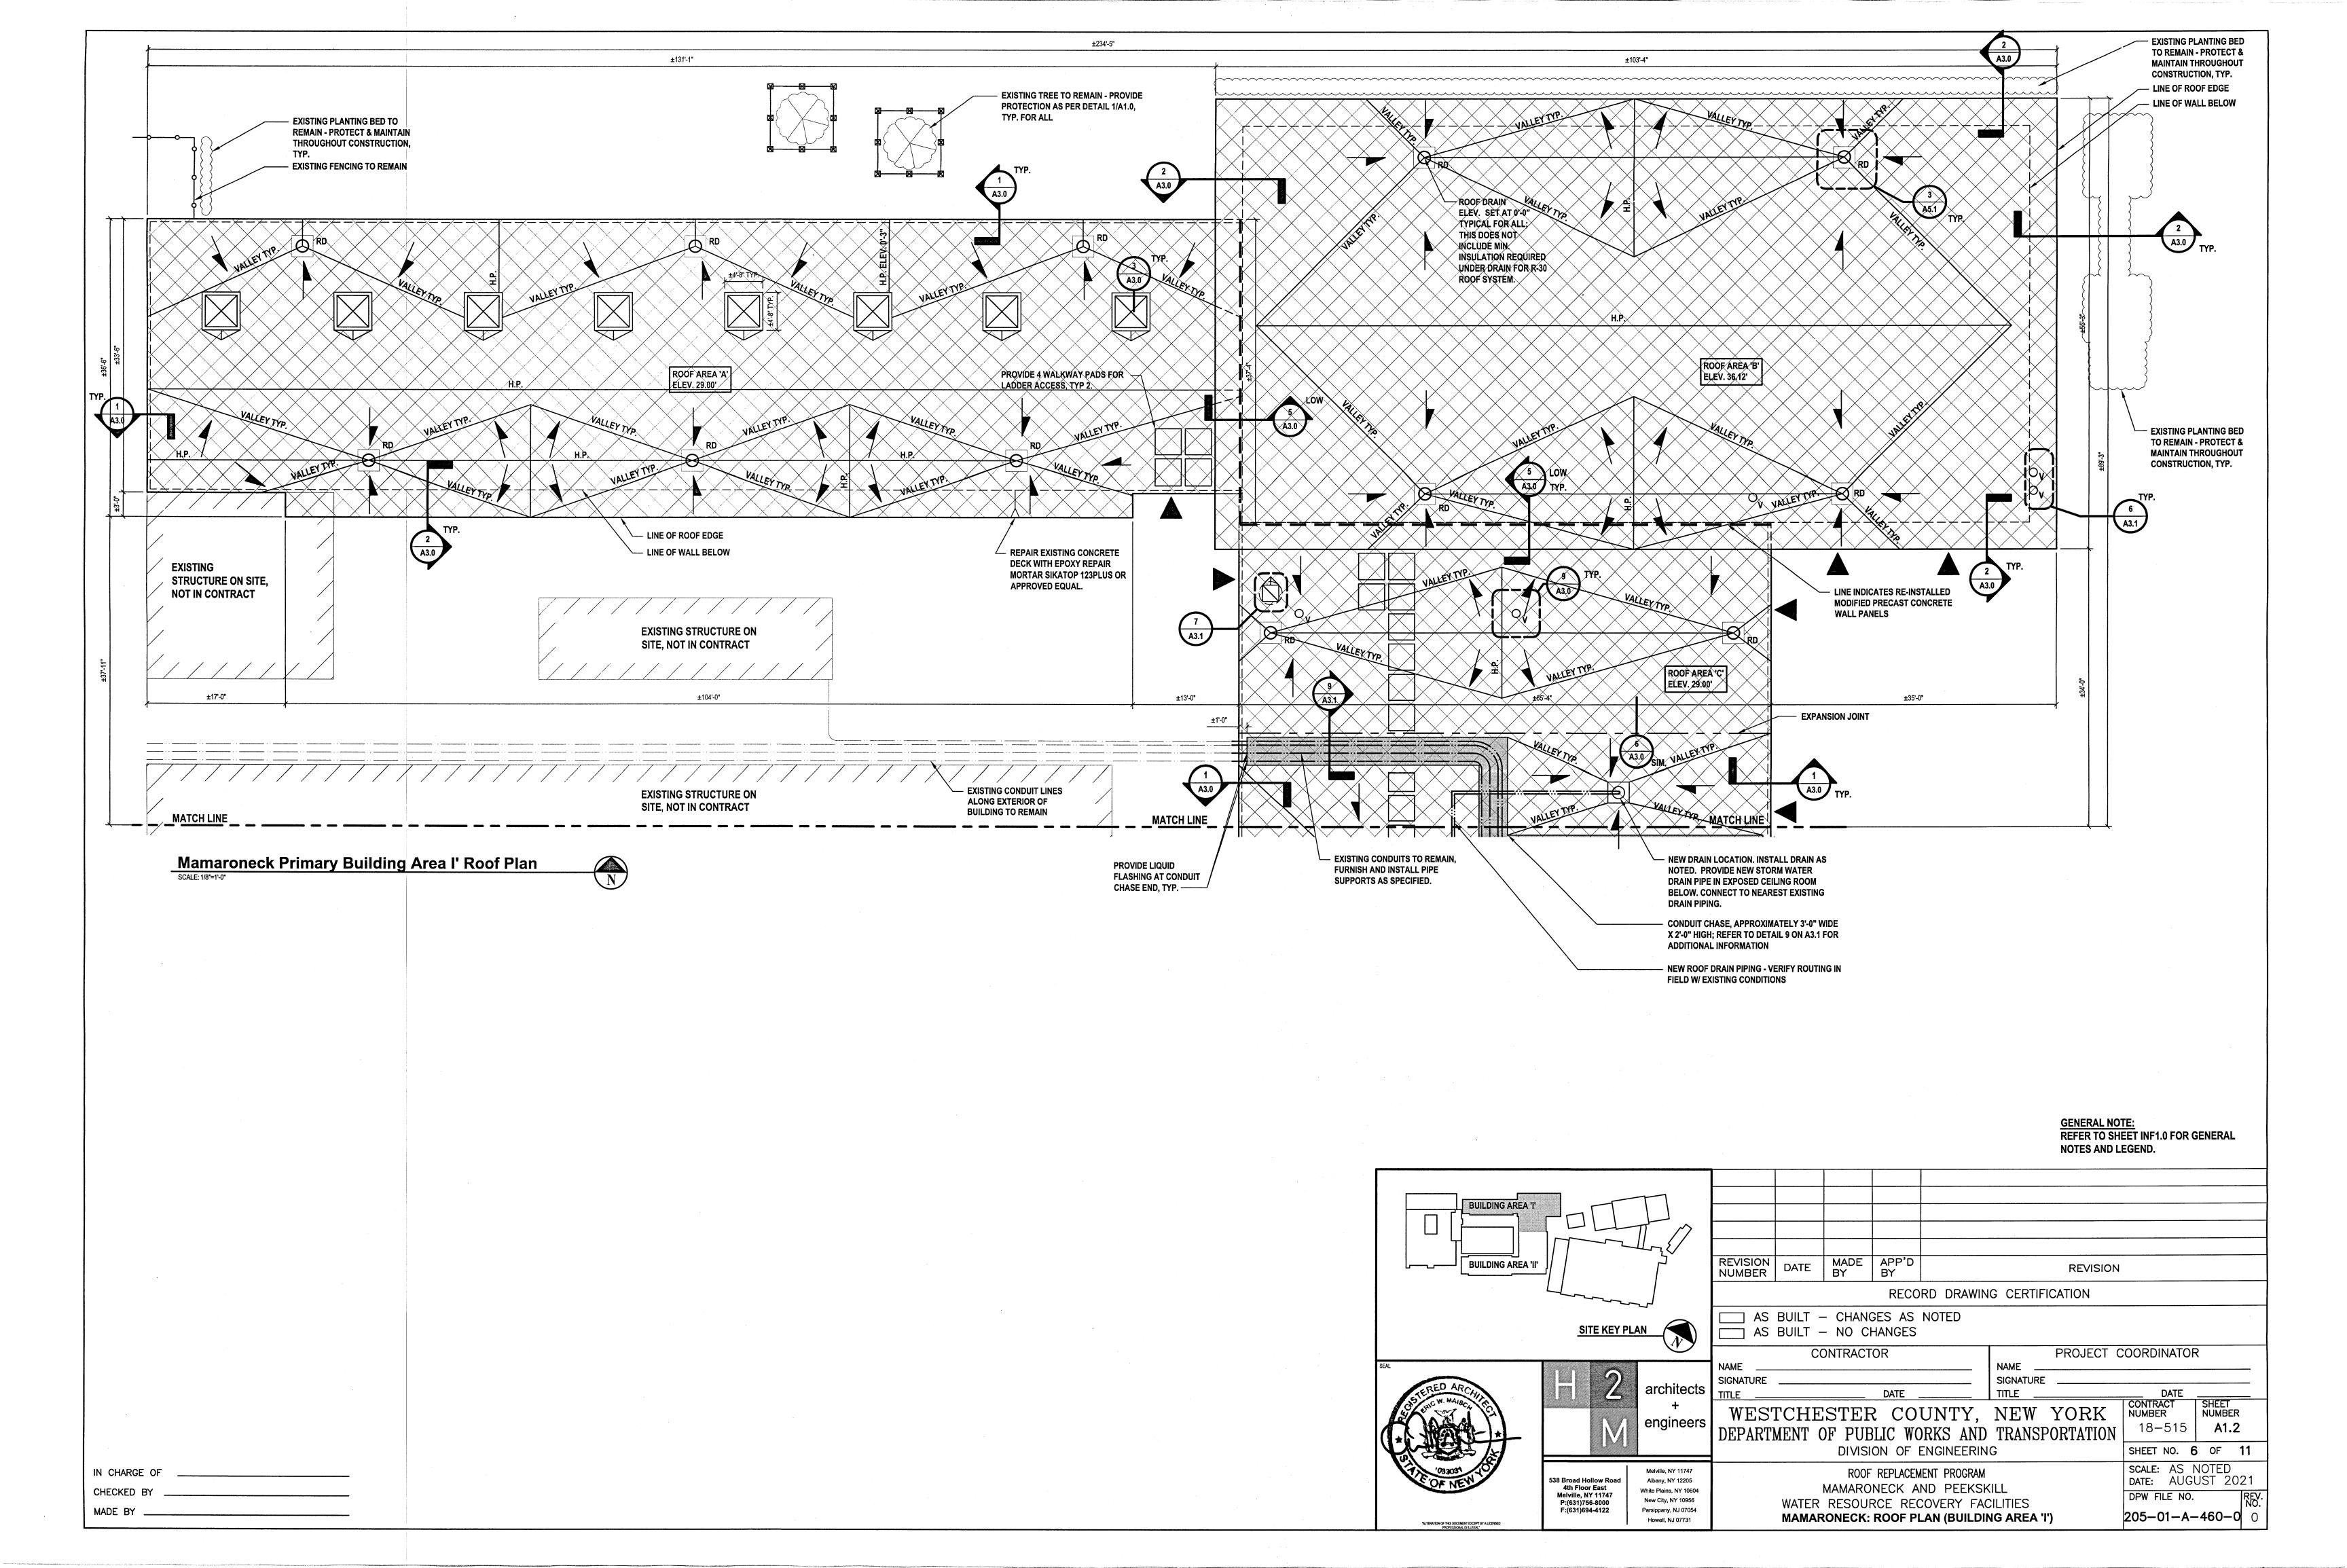

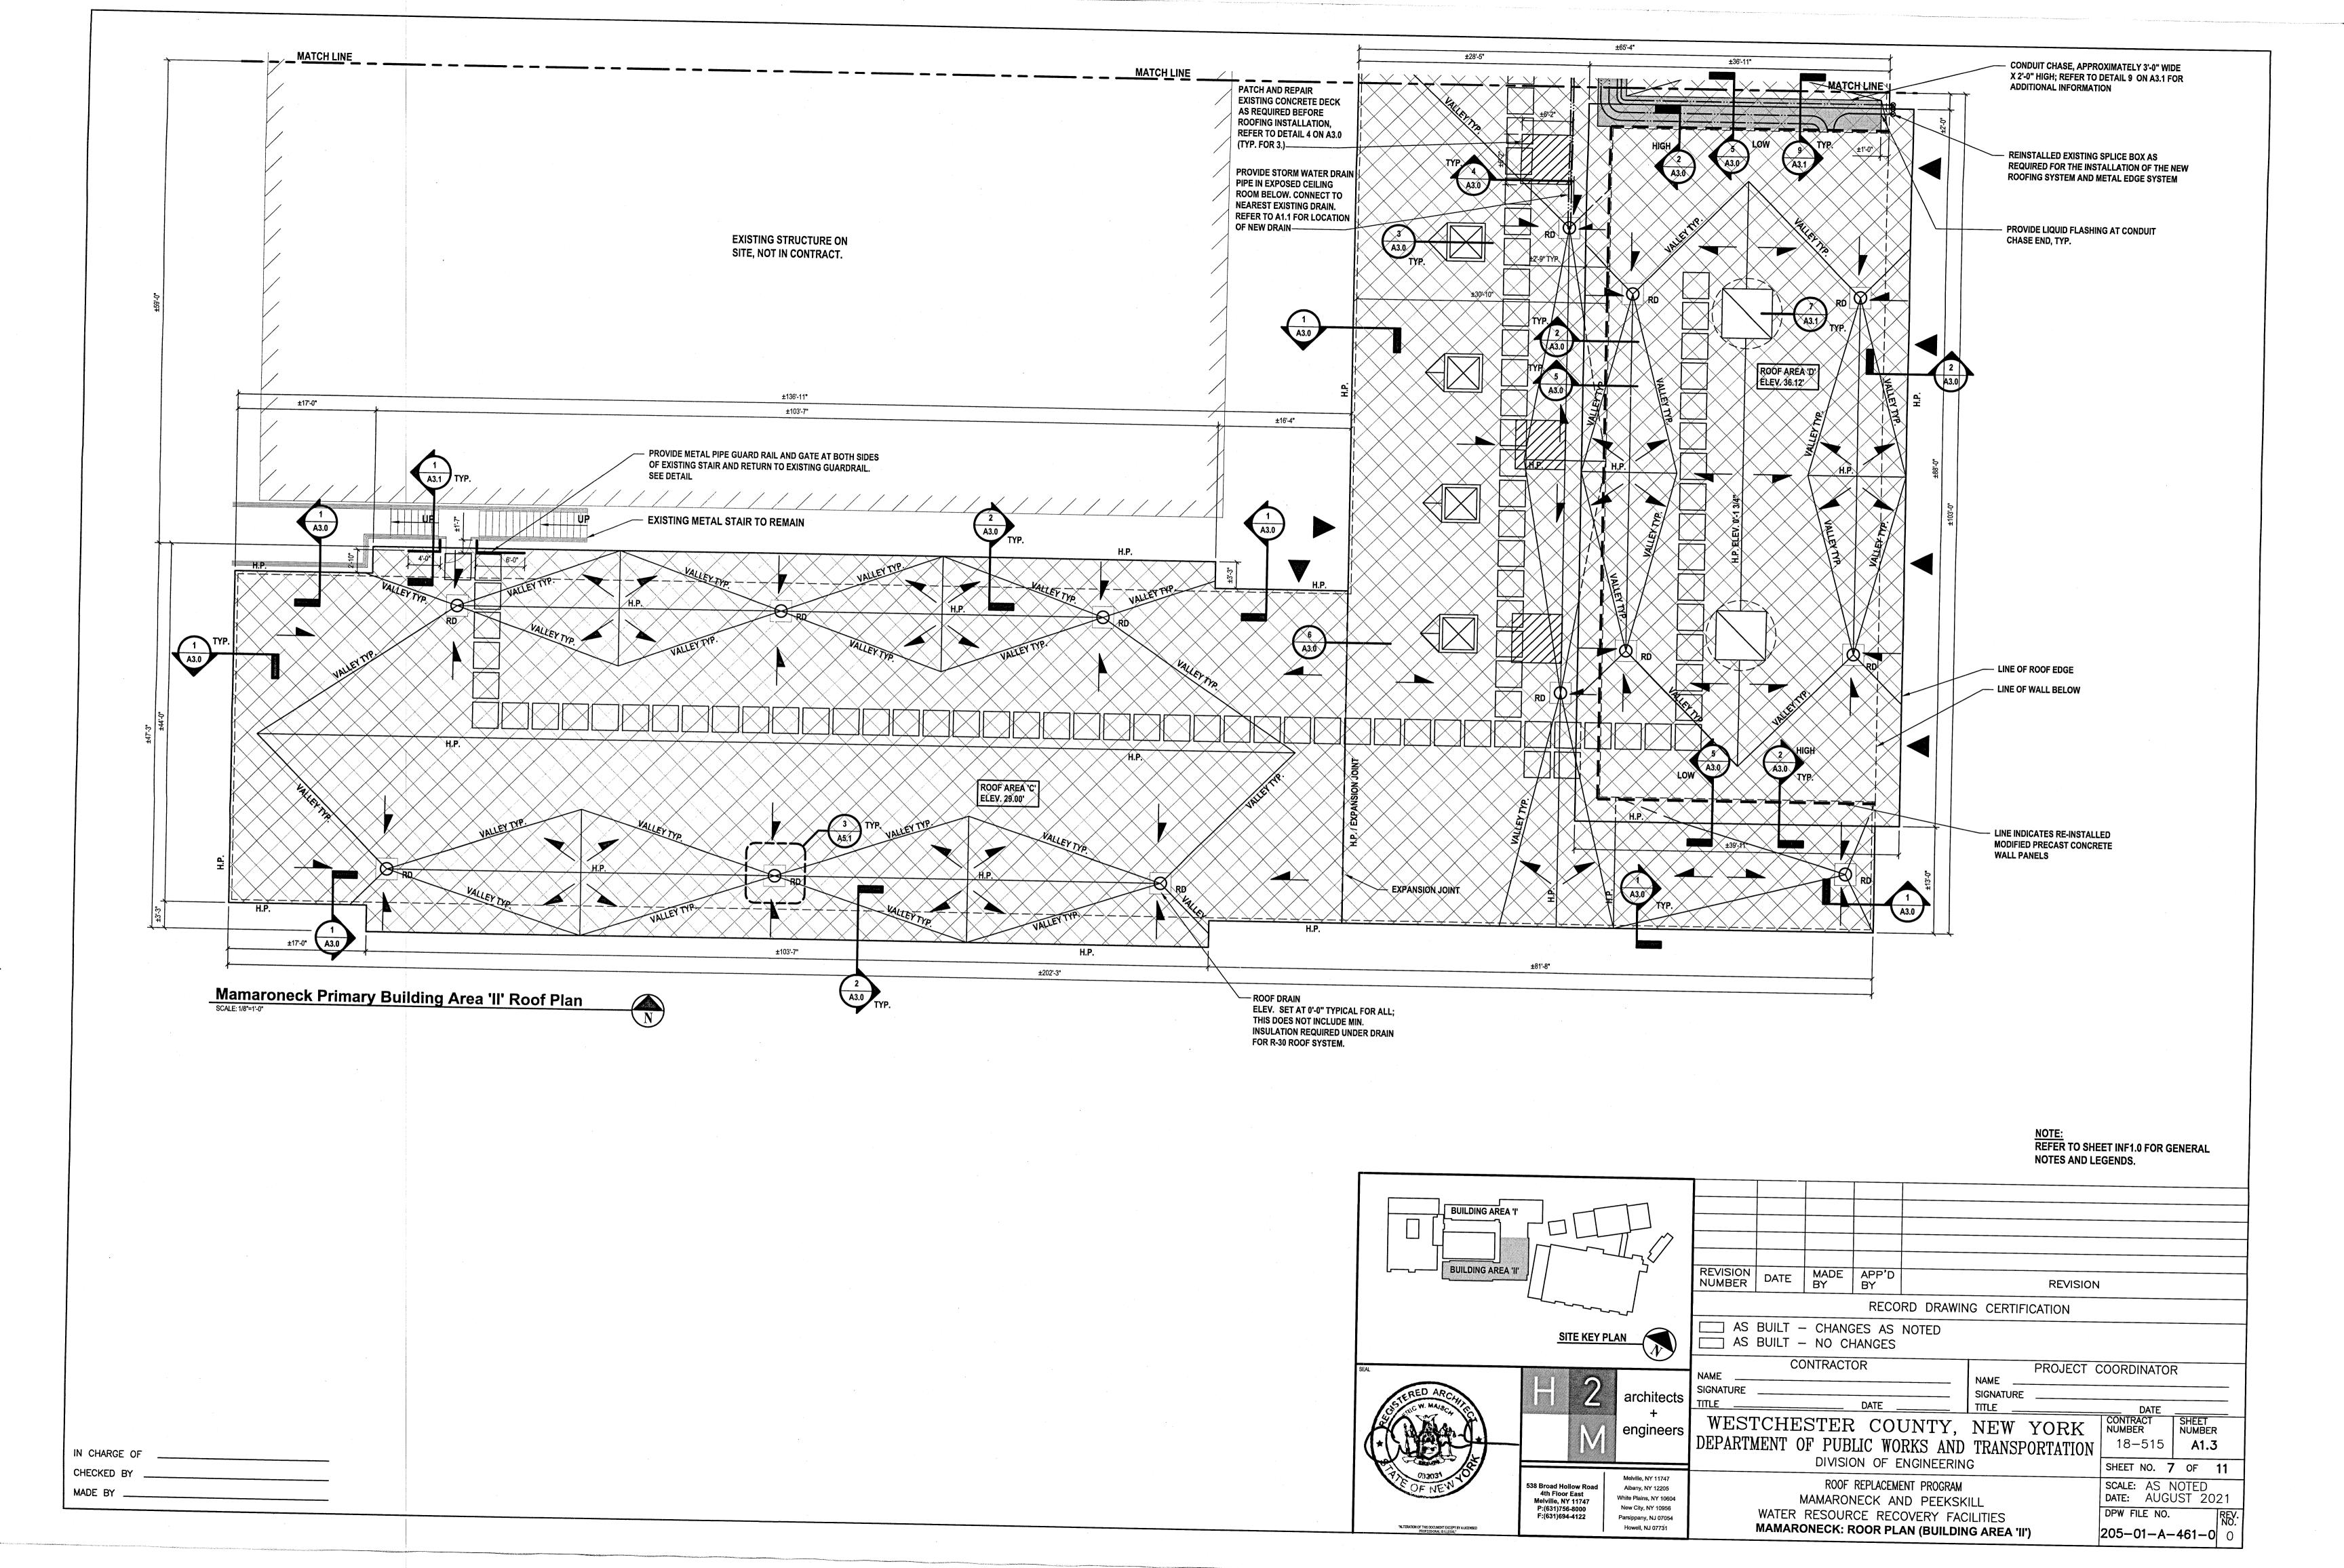

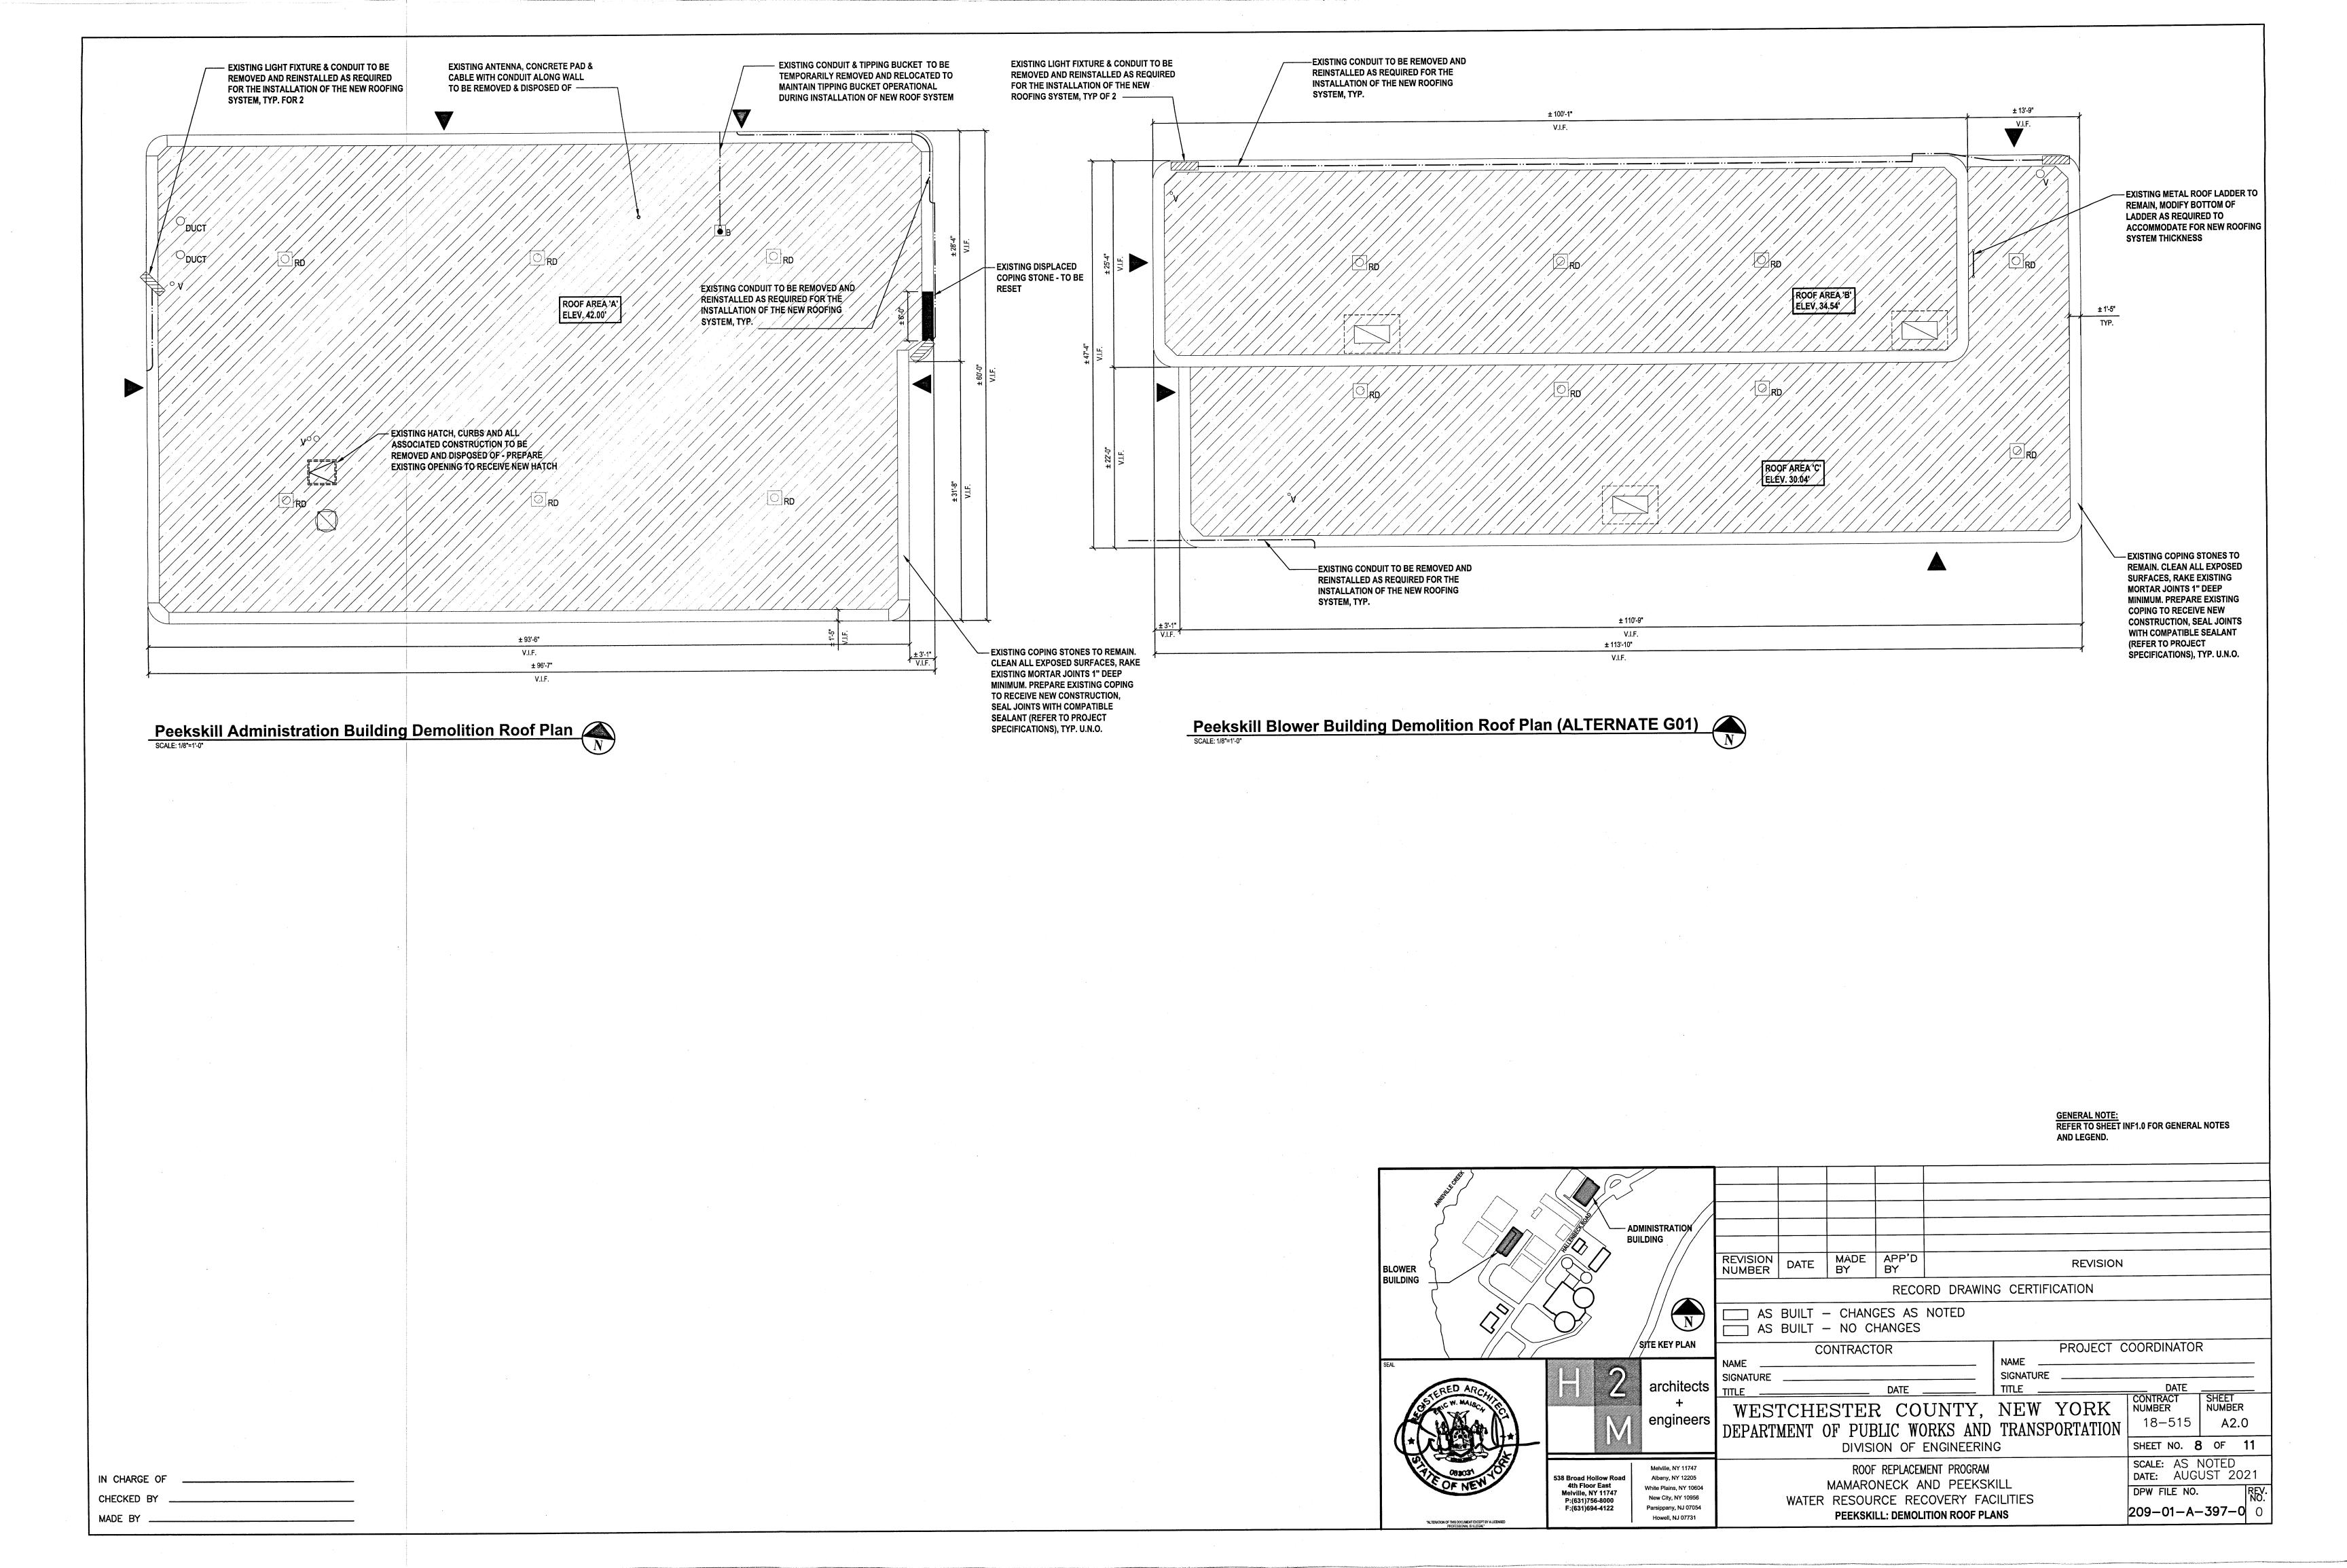

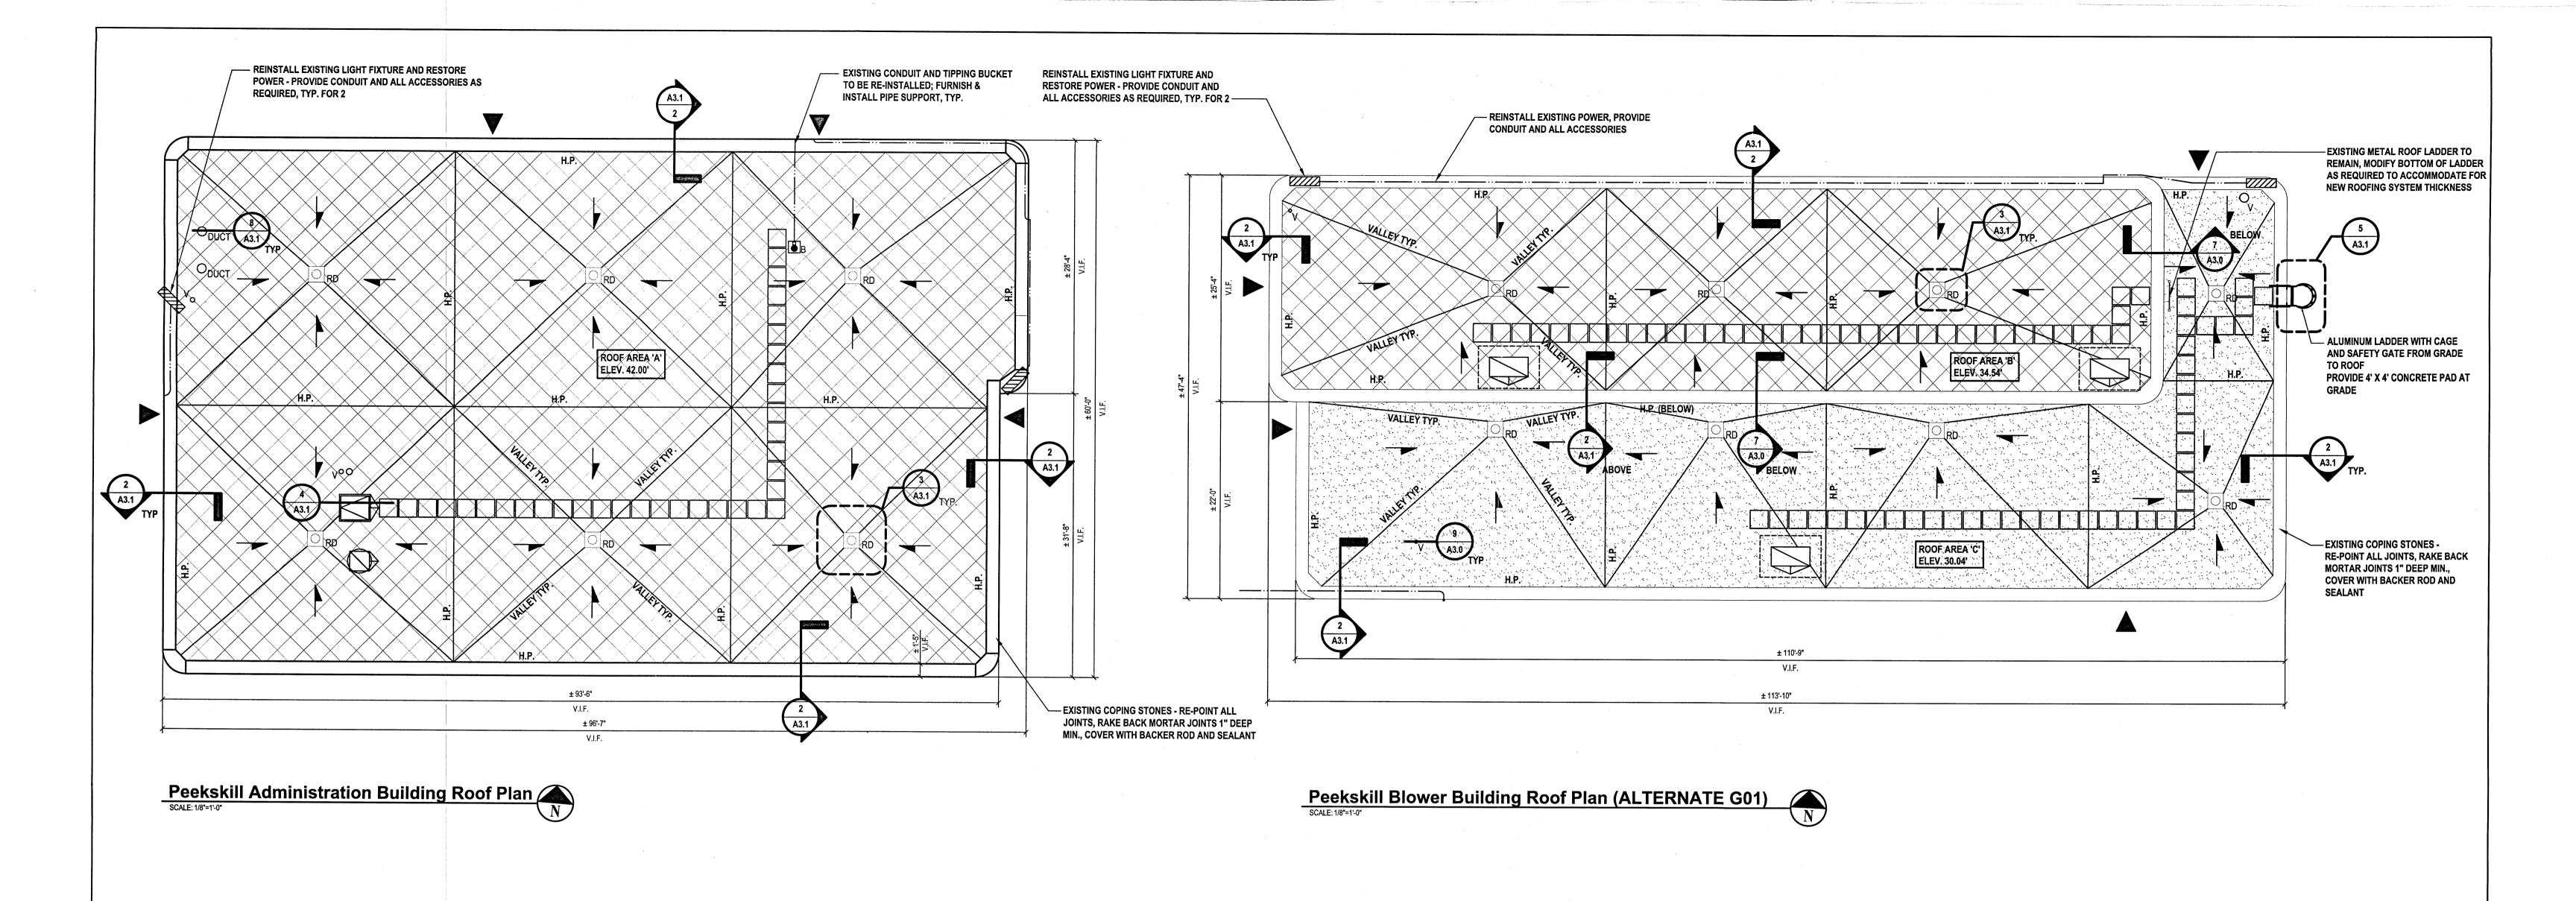

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MADE BY

- NOTES:

 1. REFER TO SHEET INF1.0 FOR GENERAL NOTES AND LEGEND.

 2. ROOF PLANS SHOW APPROXIMATE LAYOUT OF THE EXISTING PITCHED CONCRETE TOPPING SLAB TO REMAIN VERIFY EXISTING SLOPES AND LAYOUT IN FIELD, PROVIDE MINIMUM OF 1/8" SLOPE TOWARD ROOF
- 3. ROOF DRAIN ELEVATION SET AT 0'-0" TYPICAL FOR ALL; THIS DOES NOT INCLUDE MIN. INSULATION REQUIRED UNDER DRAIN FOR R-30 ROOF SYSTEM.
- 4. ALL SCOPE OF WORK ASSOCIATED WITH THE PEEKSKILL BLOWER BUILDING TO BE PROVIDED AS ALTERNATE G01

