## YONKERS PUBLIC SCHOOLS

## SCHOOL 16

759 NORTH BROADWAY YONKERS, NY 10701

### SECURITY UPDATE PROJECT

INSULATED WITH WIRE NUTS.

### SECURITY DRAWING LIST

COVER SHEET / LEGEND & INDEX

### **FLOOR PLANS**

SECURITY UPDATE PROJECT - BASEMENT SECURITY UPDATE PROJECT - FIRST FLOOR SECURITY UPDATE PROJECT - SECOND FLOOR SECURITY UPDATE PROJECT - SITE PLAN

SECURITY DEVICE RISER DIAGRAM

#### **CLOSET DETAILS**

CLOSET ELEVATIONS CCTV ONE LINE DIAGRAM

#### **TYPICALS**

**ISTAR-OVERALL SCHEMATIC SECURITY** DEVICE & POWER CONNECTION

ULTRA SE TYPICAL WIRING DIAGRAM FOR 16 CR DOORS W/ MOTION REX

ULTRA SE TYPICAL WIRING DIAGRAM FOR 16 CR DOORS W/ BUILT-IN REX

SECURITY EQUIPMENT DETAIL 1- (DOOR TYPICALS) SECURITY EQUIPMENT DETAIL 1A- (DOOR TYPICALS)

SECURITY EQUIPMENT DETAIL 2- (ACCESS DEVICE TYPICALS)

SECURITY EQUIPMENT DETAIL 3- (ILDA DEVICE TYPICALS) SECURITY EQUIPMENT DETAIL 4- (BURG DEVICE TYPICALS)

SECURITY EQUIPMENT DETAIL 5- (CCTV TYPICALS)

TYPE, ADDRESS AND CABLE TYPE & QTY ACCESS CONTROL DEVICE TYPE, ADDRESS AND CABLE - ACTIVATION PUSH BUTTON ADDRESS — BURG KEYPAD & CABLE TYPE LOCAL PANEL NAME / LOCATION — ILDA ADDRESS & CABLE TYPE - DRAWING & DETAIL NUMBER — FINAL PANEL TERMINATION LOCATION — FINAL PANEL TERMINATION LOCATION -INTERCOM REFERENCE TAG X-IC-YY-Z POLICE BLUE ARMING FLOOR ICM# PATCH INTERCOM CARD READER REFERENCE TAG —DEVICE TYPE (SEE SECURITY ICONS) DEVICE TYPE (SEE SECURITY ICONS) ACCESS CONTROL DEVICE ACCESS CONTROL DEVICE TYPE, ADDRESS AND CABLE SECURITY DEVICES LEGEND TYPE, ADDRESS AND CABLE TYPE & QTY TYPE & QTY —DEVICE DETAIL IDF-X —DEVICE DETAIL DEVICE TERMINATION LOCATION LR = LONG RANGE BIO = BIOMETRIC DEVICE TERMINATION LOCATION CARD READER EL = ELEVATOR BC = BARCODE-BUZZER REFERENCE TA DPDT = DOUBLE POLE R = RECESSDOUBLE DOOR CONTACTS FLOOR DEVICE# ISTAR BOARD **DOUBLE THROW** -CCTV REFERENCE TAG S = SURFACE**GENERAL NOTES** DEVICE TYPE (SEE SECURITY ICONS) CCTV R = RECESSDPDT = DOUBLE POLE floor camera'# p'atch ACCESS CONTROL DEVICE DOOR CONTACT DOUBLE THROW TYPE, ADDRESS AND CABLE S = SURFACE—DEVICE TYPE (SEE SECURITY ICONS) TYPE & QTY GENERAL NOTES SHALL APPLY TO ALL DRAWINGS. —DEVICE DETAIL ACCESS CONTROL DEVICE . WORK TO COMPLY WITH ALL APPLICABLE LOCAL CODES, REGULATORY AGENCIES, TL: SE-XXX-SK BURG PANEL KEY PAD TYPE, ADDRESS AND CABLE INCLUDING, BUT NOT LIMITED TO, NEC, OSHA, ETC. DEVICE TERMINATION LOCATION CLOSET: IDF-X —DEVICE DETAIL —DOOR CONTACT REFERENCE TAG . THE INSTALLING SECURITY CONTRACTOR SHALL BE RESPONSIBLE FOR SCHEDULING WITH BUILDING MANAGEMENT THE USE OF ELEVATOR OR OTHER HOISTING FACILITIES FOR ELECTRIFIED DOOR OPERATOR (PBO) DEVICE TERMINATION LOCATION HANDLING THE DELIVERY OF MATERIALS. FLOOR DEVICE# ZONE EXPANDER#-POR . FIRE STOPPING OF ALL PENETRATIONS SHALL BE PROVIDED BY THE INSTALLING SECURITY DPDT = DOUBLE POLE -MOTION SENSOR REFERENCE TAG CONTRACTOR AS REQUIRED BY CODE. OVERHEAD DOOR CONTACT DEVICE TYPE (SEE SECURITY ICONS) DOUBLE THROW X-MS-YY-Z ACCESS CONTROL DEVICE THESE DRAWINGS ARE DIAGRAMMATIC IN NATURE, AND FINAL SYSTEM CONDUIT AND FLOOR DEVICE# ZONE TYPE, ADDRESS AND CABLE CONDUCTOR LAYOUTS SHALL BE PROVIDED IN ACCORDANCE WITH THE MANUFACTURER'S EXPANDER#-PORT APPROVED EQUIPMENT, CONDUIT, AND WIRING SHOP DRAWINGS, AND FIELD CONDITIONS. ELECTRIC MORTISE LOCK REX = REQUEST TO EXIT BUILT IN DEVICE TYPE (SEE SECURITY ICONS) —DEVICE DETAIL . THE INSTALLING CONTRACTOR MUST COORDINATE WITH THE DEVICE INSTALLATION DETAILS. ACCESS CONTROL DEVICE —DEVICE TERMINATION LOCATION AND ENSURE THAT DEVICE BACKBOXES ARE APPROPRIATE PER THE FINAL SHOP DRAWING TYPE, ADDRESS AND CABLE ELECTROMAGNETIC LOCK APPROVED DEVICE, ON A LOCATION-BY-LOCATION BASIS, AND MEET ARCHITECTURAL TYPE & QTY —DOOR RELEASE REFERENCE TAG REQUIREMENTS FOR SURFACE OR RECESS MOUNTING. RECESS MOUNTING IS THE PREFERRED DEVICE DETAIL X-DC-YY-Z DEVICE TERMINATION LOCATION FLOOR DEVICE# ZONE . PROVIDE APPROPRIATE METALLIC RACEWAY FOR THE SECURITY SYSTEM AS NEEDED IN ELECTRIC STRIKE LOCK EXPANDER#-PORT ACCORDANCE WITH THE NATIONAL ELECTRIC CODE AND SO AS NOT TO EXCEED 40% -DEVICE TYPE (SEE SECURITY ICONS) -MOTION SENSOR REFERENCE TAG —ACCESS CONTROL DEVICE . THE INSTALLING CONTRACTOR SHALL PROVIDE ALL 120/220VAC AS REQUIRED FOR THE END OF LINE RESISTOR TYPE, ADDRESS AND CABLE SECURITY SYSTEM UNLESS OTHERWISE NOTED. FINAL 120 VAC TERMINATIONS IN THE SECURITY TYPE & QTY FLOOR DEVICE# ZONE EQUIPMENT SHALL BE PERFORMED BY THE INSTALLING SECURITY CONTRACTOR. EXPANDER#-PORT DEVICE DETAIL DEVICE TYPE (SEE SECURITY ICONS) . THE INSTALLING CONTRACTOR SHALL PROVIDE AND INSTALL ALL INTERCONNECTING REQUEST TO EXIT MOTION SENSOR DEVICE TERMINATION LOCATION CONDUITS AND RACEWAYS INSIDE THE SECURITY EQUIPMENT AND TERMINATE ALL WIRES AS ACCESS CONTROL DEVICE SHOWN IN THIS DRAWING SET. TYPE, ADDRESS AND CABLE IDF-X TYPE & QTY 0. THE INSTALLING CONTRACTOR SHALL PROVIDE AND INSTALL ALL CABLE PASS-THROUGH INTELLIGENT LOCAL DOOR ALARM (ILDA) - "D" CABLE DEVICE DETAIL HOLES IN MILLWORK UNLESS OTHERWISE NOTED. —ACCESS CONTROL HEADEND —DEVICE TERMINATION LOCATION ROOM NUMBER . THE INSTALLING CONTRACTOR SHALL PROVIDE AND INSTALL ALL OVERHEAD CABLE ET: SE:XXX ELECTRIC LOCKING CRASH BAR REX = BUILT IN REQUEST TO EXIT SUPPORTED BY J-HOOKS, CABLE TRAY OR EQUIVALENT. CABLE SHALL NOT BE SUPPORTED BY DRAWING & DETAIL NUMBER CEILING GRID, DUCTWORK, SPRINKLER PIPES, ELECTRICAL CONDUIT OR GAS PIPES. —ilda reference tag POWER/DATA REQUIREMNTS 2. THE INSTALLING CONTRACTOR TO PROVIDE GROUNDING OF ALL ELECTRONICS EQUIPMENT FLOOR DEVICE# ZONE ON THE PLYWOOD BACKBOARD. USE GROUND BAR OR COORDINATE WITH GENERAL MOTION SENSOR (LONG RANGE) - "A" CABLE MOTION SENSORS WILL BE WALL EXPANDER#-PORT CONTRACTOR FOR NEAREST GROUNDING LOCATION. MOUNTED UNLESS MOTION DEVICE TYPE (SEE SECURITY ICONS) 3. THE INSTALLING CONTRACTOR SHALL PREP ALL DOORS FOR DOOR HARDWARE. THIS SENSOR IS 360° CEILING TYPE —ACCESS CONTROL DEVICE INCLUDES MAGNETIC LOCKS, ELECTRIC LOCKS, DOOR FRAMES FOR ELECTRIC STRIKES, HOLES MOTION SENSOR (SHORT RANGE) - "A" CABLE CCTV HEADEND OTL: SE-XXX-SK# TYPE, ADDRESS AND CABLE FOR DOOR CONTACTS AND MAGNETIC LOCK ASSEMBLIES. TYPE & QTY ROOM NUMBER ET: SE:XXX 4. THESE DRAWINGS INDICATE THE GENERAL INTENT OF WORK AND ARE NOT INTENDED TO DEVICE DETAIL INDICATE OR DESCRIBE ALL WORK REQUIRED FOR THE FULL PERFORMANCE AND DRAWING & DETAIL NUMBER DEVICE TERMINATION LOCATION COMPLETION OF THE CONTRACT. 5. ALL CONDUIT SHALL BE DEBURRED, CLEANED, CAPPED, TAGGED, AND PROVIDED WITH PULL TEMPERATURE SENSOR WIRES AND BRUSHINGS. WHERE CONDUITS OR WIREWAYS PASS THROUGH FIRE RATED ASSEMBLIES. THE PENETRATIONS SHALL BE FIRE- STOPPED. CABLE LEGEND 6. PRIOR TO SYSTEM TURN-ON, THE INSTALLING SECURITY CONTRACTOR SHALL REVIEW THE INSTALLATION OF ALL ELECTRIFIED DOOR HARDWARE WITH OWNER'S REP TO VERIFY VIDEO MONITOR CABLE TYPE MANUFACTURER PART NUMBER DESCRIPTION CORRECT INSTALLATION & PROPER FUNCTIONING. 7. AT THE TIME OF ACCESS CONTROL SYSTEM TURN ON, THE INSTALLING CONTRACTOR SHALL 20 AWG / 2 PAIR, INDIVIDUALLY SHIELDED S=SUBSTATION VS=VIDEO SUBSTATION INTERCOM, COMMUNICATION, REX .194 IN REMEE TYPE A INTERCOM PROVIDE THE SAME PERSONNEL WHO PERFORMED & SUPERVISED THE WORK TO PLENUM PINK CABLE M=MASTER VM=VIDEO MASTER TROUBLESHOOT, TEST THE INSTALLATION AND REMEDY ALL RELATED PUNCH LIST ITEMS FOR PLC COMMUNICATION .480 IN BELDEN 3082A DEVICENET CABLE 18. THE INSTALLING CONTRACTOR SHALL BE RESPONSIBLE FOR REMEDY OF ANY CABLE &/OR 18AWG / 2 COND PLENUM PINK EQUIPMENT INSTALLATION PROBLEMS AND ALL RELATED PUNCH LIST ITEMS. REMEE PTZ POWER 9. CLIENTS FIRE ALARM CONTRACTOR SHALL PROVIDE A SET OF NORMALLY CLOSED (N/C) 20AWG / 8 COND OVERALL SHIELD CONTACTS TO RELEASE ON GENERAL ALARM. CUSTODIAL ARMING STATION CARD READER, COMMUNICATION .207 IN PLENUM PINK CABLE 0. THE INSTALLING CONTRACTOR IS RESPONSIBLE FOR PROVIDING BACK A COMPLETE, MARKED UP SET FOR THE GENERATION OF CORRECT AS BUILT DRAWINGS. INSTALLING SECURITY CORNING 6 STRAND 62.5M RISER FIBER - MULTIMODE NETWORK BACKBONE CONTRACTOR IS TO PROVIDE THE SECURITY PROJECT MANAGER WITH THE UPDATED SETS FIXED MINI DOME OUTDOOR VANDAL CAMERA ANALOG CCTV CAMERA, RG59/U 20AWG PLENUM PINK CABLE TYPE F REMEE ANALOG MONITOR 21. ALL WIRES TO BE MACHINE LABELED VIA SELF LAMINATING LSL-77 TAGS. PROVIDE FOR OWNER'S REP REVIEW PRIOR TO USE 14 AWG / 6 COND THHN STRANDED FIXED MINI DOME INDOOR CAMERA QUICK PULL CABLE COLOR: BLUE, RED, DETENTION LOCK POWER/STATUS 22. SECURITY SCREWS TO BE USED AS NEEDED AND EXPECTED TO MAINTAIN SYSTEM'S INTEGRITY BROWN, YELLOW, PINK, WHITE REMEE TYPE I 23 AWG / 4 PAIR CAT5E – UNSHIELDED PLENUM IP CCTV CAMERA, NETWORK PTZ DOME OUTDOOR CAMERA POWER REQUIREMENTS 4 ELEMENT COMPOSITE PINK CABLE PLENUM (A) - TYPE A: 20AWG / 2 PAIR – REX PTZ DOME INDOOR CAMERA (C) - TYPE C: 18AWG / 2 COND – LOCK POWER TYPE M REMEE ACCESS CONTROL DOOR .420 IN ELECTRICAL CONTRACTOR TO PROVIDE A HARD WIRED CONNECTION TO A 120 VAC ) - TYPE D: 20AWG / 8 COND – CARD READER 20A EMERGENCY CIRCUIT DEDICATED TO SECURITY IN EACH RISER LOCATION WITHIN A (Q) - TYPE Q: 20AWG / 2 COND – DOOR CONTACT 4"x4" BOX SURFACE MOUNTED 18" AFF WITH WIRE ENDS TERMINATED AND INSULATED WITH WIRE NUTS. PLC COMMUNICATION HITACHI 57-2631 24AWG / 25 PAIR CAT5E PLENUM FIXED BOX OUTDOOR CAMERA POWER (NON-EMERGENCY CIRCUIT) ELECTRICAL CONTRACTOR TO PROVIDE A HARD WIRED CONNECTION TO A 120 VAC 18 AWG / 6 COND OVERALL SHIELDED, PVC WEST PENN WIRE PEDESTAL CARD READER 20A NON-EMERGENCY CIRCUIT DEDICATED TO SECURITY IN EACH RISER LOCATION FIXED BOX INDOOR CAMERA WITHIN A 4"x4" BOX SURFACE MOUNTED 18" AFF WITH WIRE ENDS TERMINATED AND

REFERENCE DEVICE ATTRIBUTE LEGEND

— ACCESS CONTROL REFERENCE

FLOOR ISTAR# READER

22 AWG / 2 PAIR, 1 PAIR SHIELDED, 1 PAIR

UNSHIELDED, PVC

PEDESTAL INTERCOM

WEST PENN WIRE

AQC357

DOOR - H.R.

-CUSTODIAN ARMING DOOR

X-CAS-YY-Z

FLOOR DEVICE# ISTAR BOARD

REFERENCE TAG

— ACCESS CONTROL DEVICE

 DEVICE PLACEMENT, RISER DEPICTION, CABLE TYPES AND ROUTES, DEVICE TERMINATION AND OTHERS ARE FOR REFERENCE ONLY.

- . THE CONTRACTOR IS RESPONSIBLE FOR UNDERSTANDING AND VERIFYING THE ENTIRE DRAWINGS SET AND SPECIFICATIONS, VERIFY ACTUAL FIELD CONDITIONS AND DELIVER A TURN KEY SOLUTION TO COY BOE.
- CONTRACTOR TO VERIFY CAMERAS FIELD OF VIEW AND ADJUST AS NEEDED TO THE
- 4. PRIOR TO PULLING CAT-6 WIRES, CONTRACTOR TO VERIFY CABLE LENGTH DOES NOT TO EXCEED 300' WHEN BROUGHT TO CLOSEST CLOSET.

SATISFACTION OF BOE SECURITY MANAGER.

- 6. ALL CAT-6 CABLES TO BE TESTED AND CERTIFIED AS PER BID DOCUMENT
- 6. CONTRACTOR TO MARK ANY DEVIATIONS FROM THE PROVIDED RISER AND NOTE ON THE "AS BUILT" . CONTRACTOR TO PRODUCE AND DELIVER A

BOUND "AS BUILT" SET IN BOTH "D" SIZE HARD COPY (2 SETS) AND A CD WITH .PDF FORMAT.

8. CONTRACTOR IS RESPONSIBLE FOR SYSTEM COMMISSIONING. ITG'S ROLE IS LIMITED TO SYSTEM PROGRAMMING ONLY.

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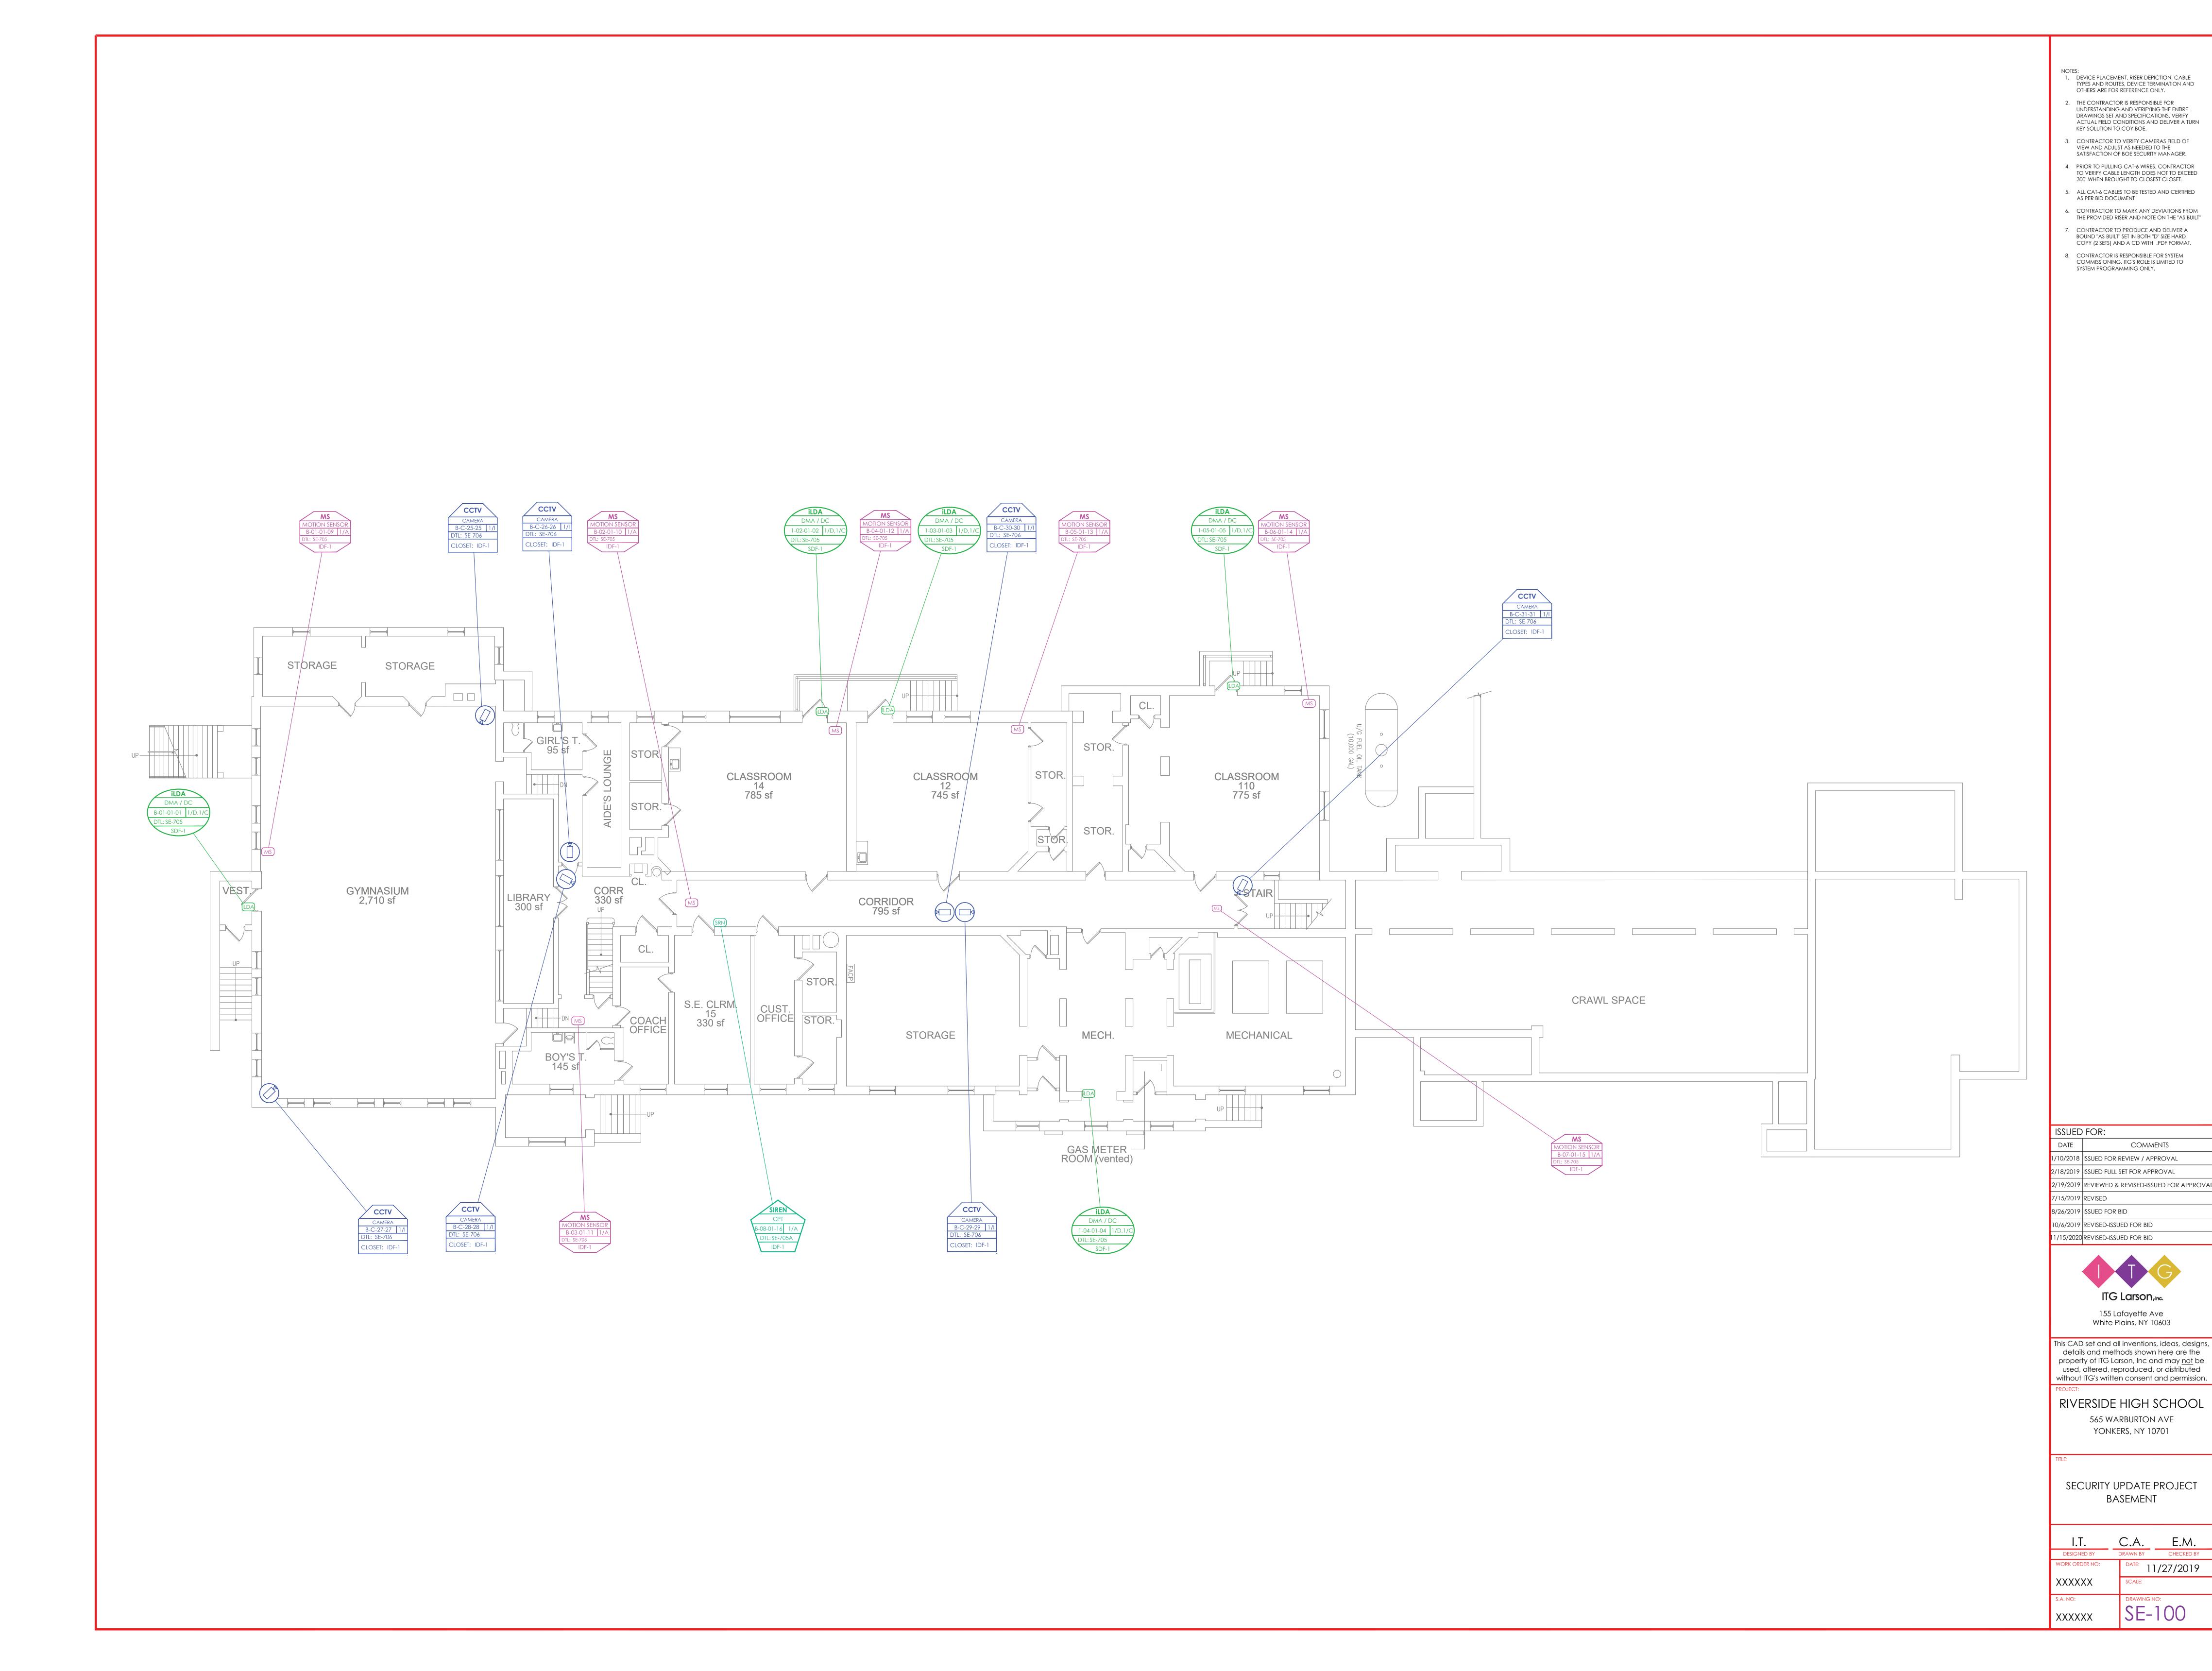
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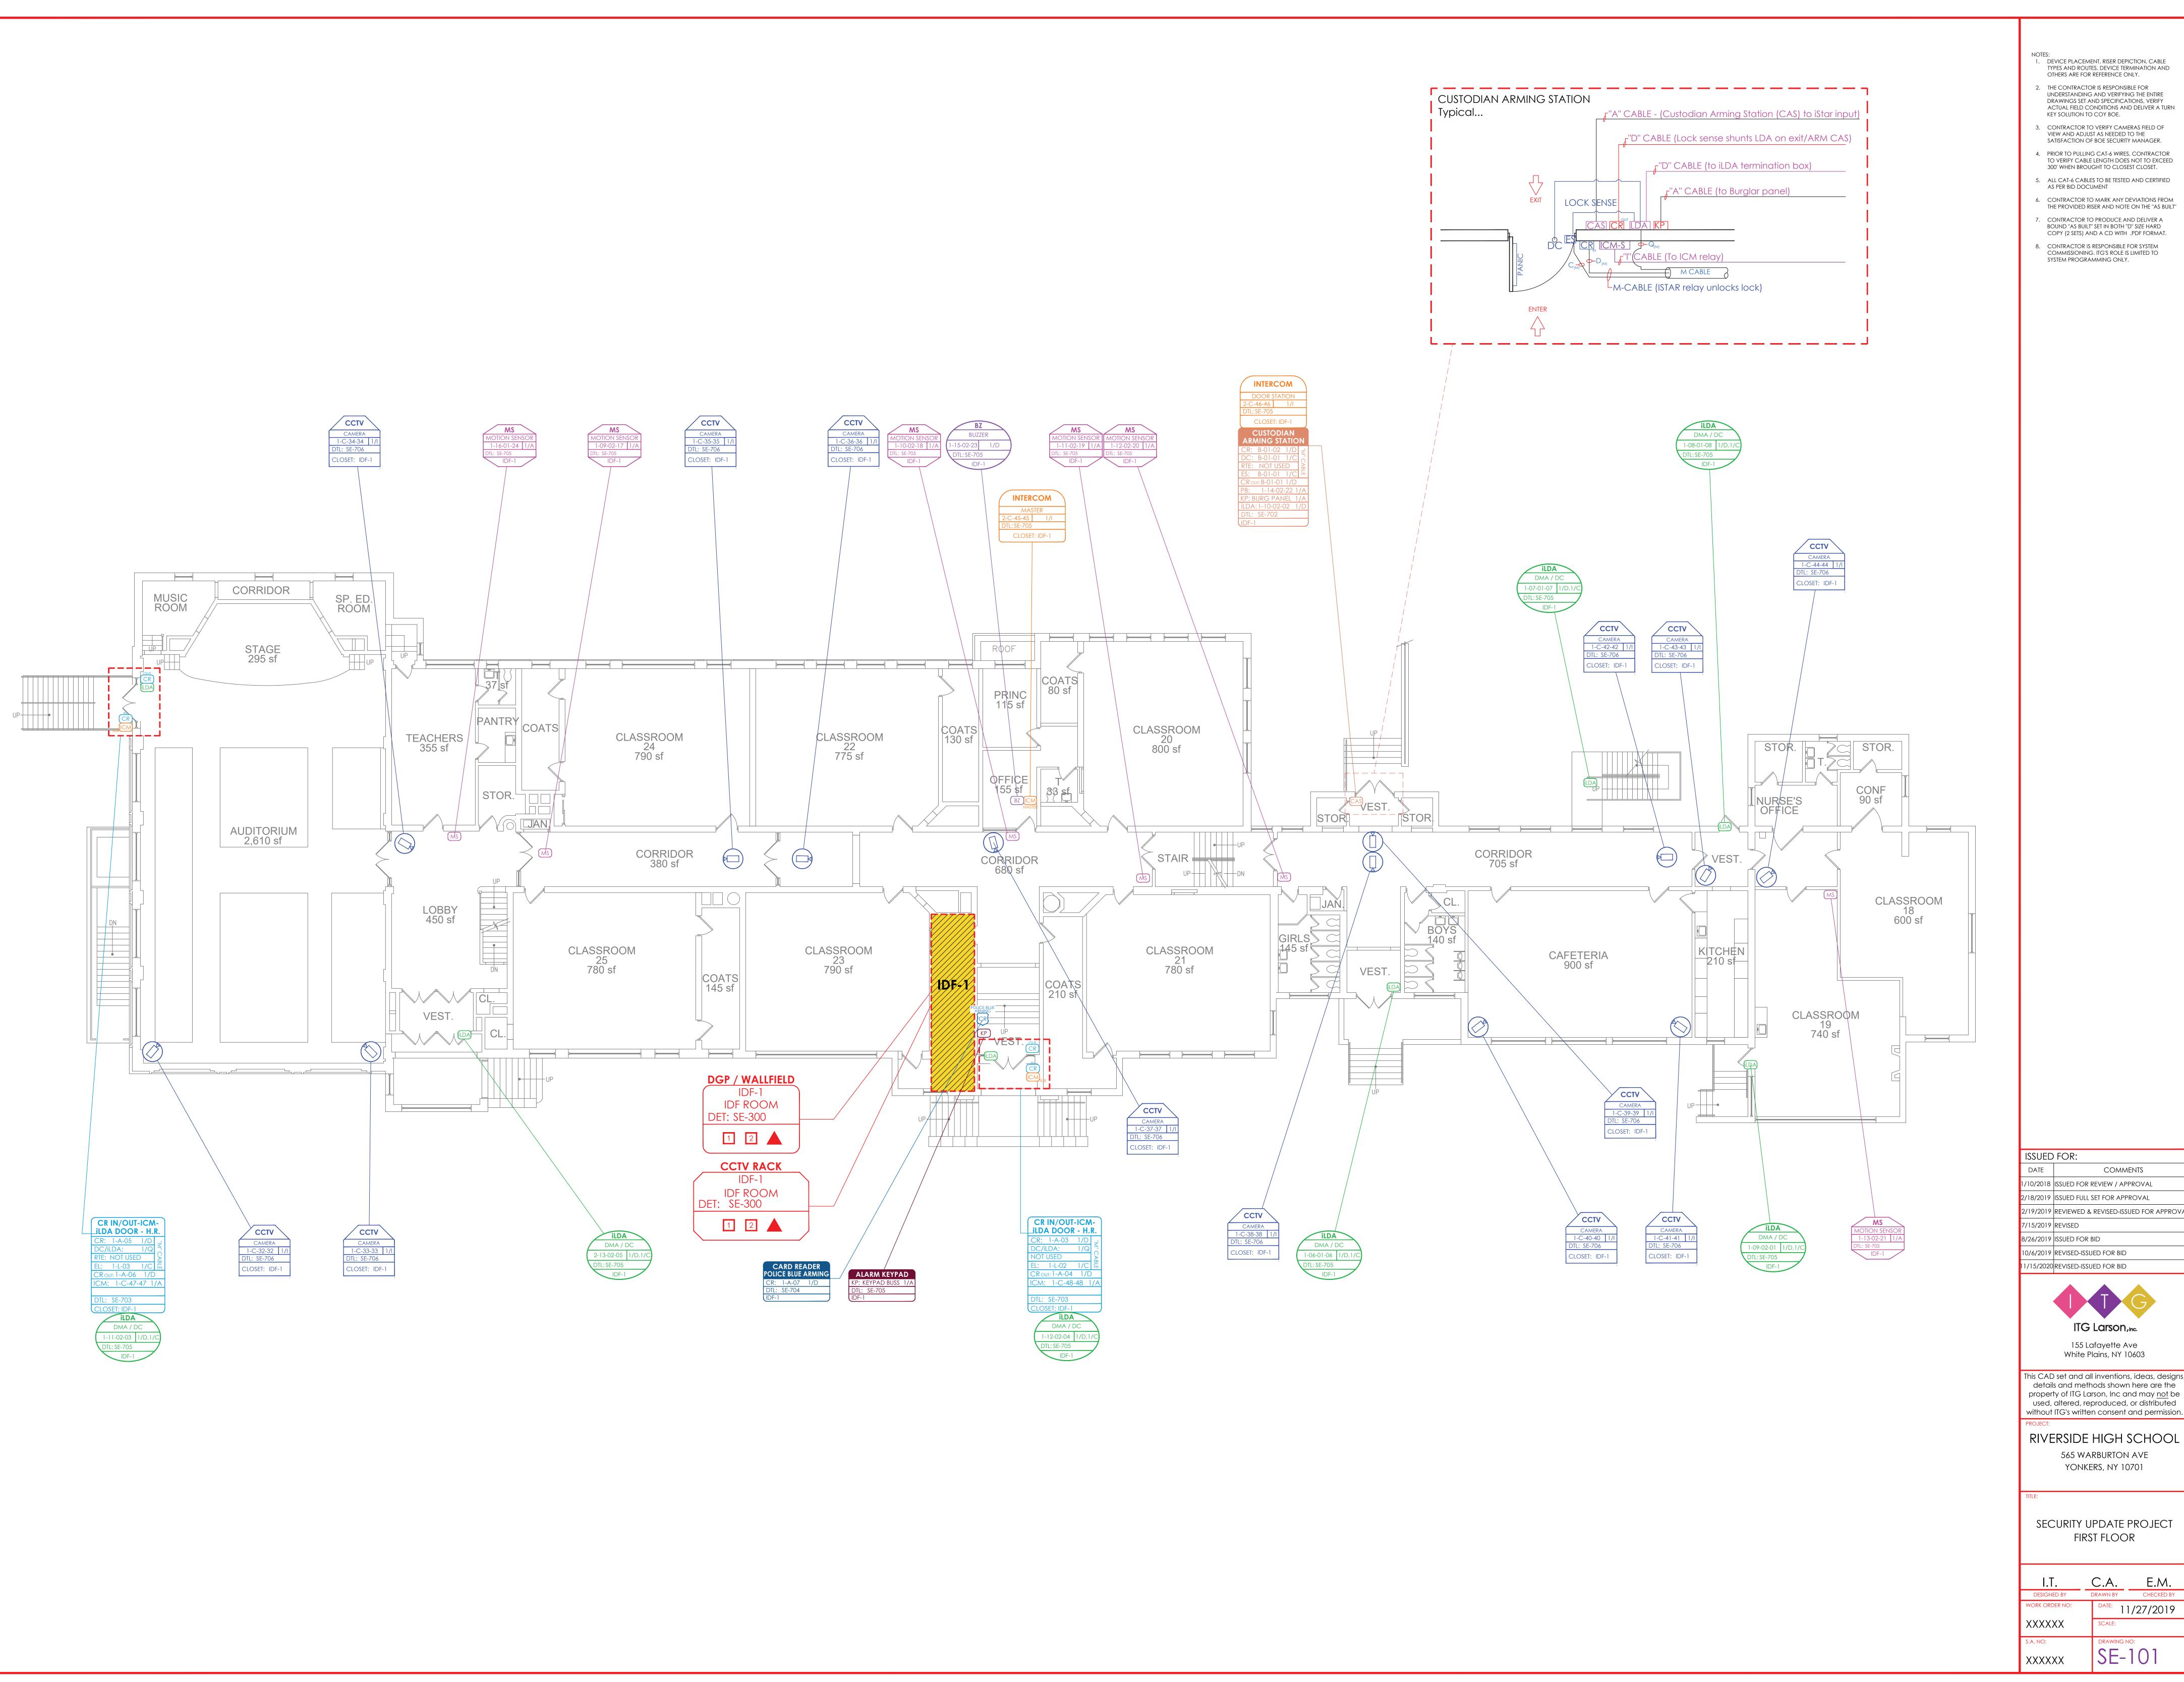
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RIVERSIDE HIGH SCHOOL 565 WARBURTON AVE YONKERS, NY 10701

> COVER SHEET / LEGEND & INDEX

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- ACTUAL FIELD CONDITIONS AND DELIVER A TURN KEY SOLUTION TO COY BOE.
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- AS PER BID DOCUMENT 6. CONTRACTOR TO MARK ANY DEVIATIONS FROM
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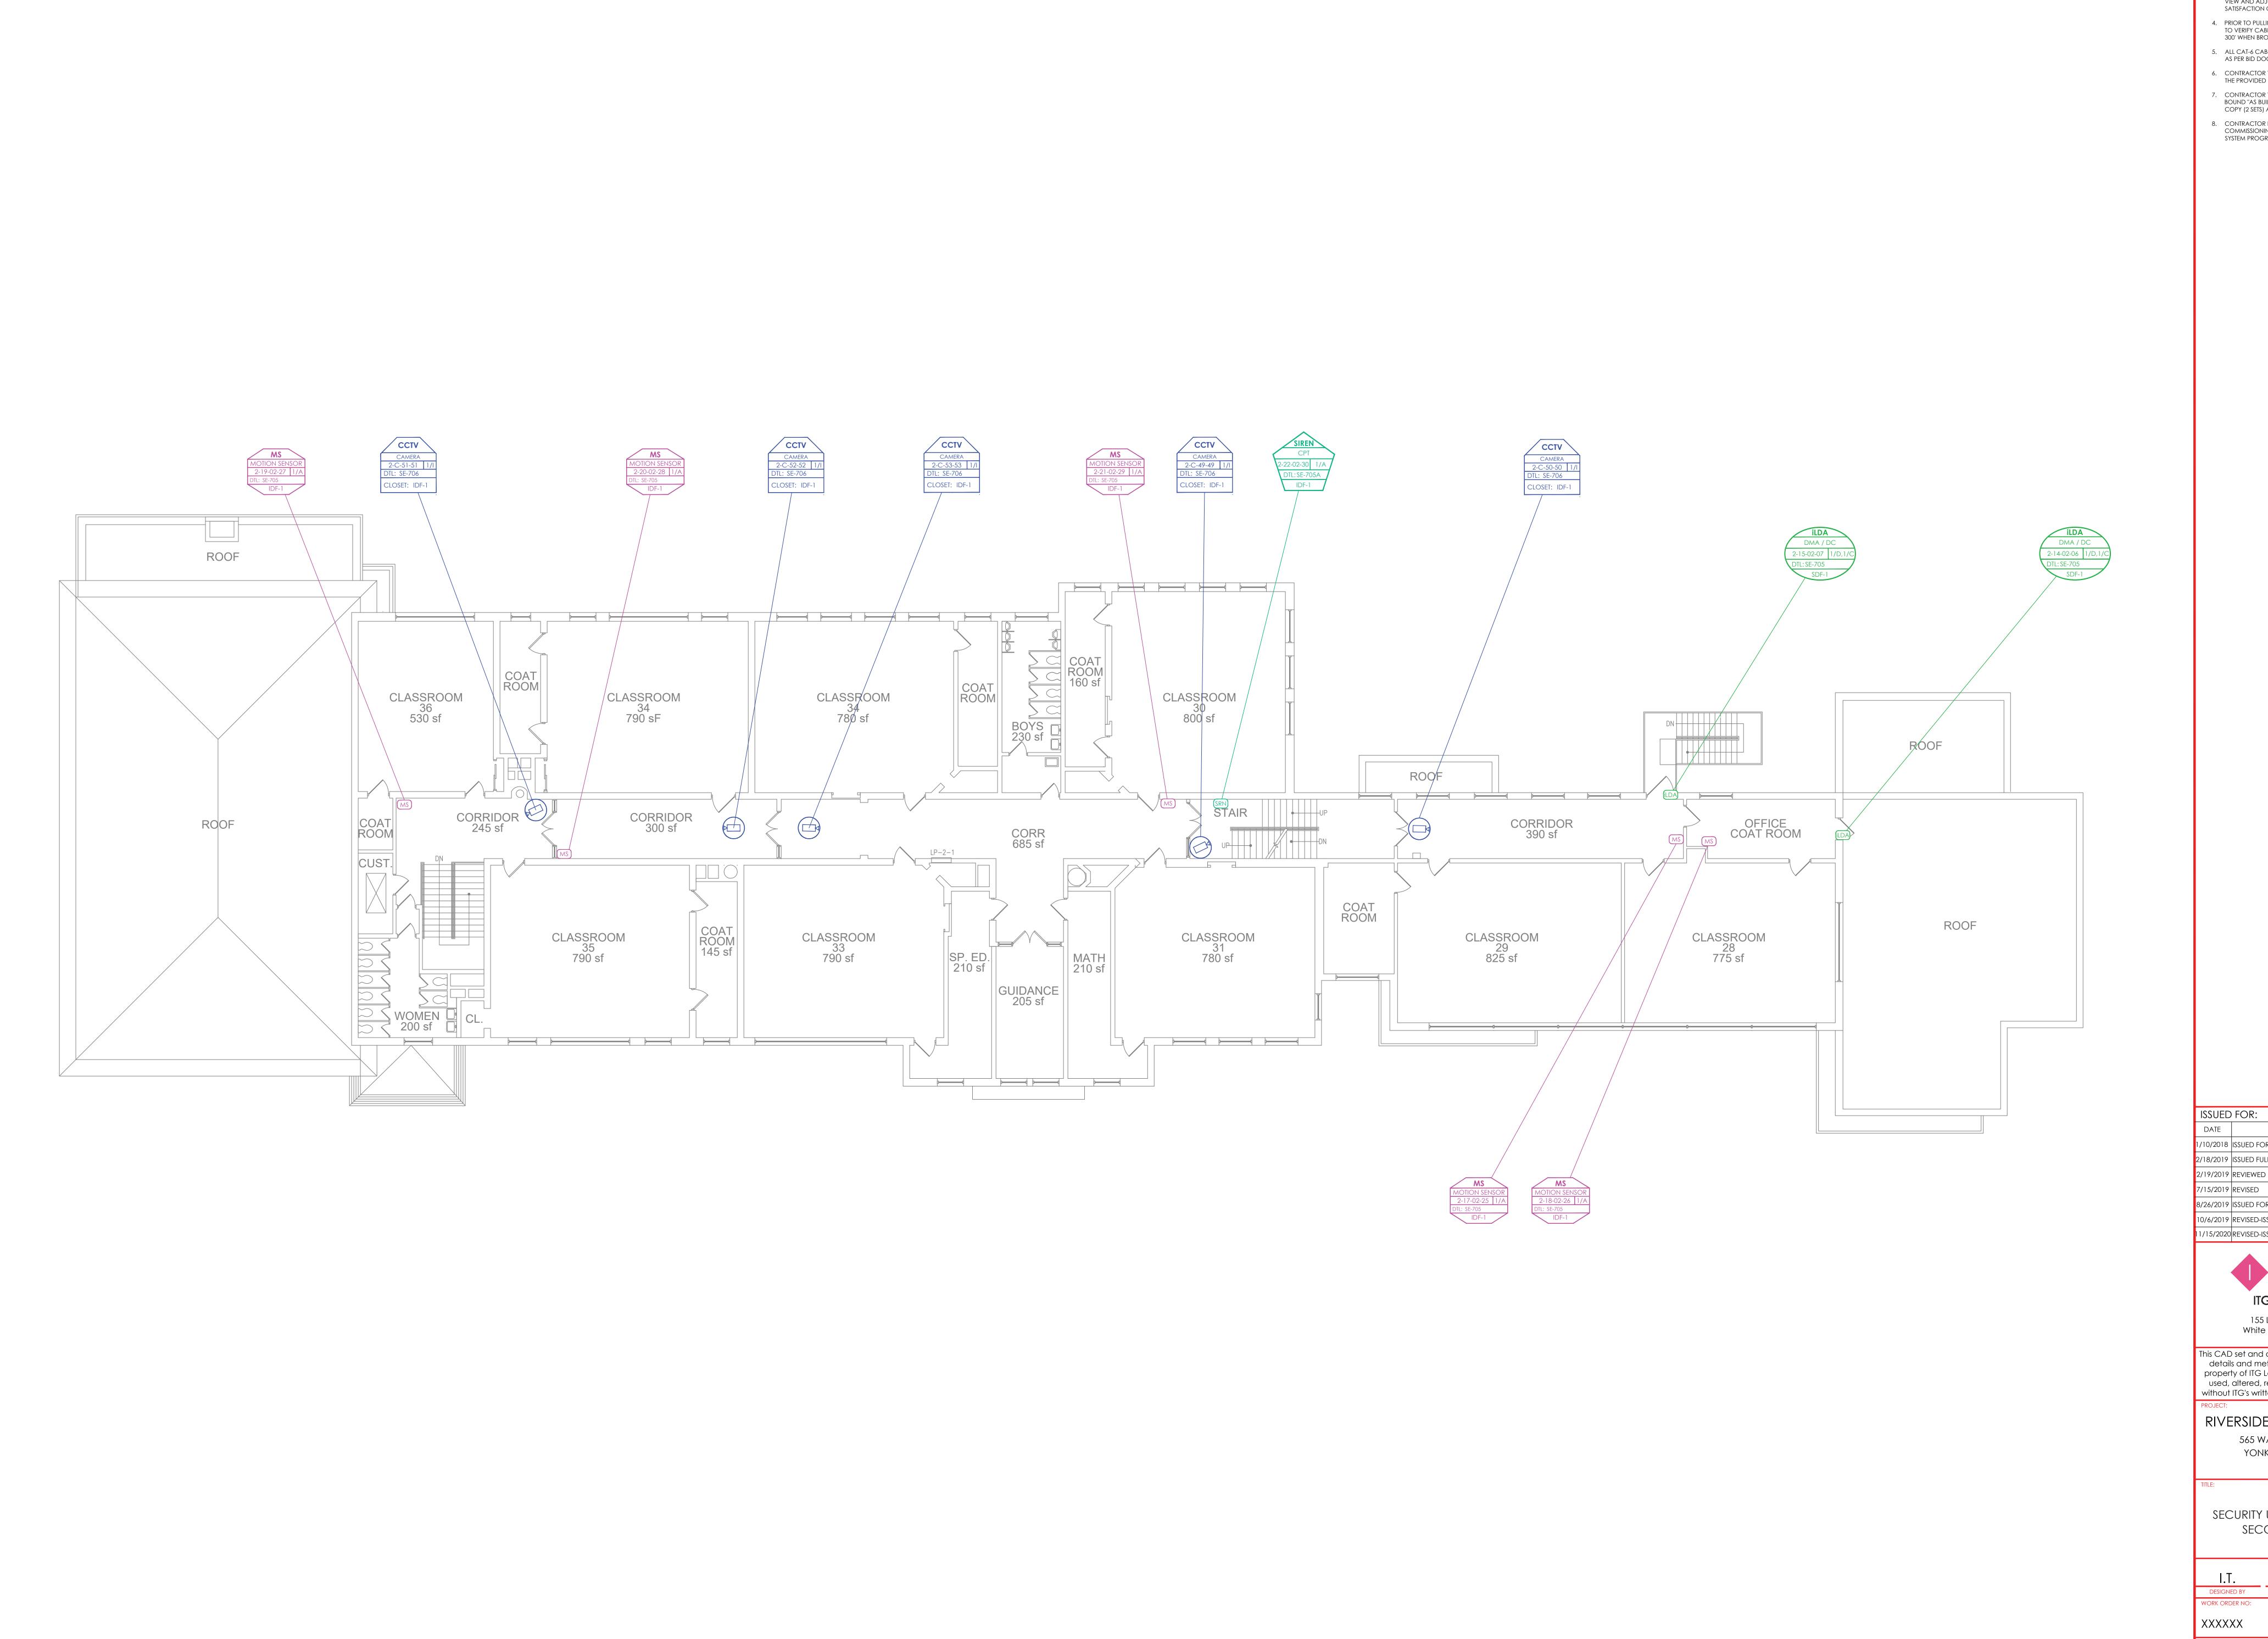
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SECURITY UPDATE PROJECT

11/27/2019 SE-101



1. DEVICE PLACEMENT, RISER DEPICTION, CABLE TYPES AND ROUTES, DEVICE TERMINATION AND OTHERS ARE FOR REFERENCE ONLY.

2. THE CONTRACTOR IS RESPONSIBLE FOR UNDERSTANDING AND VERIFYING THE ENTIRE DRAWINGS SET AND SPECIFICATIONS, VERIFY
ACTUAL FIELD CONDITIONS AND DELIVER A TURN

KEY SOLUTION TO COY BOE.

 CONTRACTOR TO VERIFY CAMERAS FIELD OF VIEW AND ADJUST AS NEEDED TO THE SATISFACTION OF BOE SECURITY MANAGER. 4. PRIOR TO PULLING CAT-6 WIRES, CONTRACTOR

TO VERIFY CABLE LENGTH DOES NOT TO EXCEED 300' WHEN BROUGHT TO CLOSEST CLOSET. 5. ALL CAT-6 CABLES TO BE TESTED AND CERTIFIED AS PER BID DOCUMENT

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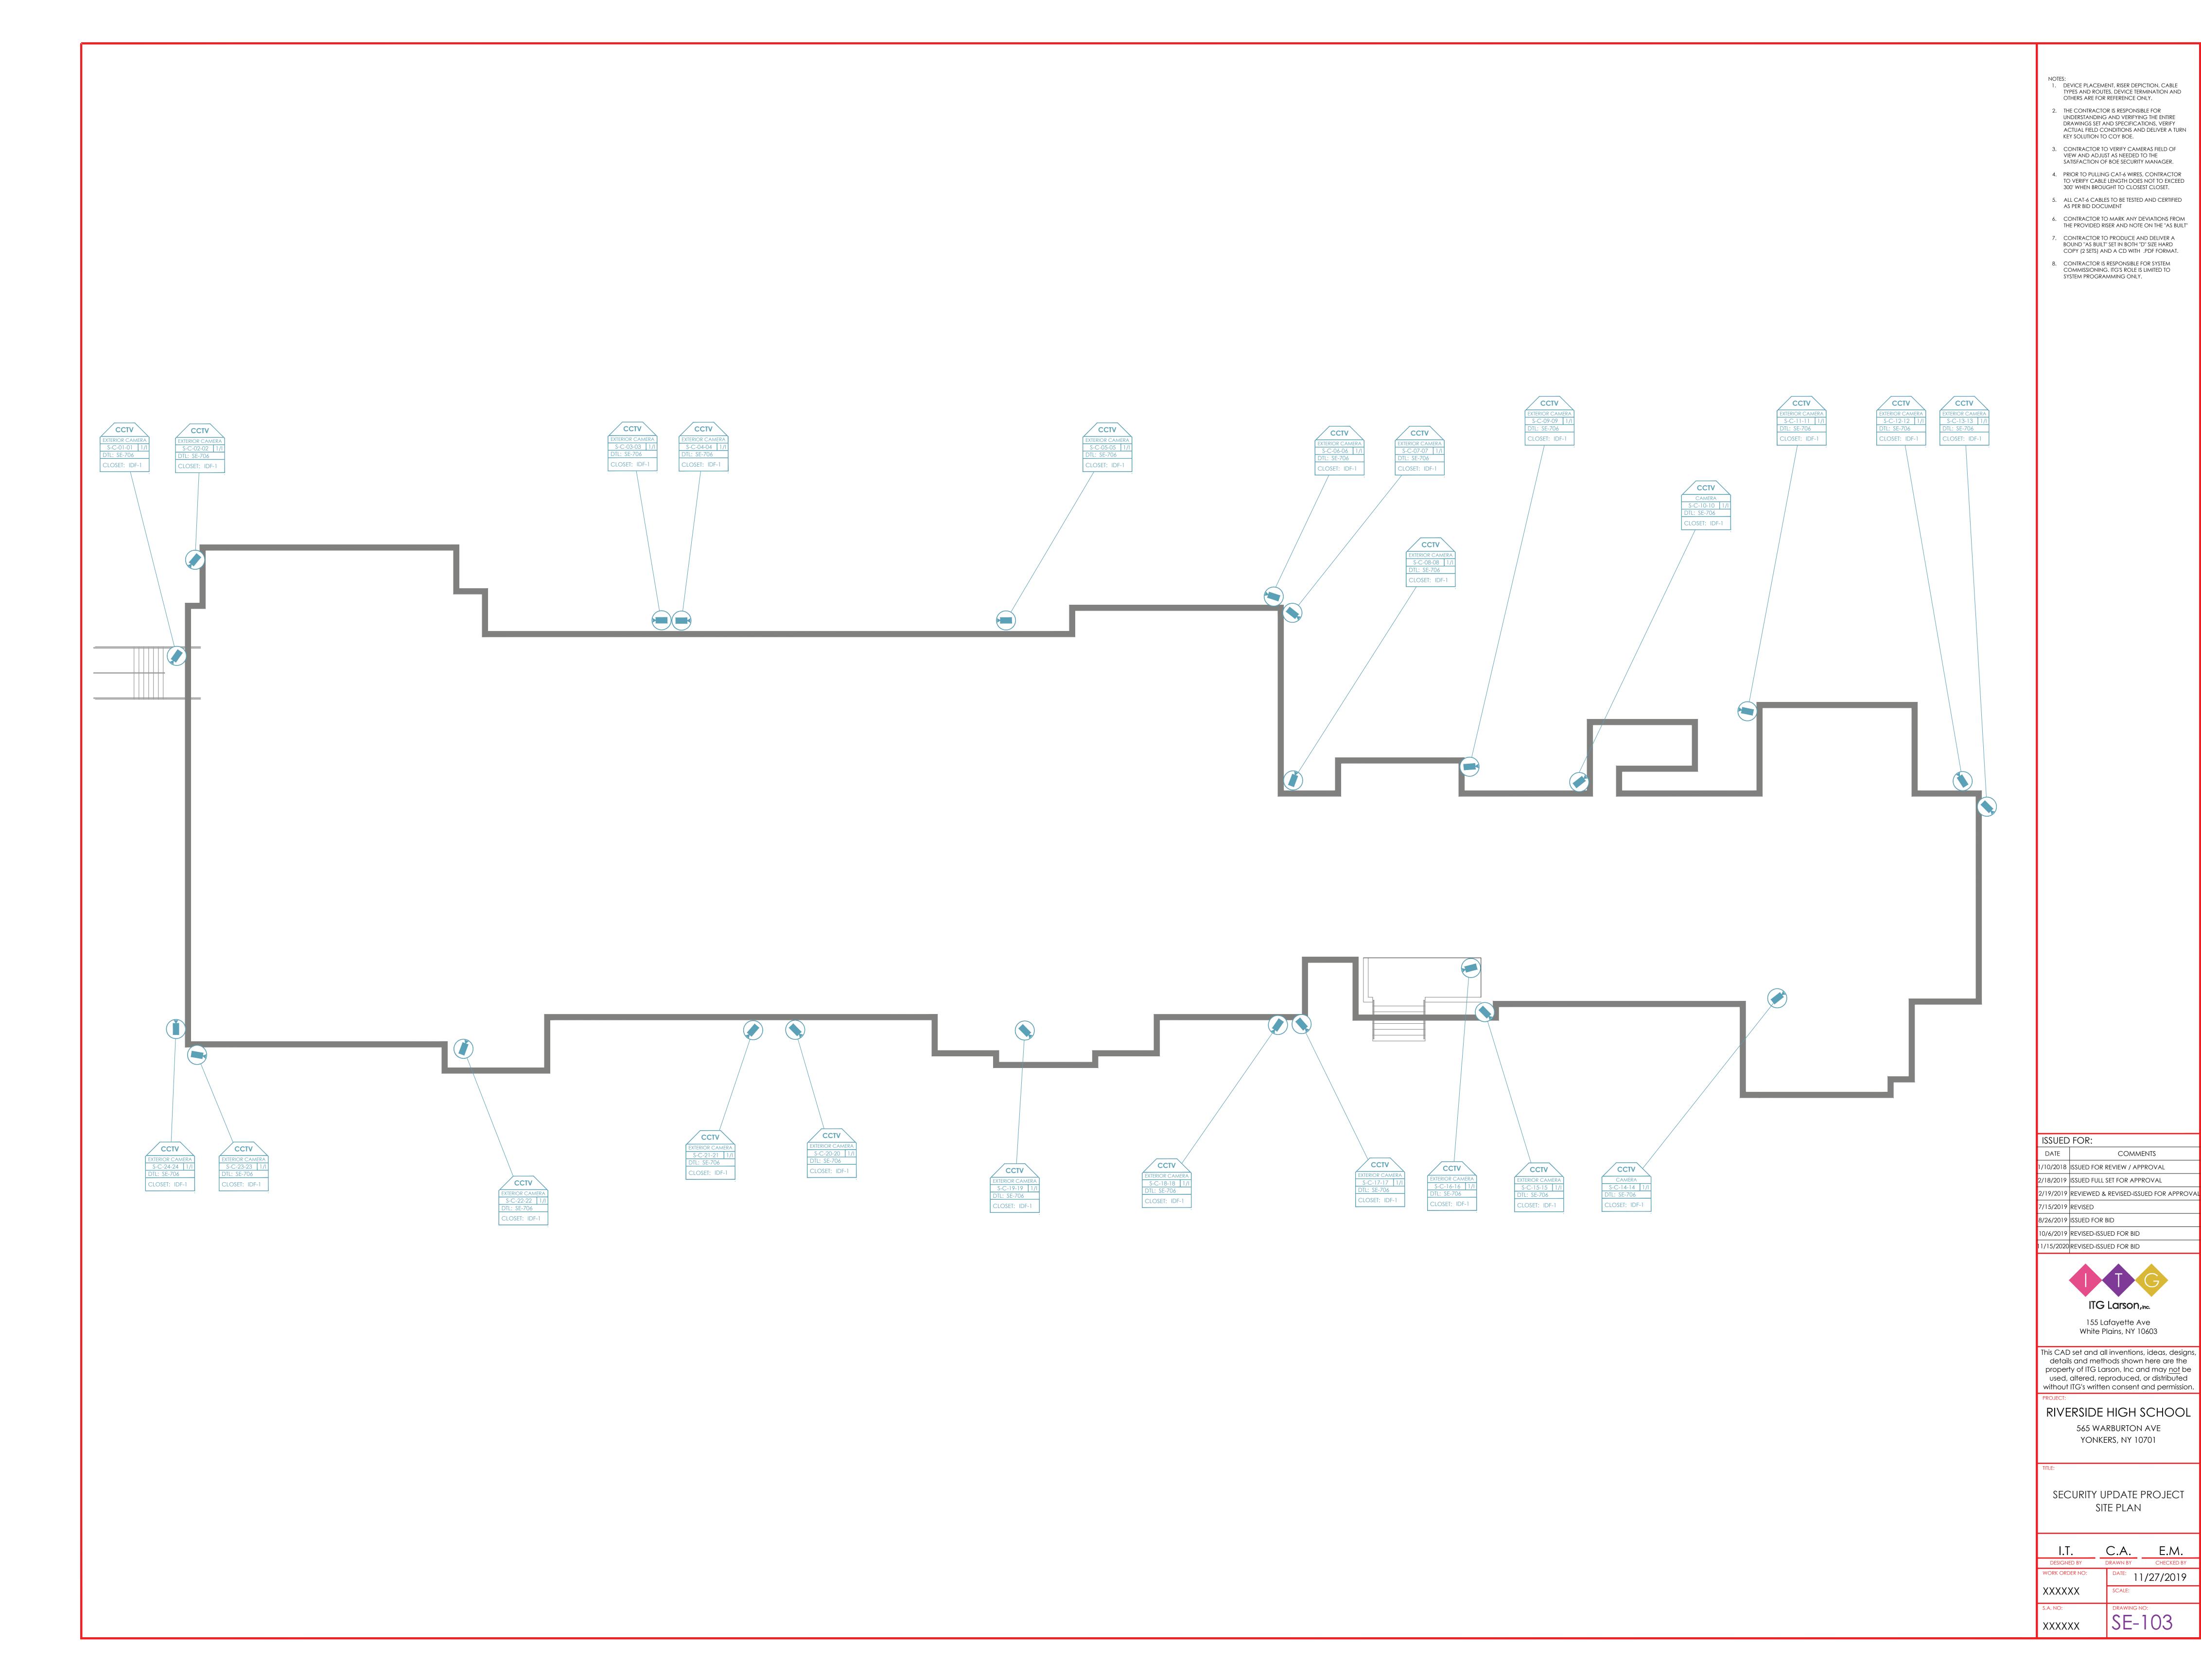
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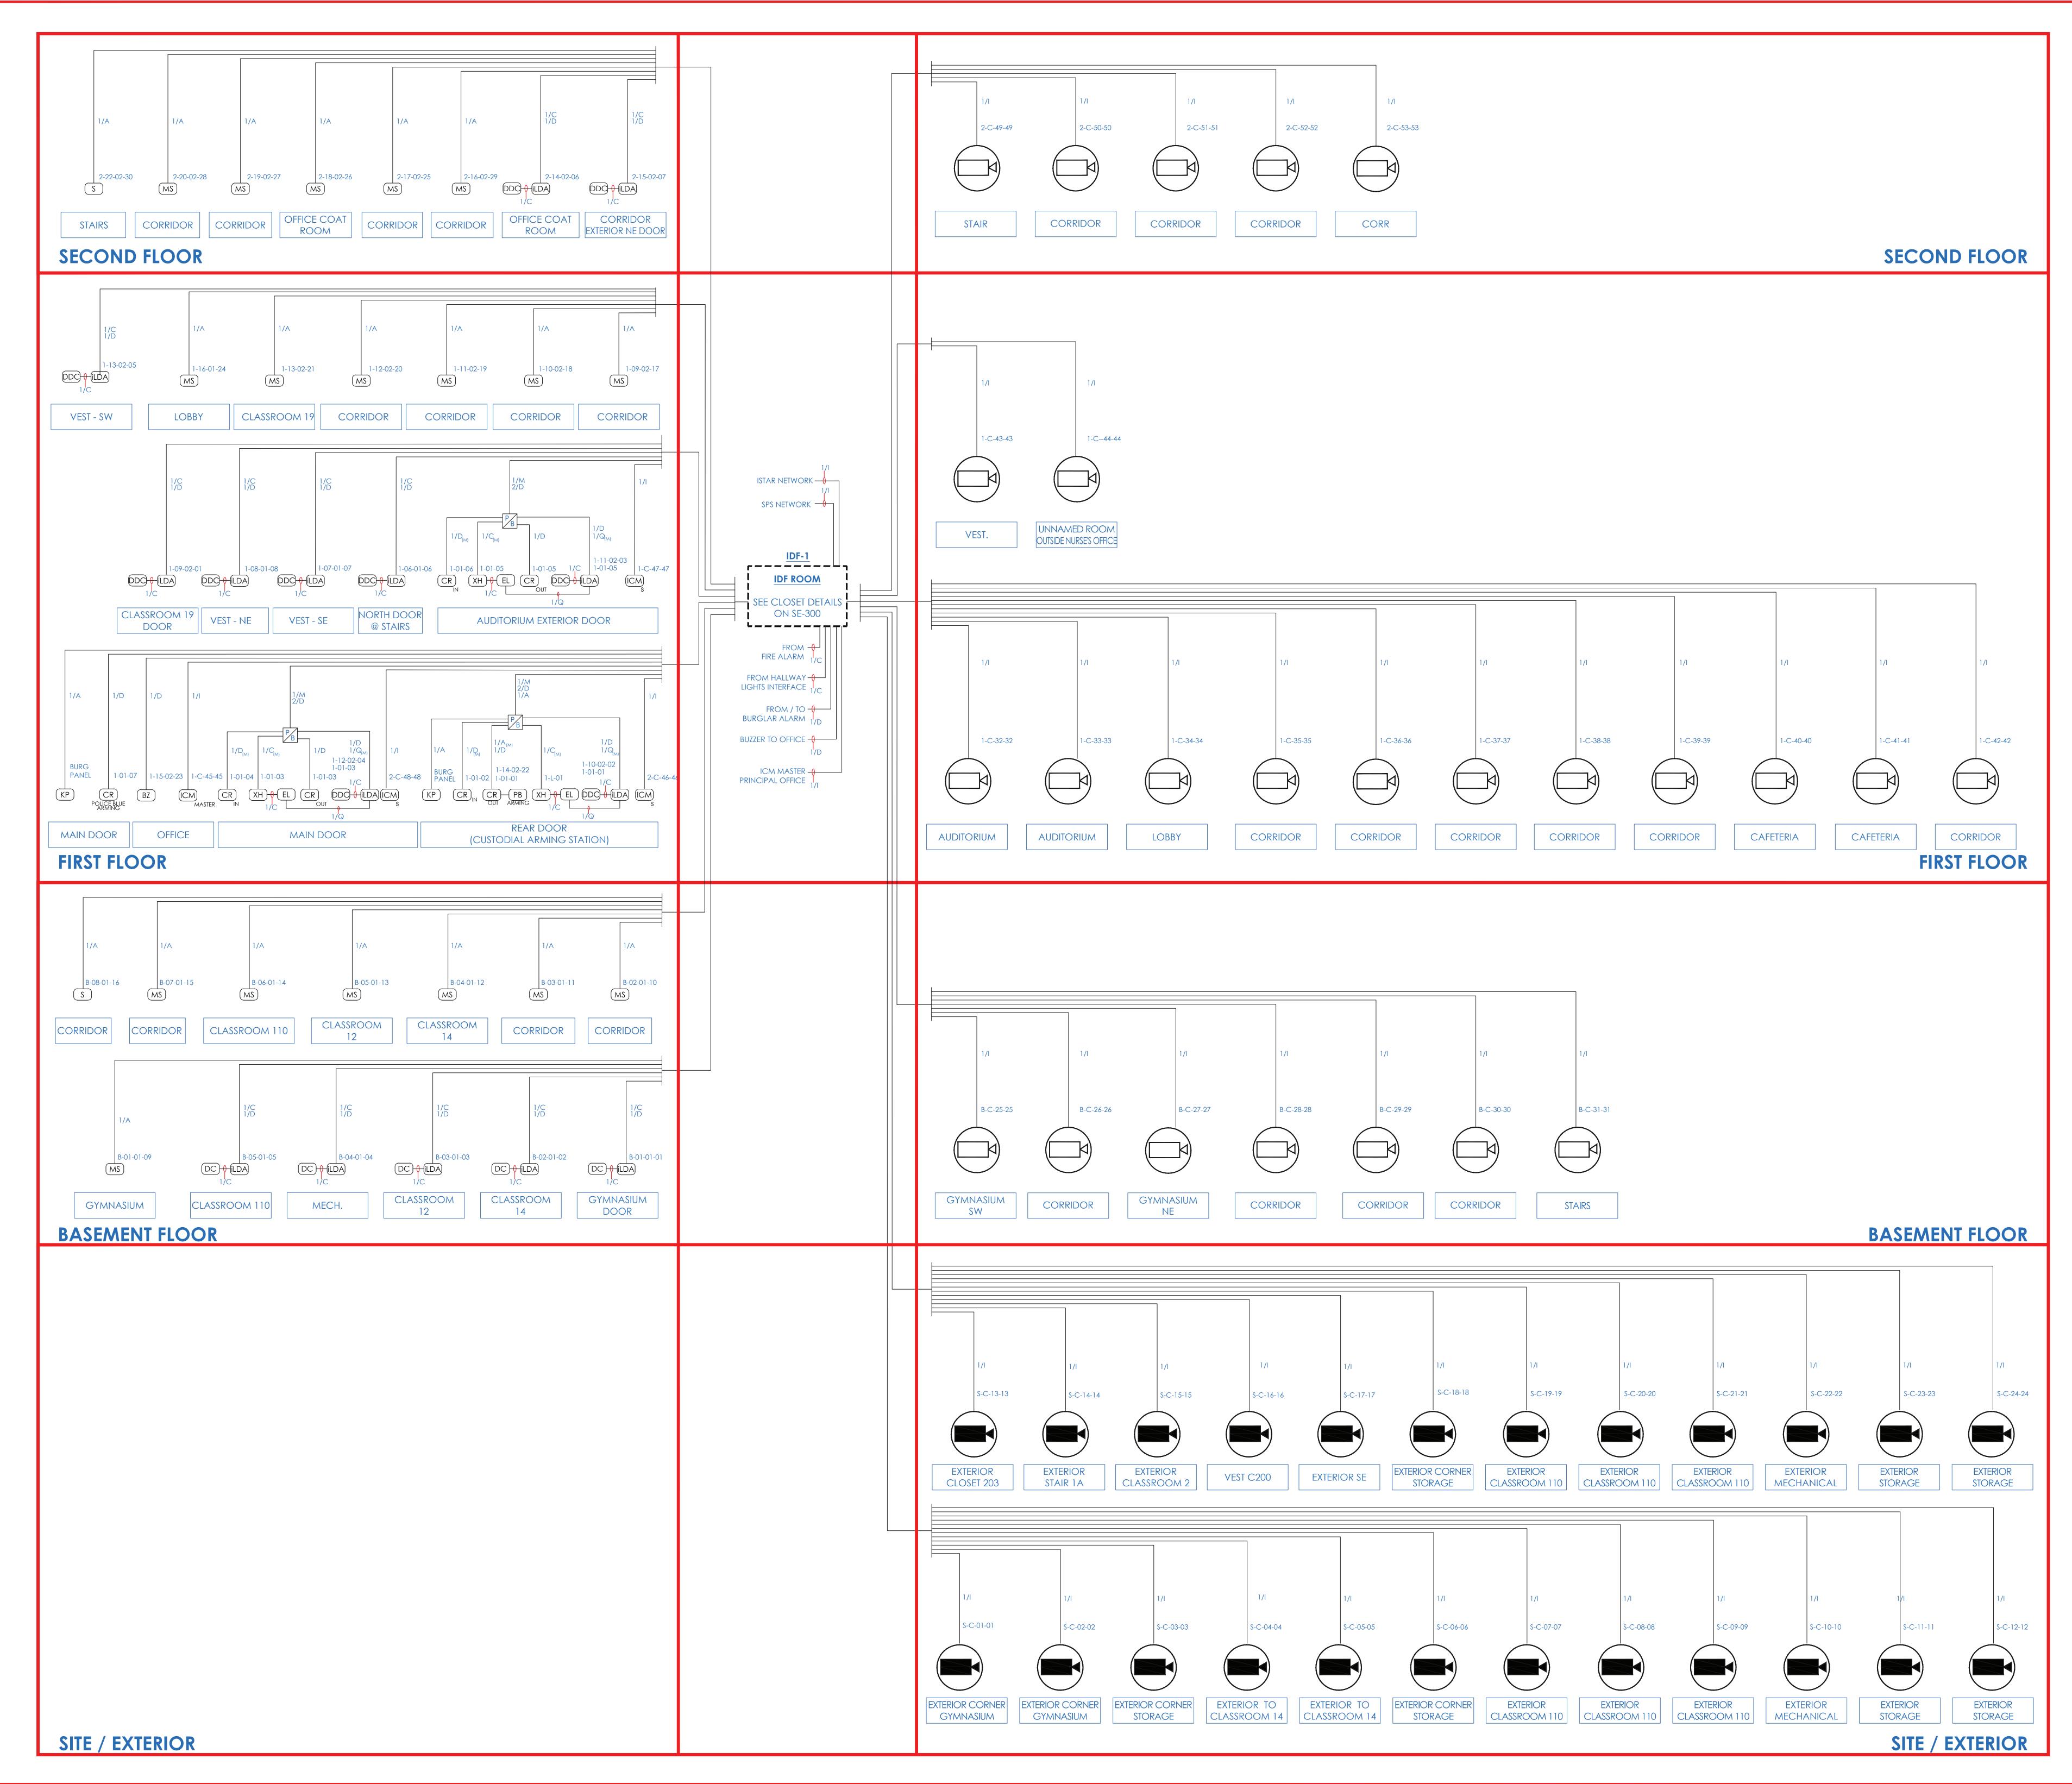
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YONKERS, NY 10701

SECURITY UPDATE PROJECT SECOND FLOOR

I.T.	C.A.	E.M.
DESIGNED BY	DRAWN BY	CHECKED BY
WORK ORDER NO:	DATE: 1	1/27/2019
XXXXXX	SCALE:	
S.A. NO:	DRAWING N	IO:
XXXXXX	SE-	102





DEVICE PLACEMENT, RISER DEPICTION, CABLE
 TYPES AND ROUTES, DEVICE TERMINATION AND
 OTHERS ARE FOR REFERENCE ONLY.

- THE CONTRACTOR IS RESPONSIBLE FOR UNDERSTANDING AND VERIFYING THE ENTIRE DRAWINGS SET AND SPECIFICATIONS, VERIFY ACTUAL FIELD CONDITIONS AND DELIVER A TURN KEY SOLUTION TO COY BOF
- KEY SOLUTION TO COY BOE.

  3. CONTRACTOR TO VERIFY CAMERAS FIELD OF VIEW AND ADJUST AS NEEDED TO THE

SATISFACTION OF BOE SECURITY MANAGER.

- PRIOR TO PULLING CAT-6 WIRES, CONTRACTOR TO VERIFY CABLE LENGTH DOES NOT TO EXCEED 300' WHEN BROUGHT TO CLOSEST CLOSET.
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8. CONTRACTOR IS RESPONSIBLE FOR SYSTEM

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SECURITY DEVICE

RISER DIAGRAM

I.T. C.A. E.M.
SIGNED BY DRAWN BY CHECKED BY
CORDER NO: DATE: 11/27/2019

XXXXXX

SCALE: NO SCALE

S.A. NO: DRAWING NO:

XXXXXXX

SCALE: NO SCALE

DRAWING NO:

SE-200


### ISTAR ULTRA-SE & SPS-2900/UIB 16 DOORS CONCRETE DECK DROP CEILING 6'(W)x8'(H)x3/4"(TH) FIRE RATED PLYWOOD PAINTED TO MATCH ROOM. N/C CONTACT FROM 10 6"x6"x48" WIRE TROUGH N/O CONTACT FROM [11] **CELLULAR** LIGHTS INTERFACE 2 CKT-1 BY ELEC. CONTRACTOR 16"X12"X4" MONTANA DATACOM DMA INTERFACE MFG-NU2 5 P/N- SPS-9900/ UIB BURG **ENCLOSURE** (TYPICAL OF 2) iLDA 1-8 22"X16"X5" DSC - 128 ZONE PANEL 22"X16"X5" P/N- HS2128E 12"X12"X4" BRING 1 CAT-5E DROP RJ-45 JACK FROM SECURITY PATCH **BURG KEYPAD iSTAR** PANEL TO BURG PANEL. P/N- HS2LCD COORDINATE LOCATION & ULTRA SE® TERMINATION. ADD 1/A CABLE FROM LOCK POWER SPS TO ALL **OTHER SPS's** iLDA 9-16 22"X16"X5" 24"x16"x4" 7 8 MFG-iSTAR P/N- ULTRA-SE **ZONES 9-40** 22"X16"X5" UTILITY UTILITY 2 CKT-1 BY ELEC. 4 CONTRACTOR 16"X12"X4" 16"X12"X4" QTY(1)- CKT-1 120 VAC EMERGENCY CIRCUIT BY 2 ELEC. CONTRACTOR


## INSTALLATION PROCEDURE iSTAR ULTRA SE WITH SPS-9900/ UIB ACCESS CONTROL HEADEND

- LAYOUT EQUIPMENT TO BE MOUNTED AT DESIGNATED PLYWOOD (FIRE RATED AND PAINTED TO MATCH ROOM) BOARD IN SDF ROOM IN ACCORDANCE WITH THE PROVIDED ELEVATIONS HERE.

  STEPS KEYED ON THE DRAWINGS ARE NOTED BELOW.
- 2 COMPLETE INSTALLATION OF 120VAC/20A DEDICATED CIRCUIT AS SHOWN.
- FURNISH AND INSTALL A 6"x6"x48" CABLE TROUGH WITH SCREW FASTENED REMOVABLE COVER (NEMA TYPE 1), MOUNTED HORIZONTALLY, ON THE PLYWOOD 4" FROM THE TOP EDGE OF PLYWOOD.
- FURNISH AND INSTALL A 4"x4"x60" CABLE TROUGH WITH SCREW FASTENED REMOVABLE COVER (NEMA TYPE 1), MOUNTED VERTICALLY, CENTERED ON THE PLYWOOD ADJOINING TO HORIZONTAL TROUGH. PROVIDE PUNCH OUTS TO MATCH THE EQUIPMENT AS SHOWN.
- 5 MOUNT THE UTILITY ENCLOSURE 4" FROM BOTTOM EDGE OF VERTICAL TROUGH.
- FURNISH AND INSTALL 2" COUPLERS (SEE DRAWING ABOVE FOR QTY.) FROM THE LOCK POWER SUPPLY (SPS-9900/UIB) TO THE CENTER TROUGH AS SHOWN. DO NOT ENTER BOTTOM OF P/S (INTERFERES WITH BATTERY).
- 7 FURNISH AND INSTALL 1-1/2" COUPLERS (SEE DRAWING ABOVE FOR QTY.) FROM THE ISTAR ULTRA SE TO THE CENTER TROUGH AS SHOWN.
- MOUNT [iSTAR ULTRA SE] ENCLOSURE 1" BELOW THE LOCK POWER SUPPLY. FURNISH AND INSTALL 2" COUPLERS (SEE DRAWING ABOVE FOR QTY.) FROM [ISTAR ULTRA SE] ENCLOSURE TO THE CENTER TROUGH AS SHOWN.
- BRING CAT-5 CABLE AND/OR MOUNT AN RJ-45 JACK FOR PANEL DATA COMM, FROM NEAREST NETWORK SWITCH TO HERE. COORDINATE TERMINATION WITH TELECOM VENDOR OR CUSTOMER'S DATA CONSULTANT. ADD 1/A CABLE FROM LOCK POWER SUPPLY (SPS) TO ALL OTHER SPS'S.
- COORDINATE WITH MEP/ BLDG MANAGEMENT TO PROVIDE ONE SET OF NORMALLY CLOSED (N/C) DRY CONTACT FROM THE SITE'S FIRE ALARM SYSTEM, TO OPEN ON GENERAL ALARM ACTIVATION. (PROVIDED BY FIRE VENDOR). ELECTRIC LOCKS MUST BE FAIL SAFE FOR THIS FUNCTIONALITY. PERFORM SAME FOR HALLWAY LIGHTS INTERFACE
- PROVIDE 18/2 PAIR OF WIRES FROM BUILDING'S LIGHTING SYSTEM. ARRANGE SUCH THAT DESIGNATED BUILDING'S LIGHTS ARE TURNED ON WHEN THE SECURITY SYSTEM CLOSES THE CIRCUIT
- 12 ALL CONDUITS AND CONNECTIONS SHALL BE INSTALLED TO REQUIRED ENCLOSURES AS NEEDED PER DIAGRAM PROVIDED.
- 13 ALL CONNECTIONS BETWEEN PANELS & TROUGHS SHOULD BE CHASE NIPPLES & RIGID COUPLINGS.
- 14 INSTALL TAMPER SWITCHES AND WIRE PANELS IN SERIES TO DESIGNATED INPUT SHOWN ON POINT-TO-POINT CHARTS.

### **CCTV NETWORK RACK**

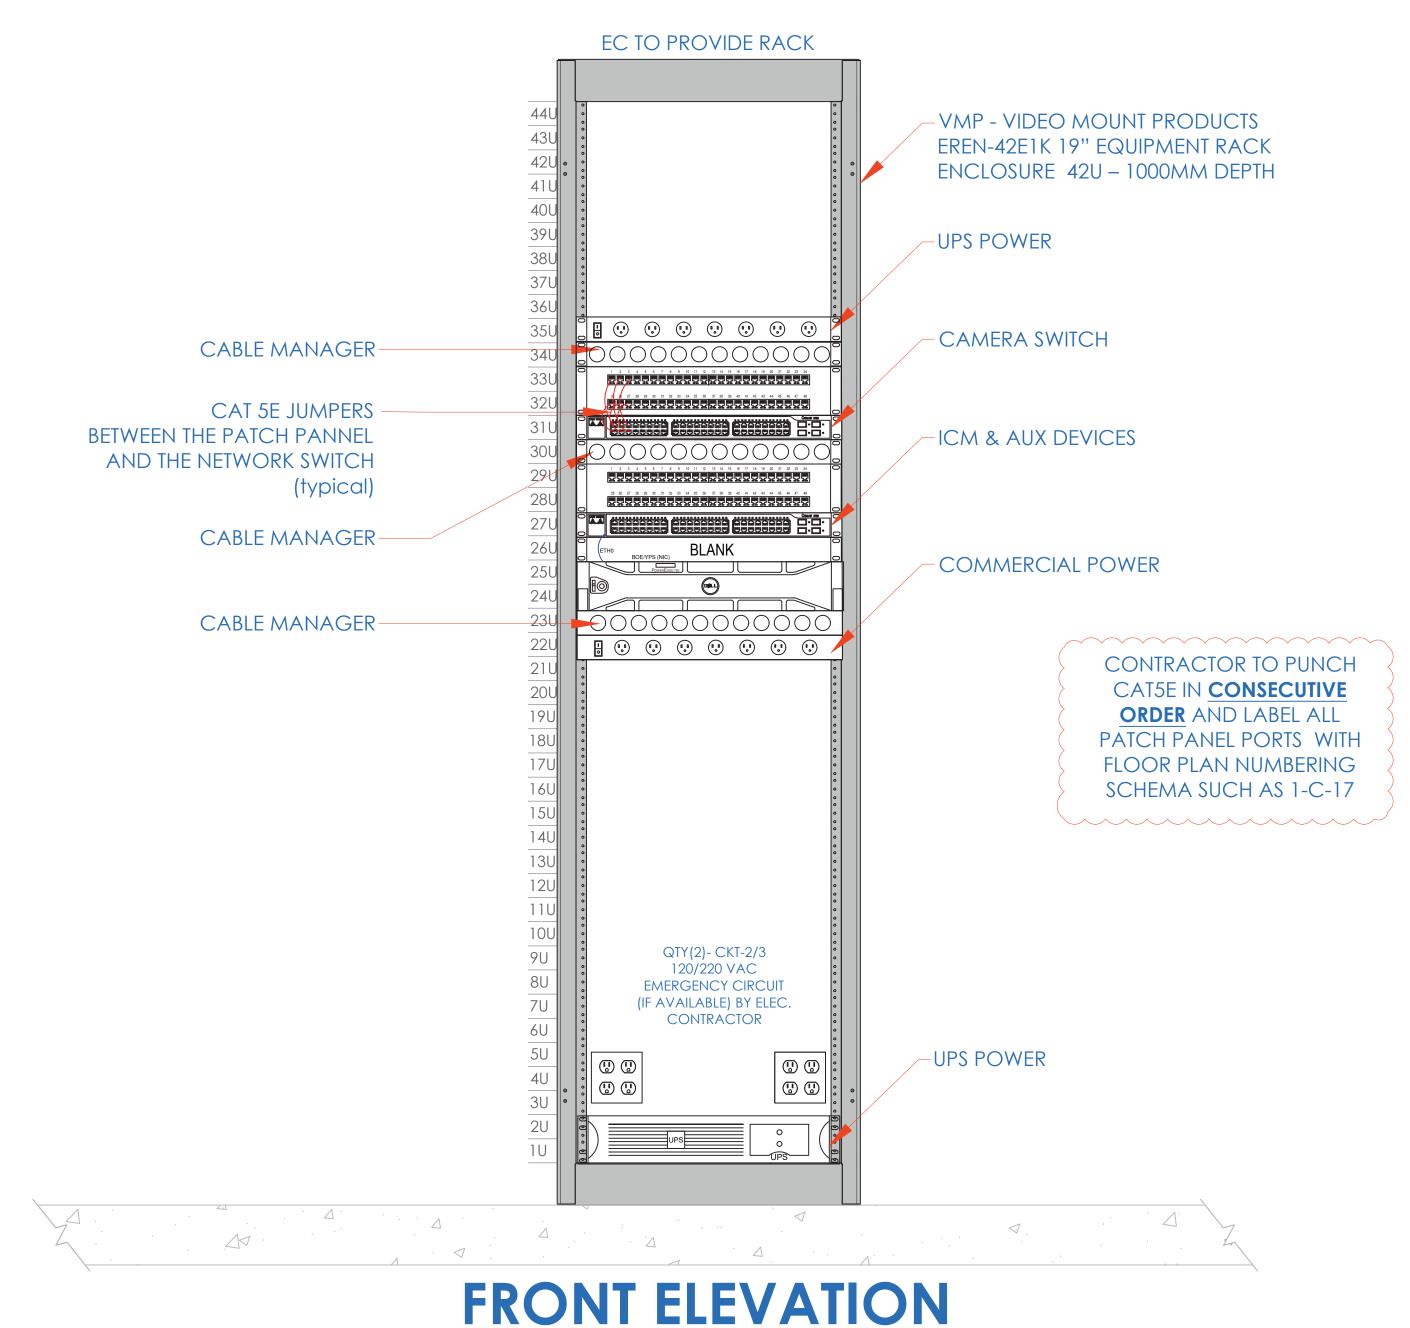

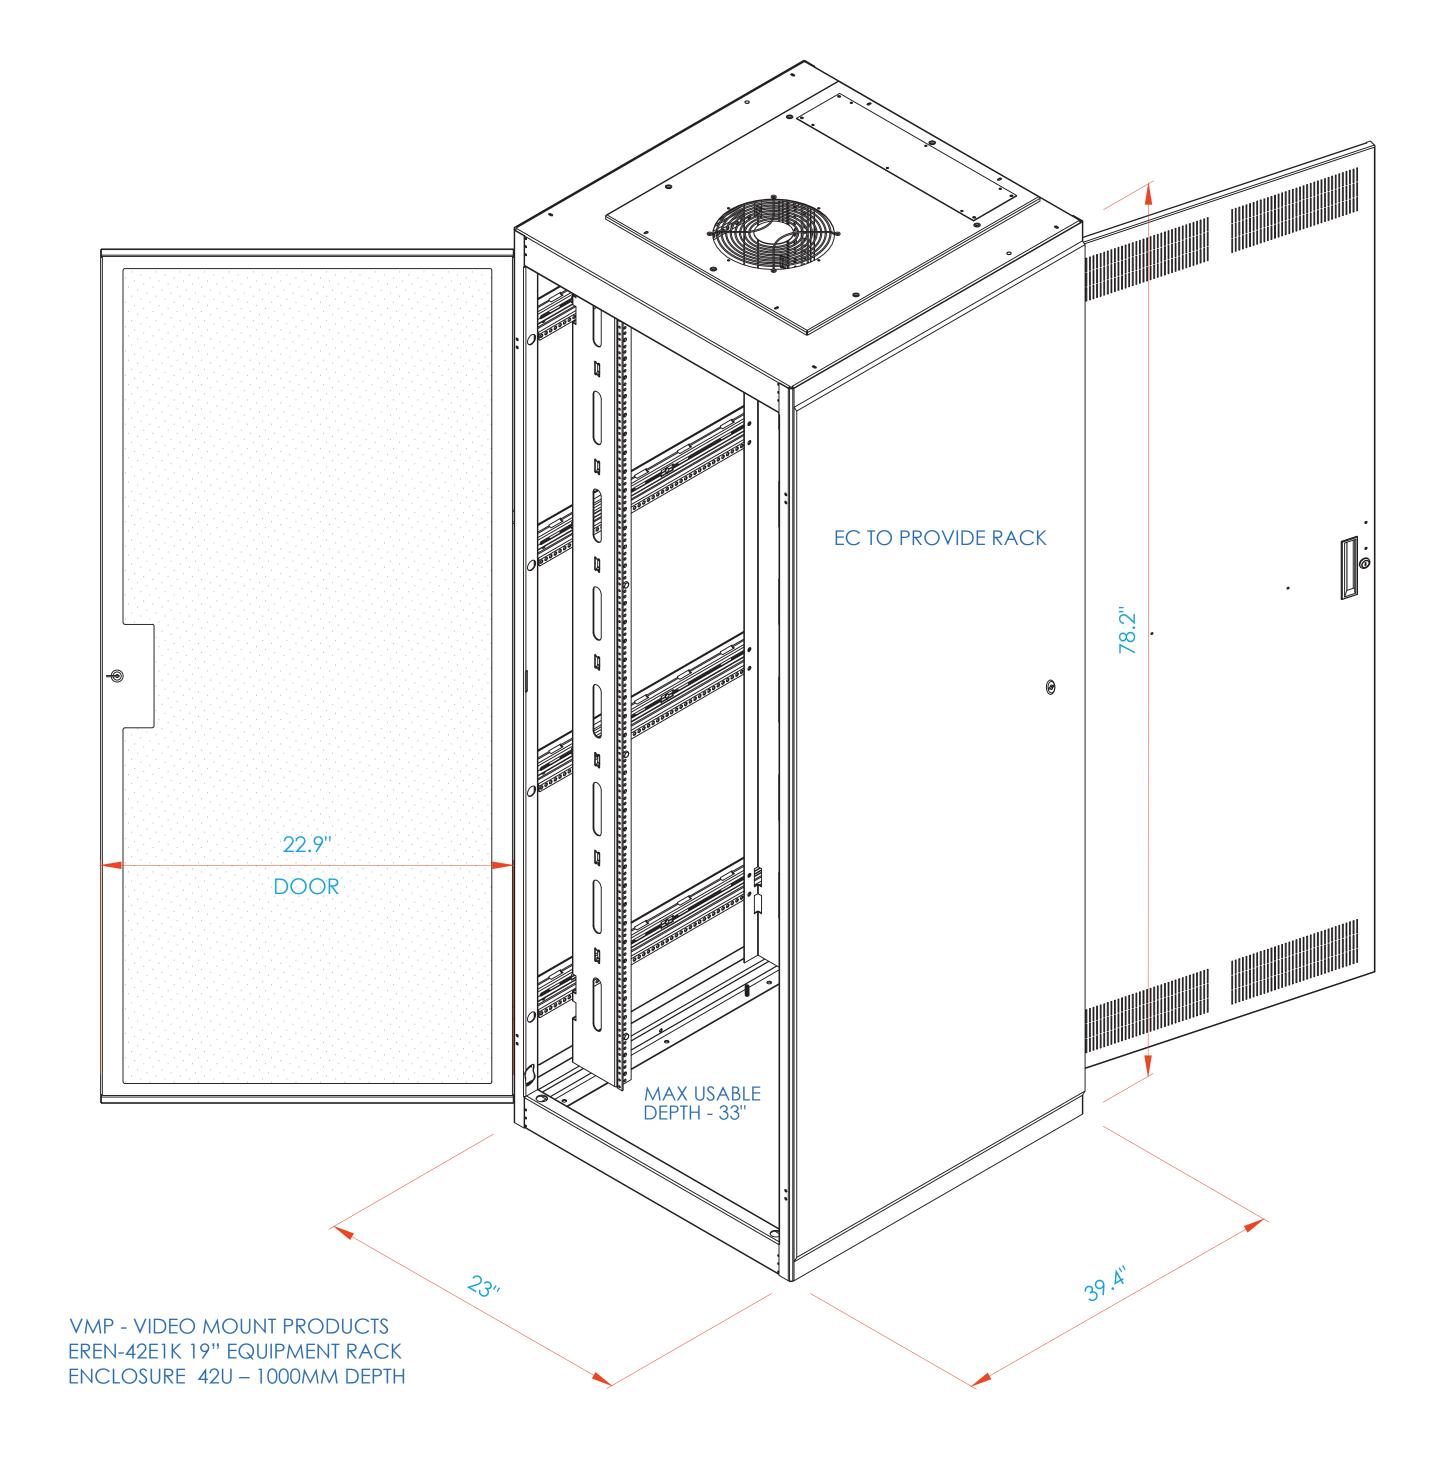

RACK - 3D VIEW

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11/15/2020 REVISED-ISSUED FOR BID

ITG Larson, Inc.

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RIVERSIDE HIGH SCHOOL

White Plains, NY 10603

565 WARBURTON AVE YONKERS, NY 10701

CLOSET ELEVATIONS IDF-1

I.T. C.A. E.M.

DESIGNED BY DRAWN BY CHECKED BY

WORK ORDER NO:

XXXXXXX

DATE: 11/27/2019

SCALE: N.T.S.

DRAWING NO:

XXXXXXX

SE-300


### ISTAR ULTRA-SE & SPS-9900/UIB 16 DOORS CONCRETE DECK DROP CEILING 6'(W)x8'(H)x3/4"(TH) FIRE RATED PLYWOOD PAINTED TO MATCH - N/C CONTACT FROM 10 3 6"x6"x36" WIRE TROUGH N/O CONTACT FROM [1] LIGHTS INTERFACE 2 CKT-1 BY ELEC. CONTRACTOR MONTANA DATACOM DMA INTERFACE MFG-NU2 5 P/N- SPS-9900/ UIB **ENCLOSURE** (TYPICAL OF 2) iLDA 1-8 22"X16"X5" 22"X16"X5" BRING 1 CAT-5E DROP RJ-45 JACK FROM SECURITY PATCH PANEL TO BURG PANEL. COORDINATE LOCATION & TERMINATION. ADD 1/A CABLE 16"X12"X4" FROM LOCK POWER SPS TO ALL **OTHER SPS's** 7 8 MFG-iSTAR P/N- ULTRA-SE QTY(1)- CKT-1 120 VAC EMERGENCY CIRCUIT BY 2 ELEC. CONTRACTOR


## INSTALLATION PROCEDURE ISTAR ULTRA SE WITH SPS-9900/ UIB ACCESS CONTROL HEADEND

- LAYOUT EQUIPMENT TO BE MOUNTED AT DESIGNATED PLYWOOD (FIRE RATED AND PAINTED TO MATCH ROOM) BOARD IN SDF ROOM IN ACCORDANCE WITH THE PROVIDED ELEVATIONS HERE.

  STEPS KEYED ON THE DRAWINGS ARE NOTED BELOW.
- 2 COMPLETE INSTALLATION OF 120VAC/20A DEDICATED CIRCUIT AS SHOWN.
- FURNISH AND INSTALL A 6"x6"x48" CABLE TROUGH WITH SCREW FASTENED REMOVABLE COVER (NEMA TYPE 1), MOUNTED HORIZONTALLY, ON THE PLYWOOD 4" FROM THE TOP EDGE OF PLYWOOD.
- FURNISH AND INSTALL A 4"x4"x60" CABLE TROUGH WITH SCREW FASTENED REMOVABLE COVER (NEMA TYPE 1), MOUNTED VERTICALLY, CENTERED ON THE PLYWOOD ADJOINING TO HORIZONTAL TROUGH. PROVIDE PUNCH OUTS TO MATCH THE EQUIPMENT AS SHOWN.
- MOUNT THE UTILITY ENCLOSURE 4" FROM BOTTOM EDGE OF VERTICAL TROUGH.
- FURNISH AND INSTALL 2" COUPLERS (SEE DRAWING ABOVE FOR QTY.) FROM THE LOCK POWER SUPPLY (SPS-9900/UIB) TO THE CENTER TROUGH AS SHOWN. DO NOT ENTER BOTTOM OF P/S (INTERFERES WITH BATTERY).
- 7 FURNISH AND INSTALL 1-1/2" COUPLERS (SEE DRAWING ABOVE FOR QTY.) FROM THE ISTAR ULTRA SE TO THE CENTER TROUGH AS SHOWN.
- 8 MOUNT [ISTAR ULTRA SE] ENCLOSURE 1" BELOW THE LOCK POWER SUPPLY. FURNISH AND INSTALL 2" COUPLERS (SEE DRAWING ABOVE FOR QTY.) FROM [ISTAR ULTRA SE] ENCLOSURE TO THE CENTER TROUGH AS SHOWN.
- BRING CAT-5 CABLE AND/OR MOUNT AN RJ-45 JACK FOR PANEL DATA COMM, FROM NEAREST NETWORK SWITCH TO HERE. COORDINATE TERMINATION WITH TELECOM VENDOR OR CUSTOMER'S DATA CONSULTANT. ADD 1/A CABLE FROM LOCK POWER SUPPLY (SPS) TO ALL OTHER SPS's.
- COORDINATE WITH MEP/ BLDG MANAGEMENT TO PROVIDE ONE SET OF NORMALLY CLOSED (N/C) DRY CONTACT FROM THE SITE'S FIRE ALARM SYSTEM, TO OPEN ON GENERAL ALARM ACTIVATION. (PROVIDED BY FIRE VENDOR). ELECTRIC LOCKS MUST BE FAIL SAFE FOR THIS FUNCTIONALITY. PERFORM SAME FOR HALLWAY LIGHTS INTERFACE
- PROVIDE 18/2 PAIR OF WIRES FROM BUILDING'S LIGHTING SYSTEM. ARRANGE SUCH THAT DESIGNATED BUILDING'S LIGHTS ARE TURNED ON WHEN THE SECURITY SYSTEM CLOSES THE CIRCUIT
- 12 ALL CONDUITS AND CONNECTIONS SHALL BE INSTALLED TO REQUIRED ENCLOSURES AS NEEDED PER DIAGRAM PROVIDED.
- 13 ALL CONNECTIONS BETWEEN PANELS & TROUGHS SHOULD BE CHASE NIPPLES & RIGID COUPLINGS.
- 14 INSTALL TAMPER SWITCHES AND WIRE PANELS IN SERIES TO DESIGNATED INPUT SHOWN ON POINT-TO-POINT CHARTS.

### **CCTV NETWORK RACK**

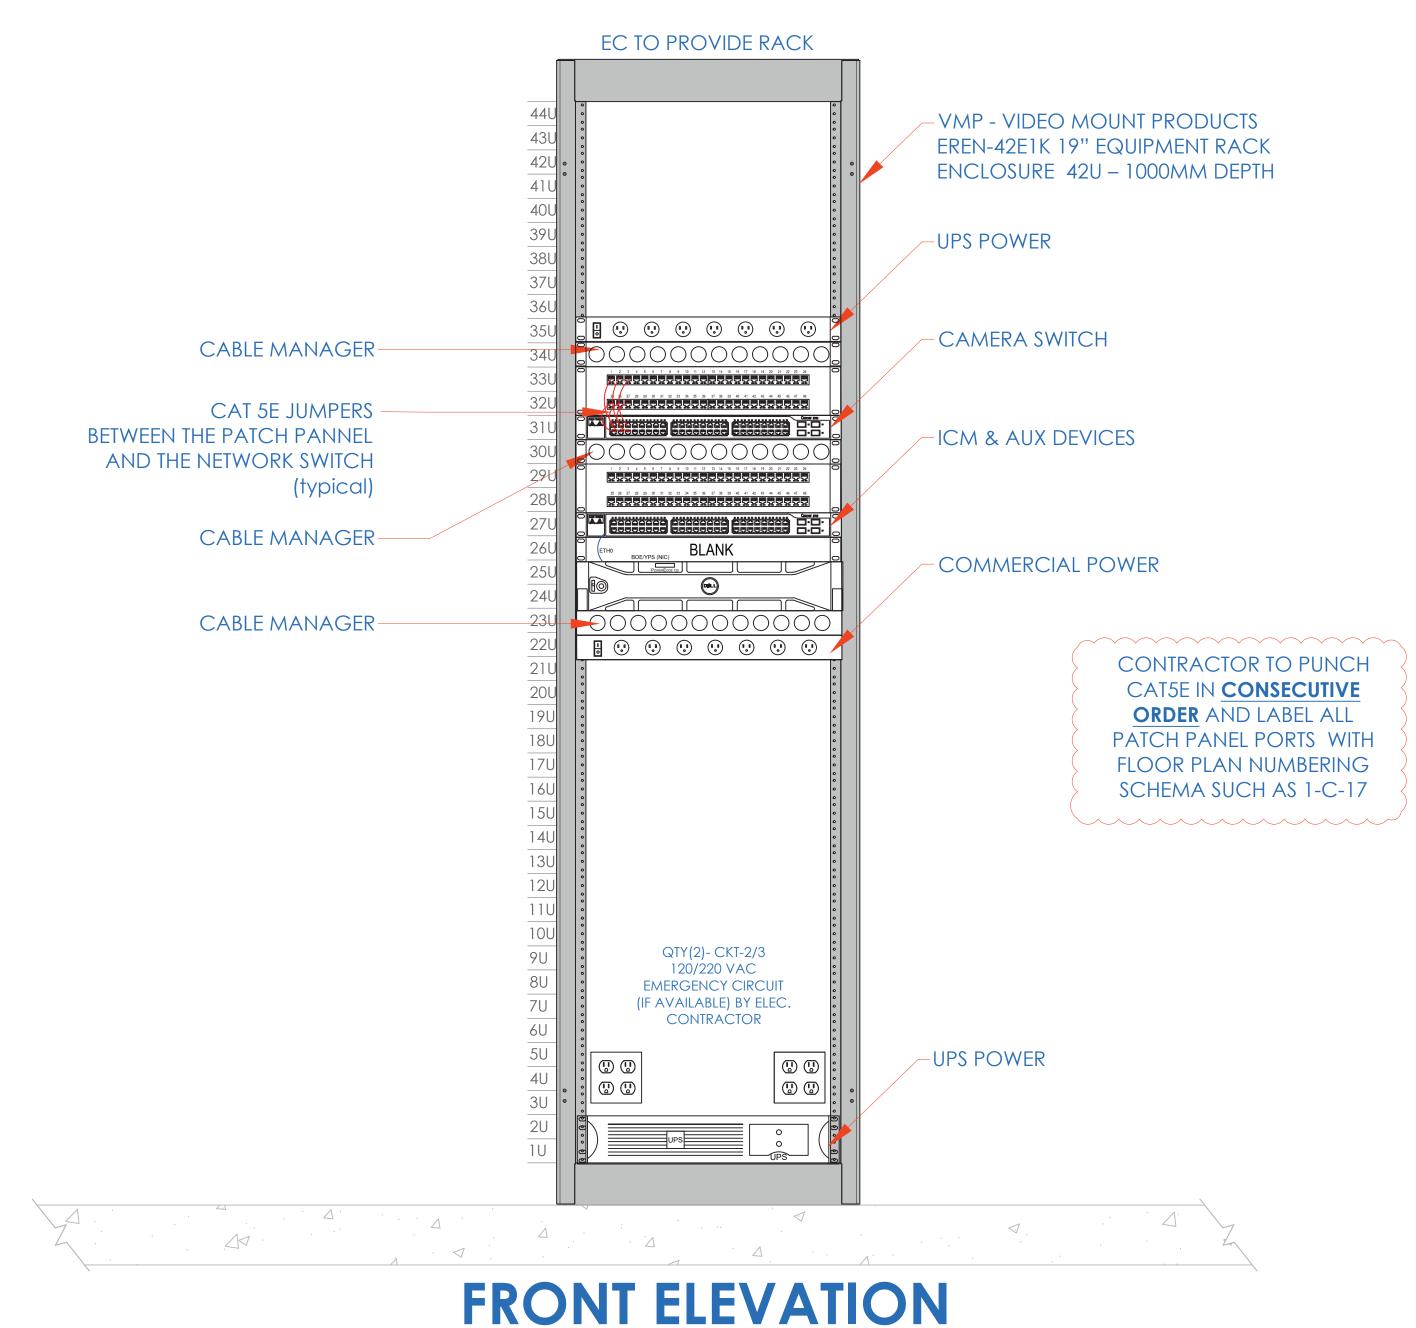

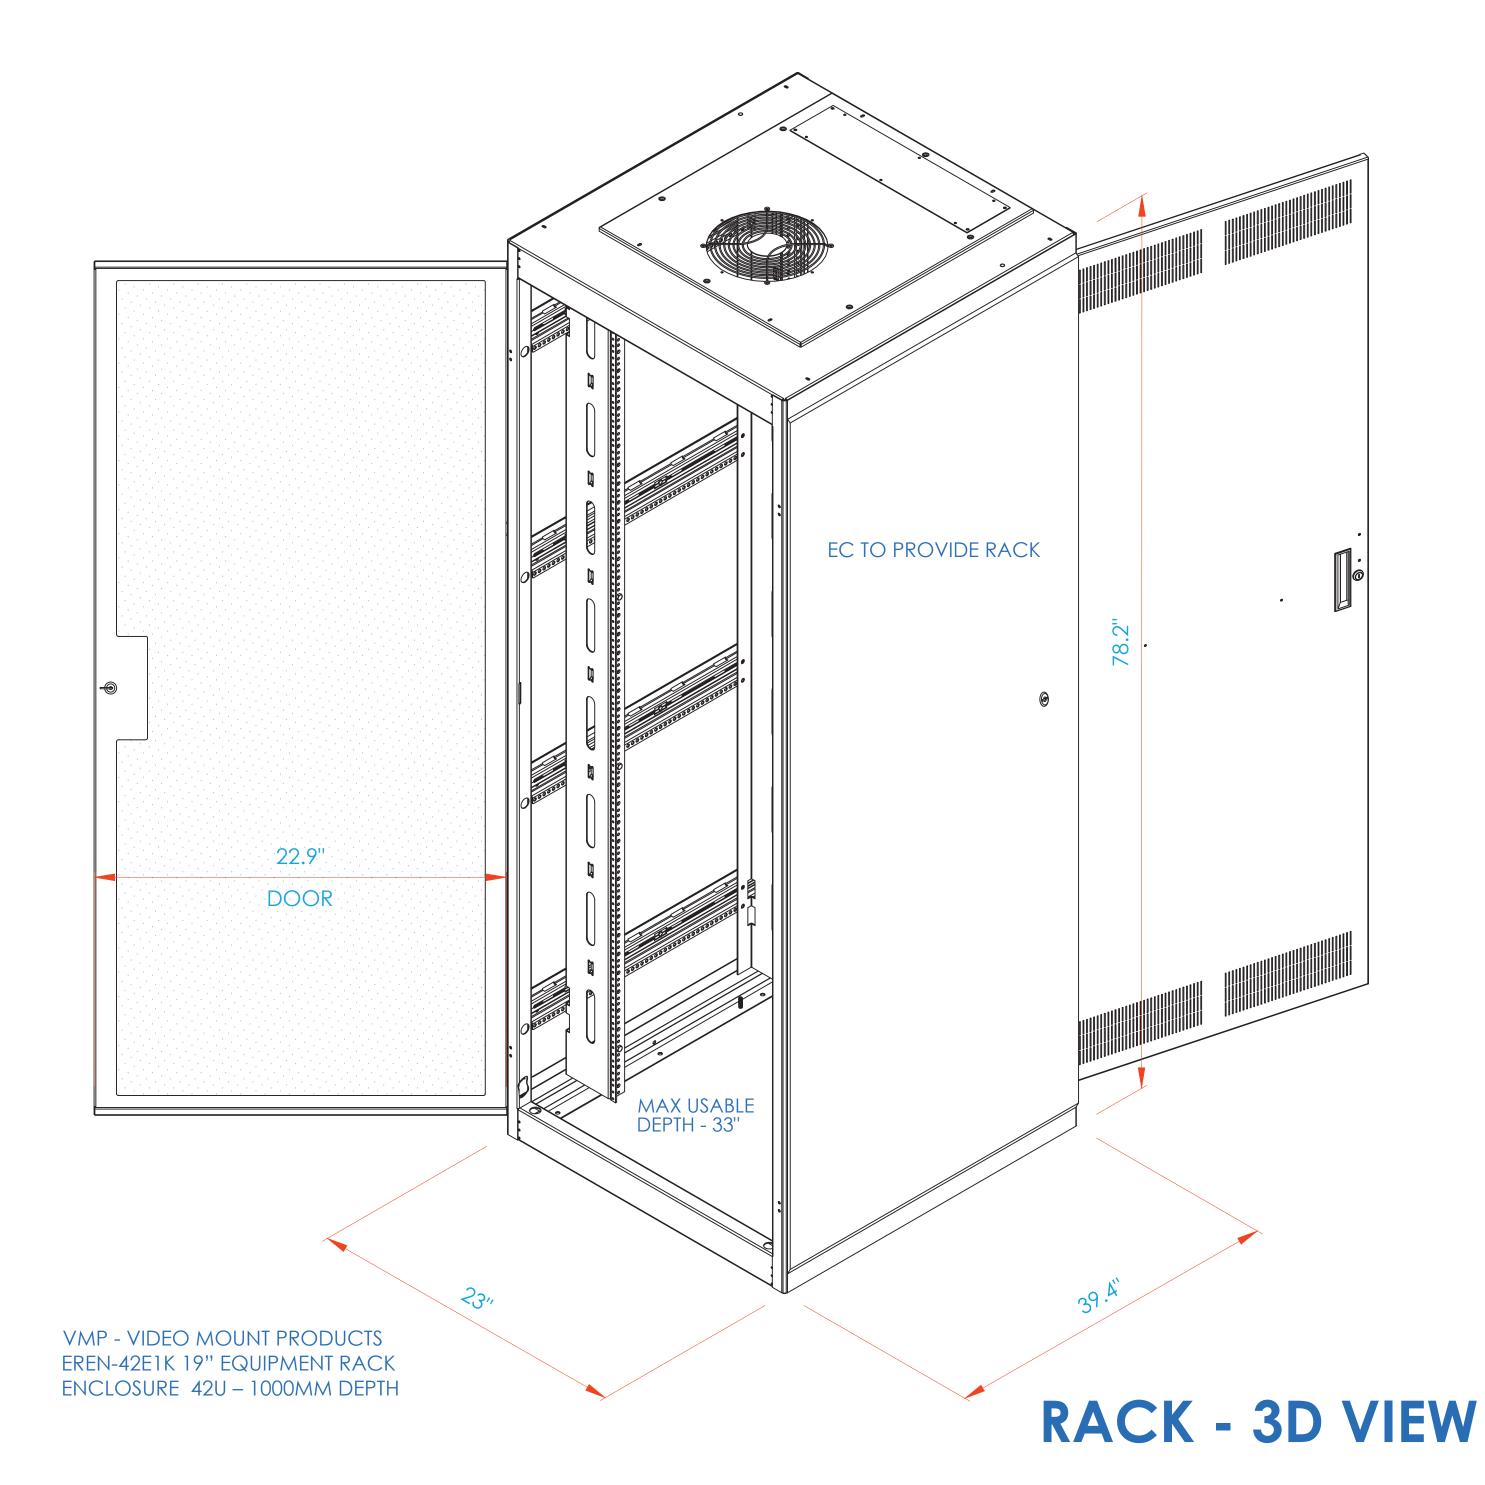

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- THE CONTRACTOR IS RESPONSIBLE FOR UNDERSTANDING AND VERIFYING THE ENTIRE DRAWINGS SET AND SPECIFICATIONS, VERIFY ACTUAL FIELD CONDITIONS AND DELIVER A TURN KEY SOLUTION TO COY BOE.
- 3. CONTRACTOR TO VERIFY CAMERAS FIELD OF
- VIEW AND ADJUST AS NEEDED TO THE SATISFACTION OF BOE SECURITY MANAGER.

PRIOR TO PULLING CAT-6 WIRES, CONTRACTOR

TO VERIFY CABLE LENGTH DOES NOT TO EXCEED 300' WHEN BROUGHT TO CLOSEST CLOSET.

5. ALL CAT-6 CABLES TO BE TESTED AND CERTIFIED

AS PER BID DOCUMENT

- CONTRACTOR TO MARK ANY DEVIATIONS FROM THE PROVIDED RISER AND NOTE ON THE "AS BUILT"
- 7. CONTRACTOR TO PRODUCE AND DELIVER A BOUND "AS BUILT" SET IN BOTH "D" SIZE HARD COPY (2 SETS) AND A CD WITH .PDF FORMAT.
- 8. CONTRACTOR IS RESPONSIBLE FOR SYSTEM COMMISSIONING. ITG'S ROLE IS LIMITED TO SYSTEM PROGRAMMING ONLY.



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RIVERSIDE HIGH SCHOOL

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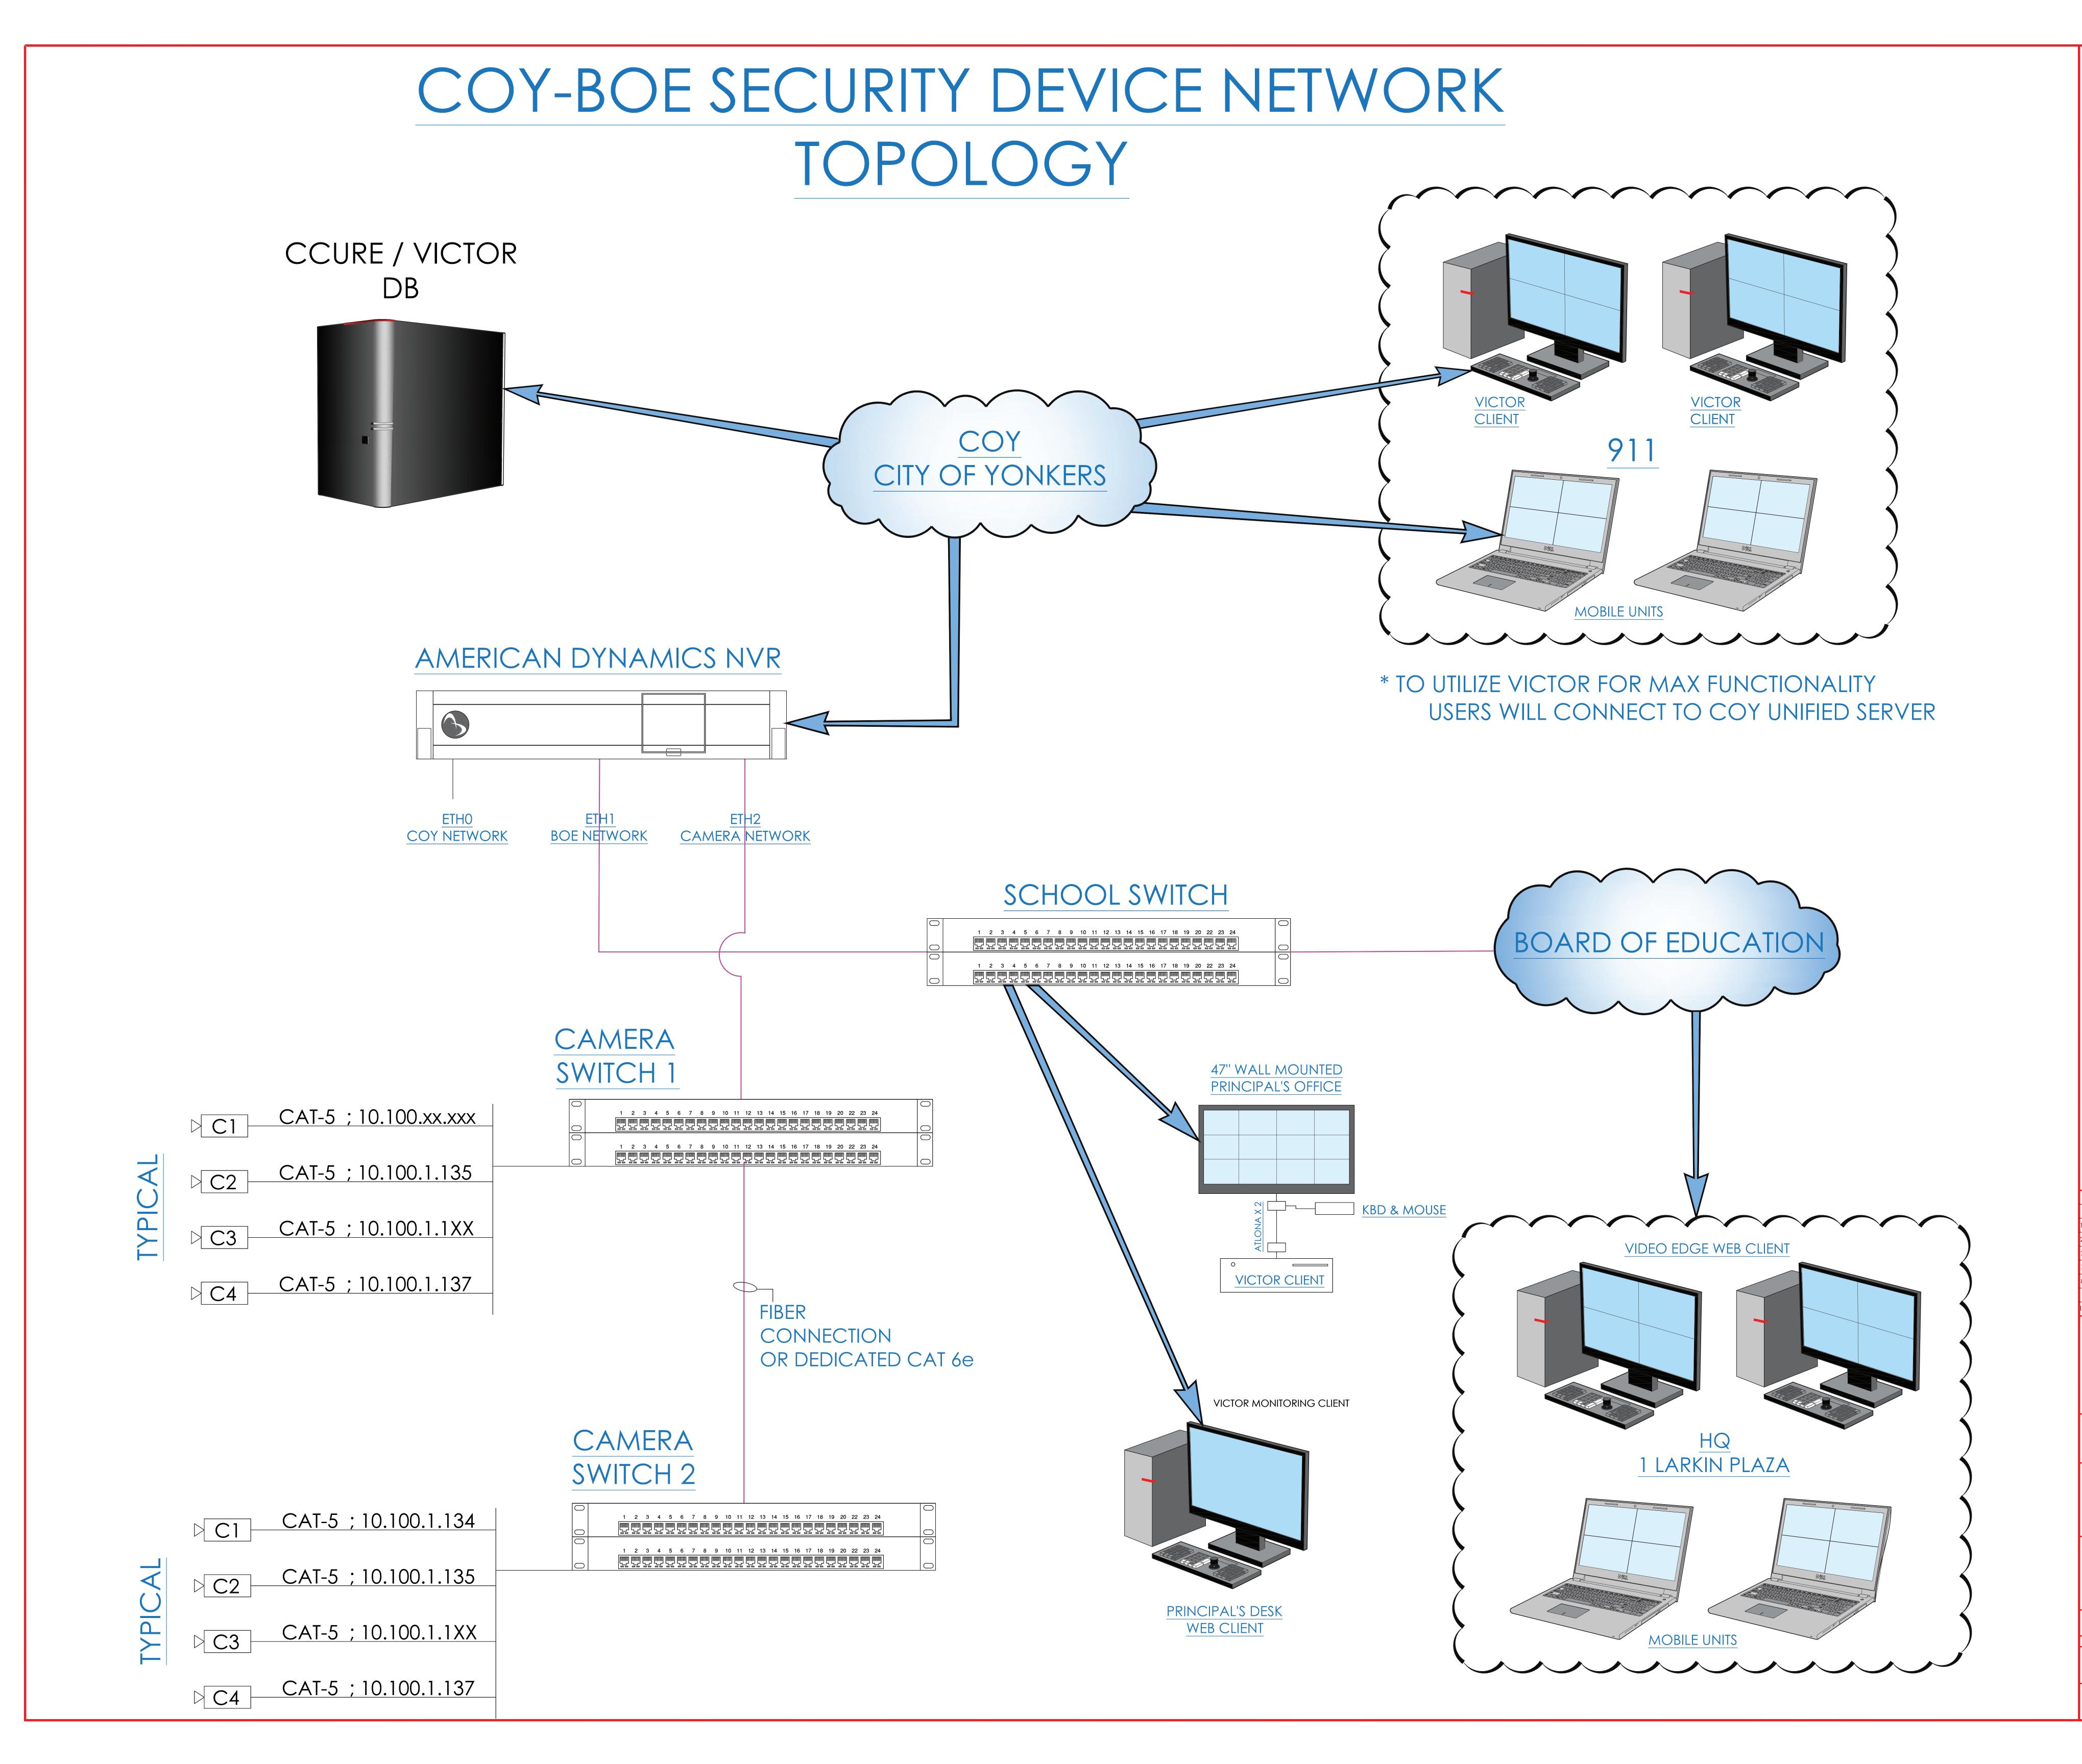
**CLOSET ELEVATIONS** 

IDF-2

11/27/2019

SE-301

XXXXXX



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2/19/2019 REVIEWED & REVISED-ISSUED FOR APPROV

7/15/2019 REVISED

8/26/2019 ISSUED FOR BID

10/6/2019 REVISED-ISSUED FOR BID

11/15/2020 REVISED-ISSUED FOR BID



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PROJECT:

YR)MERSIDEUBGG SCHOOLS
565 WARBURTON AVE
YONKERS, NY 10701

CCTV

ONE LINE DIAGRAM

I.T. C.A. E.M.

ESIGNED BY DRAWN BY CHECKED BY

K ORDER NO: DATE: 11 (0.7 (0.010)

DESIGNED BY
WORK ORDER NO:

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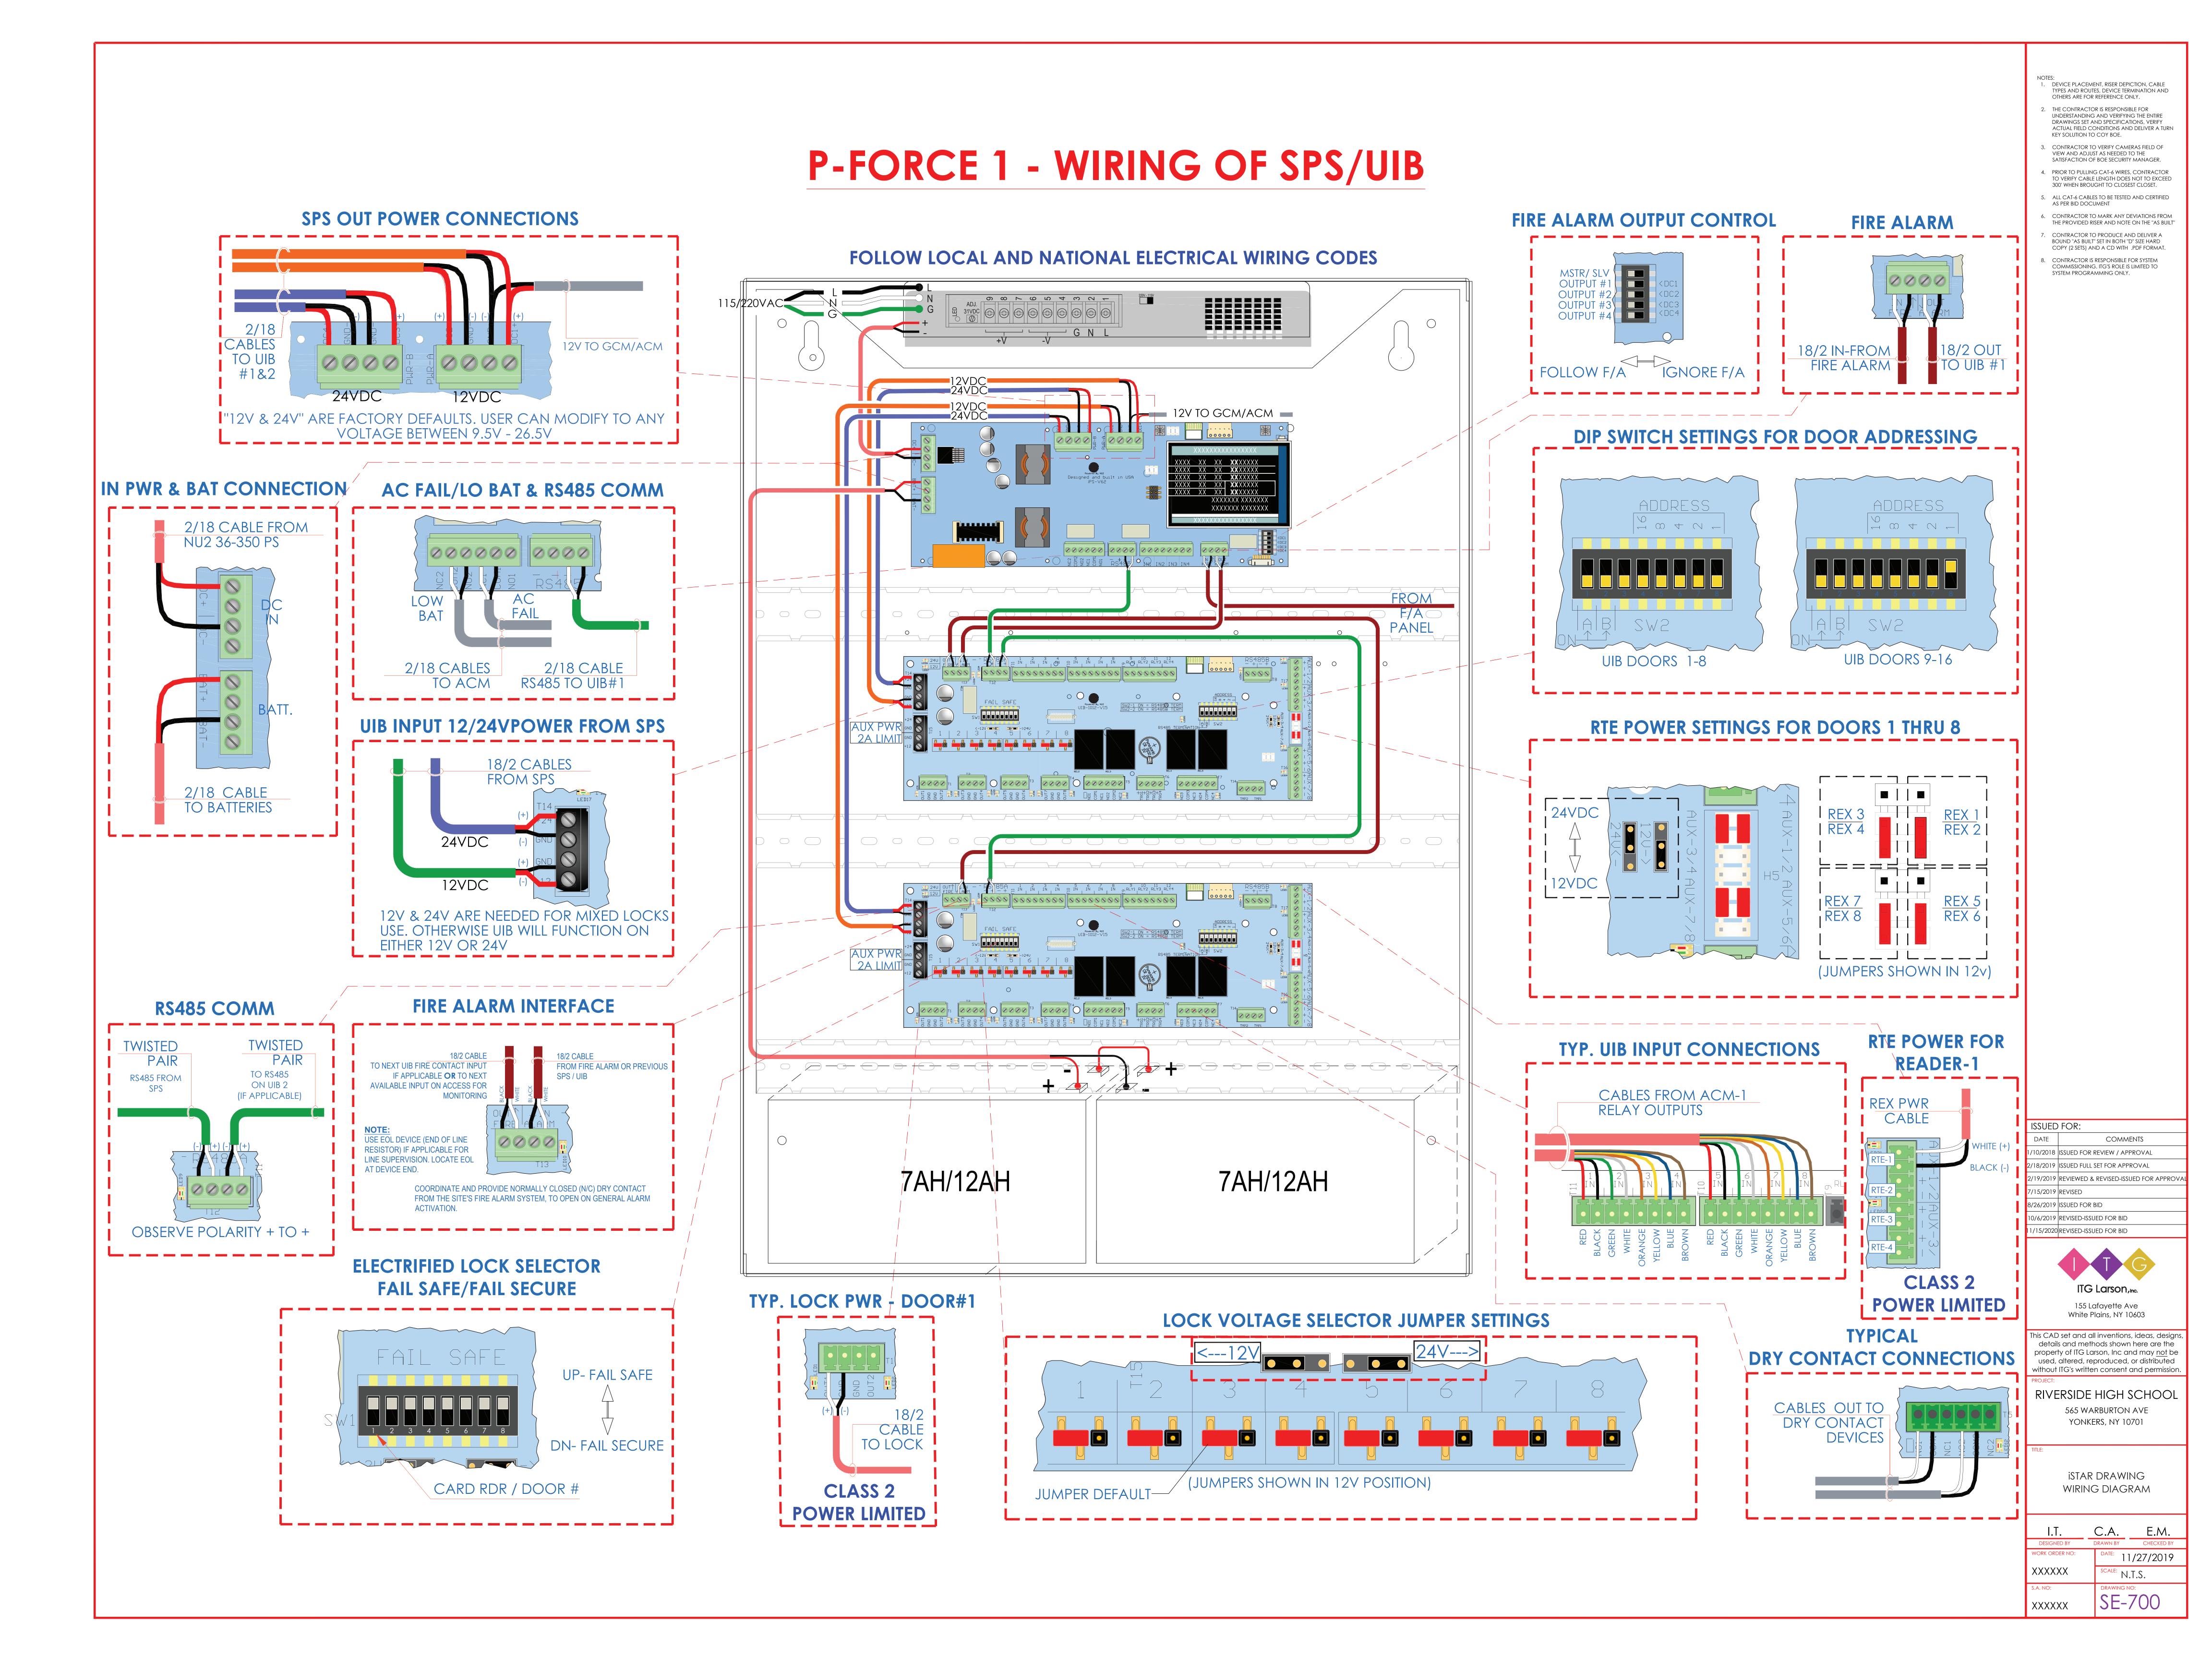
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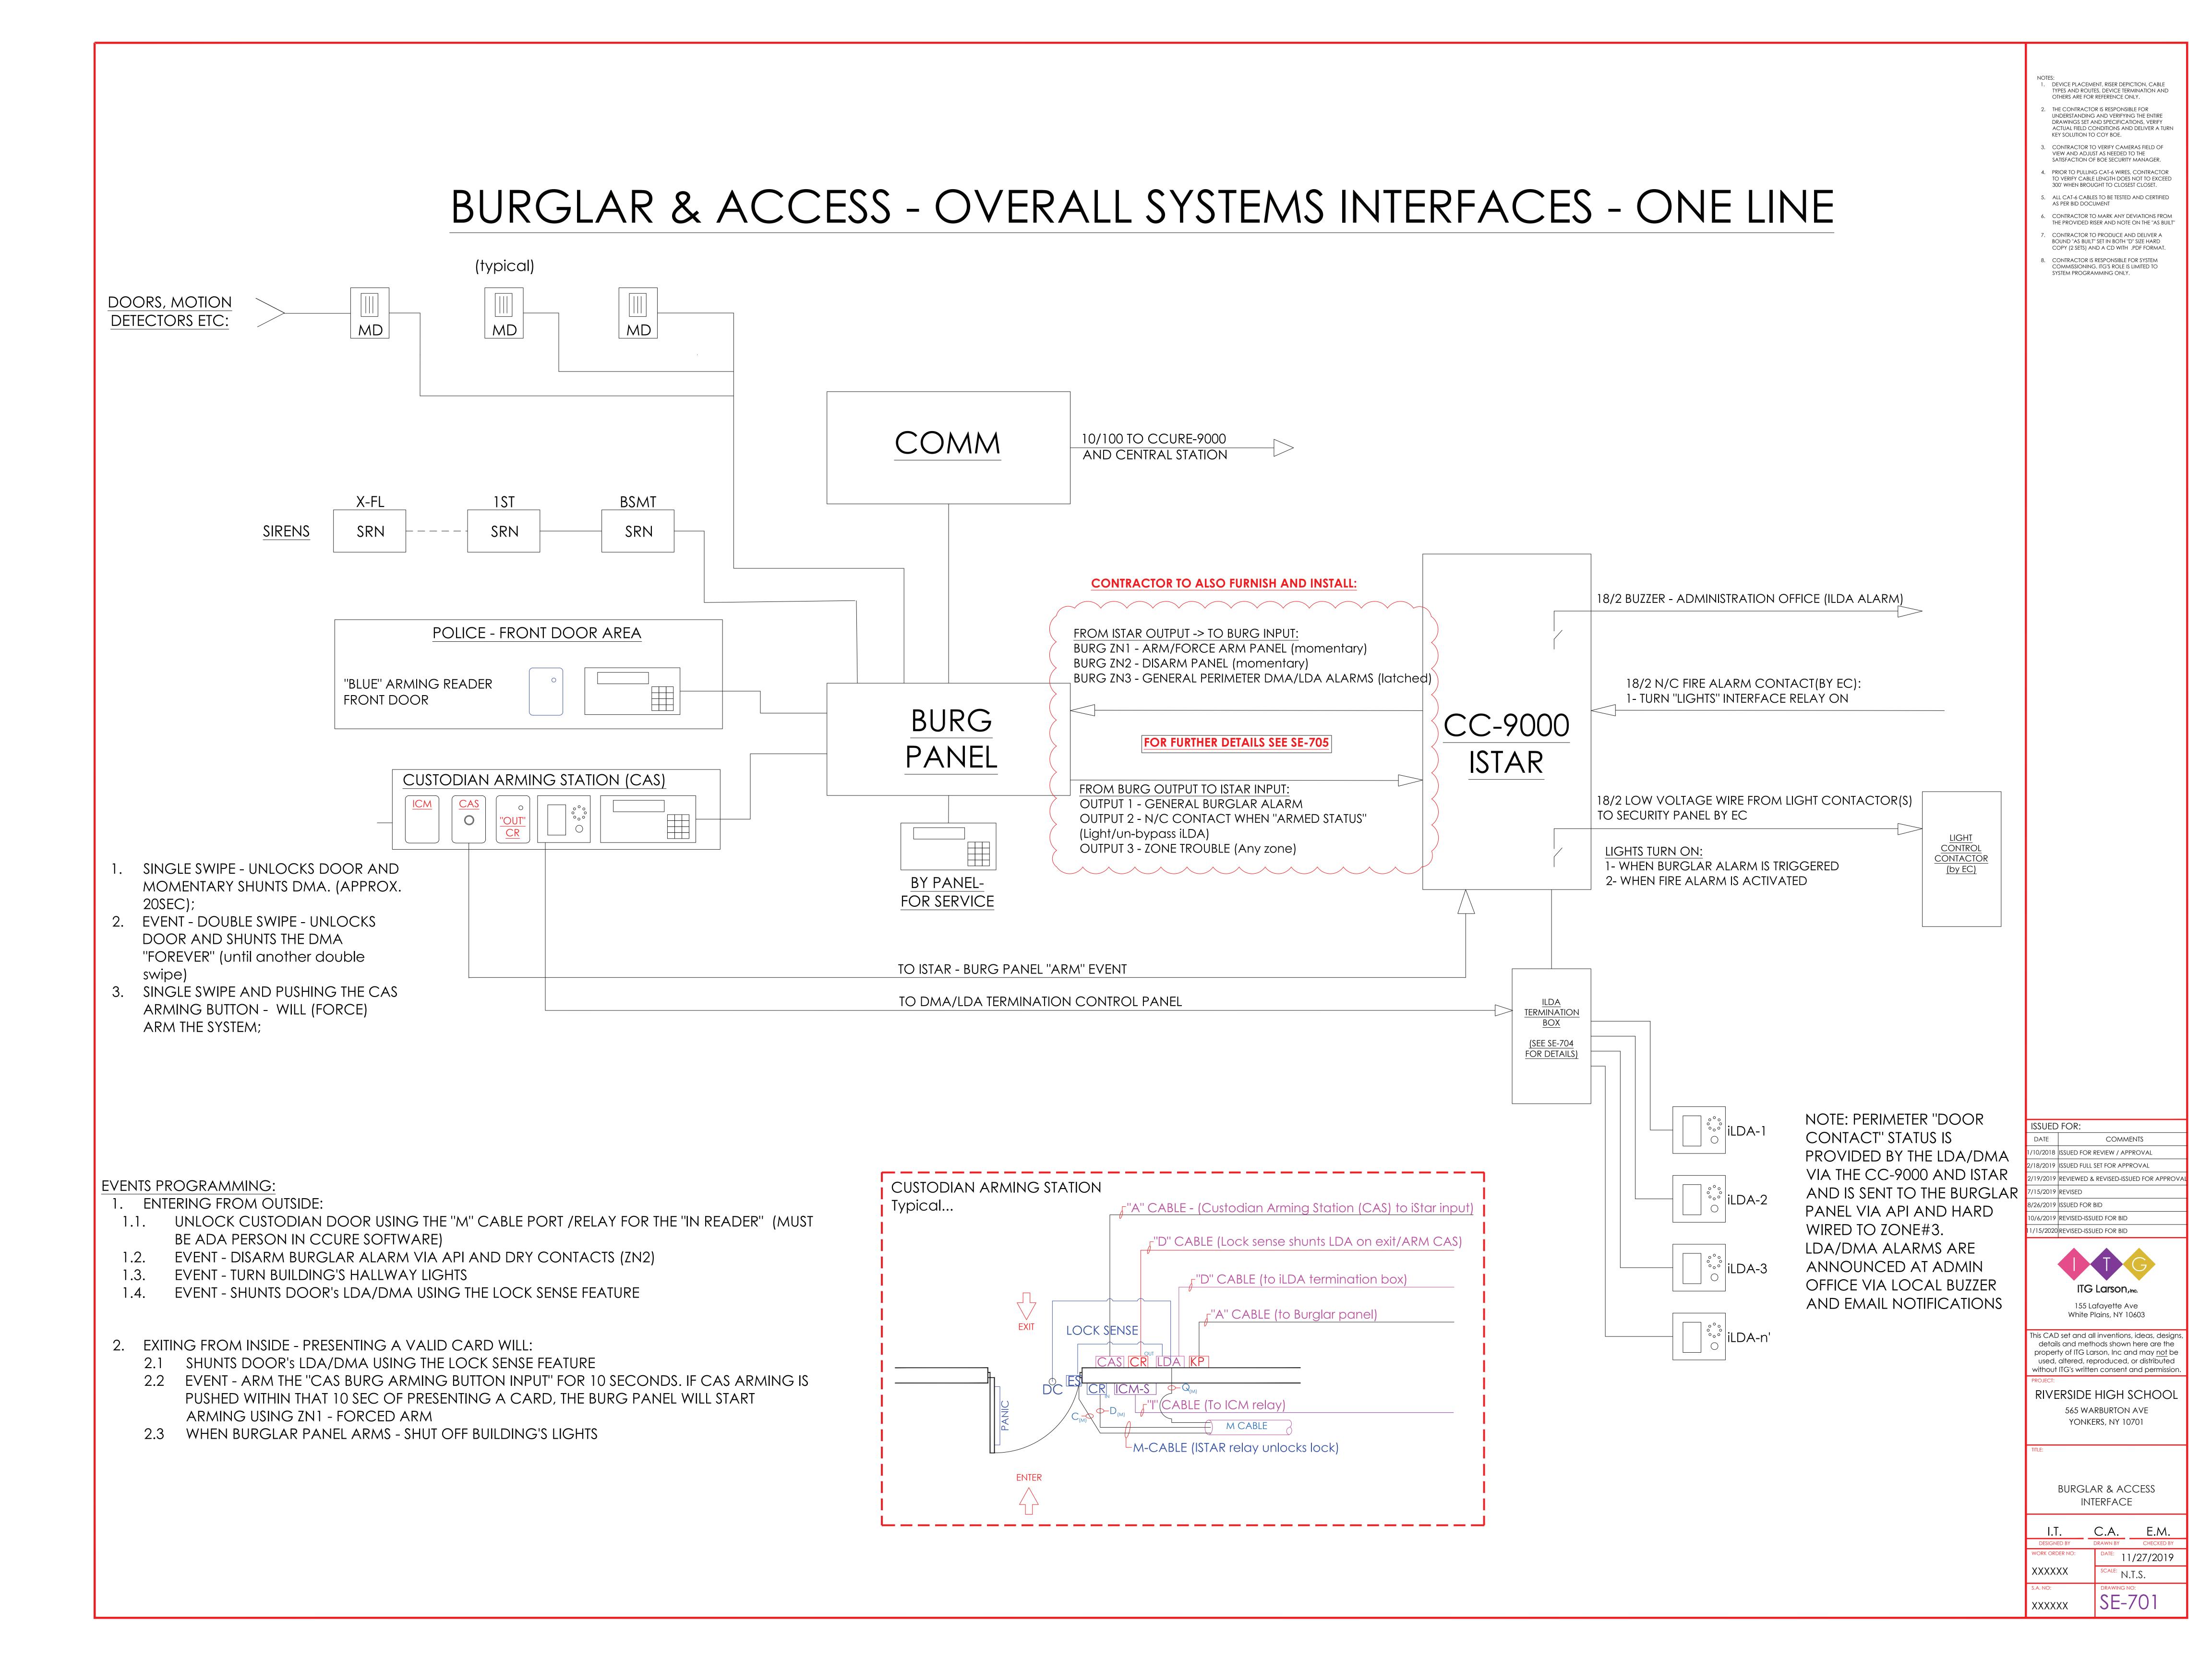
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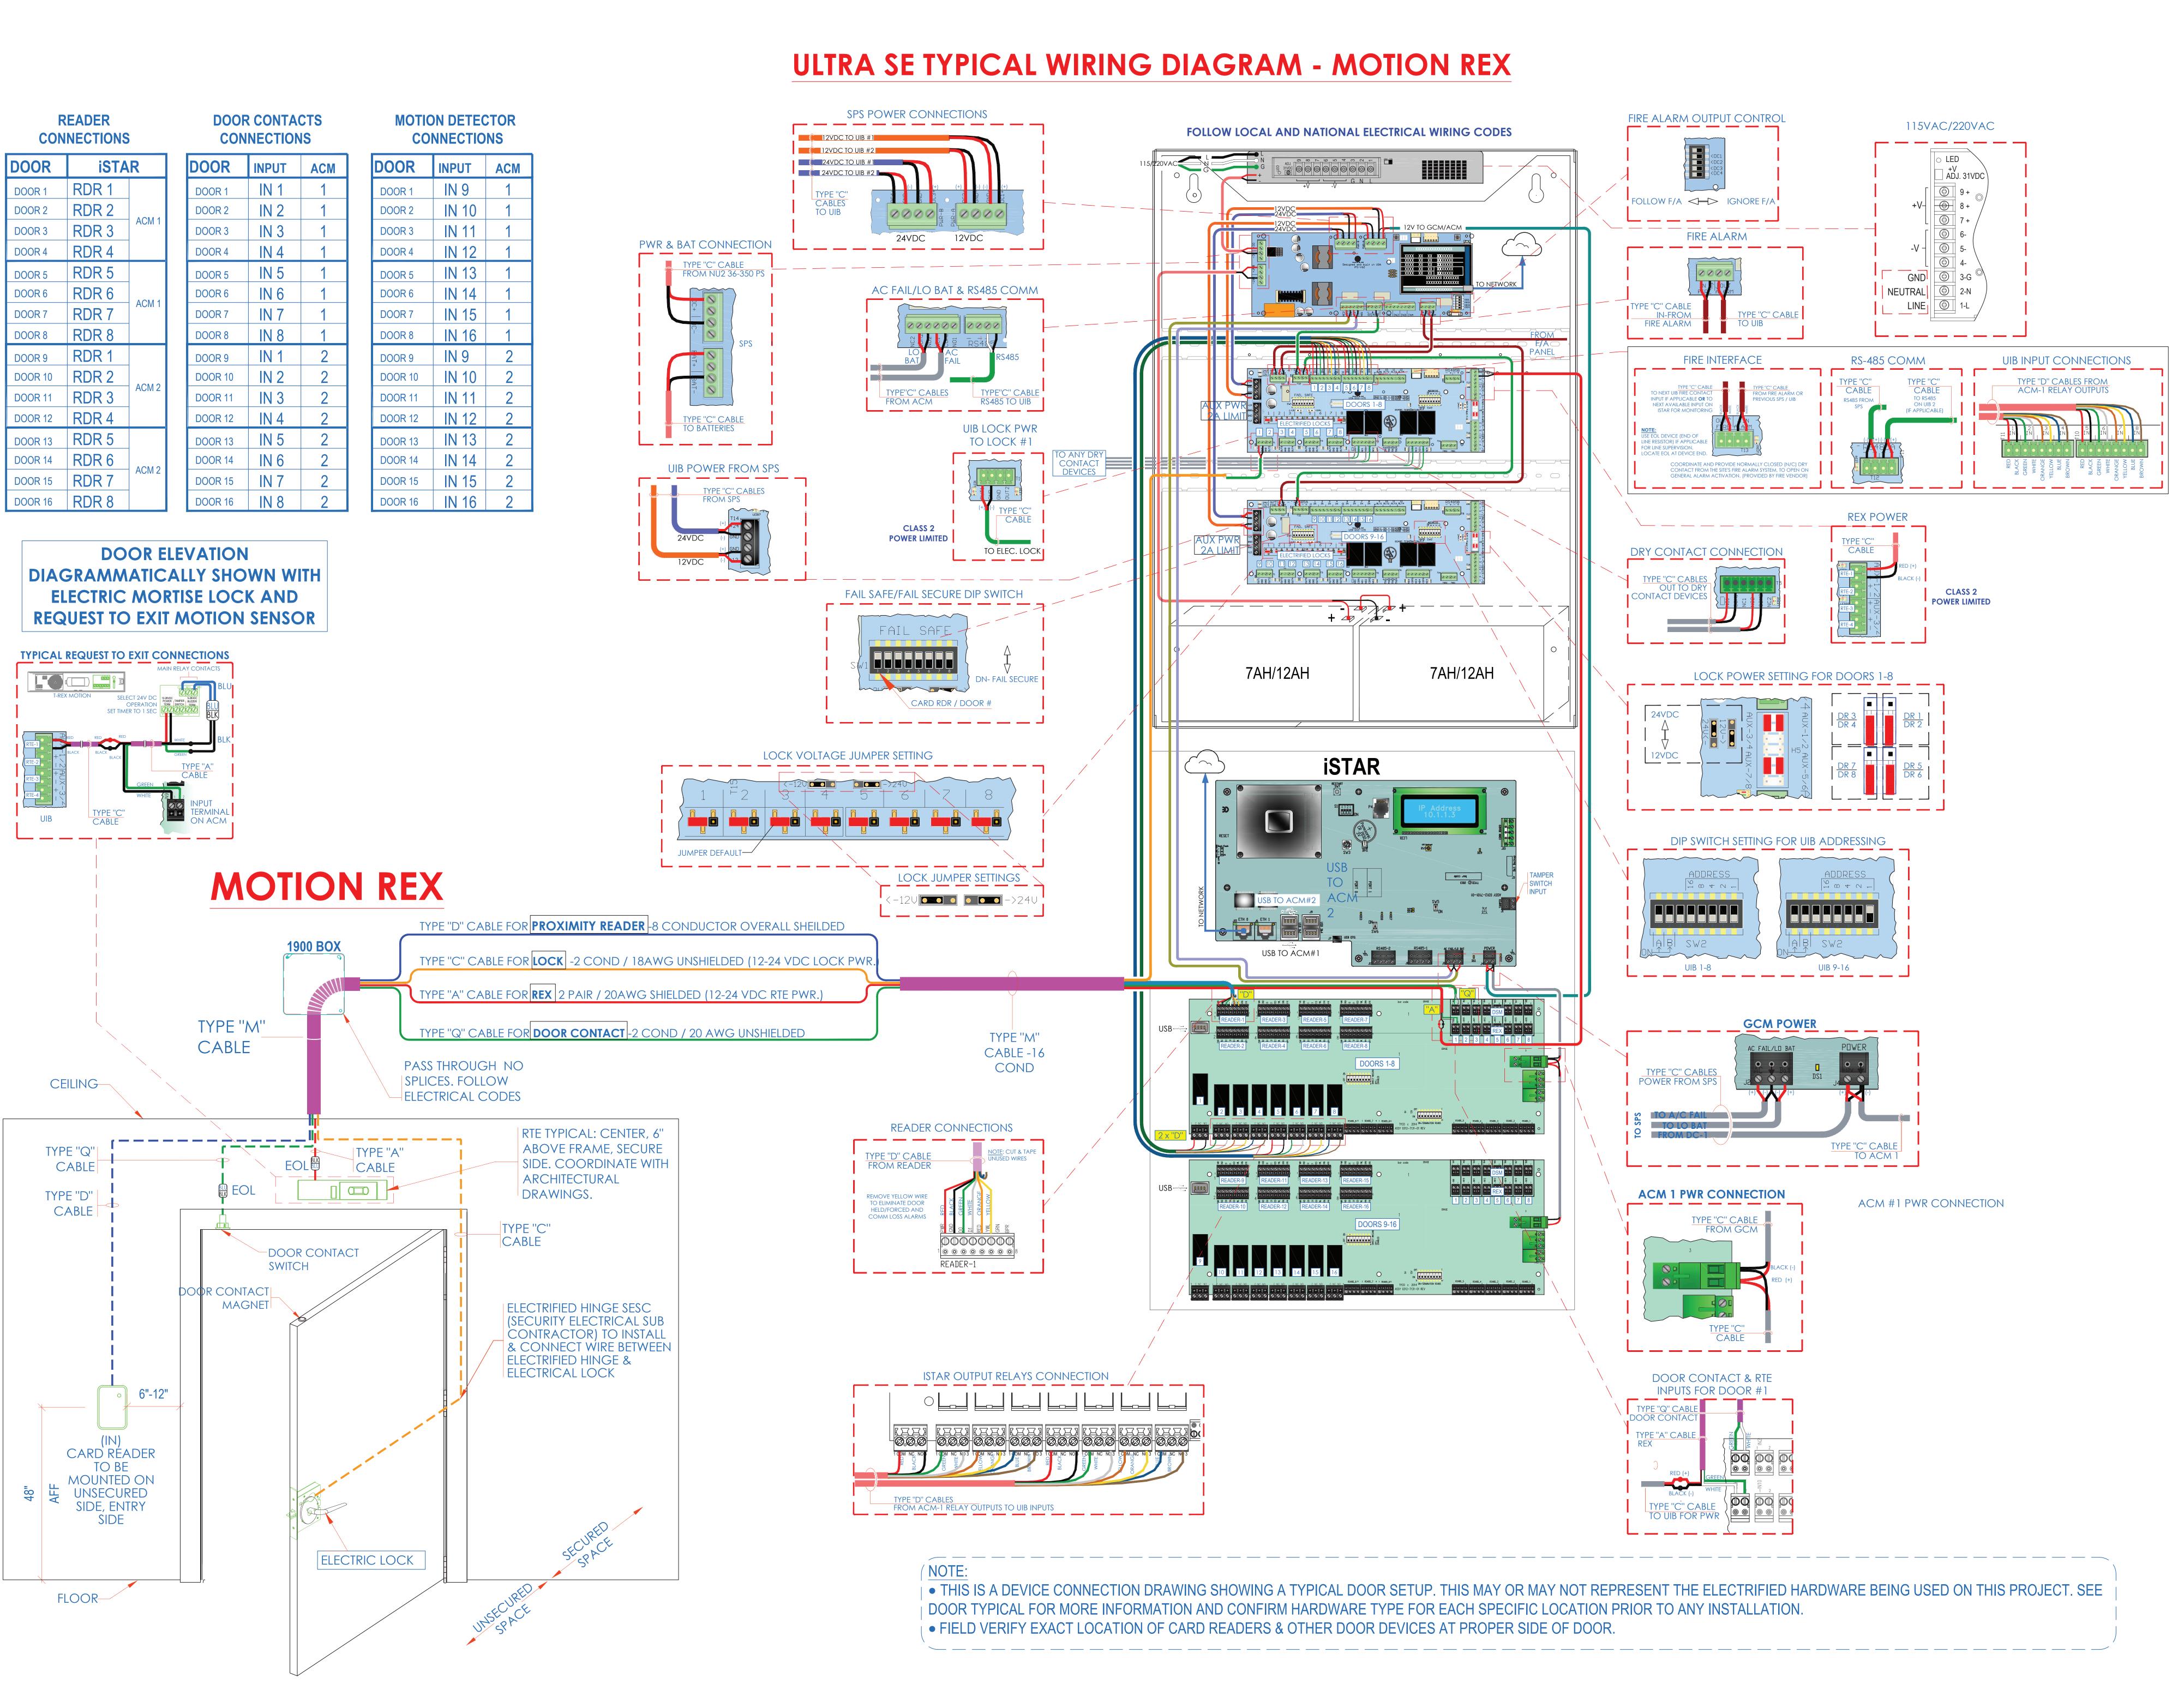
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SE-303







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SATISFACTION OF BOE SECURITY MANAGER.

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- THE PROVIDED RISER AND NOTE ON THE "AS BUILT"

  7. CONTRACTOR TO PRODUCE AND DELIVER A
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PROJECT:

RIVERSIDE HIGH SCHOOL

565 WARBURTON AVE
YONKERS, NY 10701

ULTRA SE TYPICAL WIRING DIAGRAM FOR 16 CR DOORS W/ MOTION REX

I.T. C.A. E.M.

DESIGNED BY DRAWN BY CHECKED BY

WORK ORDER NO:

XXXXXXX

SCALE: N.T.S.

DRAWING NO:

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SE-702-A

#### ULTRA SE TYPICAL WIRING DIAGRAM - REX LOCK SPS POWER CONNECTIONS **READER** DOOR CONTACTS MOTION DETECTOR FIRE ALARM OUTPUT CONTROL 115VAC/220VAC **CONNECTIONS CONNECTIONS** CONNECTIONS FOLLOW LOCAL AND NATIONAL ELECTRICAL WIRING CODES ) LED \_\_\_ ADJ. 31VDC \ **DOOR 1** DOOR 1 FOLLOW F/A 🗢 IGNORE F/A DOOR 2 DOOR 2 DOOR 3 DOOR 3 DOOR 3 PWR & BAT CONNECTION DOOR 4 DOOR 4 DOOR 4 FROM NU2 36-350 P DOOR 5 DOOR 5 DOOR 5 AC FAIL/LO BAT & RS485 COMM DOOR 6 DOOR 6 DOOR 6 DOOR 7 DOOR 7 DOOR 8 DOOR 8 DOOR 8 DOOR 9 DOOR 9 UIB INPUT CONNECTIONS FIRE INTERFACE **DOOR 10 DOOR 10** DOOR 10 **DOOR 11 DOOR 11** FROM ACM RS485 FROM DOOR 12 DOOR 12 DOOR 12 **UIB LOCK PWR** DOOR 13 | IN 5 **DOOR 13** TO LOCK #1 **DOOR 13 DOOR 14 DOOR 14** CONTACT UIB POWER FROM SPS CONTACT FROM THE SITE'S FIRE ALARM SYSTEM, TO OPEN ON **DOOR 15 DOOR 15 DOOR 15** DOOR 16 DOOR 16 **DOOR 16** REX POWER POWER LIMITED CABLE **DOOR ELEVATION** DRY CONTACT CONNECTION TO ELEC. LOCK DIAGRAMMATICALLY SHOWN WITH **ELECTRIC MORTISE LOCK AND** REQUEST TO EXIT MOTION SENSOR POWER LIMITED 7AH/12AH 7AH/12AH LOCK POWER SETTING FOR DOORS 1-8 CARD RDR / DOOR # LOCK VOLTAGE JUMPER SETTING **iSTAR** DIP SWITCH SETTING FOR UIB ADDRESSING ADDRESS REX IN LOCK TYCI © 2013 LOCK JUMPER SETTINGS 0 0 4 0 ← TYPE "D" CABLE FOR **PROXIMITY READER** -8 CONDUCTOR OVERALL SHEILDED 1900 BOX TYPE "C" CABLE FOR LOCK -2 COND / 18AWG UNSHIELDED (12-24 VDC LOCK PWR TYPE "A" CABLE FOR REX 2 PAIR / 20AWG SHIELDED (12-24 VDC RTE PWR.) **GCM POWER** TYPE "M" TYPE "Q" CABLE FOR **DOOR CONTACT** -2 COND / 20 AWG UNSHIELDED TYPE "M" CABLE CABLE -16 PASS THROUGH NO COND TYPE "C" CABLES POWER FROM SPS SPLICES. FOLLOW CEILING-ELECTRICAL CODES READER CONNECTIONS ·--<u>----</u>::======: TYPE "C" CABLE TO ACM 1 TYPE "Q" TYPE "D" CABLE FROM READER CABLE CABLE TYPE "C" TYPE "D" **ACM 1 PWR CONNECTION** CABLE ACM #1 PWR CONNECTION CABLE HELD/FORCED AND -DOOR CONTACT DOOR CONTACT MAGNET **ELECTRIFIED HINGE SESC** (SECURITY ELECTRICAL SUB CONTRACTOR) TO INSTALL & CONNECT WIRE BETWEEN ELECTRIFIED HINGE & ELECTRICAL LOCK TYPE "A" ISTAR OUTPUT RELAYS CONNECTION DOOR CONTACT & RTE CABLE FOR INPUTS FOR DOOR #1 BUILT IN REX TYPE "A" CABLE CARD RÉADER TO BE without ITG's written consent and permission MOUNTED ON ₩ UNSECURED TYPE "D" CABLES FROM ACM-1 RELAY OUTPUTS TO UIB INPUTS SIDE, ENTRY SIDE ELECTRIC LOCK w/ BUILT IN REX • THIS IS A DEVICE CONNECTION DRAWING SHOWING A TYPICAL DOOR SETUP. THIS MAY OR MAY NOT REPRESENT THE ELECTRIFIED HARDWARE BEING USED ON THIS PROJECT. SEE FLOOR— DOOR TYPICAL FOR MORE INFORMATION AND CONFIRM HARDWARE TYPE FOR EACH SPECIFIC LOCATION PRIOR TO ANY INSTALLATION. • FIELD VERIFY EXACT LOCATION OF CARD READERS & OTHER DOOR DEVICES AT PROPER SIDE OF DOOR.

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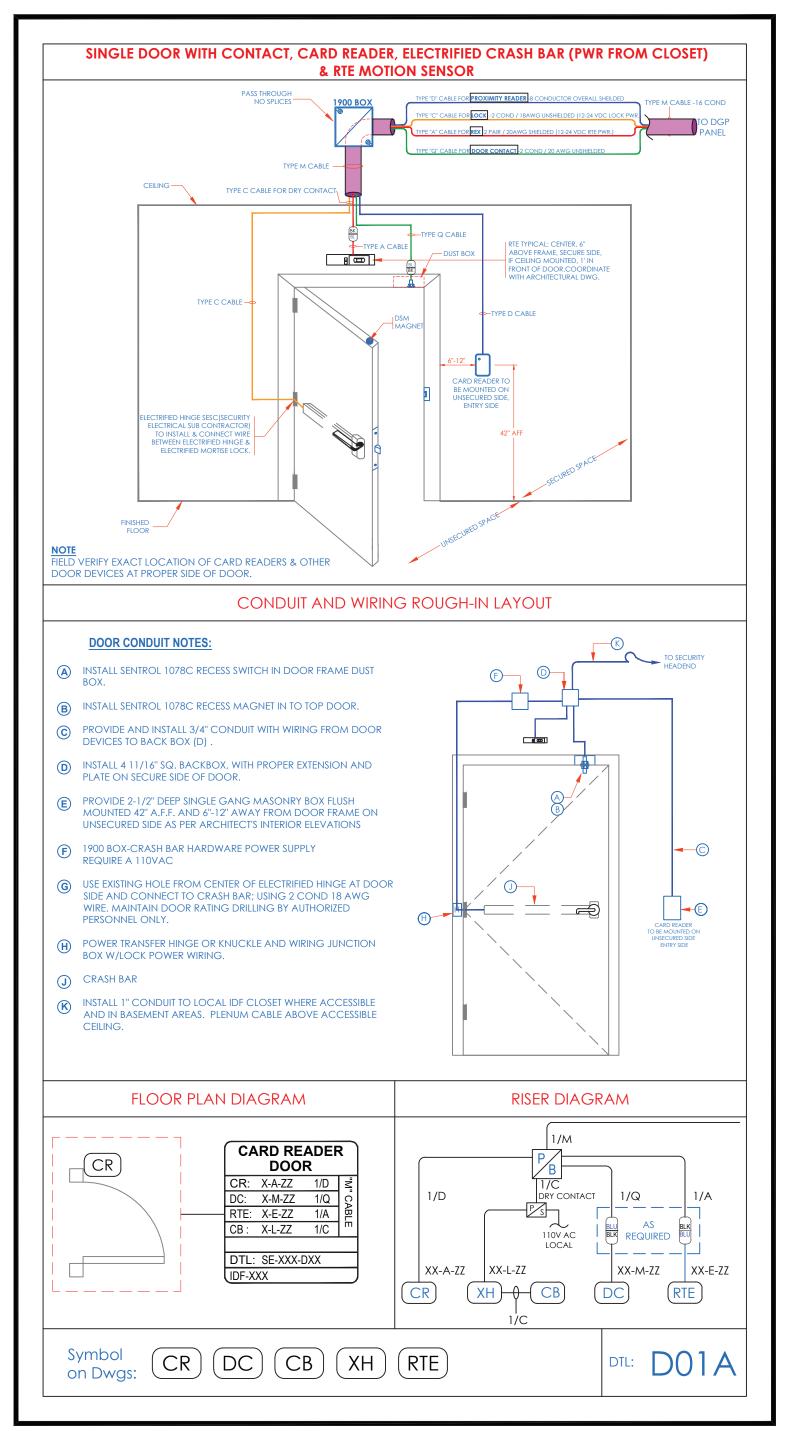
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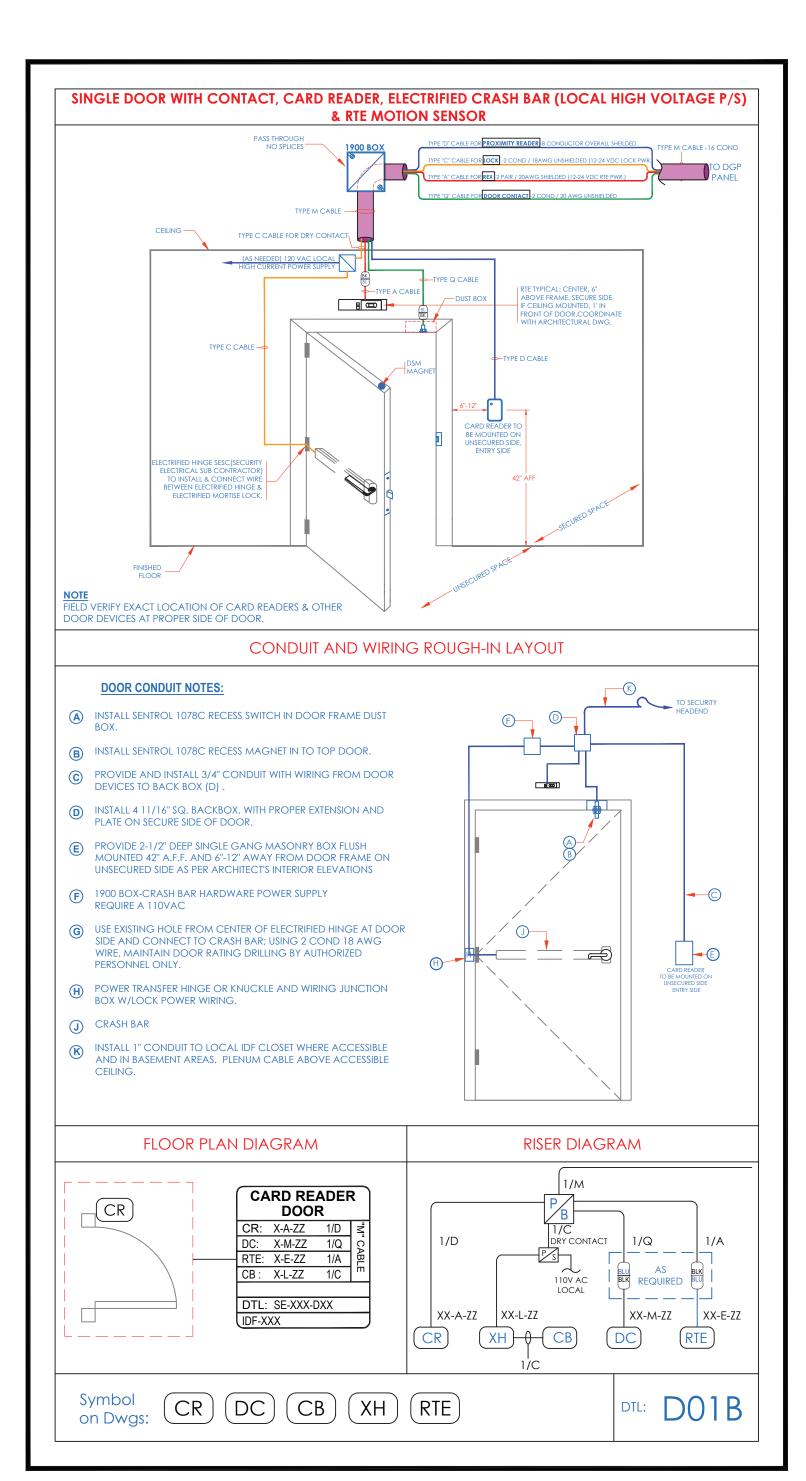
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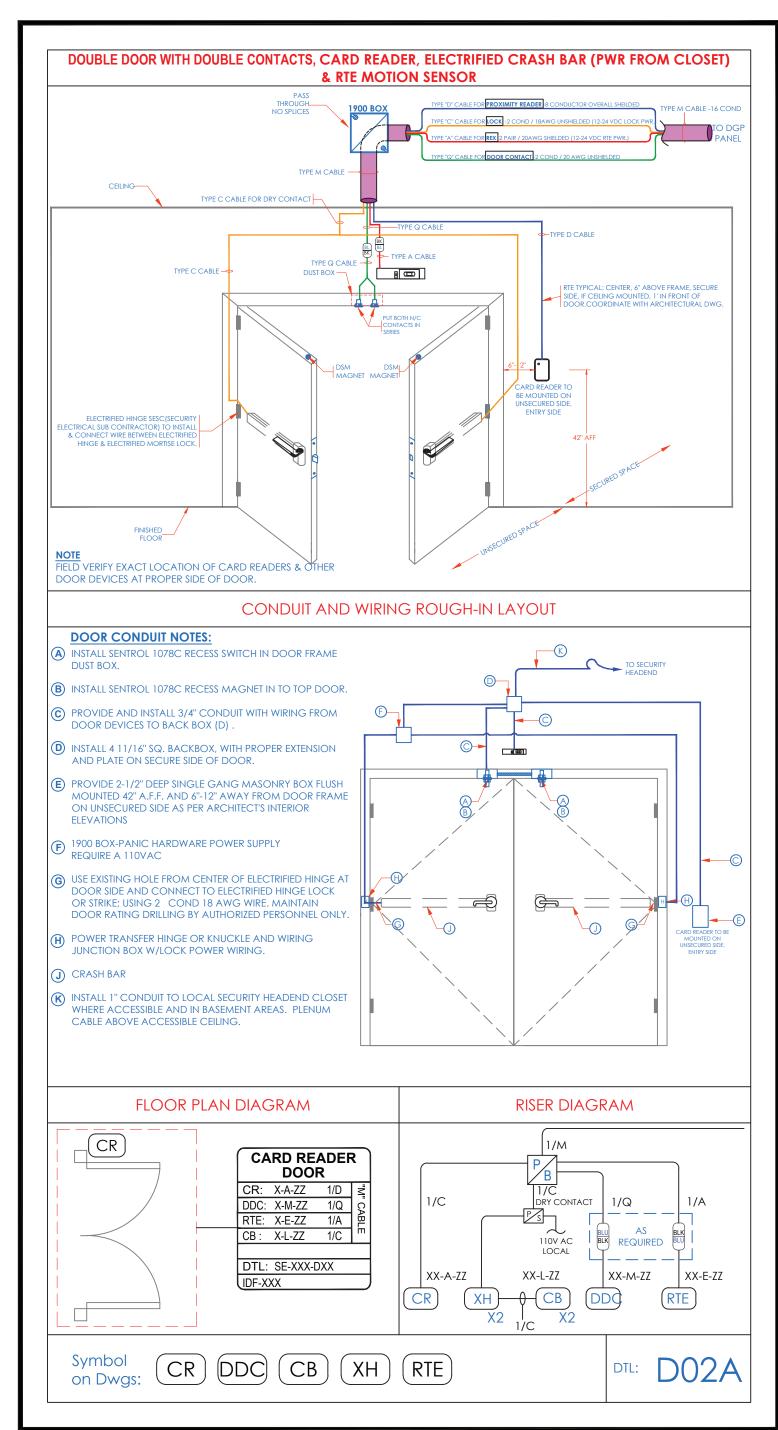
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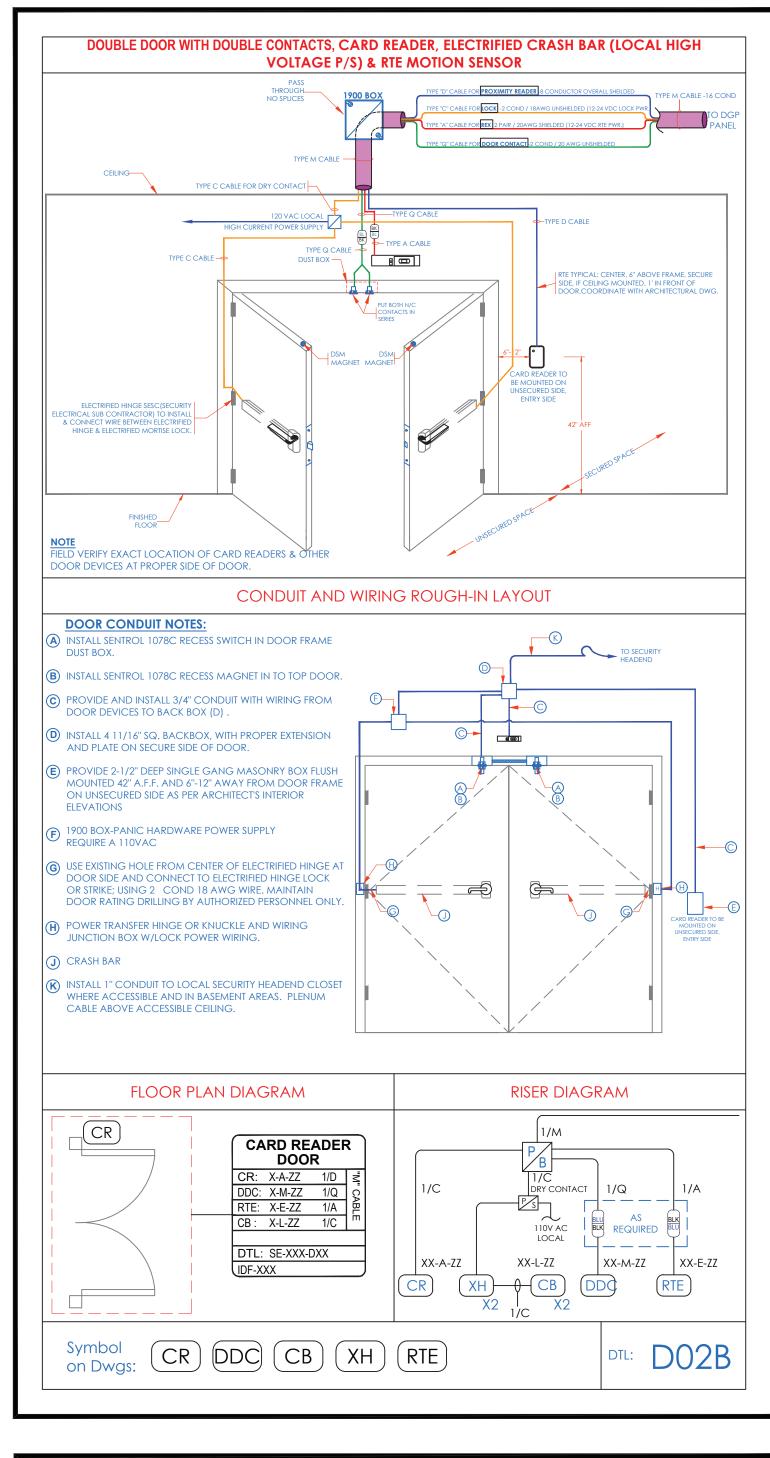
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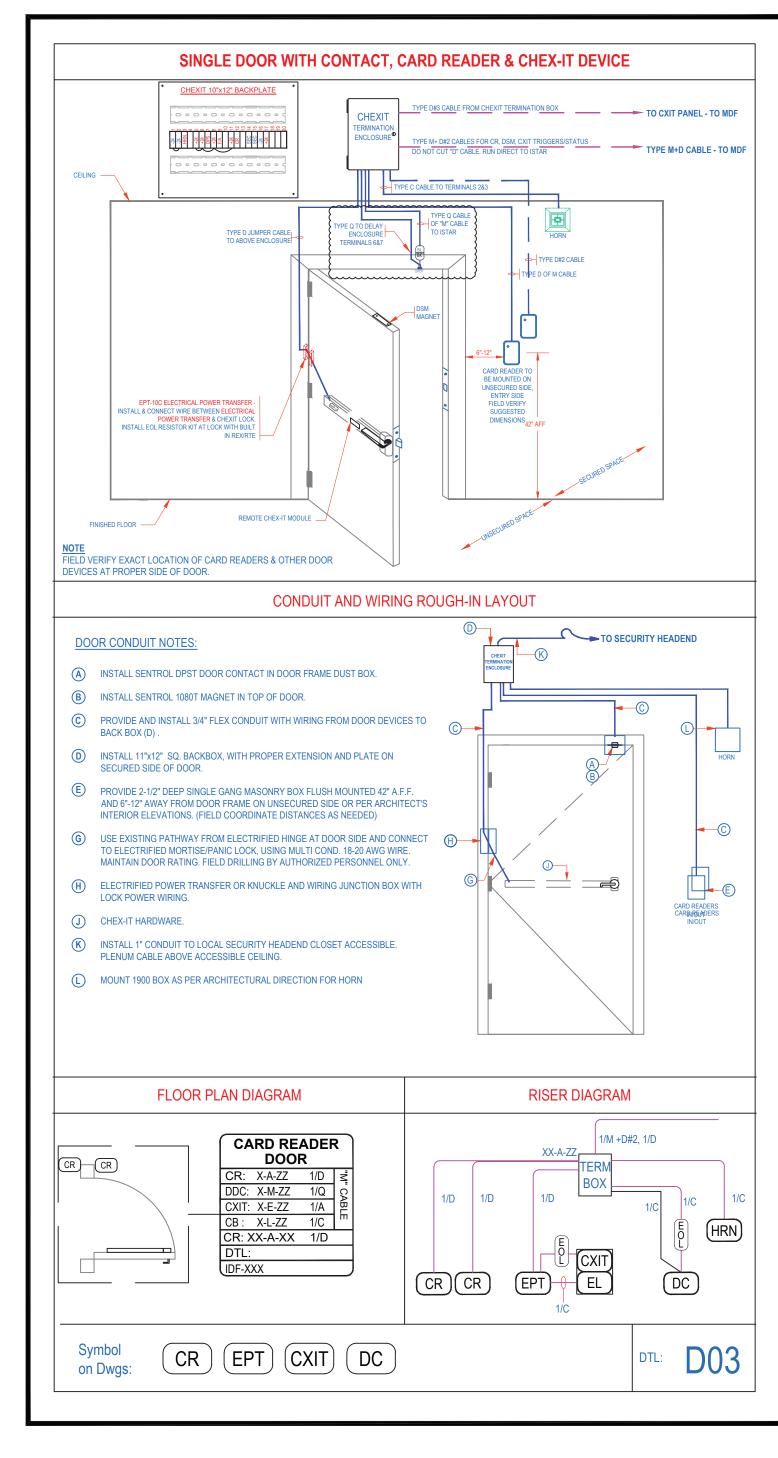
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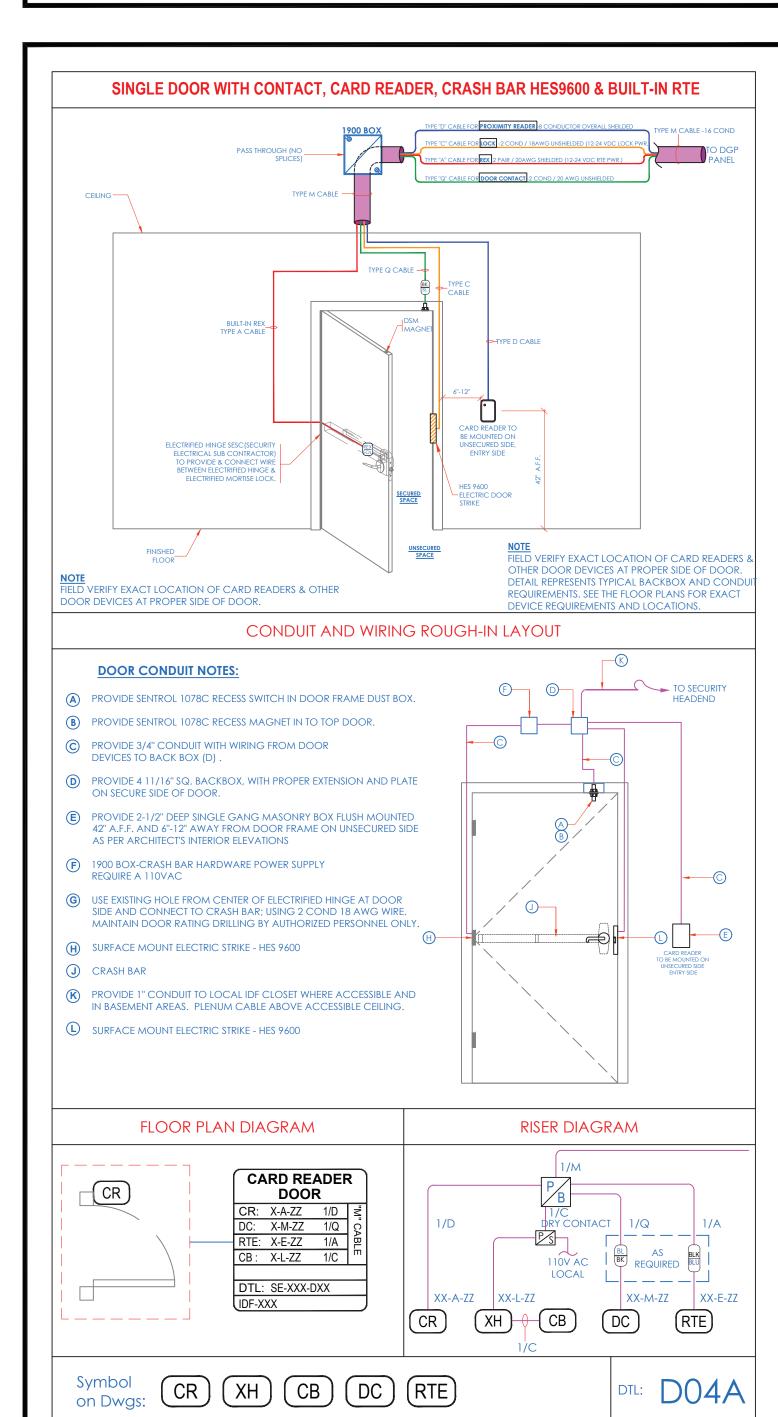

















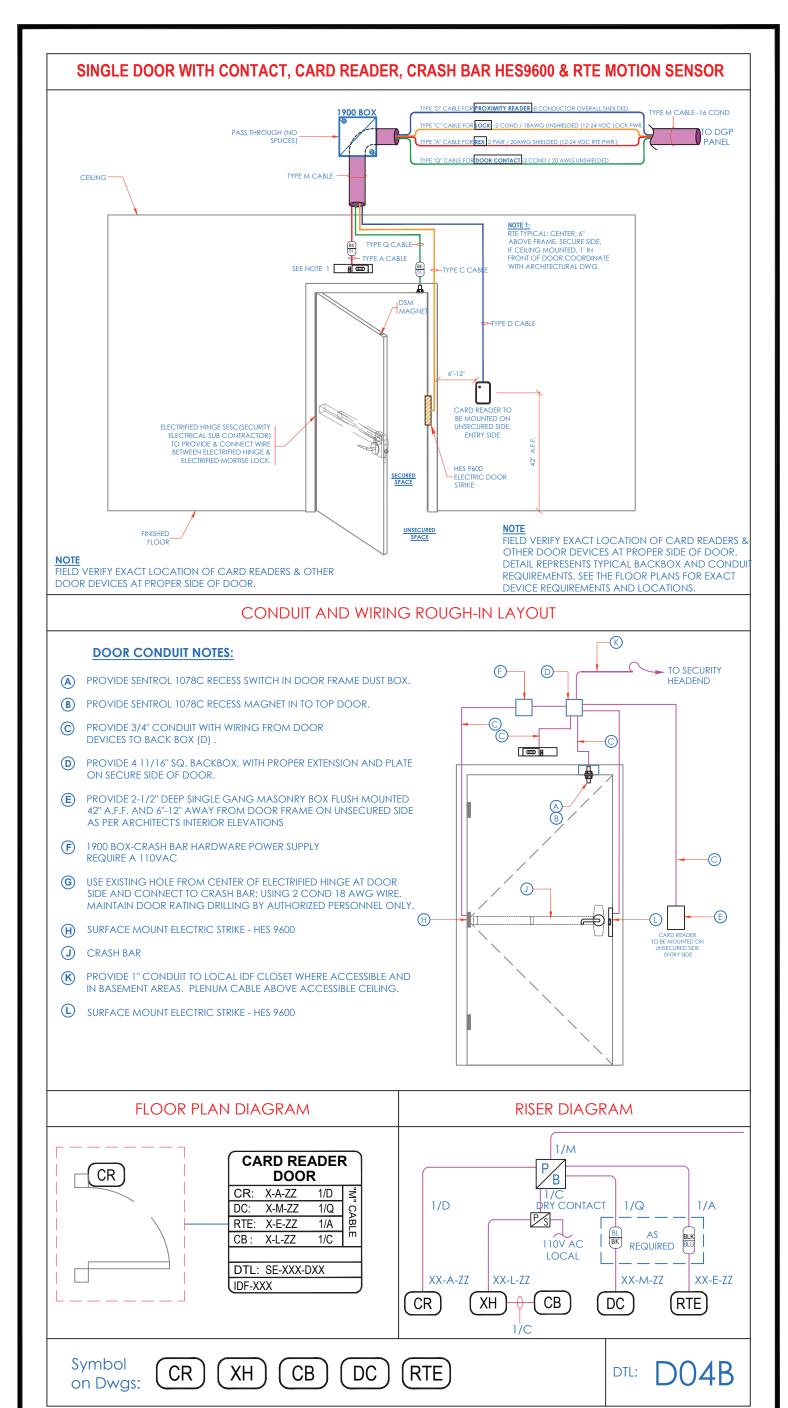

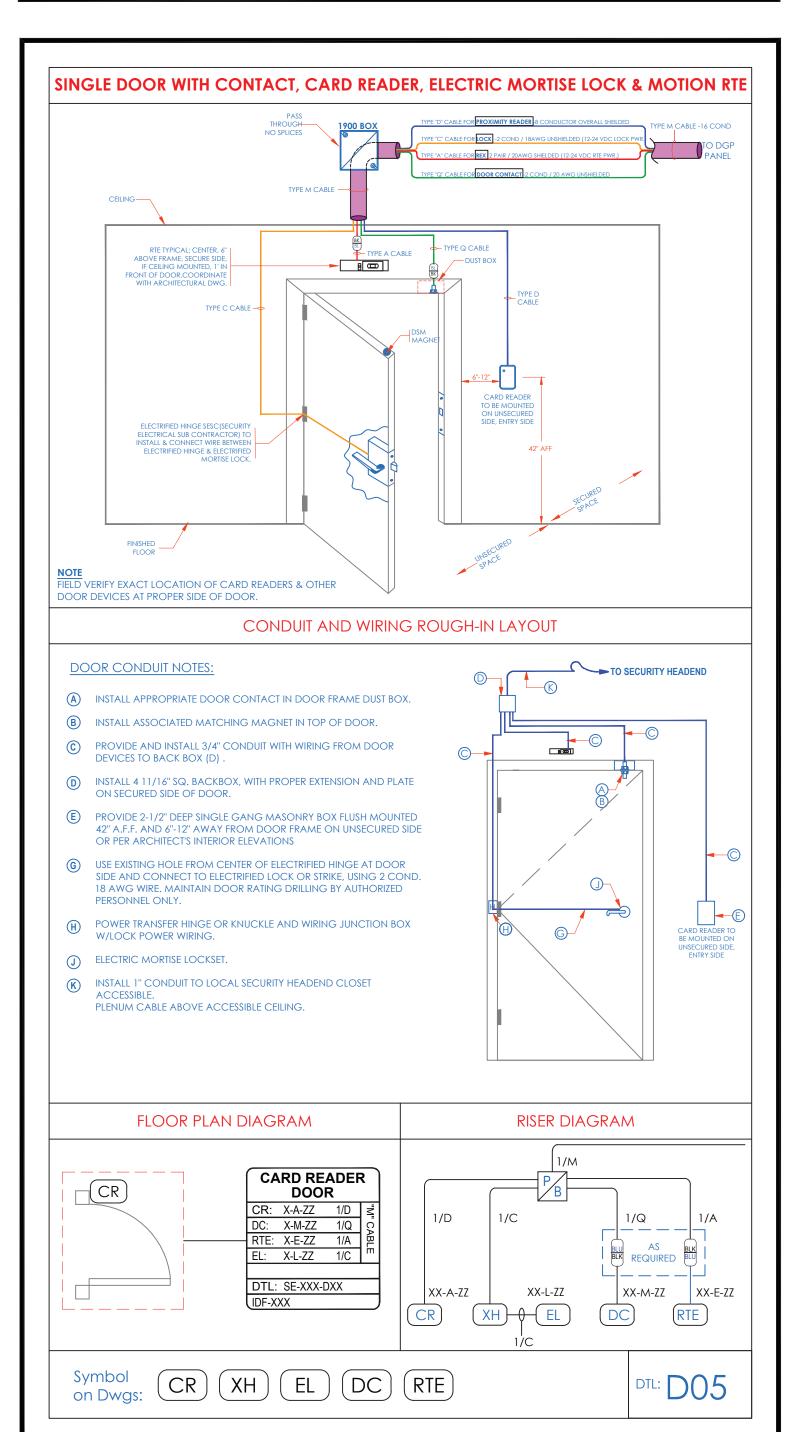

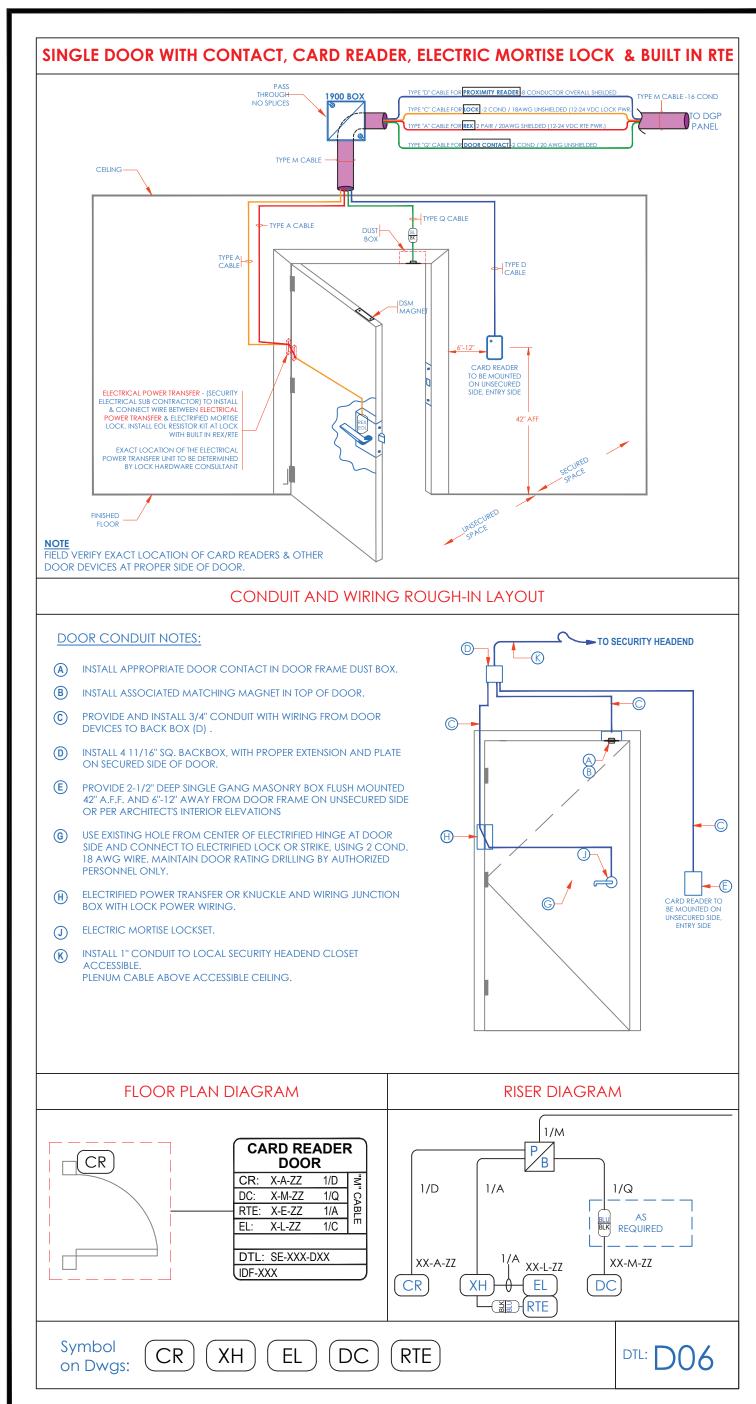

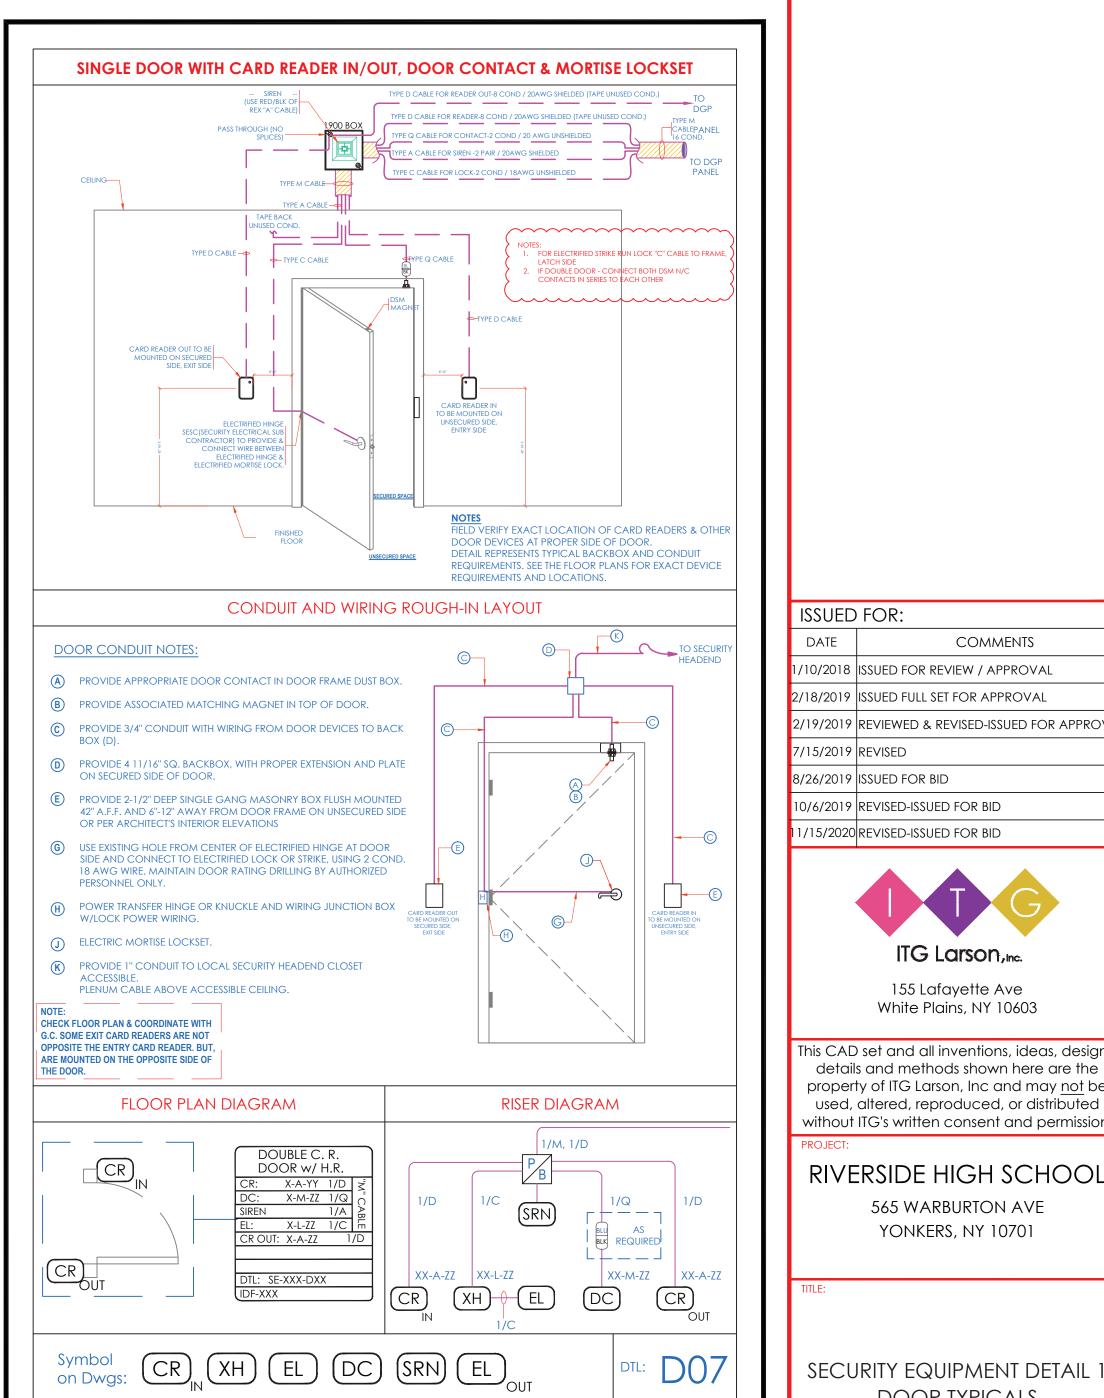

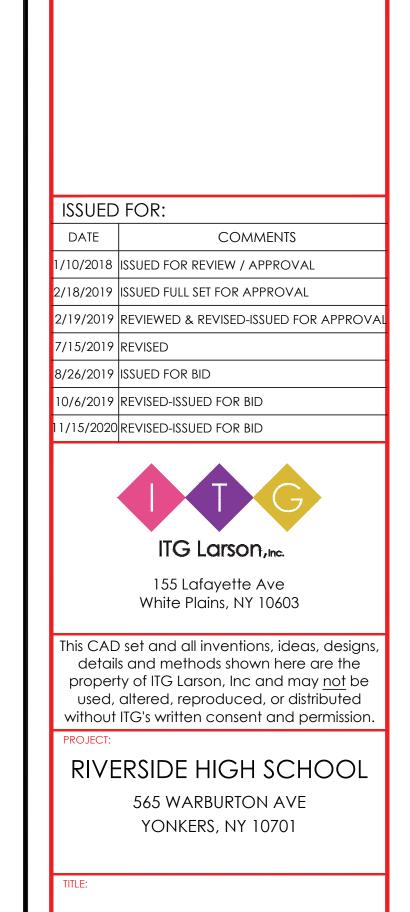

DOOR TYPICALS

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11/27/2019

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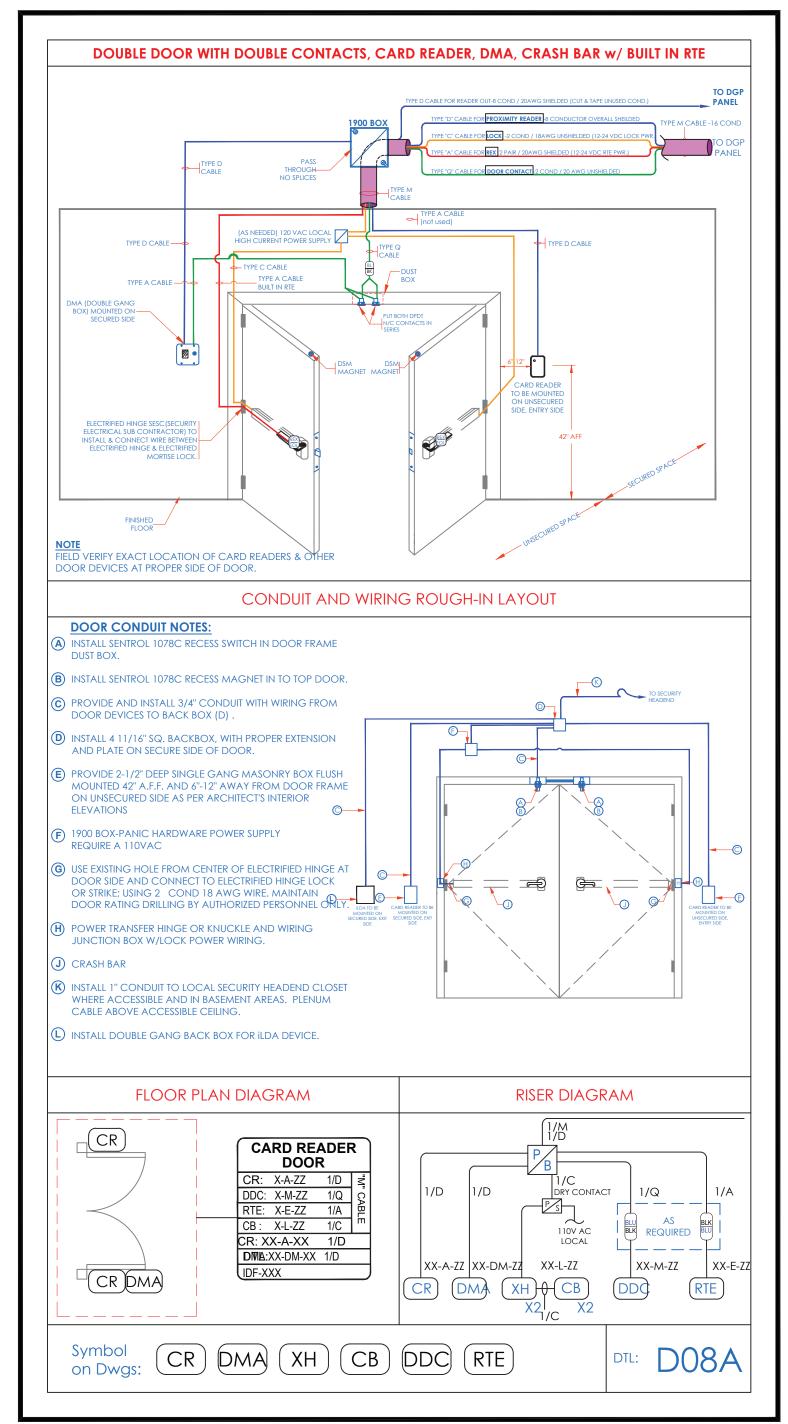
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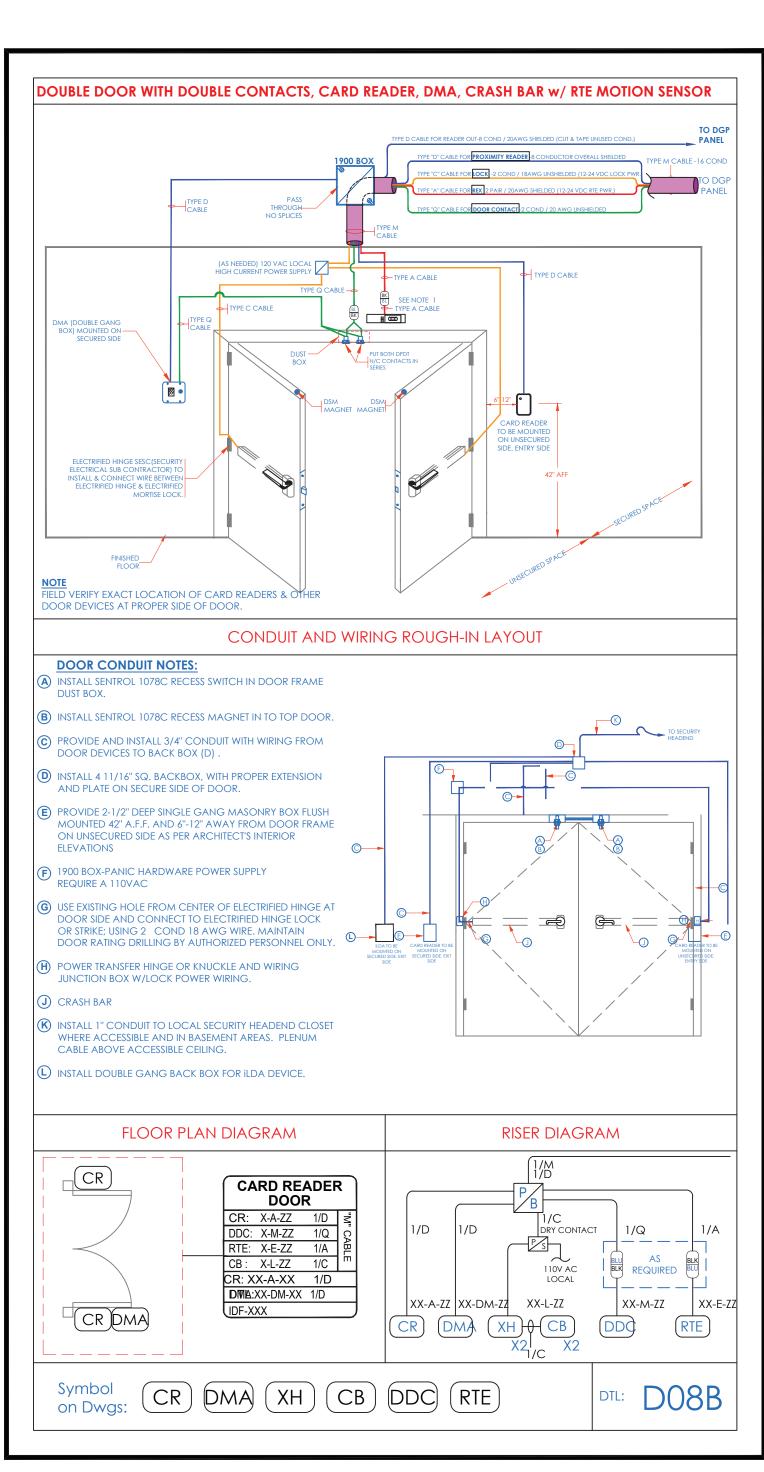
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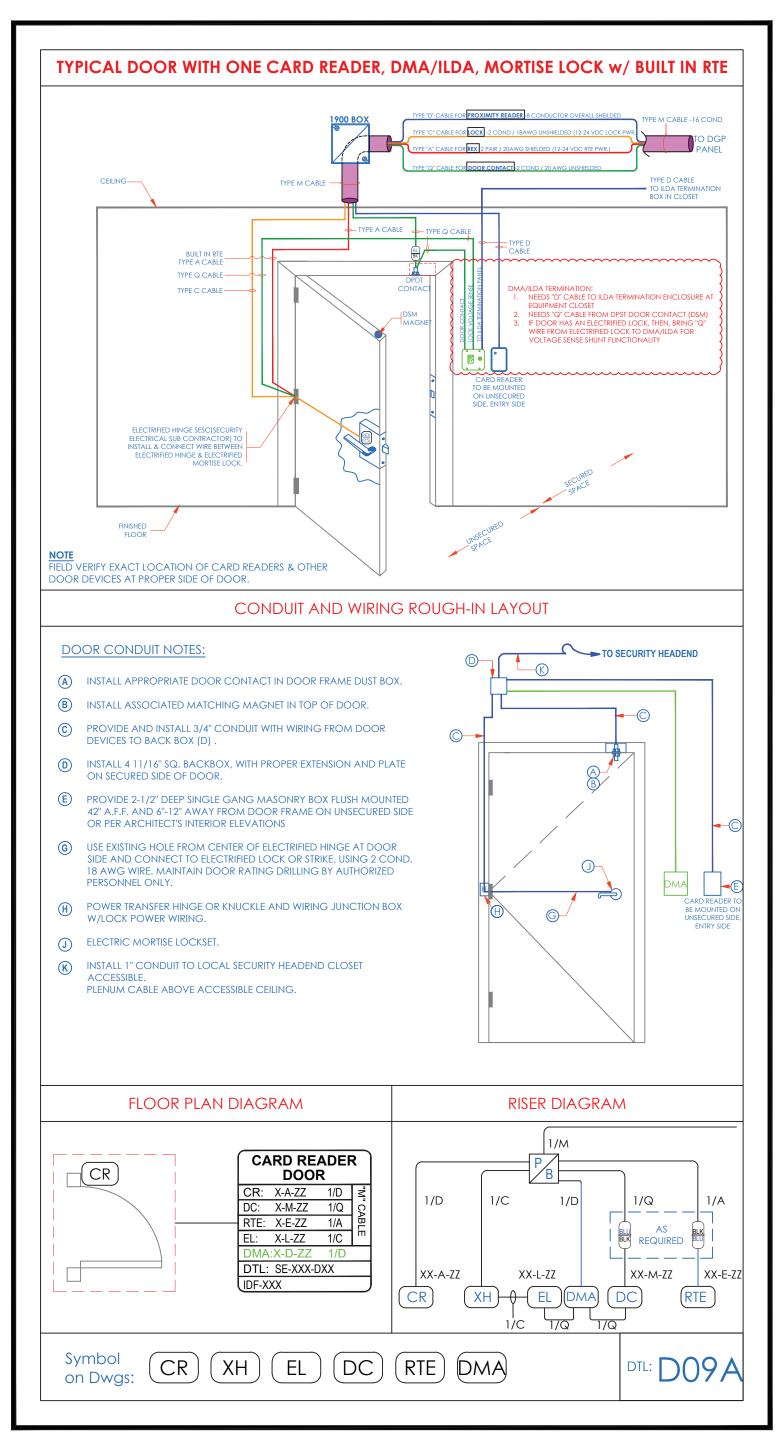
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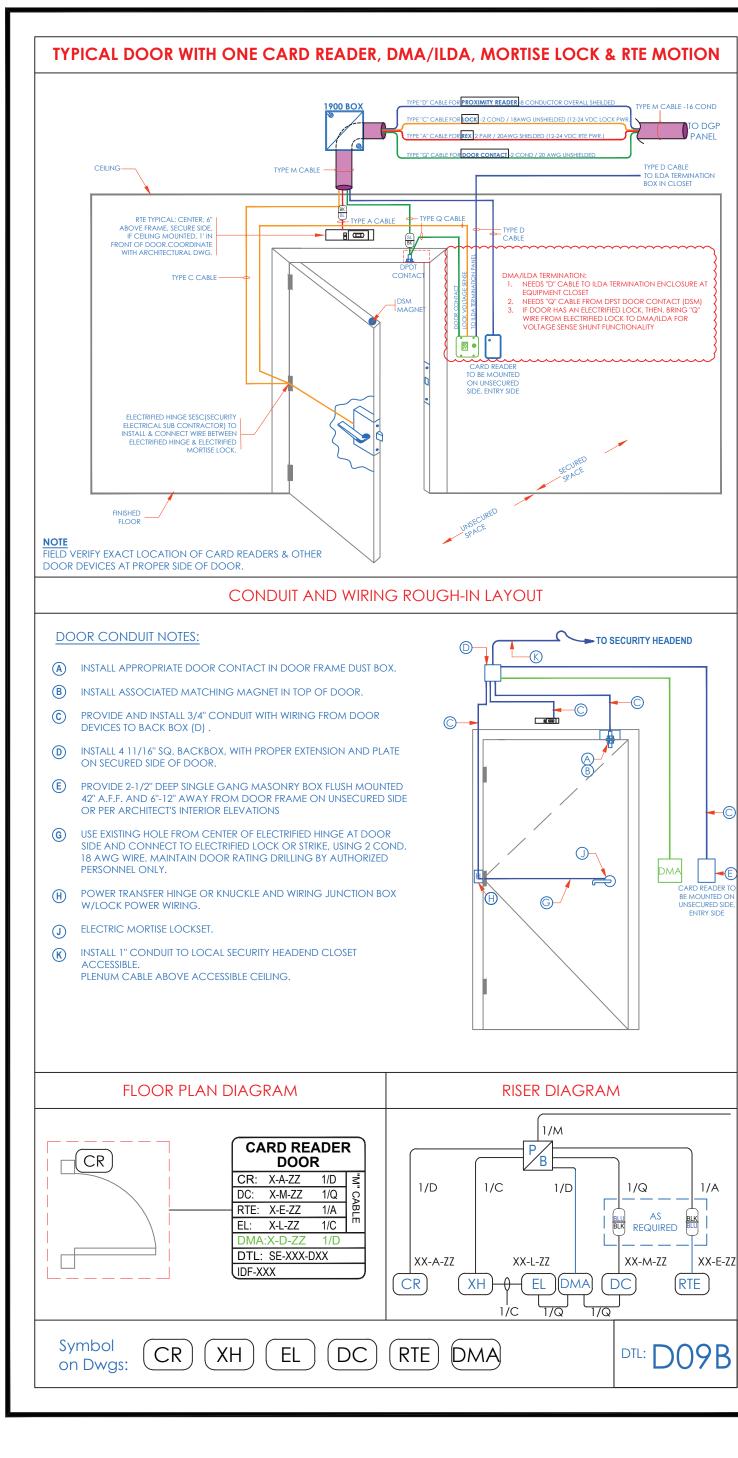
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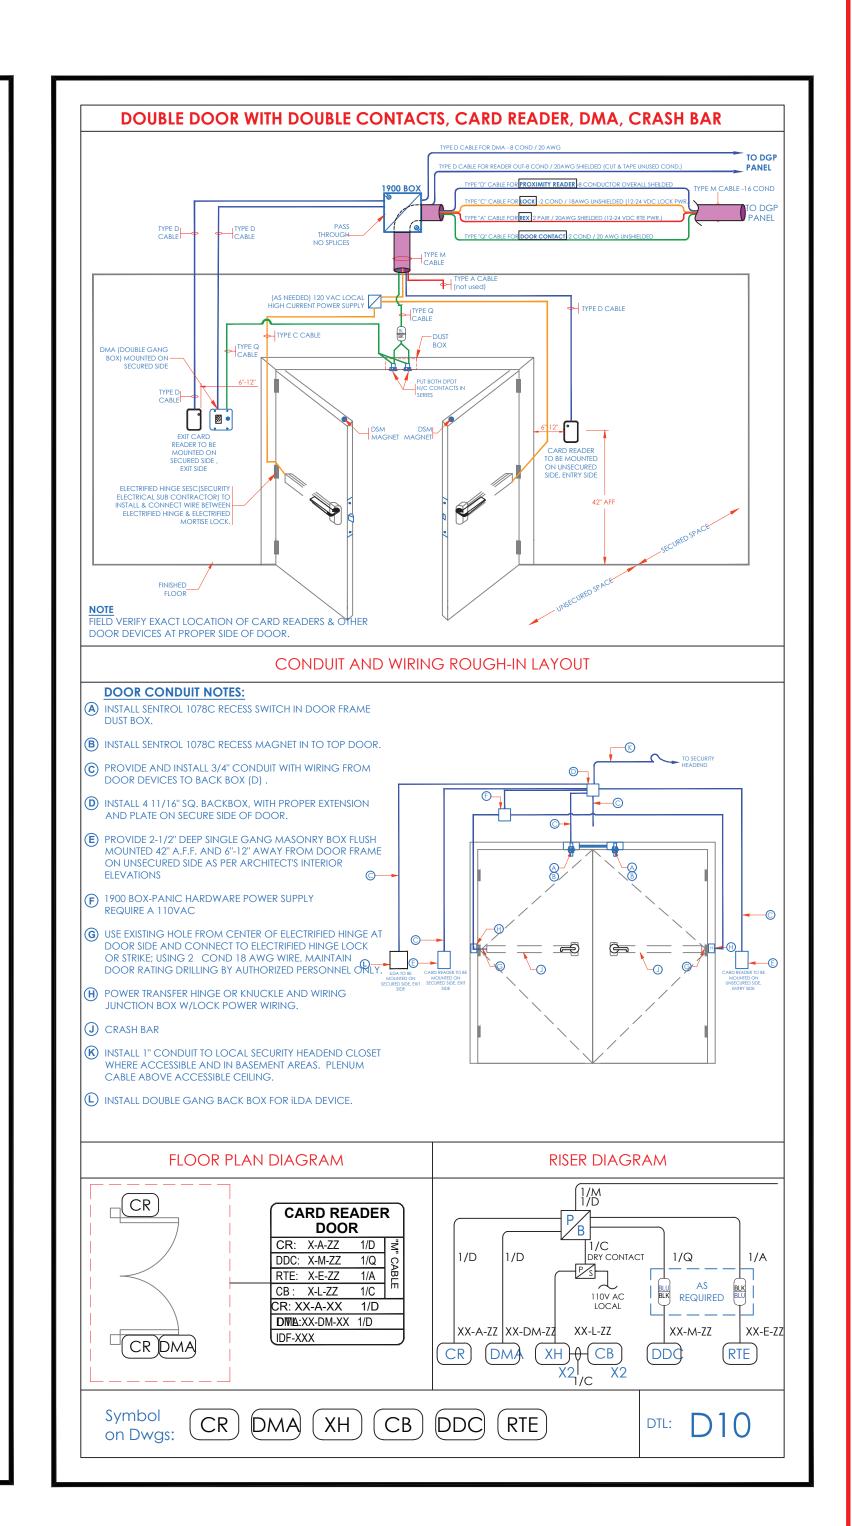
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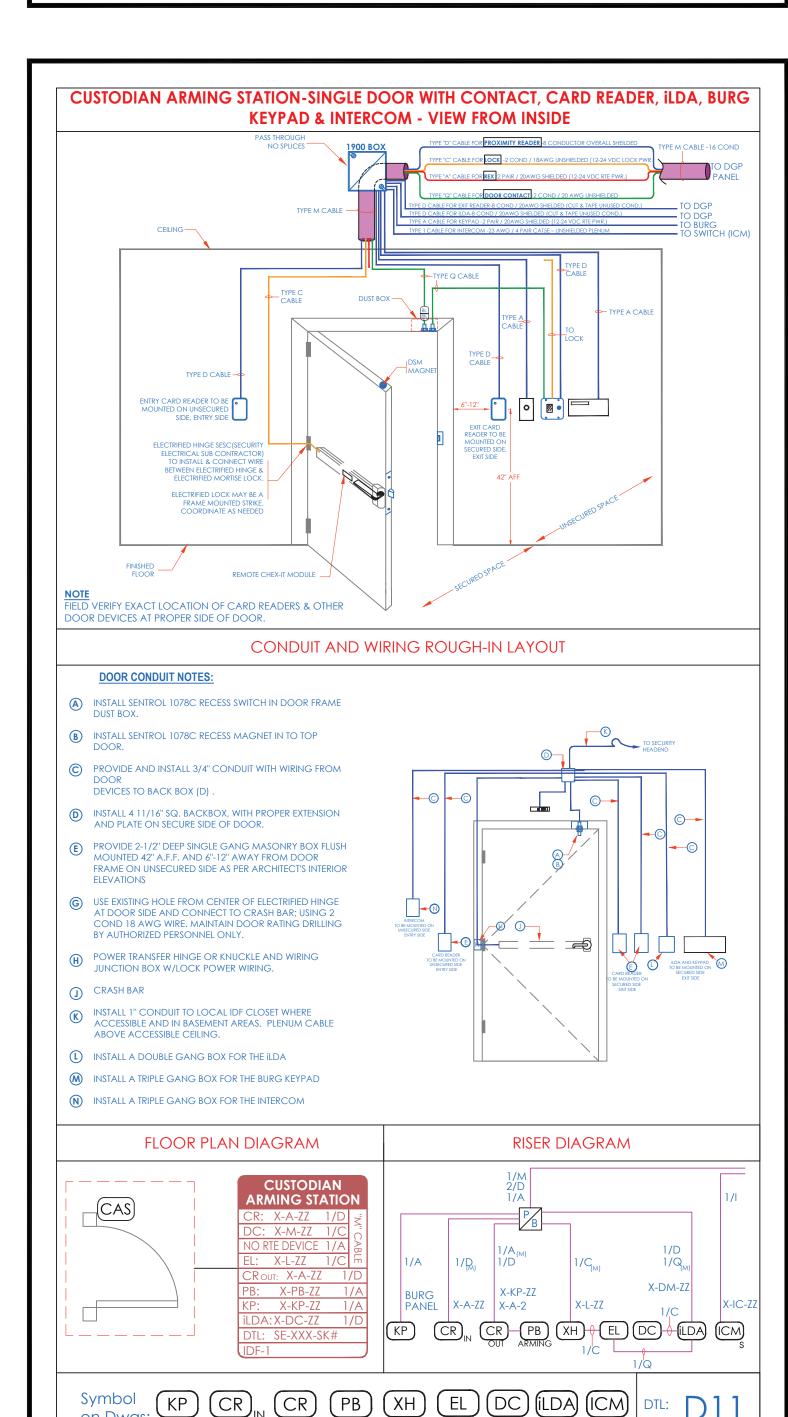
















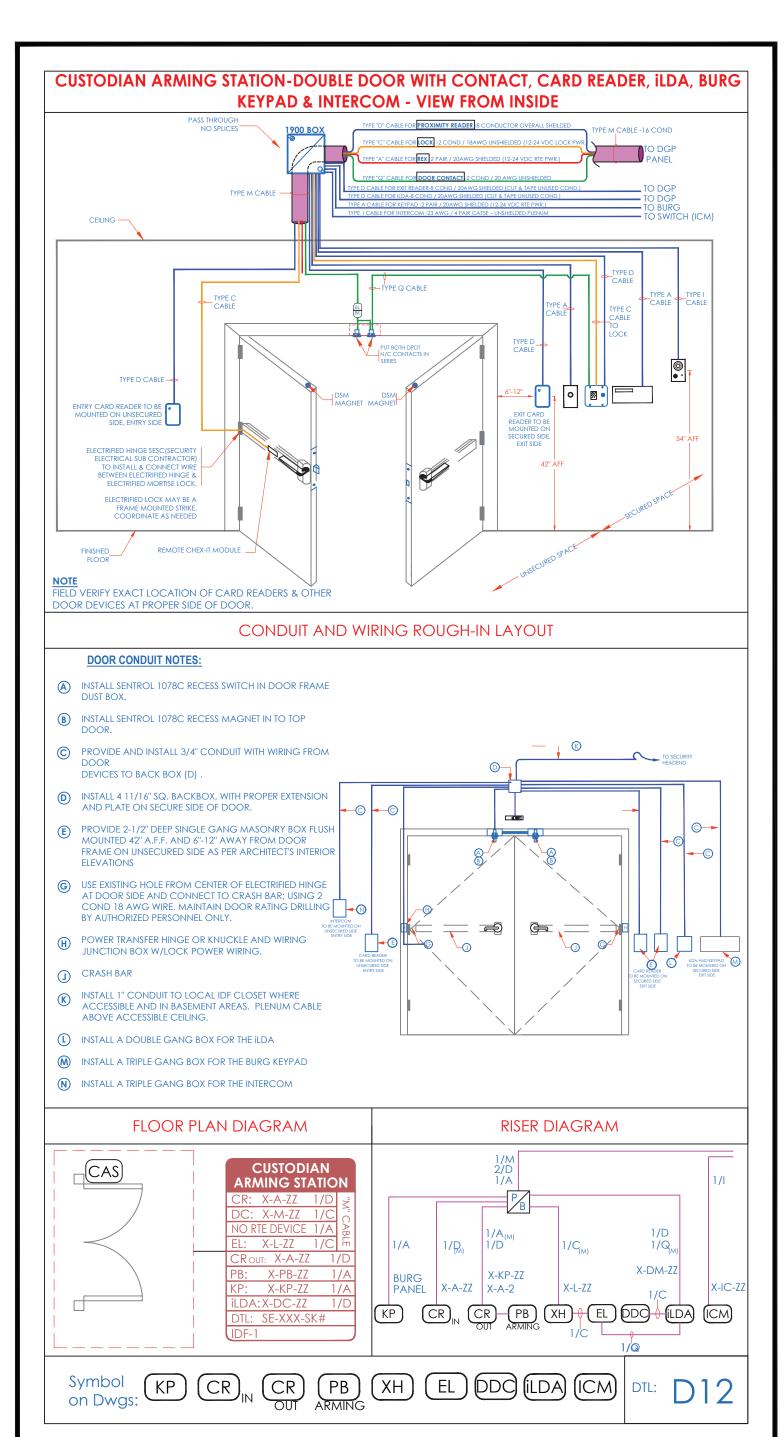

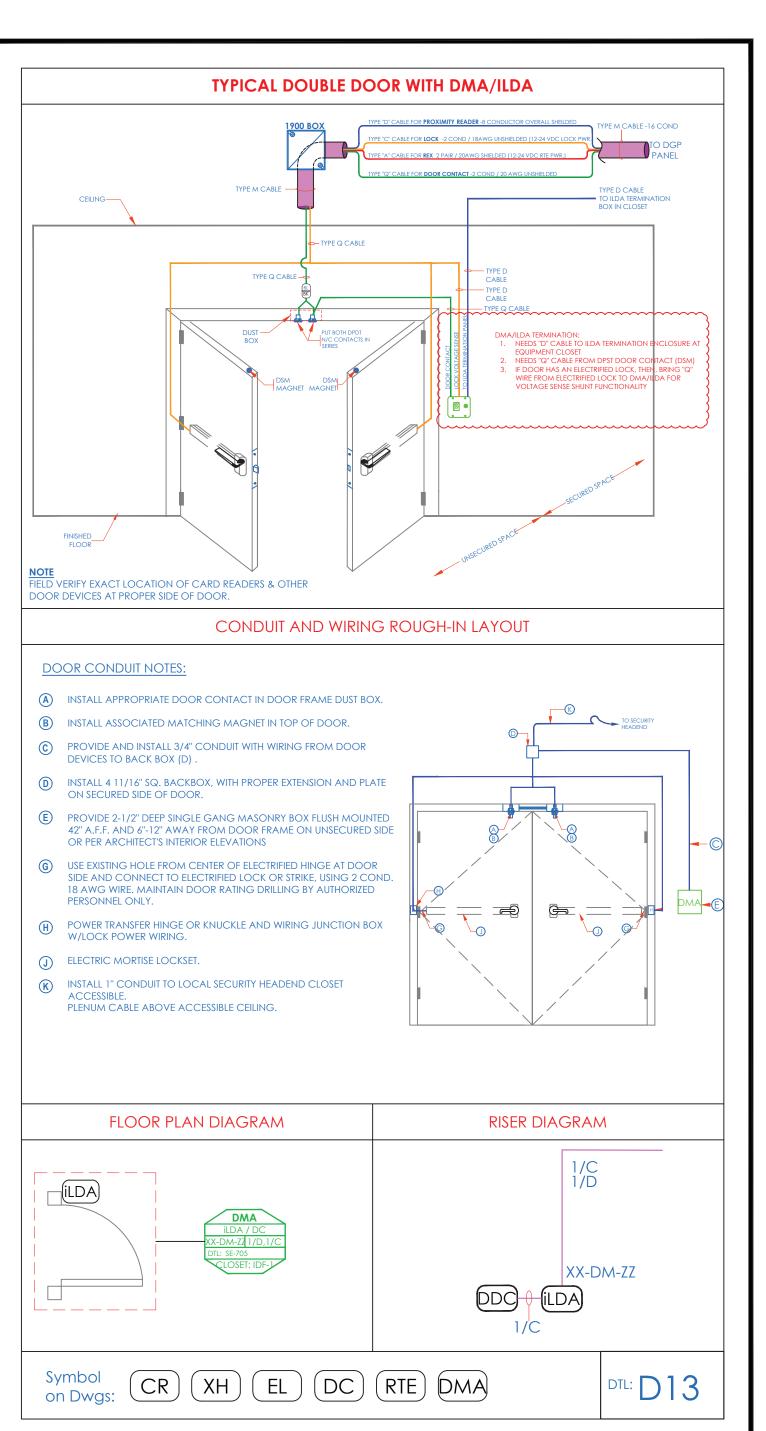

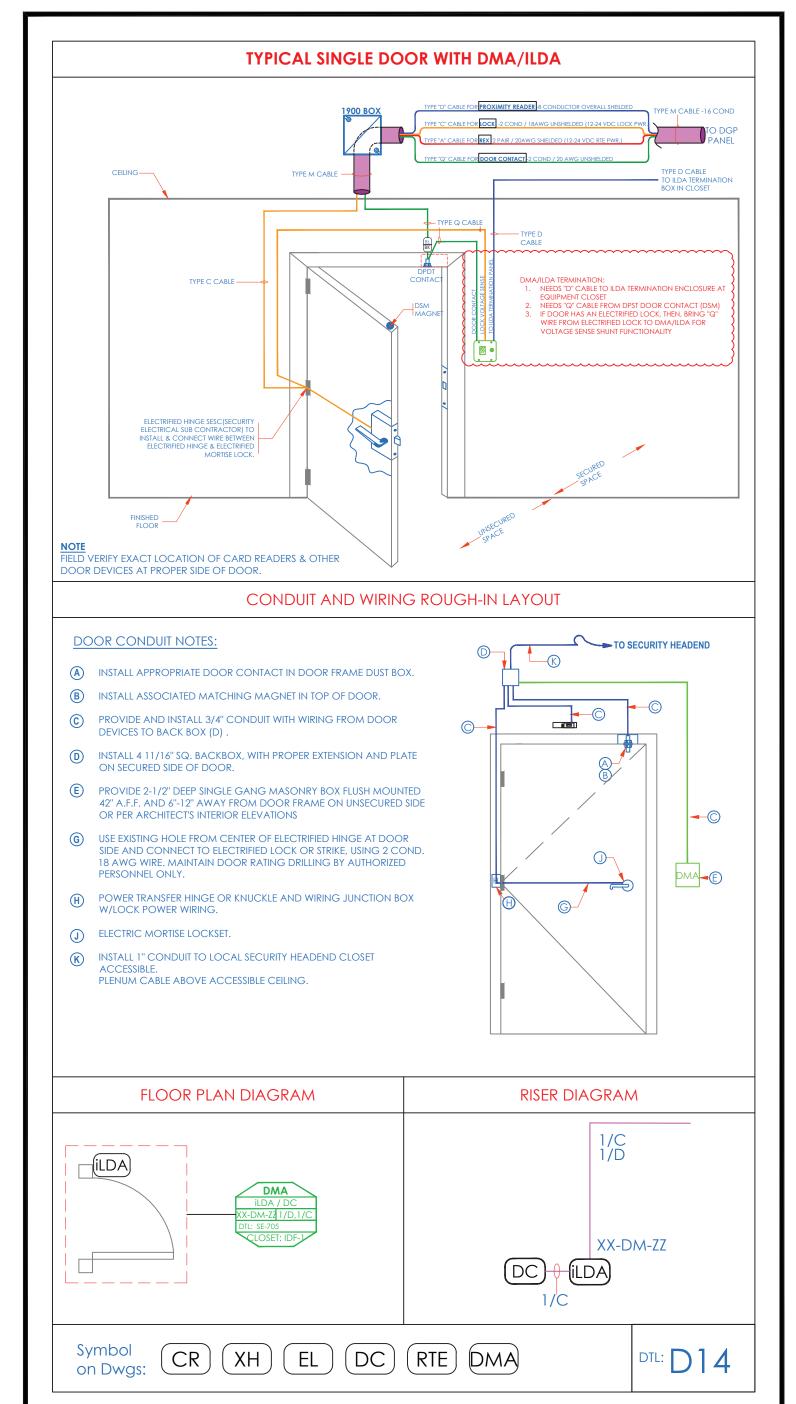

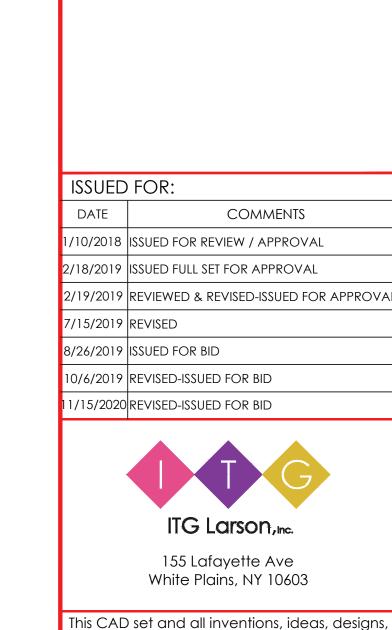

DEVICE PLACEMENT, RISER DEPICTION, CABLE TYPES AND ROUTES, DEVICE TERMINATION AND

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AS PER BID DOCUMENT

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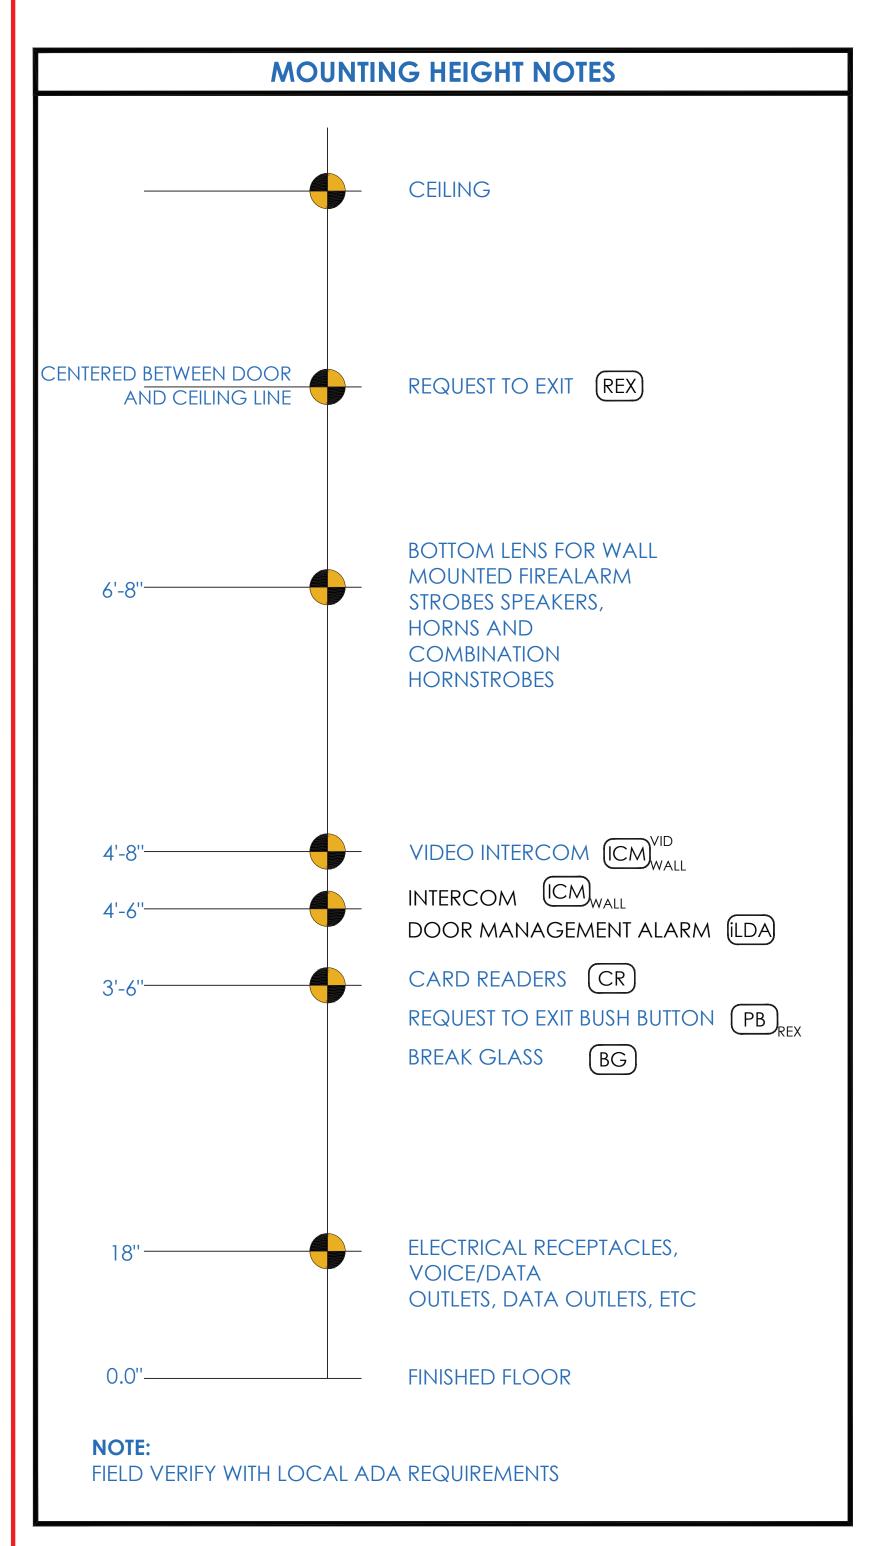
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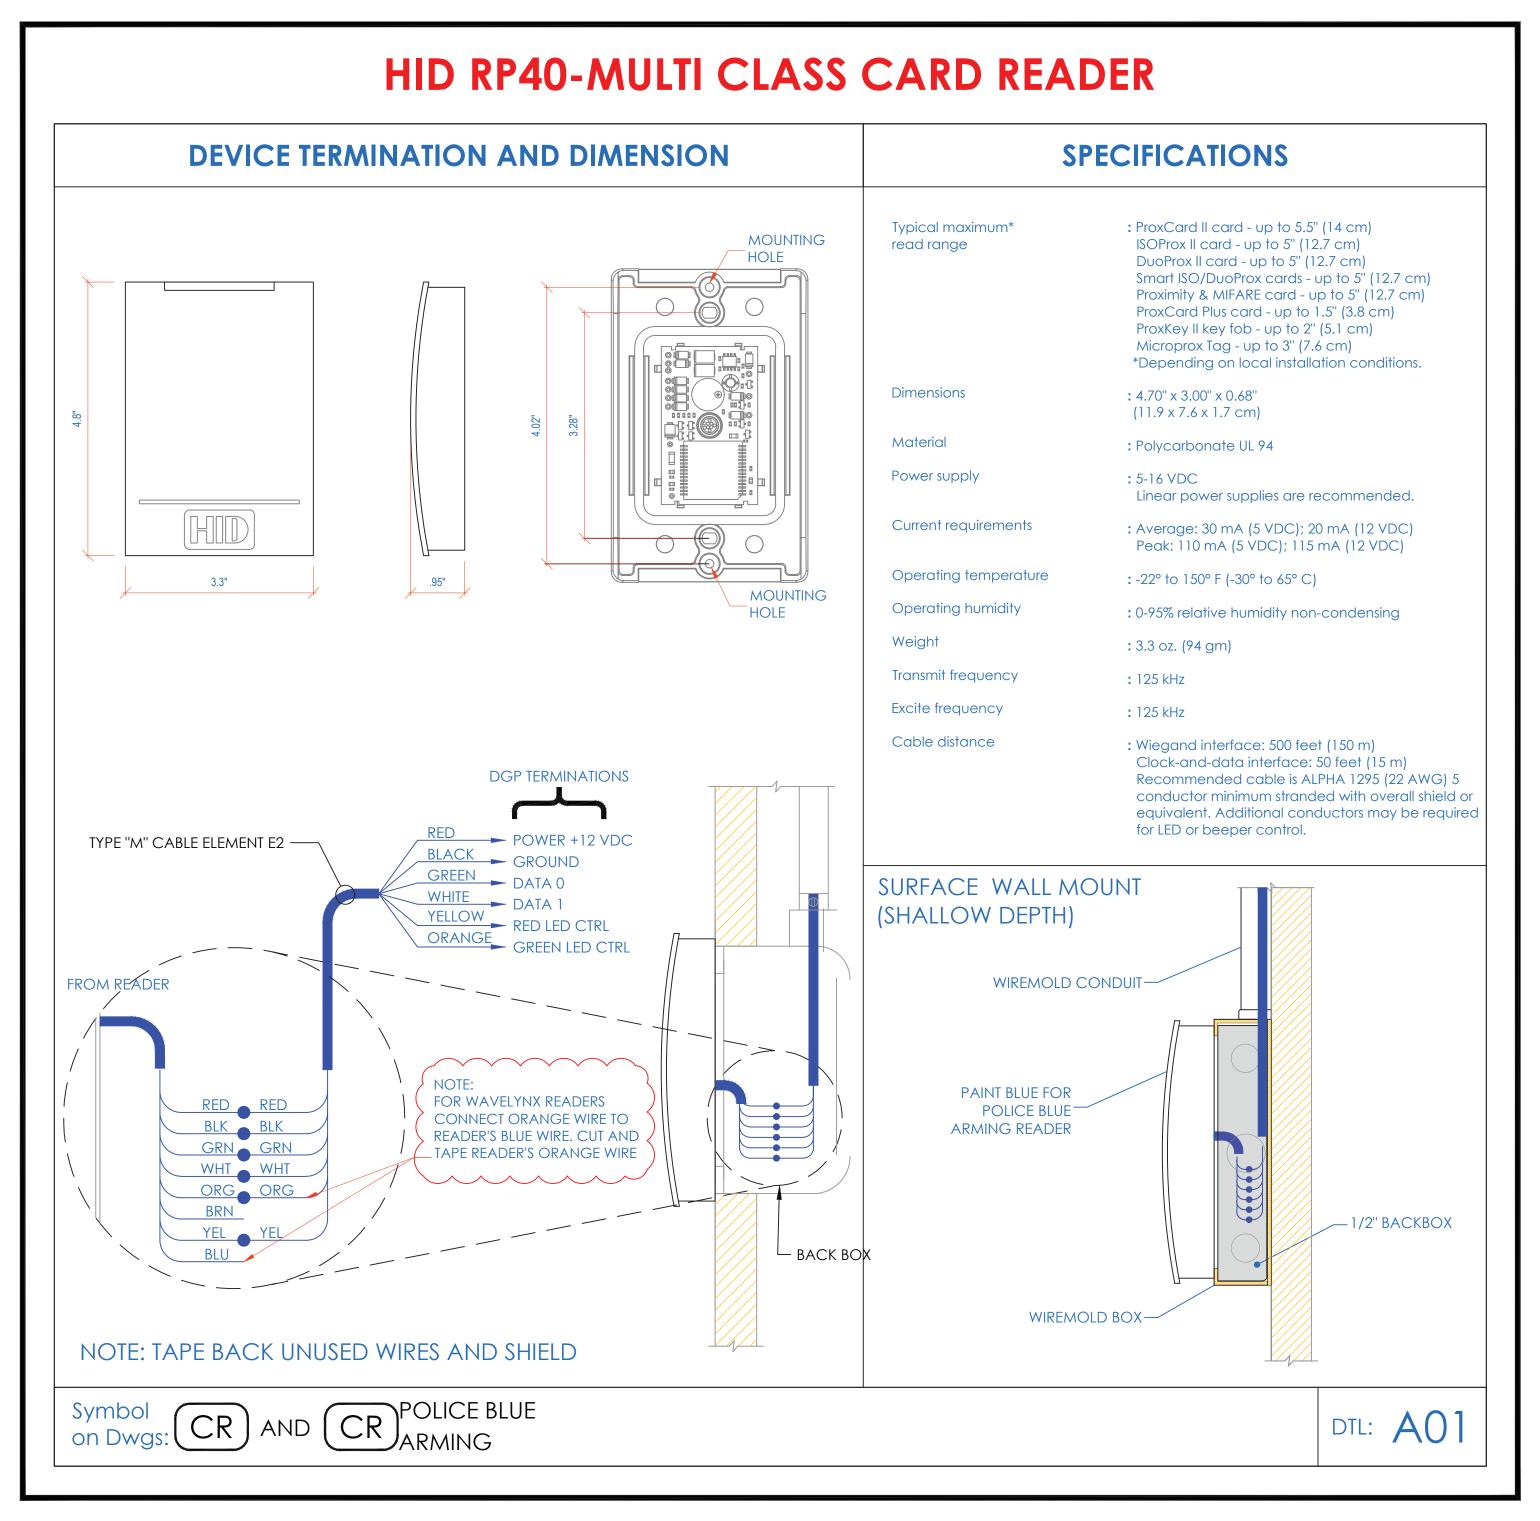
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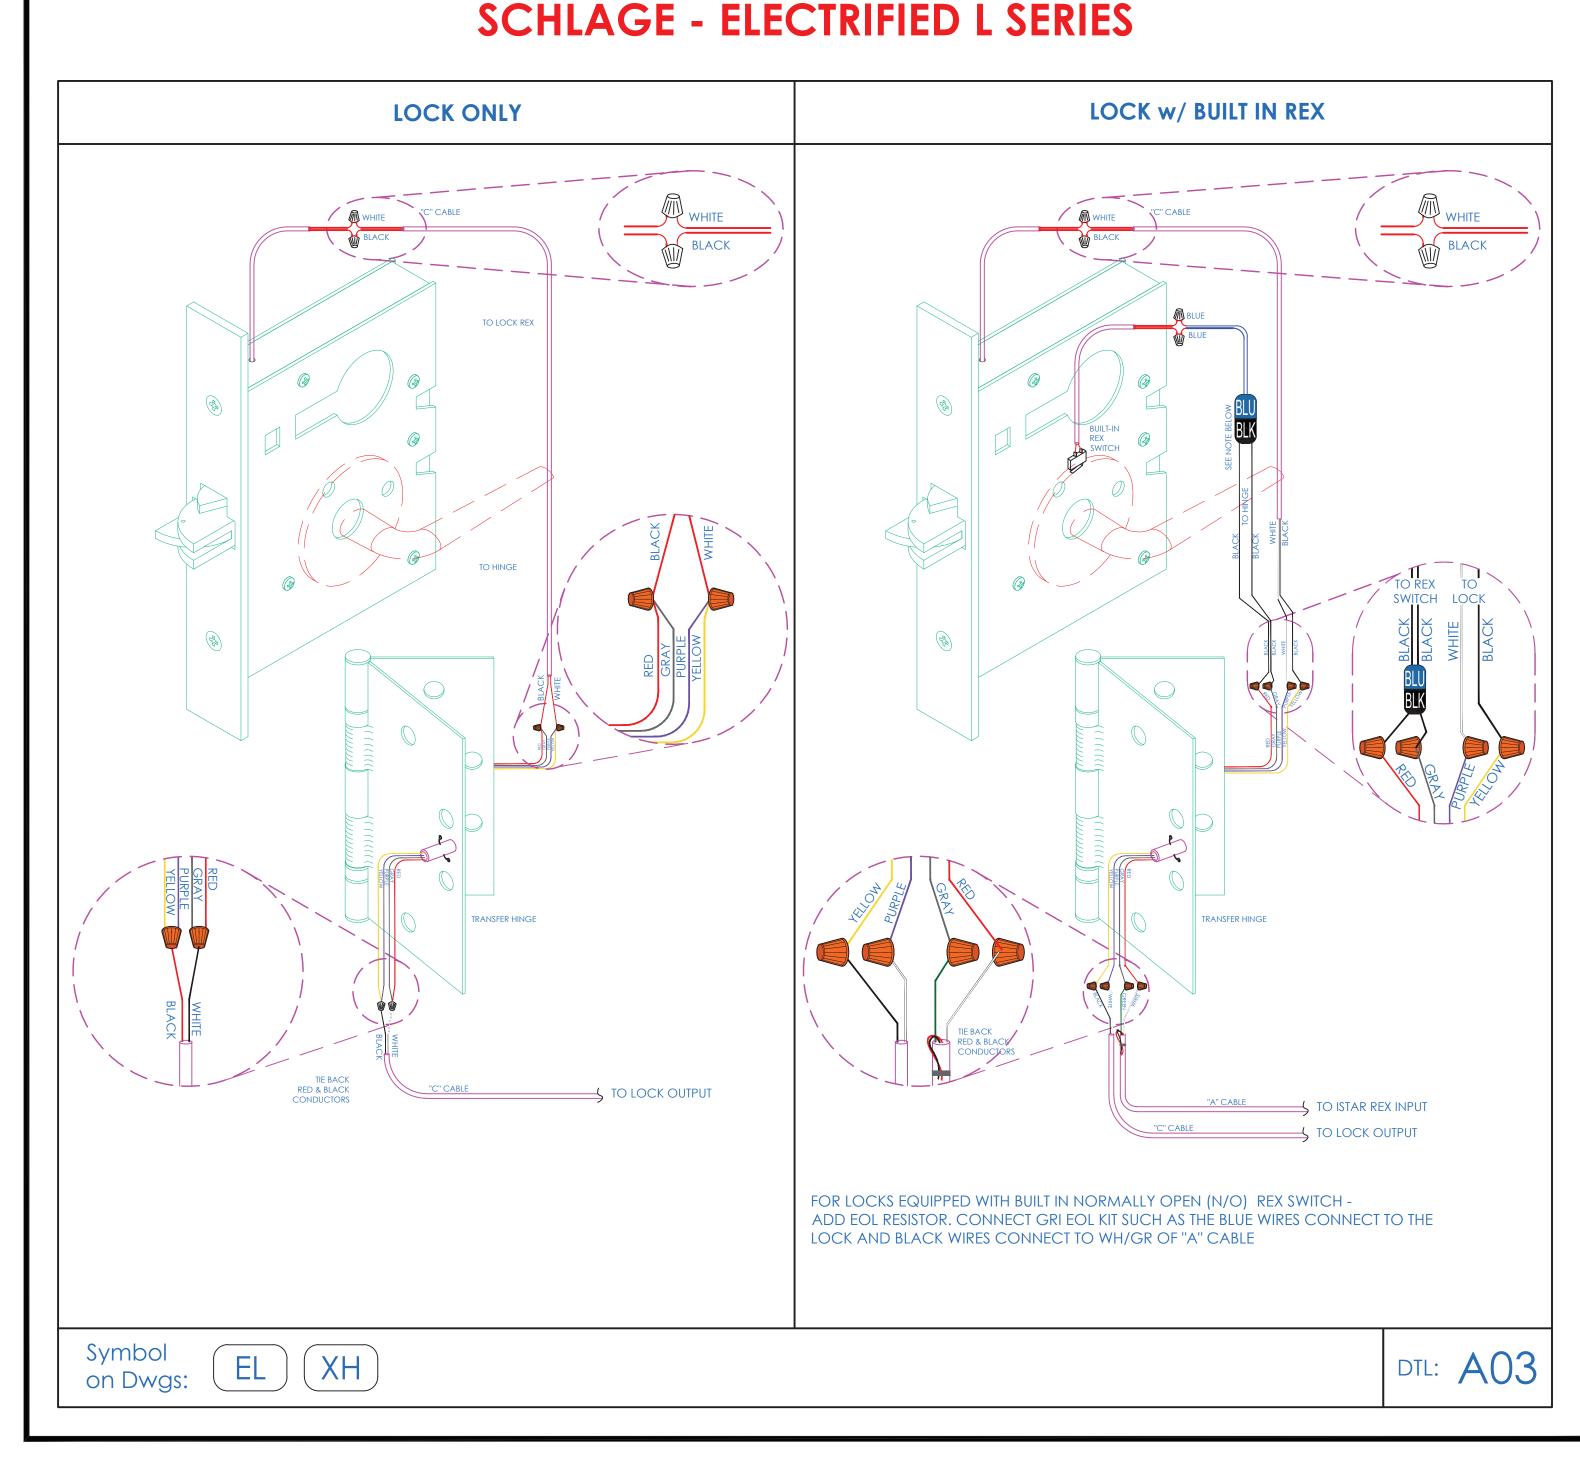
RIVERSIDE HIGH SCHO 565 WARBURTON AVE YONKERS, NY 10701


SECURITY EQUIPMENT DETAIL 1A DOOR TYPICALS


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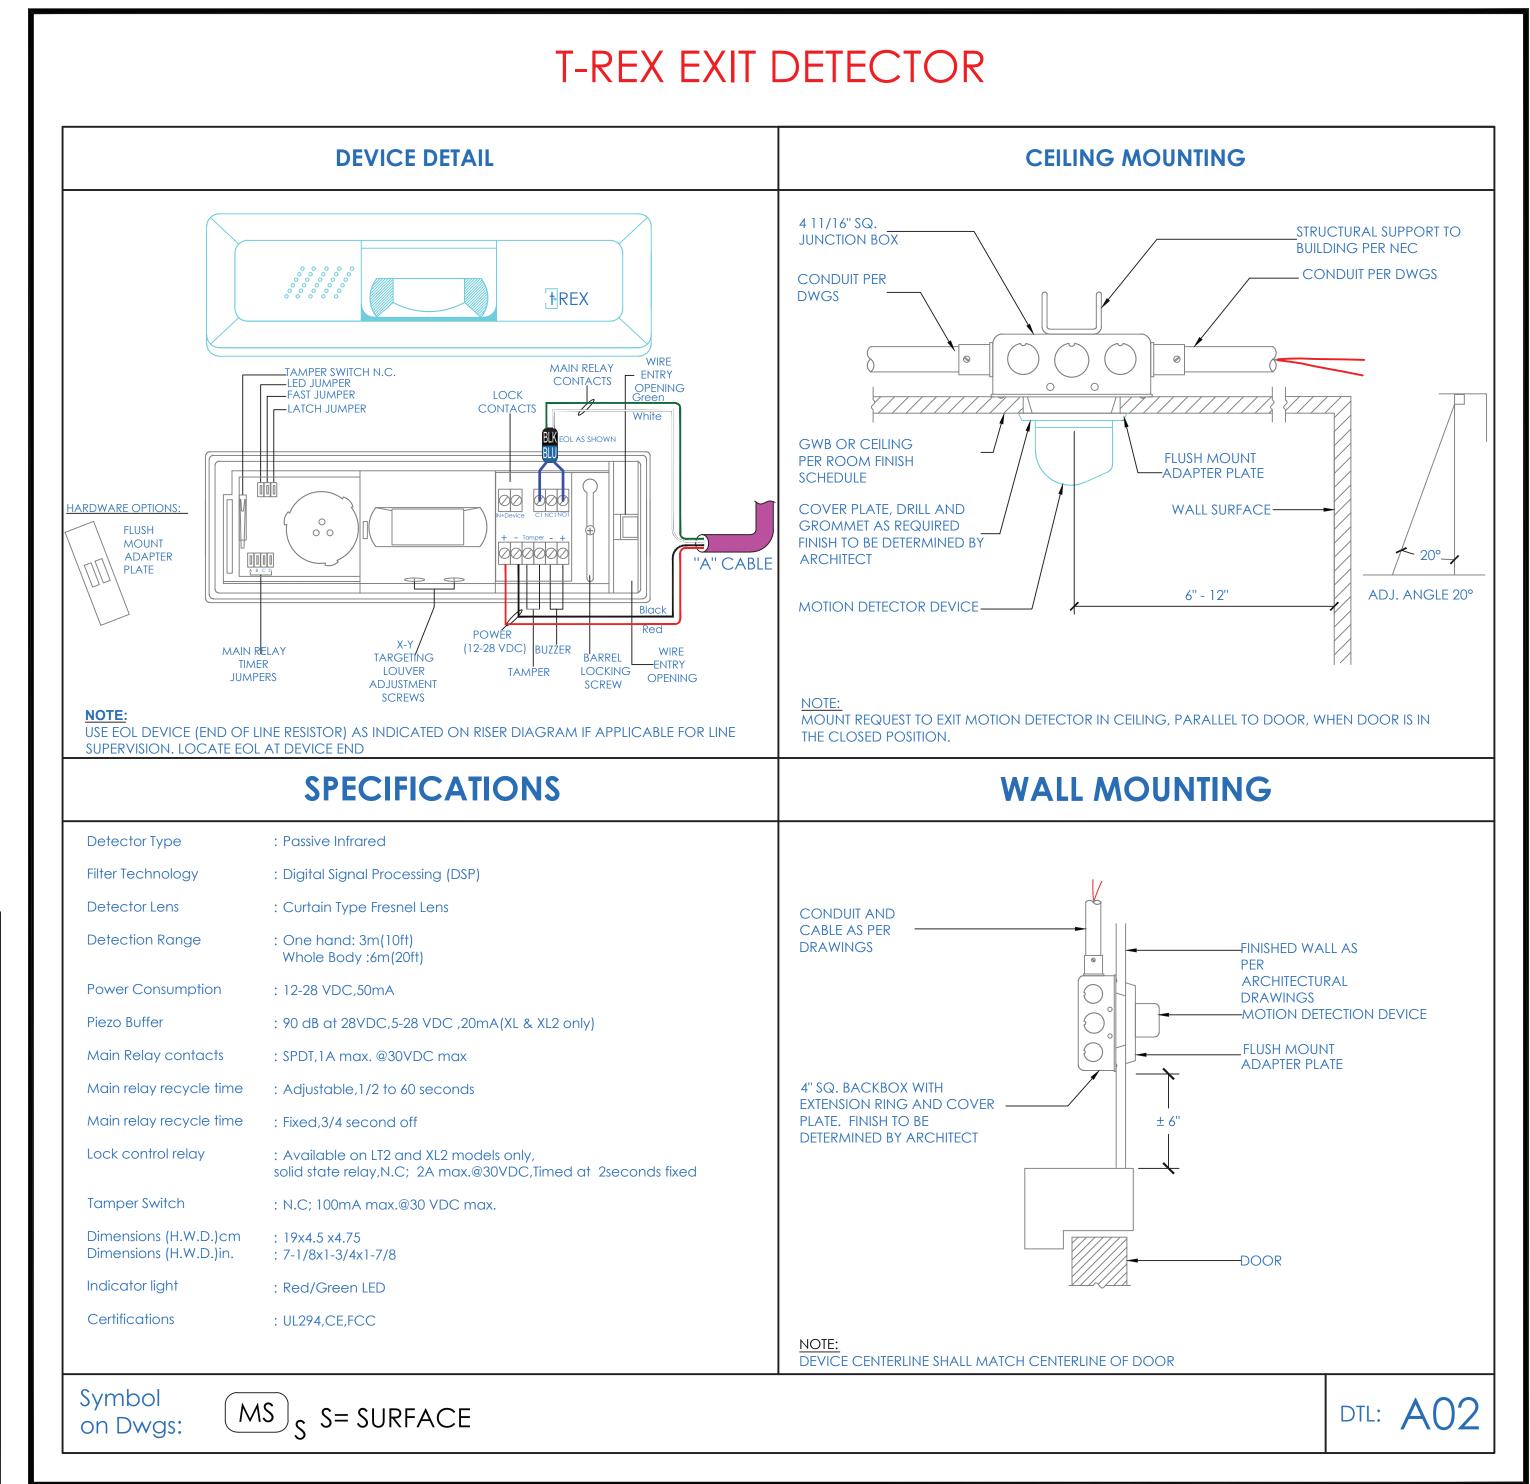









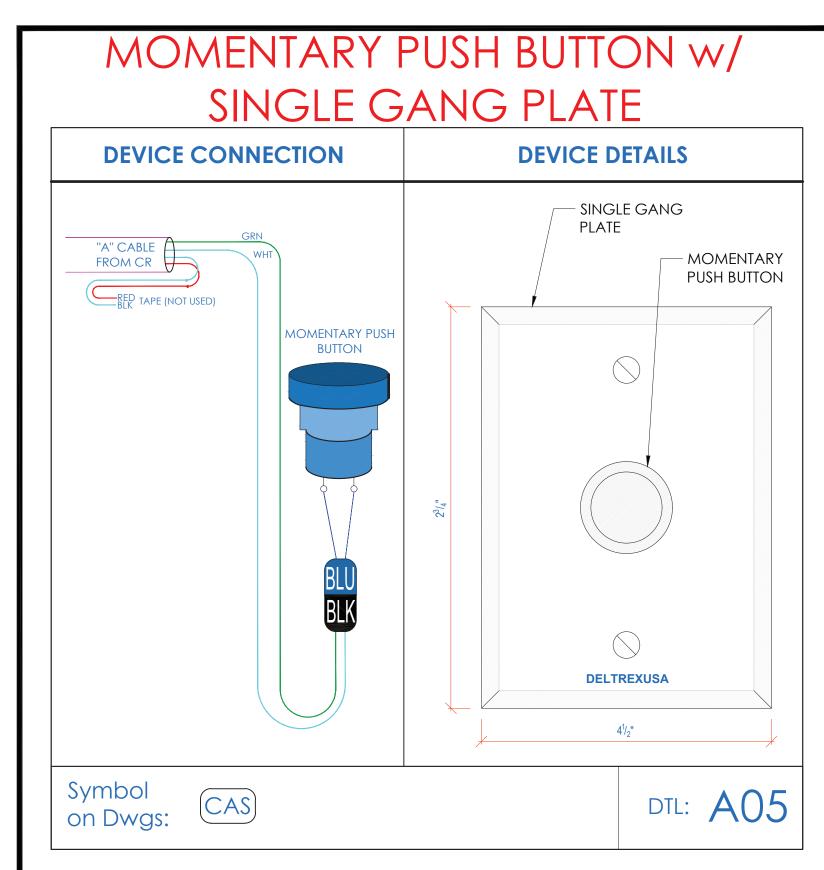

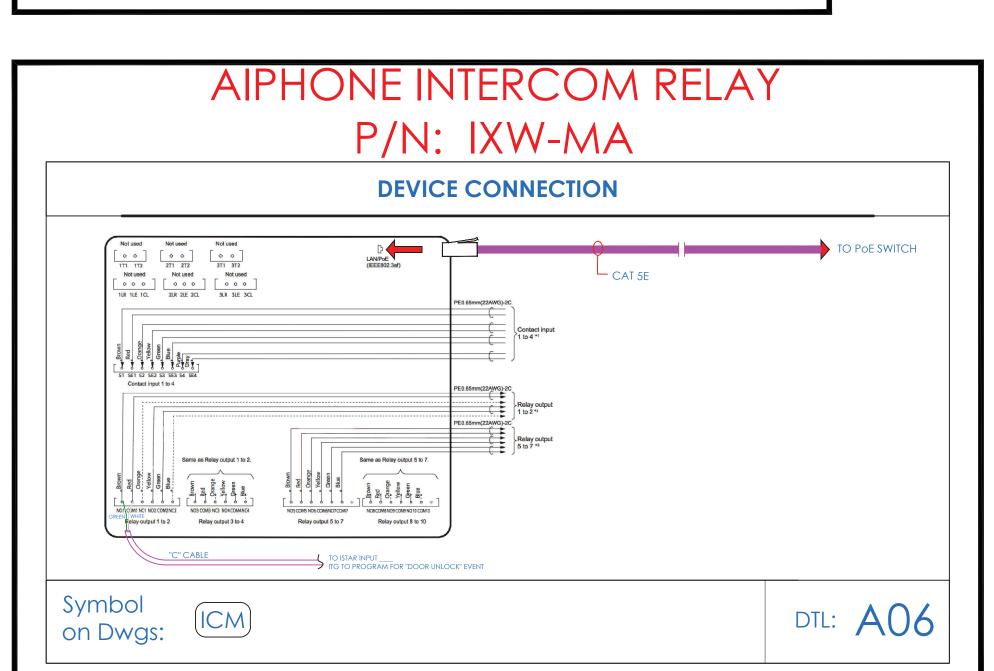

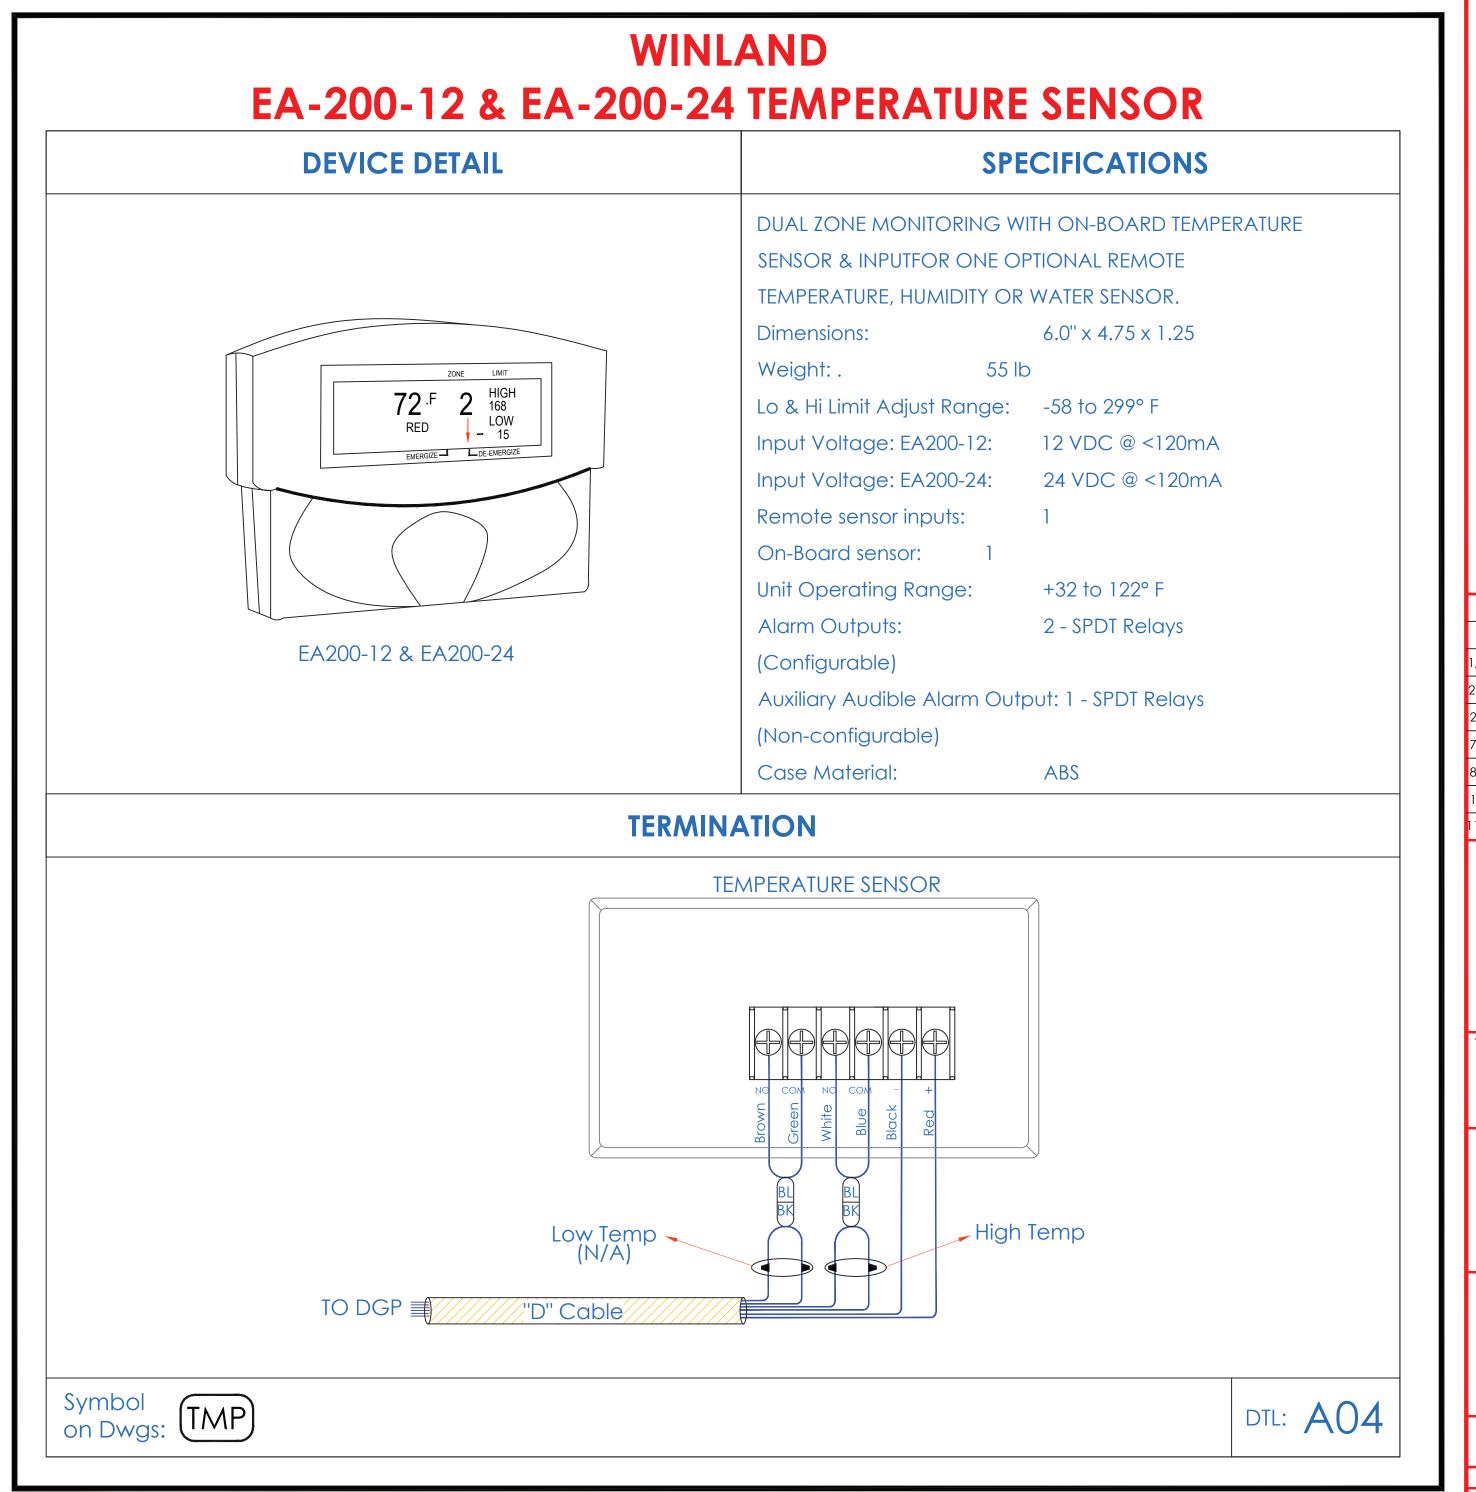

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. DEVICE PLACEMENT, RISER DEPICTION, CABLE TYPES AND ROUTES, DEVICE TERMINATION AND

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TO VERIFY CABLE LENGTH DOES NOT TO EXCEED 300' WHEN BROUGHT TO CLOSEST CLOSET. ALL CAT-6 CABLES TO BE TESTED AND CERTIFIED AS PER BID DOCUMENT

. CONTRACTOR TO MARK ANY DEVIATIONS FROM THE PROVIDED RISER AND NOTE ON THE "AS BUILT" CONTRACTOR TO PRODUCE AND DELIVER A

BOUND "AS BUILT" SET IN BOTH "D" SIZE HARD COPY (2 SETS) AND A CD WITH .PDF FORMAT.

CONTRACTOR IS RESPONSIBLE FOR SYSTEM COMMISSIONING. ITG'S ROLE IS LIMITED TO SYSTEM PROGRAMMING ONLY.

ISSUED FOR: 2/18/2019 ISSUED FULL SET FOR APPROVAL 2/19/2019 REVIEWED & REVISED-ISSUED FOR APPROV. 7/15/2019 REVISED 8/26/2019 ISSUED FOR BID 10/6/2019 REVISED-ISSUED FOR BID 1 1/15/2020 REVISED-ISSUED FOR BID

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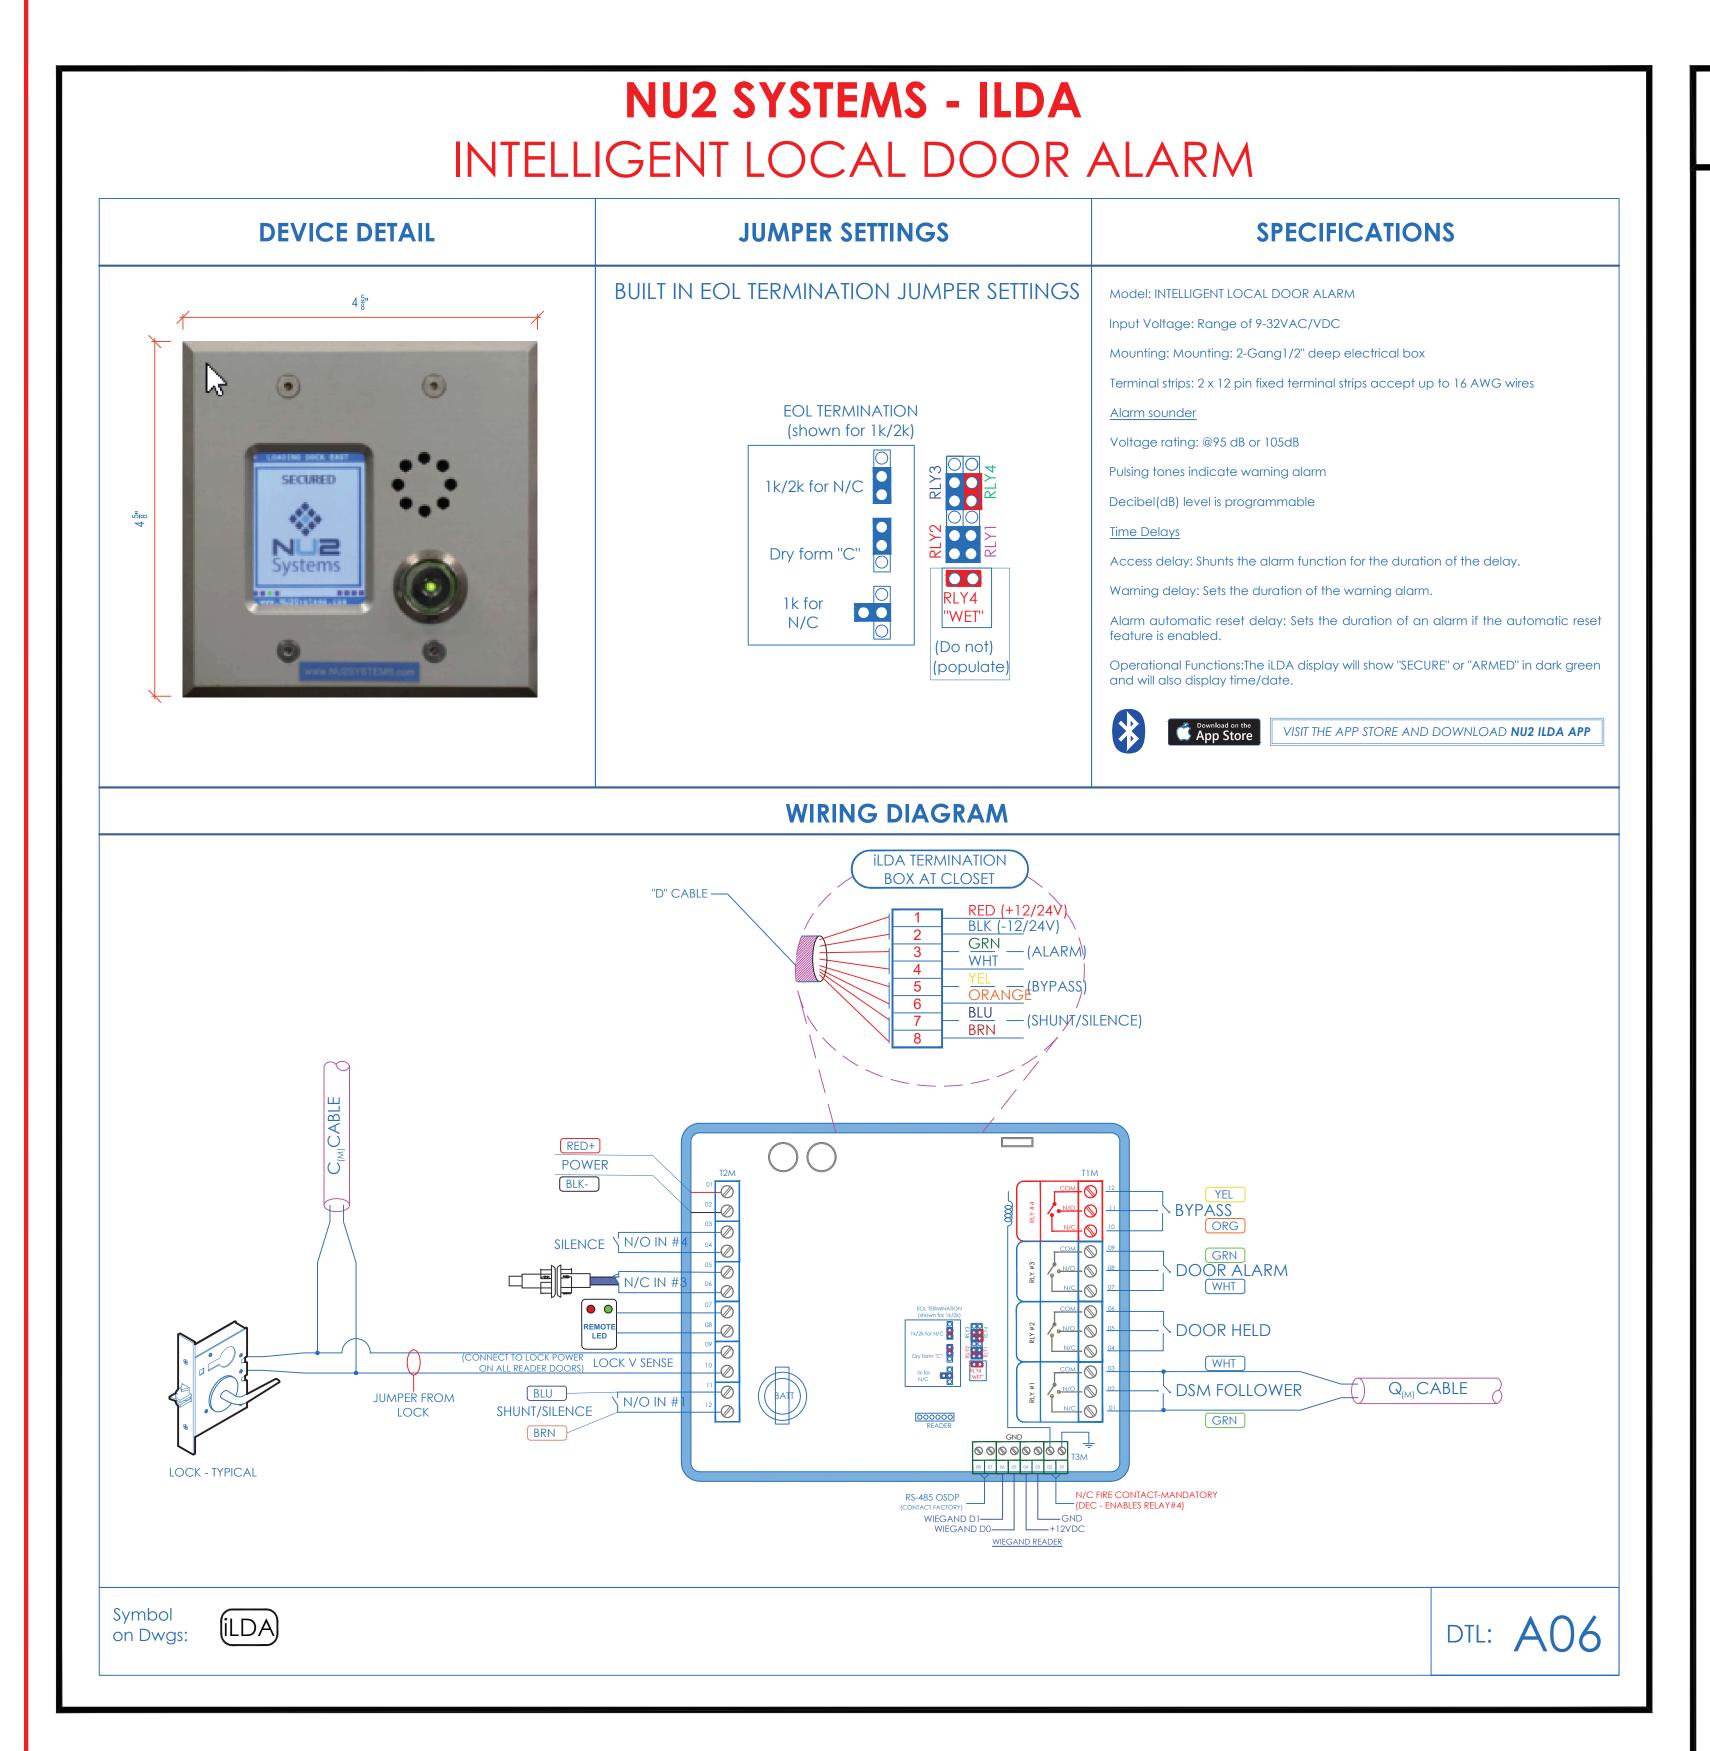
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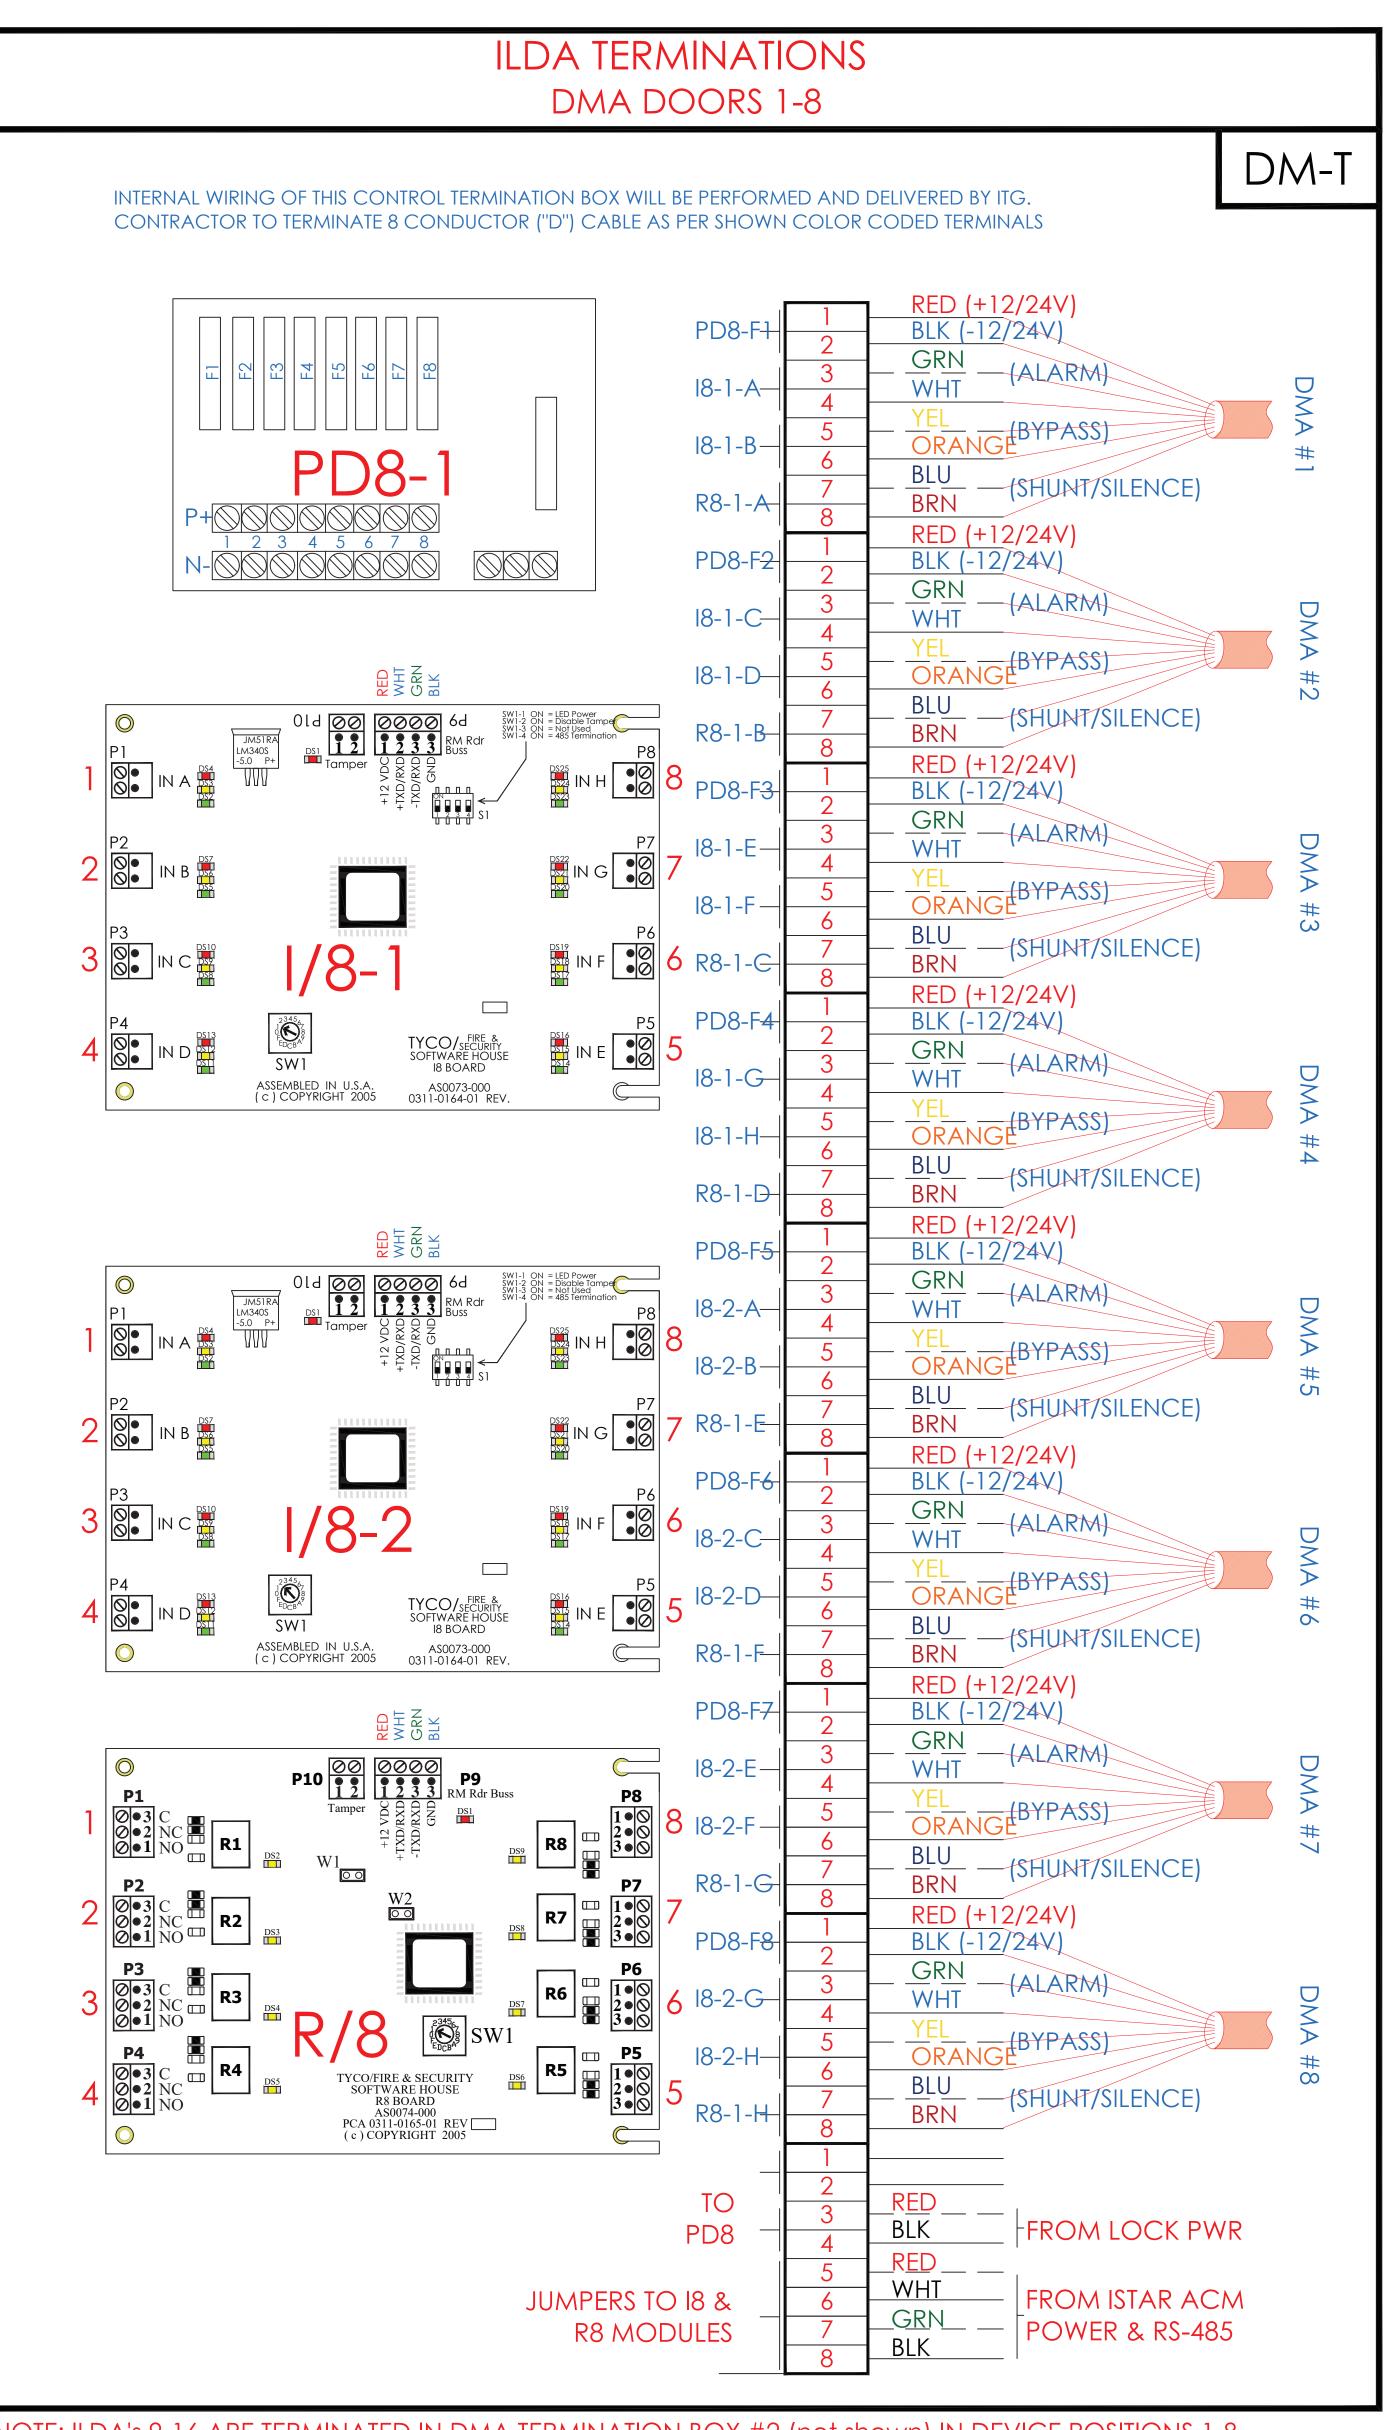
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SECURITY EQUIPMENT DETAIL 2 ACCESS DEVICE TYPICALS

<sup>1E:</sup> 11/27/2019 XXXXXX XXXXXX





NOTE: ILDA's 9-16 ARE TERMINATED IN DMA TERMINATION BOX #2 (not shown) IN DEVICE POSITIONS 1-8. SEE SE-300 CLOSET DETAILS FOR MOUNTING OF BOXES 1&2. SEE ILDA/DMA TERMINATION MATRIX THIS PAGE

#### TYPES AND ROUTES, DEVICE TERMINATION AND OTHERS ARE FOR REFERENCE ONLY. 2. THE CONTRACTOR IS RESPONSIBLE FOR

UNDERSTANDING AND VERIFYING THE ENTIRE DRAWINGS SET AND SPECIFICATIONS, VERIFY

1. DEVICE PLACEMENT, RISER DEPICTION, CABLE

- ACTUAL FIELD CONDITIONS AND DELIVER A TURN KEY SOLUTION TO COY BOE.
- 3. CONTRACTOR TO VERIFY CAMERAS FIELD OF VIEW AND ADJUST AS NEEDED TO THE SATISFACTION OF BOE SECURITY MANAGER.
- 4. PRIOR TO PULLING CAT-6 WIRES, CONTRACTOR TO VERIFY CABLE LENGTH DOES NOT TO EXCEED 300' WHEN BROUGHT TO CLOSEST CLOSET.
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# ILDA/DMA TERMINATION MATRIX

ILDA/DMA TERMINATION MATRIX				
CLOSET	вох	PORT	CAD	LOCATION
		1	B-01-01-01	GYMNASIUM DOOR
	$\vdash$	2	B-02-01-02	CLASSROOM 14
	Æ	3	B-03-01-03	CLASSROOM 12
	ENCLOSURE	4	B-04-01-04	MECH.
	0.	5	B-05-01-05	CLASSROOM 110
$\vdash$	<u>5</u>	6	1-06-01-06	NORTH DOOR @ STAIRS
1		7	1-07-01-07	VEST - SE
		8	1-08-01-08	VEST - NE
CLOSET		1	1-09-02-01	CLASSROOM 19
	. 7	2	1-10-02-02	REAR DOOR-CUSTODIAL ARMING STATION
$\circ$	щ	3	1-11-02-03	AUDITORIUM EXTERIOR DOOR
	J.	4	2-12-02-04	MAIN DOOR
	0	5	2-13-02-05	VEST - SW
	ENCLOSURE	6	2-14-02-06	OFFICE COAT ROOM
		7	2-15-02-07	CORRIDOR EXTERIOR NE DOOR
		8	SPARE	

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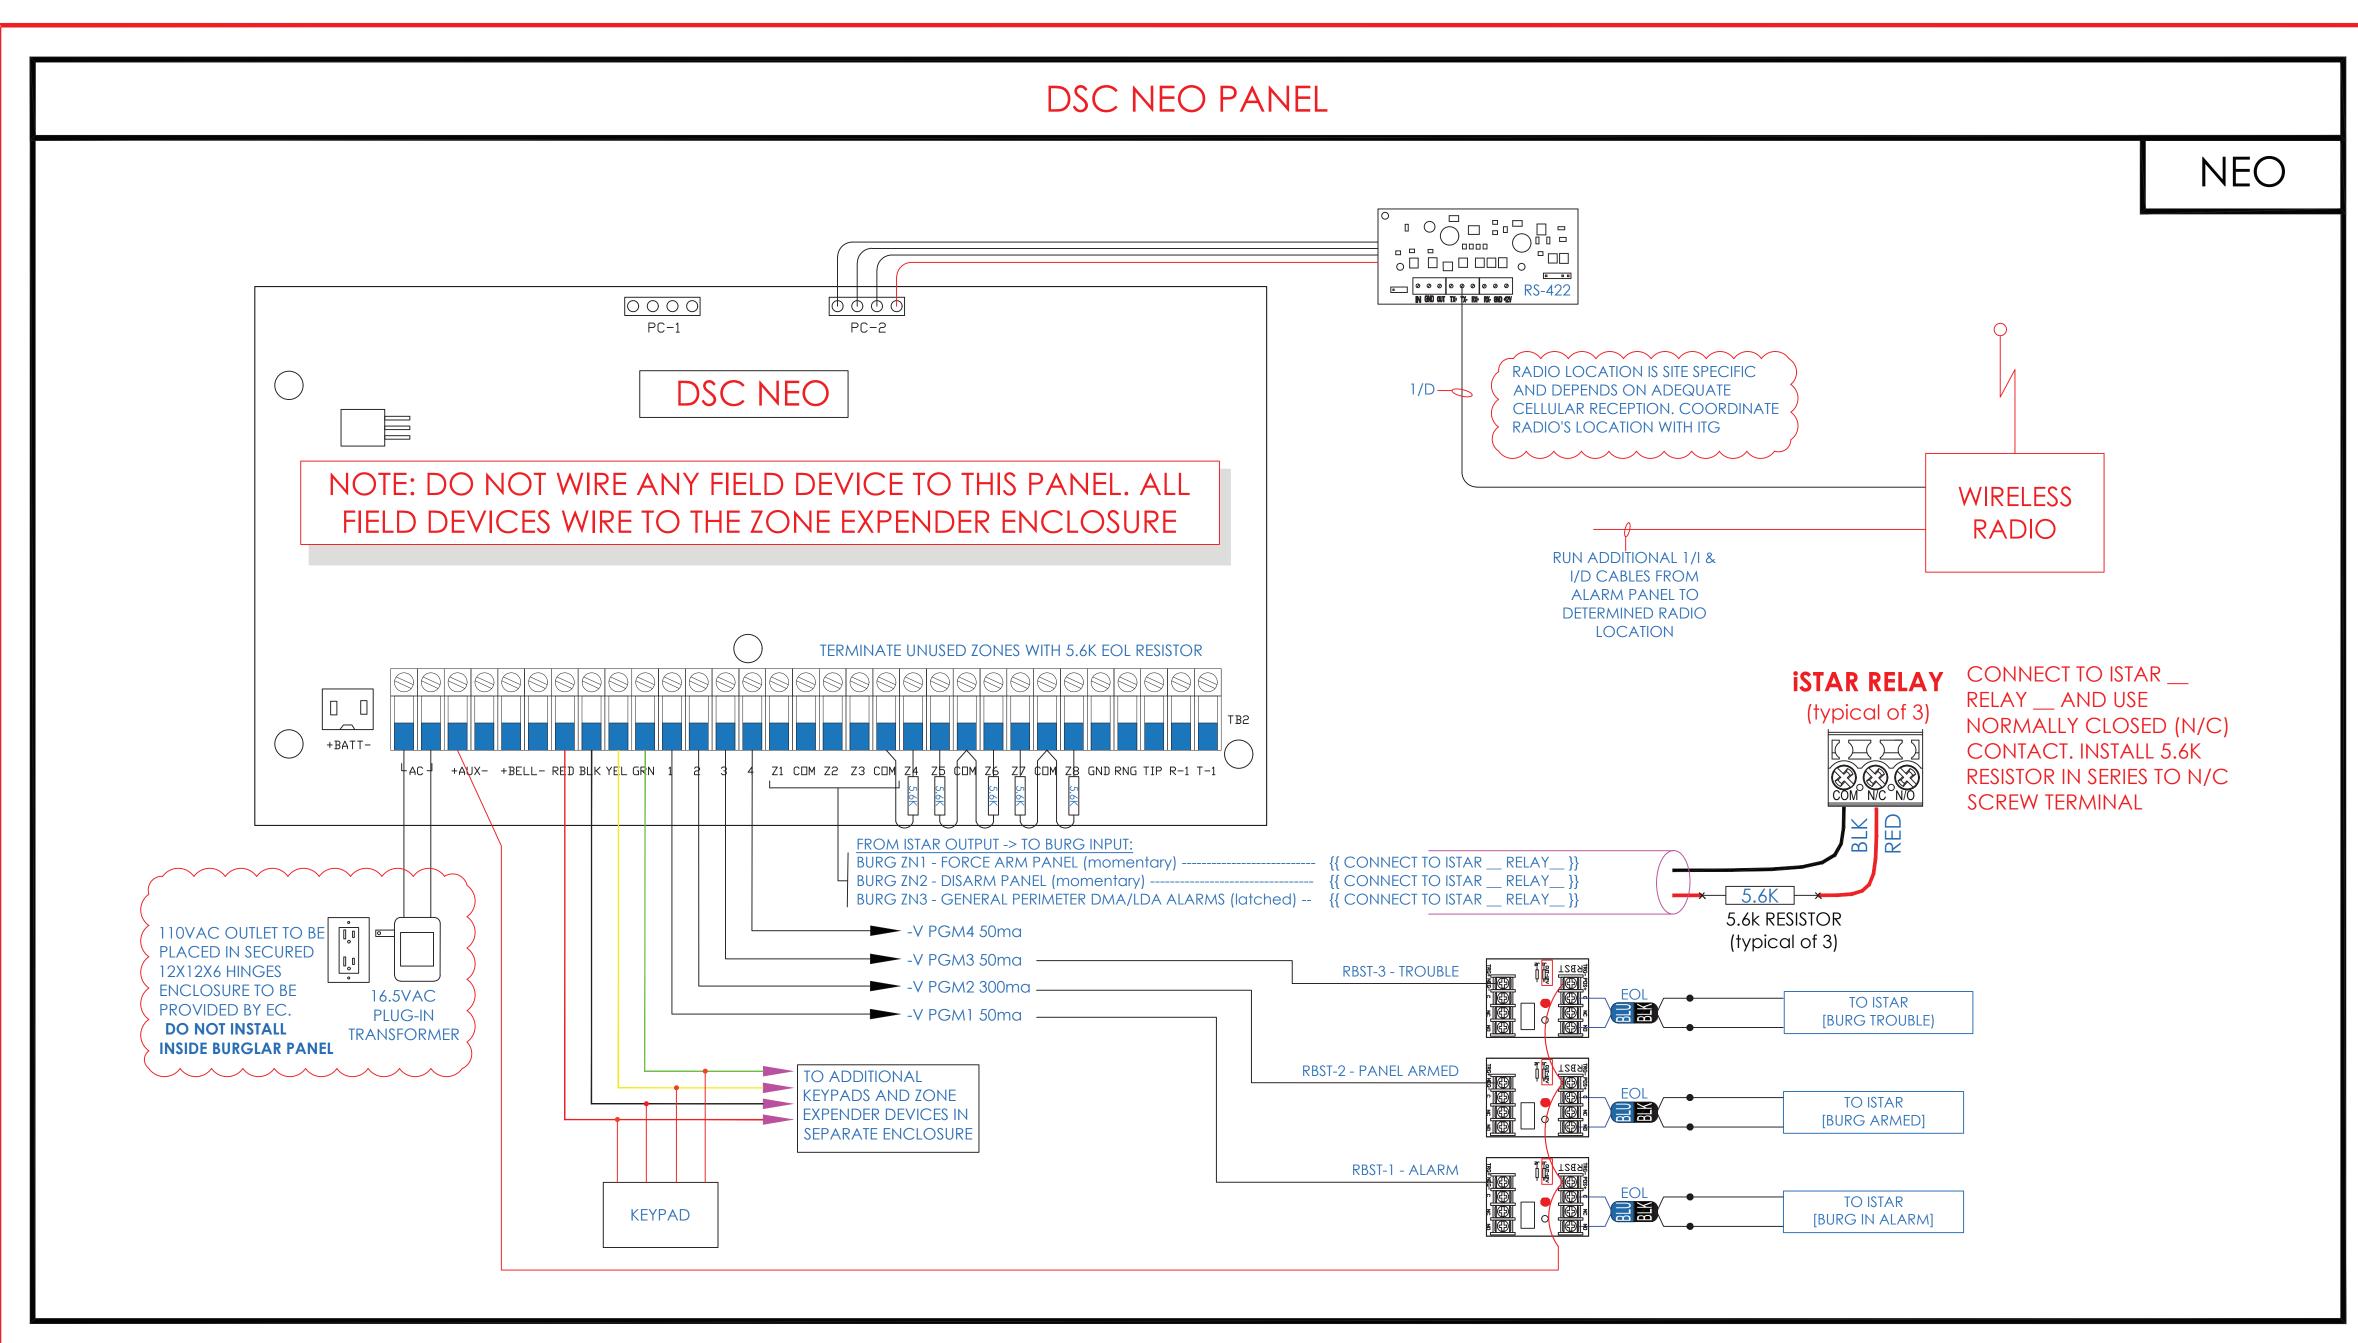
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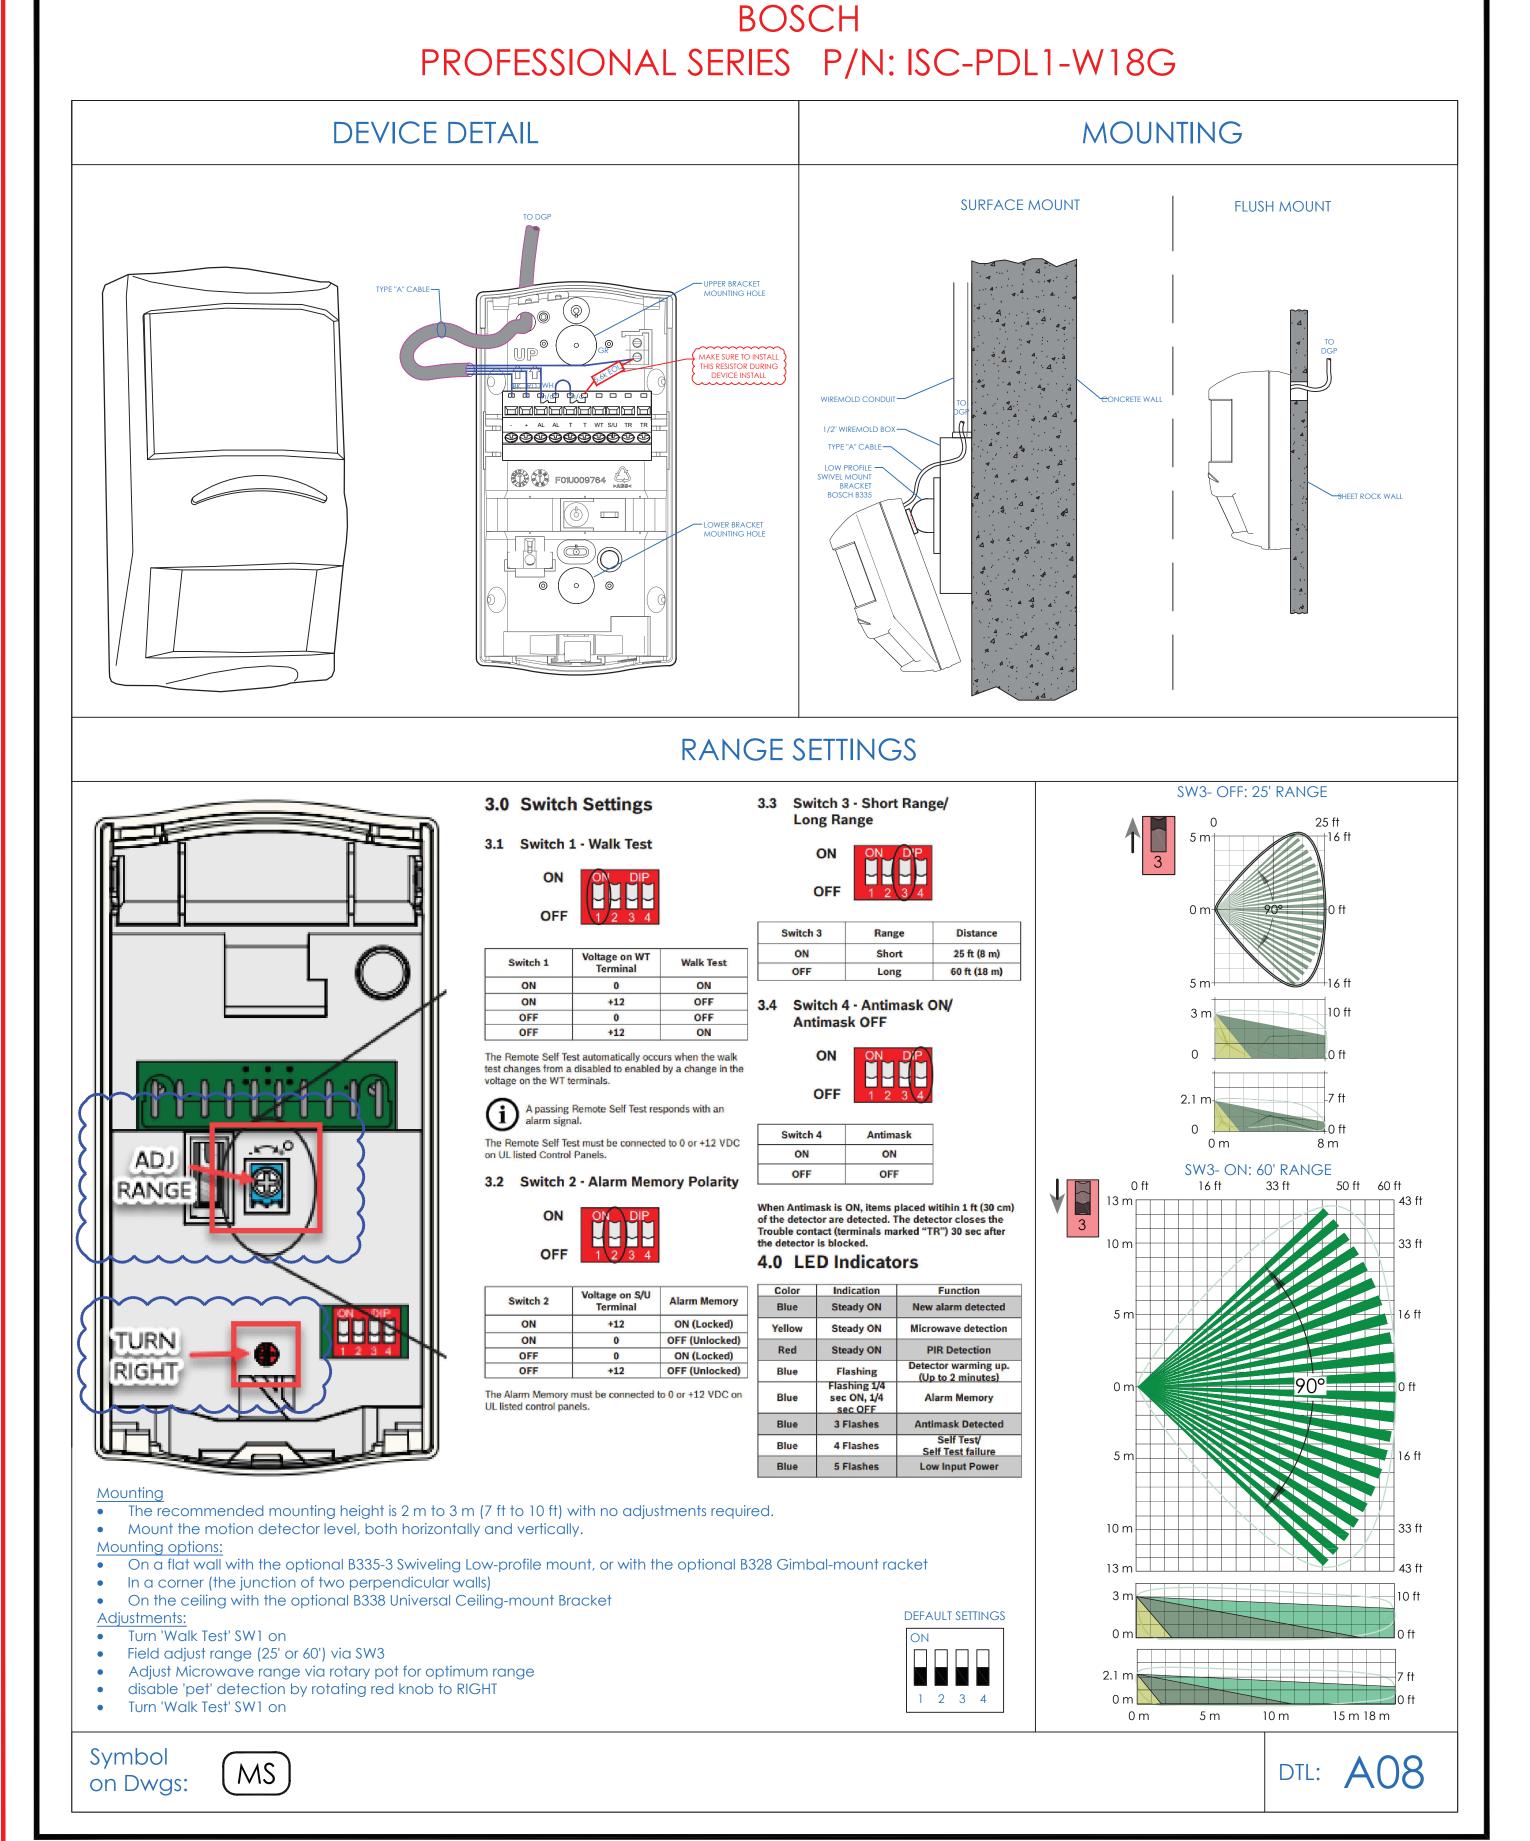
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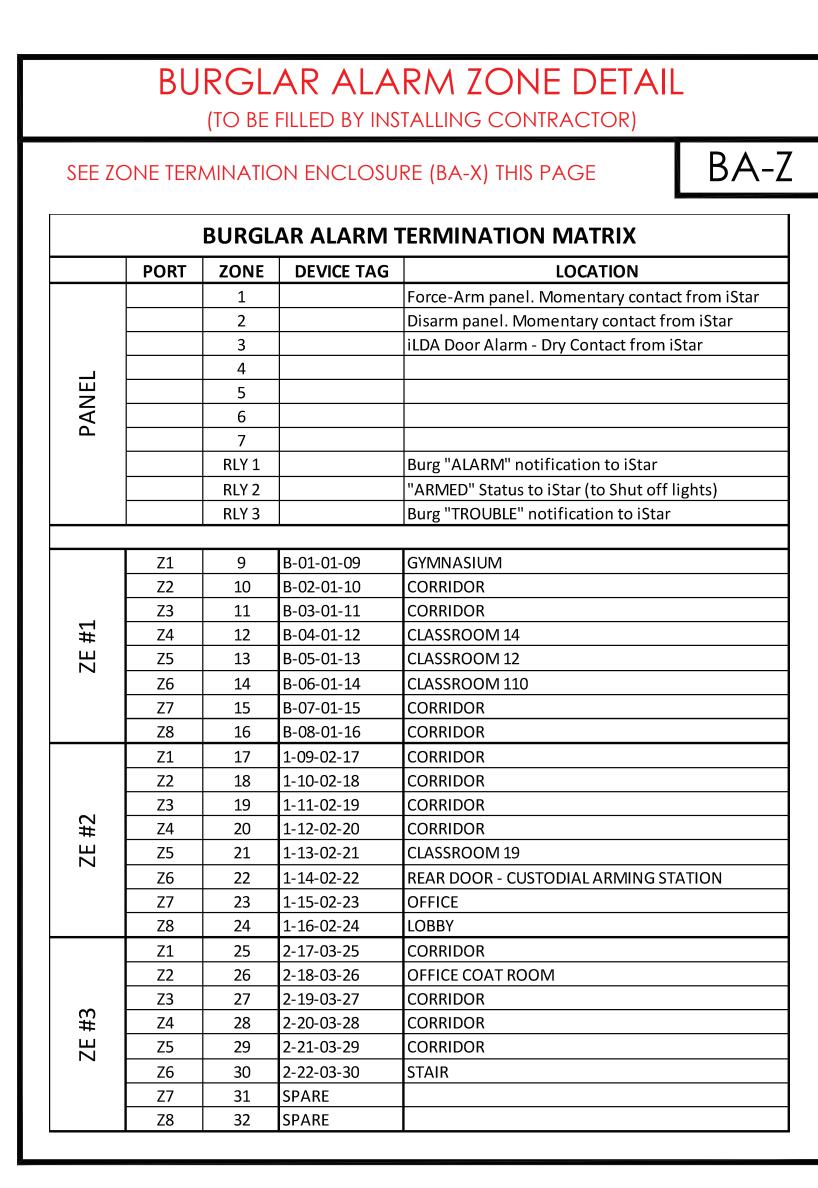
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SECURITY EQUIPMENT DETAIL 3 ILDA DEVICE TYPICALS

I.T.	C.A.	E.M.
DESIGNED BY	DRAWN BY	CHECKED BY
WORK ORDER NO:	DATE: 1	1/27/2019
XXXXXX	scale: N	.T.S.
S.A. NO:	DRAWING 1	10:
XXXXXX	SE-	705







## BURGLAR ALARM ZONE EXPANDER MODULE CONFIGURATION & WIRING

TERMINATE UNUSED ZONES WITH 5.6K EOL RESISTOR

NOTE THAT THE FIRST

ZONE (Z1) IS HERE

FFFFFFFF PD8

BURG

ZONE EXPANDER 9-16

12VDC IN ONLY

2+ \( \quad \qqq \quad \

1-0000000

BA-X

ZE#2

**ZONE EXPANDER 17-24** 

3666666666666666666666

2. THE CONTRACTOR IS RESPONSIBLE FOR UNDERSTANDING AND VERIFYING THE ENTIRE DRAWINGS SET AND SPECIFICATIONS, VERIFY ACTUAL FIELD CONDITIONS AND DELIVER A TURN KEY SOLUTION TO COY BOE

OTHERS ARE FOR REFERENCE ONLY.

DEVICE PLACEMENT, RISER DEPICTION, CABLE

TYPES AND ROUTES, DEVICE TERMINATION AND

ACTUAL FIELD CONDITIONS AND DELIVER A
KEY SOLUTION TO COY BOE.

 CONTRACTOR TO VERIFY CAMERAS FIELD OF VIEW AND ADJUST AS NEEDED TO THE SATISFACTION OF BOE SECURITY MANAGER.

PRIOR TO PULLING CAT-6 WIRES, CONTRACTOR
 TO VERIFY CABLE LENGTH DOES NOT TO EXCEED
 300' WHEN BROUGHT TO CLOSEST CLOSET

300' WHEN BROUGHT TO CLOSEST CLOSET.

5. ALL CAT-6 CABLES TO BE TESTED AND CERTIFIED

AS PER BID DOCUMENT


6. CONTRACTOR TO MARK ANY DEVIATIONS FROM
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7. CONTRACTOR TO PRODUCE AND DELIVER A
BOUND "AS BUILT" SET IN BOTH "D" SIZE HARD
CORY (2 SETS) AND A CO WITH PRE FORMAT

COPY (2 SETS) AND A CD WITH .PDF FORMAT.

8. CONTRACTOR IS RESPONSIBLE FOR SYSTEM

COMMISSIONING. ITG'S ROLE IS LIMITED TO SYSTEM PROGRAMMING ONLY.

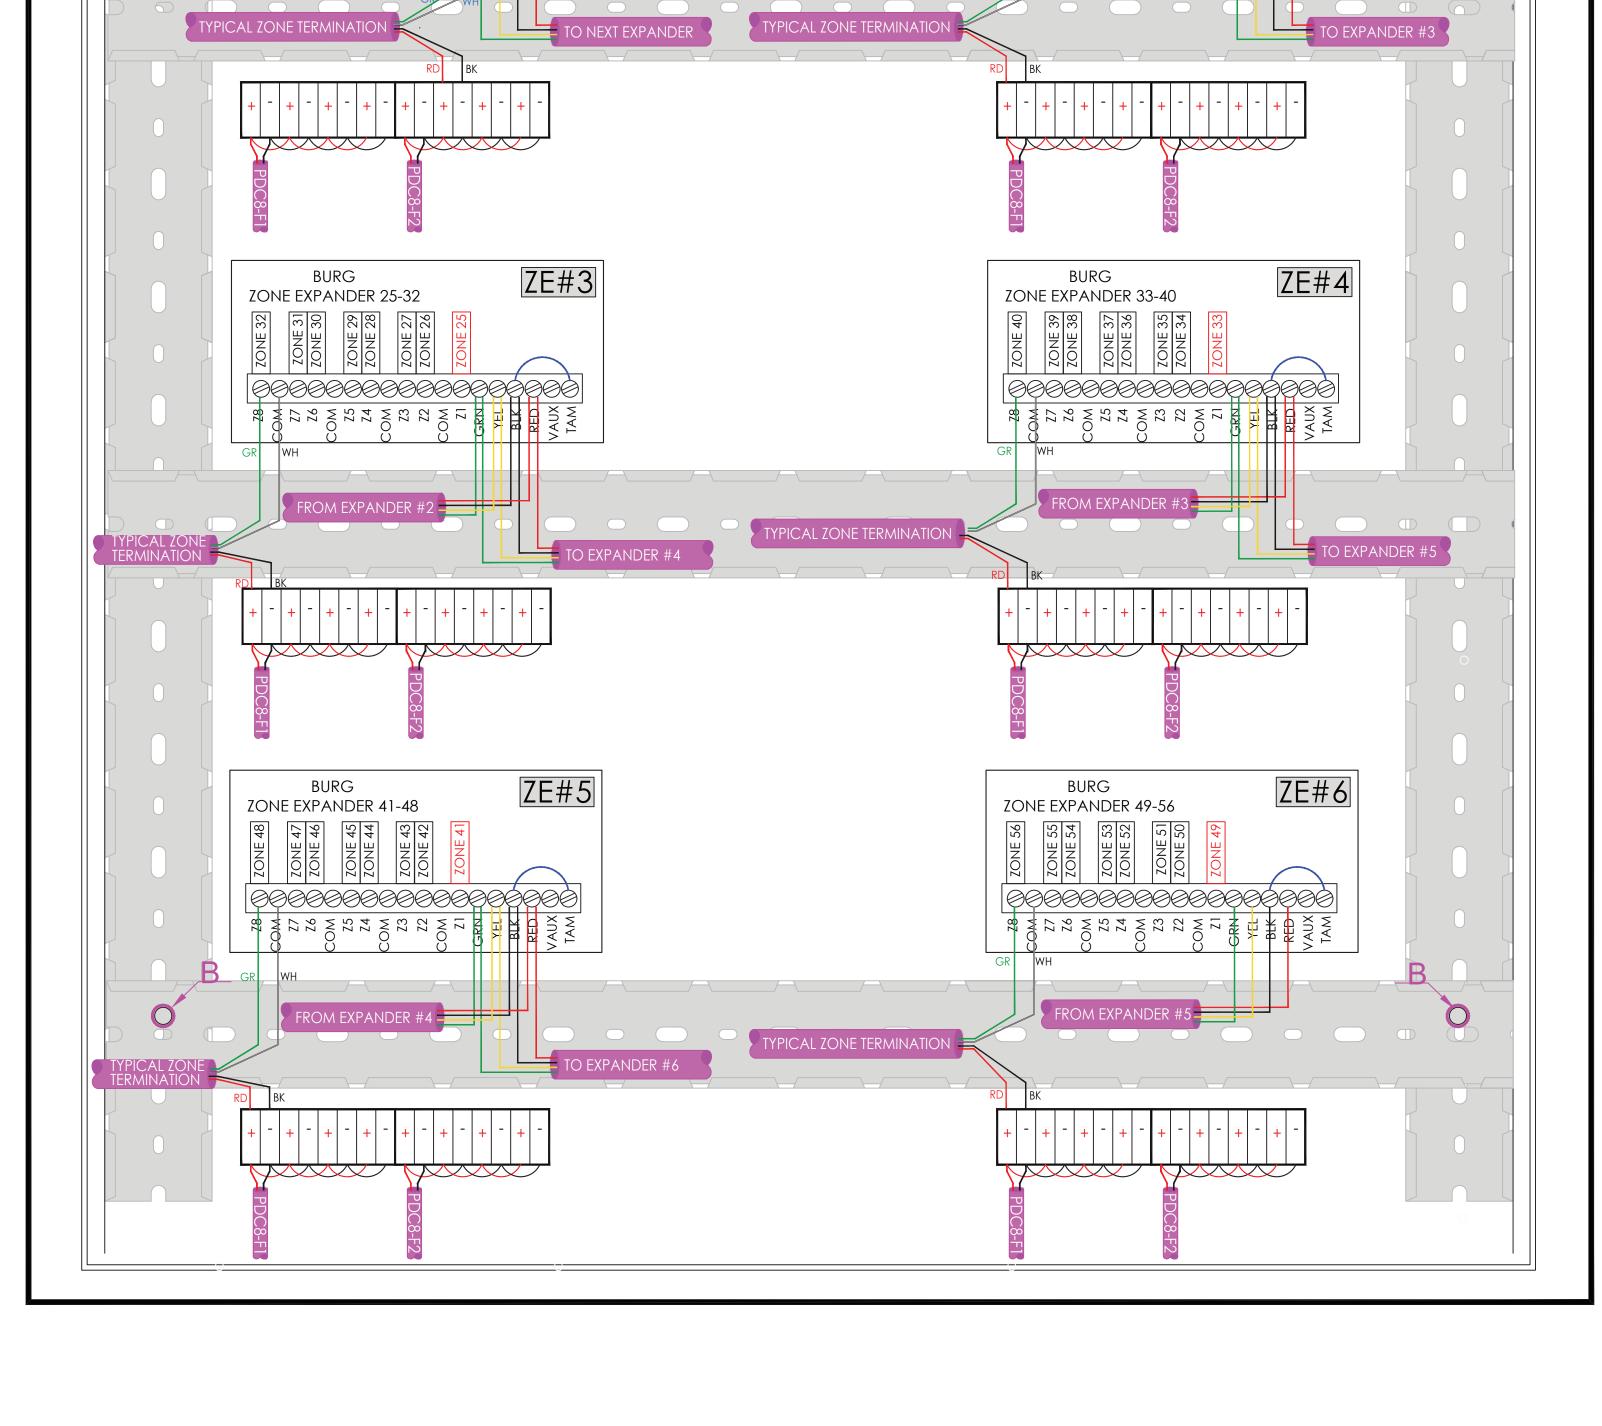

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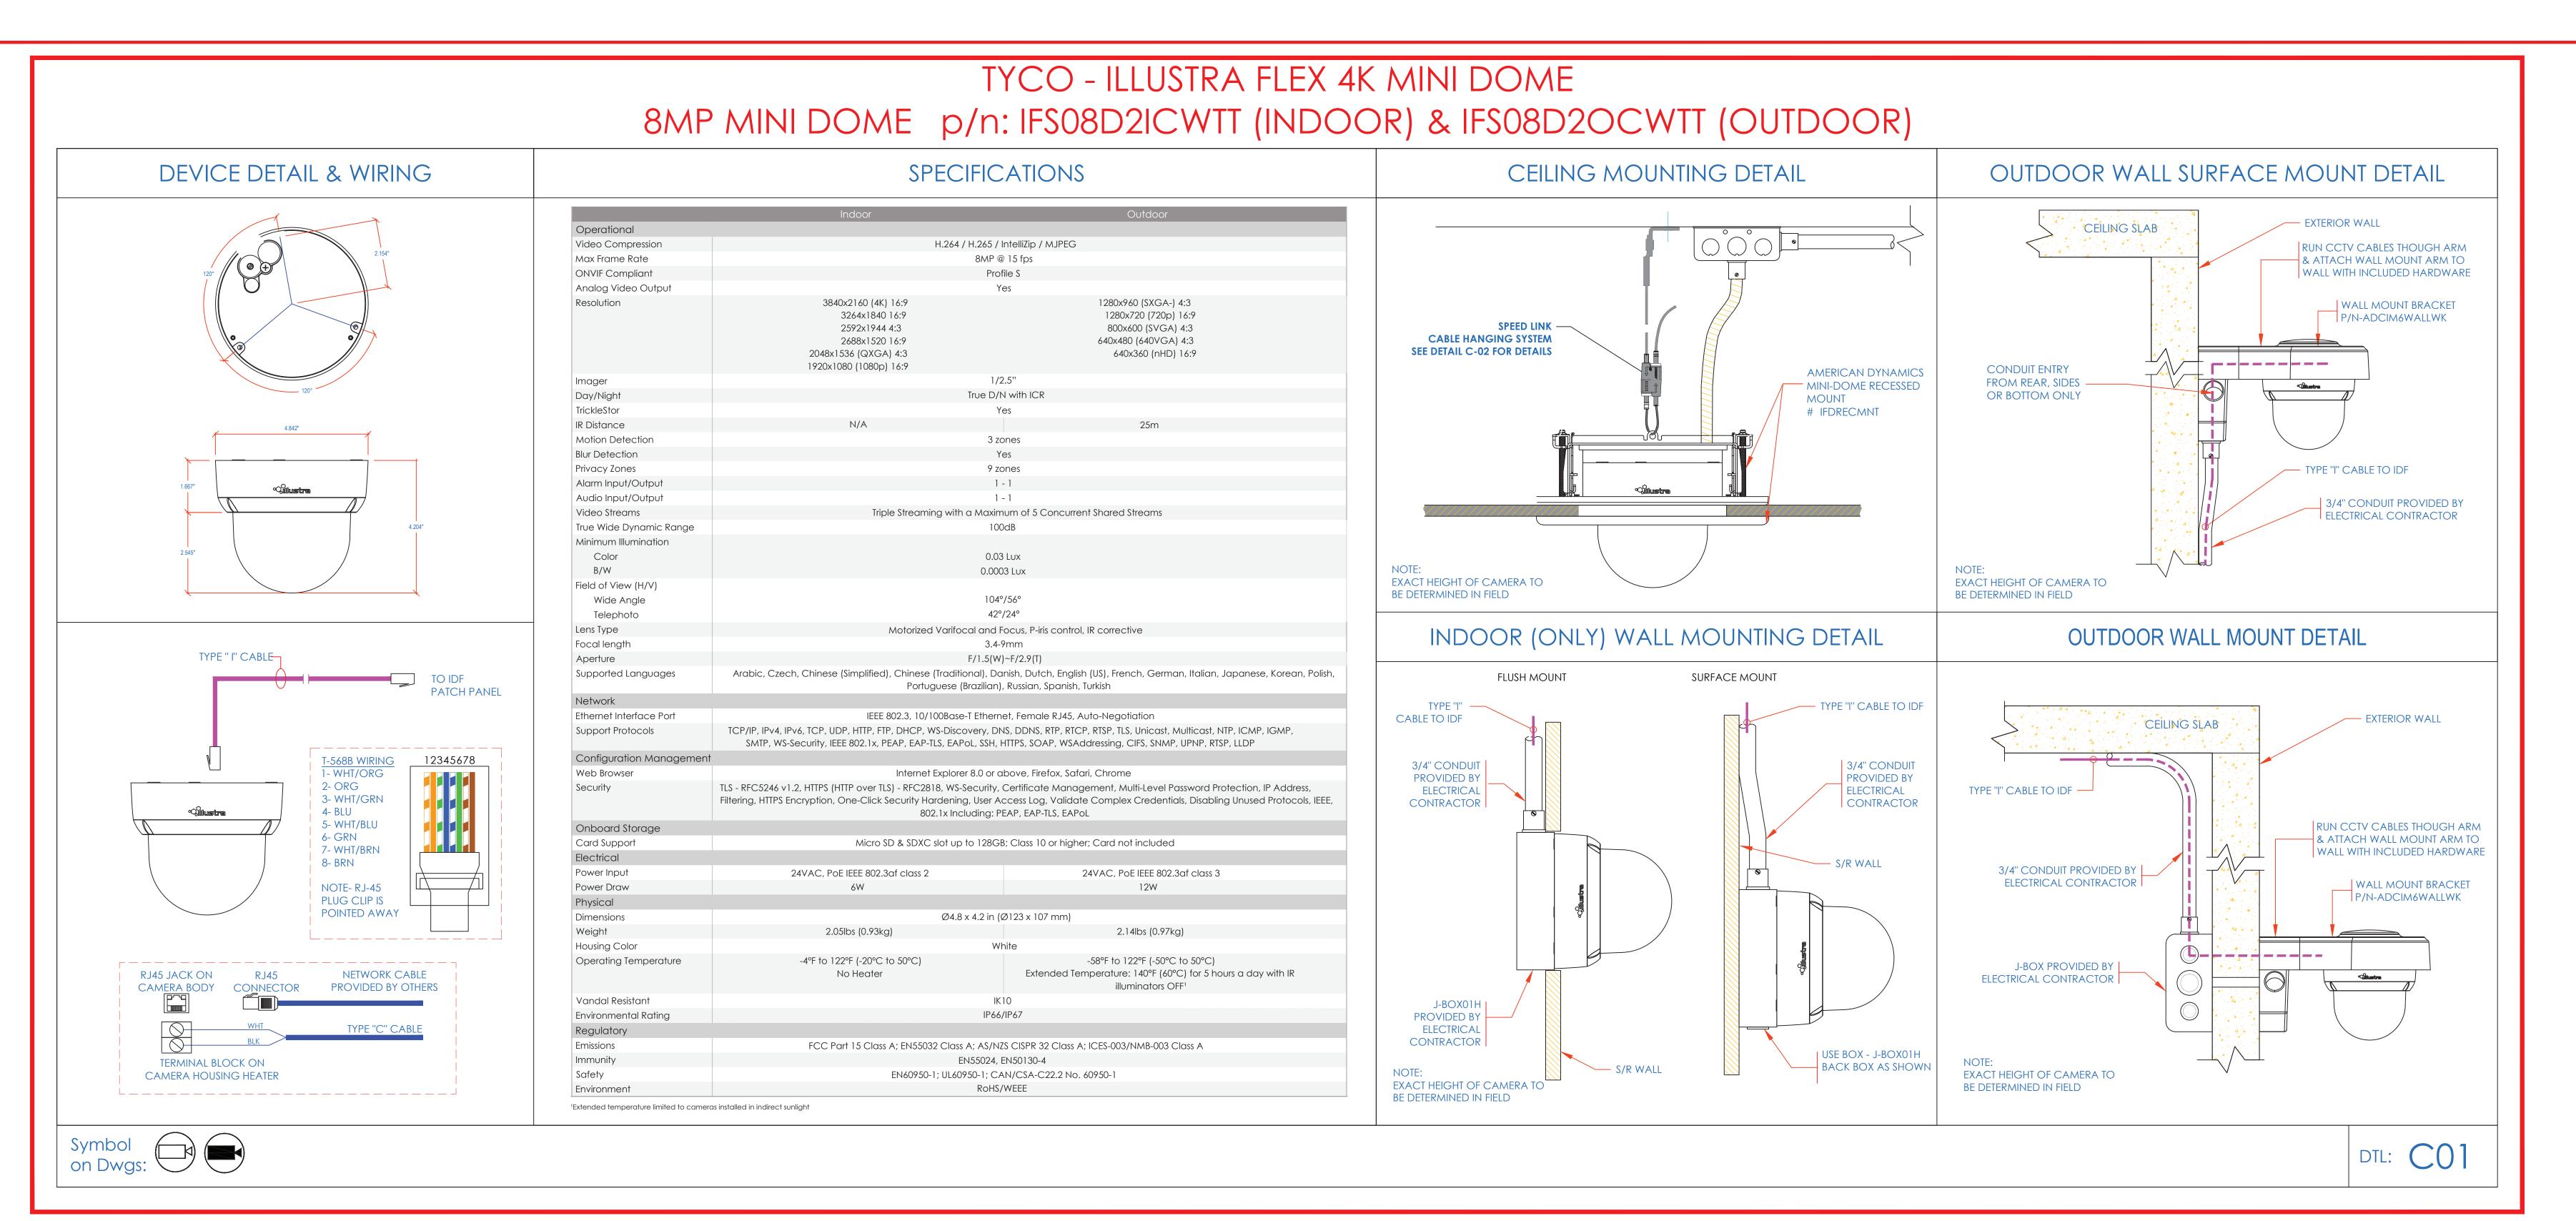
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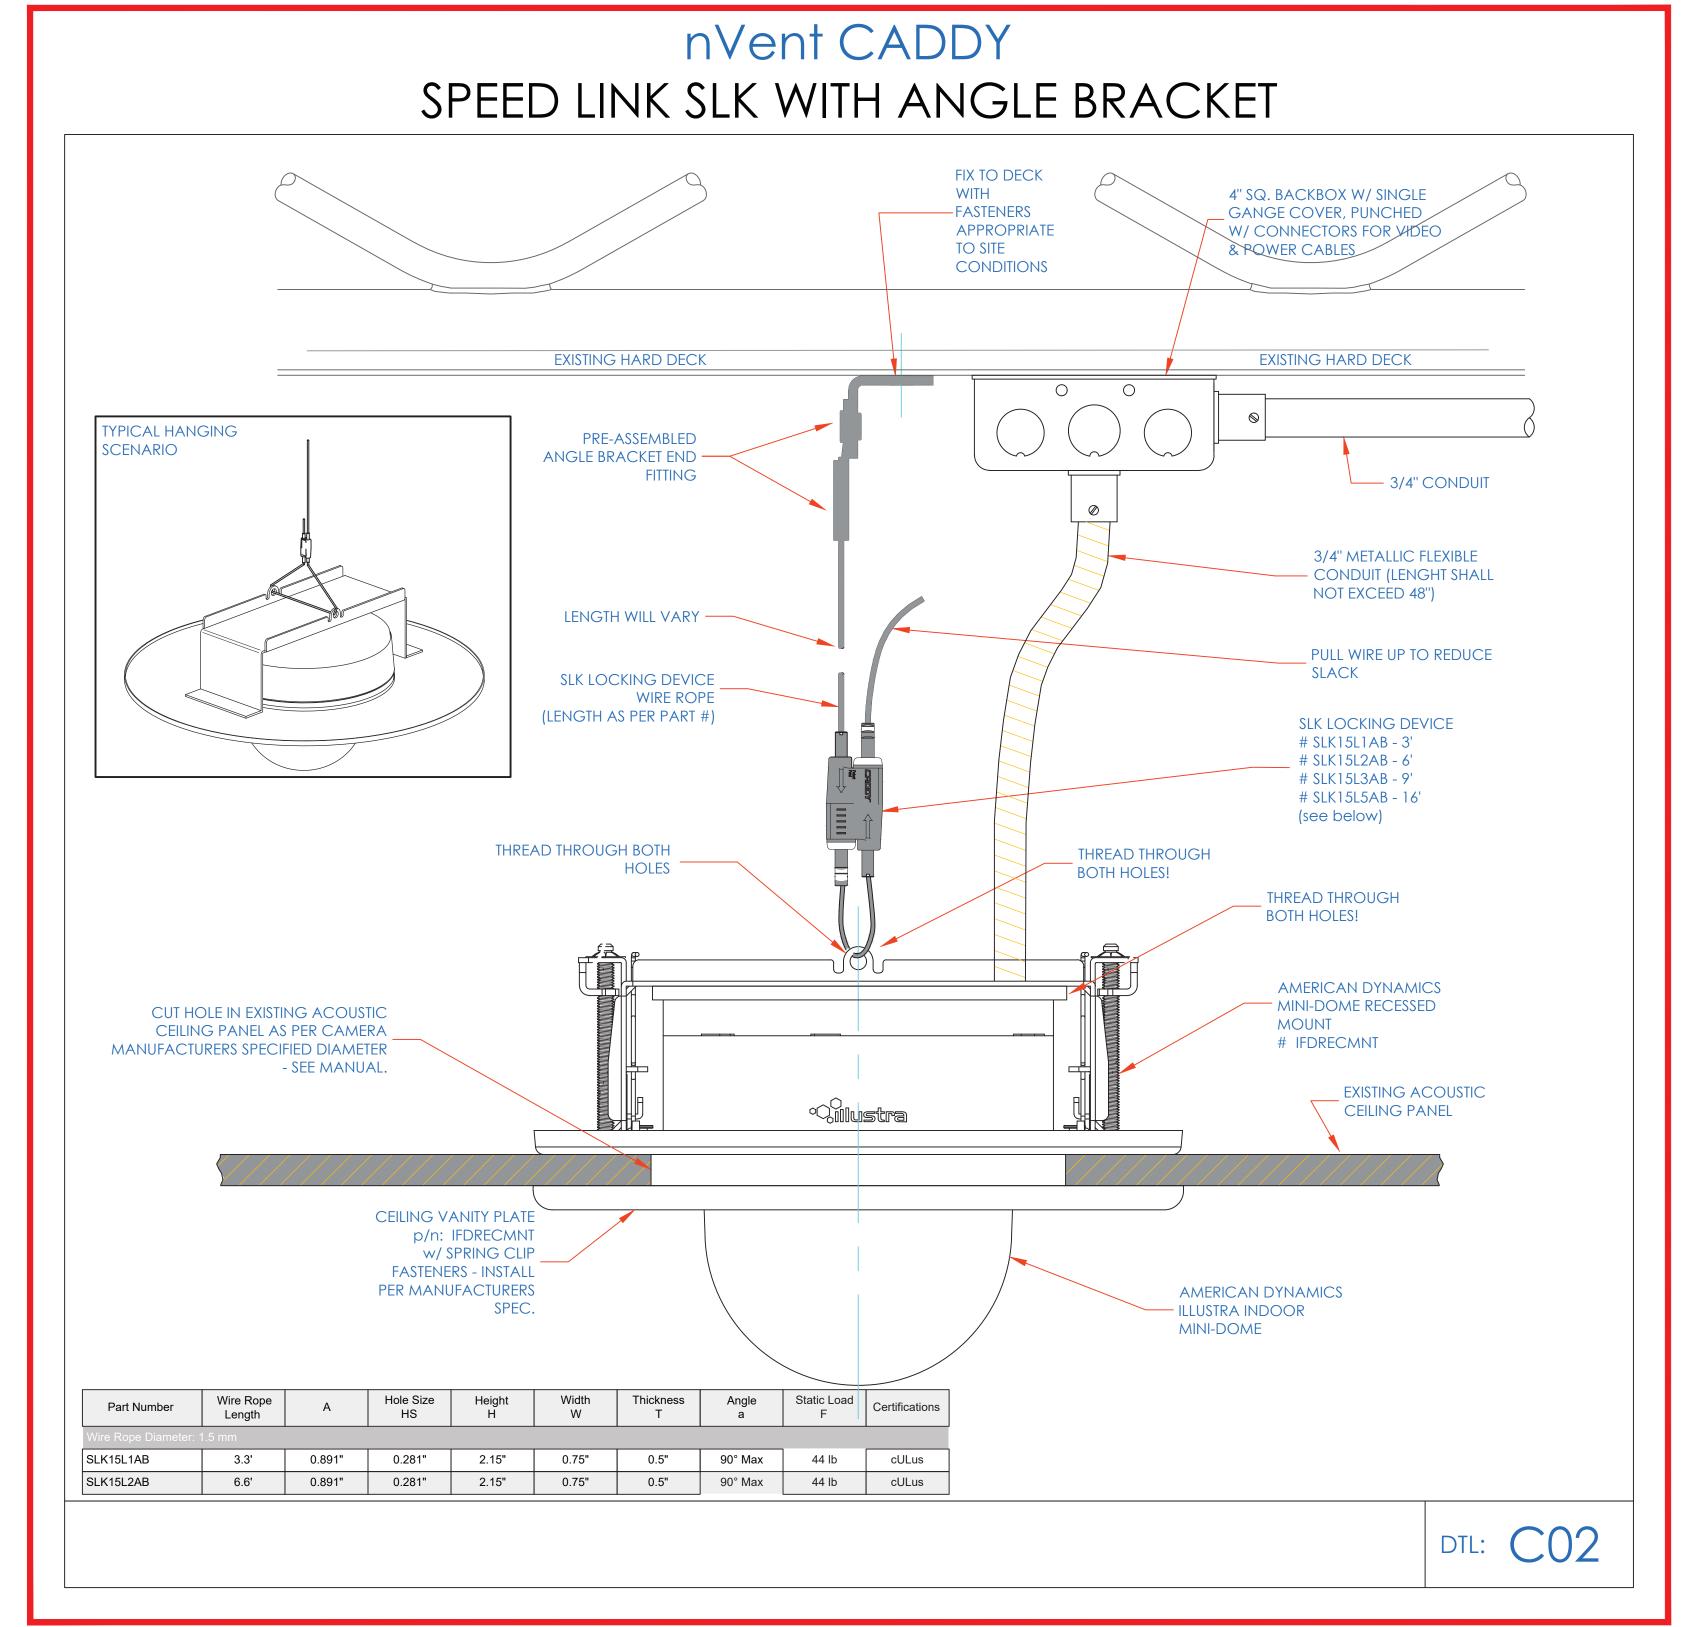
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YONKERS, NY 10701

SECURITY EQUIPMENT DETAIL 4

BURG DEVICE TYPICALS		
I.T.	C.A.	E.M.
DESIGNED BY	DRAWN BY	CHECKED BY
WORK ORDER NO:	DATE: 1	1/27/2019
XXXXXX	scale: N	.T.S.





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SYSTEM PROGRAMMING ONLY.

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COMMISSIONING. ITG'S ROLE IS LIMITED TO

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PROJECT:

RIVERSIDE HIGH SCHOOL

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SECURITY EQUIPMENT DETAIL 5
CCTV TYPICALS

I.T.	C.A.	E.M.
DESIGNED BY	DRAWN BY	CHECKED BY
WORK ORDER NO:	DATE: 1	1/27/2019
XXXXXX	SCALE: NO SCALE	
S.A. NO:	DRAWING I	NO:
XXXXXX	SE-	706