

GENERAL NOTES

1 THE CONTRACTOR SHALL PROTECT EXISTING SERVICES AND EQUIPMENT DURING THE WORK.

REMOVAL KEYED NOTES:	
R1	REMOVE EXISTING AIR HANDLER AND ALL ASSOCIATED DUCTWORK BACK TO EXTENT OF THE ROOM. REMOVE EXISTING CEILING SUPPORTS. REMOVE PIPING BACK TO MAIN AND CAP. REMOVE EXISTING CONTROL WIRING. PREPARE PIPING FOR NEW INSTALLATION.
R2	REMOVE EXISTING EXHAUST FAN. MC TO PROVIDE AND INSTALL CAP AND INSULATION ON EXISTING ROOF CURB. EXISTING FLASHING ON FAN CURB IS HOT WITH ASBESTOS, AVOID CONTACT. REFER TO DETAIL 8/MS-H501
R3	DISCONNECT AND REMOVE EXISTING FIN TUBE HEATERS AND ASSOCIATED HOT WATER SUPPLY/RETURN PIPING
R4	EXISTING O.A. LOUVERS TO BE REMOVED BY M.C. G.C. TO PROVIDE NEW WINDOWS TO MATCH EXISTING

ARCHITECT



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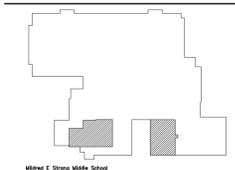
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SED CONTROL NUMBERS

YHS - #66-24-02-06-0-005-028
MS - #66-24-02-06-0-007-027
CES - #66-24-02-06-0-003-022
MES - #66-24-02-06-0-004-025
BES - #66-24-02-06-0-002-020



DISTRICT WIDE
IMPROVEMENTS 2020
PHASE II

MILDRED E. STRANG
MIDDLE SCHOOL
2701 CROMPOND RD.
YORKTOWN HEIGHTS, NY 10598

REVISIONS

No.	Description	Date

ISSUED: BID ISSUE


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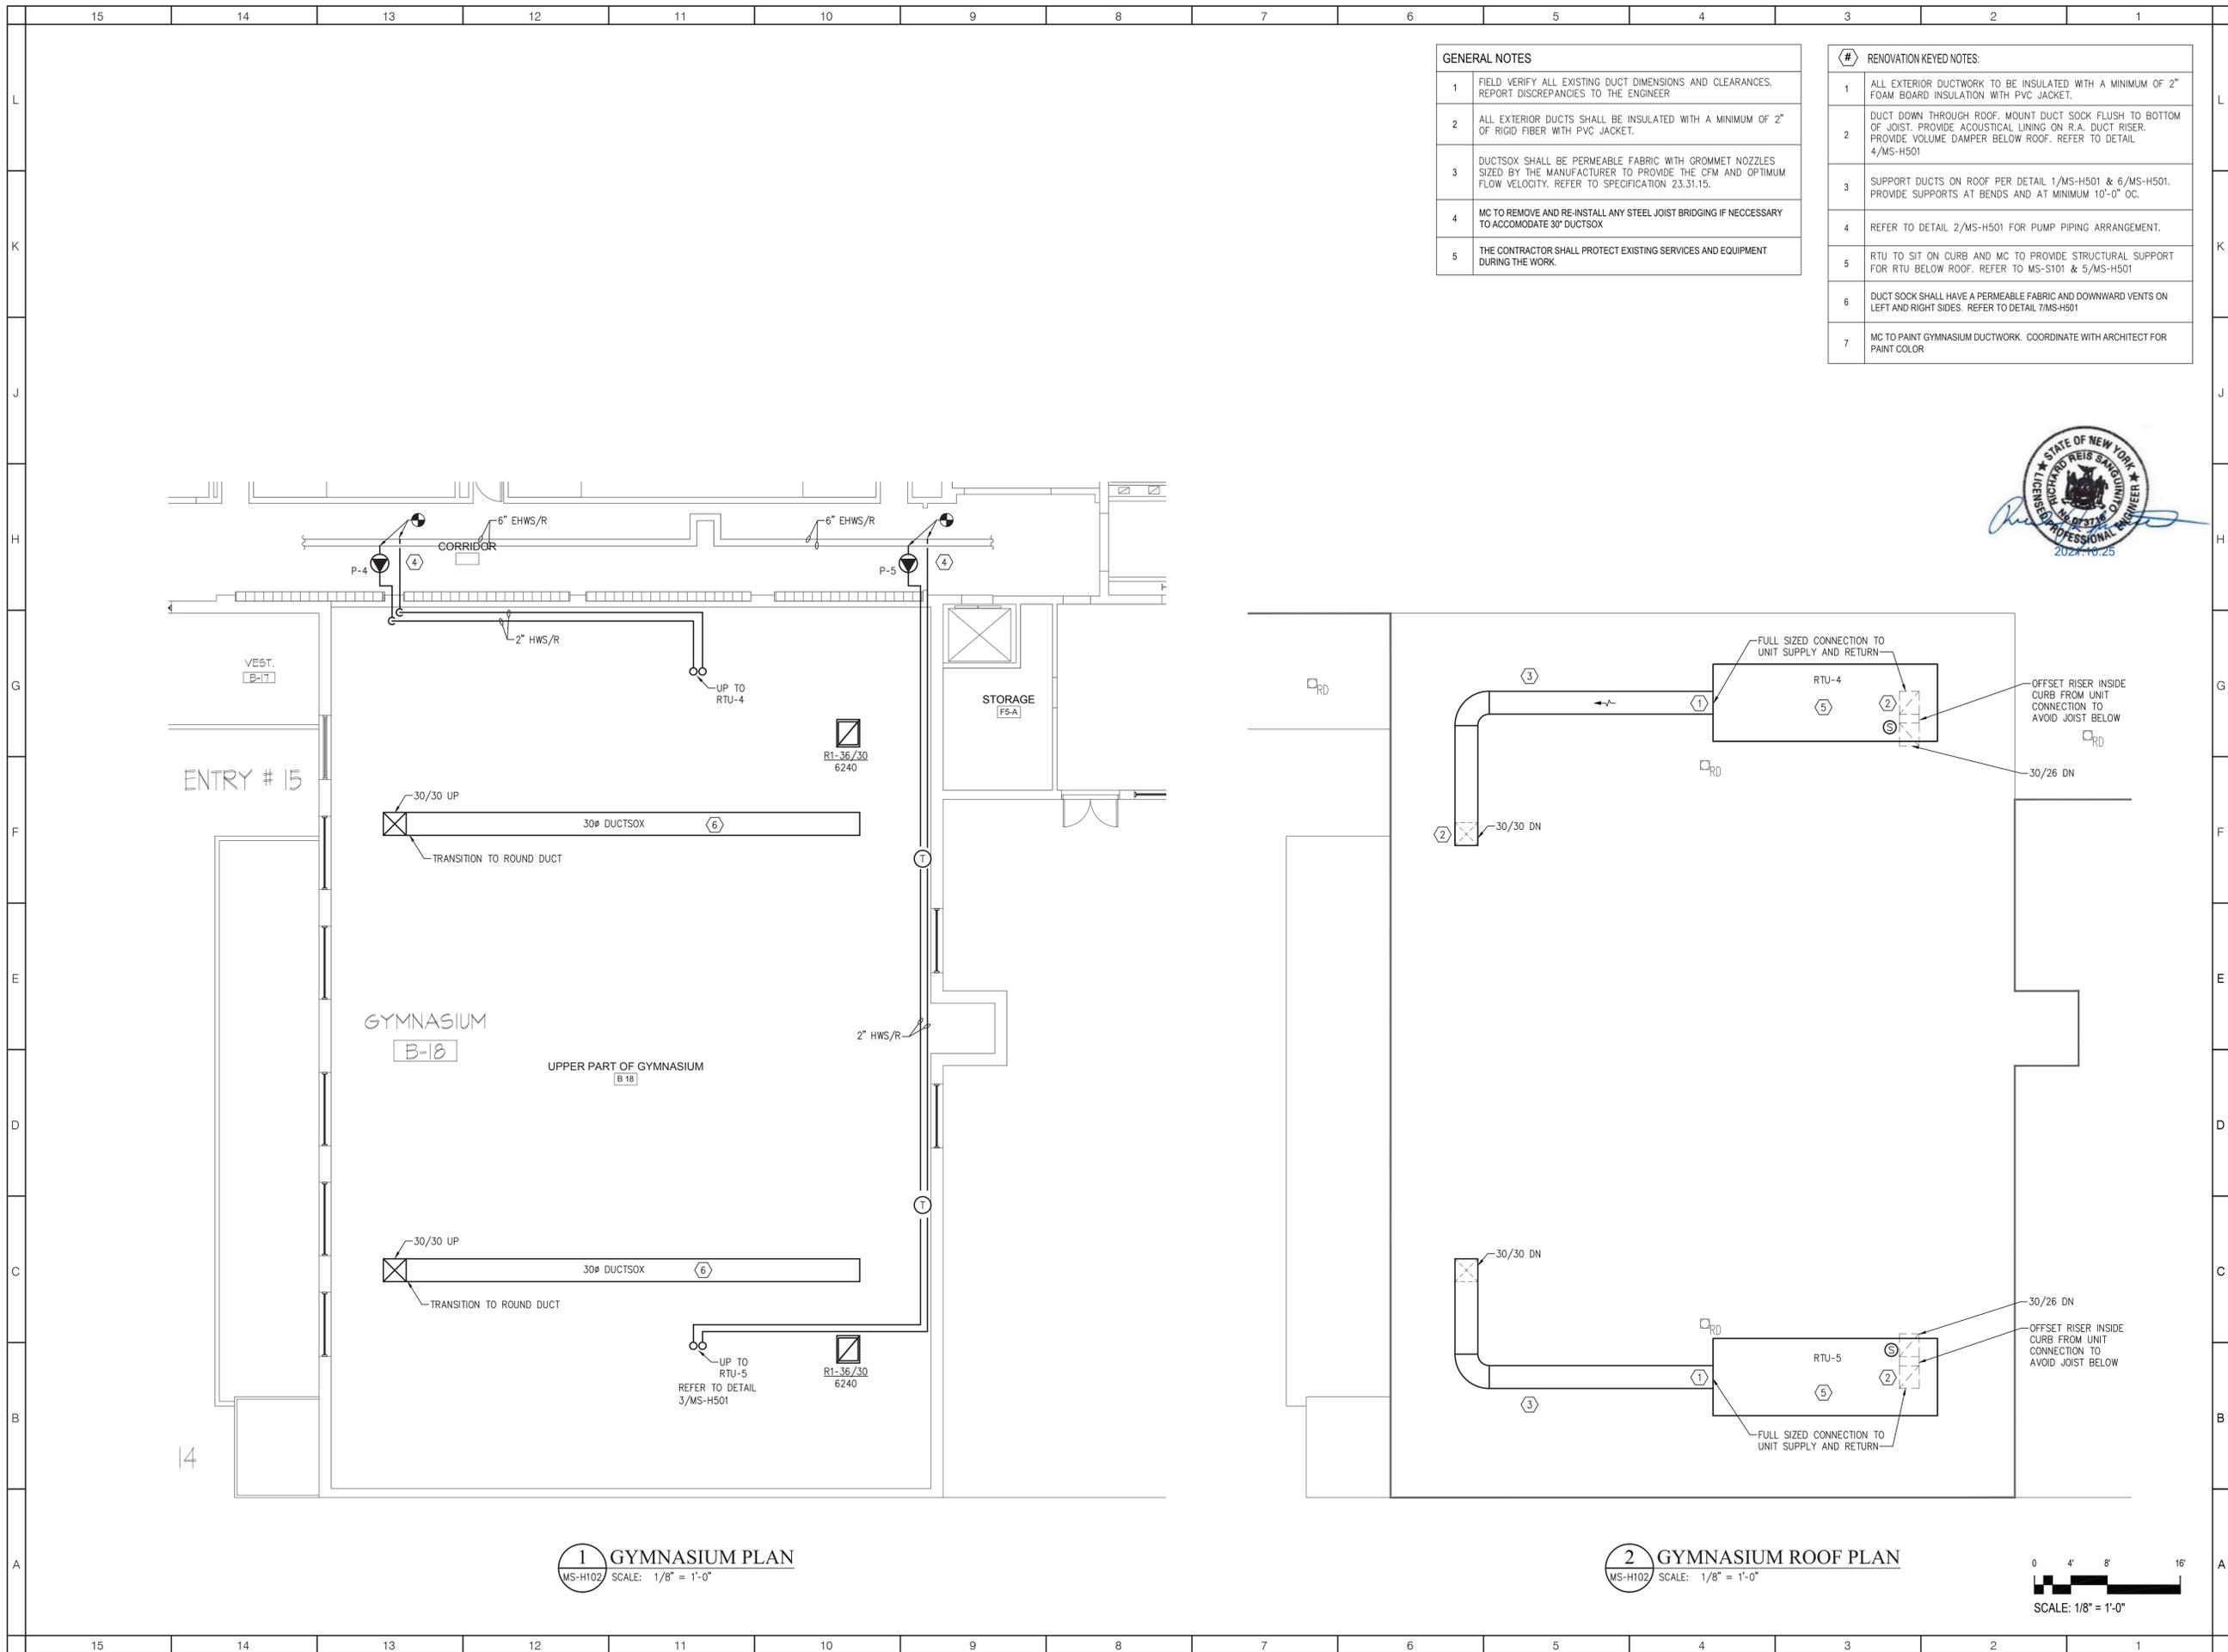
SCALE: AS NOTED

SHEET NAME:
GYMNASIUM REMOVAL
PLAN

SHEET NUMBER:

MS-H101



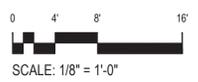

GENERAL NOTES	
1	FIELD VERIFY ALL EXISTING DUCT DIMENSIONS AND CLEARANCES. REPORT DISCREPANCIES TO THE ENGINEER
2	ALL EXTERIOR DUCTS SHALL BE INSULATED WITH A MINIMUM OF 2" OF RIGID FIBER WITH PVC JACKET.
3	DUCTSOX SHALL BE PERMEABLE FABRIC WITH GROMMET NOZZLES SIZED BY THE MANUFACTURER TO PROVIDE THE CFM AND OPTIMUM FLOW VELOCITY. REFER TO SPECIFICATION 23.31.15.
4	MC TO REMOVE AND RE-INSTALL ANY STEEL JOIST BRIDGING IF NECESSARY TO ACCOMMODATE 30" DUCTSOX
5	THE CONTRACTOR SHALL PROTECT EXISTING SERVICES AND EQUIPMENT DURING THE WORK.

# RENOVATION KEYED NOTES	
1	ALL EXTERIOR DUCTWORK TO BE INSULATED WITH A MINIMUM OF 2" FOAM BOARD INSULATION WITH PVC JACKET.
2	DUCT DOWN THROUGH ROOF. MOUNT DUCT SOCK FLUSH TO BOTTOM OF JOIST. PROVIDE ACOUSTICAL LINING ON R.A. DUCT RISER. PROVIDE VOLUME DAMPER BELOW ROOF. REFER TO DETAIL 4/MS-H501
3	SUPPORT DUCTS ON ROOF PER DETAIL 1/MS-H501 & 6/MS-H501. PROVIDE SUPPORTS AT BENDS AND AT MINIMUM 10'-0" OC.
4	REFER TO DETAIL 2/MS-H501 FOR PUMP PIPING ARRANGEMENT.
5	RTU TO SIT ON CURB AND MC TO PROVIDE STRUCTURAL SUPPORT FOR RTU BELOW ROOF. REFER TO MS-S101 & 5/MS-H501
6	DUCT SOCK SHALL HAVE A PERMEABLE FABRIC AND DOWNWARD VENTS ON LEFT AND RIGHT SIDES. REFER TO DETAIL 7/MS-H501
7	MC TO PAINT GYMNASIUM DUCTWORK. COORDINATE WITH ARCHITECT FOR PAINT COLOR



ARCHITECT

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CES -	#66-24-02-06-0-003-022
MES -	#66-24-02-06-0-004-025
BES -	#66-24-02-06-0-002-020



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IMPROVEMENTS 2020
PHASE II

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MIDDLE SCHOOL
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YORKTOWN HEIGHTS, NY 10598

REVISIONS		
No.	Description	Date

ISSUED: BID ISSUE
DATE: 10/25/2021
SCALE: AS NOTED
SHEET NAME:
GYMNASIUM RENOVATION
PLANS

SHEET NUMBER:
MS-H102



DISTRICT WIDE
IMPROVEMENTS 2020
PHASE II

MILDRED E. STRANG
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2701 CROMPOND RD.
YORKTOWN HEIGHTS, NY 10598

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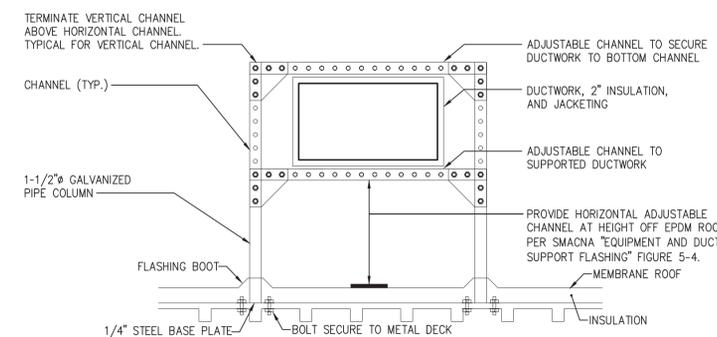
SCALE: AS NOTED

SHEET NAME:

DETAILS & SCHEDULES


SHEET NUMBER:

MS-H501



NOTE: SEE SPECIFICATION 23 05 40 "HANGER & SUPPORTS"
NOTE: ADD WIND RESTRAINTS AS NEEDED.
NOTE: SUPPORT DUCTWORK EVERY 10 FT. EVERY OTHER DUCT SUPPORT MAY BE MOUNTED ON FEET DIRECTLY ON ROOF MEMBRANE INSTEAD OF BEING ANCHORED TO THE ROOF DECK.
NOTE: REFER TO 6/MS-H501


1 DUCTWORK ROOF SUPPORT DETAIL 1 (ANCHORED)
MS-H501 SCALE: NOT TO SCALE

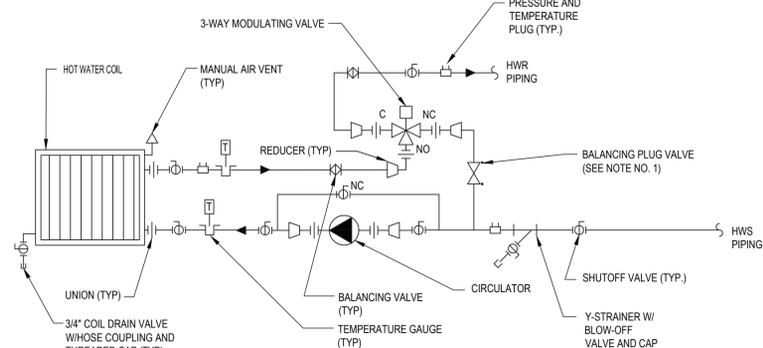


SEQUENCE OF OPERATION
1. PUMP STARTS ON CALL FOR HEAT AND 3-WAY VALVE SHALL MODULATE TO MAINTAIN SPACE TEMPERATURE WITHOUT CYCLING.
2. FREEZE PROTECTION OVERRIDE, OF OA TEMPERATURE <35° PUMP IS ON 3-WAY OPENS TO BYPASS IF NOT HEATING.

NOTE
1. SET BALANCING VALVES TO EQUAL THE PRESSURE DROP ACROSS THE HYDRONIC COIL

2 3-WAY COIL DETAIL
MS-H501 SCALE: NOT TO SCALE

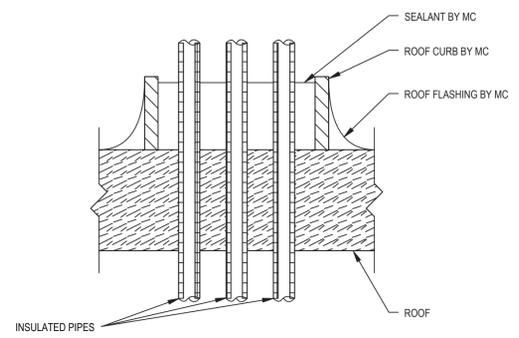


3 ROOF PIPING PENETRATION DETAIL
MS-H501 SCALE: NOT TO SCALE

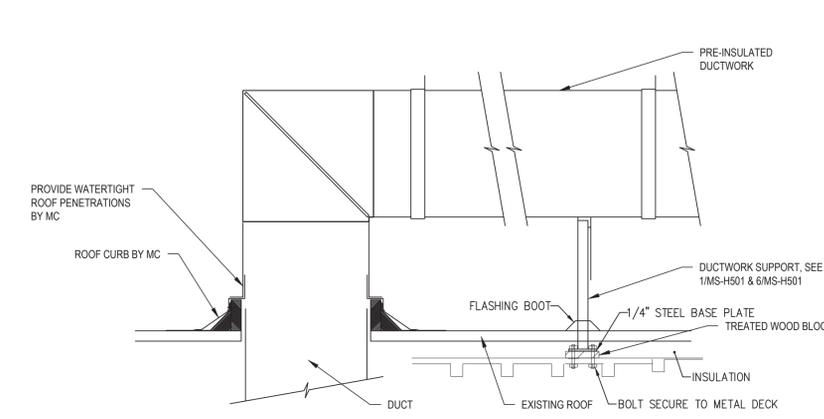


NOTE: MC TO REMOVE ROOFING AND INSULATION AS REQUIRED AND ROOFING CONTRACTOR TO REPAIR ROOFING AND INSULATION PER ROOFING MANUFACTURERS REQUIREMENTS.


4 DUCTWORK ROOF PENETRATION AND SUPPORT DETAIL
MS-H501 SCALE: NOT TO SCALE

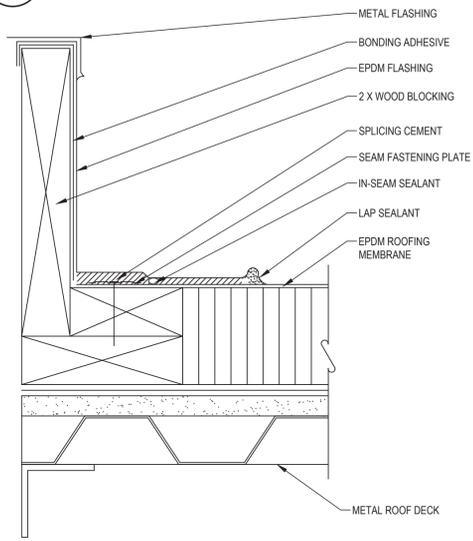


5 RTU ROOF CURB DETAIL
MS-H501 SCALE: NOT TO SCALE

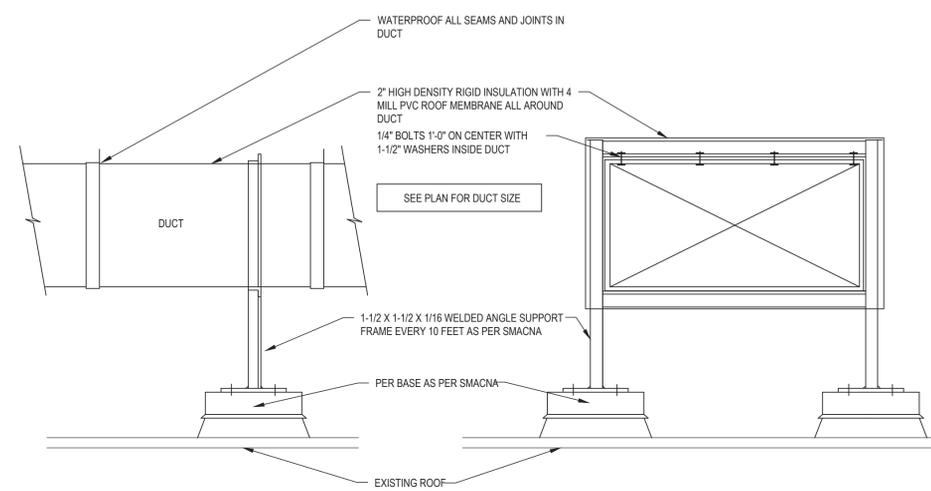

6 DUCTWORK ROOF SUPPORT DETAIL 2 (UN-ANCHORED)
MS-H501 SCALE: NOT TO SCALE

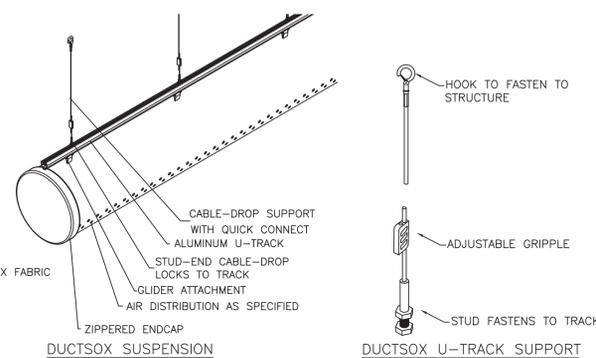

7 DUCTSOX SUSPENSION DETAIL
MS-H501 SCALE: NOT TO SCALE

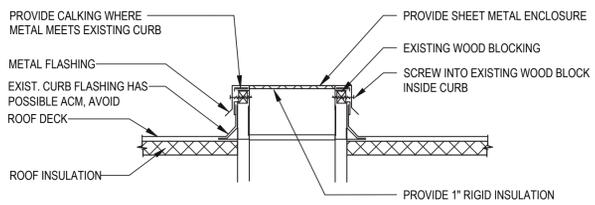

8 ROOF CURB CAP DETAIL
MS-H501 SCALE: NOT TO SCALE

VENTILATION REQUIREMENTS

Space Designation	Area Area SF	Occupants /1000 SF	Total	Ventilation Required		Uncorrected Ventilation	Efficiency Factor	Corrected CFM
				Per Occup.	Per SF			
MS Gym	6,100	7	43	20.00	0.18	1,950	80%	2,440
Total	6,100		43			1,950	80%	2,440

PUMP SCHEDULE

TAG	SERVICE	TYPE	FLUID	GPM	HEAD	RPM	ELECTRICAL		DISCONNECT		
							HP	VOLTS/PH/HZ	TYPE	FURNISHED BY	INSTALLED BY
P-4	RTU-4	IN-LINE CIRC.	HW	15	23	1725	3/4	120/1/60	SWITCH	EC	EC
P-5	RTU-5	IN-LINE CIRC.	HW	15	23	1725	3/4	120/1/60	SWITCH	EC	EC

ROOFTOP AIR-CONDITIONING UNIT SCHEDULE

TAG	SERVICE	TYPE	AIRFLOW (CFM)	OUTSIDE AIR (CFM)	SUPPLY FAN				EXHAUST FAN				CAPACITY				DX COOLING				HEATING				NOTES	BASIS OF DESIGN					
					ESP (IN. WG)	TOTAL SP (IN. WG)	FAN TYPE	HP	ESP (IN. WG)	TOTAL SP (IN. WG)	FAN TYPE	HP	IEER	NOMINAL TONNAGE	TOTAL (MBH)	SENS. (MBH)	LATENT (MBH)	DRY BULB (°F)	WET BULB (°F)	DRY BULB (°F)	WET BULB (°F)	ENTERING WATER (°F)	LEAVING WATER (°F)	ENTERING AIR DRY BULB (°F)			LEAVING AIR DRY BULB (°F)	GPM	WATER PD (FT)	AIR PD (IN)	OUTPUT MBH
RTU-4	GYMNASIUM	RTU	6250	1300	1.5	3	PLENUM	7.5	.75	PLENUM	5	14.2	16	200.18	166.83	33	79	64.76	53.8	53.64	180	150	59.4	99	15	1.1	0.5	276	HW	1,2,3,4,5,6	AAON
RTU-5	GYMNASIUM	RTU	6250	1300	1.5	3	PLENUM	7.5	.75	PLENUM	5	14.2	16	200.18	166.83	33	79	64.76	53.8	53.64	180	150	59.4	99	15	1.1	0.5	276	HW	1,2,3,4,5,6	AAON

- COORDINATE SIZE AND LOCATION OF UNIT WITH EXISTING FRAMING. MOUNT/SECURE/ANCHOR UNIT ON DUNNAGE PROVIDED BY GC.
- COORDINATE SIZE AND LOCATION OF ROOF PENETRATIONS WITH GC FOR SUPPLY AND RETURN DUCT.
- ALL WORK IS BY MC (ABATEMENT, STEEL, CURBS, ROOF FLASHING, ETC.), ONLY ITEM EXCLUDED IS ELECTRICAL BY EC.
- PROVIDE SMOKE DETECTOR IN RETURN AIR STREAM
- PROVIDE 2 STAGE FILTER; 2" MERV-8 & 4" MERV-14
- RTU SHALL HAVE A FRONT, HORIZONTAL DISCHARGE AND BOTTOM, VERTICAL RETURN

