GENERAL NOTES

- REMOVAL & RELOCATION OF CERTAIN EXISTING WORK SHALL BE NECESSARY FOR THE PERFORMANCE OF THE NEW WORK SHOWN HEREIN. ALL EXISTING CONDITIONS ARE NOT COMPLETELY DETAILED ON THE DRAWINGS. THE CONTRACTOR SHALL SURVEY THE SITE & MAKE ALL NECESSARY CHANGES BASED ON EXISTING CONDITIONS AS REQUIRED FOR PROPER DEMOLITION OF EXISTING WORK & SHALL INCLUDE ALL MATERIALS & LABOR FOR SAME IN HIS BID PRICE. NO ALLOWANCE WILL BE MADE FOR FAILURE TO DO SO.
- PRIOR TO SUBMITTING A BID, THE CONTRACTOR SHALL VISIT THE PREMISES OF THE PROPOSED WORK & SHALL CAREFULLY EXAMINE THE ENGINEERING DRAWINGS. EXISTING CONDITIONS & LIMITATIONS THEREOF. VERIFY ACTUAL LOCATIONS WHERE THE NEW PIPING WILL BE ROUTED, COORDINATE WITH NEW & EXISTING WORK & PROVIDE CLEARANCE W/ BUILDING STRUCTURE, OTHER SERVICES, ETC.. THE CONTRACTOR SHALL INCLUDE ALL COSTS WHATSOEVER WHICH ARE INCURRED AS A RESULT OF LIMITATIONS OF THE EXISTING & NEW CONDITIONS. LATER CLAIMS FOR EXTRA LABOR, EQUIPMENT, MATERIALS, ETC. REQUIRED DUE TO DIFFICULTIES WHICH COULD HAVE BEEN FORESEEN WILL NOT BE CONSIDERED AS EXTRA WORK.
- INSTALL WORK SO AS TO BE READILY ACCESSIBLE FOR OPERATING, MAINTENANCE & REPAIR. MINOR DEVIATIONS FROM DRAWINGS MAY BE MADE TO ACCOMPLISH THIS, BUT CHANGES OF MAGNITUDE WHICH INVOLVE EXTRA COST SHALL NOT BE MADE WITHOUT APPROVAL.
- INVESTIGATE EACH SPACE THROUGH WHICH EQUIPMENT MUST BE MOVED. WHEN NECESSARY, EQUIPMENT SHALL BE SHIPPED FROM MANUFACTURER IN CRATED SECTIONS OF SIZE SUITABLE FOR MOVING THROUGH AREAS AVAILABLE. ASCERTAIN FROM BUILDING OWNER AT WHAT TIMES OF DAY EQUIPMENT MAY BE MOVED THROUGH THE BUILDING.
- COORDINATE THE EXACT SIZE & LOCATION OF NEW OPENINGS WITH EXISTING STRUCTURE. PATCH / INSULATE AS REQUIRED. CONTRACTOR SHALL FIRESTOP ALL PENETRATIONS FROM NEW PIPING, CONDUIT, DUCTWORK, ETC. THROUGH EXISTING OR NEW FIRE/ SMOKE BARRIERS. REFER TO SPECIFICATION SECTION 15511 FOR FURTHER DETAILS.
- IT IS THE INTENT OF THIS CONTRACT FOR REMAINING SYSTEMS TO BE LEFT IN GOOD WORKING ORDER. READY FOR OPERATION. COORDINATE ANY REQUIRED SYSTEM SHUTDOWNS WITH OWNER 48 HOURS IN ADVANCE. EXISTING SYSTEM SHUTDOWNS WILL NOT BE PERMITTED IF THEY INTERFERE WITH THE DAILY OPERATIONS OF THE BUILDING. CONTRACTOR WILL BE REQUIRED TO TAKE PROPER PRECAUTIONS AGAINST DAMAGING OR DISRUPTING BUILDING SYSTEMS, WIRING, PIPING OR CONTROL TUBING. ANY DAMAGE TO THESE ITEMS SHALL BE REPAIRED AT THE CONTRACTOR'S COST AS A PART OF THIS
- THE CONTRACTOR SHALL REPAIR / RESTORE TO ORIGINAL CONDITION ANY EXISTING EQUIPMENT OR MATERIALS DAMAGED IN THE PROCESS OF INSTALLATION, OR DEMOLITION TO THE SATISFACTION OF THE OWNER'S REPRESENTATIVE. CONTRACTOR SHALL MAKE REPAIRS USING THE SAME OR EQUIVALENT MATERIALS. WORK WILL BE PERFORMED AT THE CONTRACTOR'S COST.
- CONTRACTOR SHALL INCUR ANY COSTS OR BURDENS ASSOCIATED WITH LOST OR STOLEN EQUIPMENT /
- DURING THE LIFE OF THE CONTRACT PERIOD, CONTRACTOR SHALL REMOVE ALL RUBBISH / EXCESS MATERIAL ACCUMULATED AS A RESULT OF HIS OPERATIONS ON A DAILY BASIS. ALL AREAS / EQUIPMENT AFFECTED UNDER THIS CONTRACT SHALL BE KEPT CLEAN OF DUST / DEBRIS. ALL AREAS SHALL RECEIVE A FINAL CLEANING PRIOR TO FINAL ACCEPTANCE BY THE OWNER.
- PROVIDE FOR LEGAL REMOVAL / DISPOSAL OF ALL RUBBISH / DEBRIS FROM THE BUILDING & SITE. PROTECT ALL WORK NOT SLATED FOR DEMOLITION.
- THIS CONTRACTOR SHALL COORDINATE HIS WORK WITH ALL OTHER TRADES PRIOR TO SCHEDULING THE WORK. WORK SHALL BE PERFORMED IN PROPER SEQUENCE, AS AGREED TO BY ALL TRADES. ANY COSTS INCURRED BY THE OWNER DUE TO IMPROPER SEQUENCING OF WORK WILL BE PAID FOR BY THIS
- CONTRACTOR SHALL OBTAIN ALL PERMITS, PAY ALL FEES, CONNECTION CHARGES, ETC. ASSOCIATED
- PAINT / TOUCH UP ALL SURFACES MARRED AS A RESULT OF THE PERFORMANCE OF THE CONTRACT
- THE MECHANICAL CONTRACTOR SHALL REFER TO / REVIEW ALL OTHER TRADE DRAWINGS IN THE BID PACKAGE & SHALL BE RESPONSIBLE FOR / PERFORM ALL WORK INDICATED AS (M.C.) MECHANICAL WORK AS A PART OF THE BASE BID UNLESS SPECIFICALLY NOTED OTHERWISE.
- SUBSTITUTED FOLIPMENT OF GREATER OR LARGER POWER DIMENSIONS CAPACITIES & RATINGS MAY BE FURNISHED PROVIDED THAT SAID EQUIPMENT IS APPROVED IN WRITING PRIOR TO ORDER. ANY CONNECTING MECHANICAL SERVICES, ELECTRICAL SERVICES, BASES, STRUCTURAL APPURTENANCES, ETC. REQUIRED TO BE INCREASED DUE TO THE USE OF SAID EQUIPMENT WILL BE PAID FOR IN FULL BY THE MECHANICAL CONTRACTOR, INCLUDING ANY ADDITIONAL REQUIRED ENGINEERING FEES.
- EACH PIECE OF EQUIPMENT SHALL BE PROVIDED WITH A PERMANENT TYPE LAMINATED, BLACK FINISH, WHITE CORE, PHENOLIC NAMEPLATE. NAMEPLATES SHOULD INDICATE THE NAME & NUMBER OF THE UNIT, UNIT VOLTAGE, & ANY INTERLOCK REFERENCE. STARTERS / DISCONNECT SWITCHES SHOULD ALSO BE EQUIPPED WITH AN IDENTICAL NAMEPLATE WITH THE SAME INFORMATION.
- "ATTIC STOCK" UPON COMPLETION OF THE PROJECT, MECHANICAL CONTRACTOR SHALL COMPLETELY REMOVE / DISPOSE OF FILTERS USED DURING CONSTRUCTION & START-UP PROCEDURES. INSTALL NEW FILTERS IN ALL EQUIPMENT, MERV-8 OR BETTER UPON TURN OVER OF THE PROJECT TO THE OWNER. IN ADDITION, PROVIDE (2) COMPLETE SETS OF FILTERS FOR EACH PEICE OF EQUIPMENT & TURN OVER TO
- MECHANICAL CONTRACTOR SHALL PROVIDE (1) SPARE MOTOR FOR EACH SIZE MOTOR USED ON THE PROJECT. IN INSTANCES WHERE MORE THAN TEN OF THE SAME MOTOR ARE USED, MECHANICAL CONTRACTOR SHALL PROVIDE (1) SPARE MOTOR FOR EVERY TEN MOTORS OF A GIVEN SIZE USED ON THE
- MAINTENANCE MANUAL: UPON COMPLETION OF THE PROJECT, THE MECHANICAL CONTRACTOR SHALL PROVIDE A BINDER CONTAINING THE OPERATIONS & MAINTENANCE MANUALS FOR EACH NEW PEICE OF EQUIPMENT INSTALLED UNDER THIS PROJECT. THE FIRST SECTION OF THE MAINTENANCE MANUAL SHALL CONTAIN A LIST OF EACH PEICE OF EQUIPMENT, COMPLETE WITH INFORMATION SHOWING APPROPRIATE REPLACEMENT FILTER SIZES / TYPES, APPROPRIATE REPLACEMENT BELT SPECIFICATIONS, REPLACEMENT MOTOR SPECIFICATIONS, REPLACEMENT BEARING SPECIFICATIONS, VOLTAGES OF UNIT, ETC. THIS SHALL SERVE AS A WRITTEN DATABASE DESCRIBING ALL MAINTENANCE INFORMATION FOR EACH NEW PEICE OF

BOILER ROOM and PIPING NOTES

- THE DRAWINGS SHOW THE GENERAL ARRANGEMENT OF ALL PIPING & EQUIPMENT, & INDICATE THE REQUIRED SIZE / POINTS OF TERMINATION OF THE PIPING & SUGGEST PROPER ROUTING OF SAME. IT IS NOT THE INTENTION OF THE DRAWINGS TO SHOW ALL NECESSARY OFFSETS, RISES, DROPS, OBSTRUCTIONS OR STRUCTURAL CONDITIONS. IT SHALL BE THE RESPONSIBILITY OF THIS CONTRACTOR TO INSTALL HIS WORK IN SUCH A MANNER THAT IT WILL CONFORM TO THE STRUCTURE, AVOID OBSTRUCTIONS, PRESERVE HEADROOM & KEEP OPENINGS / PASSAGEWAYS CLEAR WITHOUT FURTHER CONSTRUCTION OR COST.
- ALL FLOOR MOUNTED BOILER ROOM EQUIPMENT SHALL BE INSTALLED ON A LEVEL, REINFORCED CONCRETE HOUSEKEEPING PAD, 4" THICK MIN. UNLESS OTHERWISE NOTED. ALL HOUSEKEEPING PADS SHALL BE INSTALLED BY THE MECHANICAL CONTRACTOR. PADS SHALL BE REINFORCED W/ WELDED WIRE MESH & SHALL BE POURED USING 3,000 PSI CONCRETE.
- MECHANICAL CONTRACTOR SHALL PROVIDE & INSTALL ALL REQUIRED STRUCTURAL SUPPORTS FOR ALL PIPING SYSTEMS & EQUIPMENT AS REQUIRED. PIPING SYSTEMS SHALL BE EQUIPPED WITH EXPANSION COMPENSATORS AT THE INTERVALS REQUIRED. PROVIDE PIPING GUIDES / ANCHORS AS REQUIRED.
- MECHANICAL CONTRACTOR SHALL PROPERLY INSULATE ALL NEW PIPING SYSTEMS & EQUIPMENT. REFER TO SPECIFICATION SECTION 15250 FOR FURTHER DETAILS REGARDING INSULATION REQUIREMENTS. UPON COMPLETION OF INSULATION WORK, MECHANICAL CONTRACTOR SHALL PROPERLY LABEL EACH PIPING RUN SHOWING THE TYPE OF FLUID CARRIED & DIRECTION OF FLOW. PIPE IDENTIFICATION MARKERS SHALL BE INSTALLED EVERY 20 FEET IN THE PIPING RUNS.
- ALL VALVES WITHIN PIPING SYSTEMS SHALL BE TAGGED USING A 1-1/2" DIA. BRASS TAG. PROVIDE A LEGEND LISTING VALVE #, TYPE OF VALVE, SERVICE TYPE, & LOCATION OF VALVE. KEY VALVE #'S TO AS-BUILT DRAWINGS UPON COMPLETION OF PROJECT.
- MECHANICAL CONTRACTOR SHALL SUBMIT (3) SETS OF OPERATING MANUALS FOR EACH PIECE / TYPE OF MECHANICAL EQUIPMENT.
- MECHANICAL CONTRACTOR SHALL PROVIDE & INSTALL ALL WIRING & DEVICES AS REQUIRED TO CONTROL THE BOILER ROOM EQUIPMENT AS DESCRIBED IN THE SEQUENCE OF OPERATIONS LISTED IN THE PROJECT MANUAL. REFER TO SPECIFICATION SECTION 15903 FOR FURTHER DETAILS.

FIRESTOPPING NOTES

- ALL PENETRATIONS RELATED TO MECHANICAL WORK THROUGH FIRE RATED WALLS, FLOORS OR OTHER STRUCTURES SHALL BE FIRE STOPPED AS REQUIRED TO MAINTAIN THE RATING OF THE WALL B MECHANICAL CONTRACTOR. IT IS ASSUMED THAT ALL WALLS IN THE CONSTRUCTION CARRY A MINIMUM FIRE RATING OF 1 HR. IT SHOULD BE ASSUMED THAT ALL MACHINE ROOM WALLS / BOILER ROOM WALLS ELECTRIC ROOM WALLS CARRY A RATING OF 2 HR. MECHANICAL CONTRACTOR SHALL BE RESPONSIBLE FOR A COMPLETE REVIEW OF THE ARCHITECTURAL DRAWINGS IN ORDER TO DETERMINE FIRE RATINGS OF ALL WALLS / PARTITIONS RELATED TO WORK UNDER THIS CONTRACT.
- MECHANICAL CONTRACTOR SHALL REVIEW THE COMPLETE ARCHITECTURAL SET OF DRAWINGS IN ORDER TO DETERMINE WHERE DUCT PENETRATIONS THROUGH RATED BARRIERS. DUCTS PENETRATING SAID RATED BARRIERS SHALL BE EQUIPPED WITH A UL LISTED FUSIBLE LINK TYPE FIRE DAMPER, RATED FOR SERVICE FOR WHICH IT IS BEING USED. FIRE DAMPERS SHALL BE PROVIDED & INSTALLED BY THE MECHANICAL CONTRACTOR, COMPLETE W/ DUCT ACCESS DOORS DIRECTLY ADJACENT TO THE DAMPER, POSITIONED FOR EASY REPLACEMENT OF THE LINK.
- MECHANICAL CONTRACTOR SHALL REVIEW THE COMPLETE ARCHITECTURAL SET OF DRAWINGS IN ORDER TO DETERMINE WHERE DUCT PENETRATIONS THROUGH RATED BARRIERS OCCUR BETWEEN SEPARATE SMOKE ZONES. DUCTS PENETRATING SAID FIRE / SMOKE BARRIERS SHALL BE EQUIPPED WITH A UL LISTED COMBINATION FIRE / SMOKE DAMPER, RATED FOR SERVICE FOR WHICH IT IS BEING USED. FIRE / SMOKE DAMPERS SHALL BE PROVIDED & INSTALLED BY THE MECHANICAL CONTRACTOR, COMPLETE V DUCT ACCESS DOORS DIRECTLY ADJACENT TO THE DAMPER. DAMPER ACTUATOR & RELATED WIRING SHALL BE PROVIDED & INSTALLED BY THE ELECTRICAL CONTRACTOR. COORDINATE DAMPER INSTALLATIONS W/ E.C. TO VERIFY PROPER CLEARANCES TO ASSURE PROPER DAMPER OPERATION.
- MECHANICAL CONTRACTOR SHALL PROVIDE A FULL SET OF AS-BUILT DRAWINGS, SHOWING EACH DAMPER LOCATION, TYPE OF DAMPER, ACCESS DOOR LOCATIONS, ETC.
- CONTRACTOR SHALL REFER TO SPECIFICATION SECTION 15511 FOR FURTHER DETAILS REGARDING FIRESTOPPING MATERIALS & METHODS. CONTRACTOR SHALL SUBMIT SHOP DRAWINGS OF PRODUCTS TO BE USED. FIRESTOP MATERIALS OTHER

THAN THE PRODUCTS SPECIFIED SHALL INCLUDE FULL TECHNICAL DATA WITH SHOP DRAWINGS TO

DEMONSTRATE EQUALITY WITH THE SPECIFIED FIRESTOPPING MATERIALS.

GENERAL INSTRUMENTATION NOTES

- AT A MINIMUM, PROVIDE THERMOMETERS / WELLS AT THE FOLLOWING LOCATIONS:
- AT INLETS & OUTLET OF EACH THREE WAY VALVE (UNIT VENTILATORS / CABINET UNIT HEATER
- AT INLET & OUTLET OF EACH HYDRONIC BOILER, CHILLER OR COOLING TOWER. AT INLET & OUTLET OF EACH HYDRONIC COIL IN AIR HANDLING UNITS & BUILT-UP CENTRAL SYSTEMS.
- AT A MINIMUM, PROVIDE LIQUID FILLED PRESSURE GAUGES / WELLS AT THE FOLLOWING LOCATIONS:
- AT SUCTION & DISCHARGE OF EACH PUMP. FOR EACH MAKEUP WATER LINE.
- BEFORE & AFTER ALL PRESSURE REDUCING VALVES.
- AT ACCESSIBLE HIGH POINT OF ALL HYDRONIC PIPING SYSTEMS. AT ALL EXPANSION / COMPRESSION TANKS.

PIPING SYSTEMS and EQUIPMENT VENTING NOTES

- MECHANICAL CONTRACTOR WILL BE RESPONSIBLE FOR THE PROPER VENTING OF ALL NEWLY INSTALLED HYDRONIC PIPING SYSTEMS. AUTOMATIC AIR VENTS SHALL BE INSTALLED AT EVERY HIGH POINT IN THE PIPING SYSTEM WHERE AIR CAN COLLECT. PROVIDE COCK IN RISER PRIOR TO AUTOMATIC AIR VENT. NEW AIR VENTS SHALL BE "TACO" #HY-VENT OR EQUIVALENT.
- MECHANICAL CONTRACTOR SHALL PROVIDE & INSTALL NEW AUTOMATIC AIR VENT FOR EACH AIR HANDLING UNIT COIL OR DUCT MOUNTED COIL. INSTALL SHUT-OFF COCK PRIOR TO VENT TIE-IN.
- MECHANICAL CONTRACTOR SHALL PROVIDE NEW MANUAL AIR VENTS FOR ALL UNIT VENTILATOR COILS, CONVECTORS, FAN COIL UNITS, FIN TUBE RADIATORS, ETC. MANUAL VENTS SHALL BE "TACO" #417 COIN VENT OR EQUIVALENT. PROVIDE SHUT-OFF COCK PRIOR TO VENT. AIM COIN VENT DISCHARGE IN AN APPROPRIATE MANNER AS TO FACILITATE THE CAPTURE OF BLEED WATER WHILE PERFORMING SYSTEM BLEEDING OPERATIONS.

ELECTRICAL WORK UNDER MECHANICAL CONTRACT

- MECHANICAL CONTRACTOR SHALL PROVIDE ALL STARTERS & DISCONNECT SWITCHES REQUIRED FOR ALL NEW MECHANICAL EQUIPMENT. STARTER / DISCONNECT SWITCH INSTALLATION TO BE PERFORMED UNDER THE ELECTRICAL CONTRACT. COORDINATE WORK W/ ELECTRICAL CONTRACTOR PRIOR TO START
- POWER WIRING REQUIRED FOR CONTROLS SHALL BE PERFORMED UNDER THE MECHANICAL CONTRACT UNLESS SPECIFICALLY NOTED OTHERWISE ON THE ELECTRICAL DRAWINGS. MECHANICAL CONTRACTOR SHALL OBTAIN THE SERVICES OF A LICENSED ELECTRICIAN (PER NEC REQUIREMENTS) TO PERFORM ALI ELECTRICAL WORK.

DUCTWORK NOTES

- PROVIDE ALL NEW DUCTWORK AS SHOWN AND SPECIFIED UNDER SPECIFICATION SECTION 015891, AND IN CONFORMANCE WITH 'SMACNA' SPECIFICATIONS.
- IF A DUCT ELBOW IS SHOWN TO BE RADIUSED, THEN RADIUSED ELBOWS SHALL BE INSTALLED. SQUARE ELBOWS MAY NOT BE SUBSTITUTED WHERE RADIUSED ELBOWS ARE SHOWN. WHERE SQUARE ELBOWS ARE SHOWN, TURNING VANES SHALL BE INSTALLED UPON APPROVAL BY THE ENGINEER.
- PROVIDE DUCT LINING IN ALL DUCTWORK THAT IS CONVEYING BELOW AMBIENT TEMPERATURE AIR & IS NOT INSULATED. PROVIDE LINING IN SUPPLY & RETURN AIR DUCTWORK FROM AIR HANDLING EQUIPMENT TO 20 FEET AWAY FROM THE UNIT(S). IN ADDITION, INCLUDE LINING IN ANY OTHER DUCT SPECIFICALLY SHOWN OR SPECIFIED TO BE EQUIPPED WITH LINING. REFER TO SPECIFICATION SECTION 15891 & 15290 FOR FURTHER INFORMATION.
- WHERE FLEXIBLE DUCTWORK IS USED, LENGTHS MAY NOT EXCEED 4 FEET TOTAL IN ANY ONE RUN OF FLEXIBLE DUCTWORK. FLEXIBLE DUCTWORK SHALL BE RATED IN ACCORDANCE WITH UL 181, CLASS 1. REFER TO SPECIFICATION SECTION 15891 FOR FURTHER INFORMATION.
- MECHANICAL CONTRACTOR SHALL PROVIDE A BUTTERFLY TYPE VOLUME DAMPER WITH LOCKING QUADRANT HANDLE PRIOR TO EACH AIR OUTLET SHOWN. INSTALL DAMPER AT LEAST 5 FEET AWAY FROM
- MECHANICAL CONTRACTOR SHALL PROVIDE FLEXIBLE DUCT CONNECTIONS WHERE DUCT SYSTEMS CONNECT TO EQUIPMENT. REFER TO SPECIFICATION SECTION 15891 FOR FURTHER INFORMATION.

TESTING and BALANCING NOTES

- MECHANICAL CONTRACTOR WILL BE REQUIRED TO PERFORM ALL EQUIPMENT & SYSTEM TESTING BALANCING REQUIRED UNDER THIS CONTRACT. PROVIDE A FULL REPORT DETAILING ALL DESIGN & ACTUAL CONDITIONS FOR ALL AIR & HYDRONIC SYSTEMS SHOWN ON THE DRAWINGS. REFER TO SPECIFICATION SECTIONS 15990 & 15997 FOR FURTHER DETAILS.
- UPON NOTICE OF COMPLETION OF WORK BY THE CONTRACTOR, OWNER WILL OBTAIN THE SERVICES OF AN INDEPENDENT TESTING & BALANCING CONTRACTOR TO VERIFY THE RESULTS OF THE TESTING & BALANCING REPORT SUBMISSION. INDEPENDENT TESTING AGENCY SHALL SELECT A RANDOM NUMBER OF MEASUREMENTS TO BE CHECKED. MEASUREMENTS WILL BE CHECKED IN THE SAME MANNER AS ORIGINALLY MEASURED. NUMBER OF VERIFICATION MEASUREMENTS SHALL BE APPROXIMATELY 25% OF THE TOTAL MEASUREMENTS FOR THE PROJECT.
- IF MORE THAN 10% OF THE VERIFICATION TESTING SHOWS DEVIATIONS OF 10% OR MORE / SOUND LEVEI OF 2dB DIFFERENT THAN THAT ORIGINALLY MEASURED, THE ORIGINAL REPORT WILL BE REJECTED. A SYSTEMS WILL THEN BE REQUIRED TO BE COMPLETELY RE-TESTED, WITH A SECOND REPORT SUBMITTE IN THE EVENT THAT THE ORIGINAL REPORT IS REJECTED, ALL SYSTEMS SHALL BE READJUSTED & TESTEI NEW CERTIFIED REPORTS SUBMITTED, AND NEW VERIFICATION TESTS MADE, AT NO ADDITIONAL COST T THE OWNER. THE CONTRACTOR WILL BE RESPONSIBLE FOR ALL COSTS INVOLVED WITH THE

ADDDEVIATIONS	
<u>ABBREVIATIONS</u>	
A.F.F	ABOVE FINISHED FLOOR
	BAÇKDRAFT DAMPER
	COLD WATER SUPPLY.
	CUBIC FEET OF AIR PER MINUTE
D	DEEP / DEPTH
	DIAMETER
	FEET PER MINUTE
	FIRE DAMPER - DUCT MOUNTED
	FLAT OVAL DUCTWORK
	GALLONS PER HOUR
н	HIGH
H.C	HANDICAPPED
HWS	. HEATING SYSTEM HOT WATER SUPPLY.
HWR	HEATING SYSTEM HOT WATER RETURN
HP	HORSEPOWER
I.D.,	INSIDE DIAMETER
	KILQWATT,
	LQNG
LAT	
	LOW PRESSURE STEAM CONDENSATE
LP\$	
LWT	LEAVING WATER TEMPERATURE
MAX	MAXIMUM
MIN	MIŅIMUM
МВН	BŢU x 1,000.
MFR	MANUFACTURER
M.H	
MTD	
N.I.C	
	NOMIŅAL
N.T,S.,	NOT TO SCALE
O.A	QUTSIDE AIR
O.C	ON CENTER
O.D	OUTSIDE DIAMETER
O.S. &.Y	OUTSIDE SCREW & YOKE
	ON CENTER
	PNEUMATIC / ELECTRIC
PREFAB	
	PRESSURE REDUCING VALVE
PSI	DETURN AIR
R.A	
REQ'D	REQUIRED
RPM	REVOLUTIONS PER MINUTE
S.A	SUPPLY AIR
SCH	SCHEDULE
	STATIC PRESSURE
	STANDARD
	TEMPERATURE
	THERMAL EXPANSION VALVE
VOL	
V.D	
VOL	VELOCITY,
VFD	VARIABLE FREQUENCY DRIVE
W	
W/	
W/O	
	WET BULB TEMPERATURE
WTD	
WTR	

SYMBOL	DESCRIPTION
24x12 / 20"~	RECTANGULAR GALVANIZED DUCTWORK - DIMENSIONS 'W' x 'H'
\$	NEW SUPPLY DUCTWORK TO RISE UP
	NEW SUPPLY DUCTWORK TO DROP DOWN
	NEW RETURN DUCTWORK TO RISE UP
	NEW RETURN DUCTWORK TO DROP DOWN
\	TRANSITION IN DUCTWORK
	FIRE DAMPER INSTALLED IN DUCTWORK
	VOLUME DAMPER IN DUCT (w/ LOCKING QUADRANT HANDLE)
5	ROUND DUCT WORK TO RISE UP
24 0	ROUND DUCTWORK TO DROP DOWN
42x18 F0	FLAT OVAL DUCT WORK
	RECTANGULAR TO ROUND DUCT TRANSITION
Z-Z-Z-Z-Z-Z-Z-Z-Z-Z-Z-Z-Z-Z-Z-Z-Z-Z-Z-	ELBOW IN DUCTWORK w/ TURNING VANES
	ELBOW IN DUCTWORK (RADIUS + 1.5 x D)
	45 DEG. TAKEOFF FITTING
	90 DEG. TAKEOFF w/ BELLMOUTH FITTING
	FLEXIBLE DUCTWORK TO DIFFUSER (4 FT. MAX. RUN)
	4-WAY PATTERN CEILING DIFFUSER
	3-WAY PATTERN CEILING DIFFUSER
	2-WAY PATTERN CILING DIFFUSER (90 DEG. / OPPOSING PATTE
	CEILING RETURN AIR REGISTER
	LINEAR SLOT DIFFUSER
	ROOF MOUNTED EXHAUST FAN

IPING SYMBOL I	_EGEND
SYMBOL	DESCRIPTION
 	PIPING TO RISE UP (TEE)
	PIPING TO DROP DOWN (TEE)
+0	PIPING TO RISE UP (ELBOW)
	PIPING TO DROP DOWN (ELBOW)
Y.A.	PIPING ANCHOR
	PIPING GUIDE
	COLD WATER SUPPLY PIPING
HWS —	HEATING SYSTEM SUPPLY PIPING
——————————————————————————————————————	HEATING SYSTEM RETURN PIPING
	CHILLED WATER SUPPLY PIPING
	CHILLED WATER RETURN PIPING
·	CONDENSER WATER SUPPLY PIPING
· · · · · · · · · · · · · · · · · · ·	CONDENSER WATER RETURN PIPING
CD	CONDENSATE DRAINAGE PIPING
LPC	LOW PRESSURE STEAM CONDENSATE PIPING
LPS	LOW PRESSURE STEAM PIPING
G	LOW PRESSURE NATURAL GAS PIPING
EG	ELEVATED PRESSURE NATURAL GAS PIPING
₩	GAS COCK
	DIRT LEG IN PIPING
<u>'</u>	LIQUEFIED PETROLEUM GAS PIPING
LP	
V	VENT PIPING
<u> </u>	LINEAR EXPANSION COMPENSATOR
	EXPANSION LOOP IN PIPING
	UNION IN PIPING
· · · · · · · · · · · · · · · · · · ·	PIPING STRAINER (w/ BLOWDOWN VALVE)
	REDUCER / INCREASER FITTINGS IN PIPING
	ECCENTRIC REDUCER IN PIPING
	THERMOMETER
<u> </u>	PRESSURE GAUGE
	FULL PORT BALL VALVE
	GATE VALVE
	SWING CHECK VALVE
	BALANCING VALVE
	3-WAY VALVE (w/ OPERATOR)
	CIRCUIT CETTER
3	TRIPLE DUTY VALVE
	WAFER VALVE
	PLUG / CAP IN PIPING
4	PNEUMATIC CONTROL VALVE OPERATOR
	ELECTRIC CONTROL VALVE OPERATOR
₱ ♦	AUTOMATIC AIR VENT
	EXISTING PIPING

NOTE - SINGLE PRIME CONTRACT:

1. UNDER BASE BID - GC-2, ALL GENERAL CONSTRUCTION, MECHANICAL CONSTRUCTION, PLUMBING CONSTRUCTION, AND ELECTRICAL CONSTRUCTION WORK SCOPE SHOWN SHALL BE PROVIDED AND INSTALLED BY THE SINGLE PRIME CONTRACTOR. REFER TO SPECIFICATIONS (INSTRUCTIONS TO BIDDERS and BID PROPOSAL FORM) FOR ADDITIONAL INFORMATION REGARDING SINGLE PRIME CONTRACT.

٧.	DATE	ITEM	
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KEY PLAN

NOT TO SCALE

R.D.P.

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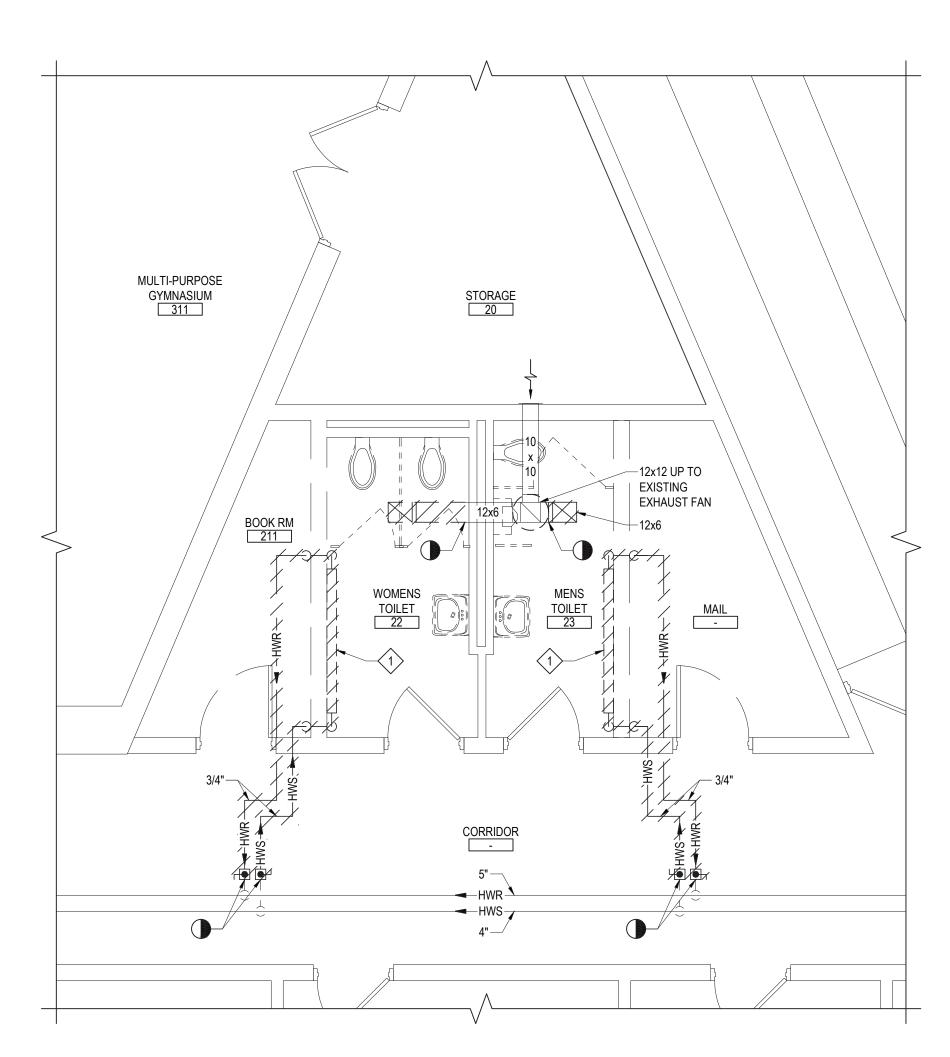
66-14-02-02-0-002-021 BRIARCLIFF MANOR U.F.S.D. DISTRICT NAME

PROJECT

PHASE 2 BOND IMPROVEMENT AT TODD ES DWG TITLE GENERAL NOTES, LEGENDS AND SCHEDULES

SCALE: AS NOTED BID PICK-UP: NOVEMBER 14, 2022

M0.01 HSMS




TOILET ROOM HVAC DEMOLITION PLAN


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DEMOLITION WORK KEYED NOTES:

NOTE:

M.C. TO DEMO & REMOVE EXISTING HOT WATER FIN-TUBE. M.C. TO COORDINATE ANY REQUIRED SHUT-DOWN WITH SCHOOL FACILITIES DEPT. PRIOR TO COMMENCING WORK. M.C. TO COORDINATE ALL WORK WITH G.C.



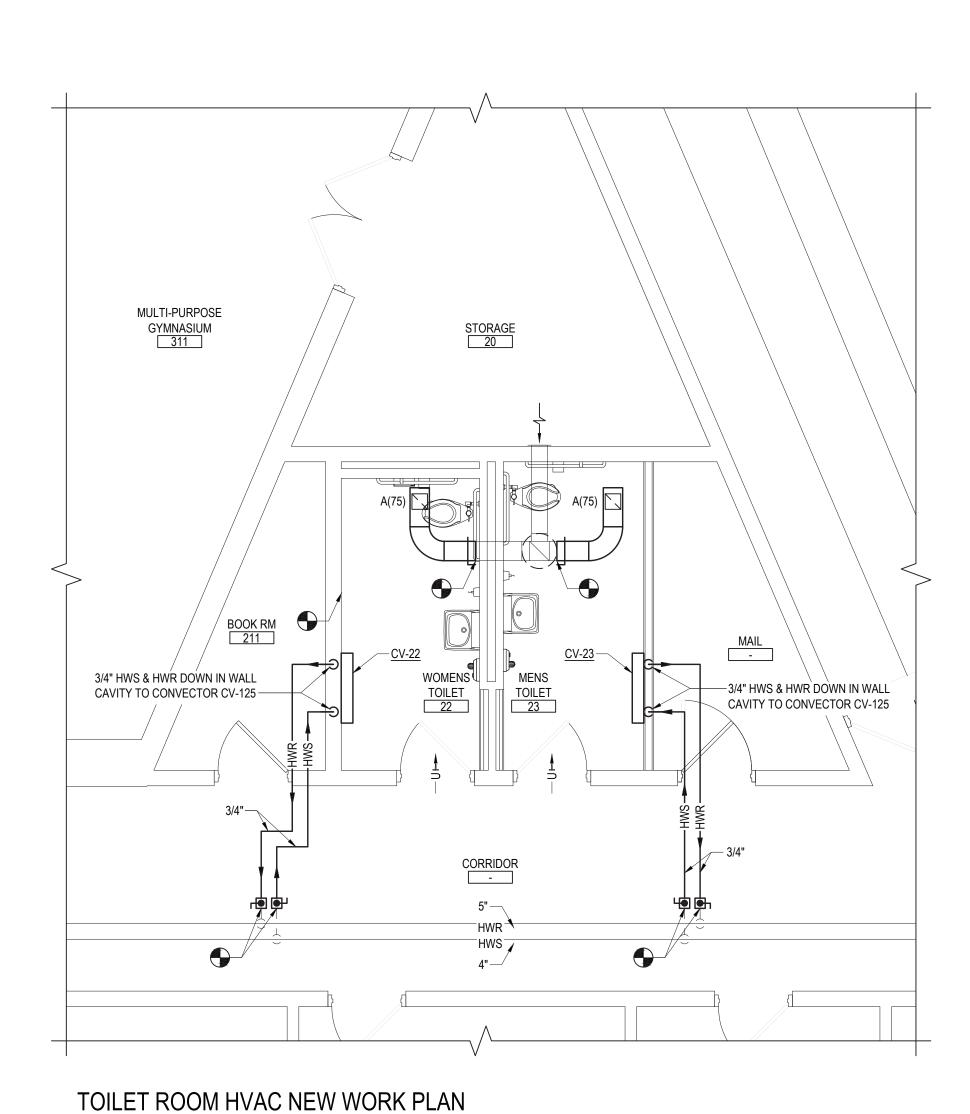

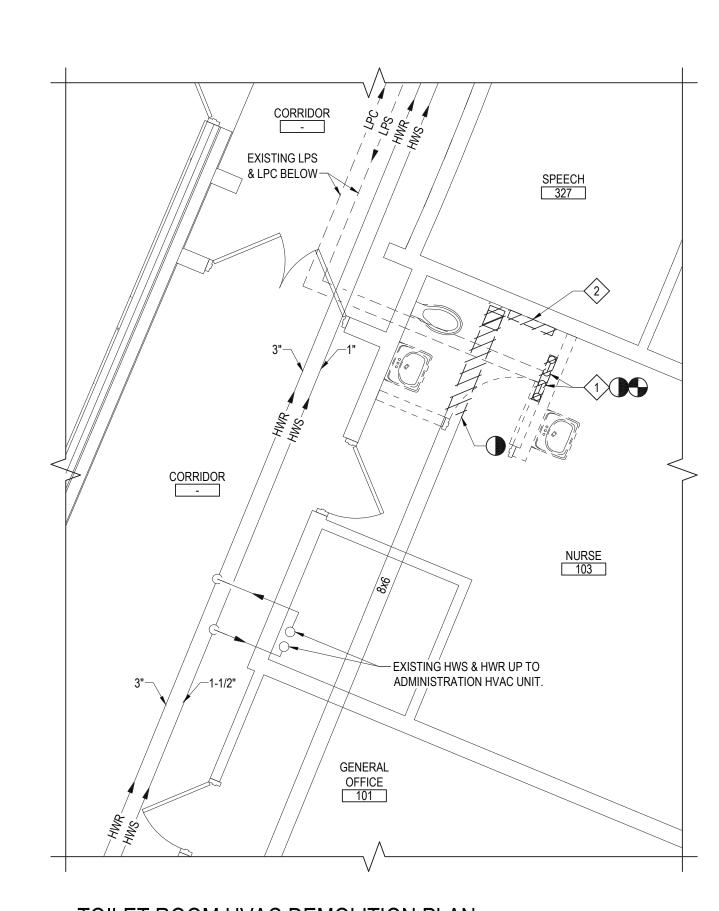TOILET ROOM HVAC DEMOLITION PLAN

SCALE: 1/4" = 1'-0"

DEMOLITION WORK KEYED NOTES:


NOTE:

SCALE: 1/4" = 1'-0"

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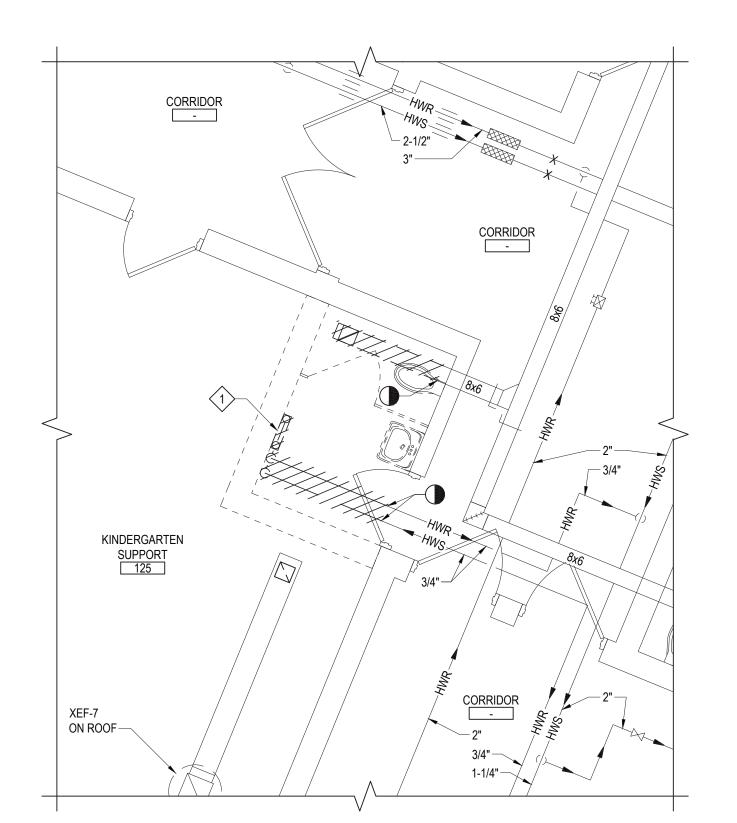
M.C. TO DEMO & REMOVE EXISTING STEAM CONVECTOR. M.C. TO HAVE G.C. CHOP FLOOR TO ALLOW M.C. TO ACCESS EXISTING LPS & LPC TO CUT AND CAP PIPES (BELOW FLOOR) FEEDING STEAM CONVECTOR. G.C. TO PATCH FLOOR UPON COMPLETION OF M.C.'S WORK. COORDINATE ANY REQUIRED SHUT-DOWN WITH SCHOOL FACILITIES DEPT. PRIOR TO COMMENCING WORK. M.C. TO COORDINATE ALL WORK WITH G.C.

M.C. TO DEMO & REMOVE EXISTING ELECTRIC BASEBOARD RADIATOR. M.C. TO COORDINATE WORK WITH E.C. & G.C.

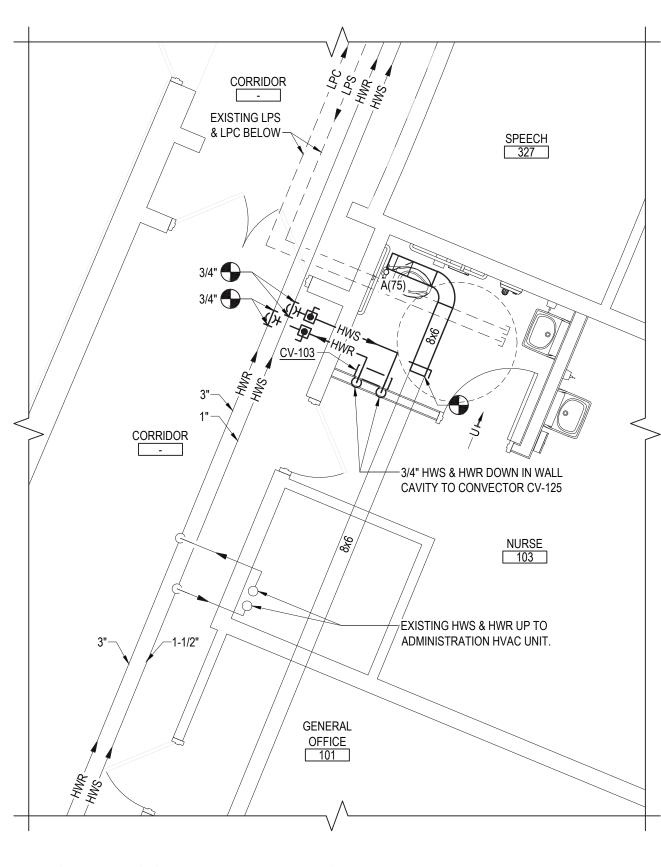

TOILET ROOM HVAC NEW WORK PLAN

NOTE: SCALE: 1/4" = 1'-0"




TOILET ROOM HVAC DEMOLITION PLAN

NOTE:

DEMOLITION WORK KEYED NOTES:

M.C. TO DEMO & REMOVE EXISTING HOT WATER CONVECTOR. M.C. TO COORDINATE ANY REQUIRED SHUT-DOWN WITH SCHOOL FACILITIES DEPT. PRIOR TO COMMENCING WORK. M.C. TO COORDINATE ALL WORK WITH G.C.

SCALE: 1/4" = 1'-0"

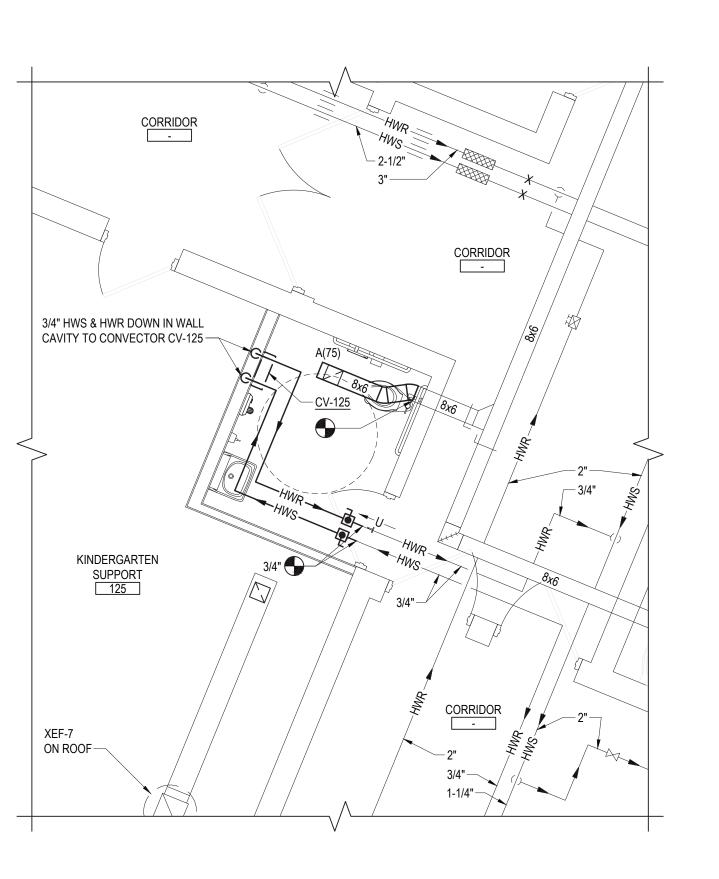

TOILET ROOM HVAC NEW WORK PLAN

NOTE:

SCALE: 1/4" = 1'-0"

AIR DEVICE SCHEDULE
(ANEMOSTAT AS STANDARD)

MANUFACTURER MODEL NO.

TAG NECK SIZE MODULE SIZE CFM RANGE SYMBOL & FLOW PATTERN

ANEMOSTAT 30
(SURFACE MTD.)
EXHAUST A 8x8 UP TO 150 EXHAUST

NOTES:

1) MECHANICAL CONTRACTOR TO COORDINATE BORDER TYPES WITH CLG. CONSTRUCTION.


2 ALL BALANCING TO BE PERFORMED THRU BRANCH DAMPERS.

3) EXHAUST GRILLES BASED ON ANEMOSTAT MODEL 30.

4) MAXIMUM NC LEVELS ARE <25 FOR ALL EXHAUST.

MODEL 30:

RETURN / EXHAUST GRILLES & REGISTERS SHALL BE ANEMOSTAT MODEL 30 (3/4" BLADE SPACING) FIXED BLADE, NON-ADJUSTABLE GRILLES, MANUFACTURED FROM (STEEL) AS SCHEDULED. PROVIDE SIZES AND MOUNTING TYPES AS SCHEDULED. FOR SURFACE MOUNTING APPLICATIONS, COUNTERSUNK MOUNTING HOLES SHALL BE PROVIDED IN THE BORDER, WITH OVAL HEAD SCREWS ALSO PROVIDED BY THE GRILLE MANUFACTURER. BLADES SHALL BE ON 3/4" SPACING, AND SHALL RUN HORIZONTAL OR VERTICAL (SHORT OR LONG DIMENSION) AS SHOWN. BLADES SHALL BE POSITIONED AT 45° DEFLECTION ANGLES, AND HELD RIGIDLY FIXED IN PLACE BY REAR MULLIONS WELDED TO THE GRILLE FRAME. CORNERS SHALL BE WELDED OR STAKED FOR NEAT, UNIFORM MITERED CORNERS. WHERE SCHEDULED. PROVIDE A BAKED-ON, ARCTIC WHITE FINISH, OR CUSTOM COLOR AS SELECTED BY THE ARCHITECT.

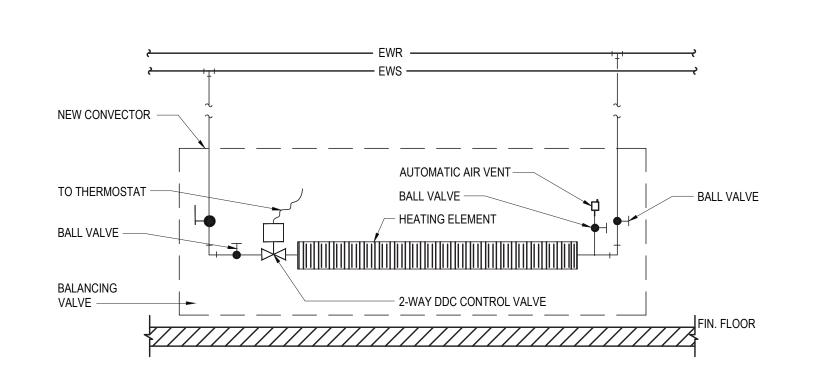


CONVECTORS HEATING ELEMENT PIPING

SCALE: N.T.S.

THREADED SUPPORT ROD TIED INTO THREADED SUPPORT ROD BOILER RM. / MACHINE RM. STRUCTURE TIED INTO BOILER RM. / MACHINE RM. STRUCTURE TYP. FOR FIBERGLASS PIPING INSULATION NEW CLEVIS HANGER (SIZE AS REQ'D.) -TYP. FOR FIBERGLASS PIPING INSULATION — **HEAVY GAUGE STEEL** INSULATION SHIELD -PROVIDE RIGID PIPING INSULATION UNDER HEAVY GA. STEEL SHIELD PROVIDE RIGID PIPING INSULATION UNDER HEAVY GA. STEEL SHIELD -HEAVY GAUGE STELL INSULATION SHIELD

CLEVIS HANGER PIPING SUPPORT DETAIL

SCALE: N.T.S.

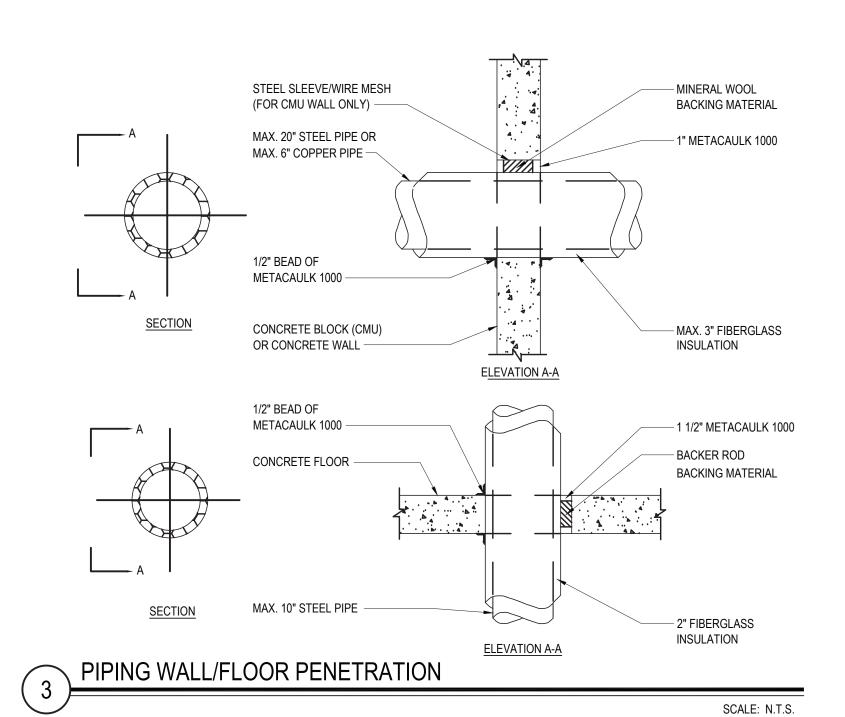

REV. DATE ITEM

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AREA OF WORK

KEY PLAN

NOT TO SCALE

SE 2 BOND IMPROVMENTS

DD ELEMENTARY SCHOOL

HAM ROAD, BRIARCLIFF MANOR, NY 10510

HVAC

DWG TITLE

DRAWING BY: Z.M.Z.

CHECK BY: ---

NOTICE

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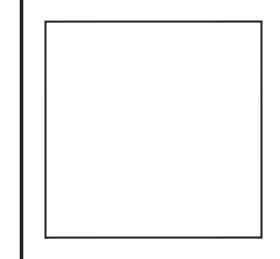
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SED No.

66-14-02-02-0-002-021

DISTRICT
BRIARCLIFF MANOR U.F.S.D.
DISTRICT NAME

PROJECT
PHASE 2 BOND IMPROVEMENT

AT TODD ES

DWG TITLE HVAC DEMOLITION & PROPOSED PART PLANS

SCALE: AS NOTED

DATE:

BID PICK-UP: NOVEMBER 14, 2022

FILE No: 21-247D

M1.01

SLOPE TOP, WALL-MOUNTED, HOT WATER CONVECTOR SCHEDULE (CV-22, CV-23, CV-103 & CV-125) (BASIS: ZEHNDER RITTLING) SL-18-24-04 Standard Colors Qty Coil Config Inlet/Outlet End Pocket 1 Hot Water NONE **General Information** Altitude: 18" H 4" D SL - SLOPE TOP WALL Dark Gray ft. H2O inches Dimensions and data Model SL; wall hung slope top Pricing for standard colors varies by product and Slight color variation may exist between actual finish and color chips. color, refer to price lists for detailed information. All colors are supplied in semi-gloss. Variation in color and gloss may occur in the manufacturing process. Custom color matching is available at additional cost. Metallic colors are Electronic file is for reference only, subject to the not available. ■ All products with a prime finish must have a field-applied topcoat for a calibration of each individual monitor it is viewed on. Contact the factory for a printed color chart to obtain an accurate representation of standard colors. Optional access doors shown D + 7/8" --Outlet grille



KEY PLAN NOT TO SCALE DRAWING BY: Z.M.Z. CHECK BY: THIS DRAWING, PREPARED FOR THE SPECIFIC PROJECT INDICATED IS AN INSTRUMENT OF SERVICE AND THE PROPERTY OF BBS ARCHITECTS, LANDSCAPE ARCHITECTS AND ENGINEERS, PC. INFRINGEMENT OR ANY USE OF THIS DRAWING FOR ANY OTHER PROJECT IS PROHIBITED. ANY ALTERATION OR REPRODUCTION OF THIS DOCUMENT IS ALSO PROHIBITED WITHOUT THE WRITTEN CONSENT OF THE ARCHITECT OR ENGINEER. LANDSCAPE ARCHITECTS ENGINEERS 244 EAST MAIN STREET | 187 WOLF ROAD, STE. 20. PATCHOGUE NEW YORK 11772 NEW YORK 12205 T. 631.475.0349 F. 631.475.0361 F. 518.621.7655 www.BBSARCHITECTURE.com 66-14-02-02-0-002-021 DISTRICT BRIARCLIFF MANOR U.F.S.D. DISTRICT NAME PROJECT PHASE 2 BOND IMPROVEMENTS

REV. DATE

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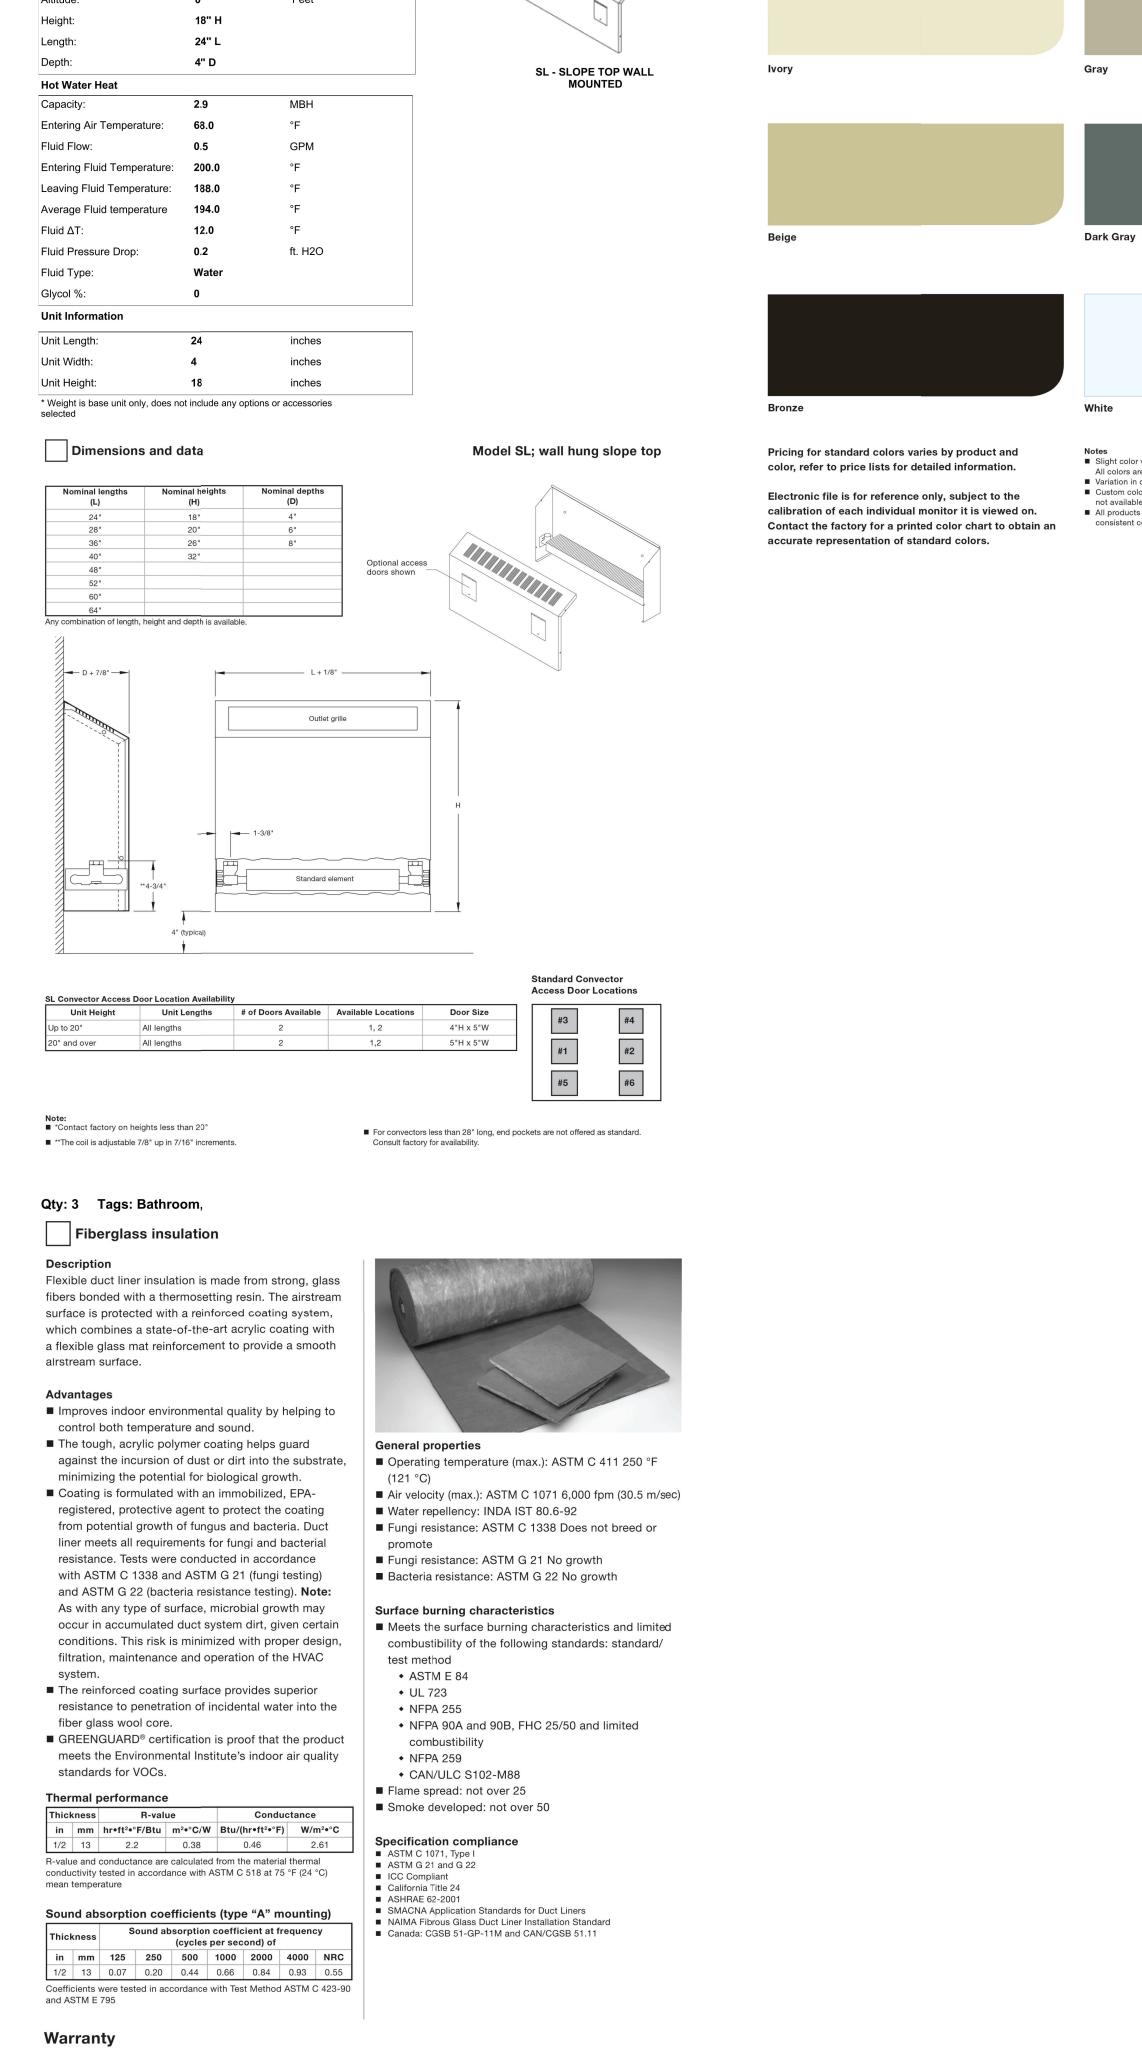
CONDITIONS SHOWN ARE REPRESENTED AS SUGGESTIVE INFORMATION AS THEY MAY NOT HAVE BEEN BUILT AND DETAILED

AT TODD ES

DWG TITLE MECHANICAL SCHEDULES & DETAILS SCALE: AS NOTED

BID PICK-UP: NOVEMBER 14, 2022 FILE No: 21-247D

M6.01



Zehnder Rittling guarantees its products to be free from defects in material and workmanship for a period of one year from

Should there be any defects in the good(s), the purchaser should promptly notify Zehnder Rittling. Upon receipt of written consent from Zehnder Rittling, the purchaser shall return the defective good(s) to the factory for inspection with freight prepaid.

Defects arising from damage due to shipment, improper installation, negligence or misuse by others are not covered by this

If inspection shows the goods to be defective, Zehnder Rittling will at its discretion repair or replace the said item(s).

This warranty is extended only to the original purchaser from Zehnder Rittling.

date of shipment from our factory.

warranty.