

CAMP KAUFMANN, GIRL SCOUTS OF GREATER NEW YORK

81 CAMP ROAD
HOLMES, NY 12531

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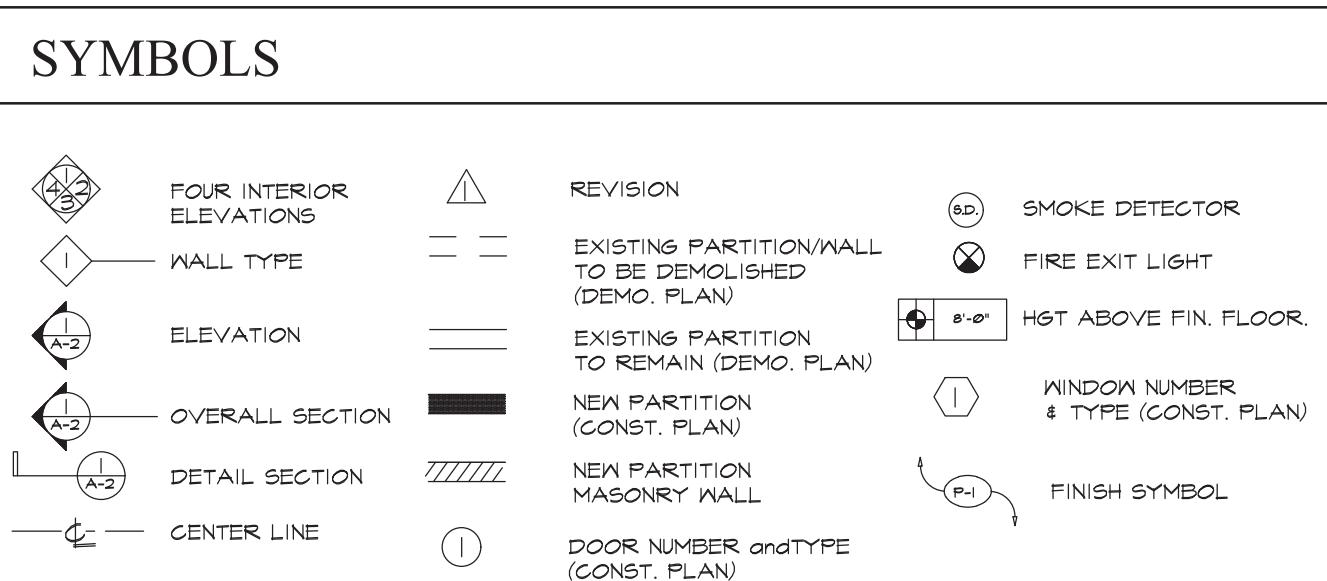
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GENERAL NOTES

- All materials, assemblies, forms, and methods of construction shall comply with these documents and any of the codes and standards referenced within any or all of these documents.
- Contractor(s) must comply at all times with OSHA rules and requirements.
- Contractor(s) shall be solely responsible for construction means, methods, techniques, sequences, or procedures for safety precautions and programs in conjunction with the work.
- Contractor(s) must be familiar with all of the drawings and specifications (Contract Documents) pertaining to all of the trades connected with the project.
- The Contractor(s) shall study and compare all drawings and verify all measurement figures before laying out or constructing the work. Deviation from the drawings and the dimensions given therein shall be made only after written approval or confirmation is requested by the Contractor(s) and issued by the Architect.
- Whenever any additional materials and/or workmanship not shown are required to complete the work of the Contract Documents in accordance with the obvious intent thereof, the Contractor shall provide these materials and workmanship at no additional cost to the Owner.
- In the event of conflicts, omissions, ambiguities, discrepancies and/or unclear circumstances between any of the requirements of the Contract Documents, the requirement that is most inclusive and of highest quality, and/or cost shall govern. Contractor(s) shall (a) provide the better quality or greater quantity of work or (b) comply with the more stringent requirement, either or both, in accordance with the Architect's interpretation. No extra compensation shall be awarded to the Contractor(s) based upon a claim of ambiguity or unclear circumstances in the Contract Documents.
- The Contractor(s) shall verify the accuracy of all elevations, dimensions, and locations and report any discrepancy between existing conditions and the information shown on the drawings prior to the start of work. Any errors due to the Contractor(s) failure to verify such elevations, dimensions, and locations shall be rectified by the Contractor(s) without change to the project schedule and at no cost to the Owner.
- If a change in the work is found necessary due to a discrepancy between actual field conditions and the drawings, the Contractor(s) shall submit detailed drawings of such departure for the approval of the Architect before making any changes.
- Contractor(s) shall coordinate neighborhood street access, delivery routing, vehicle parking locations, acceptable hours for construction and material delivery with the Owner and the Owner's Representative.
- Contractor(s) shall not cause interruption in services such as power, water, or heat without the approval of the Owner and Owner's Representative.
- Contractor(s) shall protect all areas adjacent to the construction area from damage by construction vehicles, equipment, or construction personnel. Any damage to adjacent areas shall be repaired by the Contractor(s) with no change to the project schedule and at no cost to the Owner.
- Provisions shall be made to prevent the passage of dust and contaminants into adjacent parts of the building which are not part of the Construction Contract. Periodic inspection and repairs of the containment barriers must be made to prevent exposure to dust or contaminants.
- Under no circumstances shall the Contractor(s) submit the Architect's own construction drawings or details as their shop drawings or as-built drawings. Shop drawings and as-built drawings must be original documents provided by the Contractor(s).
- Unless otherwise noted, all gypsum board shall be fire-rated (Type X).
- All rough wood framing, plywood, and blocking shall be fire retardant treated.
- All horizontal penetrations through fire rated walls and all vertical penetrations through floor structures shall be properly firestopped and/or equipped with smoke/fire dampers to maintain the integrity of the fire ratings indicated. Where firestopping is not required, spaces between the tops of walls or around penetrations shall be filled with noncombustible material approved by the Architect.
- Control and expansion joints will be required in all CMU and brick (interior and exterior), per industry standards (National Concrete Masonry Institute and Brick Institute of America); sketches showing precise joint locations will be subsequently issued by the Architect.

DEMOLITION NOTES

- See Specification Section 024119 "Selective Demolition."
- The Contractor is solely responsible for all activities, actions, supervision, and control related to the demolition of any and all portions of the existing building.
- The Contractor is solely responsible for verifying the integrity of the existing structure before demolishing any walls, floors, ceilings, and/or roofing.
- The Contractor is solely responsible for identifying any load-bearing walls prior to demolition, and for providing reinforcement or support before demolition, saw-cutting or other operations begin.
- The installation, use, and removal of shoring, reinforcement, and/or temporary supports are the sole responsibility of the Contractor.
- It is understood that the Architect has no responsibility whatsoever for the Contractor's demolition operations including, but not limited to sequence of operations, means, methods, supervision, or control.
- Any injuries resulting from the Contractor's demolition operations are the sole responsibility of the Contractor.

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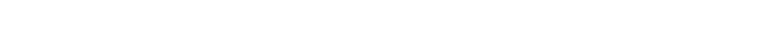
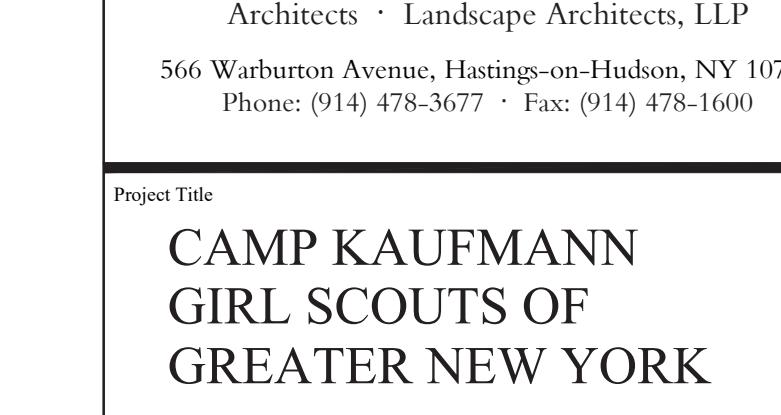
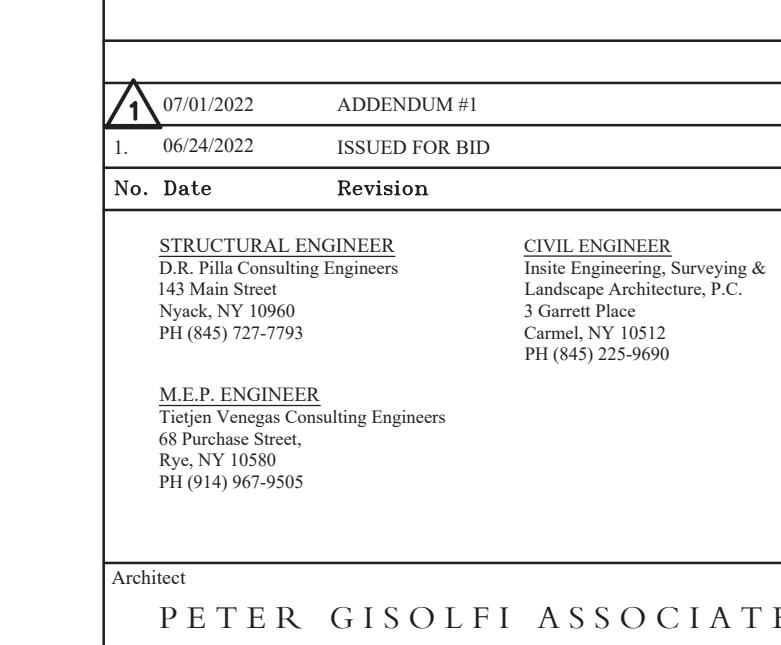
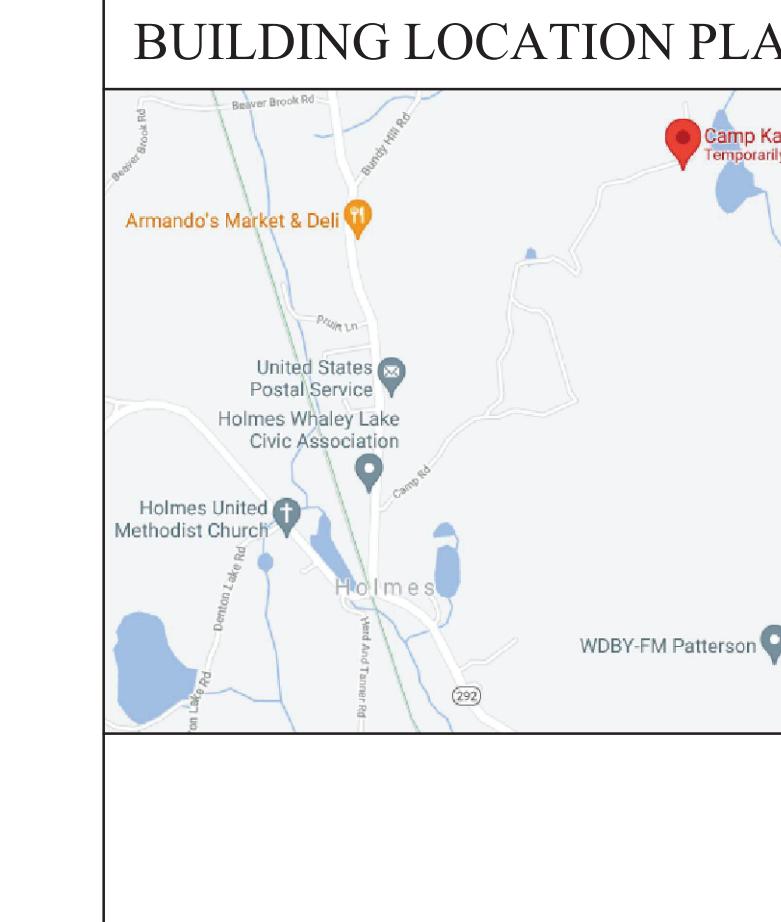
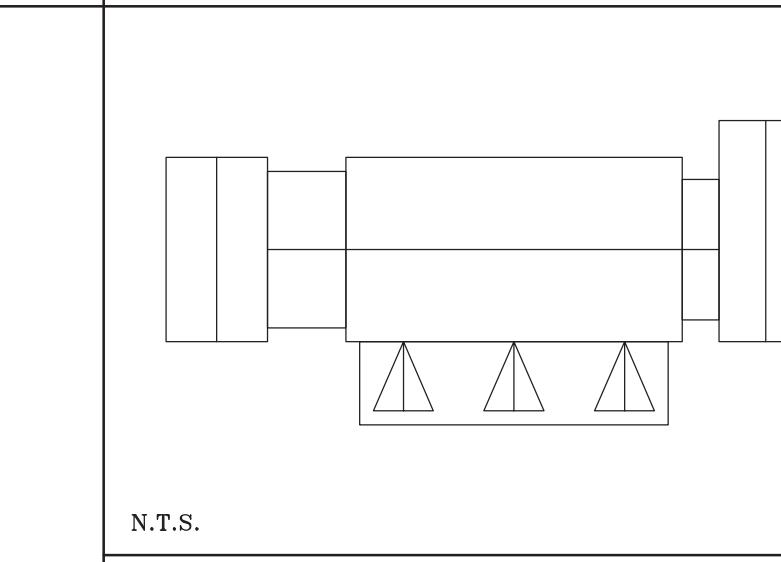
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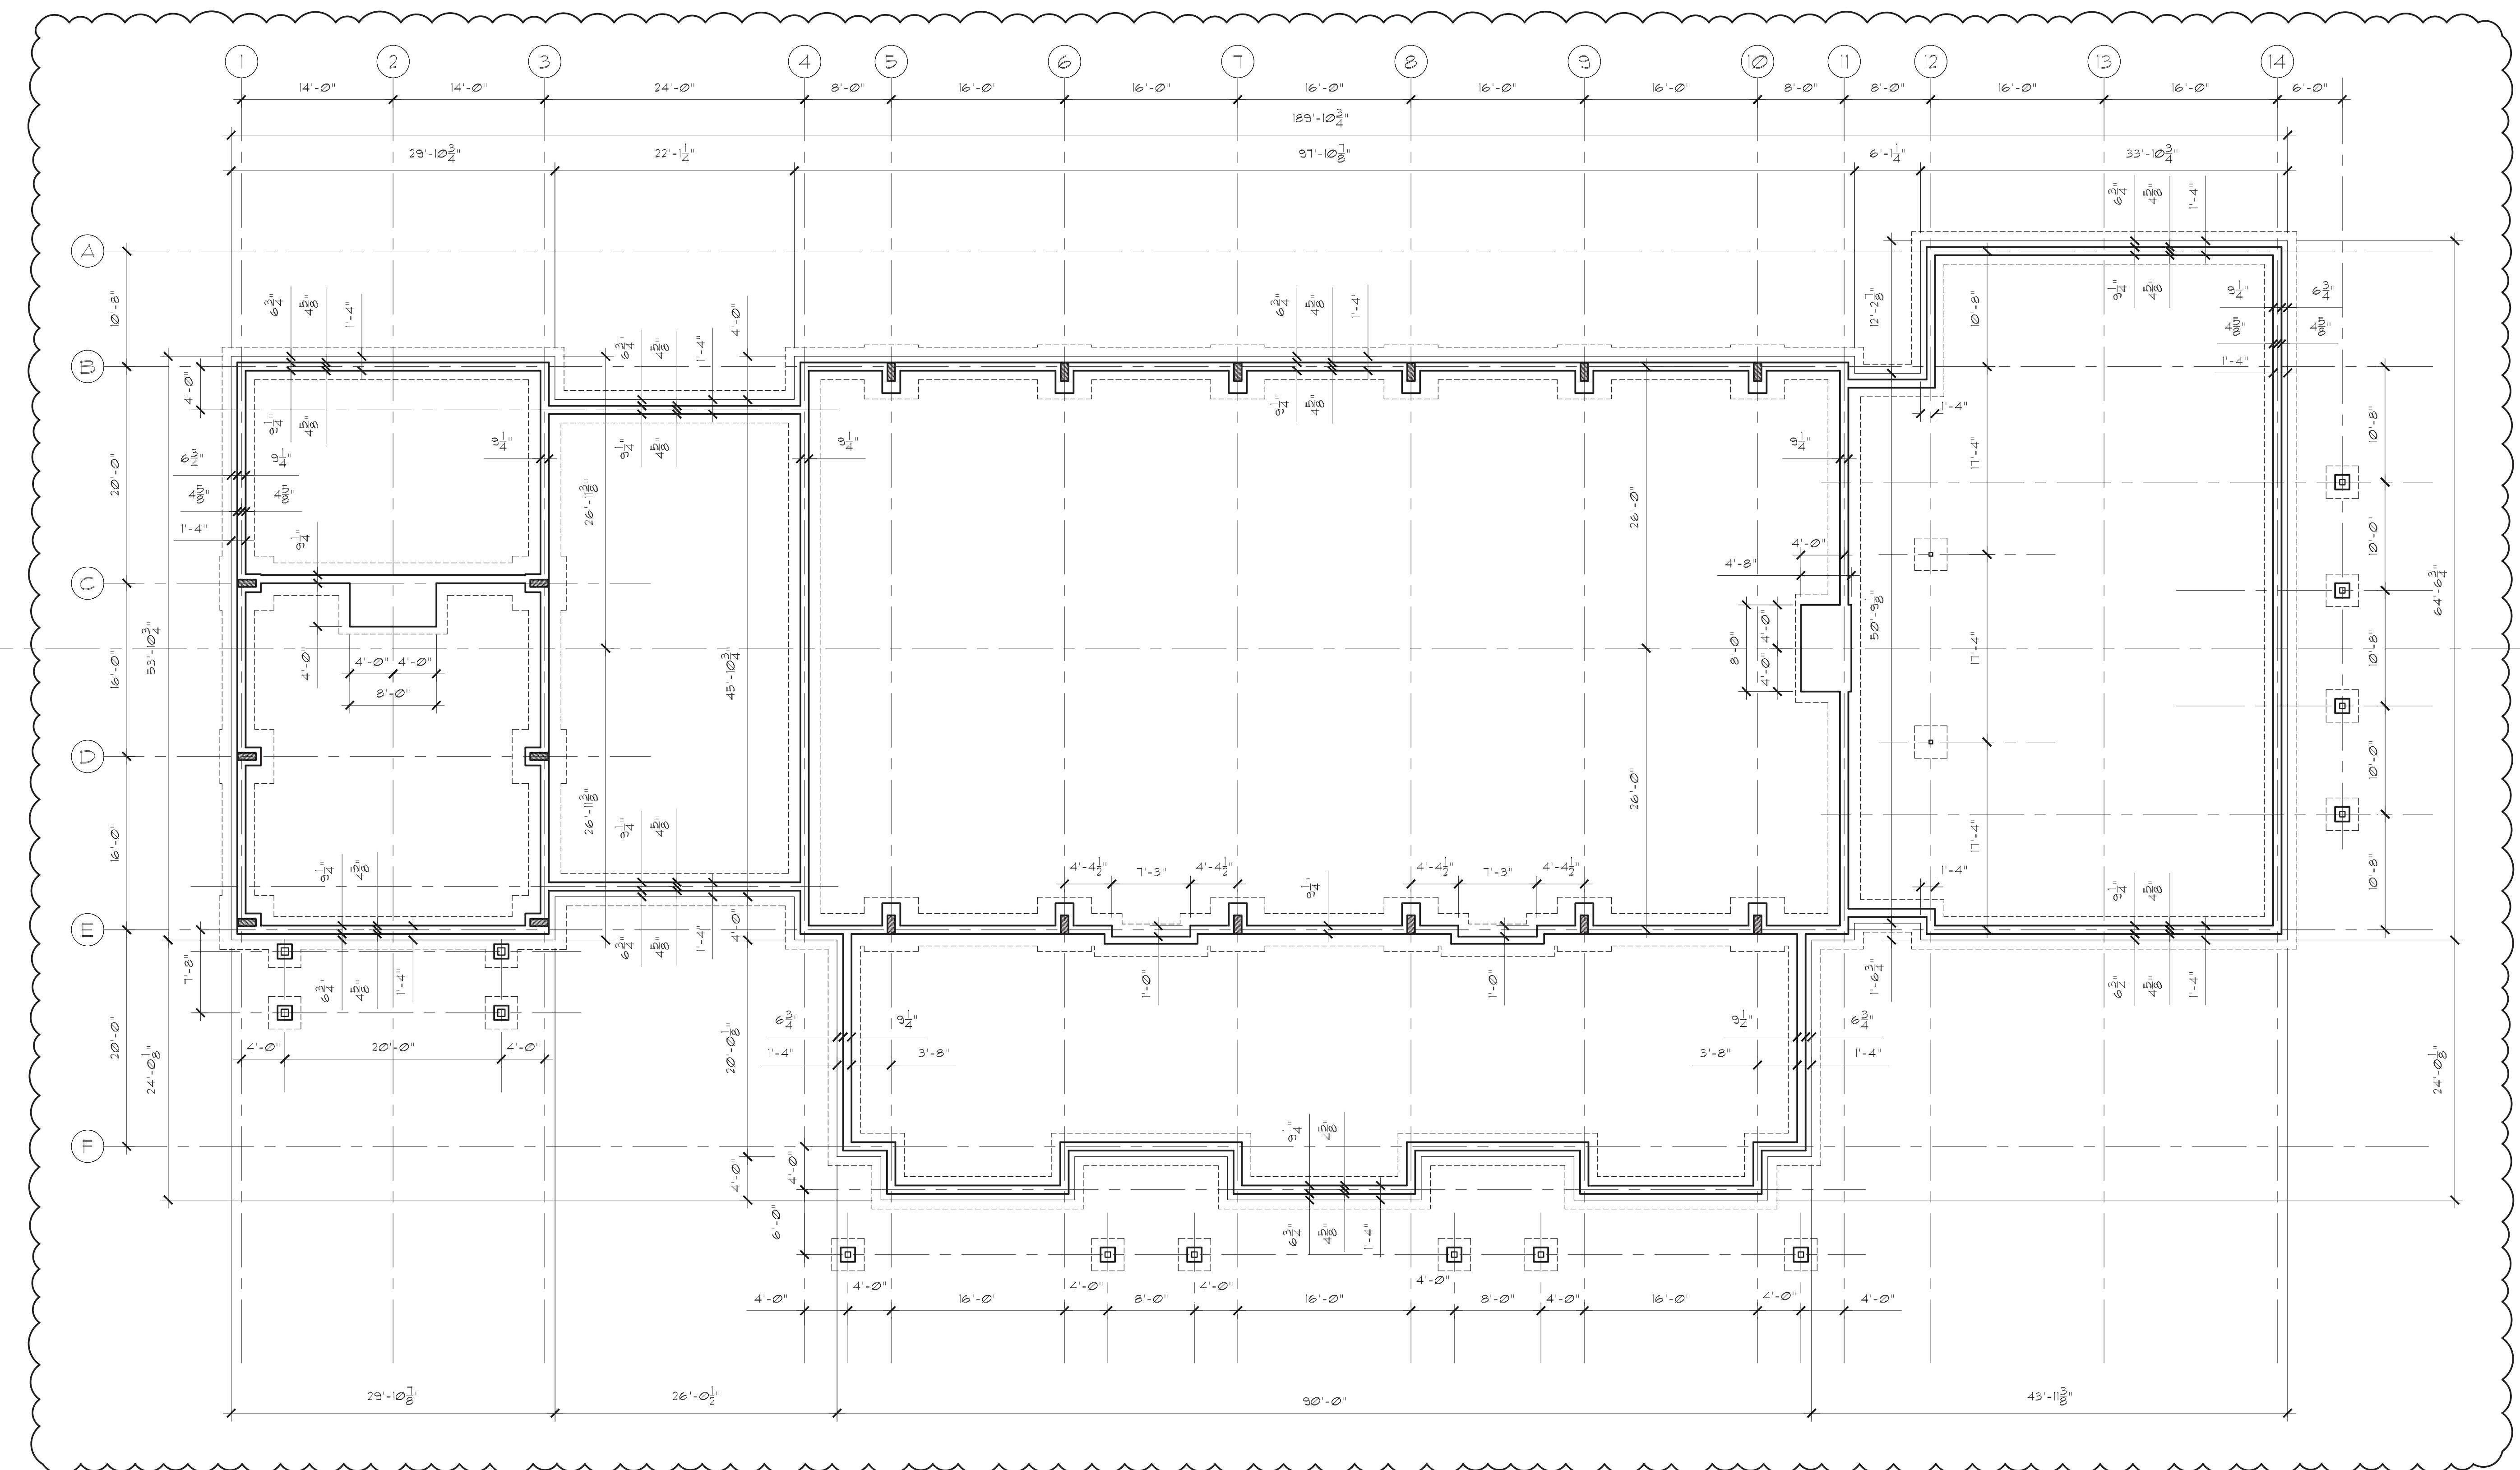
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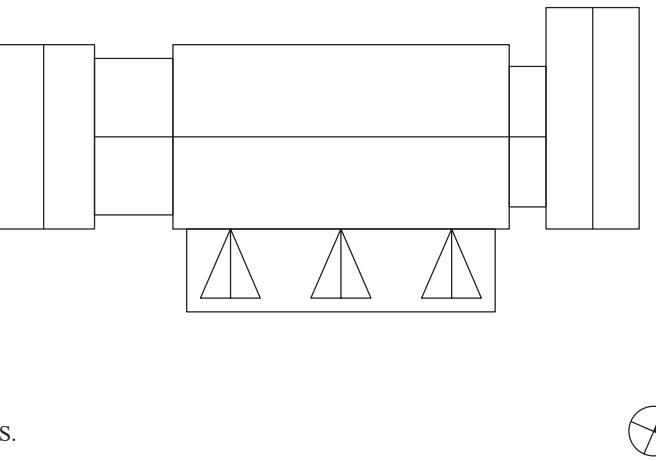
KEY PLAN





1 FOUNDATION PLAN
SCALE: 1/8" = 1'-0"

KEY PLAN



N.T.

For more information about the study, please contact Dr. [REDACTED] at [REDACTED].

 1	07/01/2022	ADDENDUM #1
1.	06/24/2022	ISSUED FOR BID

No.	Date	Revision
<hr/>		
<u>STRUCTURAL ENGINEER</u> D.R. Pilla Consulting Engineers 143 Main Street Nyack, NY 10960 NY (845) 527-7732	<u>FOR REFERENCE ONLY</u> <u>CIVIL ENGINEER</u> Insite Engineering, Surveying & Landscape Architecture, P.C. 1000 University Street, Suite 1000 Seattle, WA 98101-3143	

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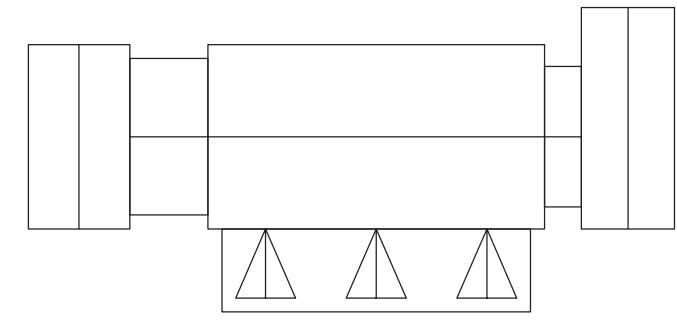
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HOLMES, NY 12551

FOUNDATION PLAN

Seal & Signature	Date:	06/21/2021
	PROJECT No: 2005	
	DRAWN BY: CS, RW, MK	
	CHK BY: NL	
	DWG No:	
	A-100	
	CADD FILE No:	-
W:\2005 Girl Scouts of Greater NY		

KEY PLAN



N.T.S.

NOTE

1. STEEL STAIRS SHALL BE ENGINEERED AND CONSTRUCTED FROM THE FOLLOWING:
TREADS: 11" x 42" DIAMOND STEEL
PLATE TREADS (WELDED TO STEEL
STRINGER) WITH SCREWED DOWN NON-SLIP
NOsing.
 2. RISERS: CLOSED RISERS SHALL BE 1"
MAX. AND CONSTRUCTED FROM DIAMOND
PLATE WELDED TO STEEL STRINGER.
C. STRINGER: STRINGER SHALL BE "C"
CHANNEL.
 3. HANDRAIL: HANDRAIL SHALL BE 1" DIA
STEEL TUBE HANDRAIL (BOTH SIDES OF
STAIR) BOLTED TO WALL.
 4. FINISH: PRIMED WITH RUST INHIBITOR AND
PAINTED.
 5. FLOOR TO FLOOR HEIGHT IS 10'-0".
- CONTRACTOR SHALL FIELD VERIFY ALL DIM.
PRIOR TO FABRICATION.
2. ALL EXPOSED WOOD AT EXTERIOR
INCLUDING POSTS, BEAMS, TRIMS, RAFTERS
AND ROOF DECK AT PORTICO #1 & 2
SHALL BE RED CEDAR (STAINED), UNLESS
STATED OTHERWISE.

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Project Title


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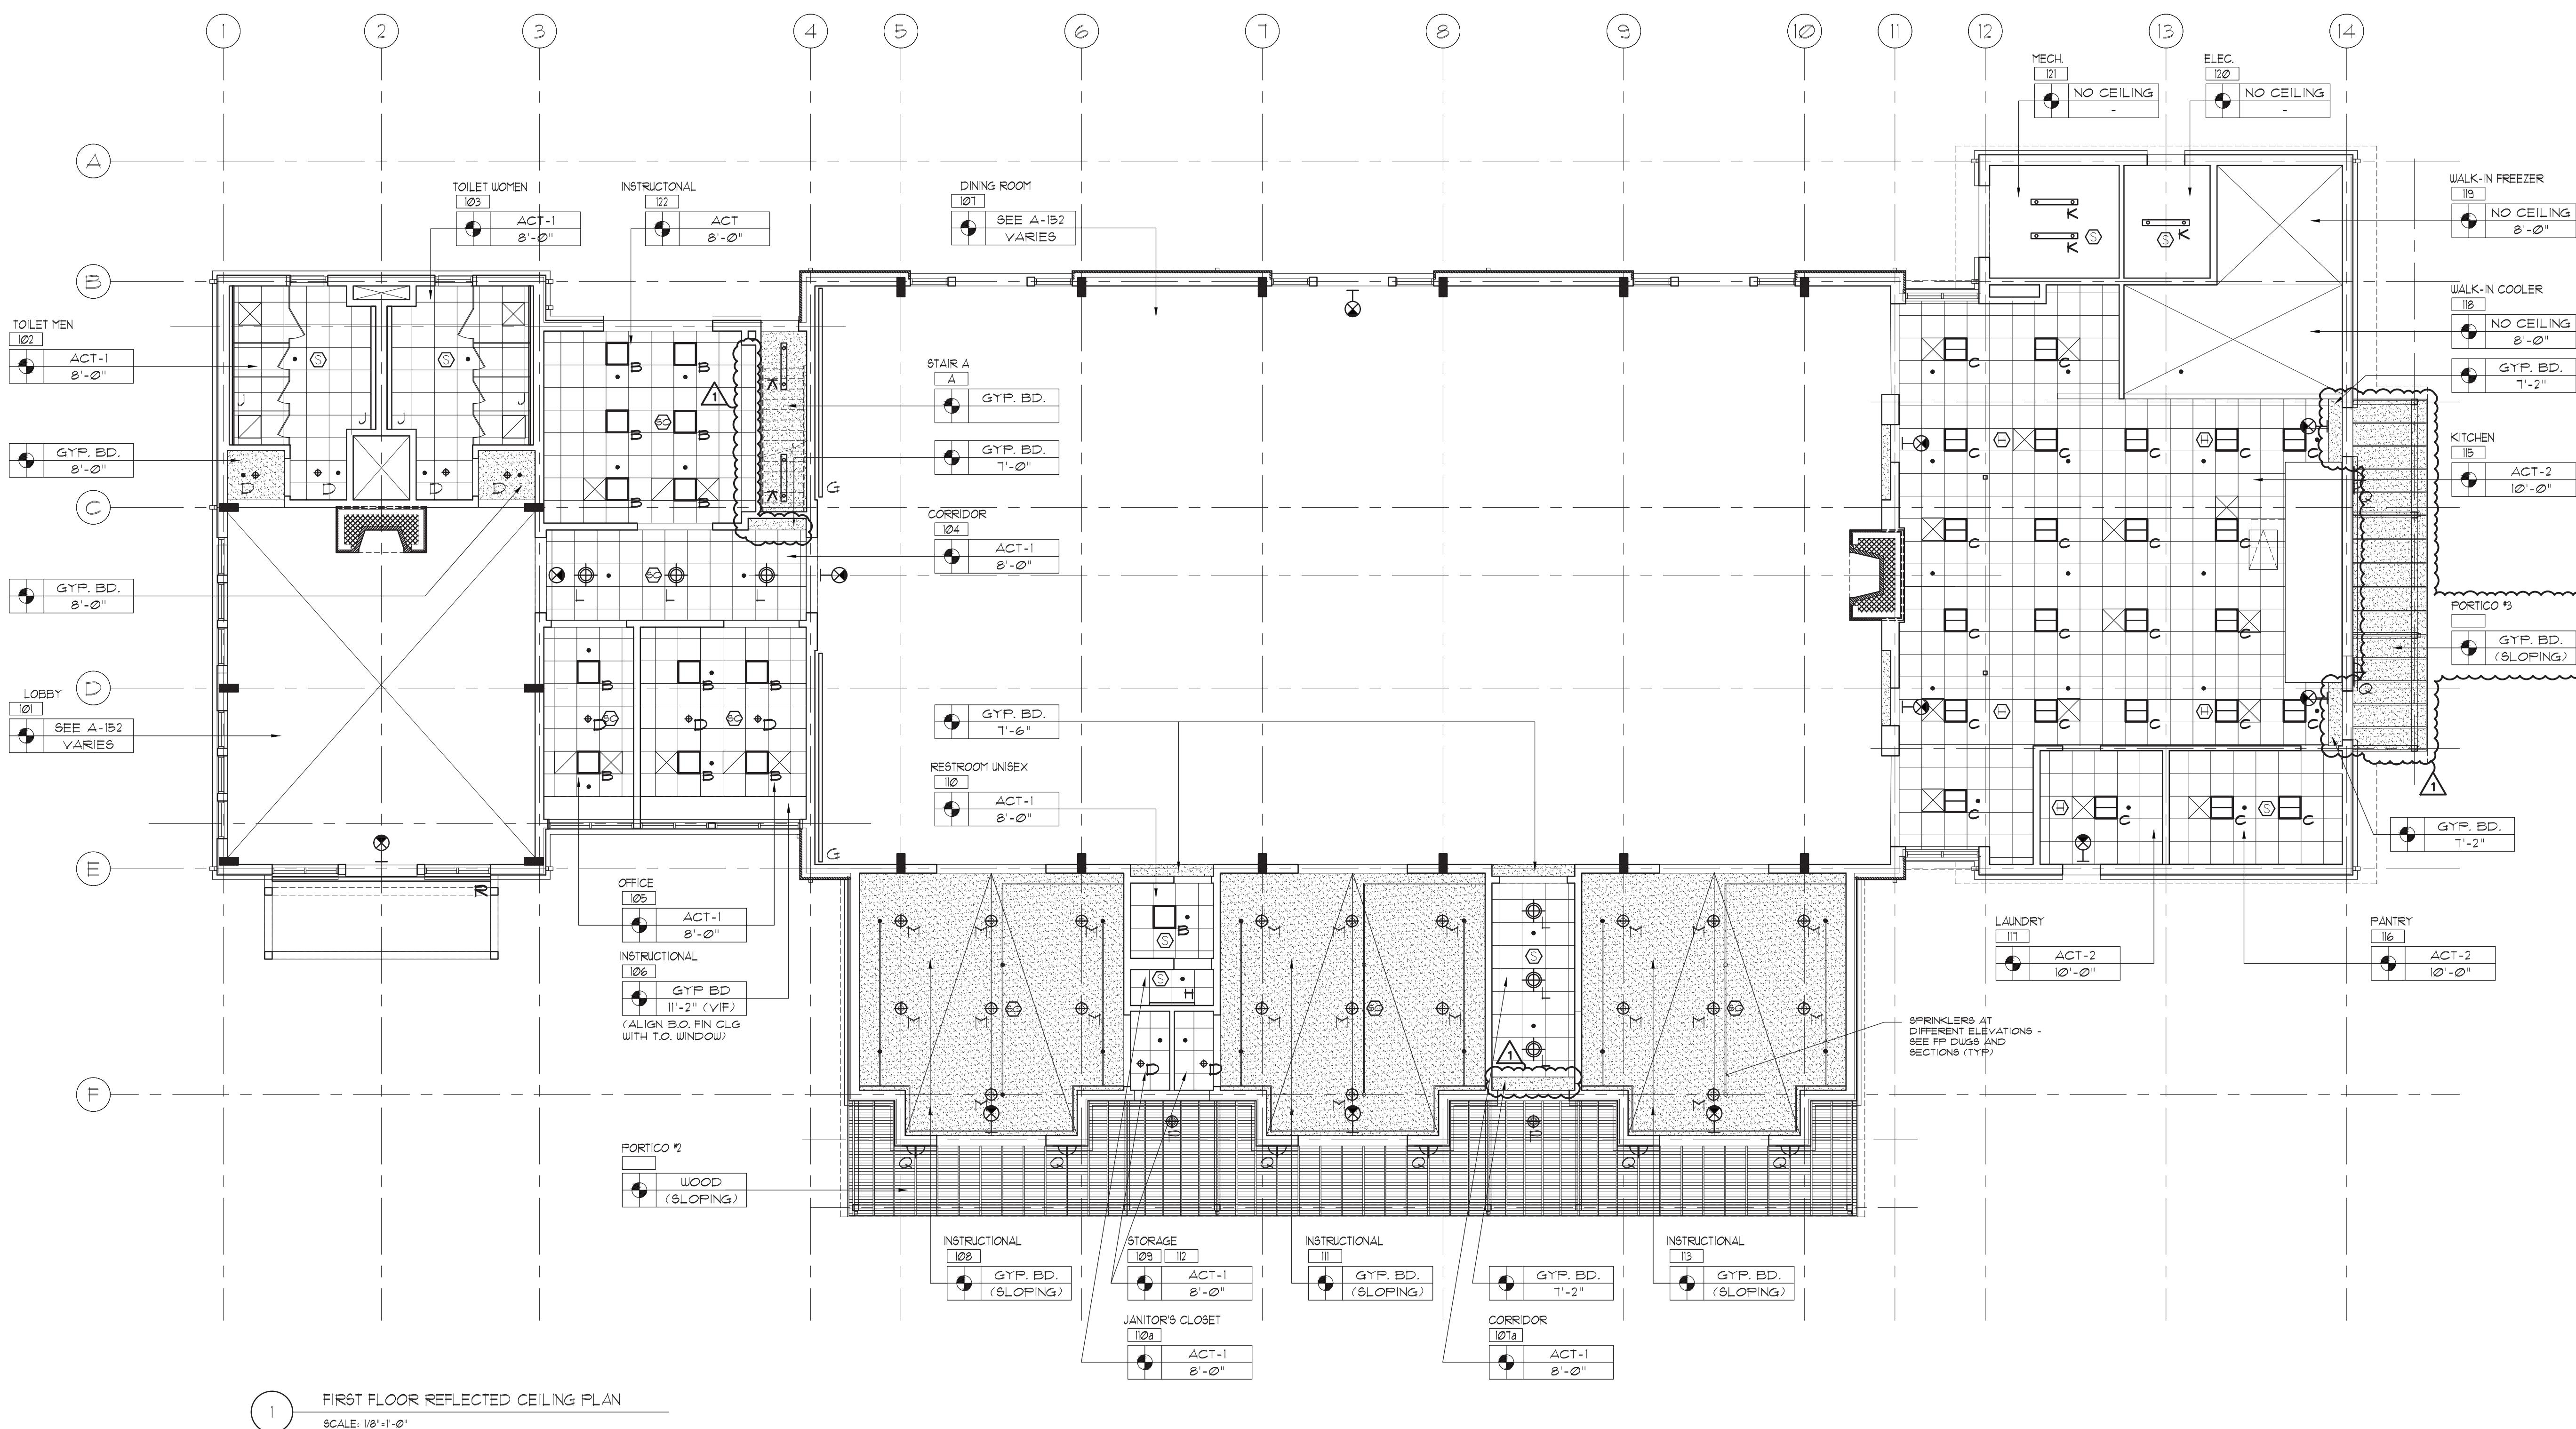
Drawing Title

FIRST FLOOR
CONSTRUCTION PLAN

Seal & Signature	Date: 06/21/2021
PROJECT No: 2005	DRAWN BY: CS, RW, MK
CHK BY: NL	DWG No:
A-101	
CADD FILE No:	-
W-2005 Girl Scouts of Greater NY	


1 FIRST FLOOR CONSTRUCTION PLAN
SCALE: 1/8"=1'-0"



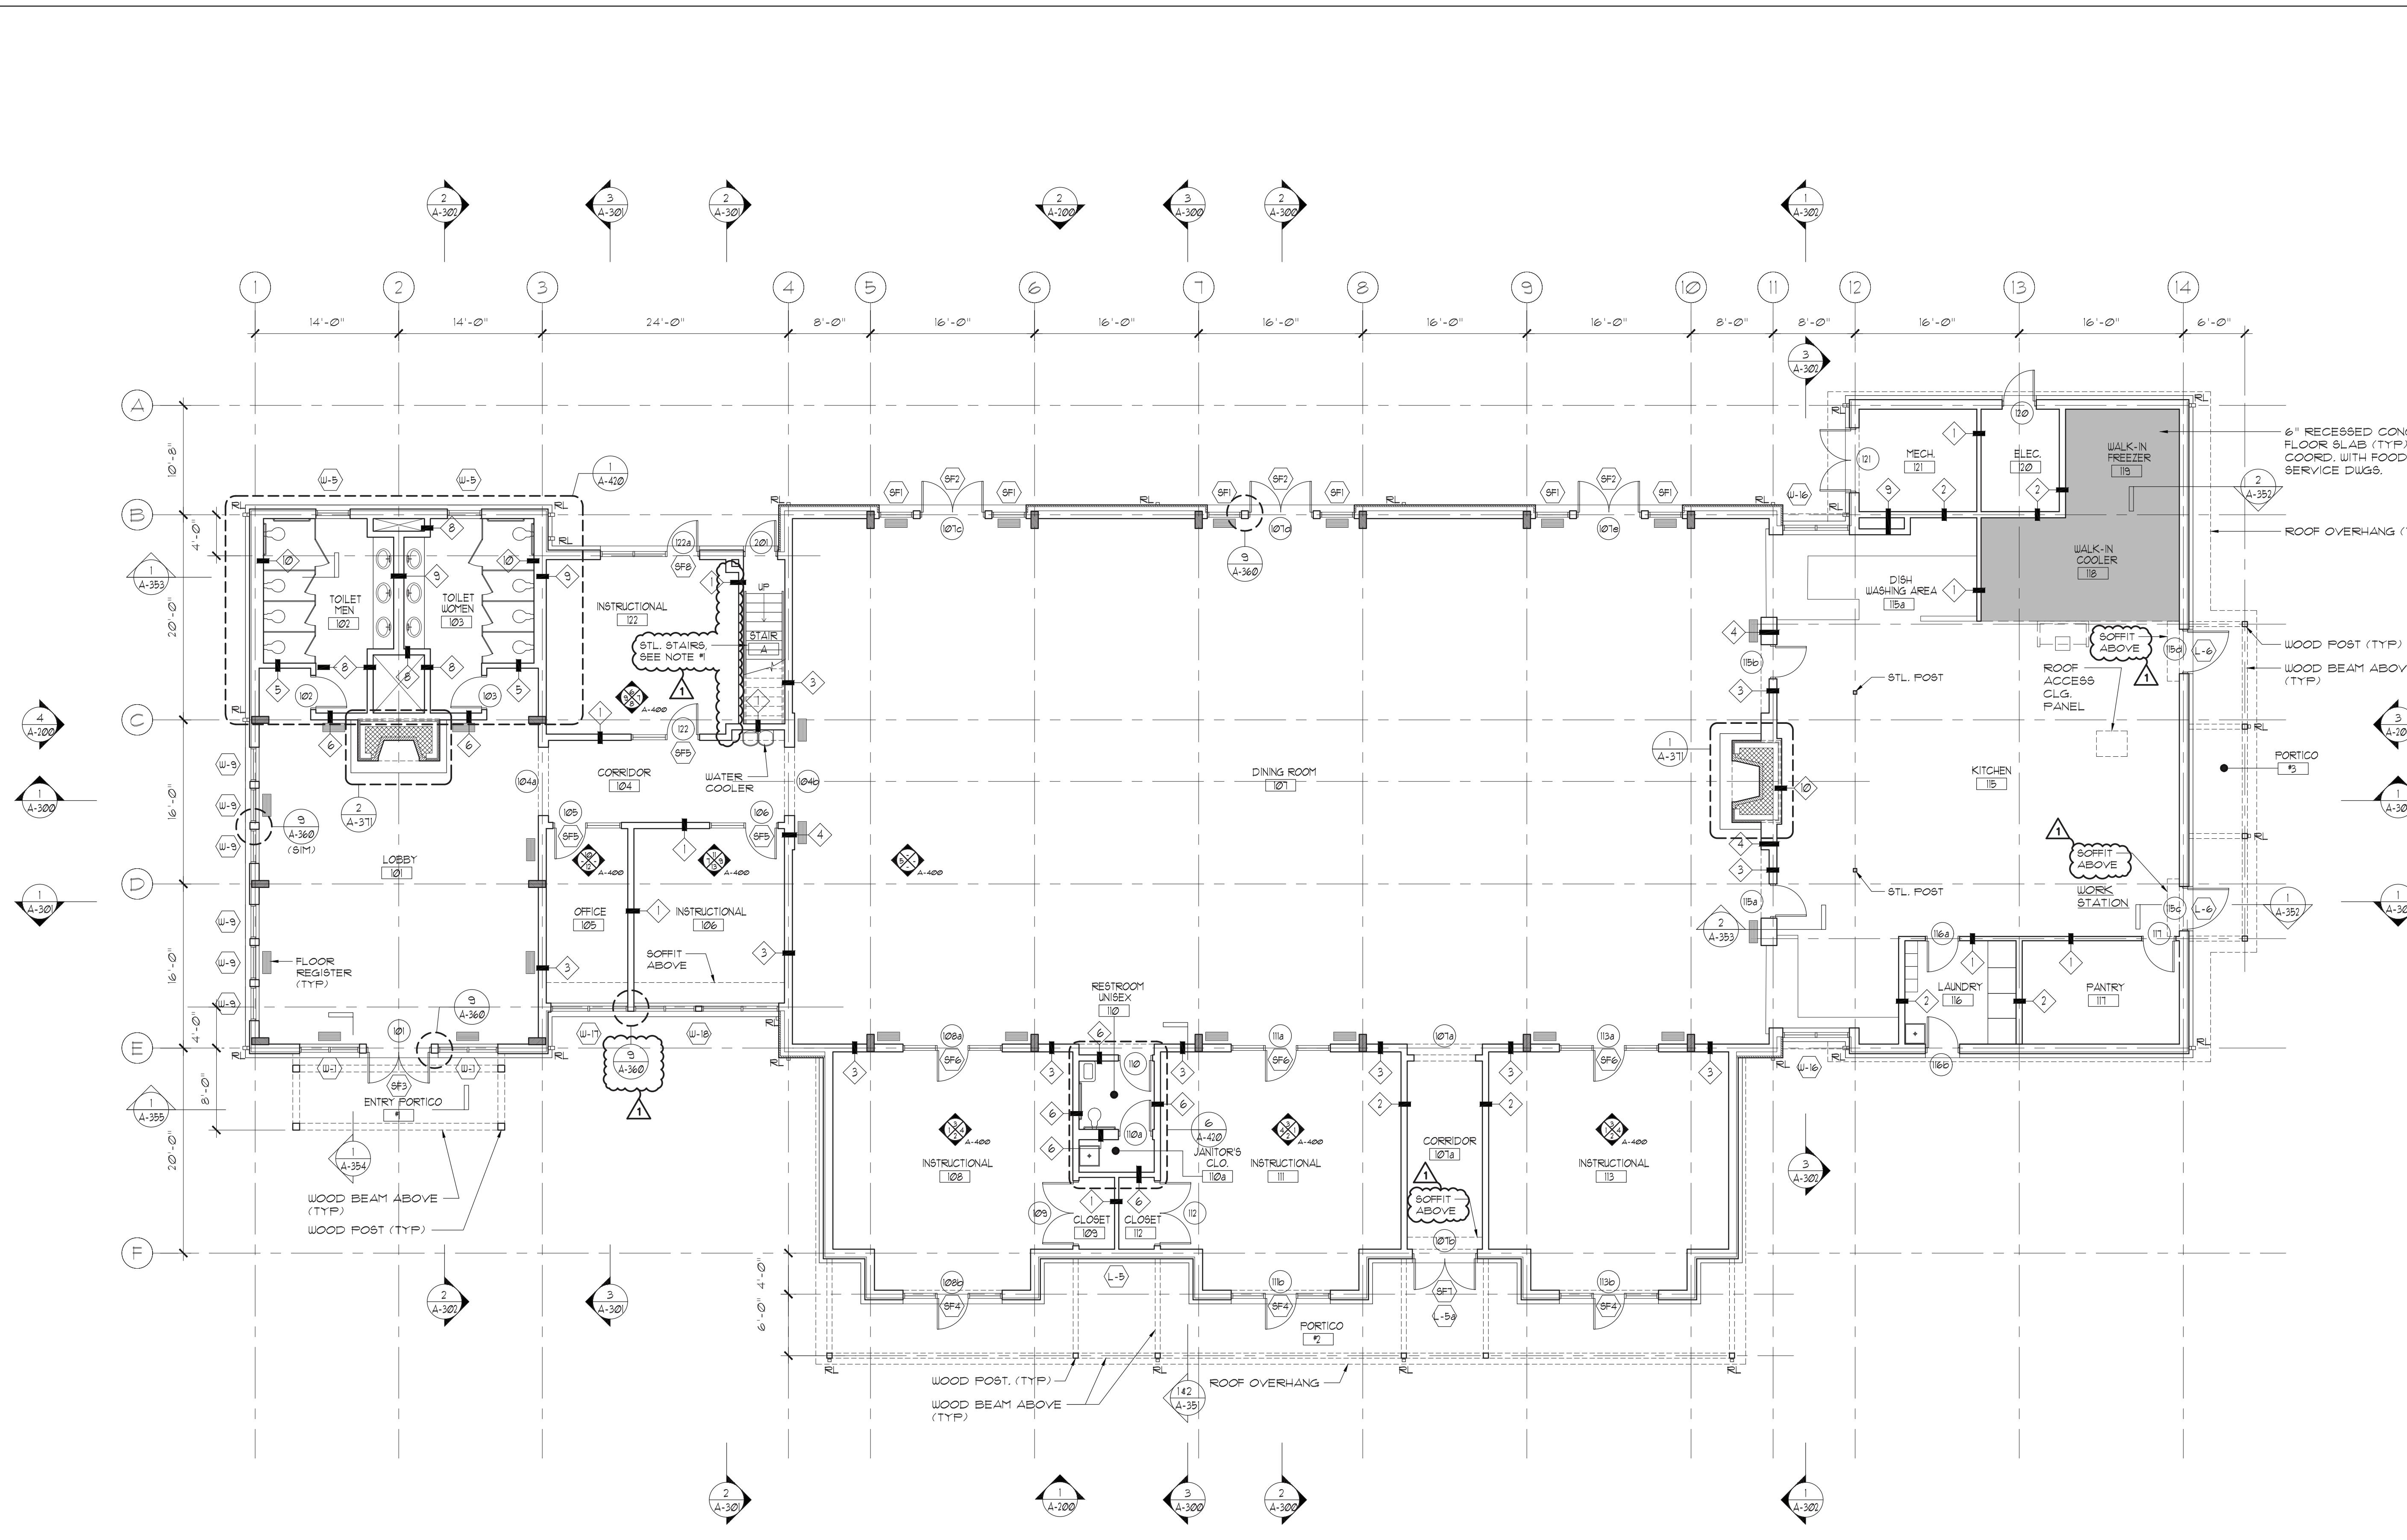


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FIRST FLOOR REFLECTED CEILING PLAN

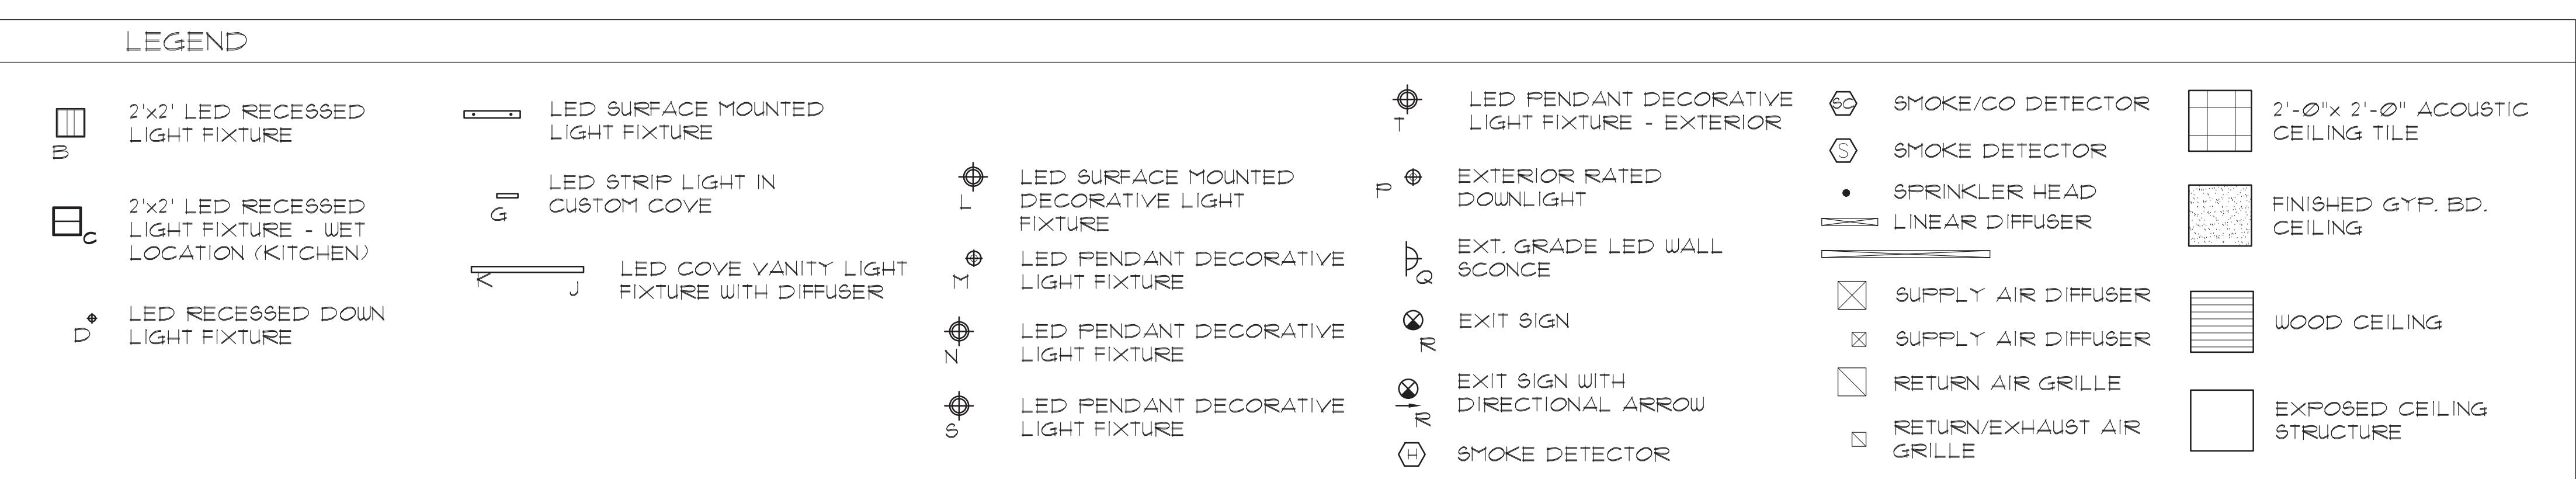

KEY PLAN

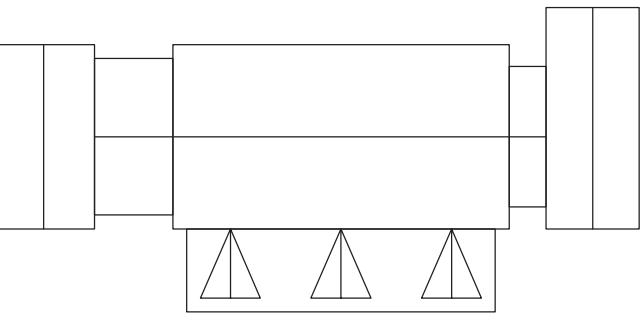

N.T.S.

1

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Project Title


**CAMP KAUFMANN
GIRL SCOUTS OF
GREATER NEW YORK**

81 CAMP ROAD
HOLMES, NY 12531

FIRST FLOOR REFLECTED CEIL

Seal & Signature	Date: 06/21/2021
	PROJECT No: 2005
	DRAWN BY: CS, RW, MK
	CHK BY: NL
	DWG No:
	A-151
	CADD FILE No: -
	W:\\2005 Girl Scouts of Greater NY


KEY PLAN

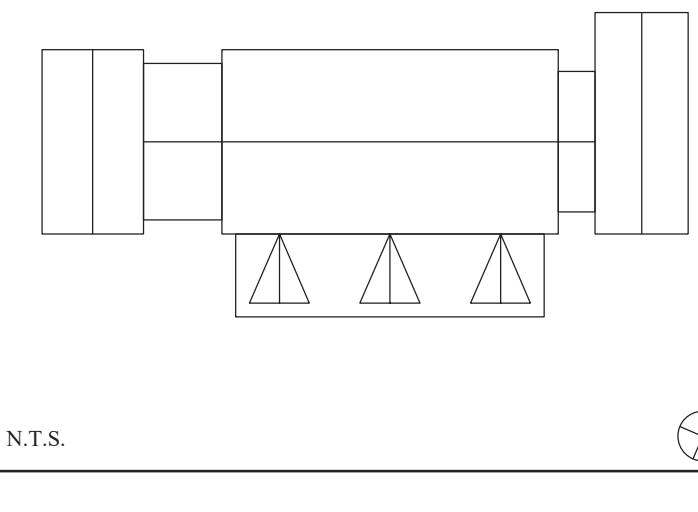


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GENERAL CONSTRUCTION NOTES


- IF DISCREPANCIES ARE FOUND BETWEEN ARCHITECTURAL DRAWINGS, AND STRUCTURAL DRAWINGS, CONTRACTOR SHALL CONTACT ARCHITECT FOR CLARIFICATION OR RESOLUTION BEFORE PROCEEDING WITH THE WORK.
- IF DISCREPANCIES ARE FOUND BETWEEN ARCHITECTURAL DRAWINGS, AND ROOFING DRAWINGS, CONTRACTOR SHALL CONTACT ARCHITECT FOR CLARIFICATION OR RESOLUTION BEFORE PROCEEDING WITH THE WORK.
- PLACE WEEP HOLES AT 24" O.C. ABOVE EACH FLASHING TERMINATION POINT. CONTRACTOR SHALL NOT COVER ANY WEEP HOLES NEAR GRADE WITH SOIL OR LANDSCAPE MATERIAL.
- PROVIDE FIRE RESISTANT COATING ON ALL EXPOSED SURFACES OF SPRAY-FOAM INSULATION.
- AT STUD WALLS WHERE CAST STONE SILLS, ROOF AND OTHER FLASHING ASSEMBLIES ARE TO BE INSTALLED PROVIDE 12 GAUGE STEEL PLATE BLOCKING BEHIND SHEATHING (OVER STUD FRAMING) TO RECEIVE FASTENERS.

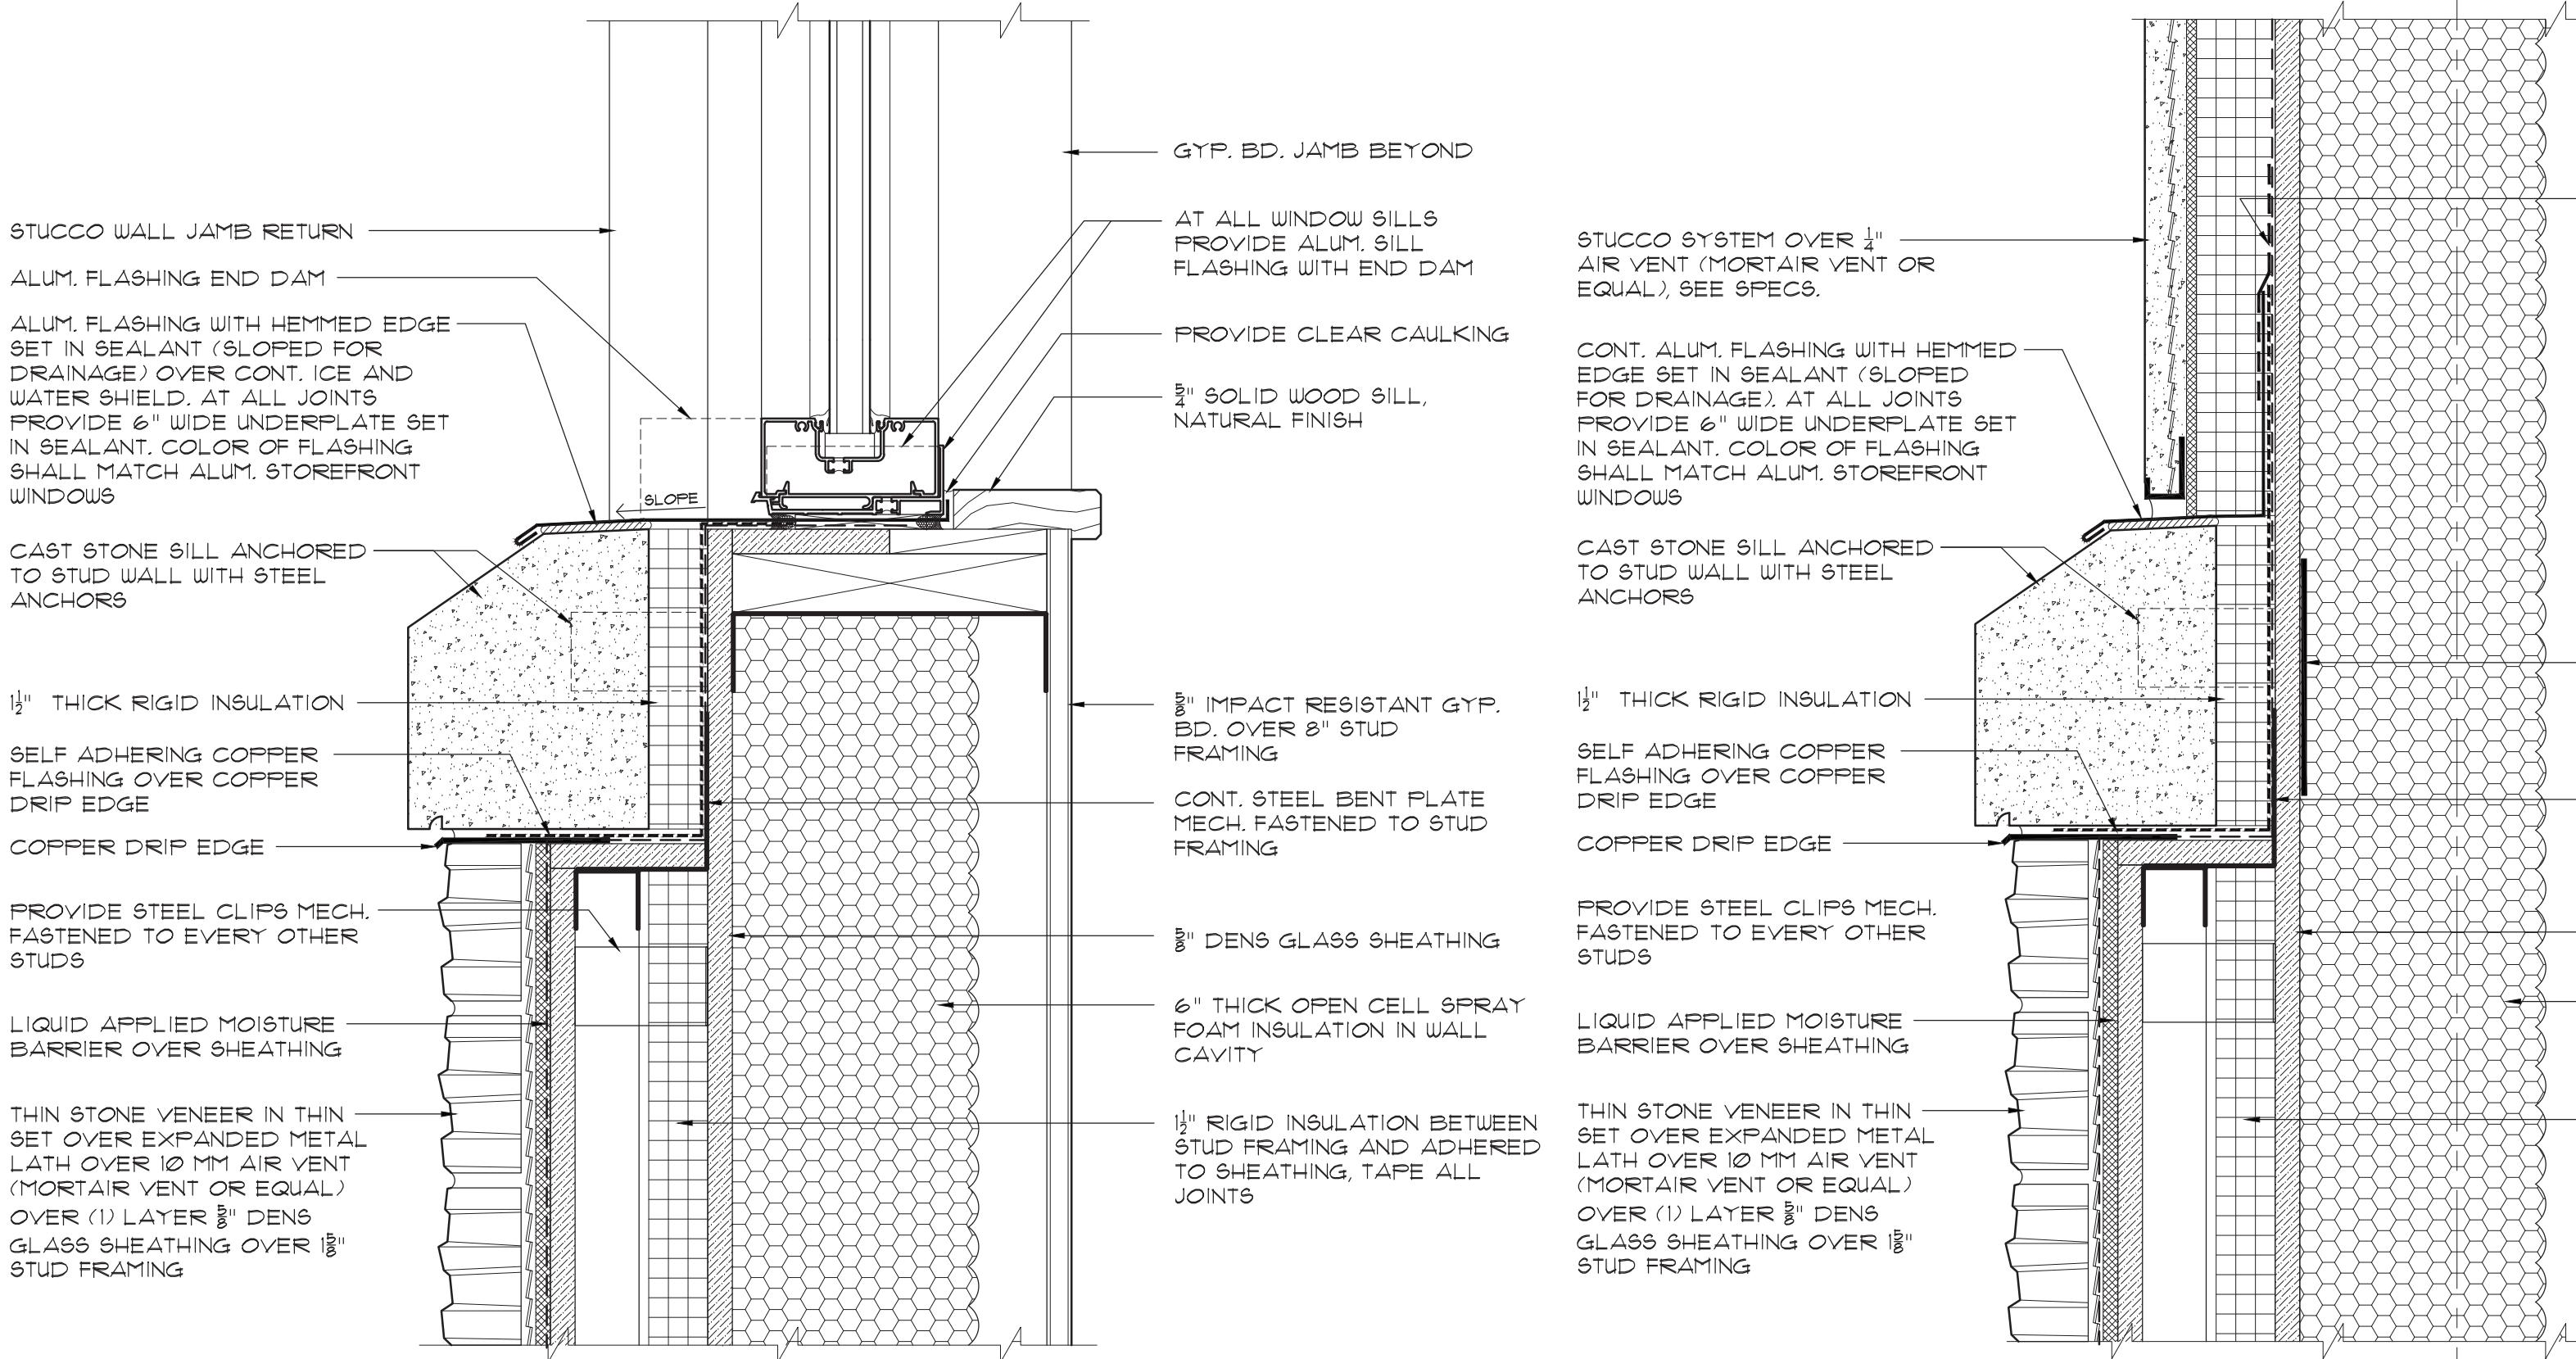


1 TYPICAL SILL DETAIL
SCALE: 3'-0"

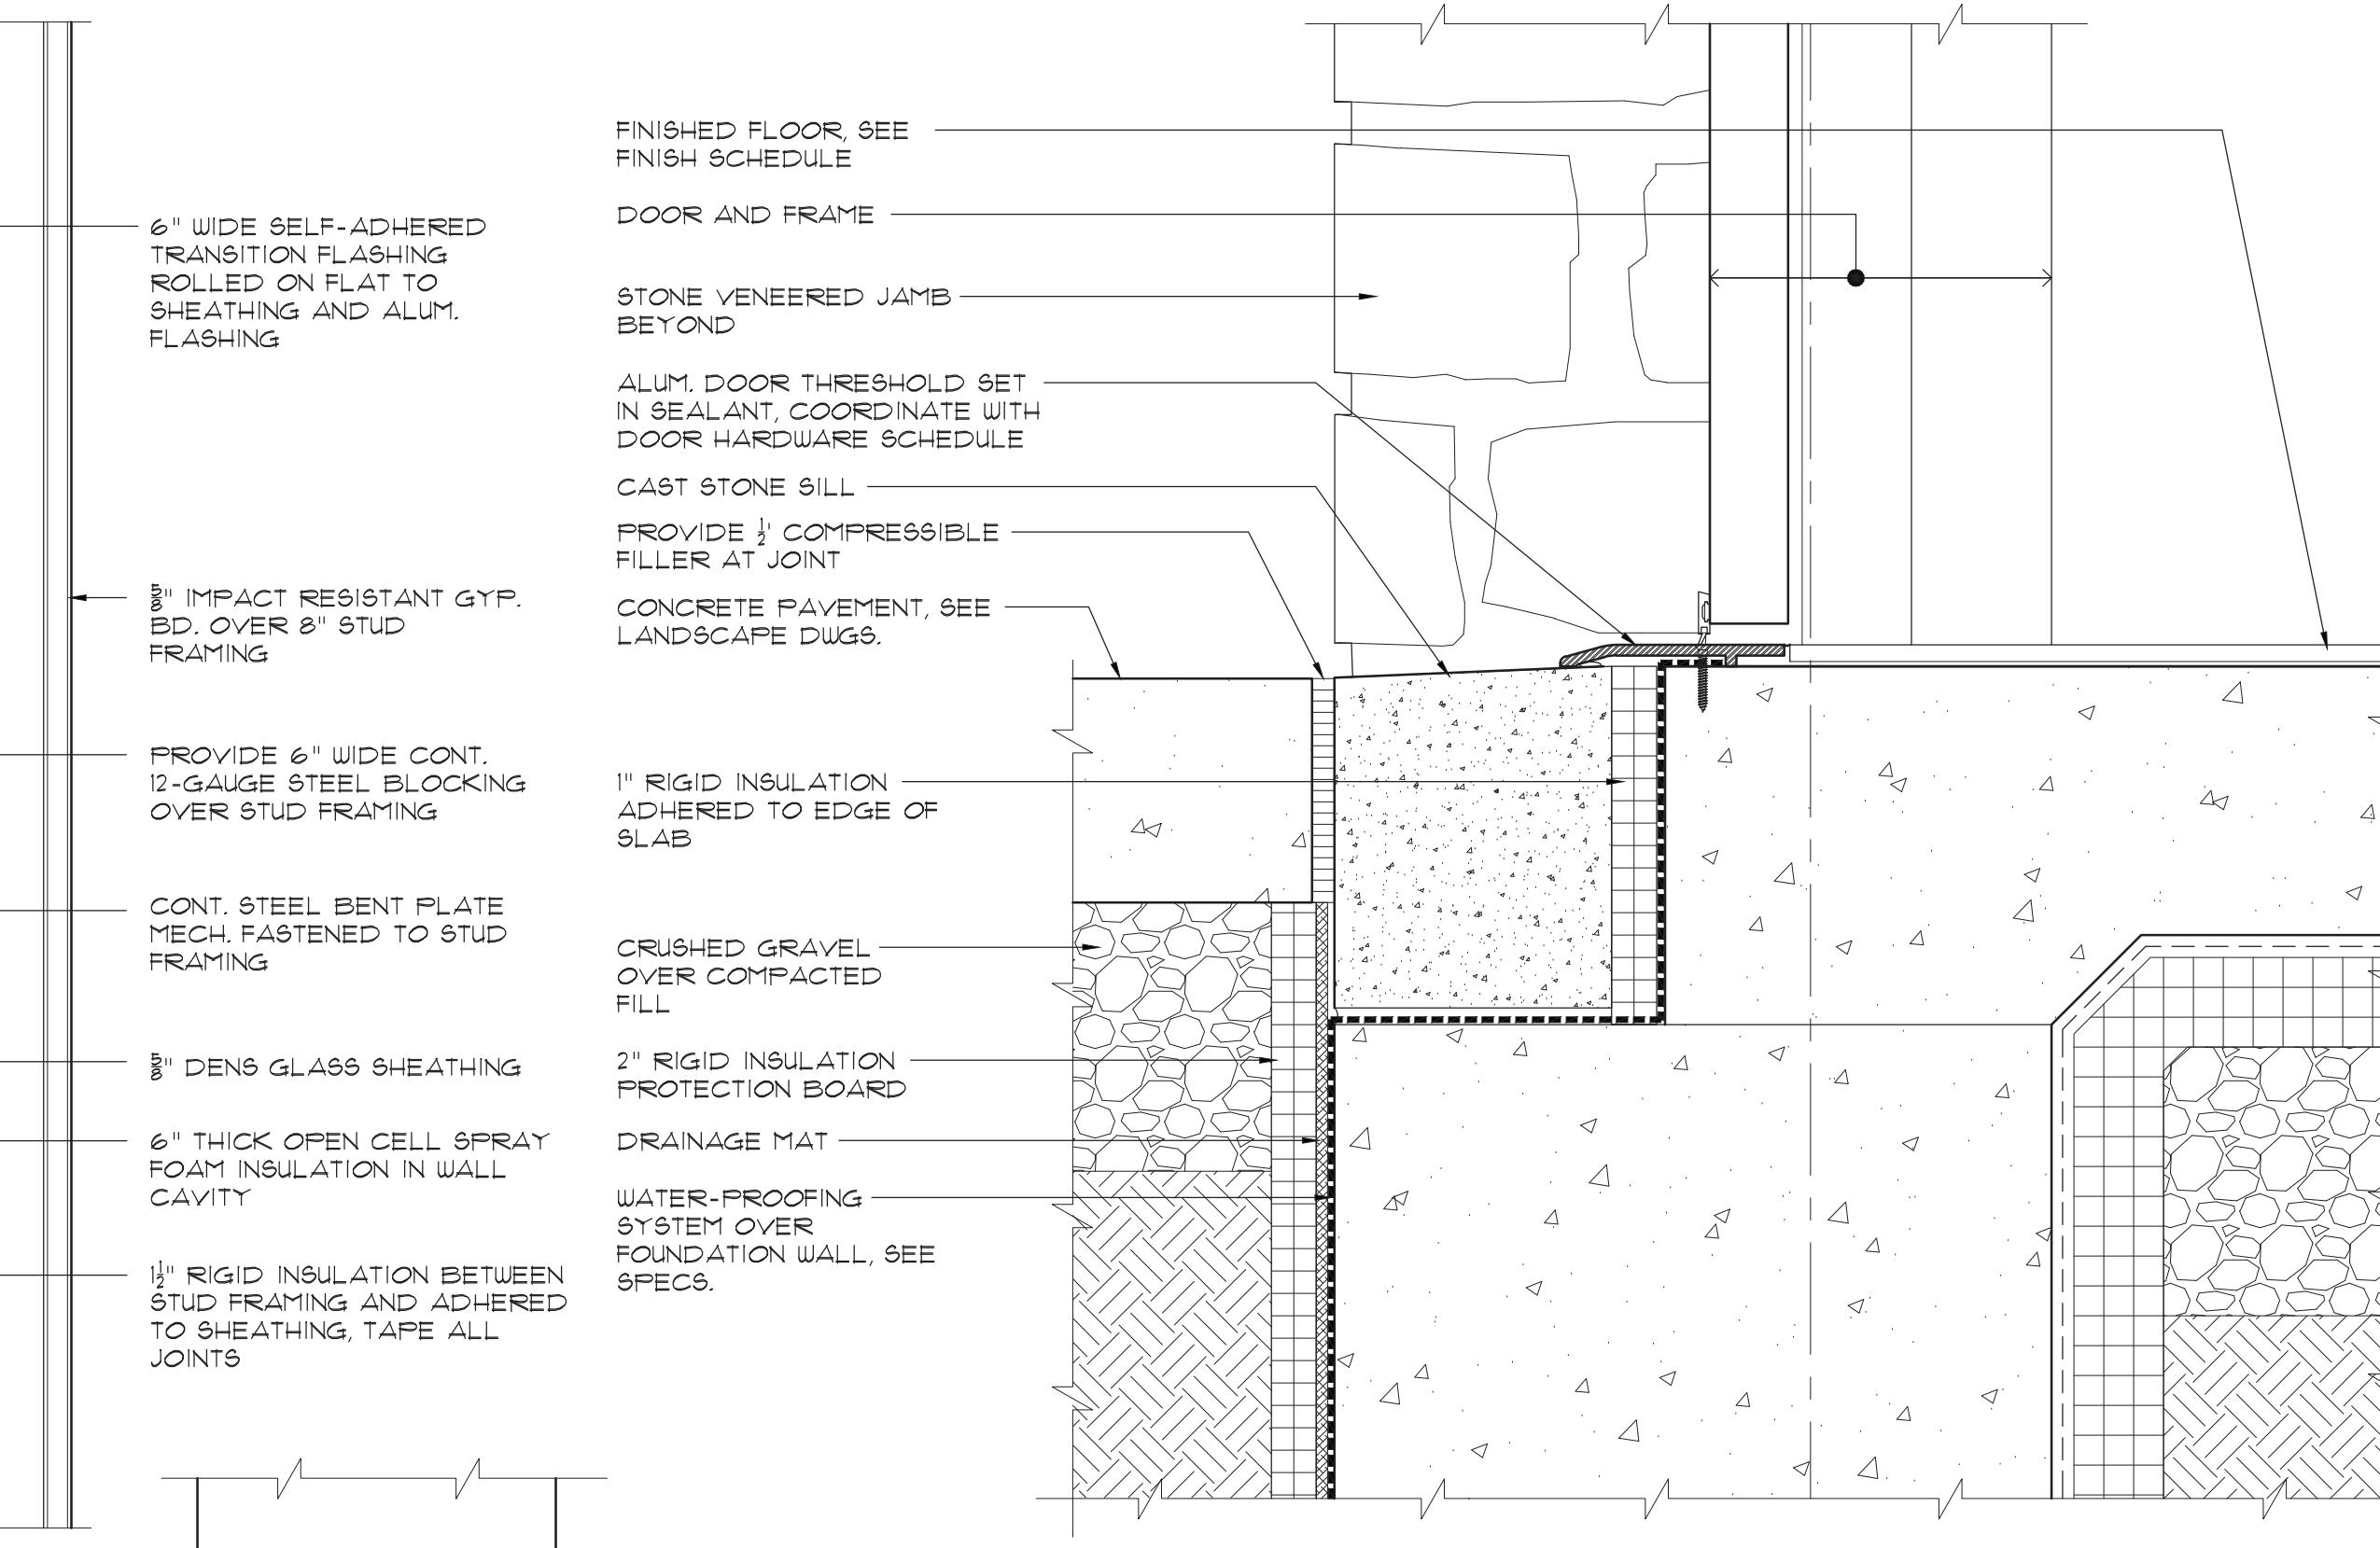


2 WALL DETAIL AT WATER-TABLE
SCALE: 3'-0"

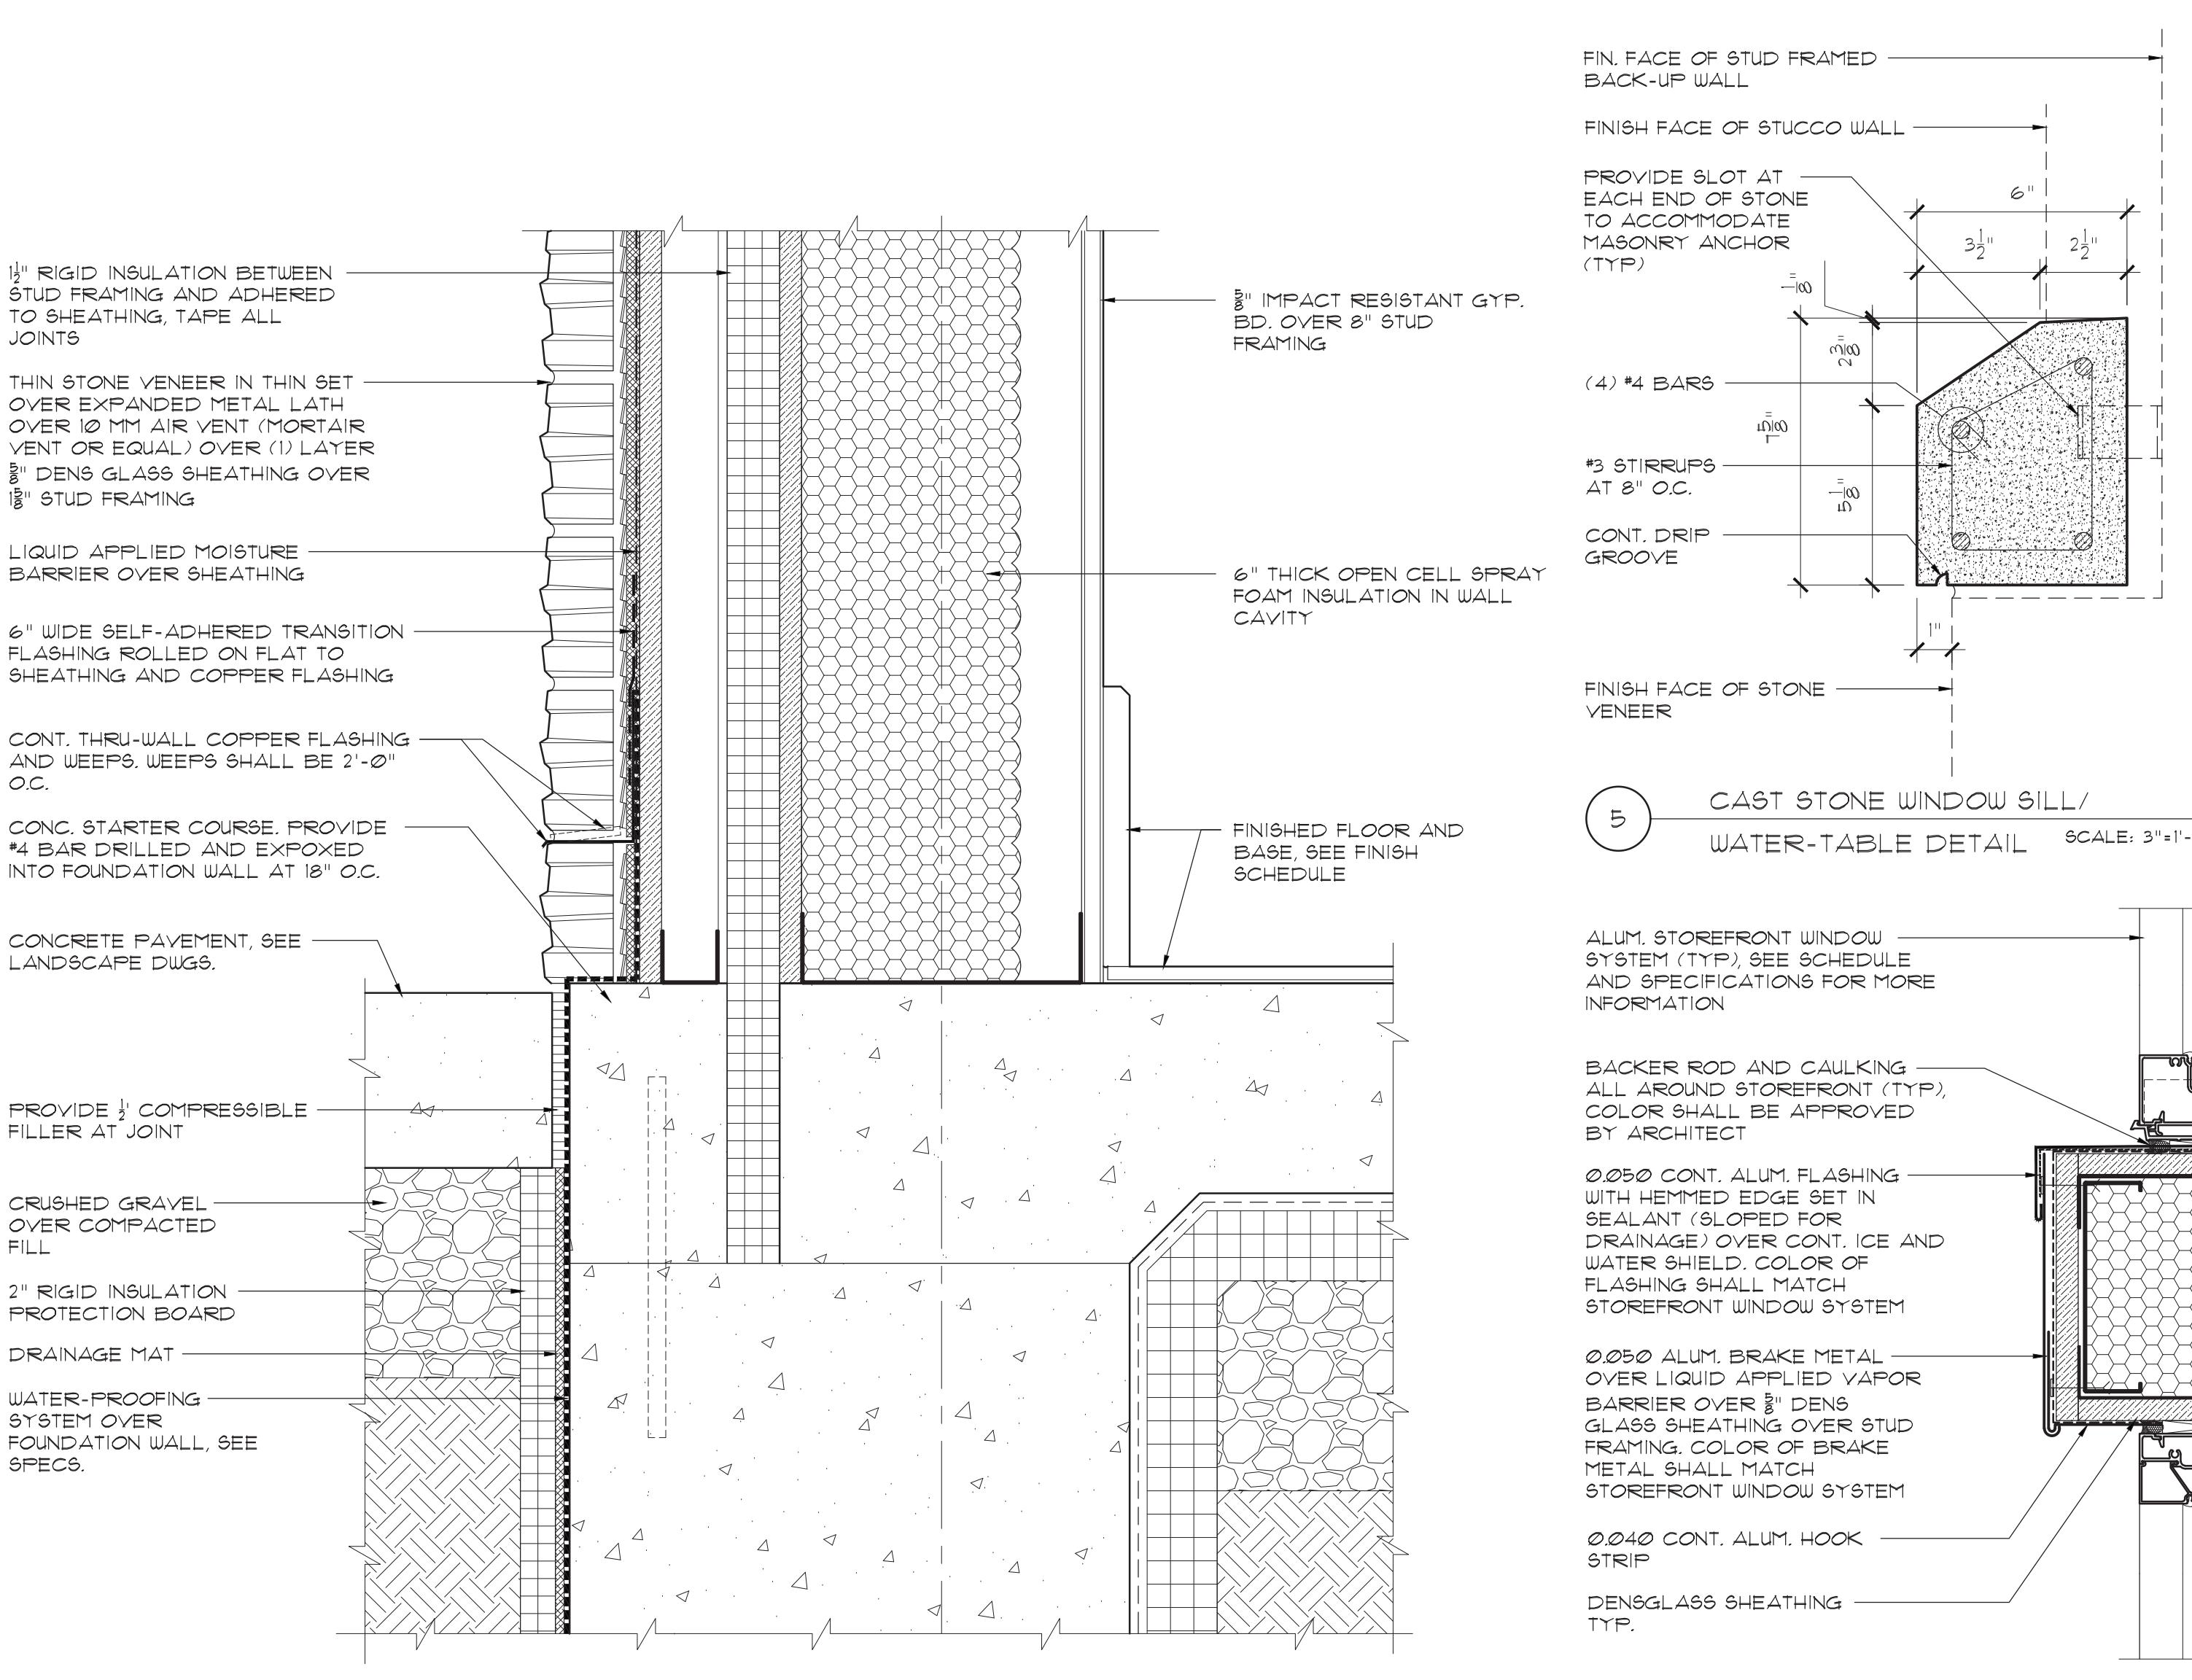


4 ENLARGED WALL DETAIL
SCALE: 3'-0"

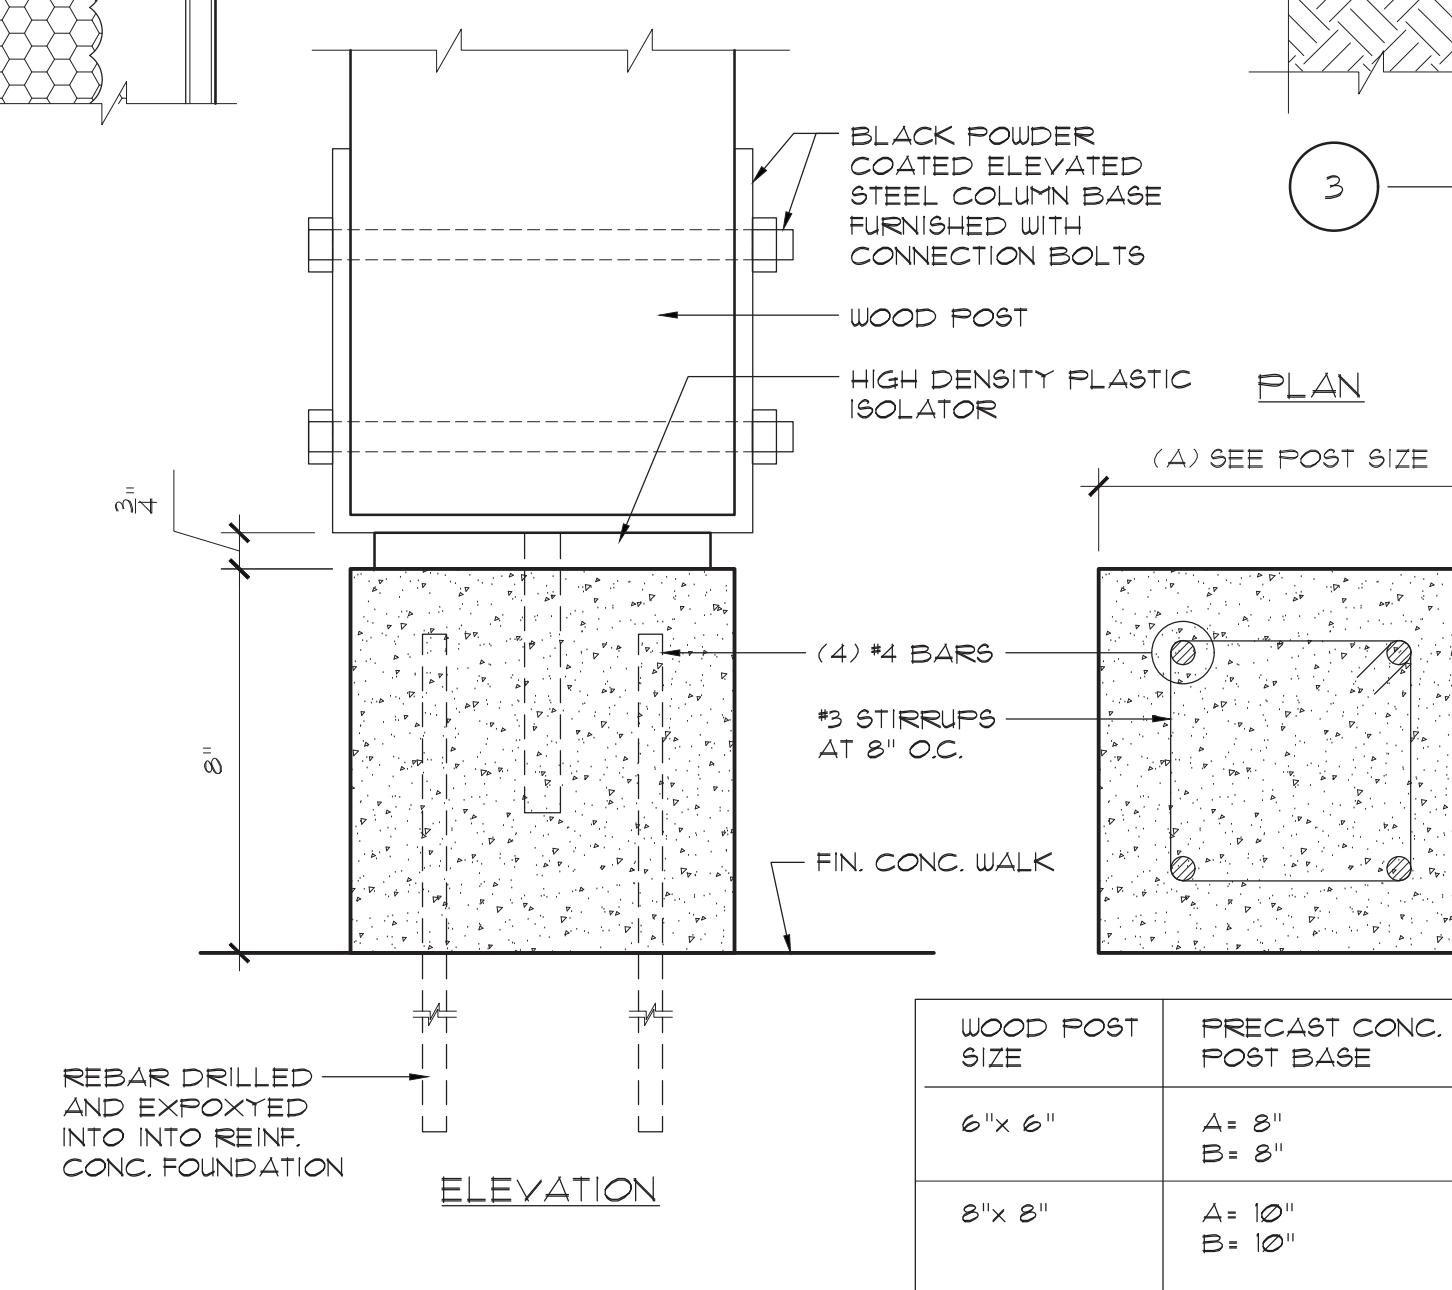

3 TYPICAL EXTERIOR DOOR SILL DETAIL
SCALE: 3'-0"

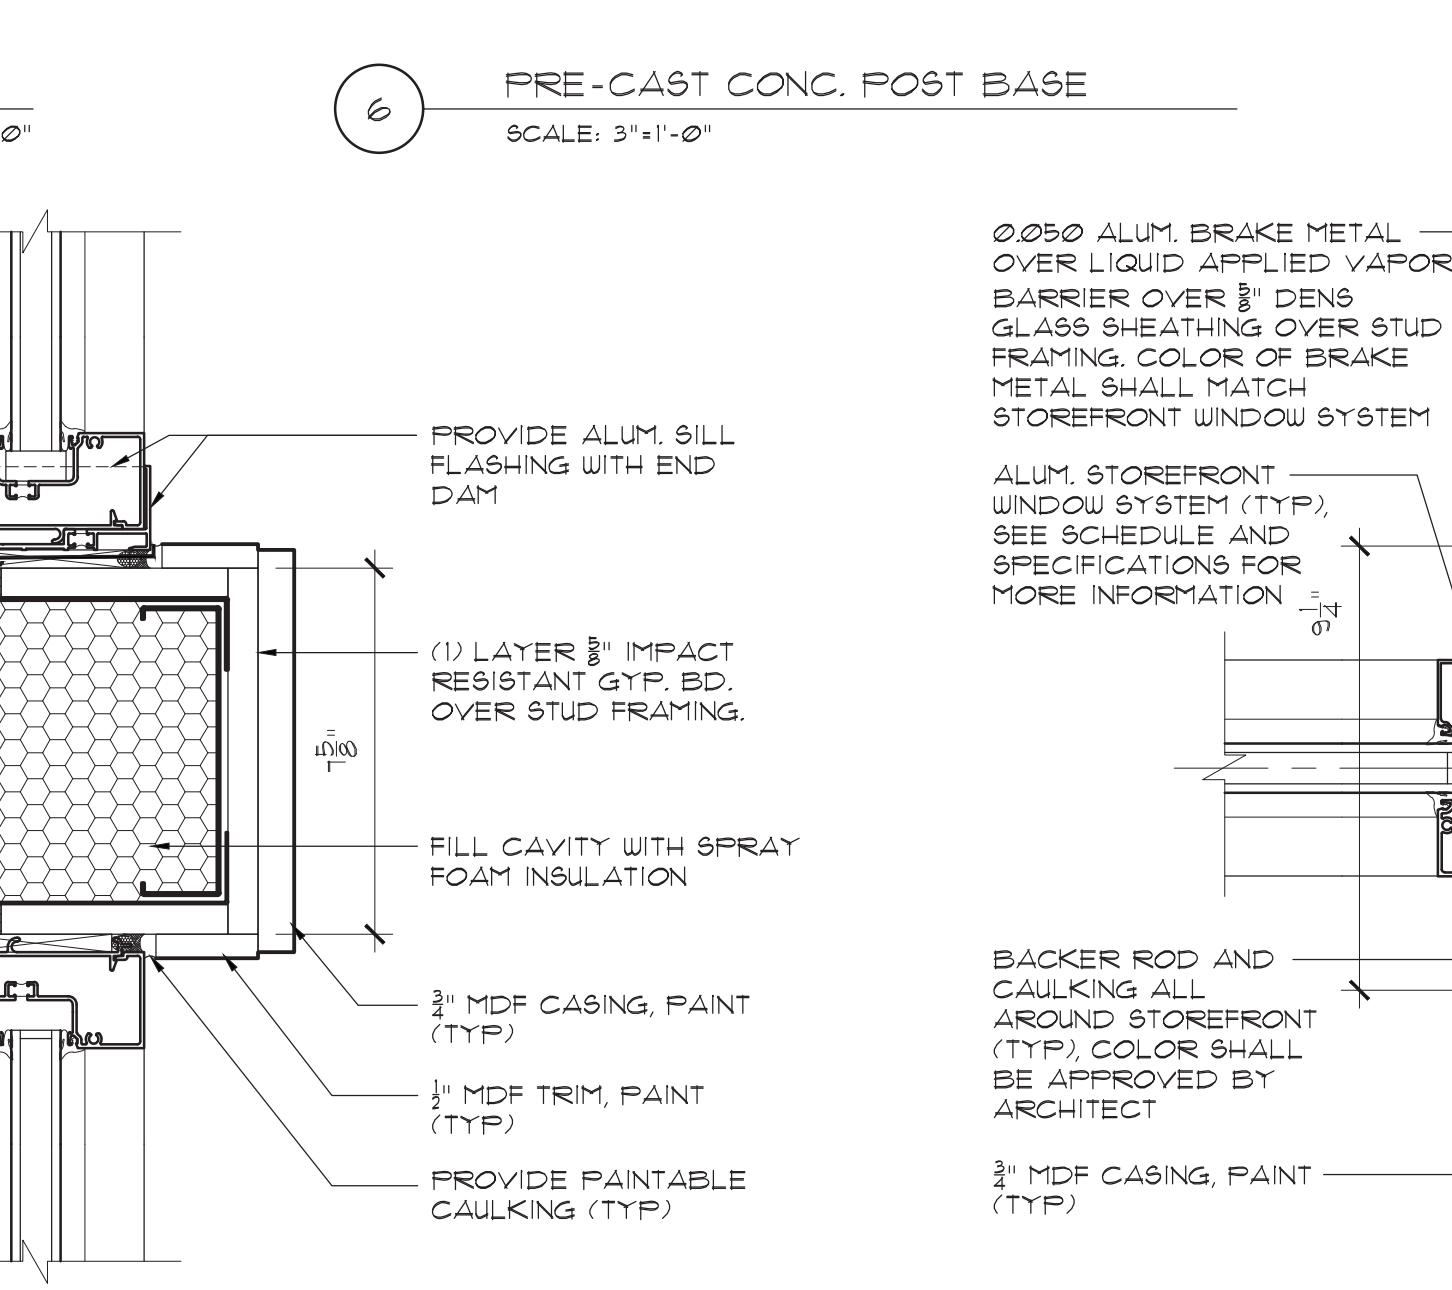

7 TYPICAL HORIZ. MULLION DETAIL
SCALE: 3'-0"

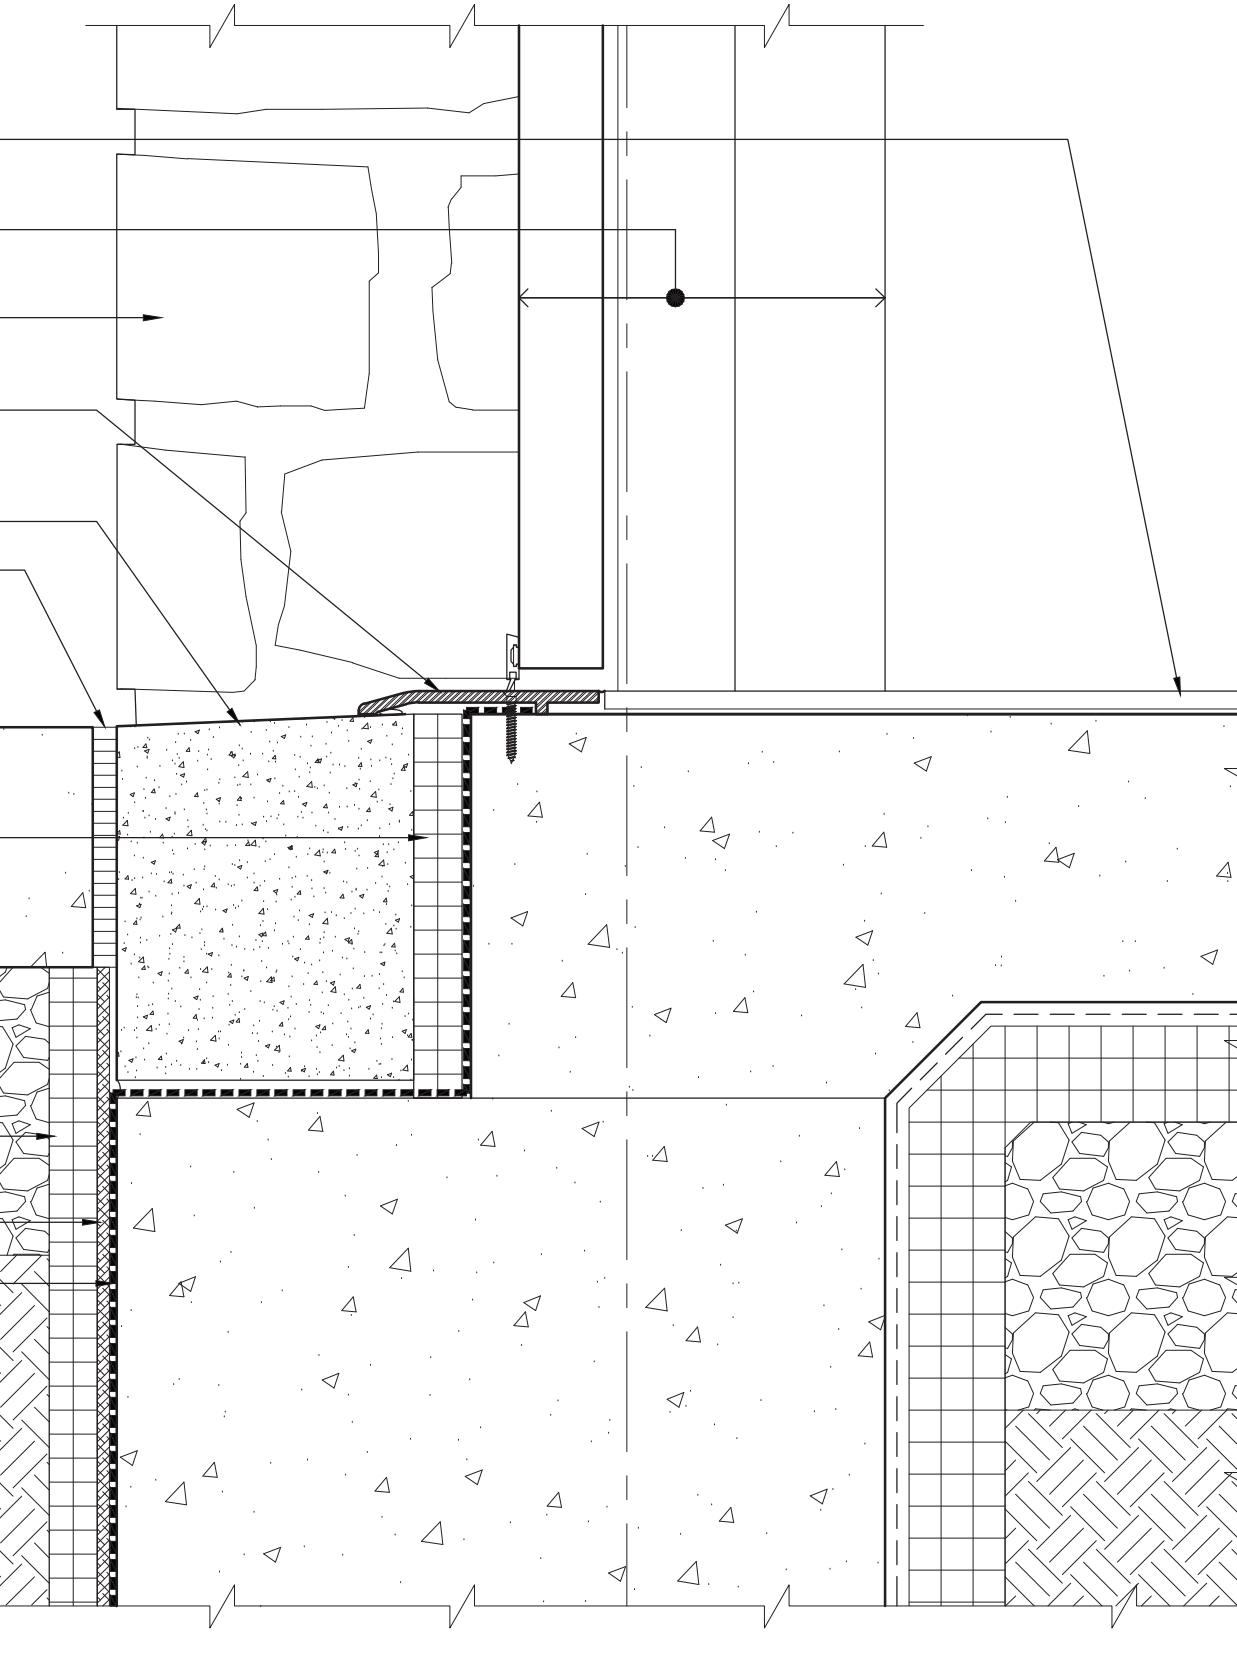

8 TYPICAL VERT. MULLION DETAIL
SCALE: 3'-0"

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Project Title: CAMP KAUFMANN
GIRL SCOUTS OF
GREATER NEW YORK

81 CAMP ROAD
HOLMES, NY 12531

Drawing Title:

ENLARGED DETAILS

Seal & Signature	Date: 06/21/2021
PROJECT No.: 2005	
DRAWN BY: CS, RW, MK	
CHK BY: NL	
DWG No:	
A-360	
CADD FILE No:	
W-2005 Girl Scouts of Greater NY	

