MECHANICAL ABBREVIATIONS

AC	AIR CONDITIONING UNIT	GPM	GALLONS PER MINUTE	RAR	RETURN AIR REGISTER
ACCU	AIR COOLED CONDENSING UNIT	HP	HEAT PUMP	RCP	REFLECTED CEILING PLAN
AD	ACCESS DOOR	HWR	HEATING HOT WATER RETURN	RF	RETURN FAN
AFF	ABOVE FINISHED FLOOR	HWS	HEATING HOT WATER SUPPLY	RG	RETURN GRILLE
АН	AIR HANDLER (SPLIT REFRIG)	HZ	HERTZ	SA	SUPPLY AIR
AHU	AIR HANDLING UNIT	LAT	LEAVING AIR TEMPERATURE	SAR	SUPPLY AIR REGISTER
AL	ACOUSTICAL LINING	LD	LINEAR DIFFUSER	SD	SMOKE DAMPER
BDD	BACK DRAFT DAMPER	MOD	MOTOR OPERATED DAMPER	SF	SUPPLY FAN
CD	CEILING DIFFUSER	MUA	MAKE-UP AIR UNIT	SP	STATIC PRESSURE
CFM	CUBIC FEET PER MINUTE	NC	NORMALLY CLOSED	TG	TRANSFER GRILLE
CUH	CABINET UNIT HEATER	NO	NORMALLY OPEN	TYP	TYPICAL
DB	DRY BULB	NIC	NOT IN CONTRACT	UH	UNIT HEATER
EAT	ENTERING AIR TEMPERATURE	NK	NECK	UON	UNLESS OTHERWISE NOTED
EF	EXHAUST FAN	OA	OUTSIDE AIR	VAV	VARIABLE AIR VOLUME UNIT
ER	EXHAUST REGISTER	OAI	OUTSIDE AIR INTAKE	VD	VOLUME DAMPER
	EXTERNAL STATIC PRESSURE	OAT	OUTSIDE AIR TEMPERATURE		
ESP		OBD	OPPOSED BLADE DAMPER	WB	WET BULB
FC	FLEXIBLE CONNECTION	RA	RETURN AIR	WMS	WIRE MESH SCREEN
FCU	FAN COIL UNIT	RAG	RETURN AIR GRILLE		
	E:0E 0 : : : 0 = 0				

NOTE: NOT ALL SYMBOLS AND ABBREVIATIONS ARE NECESSARILY USED ON THIS PROJECT

FIRE DAMPER

— – — COLD WATER

GENERAL NOTES

- 1. ALL WORK SHALL COMPLY WITH AND BE INSTALLED IN ACCORDANCE WITH THE 2020 NYS BUILDING CODE, NYS MECHANICAL CODE, NYS ENERGY CONSERVATION CODE OF 2020 AND THE LATEST NEW YORK STATE SUPPLEMENTAL CODE.
- 2. DUCTWORK IS SHOWN DIAGRAMMATICALLY. EXACT ROUTING OF NEW DUCTWORK SHALL BE DETERMINED IN FIELD.
- 3. THE WORDS PROVIDE OR INSTALL, SINGLY OR IN COMBINATION, SHALL MEAN FURNISH AND INSTALL.
- 4. THE CONTRACTOR SHALL PROVIDE ALL CUTTING AND PATCHING AS REQUIRED FOR THE INSTALLATION OF HIS WORK. NO CUTTING OF STRUCTURAL MEMBERS PERMITTED.
- 5. THE CONTRACTOR SHALL TURN OVER TO THE OWNER AT THE COMPLETION OF ALL WORK, THREE (3) COPIES OF OPERATING, MAINTENANCE AND INSTRUCTION MANUALS WHICH SHALL INCLUDE ALL EQUIPMENT BROCHURES, DUCT AND WIRING DIAGRAMS, DRAWINGS, TEMPERATURE CONTROLS, AND START—UP AND SHUTDOWN PROCEDURES OF ALL NEW EQUIPMENT INSTALLED.
- 6. THE CONTRACTOR SHALL FILE FOR AND SECURE ALL PERMITS AND PAY ALL FEES REQUIRED FOR THE INSTALLATION OF HIS WORK.
 7. THE CONTRACTOR SHALL GUARANTEE ALL MATERIAL AND WORK INSTALLED BY HIM TO BE FREE FROM DEFECTS AND WORKMANSHIP FOR A PERIOD OF ONE (1) YEAR, AFTER ACCEPTANCE OF THE INSTALLATION BY THE ENGINEER AND OWNER. THE CONTRACTOR SHALL SUBMIT A WRITTEN STATEMENT STATING SAME TO THE OWNER.
- 8. ALL WORK SHALL BE PERFORMED BY LICENSED CONTRACTORS IN THE TRADE HAVING JURISDICTION.
- 9. ANY DEVIATION OR CHANGE IN DESIGN SHALL NOT BE MADE WITHOUT WRITTEN APPROVAL OF THE ENGINEER.
- 10. THIS CONTRACTOR SHALL SUBMIT SHOP DRAWINGS OF ALL EQUIPMENT AND MATERIALS INCLUDING CONTROL WIRING DIAGRAMS TO THE ENGINEER FOR APPROVAL PRIOR TO FABRICATION AND INSTALLATION OF NEW WORK. SHOP DRAWINGS SHALL INDICATE STRUCTURAL MEMBERS, WALLS, FLOORS, DUCTWORK, ETC., WITH ELEVATIONS AT WHICH NEW WORK IS TO BE INSTALLED. ANY DEVIATION IN DESIGN SHALL NOT BE MADE WITHOUT WRITTEN APPROVAL OF THE ENGINEER.
- 11. THIS CONTRACTOR SHALL HIRE AN INDEPENDENT BALANCING CONTRACTOR WHO IS CERTIFIED BY AABC OR NEBB TO PERFORM AIR BALANCING WORK. THREE (3) COPIES OF BALANCING REPORT SHALL BE SUBMITTED TO THE ARCHITECT/ENGINEER FOR APPROVAL.
- 12. ALL WIRING OF MECHANICAL EQUIPMENT SHALL BE PROVIDED BY THE ELECTRICAL CONTRACTOR UNDER THE SUPERVISION OF THE HVAC
- 13. ALL ELECTRICAL WORK SHALL BE INSTALLED AS REQUIRED BY THE CONNECTICUT BUILDING CODE CHAPTER 27, THE NATIONAL ELECTRIC CODE AND NFPA 70.
- 14. ALL EQUIPMENT SHALL BE INSTALLED IN ACCORDANCE WITH THE MFR'S RECOMMENDATIONS.

MECHANICAL SYMBOLS (SERVICE AS INDICATED) NEW DUCTWORK EXISTING PIPING TO REMAIN ——E.(NAME) ——— (SERVICE AS INDICATED) EXISTING PIPING TO BE REMOVED ~//_(NAME)///, (SERVICE AS INDICATED) EXISTING DUCTWORK TO REMAIN EXISTING DUCTWORK TO BE REMOVED SECTION THROUGH RETURN OR EXHAUST AIR SECTION THROUGH SUPPLY OR OUTSIDE AIR DUCT BUTTERFLY VALVE ACCESS DOOR (BOTTOM OR SIDE) BALL VALVE ACOUSTICALLY LINED DUCT CHECK VALVE FD DAMPER, FIRE VD DAMPER. MANUAL VOLUME RELIEF/SAFETY VALVE THREE WAY CONTROL VALVE TRANSITION, RECTANGULAR TO ROUND TWO WAY CONTROL VALVE FLEXIBLE DUCT UNION - SCREWED OR FLANGED STRAINER PIPE RISING UP CEILING SUPPLY AIR DIFFUSER (CD) PIPE DROPPING DOWN PIPE UP SIDEWALL SUPPLY AIR REGISTER (SR) THERMOMETER PRESSURE GAGE ELBOW TURNED DOWN ELBOW TURNED UP CENTRIFUGAL FAN ELBOW, SQUARE OR RECTANGULAR TYPE ROOM OR ZONE THERMOSTAT WITH AIRFOIL TURNING VANES CONNECT NEW TO EXISTING CEILING RETURN AIR REGISTER (RR) DISCONNECT FROM EXISTING SIDEWALL RETURN AIR REGISTER (RR) FIRE DAMPER AND ACCESS DOOR OPEN END DUCT VD VOLUME DAMPER FLEXIBLE CONNECTION CEILING RETURN GRILLE CEILING DIFFUSER

DIRECTION OF AIR FLOW

HVAC NOTES

- PROVIDE SLEEVES FOR ALL DUCTS AND PIPING PASSING THROUGH PARTITIONS, FLOORS OR MASONRY WALLS. PACK SLEEVE AROUND DUCT WITH THERMOFIBER OR APPROVED FIRE RATED MATERIAL. SLEEVES SHALL BE 18 GAGE GALVANIZED SHEET STEEL. SEAL ALL SLEEVES WETHERTIGHT THROUGH EXTERIOR WALLS.
- 2. SUSPEND AND SUPPORT ALL NEW DUCTWORK AND EQUIPMENT FROM BUILDING STRUCTURE ONLY.
- 3. DUCTWORK SHALL BE FABRICATED AND INSTALLED ACCORDING TO LOCAL CODE & SMACNA LOW PRESSURE FLEXIBLE AND METAL DUCT STANDARDS LATEST EDITION. PROVIDE BUTTERFLY TYPE VOLUME DAMPERS WITH LOCKING QUADRANT AS INDICATED ON THE PLANS. DUCT SHALL BE GALV. SHEET METAL.
- 4. PROVIDE ALL SUPPORT STEEL AS REQUIRED FOR DUCTWORK.
- 5. THIS CONTRACTOR SHALL HIRE AN INDEPENDENT BALANCING CONTRACTOR WHO IS CERTIFIED BY AABC OR NEBB TO PERFORM AIR BALANCIDNG WORK. THREE (3) COPIES OF BALANCING REPORT TO BE SUBMITTED TO THE ARCHITECT/ENGINEER AND OWNER FOR APPROVAL.
- 6. ALL WIRING OF MECHANICAL EQUIPMENT, ETC. SHALL BE PROVIDED BY THE ELECTRICAL CONTRACTOR UNDER THE SUPERVISION OF THE HVAC CONTRACTOR.
- 7. ALL EQUIPMENT SHALL BE INSTALLED IN ACCORDANCE WITH THE MFR'S RECOMMENDATIONS.
- B. ALL CONTROL WIRING & CONTROLS RELATED WORK SHALL BE FURNISHED AND INSTALLED BY THE MECHANICAL CONTRACTOR.
- 9. OUTDOOR COMBUSTION AIR SHALL BE AS DIRECTED BY 2020 NYS FUEL GAS CODE SECTION 304.6.
- 10. LOCATION OF EXHAUST OUTLETS AND DUCT DISCHARGING TO THE OUTDOORS SHALL BE AS DIRECTED BY 2020 NYS MECHANICAL CODE SECTION 501.2.1.
- 11. PROVIDE INSULATION ON ALL FRESH AIR IN-TAKE DUCT.
- 12. VENTING SYSTEM TERMINATION LOCATION SHALL BE AS DIRECTED BY 2020 NEW YORK STATE FUEL GAS CODE SECTION 503.8.

SCOPE OF WORK:

1) REPLACE EXISTING BOILER AND ASSOCIATED PIPING AND CONTROLS
2) INSTALLATION OF NEW GAS-FIRE FURNACE WITH COOLING COIL.
3) INSTALLATION OF NEW STEAM RADIATORS IN CREATION ROOM AND MEETING ROOM.

NYS MC 2020 TABLE 403.3.1.1 MINIMUM VENTILATION REQUIRED

OCCUPANCY CLASSIFICATION	OCCUPANT DENSITY (#/1000 SQ FT)	PEOPLE OUTDOOR AIRFLOW RATE IN BREATHING ZONE Rp CFM / PERSON	AREA OUTDOOR AIRFLOW RATE IN BREATHING ZONE Rz CFM / SQ FT	EXHAUST AIRFLOW RATE CFM / SQ FT
DORMITORY	20	5.0	0.06	1
RECREATION ROOM	30	7.5	0.06	1
MEETING ROOM	50	5.0	0.06	<u>-</u>

- OCCUPANT DENSITY IS 10 PEOPLE FOR DORMITORY OF 500 SQ. FT.

BREATHING ZONE OUTDOOR AIRFLOW IS (10 PERSONS X 5.0 CFM/PERSON) + (500 SQ. FT. X 0.06 SQ. FT.) = 80 CFM


- REQUIRED OUTDOOR AIRFLOW IS 80 CFM / 0.8 (AIR DISTRIBUTION EFFECTIVENESS BASE ON CEILING SUPPLY OF WARM AIR AND CEILING RETURN) = 100 CFM

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	2	REVISED	9/10/2021
	1	CLIENT REVIEW	3/11/2021
	NO.	ISSUED FOR	DATE

REVISIONS



SCOPE OF WORK:

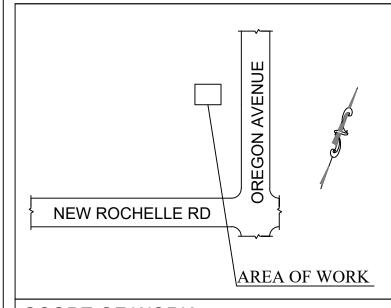FIRE HOUSE (MECHANICAL)

PROJECT LOCATION:

10 OREGON AVENUE BRONXVILLE, NY 10708

SHEET TITLE:

MECHANICAL ABBREVIATIONS, NOTES AND SYMBOLS

PROJECT #: 21-0311-00

SCALE: AS NOTED

DATE: 10/20/2020

DRAWN BY: AM

REVIEWED BY: DL/MW

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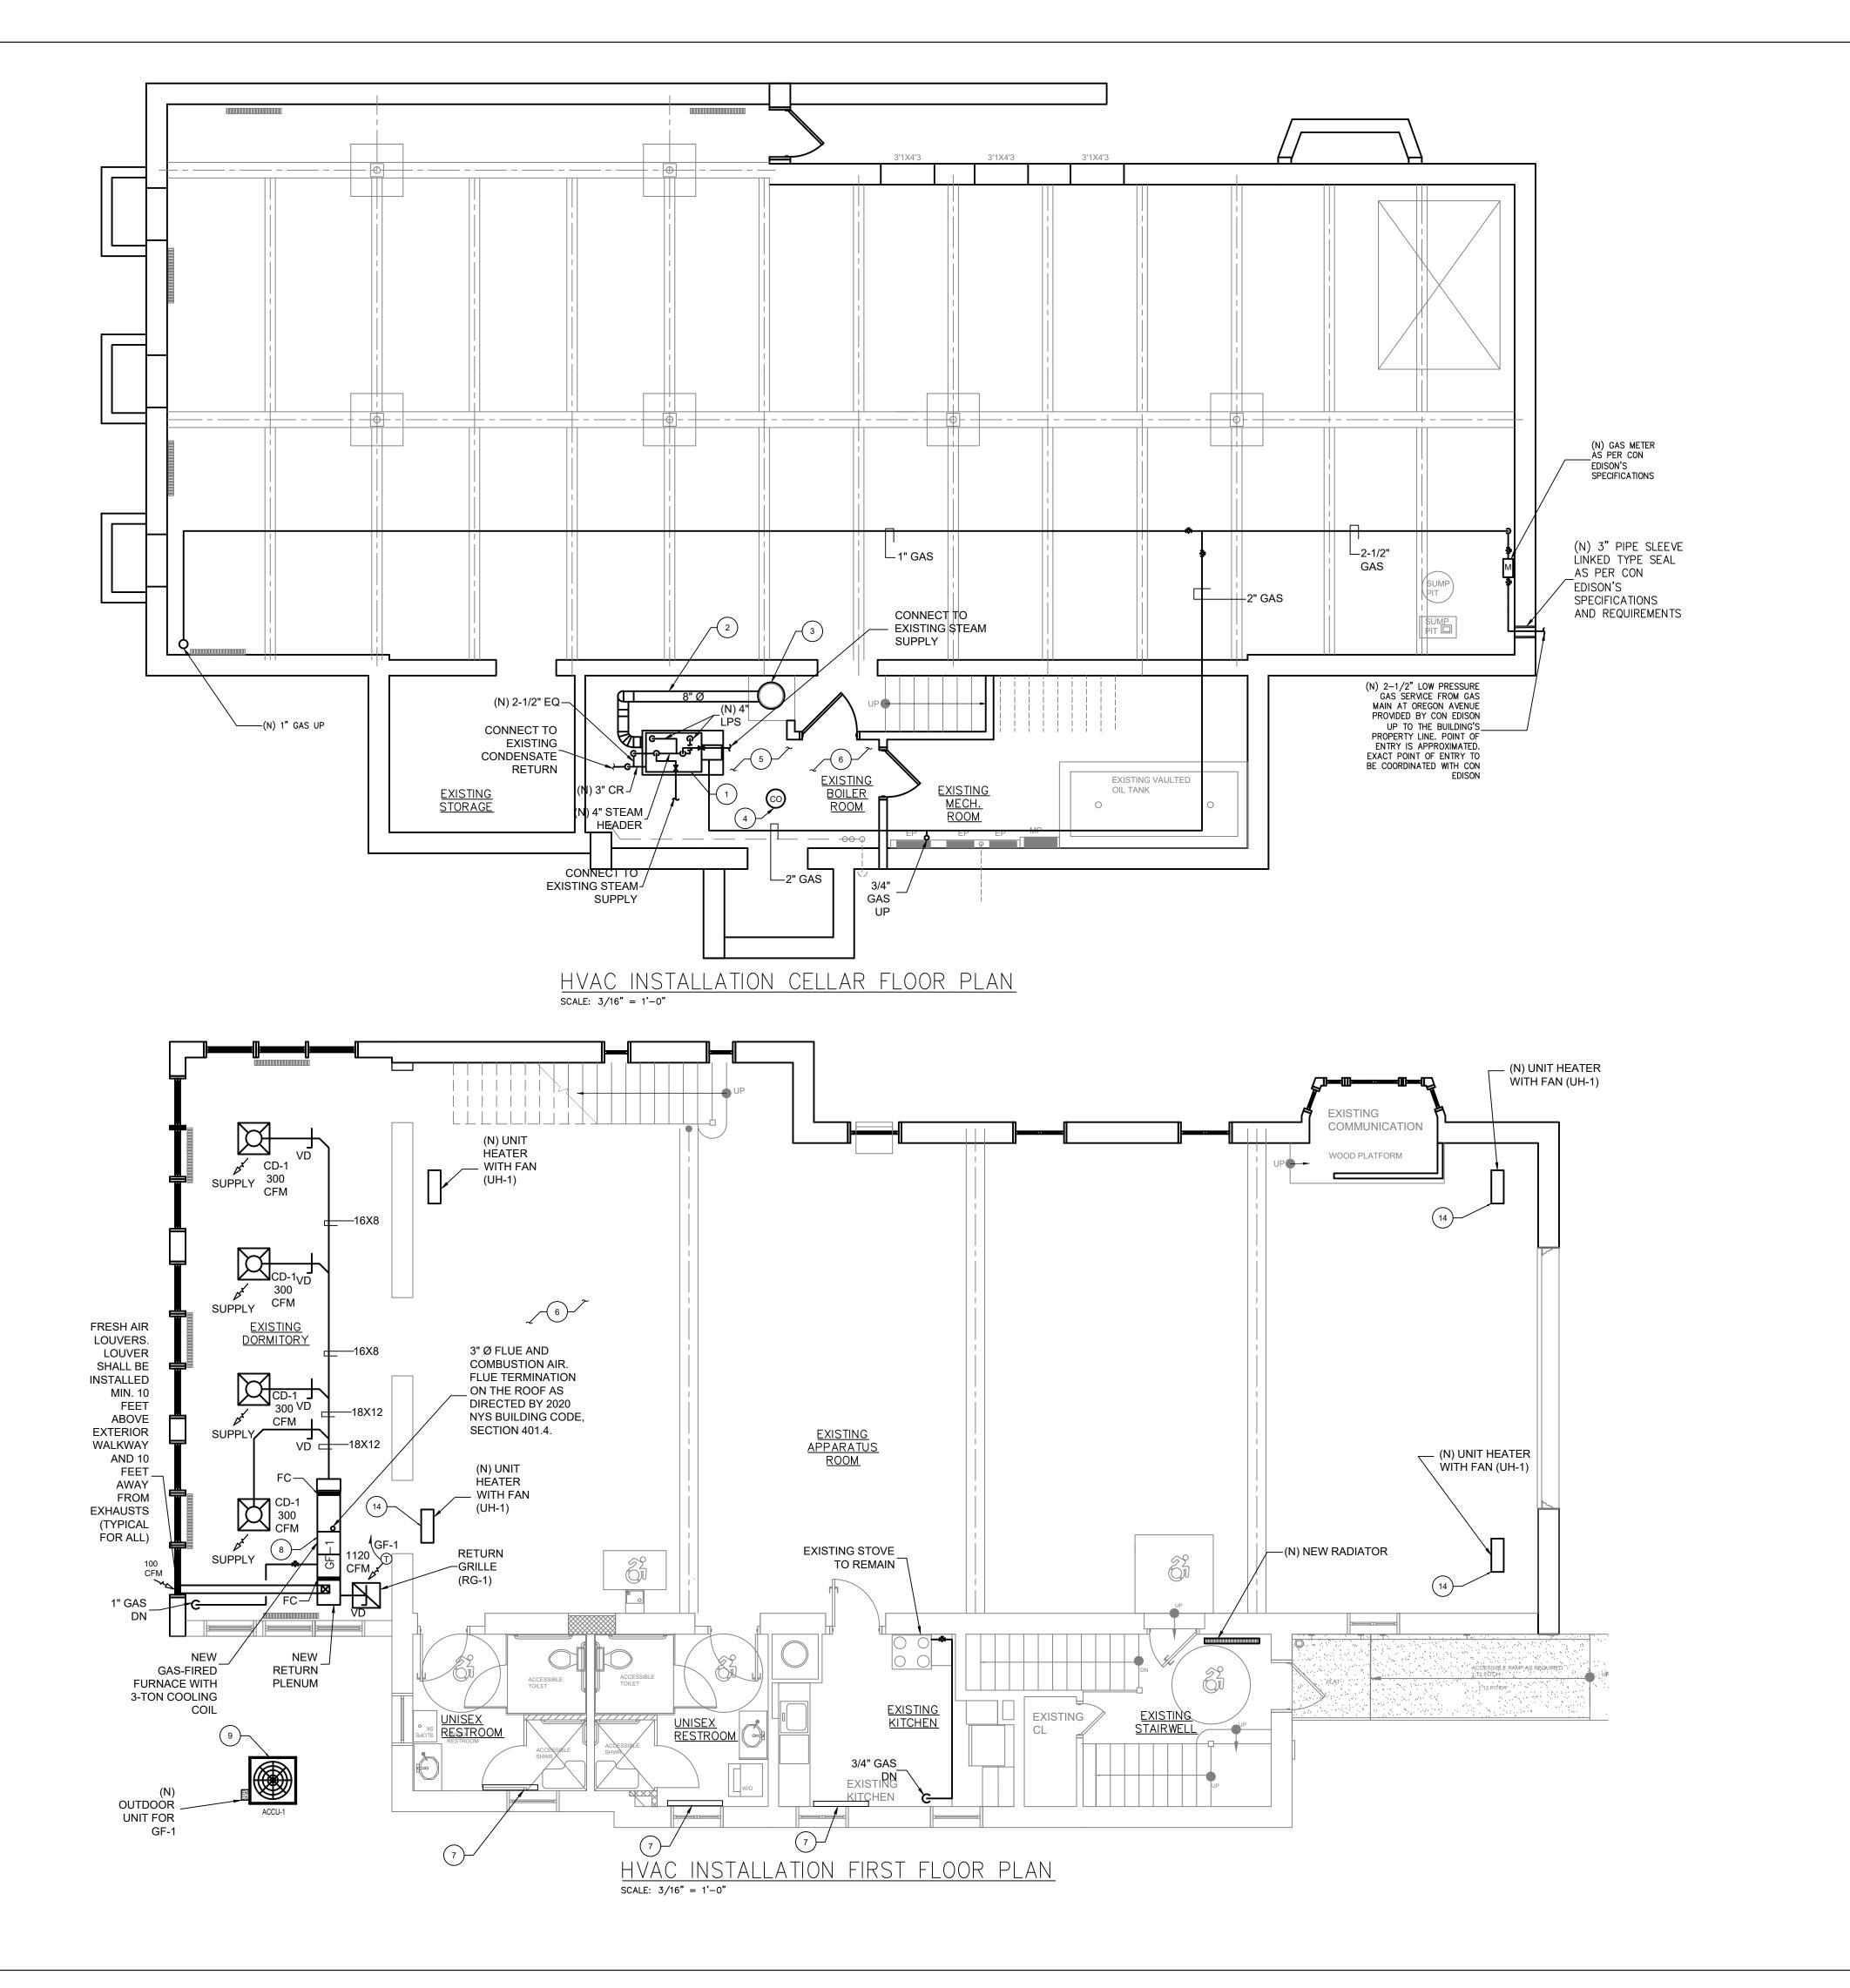
SHEET NO.:

M-100.00

SHEET: 1 OF 7

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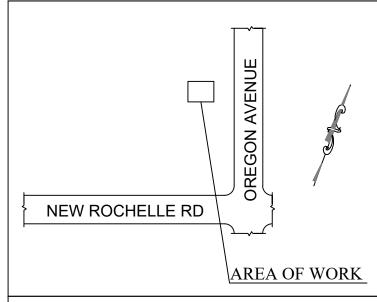


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SCOPE OF WORK:

FIRE HOUSE (MECHANICAL)

PROJECT LOCATION:

10 OREGON AVENUE BRONXVILLE, NY 10708

SHEET TITLE:

CELLAR AND 1ST FLOOR -HVAC INSTALLATION PLANS

PROJECT #: 21-0311-00 AS NOTED SCALE: DATE: 10/20/2020 DRAWN BY: AM

REVIEWED BY: DL/MW


SHEET NO.:

M-101.00

SHEET: 2 OF 7

DOB JOB#

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HVAC INSTALLATION SECOND FLOOR PLAN

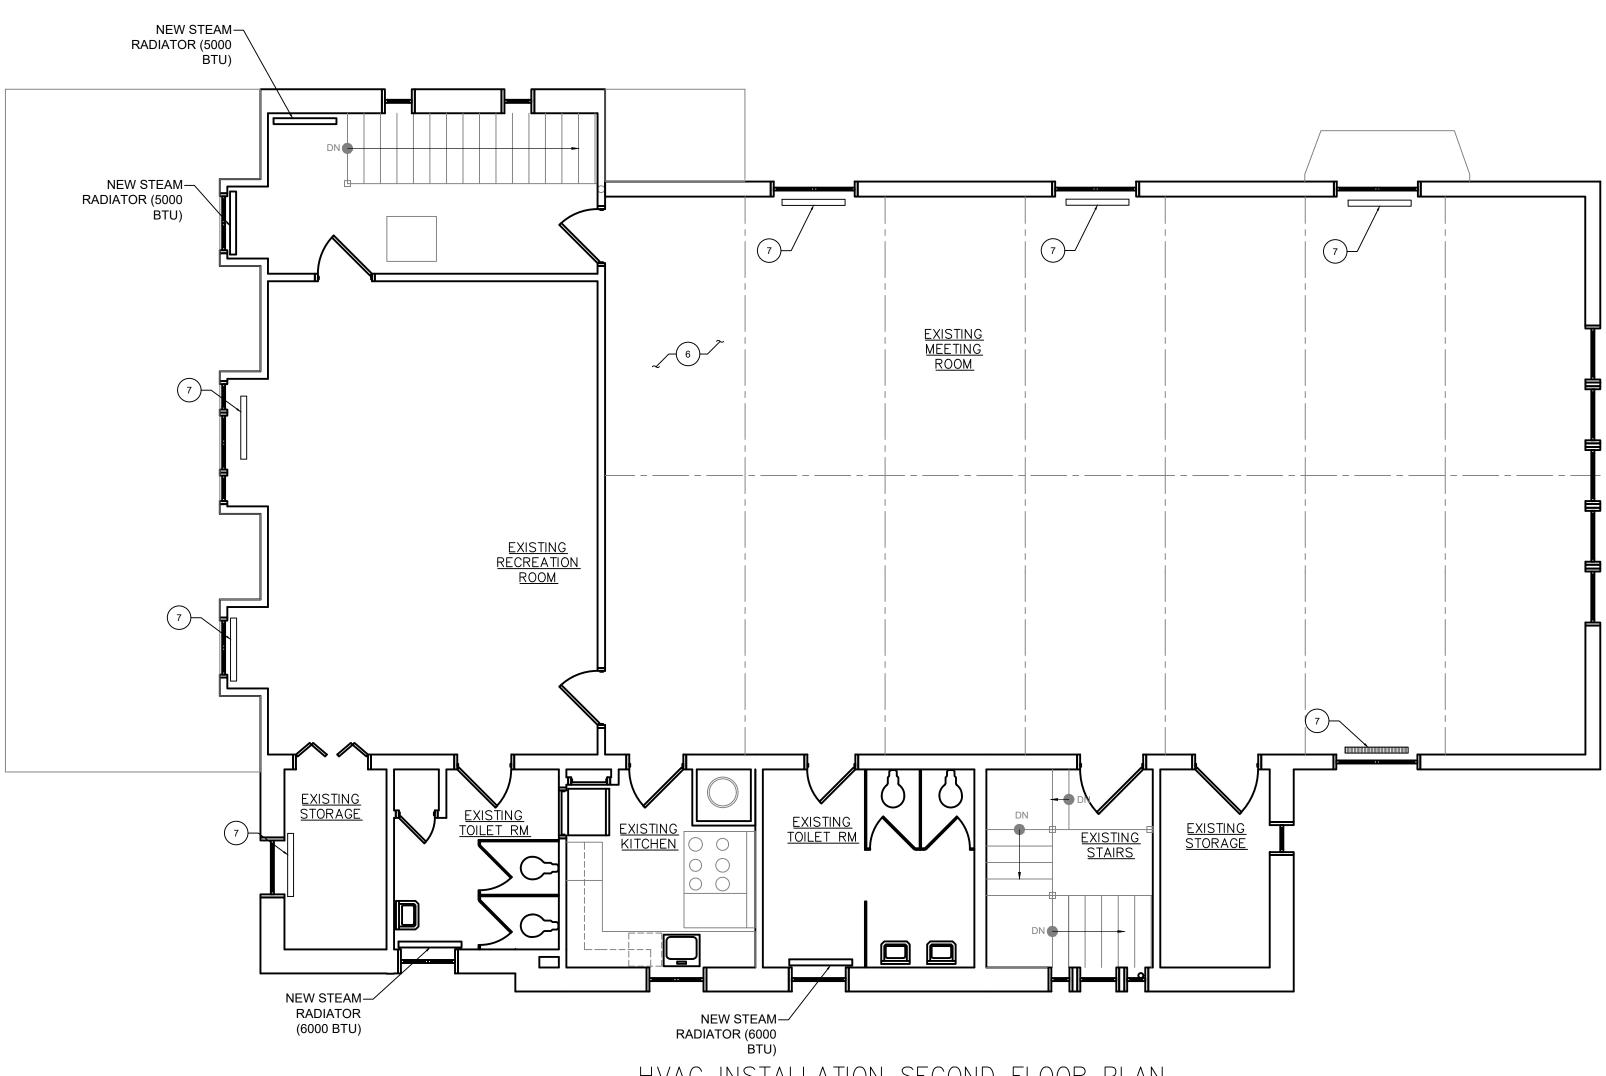SCALE: 3/16" = 1'-0"

ITEMS OF WORK: INSTALLATION


- FURNISH AND INSTALL NEW LOW PRESSURE STEAM BOILER AND ASSOCIATED DUEL FUEL BURNER (GAS AND NO. 2 FUEL OIL), VALVES, PIPING, FITTINGS, LOW WATER CUTOFFS, CONTROLS, AND BOILER BREECHING FOR A COMPLETE FUNCTIONING SYSTEM. INSTALL NEW 4" HOUSE KEEPING PAD.
- FURNISH AND INSTALL NEW 8" Ø BREECHING INCLUDING NEW INSULATION AND BAROMETRIC DAMPER FOR BOILER AS SHOWN ON PLAN. SEE SPECIFICATION. MODIFY AS REQUIRED. BREECHING SHALL BE 14 GAUGE AND WELDED WITH GAS TIGHT SEAMS. CONTRACTOR SHALL SUBMIT SHOP DRAWINGS FOR ENGINEER'S APPROVAL. PROVIDE CLEANOUTS AS REQUIRED.
- FURNISH AND INSTALL NEW 12" SINGLE WALL STAINLESS STEEL FLUE. INSTALL ALL REQUIRED EXPANSION JOINTS AND SUPPORT PER THE MANUFACTURER RECOMMENDATIONS. PROVIDE 3" DRAIN CONNECTION AT THE BOTTOM OF THE CHIMNEY AND PIPE TO THE NEAREST FLOOR DRAIN. CONTRACTOR SHALL SUBMIT SHOP DRAWINGS FOR ENGINEER'S APPROVAL.
- FURNISH AND INSTALL A NEW CARBON MONOXIDE ALARM W/LOCAL ANNUNCIATION, SENSORS AND WIRING IN THE BOILER ROOM. INTERLOCK NEW SENSORS WITH NEW BURNERS.
- NSULATE ALL NEW HW, CW, HWR, STEAM AND CONDENSATE PIPING IN THE BOILER ROOM AS PER THE LATEST NEW YORK STATE ENERGY CONSERVATION CODE. RE-INSULATE ALL EXISTING PIPING THAT ARE DAMAGED OR DISTURBED. SEE SPECIFICATIONS.
- $\left(egin{array}{c}6\end{array}
 ight)$ REPLACE ALL STEAM TRAP IN THE BOILER ROOM AND THROUGHOUT THE BUILDING.
- EXISTING STEAM RADIATOR TO REMAIN. REPLACE ALL STEAM TRAP AND DANFOSS VALVE. TYPICAL FOR $\binom{7}{}$ ALL EXISTING RADIATOR THROUGHOUT.
- FURNISH AND INSTALL NEW GAS-FIRE FURNACE WITH COOLING COIL (GF-1) FOR A COMPLETE FUNCTIONING SYSTEM. PROVIDE PROPER SUPPORTS AND VIBRATION ISOLATORS AS REQUIRED. SEE SCHEDULE AND SPECIFICATIONS FOR DETAILS. PROVIDE 7- DAY PROGRAMMABLE THERMOSTAT.
- FURNISH AND INSTALL NEW CONDENSING UNIT AND CONNECT TO THE COOLING COIL ASSOCIATED WITH NEW GAS-FIRE FURNACE. INSTALL UNIT ON 4' CONCRETE PAD WITH NEOPRENE PAD. SEE SCHEDULE FOR DETAIL.
- 10 NOT USED
- 11) NOT USED
- 12 NOT USED
- 13 NOT USED
- REMOVE EXISTING UNIT HEATER AND REPLACE WITH NEW. FURNISH AND INSTALL NEW UNIT HEATER AS MANUFACTURED BY MODINE OR APPROVED EQUAL. CONNECT TO EXISTING STEAM CONDENSATE PIPING. PROVIDE NEW STEAM TRAP (TYPICAL FOR ALL). PROVIDE PROPER SUPPORTS AS REQUIRED. SEE SCHEDULE FOR DETAIL.



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2 REVISED 9/10/2021 **CLIENT REVIEW** 3/11/2021 NO. ISSUED FOR DATE

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FIRE HOUSE (MECHANICAL)

PROJECT LOCATION:

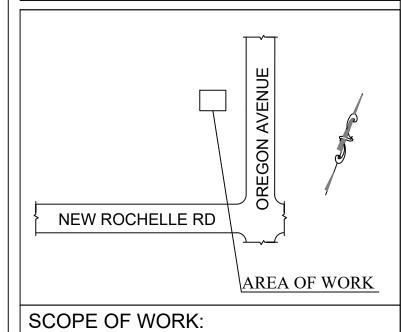10 OREGON AVENUE BRONXVILLE, NY 10708

SHEET TITLE:

2ND LOWER FLOOR-HVAC INSTALLATION PLAN

PROJECT #: 21-0311-00 AS NOTED SCALE: DATE: 10/20/2020 DRAWN BY: AM

REVIEWED BY: DL/MW

M-102.00

SHEET NO.:

SHEET: 3 OF 7

DOB JOB#

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		BOILER SC	HEDULE					
U	NIT NO.		B-1					
SE	ERVICE		HEATING					
LC	CATIO	N	BOILER ROOM					
ΤY	/PE		CAST IRON FIREBOX					
	HORSI	EPOWER	18.9					
	STEAN	I NET RATING (MBH)	476					
SS	GROS	S OUTPUT (MBH)	634					
RATINGS	HEATIN	NG SURFACE (SQ. FT)	1983					
₽.	FURNA	ACE VOLUME (CU. FT)	6.69					
	WATER	R CONTENT (GALLONS)	72					
	DESIG	N PRESSURE (PSIG)	15					
		FIRING RATE (GPH)	5.5					
~	OIL	GRADE OF OIL	2					
BURNER	INTEGI MOTOI	RAL OIL/AIR SYSTEM R HP	-					
	BURNE	ER MOTOR RPM	3450					
	NOZZL	E LINE HEATER (KW)	-					
~		МВН	476					
Sı	EAM	OPER. PRES. (PSIG)	5					
ELEC.		V/Ø/HZ	120/1/60					
REMARKS: 1. SELECTION BASED ON WEIL MCLAIN STEAM BOILER, MODEL 68 AND BURNER, WEBSTER, MODEL WJB1C-03 (DUAL FUEL)								

					AIR [DISTR	IBUT	ION SC	CHE	DULE	Ξ
TAG	MAKE	MODEL	SIZE	(CFM	NECK SIZE MA		ЛАХ N.C.	DAM	PER	FINISH
SG-1	TITUS	300	14"X6"	2	225 -		-		-	ALUMINUM OFF-WHITE	
CD-1	TITUS	TMS	24"X24"		300	10" DIA		14	-	-	ALUMINUM OFF-WHITE
RG-1	TITUS	350F	24"X20"	1	1120 -		-	-	-	ALUMINUM OFF-WHITE	
RG-2	TITUS	350F	18"X10"	2	280 -			-	-	-	ALUMINUM OFF-WHITE
RG-3	TITUS	350F	20"X20"	9	940	-		-	-	-	ALUMINUM OFF-WHITE
RG-4	TITUS	350F	36"X32"	SE	E PLAN	-		-	-	-	ALUMINUM OFF-WHITE
		AIR	COOL	ED C	ONDEN	ISING	UNIT	SCHE	EDU	LE	
TAG	MANUFACTURE	R COOLI	NG REQUIRE	MENTS	Е	ELECTRICAL		UNIT WEIGHT		NOTES	;
	& MODEL NO.	& BTUH TOTAL OAT DB OAT WB V-PH-HZ MCA MOCE		MOCP	(LBS)						

74.0

UNIT	No	UH-1				
CIVIII	110.	011-1				
MANU	IFACTURER	MODINE				
MODE	EL No.	HSB 121				
SERV	ICE	APPARATUS				
LOCA	TION	WALL				
CAPA	CITY (BTU)	121,000				
STAT	C PRESSURE (IN. W.C.)	-				
ENCL	OSURE	-				
МОТ	HP	-				
OR DAT A	RPM	-				
	V / Ø / Hz	-				

1. PROVIDE NEW STEAM TRAP.

REQUIRED.

2. PROVIDE PROPER SUPPORTS AS

1. SELECTION BASED ON WEIL MCLAIN STEAM BOILER, MODEL 680
AND BURNER, WEBSTER, MODEL WJB1C-03 (DUAL FUEL)

- 2. PROVIDE LOW GAS PRESSURE SWITCH & GAS PRESSURE
- . BURNER SHALL BE WITH "LOWER GAS SUPPLY PRESSURE CONFIGURATIONS". TYPICAL FOR ALL NEW BURNERS.

GAS FIRED FURNACE WITH COOLING COIL SC	HEDULE

	EQUIPMENT	SUPPLY	AID DDESS INFOT OUTPOT EFFIC- GAS OUTSIDE	LECTRIC	WEIGHT		R & SEER/EER	REMARKS						
	NO.	(CFM)	(IN. W.G.)	(BTU)	(BTU)	IENCY A.F.U.E.	RATE (CFH)	AIR (CFM)	AMPS	V-HZ-PH	(LBS)	MODEL		
	GF-1	1200	0.5	60,000	58,000	96.2%	60	-	9.7	115-60-1	150	CARRIER, MODEL 59TN6A060E	15.2/12.5	- PROVIDE UNIT WITH MATCHING COOLING COIL -CARRIER MODEL CNPHP36 - ASSOCIATED WITH ACCU-1
H								I						

(TAG) REMARKS

PROVIDE FRAME STYLE AS REQUIRED

(CD) CEILING SUPPLY AIR DIFFUSER

PROVIDE FRAME STYLE AS REQUIRED

(SG) SUPPLY AIR GRILLE

(RG) RETURN AIR GRILLE

(RG) RETURN AIR GRILLE

(RG) RETURN AIR GRILLE

(RG) RETURN AIR GRILLE

ASSOCIATED WITH INDOOR COOLING COIL WITH

FURNACE (GF-1)

1) PROVIDE 7-DAY PROGRAMMABLE THERMOSTAT FOR EACH FURNACE.

2) PROVIDE DRIP PAN UNDERNEATH EACH UNIT. DRAIN CONDENSATE TO THE NEAREST FLOOR DRAIN OR SERVICE SINK WITH MIN. 1" AIR GAP. 3) PROVIDE VIBRATION ISOLATORS FOR EACH HORIZONTAL UNIT.

24ACC648

* SIZE REFRIGERANT PIPING PER THE MANUFACTURER'S RECOMMENDATIONS.

* INSTALL UNIT ON NEW PAD

SAF-1 MEETING ROOM

UNIT

NO.

AREA

SERVED

NOTES: 1) PROVIDE FLEXIBLE CONNECTION AT OUTLET OF EXHAUST FAN.

LOCATION

OF UNIT

RECREATION CEILING

2) PROVIDE CONTROLS, SENSORS AND MOTORIZED DAMPERS AS REQUIRED FOR A COMPLETE FUNCTIONING SYSTEM.

SPILL AIR FAN SCHEDULE

R.P.M. TYPE OF DRIVE

637 BELT

FAN DATA

CAPACITY PRESSURE IN.

STATIC

0.75

3) INSTALL SPILL AIR FAN AS PER MANUFACTURER'S RECOMMENDATIONS. 4) PROVIDE PROPER SUPPORTS AS PER MANUFACTURER'S RECOMMENDATIONS.

3000

EQUIPMENT	SUPPLY AIR	STATIC PRESS.	INPUT	OUTPUT	EFFIC-	GAS	OUTSIDE	E	LECTRIC	WEIGHT	MANUFACTURER &	SEER/EER	REMARKS
NO.	(CFM)	(IN. W.G.)	(BTU)	(BTU)	IENCY A.F.U.E.	RATE (CFH)	AIR (CFM)	AMPS	V-HZ-PH	(LBS)	MODEL		
GF-1	1200	0.5	60,000	58,000	96.2%	60	-	9.7	115-60-1	150	CARRIER, MODEL 59TN6A060E	15.2/12.5	- PROVIDE UNIT WITH MATCHING COOLING COIL -CARRIER MODEL CNPHP36 - ASSOCIATED WITH ACCU-1

248

REMARKS

MODEL BDF-150

BASED ON GREENHECK

MOTOR DATA

BHP VOLTAGE PHASE

208

0.82

ACCU-1

4) PROVIDE DIRECT VENT ASSEMBLY FOR EACH UNIT AND TERMINATE AS PER MANUFACTURER'S RECOMMENDATIONS AND NYS MECHANICAL CODE, 2020. 5) PROVIDE FLEXIBLE CONNECTION AT EACH SUPPLY AND RETURN DUCT CONNECTION TO THE UNIT

* PROVIDE DISCONNECT SWITCH AND GFI RECEPTACLE

6) CONNECT 1/2" GAS PIPING TO EXISTING GAS MAIN.

48,000

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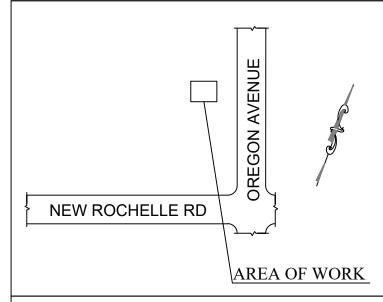
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1	CLIENT REVIEW	3/11/2021
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REVISIONS



SCOPE OF WORK:

FIRE HOUSE (MECHANICAL)

PROJECT LOCATION:

10 OREGON AVENUE BRONXVILLE, NY 10708

SHEET TITLE:

MECHANICAL SCHEDULES

PROJECT #: 21-0311-00 AS NOTED SCALE: DATE: 10/20/2020 DRAWN BY: AM


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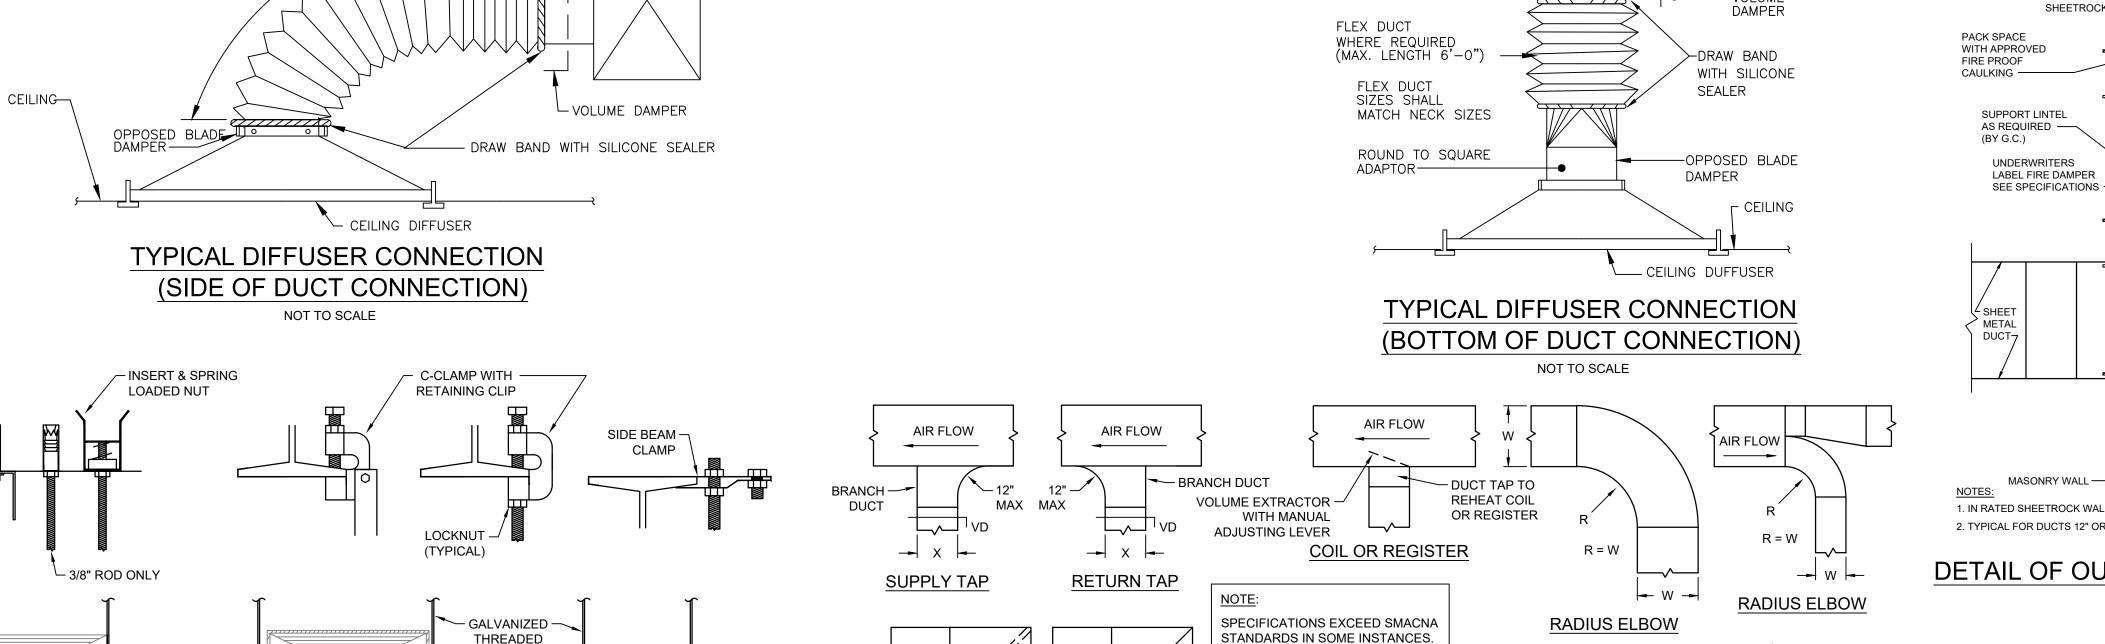
SHEET NO.:

M-103.00

SHEET: 4 OF 7

DOB JOB#



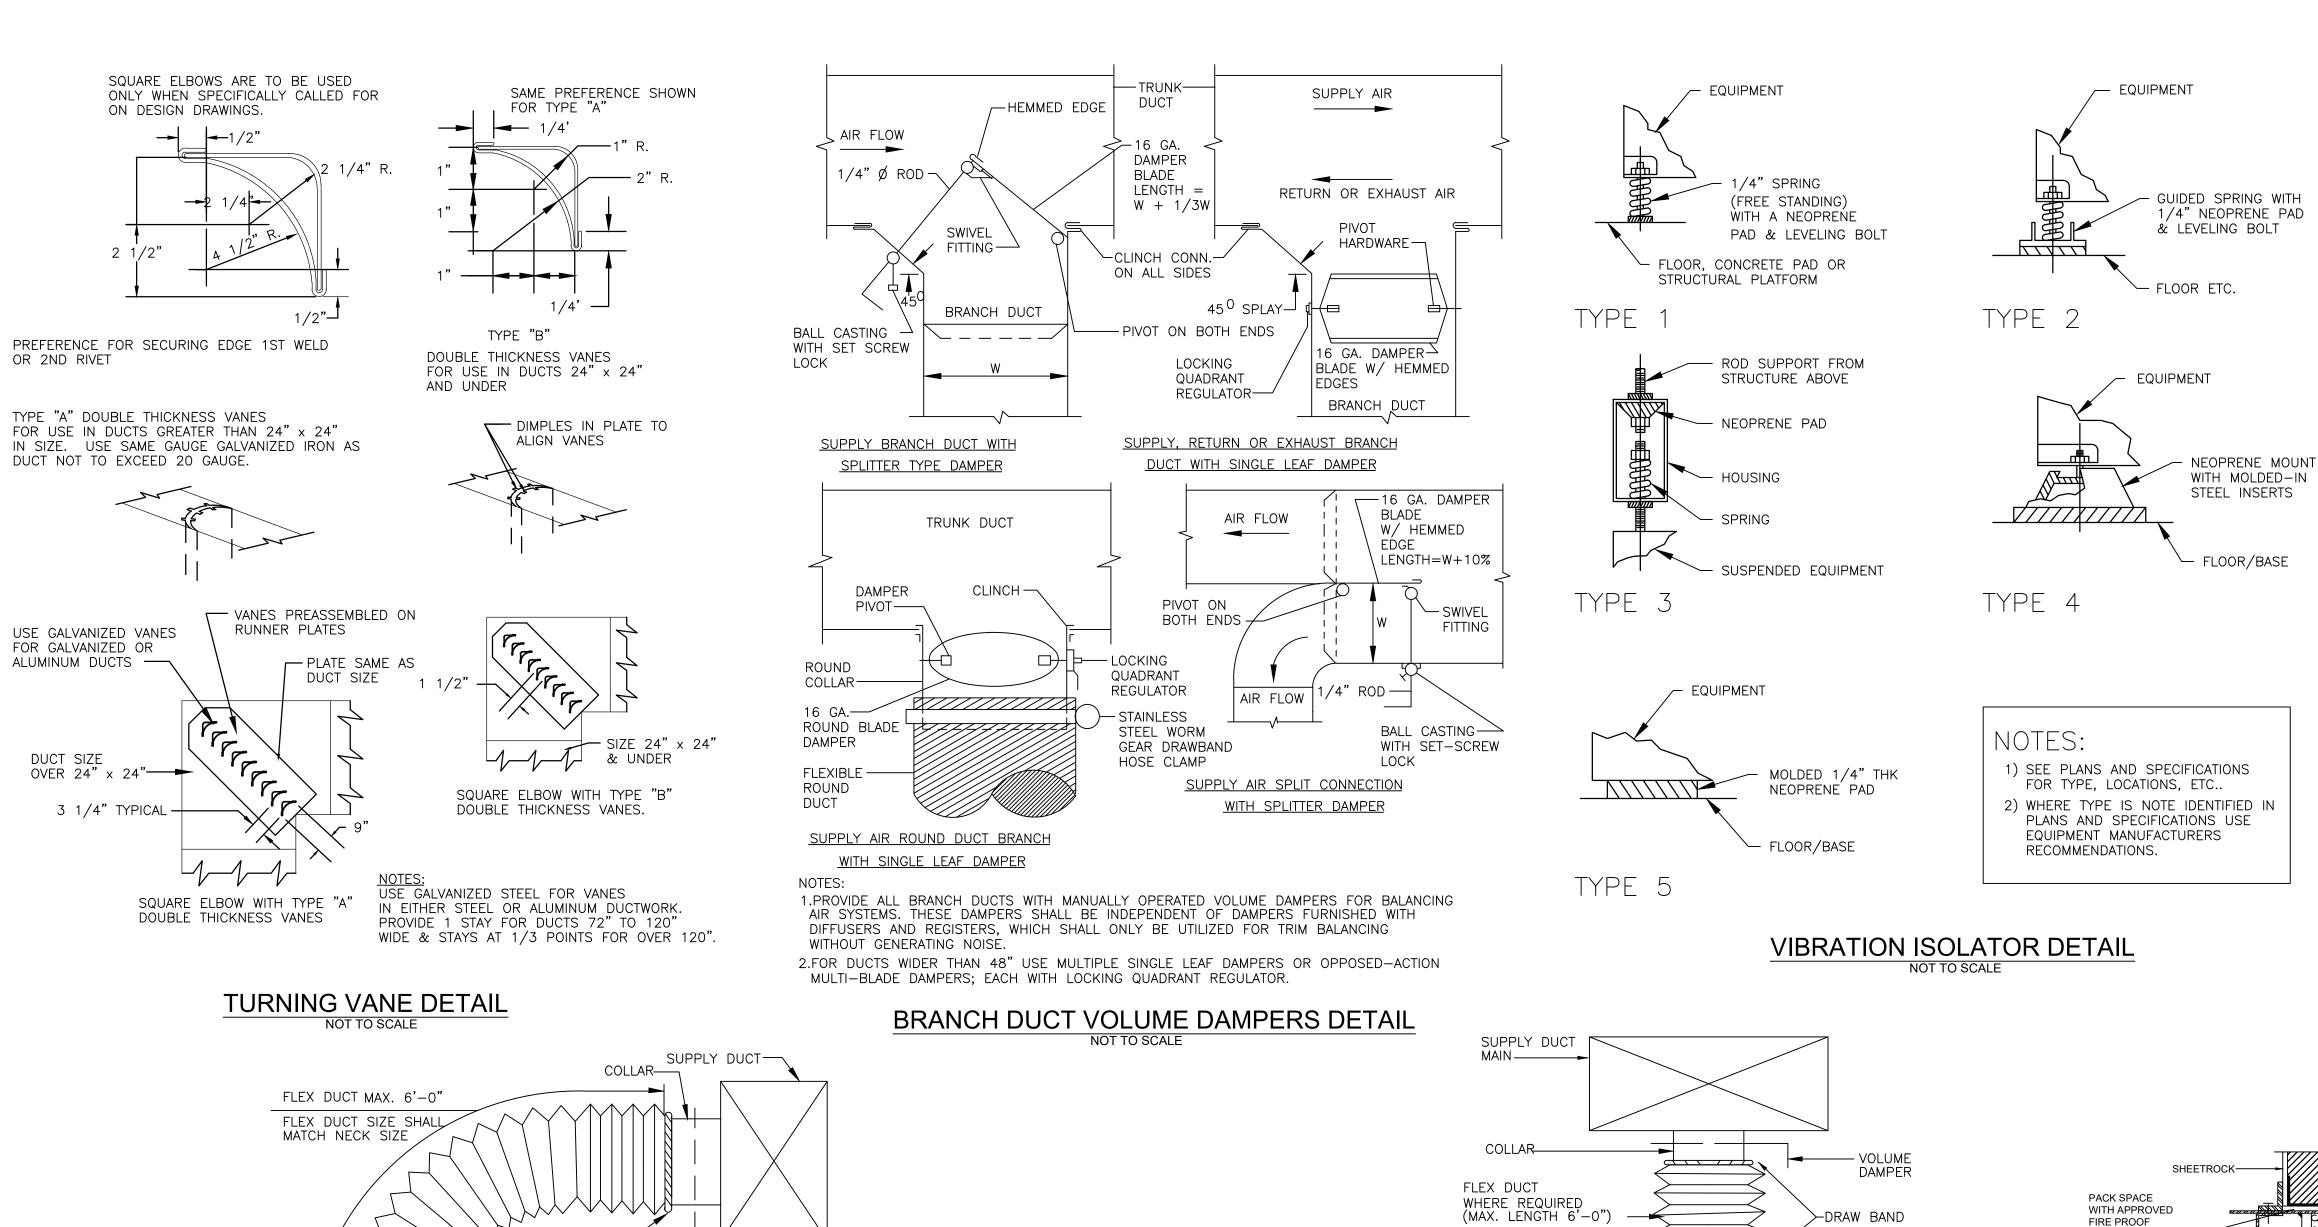

TURNING

VANES

SQUARE

ELBOW

DOUBLE

VANES

SQUARE

ELBOW

THICKNESS

-PACK SPACE WITH APPROVED MASONRY WALL FIRE PROOF CAULKING 1. IN RATED SHEETROCK WALLS, METAL STUD FRAME PROVIDED BY GENERAL CONTRACTOR. 2. TYPICAL FOR DUCTS 12" OR LESS IN DEPTH. DETAIL OF OUT OF AIR STREAM FIRE DAMPER

₹ 20° MAX

TRANSITION

— METAL STUD

—RATED FIRE WALL

-DAMPER WELDED

TO SLEEVE

-MOUNTING ANGLE

ACCESS

-1 1/2"X 1 1/2"X 1/8" ANGLE IRON

TIGHT TO MASONRY ALL

AROUND DUCT BY SHEET METAL CONTRACTOR

SEE NOTE #1

U.L. APPROVED FACTORY

J.L. APPROVED FACTORY

METAL <

DUCT-

STANDARD SLEEVE

-SLIP JOINT BREAK AWAY DUCT CONNECTION

STANDARD SLEEVE

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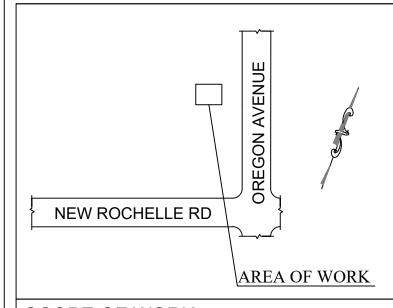


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2 REVISED 9/10/2021 **CLIENT REVIEW** 3/11/2021 DATE NO. ISSUED FOR

REVISIONS



SCOPE OF WORK:

FIRE HOUSE (MECHANICAL)

PROJECT LOCATION:

10 OREGON AVENUE BRONXVILLE, NY 10708

SHEET TITLE:

MECHANICAL DETAILS

PROJECT #: 21-0311-00 SCALE: **AS NOTED** DATE: 10/20/2020 DRAWN BY: AM

REVIEWED BY: DL/MW

SHEET NO.:

M-104.00

SHEET: 5 OF 7

DOB JOB #

DUCTWORK SUPPORTS DETAIL

25" OR WIDER

NOTE: ALL DUCTS AND ACCESSORIES DIMENSIONS, GAUGES AND SPACING TO BE PER SMACNA GUIDELINES.

GALVANIZED -

SUPPORT ANGLE

EXPANSION

STRAP

BOLT & WASHER -

1/8" x 1" GALV -METAL STRAP

6" O.C. MIN.

OF TWO

SHIELD

ROUND OR SPIRAL

- GALVANIZED

SUPPORT STRAP

THREADED

ROD

DUCTWORK CONSTRUCTION DETAILS

SMACNA SHALL BE CONSIDERED

THE MINIMUM STANDARD UNLESS

ALL DUCTS TURNING 90 DEGREES

SHALL HAVE TURNING VANES,

12x12 *


* DIMENSION DENOTES

ACOUSTICALLY

LINED DUCT

CLEAR OPENING

OTHERWISE NOTED.

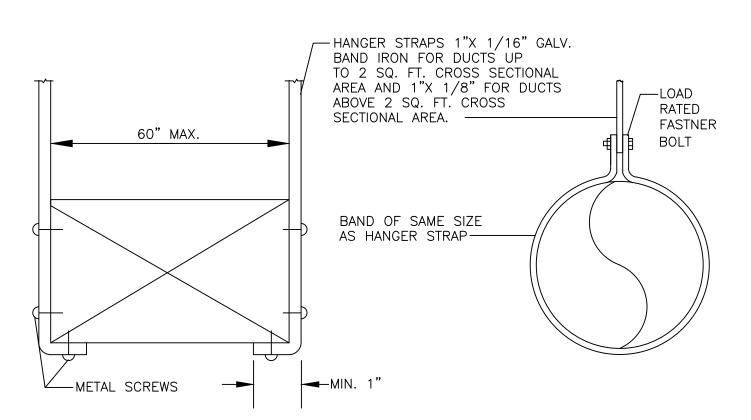


SPACING OF HANGER STRAPS SHALL NOT EXCEED 8'-0" FOR DUCTS 4 SQ. FT. OR LESS, 6'-0" FOR DUCTS 4 SQ. FT. TO 10 SQ. FT. AND 4'-0" FOR DUCTS OVER 10 SQ. FT. OF CROSS SECTIONAL AREA.


EXPANSION SHIELD (SEE NOTE #1) (DO NOT USE IN CINDER CONCRETE INSERT CONCRETE LOOP BENT ONTO END OF STRAP ROD HANGER STRAP SLOT IN DECK METAL DECK

NOTE: DUCT HANGERS UPPER ATTACHMENTS


1. FOR N.Y.C. USE BS&A OR MEA APPROVED INSERTS.

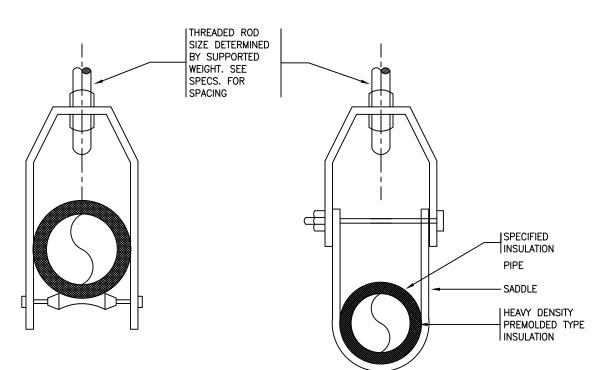


ADJUSTABLE CLEVIS PIPE SUPPORT PIPE HANGERS

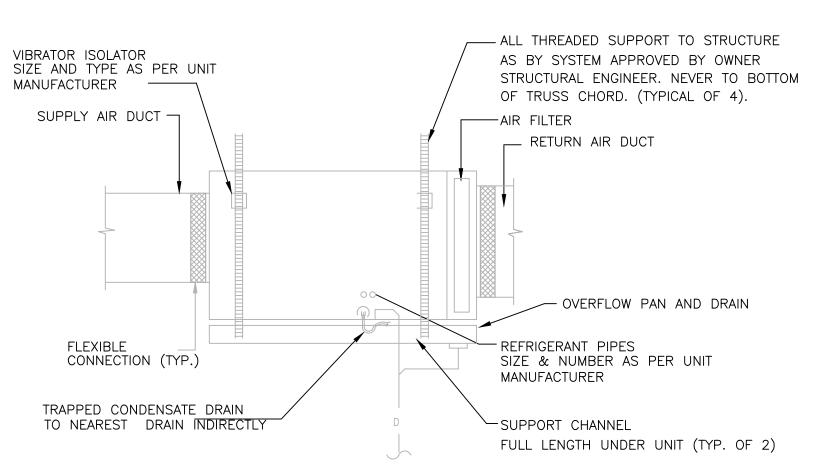

(GF) GAS FURNACE HORIZONTAL INSTALLATION DETAIL NOT TO SCALE

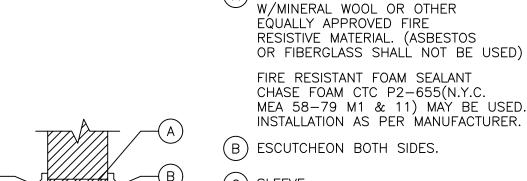

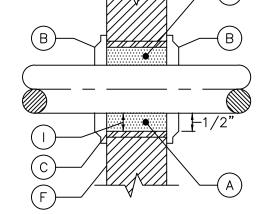



D INSULATION (OUTSIDE DIAMETER)


(A) PACK ALL SPACES FULL DEPTH


- ANHYDROUS CALCIUM SILICATE INSULATION THRU SLEEVE.
- F FIRE RATED PARTITION, WALL OR FLOOR.
- G FIBERGLASS INSULATION
- H TERMINATE INSULATION AT ESCUTCHEON
- MAXIMUM 1/2" CLEARANCE BETWEEN INSIDE OF SLEEVE

PIPE PENETRATION OF FIRE-RATED PARTITION NOT TO SCALE

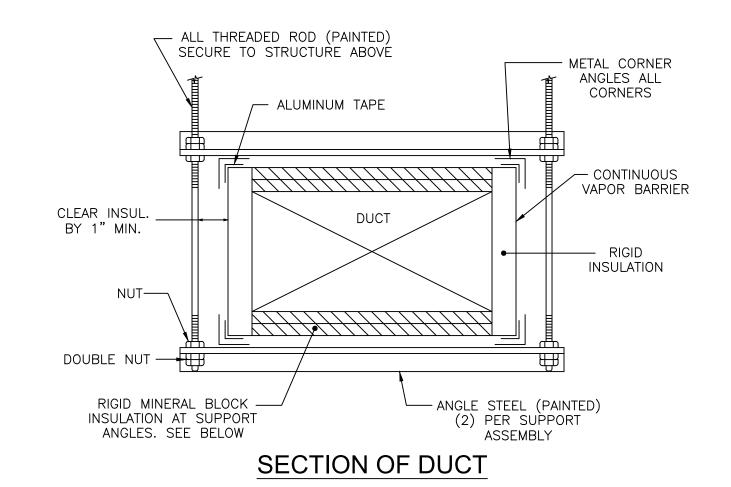


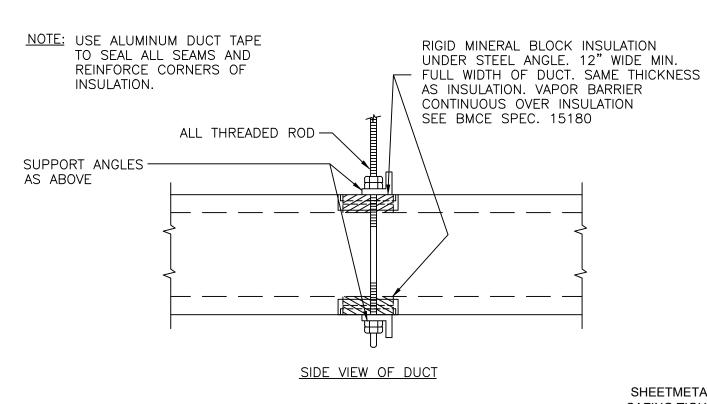


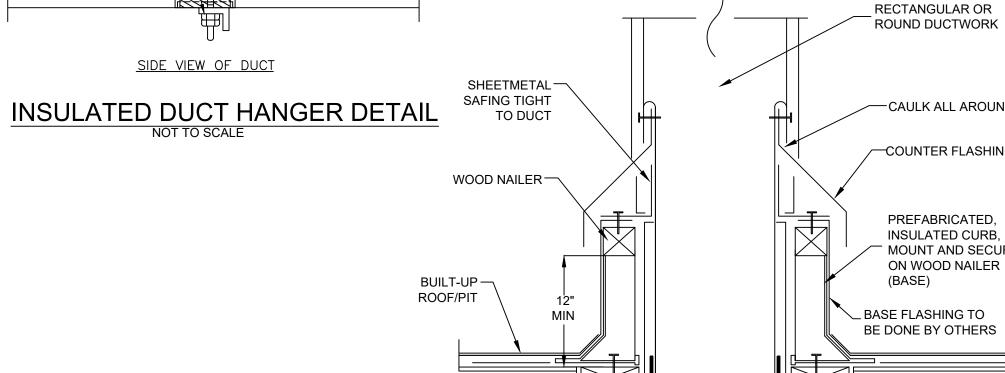

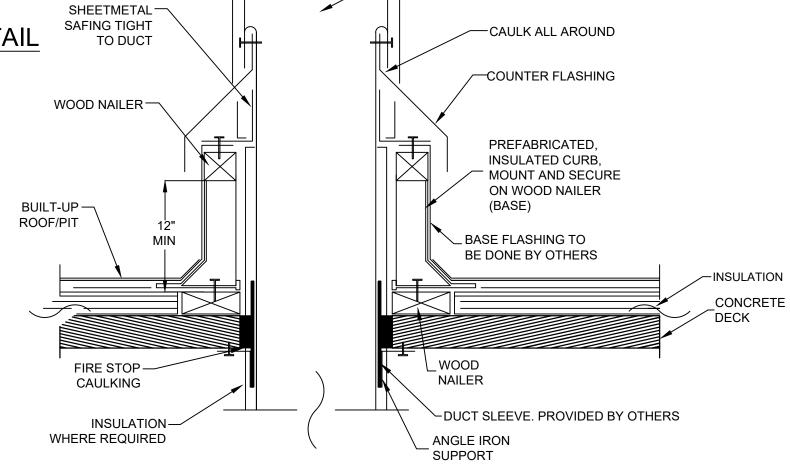


DUCT PENETRATION DETAIL

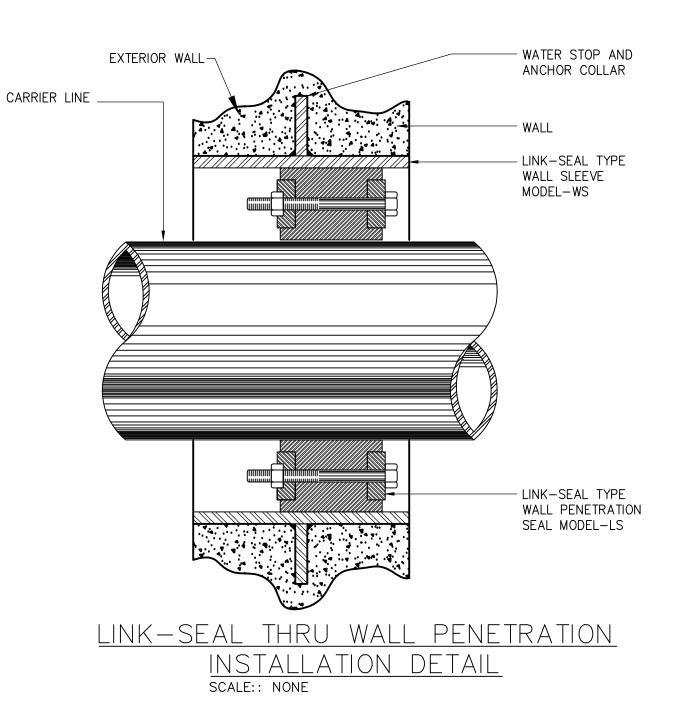

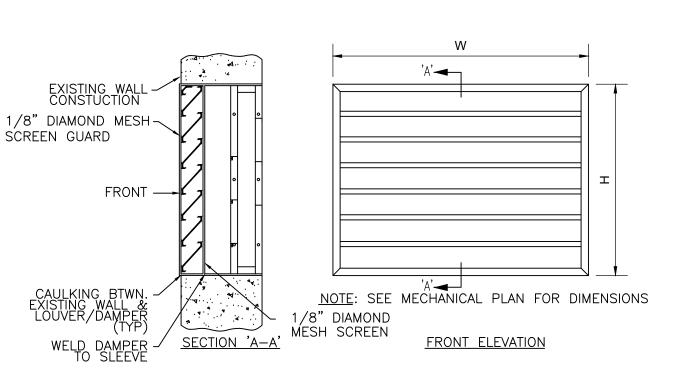

OUTSIDE AIR LOUVER

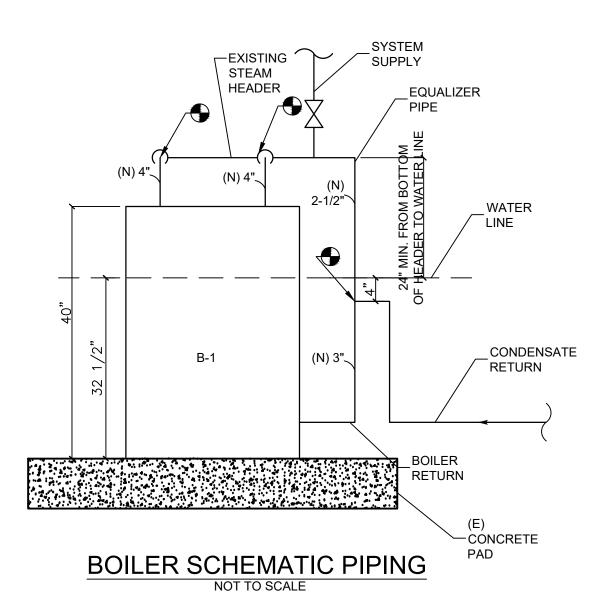


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5
4
3
2 REVISED 9/10/2021
1 CLIENT REVIEW 3/11/2021
NO. ISSUED FOR DATE

REVISIONS



SCOPE OF WORK:

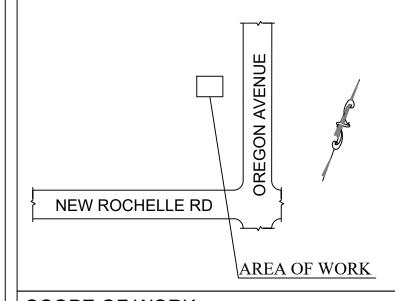FIRE HOUSE (MECHANICAL)

PROJECT LOCATION:

10 OREGON AVENUE BRONXVILLE, NY 10708

SHEET TITLE:

MECHANICAL DETAILS

PROJECT #: 21-0311-00

SCALE: AS NOTED

DATE: 10/20/2020

DRAWN BY: AM

REVIEWED BY: DL/MW

STATE OF NEW PORT

DOB STAMP & SIGNATURE

SHEET NO.:

M-105.00

SHEET: 6 OF 7

DOB JOB #

GENERAL NOTES

- 1. ALL WORK SHALL COMPLY WITH AND BE INSTALLED IN ACCORDANCE WITH THE 2020 NEW YORK STATE BUILDING, PLUMBING AND FUEL GAS CODES AND 2020 NEW YORK STATE ENERGY CONSERVATION CODE, CON EDISON GAS PIPING STANDARDS, ASME POWER PIPING CODE B31.1, LATEST EDITION, AND ALL CODES HAVING JURISDICTION OVER THE WORK.
- 2. CONTRACTOR SHALL VERIFY EXACT LOCATION OF ALL EXISTING EQUIPMENT AND PIPING IN FIELD PRIOR TO BID, FABRICATION, AND INSTALLATION OF ANY NEW WORK.
- 3. PIPING SHOWN ON PLANS IS DIAGRAMATIC, EXACT ROUTING OF NEW PIPING SHALL BE DETERMINED IN FIELD.
- 4. THE WORDS PROVIDE OR INSTALL, SINGLY OR IN COMBINATION SHALL MEAN FURNISH AND INSTALL.
- 5. THE CONTRACTOR SHALL PROVIDE ALL CUTTING AND PATCHING AS REQUIRED FOR THE INSTALLATION OF HIS
- 6. THIS CONTRACTOR SHALL BE RESPONSIBLE FOR THE PROTECTION OF HIS WORK AND NEWLY INSTALLED OR EXISTING WORK, INCLUDING PROTECTION OF BUILDING TENANTS, PUBLIC, AND PERSONNEL. PROVIDE APPROPRIATE BARRIERS, SIGNS, AND SAFETY GUARD RAILS AS REQUIRED.
- 7. LIMIT THE SPREAD OF DUST WHEN CUTTING BY INSTALLING POLYETHYLENE BARRIERS OR TARPAULINS TO CONTAIN AIRBORNE MATERIALS.
- 8. WHERE WELDING IS TO TAKE PLACE OR OPEN FLAME IS USED FOR CUTTING, BRAZING, ETC., CONTRACTOR SHALL PROVIDE FIRE EXTINGUISHERS IN PROXIMITY OF WORK
- 9. NO SYSTEM SHALL BE SHUT DOWN WITHOUT PERMISSION OF THE BUILDING MANAGEMENT. ADEQUATE NOTICE SHALL BE GIVEN TO THE BUILDING MANAGEMENT AND TENANTS WHEN SYSTEM SHUTDOWN INVOLVES A TEMPORARY DISRUPTION TO BUILDING SERVICES.
- 10. ANY DISRUPTION OF BUILDING SERVICES SHALL BE KEPT TO A MINIMUM NOT TO EXCEED 8 HOURS AND SHALL NOT BE IMPLEMENTED WITHOUT RECEIVING PRIOR WRITTEN APPROVAL OF THE BUILDING MANAGEMENT.
- 11. ALL WORK SHALL BE COORDINATED WITH THE BUILDING MANAGER AND ALL TRADES RELATED TO THE INSTALLATION OF THIS PROJECT.
- 12. THE CONTRACTOR SHALL TURN OVER TO THE OWNER AT THE COMPLETION OF ALL WORK, THREE (3) COPIES OF OPERATING, MAINTENANCE, AND INSTRUCTION MANUALS WHICH SHALL INCLUDE ALL EQUIPMENT BROCHURES, PIPING AND WIRING DIAGRAMS, DRAWINGS, TEMPERATURE CONTROLS, AND START-UP AND SHUTDOWN PROCEDURES OF ALL NEW EQUIPMENT INSTALLED.
- 13. THE CONTRACTOR SHALL FILE FOR AND SECURE ALL PLANS. PERMITS AND PAY ALL FEES REQUIRED FOR THE INSTALLATION OF THIS WORK WITH THE MUNICIPAL AGENCIES AND AUTHORITIES HAVING JURISDICTION
- 14. THE CONTRACTOR SHALL GUARANTEE ALL MATERIAL AND WORK INSTALLED TO BE FREE FROM DEFECTS IN WORKMANSHIP FOR A PERIOD OF ONE (1) YEAR, AFTER ACCEPTANCE OF THE INSTALLATION BY THE ENGINEER AND OWNER. THE CONTRACTOR SHALL SUBMIT A WRITTEN STATEMENT STATING SAME TO THE OWNER.
- 15. THE CONTRACTOR SHALL SUBMIT INSURANCE CERTIFICATES TO THE OWNER IN THE AMOUNT OF \$1,000,000 FOR LIABILITY AND BODILY INJURY PRIOR TO COMMENCING ANY WORK AND SHALL INDEMNIFY THE OWNER, HIS REPRESENTATIVES AND THE ENGINEER FROM ANY CLAIMS OR SUITS RESULTING IN NEGLIGENCE ON THE PART OF THE CONTRACTOR FOR FAILING TO EXECUTE HIS WORK IN ACCORDANCE WITH THE CONTRACT DOCUMENTS.
- 16. THE CONTRACTOR SHALL PROVIDE ALL RIGGING, HOISTING, AND SCAFFOLDING AS REQUIRED FOR THE INSTALLATION OF HIS WORK.
- 17. ALL WORK SHALL BE PERFORMED BY LICENSED CONTRACTORS IN THE TRADE HAVING JURISDICTION.
- 18. ANY DEVIATION OR CHANGE IN DESIGN SHALL NOT BE MADE WITHOUT WRITTEN APPROVAL OF THE ENGINEER OR OWNER.
- 19. ALL WORK SHALL BE PERFORMED DURING NORMAL WORKING HOURS: 8 A.M. TO 5 P.M. MONDAY THROUGH FRIDAY EXCEPT LEGAL HOLIDAYS OR FOR EMERGENCY REPAIRS, UNLESS DIRECTED OTHERWISE BY THE BUILDING
- 20. PATCHING OF WALLS SHALL MATCH EXISTING SURROUNDING AREA IN ALL RESPECTS. WORK AREA SHALL BE LEFT BROOM CLEAN AT THE END OF EACH DAY. ALL REMOVED MATERIAL AND RUBBISH SHALL BE DISCARDED FROM PREMISES DAILY IN AN APPROVED AND SAFE MANNER.
- 21. THE CONTRACTOR SHALL SUBMIT 6 SETS OF SHOP DRAWINGS OF ALL EQUIPMENT AND MATERIALS INCLUDING CONTROL WIRING DIAGRAMS TO THE ENGINEER FOR APPROVAL PRIOR TO FABRICATION AND INSTALLATION OF NEW WORK. SHOP DRAWINGS SHALL INDICATE STRUCTURAL MEMBERS, WALLS, FLOORS, PIPING, DUCTWORK, ETC., WITH ELEVATIONS AT WHICH NEW WORK IS TO BE INSTALLED.
- 22. THE CONTRACTOR SHALL MAINTAIN ON THE JOB SITE A SET OF SHOP DRAWINGS IN WHICH ANY DEVIATIONS FROM THE ORIGINAL DESIGN SHALL BE NOTED. UPON COMPLETION OF THE INSTALLATION OF NEW WORK THE CONTRACTOR SHALL TURN OVER TO THE OWNER AND ENGINEER TWO (2) PRINTS OF AS-BUILT SHOP DRAWINGS INCLUDING ALL APPROVED FIELD CHANGES AND DEVIATIONS. PRIOR TO FINAL PAYMENT THE CONTRACTOR SHALL SUBMIT ONE SET OF SEPIAS WITH CORRECTIONS NOTED TO THE OWNER SIGNED AS BUILT BY A PRINCIPAL OF THE FIRM AND DATED.

SPECIFICATIONS:

A. <u>PIPING:</u>

I. PEX TUBE AND FITTINGS

- 1. PEX DISTRIBUTION SYSTEM: ASTM F 877. SDR 9 TUBING.
- 2. FITTINGS FOR PEX TUBE: ASTM F 1807, METAL-INSERT TYPE WITH COPPER OR STAINLESS-STEEL CRIMP RINGS AND MATCHING PEX TUBE DIMENSIONS.
- 3. MANIFOLD: MULTIPLE-OUTLET, PLASTIC OR CORROSION-RESISTANT-METAL ASSEMBLY COMPLYING WITH ASTM F 877; WITH PLASTIC OR CORROSION-RESISTANT-METAL VALVE FOR EACH OUTLET.

II. COPPER TUBE AND FITTINGS

- 1. HARD COPPER TUBE: ASTM B 88: TYPE L, TYPE M AND TYPE K WATER TUBE, DRAWN TEMPER.
- 2. CAST-COPPER, SOLDER-JOINT FITTINGS: ASME B16.18, PRESSURE FITTINGS.
- 3. WROUGHT-COPPER, SOLDER-JOINT FITTINGS: ASME B16.22,

WROUGHT-COPPER PRESSURE FITTINGS.

4. BRONZE FLANGES: ASME B 16.24, CLASS 150, WITH SOLDER-JOINT

ENDS.

- 5. COPPER UNIONS:
- a. MSS SP-123. b. CAST-COPPER-ALLOY, HEXAGONAL-STOCK BODY.
- c. BALL-AND-SOCKET, METAL-TO-METAL SEATING SURFACES. d. SOLDER-JOINT OR THREADED ENDS.

6. COPPER PRESSURE-SEAL-JOINT FITTINGS

- a. FITTINGS FOR NPS 2 AND SMALLER: WROUGHT-COPPER FITTING WITH EPDM-RUBBER, O-RING SEAL IN EACH END. b. FITTINGS FOR NPS 2-1/2 TO NPS 4: CAST-BRONZE OR WROUGHT-COPPER FITTING WITH EPDM-RUBBER, O-RING SEAL IN EACH END.
- 7. COPPER PUSH-ON-JOINT FITTINGS:
- a. CAST-COPPER FITTING COMPLYING WITH ASME B16.18 OR WROUGHT COPPER FITTING COMPLYING WITH ASME B 16.22. b. STAINLESS-STEEL TEETH AND EPDM-RUBBER, O-RING SEAL IN EACH END INSTEAD OF SOLDER-JOINT ENDS.

III. CPVC PIPING

- 1. CPVC PIPE: ASTM F 441/F 441M, SCHEDULE 40 AND SCHEDULE 80. 2. CPVC SOCKET FITTINGS: ASTM F 438 FOR SCHEDULE 40 AND ASTM
- F 439 FOR SCHEDULE 80. 3. CPVC THREADED FITTINGS: ASTM F 437, SCHEDULE 80. 4. CPVC PIPING SYSTEM: ASTM D 2846/D 2846M, SDR 11, PIPE AND
- 5. CPVC TUBING SYSTEM: ASTM D 2846/D 2846M, SDR 11, TUBE AND
- SOCKET FITTINGS.

IV. PVC PIPE AND FITTINGS

- 1. PVC PIPE: ASTM D 1785, SCHEDULE 40 AND SCHEDULE 80. 2. PVC SOCKET FITTINGS: ASTM D 2466 FOR SCHEDULE 40 AND ASTM D 2467 FOR SCHEDULE 80.
- 3. PVC SCHEDULE 80 THREADED FITTINGS: ASTM D 2464.

V. PIPING JOINING MATERIALS

- 1. PIPE-FLANGE GASKET MATERIALS: a. AWWA C110/A21.10, RUBBER, FLAT FACE, 1/8 INCH THICK OR ASME B16.21, NONMETALLIC AND ASBESTOS FREE UNLESS OTHERWISE INDICATED.
- b. FULL-FACE OR RING TYPE UNLESS OTHERWISE INDICATED. 2. METAL, PIPE-FLANGE BOLTS AND NUTS: ASME B18.2.1, CARBON
- STEEL UNLESS OTHERWISE INDICATED. 3. SOLDER FILLER METALS: ASTM B 32. LEAD-FREE ALLOYS.
- 4. FLUX: ASTM B 813, WATER FLUSHABLE 5. BRAZING FILLER METALS: AWS A5.8/A5.8M, BCUP SERIES,
- OTHERWISE INDICATED. 6. SOLVENT CEMENTS FOR JOINING CPVC PIPING AND TUBING: ASTM F
 - a. CPVC SOLVENT CEMENT SHALL HAVE A VOC CONTENT OF 490 G/L OR LESS WHEN CALCULATED ACCORDING TO 40 CFR 59, SUBPART D (EPA METHOD 24).

COPPER-PHOSPHORUS ALLOYS FOR GENERAL-DUTY BRAZING UNLESS

- b. ADHESIVE PRIMER SHALL HAVE A VOC CONTENT OF 550 G/L OR LESS WHEN CALCULATED ACCORDING TO 40 CFR 59, SUBPART D (EPA METHOD)
- 7. SOLVENT CEMENT AND ADHESIVE PRIMER SHALL COMPLY WITH THE TESTING AND PRODUCT REQUIREMENTS OF THE CALIFORNIA DEPARTMENT OF HEALTH SERVICES' "STANDARD PRACTICE FOR THE TESTING OF VOLATILE ORGANIC EMISSIONS FROM VARIOUS SOURCES USING SMALL-SCALE ENVIRONMENTAL CHAMBERS."
- 8. SOLVENT CEMENTS FOR JOINING PVC PIPING: ASTM D 2564. INCLUDE PRIMER ACCORDING TO ASTM F 656. a. PVC SOLVENT CEMENT SHALL HAVE A VOC CONTENT OF 510 G/L OR LESS WHEN CALCULATED ACCORDING TO 40 CFR 59, SUBPART D (EPA METHOD 24).
 - b, ADHESIVE PRIMER SHALL HAVE A VOC CONTENT OF 550 G/L OR LESS WHEN CALCULATED ACCORDING TO 40 CFR 59, SUBPART D (EPA METHOD 24).
 - c. SOLVENT CEMENT AND ADHESIVE PRIMER SHALL COMPLY WITH THE TESTING AND PRODUCT REQUIREMENTS OF THE CALIFORNIA DEPARTMENT OF HEALTH SERVICES' "STANDARD PRACTICE FOR THE TESTING OF VOLATILE ORGANIC EMISSIONS FROM VARIOUS SOURCES USING SMALL-SCALE ENVIRONMENTAL CHAMBERS."
- 9. PLASTIC, PIPE-FLANGE GASKETS, BOLTS, AND NUTS: TYPE AND MATERIAL RECOMMENDED BY PIPING SYSTEM MANUFACTURER UNLESS OTHERWISE INDICATED.

PIPING (CONT.):

VI. TRANSITION FITTINGS

- GENERAL REQUIREMENTS:
- a. SAME SIZE AS PIPES TO BE JOINED. b. PRESSURE RATING AT LEAST EQUAL TO PIPES TO BE JOINED. c. END CONNECTIONS COMPATIBLE WITH PIPES TO BE JOINED.
- 2. FITTING-TYPE TRANSITION COUPLINGS: MANUFACTURED PIPING COUPLING
- OR SPECIFIED PIPING SYSTEM FITTING.
- 3. PLASTIC-TO-METAL TRANSITION FITTINGS:
 - a. CPVC OR PVC ONE-PIECE FITTING WITH MANUFACTURER'S SCHEDULE 80 EQUIVALENT DIMENSIONS.
 - b. ONE END WITH THREADED BRASS INSERT AND ONE SOLVENT-CEMENT-SOCKET OR THREADED END.
- 4. PLASTIC-TO-METAL TRANSITION UNIONS:
- *DESCRIPTION: a. CPVC OR PVC FOUR-PART UNION.
- b. BRASS OR STAINLESS-STEEL THREADED END. c. SOLVENT-CEMENT-JOINT OR THREADED PLASTIC END.
- d. RUBBER O-RING. e. UNION NUT.

VII. GAS PIPING:

PIPING SHALL BE SCHEDULE 40 STEEL WITH 150 LBS. MALLEABLE IRON SCREWED FITTINGS. GAS PIPING OVER 3" SHALL BE WELDED AS PER CON EDISON REQUIREMENTS

VIII. DIELECTRIC FITTINGS

1, GENERAL REQUIREMENTS: ASSEMBLY OF COPPER ALLOY AND FERROUS MATERIALS WITH SEPARATING NONCONDUCTIVE INSULATING MATERIAL.

INCLUDE END CONNECTIONS COMPATIBLE WITH PIPES TO BE JOINED.

- 2. DIELECTRIC UNIONS:
 - a. STANDARD: ASSE 1079. b. PRESSURE RATING: 125 PSIG (MINIMUM AT 180 DEG F
 - c. END CONNECTIONS: SOLDER-JOINT COPPER ALLOY AND THREADED FERROUS.
- 3. DIELECTRIC FLANGES: a, STANDARD: ASSE 1079.
- b. FACTORY-FABRICATED, BOLTED, COMPANION-FLANGE ASSEMBLY.
- c. PRESSURE RATING: 125 PSIG MINIMUM AT 180 DEG F. d. END CONNECTIONS: SOLDER-JOINT COPPER ALLOY AND THREADED FERROUS; THREADED SOLDER-JOINT COPPER ALLOY AND THREADED FERROUS.

4. DIELECTRIC-FLANGE INSULATING KITS:

- a. NONCONDUCTING MATERIALS FOR FIELD ASSEMBLY OF COMPANION
- b. PRESSURE RATING: 150 PSIG (1035 KPA).
- c. GASKET: NEOPRENE OR PHENOLIC. d. BOLT SLEEVES: PHENOLIC OR POLYETHYLENE.
- e. WASHERS: PHENOLIC WITH STEEL BACKING WASHERS.
- 5. DIELECTRIC NIPPLES:
 - a. STANDARD: IAPMO PS 66. b. ELECTROPLATED STEEL NIPPLE COMPLYING WITH ASTM F 1545. c. PRESSURE RATING AND TEMPERATURE: 300 PSIG AT 225 DEG F. d. END CONNECTIONS: MALE THREADED OR GROOVED.
- e. LINING: INERT AND NONCORROSIVE, PROPYLENE. XI. PIPING INSULATION
 - ALL COLD AND HOT WATER PIPING TO BE INSULATED WITH R-3 INSULATION.

INSULATION MATERIALS

- 1. PRODUCTS SHALL NOT CONTAIN ASBESTOS, LEAD, MERCURY, OR
- MERCURY COMPOUNDS. 2. PRODUCTS THAT COME IN CONTACT WITH STAINLESS STEEL SHALL HAVE
- ACCORDING TO ASTM C 871. 3. INSULATION MATERIALS FOR USE ON AUSTENITIC STAINLESS STEEL SHALL

A LEACHABLE CHLORIDE CONTENT OF LESS THAN 50 PPM WHEN TESTED

- BE QUALIFIED AS ACCEPTABLE ACCORDING TO ASTM C 795. 4. FOAM INSULATION MATERIALS SHALL NOT USE CFC OR HCFC BLOWING
- AGENTS IN THE MANUFACTURING PROCESS. 5. CELLULAR GLASS: INORGANIC, INCOMBUSTIBLE, FOAMED OR CELLULATED
- GLASS WITH ANNEALED, RIGID, HERMETICALLY SEALED CELLS. a. BLOCK INSULATION: ASTM C 552, TYPE I b. SPECIAL-SHAPED INSULATION: ASTM C 552, TYPE III.
- c. BOARD INSULATION: ASTM C 552, TYPE IV.
- d. PREFORMED PIPE INSULATION WITHOUT JACKET: COMPLY WITH ASTM C 552, TYPE II, CLASS 1.
- e. PREFORMED PIPE INSULATION WITH FACTORY-APPLIED: COMPLY WITH ASTM C 552, TYPE II, CLASS 2.
- f. FACTORY FABRICATE SHAPES ACCORDING TO ASTM C 450 AND ASTM C 585.
- 6. FLEXIBLE ELASTOMERIC INSULATION: CLOSED-CELL, SPONGE- OR EXPANDED-RUBBER MATERIALS. COMPLY WITH ASTM C 534, TYPE I FOR TUBULAR MATERIALS.
- 7. MINERAL-FIBER BLANKET INSULATION: MINERAL OR GLASS FIBERS BONDED WITH A THERMOSETTING RESIN. COMPLY WITH ASTM C 1290,
- 8. MINERAL-FIBER, PREFORMED PIPE INSULATION:
 - a. TYPE I, 850 DEG F MATERIALS: MINERAL OR GLASS FIBERS BONDED WITH A THERMOSETTING RESIN. COMPLY WITH ASTM C 547, TYPE I, GRADE A, WITHOUT FACTORY-APPLIED JACKET. b. TYPE II, 1200 DEG F MATERIALS: MINERAL OR GLASS FIBERS BONDED WITH A THERMOSETTING RESIN. COMPLY WITH ASTM C 547, TYPE II, GRADE A, WITHOUT FACTORY-APPLIED JACKET.
- 9. MINERAL-FIBER, PIPE INSULATION WICKING SYSTEM: PREFORMED PIPE INSULATION COMPLYING WITH ASTM C 547, TYPE I, GRADE A, WITH ABSORBENT CLOTH FACTORY-APPLIED TO THE ENTIRE INSIDE SURFACE OF PREFORMED PIPE INSULATION AND EXTENDED THROUGH THE LONGITUDINAL JOINT TO OUTSIDE SURFACE OF INSULATION UNDER INSULATION JACKET. FACTORY APPLY A WHITE, POLYMER, VAPOR-RETARDER JACKET WITH SELF-SEALING ADHESIVE TAPE SEAM AND EVAPORATION HOLES RUNNING CONTINUOUSLY ALONG THE
- 10. POLYOLEFIN: UNICELLULAR, POLYETHYLENE THERMAL PLASTIC INSULATION. COMPLY WITH ASTM C 534 OR ASTM C 1427, TYPE I GRADE 1 FOR TUBULAR MATERIALS AND TYPE II, GRADE 1 FOR SHEET MATERIALS.

LONGITUDINAL SEAM, EXPOSING THE ABSORBENT CLOTH.

PIPING (CONT.):

X. PIPING SUPPORTS

- 1. ALL PIPING SHALL BE SUPPORTED FROM THE BUILDING STRUCTURE ONLY USING APPROVED TYPE CLEVIS HANGERS, BEAM CLAMPS, THREADED RODDOR AS PER MANUFACTURER'S RECOMMENDATIONS.
- XI. PIPING VALVES AND SPECIALTIES LOW PRESSURE STEAM AND CONDENSATE PIPING
- 1. PIPING SHALL BE SCHEDULE 40 STEEL, SEAMLESS, ASTM-A53 GRADE A OR B WITH 150 LB. STEEL WELD NECK FITTINGS AND FLANGES IN SIZES 2-1/2 AND LARGER. FLANGE GASKETS SHALL BE NON-ASBESTOS, 304 S.S. SPIRAL WOUND, SIMILAR TO FLEXITALLIC. PIPING 2" AND SMALLER SHALL BE SCREWED WITH 125 LB. CAST IRON FLAT BAND STEAM FITTINGS.

XII. FUEL OIL

FITTINGS.

XIII. GAS PIPING

- 1. PIPING SHALL BE SCHEDULE 40 STEEL WITH 150 LBS. MALLEABLE IRON SCREWED
- PIPING SHALL BE SCHEDULE 40 STEEL WITH 150 LBS. MALLEABLE IRON SCREWED FITTINGS. GAS PIPING OVER 3" SHALL BE WELDED PER CON EDISON REQUIREMENTS

XIV. COLD WATER, HOT WATER & RECIRCULATING WATER PIPING

1. PIPING SHALL BE COPPER TUBING TYPE L WITH WROUGHT COPPER SWEAT FITTINGS AND 95/5 BRAZED JOINTS.

<u>DUCTWORK</u>

1. GENERAL REQUIREMENTS

- A. CONSTRUCT ALL APPARATUS OF MATERIALS AND PRESSURE RATINGS SUITABLE FOR THE CONDITIONS ENCOUNTERED DURING CONTINUOUS OPERATION.
- B. WHERE CORROSION CAN OCCUR, APPROPRIATE CORROSION RESISTANT MATERIALS AND ASSEMBLY METHODS MUST BE USED.
- C. PROVIDE ALL CONTROLS, WIRING, PIPING, VALVES, TUBING ACCESSORIES AND OTHER COMPONENTS NECESSARY TO MAKE ALL SYSTEMS COMPLETE AND OPERABLE.

A. ALL WORK SHALL MEET WITH THE 2015 INTERNATIONAL BUILDING, MECHANICAL AND FUEL GAS CODES AS MODIFIED BY 2016 UNIFORM CODE SUPPLEMENT OF NEW YORK. ALL WORK SHALL ALSO COMPLY WITH 2015 INTERNATIONAL ENERGY CONSERVATION CODE AS MODIFIED BY 2016 SUPPLEMENT TO THE NEW YORK STATE ENERGY CONSERVATION CONSTRUCTION CODE (REVISED AUGUST 2016)

3. SHOP DRAWINGS AND SUBMITTALS REQUIRED

A. MANUFACTURER'S DATA OR SHOP DRAWINGS OF THE FOLLOWING APPARATUS GIVING FULL INFORMATION AS TO DIMENSIONS, MATERIALS AND ALL INFORMATION PERTINENT

TO THE ADEQUACY OF THE PROPOSED EQUIPMENT SHALL BE SUBMITTED.

- 1. GAS-FIRED FURNACES
- 2. CONDENSING UNITS
- DUCTWORK LAYOUT
- 4. AIR BALANCING REPORT

4. TESTING AND BALANCING

A. ALL FANS AND DUCT SYSTEMS SHALL BE COMPLETELY BALANCED BY THE ADJUSTMENT OF SHEAVES, DAMPERS, REGISTERS AND OTHER DEVICES TO OBTAIN THE AIR QUANTITIES INDICATED ON THE DESIGN DRAWINGS.

5. <u>DUCTWORK</u>

- A. PROVIDE ALL LABOR, MATERIALS, EQUIPMENT AND SERVICES AND PERFORM ALL OPERATIONS REQUIRED FOR COMPLETE INSTALLATION OF THE DUCTWORK, REGISTERS. DAMPERS AND ALL AUXILIARY WORK OF ANY KIND, NECESSARY TO MAKE THE VARIOUS AIR CONDITIONING, VENTILATING AND HEATING SYSTEMS OF THE BUILDING
- B. INSTALL DUCTS, PLENUMS AND HANGERS PLUMB AND LEVEL, WITH JOINTS SQUARE AND DEVOID OF SHARP EDGES. ROUTE DUCTWORK TO MINIMIZE DIRECTIONAL CHANGES AND ABRUPT TRANSITIONS. PROVIDE ADEQUATE SPACE AROUND DUCTS TO ASSURE PROPER SUPPORT AND TO ALLOW THE INSTALLATION OF THE INSULATION
- C. ANY DUCTWORK PASSING THROUGH WATERPROOF WALL OR ROOF CONSTRUCTIONS

COMPLETE AND READY FOR SATISFACTORY OPERATION.

LOCAL AUTHORITIES HAVING JURISDICTION.


- HALL BE PROVIDED WITH COUNTERFLASHING BY THIS CONTRACTOR. D. CONSTRUCT AND SUPPORT ALL DUCTWORK AND FAN AND APPARATUS PLENUMS IN ACCORDANCE WITH THE LATEST STANDARDS OF THE SHEET METAL AND AIR CONDITIONING CONTRACTORS NATIONAL ASSOCIATION. ALL WORK, MATERIALS AND EQUIPMENT SHALL COMPLY WITH THE LATEST REQUIREMENTS OF NFPA 90A AND THE
- E. BRACING, GAUGES AND SUPPORTS INDICATED IN SMACNA MANUALS ARE THE MINIMUM ACCEPTABLE. INSTALL ADDITIONAL BRACING OR SUPPORTS TO ELIMINATE ANY DISTORTION OR VIBRATION WHEN THE SYSTEMS ARE OPERATING OR UNDER TESTS. NO
- DUCT SHALL BE LESS THAN 24 GAUGE. 6. HANGERS AND SUPPORTS
- A. PROVIDE HANGERS AND SUPPORTS TO SUPPORT THE WEIGHT OF DUCTS AND ASSOCIATED EQUIPMENT. FASTEN HANGERS AND SUPPORTS TO STEEL STRUCTURE BY BEAM CLAMPS OR BY STEEL CLIPS WELDED TO THE LOWER FLANGES OF BEAMS AND GIRDERS AND TO CONCRETE STRUCTURE BY INSERTS OR EXPANSION ANCHORS. PROVIDE FASTENINGS ADEQUATE TO INSURE PERMANENT STABILITY, TO EFFECTIVELY

7. FLEXIBLE CONNECTIONS

EQUIVALENT.

A. INSTALL AIRTIGHT FLEXIBLE CONNECTIONS WHERE DUCTWORK OR CASINGS CONNECT TO FAN INLETS AND DISCHARGES. FASTEN CONNECTION SECURELY WITH BOLTED CLAMPS. MAKE THE UNCLAMPED PORTION OF THE CONNECTION NOT LESS THAN 6" LONG, CRIMPED FOR FLEXIBILITY. CONSTRUCTION - 30 OUNCE CLOSELY WOVEN GLASS FABRIC, DOUBLE-COATED WITH NEOPRENE: VENTFABRICS, INC. "VENTGLAS" OR

RESIST ALL APPLIED LOADS AND STRAINS, AND TO COMPLY WITH APPLICABLE CODES.

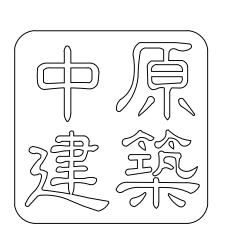


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6402 8TH AVENUE, SUITE 401, BROOKLYN, NEW YORK 11220 TEL:(718)928-6628 FAX:(228)200-0022 E-MAIL:INFO@PONDOSA.COM

Architecture + Planning

	E WALLIN COLOUR	
5		
4		
3		
2	REVISED	9/10/2021
1	CLIENT REVIEW	3/11/2021
NO.	ISSUED FOR	DATE

REVISIONS

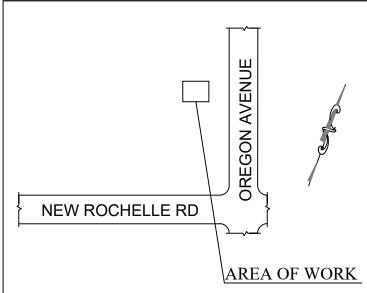

SCOPE OF WORK:

FIRE HOUSE (MECHANICAL

PROJECT LOCATION:

10 OREGON AVENUE BRONXVILLE, NY 10708

SHEET TITLE:

MECHANICAL SPECIFICATIONS

PROJECT #: 21-0311-00 SCALE: AS NOTED DATE: 10/20/2020

 AM

DRAWN BY: REVIEWED BY: DL/MW



SHEET NO .: M-106.00

DOB JOB #

DOB STAMP & SIGNATURE

SHEET: 7 OF 7

- ALL WORK MUST BE PERFORMED IN ACCORDANCE W/ THE TOWN OF EASTCHESTER ZONING LAW, THE 2020 BUILDING CODE OF NEW YORK STATE THE 2020 EXISTING BUILDING CODE OF NYS, AND ALL SUPPLEMENTS AND ALL CURRENT SUPPLEMENTS AND ALL OTHER APPLICABLE
- ORDINANCES, REGULATIONS, AND STANDARDS REQUIRED. 2. ALL MANUFACTURED ITEMS SHALL BE INSTALLED OR APPLIED AS
- 3. CONTRACTOR TO INCLUDE ALL MATERIALS, LABOR, INCIDENTALS AND SERVICES FOR SATISFACTORYS COMPLETION OF THE WORK.

DIRECTED BY THE MANUFACTURERS RECOMMENDATIONS.

- . CONTRACTOR SHALL VERIFY ALL EXISTING CONDITIONS IN THE FIELD AND SHALL NOTIFY THE ARCHITECT/ENGINEER OF ANY DISCREPANCIES BEFORE STARTING THE WORK.
- CONTRACTOR SHALL PERFORM ALL WORK REQUIRED FOR THE TOTAL COMPLETION OF THE PROJECT, WHETHER OR NOT INDICATED ON THE DRAWINGS. THE INTENTION OF THE DRAWINGS IS FOR A COMPLETE AND PROPER FUNCTIONING OF THE ENTIRE PROJECT.

- CONTRACTOR, AND HIS SUBCONTRACTORS, SHALL MAINTAIN WORKMEN'S CONPENSATION INSURANCE AS WELL AS ADEQUATE LIABILITY INSURANCE DURING THE ENTIRE LENGTH OF THE JOB.
- 2. OWNER SHALL PROVIDE ADEQUATE PROPERTY INSURANCE ON VALUE OF THE CONSTRUCTION, INCLUDING FIRE & VANDALISM.

PERMITS & SURVEYS:

- CONTRACTOR SHALL FURNISH ALL PERMITS, LICENSES AND APPROVALS NECESSARY TO COMPLETE THE WORK.
- 2. CONTRACTOR SHALL PROVIDE THE OWNER WITH A CERTIFICATE OF OCCUPANCY AND OR COMPLETION UPON COMPLETION OF WORK.

SITE MAINTENANCE

- . JOB SITE TO BE KEPT CLEAN AT ALL TIMES, TRASH TO BE REMOVED FROM THE SITE WEEKLY OR STORED IN APPROVED DUMPSTER UNTIL FULL THAN THAN CARTED AWAY FROM THE SITE.
- 2. CARE SHALL BE TAKEN TO PROTECT THE TREES ON THE PROPERTY FROM THE METHODS AND MANNERS OF CONSTRUCTION. TRAFFICKING AND STORAGE OF MATERIALS. RETURN THOSE AREAS DAMAGED BY SUCH TO THEIR ORIGINAL CONDITION.

GENERAL NOTES

- WORK MUST CONFORM TO THE OTHER REQUIREMENTS OF THE THE 2020 BUILDING CODE OF NEW YORK STATE, AND THE 2020 EXISTING BUILDING CODE OF NYS AND ALL SUPPLEMENTS FIRE DEPARTMENT REGULATIONS AND ALL APPLICABLE LAWS. UTILITY COMPANY REQUIREMENTS AND BEST TRADE PRACTICES.
- BEFORE COMMENCING WORK, THE CONTRACTOR SHALL FILE ALL REQUIREMENTS CERTIFICATES OF INSURANCE WITH DEPARTMENT OF BUILDING. OBTAIN ALL REQUIRED PERMITS FROM ALL APPLICABLE AGENCIES AND PAY ALL FEES REQUIRED BY GOVERNING AGENCIES.
- THE CONTRACTOR SHALL VERIFY ALL EXISTING CONDITIONS IN THE FIELD PROPER TO COMMENCING WORK AND SHALL REPORT ANY DISCREPANCIES BETWEEN DRAWINGS AND FIELD CONDITIONS TO THE ENGINEER/ARCHITECT
- MINOR DETAILS NOT USUALLY SHOWN OR SPECIFIED BUT NECESSARY FOR PRIOR CONSTRUCTION OF ANY PART OF WORK SHALL BE INCLUDED AS IF THEY WERE INDICATED IN THE DRAWINGS, AND THE ENGINEER/ARCHITECT AND OWNER SHALL BE NOTIFIED IN THE WRITING PRIOR TO COMMENCING WORK.
- . THE CONTRACTOR SHALL COORDINATE ALL WORK PROCEDURES WITH REQUIREMENTS OF LOCAL AUTHORITIES AND OWNER.
- THE CONTRACTOR SHALL BE RESPONSIBLE FOR THE PROTECTION OF ALL CONDITIONS AND MATERIALS WITH IN THE PROPOSED CONSTRUCTION AREA. THE CONTRACTOR SHALL DESIGN AND INSTALL ADEQUATE SHORING AND BRACING FOR ALL STRUCTURAL OR REMOVAL TASKS. THE CONTRACTOR SHALL HAVE SOLE RESPONSIBILITIES FOR ANY DAMAGE AND INJURIES CAUSED BY DURING THE EXECUTION OF THE WORK.
- PLUMBING AND ELECTRICAL WORK IF ANY SHALL BE PERFORMED BY PERSONS LICENSED IN THEIR TRADE, WHO SHALL ARRANGE FOR AND OBTAIN INSPECTIONS AND REQUIRED SIGN OFF.
- THE CONTRACTOR SHALL DO ALL PATCHING AND CUTTING, REPAIRING AS REQUIRED TO PERFORM ALL OF THE WORK INDICATED ON THE DRAWINGS AND ALL OTHER WORK THAT MAY BE REQUIRED TO COMPLETE THE JOB.
- ALL PIPING AND WIRING SHALL BE REMOVED TO A POINT OF CONCEALMENT AND SHALL BE PROPERLY CAPPED AND PLUGGED.
- SHORING OF MEMBERS AND PROTECTIONS OF THE EXISTING STRUCTURE DURING CONSTRUCTION IS THE RESPONSIBILITY OF CONTRACTOR AND SHALL COMPLY WITH ALL REQUIREMENTS OF LOCAL AND STATE CODES.
- 11. THIS PLAN AND APPLICATION HAS BEEN FILED FOR STATED WORK ONLY. ANY REVISIONS OR CHANGES TO THE SCOPE OF THE WORK SHALL REQUIRE AMENDED PLANS AND/OR A SEPARATE APPLICATION.
- 12. THE CONTRACTOR SHALL CHECK AND VERIFY ALL DIMENSIONS, NOTES, AND CONDITIONS AT THE JOB SITE, AND IS TO REPORT ANY DEVIATIONS TO THE ARCHITECT/ENGINEER PRIOR TO THE START OF ANY WORK.
- 13. PROTECTION OF ADJOINING PROPERTIES SHALL BE MAINTAINED IN ACCORDANCE WITH ALL APPLICABLE BUILDING CODES, AND RULES AND
- 14. THE PLANS ARE NOT TO BE SCALED, WRITTEN DIMENSIONS SHALL GOVERN.
- 15. IN CASE OF ANY DISCREPANCIES BETWEEN THE GENERAL NOTES, AND SPECIFIC ITEMS SHOWN ON PLANS, THE PLANS SHALL PREVAIL.
- 16. THE CONTRACTOR SHALL REPAIR ALL PORTIONS OF THE PREMISES THAT ARE DAMAGED DURING THE COURSE OF HIS WORK.
- 17. BEFORE SUBMITTING PROPOSAL, ALL CONTRACTORS SHALL VISIT THE PREMISES, FAMILIARIZE THEMSELVES WITH EXISTING CONDITIONS AND SATISFY THEMSELVES AS TO THE NATURE AND SCOPE OF WORK AND DIFFICULTIES THAT ATTEND ITS EXECUTION.
- 18. IF THE CONTRACTOR CLAIMS EXTRA COST UNDER THE CONTRACT HE SHALL GIVE THE OWNER AND THE ARCHITECT WRITTEN NOTICE THEREOF WITHIN A REASONABLE TIME BEFORE PROCEEDING TO EXECUTE THE WORK, ALL CLAIMS FOR EXTRA WORK WILL BE SUBMITTED IN WRITING FOR APPROVAL BY THE OWNER.
- 19. THE GENERAL CONTRACTOR SHALL BE RESPONSIBLE TO SCHEDULE ALL NECESSARY INSPECTIONS FROM AGENCIES RESPONSIBLE. GC IS ALSO RESPONSIBLE FOR ALL TRADE PERMITS AND INSPECTION FEES

TENANT SAFETY NOTES

- . ALL WORK TO BE ONE IN ACCORDANCE WITH THE 2020 BUILDING CODE OF NEW YORK STATE, THE 2020 EXISTING BUILDING CODE OF NYS
- AND REGULATIONS OF ALL OTHER AGENCIES HAVING JURISDICTION.

- A. CONTRACTOR TO PROVIDE ADEQUATE TEMPORARY BRACING AND SHORING WHERE EVER ANY STRUCTURAL WORKS IS INVOLVED
- B. ALL DEMOLITION OPERATIONS ,REPAIR OPERATIONS AND ALTERNATIONS OPERATIONS TO BE DONE IN ACCORDANCE WITH NEW YORK STATE BUILDING CODE AND LOCAL LAWS
- C. IF SITE SAFETY BRIDGING IS NOT REQUIRED BY CODE, AT A MINIMUM, OVERHEAD PROTECTION SHALL BE PROVIDED AT ALL ENTRANCES. WALKWAYS WITHIN 10' OF THE WORK SHALL ALSO BE BRIDGED REGARDLESS OF CODE REQUIREMENTS.

MEANS OF EGRESS

1. ALL EXISTING MEANS OF EGRESS FOR TENANTS OF BUILDING TO BE MAINTAINED CLEAR AND FREE OF ALL OBSTRUCTIONS, SUCH AS BUILDING MATERIALS, TOOLS E.T.C.

- A. ALL BUILDING MATERIALS STORED AT CONSTRUCTION AREA AND OR IN ANY AREA OF THE BUILDING ARE TO BE SECURED IN A LOCKED AREA. ACCESS TO SUCH AREAS TO BE CONTROLLED BY OWNER AND /OR GENERAL CONTRACTOR.
- B. ALL MATERIALS TO BE STORED IN AN ORDERLY FASHION.
- C. ALL FLAMMABLE MATERIALS TO BE KEPT TIGHTLY SEALED IN THEIR RESPECTIVE MANUFACTURERS CONTAINERS SUCH MATERIALS ARE TO BE KEEP AWAY FROM HEAT.
- D. ALL FLAMMABLE MATERIALS TO BE USED AND STORED IN AN ADEQUATE\ **VENTILATED SPACE**
- E. ALL ELECTRICAL POWER TO BE SHUT OFF WHERE THERE IS **EXPOSED CONDUIT**
- F. ALL ELECTRICAL POWER IN CONSTRUCTION AREA TO BE SHUT OFF AFTER WORKING HOURS.
- G. CONTRACTOR AT ALL TIMES TO MAKE SURE THERE S NO LEAKAGE OF NATURAL GAS IN THE BUILDING OR ANY FLAMMABLE GAS USED IN CONSTRUCTION.

- A. DEBRIS ,DIRT AND DUST TO KEPT TO A MINIMUM AND BE CONFINED TO IMMEDIATE CONSTRUCTION AREA.
- B. CONTRACTOR TO ISOLATE CONSTRUCTION AREA FROM OCCUPIED BUILDING AREA BY MEANS OF TEMPORARY PARTITIONS OR HEAVY
- C. DEBRIS, DIRT AND DUST TO BE CLEANED UP AND CLEARED FROM BUILDING PERIODICALLY BUT NOT LESS THAN FREQUENTLY THAN DAILY TO AVOID ANY EXCESSIVE ACCUMULATIONS.

- A. CONSTRUCTION OPERATIONS WILL BE CONFINED TO NORMAL WORKING HOURS 8 A.M. TO 5:00 P.M.. MONDAY THROUGH FRIDAY EXCEPT LEGAL HOLIDAYS.
- B. CONTRACTOR TO OBTAIN WRITTEN CONSENT OF ALL PARTIES AFFECTED
- BY HIS WORKING DURING OTHER THAN NORMAL HOURS, AS DEFINED ABOVE. C. CONTRACTOR SHALL OBTAIN AFTER HOUR WORK PERMIT FROM ALL APPLICABLE
- AGENCIES IF WORKING AFTER HOURS. D. CONSTRUCTION OPERATIONS WILL NOT INVOLVE INTERRUPTION OF HEATING WATER OR ELECTRICAL SERVICES TO OTHER TENANTS OF THE BUILDING.
- E. CONSTRUCTION WORK WILL BE CONFINED TO AREA OF WORK AND WILL NOT CREATE DUST, DIRT OR OTHER SUCH INCONVENIENCES TO OTHER APARTMENT UNITS WITHIN THE BUILDING.
- F. LOCATION WILL BE DETERMINED BY THE EXTENT OF REPAIRS OR CONSTRUCTION. STRUCTURAL DESIGN CRITERIA SHEET

BUILDING CODE: THE 2020 BUILDING CODE OF NEW YORK STATE,

STRUCTURAL MATERIALS:

REINFORCED CONCRETE (NWT & AIR-ENTRAINED) F'c=: 4000 PSI STRUCTURAL STEEL: ASTM A - 992, Fy = 50,000 PS MISCELLANEOUS STEEL ASTM A - 36, Fy = 36,000 PSI

METAL DECK AND COLD FORMED STEEL: ASTM A 446. Fv = 33.000 PSI CONCRETE MASONRY: F'm = 1950 PSI

DEAD LOADS

REINFORCED CONCRETE:	150 PCF
STRUCTURAL STEEL:	490 PCF
CONCRETE MASONRY :	140 PCF
FLOORING LOAD:	1 PSF
PARTITION LOAD:	10 PSF
CEILING LOAD:	3 PSF
MECHANICAL DUCT:	4 PSF
ROOFING:	6 PSF
SNOW LOAD: PG = 45 PSF PF = 28 PSF,	SAY 30 PSF

LIVE LOAD:

ROOF:	30 PSF
SECOND FLOOR TO FOURTH FLOOR: ALL RESIDENTIAL AREAS:	40 PSF

PUBLIC AREAS (LOBBY AND CORRIDOR):	100 PS
FIRST FLOOR:	

ALL RESIDENTIAL AREAS:	40 PSF
ALL PUBLIC SPACES (LOBBY, STORAGE, CORRIDORS):	100 PSF
ALL MECHANICAL ROOM, ETC.	100 PSF
ALL PARKING AREAS:	75 PSF
ALL OFFICE AREA:	50 PSF

WIND LOAD: 120 MPH AT 33 FEET ABOVE GROUND

ZONE A:	19.2 PSF
ZONE B:	- 10.0 PSF
ZONE C:	12.7 PSF
ZONE D:	- 5.9 PSF

SEISMIC LOAD:

SEISMIC USE GROUP: I

SEISMIC DESIGN CATEGORY: C

FOUNDATION BEARING CAPACITY: 2 TONS PER SQUARE FOOT

SAFEGUARDS DURING CONSTRUCTION:

PROJECT SHALL COMPLY WITH CHAPTER 33 SAFEGUARDS DURING CONSTRUCTION OF THE 2020 BUILDING CODE OF NEW YORK STATE,

3301.2 STORAGE AND PLACEMENT. CONSTRUCTION EQUIPMENT AND MATERIALS SHALL BE STORED AND PLACED SO AS NOT TO ENDANGER THE PUBLIC, THE WORKERS ADJOINING PROPERTY FOR THE DURATION OF THE CONSTRUCTION PROJECT.

3302.1 ALTERATIONS, REPAIRS AND ADDITIONS. REQUIRED EXITS, EXISTING STRUCTURAL ELEMENTS, FIRE PROTECTION DEVICES AND SANITARY SAFEGUARDS SHALL BE MAINTAINED AT ALL TIMES DURING REMODELING, ALTERATIONS, REPAIRS OR ADDITIONS TO ANY BUILDING OR STRUCTURE.

- 1. WHEN SUCH REQUIRED ELEMENTS OR DEVICES ARE BEING REMODELED, ALTERED OR REPAIRED, ADEQUATE SUBSTITUTE PROVISIONS SHALL BE MADE.
- 2. MAINTENANCE OF SUCH ELEMENTS AND DEVICES IS NOT REQUIRED WHEN THE

EXISTING BUILDING IS NOT OCCUPIED. 3302.2 MANNER OF REMOVAL. WASTE MATERIALS SHALL BE REMOVED IN A MANNER WHICH PREVENTS INJURY OR DAMAGE TO PERSONS, ADJOINING PROPERTIES AND PUBLIC RIGHTS-OF-WAY.

UTILITY NOTES

1. EXISTING WATER, ELECTRICAL, GAS, SANITARY SEWER, STEAM PIPES, TELEPHONE AND COMPUTER LINES SHALL BE PROTECTED AND/OR RELOCATED TO ACCOMODATE THE NEW LAYOUT

2. ANY CHANGES OR ADDITIONS TO GAS, ELECTRICAL, OR OTHER UTILITIES ARE TO BE COORDINATED BY THE GENERAL CONTRACTOR WITH A REPRESENTATIVE OF THAT UTILITY COMPANY.

VISUAL CONSTRUCTION INSPECTIONS FOR DOB

- SOIL INSPECTION FOR RAMP
- FOOTING INSPECTION FOR RAMP
- FRAMING INSPECTION
- FIRE STOPPING INSPECTION INSULATION INSPECTION
- PLUMBING INSPECTION (ROUGH AND FINAL)
- ELECTRICAL INSPECTION (ROUGH AND FINAL) MECHANICAL INSPECTION
- FINAL CONSTRUCTION INSPECTION

3306.1 PROTECTION REQUIRED. PEDESTRIANS SHALL BE PROTECTED DURING CONSTRUCTION, REMODELING AND DEMOLITION ACTIVITIES AS REQUIRED BY THIS CHAPTER AND TABLE 3306.1. SIGNS SHALL BE PROVIDED TO DIRECT PEDESTRIAN TRAFFIC.

PERMITS REQUIRED FROM DEPT. OF BUILDINGS

- BUILDING PERMIT
- PLUMBING PERMIT
- ELECTRICAL PERMIT
- CERTIFICATE OF COMPLIANCE AT COMPLETION OF PROJECT

ELECTRICAL LIGHTING AND POWER TO BE PROVIDED BY LICENSED ELECTRICIAN AND COORDINATED WITH THE FIRE DEPARTMENT

2020 ENERGY CONSERVATION CODE

OF NEW YORK STATE & UNIFORM CODE SUPPLEMENTS CHAPTER 1/15 GENERAL REQUIREMENTS

R101.1 Title. This code shall be known as the Energy Conservation Construction Code of New York State, and shall be cited as such. It is referred to herein as "this code. R501.2 Existing buildings. Except as specified in this chapter, this code shall not be used to require the removal, alteration or

abandonment of, nor prevent the continued use and maintenance of, an existing building or building system lawfully in existence

R501.4 Compliance: Alterations, Repairs, Additions and changes of occupancy to, or relocation of, existing buildings and structures shall comply with the provisions for, alterations, repairs, additions, and changes of occupancy or relocation, respectively in the International Residential Code, International Code, International Fire Code, International Fuel Gas Code, International Mechanical Code, International Plumbing Code, International Property Maintenance Code, International Private

Sewage Disposal Code and NFPA 70. R502.1 General: (Additions) Additions to an existing building, building system or portion thereof shall conform to this Code as those provisions relate to new construction without requiring the unaltered portion of the existing building or building system to

R503.1 General: Alterations to any building or structure shall comply with the requirements of the code for new construction. Alterations shall be such that the existing building or structure is no less conforming to the provisions of this code than the existing building or structure was prior to the alteration. Exception: The following alterations need not comply with the requirements for new construction provided the energy use of the

- building is not increased: Storm windows installed over existing fenestration
- Existing ceiling, wall or floor cavities exposed during construction provided that these cavities are filled with insulation Construction where the existing roof, wall or floor cavity is not exposed.
- Roof recover Roofs without insulation in the cavity and where the sheathing or insulation is exposed during re roofing shall be insulated
- either above or below the ceiling. Surface-applied window film installed on existing single pane fenestration assemblies to reduce solar heat gain provided the

code does not require the glazing or fenestration assembly to be replaced.

305.7 Alterations Affecting an Area Containing a Primary Function

Where an alteration affects the accessibility to, or contains an area of primary function, the route to the primary function area shall be accessible. The accessible route to the primary function area shall include toilet facilities and drinking fountains serving the area of primary function.

- The costs of providing the accessible route are not required to exceed 20 percent of the costs of the alterations affecting the area of primary function. This provision does not apply to alterations limited solely to windows, hardware, operating controls, electrical outlets and signs.
- 3. This provision does not apply to alterations limited solely to mechanical systems, electrical systems, installation or alteration of fire protection systems and This provision does not apply to alterations undertaken for the primary purpose of increasing the accessibility of a facility.

5. This provision does not apply to altered areas limited to Type B dwelling and sleeping units.

ADA PATH OF TRAVEL IMPROVEMENTS, 20% DISPROPORTIONATE COSTS

SCOPE OF WORK: REPLACE THE EXISTING STRUCTURAL APPARATUS FLOOR AND EXTERIOR IMPROVEMENTS

REPLACEMENT OF APPARATUS STRUCTURE FLOOR SYSTEM BUDGET:

TOTAL: 561,500 BUDGET FOR IMPROVEMENTS

20% OF 561,500 = \$112,300, MAX FOR ADA IMPROVMENTS AS PER CODE

LIST OF ADA IMPROVEMENTS FOR EXISTING BUILDING:

- INTERIOR ACCESSIBLE PORTABLE RAMP: \$10,000
- EXTERIOR ACCESSIBLE PERMANTENT RAMP TO ENTRANCE OF BUILDING AND WALKWAY: \$30,000 • EXISTING INTERIOR BATH ROOM CONVERSION TO COMPLIANT BATH ROOMS: \$75,000

TOTAL OF COSTS PROPOSED: \$115,000.00

NYS SPECIAL INSPECTIONS

SPECIAL INSPECTIONS AND PROGRESS INSPECTIONS IN ACCORDANCE WITH SECTION

THE CONTRACTOR MUST NOTIFY THE ARCHITECT OR ENGINEER FOR SPECIAL INSPECTIONS AND PROGRESS INSPECTIONS AT LEAST 72 HOURS BEFORE THE

IBC 1701 AND THE APPLICABLE SECTIONS OF THE BUILDING CODE ARE LISTED IN THE FOLLOWING TABLES:

SPECIFIC WORK COMMENCES

THE "AUTHORITY" SHALL BE RESPONSIBLE FOR THE FOLLOWING SPECIAL INSPECTIONS AND PROGRESS INSPECTIONS

REQUIRED INSPECTIONS AND TESTS OF MATERIALS DESIGNATED FOR "SPECIAL INSPECTIONS AND PROGRESS INSPECTIONS" BY THE CONTRACTOR SHALL BE MADE UNDER THE DIRECT SUPERVISION OF A LICENSED ARCHITECT OR ENGINEER RETAINED BY OR ON THE BEHALF OF THE CONTRACTOR WHO SHALL BE ACCEPTABLE TO THE ARCHITECT OR ENGINEER WHO SUPERVISED THE PREPARATION OF

1703.2 WRITTEN APPROVAL: ANY MATERIAL. APPLIANCE. EQUIPMENT. SYSTEM OR METHOD OF CONSTRUCTION MEETING THE REQUIREMENTS OF THIS CODE SHALL BE APPROVED IN WRITING AFTER SATISFACTORY COMPLETION OF THE REQUIRED TESTS AND SUBMISSION OF REQUIRED TEST REPORTS.

1704.2.4 REPORT REQUIREMENT. APPROVED AGENCIES SHALL KEEP RECORDS OF SPECIAL INSPECTIONS AND TESTS. THE APPROVED AGENCY SHALL SUBMIT REPORTS OF SPECIAL INSPECTIONS AND TESTS TO THE BUILDING OFFICIAL AND TO THE REGISTERED DESIGN PROFESSIONAL IN RESPONSIBLE CHARGE.

1704.3.1 CONTENT OF STATEMENT OF SPECIAL INSPECTIONS

ITEM SECTION SPECIAL INSPECTION ITEMS TYPE

- THE MATERIALS, SYSTEMS, COMPONENTS AND WORK REQUIRED TO HAVE SPECIAL INSPETIONS OR TESTS BY THE BUILDING OFFICIAL OR BY THE REGISTERED DESIGN PROFESSIONAL RESPONSIBLE FOR EACH PORTION OF THE WORK
- THE TYPE AND EXTENT OF EACH SPECIAL INSPECTION THE TYPE OF EXTENT OF EACH TEST ADDITIONAL REQUIREMENTS FOR SPECIAL INSPECTIONS OR TESTS FOR SEISMIC OR WIND RESISTANCE AS SPECIFIED IN SECTIONS
- FOR EACH TYPE OF SPECIAL INSPECTION, IDENTIFICATION AS TO WHETHER IT WILL BE CONTINUOUS SPECIAL INSPECTION,
- PERIODIC SPECIAL INSPECTION OR PERFORMED IN ACCORDANCE WITH THE NOTATION USED IN THE REFERENCED STANDARD WHERE THE INSPECTIONS ARE DEFINED

CONTINOUS/PERIODIC

REQUIRED

DRAWING INDEX

3. S-104 FIRST FLOOR FLOOR PLAN

9. S-404 ACCESSIBLE TYPICAL DETAILS

1. S-001 GENERAL NOTES AND SPECIFICATIONS

4. S-105 FIRST FLOOR RESTROOM REFLECTED CEILING PLAN

RAMP PLAN, SECTIONS AND ELEVATIONS

8. S-403 EQUIPMENT LIST ACCESSIBLE TYPICAL DETAILS

7. S-402 ACCESSIBLE TOILET ROOM ELEVATIONS AND DETAILS

6. S-401 ENLARGED PART FLOOR PLANS, ENLARGED ACCESSIBLE

10. S-502 FIRST FLOOR LIGHTING AND POWER FLOOR PLAN AND DOOR

ENGINEERING DRAWINGS

2. S-002 PLOT PLAN

5. S-301 DETAILS

SCHEDULE

MECHANICAL DRAWINGS

SUBMITTED SEPARATELY

REGULATIONS

I I LIVI	SECTION	SPECIAL INSPECTION TIEMS	111 =	CONTINOUS/FERIODIC	REGULATIONS	REQUIRED
1	BC 1704.6	STRUCTURAL OBERVATIONS	SEISMIC	PERIODIC	CATIGORY: ? < 75' HT.	N/A
2	BC 1704.6	STRUCTURAL OBERVATIONS	WIND	PERIODIC	CATIGORY: ? < 75' HT.	N/A
3	BC 1705.2.1	STRUCTURAL STEEL	FABRICATION	PERIODIC	AISC 360	N/A
4	BC 1705.2.2	COLD-FORMED STEEL DECK	WELDING	PERIODIC	SDI QA/QC	N/A
5	BC 1705.3	CONCRETE CONSTRUCTION	3. ANCHORS CAST 4. ANCHORS POST	PERIODIC PERIODIC PERIODIC N/A PERIODIC CONTIONOUS PERIODIC	ACI 318 CH 20, 25.2 AWS D1.4 ACI 318 ACI 318 7.8.2 N/A ACI 318 CH 19 26.4.3 ASTM C172, C31, ACI 318 ACI 318 26.11.1.2B	YES YES YES N/A YES YES YES
6	BC 1705.3.1	WELDING OF RE-BARS	WELDING	PERIODIC	AWS D1.4	YES
7	BC 1705.6	SOILS	ENGINEERS SPECIFICATIONS	VERIFICATION	SHOWN ON DWGS	YES
8	BC 1705.14	SPRAYED FIRE-RESISTANT MATERIALS	MEASUREMENTS AT NINE LOCATIONS AROUND THE BEAM OR GIRDER AT EACH END OF A 12" LENGTH	TEST IN FIELD BOND STRENGTH DENSITY THICKNESS	AS PER SECTION 1705	YES
9	BC 1705.17	FIRE-RESITANT PENETRATIONS AND JOINTS	PENETRATION FIRESTOPS	FIRESTOP SYSTEMS	ASTM E2174	YES

AN INDEPENDENT THIRD PARTY SPECIAL INSPECTION COMPANY REQUIRED TO BE RETAINED BY GENERAL CONTRACTOR. REPORTS OF INSPECTION TO BE FURNISHED TIMELY TO ENGINEER AND COPIES ARE TO BE PROVIDED TO DEPARTMENT OF BUILDINGS

BUILDING CODE SCHEDULE:

THE 2020 BUILDING CODE OF NEW YORK STATE, THE 2020 EXISTING BUILDING CODE OF NYS FOR EXISTING BUILDING LOCATED AT: CHESTER HIGHTS FIRE STATION EASTCHESTER, NEW YORK

PROPERTY DATA: LOT SIZE: 7,541 S.F. (0.17 ACRES)

SCOPE OF WORK: TO REMOVE THE EXISTING APPARATUS FIRST FLOOR SLAB AND STRUCTURAL SUPPORTS AND REPLACE WITH NEW STRUCTURE AND

BUILDING STRUCTURE TYPE: CELLAR AND FIRST FLOOR: STEEL, CONCRETE

SECOND FLOOR WOOD FRAME BUILDING CODE SUMMARY THE 2020 BUILDING CODE OF NEW YORK STATE,

THE 2020 EXISTING BUILDING CODE OF NYS

FLOOR SYSTEM AT SAME LOCATION

AND ALL UNIFORM CODE SUPPLEMENTS

NYS INTERNATIONAL EXISTING BUILDING CODE 2021 **ALTERATION-LEVEL 1** ALTERATIONS INCLUDE THE REMOVAL AND REPLACEMENT OR THE COVERING OF EXISTING MATERIAL, ELEMENTS, EQUIPMENT,

OR FIXTURES USING NEW MATERIALS, ELEMENTS, EQUIPMENT, OR FIXTURES THAT SERVE THE SAME PURPOSE.

PROPOSED: TO REMOVE AND REPLACE INTERIOR FLOOR SYSTEM THE 2020 BUILDING CODE OF NEW YORK STATE CHAPTER 3

USE AND OCCUPANCY CLASSIFICATION 303.1 GROUP S-1 EXISTING STORAGE OF VEHICLES GROUP B-2 EXISTING OPERATIONAL AND ADMINISTRATIVE AREAS

GROUP R-2 EXISTING SLEEPING FACILITIES (DORM ROOMS) PROPOSED: REPLACEMENT OF APPARATUS STORAGE AREA

• 311.2 MODERATE-HAZARD STORAGE, GROUP S-1

CHAPTER 6 TYPES OF CONSTRUCTION 601 TABLE: FIRE-RESISTANCE RATING REQUIREMENTS FOR

ROOF CONSTRUCTION: 1 HR.

BUILDING ELEMENTS (HOURS) PROPOSED TYPE TYPE I B

 REGULATION: PRIMARY STRUCTURE 2 HR REGULATION: BEARING WALLS EXTERIOR: 2 HR; INTERIOR: 2 HR.

NONBEARING WALLS AND PARTITIONS EXTERIOR: 0 HR. (SEE TABLE 602) 0HR. NONBEARING WALLS AND PARTITIONS INTERIOR: 0 HR. FLOOR CONSTRUCTION: 2 HR.

PROPOSED BUILDING: AS REQUIRED

CHAPTER 9 FIRE PROTECTION SYSTEMS 903.2.9. GROUP S-1

 FIRE AREA USED FOR THE STORAGE OF COMMERCIAL MOTOR VEHICLES WHERE THE FIRE AREA EXCEEDS 5,000 S.F.

PROPOSED REPAIR OF STRUCTURAL APPARATUS FLOOR AREA: 2327 S.F. AUTOMATIC SPRINKLER SYSTEM IS NOT REQUIRED

CHAPTER 10 MEANS OF EGRESS NO CHANGE

CONSTRUCTION MANAGEMENT 403 Main Street, Suite 871 Armonk, New York 10504 TEL: (212) 586-5192 FAX: (914) 470-1133 E-MAIL: JPATERNO@UESPC.COM

UNIVERSAL ENGINEERING

SERVICES, P.C.

ENGINEERING

GREEN DESIGN

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BID REVIEW ADA 10/19/21 IMPROVEMENTS 05/03/21 BLDG. DEPT. REVIEW BLDG. DEPT. REVIEW 06/02/20 **BID DOCUMENTS** 05/08/20 03/30/20 BID DOCUMENT REVIEW CLIENT REVIEW 12/20/19 **ISSUED FOR** DATE REVISIONS

KEY PLAN: R-20

RESTROOM ADA IMPROVEMENTS AND MECHANICAL SYSTEMS

PROJECT LOCATION:

SHEET TITLE:

SEAL.:

SCOPE OF WORK:

CHESTER HEIGHTS EASTCHESTER FIRE STATION EASTCHESTER, N.Y. SECTION: 80.J BLOCK: 03 LOT: 19 ZONE: R-20

> **GENERAL NOTES AND SPECIFICATIONS**


PROJECT #: 18-040418 AS NOTED DATE: 10/19/21

DRAWN BY: JOSEPH PATERNO, LEED AP REVIEWED BY: MICHAEL GIANATASIO, P.E

S-001

SHEET NO.:

SHEET: 1 OF 10

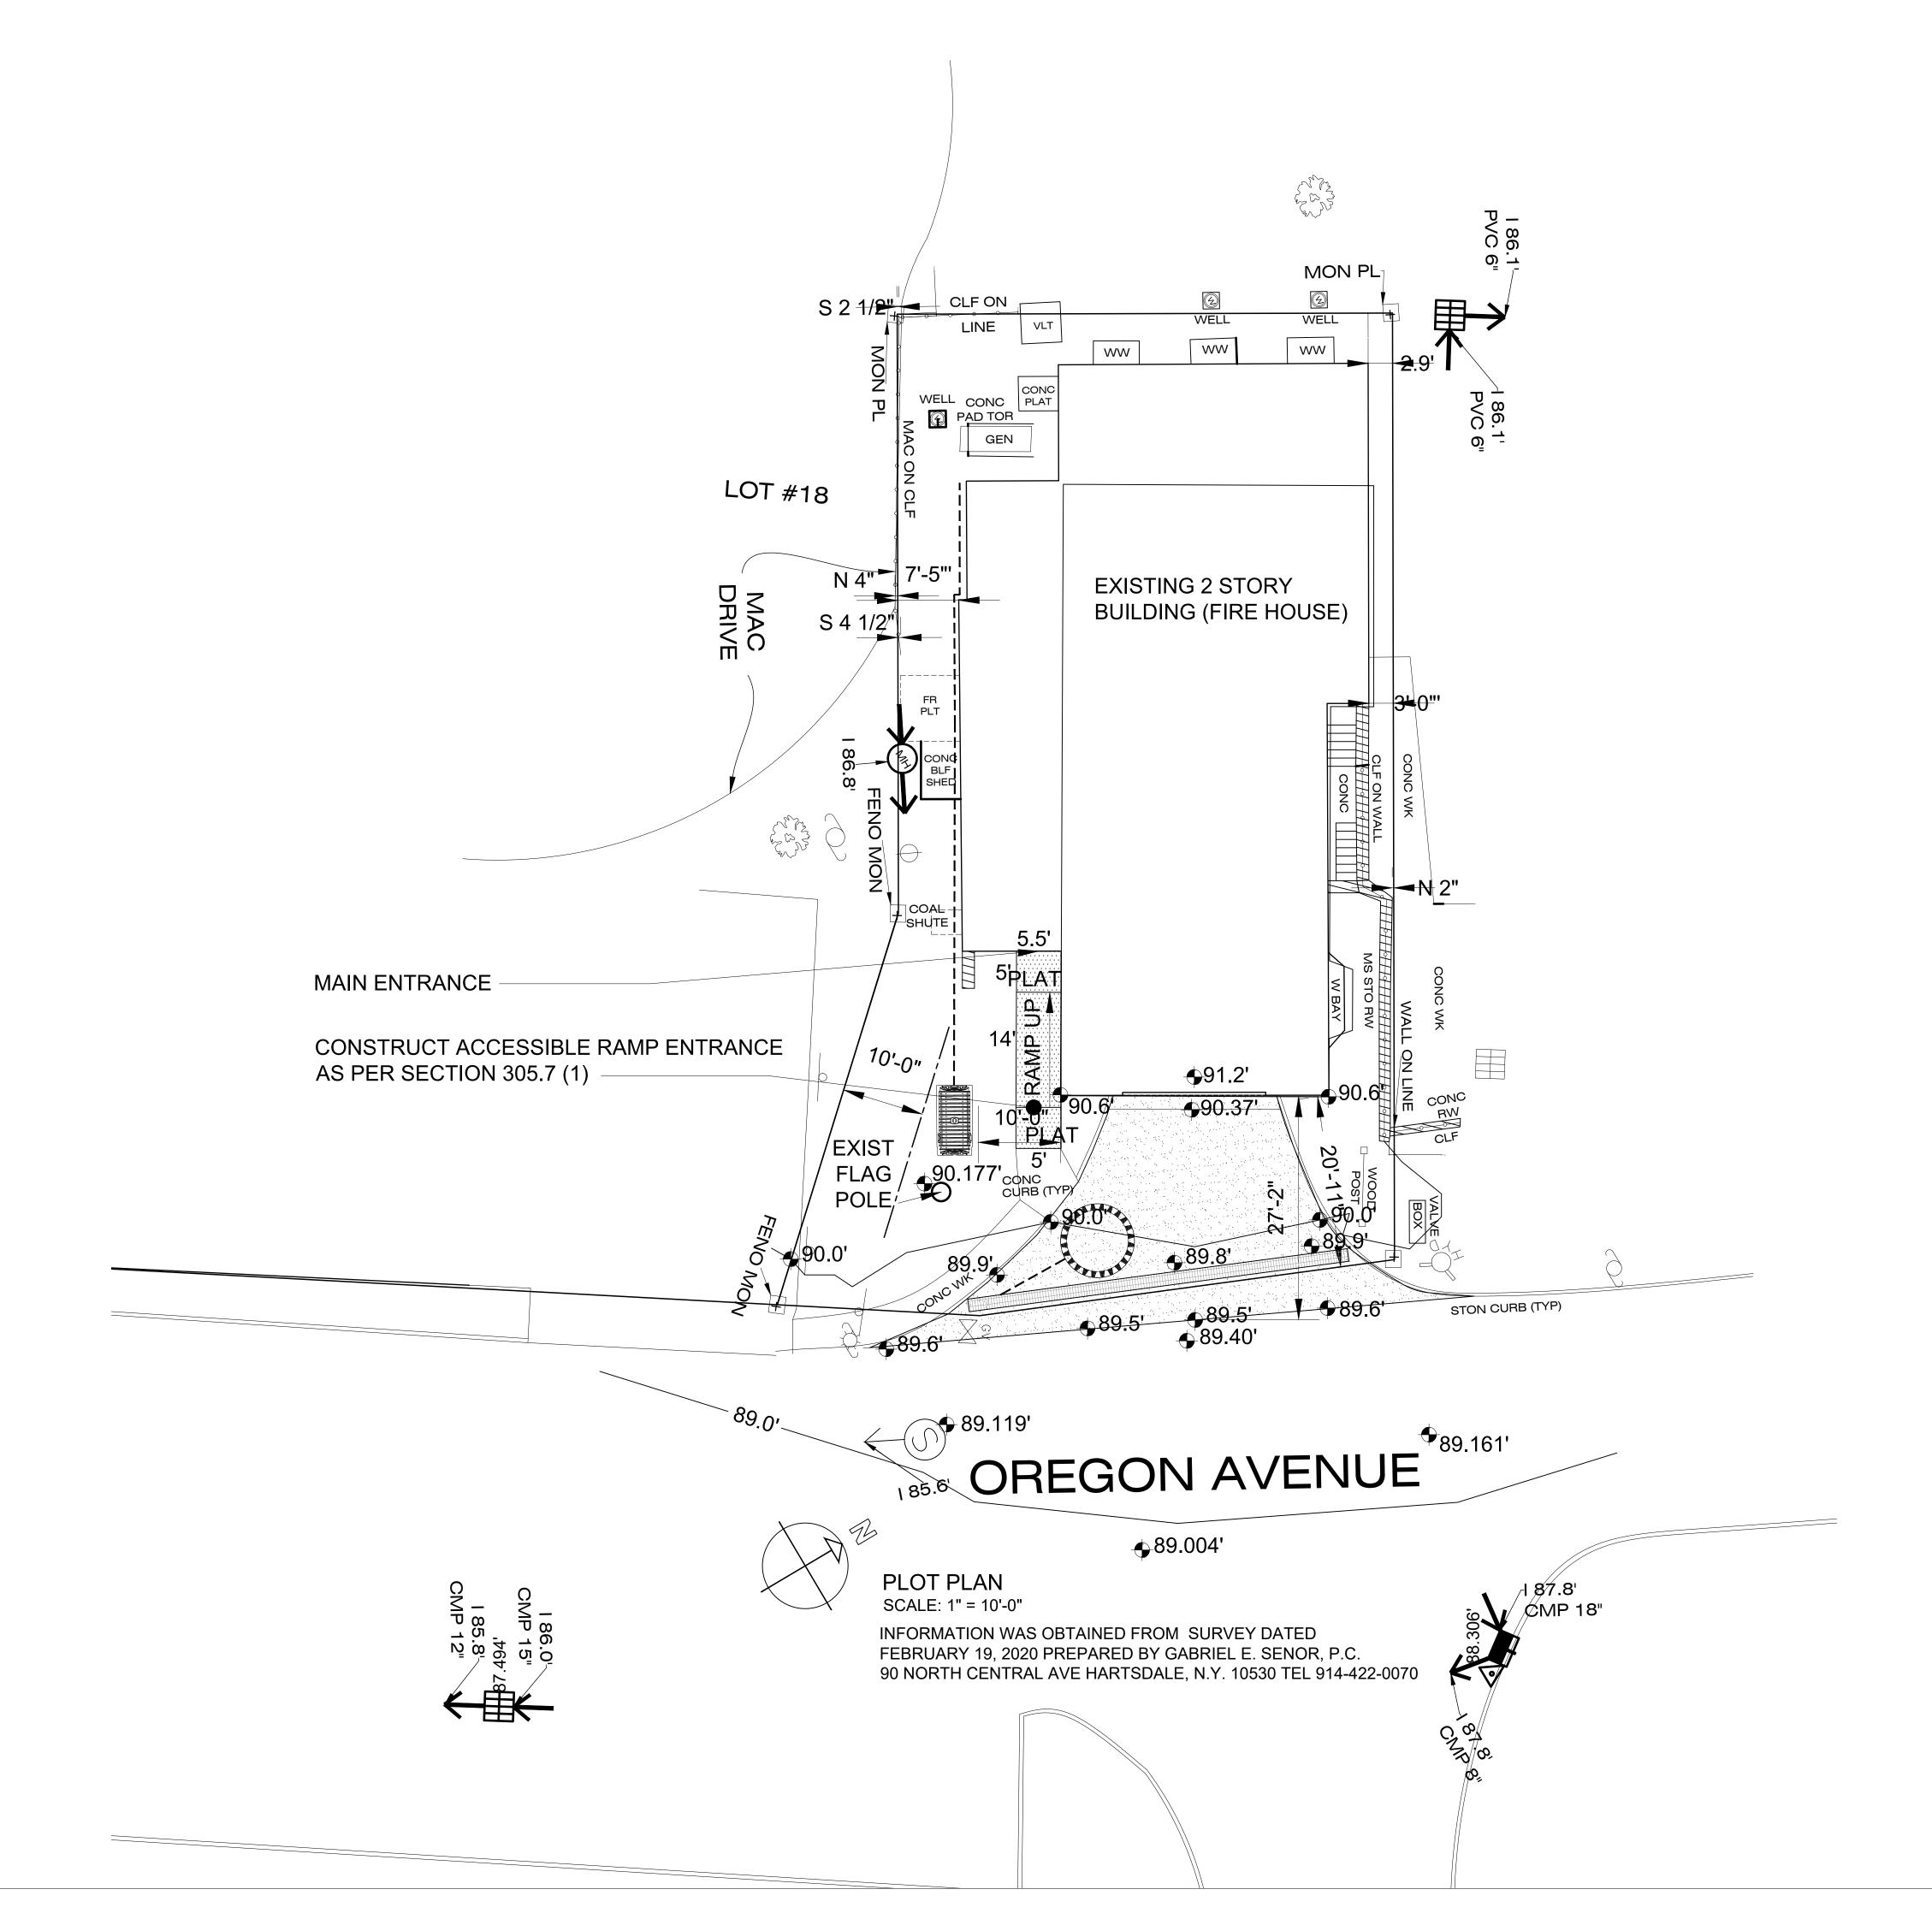

UNIVERSAL ENGINEERING SERVICES, P.C.

> **ENGINEERING GREEN DESIGN** CONSTRUCTION MANAGEMENT 403 Main Street, Suite 871 Armonk, New York 10504 TEL: (212) 586-5192 FAX: (914) 470-1133 E-MAIL: JPATERNO@UESPC.COM

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6	BID REVIEW ADA IMPROVEMENTS	10/19/21	
5	BLDG. DEPT. REVIEW	05/03/21	
4	BLDG. DEPT. REVIEW	06/02/20	
3	BID DOCUMENTS	05/08/20	
2	BID DOCUMENT REVIEW	03/30/20	
1	CLIENT REVIEW	12/20/19	
NO.	ISSUED FOR	DATE	
REVISIONS			

KEY PLAN:

SCOPE OF WORK:

RESTROOM ADA IMPROVEMENTS AND MECHANICAL SYSTEMS

PROJECT LOCATION:

CHESTER HEIGHTS EASTCHESTER FIRE STATION EASTCHESTER, N.Y.
SECTION: 80.J
BLOCK: 03 LOT: 19 ZONE: R-20

SHEET TITLE:


PLOT PLAN AND SITE DETAILS

	PROJECT #:	18-040418
	SCALE:	AS NOTED
	DATE:	10/19/21
	DRAWN BY:	JOSEPH PATERNO, LEED A
	REVIEWED BY	: MICHAEL GIANATASIO, P.I

SEAL.: SHEET NO.:

S-002

SHEET: 2 OF 10

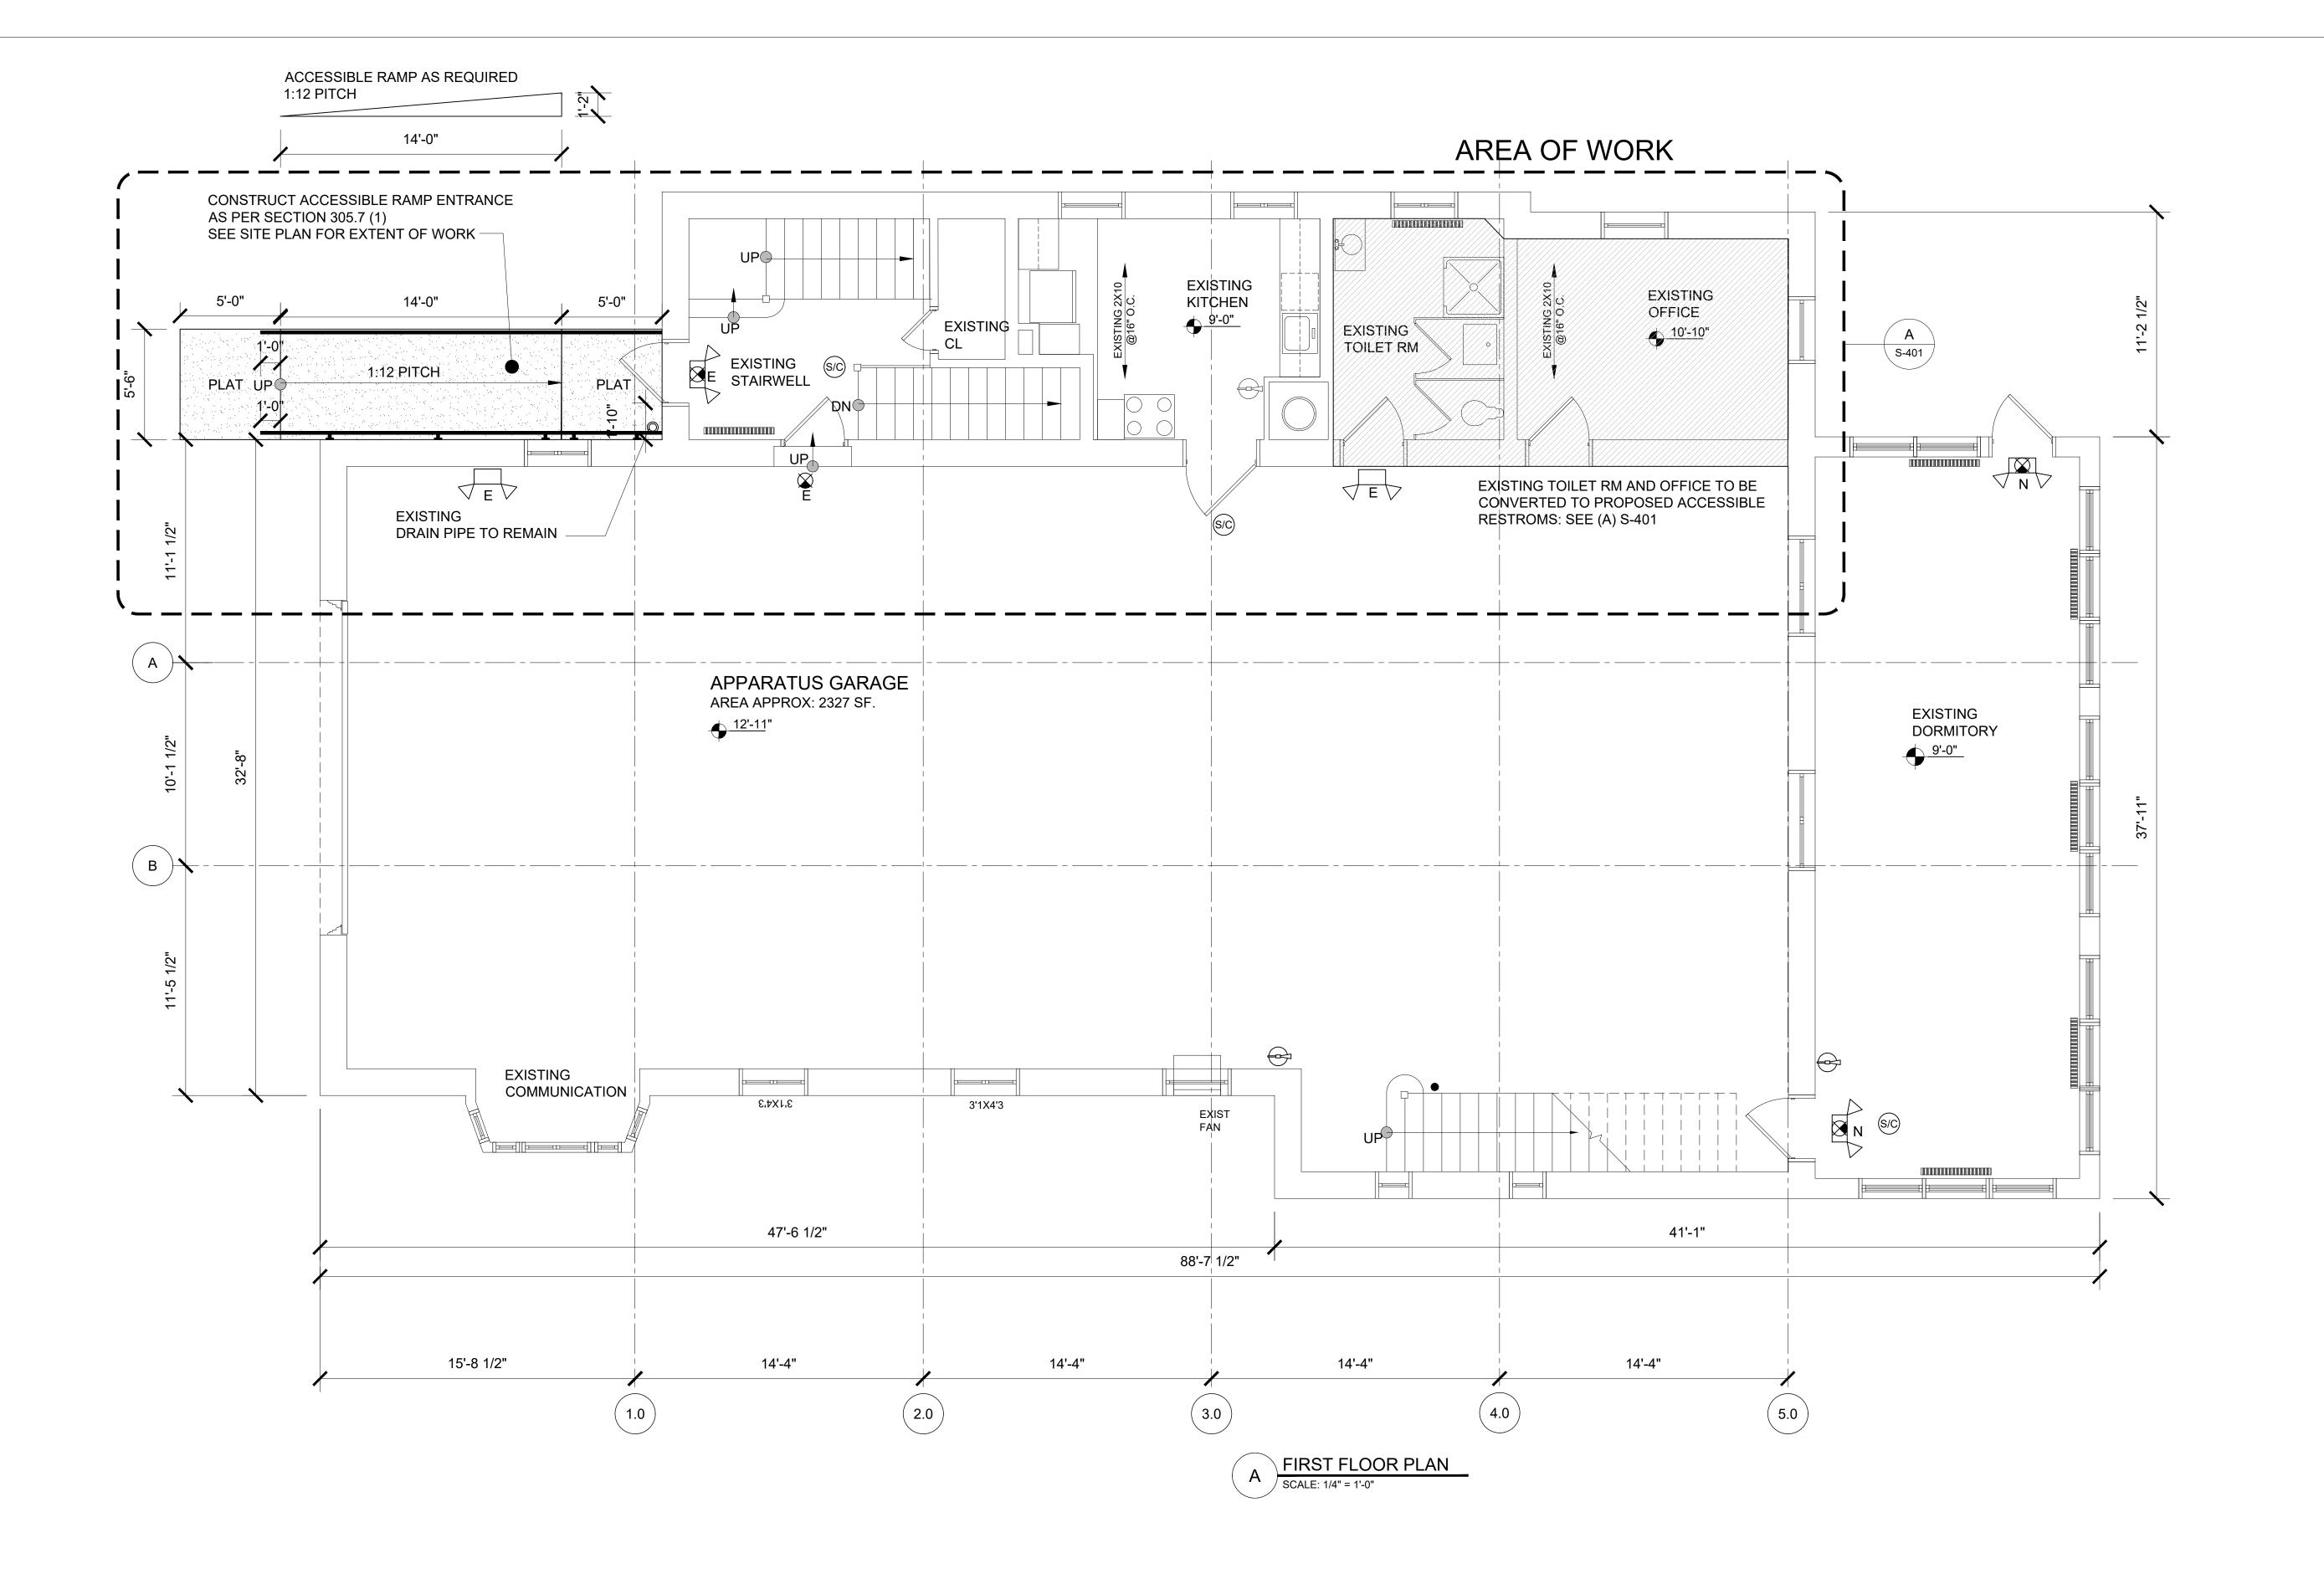

UNIVERSAL ENGINEERING SERVICES, P.C.


ENGINEERING GREEN DESIGN CONSTRUCTION MANAGEMENT 403 Main Street, Suite 871 Armonk, New York 10504 TEL: (212) 586-5192 FAX: (914) 470-1133 E-MAIL: JPATERNO@UESPC.COM

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1	CLIENT REVIEW	12/20/1		
NO.	ISSUED FOR	DATE		
REVISIONS				

KEY PLAN:



SCOPE OF WORK:

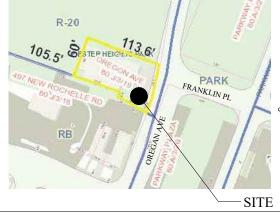RESTROOM ADA IMPROVEMENTS AND MECHANICAL SYSTEMS

PROJECT LOCATION:

CHESTER HEIGHTS EASTCHESTER FIRE STATION EASTCHESTER, N.Y. SECTION: 80.J BLOCK: 03 LOT: 19

SHEET TITLE:

FIRST FLOOR PLAN


ZONE: R-20

PROJECT #: 18-040418 AS NOTED 10/19/21 DRAWN BY: JOSEPH PATERNO, LEED AP REVIEWED BY: MICHAEL GIANATASIO, P.E. SHEET NO.:

SEAL.:

S-104

SHEET: 3 OF 10

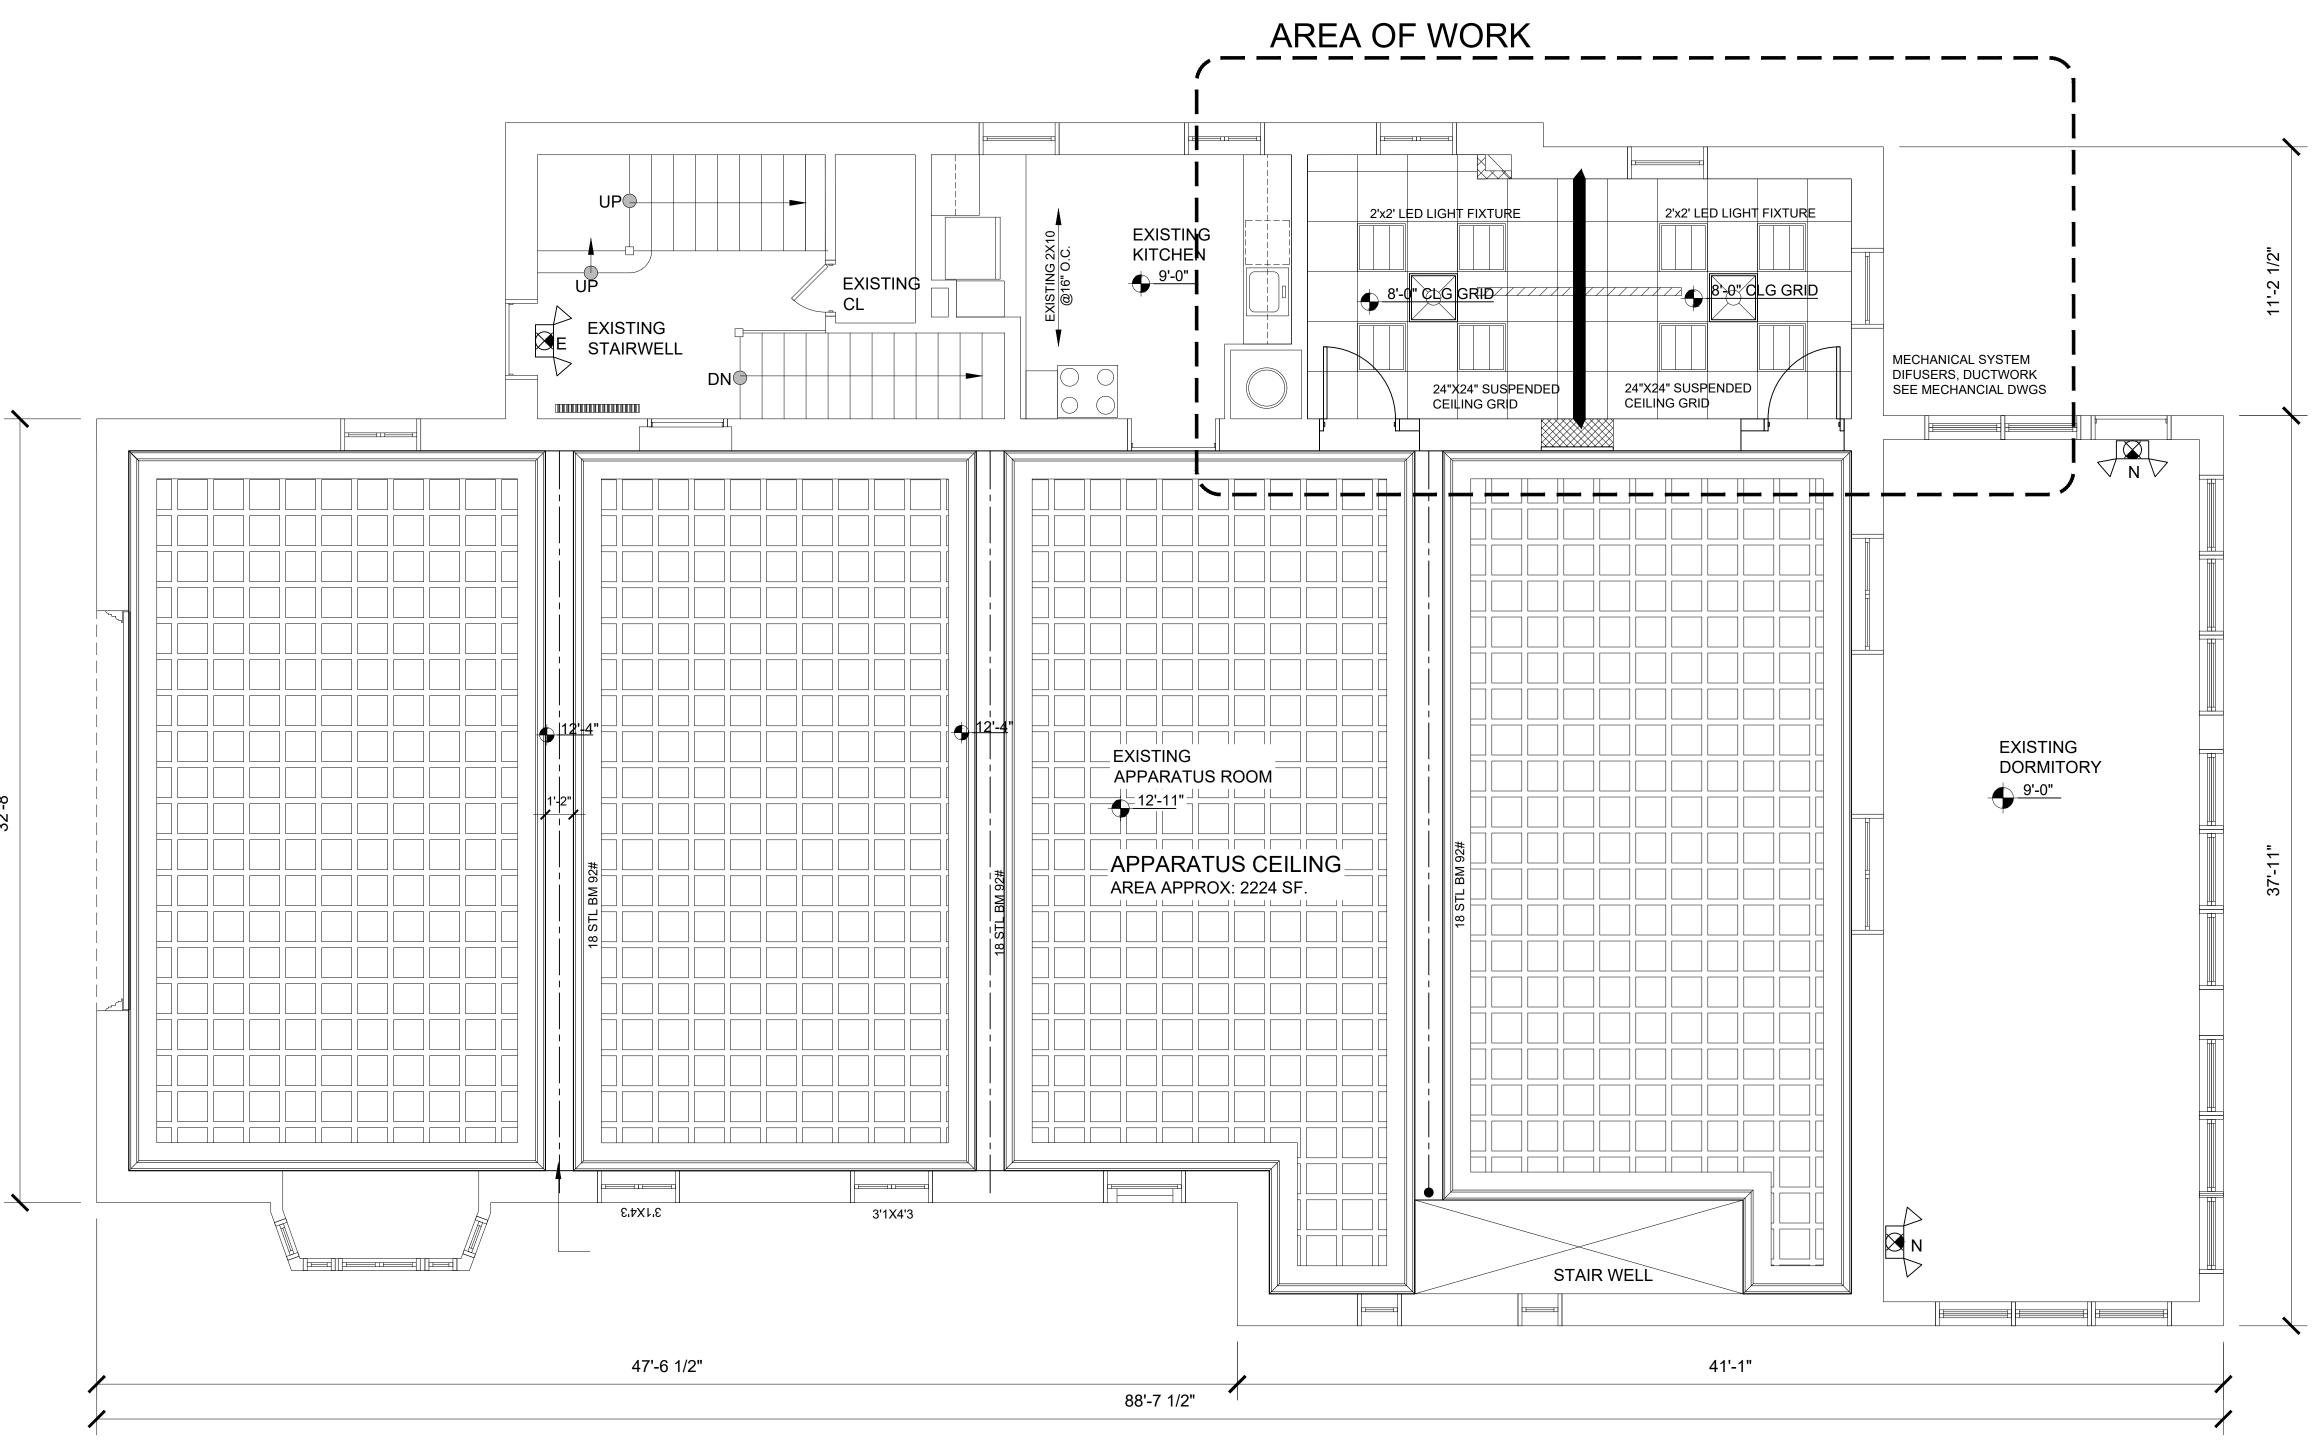


FIRST FLOOR REFLECTING CEILING PLAN

UNIVERSAL ENGINEERING SERVICES, P.C.

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IO.	ISSUED FOR	DATE
	REVISIONS	



SCOPE OF WORK:

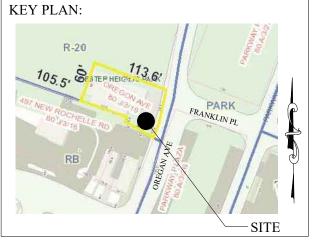RESTROOM ADA IMPROVEMENTS AND MECHANICAL SYSTEMS

PROJECT LOCATION:

CHESTER HEIGHTS EASTCHESTER FIRE STATION EASTCHESTER, N.Y. SECTION: 80.J BLOCK: 03 LOT: 19 ZONE: R-20

SHEET TITLE:


FIRST FLOOR RESTROOM REFLECTED CEILING PLAN


SCALE:	AS NO	ГЕО
DATE:	10/19/2	I
DRAWN BY:	JOSEPI	H PATERNO, LEED A
REVIEWED BY	: MICHA	AEL GIANATASIO, P
SEAL.:		SHEET NO.:

PROJECT #: 18-040418

S-105


SHEET: 4 OF 10

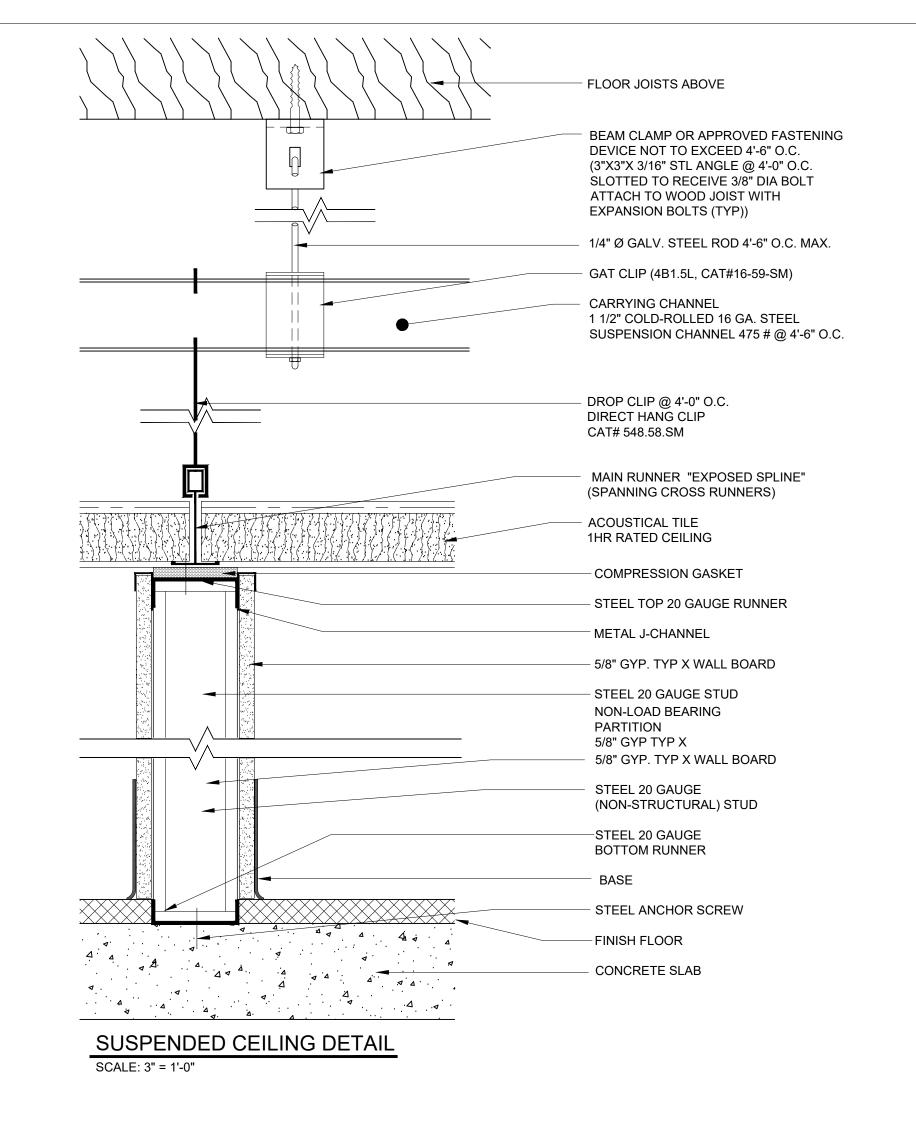


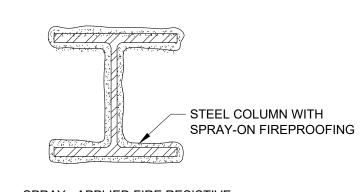


SPRAY - APPLIED FIRE RESISTIVE MATERIALS - DESIGN NO. X772



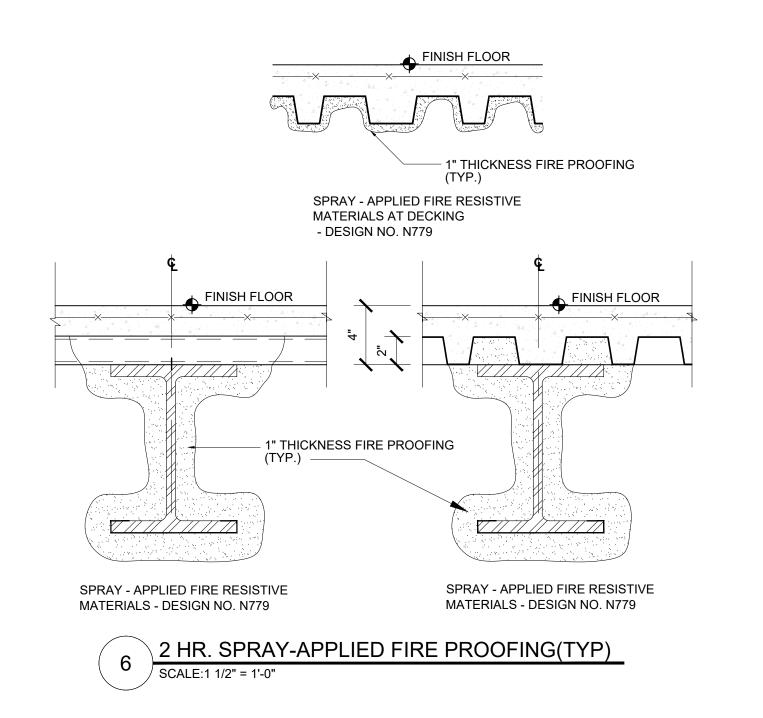

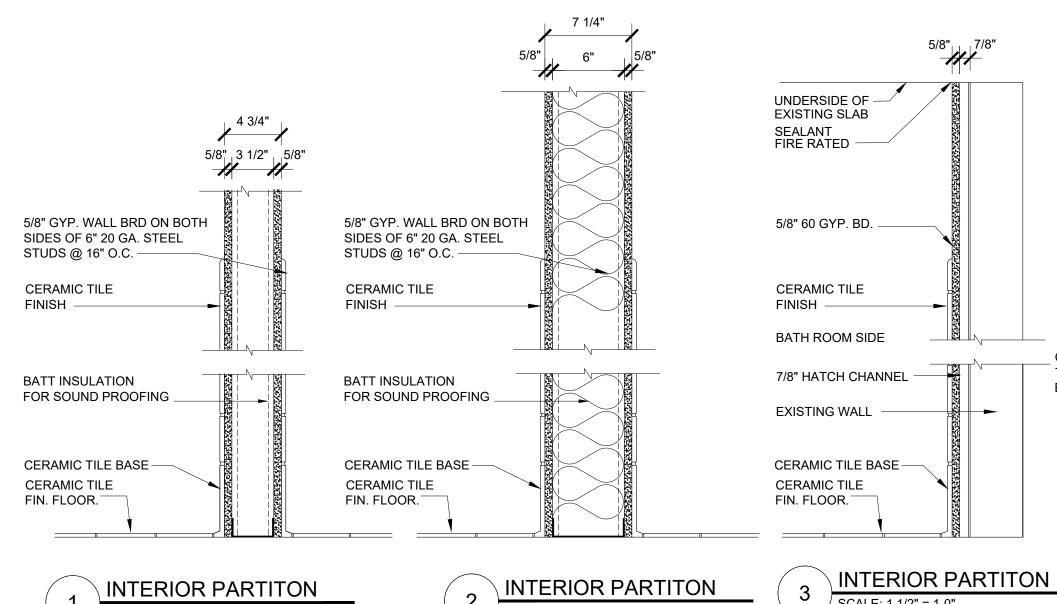

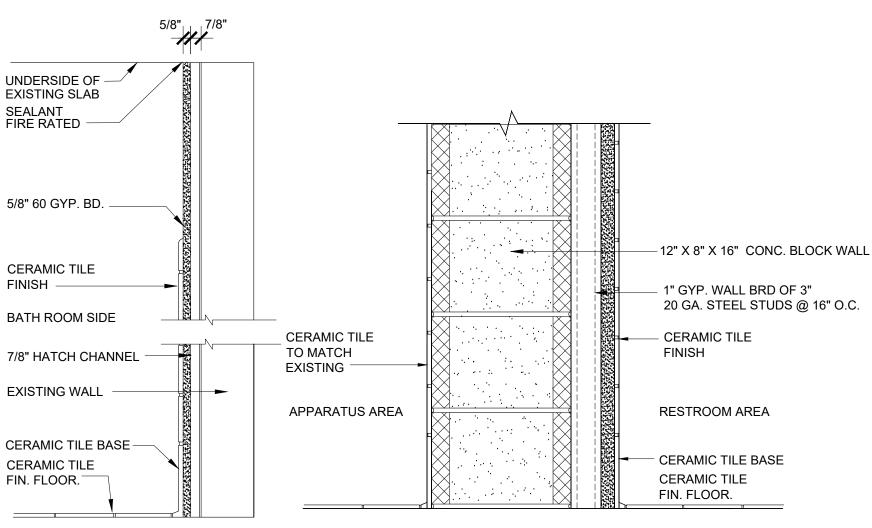

INTERIOR PARTITON

UNIVERSAL ENGINEERING SERVICES, P.C.

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1	CLIENT REVIEW	12/20/19	
VO.	ISSUED FOR	DATE	
REVISIONS			

KEY PLAN:
R-20
105.5, Sester HEIGHWE 2.6
AST NEW ROCHELLE RO
RB PART OF THE PAR
BB SAN ANE SAN
SITE

SCOPE OF WORK:

RESTROOM ADA IMPROVEMENTS AND MECHANICAL SYSTEMS

PROJECT LOCATION: CHESTER HEIGHTS EASTCHESTER FIRE STATION EASTCHESTER, N.Y. SECTION: 80.J BLOCK: 03 LOT: 19 ZONE: R-20

SHEET TITLE:


DETAILS


PROJECT #: 18-040418 AS NOTED DATE: 10/19/21 DRAWN BY: JOSEPH PATERNO, LEED AP

REVIEWED BY: MICHAEL GIANATASIO, P.E SEAL.: SHEET NO.:

S-301

SHEET: 5 OF 10

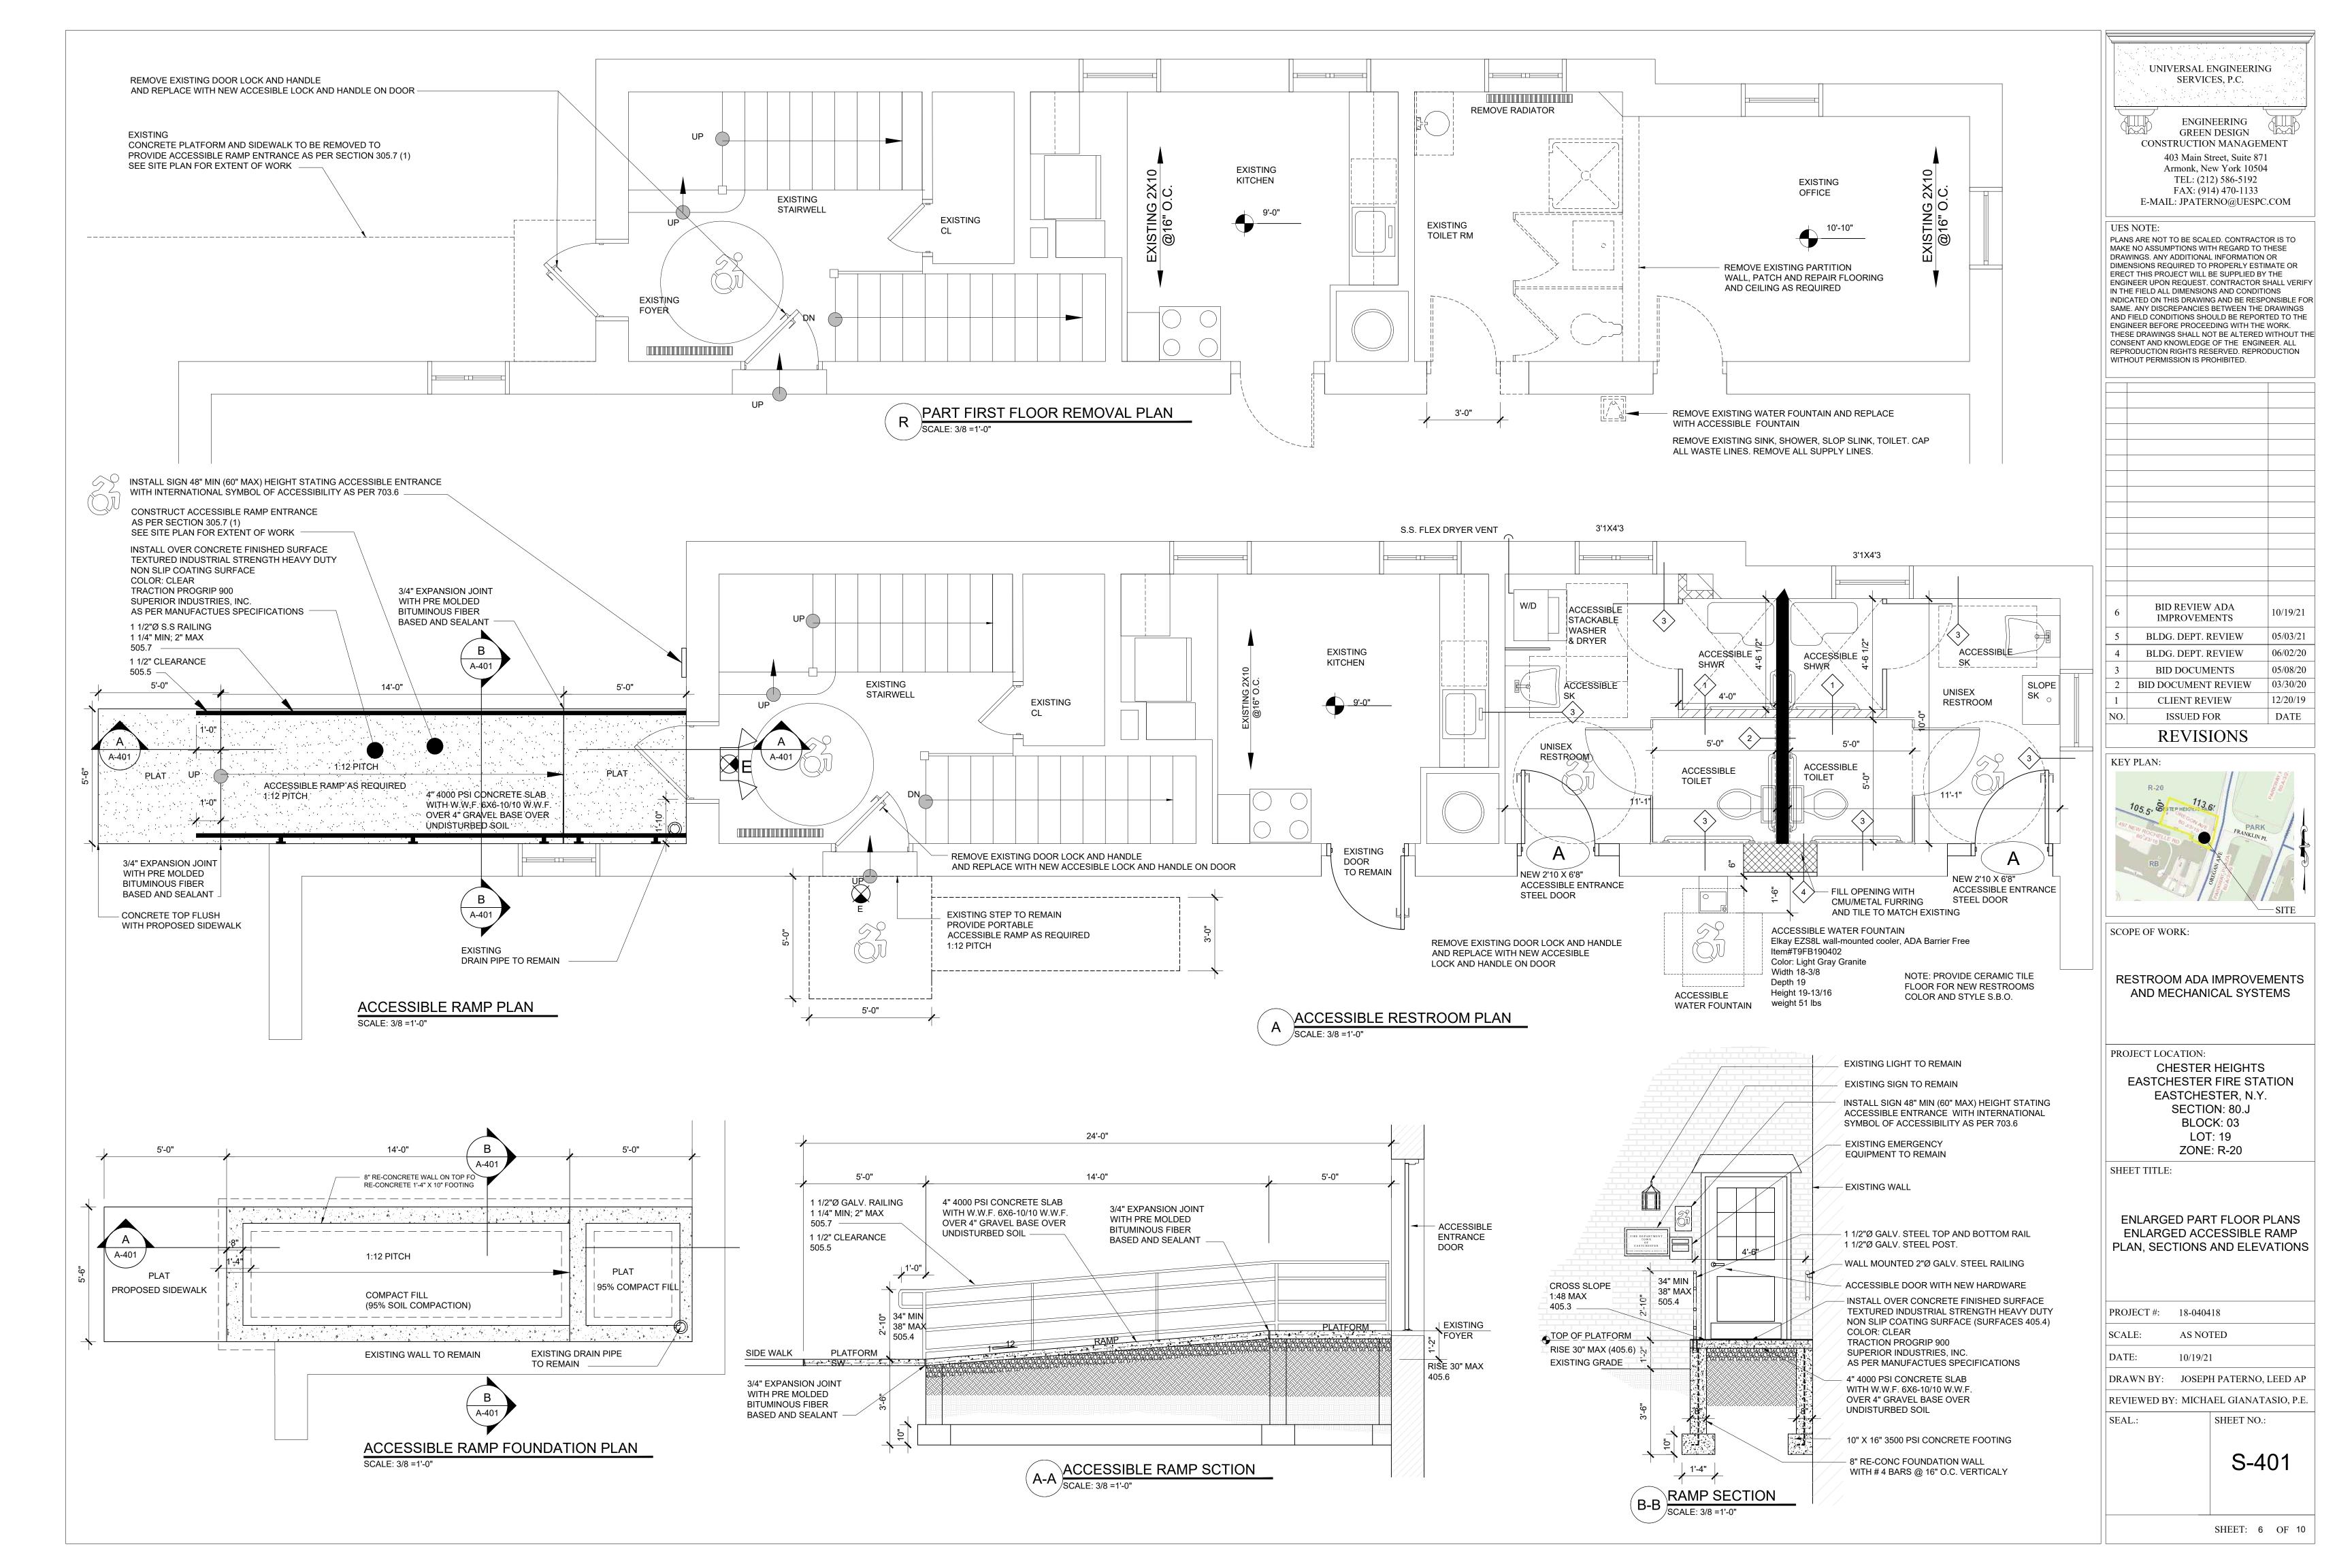

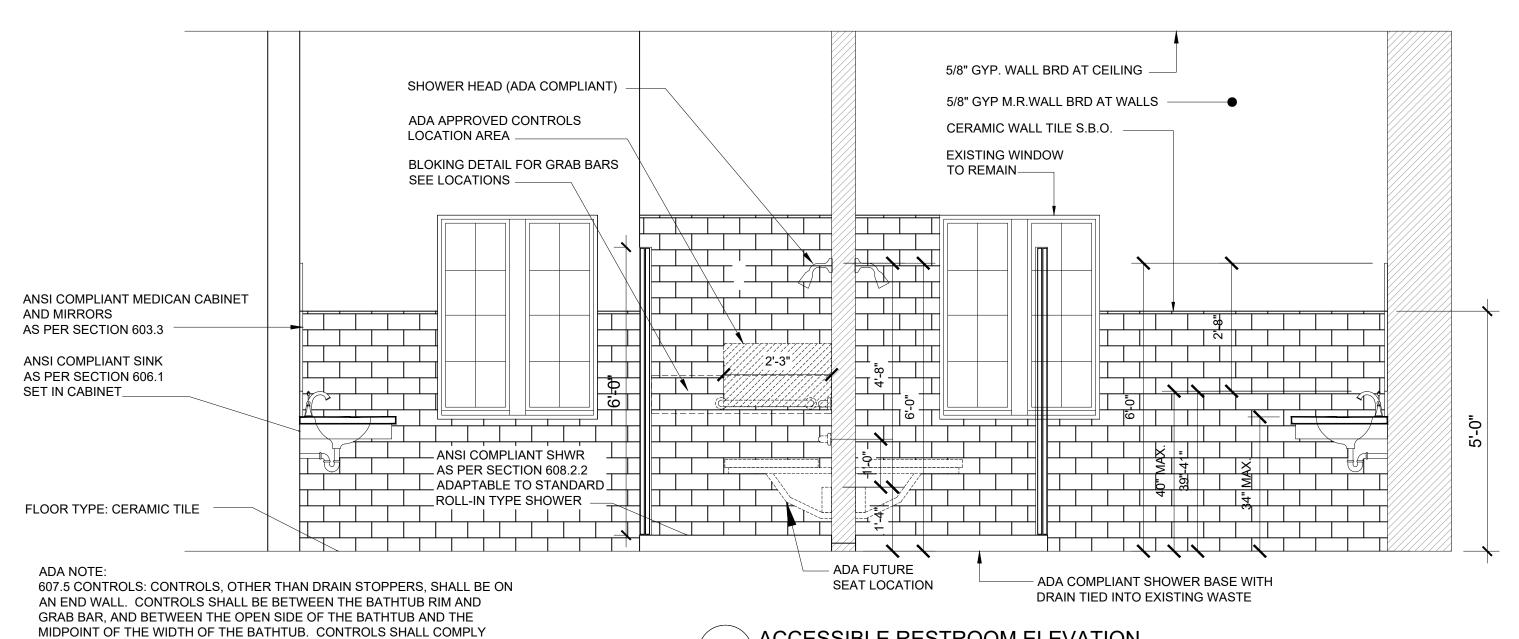

ACCESSIBLE RESTROOM ELEVATION

TOILET PARTITION 5/8" GYP. WALL BRD AT CEILING -GYP M.R.WALL BRD 5/8" GYP M.R.WALL BRD AT WALLS INSTALL AS PER DIMENSIONS CERAMIC WALL TILE S.B.O. SHOWN ON OTHER TOILET LOCATION TOILET PARTITION -BLOKING DETAIL FOR GRAB BARS SEE LOCATIONS 4'-6" ANSI COMPLIANT GRAB BARS AS PER SECTION: 604.5— 3'-6" TOILET PAPER HOLDER (ADA COMPLIANT) _ ANSI COMPLIANT TOILET AS PER SECTION 604.1 NEW 2'-10"x 6'-8" S.C. DOOR WITH ANSI HARDWARE ANSI COMPLIANT DOOR WIDTH 32" MINIMUM CLEAR AS PER SECTION 404.2.2 MARBLE SADDLE ADA COMPLIANT THRESHOLD AT DOORWAYS: 1/2" MAX HEIGHT AS PER SECTION 404.2.4 -FLOOR TYPE: CERAMIC TILE


WITH SECTION 309.4

BE 5 POUNDS (22.2 N) MAXIMUM.


309.4 OPERATION: OPERABLE PARTS SHALL BE OPERABLE WITH ONE HAND

AND SHALL NOT REQUIRE TIGHT GRASPING, PINCHING, OR TWISTING OF THE WRIST. THE FORCE REQUIRED TO ACTIVATE OPERABLE PARTS SHALL

ACCESSIBLE RESTROOM ELEVATION

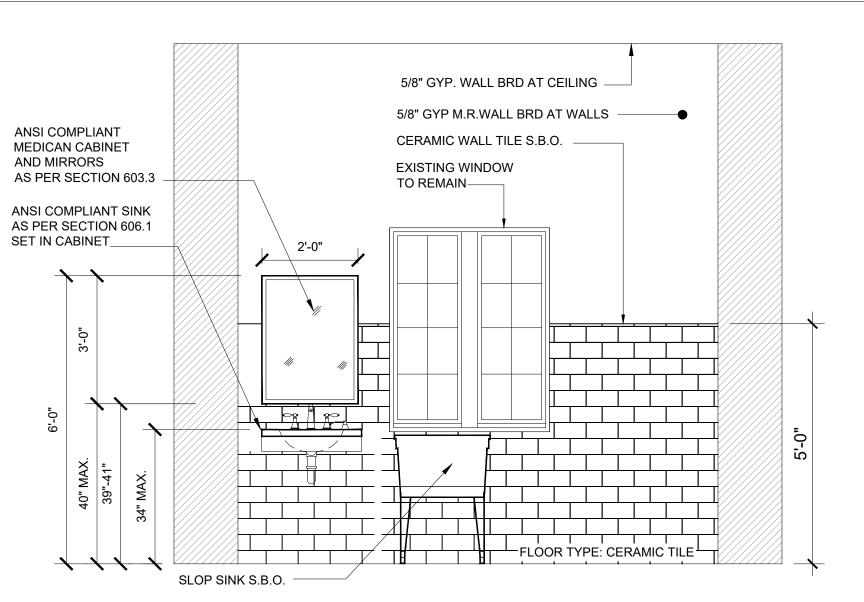

ACCESSIBLE RESTROOM ELEVATION

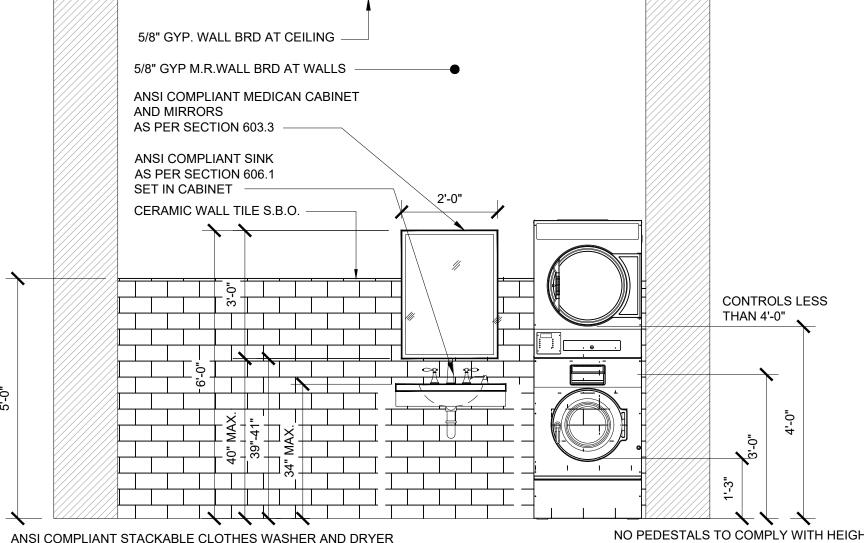

MANUFACTURE: GE APPLICANCES MODEL# GEWADREW5503

FUEL: ELECTRIC COLOR: S.B.O.


MAXIMUM HIGH FORWARD REACH FOR CONTROLS AND OPERATING MECHANISMS IS 48"; MAXIMUM LOW FORWARD REACH IS 15". NOTE: ADA COMPLIANT STACKABLE DRYERS ARE ADA COMPLIANT WHEN INSTALLED ON THE FLOOR.

THEY ARE NOT ADA COMPLIANT WHEN MOUNTED ON PEDESTALS OR STACKED BECAUSE IT PUTS THE CONTROLS ABOVE 48" HEIGHT FROM GROUND.


OPERABLE PARTS SHALL BE OPERABLE WITH ONE HAND AND SHALL NOT REQUIRE TIGHT GRASPING, PINCHING, OR TWISTING OF THE WRIST. THE FORCE REQUIRED TO ACTIVATE OPERABLE PARTS SHALL BE 5 LBS.

FRONT LOADING MACHINES SHALL HAVE THE BOTTOM OF THE OPENING TO THE LAUNDRY COMPARTMENT

LOCATED 15" MINIMUM AND 36" MAXIMUM FROM THE FLOOR

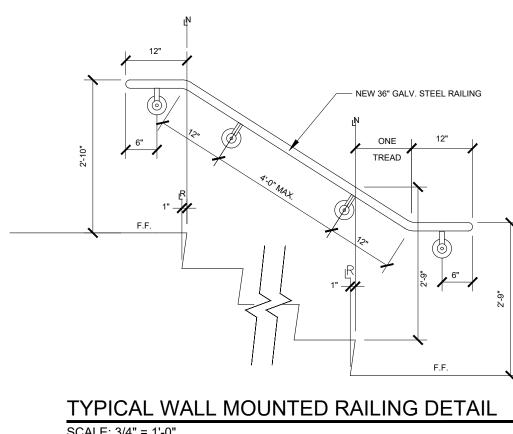


SCALE: 3/4" = 1'-0"

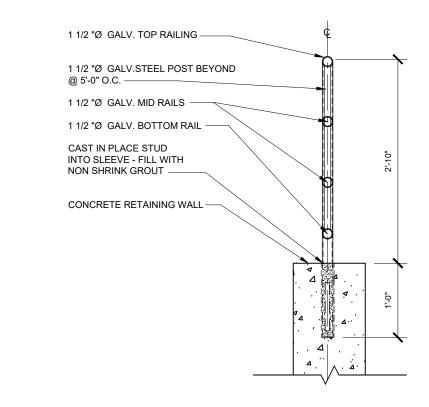

TYPICALRAILING DETAIL SCALE: 3/4" = 1'-0"

SCALE: 3" = 1'-0"

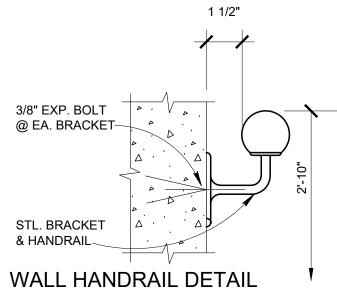

2X4 MIN. CONTINOUS WOOD BLOCKING CUT INTO METAL STUD CERAMIC TILE

SET ON THIN-SET

- GRAB BAR -(3) SCREWS

-COVER PLATE

- WALL BOARD

BLOCKING DETAIL (TYP)

- MOUNTING PLATE

34" FROM CENTERLINE OF **BLOCKING TO FLOOR** (VERIFY LOCATION OF **GRAB BARS ON FLOOR** PLANS AND ELEVATION

SCOPE OF WORK:

KEY PLAN:

RESTROOM ADA IMPROVEMENTS AND MECHANICAL SYSTEMS

UNIVERSAL ENGINEERING SERVICES, P.C.

ENGINEERING

GREEN DESIGN

CONSTRUCTION MANAGEMENT

403 Main Street, Suite 871 Armonk, New York 10504

TEL: (212) 586-5192

FAX: (914) 470-1133

E-MAIL: JPATERNO@UESPC.COM

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DIMENSIONS REQUIRED TO PROPERLY ESTIMATE OR ERECT THIS PROJECT WILL BE SUPPLIED BY THE

IN THE FIELD ALL DIMENSIONS AND CONDITIONS

ENGINEER UPON REQUEST. CONTRACTOR SHALL VERIFY

INDICATED ON THIS DRAWING AND BE RESPONSIBLE FOR SAME. ANY DISCREPANCIES BETWEEN THE DRAWINGS

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AND FIELD CONDITIONS SHOULD BE REPORTED TO THE ENGINEER BEFORE PROCEEDING WITH THE WORK.

CONSENT AND KNOWLEDGE OF THE ENGINEER. ALL REPRODUCTION RIGHTS RESERVED. REPRODUCTION

BID REVIEW ADA

IMPROVEMENTS

BLDG. DEPT. REVIEW

BLDG. DEPT. REVIEW

BID DOCUMENTS

BID DOCUMENT REVIEW

CLIENT REVIEW

ISSUED FOR

105.5, SESTEP HEIGH 13.6

REVISIONS

05/03/21

06/02/20

05/08/20

03/30/20

12/20/19

DATE

WITHOUT PERMISSION IS PROHIBITED.

MAKE NO ASSUMPTIONS WITH REGARD TO THESE DRAWINGS. ANY ADDITIONAL INFORMATION OR

UES NOTE:

PROJECT LOCATION: CHESTER HEIGHTS EASTCHESTER FIRE STATION EASTCHESTER, N.Y.

> BLOCK: 03 LOT: 19 ZONE: R-20

SHEET TITLE:

ACCESSIBLE TOILET ROOM **ELEVATIONS AND DETAILS**

SECTION: 80.J

PROJECT #: 18-040418 AS NOTED DATE: 10/19/21


DRAWN BY: JOSEPH PATERNO, LEED AP

REVIEWED BY: MICHAEL GIANATASIO, P.E

SEAL.: SHEET NO.:

S-402

SHEET: 7 OF 10

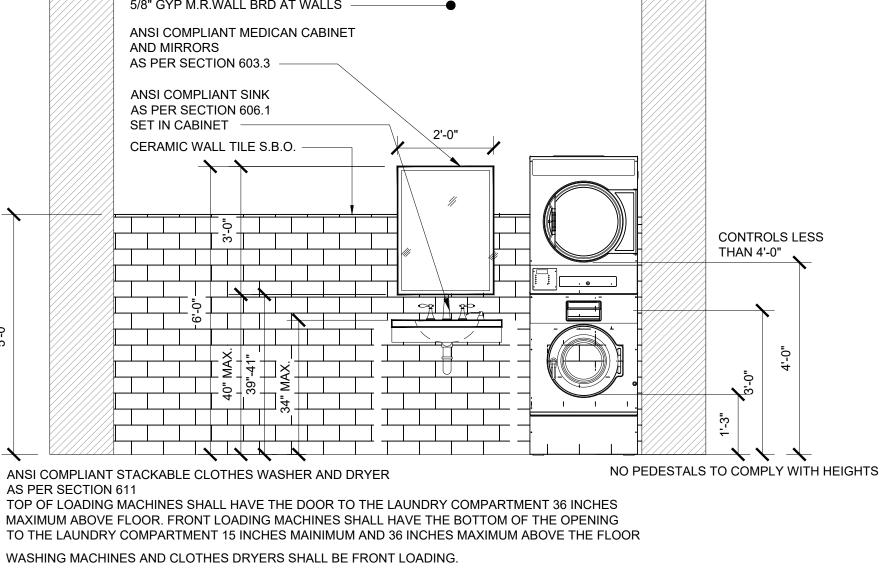

EQUIPMENT SCHEDULE:	

EQUIPMENT SCHED	ULE:		T				,
ITEM	LOCATION	MANUFACTURE	INFORMATION	SIZE	COLOR		TOTAL
GARAGE DOOR	APPARATUS FLOOR	RAYNOR GARAGE DOOR	THERMASEAL TM200C	16'-8" X 13'-1"	S.B.O.		
FLOOR DRAIN	APPARATUS FLOOR	JAY R. SMITH MFG. CO.	12" HEAVEY GAGE GALV. STEEL GRATING	12"	N.A		
TRENCH DRAIN	DRIVEWAY	PRECAST CONCRETE SALES CO.	8"Ø HEAVY DUTY DRAIN	8"Ø	S.B.O.		
CEILING PAINT	APPARATUS CEILING	BENJAMIN MOORE	ULTRA SPEC HP D.T.M. ACRYLIC GLOSS HP28 PRIMER AND FINISH COAT	N/A	S.B.O.		
DRYWELL	DRIVEWAY	PRECAST CONCRETE SALES CO.	PRE-CAST CONCRETE LEACHING RING	10"Ø X 6'	N.A		
DRYWELL	FRONT YARD	CULTEC, INC.	RECHARGER 330 XL HD	4'-4"Ø X 8'-6"	N.A		
FIRE PROOFING	CELLAR	GCP APPLIED TECHNOLOGIES	MONOKOTE Z-106.HY	N/A	N.A		
WATERPROOFING	APPARATUS FLOOR	SIKA CORPORATION	COLID FLUID APPLIED POLYURETHAN TRAFFIC WATERPROOFING SYSTEM (SIKALATIC 745 TEXTURE	N/A D)	N.A		
			SIKALISTIC PRIMER SIKALISTIC 720 BASECOAT SIKALISTIC 745 TEXTURED TOP COAT				
TOILET BOWL	RESTROOM	AMERICAN STANDARD	MADERA Elongated one-piece toilet	ADA	WHITE	MODEL: 2857.128.020	2
SINK	RESTROOM	AMERICAN STANDARD	Wheelchair 20" Wall Mounted Porcelain Bathroom Sink	ADA	WHITE	MODEL: 99140.013.020	2
FAUCET	RESTROOM	AMERICAN STANDARD	Colony Widespread Bathroom Faucet	ADA	WHITE	MODEL: 3875.501.002	2
SLOP SINK	RESTROOM	AMERICAN STANDARD	Wheelchair 20" Wall Mounted Porcelain Bathroom Sink	ADA	WHITE	MODEL: 99140.013.020	2
UTILITY SINK	RESTROOM	SPLASH	Splash CS-1-24-24-14-BS8 27" 1 Compartment Sink w/ 24"L x 24"W Bowl, 14" Deep	ADA	SS	MODEL: KaTom #: 079-BK8BS12414 • MPN: CS-1-24-24-14-BS8 (BK8BS-1-24-14)	1
UTILITY SINK FAUCET	RESTROOM	SPLASH	Splash SPL810L-12 Splash Mount Faucet w/ 10" Swing Spout & Lever Handles		SS	KaTom #: 079-SPLL01821 • MPN: SPL810L-12	1
BATH/SHOWER PARTITIONS	RESTROOM	HADRIAN	STAINLESS STEEL PARTITIONS	ADA	SS	AS PER DRAWING LAYOUTS	2
MIRROR	RESTROOM	AMERICAN SPECIALITES (ASI)	STAINLESS STEEL 24X36	ADA	SS	MODEL# 20650-B SERIES	2
GRAB BARS	RESTROOM	AMERICAN SPECIALITES (ASI)	STAINLESS STEEL AS PER DRAWINGS	ADA	SS	AS PER DRAWINGS LAYOUTS & ADA DETAILS	2
SHOWER SEAT	RESTROOM	AMERICAN SPECIALITES (ASI)	FOLDING SHOWER SEAT	ADA	SS	8206-L FOLDING SHOWER SEAT, SOLID PHENOLIC, WHITE – L SHAPED, 33" WIDE – LEFT HAND, 8206-R FOLDING SHOWER SEAT, SOLID PHENOLIC, WHITE – L SHAPED, 33" WIDE – RIGHT HAND,	2
HAND DRYERS	RESTROOM	AMERICAN SPECIALITES (ASI)	SATIN STAINLESS STEEL	ADA	SS	0185-93 PROFILE™ STEEL COVER HAND DRYERS	2
TOILET TISSUE DISPENSER	RESTROOM	AMERICAN SPECIALITES (ASI)	SATIN STAINLESS STEEL	ADA	SS	74022-HBSM TOILET TISSUE HOLDER WITH HOOD (DOUBLE) – SURFACE MOUNTED, BRIGHT	2
ACCESSIBLE WATER FOUNTAIN	APPARATUS FLOOR	Elkay	Color: Light Gray Granite	ADA		Elkay EZS8L wall-mounted cooler, ADA Barrier Free Item#T9FB190402 Color: Light Gray Granite Width 18-3/8 Depth 19 Height 19-13/16 weight 51 lbs	1

ANSI COMPLIANT DISPENSERS AS PER SECTION: 604.7 ANSI COMPLIANT GRAB BARS AS PER SECTION: 604.5 ANSI COMPLIANT SINK AS PER SECTION 606.1 ANSI COMPLIANT TOILET AS PER SECTION 604.1 ANSICOMPLIANT COAT HOOKS AND SHELVES AS PER SECTION 603.4 SHELVES: 40" MIN. 48" MAX. ABOVE FLOOR ANSI COMPLIANT MIRRORS

AS PER SECTION 603.3 FLOOR TYPE: 12" x 12" CERAMIC TILE


MARBLE SADDLE ADA COMPLIANT THRESHOLD AT DOORWAYS: 1/2" MAXIMUM HEIGHT AS PER SECTION 404.2.4

NEW 2'-10"x 6'-8" S.C. DOOR WITH ANSI HARDWARE ANSI COMPLIANT DOOR WIDTH 32" MINIMUM CLEAR AS PER SECTION 404.2.2


BLOKING DETAIL FOR GRAB BARS SEE LOCATIONS OF GRAB BARS FOR EXTENT OF WORK

ICC/ANSI A117.1-2010

1'-4" ICC/ANSI A117.1-2010 16" MIN. 18" MAX. 7'-1" 309.4 OPERATION: OPERABLE PARTS SHALL BE OPERABLE WITH ONE HAND AND SHALL NOT REQUIRE TIGHT GRASPING, PINCHING, OR TWISTING OF THE WRIST. THE FORCE REQUIRED TO ACTIVATE OPERABLE PARTS SHALL BE 5 POUNDS (22.2 N) MAXIMUM.

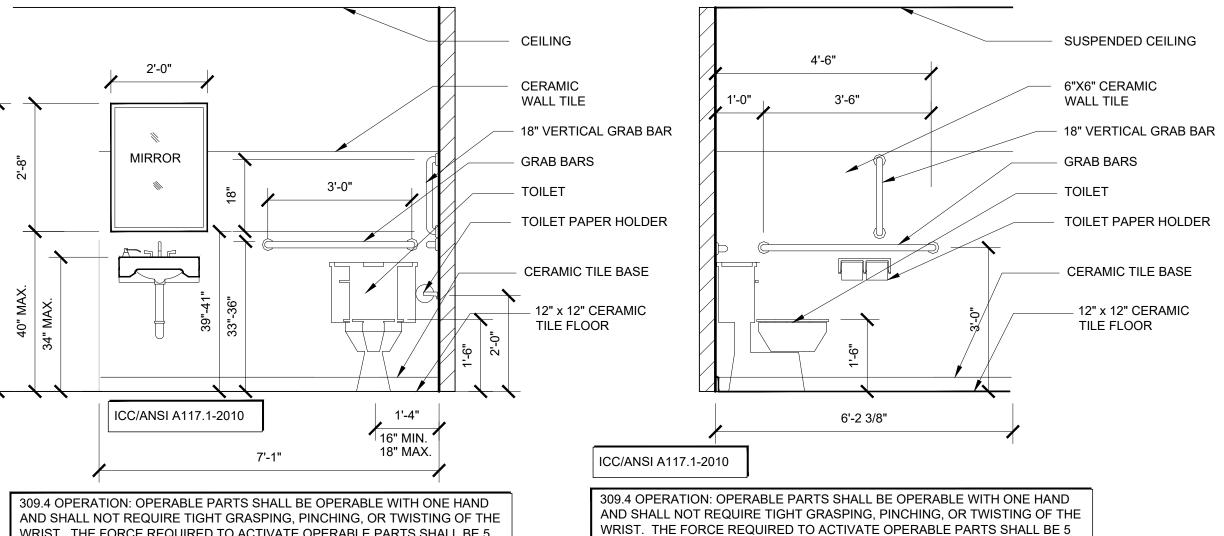

POUNDS (22.2 N) MAXIMUM.

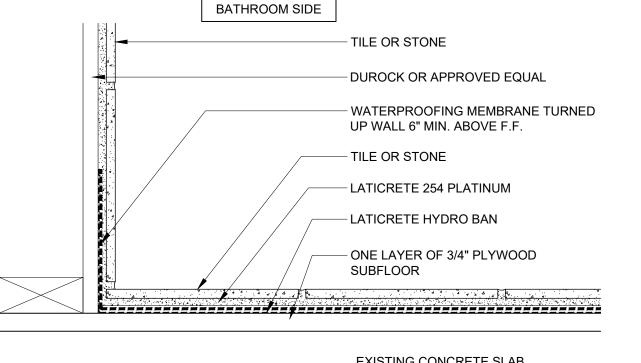

EXISTING CONCRETE SLAB TO REMAIN

WATERPROOFING DETAIL

UNIVERSAL ENGINEERING SERVICES, P.C.

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NO.	ISSUED FOR	DATE
	REVISIONS	
KEY	Y PLAN:	

R-20

SCOPE OF WORK:

RESTROOM ADA IMPROVEMENTS AND MECHANICAL SYSTEMS

PROJECT LOCATION: CHESTER HEIGHTS EASTCHESTER FIRE STATION EASTCHESTER, N.Y. SECTION: 80.J

ZONE: R-20 SHEET TITLE:

EQUIPMENT LIST ACCESSIBLE TYPICAL DETAILS

BLOCK: 03

LOT: 19


PROJECT #:	18-040418
SCALE:	AS NOTED
DATE:	10/19/21
DRAWN BY:	JOSEPH PATERNO, LEED AP


REVIEWED BY: MICHAEL GIANATASIO, P.E.

SEAL.: SHEET NO.:

S-403

SHEET: 8 OF 10

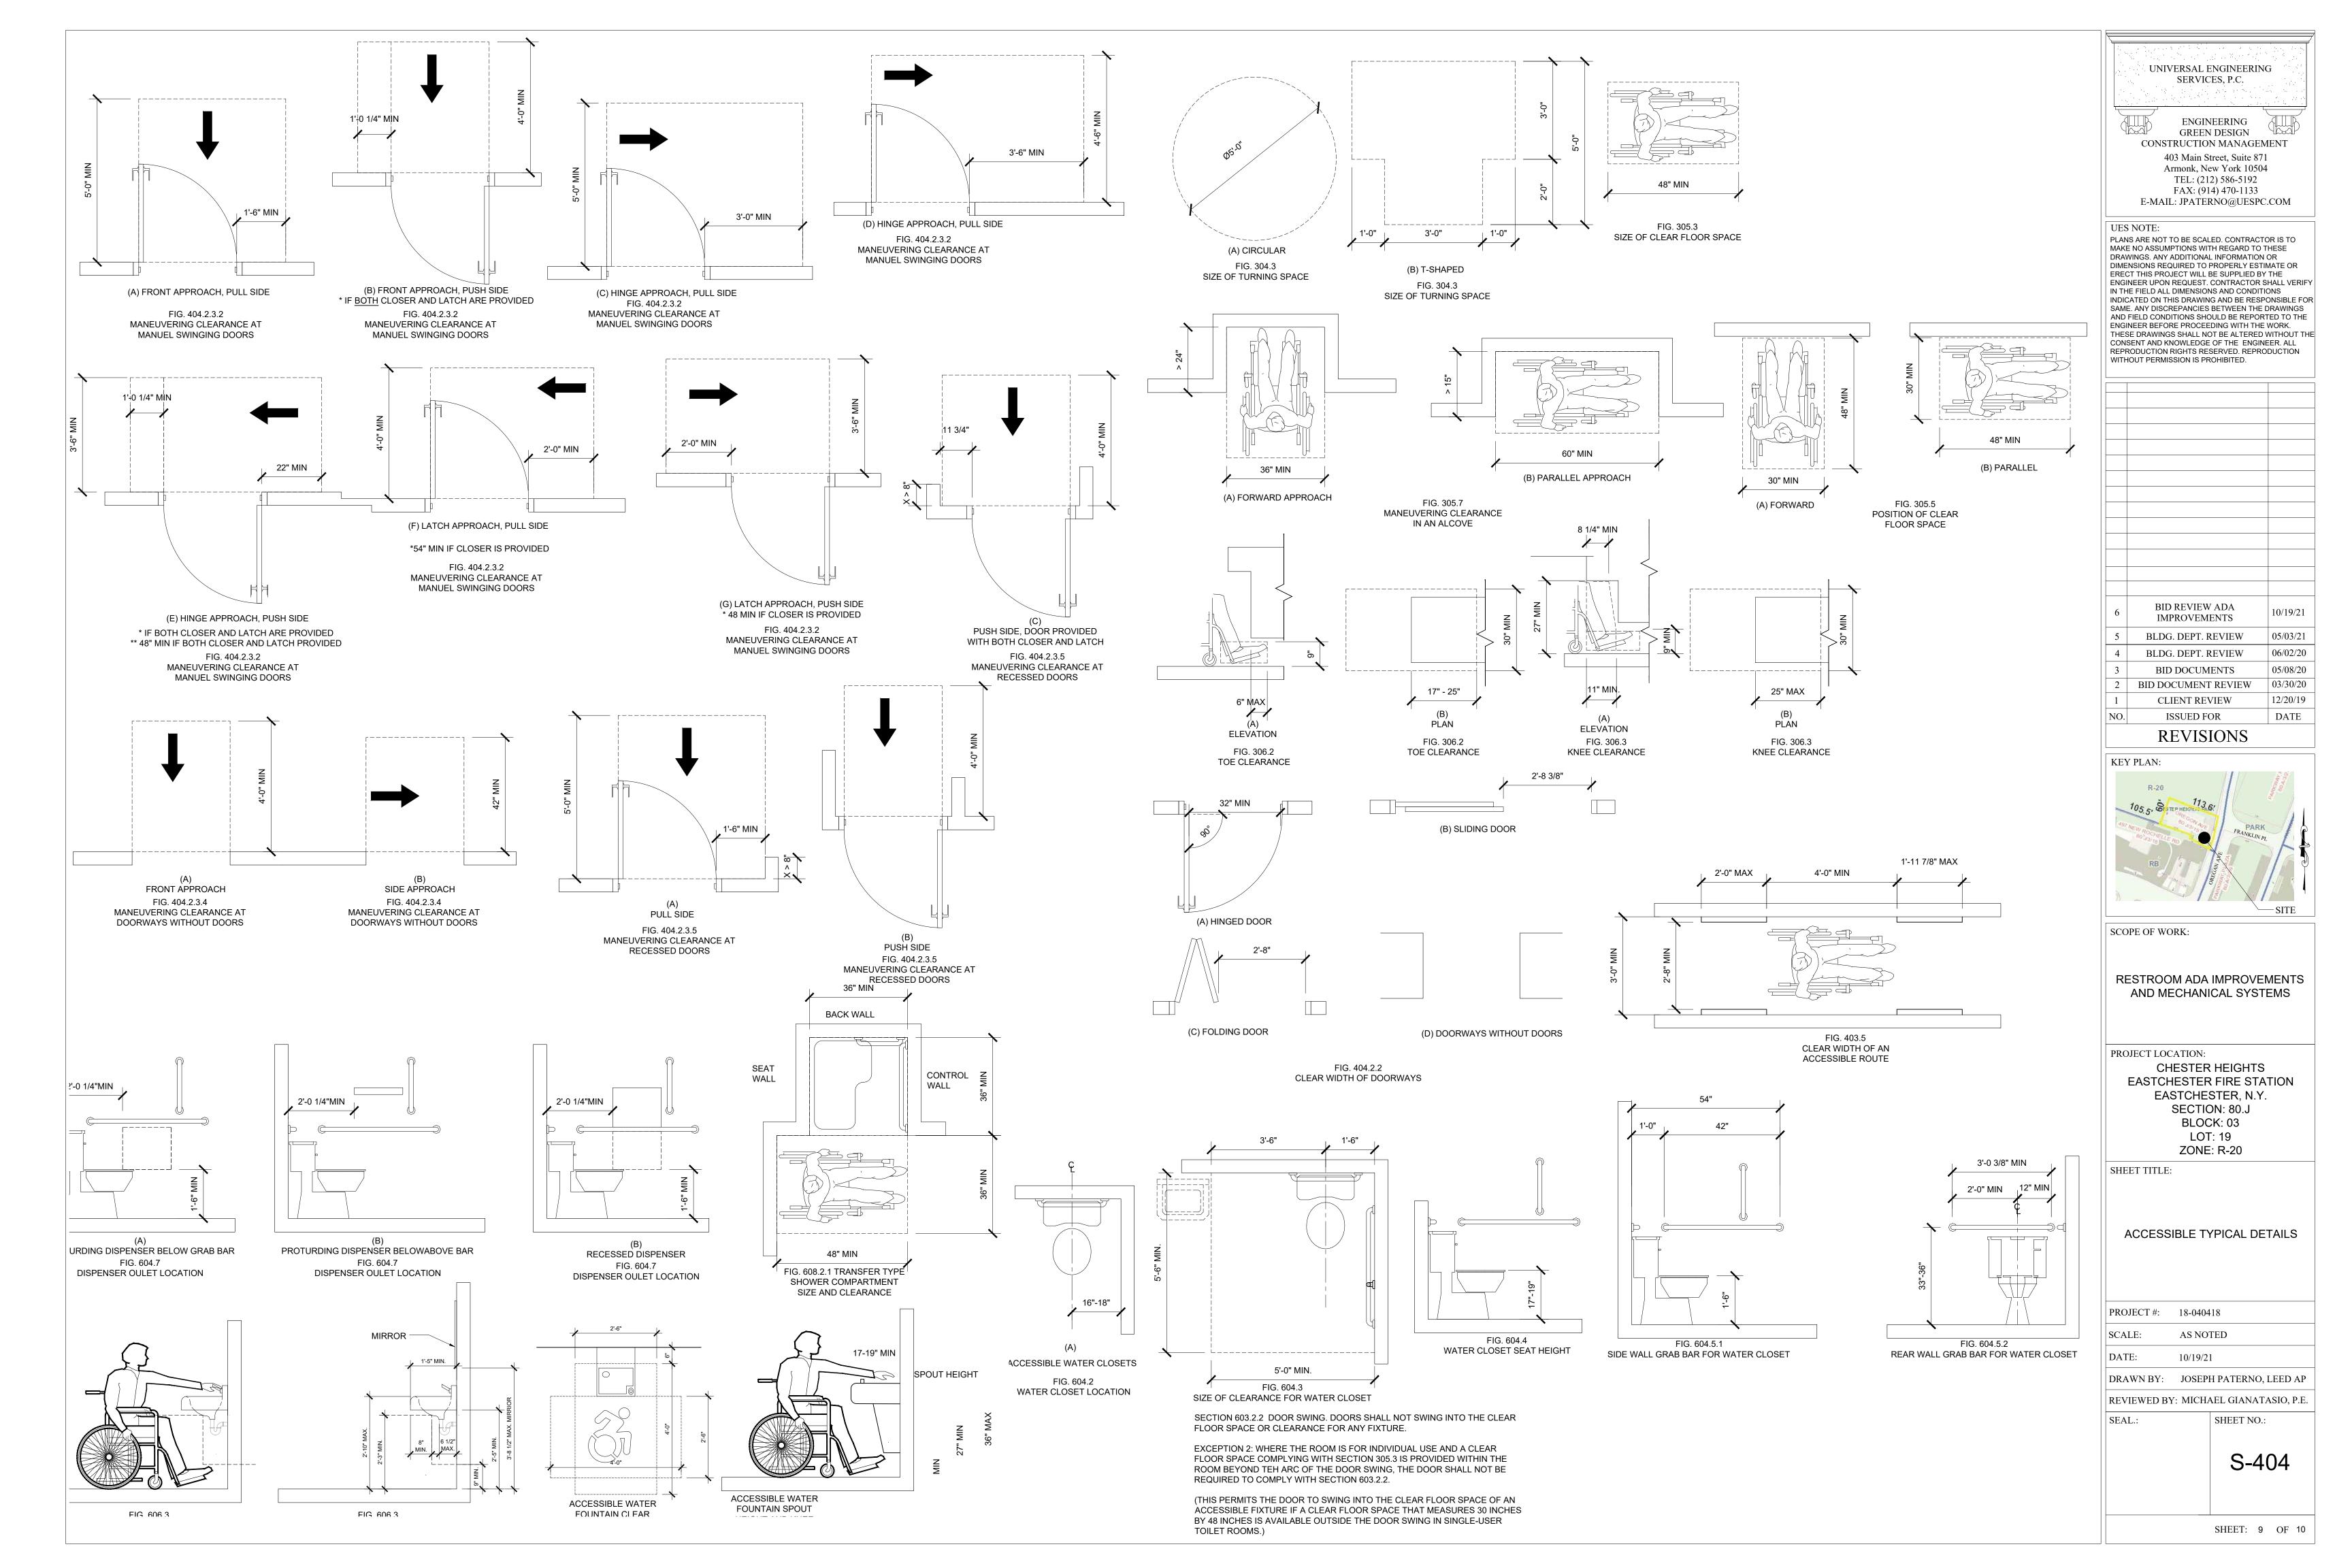

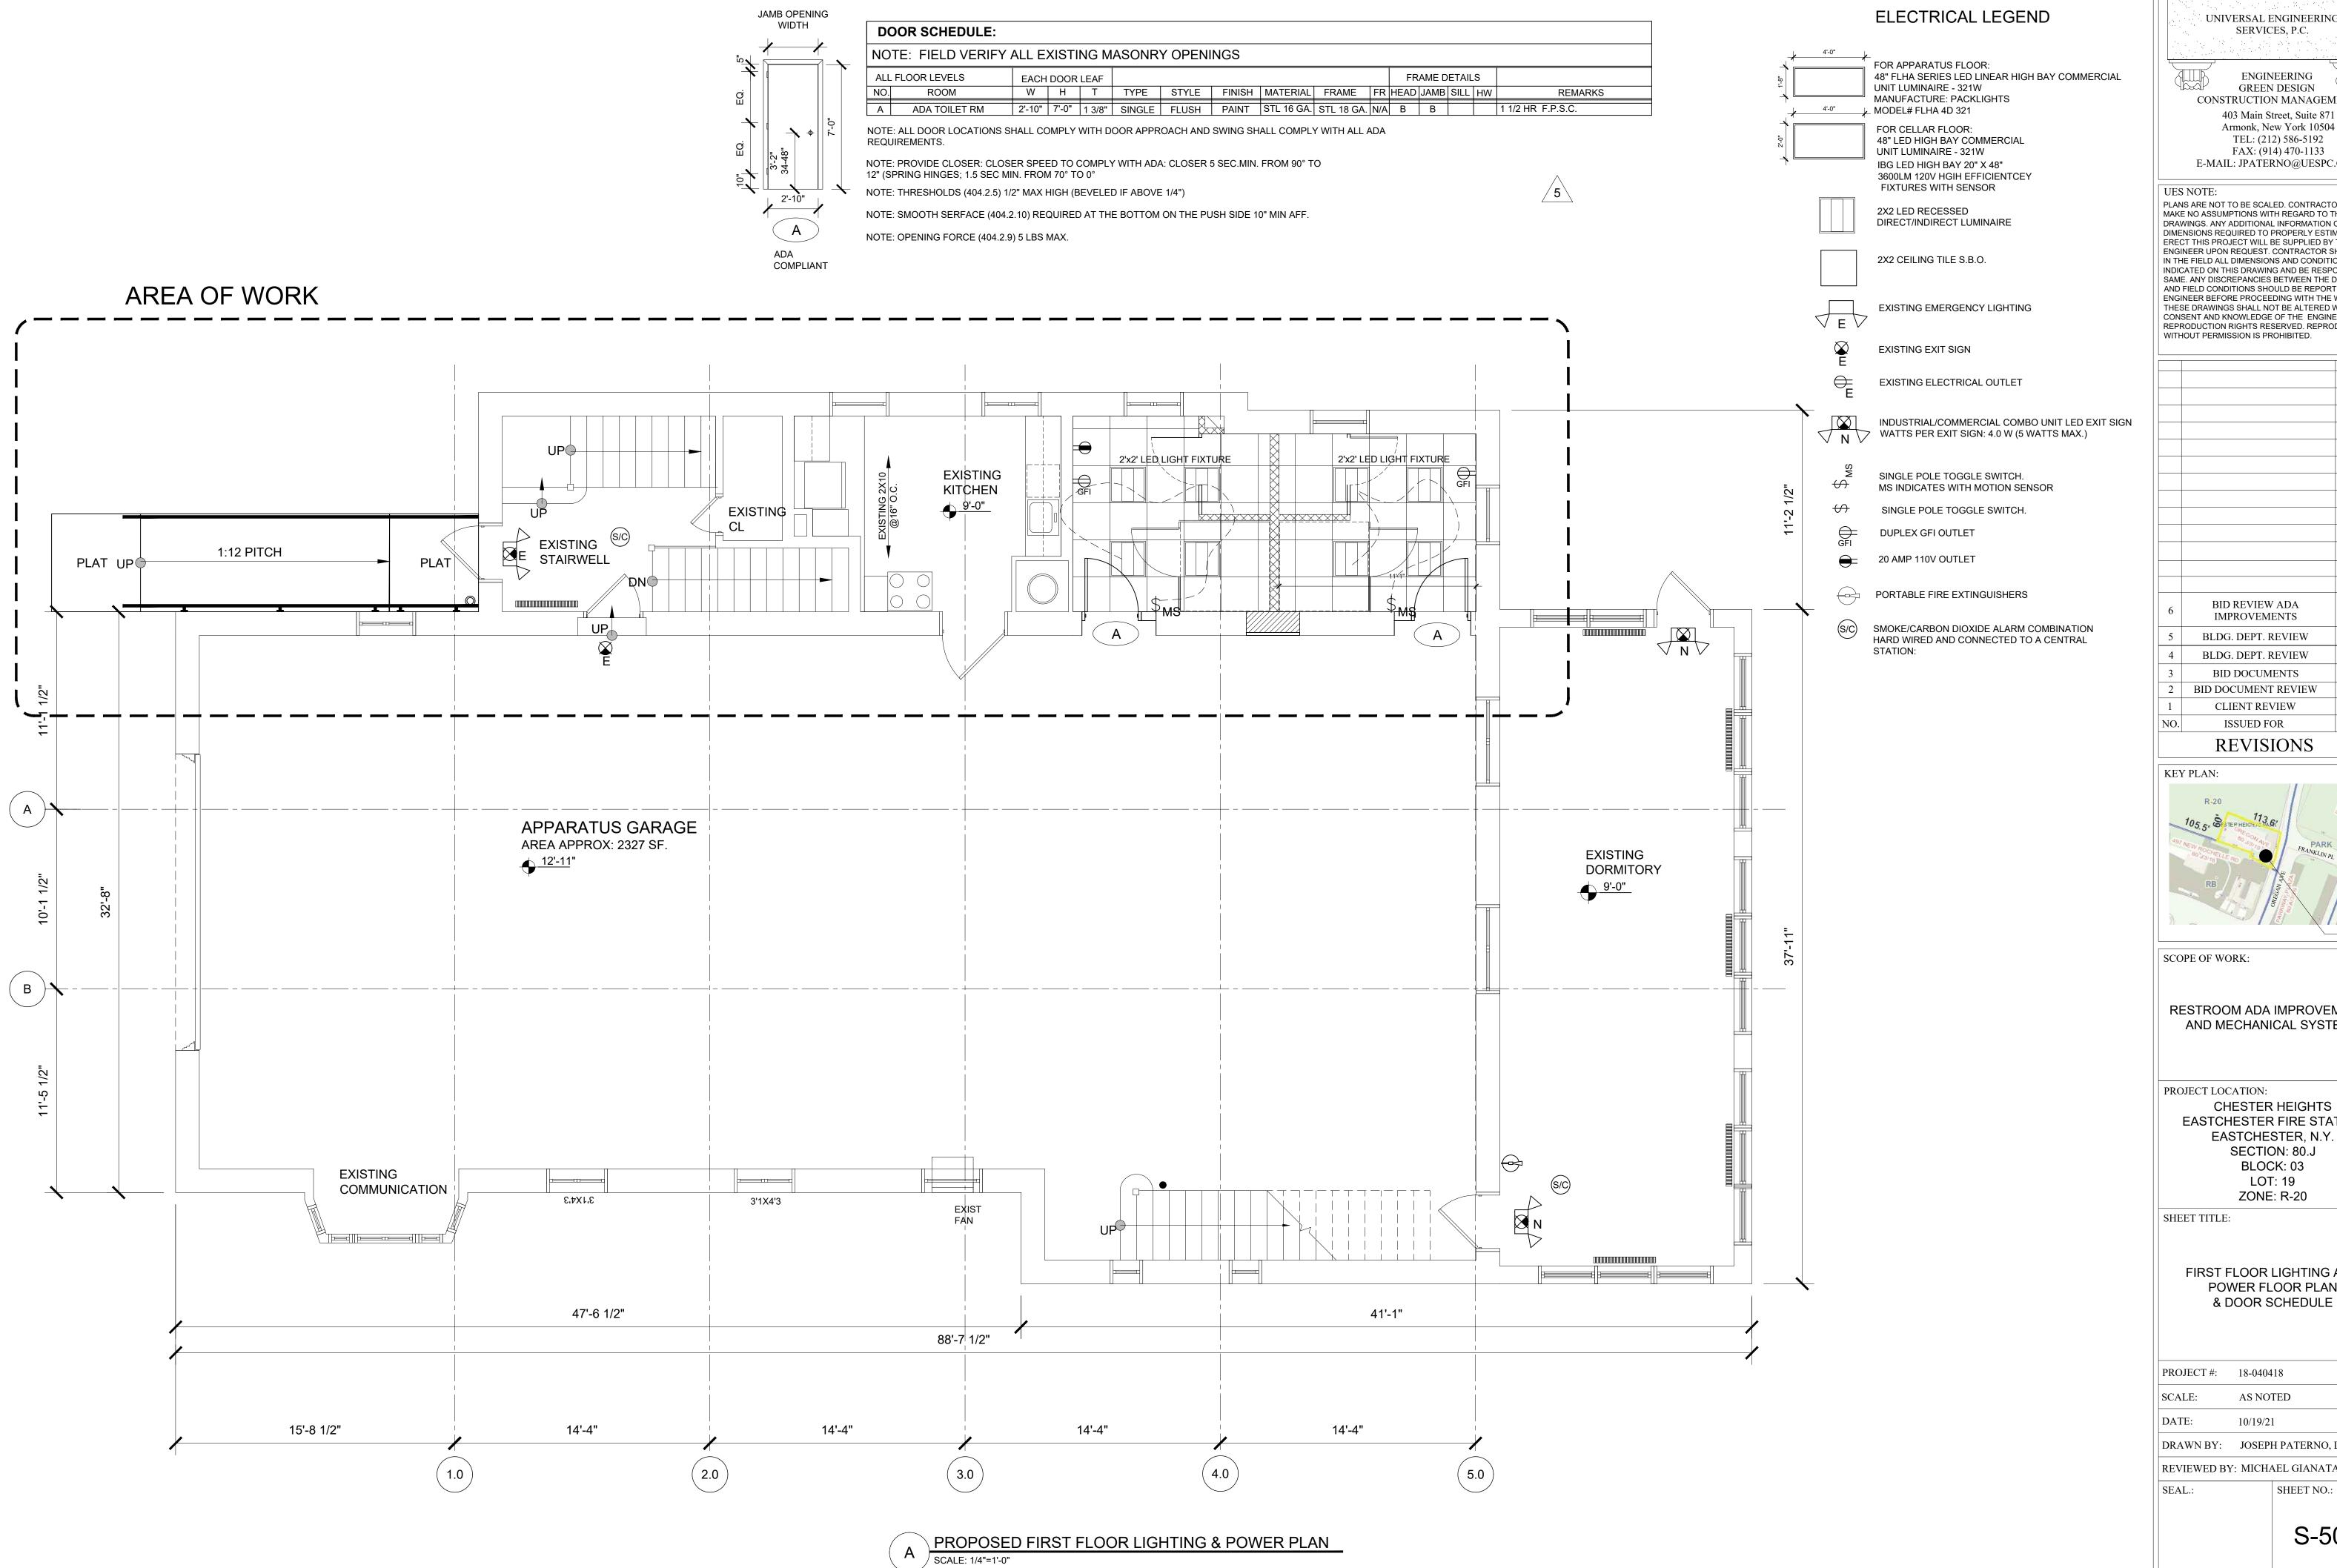

UNIVERSAL ENGINEERING SERVICES, P.C.

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6	BID REVIEW ADA IMPROVEMENTS	10/19/2
5	BLDG. DEPT. REVIEW	05/03/2
4	BLDG. DEPT. REVIEW	06/02/2
3	BID DOCUMENTS	05/08/2
2	BID DOCUMENT REVIEW	03/30/2
1	CLIENT REVIEW	12/20/1
NO.	ISSUED FOR	DATE
	REVISIONS	

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R-20	113 TEP HEIGHT 9267	-	Parkonar, Son age
RB	RD	FRANKLIN PL	
	OREGAN AVE	S S S S S S S S S S S S S S S S S S S	
			-SITE

RESTROOM ADA IMPROVEMENTS AND MECHANICAL SYSTEMS

EASTCHESTER FIRE STATION EASTCHESTER, N.Y. SECTION: 80.J BLOCK: 03 LOT: 19

FIRST FLOOR LIGHTING AND POWER FLOOR PLAN & DOOR SCHEDULE

PROJECT #: 18-040418 AS NOTED 10/19/21 DRAWN BY: JOSEPH PATERNO, LEED AP REVIEWED BY: MICHAEL GIANATASIO, P.E SHEET NO.:

S-502

SHEET: 10 OF 10