



AA ENLARGED CATWALK
1/4" = 1'-0"

- CATWALK FRAMING PLAN NOTES:**
1. FINISHED FLOOR ELEVATION = 130.50 (+14'-0")
 2. TOP OF STEEL ELEVATION = (+13'-11"), U.N.O.
 3. ALL ELEVATIONS NOTED THUS (+X'-X") REFERENCED TO FINISHED FIRST FLOOR ELEVATION.
 4. CATWALK PLATFORM FLOOR GRATING SHALL BE 19-W-4, 1"x3/16" (SMOOTH) BEARING BARS. GRATING SHALL BE ATTACHED WITH INDUSTRY STANDARD SADDLE CLIPS. GRATING SHALL SPAN BETWEEN HSS3X3X1/4 INFILL FRAMING U.N.O.
 5. REFER TO ARCHITECTURAL DRAWINGS FOR ALL NECESSARY EMBEDDED ITEMS, RAMPS, STAIRS, LANDINGS, AND FINISH DETAILS.
 6. REFER TO ARCHITECTURAL DRAWINGS FOR DIMENSIONS AND ELEVATIONS NOT SHOWN.
 7. ALL STAIRS SHALL MEET THE REQUIREMENTS OF OSHA AND IBC STANDARD FOR RISER HEIGHTS, TREAD LENGTHS, HAND RAIL AND GUARDRAIL SPACINGS.
 8. ALL HSS CONNECTIONS FOR CATWALK FRAMING TO BE DESIGNED FOR SHEAR OF 5 KIPS, U.N.O.

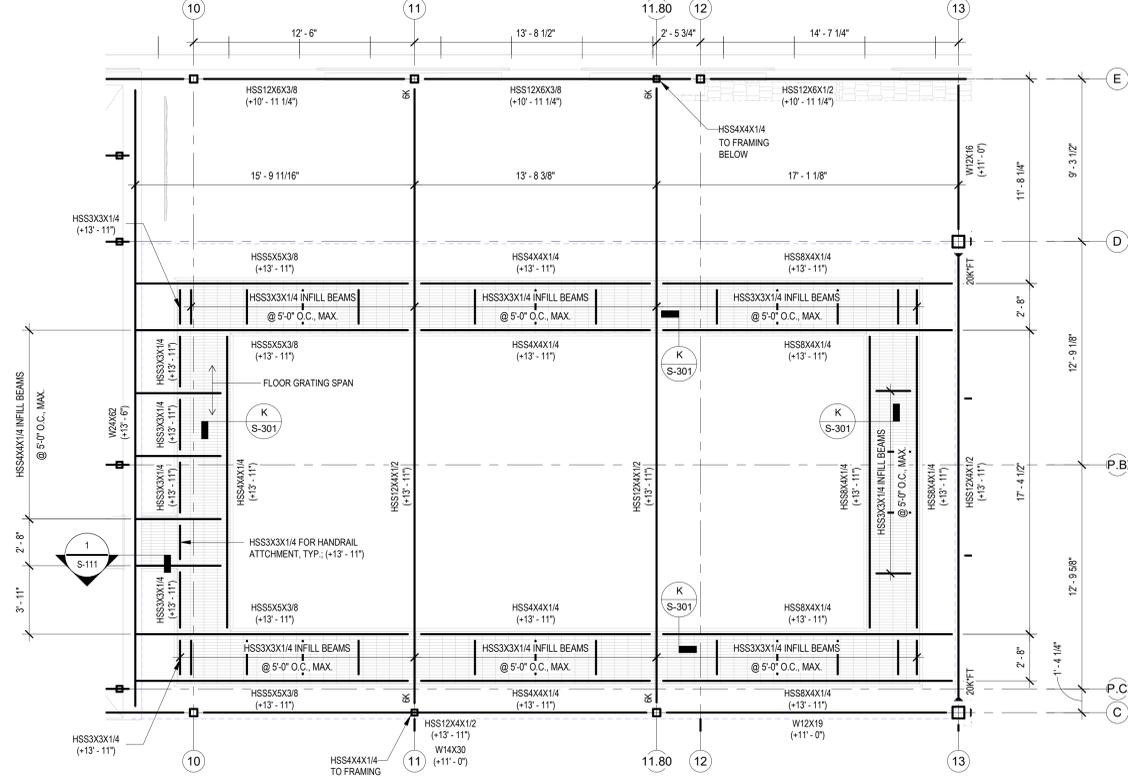


BB ENLARGED CATWALK
1/4" = 1'-0"

- CATWALK FRAMING PLAN NOTES:**
1. FINISHED FLOOR ELEVATION = 130.50 (+14'-0")
 2. TOP OF STEEL ELEVATION = (+13'-11"), U.N.O.
 3. ALL ELEVATIONS NOTED THUS (+X'-X") REFERENCED TO FINISHED FIRST FLOOR ELEVATION.
 4. CATWALK PLATFORM FLOOR GRATING SHALL BE 19-W-4, 1"x3/16" (SMOOTH) BEARING BARS. GRATING SHALL BE ATTACHED WITH INDUSTRY STANDARD SADDLE CLIPS. GRATING SHALL SPAN BETWEEN HSS3X3X1/4 INFILL FRAMING U.N.O.
 5. REFER TO ARCHITECTURAL DRAWINGS FOR ALL NECESSARY EMBEDDED ITEMS, RAMPS, STAIRS, LANDINGS, AND FINISH DETAILS.
 6. REFER TO ARCHITECTURAL DRAWINGS FOR DIMENSIONS AND ELEVATIONS NOT SHOWN.
 7. ALL STAIRS SHALL MEET THE REQUIREMENTS OF OSHA AND IBC STANDARD FOR RISER HEIGHTS, TREAD LENGTHS, HAND RAIL AND GUARDRAIL SPACINGS.
 8. ALL HSS CONNECTIONS FOR CATWALK FRAMING TO BE DESIGNED FOR SHEAR OF 5 KIPS, U.N.O.

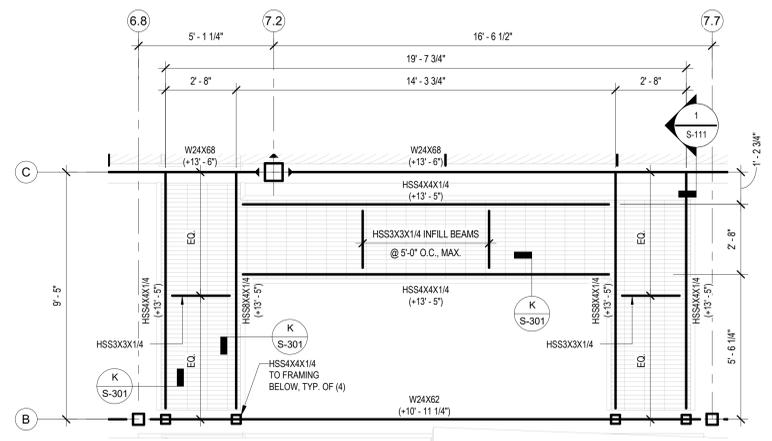


CC ENLARGED CATWALK
3/8" = 1'-0"

- CATWALK FRAMING PLAN NOTES:**
1. FINISHED FLOOR ELEVATION = 130.00 (+13'-6")
 2. TOP OF STEEL ELEVATION = (+13'-5"), U.N.O.
 3. ALL ELEVATIONS NOTED THUS (+X'-X") REFERENCED TO FINISHED FIRST FLOOR ELEVATION.
 4. CATWALK PLATFORM FLOOR GRATING SHALL BE 19-W-4, 1"x3/16" (SMOOTH) BEARING BARS. GRATING SHALL BE ATTACHED WITH INDUSTRY STANDARD SADDLE CLIPS. GRATING SHALL SPAN BETWEEN HSS3X3X1/4 INFILL FRAMING U.N.O.
 5. REFER TO ARCHITECTURAL DRAWINGS FOR ALL NECESSARY EMBEDDED ITEMS, RAMPS, STAIRS, LANDINGS, AND FINISH DETAILS.
 6. REFER TO ARCHITECTURAL DRAWINGS FOR DIMENSIONS AND ELEVATIONS NOT SHOWN.
 7. ALL STAIRS SHALL MEET THE REQUIREMENTS OF OSHA AND IBC STANDARD FOR RISER HEIGHTS, TREAD LENGTHS, HAND RAIL AND GUARDRAIL SPACINGS.
 8. ALL HSS CONNECTIONS FOR CATWALK FRAMING TO BE DESIGNED FOR SHEAR OF 5 KIPS, U.N.O.

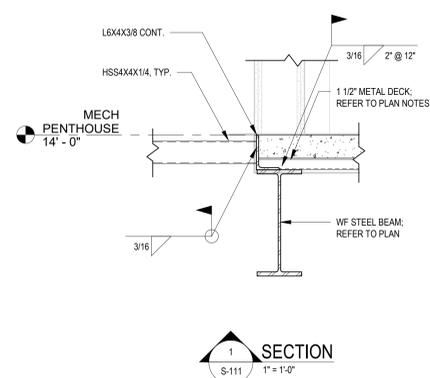

SECTION 1
1" = 1'-0"

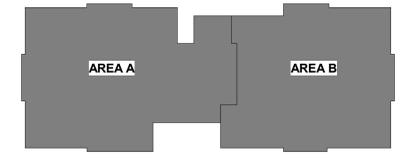

KEY PLAN

7/27/2021 5:46:11 PM

Revisions:	Date:

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5/09/2022 License valid through 11/30/2024

Office of Construction and Facilities Management

VA U.S. Department of Veterans Affairs

Drawing Title
ENLARGED FRAMING PLANS

Approved:

Phase
ISSUED FOR CONSTRUCTION

FULLY SPRINKLERED

Project Title
NEW COMMUNITY LIVING CENTER

Location
2094 Albany Post Road, Montrose, NY 10548

Issue Date
05/09/2022

Checked
WCW

Drawn
SIR

Project Number
620-334

Building Number
CLC

Drawing Number
S-111