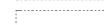


ARCHITECTURAL SYMBOL LEGEND

-  PROPOSED EXTERIOR WALL - SEE WALL SECTIONS
-  INTERIOR STUD FRAMED WALL - SEE WALL TYPES
-  AREA OF NO WORK, FACILITY TO REMAIN OPERATIONAL
-  1 HR FIRE RATED PARTITION
-  2 HR FIRE RATED PARTITION
-  SMOKE RATED PARTITION / SMOKE BARRIER / COMPARTMENT
-  1 HR FIRE AND SMOKE BARRIER
-  2 HR FIRE AND SMOKE BARRIER
-  VAVA ITEM - VA SUPPLIED & INSTALLED
-  VACC OR VC ITEM - VA SUPPLIED & CONTRACTOR INSTALLED
-  CC/CC ITEM - CONTRACTOR SUPPLIED & INSTALLED
-  A1000 FURNITURE, FIXTURE, & EQUIPMENT INDICATOR
-  MATCHLINE
-  EXPANSION JOINT
-  DEDUCTIVE ALTERNATE
-  FOUNDATION DRAIN - SEE CIVIL



GENERAL SHEET NOTES

- A. CONTRACTOR TO COORDINATE WITH ROOF INSTALLATION WARRANTY REQUIREMENTS FOR ANY MODIFICATIONS TO ROOFINGS TO ENSURE NO VIOLATIONS OCCUR OF THE WARRANTY. CONTRACTOR TO EMPLOY A CERTIFIED ROOFING INSPECTOR MEETING THE REQUIREMENTS OF THE INSTALLED ROOF. ALL WARRANTY VIOLATIONS WILL BE REQUIRED TO BE CORRECTED PRIOR TO CLOSE OUT.
- B. CONTRACTOR TO VALIDATE AND VERIFY ALL FIRE RATED AND/OR SMOKE RATED WALLS AND ASSEMBLIES INDICATED ON PLANS IN WORK AREA. PROVIDE ALL PIPING PENETRATIONS OF FIRE, SMOKE AND FULL HEIGHT WALLS SHALL BE CALKED AIRTIGHT TO THE ADJACENT STRUCTURE BY MEANS OF U.L. APPROVED FIRE PROOF GULKING MATERIAL. SEE MECHANICAL AND PLUMBING DRAWINGS FOR ADDITIONAL INFORMATION. CONTRACTOR SHALL COORDINATE ALL PIPING, PLUMBING, AND CONDUIT PIPING WITH STRUCTURAL, MECHANICAL, AND ELECTRICAL SYSTEMS AND SHALL PROVIDE NECESSARY OFFSETS TO AVOID CONFLICTS AND TO MAINTAIN REQUIRED EQUIPMENT ACCESS AND SERVICEABILITY.
- C. EXISTING CONDITIONS ARE BASED ON EXISTING PLANS AND FIELD VERIFICATION WHERE FEASIBLE. ACTUAL CONDITIONS MAY DIFFER FROM THOSE INDICATED. CONTRACTOR TO FIELD VERIFY IN ADVANCE THE LOCATION AND CONDITION OF THOSE EXISTING SYSTEMS SHOWN TO BE MODIFIED OR REMOVED. CONTRACTOR TO NOTIFY ARCHITECT SHOULD CONDITIONS BE FOUND TO DIFFER SIGNIFICANTLY FROM CONSTRUCTION DOCUMENTS.
- D. CONTRACTOR TO COORDINATE ALL NEW EQUIPMENT LOCATIONS WITH ALL TRADES PRIOR TO INSTALLATION.
- E. CONTRACTOR TO PROVIDE GALVANIC PROTECTION AS REQUIRED AT CONNECTIONS BETWEEN ALL DISSIMILAR METALS.
- F. ANY FLOOR, WALL, OR CEILING CUTTING OR FILLING THAT IS REQUIRED TO COMPLETE THIS PROJECT, THE CONTRACTOR SHALL PATCH AND PAINT AND RETURN TO MATCH EXISTING CONDITIONS AND FINISHES.
- G. CONTRACTOR TO PROVIDE ESCUTCHEONS ON ALL NEW EXPOSED EXTERIOR PIPE PENETRATIONS AND SEAL COMPLETELY.
- H. CONTRACTOR TO PROVIDE TEMPORARY FLOORING WHILE MODIFYING SUBFLOORING.
- I. ANY LANDSCAPE, HARDSCAPE, FIXTURE, SIGNAGE AND SYSTEMS OR PEDESTRIAN CONTROL DEVICES WITHIN THE TEMPORARY ACCESSIBLE PATHWAY SHALL BE PROTECTED IN PLACE OR TEMPORARILY RELOCATED AS NECESSARY FOR CONTINUED UNINTERRUPTED OPERATION, ACCESS, MAINTENANCE AND / OR VISIBILITY.

KEYNOTES

- 1 MECHANICAL UNIT. SEE MECHANICAL DRAWINGS FOR MORE INFORMATION
- 2 ROOF EXPANSION JOINT. SEE DETAILS ON A-502
- 3 LOUVER. SEE LOUVER SCHEDULE ON A-601
- 4 SLOPED ROOF. SEE ARCHITECTURAL OVERALL ROOF PLAN
- 5 SLOPED ROOF. WALL AT WINDOW SILL. SEE SECTIONS
- 6 SHIPS LADDER
- 7 METAL GUARDRAIL, TYP.
- 8 INTERIOR ROOF DRAIN AND OVERFLOW DRAIN. REF. TO PLUMBING DRAWINGS.
- 9 ROOF RIDGE AND HIP VENTS
- 10 ACCESS DOOR. REFER TO SPECIFICATIONS FOR HARDWARE INFORMATION. PROVIDE CONFINED SPACE SIGNAGE
- 11 ROOF TIE-OFF, TYP.
- 12 5" CONC HOUSEKEEPING PAD. COORD SIZE W/ FINAL SELECTED EQUIPMENT.
- 13 ROOF ACCESS LADDER AND HATCH. PROVIDE CONFINED SPACE SIGNAGE.
- 14 PROVIDE NEW CATWALK IN SPACE AS SHOWN. SUPPORT CATWALK VIA STRUCTURAL TUBING THROUGH WALLS TO FOUNDATION BELOW. SEE STRUCTURAL
- 15 PROVIDE CONVENIENCE OUTLETS IN SPACE AS INDICATED. SEE ELECTRICAL EY102 AND EP102.
- 16 PROVIDE LIGHTING TO MEET MINIMUM EGRESS REQUIREMENT IN AREAS OF CATWALK. SEE ELECTRICAL EY102 AND EP102.

KEY PLAN

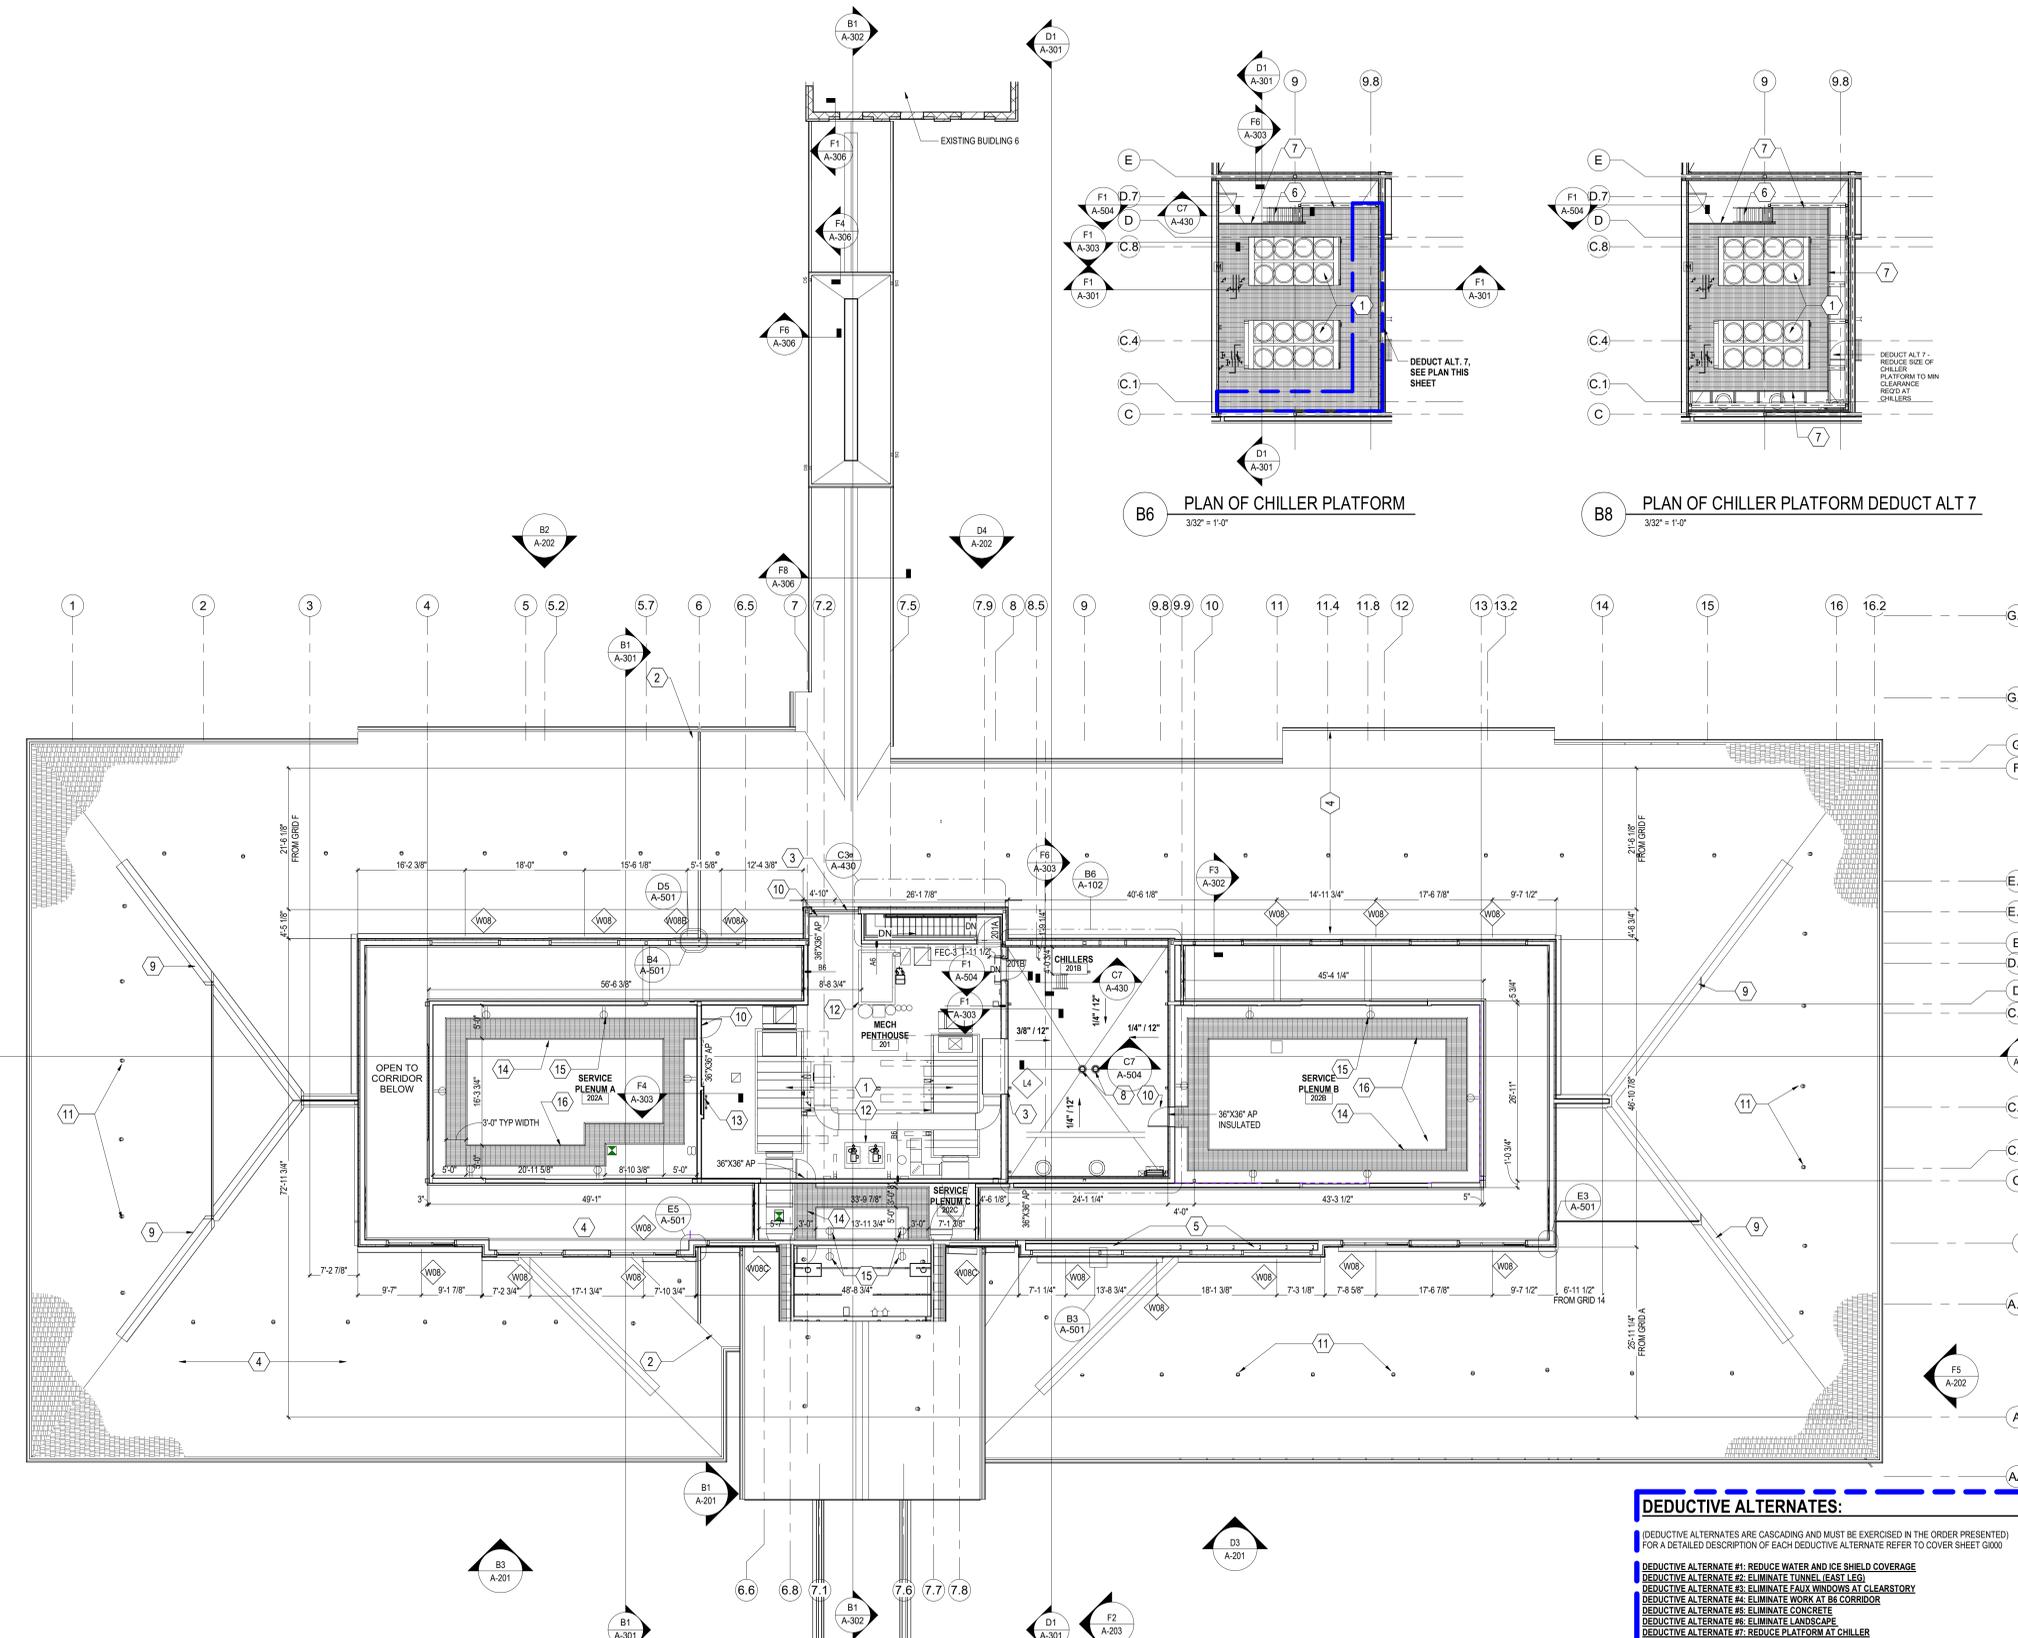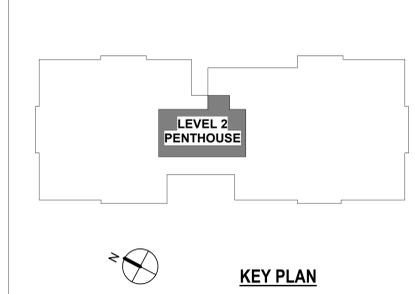

F2 ARCHITECTURAL FLOOR PLAN - PENTHOUSE
3/32" = 1'-0"

B6 PLAN OF CHILLER PLATFORM
3/32" = 1'-0"

B8 PLAN OF CHILLER PLATFORM DEDUCT ALT 7
3/32" = 1'-0"

- DEDUCTIVE ALTERNATES:**
- DEDUCTIVE ALTERNATES ARE CASCADING AND MUST BE EXERCISED IN THE ORDER PRESENTED! FOR A DETAILED DESCRIPTION OF EACH DEDUCTIVE ALTERNATE REFER TO COVER SHEET G100
- DEDUCTIVE ALTERNATE #1: REDUCE WATER AND ICE SHIELD COVERAGE
 - DEDUCTIVE ALTERNATE #2: ELIMINATE TUNNEL (EAST LEG)
 - DEDUCTIVE ALTERNATE #3: ELIMINATE FAUX WINDOWS AT CLEARSTORY
 - DEDUCTIVE ALTERNATE #4: ELIMINATE WORK AT B6 CORRIDOR
 - DEDUCTIVE ALTERNATE #5: ELIMINATE CONCRETE
 - DEDUCTIVE ALTERNATE #6: ELIMINATE LANDSCAPE
 - DEDUCTIVE ALTERNATE #7: REDUCE PLATFORM AT CHILLER
 - DEDUCTIVE ALTERNATE #8: ELIMINATE WVR SECURITY
 - DEDUCTIVE ALTERNATE #9: ELIMINATE LARGE PORCH
 - DEDUCTIVE ALTERNATE #10: ELIMINATE SMALL PORCH A
 - DEDUCTIVE ALTERNATE #11: ELIMINATE SMALL PORCH B
 - DEDUCTIVE ALTERNATE #12: ELIMINATE ENTRANCE CANOPY
 - DEDUCTIVE ALTERNATE #13: ELIMINATE FENCE FAUX ROOFS AT RESIDENT ROOMS
 - DEDUCTIVE ALTERNATE #14: ELIMINATE PATIENT LIFTS TRACK EXTENSIONS INTO RESIDENT RESTROOMS
 - DEDUCTIVE ALTERNATE #15: REDUCE THE POROUS ASPHALT / PARKING / PORTION OF DRIVE ENTRANCE
 - DEDUCTIVE ALTERNATE #16: ELIMINATE EXTERIOR SIGNAGE

Revisions:	Date:

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Office of Construction and Facilities Management

VA U.S. Department of Veterans Affairs

Drawing Title
ARCHITECTURAL OVERALL FLOOR PLAN - PENTHOUSE

Approved:

Phase
ISSUED FOR CONSTRUCTION

FULLY SPRINKLERED

Project Title
NEW COMMUNITY LIVING CENTER

Location
2094 Albany Post Road, Montrose, NY 10548

Issue Date
05/09/2022

Checked
M. PERKINS

Drawn
N. BLANCHARD

Project Number
620-334

Building Number
CLC

Drawing Number
A-102

BIM: 360/620-334 New Community Living Center/620-334-CLC-Arch-01