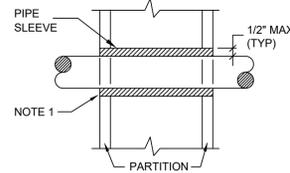


- NOTES:**
- PIPE 8" AND LARGER SHALL HAVE ROLLER SUPPORTED WITH DUAL RODS.
 - FOR CHW SERVICE OVER 3" REPLACE SADDLE WITH 12" LONG 14 GA SHIELD WITH RIGID INSULATION BETWEEN PIPE AND SHIELD.

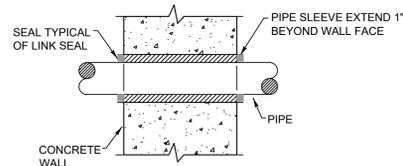
PIPE Ø (IN.)	MAX. SPACING BETWEEN HANGERS (FT.)			MIN. ROD SIZE (IN.)
	STEEL PIPE	COPPER PIPE	CPVC	
1/2 THRU 1	7	5	5	3/8
1-1/2 THRU 2	9	8	6	3/8
2-1/2	11	9	7.5	1/2
3	12	10	7.5	1/2
4	14	12	8.5	5/8
6	17	14	9	3/4
8	19	16	10	7/8
10	22	18	10.5	7/8

1 Pipe Hanger Support
M.101 N.T.S.

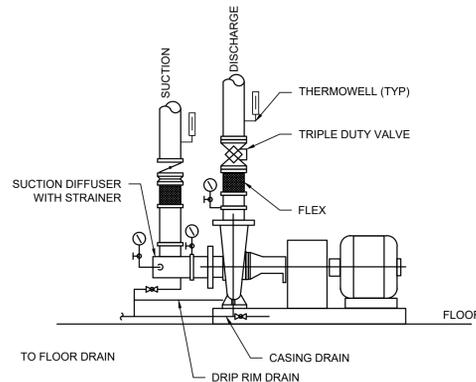


- NOTES:**
- AT FIRE RATED PARTITIONS, ADD ADDITIONAL LAYER OF FIRE SAFING INSULATION AROUND PENETRATION SO AS TO FILL CAVITY.
 - DUCT AND PIPE PENETRATIONS THRU CORRIDOR WALLS ABOVE THE CEILING ARE TO BE FIRE STOPPED AROUND THE PENETRATION.

2 Partition Wall Pipe Penetration Detail
M.101 N.T.S.

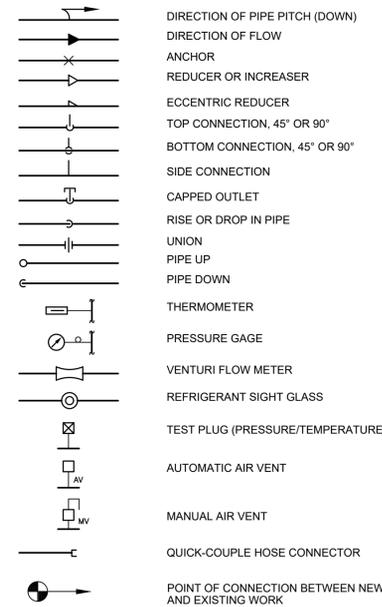


3 Exterior / Concrete Wall Pipe Penetration Detail
M.101 N.T.S.

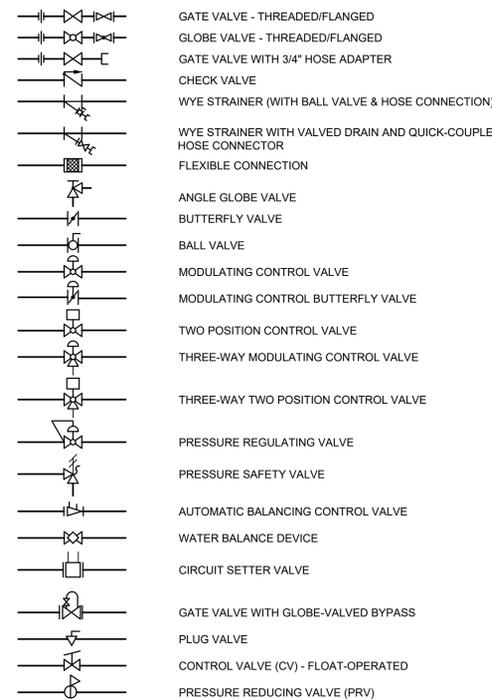


4 Base Mounted Pump Detail
M.101 N.T.S.

General Symbols:



Valve Symbols:



Mechanical Notes:

- ALL MATERIALS AND EQUIPMENT ARE TO BE NEW, UNUSED, AND FREE FROM DEFECTS OF ANY KIND. THE BASIS OF QUALITY SHALL BE THE LATEST REVISION OF ASTM, ANSI, OR OTHER ACCEPTABLE STANDARDS.
- THESE DRAWINGS ARE DIAGRAMMATIC, AND INDICATE GENERAL ARRANGEMENT OF WORK. THE CONTRACTOR SHALL BE RESPONSIBLE TO HAVE REVIEWED THE SITE FOR HIS WORK PRIOR TO HAVING SUBMITTED HIS PROPOSAL. NO ADDITIONAL COMPENSATION WILL BE ALLOWED FOR CONDITIONS FOUND DURING THE COURSE OF THE CONTRACT.
- THE CONTRACTOR SHALL COORDINATE HIS WORK WITH THAT OF ALL OTHER TRADES.
- ALL WORK INCLUDING LABOR AND MATERIALS SHALL BE FULLY GUARANTEED FOR ONE (1) YEAR FROM THE DATE OF PAYMENT AND FINAL ACCEPTANCE BY THE OWNER AND ENGINEER.
- ALL CUTTING, PATCHING, FIRE-STOPPING, AND SURFACE RESTORATION IN CONNECTION WITH THIS TRADE SHALL BE COMPLETED BY THIS CONTRACTOR.
- A MINIMUM OF FOUR (4) COPIES OF SHOP DRAWINGS SHALL BE SUBMITTED TO THE ENGINEER FOR APPROVAL PRIOR TO ORDERING AND INSTALLATION OF THE EQUIPMENT AND/OR MATERIALS. BY SUBMITTING SHOP DRAWINGS, THE CONTRACTOR REPRESENTS THAT ACTUAL FIELD CONDITIONS ARE VERIFIED BY HIM AND ARE REFLECTED ON HIS SUBMITTALS.
- THIS CONTRACTOR SHALL PAY ALL FEES, GIVE ALL NOTICES, FILE ALL NECESSARY DRAWINGS, AND OBTAIN ALL PERMITS, INSPECTIONS AND CERTIFICATES OF APPROVAL REQUIRED IN CONNECTION WITH WORK UNDER THIS CONTRACT.
- ALL WORK IN ASSOCIATION WITH THIS CONTRACT SHALL BE COMPLETED IN STRICT COMPLIANCE WITH THE 2020 BUILDING CODE OF NEW YORK STATE, 2020 MECHANICAL CODE OF NEW YORK STATE & 2020 ENERGY CONSERVATION CONSTRUCTION CODE OF NEW YORK STATE.
- ALL DUCTWORK IS TO BE CONSTRUCTED OF GALVANIZED SHEET STEEL (EXCEPT WHERE OTHERWISE SPECIFIED) WITH GAUGES, BRACING AND CONSTRUCTION IN ACCORDANCE WITH THE LATEST SMACNA DUCT MANUAL STANDARDS AND ALL OTHER AUTHORITIES HAVING JURISDICTION.
- PROVIDE MANUAL DAMPERS AT EACH SPLIT OR TAP CONNECTION TO TRUNK DUCTS FOR BALANCING PURPOSES WHETHER OR NOT SPECIFICALLY SHOWN ON DRAWINGS. EACH DAMPER SHALL BE OF THE OPPOSED BLADE DAMPER TYPE INSTALLED WITH AN OPERATOR AND LOCKING DEVICE. ALL DAMPERS LOCATED ABOVE HARD OR INACCESSIBLE CEILINGS SHALL BE INSTALLED WITH REMOTE GEAR OPERATORS.
- FURNISH & INSTALL FUSIBLE LINK FIRE DAMPERS AT ALL LOCATIONS WHERE DUCT PENETRATES FIRE-RATED FLOOR OR CEILING ASSEMBLY WHETHER OR NOT SPECIFICALLY SHOWN. INSTALL DUCTWORK CASING ACCESS DOORS AND FRAMES AHEAD OF EACH FIRE DAMPER FOR INSPECTION AND MAINTENANCE. DOORS SHALL BE A MINIMUM OF 20 GA. DOUBLE PANEL INSULATED TYPE.
- INSTALL TURNING VANES ON ALL RECTANGULAR TURNS. TURNING VANES SHALL BE DOUBLE THICKNESS TYPE CONSTRUCTED IN ACCORDANCE WITH SMACNA MANUAL.
- ROUND SHEET STEEL ELBOWS ARE TO BE INSTALLED AT THE DUCT CONNECTION TO ALL SUPPLY AIR DIFFUSERS. SHEET STEEL PLENUM BOXES ARE TO BE INSTALLED AT THE DUCT CONNECTION TO ALL RETURN AND EXHAUST AIR GRILLES. THE CONTRACTOR IS TO PAINT THE INSIDE OF THE SHEET STEEL PLENUM BOXES FLAT BLACK.
- ALL SUPPLY AND RETURN DUCTWORK LOCATED IN UNCONDITIONED SPACES OR ABOVE CEILINGS SHALL BE INSULATED WITH A MINIMUM OF R-8 INSULATION. ALL DUCTWORK LOCATED OUTSIDE THE BUILDING ENVELOPE SHALL BE INSULATED WITH A MINIMUM OF R-12 INSULATION. INSULATION SHALL BE FIBERGLASS DUCT WRAP WITH VAPOR SEAL SECURELY TAPED AROUND DUCT. IF DUCT LINING IS TO BE USED, ALL DUCT SIZES SHOWN SHALL BE CONSIDERED TO BE INSIDE CLEAR DIMENSIONS.
- INSTALL ALL DUCTWORK AS HIGH AS POSSIBLE PROVIDING RISERS, DROPS AND OFFSETS TO CLEAR STRUCTURAL MEMBERS, LIGHT FIXTURES, OTHER PIPING, AND OTHER OBSTRUCTIONS. WHERE CONFLICTS ARISE, IT SHALL BE BROUGHT TO THE ENGINEER'S ATTENTION PRIOR TO PROCEEDING.
- THE ENTIRE AIR DISTRIBUTION SYSTEM IS TO BE BALANCED TO WITHIN 10% OF THE SPECIFIED AIRFLOW REQUIREMENTS.
- THE CONTRACTOR IS RESPONSIBLE TO TEST ALL EQUIPMENT, PIPING, FIXTURES, AND SYSTEMS INSTALLED UNDER THIS CONTRACT TO ENSURE PROPER OPERATION PRIOR TO FINAL ACCEPTANCE BY THE OWNER AND ENGINEER.
- THE CONTRACTOR IS RESPONSIBLE TO DETERMINE WHETHER SPECIAL LICENSING IS REQUIRED IN ORDER TO PERFORM THE REQUIRED WORK IN THE MUNICIPALITY WHERE THE PROJECT IS LOCATED. IF THE CONTRACTOR CANNOT OBTAIN THE REQUIRED LICENSING TO COMPLETE THE WORK WITHIN THE PROJECT SCHEDULE, THEN THE CONTRACTOR SHALL NOT BE PERMITTED TO BID ON THIS PROJECT.
- CONTRACTOR IS RESPONSIBLE TO CREATE AND SUBMIT RED-LINE "AS-BUILT" PLANS TO THE ENGINEER AT THE END OF THE PROJECT. AS-BUILT PLANS SHALL ACCURATELY REPRESENT THE SYSTEMS AS THEY WERE INSTALLED.

Hydronic Piping Notes:

- ALL HYDRONIC HOT WATER PIPING AND FITTINGS ARE TO BE INSULATED WITH RIGID ONE-PIECE MOLDED SECTIONAL FIBERGLASS PIPE COVERING WITH UNIVERSAL JACKET. INSULATION SHALL BE 1-1/2" THICK FOR PIPING UP THRU 1-1/2" DIAMETER, AND 2" THICK FOR PIPING GREATER THAN 1-1/2" DIAMETER. ALL JOINTS ARE TO BE COMPLETELY SEALED A MINIMUM OF 6" BEYOND JOINT ENDS.
- ALL PIPING SHALL BE PROPERLY SUPPORTED AND ROUTED PARALLEL OR PERPENDICULAR TO BUILDING WALLS. THE CONTRACTOR SHALL FURNISH AND INSTALL ALL SUPPORT HANGERS AND MISCELLANEOUS METALS REQUIRED FOR PROPER INSTALLATION OF WORK.
- HYDRONIC PIPING SYSTEM MATERIALS ARE TO BE AS FOLLOWS:
 - PIPING UP THRU 3" DIAMETER IS TO BE TYPE L HARD DRAWN SEAMLESS COPPER TUBING MADE IN ACCORDANCE WITH ASTM B 88 WITH WROUGHT COPPER FITTINGS MADE IN ACCORDANCE WITH ASME B 16.22. JOINTS SHALL BE MADE BY APPLYING A FLUX CONFORMING WITH ASTM B 813, AND SOLDERED WITH A 95-5 LEAD-FREE SOLDER CONFORMING TO ASTM B 32.
 - PIPING GREATER THAN 3" DIAMETER IS TO BE SCHEDULE 40 GRADE B SEAMLESS CARBON STEEL MADE IN ACCORDANCE WITH ASTM A 53 WITH FITTINGS MADE IN ACCORDANCE WITH ASTM B 16.9. JOINTS SHALL BE WELDED, OR MAY BE MADE USING GROOVED AND SHOULDERS MECHANICAL JOINTS CONFORMING TO THE REQUIREMENTS OF ASTM F 1476.
- FURNISH & INSTALL DIELECTRIC UNIONS WHERE JOINING STEEL TO COPPER PIPING.
- ALL PIPING SHALL BE PITCHED SUCH THAT AIR IN THE SYSTEM CAN BE VENTED THROUGH MANUAL AIR VENTS.
- TEST PIPING AND PROVE TIGHT FOR AT LEAST TWO HOURS TO TWICE THE SYSTEM WORKING PRESSURE. TEST SHALL BE PERFORMED IN THE PRESENCE OF THE ENGINEER AND LOCAL INSPECTOR. TEST SHALL BE REPEATED IF NECESSARY UNTIL FINAL APPROVAL OF SYSTEM IS OBTAINED.
- SUPPORT HORIZONTAL PIPING UTILIZING A SPACING PER PIPING MANUFACTURER'S REQUIREMENTS.
- INSTALL VALVES ON THE ENTIRE DISTRIBUTION SYSTEM, SO LOCATED AS TO GIVE COMPLETE CONTROL TO ALL FIXTURES AND EQUIPMENT.
- INSTALL DRAIN VALVES AT BASE OF ALL RISERS AND AT LOW POINTS OF PIPING SYSTEM. INSTALL MANUAL AIR VENT VALVE FACILITIES AT THE TOP OF ALL RISERS AND AT HIGH POINTS OF THE PIPING SYSTEM.
- PROVIDE PROPER PROVISION FOR EXPANSION/CONTRACTION OF PIPING TO PREVENT STRAIN ON THE SYSTEM AND/OR THE BUILDING STRUCTURE.
- INSTALL ALL HYDRONIC PIPING AS HIGH AS POSSIBLE PROVIDING RISERS, DROPS AND OFFSETS TO CLEAR STRUCTURAL MEMBERS, LIGHT FIXTURES, OTHER PIPING, AND OTHER OBSTRUCTIONS. WHERE CONFLICTS ARISE, IT SHALL BE BROUGHT TO THE ENGINEER'S ATTENTION PRIOR TO PROCEEDING.
- THE ENTIRE HYDRONIC SYSTEM IS TO BE BALANCED TO WITHIN 10% OF THE SPECIFIED WATER FLOWRATE REQUIREMENTS. A CERTIFIED BALANCING REPORT AND VERIFICATION IS TO BE SUBMITTED TO THE ENGINEER PRIOR TO FINAL ACCEPTANCE.

PUMP SCHEDULE

EQUIPMENT TAG	MANUFACTURER (OR ACCEPT. EQUAL)	MODEL	LOCATION	AREA SERVED	PUMP TYPE	CIRCULATING FLUID				MOTOR					NOTES	
						FLUID	G.P.M.	HEAD (FT.)	TEMP. (°F)	NOM. H.P.	VOLT.	PHASE	HZ.	RPM		FLA
P-6A	TACO	FI6011D	CHILLER ROOM	COOLING TOWER	BASE MOUNTED	CONDENSER WATER	1650	75	95	40	480	3	60	1760	52	-
P-6B	TACO	FI6011D	CHILLER ROOM	COOLING TOWER	BASE MOUNTED	CONDENSER WATER	1650	75	95	40	480	3	60	1760	52	-
P-7A	TACO	FI6011D	CHILLER ROOM	CHILLER	BASE MOUNTED	CHILLED WATER	1285	75	44	40	480	3	60	1760	52	-
P-7B	TACO	FI6011D	CHILLER ROOM	CHILLER	BASE MOUNTED	CHILLED WATER	1285	75	44	40	480	3	60	1760	52	-

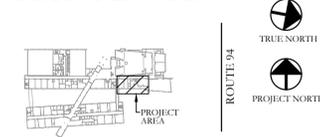
COOLING TOWER SCHEDULE

EQUIPMENT TAG	MANUFACTURER (OR ACCEPT. EQUAL)	MODEL	LOCATION	SERVES	EWT (°F)	LWT (°F)	AMBIENT WB (°F)	FLOW RATE (GPM)	SUMP CAPACITY (GAL)	DRY WEIGHT (LBS)	OPERATING WEIGHT (LBS)	SHELL MATERIAL	FAN MOTORS						NOTES	
													QTY.	NOM. H.P.	VOLT.	PHASE	HZ.	RPM		FLA
CT-1	DELTA	TM-203312	ROOF	EXISTING CHILLER	95	85	75	1,650	960	13,000	24,400	POLYETHYLENE (HDPE)	4	3.0	480	3	60	900	4.8	1-7

- PROVIDE W/ PREMIUM EFFICIENT VFD RATED MOTORS
- PROVIDE W/ ALUMINUM LADDER AND OSHA SAFETY CAGE
- PROVIDE W/ UPPER SAFETY HANDRAIL SYSTEM & SAFETY GATE
- PROVIDE W/ PVC MESH SCREEN OUTLET STRAINER
- PROVIDE W/ NEMA 4X VIBRATION CUT OFF SWITCH W/ MANUAL RESET
- PROVIDE W/ ANTI-MICROBIAL HDPE BLUE RESIN
- PROVIDE W/ NEMA 3R VFD W/ MANUAL BYPASS PACKAGE

KEY PLAN:

'CORNWALL CENTRAL HIGH SCHOOL'

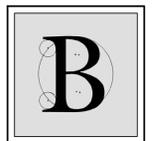


PROJECT:

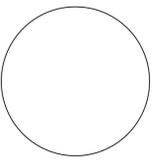
CORNWALL CENTRAL HIGH SCHOOL COOLING TOWER REPLACEMENT PROJECT
10 DRAGON DRIVE
NEW WINDSOR, NEW YORK 12553
SED #:44-03-01-06-0-012-008

SUB-CONSULTANT:

ENGINEER:



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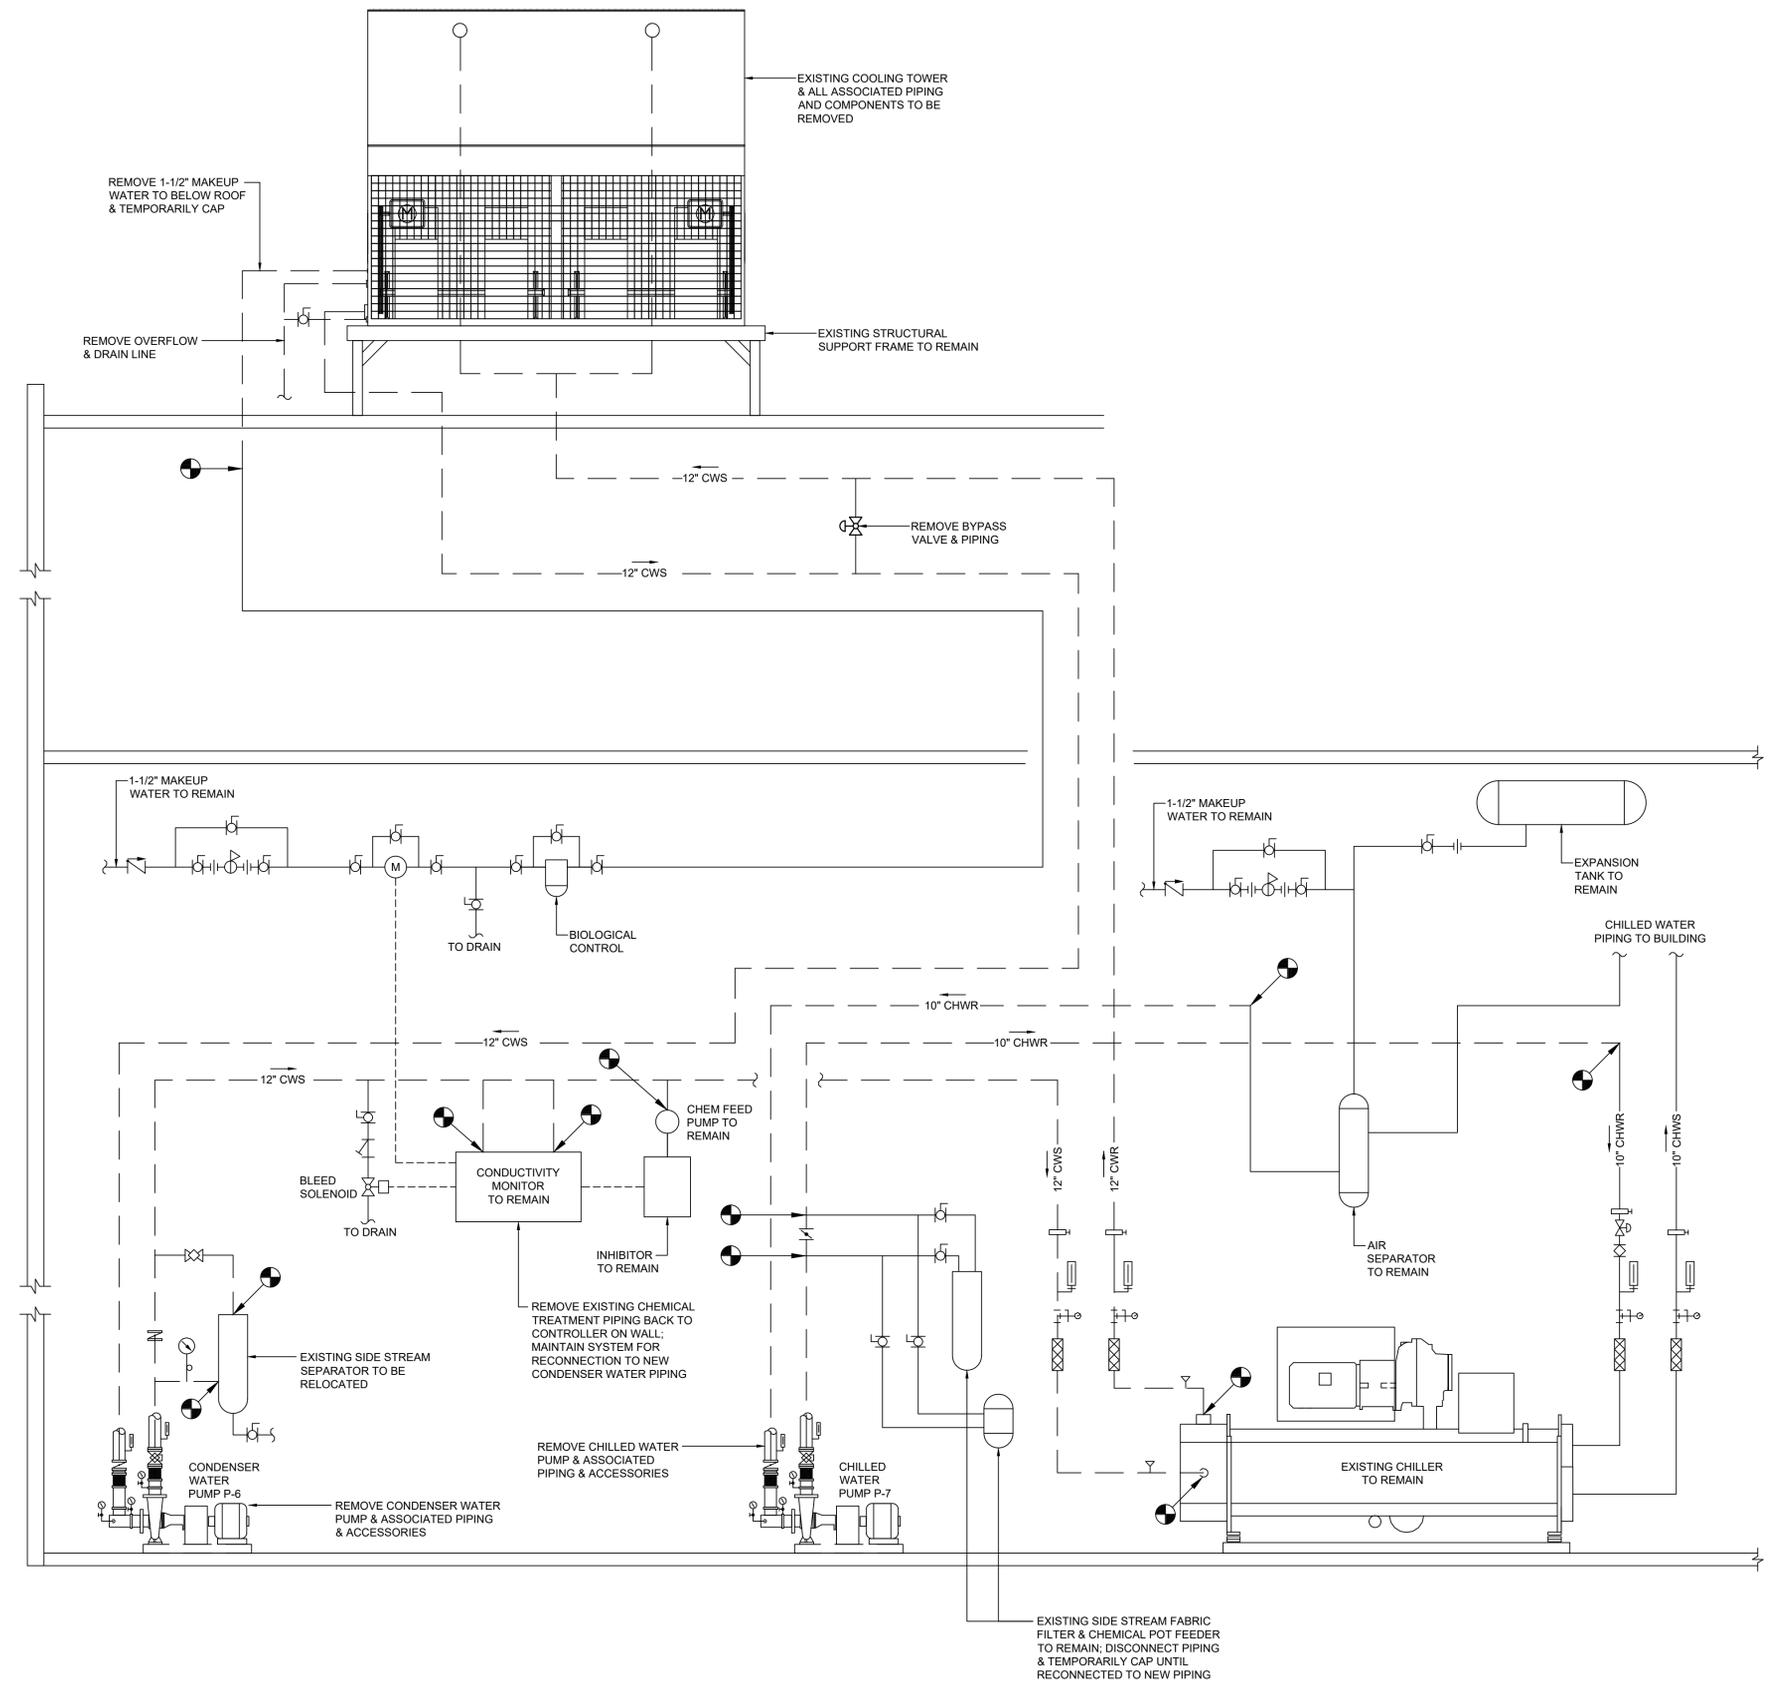
MECHANICAL NOTES, SYMBOLS, DETAILS & SCHEDULES

DATE	DRN	CHK	DESCRIPTION
05.27.2022	BJK	MGB	CONSTRUCTION SET

REV.	DATE	DRN	CHK	DESCRIPTION

PROJECT NO. **2149** SHEET NO. **M.101**

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1 Cooling Tower Demolition Piping Diagram
M.102 N.T.S.

KEY PLAN:
'CORNWALL CENTRAL HIGH SCHOOL'

ROUTE 94
TRUE NORTH
PROJECT NORTH

PROJECT:
CORNWALL CENTRAL HIGH SCHOOL COOLING TOWER REPLACEMENT PROJECT
10 DRAGON DRIVE
NEW WINDSOR, NEW YORK 12553
SED #:44-03-01-06-0-012-008

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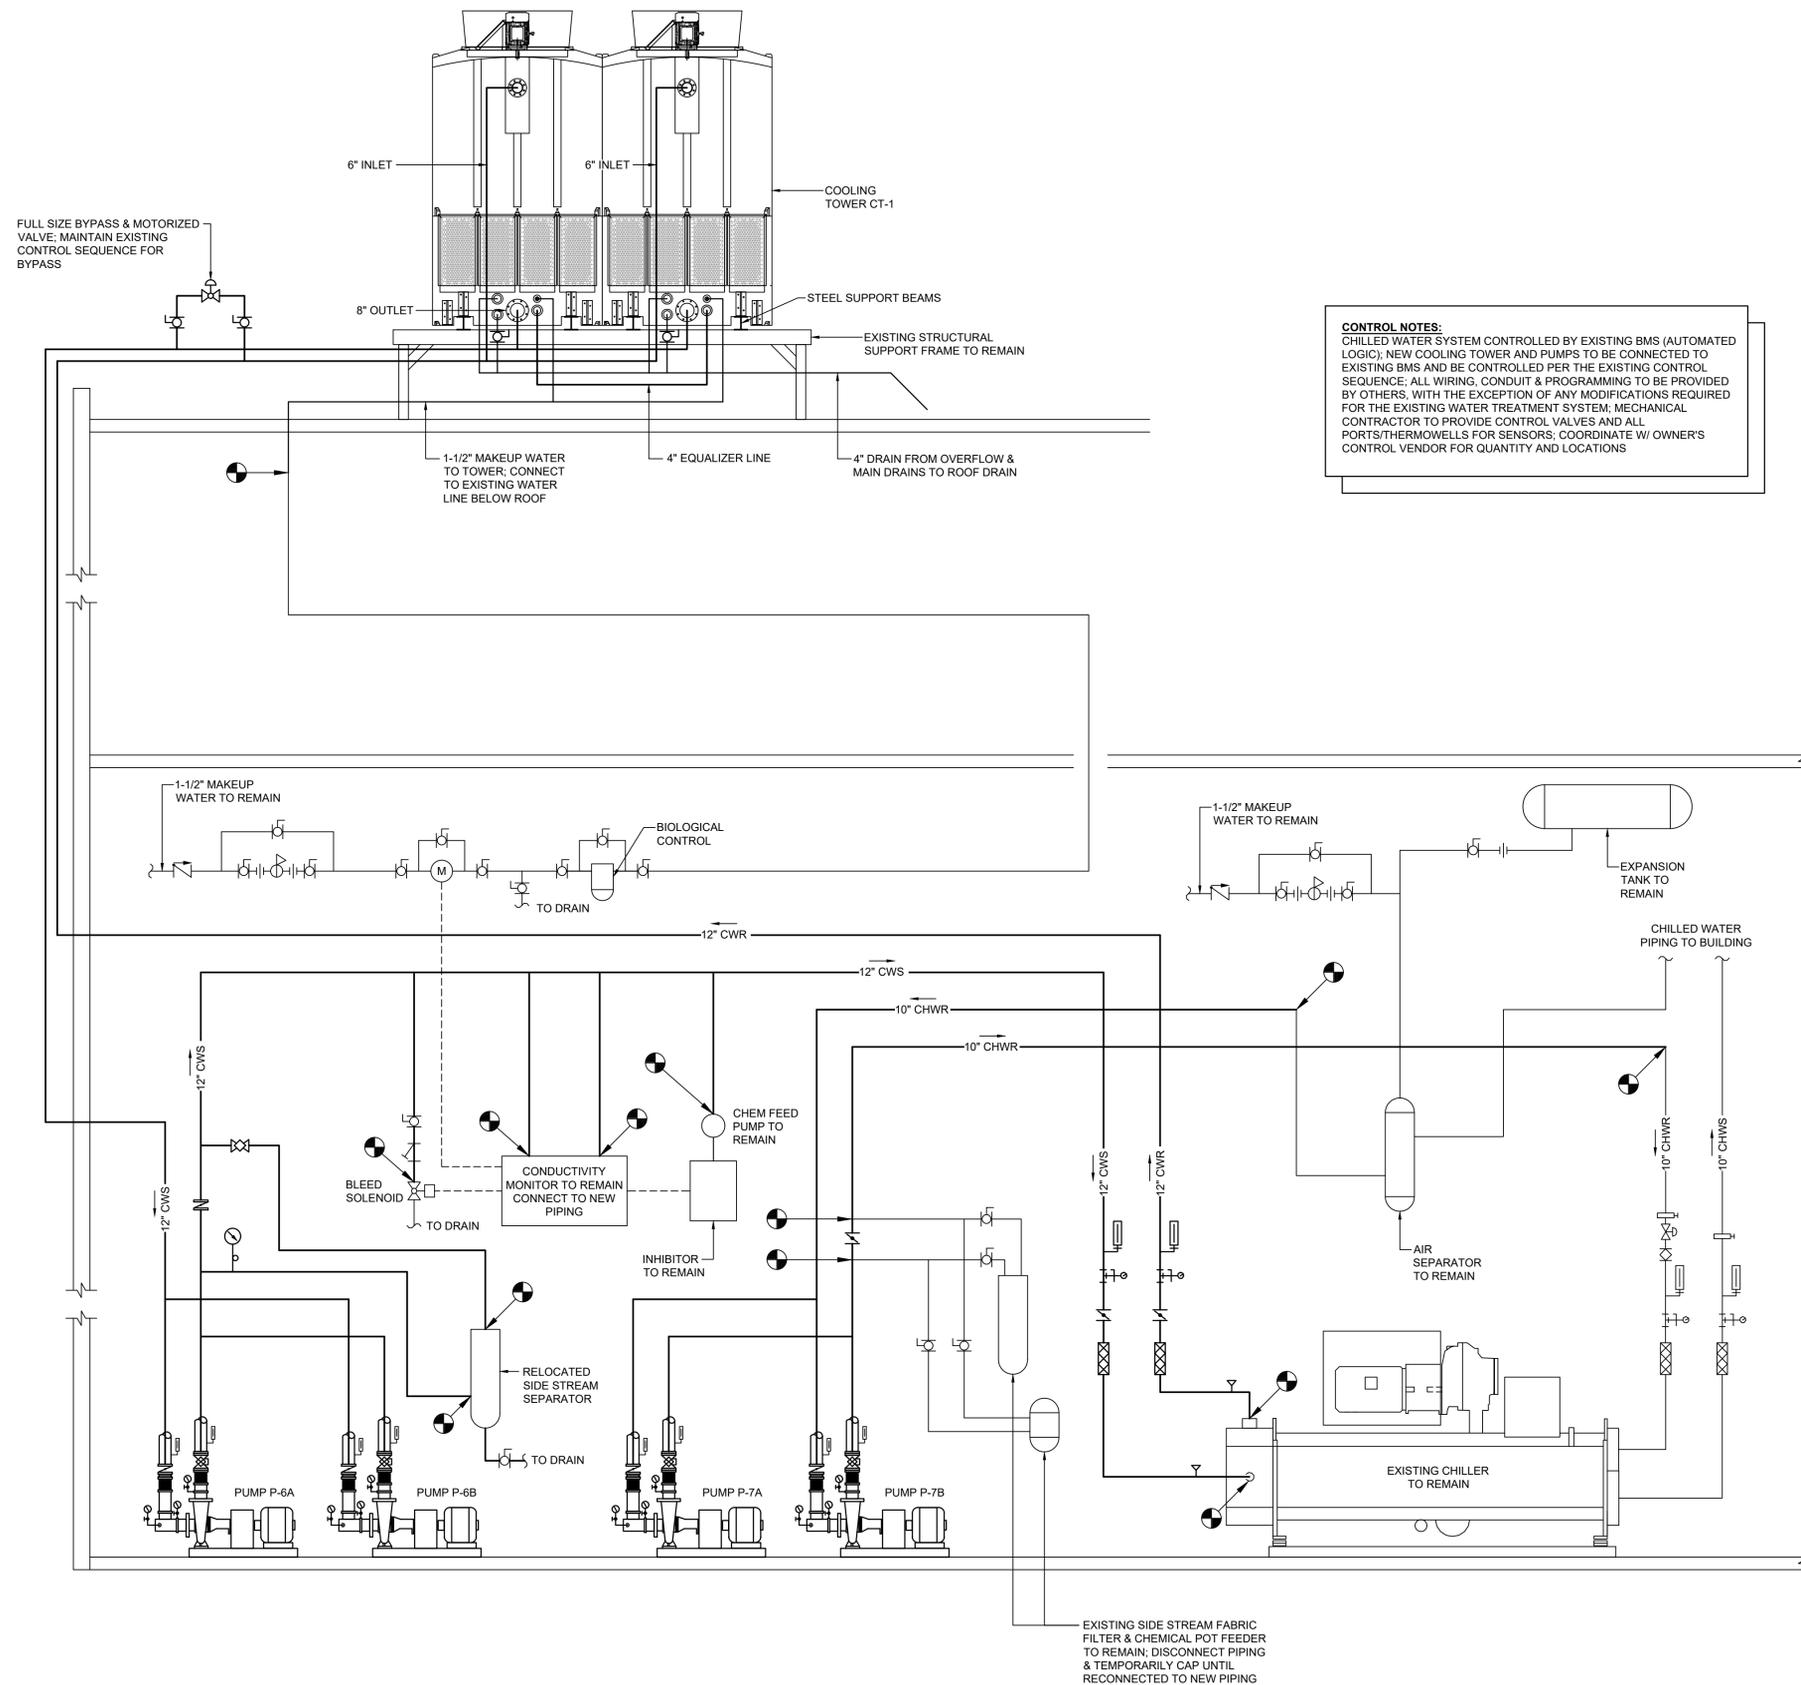
COOLING TOWER DEMOLITION PIPING DIAGRAM

DATE	DRN	CHK	DESCRIPTION
05.27.2022	BJK	MGB	CONSTRUCTION SET

REV.	DATE	DRN	CHK	DESCRIPTION

PROJECT NO. 2149	SHEET NO. M.102
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CONTROL NOTES:
 CHILLED WATER SYSTEM CONTROLLED BY EXISTING BMS (AUTOMATED LOGIC); NEW COOLING TOWER AND PUMPS TO BE CONNECTED TO EXISTING BMS AND BE CONTROLLED PER THE EXISTING CONTROL SEQUENCE; ALL WIRING, CONDUIT & PROGRAMMING TO BE PROVIDED BY OTHERS, WITH THE EXCEPTION OF ANY MODIFICATIONS REQUIRED FOR THE EXISTING WATER TREATMENT SYSTEM; MECHANICAL CONTRACTOR TO PROVIDE CONTROL VALVES AND ALL PORTS/THERMOWELLS FOR SENSORS; COORDINATE W/ OWNER'S CONTROL VENDOR FOR QUANTITY AND LOCATIONS

FULL SIZE BYPASS & MOTORIZED VALVE; MAINTAIN EXISTING CONTROL SEQUENCE FOR BYPASS

6" INLET
 6" INLET
 COOLING TOWER CT-1
 8" OUTLET
 STEEL SUPPORT BEAMS
 EXISTING STRUCTURAL SUPPORT FRAME TO REMAIN

1-1/2" MAKEUP WATER TO TOWER; CONNECT TO EXISTING WATER LINE BELOW ROOF
 4" EQUALIZER LINE
 4" DRAIN FROM OVERFLOW & MAIN DRAINS TO ROOF DRAIN

1-1/2" MAKEUP WATER TO REMAIN
 BIOLOGICAL CONTROL
 TO DRAIN
 1-1/2" MAKEUP WATER TO REMAIN
 EXPANSION TANK TO REMAIN
 CHILLED WATER PIPING TO BUILDING

12" CWS
 10" CHWR
 12" CWS
 12" CWR
 10" CHWR
 10" CHWR
 12" CWS
 12" CWR
 10" CHWR
 10" CHWS
 CHEM FEED PUMP TO REMAIN
 INHIBITOR TO REMAIN
 AIR SEPARATOR TO REMAIN
 EXISTING CHILLER TO REMAIN
 PUMP P-6A
 PUMP P-6B
 PUMP P-7A
 PUMP P-7B
 RELOCATED SIDE STREAM SEPARATOR
 BLEED SOLENOID TO DRAIN
 CONDUCTIVITY MONITOR TO REMAIN CONNECT TO NEW PIPING

EXISTING SIDE STREAM FABRIC FILTER & CHEMICAL POT FEEDER TO REMAIN; DISCONNECT PIPING & TEMPORARILY CAP UNTIL RECONNECTED TO NEW PIPING

KEY PLAN:
 'CORNWALL CENTRAL HIGH SCHOOL'

 TRUE NORTH
 PROJECT NORTH

PROJECT:
 CORNWALL CENTRAL HIGH SCHOOL COOLING TOWER REPLACEMENT PROJECT
 10 DRAGON DRIVE
 NEW WINDSOR, NEW YORK 12553
 SED #:44-03-01-06-0-012-008

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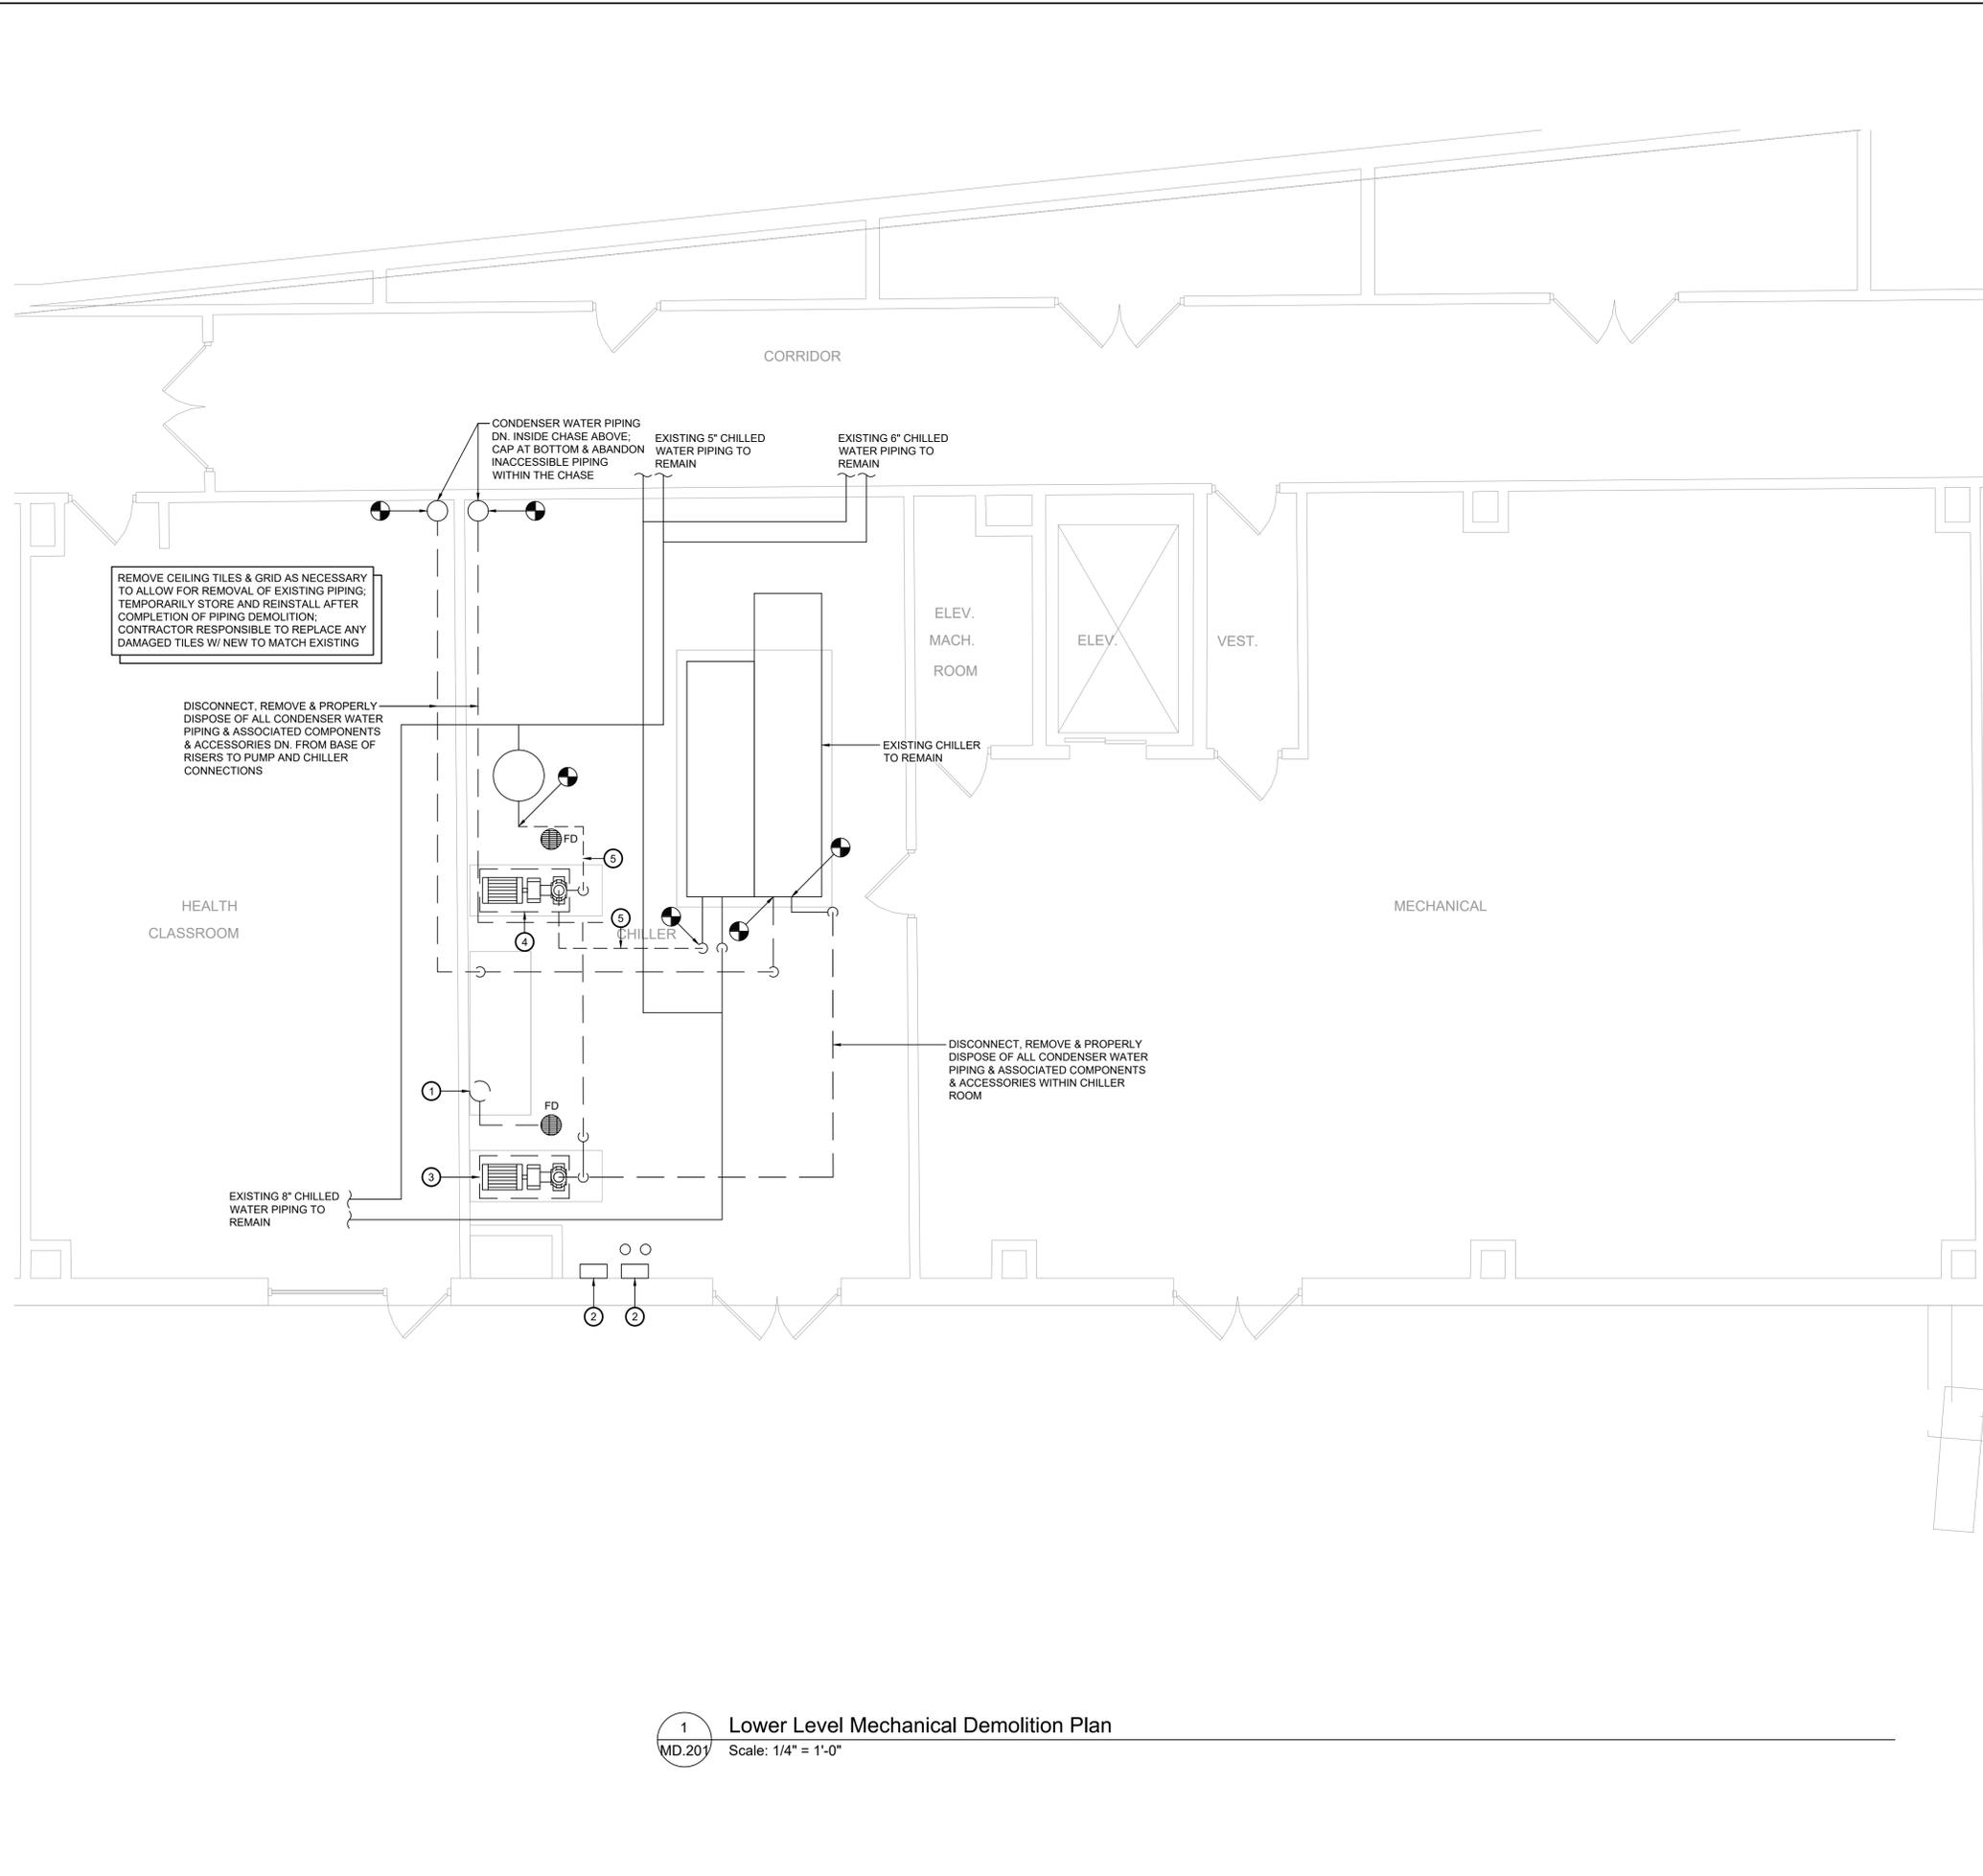
COOLING TOWER PIPING DIAGRAM

DATE	DRN	CHK	DESCRIPTION
05.27.2022	BJK	MGB	CONSTRUCTION SET

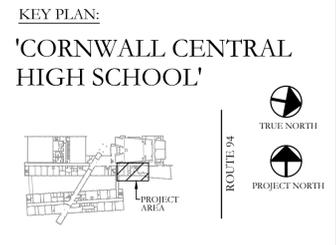
REV.	DATE	DRN	CHK	DESCRIPTION

PROJECT NO. **2149** SHEET NO. **M.103**

1 Cooling Tower Piping Diagram
 M.103 N.T.S.



- Key Notes:**
- ① DISCONNECT, REMOVE & PROPERLY DISPOSE OF EXISTING SEPARATOR FILTRATION SYSTEM AND ALL ASSOCIATED PIPING, VALVES AND CONTROLS
 - ② EXISTING WATER TREATMENT SYSTEM TO REMAIN. REMOVE ALL PIPING (SAMPLING, CHEMICAL INJECTION, ETC.) FROM CONNECTIONS AT CONDENSER WATER PIPING BACK TO THE CONTROLLERS AT THE WALL
 - ③ DISCONNECT, REMOVE & PROPERLY DISPOSE OF EXISTING CONDENSER WATER PUMP AND ALL ASSOCIATED ACCESSORIES, VALVES, ETC.
 - ④ DISCONNECT, REMOVE & PROPERLY DISPOSE OF EXISTING CHILLED WATER PUMP AND ALL ASSOCIATED ACCESSORIES, VALVES, ETC.
 - ⑤ DISCONNECT, REMOVE & PROPERLY DISPOSE OF EXISTING CHILLED WATER PIPING AND ALL ASSOCIATED ACCESSORIES, VALVES, ETC. FROM THE PUMP TO THE LOCATIONS SHOWN



PROJECT:
CORNWALL CENTRAL HIGH SCHOOL COOLING TOWER REPLACEMENT PROJECT
 10 DRAGON DRIVE
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LOWER LEVEL MECHANICAL DEMOLITION PLAN

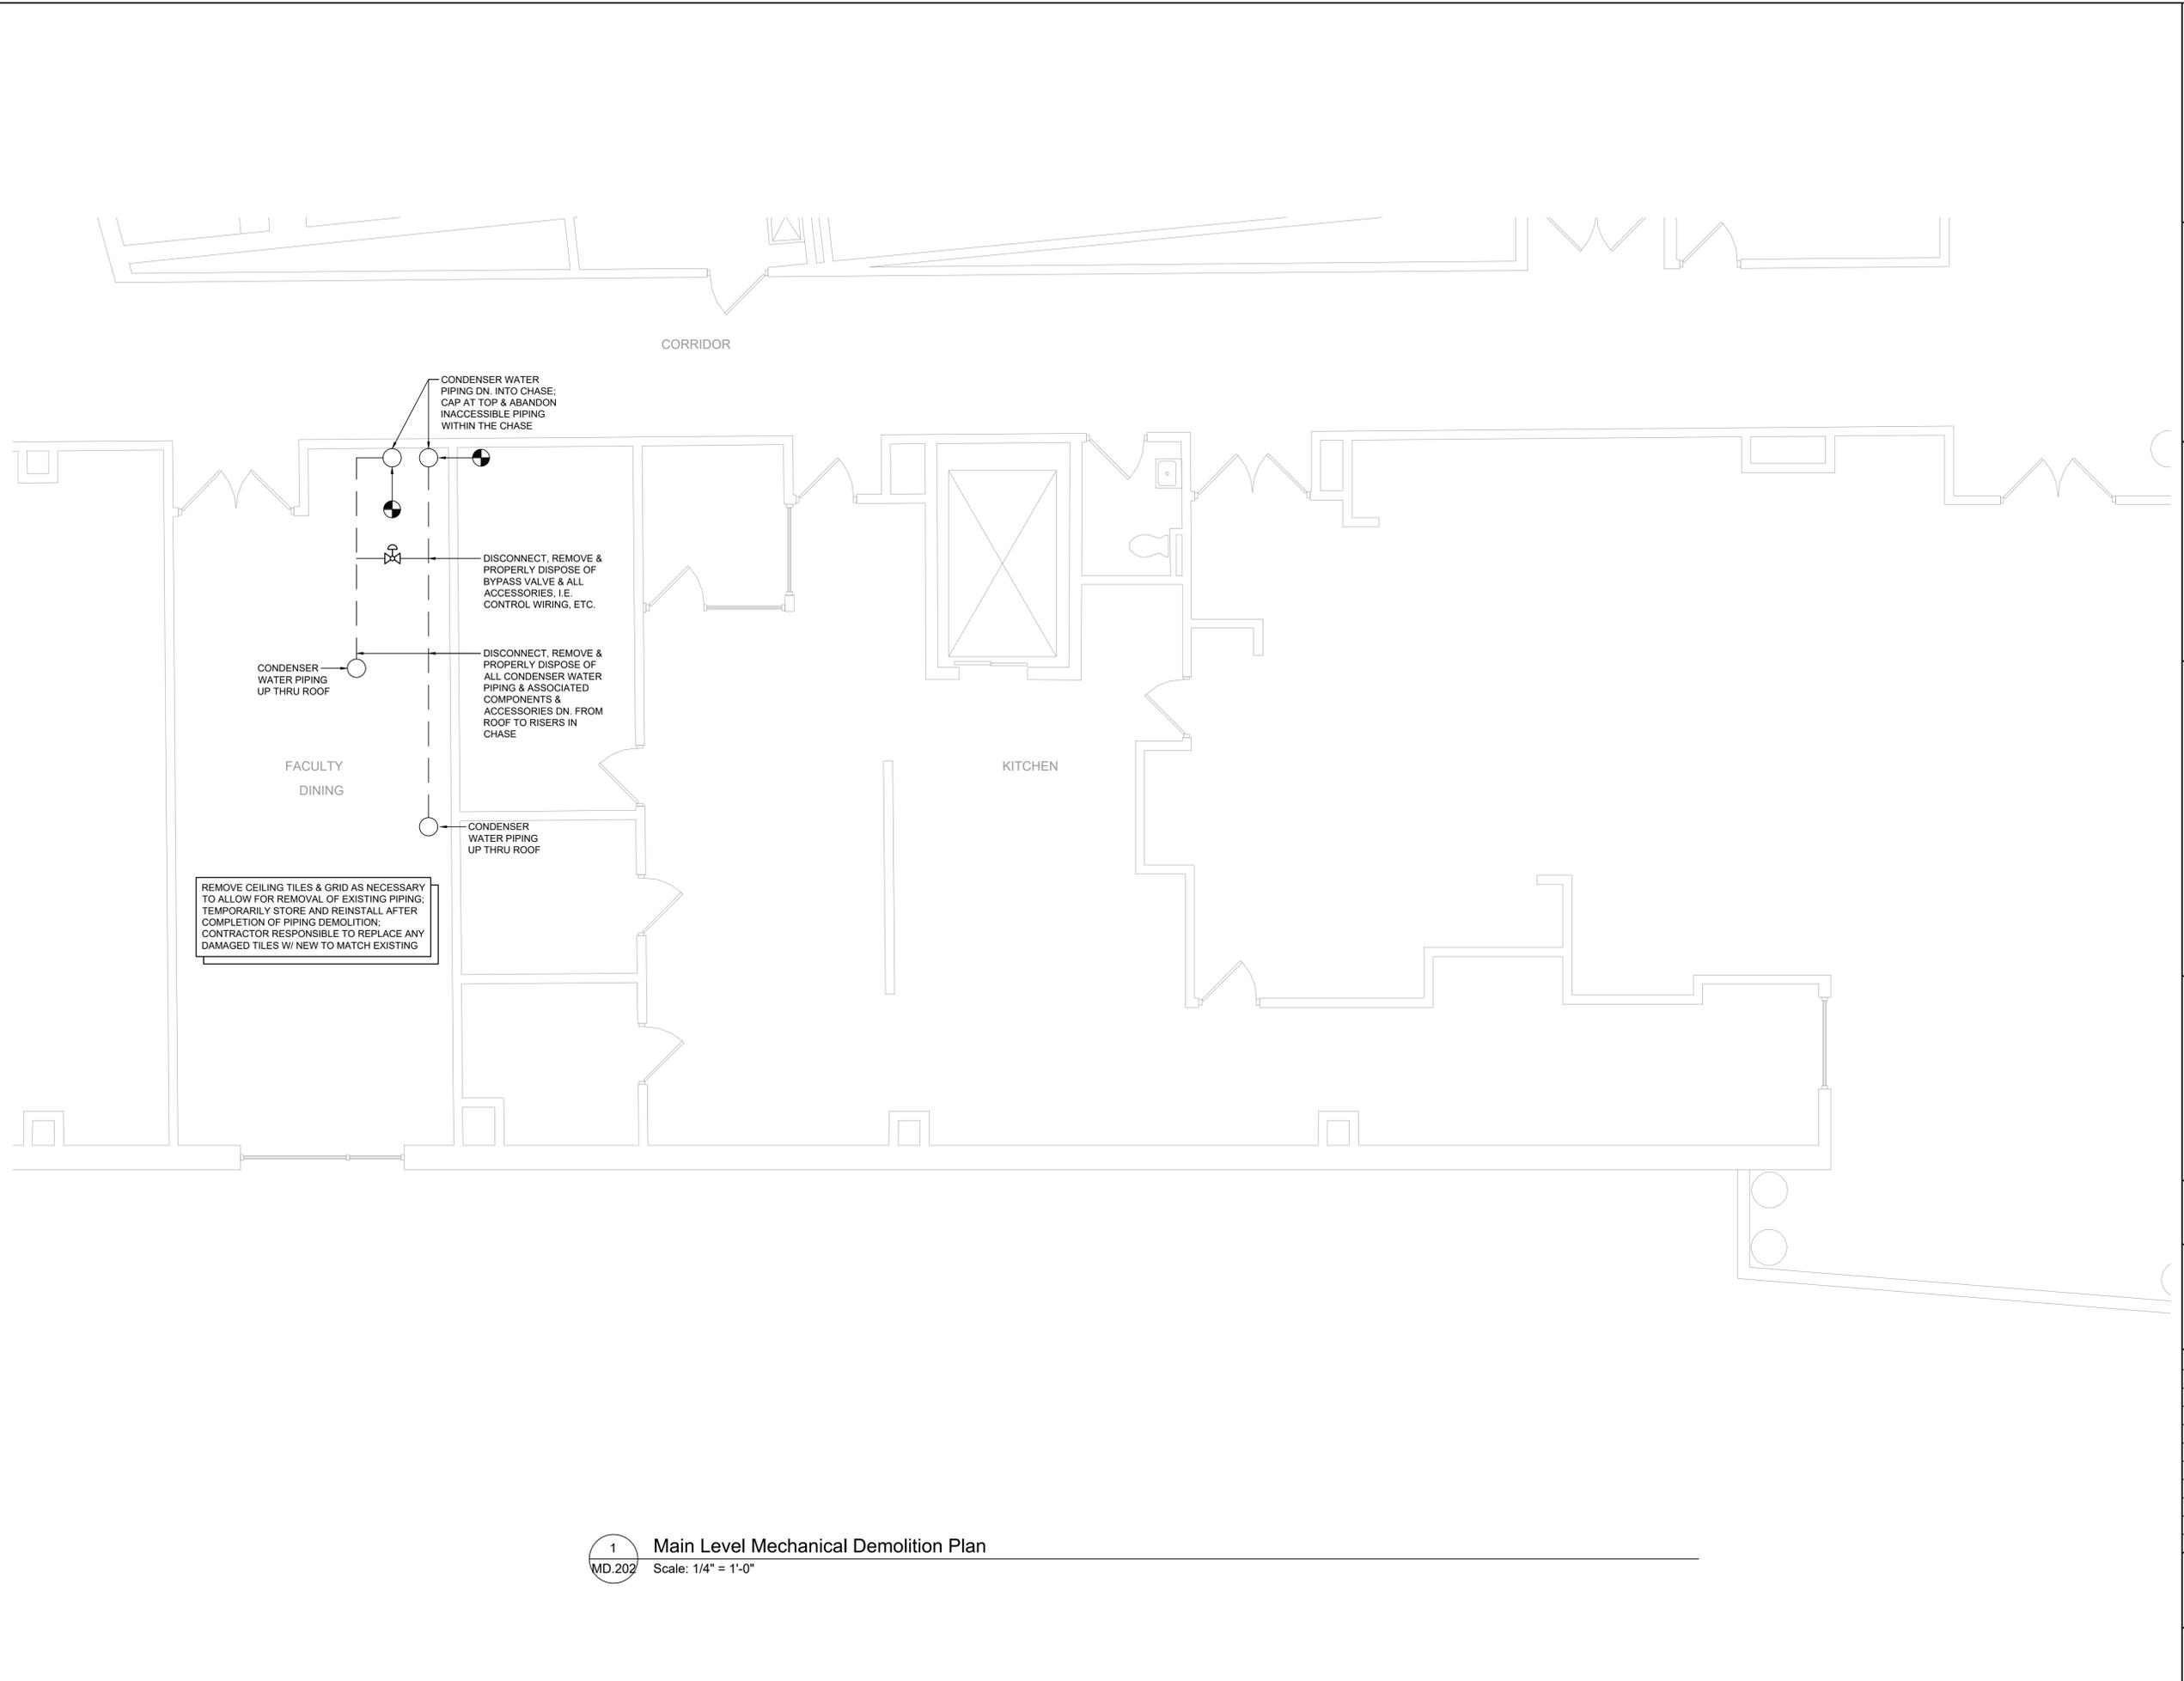
DATE:	DRN:	CHK:	DESCRIPTION:
05.27.2022	BJK	MGB	CONSTRUCTION SET

REV.	DATE:	DRN:	CHK:	DESCRIPTION:

PROJECT NO. 2149	SHEET NO. MD.201
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1 Lower Level Mechanical Demolition Plan
 MD.201 Scale: 1/4" = 1'-0"



KEY PLAN:
'CORNWALL CENTRAL HIGH SCHOOL'

ROUTE 94
 TRUE NORTH
 PROJECT NORTH

PROJECT:
CORNWALL CENTRAL HIGH SCHOOL COOLING TOWER REPLACEMENT PROJECT
 10 DRAGON DRIVE
 NEW WINDSOR, NEW YORK 12553
 SED #44-03-01-06-0-012-008

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MAIN LEVEL MECHANICAL DEMOLITION PLAN

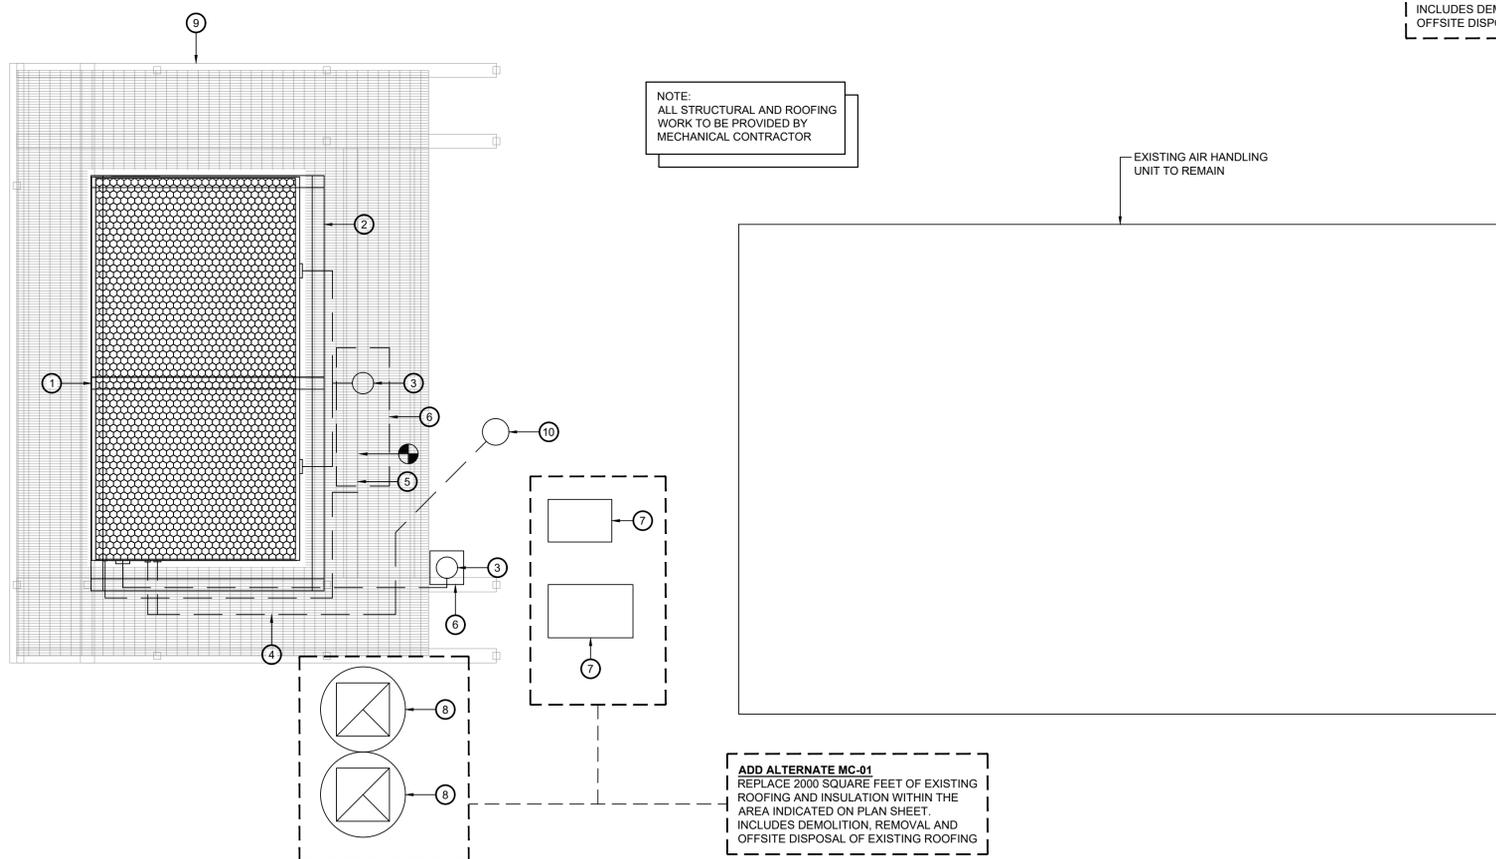
DATE	DRN	CHK	DESCRIPTION
05.27.2022	BJK	MGB	CONSTRUCTION SET

REV.	DATE	DRN	CHK	DESCRIPTION

PROJECT NO. 2149	SHEET NO. MD.202
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1 Main Level Mechanical Demolition Plan
 Scale: 1/4" = 1'-0"

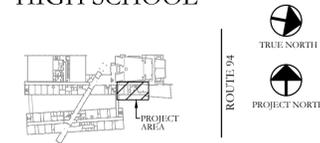


Key Notes:

- ① DISCONNECT, REMOVE & PROPERLY DISPOSE OF EXISTING EVAPORATIVE COOLING TOWER AND ALL ASSOCIATED COMPONENTS AND ACCESSORIES
- ② EXISTING COOLING TOWER SUPPORT STRUCTURE TO REMAIN
- ③ DISCONNECT, REMOVE & PROPERLY DISPOSE OF ALL EXISTING CONDENSER WATER PIPING & ALL ASSOCIATED COMPONENTS & ACCESSORIES
- ④ DISCONNECT, REMOVE & PROPERLY DISPOSE OF ALL EXISTING DRAIN PIPING & ALL ASSOCIATED COMPONENTS & ACCESSORIES
- ⑤ DISCONNECT, REMOVE & PROPERLY DISPOSE OF EXISTING 1-1/2" COPPER MAKEUP WATER PIPING & ALL ASSOCIATED COMPONENTS & ACCESSORIES FROM COOLING TOWER TO BELOW ROOF; MAINTAIN WATER LINE BELOW ROOF FOR RECONNECTION TO NEW COOLING TOWER
- ⑥ DISCONNECT, REMOVE & PROPERLY DISPOSE OF EXISTING ROOF CURB; INFILL ROOF DECK W/ MATERIAL TO MATCH EXISTING DECK
- ⑦ EXISTING FREEZER/COOLER CONDENSING UNIT TO BE DISCONNECTED, REMOVED & STORED FOR REINSTALLATION; RECOVER REFRIGERANT & STORE UNTIL SYSTEM IS REINSTALLED; TEMPORARILY CAP PIPING; DISPOSE OF EXISTING WOOD BLOCKING; DEMOLISH EXISTING PITCH POCKETS; REFRIGERANT PIPING AND WIRING TO BE ROUTED THROUGH NEW PIPE PORTAL/ ROOF CURB
- ⑧ EXISTING EXHAUST FAN TO BE DISCONNECTED, REMOVED & STORED FOR REINSTALLATION; TEMPORARILY CAP DUCTWORK TO KEEP SYSTEM CLEAN UNTIL FAN IS REINSTALLED
- ⑨ EXISTING COOLING TOWER PLATFORM TO BE DISCONNECTED, REMOVED & PROPERLY DISPOSED OF; REMOVE ALL ASSOCIATED COMPONENTS INCLUDING BUT NOT LIMITED TO LADDER, GRATING, GUARDRAILS, & STRUCTURAL SUPPORTS (BEAMS, COLUMNS, CROSS BRACING, ETC.); REMOVE COLUMNS DOWN TO ROOF STRUCTURE
- ⑩ EXISTING ROOF DRAIN TO REMAIN; REPLACE DRAIN TOP GRATE W/ NEW

KEY PLAN:

'CORNWALL CENTRAL HIGH SCHOOL'

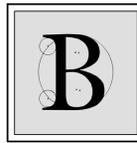


PROJECT:

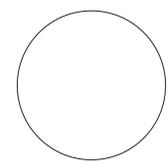
CORNWALL CENTRAL HIGH SCHOOL
COOLING TOWER REPLACEMENT PROJECT
10 DRAGON DRIVE
NEW WINDSOR, NEW YORK 12553
SED #:44-03-01-06-0-012-008

SUB-CONSULTANT:

ENGINEER:



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1898 COUNTY ROUTE 1
WESTTOWN, NEW YORK 10998
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NOT VALID FOR CONSTRUCTION UNLESS SIGNED AND SEALED BY ENGINEER

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MA - 53197 CT - 32283 FL - 85928

ROOF MECHANICAL DEMOLITION PLAN

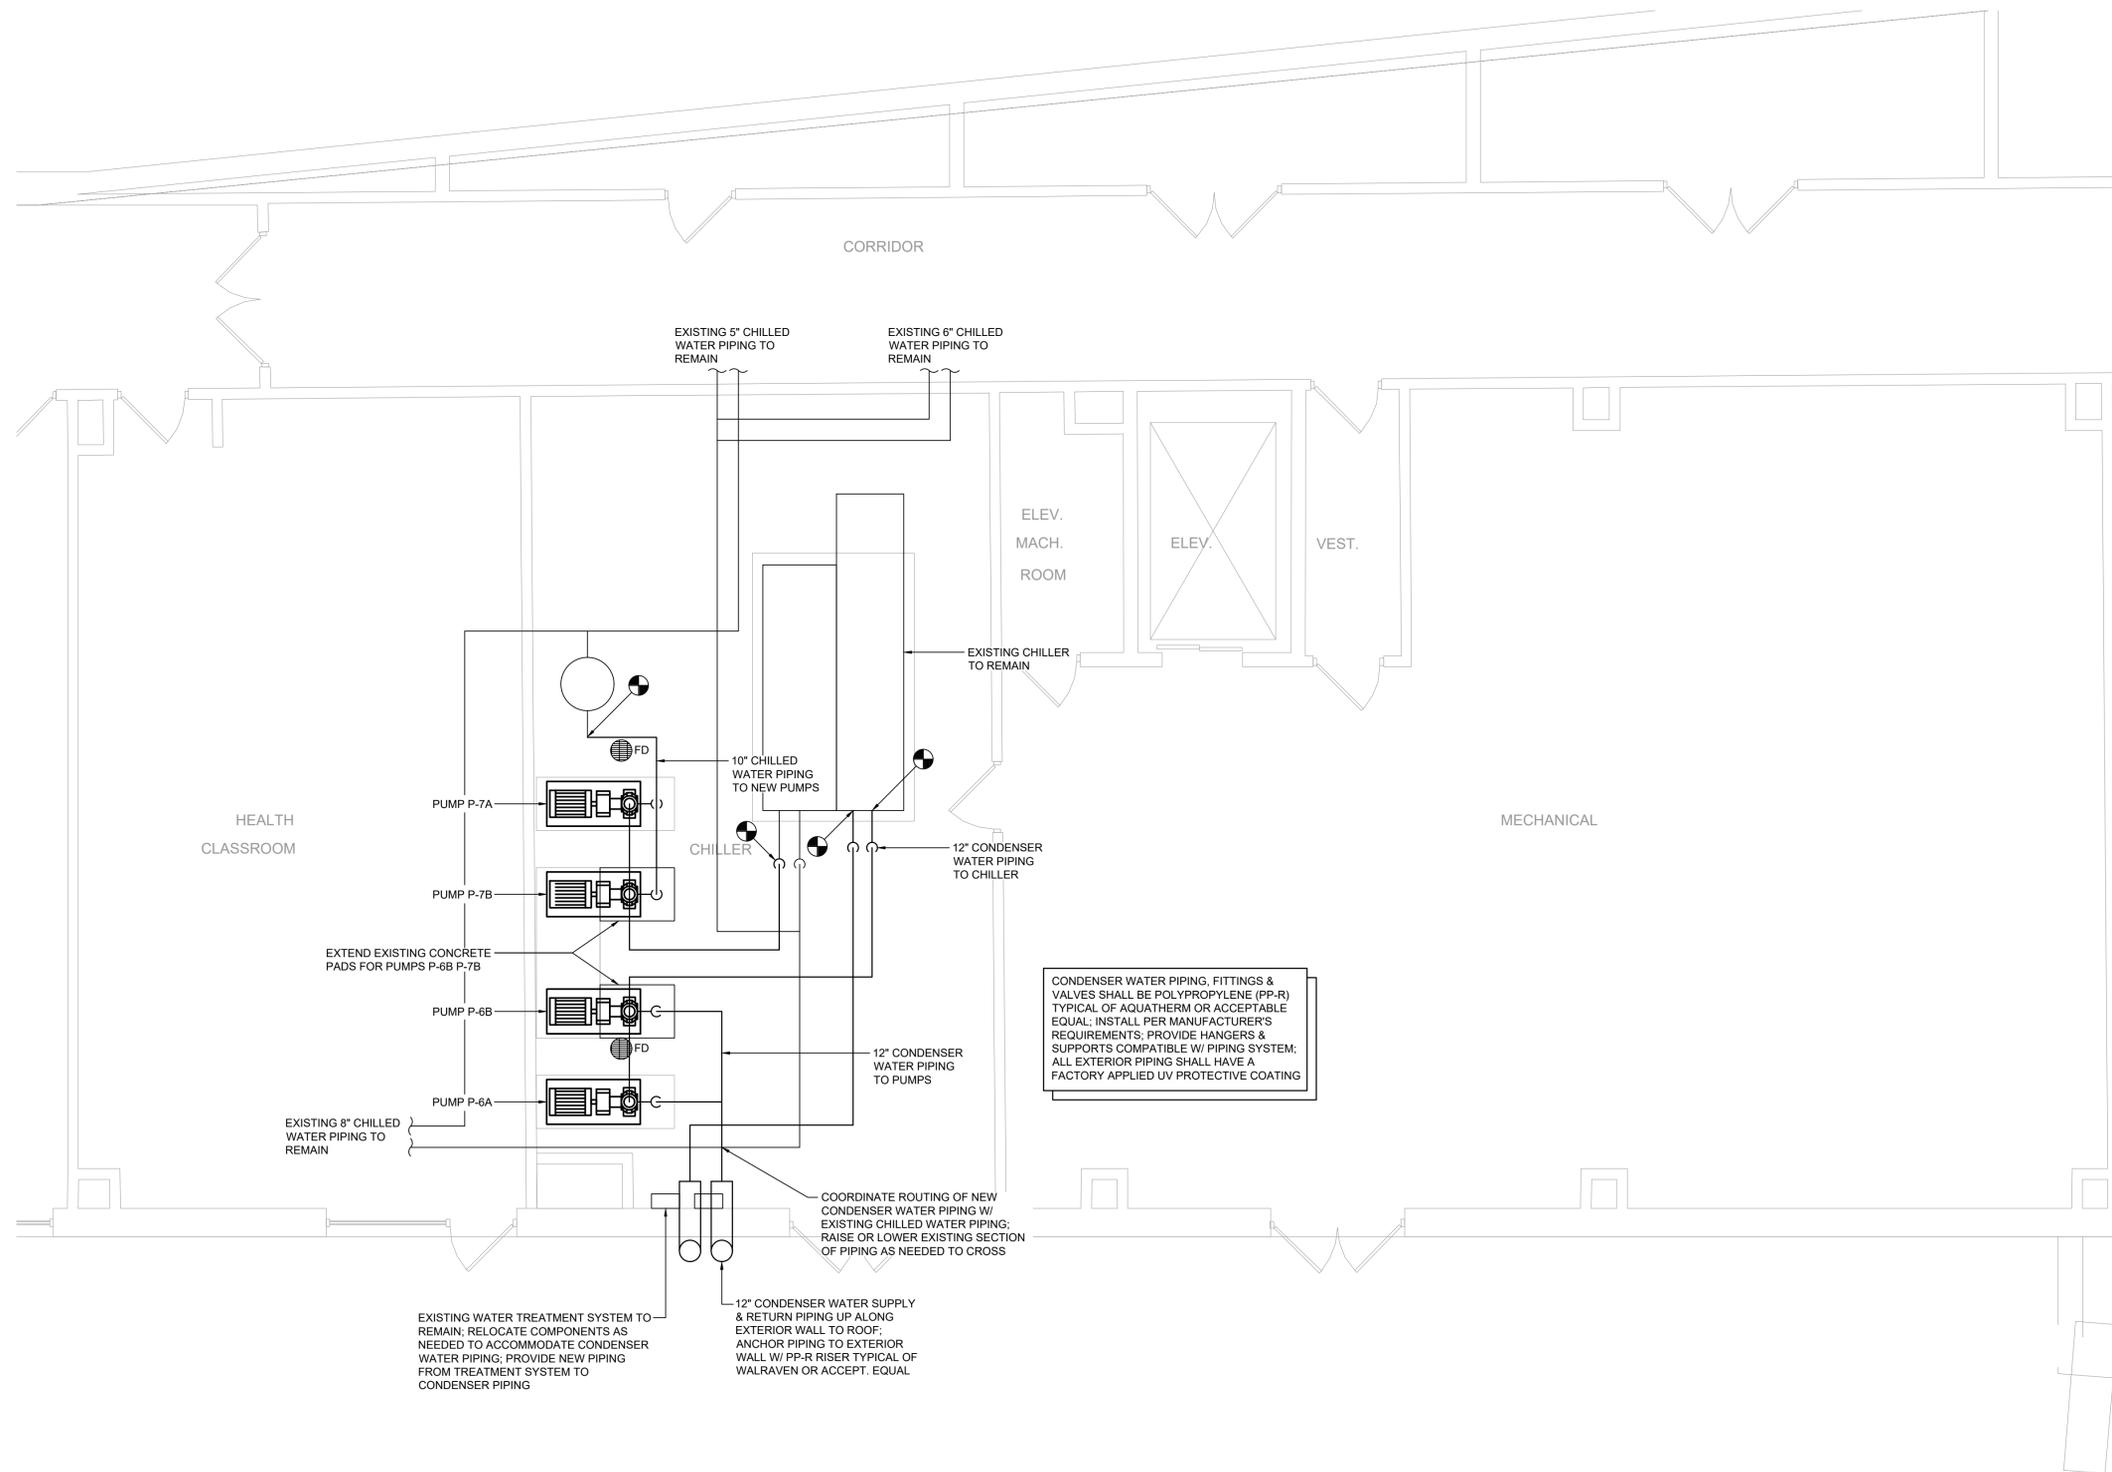
DATE	DRN	CHK	DESCRIPTION
05.27.2022	BJK	MGB	CONSTRUCTION SET

REV.	DATE	DRN	CHK	DESCRIPTION

PROJECT NO. 2149	SHEET NO. MD.203
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1 Roof Mechanical Demolition Plan
MD.203 Scale: 1/4" = 1'-0"



1 Lower Level Mechanical Plan
 M.201 Scale: 1/4" = 1'-0"

KEY PLAN:
 'CORNWALL CENTRAL HIGH SCHOOL'

ROUTE 94
 TRUE NORTH
 PROJECT NORTH

PROJECT:
 CORNWALL CENTRAL HIGH SCHOOL
 COOLING TOWER REPLACEMENT PROJECT
 10 DRAGON DRIVE
 NEW WINDSOR, NEW YORK 12553
 SED #:44-03-01-06-0-012-008

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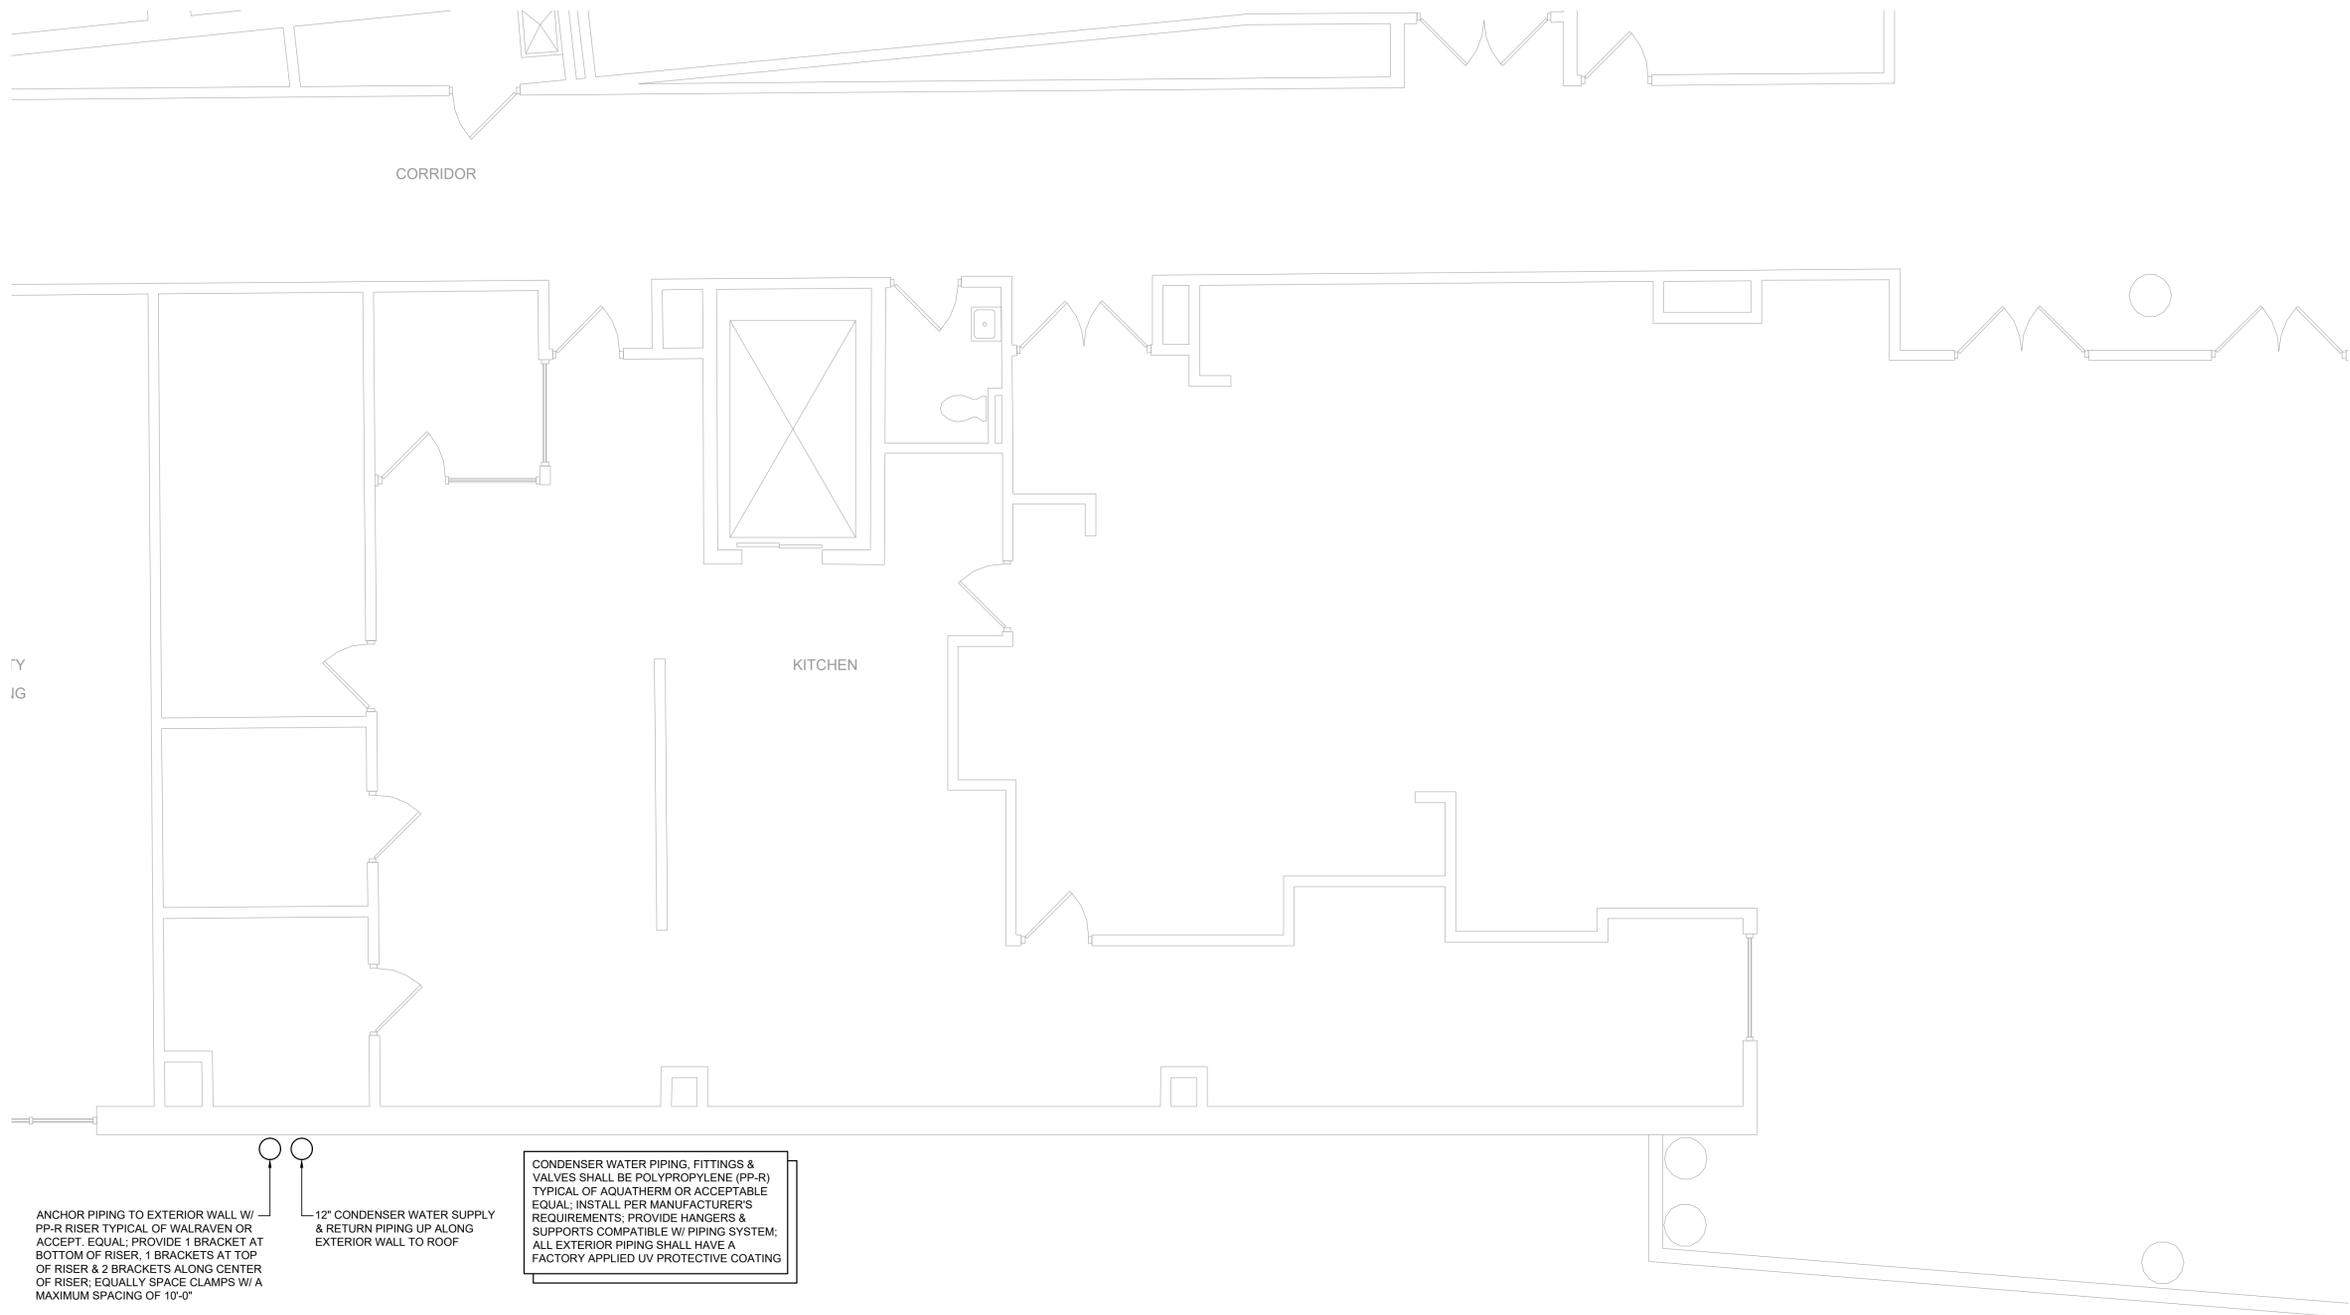
LOWER LEVEL MECHANICAL PLAN

DATE	DRN	CHK	DESCRIPTION
05.27.2022	BJK	MGB	CONSTRUCTION SET

REV.	DATE	DRN	CHK	DESCRIPTION

PROJECT NO. **2149** SHEET NO. **M.201**

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ANCHOR PIPING TO EXTERIOR WALL W/ PP-R RISER TYPICAL OF WALRAVEN OR ACCEPT. EQUAL; PROVIDE 1 BRACKET AT BOTTOM OF RISER, 1 BRACKETS AT TOP OF RISER & 2 BRACKETS ALONG CENTER OF RISER; EQUALLY SPACE CLAMPS W/ A MAXIMUM SPACING OF 10'-0"

12" CONDENSER WATER SUPPLY & RETURN PIPING UP ALONG EXTERIOR WALL TO ROOF

CONDENSER WATER PIPING, FITTINGS & VALVES SHALL BE POLYPROPYLENE (PP-R) TYPICAL OF AQUATHERM OR ACCEPTABLE EQUAL; INSTALL PER MANUFACTURER'S REQUIREMENTS, PROVIDE HANGERS & SUPPORTS COMPATIBLE W/ PIPING SYSTEM; ALL EXTERIOR PIPING SHALL HAVE A FACTORY APPLIED UV PROTECTIVE COATING

1 Main Level Mechanical Plan
 M.202 Scale: 1/4" = 1'-0"

KEY PLAN:
 'CORNWALL CENTRAL HIGH SCHOOL'

ROUTE 94
 TRUE NORTH
 PROJECT NORTH

PROJECT:
 CORNWALL CENTRAL HIGH SCHOOL COOLING TOWER REPLACEMENT PROJECT
 10 DRAGON DRIVE
 NEW WINDSOR, NEW YORK 12553
 SED #:44-03-01-06-0-012-008

SUB-CONSULTANT:

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MAIN LEVEL MECHANICAL PLAN

DATE:	DRN	CHK	DESCRIPTION
05.27.2022	BJK	MGB	CONSTRUCTION SET

REV.	DATE	DRN	CHK	DESCRIPTION

PROJECT NO. **2149** SHEET NO. **M.202**

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Key Notes:

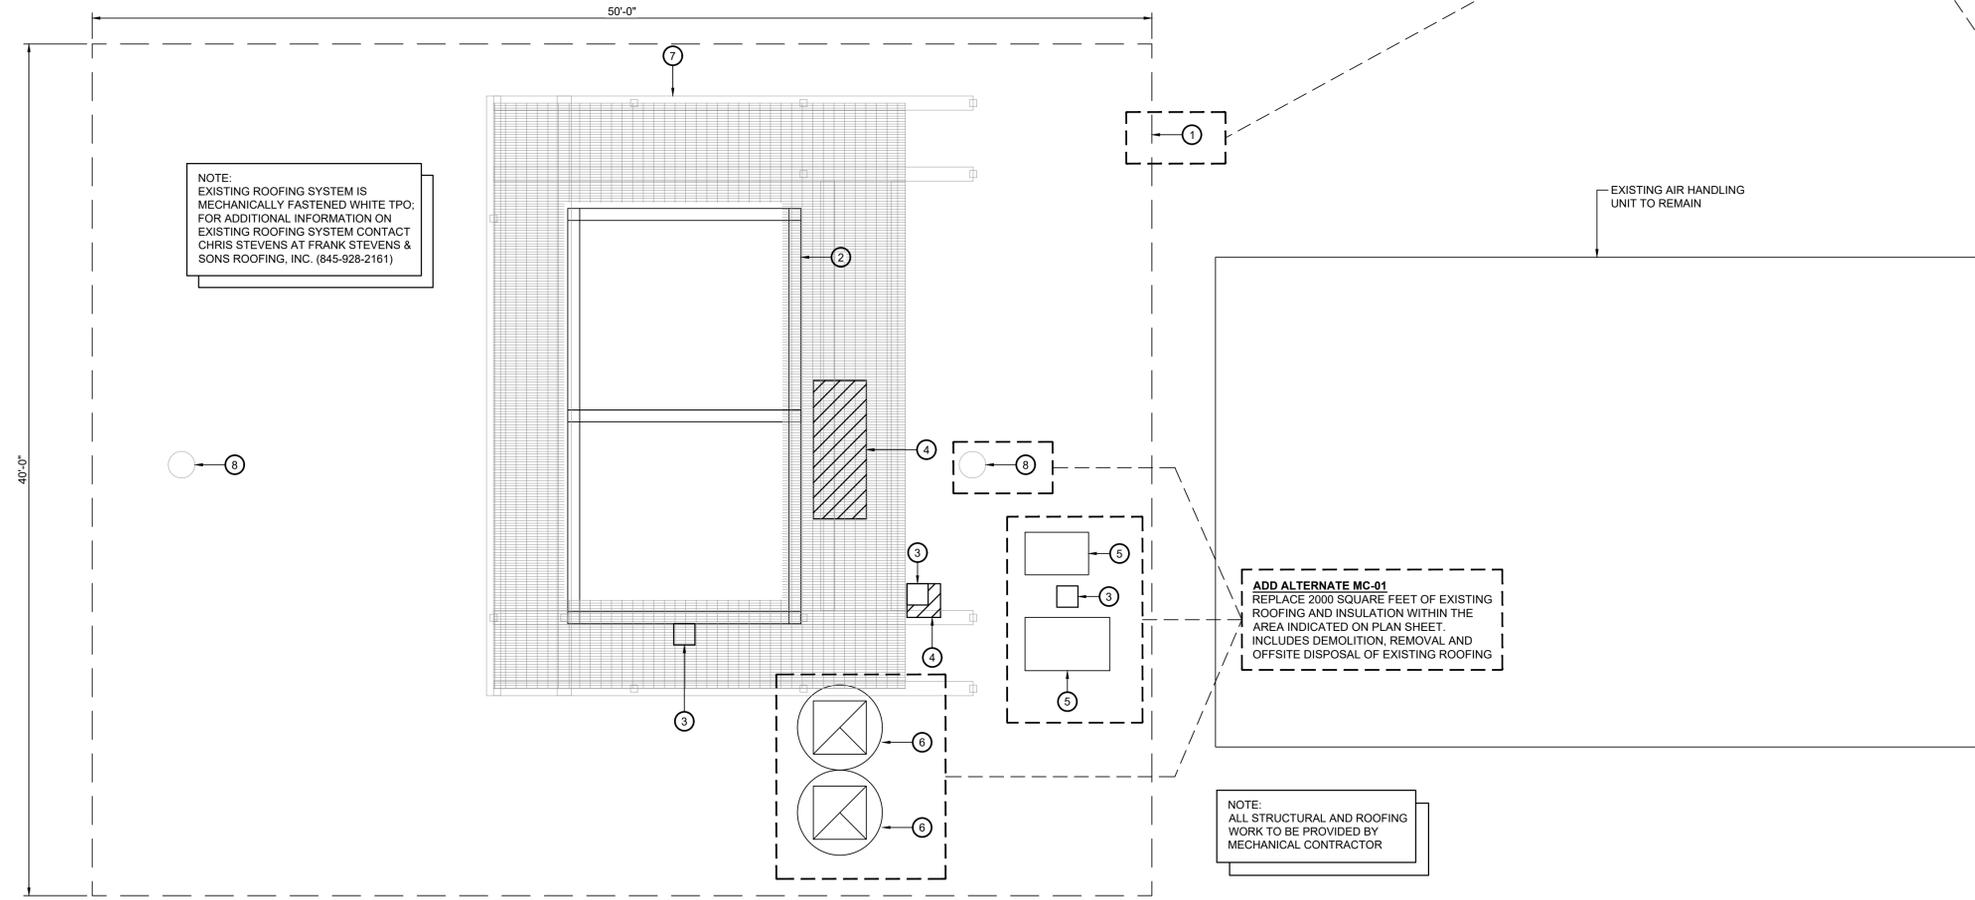
- ① REPLACE EXISTING ROOF AND ALL INSULATION WITHIN AREA INDICATED; MATCH EXISTING ROOFING SYSTEM AND INSULATION TYPE AND THICKNESS; MATCH EXISTING INSULATION TAPER TO MAINTAIN EXISTING DRAINAGE PATTERN
- ② EXISTING COOLING TOWER SUPPORT STRUCTURE TO REMAIN, PROVIDE FLASHING AT STRUCTURAL SUPPORTS THRU ROOF
- ③ PIPING/CONDUIT CURB; FLASH INTO ROOF SYSTEM
- ④ DISCONNECT, REMOVE & PROPERLY DISPOSE OF EXISTING ROOF CURB; INFILL ROOF DECK W/ MATERIAL TO MATCH EXISTING DECK
- ⑤ EXISTING CONDENSING UNIT TO BE TEMPORARILY REMOVED AND REINSTALLED ON ROOF SUPPORT MTD. ON TOP OF ROOF SURFACE
- ⑥ EXISTING EXHAUST FAN TO BE TEMPORARILY REMOVED AND REINSTALLED; FLASH NEW ROOFING SYSTEM INTO EXISTING CURB
- ⑦ EXISTING COOLING TOWER MAINTENANCE PLATFORM TO BE DISCONNECTED, REMOVED; PATCH OVER WHERE STRUCTURAL SUPPORTS WERE REMOVED FROM ROOF
- ⑧ EXISTING ROOF DRAIN TO REMAIN; CONNECT NEW ROOFING SYSTEM INTO EXISTING DRAIN AND REPLACE DRAIN TOP GRATE W/ NEW

ADD ALTERNATE MC-01
 REPLACE 2000 SQUARE FEET OF EXISTING ROOFING AND INSULATION WITHIN THE AREA INDICATED ON PLAN SHEET. INCLUDES DEMOLITION, REMOVAL AND OFFSITE DISPOSAL OF EXISTING ROOFING

ADD ALTERNATE MC-01
 REPLACE 2000 SQUARE FEET OF EXISTING ROOFING AND INSULATION WITHIN THE AREA INDICATED ON PLAN SHEET. INCLUDES DEMOLITION, REMOVAL AND OFFSITE DISPOSAL OF EXISTING ROOFING

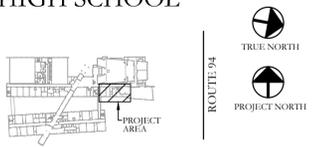
NOTE:
 ALL STRUCTURAL AND ROOFING WORK TO BE PROVIDED BY MECHANICAL CONTRACTOR

NOTE:
 EXISTING ROOFING SYSTEM IS MECHANICALLY FASTENED WHITE TPO; FOR ADDITIONAL INFORMATION ON EXISTING ROOFING SYSTEM CONTACT CHRIS STEVENS AT FRANK STEVENS & SONS ROOFING, INC. (845-928-2161)



KEY PLAN:

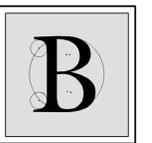
'CORNWALL CENTRAL HIGH SCHOOL'



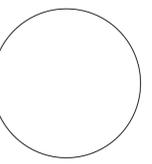
PROJECT:
 CORNWALL CENTRAL HIGH SCHOOL COOLING TOWER REPLACEMENT PROJECT
 10 DRAGON DRIVE
 NEW WINDSOR, NEW YORK 12553
 SED #:44-03-01-06-0-012-008

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ROOF REPLACEMENT PLAN

DATE	DRN	CHK	DESCRIPTION
05.27.2022	BJK	MGB	CONSTRUCTION SET

REV.	DATE	DRN	CHK	DESCRIPTION

PROJECT NO. 2149	SHEET NO. M.204
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1 Roof Replacement Plan
 Scale: 1/4" = 1'-0"

120/208V 3Ø 4W+G, 65kAIC RATING BUS RATING: 250A MLO

CONNECTED LOAD	CONDUCTORS	CKT. BREAKER AMPACITY	POSITION	L1 KVA	L2 KVA	L3 KVA	POSITION	CKT. BREAKER AMPACITY	CONDUCTORS	CONNECTED LOAD
PUMP P-6A	(3) #4 CU & (1) #8 GND.	70	1 3 5	-	-	-	2 4 6	70	(3) #4 CU & (1) #8 GND.	PUMP P-6B
PUMP P-7A	(3) #4 CU & (1) #8 GND.	70	7 9 11	-	-	-	8 10 12	70	(3) #4 CU & (1) #8 GND.	PUMP P-7B
SPACE	-	-	13	-	-	-	14	-	-	SPACE
SPACE	-	-	15	-	-	-	16	-	-	SPACE
SPACE	-	-	17	-	-	-	18	-	-	SPACE
SPACE	-	-	19	-	-	-	20	-	-	SPACE
SPACE	-	-	21	-	-	-	22	-	-	SPACE
SPACE	-	-	23	-	-	-	24	-	-	SPACE
SPACE	-	-	19	-	-	-	20	-	-	SPACE
SPACE	-	-	21	-	-	-	22	-	-	SPACE
SPACE	-	-	23	-	-	-	24	-	-	SPACE
SPACE	-	-	19	-	-	-	20	-	-	SPACE
SPACE	-	-	21	-	-	-	22	-	-	SPACE
SPACE	-	-	23	-	-	-	24	-	-	SPACE
SQUARE 'D' NF PANELBOARD W/ BOLT ON BREAKERS										
- KVA TOTAL										

1 New Panelboard BMLNH-3
E.101 Scale: None

277/480V 3Ø 4W+G BUS RATING: 400A MLO

CONNECTED LOAD	CONDUCTORS	CKT. BREAKER AMPACITY	POSITION	L1 KVA	L2 KVA	L3 KVA	POSITION	CKT. BREAKER AMPACITY	CONDUCTORS	CONNECTED LOAD
SPARE	-	125	1 3 5	-	-	-	2 4 6	125	EXISTING	EXISTING AHU 1A & 1B
SPARE	-	100	7 9 11	-	-	-	8 10 12	20	EXISTING	EXISTING EF-28
EXISTING AHU-5	EXISTING	40	13 15 17	-	-	-	14 16 18	20	EXISTING	EXISTING EF-27
COOLING TOWER	(3) #10 CU & (1) #10 GND.	30	19 21 23	-	-	-	20 22 24	-	-	BLANK
BLANK	-	-	25	-	-	-	26	-	-	BLANK
BLANK	-	-	27	-	-	-	28	-	-	BLANK
BLANK	-	-	29	-	-	-	30	-	-	BLANK
BLANK	-	-	31	-	-	-	32	-	-	BLANK
BLANK	-	-	33	-	-	-	34	-	-	BLANK
BLANK	-	-	35	-	-	-	36	-	-	BLANK
BLANK	-	-	37	-	-	-	38	-	-	BLANK
BLANK	-	-	39	-	-	-	40	-	-	BLANK
BLANK	-	-	41	-	-	-	42	-	-	BLANK
SQUARE D NF PANEL										
- KVA TOTAL										

DISCONNECT, REMOVE & DISPOSE OF EXISTING CIRCUITS TO EXISTING COOLING TOWER, MAINTAIN EXISTING BREAKERS AS SPARES

- PROVIDE NEW CIRCUIT BREAKERS FOR ALL NEW OR MODIFIED CIRCUITS; BREAKERS SHALL MATCH EXISTING TYPE AND RATING
- PANEL SCHEDULE SHOWN BASED ON EXISTING DIRECTORY, CONTRACTOR SHALL VERIFY IN FIELD & ADJUST CIRCUIT LAYOUT AS NEEDED BASED ON AVAILABLE POSITIONS

2 Existing Panelboard BFLNH2
E.101 Scale: None

ELECTRICAL LEGEND:

- MOTOR
- EARTH GROUND
- JUNCTION BOX
- PULL BOX
- FUSE WITH RATING
- MOLDED CASE CIRCUIT BREAKER
- DISCONNECT SWITCH, FUSED
- DISCONNECT SWITCH, UNFUSED
- STARTER, COMBINATION WITH DISCONNECT SWITCH
- STARTER OR MOTOR CONTROLLER
- METER
- 20A 120V DUPLEX CEILING MOUNTED RECEPTACLE
- 20A 120V DUPLEX WALL MOUNTED RECEPTACLE; 18" A.F.F. UNLESS OTHERWISE NOTED
- 20A 120V DUPLEX WALL MOUNTED RECEPTACLE WITH GROUND FAULT CIRCUIT INTERRUPTER
- 20A 120V QUADRUPLEX RECEPTACLE
- WALL MOUNTED SPECIAL PURPOSE RECEPTACLE
- 20A 120V WALL MOUNTED USB CHARGER RECEPTACLE TYPICAL OF HUBBELL USB20X OR ACCEPTABLE EQUAL
- FLOOR BOX WITH STAINLESS COVER TYPICAL OF LEW ELECTRIC #OB-1-SP OR ACCEPTABLE EQUAL; PUSH BUTTON OPEN; FULLY IP66 RATED WATER PROOF (WHEN IN CLOSED POSITION); W/ 20A 125V E60120 GFCI RECEPTACLE (UNLESS OTHERWISE NOTED)
- WALL PHONE OUTLET MTD, 48" A.F.F.; 3/4" EMT CDT. IN WALL TO ABOVE CEILING W/ PULL CORD
- WALL BOX FOR TELEVISION CONNECTION; 1-1/4" EMT CDT. IN WALL TO ABOVE CEILING W/ PULL CORD
- TELEPHONE/DATA COMMUNICATION BOX W/ (2) 3/4" EMT CDT. IN WALL TO ABOVE CEILING W/ PULL CORD; NO FACE PLATE
- BRANCH CIRCUIT HOMERUN; LINES INDICATE NUMBER OF CIRCUITS, NEUTRAL, AND SWITCH LEG CONDUCTORS; ONE SEPARATE GROUNDING CONDUCTOR SHALL BE PROVIDED FOR EACH HOMERUN; NOT SHOWN
- SWITCH
BLANK = SINGLE POLE
3 = THREE-WAY
D = DIMMER
P = WITH PILOT LIGHT
T = TIMER OPERATED
X = EXPLOSION PROOF
2 = DOUBLE POLE
4 = FOUR-WAY
K = KEY OPERATED
PB = PUSH BUTTON
WP = WEATHER PROOF
OC = OCCUPANCY SENSOR
- DUAL TECHNOLOGY OCCUPANCY SENSOR
- DAYLIGHT SENSOR
- HORN/STROBE DEVICE, ONE ASSEMBLY; MTD, 80" A.F.F. UNLESS OTHERWISE NOTED; 15 CANDELA UNLESS OTHERWISE NOTED
- STROBE DEVICE, MTD, 80" A.F.F. UNLESS OTHERWISE NOTED; 15 CANDELA UNLESS OTHERWISE NOTED
- MANUAL PULL STATION; MTD, 48" A.F.F.
- WATER FLOW SWITCH
- VALVE TAMPER SWITCH
- DETECTOR; LETTER INDICATES AS FOLLOWS:
BLANK = SMOKE DETECTOR
P = PHOTOELECTRIC SMOKE
M = MULTIPLE STATION SMOKE ALARM
D = PHOTOELECTRIC DUCT SMOKE DETECTOR
FSD = DUCT SMOKE DETECTOR FOR FIRE SMOKE DAMPER
- RATE OF RISE HEAT DETECTOR, 135°F
- CARBON MONOXIDE DETECTOR; MTD, 60" A.F.F.
- ADDRESSABLE FIRE ALARM CONTROL PANEL
- FIRE ALARM ANNUNCIATOR PANEL
- REMOTE TEST SWITCH & LED FOR DUCT SMOKE DETECTORS
- FIRE ALARM RELAY

ELECTRICAL NOTES:

- ALL MATERIALS AND EQUIPMENT ARE TO BE NEW, UNUSED, AND FREE FROM DEFECTS OF ANY KIND. THE BASIS OF QUALITY SHALL BE THE LATEST REVISION OF ASTM, ANSI, OR OTHER ACCEPTABLE STANDARDS.
- THESE DRAWINGS ARE DIAGRAMMATIC, AND INDICATE GENERAL ARRANGEMENT OF WORK. THE CONTRACTOR SHALL BE RESPONSIBLE TO HAVE REVIEWED THE SITE FOR HIS WORK PRIOR TO HAVING SUBMITTED HIS PROPOSAL. NO ADDITIONAL COMPENSATION WILL BE ALLOWED FOR CONDITIONS FOUND DURING THE COURSE OF THE CONTRACT.
- THE CONTRACTOR SHALL COORDINATE HIS WORK WITH THAT OF ALL OTHER TRADES.
- ALL WORK INCLUDING LABOR AND MATERIALS SHALL BE FULLY GUARANTEED FOR ONE (1) YEAR FROM THE DATE OF PAYMENT AND FINAL ACCEPTANCE BY THE OWNER AND ENGINEER.
- ALL CUTTING, PATCHING, FIRE-STOPPING, AND SURFACE RESTORATION IN CONNECTION WITH THIS TRADE SHALL BE COMPLETED BY THIS CONTRACTOR.
- A MINIMUM OF FOUR (4) COPIES OF SHOP DRAWINGS SHALL BE SUBMITTED TO THE ARCHITECT PRIOR TO ORDERING AND INSTALLATION OF THE EQUIPMENT AND/OR MATERIALS. BY SUBMITTING SHOP DRAWINGS, THE CONTRACTOR REPRESENTS THAT ACTUAL FIELD CONDITIONS ARE VERIFIED BY HIM AND ARE REFLECTED ON HIS SUBMITTALS.
- THIS CONTRACTOR SHALL PAY ALL FEES, GIVE ALL NOTICES, FILE ALL NECESSARY DRAWINGS, AND OBTAIN ALL PERMITS, INSPECTION AND CERTIFICATES OF APPROVAL REQUIRED IN CONNECTION WITH WORK UNDER THIS CONTRACT.
- EQUIPMENT AND MATERIALS FOR WHICH UNDERWRITERS LABORATORIES INC. (UL) PROVIDES PRODUCT LISTING SERVICE SHALL BE LISTED AND BEAR THE LISTING MARK.
- ALL WORK IN ASSOCIATION WITH THIS CONTRACT SHALL BE COMPLETED IN STRICT COMPLIANCE WITH THE 2015 NATIONAL ELECTRIC CODE, 2020 BUILDING CODE OF NEW YORK STATE, 2020 FIRE CODE OF NEW YORK STATE & 2020 ENERGY CONSERVATION CONSTRUCTION CODE OF NEW YORK STATE.
- ALL NEW LIGHTING FIXTURES SHALL BE INSTALLED FULLY LAMPED AND OPERABLE. THE CONTRACTOR SHALL TURN OVER TO THE OWNER SPARE LAMPS OF EVERY TYPE ON THE PROJECT IN AN AMOUNT NOT LESS THAN 2% OF THE TOTAL NUMBER OF EACH TYPE (MINIMUM 1 PER TYPE).
- THIS CONTRACTOR SHALL BE RESPONSIBLE FOR ALL COORDINATION, APPLICATIONS AND FEES OF ALL WORK ASSOCIATED WITH THE LOCAL UTILITY COMPANY AND/OR THE TELEPHONE COMPANY. ALL WORK INVOLVING THE UTILITY COMPANY SHALL BE COMPLETED IN ACCORDANCE WITH THEIR REGULATIONS AND GUIDELINES.
- ALL CONDUCTORS SHALL BE COPPER, SHALL NOT BE LESS THAN #12 AWG, AND SHALL NOT EXCEED 70 FEET FROM PANEL BOARD TO FURTHEST CONNECTION UNLESS OTHERWISE NOTED ON PLANS.
- WIRING SHALL CONSIST OF METALLIC ARMORED CABLES (TYPE AC) INSTALLED WHERE CONCEALED IN FRAMED WALLS, CEILINGS, OR PERMITTED BY THE NEC. OTHER AREAS SHALL CONSIST OF INSULATED CONDUCTORS INSTALLED IN RIGID STEEL CONDUIT (RGS), ELECTRICAL METALLIC TUBING (EMT), INTERMEDIATE METAL CONDUIT (IMC), OR FLEXIBLE METALLIC ARMORED CABLE (GREENFIELD).
- LIGHTING LOADS SHALL NOT BE COMBINED ON THE SAME CIRCUIT AS ANY OTHER ELECTRICAL LOADS.
- CONTRACTOR SHALL BE RESPONSIBLE TO FURNISH & INSTALL ALL SMALL DETAILS AND INCIDENTAL WORK NOT SHOWN OR SPECIFIED, BUT WHICH CAN BE REASONABLY INFERRED AS REQUIRED FOR A COMPLETE AND OPERATING SYSTEM OF HIGH QUALITY MEETING ALL APPLICABLE CODES AND REGULATIONS.
- FOR EACH NEW OR MODIFIED ELECTRICAL PANEL, THE CONTRACTOR SHALL PROVIDE A TYPE WRITTEN DIRECTORY CARD TO REFLECT ALL CIRCUITING. ADDITIONALLY, THE CONTRACTOR SHALL LABEL (WITH A PERMANENT MARKER OR LABEL) EACH RECEPTACLE ON THE INSIDE OF EACH FACE PLATE WITH PANEL AND CIRCUIT NUMBER DESIGNATION.
- MINIMUM REQUIREMENT FOR EQUIPMENT GROUNDING SHALL BE GOVERNED BY THE NEC. ALL GROUNDS, BONDING, ETC. SHALL MEET THESE REQUIREMENTS. THE CONTRACTOR SHALL FURNISH AND INSTALL ANY AND ALL ITEMS NECESSARY TO MEET THESE REQUIREMENTS AT NO EXTRA COST, EVEN IF SUCH ITEMS ARE NOT DETAILED ON THE DRAWINGS.
- ALL CONDUIT AND CABLE SHALL BE PROPERLY SUPPORTED AND ROUTED PARALLEL OR PERPENDICULAR TO BUILDING WALLS. THE CONTRACTOR SHALL FURNISH AND INSTALL ALL SUPPORT HANGERS AND MISCELLANEOUS METALS REQUIRED FOR PROPER INSTALLATION OF WORK.
- THE CONTRACTOR IS RESPONSIBLE TO TEST ALL EQUIPMENT, WIRING, DEVICES, AND SYSTEMS INSTALLED UNDER THIS CONTRACT TO ENSURE PROPER OPERATION PRIOR TO FINAL ACCEPTANCE BY THE OWNER AND ENGINEER.
- THE CONTRACTOR IS RESPONSIBLE TO DETERMINE WHETHER SPECIAL LICENSING IS REQUIRED IN ORDER TO PERFORM THE REQUIRED WORK IN THE MUNICIPALITY WHERE THE PROJECT IS LOCATED. IF THE CONTRACTOR CANNOT OBTAIN THE REQUIRED LICENSING TO COMPLETE THE WORK WITHIN THE PROJECT SCHEDULE, THEN THE CONTRACTOR SHALL NOT BE PERMITTED TO BID ON THIS PROJECT.

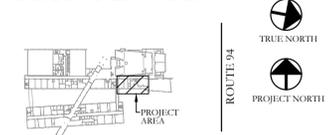
WIRE COLOR CODING TABLE

PHASE	WIRES	VOLTAGE	L1	L2	L3	NEUTRAL	GROUND
1	2 (1)	120	BLACK	-	-	WHITE	-
1	2 (1)	208	BLACK	RED	-	-	-
1	3	120	BLACK	-	-	WHITE	GREEN (2)
1	3	208	BLACK	RED	-	-	GREEN (2)
3	4	208	BLACK	RED	BLUE	-	GREEN (2)
3	5	208	BLACK	RED	BLUE	WHITE	GREEN (2)
1	3	277	BROWN	-	-	GRAY	GREEN (2)
1	3	277	BROWN	ORANGE	-	-	GREEN (2)
3	4	480	BROWN	ORANGE	YELLOW	-	GREEN (2)
3	5	480	BROWN	ORANGE	YELLOW	GRAY	GREEN (2)

NOTES:
1. FOR DOUBLE INSULATED EQUIPMENT ONLY.
2. GREEN/YELLOW MAY BE USED:
- GREEN/YELLOW SHALL BE GREEN WITH ONE OR MORE YELLOW STRIPES.
- GREEN = 50 TO 70%, YELLOW = 50 TO 30%.
- GREEN/YELLOW IS THE ONLY COLOR INTERNATIONALLY ACCEPTED FOR USE AS AN EQUIPMENT GROUNDING CONDUCTOR.
- GREEN OR GREEN/YELLOW MUST ONLY BE USED FOR GROUNDING CONDUCTORS.

KEY PLAN:

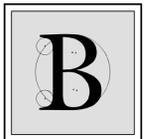
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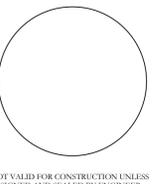
PROJECT:
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10 DRAGON DRIVE
NEW WINDSOR, NEW YORK 12553
SED #:44-03-01-06-0-012-008

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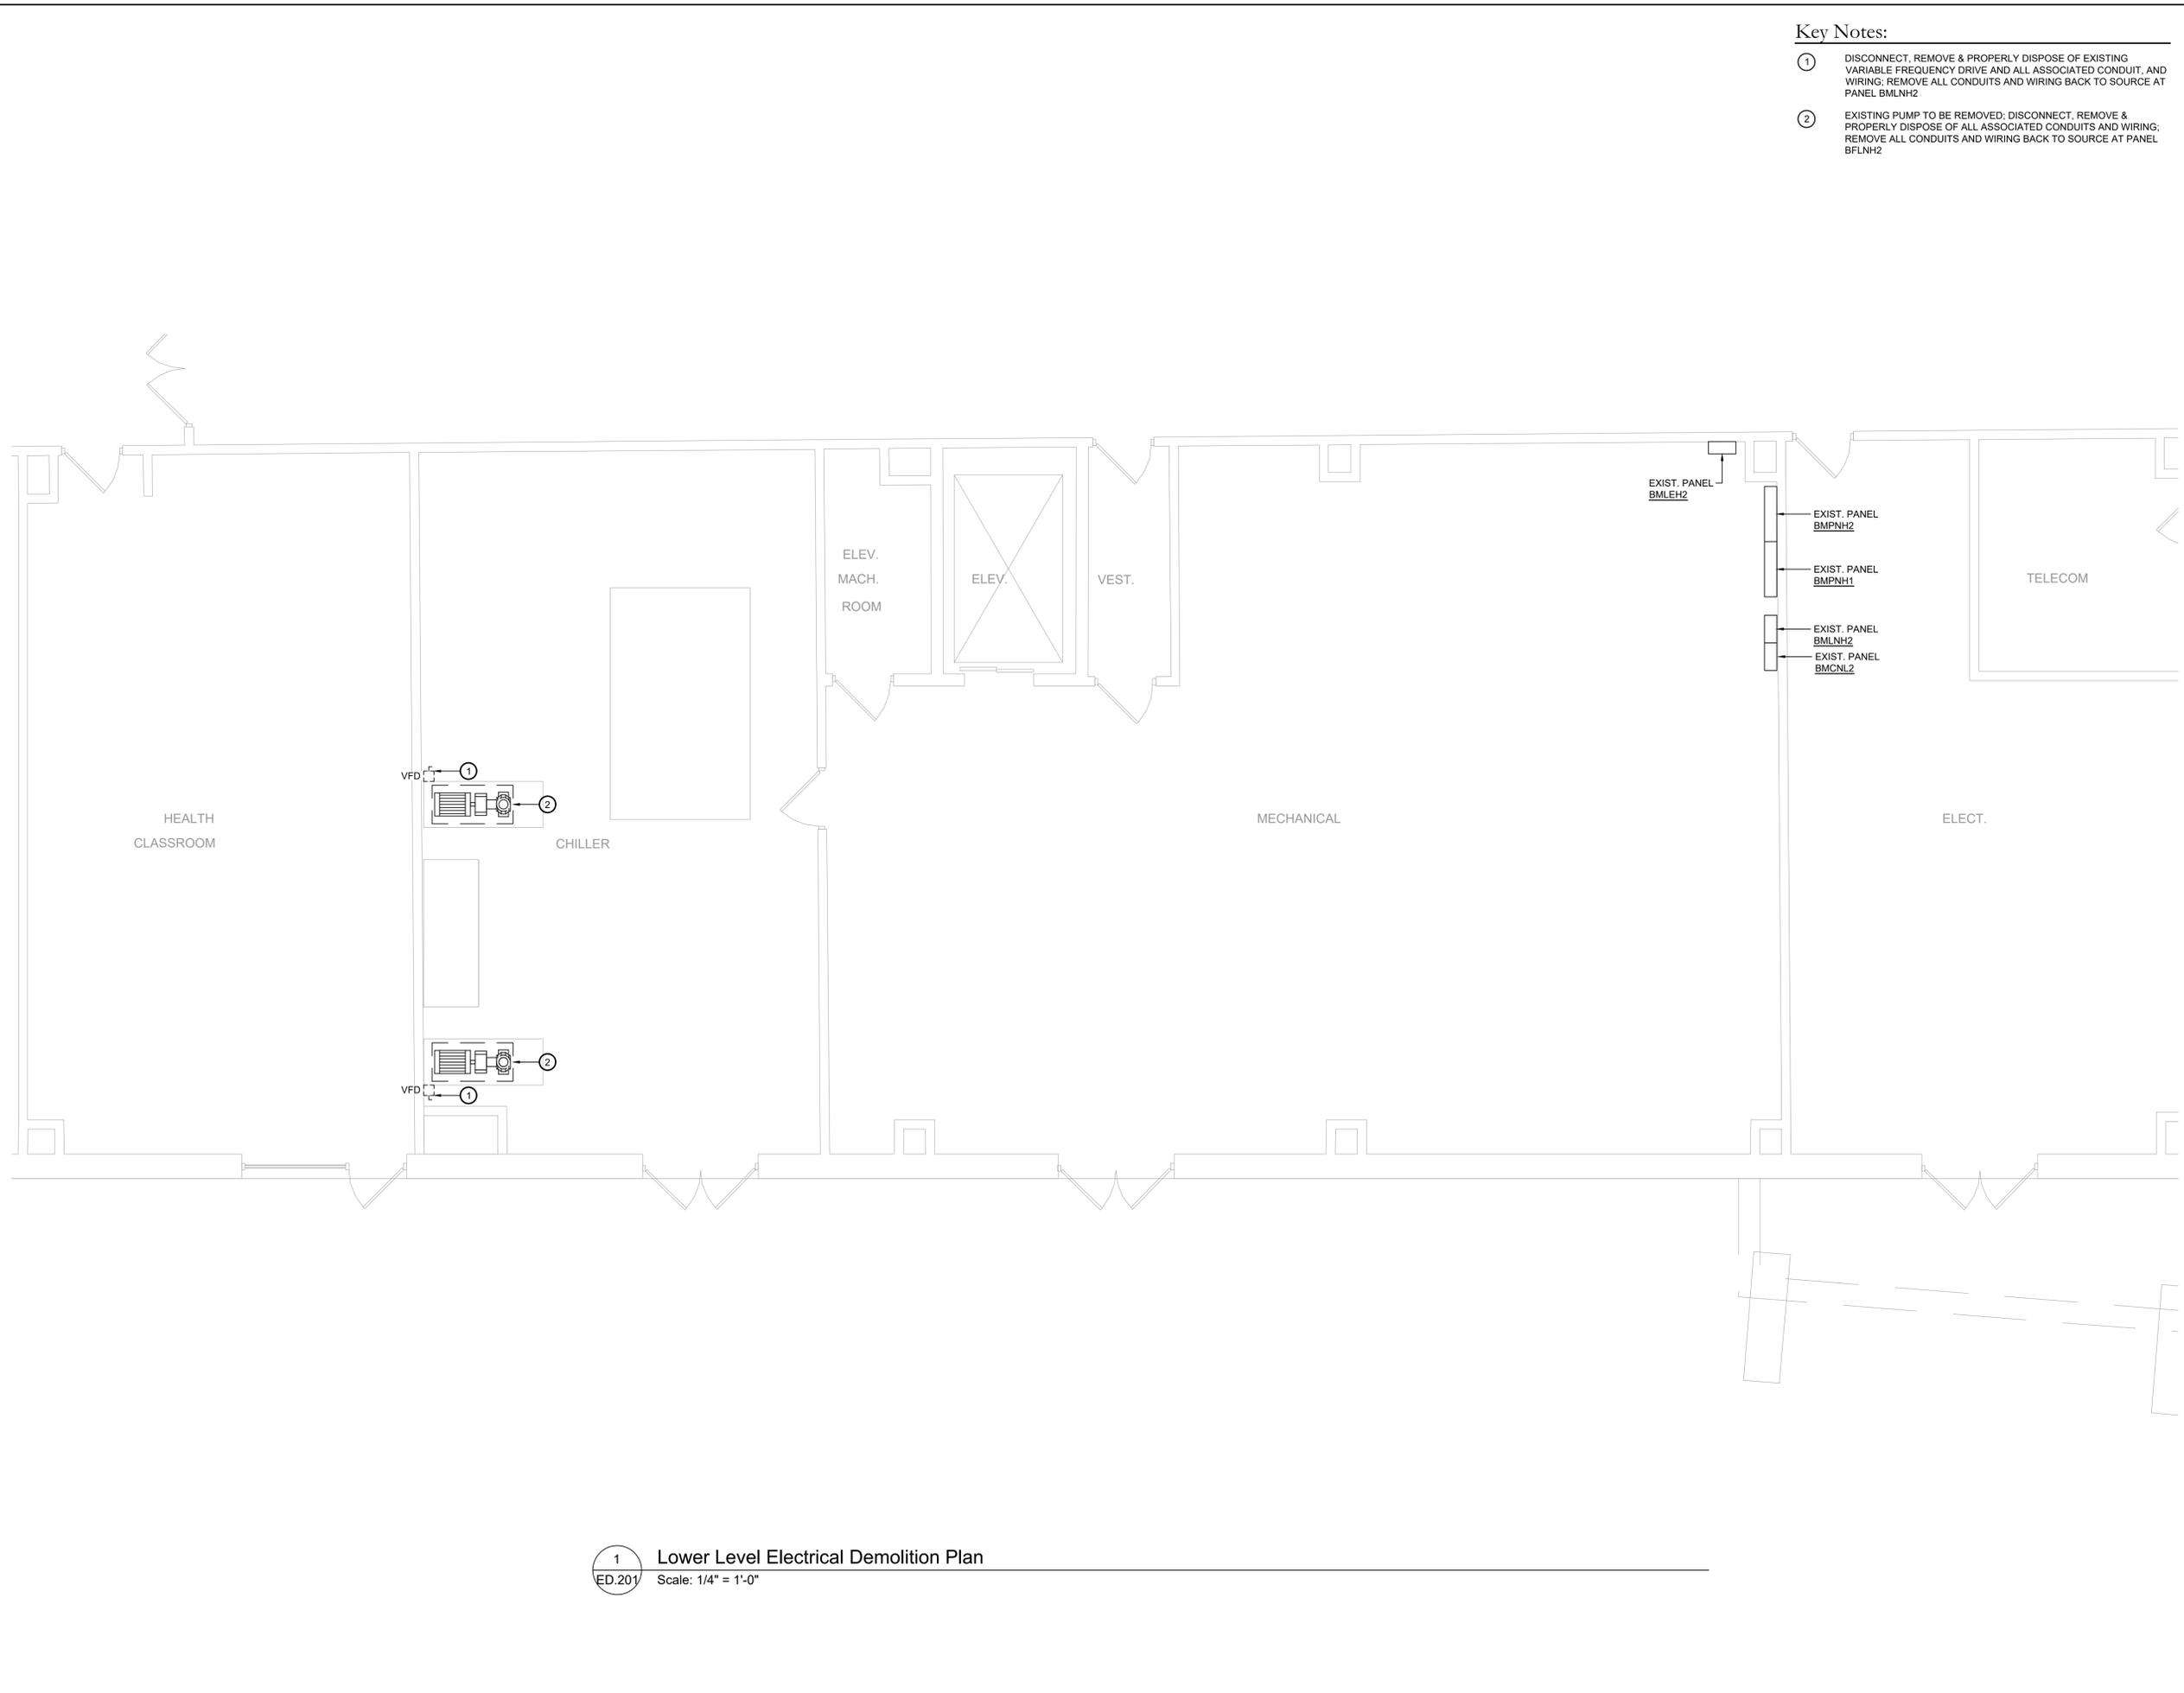
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ELECTRICAL LEGEND, NOTES & PANEL SCHEDULE

DATE	DRN	CHK	DESCRIPTION
05.27.2022	BJK	MGB	CONSTRUCTION SET

REV.	DATE	DRN	CHK	DESCRIPTION

PROJECT NO. **2149** SHEET NO. **E.101**



- Key Notes:**
- ① DISCONNECT, REMOVE & PROPERLY DISPOSE OF EXISTING VARIABLE FREQUENCY DRIVE AND ALL ASSOCIATED CONDUIT, AND WIRING; REMOVE ALL CONDUITS AND WIRING BACK TO SOURCE AT PANEL BMLNH2
 - ② EXISTING PUMP TO BE REMOVED; DISCONNECT, REMOVE & PROPERLY DISPOSE OF ALL ASSOCIATED CONDUITS AND WIRING; REMOVE ALL CONDUITS AND WIRING BACK TO SOURCE AT PANEL BFLNH2

KEY PLAN:
 'CORNWALL CENTRAL HIGH SCHOOL'

 ROUTE 94
 TRUE NORTH
 PROJECT NORTH

PROJECT:
 CORNWALL CENTRAL HIGH SCHOOL
 COOLING TOWER REPLACEMENT PROJECT
 10 DRAGON DRIVE
 NEW WINDSOR, NEW YORK 12553
 SED #:44-03-01-06-0-012-008

SUB-CONSULTANT:

ENGINEER:

BLAKE ENGINEERING PLLC
 1898 COUNTY ROUTE 1
 WESTTOWN, NEW YORK 10998
 TEL:845-467-9207 FAX:845-767-5050
 MBLAKE@BLAKEENGINEERINGPLLCCOM

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 NY - 89039 NJ - GE050037 PA - PE079303
 MA - 53197 CT - 32283 FL - 85928

LOWER LEVEL ELECTRICAL DEMOLITION PLAN

DATE:	DRN	CHK	DESCRIPTION
05.27.2022	BJK	MGB	CONSTRUCTION SET

REV.	DATE	DRN	CHK	DESCRIPTION

PROJECT NO.	SHEET NO.
2149	ED.201

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1 Lower Level Electrical Demolition Plan
 ED.201 Scale: 1/4" = 1'-0"

Key Notes:

- ① DISCONNECT, REMOVE & PROPERLY DISPOSE OF EXISTING VARIABLE FREQUENCY DRIVE AND ALL ASSOCIATED CONDUIT, AND WIRING; REMOVE ALL CONDUITS AND WIRING BACK TO SOURCE AT PANEL BFLNH2

KEY PLAN:

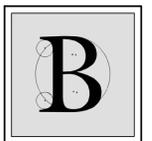
'CORNWALL CENTRAL HIGH SCHOOL'



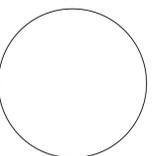
PROJECT:
 CORNWALL CENTRAL HIGH SCHOOL
 COOLING TOWER REPLACEMENT PROJECT
 10 DRAGON DRIVE
 NEW WINDSOR, NEW YORK 12553
 SED #:44-03-01-06-0-012-008

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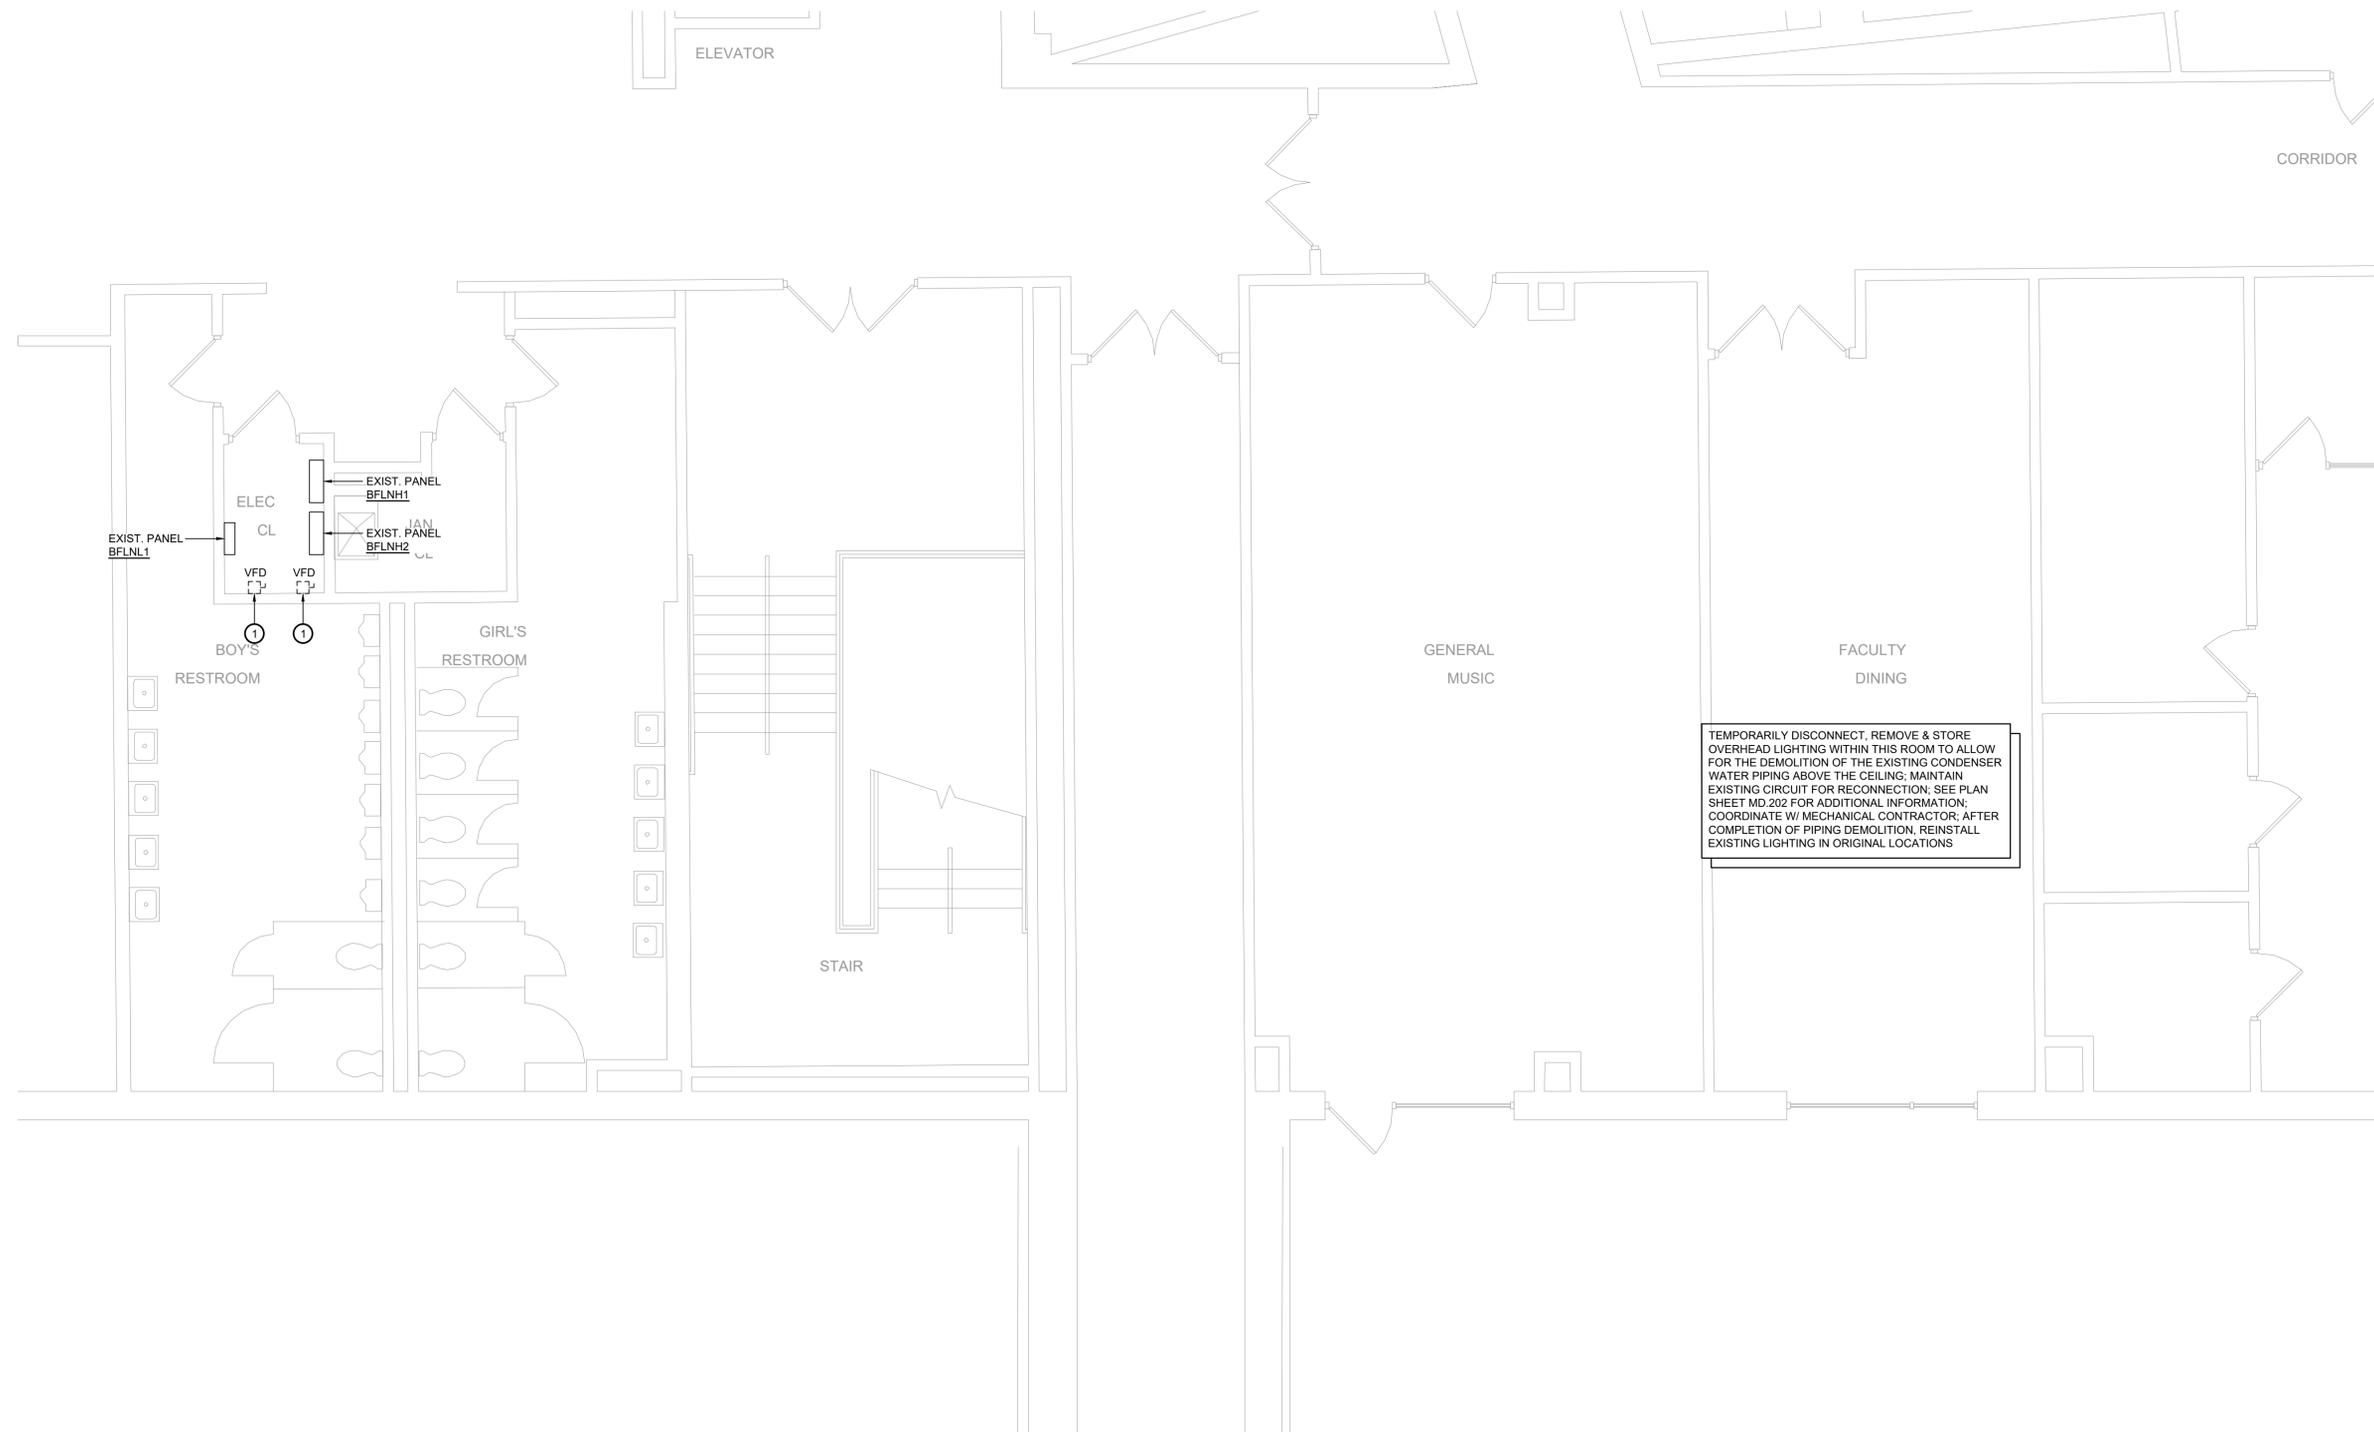
MAIN LEVEL ELECTRICAL DEMOLITION PLAN

DATE:	DRN:	CHK:	DESCRIPTION:
05.27.2022	BJK	MGB	CONSTRUCTION SET

REV.	DATE:	DRN:	CHK:	DESCRIPTION:

PROJECT NO.	SHEET NO.
2149	ED.202

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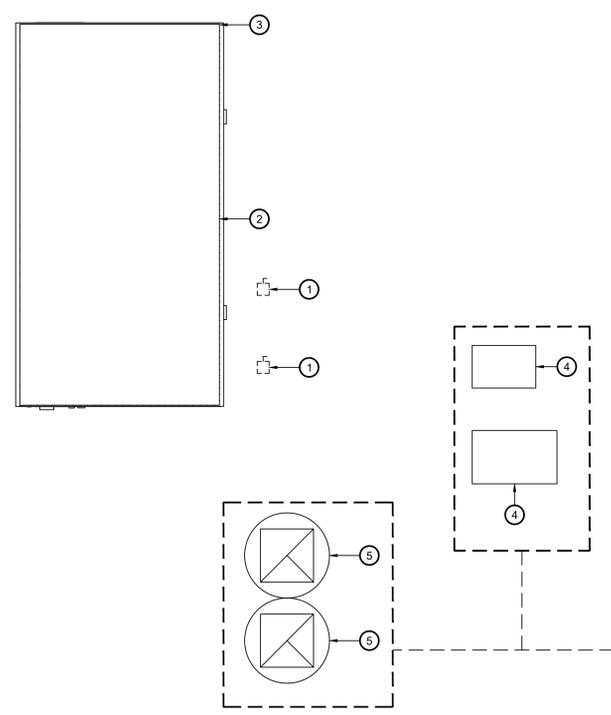
① **Main Level Electrical Demolition Plan**
 ED.202 Scale: 1/4" = 1'-0"

Key Notes:

- ① DISCONNECT, REMOVE & PROPERLY DISPOSE OF EXISTING DISCONNECT SWITCHES AND ALL ASSOCIATED CONDUIT, WIRING, COMPONENTS AND ACCESSORIES
- ② DISCONNECT, REMOVE & PROPERLY DISPOSE OF EXISTING EVAPORATIVE COOLING TOWER AND ALL ASSOCIATED COMPONENTS AND ACCESSORIES; REMOVE ALL CONDUITS AND WIRING BACK TO SOURCE AT PANEL BFLNH2
- ③ DISCONNECT, REMOVE & STORE LIGHTNING PROTECTION SYSTEM CONNECTED TO COOLING TOWER AND SUPPORT FRAME; STORE AIR TERMINALS, GROUNDING WIRE AND CONNECTIONS FOR RE-INSTALLATION ON REPLACEMENT TOWER
- ④ EXISTING FREEZER/COOLER CONDENSING UNIT TO BE DISCONNECTED, REMOVED & STORED FOR REINSTALLATION BY MC; ELECTRICAL CONTRACTOR TO DISCONNECT POWER, TEMPORARILY SECURE EXISTING CIRCUIT DURING ROOF REPLACEMENT AND RECONNECT TO EXISTING EQUIPMENT; WIRING TO BE ROUTED THROUGH NEW PIPE PORTAL/ ROOF CURB
- ⑤ EXISTING EXHAUST FAN TO BE DISCONNECTED, REMOVED & STORED FOR REINSTALLATION BY MC; ELECTRICAL CONTRACTOR TO DISCONNECT POWER, TEMPORARILY SECURE EXISTING CIRCUIT DURING ROOF REPLACEMENT AND RECONNECT TO EXISTING EQUIPMENT

ADD ALTERNATE EC-01
DISCONNECT AND RECONNECT OF POWER TO EXISTING ROOFTOP EQUIPMENT TO ALLOW FOR REPLACEMENT OF ROOFING

ADD ALTERNATE EC-01
DISCONNECT AND RECONNECT OF POWER TO EXISTING ROOFTOP EQUIPMENT TO ALLOW FOR REPLACEMENT OF ROOFING



KEY PLAN:

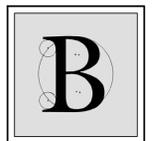
'CORNWALL CENTRAL HIGH SCHOOL'



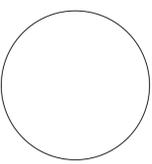
PROJECT:
CORNWALL CENTRAL HIGH SCHOOL COOLING TOWER REPLACEMENT PROJECT
 10 DRAGON DRIVE
 NEW WINDSOR, NEW YORK 12553
 SED #:44-03-01-06-0-012-008

SUB-CONSULTANT:

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ROOF ELECTRICAL DEMOLITION PLAN

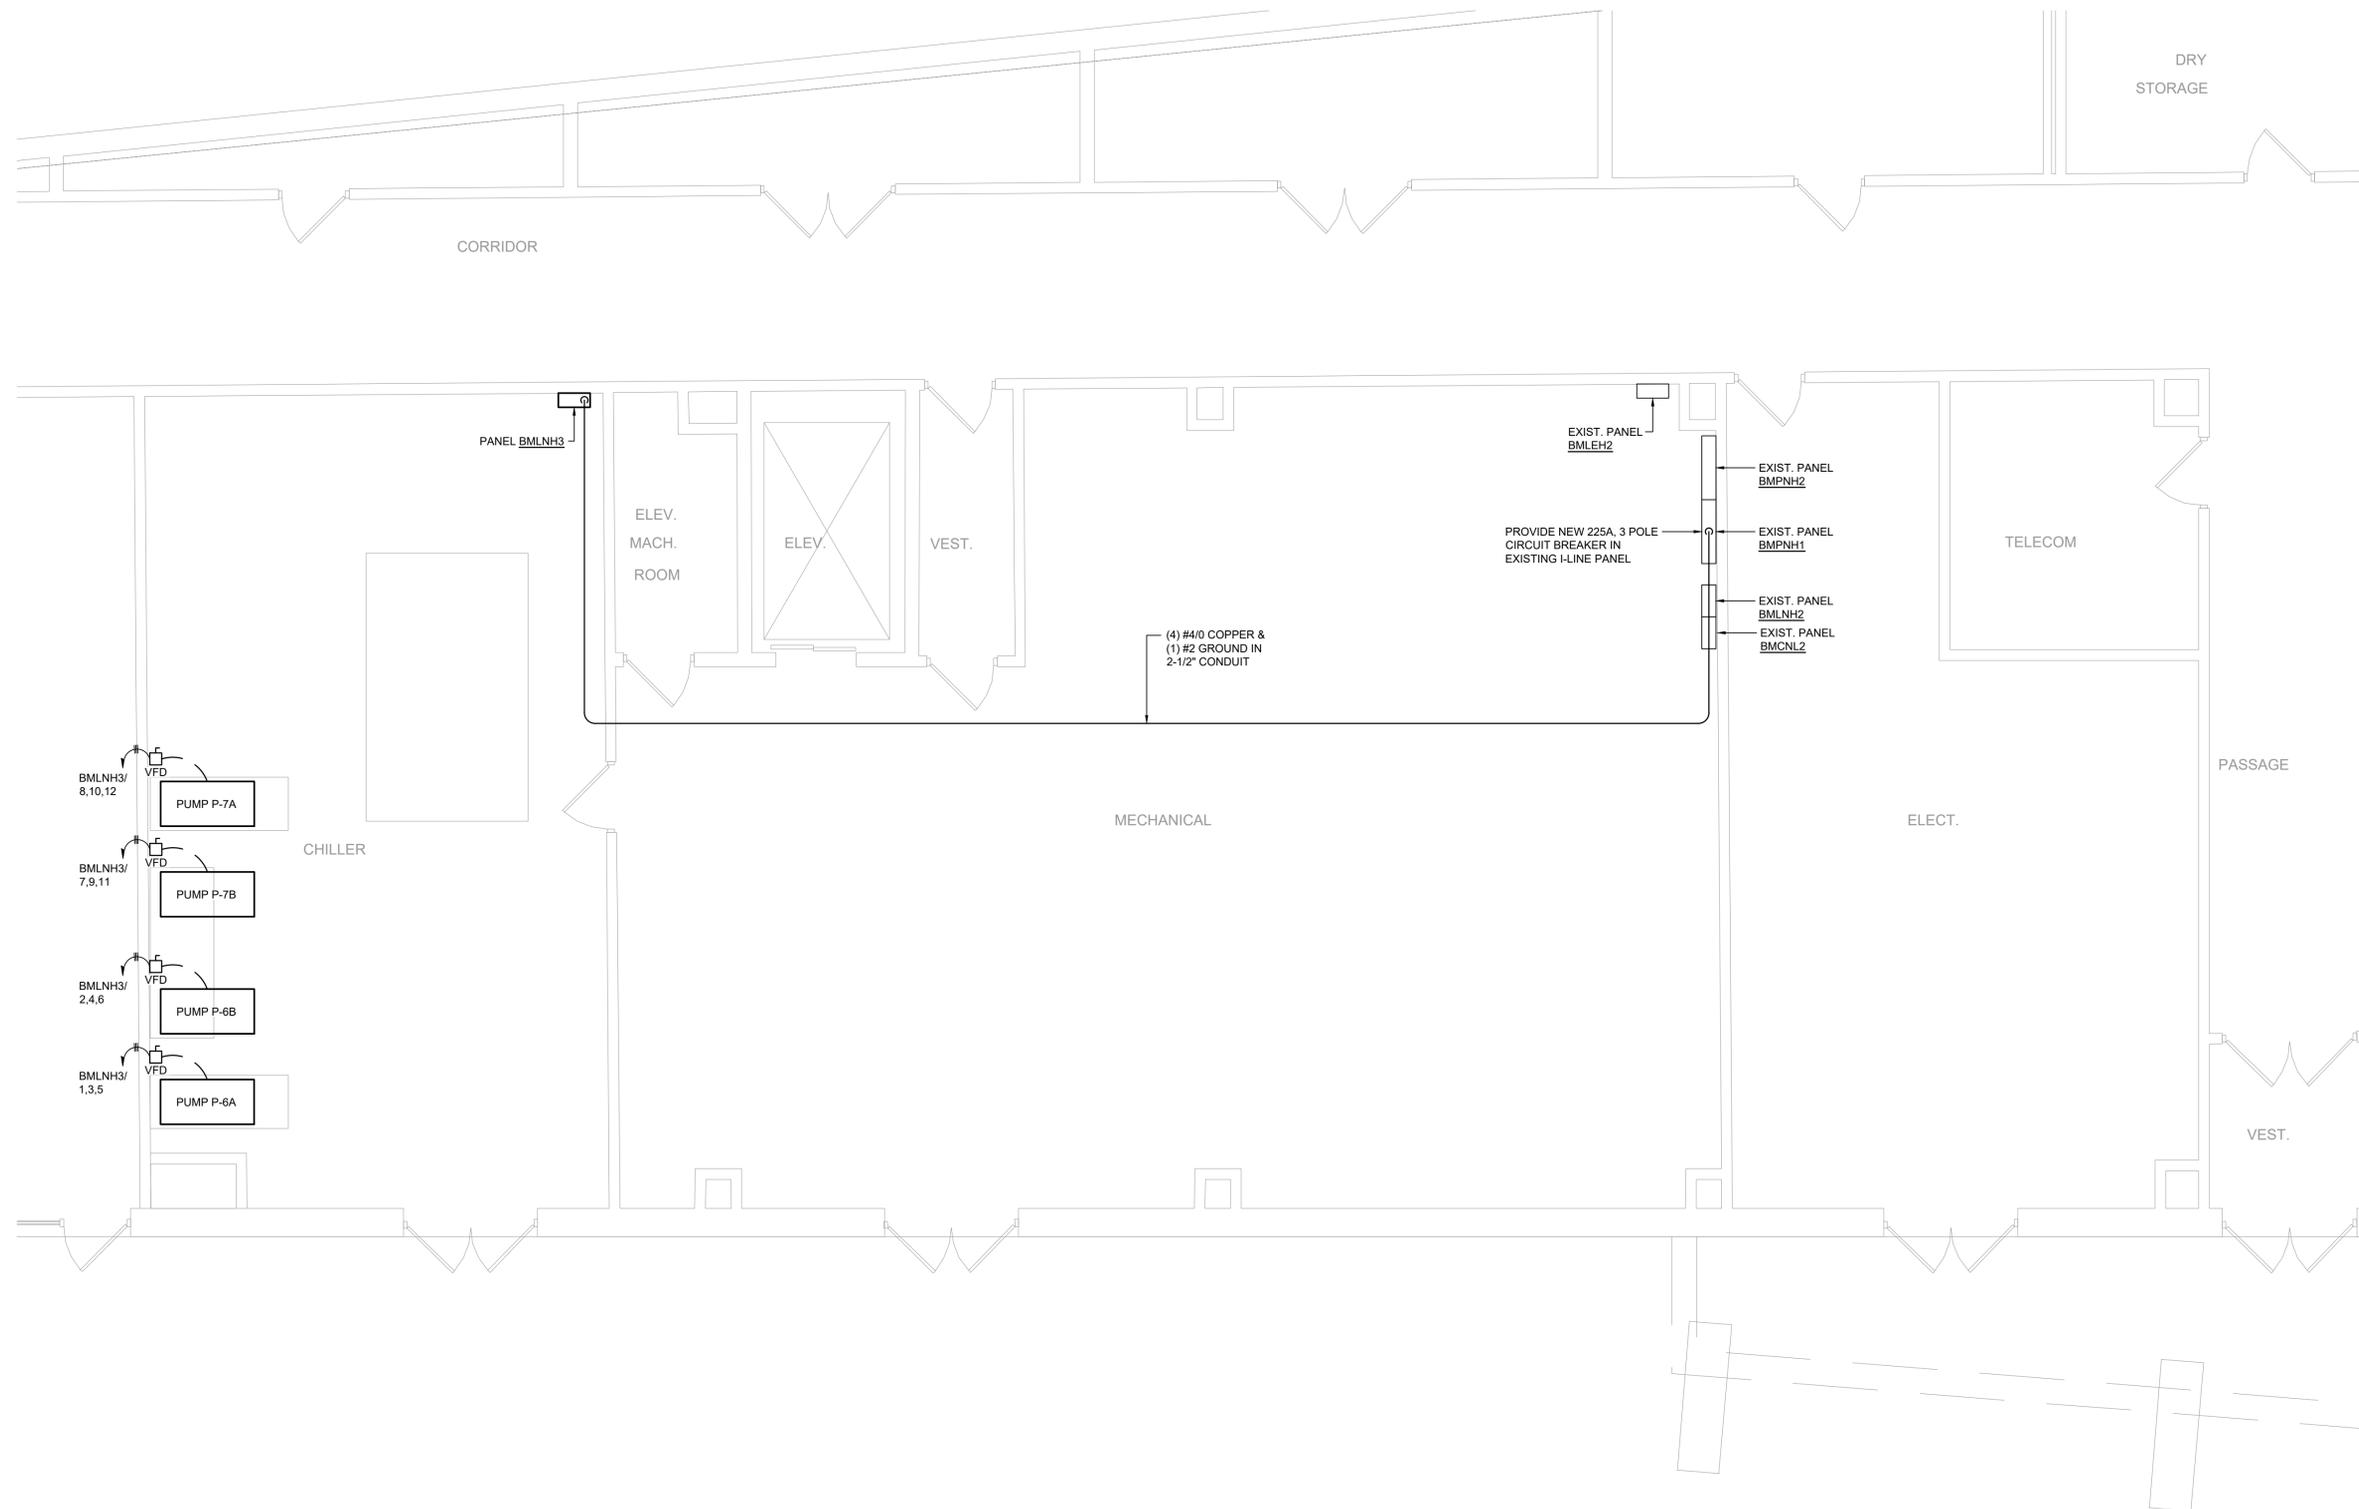
DATE:	DRN	CHK	DESCRIPTION
05.27.2022	BJK	MGB	CONSTRUCTION SET

REV.	DATE	DRN	CHK	DESCRIPTION

PROJECT NO. 2149	SHEET NO. ED.203
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1 Roof Electrical Demolition Plan
 ED.203 Scale: 1/4" = 1'-0"



KEY PLAN:
'CORNWALL CENTRAL HIGH SCHOOL'

ROUTE 94
 TRUE NORTH
 PROJECT NORTH

PROJECT:
CORNWALL CENTRAL HIGH SCHOOL COOLING TOWER REPLACEMENT PROJECT
 10 DRAGON DRIVE
 NEW WINDSOR, NEW YORK 12553
 SED #:44-03-01-06-0-012-008

SUB-CONSULTANT:

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LOWER LEVEL ELECTRICAL PLAN

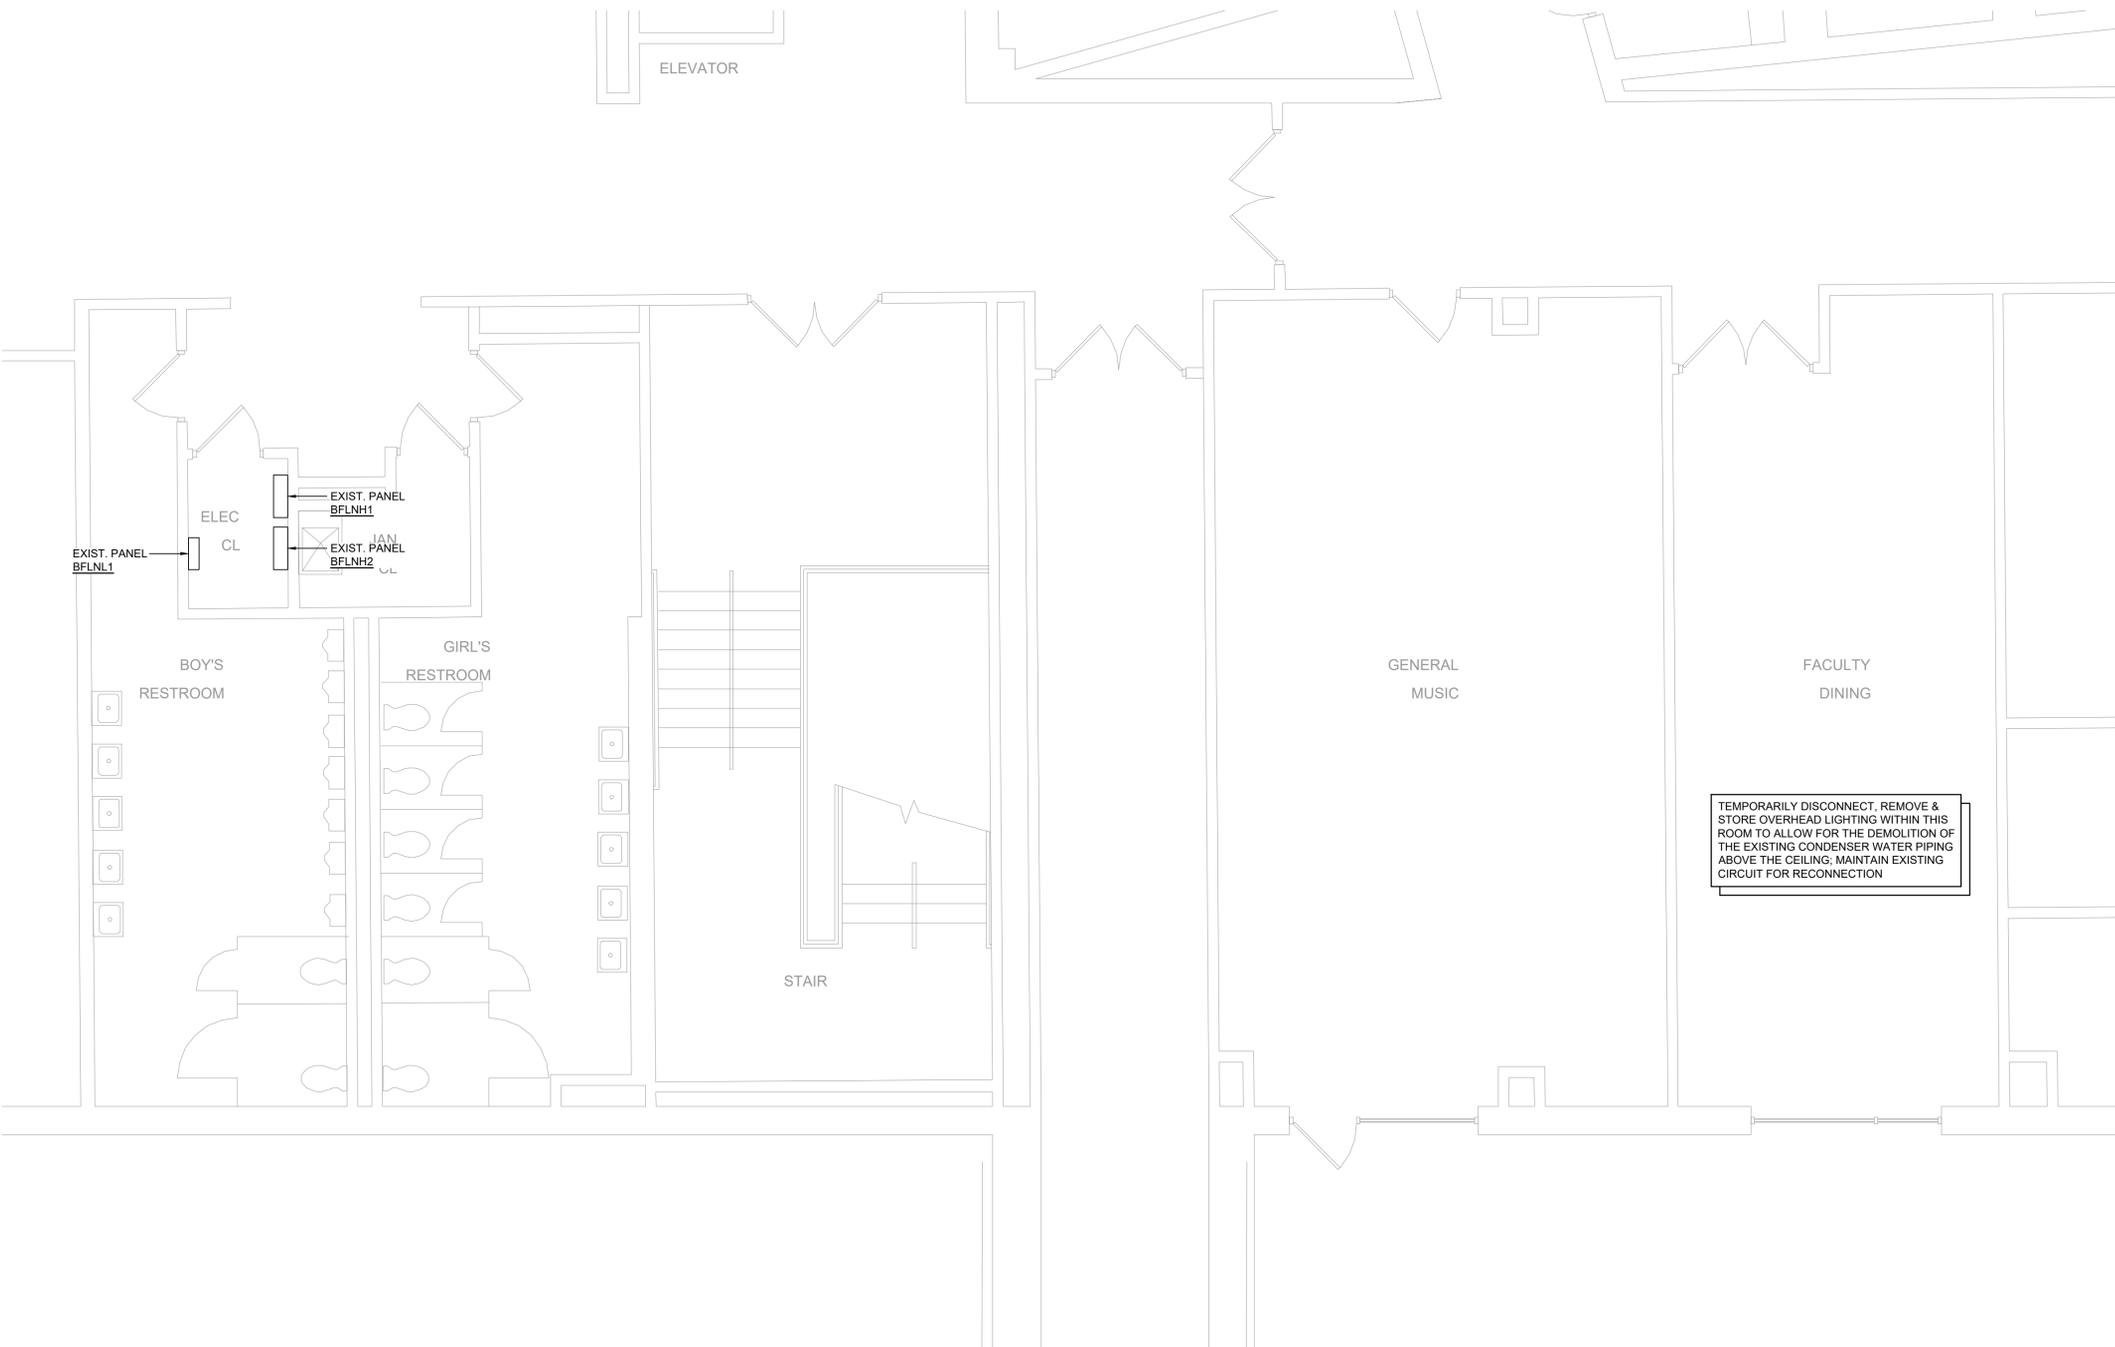
DATE:	DRN:	CHK:	DESCRIPTION:
05.27.2022	BJK	MGB	CONSTRUCTION SET

REV.:	DATE:	DRN:	CHK:	DESCRIPTION:

PROJECT NO. **2149** SHEET NO. **E.201**

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1 Lower Level Electrical Plan
 E.201 Scale: 1/4" = 1'-0"



1 Main Level Electrical Plan
 E.202 Scale: 1/4" = 1'-0"

KEY PLAN:
 'CORNWALL CENTRAL HIGH SCHOOL'

ROUTE 94

TRUE NORTH

PROJECT NORTH

PROJECT:
 CORNWALL CENTRAL HIGH SCHOOL
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MAIN LEVEL ELECTRICAL PLAN

DATE	DRN	CHK	DESCRIPTION
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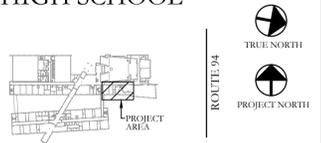
REV.	DATE	DRN	CHK	DESCRIPTION

PROJECT NO. 2149	SHEET NO. E.202
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KEY PLAN:

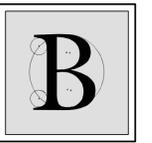
'CORNWALL CENTRAL HIGH SCHOOL'



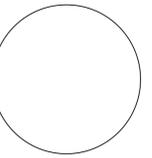
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ROOF ELECTRICAL PLAN

DATE	DRN	CHK	DESCRIPTION
05.27.2022	BJK	MGB	CONSTRUCTION SET

REV.	DATE	DRN	CHK	DESCRIPTION

PROJECT NO.

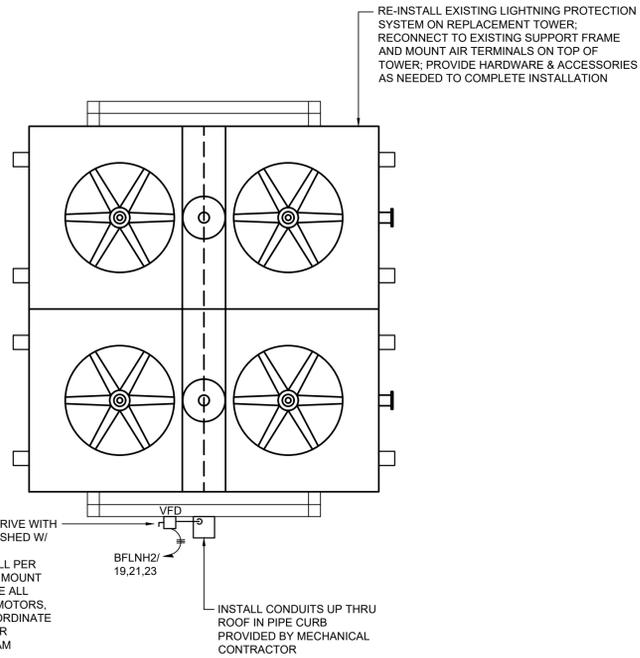
2149

SHEET NO.

E.203

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1 Roof Electrical Plan
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