

# DOMINICAN UNIVERSITY HENNESSY CENTER ROOFTOP HVAC INSTALLATION

495 WESTERN HIGHWAY,  
ORANGEBURG, NY 10962



CPL | Architecture Engineering Planning  
2875 Route 35, Suite 75-1  
Katonah, NY 10536  
CPLteam.com



**PROJECT INFORMATION**

Project Number  
**16669.00**  
Client Name  
**DOMINICAN UNIVERSITY**

Project Name  
**HENNESSY CENTER  
ROOFTOP HVAC INSTALLATION**

Project Address  
**495 WESTERN HIGHWAY  
ORANGEBURG, NY 10962**

**PROJECT ISSUE & REVISION SCHEDULE**

No. Date Description

## GENERAL NOTES

THE DESIGN OF THIS PROJECT CONFORMS TO ALL APPLICABLE PROVISIONS OF NEW YORK STATE UNIFORM FIRE PREVENTION AND BUILDING CODE, THE NEW YORK STATE ENERGY CONSERVATION CODE, AND THE MANUAL OF PLANNING STANDARDS OF THE NEW YORK STATE EDUCATION DEPARTMENT.

THE WORK OF THIS PROJECT WILL NOT INVOLVE KNOWN OR SUSPECTED ASBESTOS-CONTAINING BUILDING MATERIALS AND WILL BE DONE IN ACCORDANCE WITH INDUSTRIAL CODE RULE #56.

## DRAWING LIST


- T000 TITLE SHEET
- STRUCTURAL
- S101 RTU SUPPORT FRAMING
- ARCHITECTURAL
- A501 ROOF DETAILS
- MECHANICAL
- H000 MECHANICAL SYMBOLS LIST
- H101 LOCKER ROOM DEMOLITION PLAN
- H102 ROOF DEMOLITION PLAN
- H201 LOCKER ROOM NEW WORK PLAN
- H202 ROOF NEW WORK PLAN
- H500 CONTROL SCHEMATICS
- H900 MECHANICAL DETAILS AND SCHEDULES
- ELECTRICAL
- E000 ELECTRICAL NOTES AND SYMBOLS
- E101 FIRST FLOOR ELECTRICAL DEMOLITION PLAN
- E102 ROOF ELECTRICAL DEMOLITION PLAN
- E202 ROOF ELECTRICAL NEW WORK PLAN

Plotted By: Chelene Gabriel

Date last plotted: 8/22/2022 11:45 AM

Date last accessed: 8/22/2022 11:41 AM

Sheet size: 24x36  
Drawing Name: S:\Projects\Dominican Col Gym Roof Study\Design\06\CAD\CAD\ARCH\A0\CPL 2021 24x36 Cover Sheet.dwg

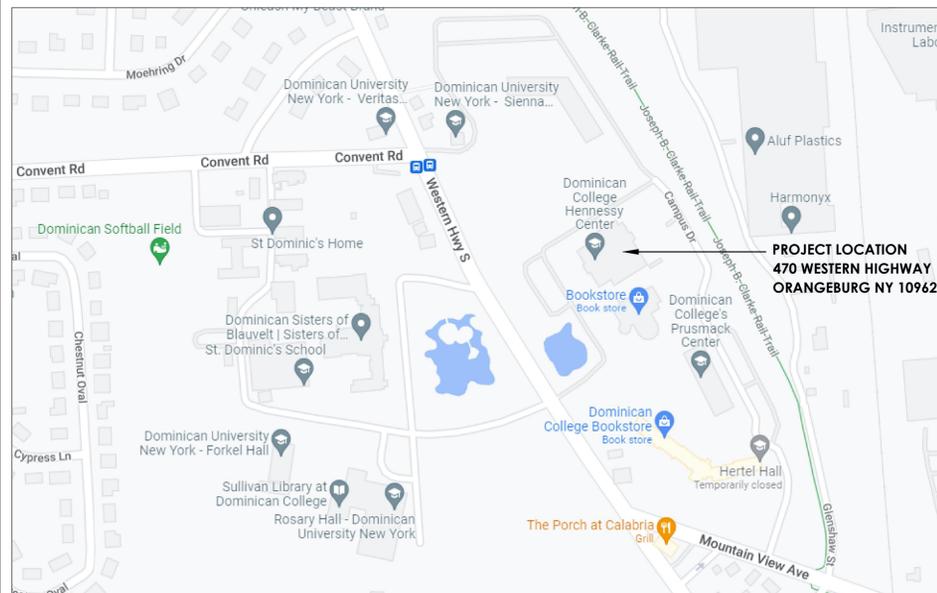


### OWNER

**DOMINICAN UNIVERSITY**  
470 WESTERN HIGHWAY  
ORANGEBURG NY, 10962  
T. 845-848-7814  
[www.uri.com](http://www.uri.com)

### ARCHITECTURE, ENGINEERING

**CPL**  
2875 ROUTE 35, SUITE 75-1  
KATONAH, NY 10536  
T. 914-276-0777  
F. 914-276-0779  
CPLTEAM.COM

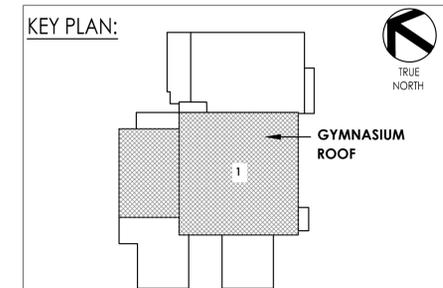

PROFESSIONAL STAMPS


NEW YORK STATE EDUCATION STATUTE  
§ 1405.4(1)(b) OF THE NEW YORK STATE EDUCATION LAW AND THE COMMERCE  
REGULATIONS THEREUNDER REQUIRE AN ARCHITECT OR ENGINEER TO SEAL AND SIGN  
ARCHITECTURAL PLANS AND ENGINEERING PLANS. THE ARCHITECT OR ENGINEER  
BEARING THE SEAL OF AN ARCHITECT, ENGINEER OR SURVEYOR IS ADVISED THE ACTING  
PARTY SHALL APPEAR TO THE BEST OF HIS OR HER BELIEF AND BE GUIDED BY FOLLOWING  
THEIR SIGNATURE AND THE DATE OF SUCH SIGNATURE, AND A SPECIFIC DESCRIPTION OF THE  
ALLOCATION.

**SHEET INFORMATION**

Issued	Scale
08/22/2022	NO SCALE
Project Status	
ISSUED TO BID	
Drawn By	Checked By
CG	CG
Drawing Title	
<b>TITLE SHEET</b>	

Drawing Number      Revision Number

**T000**

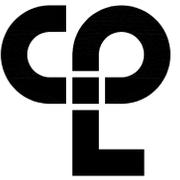

CPL | Architecture Engineering Planning  
2875 Route 35, Suite 75-1  
Katonah, NY 10536  
CPL@aam.com



ZANGRILLI ENGINEERING, P.C.  
322 ORISKANY BOULEVARD  
WESTBESICO, NEW YORK 13462  
(518) 736-7011

PROJECT INFORMATION

Project Number  
16649.00  
Client Name  
DOMINICAN UNIVERSITY

Project Name  
HENNESSY CENTER  
ROOFTOP HVAC INSTALLATION

Project Address  
495 WESTERN HIGHWAY  
ORANGEBURG, NY 10962

PROJECT ISSUE & REVISION SCHEDULE  
1.04.2018.1.0726. Date Description  
1.04.2018.1.0726.

PROFESSIONAL STAMPS



NEW YORK STATE ENGINEERING EXAMINER  
I, A MEMBER OF THE NEW YORK STATE ENGINEERING LAW AND THE COMMISSIONERS  
REGULATIONS FOR ANY PERSON, UNDER THE DIRECTION OF A LICENSED  
ENGINEERING EXAMINER OR ARCHITECTURE TO OBTAIN A LICENSE AND TO BE  
RENEWED BY THE STATE ENGINEERING EXAMINER, THE EXAMINEE  
PARTY SHALL APPLY TO THE STATE ENGINEER, AND THE AGENCY SHALL BE FOLLOWED BY  
THE EXAMINER AND THE STATE OF NEW YORK, AND A SPECIFIC DESCRIPTION OF THE  
ALLEGATION.

ISSUE INFORMATION  
Issued 08/22/2022 Scale AS NOTED  
Project Status  
Issued to IND  
Drawn by AJZ Checked by AJZ  
Drawing Title  
RTU SUPPORT FRAMING


Drawing Number  
Revision Number

S101


STRUCTURAL NOTES

1. STRUCTURAL STEEL:  
A. DESIGN STANDARD . . . . . A.I.S.C. 2010  
B. DETAILING STANDARD . . . . . A.I.S.C. 2010  
C. GRADE . . . . . A.S.T.M. A36  
D. SHOP COAT . . . . . RED OXIDE PRIMER


2. CONNECTIONS:  
A. WELDS . . . . . E 70 XX ELECTRODES

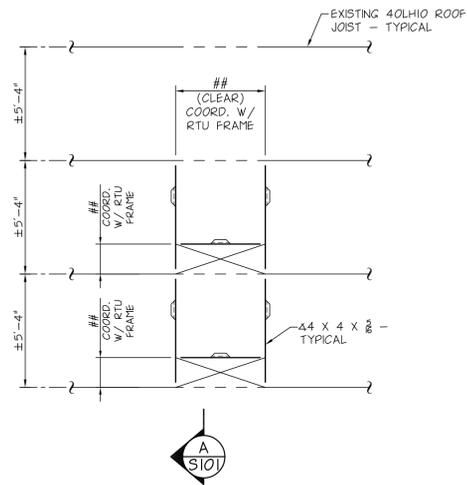

RTU SUPPORT FRAMING  
SCALE: 1/4" = 1'-0"

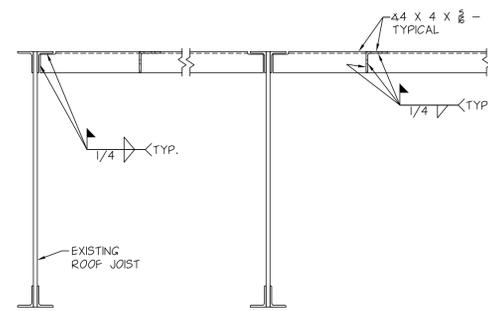

SECTION A-S101  
SCALE: 3/4" = 1'-0"

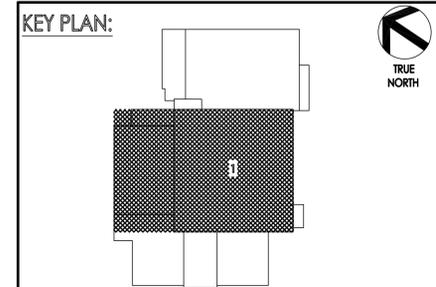

Sheet Size: 24x36  
 Drawing Name: C:\Users\Albert.Zangrilli\Desktop\Consultant\Bender.dwg  
 Date last modified: 8/22/2022 10:28 AM  
 Date last accessed: 8/22/2022 10:28 AM  
 Plotted By: Albert.Zangrilli



CPL | Architecture Engineering Planning  
 2875 Route 35, Suite 75-1  
 Katonah, NY 10536  
 CPLearn.com



**PROJECT INFORMATION**

Project Number  
 16669.00

Client Name  
 DOMINICAN UNIVERSITY

Project Name  
 HENNESSY CENTER  
 ROOFTOP HVAC INSTALLATION

Project Address  
 495 WESTERN HIGHWAY  
 ORANGEBURG, NY 10962

**PROJECT ISSUE & REVISION SCHEDULE**

No. Date Description

**PROFESSIONAL STAMPS**

NEW YORK STATE EDUCATION STATUTE  
 REG. A VALIDATION OF THE NEW YORK STATE EDUCATION LAW AND THE COMMISSIONERS  
 REG. A VALIDATION OF ANY PERSON, IN SO DOING UNDER THE DIRECTION OF A LICENSED  
 ARCHITECT, ENGINEER OR LAND SURVEYOR, SHALL BE AN OFFENSE AND, IF A FURTHER  
 PART SHALL APPEAR TO THE REG. THE REG. AND THE REGISTRATION, AS FOLLOWS BY  
 THEIR SIGNATURE AND THE DATE OF SUCH ALTERATION, AND A SPECIFIC DESCRIPTION OF THE  
 ALTERATION.

**SHEET INFORMATION**

Issued  
 08/22/2022  
 Scale  
 AS NOTED

Project Status  
 ISSUED TO BID

Drawn By  
 CG  
 Checked By  
 CG

Drawing Title  
 ROOF DETAILS

Drawing Number  
 Revision Number


**DU  
 A501**

Plotted By: Chloé Gabriel

Date last plotted: 8/22/2022 11:29 AM


Date last accessed: 8/19/2022 9:41 AM

Sheet size: 24x36  
 Drawing Name: S:\Projects\Dominican Col Gym Roof Study\Design\06 CAD\CAD ARCH\A51 A501.dwg

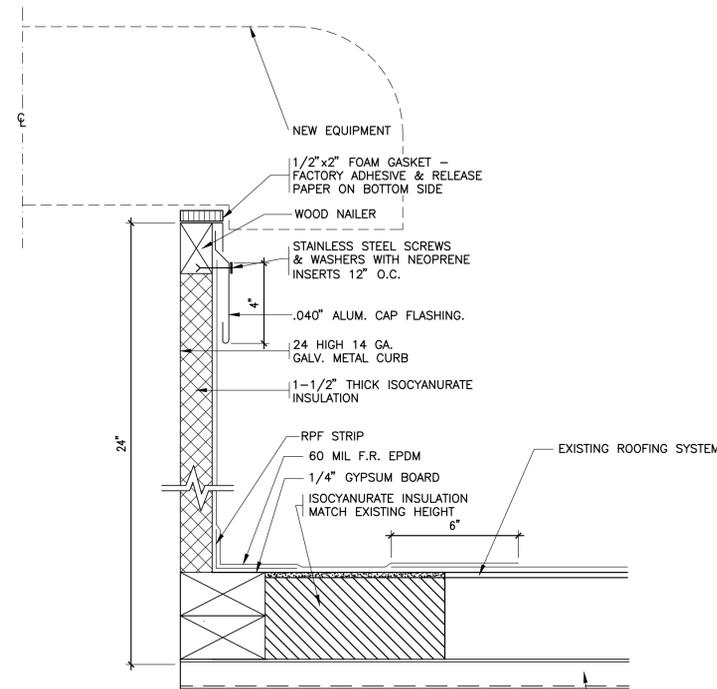

- NOTE:
- CUT & REMOVE BUILT-UP ROOF & INSULATION WHERE NEEDED TO REMOVE EXISTING CURB.
  - INSTALL NEW 24" HIGH CURB.
  - RESTORE INSULATION & BUILT-UP ROOF.


**2 FAN CURB (BUR)**  
 SCALE: 3"=1'-0"

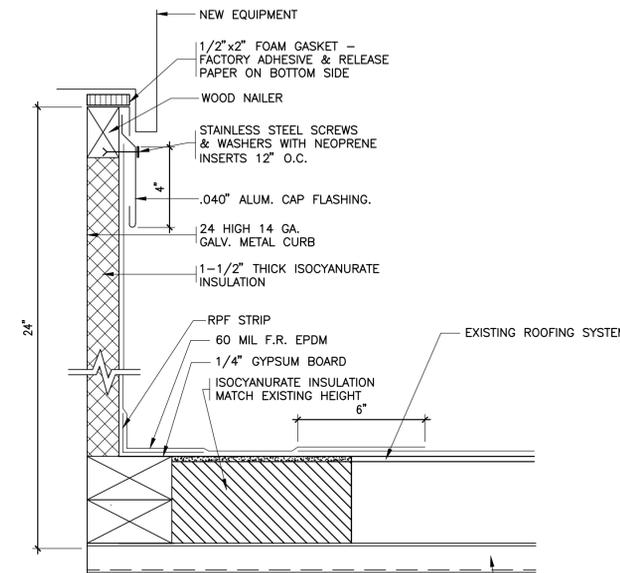

- NOTE:
- CUT & REMOVE BUILT-UP ROOF & INSULATION WHERE NEEDED TO REMOVE EXISTING CURB.
  - INSTALL NEW 24" HIGH CURB.
  - RESTORE INSULATION & BUILT-UP ROOF.

**1 HVAC CURB (BUR)**  
 SCALE: 3"=1'-0"

**KEY PLAN:**

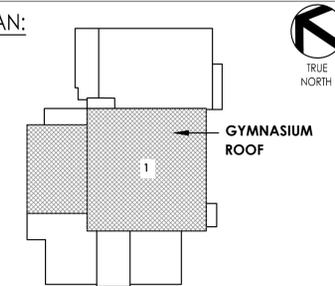

HVAC SYMBOLS LIST


SYMBOL	DESCRIPTION	SYMBOL	DESCRIPTION	SYMBOL	DESCRIPTION	SYMBOL	DESCRIPTION	SYMBOL	DESCRIPTION
AAD	AUTOMATIC AIR DAMPER		CONNECTION - TOP		DOUBLE WALL LINED DUCT		SUPPLY / RETURN / EXHAUST AIR TAKEOFFS		ELECTRIC/PNEUMATIC SWITCH OR RELAY
ACC	AIR-COOLED CONDENSING UNIT		CONNECTION - BOTTOM		DUCT SECTION - SUPPLY		DUCT SECTION - RETURN/EXHAUST		PNEUMATIC/ELECTRIC SWITCH OR RELAY
AD	ACCESS DOOR		DIRECTION OF FLOW		DUCT SECTION - ROUND DUCT IN INCHES		DUCT SECTION - FLAT OVAL DUCT IN INCHES		CURRENT TRANSDUCER
AFF	ABOVE FINISHED FLOOR		REDUCER		ACOUSTIC THERMAL LINING		FLEXIBLE DUCTWORK		OPEN/CLOSED
AHU	AIR HANDLING UNIT		CAP OR PLUG		FIRE DAMPER		GATE VALVE		START/STOP
BBD	BOILER BLOW DOWN		ELBOW DOWN		SMOKE DAMPER		BALANCING VALVE		ENABLE/DISABLE
BD	BACKDRAFT DAMPER		ELBOW UP		COMBINATION FIRE AND SMOKE DAMPER		STRAINER		TEMPERATURE SENSOR (DUCT OR PIPE MOUNTED)
CA	COMPRESSED AIR		TEE OUTLET - UP		VOLUME DAMPER		STRAINER WITH BLOW-DOWN		HUMIDITY SENSOR (DUCT MOUNTED)
CD	COOLING COIL CONDENSATE DRAIN		TEE OUTLET - DOWN		DAMPER CONTROL, PARALLEL BLADE		BUTTERFLY VALVE		FLOW TRANSMITTER
CFM	CUBIC FEET PER MINUTE		UNION		DAMPER CONTROL, OPPOSED BLADE		BUTTERFLY CONTROL VALVE, PNEUMATIC 2-WAY		PRESSURE TRANSMITTER
CHWR	CHILLED WATER RETURN		GLOBE VALVE		CHECK VALVE		BUTTERFLY CONTROL VALVE, ELECTRIC ACTUATOR		DIFFERENTIAL PRESSURE TRANSMITTER
CHWS	CHILLED WATER SUPPLY		TRIPLE DUTY VALVE		AUTOMATIC AIR DAMPER		GLOBE VALVE		ELECTRIC/PNEUMATIC TRANSDUCER
CR	CONDENSER WATER RETURN		GAS COCK, PLUG VALVE		BACK DRAFT DAMPER		CHECK VALVE		ELECTRIC/ELECTRONIC TRANSDUCER
CS	CONDENSER WATER SUPPLY		UNDERCUT DOOR 1"		BLAST GATE		UNDERCUT DOOR 1"		DUCT SMOKE DETECTOR
CW	DOMESTIC COLD WATER		LOUVERED DOOR W/ SQ. FT. OF FREE AREA		AIR DUCT (FIRST FIGURE IS DUCT WIDTH/TOP, SECOND FIGURE IS DUCT DEPTH)		LOUVERED DOOR W/ SQ. FT. OF FREE AREA		SPACE THERMOSTAT
D	DRAIN		AIR VENT - MANUAL		MULTI-BLADE AIR EXTRACTOR		AIR VENT - MANUAL		SPACE TEMPERATURE SENSOR
(E)	EXISTING		AIR VENT - AUTOMATIC		TURNING VANES		AIR VENT - AUTOMATIC		SPACE CARBON DIOXIDE SENSOR
EA	EXHAUST AIR		FLANGE		EXISTING WORK TO BE REMOVED (HATCHED)		FLANGE		SPACE NATURAL GAS SENSOR
EC	ELECTRICAL CONTRACTOR		CONTROL/SOLENOID VALVE, ELECTRIC 2-WAY		POINT OF DISCONNECTION		CONTROL/SOLENOID VALVE, ELECTRIC 2-WAY		SPACE CARBON MONOXIDE SENSOR
EF	EXHAUST FAN		CONTROL VALVE, ELECTRIC 3-WAY		AIR FLOW SENSOR		CONTROL VALVE, ELECTRIC 3-WAY		SPACE CARBON MONOXIDE SENSOR WITH GUARD
ERHC	ELECTRIC REHEAT COIL		CONTROL VALVE, PNEUMATIC 2-WAY		FILTER		CONTROL VALVE, PNEUMATIC 2-WAY		SPACE SENSOR WITH GUARD
ETR	EXISTING TO REMAIN		CONTROL VALVE, PNEUMATIC 3-WAY		TRANSITION SQUARE TO ROUND		CONTROL VALVE, PNEUMATIC 3-WAY		SPACE HUMIDISTAT
EUH	ELECTRIC UNIT HEATER		RELIEF / SAFETY VALVE		HUMIDIFIER DISPERSION TUBE		RELIEF / SAFETY VALVE		WATER FLOW SENSOR
F&T	FLOAT AND THERMOSTATIC TRAP		PRESSURE REDUCING VALVE		RISE IN DUCT		FLOAT & THERMOSTATIC TRAP		PNEUMATIC ACTUATOR
FCU	FAN-COIL UNIT		VACUUM BREAKER		DROP IN DUCT		VACUUM BREAKER		ELECTRIC ACTUATOR
FFM	FEET PER MINUTE		EXPANSION COMPENSATOR W/ GUIDES		LONG RADIUS 90° ELBOW R/W=1.5		EXPANSION COMPENSATOR W/ GUIDES		VARIABLE SPEED / FREQUENCY DRIVE
FT	FIN-TUBE		PIPE ANCHOR		LONG RADIUS 45° ELBOW R/W=1.5		PIPE ANCHOR		COOLING COIL
GC	GENERAL CONTRACTOR		PIPE GUIDE		90° ELBOW WITH TURNING VANES		PIPE GUIDE		HEATING COIL
GR	GLYCOL RETURN		THERMOSTATIC TRAP		90 VERTICAL SPLIT OFF (PLAN VIEW)		THERMOSTATIC TRAP		GAS FURNACE
GS	GLYCOL SUPPLY		BUCKET TRAP		AIR TERMINAL UNIT-DUCTWORK U - UNIT TYPE		BUCKET TRAP		HUMIDIFIER
HC	HVAC CONTRACTOR		THERMODYNAMIC TRAP		AIR TERMINAL UNIT-DUCTWORK U - UNIT TYPE		THERMODYNAMIC TRAP		ALARM
HHWR	HEATING HOT WATER RETURN		THERMOMETER		CEILING DIFFUSER WITH NECK SIZE, TYPE, & CFM		THERMOMETER		STATUS
HHWS	HEATING HOT WATER SUPPLY		WELL		ROUND CEILING DIFFUSER		WELL		FLOW SWITCH
HP	HEAT PUMP		PRESSURE GAUGE		SQUARE OR RECTANGULAR CEILING GRILLE		HEAT PUMP		DIFFERENTIAL STATIC PRESSURE SWITCH
HPC	HIGH PRESSURE CONDENSATE		STEAM PRESSURE GAUGE WITH 1/4" NEEDLE VALVE		SUPPLY REGISTER, RETURN OR EXHAUST GRILLE		HIGH PRESSURE CONDENSATE		RELAY
HPS	HIGH PRESSURE STEAM		REFRIGERANT LIQUID PIPE		SUPPLY DIFFUSER, 1-WAY, 2-WAY, 3-WAY		HIGH PRESSURE STEAM		PRESSURE GAUGE
LF	LINEAR FOOTAGE OF FIN-TUBE RADIATION		REFRIGERANT SUCTION PIPE		CEILING DIFFUSER WITH NECK SIZE, TYPE, & CFM		REFRIGERANT SUCTION PIPE		FREEZE-STAT
LPC	LOW PRESSURE CONDENSATE		ROOFTOP UNIT		FAN POWERED AIR TERMINAL UNIT U - UNIT TYPE		ROOFTOP UNIT		DIGITAL INPUT (TO BUILDING MANAGEMENT SYSTEM)
LPG	LIQUEFIED PROPANE GAS		ROOF VENT		AIR TERMINAL UNIT-DUCTWORK U - UNIT TYPE		ROOF VENT		DIGITAL OUTPUT (FROM BUILDING MANAGEMENT SYSTEM)
LPS	LOW PRESSURE STEAM		PNEUMATIC (CONTROL) TUBING		CEILING RETURN OR EXHAUST GRILLE WITH SIZE, TYPE, & CFM		LOW PRESSURE STEAM		ANALOG OUTPUT (FROM BUILDING MANAGEMENT SYSTEM)
MBH	1,000 BTU/HR		BUTTERFLY VALVE WITH PNEUMATIC AND MANUAL OPERATORS		BASE MOUNTED PUMP WITH SIZE, TYPE, & CFM		1,000 BTU/HR		ANALOG INPUT (TO BUILDING MANAGEMENT SYSTEM)
MC	MECHANICAL CONTRACTOR		IN-LINE PUMP		IN-LINE PUMP WITH SIZE, TYPE, & CFM		MECHANICAL CONTRACTOR		ELECTRICAL INTERFACE
MPC	MEDIUM PRESSURE CONDENSATE		AIR TERMINAL UNIT WITH REHEAT COIL AND SOUND ATTENUATOR		AIR TERMINAL UNIT WITH REHEAT COIL AND SOUND ATTENUATOR WITH SIZE, TYPE, & CFM		MEDIUM PRESSURE CONDENSATE		SPEED FEED BACK
MPS	MEDIUM PRESSURE STEAM		AIR TERMINAL UNIT WITH REHEAT COIL		AIR TERMINAL UNIT WITH REHEAT COIL WITH SIZE, TYPE, & CFM		MEDIUM PRESSURE STEAM		END SWITCH
MRD	MONOFLO FITTING DOWN - HHWR		AIR TERMINAL UNIT		AIR TERMINAL UNIT WITH SIZE, TYPE, & CFM		MONOFLO FITTING DOWN - HHWR		POSITION FEEDBACK
MSD	MONOFLO FITTING DOWN - HHWS		WATER-TO-AIR HEAT PUMP		WATER-TO-AIR HEAT PUMP WITH SIZE, TYPE, & CFM		MONOFLO FITTING DOWN - HHWS		TRAVERSE AVERAGING SENSOR
MSU	MONOFLO FITTING DOWN - HHWS		WATER-TO-WATER HEAT PUMP		WATER-TO-WATER HEAT PUMP WITH SIZE, TYPE, & CFM		MONOFLO FITTING DOWN - HHWS		PROBE SENSOR
MUW	MAKE-UP WATER		WALL TO WALL FIN TUBE ENCLOSURE		WALL TO WALL FIN TUBE ENCLOSURE WITH SIZE, TYPE, & CFM		MAKE-UP WATER		FREEZE STAT SENSOR
NC	NORMALLY CLOSED						NORMALLY CLOSED		
NG	NATURAL GAS						NATURAL GAS		
NO	NORMALLY OPEN						NORMALLY OPEN		
NTS	NOT TO SCALE						NOT TO SCALE		
OA	OUTSIDE AIR						OUTSIDE AIR		
PC	PLUMBING CONTRACTOR						PLUMBING CONTRACTOR		
PD	PUMP DISCHARGE						PUMP DISCHARGE		
PHWR	PRIMARY HEATING HOT WATER RETURN						PRIMARY HEATING HOT WATER RETURN		
PHWS	PRIMARY HEATING HOT WATER SUPPLY						PRIMARY HEATING HOT WATER SUPPLY		
RA	RETURN AIR						RETURN AIR		
RD	REFRIGERANT DISCHARGE						REFRIGERANT DISCHARGE		
RHC	HOT WATER REHEAT COIL						HOT WATER REHEAT COIL		
RL	REFRIGERANT LIQUID PIPE						REFRIGERANT LIQUID PIPE		
RSL	REFRIGERANT SUCTION PIPE						REFRIGERANT SUCTION PIPE		
RTU	ROOFTOP UNIT						ROOFTOP UNIT		
RV	ROOF VENT						ROOF VENT		
SA	SUPPLY AIR						SUPPLY AIR		
SHWR	SECONDARY HEATING HOT WATER RETURN						SECONDARY HEATING HOT WATER RETURN		
SHWS	SECONDARY HEATING HOT WATER SUPPLY						SECONDARY HEATING HOT WATER SUPPLY		
SSI	SPLIT SYSTEM INDOOR SECTION (EVAPORATOR SECTION)						SPLIT SYSTEM INDOOR SECTION (EVAPORATOR SECTION)		
SSO	SPLIT SYSTEM OUTDOOR SECTION (CONDENSING UNIT)						SPLIT SYSTEM OUTDOOR SECTION (CONDENSING UNIT)		
TC	TEMPERATURE CONTROLS CONTRACTOR						TEMPERATURE CONTROLS CONTRACTOR		
UH	UNIT HEATER						UNIT HEATER		
UV	UNIT VENTILATOR						UNIT VENTILATOR		
V	VENT						VENT		
WAHP	WATER-TO-AIR HEAT PUMP						WATER-TO-AIR HEAT PUMP		
WWHP	WATER-TO-WATER HEAT PUMP						WATER-TO-WATER HEAT PUMP		
							WALL TO WALL FIN TUBE ENCLOSURE		

SYMBOLS GENERAL NOTES:

1) VALVE AND DAMPER ACTUATOR TYPES (ELECTRIC OR PNEUMATIC) WHICH ARE INDICATED IN HVAC TEMPERATURE CONTROL DRAWINGS SHALL SUPERSEDE TYPE INDICATED ON ALL OTHER HVAC DRAWINGS.

HVAC CONTRACTOR GENERAL NOTES:

- IT IS THE RESPONSIBILITY OF THE CONTRACTOR TO FIELD VERIFY EXISTING CONDITIONS WITHIN THE BUILDING PRIOR TO COMMENCEMENT OF ALL DEMOLITION AND NEW WORK.
- IT IS THE RESPONSIBILITY OF THE CONTRACTOR TO REMOVE AND REPLACE EXISTING CEILINGS, UNLESS OTHERWISE NOTED ON THE ARCHITECTURAL DRAWINGS. FOR PERFORMING DEMOLITION OR NEW WORK WITHIN THE BUILDING, THE EXISTING CEILINGS SHALL BE REMOVED IN A MANNER TO AVOID DAMAGE TO THE CEILING SYSTEMS. STORAGE OF CEILING SYSTEM COMPONENTS FOR REINSTALLATION IS THE RESPONSIBILITY OF THE CONTRACTOR. THE STORAGE OF ALL MATERIAL SHALL BE IN AREAS OR LOCATIONS APPROVED BY THE OWNER. THE OWNER WILL NOT COMPENSATE FOR ANY DAMAGED OR LOST MATERIAL WHILE IN STORAGE. AFTER COMPLETION OF ALL DEMOLITION OR NEW WORK, THE CONTRACTOR SHALL REINSTALL THE CEILING SYSTEMS TO MATCH THE ORIGINAL INSTALLATION.
- DEMOLITION DRAWINGS SHOW MAJOR EQUIPMENT, PIPING, AND DUCTWORK REMOVALS. THE INTENT IS NOT TO IDENTIFY ALL MISCELLANEOUS PIPING, PIPING ACCESSORIES, DUCTWORK, DUCTWORK ACCESSORIES, SUPPORTS, CONTROLS, CONTROL ACCESSORIES, CONTROL WIRING, CONDUIT, AND PNEUMATIC CONTROL TUBING TO BE DISCONNECTED AND REMOVED, BUT IS THE REQUIREMENT UNDER THIS CONTRACT. NO EQUIPMENT, PIPING, OR DUCTWORK SHALL BE ABANDONED IN PLACE, UNLESS OTHERWISE NOTED ON THE DRAWINGS.
- ALL EQUIPMENT INDICATED TO BE TURNED OVER TO THE OWNER SHALL BE DISCONNECTED AND REMOVED FROM THE EXISTING SYSTEMS AND DELIVERED (INCLUDING LOADING AND UNLOADING) TO A STORAGE AREA WITHIN THE BUILDING AS SELECTED BY THE OWNER. IT WILL BE THE RESPONSIBILITY OF THE CONTRACTOR TO REPAIR ANY EQUIPMENT DAMAGED DURING REMOVAL AND DELIVERY. ANY DAMAGE TO EQUIPMENT PRIOR TO DISCONNECTING SHOULD BE REPORTED TO THE OWNER'S REPRESENTATIVE. IF NOT REPORTED, THE CONTRACTOR TAKES FULL RESPONSIBILITY FOR REPAIRS TO THE EQUIPMENT.
- BEFORE DISCONNECTING, REMOVING, OR SERVICING ANY AIR CONDITIONING EQUIPMENT OR SYSTEMS CONTAINING REFRIGERANTS, THE EQUIPMENT OR SYSTEMS SHALL BE EVACUATED OF ALL REFRIGERANT PER THE LATEST ADOPTED RULES AND REGULATIONS BY THE UNITED STATES ENVIRONMENTAL PROTECTION AGENCY (EPA). THE CONTRACTOR OR TECHNICIAN PERFORMING THE WORK SHALL BE CERTIFIED BY AN EPA APPROVED CERTIFYING AGENCY OR ORGANIZATION.
- ALL DUCTWORK, PIPING, AND CONDUIT PENETRATIONS THROUGH RATED WALLS OR FLOORS SHALL BE PROVIDED WITH FIRE/SMOKE STOPPINGS PER SPECIFICATION. REFER TO CODE ANALYSIS DRAWING FOR ALL RATED WALL LOCATIONS. ALL FLOORS SHALL BE CONSIDERED RATED.
- UNLESS SHOWN ON THE ARCHITECTURAL DRAWINGS, IT IS THE RESPONSIBILITY OF THIS CONTRACT TO PATCH AND FINISH ALL EXISTING DUCTWORK OR PIPE PENETRATIONS THROUGH FLOORS, ROOFS, INTERIOR WALLS, AND EXTERIOR WALLS AFTER DEMOLITION WORK. IN ADDITION, ALL NEW PENETRATIONS SHALL BE PROVIDED FOR INSTALLATION OF MECHANICAL SYSTEMS INCLUDING, BUT NOT LIMITED TO, EQUIPMENT, CURBING, DUCTWORK, PIPING, CONTROLS, ETC. PATCHING AND FINISHING SHALL MATCH EXISTING CONSTRUCTION INCLUDING FIRE RATINGS. PROVIDE LINTELS PER LINTEL SCHEDULE.
- IT IS NOT THE INTENT OF THE DRAWINGS TO SHOW ALL AIR VENTS AND DRAINS IN THE PIPING SYSTEMS. IT IS THE RESPONSIBILITY OF THE CONTRACTOR TO PROVIDE AIR VENTS AT ALL SYSTEM HIGH POINTS AND AT AREAS WITHIN THE PIPING SYSTEMS THAT COULD ACCUMULATE OR TRAP AIR WHICH WOULD PREVENT PROPER VENTING OR OPERATION OF THE SYSTEMS. DRAINS SHALL BE PROVIDED AT ALL LOW POINTS WITHIN THE PIPING SYSTEM TO FACILITATE COMPLETE DRAINING OF THE SYSTEM.
- PROVIDE THERMAL EXPANSION COMPENSATORS AND THERMAL EXPANSION LOOPS IN PIPING SYSTEM PER INDUSTRY STANDARDS.

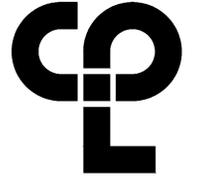

CP | Architecture Engineering Planning  
2875 Route 35, Suite 75-1  
Katonah, NY 10536  
CPlearn.com



PROJECT INFORMATION

Project Number: 16669.00  
Client Name: DOMINICAN UNIVERSITY  
Project Name: HVAC INSTALLATION  
HENNESSY CENTER  
Project Address: 495 WESTERN HIGHWAY, ORANGEBURG, NY 10962

PROJECT ISSUE & REVISION SCHEDULE

No. Date Description


PROFESSIONAL STAMPS

SHEET INFORMATION

Issued: 08/22/2022 Scale: NOT TO SCALE  
Project Status: ISSUED TO BID  
Drawn By: BEF Checked By: GMM  
Drawing Title: MECHANICAL SYMBOLS LIST

Drawing Number: GEN H000



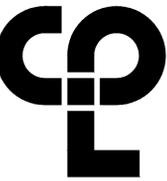

CP | Architecture Engineering Planning  
 2875 Route 35, Suite 75-1  
 Katonah, NY 10536  
 CPteam.com



**PROJECT INFORMATION**

Project Number  
16669.00  
 Client Name

**DOMINICAN UNIVERSITY**

**HVAC INSTALLATION**

HENNESSY CENTER

Project Address  
495 WESTERN HIGHWAY, ORANGEBURG, NY  
10962

**PROJECT ISSUE & REVISION SCHEDULE**

No. Date Description

**PROFESSIONAL STAMPS**

**NEW YORK STATE EDUCATION STATEMENT**

THIS IS A PLAN FOR THE NEW YORK STATE EDUCATION LAW AND THE COMMISSIONERS' REGULATION FOR ANY PERSON, IN EXERCISE UNDER THE DIRECTION OF A LICENSED ARCHITECT, ENGINEER OR LAND SURVEYOR, TO ACT AS DESIGNER OR AS A DESIGNER BEARING THE SEAL OF AN ARCHITECT, ENGINEER OR SURVEYOR IN ALL THE ACTS, TO BE PERFORMED BY HIM OR HER IN THE STATE OF NEW YORK, AND THE SIGNATURE AND THE DATE OF SUCH SIGNATURE, AND A SPECIFIC DESCRIPTION OF THE ACTIVATION.

**SHEET INFORMATION**

Issued 08/22/2022 Scale 1/8" = 1'-0"

Project Status

ISSUED TO BID

Drawn By

BKM

Drawing Title


ROOF DEMOLITION PLAN

Drawing Number

DU  
H102


**KEY NOTES:**

- 1 REMOVE EXISTING ROOFTOP UNIT AND CURB. DISCONNECT FROM EXISTING GAS PIPING AND PREPARE FOR NEW WORK.
- 2 ALT 1: REMOVE EXISTING EXHAUST FAN IN ITS ENTIRETY INCLUDING CURB. EXISTING DUCTWORK TO REMAIN. PREPARE FOR NEW WORK.
- 3 REMOVE EXISTING RELIEF VENT DAMPER AND PROVIDE CURB CAP.

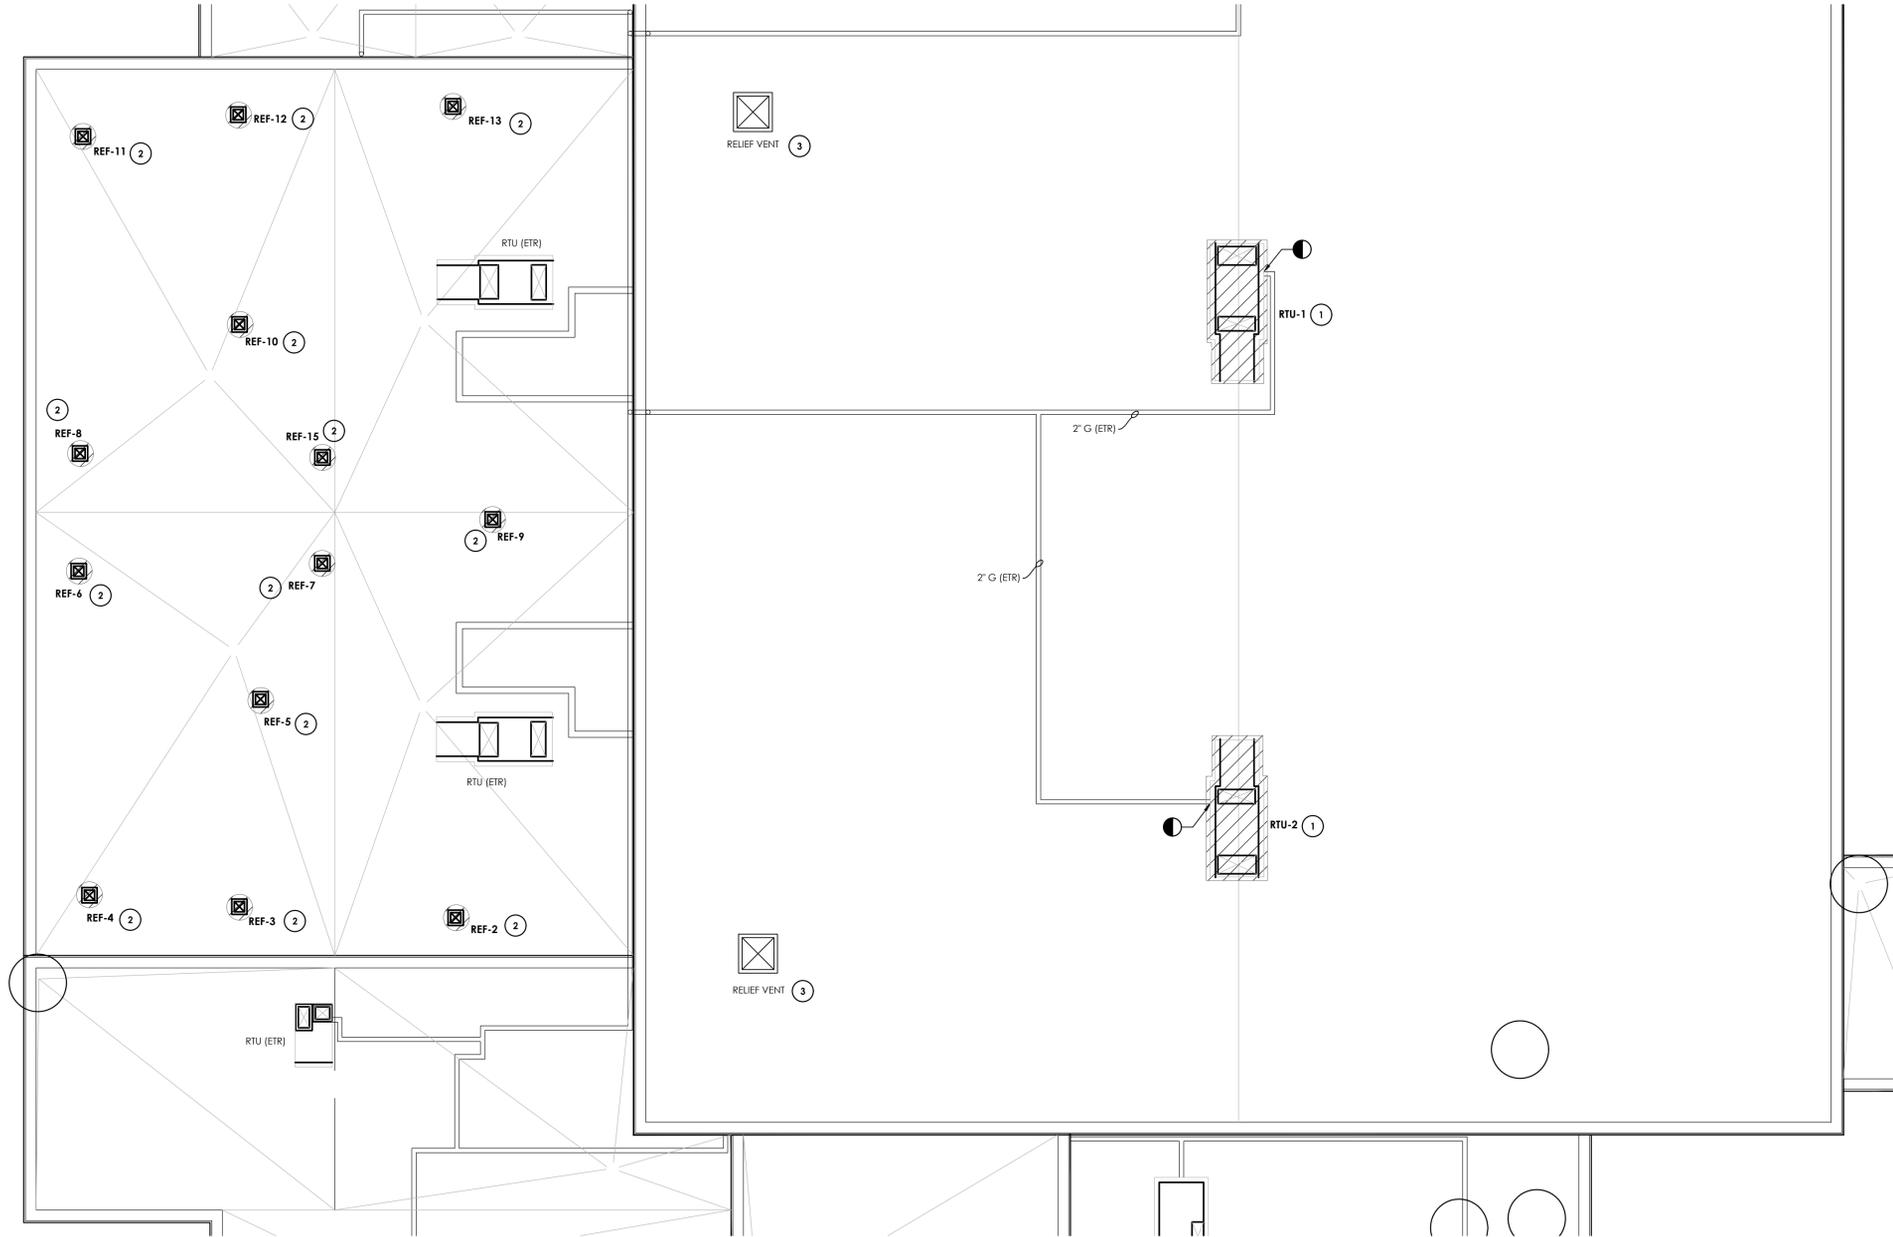

1 ROOF HVAC DEMOLITION PLAN  
 H102 SCALE: 1/8" = 1'-0"

**KEY PLAN:**

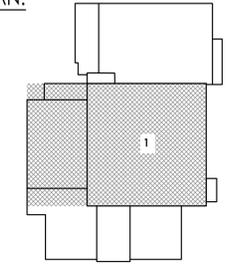

Sheet Size: 24x36  
 Drawing Name: S:\Projects\Dominican Coll Gym Roof Stud\Design\CAD\CAD\MECH\H1\H102.dwg  
 Date last accessed: 8/18/2022 10:21 AM  
 Date last plotted: 8/18/2022 10:21 AM  
 Plotted By: Brendon Mazza



CPL | Architecture Engineering Planning  
 2875 Route 35, Suite 75-1  
 Katonah, NY 10536  
 CPLearn.com



**PROJECT INFORMATION**

Project Number  
16669.00

Client Name

**DOMINICAN UNIVERSITY**

Project Name

**HVAC INSTALLATION**

HENNESSY CENTER

Project Address

495 WESTERN HIGHWAY, ORANGEBURG, NY 10962

**PROJECT ISSUE & REVISION SCHEDULE**

No. Date Description

**PROFESSIONAL STAMPS**

**NEW YORK STATE EDUCATION STATUTE**

IT IS A VIOLATION OF THE NEW YORK STATE EDUCATION LAW AND THE COMPROMISES REGULATORY CODE FOR ANY PERSON UNLESS ACTING UNDER THE DIRECTION OF A LICENSED ARCHITECT, ENGINEER OR LAND SURVEYOR, TO REPRODUCE OR TRANSMIT IN ANY MANNER, BEING THE SEAL OF AN ARCHITECT, ENGINEER OR LAND SURVEYOR, THE ACTING, PARTIAL SEAL TO REPRODUCE THESE SEALS AND THE SIGNATURE, ADDRESS OR FOLLOWED BY THE SIGNATURE AND THE DATE OF SUCH ALTERATION, AND A SPECIFIC DESCRIPTION OF THE ALTERATION.

**SHEET INFORMATION**

Issued 08/22/2022 Scale 1/8" = 1'-0"

Project Status ISSUED TO BID

Drawn By BEF Checked By GMM

Drawing Title LOCKER ROOM NEW WORK PLAN


Drawing Number

**DU**

**H201**


**KEY NOTES:**

- 1 PROVIDE NEW SUPPLY AIR DROP AND 28"Ø MAINS WITH 2" INTERNAL DUCT INSULATION. RECONNECT EXISTING BRANCH DUCTWORK AND 18" MAINS. PAINT ALL NEW DUCTWORK TO MATCH EXISTING.
- 2 PROVIDE NEW PROGRAMMABLE THERMOSTAT TO CONTROL NEW ROOFTOP UNITS. PROVIDE PROTECTIVE COVER.

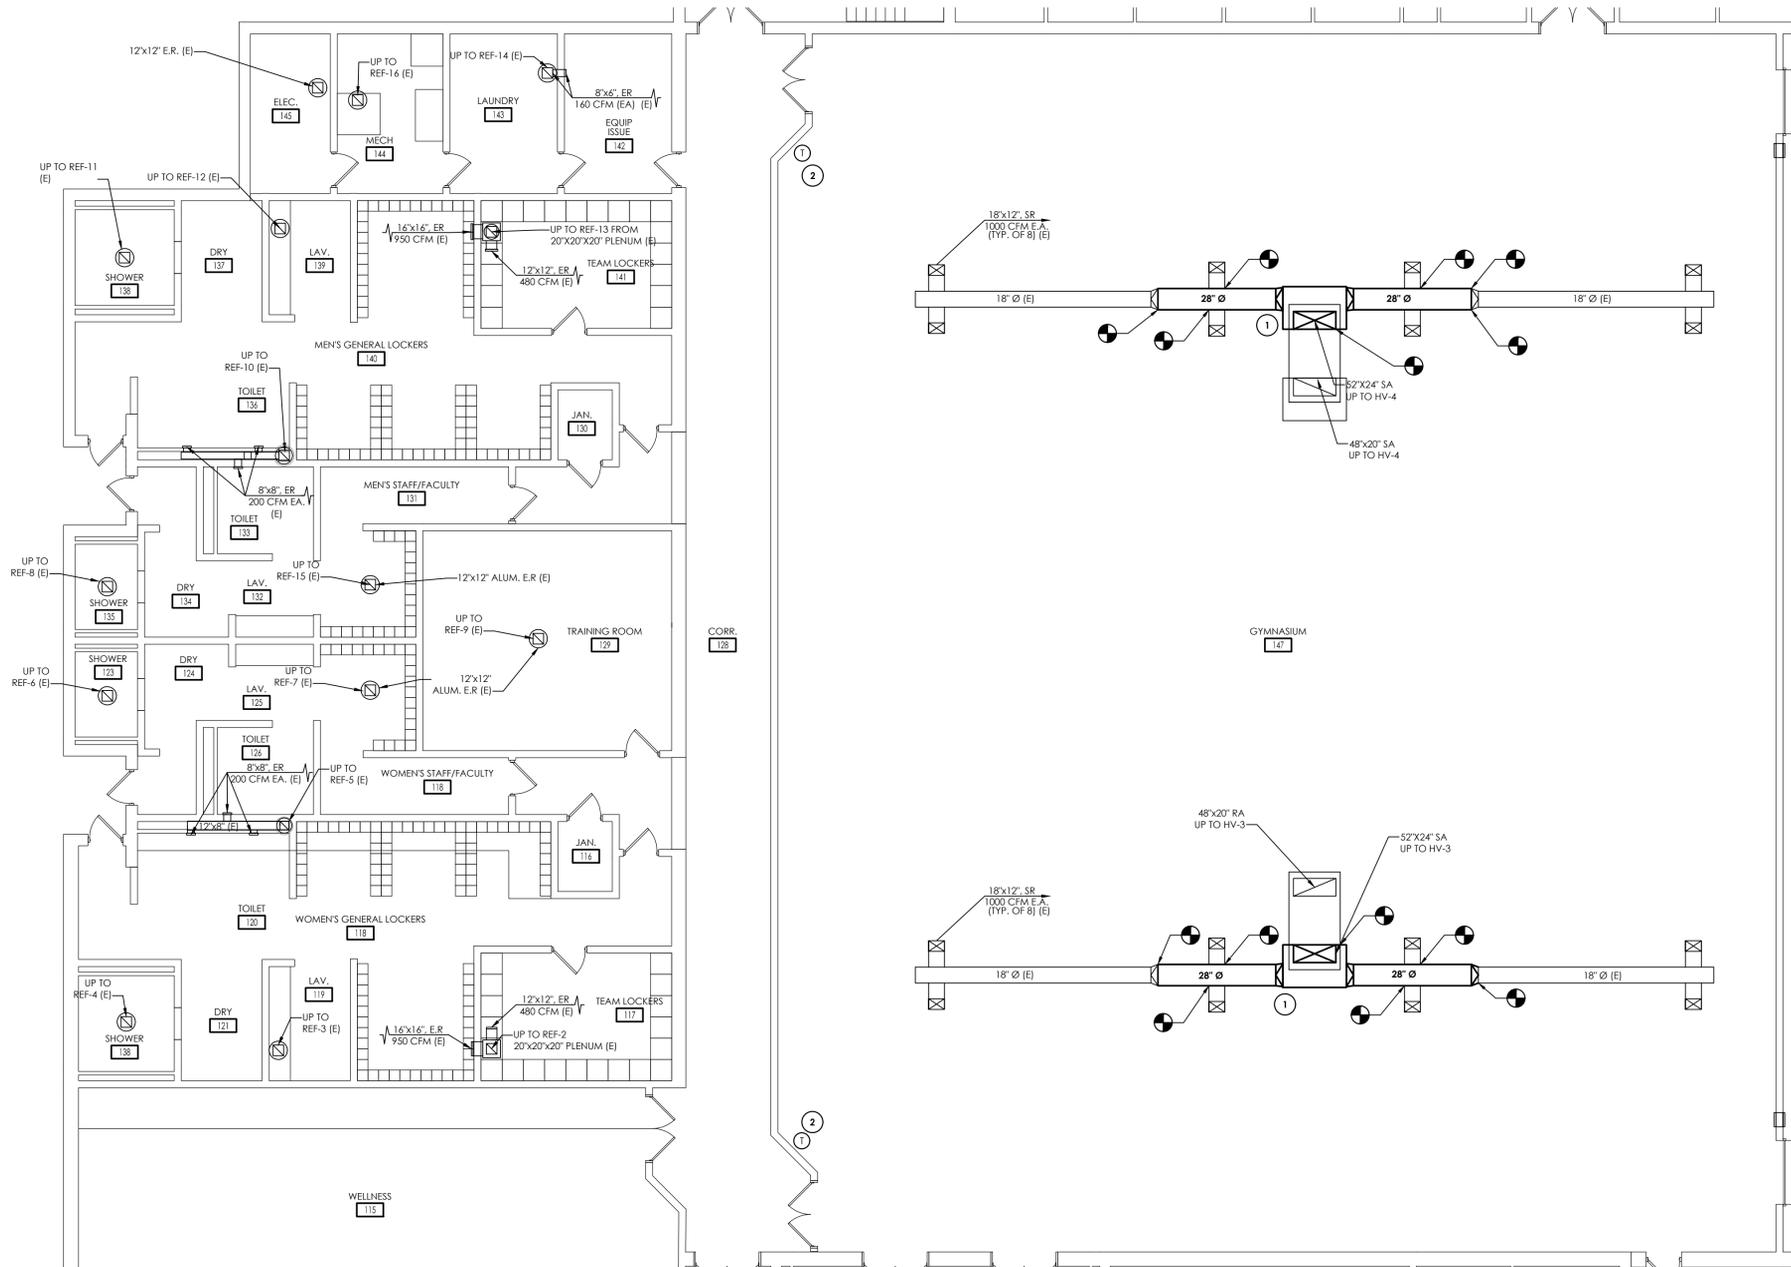

**1 LOCKER ROOM HVAC NEW WORK PLAN**  
 H201 SCALE: 1/8" = 1'-0"

**KEY PLAN:**

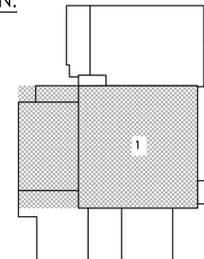

Plotted By: Brendon Mazza

Date last plotted: 8/18/2022 10:21 AM

Date last accessed: 8/17/2022 10:47 AM

Sheet size: 24x36  
 Drawing Name: S:\Projects\Dominican Coll Gym Roof Stud\1.D Design\06\CAD\MECH\H201.dwg





**ROOFTOP AIR CONDITIONING UNITS**

MARK	WEIGHT (LB)	MODEL	UNIT										COOLING						HEATING				ENERGY RECOVERY						REMARKS											
			ELECTRICAL			EFFICIENCY		SUPPLY FAN					EXHAUST FAN			EAT		LAT		TOTAL CAPACITY (MBH)		SENSIBLE CAPACITY (MBH)		AMBIENT		COMPRESSOR		TOTAL CAPACITY (MBH)		EDB (°F)		LDB (°F)		WINTER			SUMMER			
			VOLTAGE	FLA	MCA (A)	EER / SEER	AIRFLOW (CFM)	ESP (IN. WG.)	TSP (IN. WG.)	MOTOR SIZE (BHP/HP)	AIRFLOW (CFM)	ESP (IN. WG.)	TSP (IN. WG.)	MOTOR SIZE (BHP/HP)	DBWB (°F)	DBWB (°F)	TOTAL CAPACITY (MBH)	SENSIBLE CAPACITY (MBH)	DBWB (°F)	STAGES	QTY	REFRIGERANT	TYPE	TOTAL TURNDOWN RATIO	TOTAL CAPACITY (MBH)	EDB (°F)	LDB (°F)	O.A. (CFM)		OAT (DBWB)	E.A. (CFM)	LAT (DBWB)	RECOV. CAP. (MBH)	O.A. (CFM)	OAT (DBWB)	E.A. (CFM)	LAT (DBWB)	RECOV. CAP. (MBH)	APD (in. wg.)	
RTU-1	3694	AAON RN-025-3-0-EA09-3 89	460/3/60	77	81	10.4	8000	0.5	1.97	6.88/10	8000	0.5	1.97	7.13/10	76.83/63.3 2	52.98/50.91	370.54	221.67	90/71	2	2	R-410A	GAS	4.5:1	328.1	59.2	97.2	3804	2/1	3804	59.2/60.7	225.76	3804	90/71	3804	76.83/50.91	78.16	0.87	1,2,3,4,5,6,7,8,9,10,11,12,13	
RTU-2	3694	AAON RN-025-3-0-EA09-3 89	460/3/60	77	81	10.4	8000	0.5	1.97	6.88/10	8000	0.5	1.97	7.13/10	76.83/63.3 2	52.98/50.91	370.54	221.67	90/71	2	2	R-410A	GAS	4.5:1	328.1	59.2	97.2	3804	2/1	3804	59.2/60.7	225.76	3804	90/71	3804	76.83/50.91	78.16	0.87	1,2,3,4,5,6,7,8,9,10,11,12,13	

**REMARKS:**

- FACTORY MOUNTED AND WIRED DISCONNECT
- HOT GAS REHEAT
- ECONOMIZER
- UNIT SELECTION SHALL UTILIZE DIRECT DRIVE PLENUM STYLE SUPPLY AND RETURN FANS WITH PREMIUM EFFICIENCY INVERTER DUTY MOTORS, NEMA MG1.
- PROVIDE 2" THICK DOUBLE WALL GALVANIZED STEEL INSULATED CABINET, ROOF AND WALLS, MINIMUM R-13. OUTSIDE OF CABINET TO BE PAINTED
- PROVIDE ONE SUPPLY AND ONE RETURN VARIABLE FREQUENCY DRIVE WITH INTEGRAL HAND-OFF-AUTO SELECTION SWITCH, RECESSED IN UNIT CABINET, FURNISHED BY UNIT MANUFACTURER. SINGLE DRIVE TO CONTROL EACH SET OF SUPPLY AND RETURN FANS. PROVIDE WIRING AND CONDUIT BETWEEN FANS AND DRIVE. UNIT TO BE PREWIRED TO PROVIDE SINGLE POINT ELECTRICAL CONNECTION TO VFD.
- PROVIDE 1" MERV 8 PRE-FILTER & 2" MERV 13 POST-FILTER
- PROVIDE SIDE LOADING AND REMOVABLE FILTERS
- PROVIDE STAINLESS STEEL HEAT EXCHANGER AND DRIP PAN
- PROVIDE SINGLE POINT POWER
- PROVIDE FIELD INSTALLED SMOKE DETECTORS COMPATIBLE WITH EXISTING FIRE ALARM SYSTEM.
- PROVIDE CONVENIENCE OUTLET.
- PROVIDE 18" HIGH, INSULATED ROOF CURB. CONTRACTOR SHALL SECURE UNIT TO CURB AND CURB TO BUILDING STRUCTURE.

**ROOF EXHAUST FAN SCHEDULE (ALTERNATE 1)**

MARK	LOCATION	SERVICE	TYPE	CFM	SP IN W.G.	RPM	ELECTRICAL DATA				TYPICAL UNIT MFG & MODEL NO.	REMARKS:
							HP	VOLTS	PHASE	AMPS		
REF-2	ROOF	LOCKER ROOMS 117 & 118	DOWNBLAST	1430	0.2	889	.25	115	1	60	GREENHECK G-140-VG	1,2,3
REF-3	ROOF	LAV. 119 & DRY 121	DOWNBLAST	500	0.21	833	0.25	115	1	60	GREENHECK G-100-VG	1,2,3
REF-4	ROOF	SHOWER 122	DOWNBLAST	360	0.18	702	0.25	115	1	60	GREENHECK G-100-VG	1,2,3
REF-5	ROOF	TOILET 120 & 126	DOWNBLAST	600	0.47	1503	0.17	115	1	60	GREENHECK G-095-VG	1,2,3
REF-6	ROOF	SHOWER 123	DOWNBLAST	270	0.22	915	0.17	115	1	60	GREENHECK G-0950VG	1,2,3
REF-7	ROOF	LAV. 123	DOWNBLAST	360	0.18	702	0.25	115	1	60	GREENHECK G-100-VG	1,2,3
REF-8	ROOF	SHOWER 135	DOWNBLAST	270	0.22	915	0.17	115	1	60	GREENHECK G-0950VG	1,2,3
REF-9	ROOF	TRAINING ROOM 129	DOWNBLAST	500	0.21	833	0.25	115	1	60	GREENHECK G-100-VG	1,2,3
REF-10	ROOF	TOILET 133 & 136	DOWNBLAST	600	0.47	1503	0.17	115	1	60	GREENHECK G-095-VG	1,2,3
REF-11	ROOF	SHOWER 138	DOWNBLAST	360	0.18	702	0.25	115	1	60	GREENHECK G-100-VG	1,2,3
REF-12	ROOF	DRY 137 & LAV 139	DOWNBLAST	500	0.21	833	0.25	115	1	60	GREENHECK G-100-VG	1,2,3
REF-13	ROOF	LOCKER ROOMS 140 & 141	DOWNBLAST	1430	0.2	889	.25	115	1	60	GREENHECK G-140-VG	1,2,3
REF-15	ROOF	LAV. 132	DOWNBLAST	360	0.18	702	0.25	115	1	60	GREENHECK G-100-VG	1,2,3

**REMARKS:**

- FACTORY MOUNTED AND WIRED DISCONNECT.
- BACKDRAFT DAMPER.
- PROVIDE 18" HIGH, INSULATED ROOF CURB. CONTRACTOR SHALL SECURE UNIT TO CURB AND CURB TO BUILDING STRUCTURE.

**PROJECT INFORMATION**

Project Number: 16669.00  
Client Name: DOMINICAN UNIVERSITY

**HVAC INSTALLATION**

HENNESSY CENTER

Project Address: 495 WESTERN HIGHWAY, ORANGEBURG, NY 10962

**PROJECT ISSUE & REVISION SCHEDULE**

No. Date Description


**PROFESSIONAL STAMPS**

NEW YORK STATE EDUCATION DEPARTMENT  
REG. NO. 1000 OF THE NEW YORK STATE EDUCATION LAW AND THE COMPLEMENTARY REGS. AND/OR ANY PREVIOUS, IN FULL ACCORD WITH THE DECISION OF A LICENSED ARCHITECT, ENGINEER OR LAND SURVEYOR, THE ARCHITECT, ENGINEER OR LAND SURVEYOR HAS REVIEWED THE SEAL OF AN ARCHITECT, ENGINEER OR LAND SURVEYOR IS A TEST OF THE QUALITY OF THE WORK AND NOT A GUARANTEE OF THE ACCURACY OF THE INFORMATION AND THE DATE OF SUCH INFORMATION, AND A SPECIFIC DESCRIPTION OF THE INFORMATION.

**SHEET INFORMATION**

Issued: 08/22/2022 Scale: NOT TO SCALE  
Project Status: ISSUED TO BID  
Drawn By: BEF Checked By: GMM  
Drawing Title: MECHANICAL DETAILS AND SCHEDULES


Drawing Number: DU H900

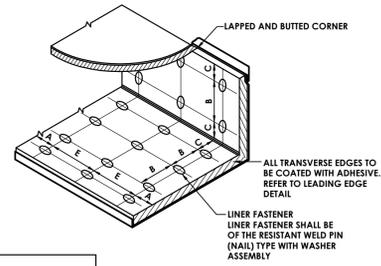

VELOCITY	DIMENSIONS			
	A	B	C	E
0-2500 FPM	3"	12"	4"	18"
2501-4000 FPM	3"	6"	4"	16"


**NOTE:**  
LINER ADHERED TO THE DUCT WITH 100% AREA COVERAGE OF ADHESIVE.

**1 DUCT LINER INSTALLATION DETAIL**  
H900 NOT TO SCALE

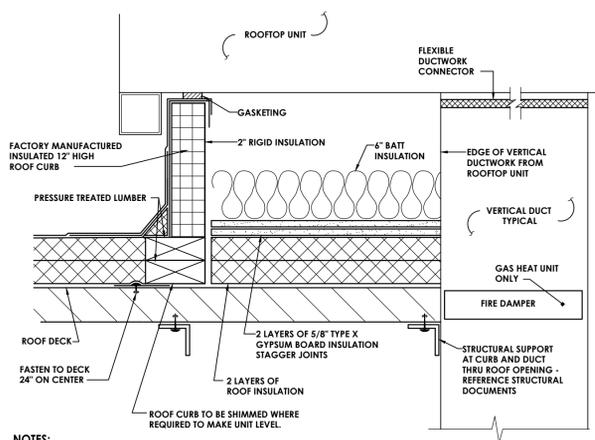

**NOTES:**  
1) ALL ROOF TOP HVAC UNITS REQUIRED TO HAVE CURB AND CURB INTERIOR AS SHOWN.

**2 ROOFTOP UNIT - ROOF CURB DETAIL**  
H900 NOT TO SCALE

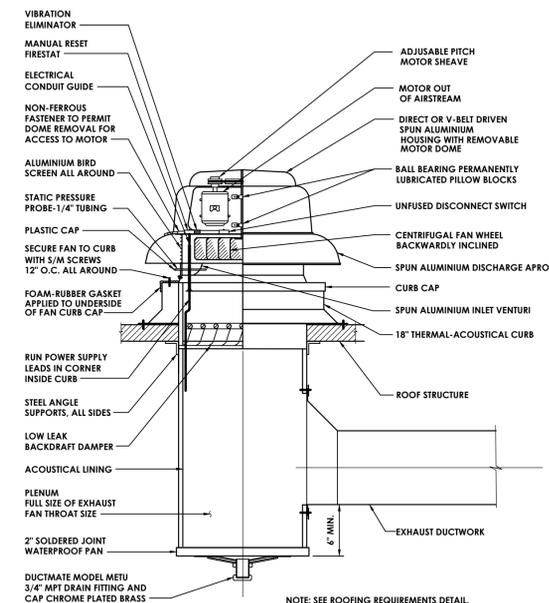

**3 EXHAUST FAN DETAIL**  
H900 NOT TO SCALE

Sheet Size: 24x36  
Drawing Name: S:\Projects\Dominican Coll Gym Roof Study\Design\06-CAD\CAD\Mech\HP\H900.dwg  
Plotted By: Brendon Mazza  
Date last accessed: 8/18/2022 11:36 AM  
Date last plotted: 8/18/2022 11:36 AM

**WIRING LEGEND:**

<b>S</b>	SWITCH
(NONE)	SINGLE POLE TOGGLE SWITCH
2	TWO POLE TOGGLE SWITCH
3	THREE WAY TOGGLE SWITCH
4	FOUR WAY TOGGLE SWITCH
WP	SINGLE POLE WEATHER PROOF SWITCH
K	SINGLE POLE KEVED SWITCH
K2	TWO POLE KEVED SWITCH
K3	THREE WAY KEVED SWITCH
K4	FOUR WAY KEVED SWITCH
F	SINGLE POLE SWITCH WITH PILOT LIGHT
TM	SINGLE POLE SWITCH WITH ONE HOUR TIMER
T	THERMAL SWITCH
TP	THERMAL SWITCH WITH PILOT LIGHT
M	MOMENTARY CONTACT SWITCH
<b>Si</b>	ROMAN NUMERAL DESIGNATES NUMBER OF SWITCHES
<b>S.</b>	LOWER CASE LETTER DESIGNATES SWITCH LEG
	SINGLE RECEPTACLE
	PLUG MOLD
	DUPLEX RECEPTACLE
	QUADRUPLEX RECEPTACLE
	SPECIAL RECEPTACLE
GFI	GROUND FAULT CIRCUIT INTERRUPTER
WP	WEATHER PROOF IN-USE COVER
SS	SURGE SUPPRESSION
C	COUNTER HEIGHT
TR	TAMPER RESISTANT, UL LISTED
IG	ISOLATED GROUND
RT	RAIN TITE
E	EMERGENCY
X	TYPE X (SEE RECEPTACLE SCHEDULE)
	POWER POLE
	RECESSED FLOOR MOUNTED DUPLEX RECEPTACLE
	SURFACE MOUNTED FLOOR RECEPTACLE
	CEILING MOUNTED DUPLEX RECEPTACLE
	CONDUIT
	EXPOSED LOW VOLTAGE WIRING
	HORIZONTAL NON-METALLIC WIREWAY WITH DATA JACK OUTLETS AND ISOLATED GROUND TYPE DUPLEX RECEPTACLES
	VERTICAL NON-METALLIC WIREWAY WITH DATA JACK OUTLETS AND ISOLATED GROUND TYPE DUPLEX RECEPTACLES
	WIRE MOLD
	JUNCTION BOX
F	FIRE SYSTEM
S	SECURITY SYSTEM
	DISCONNECT SWITCH
	DISCONNECT SWITCH - WEATHER PROOF (NEMA 3R)
	FUSED DISCONNECT SWITCH
	COMBINATION FUSED DISCONNECT/ MAGNETIC STARTER SWITCH
HOA	HAND/OFF/AUTO
SS	START/STOP
	MANUAL STARTER
	COMBINATION VARIABLE SPEED DRIVE AND DISCONNECT
	VARIABLE SPEED DRIVE
	PUSHBUTTON - START, STOP
	PUSHBUTTON - START, STOP, WITH PILOT LIGHT
	PUSHBUTTON - UP, DOWN, STOP
EF-1	MOTOR WITH DESIGNATOR
	DOOR POWER OPERATOR
	TIME CLOCK
	WATER HEATER
	HAND DRYER, HARD WIRED
	THERMOSTAT
HVP1-6	BRANCH CIRCUIT HOME RUN WITH PANEL NAME AND CIRCUIT NUMBER, QUANTITY OF ARROWHEADS DENOTES QUANTITY OF BRANCH CIRCUITS
GFI BKR.	GFI TYPE BREAKER
A.F. BKR.	ARC FAULT BREAKER
	BRANCH CIRCUIT WIRING, PROVIDE QUANTITIES OF CONDUCTORS REQUIRED FOR CIRCUITING AND SWITCHING AS INDICATED
	POWER LEG ONLY (NO SWITCH LEG BETWEEN ROOMS)
	HARDWIRE CONNECTION
	CONDUIT RISER UP
	CONDUIT RISER DOWN
	TRANSFORMER
	TYPE "1C" TRANSFORMER
	MUSHROOM HEAD PUSH BUTTION (EMERGENCY STOP)
	EMERGENCY BREAK GLASS STATION
	GROUNDING ROD

**SINGLE LINE DIAGRAM LEGEND:**

	EARTH GROUND
	CHASSIS GROUND
	TRANSFORMER - KVA, PRIMARY AND SECONDARY VOLTAGE INDICATED, CONNECTIONS, K-RATING, AND SHIELD SPECIFIED
	CURRENT TRANSFORMER
	POTENTIAL TRANSFORMER
	FUSE
	DISCONNECT/LOADBREAK SWITCH
	CIRCUIT BREAKER
	CIRCUIT BREAKER DRAWOUT MOUNTED (LOW VOLTAGE)
	AUTOMATIC TRANSFER SWITCH (NORMAL POSITION SHOWN)
	METER
	ENCLOSED CIRCUIT BREAKER
	LIGHTNING ARRESTER
	FUSED DISCONNECT SWITCH
	PANELBOARD - RATINGS AS SPECIFIED IN SINGLE LINE DIAGRAM AND ON PANELBOARD SCHEDULE

**COMMUNICATIONS LEGEND:**

	TELEPHONE (1) CAT3 - TELEPHONE JACK & CABLE
(NONE)	STANDARD MODULAR JACK FOR TELEPHONE
W	WALL MOUNTED TELEPHONE MODULAR JACK
P	PUBLIC TELEPHONE MODULAR JACK
C	COUNTER HEIGHT MODULAR JACK
	TELEPHONE FLOOR OUTLET (1) CAT3 - TELEPHONE JACK & CABLE
	DATA OUTLET WITH FLUSH BOX AND FACEPLATE (1) CAT5e - DATA JACK & CABLE
	COMPUTER FLOOR OUTLET (1) CAT5e - DATA JACK & CABLE
	COMBINATION TELEPHONE CABLE AND DATA OUTLETS IN DOUBLE GANG FLUSH MOUNTED BOX WITH FACEPLATE
	WIRELESS TRANSMITTER (PROVIDED BY OWNER) CONTRACTOR TO PROVIDE (2) CAT5e DATA JACKS & CABLING
1/D	BACK BOX FOR OWNER PROVIDED TEL/COM WIRING & DEVICES
	DATA RACK
	COAX CABLE (TYPE F CONNECTOR)
	CEILING MOUNT LCD PROJECTOR
	SPEAKER (PUBLIC ADDRESS) (NONE) CEILING MOUNTED w WALL MOUNTED
	SPEAKER (LOCAL SOUND SYSTEM)
	SPEAKER HORN
	MICROPHONE JACK
	SPEAKER JACK
	VOLUME CONTROL
	CLOCK
	DOUBLE FACE CLOCK
	COMBINATION CLOCK AND SPEAKER
	INTERCOM STATION
	REMOTE PRE-AMPLIFIER AND PAGING MICROPHONE
	CONSOLE JACK
	HOUSE LIGHT CONTROL STATION
	WALL BOX AS SPECIFIED
	FLOOR BOX

**NOTE:**

SYMBOLS SHOWN ON THIS ELECTRICAL SYMBOLS LIST ARE FOR REFERENCE PURPOSES ONLY. ALL OF THESE SYMBOLS MAY NOT BE USED FOR THIS PROJECT.

**FIRE/LIFE SAFETY LEGEND:**

	FIRE ALARM PULL STATION
	FIRE ALARM BELL
	FIRE ALARM HORN
	FIRE ALARM HORN AND STROBE COMBINATION
	FIRE ALARM HORN AND STROBE COMBINATION, WEATHER PROOF
	FIRE ALARM SPEAKER
	FIRE ALARM SPEAKER - CEILING MOUNTED
	FIRE ALARM SPEAKER AND STROBE COMBINATION
	FIRE ALARM STROBE
	FIRE ALARM STROBE - CEILING MOUNTED
	SMOKE DETECTOR
	SMOKE DETECTOR WITH GUARD
	CARBON MONOXIDE DETECTOR
	NATURAL GAS SENSOR
	HEAT DETECTOR
	COMBINATION SMOKE/HEAT DETECTOR
	HEAT DETECTOR - 190° FIXED TEMPERATURE
	HEAT DETECTOR - EXPLOSION PROOF
	BEAM SMOKE DETECTOR TRANSMITTER
	BEAM SMOKE DETECTOR RECEIVER
	DUCT DETECTOR
SA	INDICATES INSTALLATION IN SUPPLY AIR
RA	INDICATES INSTALLATION IN RETURN AIR
	REMOTE TEST STATION FOR DUCT DETECTOR
	FIRE ALARM SHUT DOWN RELAY
	FIRE DOOR HOLD OPEN
	TAMPER SWITCH
	FLOW SWITCH
	FIRE SUPPRESSION ANSUL SYSTEM CONNECTION
	SMOKE DAMPER RELAY CONNECTION
SD/D	SMOKE DAMPER AND FIRE DAMPER
SD	SMOKE DAMPER
	CONTROL MODULE, ADDRESSABLE
	AREA OF RESCUE CALL STATION
	AREA OF RESCUE MASTER TELEPHONE STATION

**SECURITY LEGEND:**

	SECURITY KEY PAD
	VIDEO CAMERA
	CCTV VIDEO MONITOR
	PASSIVE INFRARED MOTION DETECTOR
	PROXIMITY CARD READER
	CALL SWITCH
	DOOR CONTACT
	WINDOW CONTACT
	ELECTRIC STRIKE DOOR RELEASE
	MAGNETIC DOOR RELEASE

**NURSE CALL LEGEND:**

	NURSE CALL BUTTON
	NURSE CALL PATIENT BED STATION
	CODE CALL BUTTON
	NURSE CALL STAFF ASSIST STATION
	NURSE CALL STAFF STATION
	NURSE CALL DUTY/STAFF STATION
	NURSE CALL DUTY STATION
	NURSE CALL LIGHT
	NURSE CALL CODE LIGHT
	NURSE CALL ZONE LIGHT
	NURSE CALL MASTER STATION
	NURSE CALL EMERGENCY PULL STATION
	NURSE CALL INFRARED SENSOR

**LIGHT FIXTURE LEGEND:**

	LIGHTING FIXTURE (SEE LIGHTING FIXTURE SCHEDULE FOR LETTER DESIGNATION AND DESCRIPTION OF FIXTURES)
	EMERGENCY AND/OR NIGHT LIGHT LIGHTING FIXTURE
	EXIT LIGHTING FIXTURE UNIVERSAL MOUNT, SINGLE/DOUBLE FACE (WHERE USED, ARROW INDICATES CHEVRON DIRECTION)
	BATTERY POWERED EMERGENCY LIGHT
	EMERGENCY LIGHT REMOTE HEAD
	TRACK LIGHTING
	POLE MOUNTED LIGHTING (QUANTITY AND ORIENTATION OF HEADS AS SHOWN)
	OCCUPANCY SENSOR - CEILING MOUNTED
	OCCUPANCY SENSOR - WALL MOUNTED
	LIGHTING CONTACTOR
	PHOTOCCELL
<b>S.</b>	SWITCH
LV	LOW VOLTAGE 1-4 BUTTON STATION (CONNECT TO LIGHTING CONTROL STATION)
O	OCCUPANCY SENSOR SWITCH
D	DIMMER (INCANDESCENT)
D3	THREE WAY DIMMER (INCANDESCENT)
DF	DIMMER (FLUORESCENT)

**PANEL LEGEND:**

	EXISTING ELECTRICAL PANEL
	NEW ELECTRICAL PANEL
MDP	MAIN DISTRIBUTION PANEL
LVP	LOW VOLTAGE PANEL
HVP	HIGH VOLTAGE PANEL
LP	LIGHTING CONTROL PANEL
IG	ISOLATED GROUND PANEL
MSB	MAIN SWITCH BOARD
MCC	MOTOR CONTROL CENTER
TVSS	TRANSIENT VOLTAGE SURGE SUPPRESSION
ATS	AUTOMATIC TRANSFER SWITCH
ESX	ELECTRICAL SYSTEMS PANEL
SACP	SECURITY ALARM CONTROL PANEL
FACP	FIRE ALARM CONTROL PANEL
FA	PUBLIC ADDRESS CONTROL PANEL
FAAP	FIRE ALARM ANNUNCIATOR PANEL

**ELECTRICAL PANELBOARD LABELING PLACARD**

LINE 1 - PANELBOARD NAME: PP1 (EXAMPLE)  
 LINE 2 - VOLTAGE AND PHASE: 480/277V-3PH-4W (EXAMPLE)  
 LINE 3 - WHERE PANELBOARD IS FED FROM: FF MSB BREAKER #14 (EXAMPLE)

**GENERAL ELECTRICAL NOTES:**

- HATCHED AREAS // DESIGNATE EXISTING EQUIPMENT TO BE REMOVED, UNLESS OTHERWISE NOTED.
- ALL WORK TO BE DONE IN ACCORDANCE WITH THE LATEST ADOPTED EDITION OF THE NATIONAL ELECTRIC CODE (NFPA 70).
- CONTRACTOR SHALL FIELD VERIFY ALL CONDITIONS AND COORDINATE WITH EXISTING EQUIPMENT PRIOR TO BIDDING.
- BUILDING:**  
 INSTALLATION HEIGHT TO CENTER OF EQUIPMENT ABOVE FINISHED FLOOR UNLESS OTHERWISE NOTED TO BE:  
 RECEPTACLE = 18"  
 SWITCH = 44"  
 MODULAR JACK FOR WALL MOUNTED TELEPHONE = 52"  
 MODULAR TELEPHONE JACK = 18"  
 AUDIO/VISUAL FIRE ALARM INDICATORS = 88"  
 FIRE ALARM PULL STATIONS = 48"  
 TELEVISION OUTLET = 7'-0"  
 COMPUTER OUTLET = 18"  
 CALL SWITCH = 44"  
 REMOTE TEST STATION FOR DUCT DETECTOR = 52"  
 C = ABOVE COUNTER BACKSPASH, COORDINATE WITH ARCHITECTURAL ELEVATIONS AND MILLWORK.
- INSTALL DATA JACKS FOR CEILING MOUNTED WIRELESS TRANSMITTERS ABOVE CEILING IN ALL AREAS WHERE THERE IS AN ACCESSIBLE CEILING. PROVIDE FLUSH MOUNTED JACKS IN ALL HARD CEILINGS.
- ALL CONDUIT AND WIRING TO BE CONCEALED IN WALLS, FLOOR, OR ABOVE CEILINGS UNLESS OTHERWISE NOTED OR APPROVED BY THE ARCHITECT/ENGINEER. ALL DEVICE OUTLET BOXES SHALL BE RECESSED UNLESS OTHERWISE NOTED OR APPROVED BY THE ARCHITECT/ENGINEER. WHERE APPROVED OR NOTED, SURFACE METAL RACEWAY AND DEVICE BOXES SHALL BE USED IN-LIEU OF CONDUIT AND CONCEALED BOXES AT NO EXTRA COST TO THE OWNER.
- ALL CONDUIT ROUTES SHOWN ARE APPROXIMATE ONLY. CONTRACTOR SHALL FIELD VERIFY FINAL ROUTE.
- CONDUIT RUNS SHOWN ARE SCHEMATICAL AND DO NOT INDICATE THE NECESSARY FITTINGS AND JUNCTION BOXES THAT ARE INCLUDED IN THE SCOPE OF THE WORK.

**GROUNDING:**

- ALL METAL RACEWAYS, INCLUDING CONDUIT, WIRE TROUGHS, WIREMOLD, ETC., SHALL BE GROUNDED. ALL CONNECTIONS IN METAL RACEWAYS SHALL BE COMPLETED IN SUCH A MANNER AS TO MAINTAIN A CONTINUOUS PATH TO GROUND THROUGHOUT THE ENTIRE LENGTH OF THE RACEWAY.

**WIRING:**

- UNLESS NOTED OTHERWISE ON THE DRAWINGS OR ON THE EQUIPMENT WIRING SCHEDULE, EACH BRANCH CIRCUIT SHALL BE THREE (3) #12 AWG THHN/THWN (1 HOT, 1 NEUTRAL & 1 EQUIPMENT GROUND) IN 3/4" EMT CONDUIT. PROTECT EACH CIRCUIT WITH A 20 AMPERE, 1-POLE OVERCURRENT DEVICE UNLESS OTHERWISE NOTED. PROVIDE #10 AWG FOR 120V BRANCH CIRCUITS LONGER THAN 100 FEET. COMBINED NEUTRALS ARE NOT PERMITTED.



CPL | Architecture Engineering Planning  
 2875 Route 35, Suite 75-1  
 Katonah, NY 10536  
 CPLeam.com



**PROJECT INFORMATION**

Project Number  
16669.00

Client Name

**DOMINICAN UNIVERSITY**

**HVAC INSTALLATION**

Project Name

**HVAC INSTALLATION**

Project Address

495 WESTERN HIGHWAY, ORANGEBURG, NY 10962

**PROJECT ISSUE & REVISION SCHEDULE**

No. Date Description

**PROFESSIONAL STAMPS**

**NEW YORK STATE EDUCATION DEPARTMENT**

REGULATIONS FOR ANY PROFESSIONAL ENGINEER OR ARCHITECT UNDER THE SUPERVISION OF A LICENSED ARCHITECT, ENGINEER OR LAND SURVEYOR. THIS ACTING PROFESSIONAL SEAL IS VALID FOR ONE YEAR FROM THE DATE OF ISSUANCE. THE SEAL OF AN ARCHITECT, ENGINEER OR LAND SURVEYOR IS VALID FOR ONE YEAR FROM THE DATE OF ISSUANCE. THE SEAL OF AN ARCHITECT, ENGINEER OR LAND SURVEYOR IS VALID FOR ONE YEAR FROM THE DATE OF ISSUANCE. THE SEAL OF AN ARCHITECT, ENGINEER OR LAND SURVEYOR IS VALID FOR ONE YEAR FROM THE DATE OF ISSUANCE.

**SHEET INFORMATION**

Issued 08/22/2022 Scale AS SHOWN

Project Status

ISSUED TO BID

Drawn By AL Checked By JT

Drawing Title

**ELECTRICAL NOTES AND SYMBOLS**

Drawing Number

Revision Number

DU

E000


Plotted By: Andrea Lowes

Date last plotted: 8/18/2022 2:04 PM


Date last accessed: 8/18/2022 1:54 PM

Drawing Name: S:\Projects\dominican.cad\gym\roof\study\105 CAD ACAD ELEC EDY E000 ELECTRICAL NOTES AND SYMBOLS.dwg

Sheet size: 24x36  
 Drawing Name: S:\Projects\dominican\csl\gm\roof\study\06\CAD\CAO\ELEC\E101 FIRST FLOOR ELECTRICAL DEMOLITION PLAN.dwg  
 Date last accessed: 8/18/2022 1:54 PM  
 Date last plotted: 8/18/2022 2:04 PM  
 Plotted By: Andrea Lowes

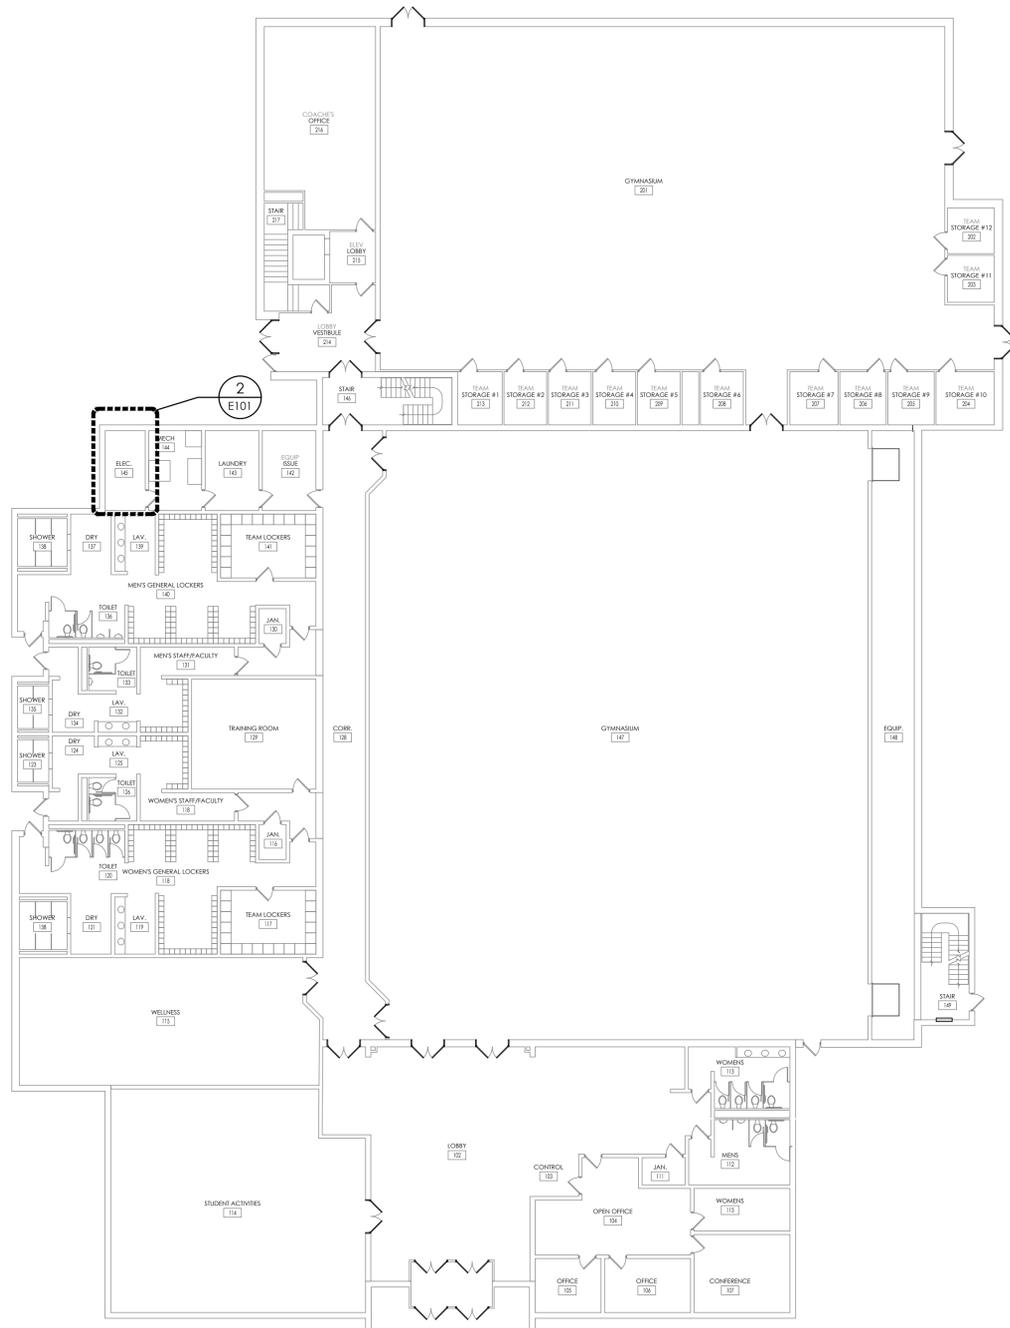

**1 FIRST FLOOR OVERALL PLAN**  
 SCALE: 1/16" = 1'-0"

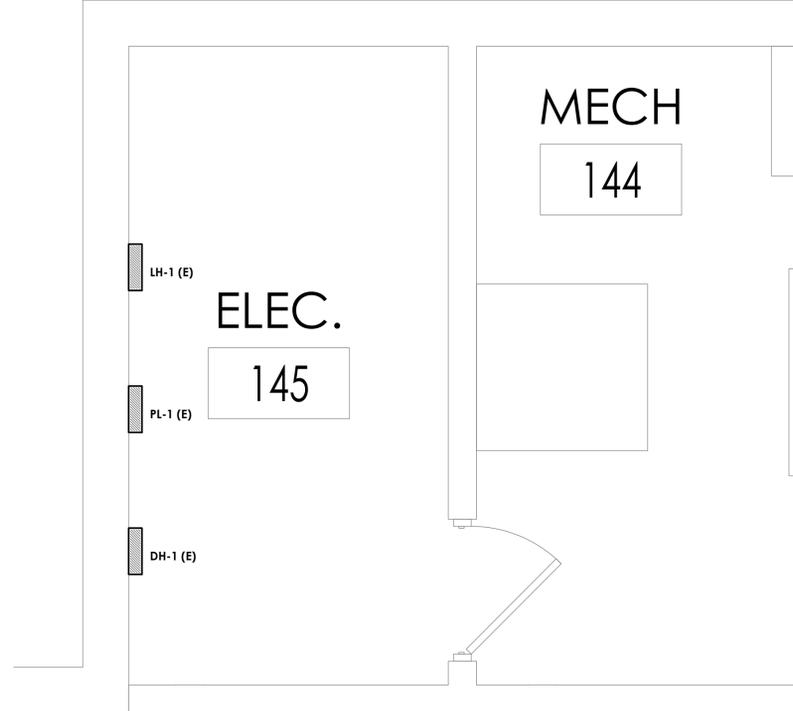

**2 ELECTRICAL ROOM PANEL LOCATION**  
 SCALE: 1/2" = 1'-0"

**GENERAL DEMOLITION NOTES:**

- A. ALL ITEMS SHOWN ARE TO BE REMOVED UNLESS LABELED AS (E) EXISTING TO REMAIN. ANY DEVICE, AS WELL AS ITS ASSOCIATED CIRCUITING, AND CONDUIT, LABELED "(E)" SHALL REMAIN, UNLESS OTHERWISE NOTED.
- B. INFORMATION ON DRAWINGS WAS OBTAINED THROUGH FIELD OBSERVATION AND AS-BUILT DOCUMENTATION. THE CONTRACTOR IS RESPONSIBLE FOR THE REMOVAL AND REPLACEMENT OF ANY DEVICES AND CABLING THAT MAY NOT BE SHOWN ON DRAWING AT NO ADDITIONAL COST TO OWNER.
- C. DRAWINGS INDICATE GRAPHICAL REPRESENTATIONS OF APPROXIMATE EQUIPMENT AND DEVICE LOCATIONS. CONTRACTOR SHALL VISIT THE SITE TO DETERMINE THE EXACT EXTENT OF ELECTRICAL WORK REQUIRED TO COMPLETE THE PROJECT. EXISTING CONDITIONS ARE TAKEN FROM FIELD OBSERVATION AND EXISTING BUILDING DOCUMENTS. OTHER ELECTRICAL ITEMS MAY EXIST FOR WHICH THE CONTRACTOR IS RESPONSIBLE AT NO ADDITIONAL COST.
- D. THE CONTRACTOR SHALL REMOVE THE EXISTING ELECTRIC IN AREAS OF NEW RENOVATIONS TO ACCOMMODATE NEW CONSTRUCTION. REROUTING OF EXISTING MAY BE REQUIRED AT NEW OPENINGS IN EXISTING CONSTRUCTION OR INTERFERENCE WITH OTHER NEW WORK AS NOTED IN THE FOLLOWING NOTES.
- E. DRAWINGS INDICATE SPECIFIC ITEMS TO BE REMOVED AND/OR RELOCATED IN ORDER TO INDICATE GENERAL SCOPE. ADDITIONAL ITEMS NOT INDICATED, BUT NECESSARY FOR PROJECT RENOVATIONS, SHALL BE REMOVED, RELOCATED AND/OR REROUTED. THE CONTRACTOR SHALL ASSUME WITHIN THE BASE BID A NOMINAL AMOUNT OF BRANCH CIRCUITS, FIXTURES, DEVICES, AND SYSTEMS WIRING WITHIN WALLS OR OPENINGS TO BE REMOVED OR RELOCATED AS REQUIRED TO ACCOMMODATE THE NEW CONSTRUCTION.
- F. COORDINATE DEMOLITION OF EQUIPMENT, DEVICES, ETC. WITH OTHER DISCIPLINES AS APPLICABLE. REFER TO ARCHITECTURAL DEMOLITION DRAWINGS AND NOTES FOR COORDINATION.
- G. ALL ITEMS (DEVICES, FIXTURES, ETC.) SHOWN ARE TO BE REMOVED UNLESS LABELED AS EXISTING TO REMAIN - (E). THESE ITEMS AND THEIR RELATED WIRING/CONDUIT SHALL BE REMOVED BACK TO THE SOURCE CONTROL PANEL/PANELBOARD UNLESS OTHERWISE NOTED. ON CIRCUITS WHERE OTHER DEVICES, FIXTURES, ETC. ARE FOUND THAT MUST REMAIN, MAINTAIN CIRCUIT CONTINUITY BY PROVIDING ADDITIONAL WIRING, TO FEED THROUGH TO THESE REMAINING ITEMS. RELOCATE ANY CIRCUITS THAT REMAIN, TO AVOID CONFLICT WITH NEW CONSTRUCTION AS REQUIRED. PROPERLY TERMINATE ALL WIRING.
- H. CONTRACTOR SHALL PROPERLY DISPOSE OF ALL ITEMS AND/OR EQUIPMENT BEING REMOVED AS PART OF THE PROJECT. THE OWNER SHALL HAVE THE RIGHT OF RETAINING ANY ITEMS BEING REMOVED.
- I. CONTRACTOR SHALL PROVIDE NEW COVERPLATES ON ALL UNUSED FLUSH MOUNT DEVICE BOXES UPON COMPLETION OF PROJECT.
- J. FIREPROOFING AND/OR FIRE STOP MATERIALS REMOVED FROM FIRE RATED WALLS AND CEILINGS AS A RESULT OF DEMOLITION SHALL BE RE-INSTALLED USING AN APPROVED METHOD AS DESCRIBED IN ASSOCIATED PROJECT SPECIFICATIONS.



**CPL | Architecture Engineering Planning**  
 2875 Route 35, Suite 75-1  
 Katonah, NY 10536  
 CPLteam.com



**PROJECT INFORMATION**

Project Number  
16669.00  
 Client Name

**DOMINICAN UNIVERSITY**

Project Name

**HVAC INSTALLATION**

Project Address

495 WESTERN HIGHWAY, ORANGEBURG, NY  
10962

**PROJECT ISSUE & REVISION SCHEDULE**

No. Date Description

**PROFESSIONAL STAMPS**

NEW YORK STATE EDUCATION STATUTE  
 IT IS A VIOLATION OF THE NEW YORK STATE EDUCATION LAW AND THE COMMISSIONERS REGULATIONS FOR ANY PERSON UNDER THE JURISDICTION OF A LICENSED ASSOCIATED MEMBER OF ANY OFFICE OF THE STATE EDUCATION SERVICE TO ACT AS ARCHITECT OR ENGINEER BEARING THE SEAL OF AN ARCHITECT, ENGINEER OR SURVEYOR IN ANY STATE, PARTY OR AREA TO THESE TERMS AND CONDITIONS, UNLESS HE IS FOLLOWED BY THE SIGNATURE AND THE DATE OF SUCH ALTERATION, AND A SPECIFIC DESCRIPTION OF THE ALTERATION.


**SHEET INFORMATION**

Issued  
08/22/2022  
 Project Status  
ISSUED TO BID  
 Drawn By  
AL  
 Checked By  
JT  
 Drawing Title  
**FIRST FLOOR ELECTRICAL DEMOLITION PLAN**

Drawing Number  
Revision Number

**DU  
E101**

**KEY PLAN:**

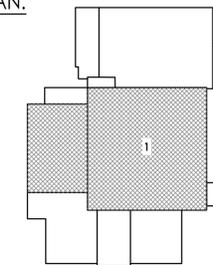


Plotted By: Andrie Lowes

Date last accessed: 8/18/2022 1:54 PM

Date last accessed: 8/18/2022 1:54 PM

Sheet size: 24x36  
Drawing Name: S:\Projects\dominican cal\gym\roof study\06 CAD\ACAD\ELEC\1\E102 ROOF ELECTRICAL DEMOLITION PLAN.dwg

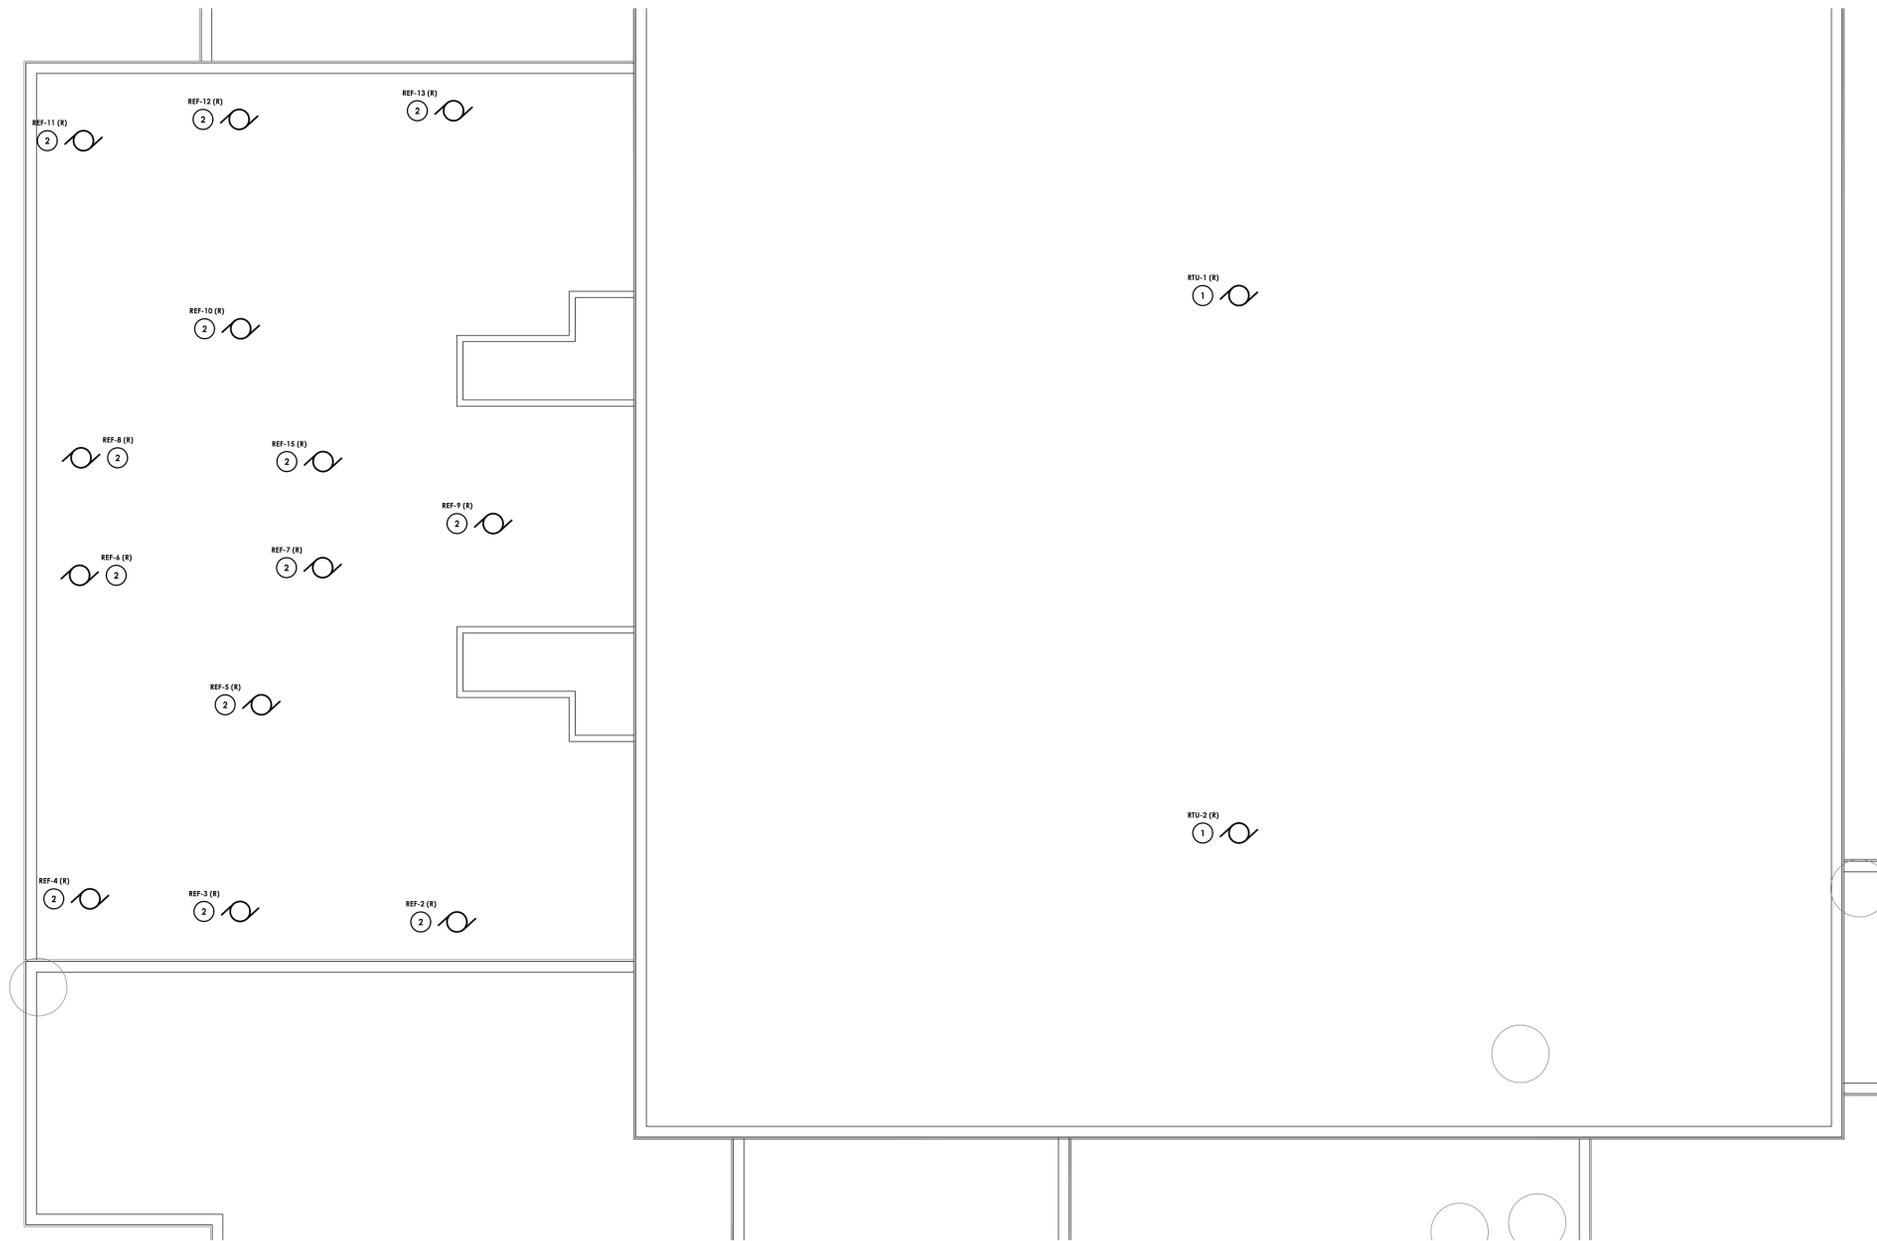

**1**  
**E102** **ROOF ELECTRICAL DEMOLITION PLAN**  
SCALE: 3/32" = 1'-0"



**GENERAL DEMOLITION NOTES:**

- A. ALL ITEMS SHOWN ARE TO BE REMOVED UNLESS LABELED AS (E) EXISTING TO REMAIN. ANY DEVICE, AS WELL AS ITS ASSOCIATED CIRCUITING, AND CONDUIT, LABELED "(E)" SHALL REMAIN, UNLESS OTHERWISE NOTED.
- B. INFORMATION ON DRAWINGS WAS OBTAINED THROUGH FIELD OBSERVATION AND AS-BUILT DOCUMENTATION. THE CONTRACTOR IS RESPONSIBLE FOR THE REMOVAL AND REPLACEMENT OF ANY DEVICES AND CABLING THAT MAY NOT BE SHOWN ON DRAWING AT NO ADDITIONAL COST TO OWNER.
- C. DRAWINGS ARE GRAPHICAL REPRESENTATIONS OF APPROXIMATE EQUIPMENT AND DEVICE LOCATIONS. CONTRACTOR SHALL VISIT THE SITE TO DETERMINE THE EXACT EXTENT OF ELECTRICAL WORK REQUIRED TO COMPLETE THE PROJECT. EXISTING CONDITIONS ARE TAKEN FROM FIELD OBSERVATION AND EXISTING BUILDING DOCUMENTS. OTHER ELECTRICAL ITEMS MAY EXIST FOR WHICH THE CONTRACTOR IS RESPONSIBLE AT NO ADDITIONAL COST.
- D. THE CONTRACTOR SHALL REMOVE THE EXISTING ELECTRIC IN AREAS OF NEW RENOVATIONS TO ACCOMMODATE NEW CONSTRUCTION. REROUTING OF EXISTING MAY BE REQUIRED AT NEW OPENINGS IN EXISTING CONSTRUCTION OR INTERFERENCE WITH OTHER NEW WORK AS NOTED IN THE FOLLOWING NOTES.
- E. DRAWINGS INDICATE SPECIFIC ITEMS TO BE REMOVED AND/OR RELOCATED IN ORDER TO INDICATE GENERAL SCOPE. ADDITIONAL ITEMS NOT INDICATED, BUT NECESSARY FOR PROJECT RENOVATIONS, SHALL BE REMOVED, RELOCATED AND/OR REROUTED. THE CONTRACTOR SHALL ASSUME WITHIN THE BASE BID A NOMINAL AMOUNT OF BRANCH CIRCUITS, FIXTURES, DEVICES, AND SYSTEMS WIRING WITHIN WALLS OR OPENINGS TO BE REMOVED OR RELOCATED AS REQUIRED TO ACCOMMODATE THE NEW CONSTRUCTION.
- F. COORDINATE DEMOLITION OF EQUIPMENT, DEVICES, ETC. WITH OTHER DISCIPLINES AS APPLICABLE. REFER TO ARCHITECTURAL DEMOLITION DRAWINGS AND NOTES FOR COORDINATION.
- G. ALL ITEMS (DEVICES, FIXTURES, ETC.) SHOWN ARE TO BE REMOVED UNLESS LABELED AS EXISTING TO REMAIN - (E). THESE ITEMS AND THEIR RELATED WIRING/CONDUIT SHALL BE REMOVED BACK TO THE SOURCE CONTROL PANEL/PANELBOARD UNLESS OTHERWISE NOTED. ON CIRCUITS WHERE OTHER DEVICES, FIXTURES, ETC. ARE FOUND THAT MUST REMAIN, MAINTAIN CIRCUIT CONTINUITY BY PROVIDING ADDITIONAL WIRING, TO FEED THROUGH TO THESE REMAINING ITEMS. RELOCATE ANY CIRCUITS THAT REMAIN, TO AVOID CONFLICT WITH NEW CONSTRUCTION AS REQUIRED. PROPERLY TERMINATE ALL WIRING.
- H. CONTRACTOR SHALL PROPERLY DISPOSE OF ALL ITEMS AND/OR EQUIPMENT BEING REMOVED AS PART OF THE PROJECT. THE OWNER SHALL HAVE THE RIGHT OF RETAINING ANY ITEMS BEING REMOVED.
- I. CONTRACTOR SHALL PROVIDE NEW COVERPLATES ON ALL UNUSED FLUSH MOUNT DEVICE BOXES UPON COMPLETION OF PROJECT.
- J. FIREPROOFING AND/OR FIRE STOP MATERIALS REMOVED FROM FIRE RATED WALLS AND CEILINGS AS A RESULT OF DEMOLITION SHALL BE RE-INSTALLED USING AN APPROVED METHOD AS DESCRIBED IN ASSOCIATED PROJECT SPECIFICATIONS.

**KEY NOTES:**

- ① DISCONNECT AND REMOVE EXISTING ROOF TOP UNIT IN ITS ENTIRETY. REMOVE ALL CONDUIT AND WIRING BACK TO SOURCE PANEL.
- ② ALT 1: DISCONNECT AND REMOVE EXISTING EXHAUST FAN IN ITS ENTIRETY. PULL ALL CONDUIT AND WIRING TO A POINT OUTSIDE THE AREA OF DEMOLITION AND TAG CIRCUITRY FOR RE-USE.

**KEY PLAN:**

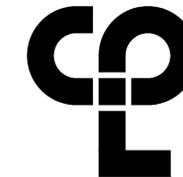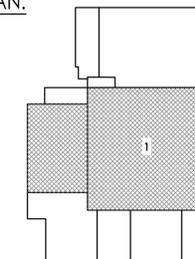

**CP | Architecture Engineering Planning**  
2875 Route 35, Suite 75-1  
Katonah, NY 10536  
CPTeam.com



**PROJECT INFORMATION**

Project Number  
16669.00

Client Name

**DOMINICAN UNIVERSITY**

Project Name

**HVAC INSTALLATION**

Project Address

495 WESTERN HIGHWAY, ORANGEBURG, NY  
10962

**PROJECT ISSUE & REVISION SCHEDULE**

No. Date Description

**PROFESSIONAL STAMPS**

NEW YORK STATE EDUCATION STATUTE  
IT IS A VIOLATION OF THE NEW YORK STATE EDUCATION LAW AND THE COMMISSIONERS' REGULATIONS FOR ANY PERSON UNLESS ACTING UNDER THE SUPERVISION OF A LICENSED ARCHITECT, ENGINEER OR LAND SURVEYOR TO ACT AS ARCHITECT OR ENGINEER IF ANY PERSON BEARING THE SEAL OF AN ARCHITECT, ENGINEER OR SURVEYOR IS ALTHOUGH THE ACTING PARTY FAILS AFTER TO THE END THEREOF TO SIGN HIS SEAL AND HIS SIGNATURE IS FOLLOWED BY HIS SIGNATURE AND THE DATE OF SUCH ALTERATION, AND A SPECIFIC DESCRIPTION OF THE ALTERATION.

**SHEET INFORMATION**

Issued 08/22/2022 Scale AS SHOWN

Project Status ISSUED TO BID

Drawn By AL Checked By JT

Drawing Title

**ROOF ELECTRICAL DEMOLITION PLAN**

Drawing Number

Revision Number

**DU**  
**E102**



CP | Architecture Engineering Planning  
2875 Route 35, Suite 75-1  
Katonah, NY 10536  
CPteam.com



**PROJECT INFORMATION**

Project Number  
16669.00  
Client Name

**DOMINICAN UNIVERSITY**

Project Name  
**HVAC INSTALLATION**

Project Address  
495 WESTERN HIGHWAY, ORANGEBURG, NY  
10962

**PROJECT ISSUE & REVISION SCHEDULE**

No. Date Description

**PROFESSIONAL STAMPS**

NEW YORK STATE EDUCATION STATUTE  
THE REGULATION OF THE NEW YORK STATE EDUCATION LAW AND THE COMMISSIONERS  
REGULATION FOR ANY PERSON UNDER THE JURISDICTION OF A LICENSED  
ASSOCIATED ENGINEER OR ARCHITECT, ENGINEER OR SURVEYOR IS ALTERED BY THE REGISTERED  
PARTY FIRST REFER TO THE NEW YORK STATE EDUCATION LAW AND THE REGISTERED PARTY'S  
SIGNATURE AND THE DATE OF SUCH ALTERATION, AND A SPECIFIC DESCRIPTION OF THE  
ALTERATION.

**SHEET INFORMATION**

Issued 08/22/2022 Scale AS SHOWN  
Project Status ISSUED TO BID  
Drawn By AL Checked By JT  
Drawing Title  
**ROOF ELECTRICAL NEW WORK PLAN**

Drawing Number Revision Number

**DU**  
**E202**



**GENERAL NOTES:**

- A. INFORMATION ON DRAWING WAS OBTAINED THROUGH FIELD OBSERVATIONS AND AS-BUILT DOCUMENTATION.
- B. DRAWINGS ARE GRAPHICAL REPRESENTATIONS OF APPROXIMATE EQUIPMENT AND DEVICE LOCATIONS. CONTRACTOR SHALL VISIT THE SITE TO DETERMINE THE EXACT EXTENT OF FIRE ALARM WORK REQUIRED TO COMPLETE THE PROJECT.
- C. NEW FIRE ALARM INITIATION AND/OR NOTIFICATION DEVICES SHOWN SHALL BE COMPATIBLE WITH AND CONNECTED TO EXISTING HONEYWELL MS-9600UDLS FIRE ALARM CONTROL PANEL AND SYSTEM SERVING BUILDING. CONTRACTOR SHALL BE RESPONSIBLE FOR ALL TERMINATIONS, PROGRAMING, TESTING, ETC. FOR A COMPLETE OPERATIONAL SYSTEM.
- D. NEW DUCT DETECTOR REMOTE STATIONS SHOWN INSTALLED IN FINISHED SPACES SHALL BE FLUSH MOUNTED IN WALL WHERE SHOWN 12" BELOW FINISHED CEILING LEVEL. STATIONS SHOWN IN UNFINISHED SPACES SUCH AS MECHANICAL /ELECTRICAL ROOMS, JANITOR CLOSETS, ETC SHALL BE INSTALLED AT 48" AFF.
- E. DISCONNECT SWITCHES FOR MECHANICAL EQUIPMENT TO BE FURNISHED AND INSTALLED BY THE MECHANICAL CONTRACTOR AND WIRED BY THE ELECTRICAL CONTRACTOR.
- F. (E) - EXISTING TO REMAIN. ANY DEVICE EQUIPMENT, ETC. LABELED AS "(E)" IS EXISTING TO REMAIN UNLESS OTHERWISE NOTED.
- G. (RL) - RELOCATED. ANY DEVICE EQUIPMENT, ETC. LABELED AS "(RL)" IS RELOCATED EXISTING. DEVICE/EQUIPMENT SHALL BE RE-INSTALLED AT LOCATION INDICATED. REWORK/EXTEND WIRING AND CONDUIT TO NEW LOCATION AS REQUIRED.
- H. FINAL TESTING OF FIRE ALARM SYSTEM SHALL COMPLY WITH NFPA72 REQUIREMENTS. ANY ALTERED CIRCUIT(S) SHALL HAVE ALL ASSOCIATED LOOP DEVICES TESTED IN THEIR ENTIRETY AND 10% OF NEIGHBORING ZONE/LOOP DEVICES ARE ALSO TO BE TESTED.
- I. ALL NEW FAN SHUTDOWN RELAYS SHALL BE PROGRAMMED TO DE-ENERGIZE ASSOCIATED HVAC UNIT FAN UPON ACTIVATION OF FIRE ALARM SYSTEM.
- J. ALL SYSTEMS CABLING SHALL BE RUN IN FREE-AIR AND SUPPORTED ABOVE CEILINGS VIA J-HOOKS. J-HOOKS NOT TO EXCEED 5'-0" SPACING.

**KEY NOTES:**

- 1 PROVIDE POWER TO NEW ROOF TOP UNIT. PROVIDE (3) #2, (1) #8 GND IN 1-1/2" CONDUIT TO EXISTING PANEL 'PL-1'. PROVIDE NEW 90A/3P CIRCUIT BREAKER IN EXISTING PANEL. NEW BREAKER SHALL MATCH AIC RATING OF EXISTING PANEL.
- 2 PROVIDE SMOKE DUCT DETECTOR FOR RETURN AND SUPPLY LINE OF RTU'S. PROVIDE FAN SHUTDOWN RELAYS SO THAT UNIT WILL SHUTDOWN ALL FANS ASSOCIATED WITH UNIT ON ACTIVATION OF THE BUILDING FIRE ALARM.
- 3 PROVIDE FAN SHUTDOWN RELAYS AT HVAC EQUIPMENT CONTROLS. INTERCONNECT RELAYS TO BUILDING FIRE ALARM SYSTEM TO SHUTDOWN FAN MOTORS WHEN THE FIRE ALARM IS ACTIVATED.
- 4 PROVIDED ASSOCIATED REMOTE TEST SWITCHES IN CEILING SPACE BELOW. REFER TO DRAWING DC-E101.
- 5 ALT 1: RECONNECT NEW EXHAUST FAN TO EXISTING CIRCUITRY TAGGED FOR RE-USE. SPICE AND REWORK/EXTEND WIRING AS NECESSARY.

**KEY PLAN:**

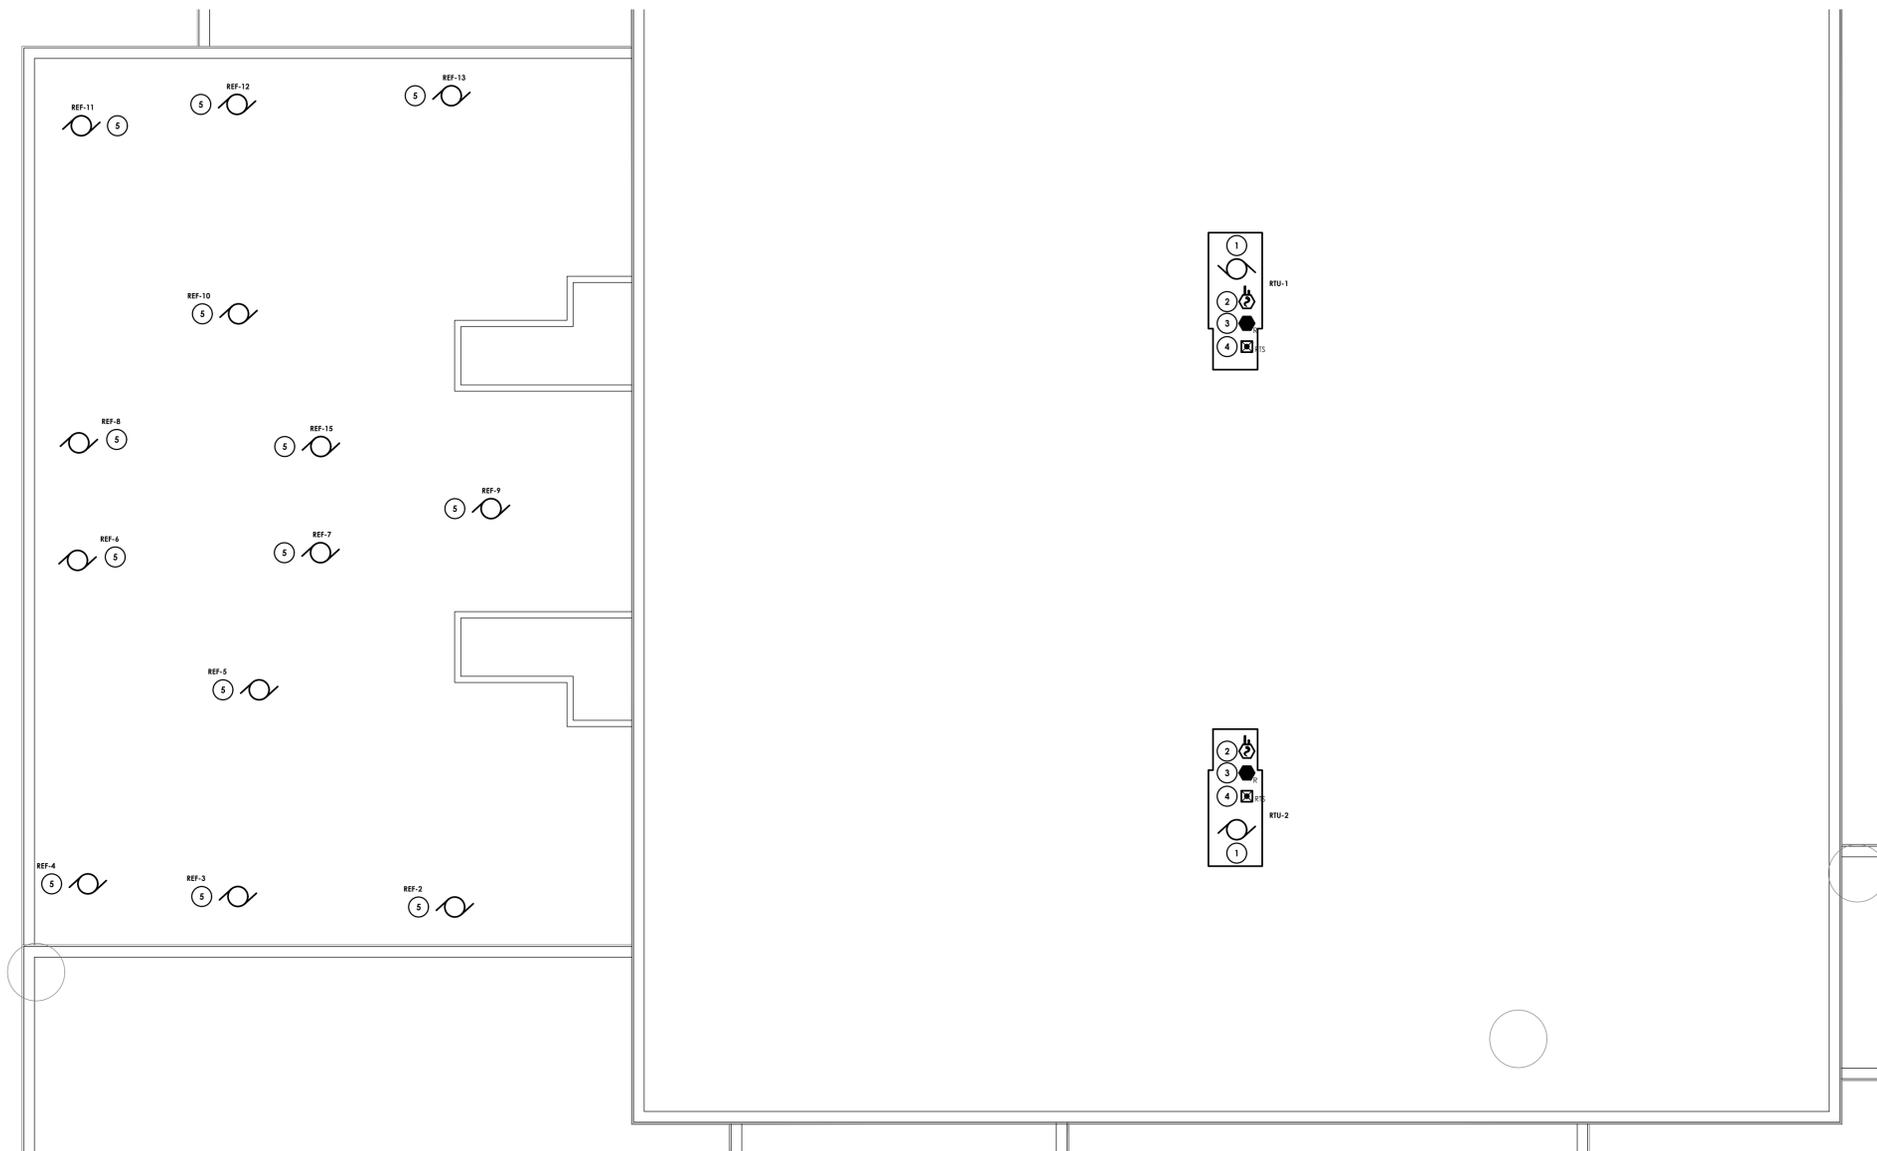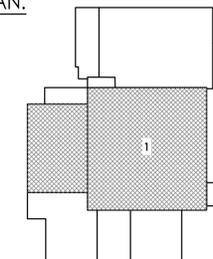

**1**  
**E202**  
**ROOF ELECTRICAL NEW WORK PLAN**  
SCALE: 1/8" = 1'-0"

Plotted By: Andrie Lowes

Date last accessed: 8/18/2022 2:04 PM

Date last accessed: 8/18/2022 2:02 PM

Sheet size: 24x36  
Drawing Name: S:\Projects\dominican cat\gym\roof study\06 CAD\CAD\ELEC\E202 ROOF ELECTRICAL NEW WORK PLAN.dwg