## **HVAC DEMOLITION NOTES**

- 1. COORDINATE WITH ARCHITECTURAL PLANS FOR EXACT AREAS TO BE DEMOLISHED.
- 2. REMOVE ALL EQUIPMENT, DUCTWORK AND PIPING AS INDICATED ON PLAN. REMOVALS SHALL INCLUDE ALL SUPPORTS AND HANGERS, HOUSEKEEPING PADS, DAMPERS, VALVES. FITTINGS. CONTROLS AND ASSOCIATED LOW VOLTAGE WIRING, AND ANY OTHER ASSOCIATED ACCESSORIES WHICH PERTAIN TO THE EQUIPMENT TO BE REMOVED.
- 3. REMOVAL OF ALL POWER CONNECTIONS TO DEMOLITION ITEMS SHALL BE BY THE E.C.
- 4. ANY DISCREPANCIES BETWEEN THE DEMOLITION PLANS AND ACTUAL FIELD CONDITIONS SHALL BE BROUGHT TO THE ATTENTION OF THE ARCHITECT OR ENGINEER. ANY DEMOLITION WORK WHICH MAY BE QUESTIONABLE DUE TO UNFORESEEN FIELD CONDITIONS SHALL NOT BE REMOVED UNTIL REVIEWED BY THE ARCHITECT, ENGINEER OR BUILDING FACILITIES MANAGER.
- 5. DEMOLITION WORK SHALL INCLUDE THE PREPARATION OF EXISTING EQUIPMENT FOR CONNECTION TO NEW EQUIPMENT. COORDINATE DEMOLITION WORK WITH THE CONSTRUCTION PLANS.
- 6. ALL EQUIPMENT REMOVALS SHALL BECOME THE PROPERTY OF THIS CONTRACTOR. THIS CONTRACTOR SHALL BE RESPONSIBLE FOR THE PROPER REMOVAL AND DISPOSAL OF DEMOLITION ITEMS OFF-SITE, UNLESS OTHERWISE NOTED.
- 7. ALL CUTTING AND PATCHING NECESSARY FOR THE DEMOLITION WORK SHALL BE THE RESPONSIBILITY OF THIS CONTRACTOR.
- 8. IT SHALL BE THE OWNER'S RESPONSIBILITY TO REMOVE ANY LOOSE EQUIPMENT, FURNITURE, SUPPLIES, ETC. THAT MAY BE LOCATED IN THE AREA OF WORK.
- 9. THE PLANS ARE INTENDED TO CONVEY THE EXTENT AND SCOPE OF THE DEMOLITION WORK. EVERY ITEM INTENDED FOR REMOVAL MAY NOT BE SHOWN. THE CONTRACTOR IS ADVISED TO SURVEY THE PROJECT SITE BEFORE SUBMITTING A BID FOR DEMOLITION

## **GENERAL NOTES:**

- 1. THE DRAWINGS ON THESE PLANS ARE DIAGRAMMATIC. THIS CONTRACTOR SHALL BE RESPONSIBLE FOR COORDINATING ALL HVAC WORK WITH OTHER TRADES AND THE BUILDING STRUCTURE. NO EXTRA PAYMENTS WILL BE AUTHORIZED FOR REROUTING OR REMOVAL OF INSTALLED WORK DUE TO LACK OF COORDINATION WITH OTHER SYSTEMS.
- 2. THIS CONTRACTOR SHALL BE RESPONSIBLE FOR ALL CUTTING AND PATCHING OF WALLS, FLOORS AND CEILINGS AS REQUIRED FOR INSTALLATION OF HIS WORK.
- 3. ACCESS PANELS SHALL BE PROVIDED IN CEILINGS, WALLS, FLOORS, ETC., AS REQUIRED TO MAINTAIN ACCESSIBILITY TO DAMPERS, ETC.
- 4. PROVIDE DUCT ACCESS DOORS AT ALL MOTORIZED DAMPERS, FIRE DAMPERS, AND SMOKE DAMPERS.
- 5. ALL PENETRATIONS THROUGH FIRE RATED PARTITIONS SHALL BE SEALED FIRE AND SMOKE TIGHT WITH AN APPROPRIATE U.L. LISTED FIRESTOPPING MATERIAL AND OR SYSTEM.
- 6. ALL DUCTWORK PASSING THROUGH A FIRE RATED PARTITION SHALL BE PROVIDED WITH A FIRE DAMPER TO MAINTAIN THE FIRE RATING OF THE PARTITION.
- 7. LOCATIONS OF DIFFUSERS AND GRILLES ARE APPROXIMATE. REFER TO ARCHITECTURAL PLANS FOR EXACT LOCATIONS.
- 8. ALL BRANCHES AND TAKE-OFFS SHALL BE EQUIPPED WITH VOLUME CONTROL DAMPERS. DAMPERS TO BE OPPOSED BLADE TYPE, 4" MAX. BLADE HEIGHT. VOLUME DAMPERS TO BE LOCATED AS NEAR TO THE POINT OF TAKE-OFF AS PRACTICAL.
- 9. FLEXIBLE DUCT CONNECTIONS SHALL BE LIMITED TO A MAXIMUM LENGTH OF FIVE (5) FEET AND SUPPORTED AT MID-POINT.
- 10. ALL SUPPLY & RETURN AIR DUCTWORK SHALL BE INSULATED.

BY THE HVAC CONTRACTOR.

MET TO THE SATISFACTION OF ALL PARTIES.

- 11. PROVIDE SHUT-OFF VALVES AT ALL PIPING BRANCH TAKE-OFFS AND AT ALL CONNECTIONS TO EQUIPMENT.
- 12. PROVIDE DRAINS WITH HOSE ADAPTERS AND CAPS ON PIPING AT ALL LOW POINTS. PROVIDE MANUAL VENTS ON PIPING AT ALL HIGH POINTS.
- 13. COORDINATE ELECTRICAL CHARACTERISTICS AND REQUIREMENTS OF ALL MECHANICAL EQUIPMENT WITH ELECTRICAL CONTRACTOR.
- 14. ALL MOTOR STARTERS SHALL BE FURNISHED BY THE HVAC CONTRACTOR AND INSTALLED
- BY THE ELECTRICAL CONTRACTOR. 15. ALL REQUIRED CONTROL EQUIPMENT AND WIRING SHALL BE FURNISHED & INSTALLED
- 16. THE TERMS "PROVIDE" OR "FURNISH", AS USED ON THESE PLANS, INDICATE THAT THE CONTRACTOR IS TO FURNISH AND INSTALL THE REFERENCED EQUIPMENT OR SYSTEMS IN THEIR ENTIRETY AS REQUIRED FOR A COMPLETE AND OPERABLE SYSTEM.
- 17. CONTRACTOR SHALL PROVIDE AND INSTALL ALL COMPONENTS INDICATED ON DETAIL SHEETS, PLANS, SPECIFICATIONS AND ALL PERTINENT EQUIPMENT REQUIRED FOR A
- COMPLETE AND WORKABLE SYSTEM. 18. CONTRACT CLOSE OUT: IN THE PRESENCE OF THE OWNER, ENGINEER OR ARCHITECT; DEMONSTRATING OPERATION OF SYSTEMS AND THAT ALL SPECIFICATIONS HAVE BEEN
- 19. IT IS THE INTENTION THAT THESE SPECIFICATIONS, AND DRAWINGS ACCOMPANYING SAME, SHALL PROVIDE FOR THE FURNISHING AND INSTALLING OF THE () SYSTEMS COMPLETE AS SPECIFIED AND SHOWN. ANY WORK SHOWN ON THE DRAWINGS AND NOT PARTICULARLY DESCRIBED IN THE SPECIFICATIONS OR VICE VERSA. OR ANY WORK CHANGES WHICH MAY BE EVIDENTLY NECESSARY TO COMPLETE THE INSTALLATION SHALL BE FURNISHED BY THIS CONTRACTOR.
- 20. IT IS THE INTENT AND PURPOSE OF THESE SPECIFICATIONS AND DRAWINGS TO INCLUDE AND PROVIDE FOR ALL MATERIALS, APPLIANCES AND LABOR TO PROPERLY COMPLETE AND LEAVE IN PERFECT WORKING CONDITION THE ENTIRE SYSTEM HEREINAFTER SPECIFIED. ANY MATERIAL, LABOR OR APPLIANCE NOT SPECIFICALLY MENTIONED IN THESE SPECIFICATIONS OR SHOWN ON THE DRAWINGS. BUT NECESSARY FOR A COMPLETE INSTALLATION MUST BE FURNISHED BY THIS CONTRACTOR.
- 21. IT IS THE INTENT OF THESE PLANS AND SPECIFICATIONS TO PROVIDE ALTERATIONS AND/OR NEW CONSTRUCTION AS INDICATED ON THE DRAWINGS AND IN THE SPEĆIFICATIONS TO PROVIDE COMPLETE NEW SYSTEMS IN EVERY RESPECT, CAPABLE OF OPERATING AS DESIGNED. IT IS NOT INTENDED THAT EVERY FITTING, MINOR DETAIL OR FEATURE BE SHOWN ON DRAWINGS. THE CONTRACTOR SHALL BE RESPONSIBLE FOR ANY DETAIL NECESSARY FOR COMPLETION OF THESE SYSTEMS IN ACCORDANCE WITH GOOD PRACTICE.

## **HVAC LINE TYPES**

-/-/-/- or ----- EXISTING EQUIPMENT/DUCT TO BE REMOVED EXISTING EQUIPMENT/DUCT TO REMAIN NEW EQUIPMENT / DUCT CHILLED WATER RETURN CHILLED WATER SUPPLY HOT WATER RETURN

HOT WATER SUPPLY

Occupancy

Classification

Public

Toilet Rooms

Public

Kitchens

(Cooking)

Restroom | Toilet Rooms -

Area (SF)

47.1208

20.2488

Unit No.

(108A)

Janitors

Closet

(108B)

Kitchen

(110)

Occupancy

Density

# of Occupants

13.30

# AXB DUCTWORK DOUBLE LINE REPRESENTATION: "A" INC REPRESENTATION: "A" INDICATES DUCT WIDTH: "B" INDICATES DUCT DEPTH. DUCTWORK SINGLE LINE REPRESENTATION: "A" INDICATES DUCT WIDTH; "B" INDICATES DUCT DEPTH. SUPPLY AIR DUCT UP SUPPLY AIR DUCT DOWN RETURN AIR DUCT UP RETURN AIR DUCT DOWN EXHAUST AIR DUCT UP EXHAUST AIR DUCT DOWN SUPPLY AIR FLOW RETURN/EXHAUST AIR FLOW VOLUME DAMPER MOTORIZED DAMPER w/ ACCESS DOOR FIRE DAMPER W/ ACCESS DOOR SUPPLY AIR TERMINAL RETURN/EXHAUST AIR TERMINAL EXHAUST AIR TERMINAL

**DUCTWORK SYMBOLS** 

PIPING SYMBOLS						
	- DIRECTION OF FLOW					
	- TOP CONNECTION, 45° OR 90°					
	- BOTTOM CONNECTION, 45° OR 90°					
, <del>t</del> ,	- SIDE CONNECTION					
	- CAPPED OUTLET					
	PIPE DOWN TURN					
o	PIPE RISE					

# **VALVE SYMBOLS**

—*U*I— TWO POSITION CONTROL VALVE

—D— DROP DUCT

—R— RISE DUCT

Corrected # of

OA

7.5

Occupants (CFM/person) (CFM/ft²)

OA

0.12

(CFM)

184.80

0.8

GATE VALVE - THREADED/FLANGED GATE VALVE WITH 3/4" HOSE ADAPTER GLOBE VALVE - THREADED/FLANGED CHECK VALVE STRAINER (WITH BALL VALVE & HOSE CONNECTION) STRAINER WITH VALVED DRAIN AND QUICK-COUPLE HOSE CONNECTOR FLEXIBLE CONNECTION ANGLE GLOBE VALVE <u>\_\_lø1</u>\_\_ BUTTERFLY VALVE <u>—</u>ф— BALL VALVE CONTROL VALVE (CV) - FLOAT-OPERATED MODULATING CONTROL VALVE MODULATING CONTROL BUTTERFLY VALVE THREE-WAY MODULATING CONTROL VALVE THREE-WAY TWO POSITION CONTROL VALVE PRESSURE REGULATING VALVE PRESSURE REDUCING VALVE (PRV) TEMPERATURE & PRESSURE RELIEF VALVE SAFETY OR PRESSURE RELIEF VALVE AUTOMATIC BALANCING CONTROL VALVE WATER BALANCE DEVICE WATER FLOW MEASURING DEVICE CIRCUIT SETTER VALVE GATE VALVE WITH GLOBE-VALVED BYPASS TRIPLE DUTY VALVE WATER LEVEL CONTROLLER FLOW METER COMBINATION BALANCING AND SHUT-OFF VALVE MANUAL AIR VENT TEST PLUG (PRESSURE/TEMPERATURE)

# **GENERAL SYMBOLS**

LUBRICATED PLUG VALVE

PLUG VALVE

**─**Ū

POINT OF CONNECTION BETWEEN NEW AND EXISTING WORK POINT OF DISCONNECT

- INDICATES SECTION LETTER INDICATES DRAWING NUMBER WHERE LOCATED XXX INDICATES TYPE OF AIR OUTLET INDICATES AIR FLOW REQUIREMENTS

WALL MOUNT THERMOSTAT

'A' DESIGNATES COMPONENT SERVED

**Greenwood Lake Elementary School Ventilation Table** Uncorrected OA | Air Distribution | Final Outdoor System Outdoor Air Final Exhaust EA (CFM/ft<sup>2</sup>) Effectiveness | Airflow (CFM) | Airflow (CFM) | Fraction Airflow (CFM) 50 CFM (CNT)/ 50 CFM ---70 CFM (INT) (Continuous) 50 CFM 60 CFM (CNT)/ 70 CFM (INT) (Continuous)

0.22

0.7

1050

231

## **ABBREVIATIONS**

AIR CONDITIONING UNIT ACT ACOUSTIC CEILING TILE ACCU AIR COOLED CONDENSING UNIT ACCESS DOOR AFTER FILTER ABOVE FINISHED FLOOR AFM AIR FLOW MEASURING DEVICE AIR HANDLING UNIT AUTOMATIC LOUVER DAMPER (PNEUMATIC) ACCESS PANEL BDD BACK DRAFT DAMPER BOTTOM GRILLE (WALL TYPE) BOTTOM REGISTER (WALL TYPE) BTUH BRITISH THERMAL UNITS/HOUR COOLING COIL CD CEILING DIFFUSER CFM CUBIC FEET PER MINUTE CG CEILING GRILLE CLG CEILING CLEAN OUT CONDENSATE PUMP CEILING REGISTER CUH CABINET UNIT HEATER CW COLD WATER DRY BULB TEMPERATURE. \*F DECIBELS dΒ DOWN DIFFERENTIAL PRESSURE DEW POINT TEMPERATURE. \*F DUCT SMOKE DETECTOR DIRECT EXPANSION EXHAUST AIR ENTERING AIR TEMP ELECTRICAL CONTRACTOR E.C. ECC ENGINEERING CONTROL CENTER EER ENERGY EFFICIENCY RATIO EXHAUST FAN EGW ETHYLENE GLYCOL-WATER SOLUTION EMD END OF MAIN DRIP (STEAM) ERC ENERGY RECOVERY COIL ELECTRIC RADIANT CEILING PANEL EXPANSION TANK EUH ELECTRIC UNIT HEATER EXIST **EXISTING** F.A.I. FRESH AIR INTAKE FLEXIBLE CONNECTION FCU FAN COIL UNIT FIRE DAMPER FD FLOOR F.O.R. FUEL OIL RETURN F.O.S. FUEL OIL SUPPLY FPC FIRE PROTECTION CONTRACTOR F/SD COMBINATION FIRE/SMOKE DAMPER FIN TUBE RADIATION NATURAL GAS PIPE GENERAL CONTRACTOR GH GRAVITY HOOD GALLONS PER MINUTE H.C. HVAC CONTRACTOR HEPA FILTER HORSEPOWER HRP HYDRONIC RADIANT CEILING PANEL HEATING AND VENTILATING UNIT INLET VANES LCD LINEAR CEILING DIFFUSER LFD LAMINAR FLOW DIFFUSER LINEAR FEET LP GAS PIPING LPG LOW PRESSURE STEAM CONDENSATE LPR LPS LOW PRESSURE STEAM LBS/HR POUNDS PER HOUR MIXING BOX

MD MOTORIZED DAMPER MER MECHANICAL EQUIPMENT ROOM MAX. MAXIMUM MBH ONE THOUSAND BTUH MIN. MINIMUM NOM. NOMINAL OA OUTSIDE AIR

WFM

WMS

P.C. PLUMBING CONTRACTOR PD PRESSURE DROP (FEET OF WATER) PRE-FILTER PGW PROPYLENE GLYCOL-WATER SOLUTION PRV

PREHEAT PRESSURE REDUCING VALVE PSI POUNDS PER SQUARE IN. RETURN AIR RETURN FAN

RHC REHEAT COIL RELATIVE HUMIDITY RPZ REDUCED PRESSURE ZONE SUPPLY AIR SD SMOKE DAMPER Sp. Gr SPECIFIC GRAVITY SH STEAM HUMIDIFIER SP STATIC PRESSURE

SPD SPLITTER DAMPER SPS STATIC PRESSURE SENSOR S.S. STAINLESS STEEL TOP GRILLE (WALL TYPE) TOP REGISTER (WALL TYPE) TWU THRU WALL UNIT UNIT HEATER UH U.N.O.

VERIFY IN FIELD

WIRE MESH SCREEN

UNLESS NOTED OTHERWISE UNIT VENTILATOR VALVE VOLUME DAMPER **VOLUME EXTRACTOR** VIBRATION ISOLATOR

WET BULB TEMPERATURE, \*F

WATER FLOW MEASURING DEVICE

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KEY PLAN

GREENWOOD LAKE

UNION FREE

SCHOOL DISTRICT

SED PROJECT NUMBER

44-21-11-02-0-002-015

CAPITAL IMPROVEMENTS

**LEGEND** 

12/29/21 FOR BID

UNAUTHORIZED ALTERATION OR ADDITION TO A

PLAN BEARING A LICENSED PROFESSIONAL

ENGINEER'S SEAL IS A VIOLATION OF SECTION

7209, SUB-DIVISION 2 OF THE N.Y. STATE

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ERIC D. FELLENZER, P.E.

NY PROFESSIONAL ENGINEER NO. 073084-1

No. | Date | Revisions


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1-8-21

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HVAC SYMBOLS, NOTES, & ABBREVIATIONS

SED PROJECT NUMBER
44-21-11-02-0-002-015

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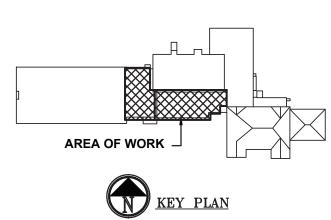
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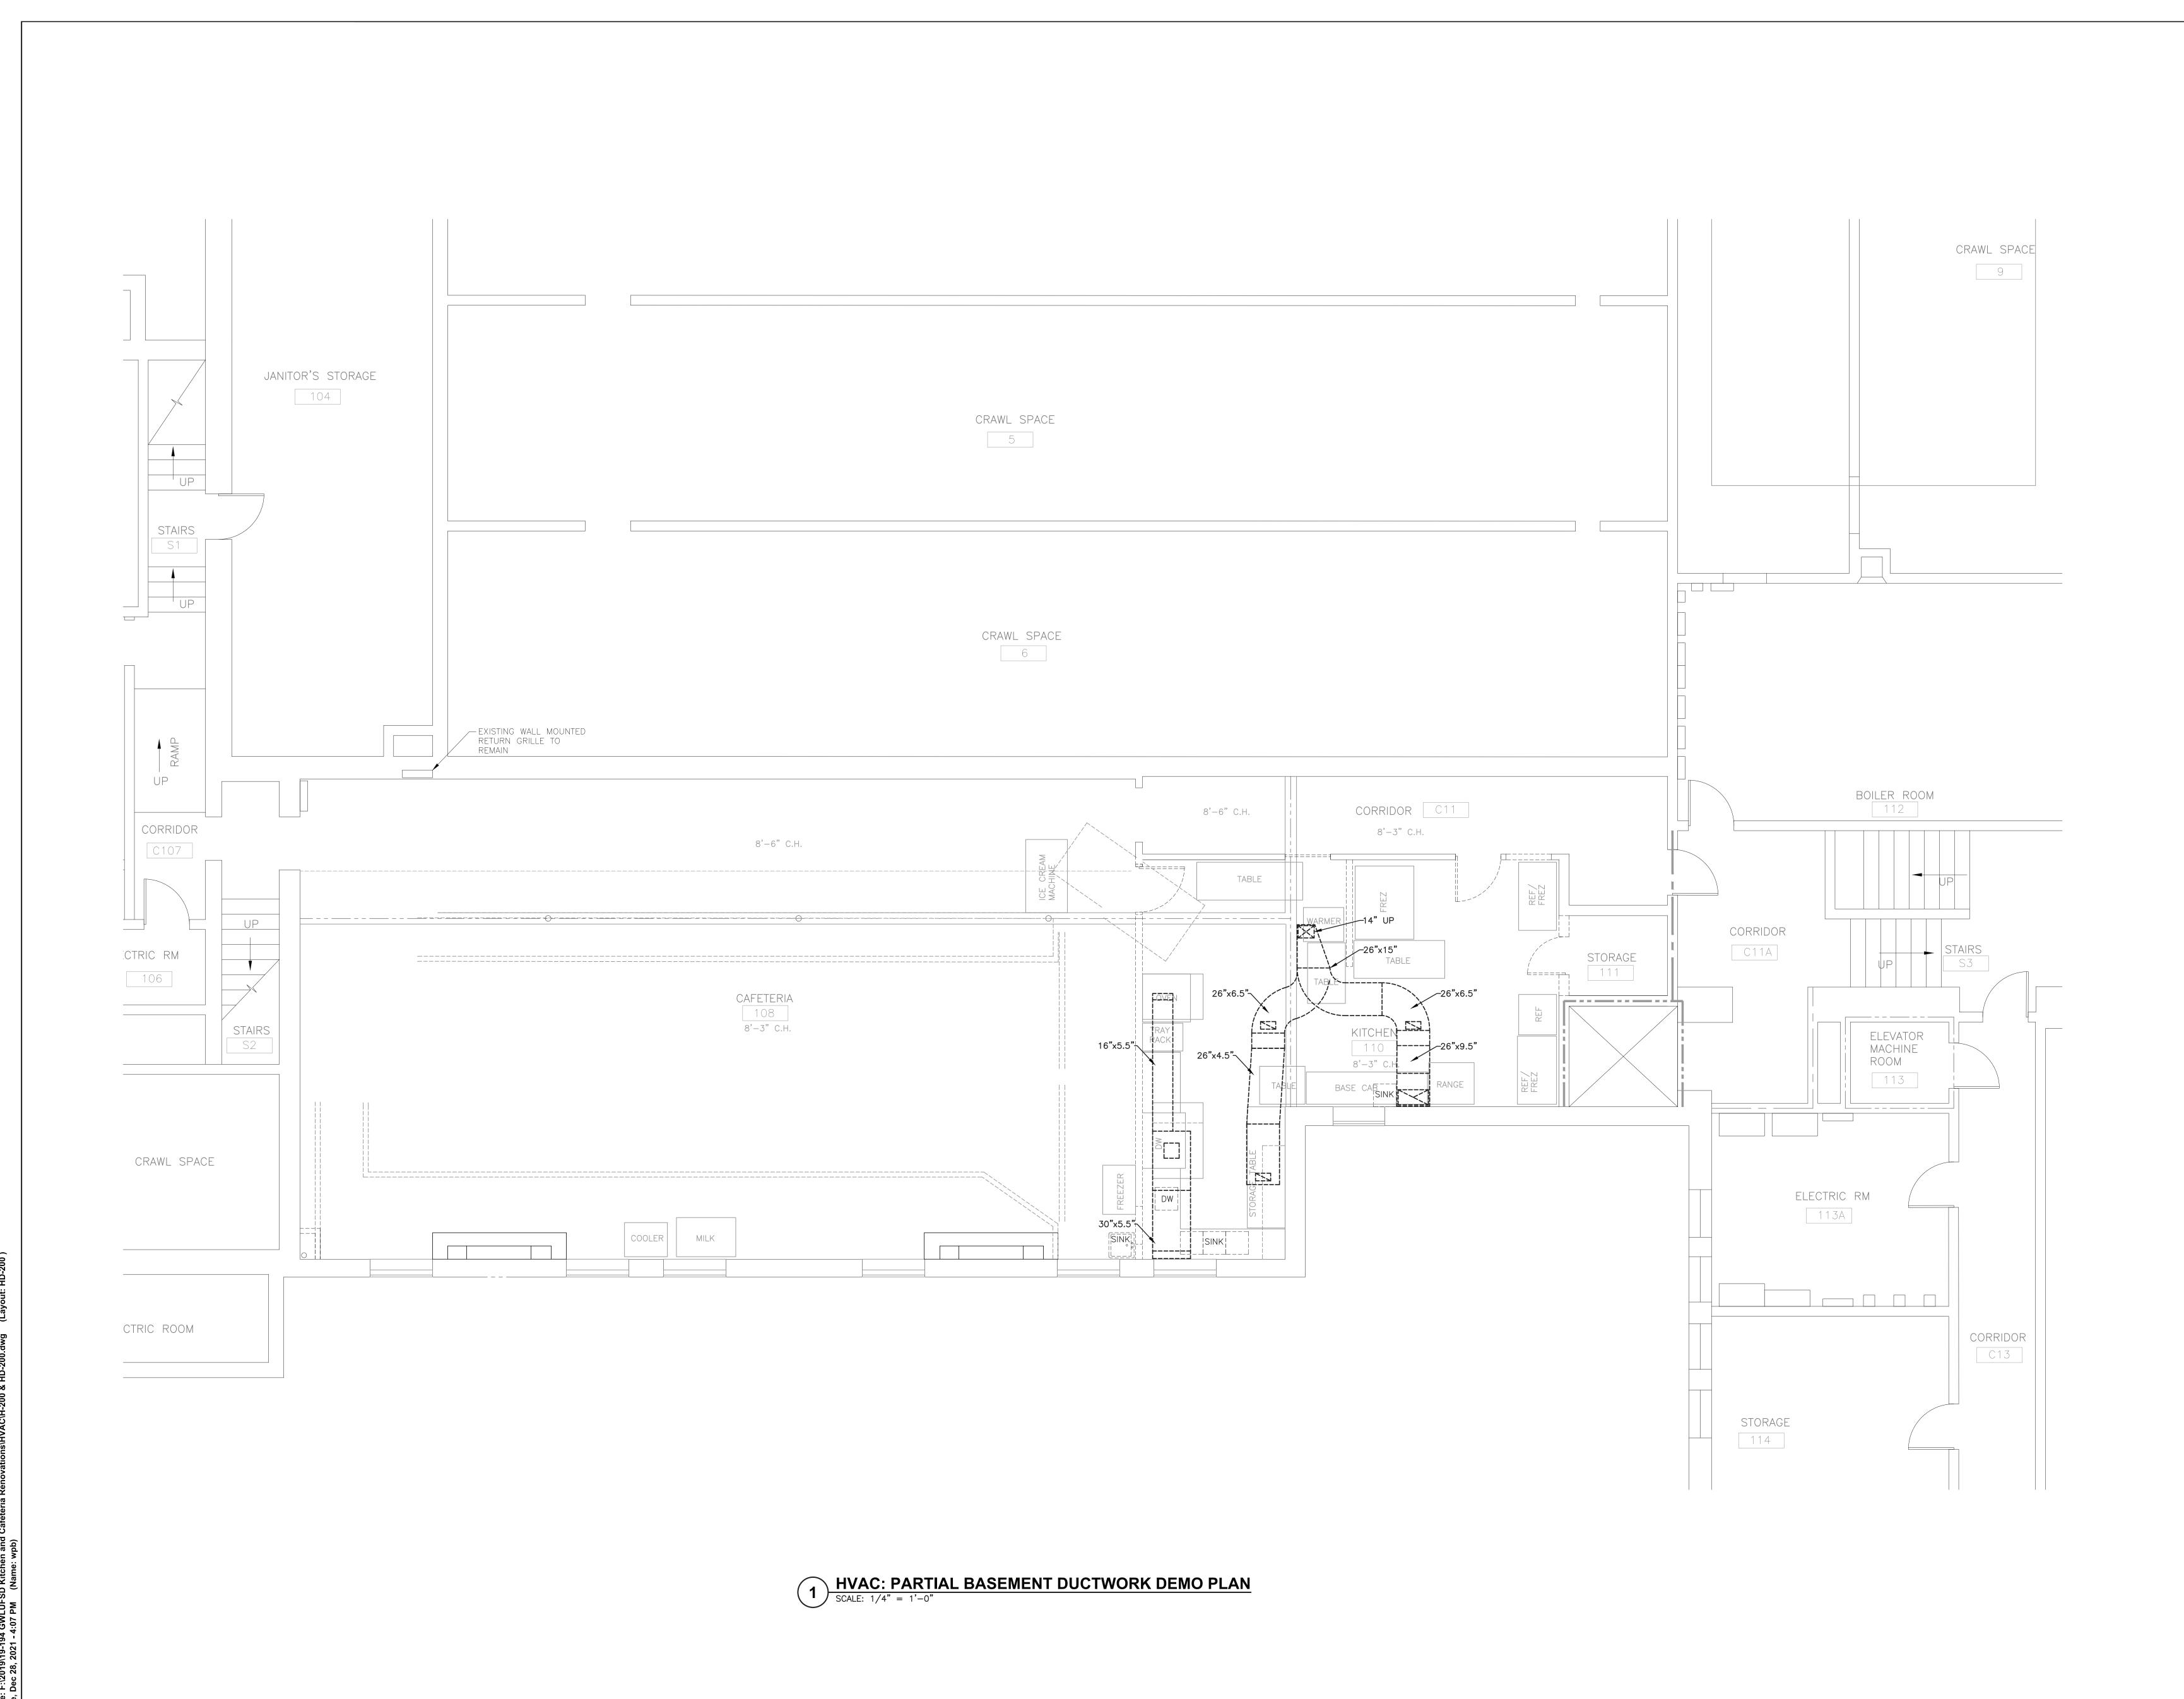
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HVAC:
PARTIAL BASEMENT
HYDRONIC PIPING
DEMO PLAN

Drawing No.

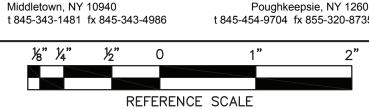**HD-100** 



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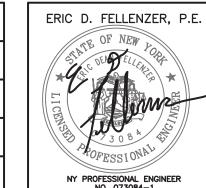
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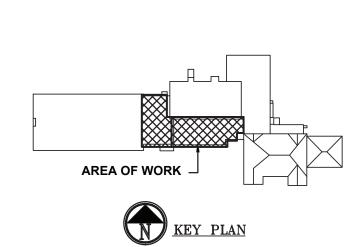
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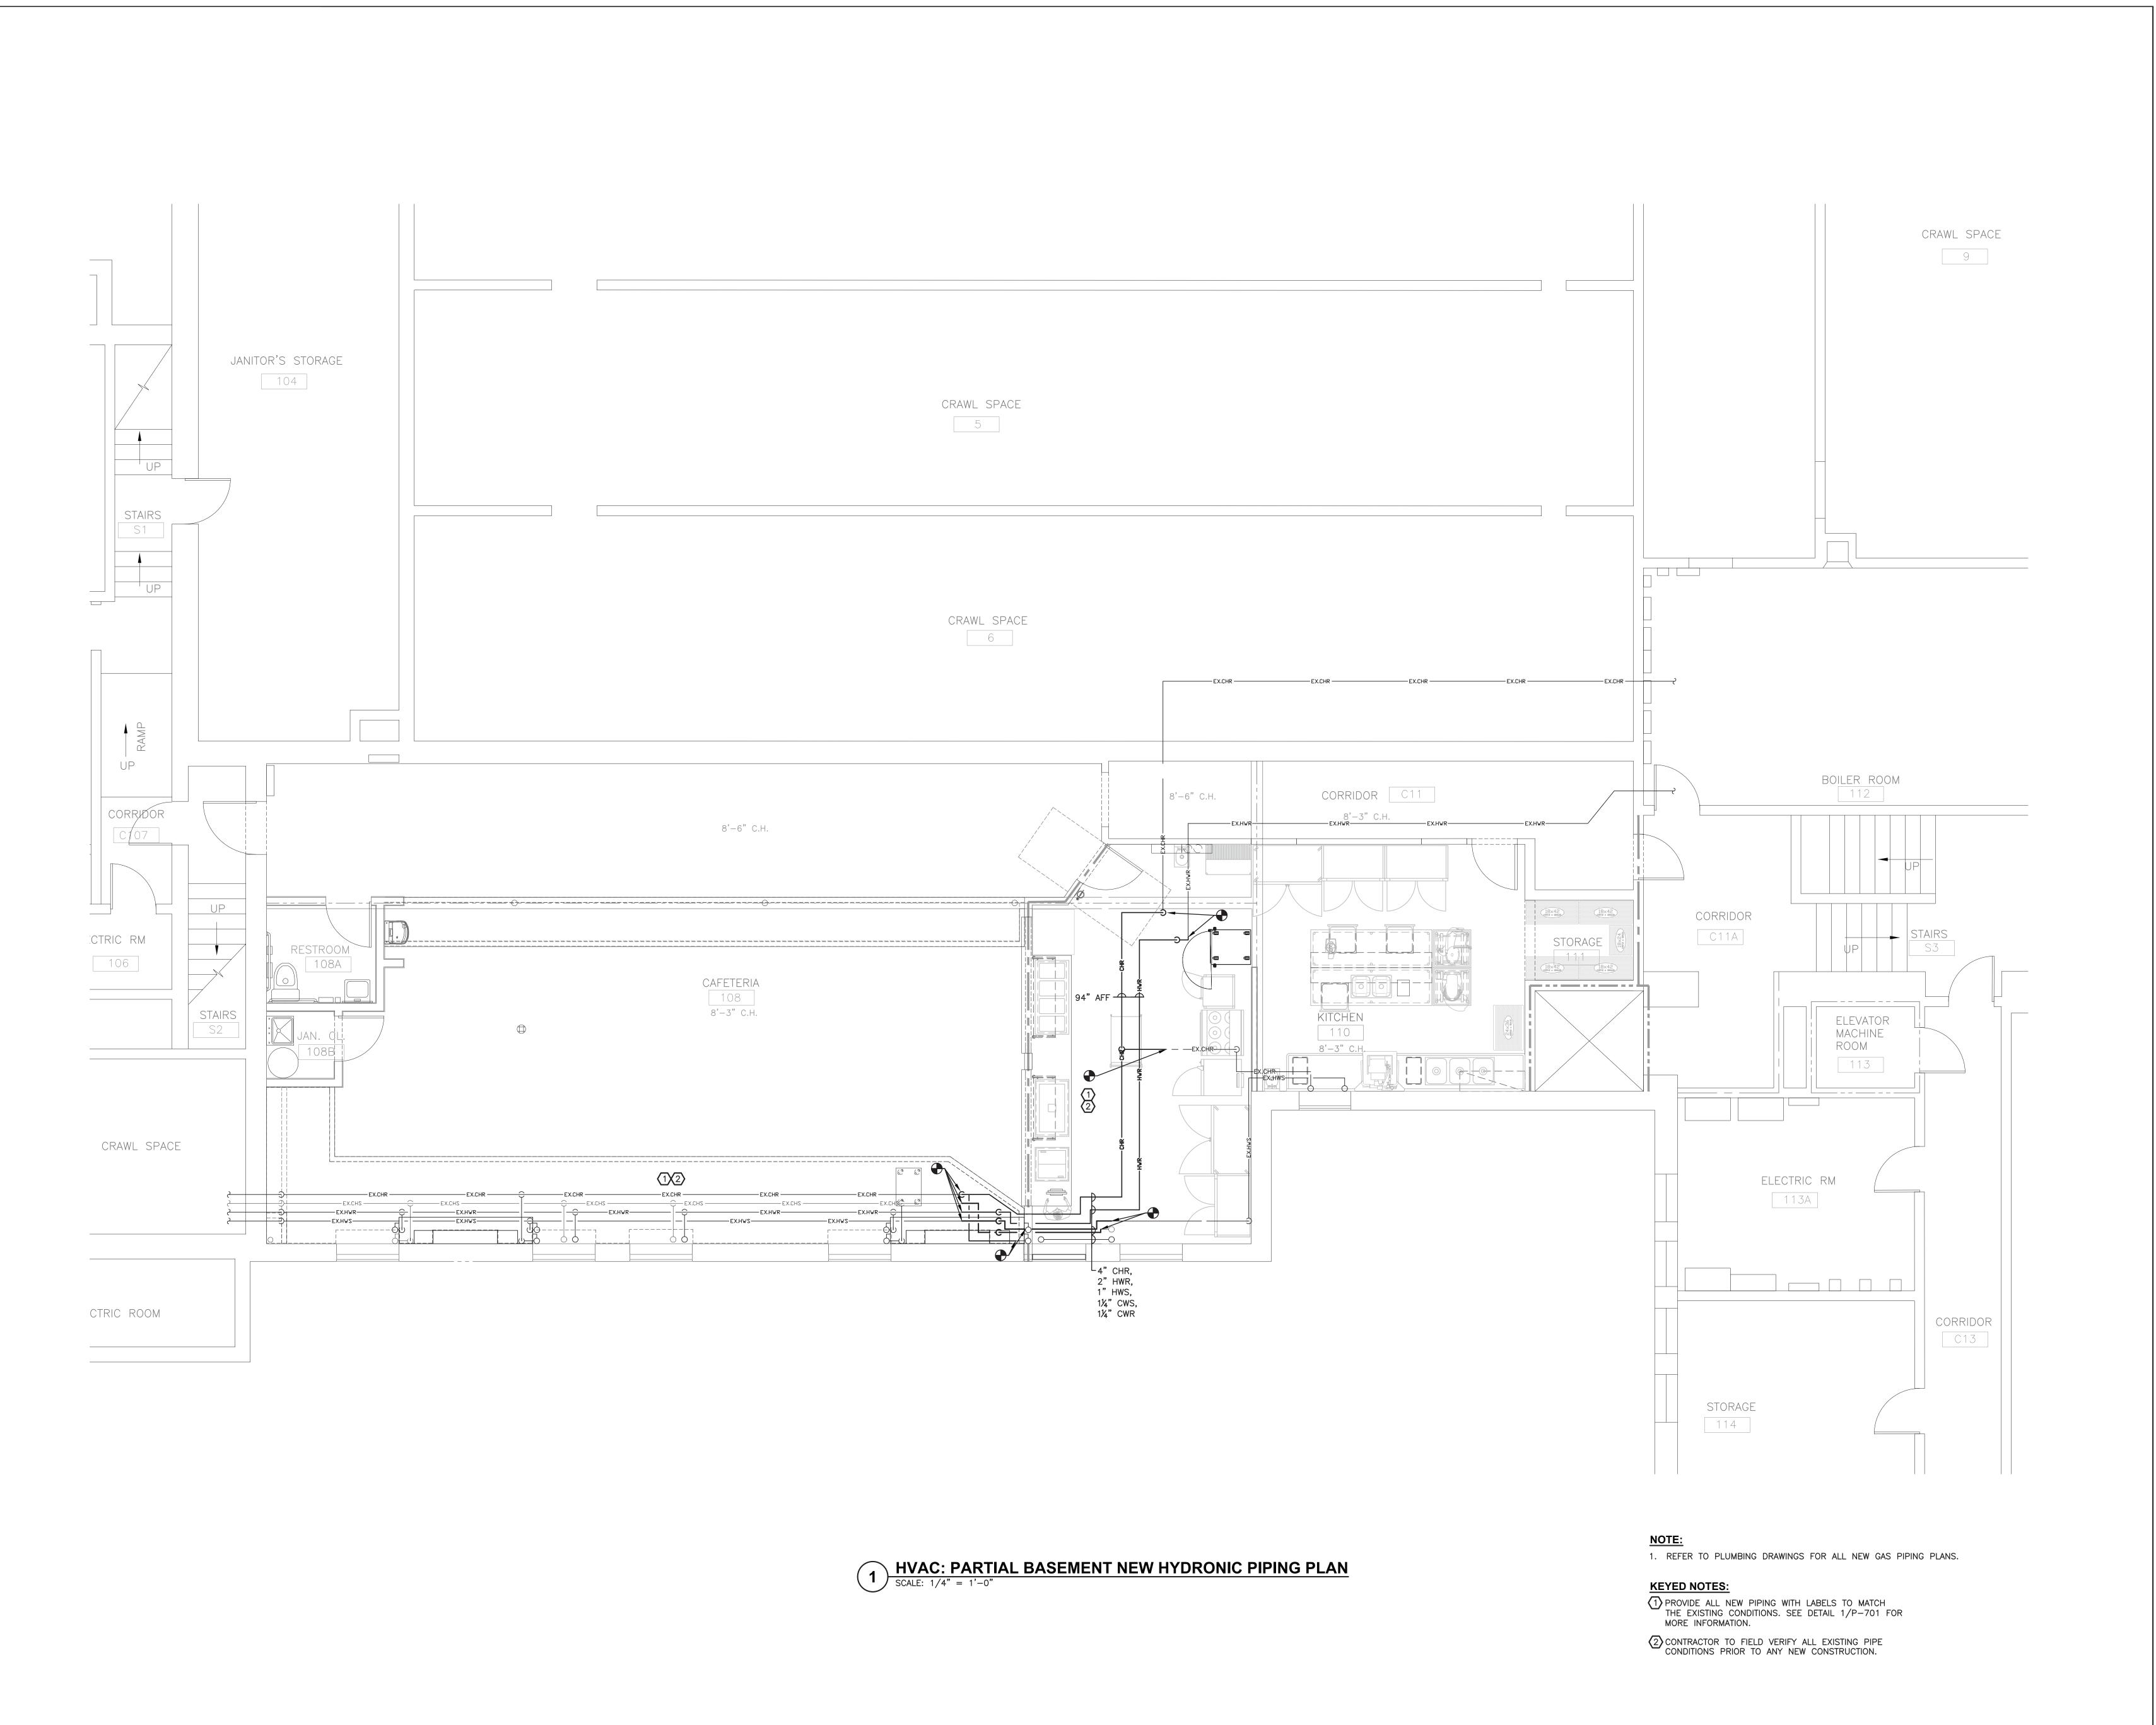
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HVAC:
PARTIAL BASEMENT
DUCTWORK DEMO PLAN

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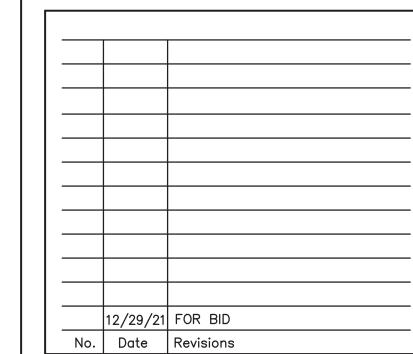
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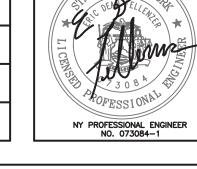
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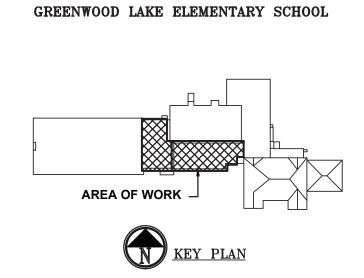
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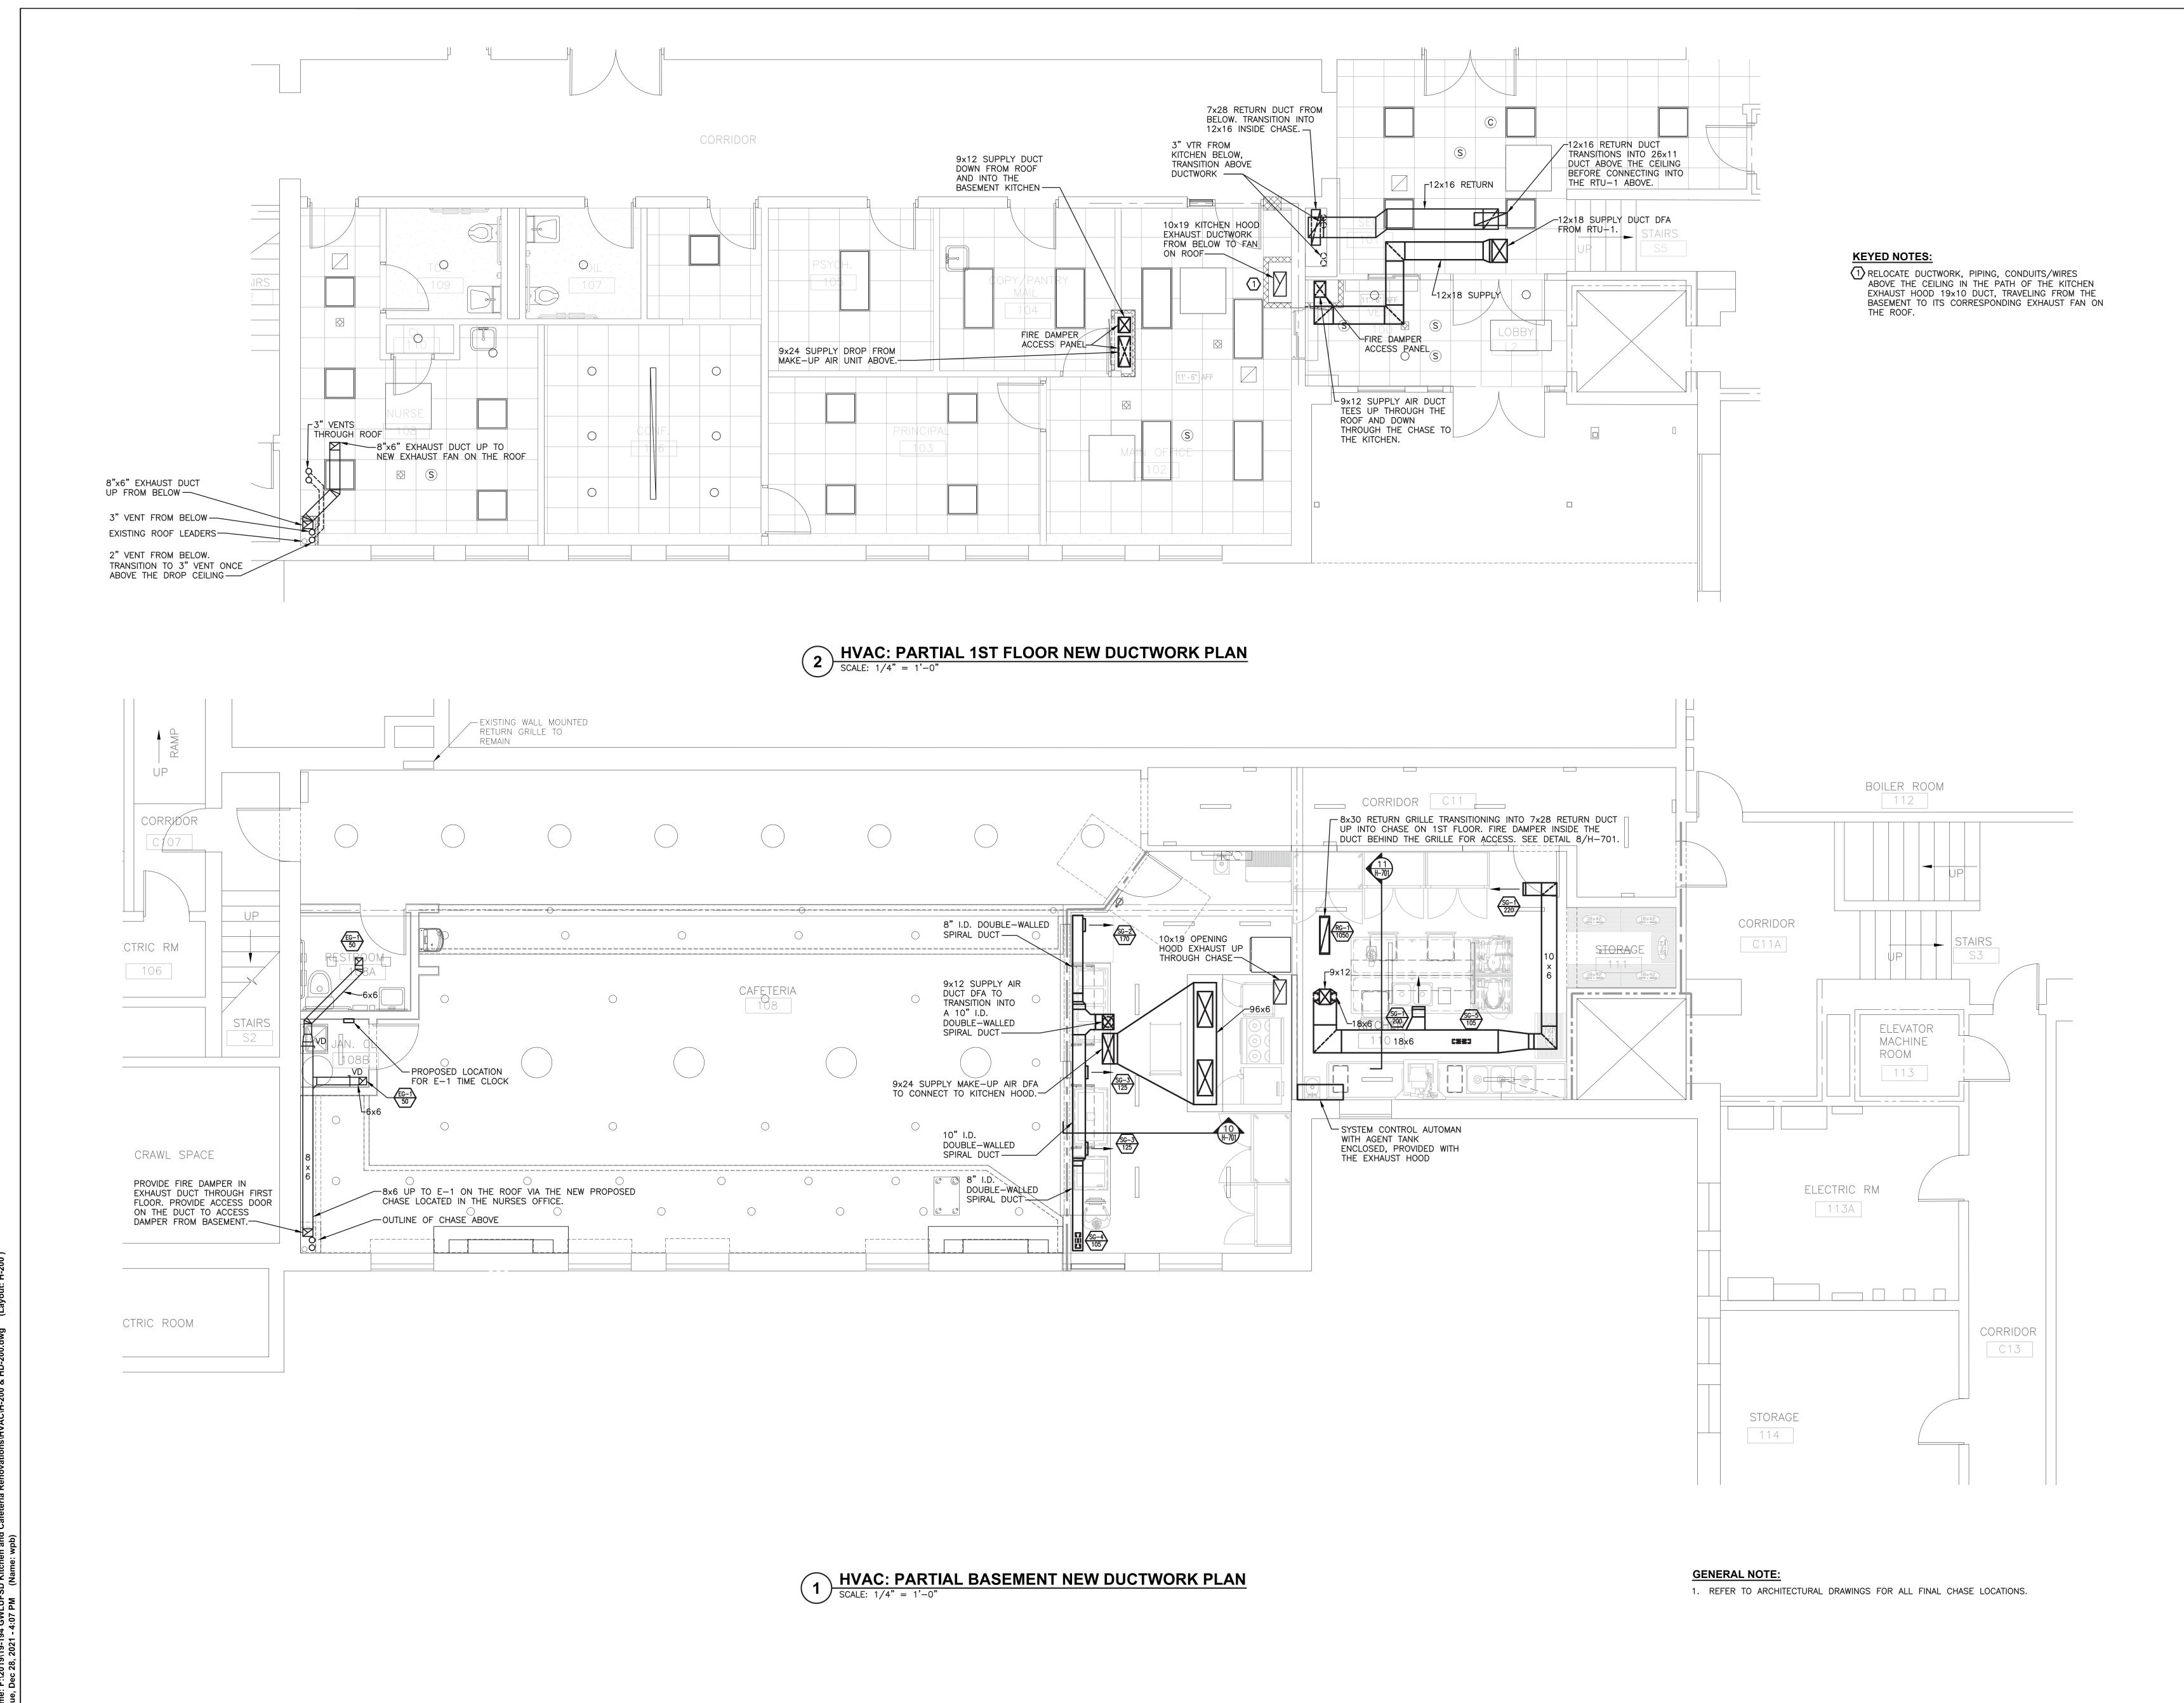
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Drawing Title

HVAC:
PARTIAL BASEMENT
NEW HYDRONIC PIPING PLAN

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44-21-11-02-0-002-015

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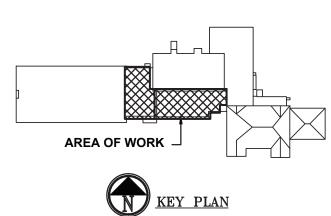
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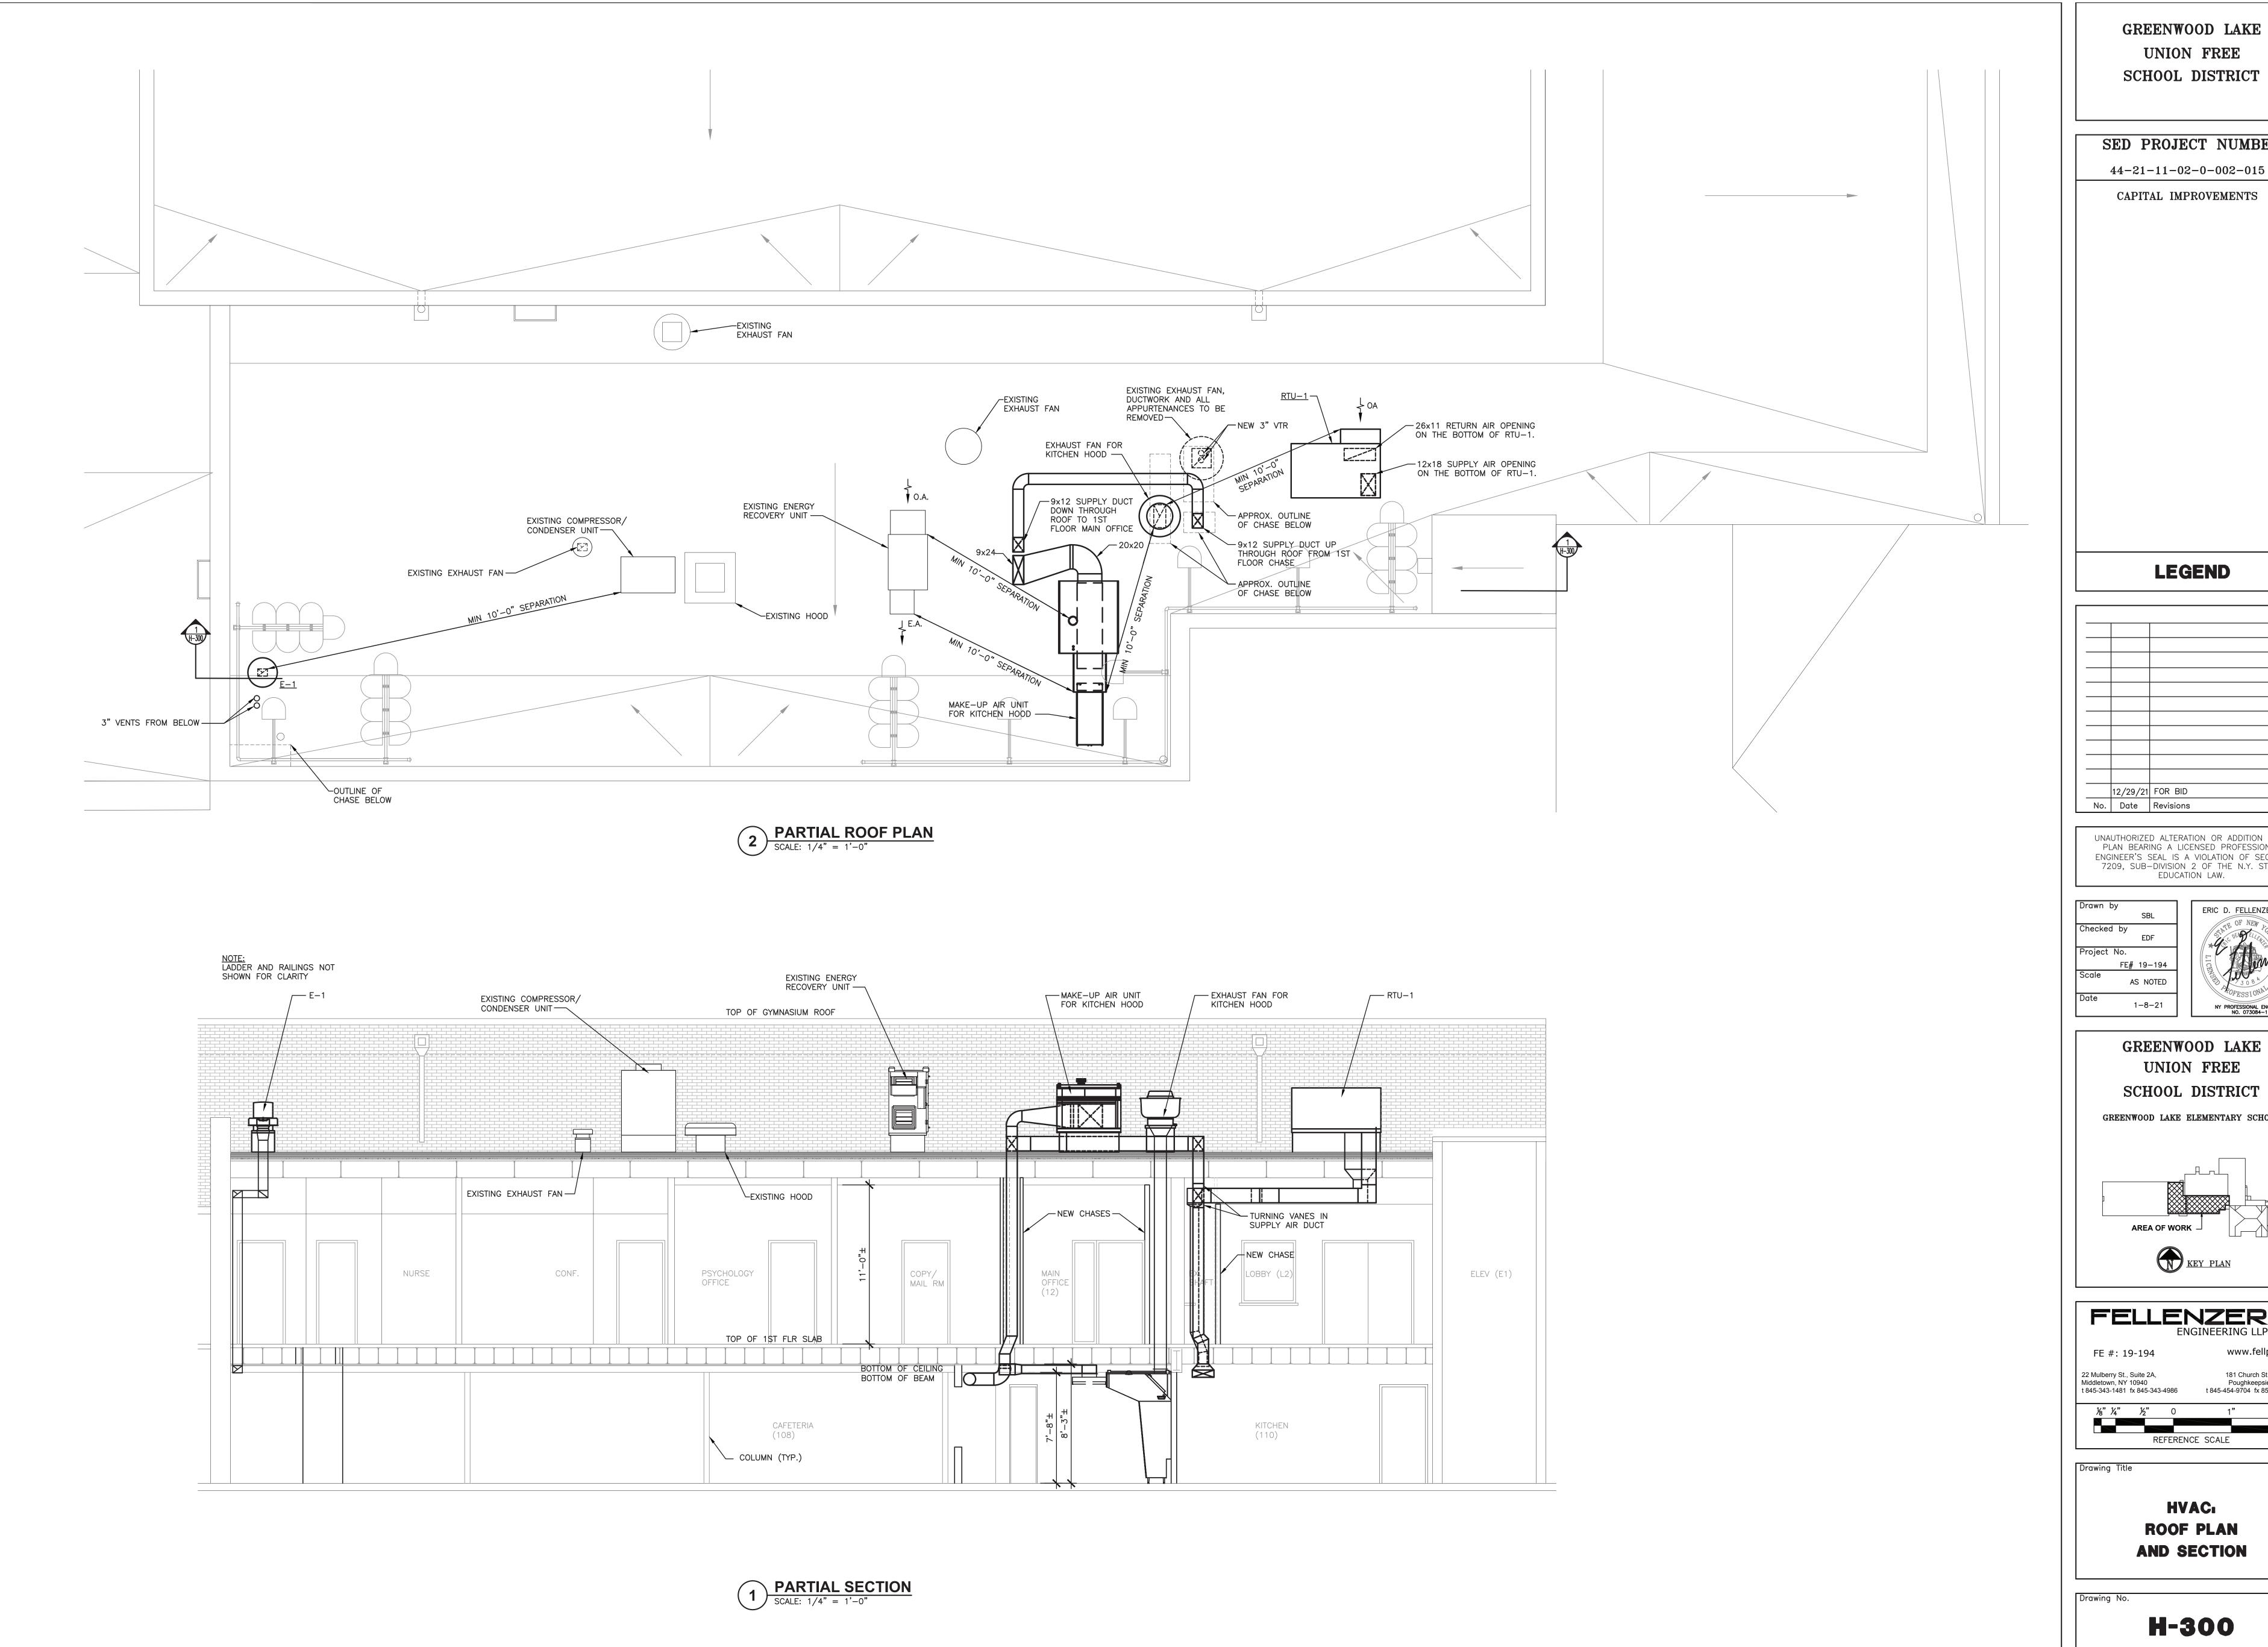
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NEW DUCTWORK PLAN


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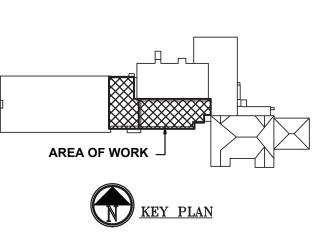


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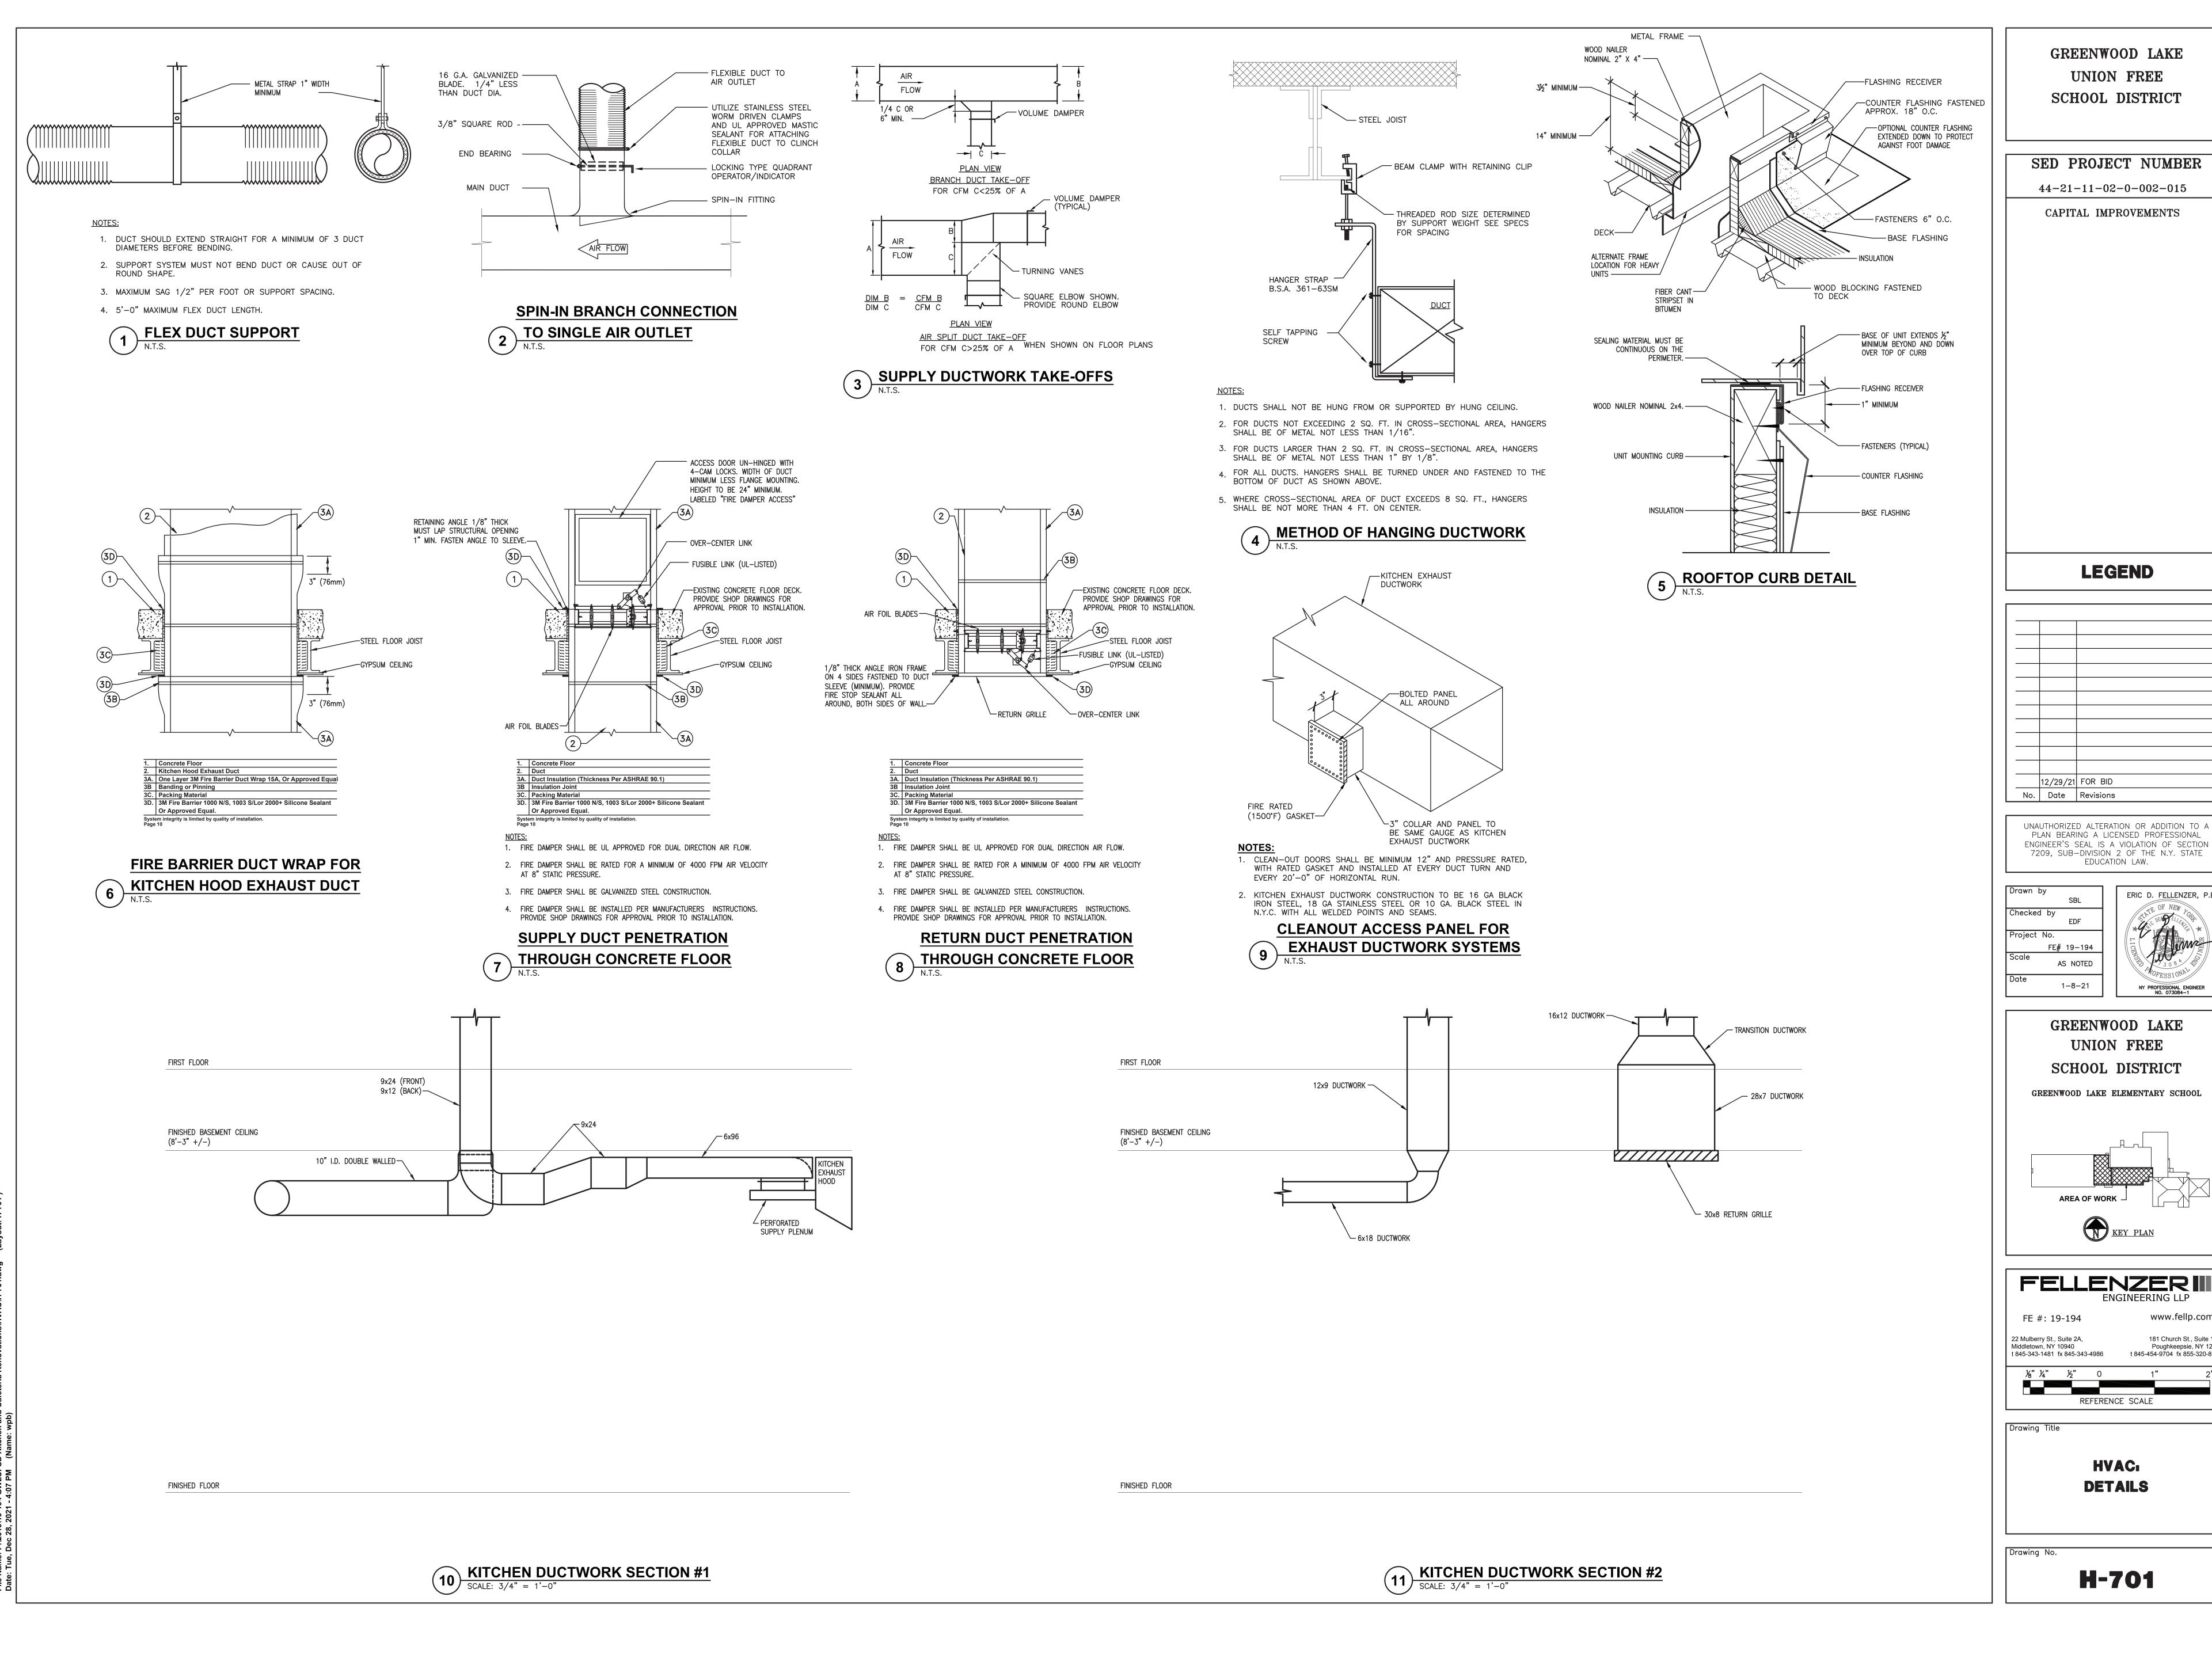


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HVAC **ROOF PLAN AND SECTION** 



H-701
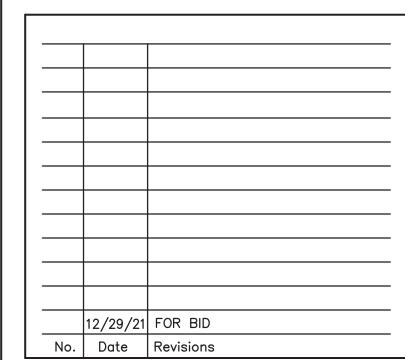
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1-8-21

ERIC D. FELLENZER, P.E.

- 1. AFUE COLUMN REPRESENTS ANNUAL FUEL UTILIZATION EFFICIENCY. 2. RTU-1 SHALL BE INTEGRATED INTO THE EXISTING BUILDING MANAGEMENT SYSTEM. PROVIDE ALL APPURTENANCES REQUIRED FOR A COMPLETE AND OPERATIONAL SYSTEM. COORDINATE WITH GREENWOOD LAKE CONTROLS
- CONTRACTOR FOR ALL REQUIREMENTS. 3. PROVIDE UNIT WITH A HIGH STATIC BLOWER.
- 4. PROVIDE UNIT WITH A ECONOMIZER.
- 5. PROVIDE UNIT WITH HINGED PANELS. 6. PROVIDE UNIT WITH A 2" THICK MERV 13 THROWAWAY FILTER.
- 7. PROVIDE UNIT WITH A MANUFACTURER APPROVED ROOF CURB. ROOF CURB MUST BE A MIN. OF 14" OVERALL HEIGHT.

EXHAUST FAN SCHEDULE														
GENERAL DATA								ELECTRICAL DATA		DEMA DIZO				
I.D.	MANUFACTURER	MODEL NO.	AIRFLOW	TOTAL EXTERNAL S.P.	FAN RPM	POWER START UP	USAGE OPERATING	- MOTOR SIZE	SONES	SOUND LEVEL	WEIGHT	VOLTAGE/PHASE	FLA	REMARKS
E-1	GREENHECK	G-097-VG	100 CFM	0.50 " WG	1,135	0.03 BHP	0.03 BHP	1/4 HP	4.6	47 dBA	38 LBS.	115/1	2.85	SEE NOTES

1. PROVIDE UNIT WITH A BACKDRAFT DAMPER, MOTOR STARTER, AND BIRDSCREEN. 2. PROVIDE UNIT WITH A 24 HOUR / 7 DAY TIME CLOCK.

	REGISTER & GRILLE SCHEDULE									
I.D.	MANUFACTURER	MODEL NO.	AIRFLOW (CFM)	FRAME TYPE	NOMINAL FACE SIZE	BLADE DEFLECTION	BLADE SPACING	FINISH	REMARKS	
SG-1	TITUS	271FS	200-220	DUCT MOUNTED	10" x 6"	DOUBLE	3/4"	WHITE	SEE NOTES	
SG-2	HART/COOLEY	SVH-3-12X4-W-8	170	DUCT MOUNTED	12" X 4"	DOUBLE	3/4"	WHITE ENAMEL	SEE NOTES	
SG-3	HART/COOLEY	SVH-3-10X4-W-10	125	DUCT MOUNTED	10" X 4"	DOUBLE	3/4"	WHITE ENAMEL	SEE NOTES	
SG-4	HART/COOLEY	SVH-3-10X4-W-8	125	DUCT MOUNTED	10" X 4"	DOUBLE	3/4"	WHITE ENAMEL	SEE NOTES	
SG-5	HART/COOLEY	USVH-3-14X3-W	105	DUCT MOUNTED	14" X 3"	DOUBLE	3/4"	WHITE	SEE NOTES	
RG-1	TITUS	56FL	1050	SURFACE MOUNTED	30" x 8"	SINGLE	3/4"	WHITE	SEE NOTES	
EG-1	TITUS	56FL	50	SURFACE MOUNTED	6" x 6"	SINGLE	3/4"	WHITE	SEE NOTES	

1. ALL FINAL MOUNTING LOCATIONS FOR ALL GRILLES, REGISTERS & DIFFUSERS CAN BE SEEN ON THE ARCHITECTURAL PLANS, ALL LOCATIONS SHOWN ON THE MECHANICAL PLAN ARE TENTATIVE.

INSULATION S	SCHED	ULE	"KNAUF" AS STANDARD OR APPROVED EQUAL			
INSIDE BUILDING THERMAL ENVELOPE	FIBERGLASS FL R=8.0 (INSTAL		KET, 1.0 LB/CF COMPRESSION)			
SERVICE	FACING	MINIMUM THICKNESS TO MEET ASHRAE 90.1 REQUIREMENTS				
SUPPLY/RETURN AIR	FSK	2"				
OUTDOOR AIR	FSK	2"				
EXHAUST AIR	-	NONE				
OUTSIDE BUILDING THERMAL ENVELOPE	FIBERGLASS FI R=12.0	EXIBLE BLAN	KET, 1.0 LB/CF			
SERVICE	FACING	THICKNESS TO EXCEED ASHRAE 90.1 REQUIREMENTS				
SUPPLY/RETURN AIR	ASJ	4"				

\* FLEXIBLE ELASTOMERIC FOAM INSULATION (ARMACELL OR EQUIVALENT)

1. ALL EDGES SHALL BE CLEAN CUT.

- 2. ALL SEAMS AND BUTT JOINTS SHALL BE ADHERED AND SEALED USING ARMAFLEX 520 ADHESIVE. HORIZONTAL JOINTS SHALL BE AT BOTTOM OF DUCTS & PIPES.
- 3. ALL EXPOSED END CUTS SHALL BE COATED WITH ARMAFLEX 520 ADHESIVE.
- 4. INSULATION AT HIGH END OF PIPING RUNS SHALL BE ADHERED DIRECTLY TO THE PIPING USING A 1" STRIP OF 520 ADHESIVE ON THE I.D. OF THE INSULATION AND ON THE PIPE.
- 5. FOR ALL OUTDOOR EXPOSED DUCTWORK, THE HORIZONTAL SURFACE SHALL BE SLOPED TP PREVENT POUNDING ON SURFACE OF COATED INSULATION (2° MIN.).
- 6. THE "ARMA TUFF" PLUS SYSTEM MAY BE USED IN LIEU OF EXTERIOR DUCT INSULATION/WEATHER RESISTANT SYSTEM DESCRIBED IN SCHEDULE ABOVE.

## MINIMUM DUCT INSULATION

COMMERCIAL

ALL SUPPLY AND RETURN AIR DUCTS AND PLENUMS SHALL BE INSULATED WITH A MINIMUM OF R-6 INSULATION WHEN LOCATED IN UNCONDITIONED SPACES AND WITH A MINIMUM OF R-8 INSULATION WHEN LOCATED OUTSIDE THE BUILDING ENVELOPE. WHEN LOCATED WITHIN A BUILDING ENVELOPE ASSEMBLY, THE DUCT OR PLENUM SHALL BE SEPARATED FROM THE BUILDING EXTERIOR OR UNCONDITIONED OR EXEMPT SPACES BY A MINIMUM OF R-8

## **EXCEPTIONS:**

- 1. WHEN LOCATED WITHIN EQUIPMENT.
- 2. WHEN THE DESIGN TEMPERATURE DIFFERENCE BETWEEN THE INTERIOR AND EXTERIOR OF THE DUCT OR PLENUM DOES NOT EXCEED 15°F (8°C).

ALL JOINTS, LONGITUDINAL AND TRANSVERSE SEAMS, AND CONNECTIONS IN DUCTWORK, SHALL BE SECURELY FASTENED AND SEALED WITH WELDS, GASKETS, MASTICS (ADHESIVES), MASTIC-PLUS- EMBEDDED FABRIC SYSTEMS OR TAPES. TAPES AND MASTICS USED TO SEAL DUCTWORK SHALL BE LISTED AND LABELED IN ACCORDANCE WITH UL 181A OR UL 181B. DUCT CONNECTIONS TO FLANGES OF AIR DISTRIBUTION SYSTEM EQUIPMENT SHALL BE SEALED AND MECHANICALLY FASTENED. <u>UNLISTED</u> DUCT TAPE IS NOT PERMITTED AS A SEALANT ON ANY METAL


GREENWOOD LAKE UNION FREE SCHOOL DISTRICT

SED PROJECT NUMBER


44-21-11-02-0-002-015


CAPITAL IMPROVEMENTS


**LEGEND** 

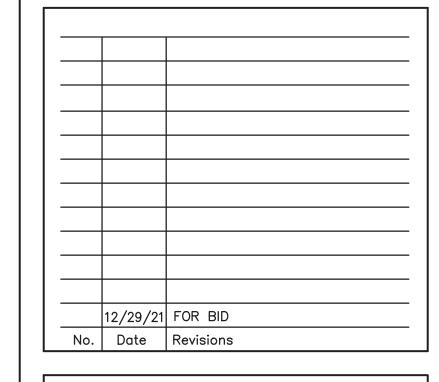


UNAUTHORIZED ALTERATION OR ADDITION TO A PLAN BEARING A LICENSED PROFESSIONAL ENGINEER'S SEAL IS A VIOLATION OF SECTION 7209, SUB-DIVISION 2 OF THE N.Y. STATE EDUCATION LAW.

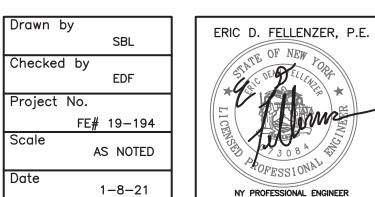

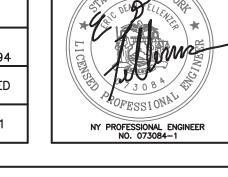

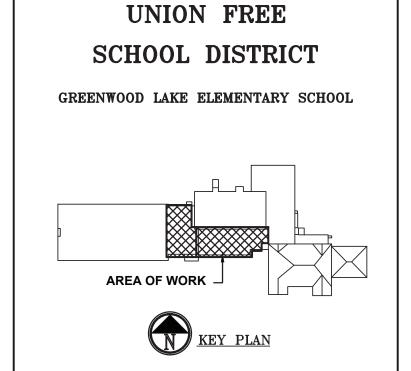


GREENWOOD LAKE

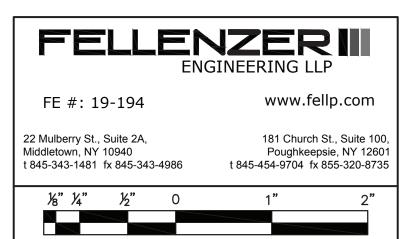

REFERENCE SCALE Drawing Title

> HVAC **SCHEDULES**

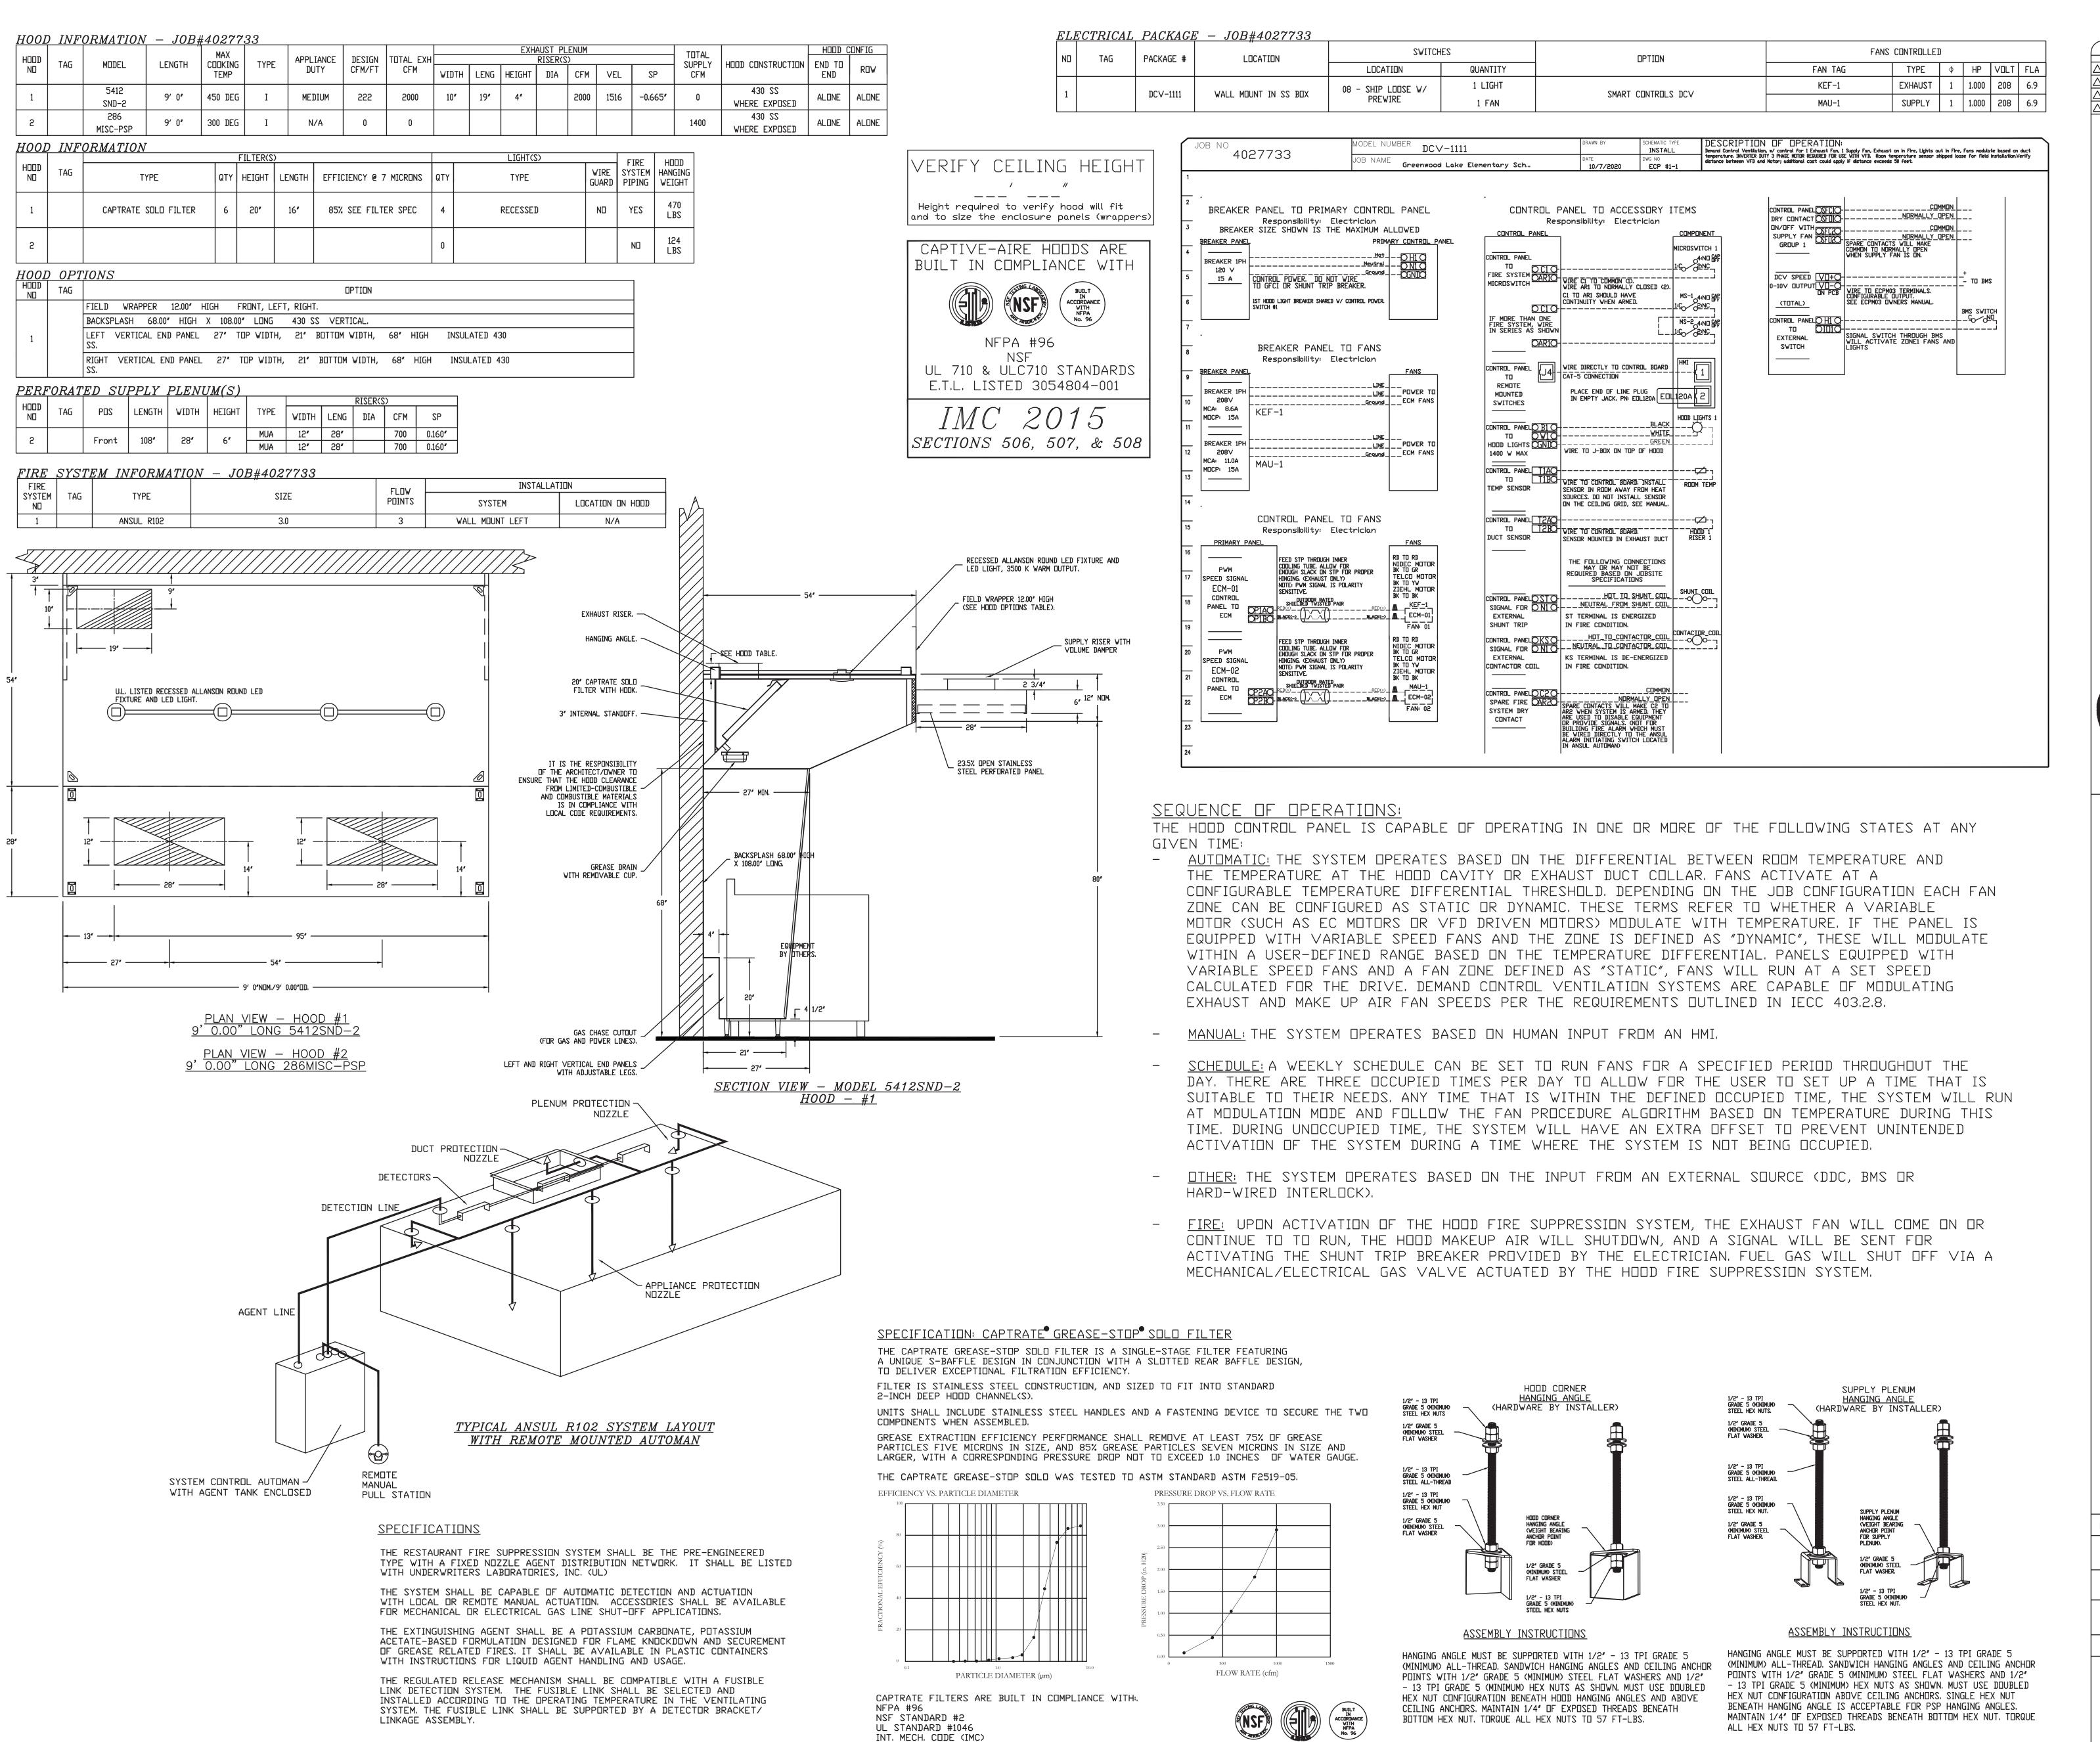

ULC-S649

GREENWOOD LAKE UNION FREE SCHOOL DISTRICT

SED PROJECT NUMBER 44-21-11-02-0-002-015 CAPITAL IMPROVEMENTS

**LEGEND** 

**REVISIONS** 

DESCRIPTION

12/29/21 FOR BID No. | Date | Revisions


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Project No. FE# 19-194 AS NOTED

1-8-21



GREENWOOD LAKE UNION FREE SCHOOL DISTRICT GREENWOOD LAKE ELEMENTARY SCHOOL

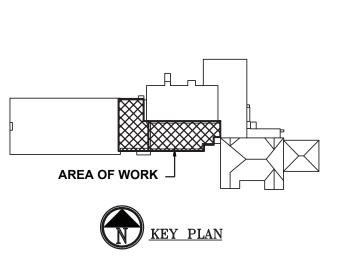

FELLENZER III www.fellp.com FE #: 19-194

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4027733

DRAWN SWA SCALE:

3/4" = 1'-0" **R4 DRAWING** 

SHEET NO.

**DATE:** 3/23/21

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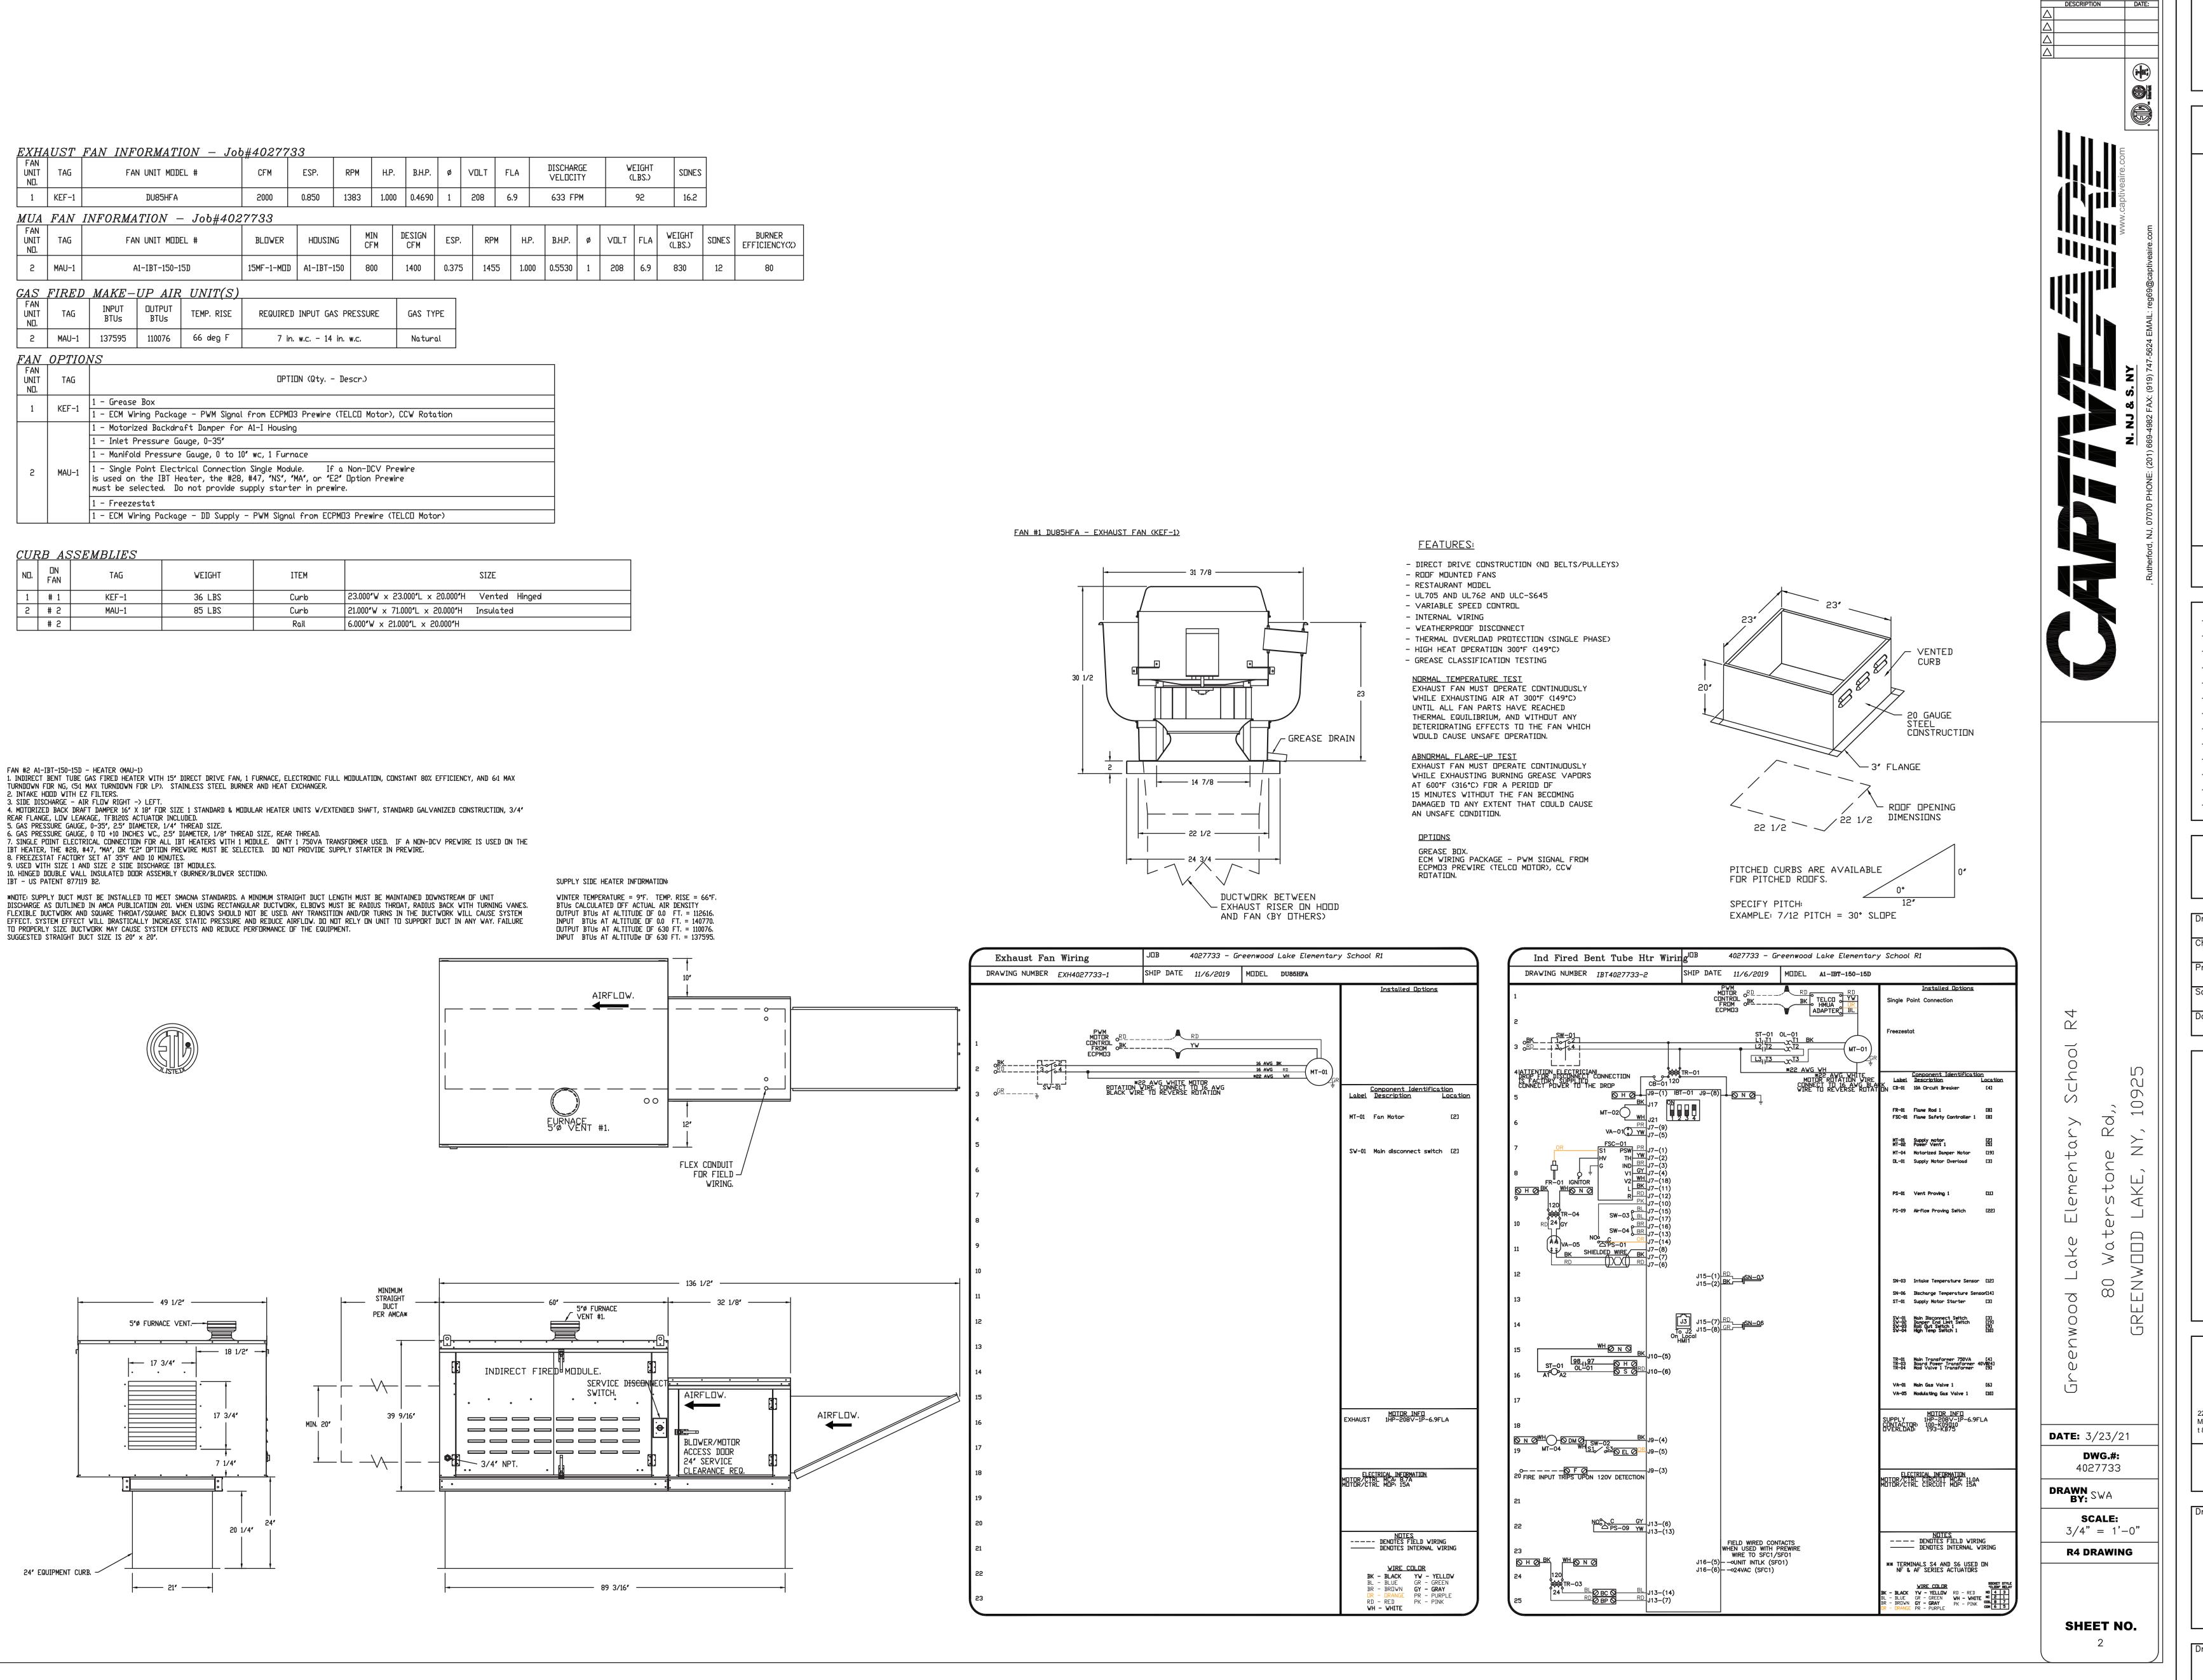
Drawing Title

½"¼" ½" O

HVAC **CAPTIVE AIRE DRAWINGS** 

REFERENCE SCALE

Drawing No.



GREENWOOD LAKE UNION FREE


SCHOOL DISTRICT

SED PROJECT NUMBER 44-21-11-02-0-002-015

CAPITAL IMPROVEMENTS

**REVISIONS** 


**LEGEND** 

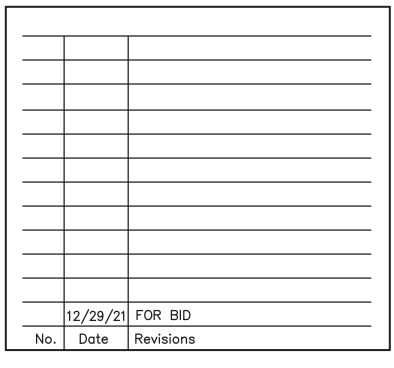

UNAUTHORIZED ALTERATION OR ADDITION TO A PLAN BEARING A LICENSED PROFESSIONAL ENGINEER'S SEAL IS A VIOLATION OF SECTION 7209, SUB-DIVISION 2 OF THE N.Y. STATE EDUCATION LAW.

Checked by AS NOTED

1-8-21

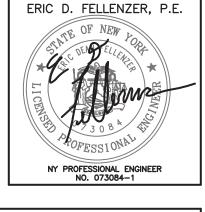

GREENWOOD LAKE UNION FREE SCHOOL DISTRICT GREENWOOD LAKE ELEMENTARY SCHOOL



www.fellp.com FE #: 19-194 22 Mulberry St., Suite 2A, 181 Church St., Suite 100 Middletown, NY 10940 Poughkeepsie, NY 12601 t 845-343-1481 fx 845-343-4986 t 845-454-9704 fx 855-320-8735 %"¼" ½" 0 REFERENCE SCALE

HVAC **CAPTIVE AIRE DRAWINGS** 

Drawing No.