



Josephine-Louise Public Library

General Construction

SECOND FLOOR COMMUNITY ROOM RENOVATIONS


Prepared for: Josephine-Louise
Public Library

5 Scofield Street
Walden, New York 12586
Ph: (845) 778-7621
F: (845) 778-1946

Library Board: Mel Wesenberg, President
Eden Holmes, Vice President
Laura McNamee, Secretary
Jason Trafton, Treasurer Liaison
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John Capello
Geraldyn Cronin

Library Director: Ginny Neidermier

Architect:

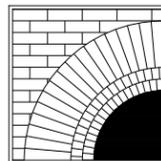

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ARCHITECTS,
LLP

57 West High Street
Ballston Spa
New York 12020
Ph: 518 . 885 . 1255
Fax: 518 . 885 . 1266
www.brmaarchitects.com

Mechanical, Electrical, Plumbing & Fire Protection Engineers:



Sage Engineering Associates, LLP
CONSULTING ENGINEERS
9 Columbia Circle
Albany, New York 12203
Ph: 518.453.6091

GENERAL NOTES

- DO NOT SCALE THE DRAWINGS.
- ALL MATERIALS, PRODUCTS AND FINISHES SHALL BE INSTALLED IN FULL COMPLIANCE WITH ALL MANUFACTURER'S INSTRUCTIONS.
- ALL INTERIOR DIMENSIONS ARE TAKEN FROM FINISH FACE, CENTERLINE OF STEEL, OR FACE OF MASONRY UNLESS OTHERWISE NOTED.
- THE CONTRACTOR SHALL VERIFY ALL DIMENSIONS AND EXISTING CONDITIONS IN THE FIELD PRIOR TO COMMENCING ANY CONSTRUCTION WORK.
- THESE DRAWINGS DO NOT CONTAIN THE NECESSARY COMPONENTS FOR CONSTRUCTION SAFETY. SAFETY DURING CONSTRUCTION IS THE CONTRACTOR'S RESPONSIBILITY.
- UNAUTHORIZED ADDITION OR ALTERATION TO THESE DOCUMENTS WITHOUT CONSULTING THE ARCHITECT IS A VIOLATION OF THE N.Y.S. EDUCATION LAW.
- ALL WORK IS TO BE IN STRICT ACCORDANCE WITH THE BUILDING CODE OF NEW YORK STATE, ENERGY CONSERVATION CONSTRUCTION CODE OF NEW YORK STATE AND APPLICABLE REFERENCE STANDARDS.

ABBREVIATIONS

AFF	ABOVE FINISH FLOOR	MIN	MINIMUM
AFG	ABOVE FINISH GRADE	MO	MASONRY OPENING
ALUM	ALUMINUM	NIC	NOT IN CONTRACT
APPROX	APPROXIMATE	OPP	OPPOSITE
CL	CENTERLINE	PT	PRESSURE TREATED
CJ	CONTROL JOINT	RO	ROUGH OPENING
COORD	COORDINATE	SIM	SIMILAR
DWG	DRAWING	TYP	TYPICAL
ELEV	ELEVATION	UNO	UNLESS NOTED OTHERWISE
EX	EXISTING	VIF	VERIFY IN FIELD
ETR	EXISTING TO REMAIN	w/	WITH
GWB	GYPSUM WALL BOARD	w/o	WITHOUT
INSUL	INSULATION	WD	WOOD
MAX	MAXIMUM		
MFGR	MANUFACTURER		

SCHEDULE OF DRAWINGS

GENERAL:

G100 TITLE SHEET: GENERAL NOTES, ABBREVIATIONS + SCHEDULE OF DRAWINGS

ARCHITECTURAL:

AR001 OVERALL SECOND FLOOR PLAN - DEMOLITION + REMOVALS
AR002 OVERALL SECOND FLOOR REFLECTED CEILING PLAN - DEMOLITION + REMOVALS
A001 OVERALL SECOND FLOOR PLAN - NEW WORK
A002 OVERALL SECOND FLOOR REFLECTED CEILING PLAN - NEW WORK
A100 ENLARGED PARTIAL SECOND FLOOR PLAN - NEW WORK
A101 ENLARGED PARTIAL SECOND FLOOR REFLECTED CEILING PLAN - NEW WORK
A102 ENLARGED PARTIAL SECOND FLOOR FINISH PLAN - NEW WORK
A200 ELEVATIONS
A201 ELEVATIONS
A300 CABINETS DETAILS
A301 CABINETS DETAILS
A400 FINISH & DOOR SCHEDULES, TYPES & DETAILS
F100 COMMUNITY ROOM FURNITURE LAYOUT (FOR REFERENCE ONLY)

MECHANICAL:

H001 LEGEND, SYMBOLS, ABBREVIATIONS AND SPECIFICATIONS
H002 SCHEDULES
H003 DETAILS
HR001 MECHANICAL SECOND FLOOR REMOVAL PLAN
H101 MECHANICAL SECOND FLOOR INSTALLATION PLAN

ELECTRICAL:

E001 LEGEND
ER101 ENLARGED SECOND FLOOR REMOVAL PLAN - POWER
ER201 OVERALL SECOND FLOOR REMOVAL PLAN - LIGHTING AND FIRE ALARM
E101 ENLARGED SECOND FLOOR PLAN - POWER
E201 OVERALL SECOND FLOOR PLAN - LIGHTING AND FIRE ALARM

CODE SUMMARY

OCCUPANCY CLASSIFICATION:
A-3 ASSEMBLY / LIBRARY
BUILDING CONSTRUCTION
CLASSIFICATION:
IIB (NON-COMBUSTIBLE EXTERIOR;
COMBUSTIBLE INTERIOR).
CLASSIFICATION OF WORK:
ALTERATIONS LEVEL 1 - 1,122 SF



BID SET: 11 OCTOBER 2022

ARCHITECT'S JOB No: 19-42-17A


DWG. No.

G100

SET No.: _____

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THE ARCHITECT CERTIFIES THAT THIS PROJECT HAS BEEN DESIGNED BY ME, OR UNDER MY SUPERVISION, IN ACCORDANCE WITH THE NEW YORK STATE UNIFORM FIRE PREVENTION AND BUILDING CODE, INCLUDING AMENDMENTS AS PUBLISHED BY NEW YORK DEPARTMENT OF STATE (CURRENT VERSION); THE ENERGY CONSERVATION CONSTRUCTION CODE (CURRENT VERSION), AND APPLICABLE FEDERAL STATE AND LOCAL LAWS, CODES, AND REGULATIONS, AND TO THE BEST OF MY KNOWLEDGE AND BELIEF, THESE DOCUMENTS ARE IN CONFORMANCE THEREWITHIN.

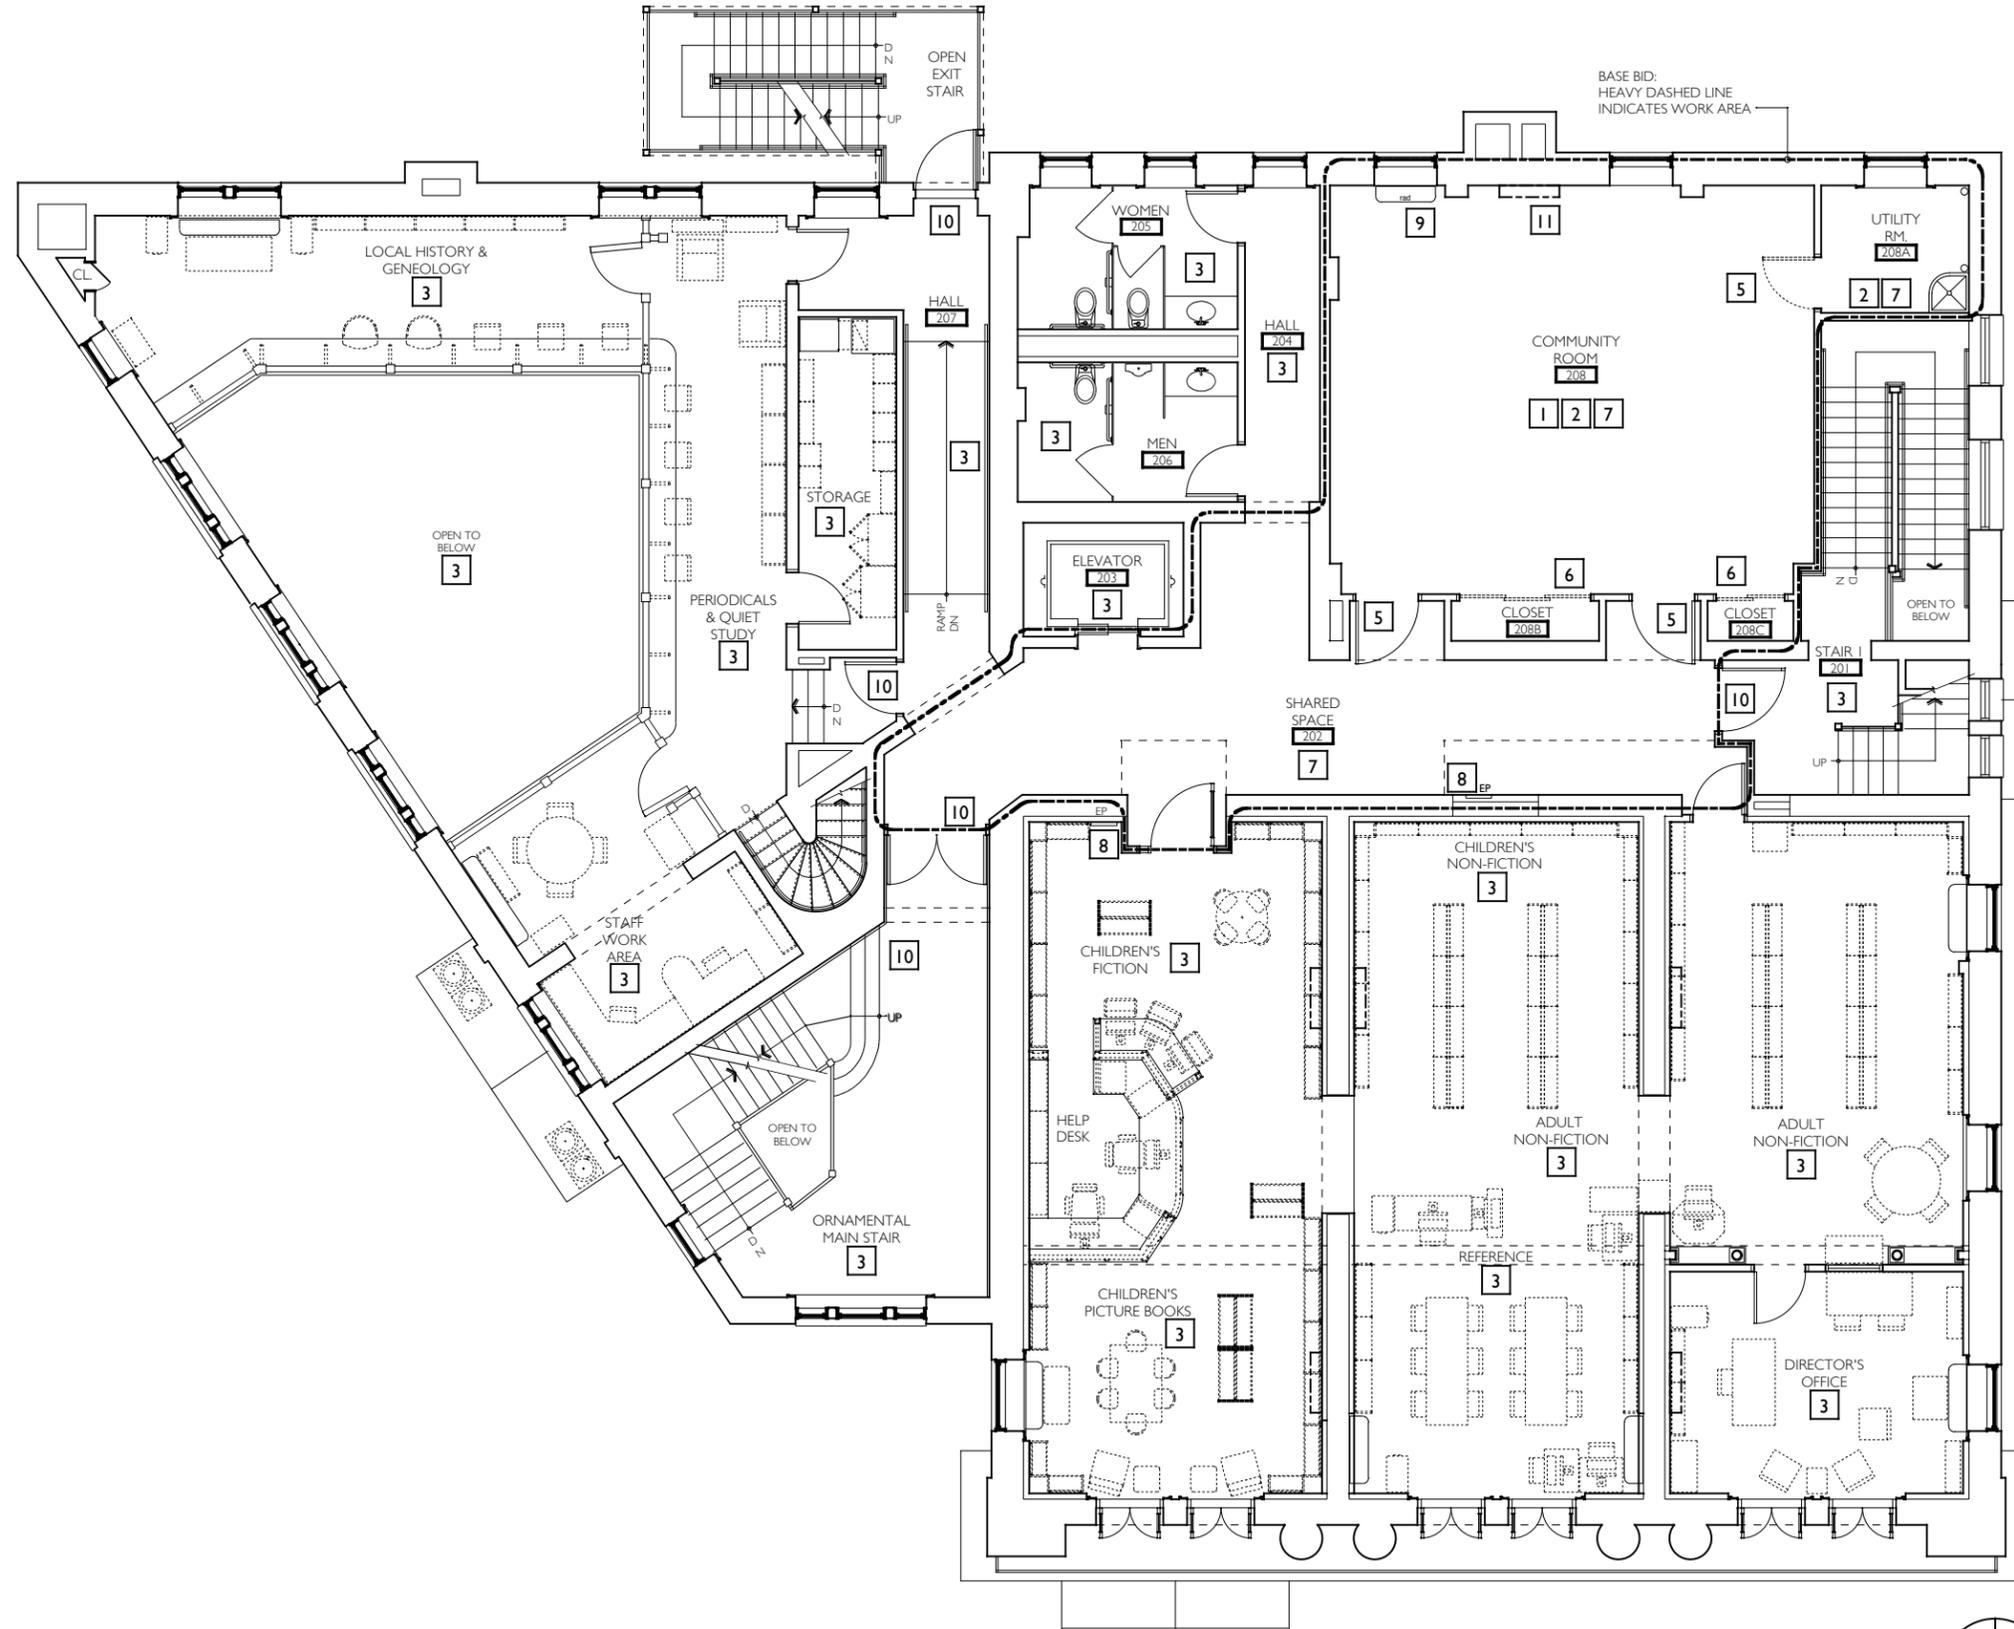

DRAWING SYMBOL LEGEND	
7	SPECIFIC WORK ITEM
	EXISTING WALL OR PARTITION TO REMAIN
	WORK AREA

- GENERAL NOTES - REMOVALS**
- PROTECT ALL EXISTING DOORS, FRAMES, WINDOWS, GLAZING, WOOD TRIM, BASE & TIN CEILING / CORNICES WITHIN SPACES TO REMAIN, UNO.
 - PROTECT ALL ARCHITECTURAL FEATURES THROUGHOUT LIBRARY / BUILDING TO REMAIN.
 - NOTIFY ARCHITECT AND LIBRARY OF ANY AND ALL DISCREPANCIES FOUND ON THE PLANS, IN NOTES OR EXISTING CONDITIONS.
 - REFER TO A100 FOR ENLARGED COMMUNITY ROOM PLAN - NEW WORK.
 - REFER TO A101 FOR ENLARGED REFLECTED CEILING PLAN - NEW WORK.
 - REFER TO A102 FOR FLOOR FINISH PLAN.
 - REFER TO E-DRAWINGS FOR MISCELLANEOUS ELECTRICAL REMOVALS / NEW WORK.
 - MAINTAIN ALL EXISTING MEANS OF EGRESS FREE FROM CONSTRUCTION DEBRIS DURING DURATION OF WORK IN THE CHILDREN'S AREA.
 - CONTRACTOR SHALL PROVIDE REMOVAL OF EXISTING FLOORING IN SCOPE OF WORK AREA AND PREP FOR NEW FLOORING. SEE ALSO A102. OWNER SHALL PROVIDE NEW FLOORING MATERIAL AND ADHESIVES.
 - REFER TO H-DRAWINGS FOR MECHANICAL AND PLUMBING REMOVALS / NEW WORK.
 - REFER TO A002 FOR OVERALL SECOND FLOOR REFLECTED CEILING PLAN EXISTING CONDITIONS, DEMOLITION & REMOVALS.

- SPECIFIC NOTES - REMOVALS**
- | | |
|--|--|
| 1 | ALL EXISTING FURNITURE & SHELVING IN COMMUNITY ROOM TO BE REMOVED BY OWNER PRIOR TO COMMENCEMENT OF NEW WORK. |
| 2 | ALL FINISH FLOORING IN SCOPE OF WORK AREA TO BE REMOVED, INCLUDING BASE AND PREPPED FOR NEW CARPET TILE. SEE A102 FOR COORDINATION WITH FLOORING CONTRACT. |
| 3 | NO WORK IN THIS ROOM / AREA (BASE BID) UNO |
| 4 | NEW BUILT-IN BENCHES, CABINETS AND COUNTERS. SEE A200 & A201 FOR ELEVATIONS AND A300 & A301 FOR DETAILS. |
| 5 | REMOVE EXISTING DOOR & HARDWARE. PROTECT EXISTING FRAME TO REMAIN. |
| 6 | REMOVE EXISTING DOOR / FRAMES / HARDWARE IN THEIR ENTIRETY. SEE A001 FOR NEW CONSTRUCTION. |
| 7 | REPAIR CRACKS & PREP ALL EXISTING WALLS, DOOR & WINDOW SASH AND TRIM, METAL & WOOD TRIM, AND GWB CEILING WITHIN THIS SPACE FOR NEW PAINTING. |
| 8 | EXISTING ELECTRICAL PANEL TO REMAIN |
| 9 | EXISTING CAST IRON RADIATOR & COVER TO REMAIN. |
| 10 | MAINTAIN ENTRY / EXIT STAIR CLEAR AND UNOBSTRUCTED AT ALL TIMES DURING CONSTRUCTION. |
| 11 | REMOVE EXISTING HVAC UNIT. SEE H-DRAWINGS FOR ADDITIONAL NOTES / NEW UNIT |

BID SET: 10 OCTOBER 2022

REVIEW SET: 19 AUGUST 2022

ISSUES and REVISIONS

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FAX: 518 • 885 • 1266
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SECOND FLOOR
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DWN. BY: LMH
SCALE: AS NOTED
JOB NO.: 19.42.17A
DATE: 10.10.2022


OVERALL SECOND FLOOR
PLAN - DEMOLITION &
REMOVALS


TITLE

AR001

DWG. NO.

1 OVERALL SECOND FLOOR PLAN - DEMOLITION & REMOVALS
AR001 SCALE: 3/32" = 1'-0"

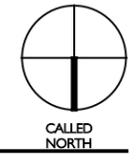

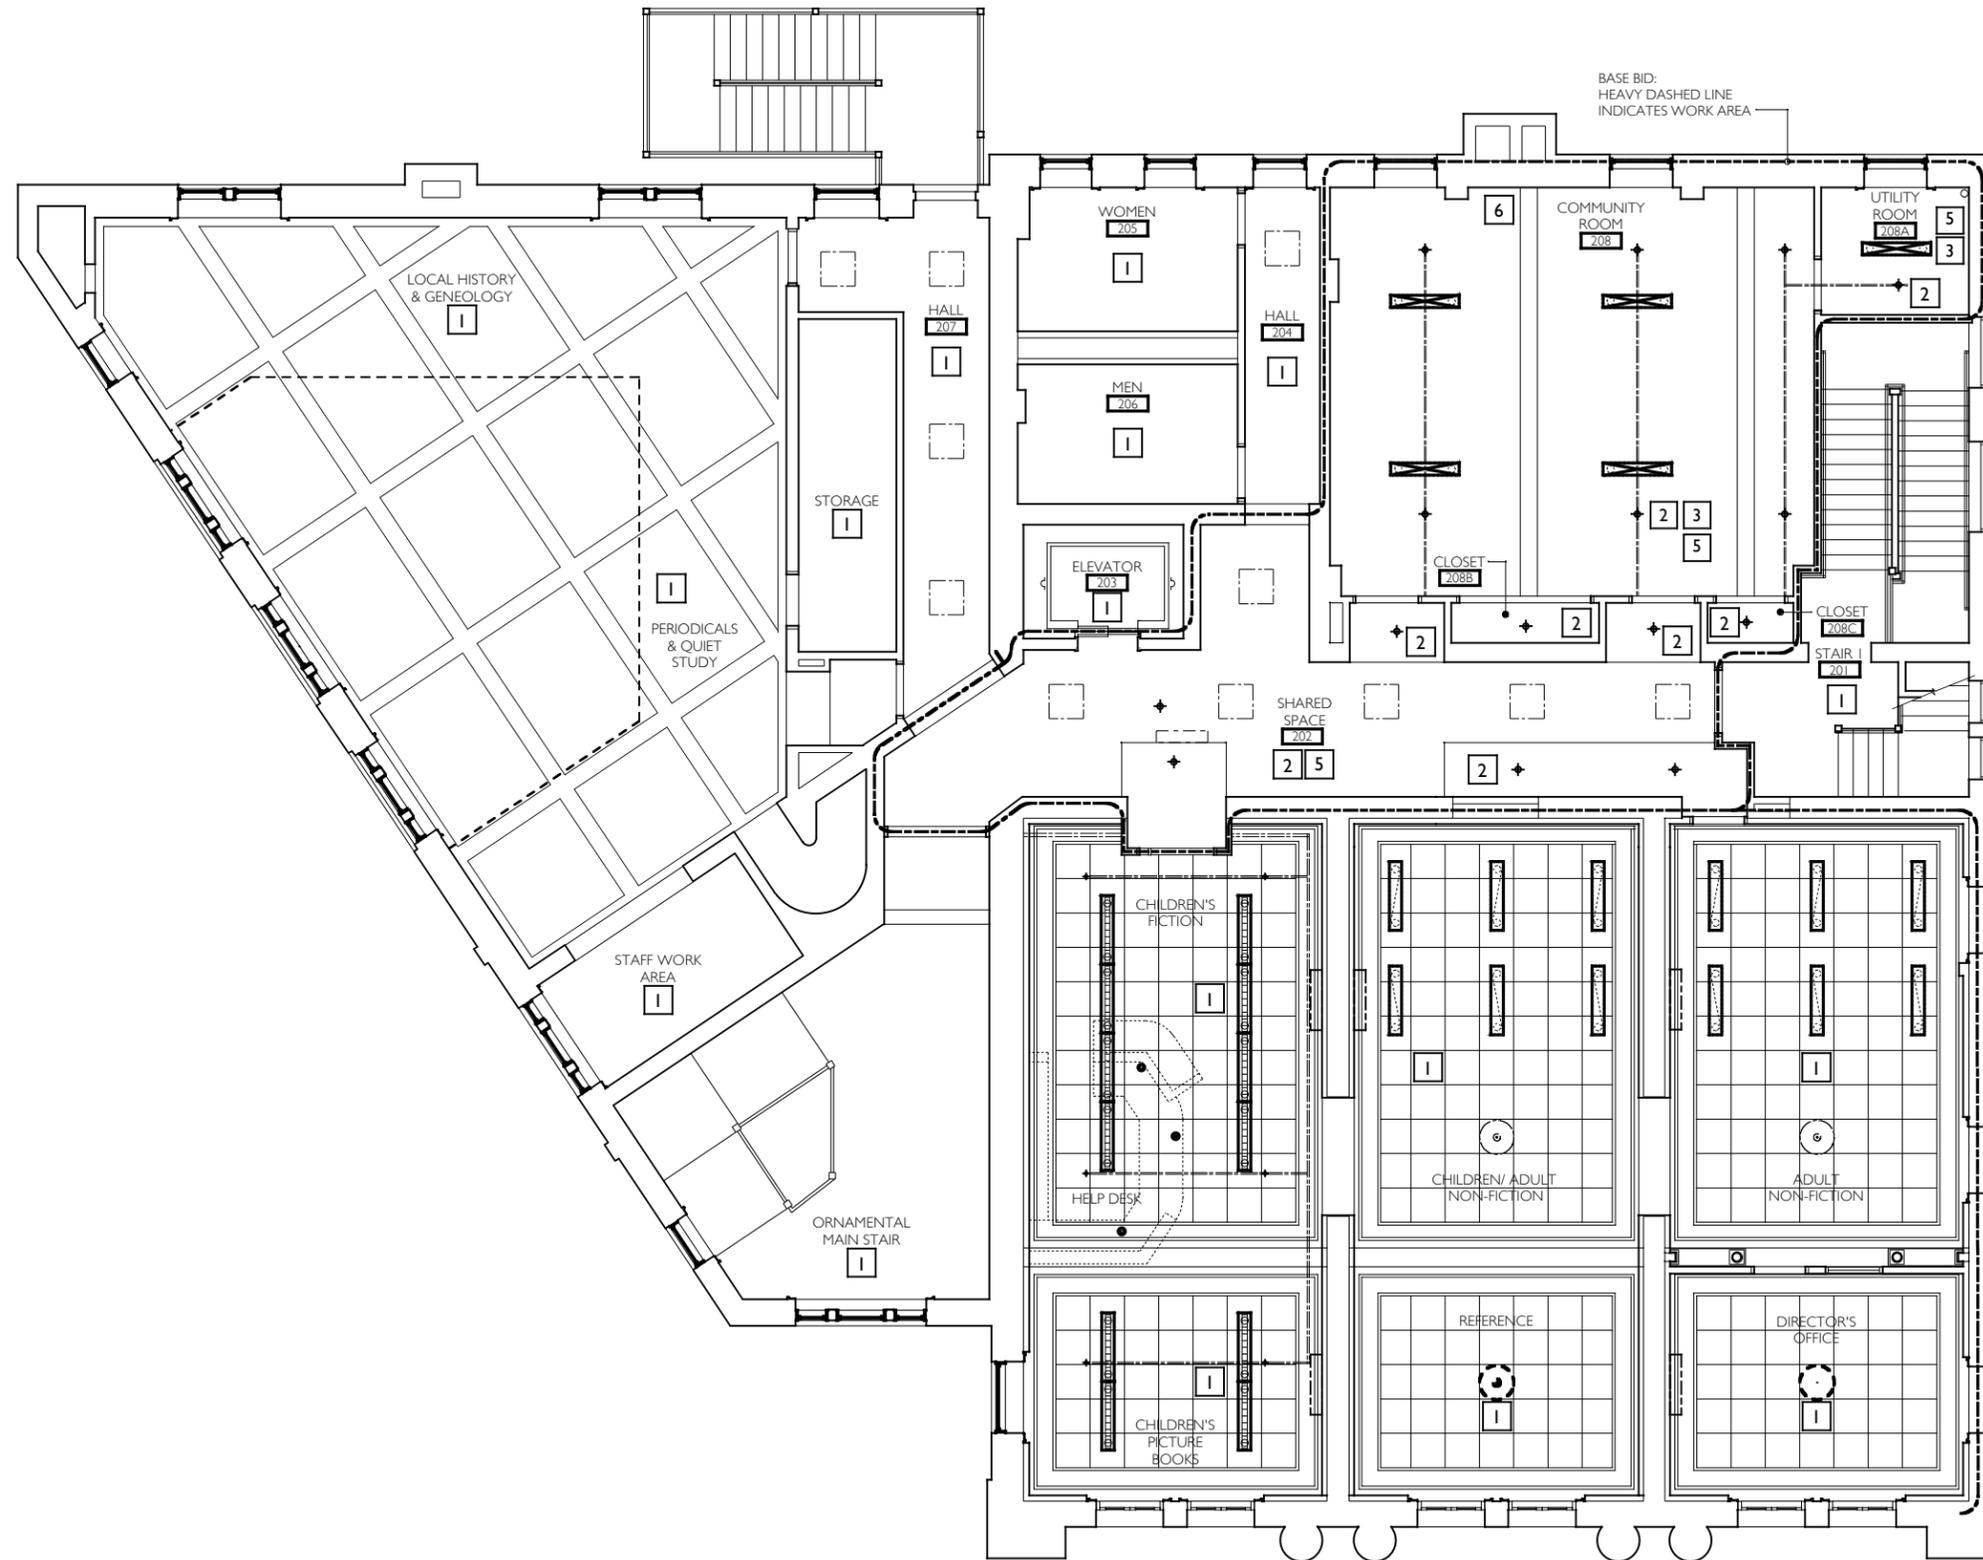

BASE BID:
HEAVY DASHED LINE
INDICATES WORK AREA

DRAWING SYMBOL LEGEND

- 7 SPECIFIC WORK ITEM
- EXISTING WALL OR PARTITION TO REMAIN
- - - - - WORK AREA
- REMOVE EXISTING PENDANT LIGHT FIXTURE. SEE E-DRAWINGS FOR NOTES
- EXISTING EXPOSED SPRINKLER PIPING + HEAD TO REMAIN

GENERAL NOTES - REMOVALS

1. PROTECT ALL EXISTING DOORS, FRAMES, WINDOWS, GLAZING, WOOD TRIM, BASE & TIN CEILING IN SPACES TO REMAIN WITH NEW CONSTRUCTION.
2. PROTECT ALL ARCHITECTURAL FEATURES THROUGHOUT ENTIRE LIBRARY SPACE TO REMAIN.
3. NOTIFY ARCHITECT AND OWNER OF ANY AND ALL DISCREPANCIES FOUND ON THE PLANS, IN NOTES OR EXISTING CONDITIONS.
4. REFER TO A001 FOR OVERALL SECOND FLOOR PLAN LAYOUT (EXISTING CONDITIONS / DEMOLITION & REMOVALS).
5. REFER TO A101 FOR ENLARGED REFLECTED CEILING PLAN OF NEW WORK AREA.
6. REFER TO E-DRAWINGS FOR MISCELLANEOUS ELECTRICAL REMOVALS / NEW WORK.
7. PATCH / REPAIR & REPAINT CEILING IN AREAS WHERE LIGHTING IS TO BE REMOVED. SEE E-DRAWINGS FOR ELECTRICAL COORDINATION FOR EXISTING LIGHTING REMOVALS + NEW LIGHTING FIXTURE TYPES.
8. REFER TO H-DRAWINGS FOR MECHANICAL AND PLUMBING REMOVALS / NEW WORK.

SPECIFIC NOTES - REMOVALS

1	NO WORK IN THIS ROOM / AREA (BASE BID) UNO
2	EXISTING FIRE PROTECTION PIPING AND SPRINKLER HEADS TO REMAIN.
3	PATCH / REPAIR + PAINT EXISTING GYPSUM / PLASTER CEILING / SOFFIT AFTER MECH/ELECTRICAL ROUGH-IN WORK HAS BEEN COMPLETED.
4	REMOVE EXISTING LIGHT FIXTURE & SUPPORT RODS TO EXISTING STRUCTURE ABOVE. COORDINATE WITH NEW PENDANT FIXTURES FOR CIRCUITING. (SEE ALSO E-DRAWINGS)
5	SEE A101 FOR ENLARGED REFLECTED CEILING PLAN IN THIS AREA - ADDITIONAL NOTES
6	REMOVE EXISTING HVAC EQUIPMENT / UNIT. SEE H-DRAWINGS FOR SCOPE OF WORK.

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ARCHITECTS, LLP

57 West High Street
Ballston Spa
New York 12020

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FAX: 518 • 885 • 1266
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**SECOND FLOOR
COMMUNITY ROOM
RENOVATION FOR THE
Josephine-Louise
Public Library**



DWN. BY: LMH
SCALE: AS NOTED
JOB NO.: 19.42.17A
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**OVERALL SECOND FLOOR
REFLECTED CEILING PLAN -
DEMOLITION & REMOVALS**


TITLE

AR002

DWG. NO.

1 OVERALL SECOND FLOOR REFLECTED CEILING PLAN - DEMOLITION & REMOVALS
AR002 SCALE: 3/32" = 1'-0"



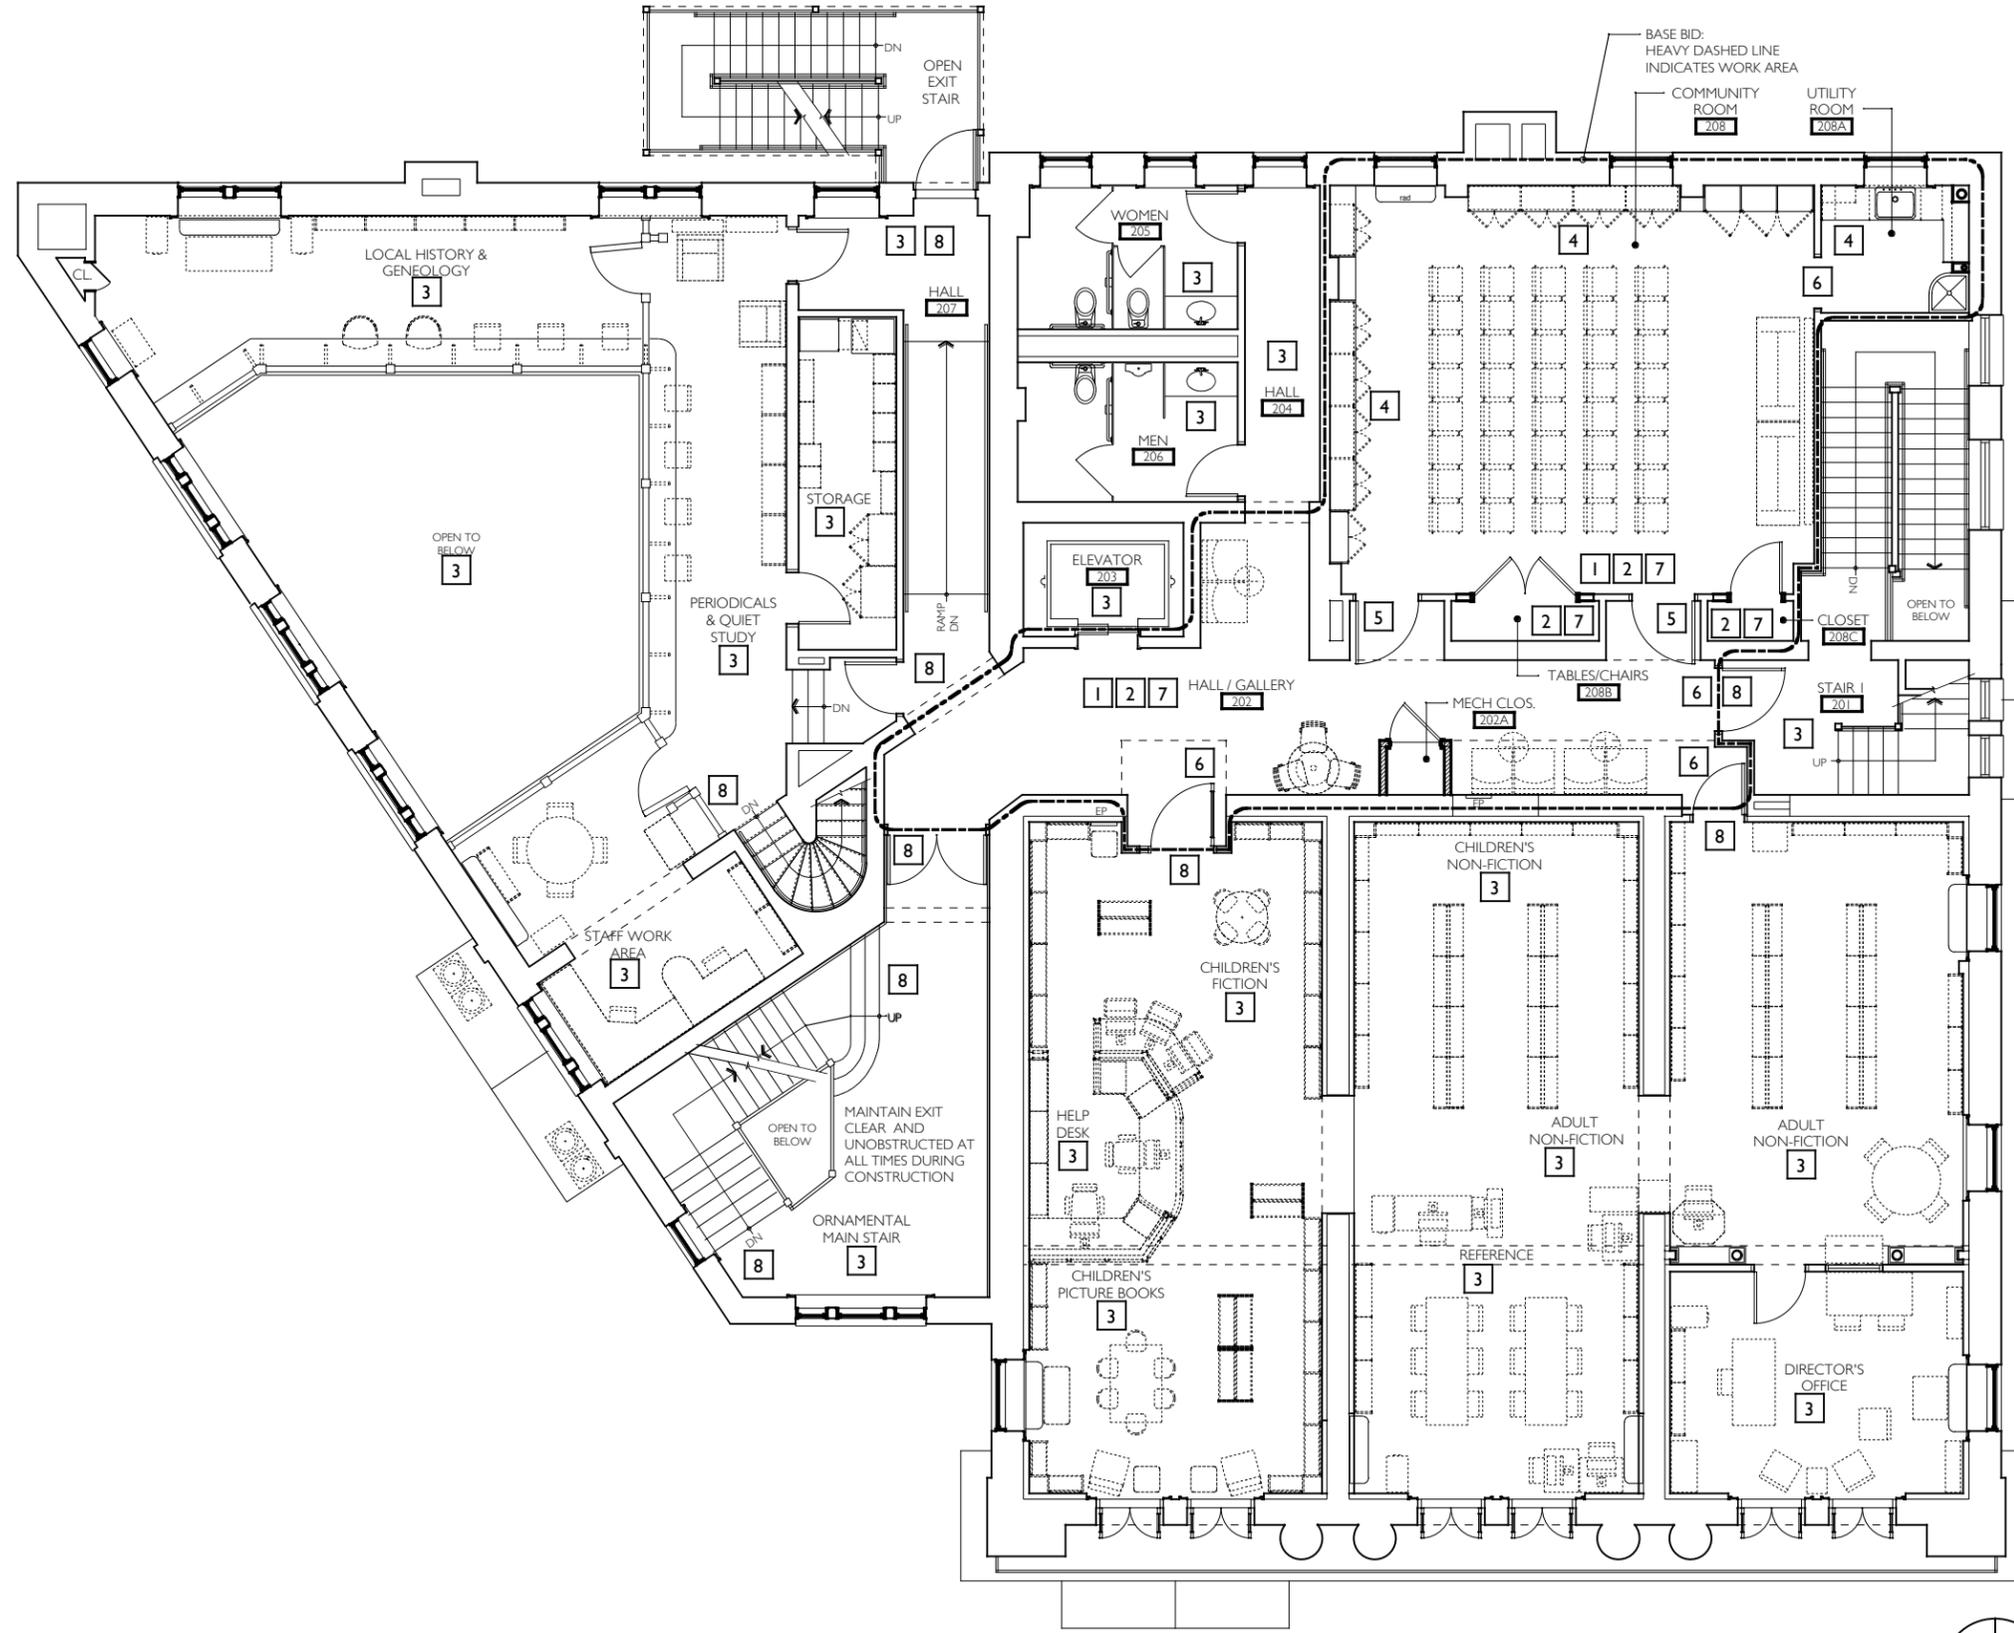

DRAWING SYMBOL LEGEND	
7	SPECIFIC WORK ITEM
---	EXISTING WALL OR PARTITION TO REMAIN
----	EXISTING OVERHEAD CONSTRUCTION
---	WORK AREA

- GENERAL NOTES - NEW WORK**
- PROTECT ALL EXISTING DOORS, FRAMES, WINDOWS, GLAZING, WOOD TRIM, BASE & TIN CEILING WITHIN LIBRARY & COMMON SPACES TO REMAIN.
 - PROTECT ALL OTHER ARCHITECTURAL FEATURES THROUGHOUT LIBRARY & COMMON SPACES TO REMAIN.
 - NOTIFY ARCHITECT AND OWNER OF ANY AND ALL DISCREPANCIES FOUND ON THE PLANS, IN NOTES OR EXISTING CONDITIONS.
 - REFER TO A100 FOR ENLARGED PLAN - NEW WORK.
 - REFER TO A101 FOR REFLECTED CEILING PLAN - NEW WORK.
 - REFER TO A102 FOR FINISH FLOOR PLAN.
 - REFER TO E-DWGS FOR MISCELLANEOUS ELECTRICAL WORK. SEE M-DWGS FOR MISCELLANEOUS HVAC & SPRINKLER WORK.
 - REFER TO A001 & A002 FOR OVERALL SECOND FLOOR PLAN & REFLECTED CEILING PLAN - DEMOLITION & REMOVALS DRAWINGS.
 - REFER TO A001 & A002 FOR OVERALL SECOND FLOOR PLAN & REFLECTED CEILING PLAN - NEW WORK.
 - REFER TO A300 & A301 FOR CABINETRY DETAILS
 - REFER TO A400 FOR FINISH & DOOR SCHEDULES & DOOR TYPES / DETAILS

- SPECIFIC NOTES - NEW WORK**
- ALL NEW FURNITURE IN SPACE TO BE PROVIDED AND INSTALLED BY SEPARATE CONTRACT. COORDINATE WITH OWNER FOR SCHEDULE. SEE F100 FOR REFERENCE.
 - ALL NEW FINISH FLOORING IN SPACE TO BE PROVIDED AND INSTALLED BY SEPARATE CONTRACT. COORDINATE WITH OWNER FOR SCHEDULE. SEE A102 FOR REFERENCE.
 - NO WORK IN THIS AREA / ROOM
 - NEW BUILT-IN BENCHES, CABINETS AND COUNTERS. SEE A200 & A201 FOR ELEVATIONS AND A300 & A301 FOR DETAILS.
 - PAINT EXISTING DOOR & FRAME (BOTH SIDES). PROTECT EXISTING HARDWARE TO REMAIN.
 - PAINT EXISTING DOOR FRAME TO REMAIN - HALLWAY SIDE ONLY. PROTECT EXISTING HARDWARE TO REMAIN.
 - PRIOR TO FLOORING WORK, PREP AND PAINT ALL EXISTING WALLS, DOOR & WINDOW SASH AND TRIM, METAL & WOOD TRIM, AND GWS CEILING WITHIN THIS SPACE.
 - MAINTAIN ALL FIRE EXITS CLEAR AND UNOBSTRUCTED AT ALL TIMES DURING CONSTRUCTION.

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OVERALL SECOND FLOOR
PLAN - NEW WORK


TITLE

A001

DWG. NO.

1 OVERALL SECOND FLOOR PLAN - NEW WORK
SCALE: 3/32" = 1'-0"



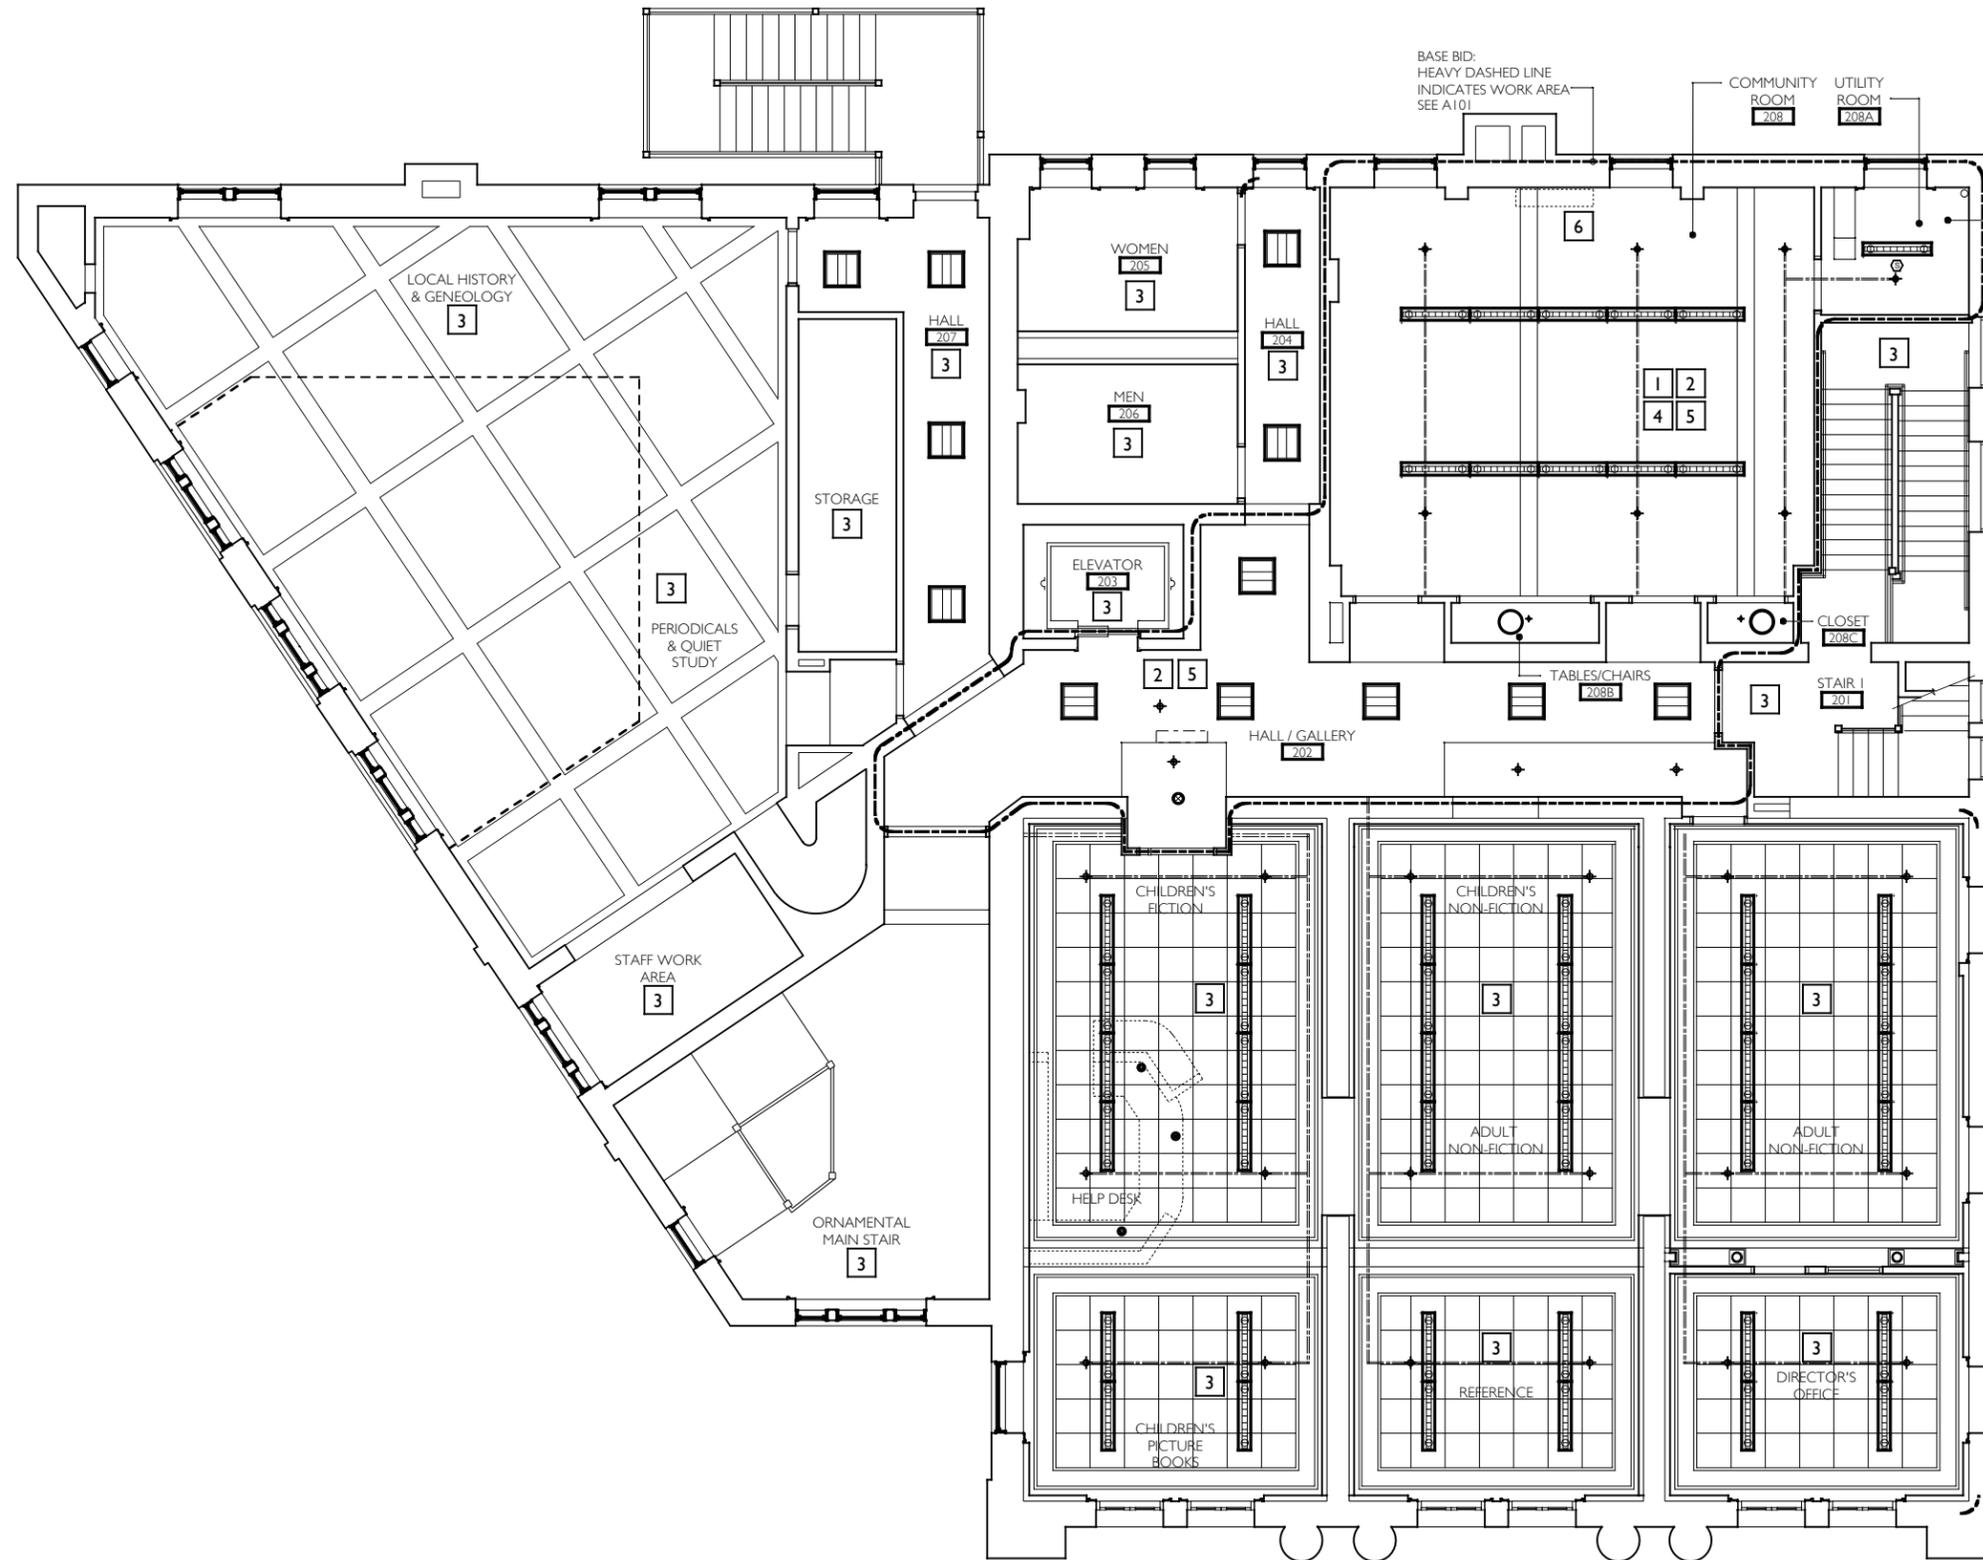

DRAWING SYMBOL LEGEND	
7	SPECIFIC WORK ITEM
---	EXISTING WALL OR PARTITION TO REMAIN
- - - -	WORK AREA
⊖	NEW PENDANT MOUNTED DIRECT / INDIRECT LIGHT FIXTURE. SEE E-DRAWINGS
○	NEW SURFACE MOUNTED LIGHT FIXTURE. SEE E-DRAWINGS
⊕	NEW 24" x 24" SURFACE MOUNTED INDIRECT LIGHT FIXTURE - FOR TYPE, SEE E-DRAWINGS
⊕	EXISTING EXPOSED SPRINKLER PIPING + HEAD TO REMAIN
⊖	NEW HVAC EQUIPMENT / UNIT. SEE H-DRAWINGS FOR SIZES
⊖	NEW EXPOSED DUCTWORK. SEE H-DRAWINGS FOR SIZES
⊖	AREA OF DUCT PENETRATION THROUGH EXISTING WALLS

- GENERAL NOTES - NEW WORK**
1. PROTECT ALL EXISTING DOORS, FRAMES, WINDOWS, GLAZING, WOOD TRIM, BASE & TIN CEILING WITHIN LIBRARY & COMMON SPACES TO REMAIN.
 2. PROTECT ALL OTHER ARCHITECTURAL FEATURES THROUGHOUT LIBRARY & COMMON SPACES TO REMAIN.
 3. NOTIFY ARCHITECT AND OWNER OF ANY AND ALL DISCREPANCIES FOUND ON THE PLANS, IN NOTES OR EXISTING CONDITIONS.
 4. REFER TO A100 FOR ENLARGED CHILDREN'S ROOM PLAN - NEW WORK.
 5. REFER TO A101 FOR REFLECTED CEILING PLAN - NEW WORK.
 6. REFER TO A102 FOR FINISH FLOOR PLAN.
 7. REFER TO E-DRAWINGS FOR MISCELLANEOUS ELECTRICAL WORK. SEE H-DRAWINGS FOR MISCELLANEOUS MECHANICAL & PLUMBING WORK.
 8. PATCH / REPAIR & REPAINT CEILING IN AREAS WHERE LIGHTING IS TO BE REMOVED. SEE E-DRAWINGS FOR ELECTRICAL COORDINATION FOR EXISTING LIGHTING REMOVALS + NEW LIGHTING FIXTURE TYPES.
 9. REFER TO A001 & A002 FOR OVERALL SECOND FLOOR PLAN & REFLECTED CEILING PLAN - DEMOLITION & REMOVALS DRAWINGS.
 10. REFER TO A001 & A002 FOR OVERALL SECOND FLOOR PLAN & REFLECTED CEILING PLAN - NEW WORK.
 11. REFER TO A300 & A301 FOR CABINETRY DETAILS
 12. REFER TO A400 FOR FINISH & DOOR SCHEDULES & DOOR TYPES / DETAILS

- SPECIFIC NOTES - NEW WORK**
1. SEE E-DWGS FOR LIGHTING TYPES AND NOTES
 2. EXISTING SPRINKLER PIPING AND HEADS TO REMAIN.
 3. NO WORK IN THIS ROOM / AREA (BASE BID) UNO
 4. PATCH / REPAIR + PAINT EXISTING GYPSUM / PLASTER CEILING AND/OR SOFFITS AFTER ELECTRICAL ROUGH-IN WORK HAS BEEN COMPLETED.
 5. SEE A101 FOR ENLARGED REFLECTED CEILING PLAN IN THIS AREA - ADDITIONAL NOTES
 6. NEW HVAC UNIT. SEE H-DRAWINGS FOR DETAILS, TYPE AND NOTES

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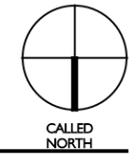
OVERALL SECOND FLOOR
REFLECTED CEILING PLAN -
NEW WORK

TITLE

A002

DWG. NO.

1 OVERALL SECOND FLOOR REFLECTED CEILING PLAN - NEW WORK
A002 SCALE: 3/32" = 1'-0"




FLOOR PLAN LEGEND

- 3 A200 ENLARGED ELEVATION NUMBER SHEET LOCATION
- 4 A200 2 ENLARGED ELEVATION NUMBER SHEET LOCATION
- 3 OFFICE ROOM NAME ROOM NUMBER 203
- EXISTING CONSTRUCTION
- OVERHEAD CONSTRUCTION
- NEW STUD PARTITION
- 03 NEW DOOR NUMBER (SEE SHEET A400)

GENERAL NOTES

- 1) SEE AR001 & AR002 FOR OVERALL PLANS - DEMOLITION & REMOVALS PLANS
- 2) SEE A001 & A002 FOR OVERALL PLANS - NEW WORK
- 3) SEE A101 FOR REFLECTED CEILING PLAN, DETAILS & NOTES.
- 4) SEE A102 FOR NEW FINISH FLOOR PLAN, DETAILS & NOTES.
- 5) SEE A200 & A201 FOR ELEVATIONS
- 6) SEE A400 FOR FINISH AND DOOR SCHEDULES
- 7) SEE A300 & A301 FOR CABINETRY & DETAILS.
- 8) SEE E-DRAWINGS FOR ALL ELECTRICAL WORK.
- 9) SEE H-DRAWINGS FOR ALL MECHANICAL & PLUMBING WORK.
- 10) ALL EXISTING DOORS AND WINDOWS TO REMAIN UNLESS NOTED OTHERWISE.

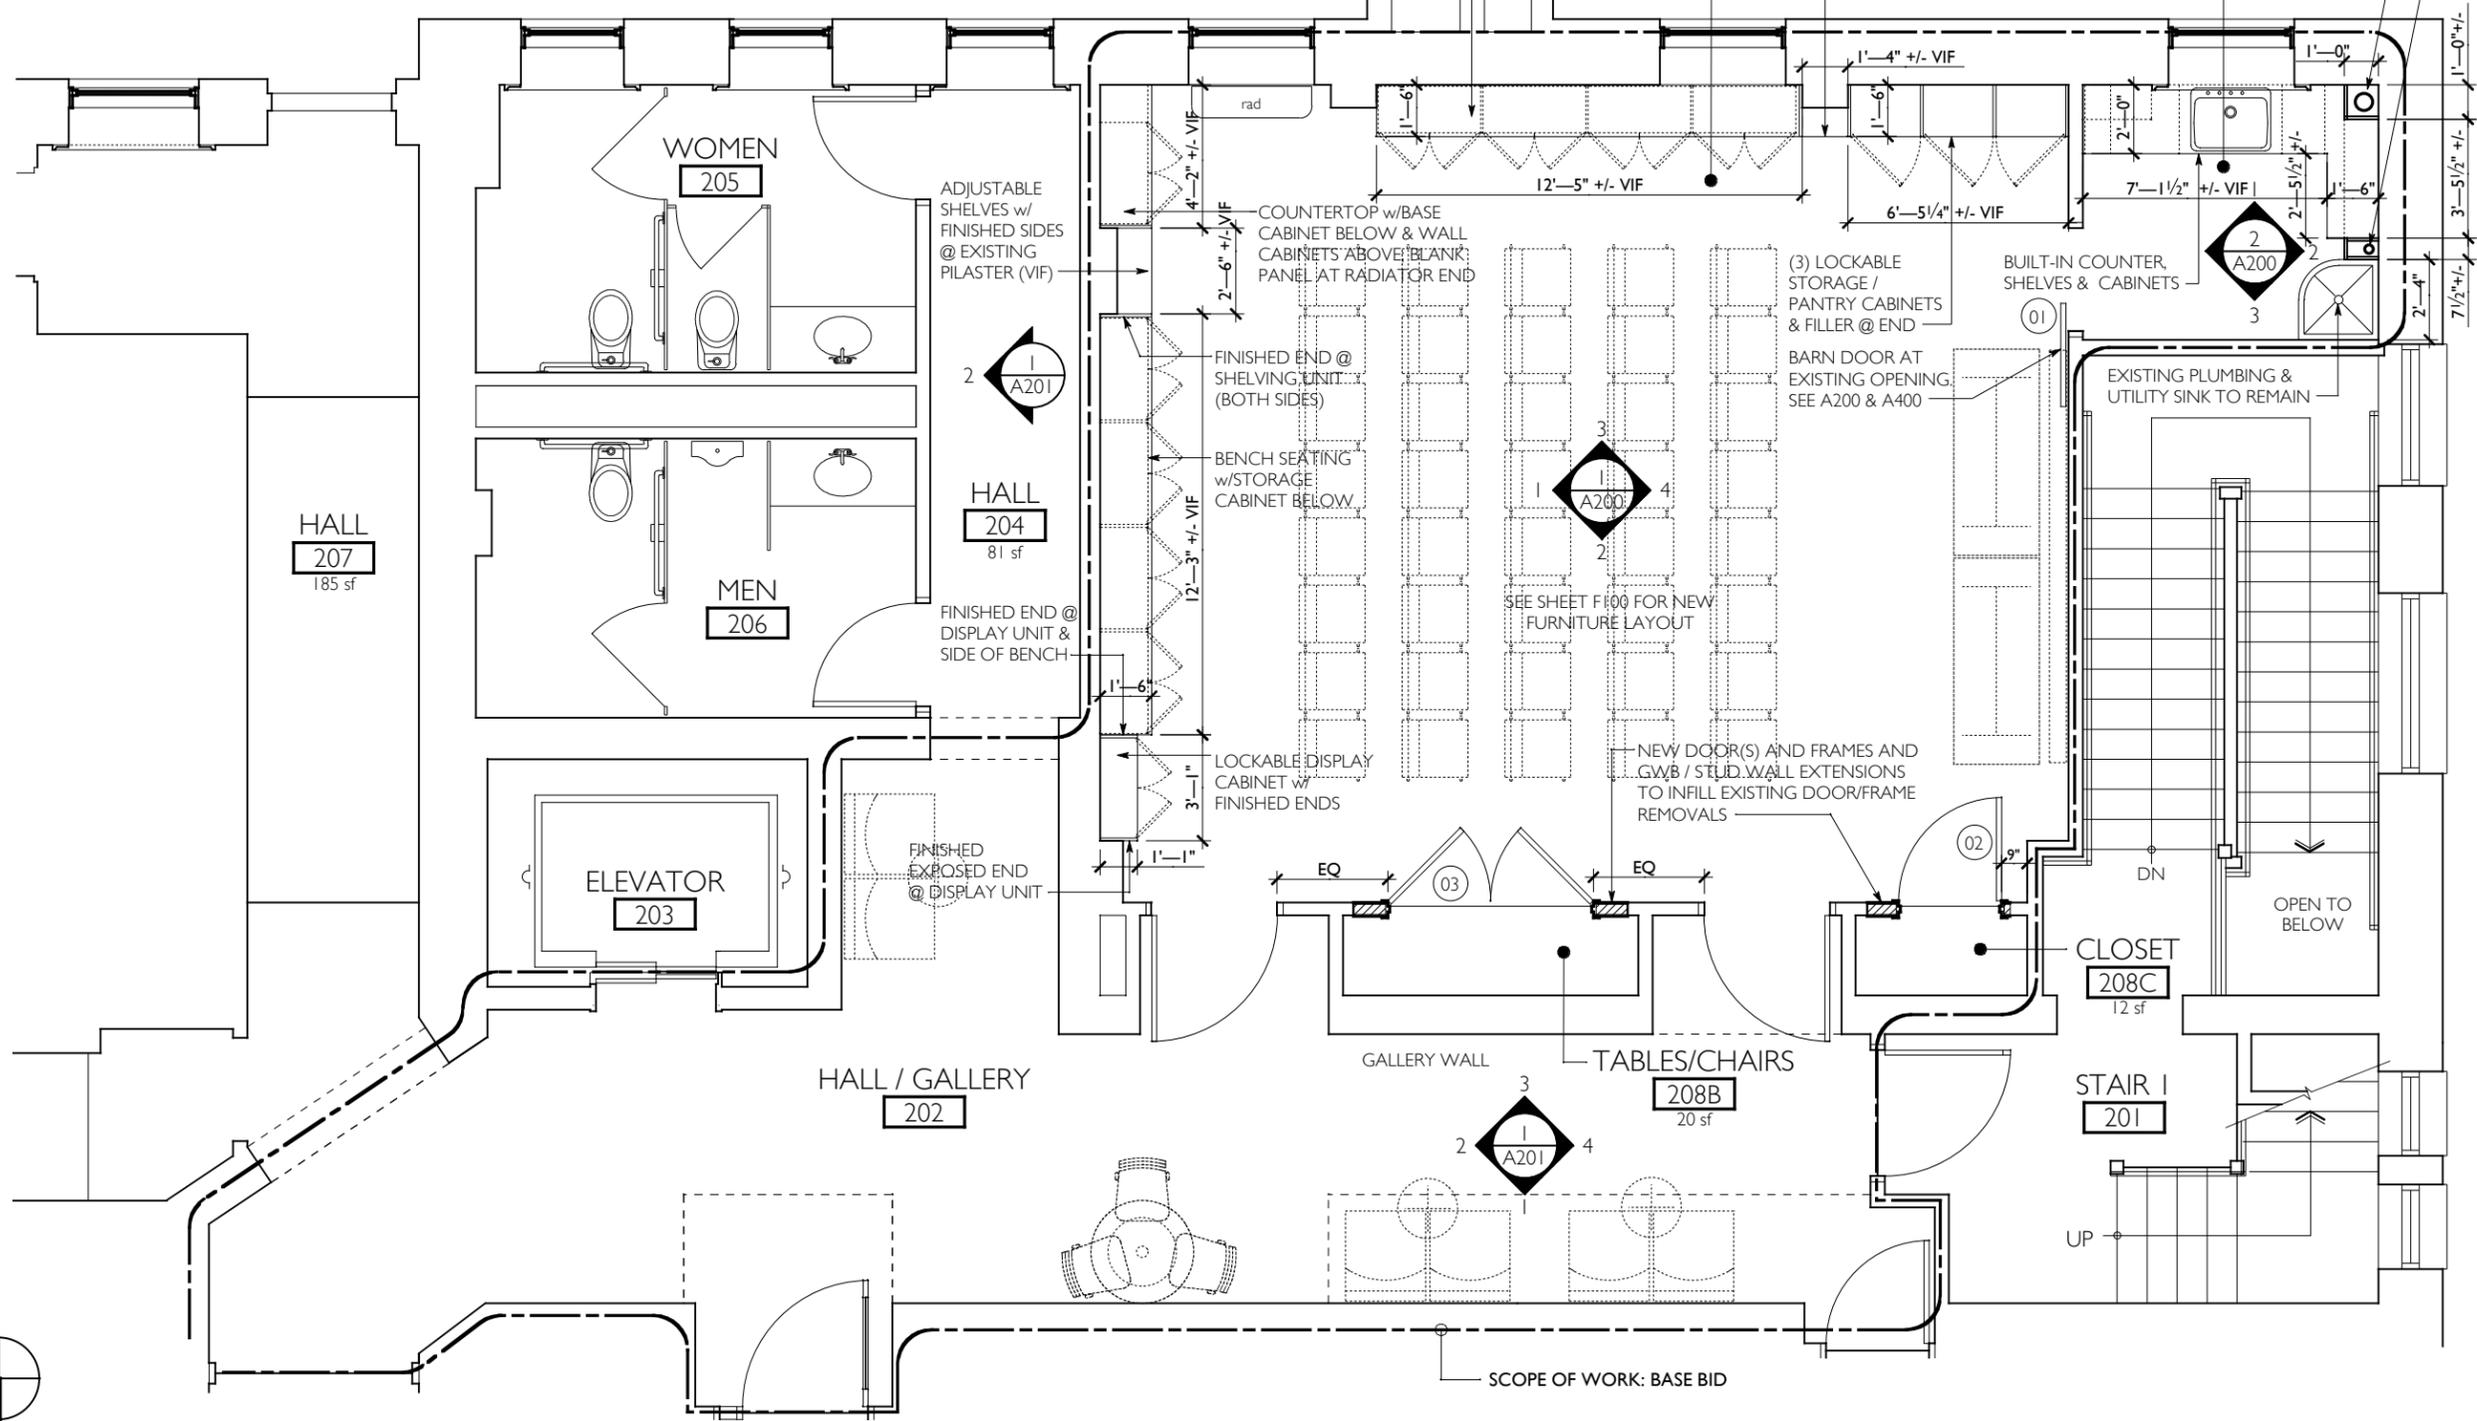

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 ISSUES and REVISIONS



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ENLARGED PARTIAL
 SECOND FLOOR PLAN -
 NEW WORK

TITLE

A100

DWG. NO.




1 ENLARGED PARTIAL SECOND FLOOR PLAN - NEW WORK
 A100 SCALE: 3/16" = 1'-0"

DRAWING SYMBOL LEGEND	
	SPECIFIC WORK NOTE
	EXISTING WALL / PARTITION TO REMAIN
	NEW LINEAR PENDANT MOUNTED DIRECT/INDIRECT LIGHT FIXTURE. SEE E-DRAWINGS FOR TYPE
	NEW SURFACE MOUNTED LIGHT FIXTURE. SEE E-DRAWINGS FOR TYPE
	EXISTING EXPOSED SPRINKLER LINE & HEAD TO REMAIN
	EXISTING EXIT SIGNS - SEE E-DWGS
	SMOKE DETECTOR - SEE E-DWGS

GENERAL NOTES	
1.	NOTIFY ARCHITECT AND OWNER OF ANY AND ALL DISCREPANCIES FOUND ON THE PLANS, IN NOTES OR EXISTING CONDITIONS.
2.	SEE H-DRAWINGS FOR NEW HVAC UNITS, DUCTWORK, PIPING, GRILLES, LOUVERS, ETC.
3.	EXISTING SPRINKLER PIPING, HEADS & ACCESSORIES TO REMAIN. PAINT AFTER CEILING WORK IS COMPLETE.
4.	SEE E-DRAWINGS FOR LIGHT FIXTURE TYPES. LOCATE AS PER REFLECTED CEILING PLAN

SPECIFIC NOTES			
1	NO CEILING WORK IN THIS ROOM / AREA (BASE BID)	6	EXISTING DUCTWORK TO UPPER FLOOR TO REMAIN
2	EXISTING FIRE PROTECTION PIPING AND SPRINKLER HEADS TO REMAIN. PAINT EXPOSED PIPING - PROTECT HEADS.	7	NEW HVAC WALL MOUNTED UNIT - SEE H-DRAWINGS
3	EXISTING PLASTER BEAM TO REMAIN (PAINT SAME COLOR AS CEILING)		
4	EXISTING FIRE ALARM DEVICE TO REMAIN. PROTECT DURING CONSTRUCTION		
5	PAINT EXISTING PLASTER / GYPSUM BOARD CEILING / SOFFIT AND/OR WINDOW, DOOR, FRAME TRIM TO REMAIN		

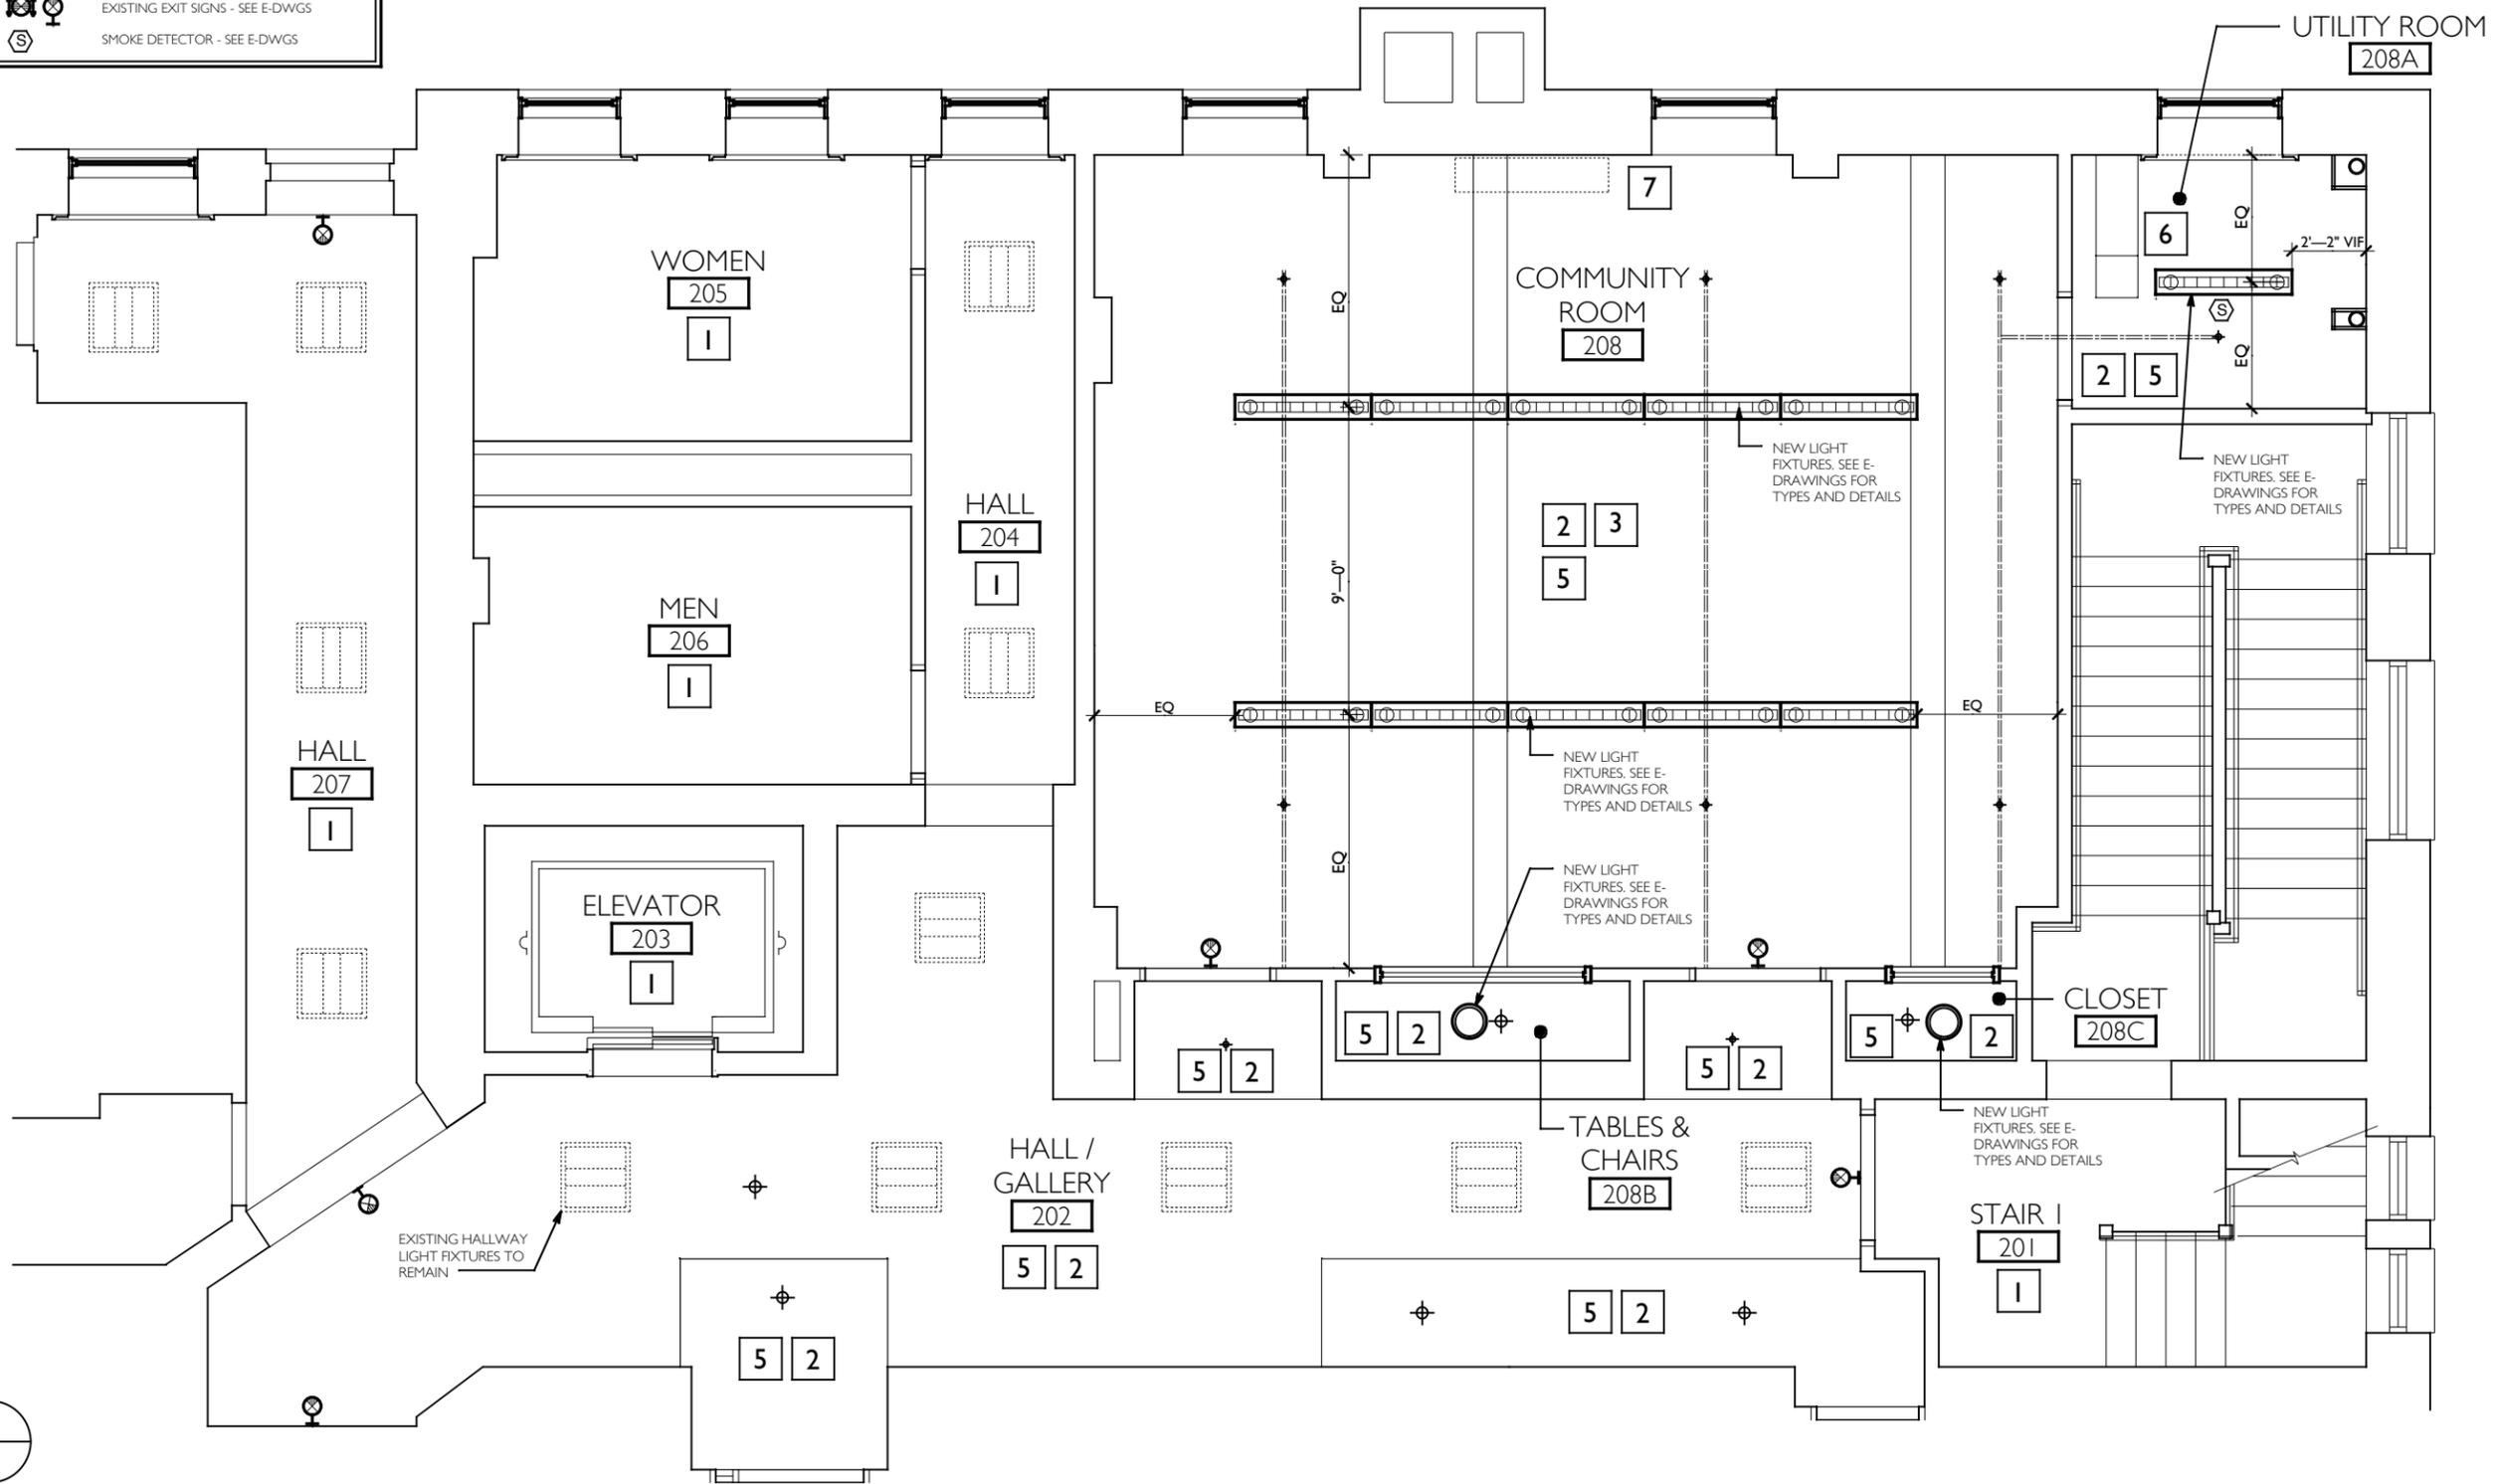

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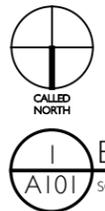
SECOND FLOOR
 COMMUNITY ROOM
 RENOVATIONS FOR THE
**Josephine-Louise
 Public Library**



DWN. BY: LMH
 SCALE: AS NOTED
 JOB NO.: 19.42.17A
 DATE: 10.10.2022

ENLARGED PARTIAL
 SECOND FLOOR REFLECTED
 CEILING PLAN - NEW WORK


TITLE
A101
 DWG. NO.



A101 ENLARGED PARTIAL SECOND FLOOR REFLECTED CEILING PLAN - NEW WORK
 SCALE: 3/16" = 1'-0"

DRAWING SYMBOL LEGEND	
	CARPET TILE: SQUARE LINEAR PATTERN (INTERFACE MAIN LINE 104249 BATTLESHIP/ LINE)
	LVT 1: LUXURY VINYL TILE PLANK, ASHLAR PATTERN (INTERFACE NATURAL WOODGRAINS A00212 CEDAR)
	RESILIENT REDUCER STRIP

- | FINISH FLOOR NOTES | |
|--------------------|---|
| 1) | NOTIFY ARCHITECT IN WRITING OF ANY AND ALL DISCREPANCIES IN EXISTING CONDITIONS PRIOR TO COMMENCEMENT OF WORK. |
| 2) | FLOORING CONTRACTOR SHALL PROVIDE FLOORING MATERIALS: CARPET TILE AND LUXURY VINYL TILE & THEIR ADHESIVES VIA NYS CONTRACT. GC SHALL INSTALL FLOORING IN THIS CONTRACT. |
| 3) | LOCATE ALL RESILIENT STRIPS UNDER DOORS, UNLESS NOTED OTHERWISE. COLOR FROM MANUFACTURERS STANDARDS TO COMPLIMENT ADJACENT WORK |
| 4) | GC PROVIDE AND INSTALL ALL BASE MATERIALS. |

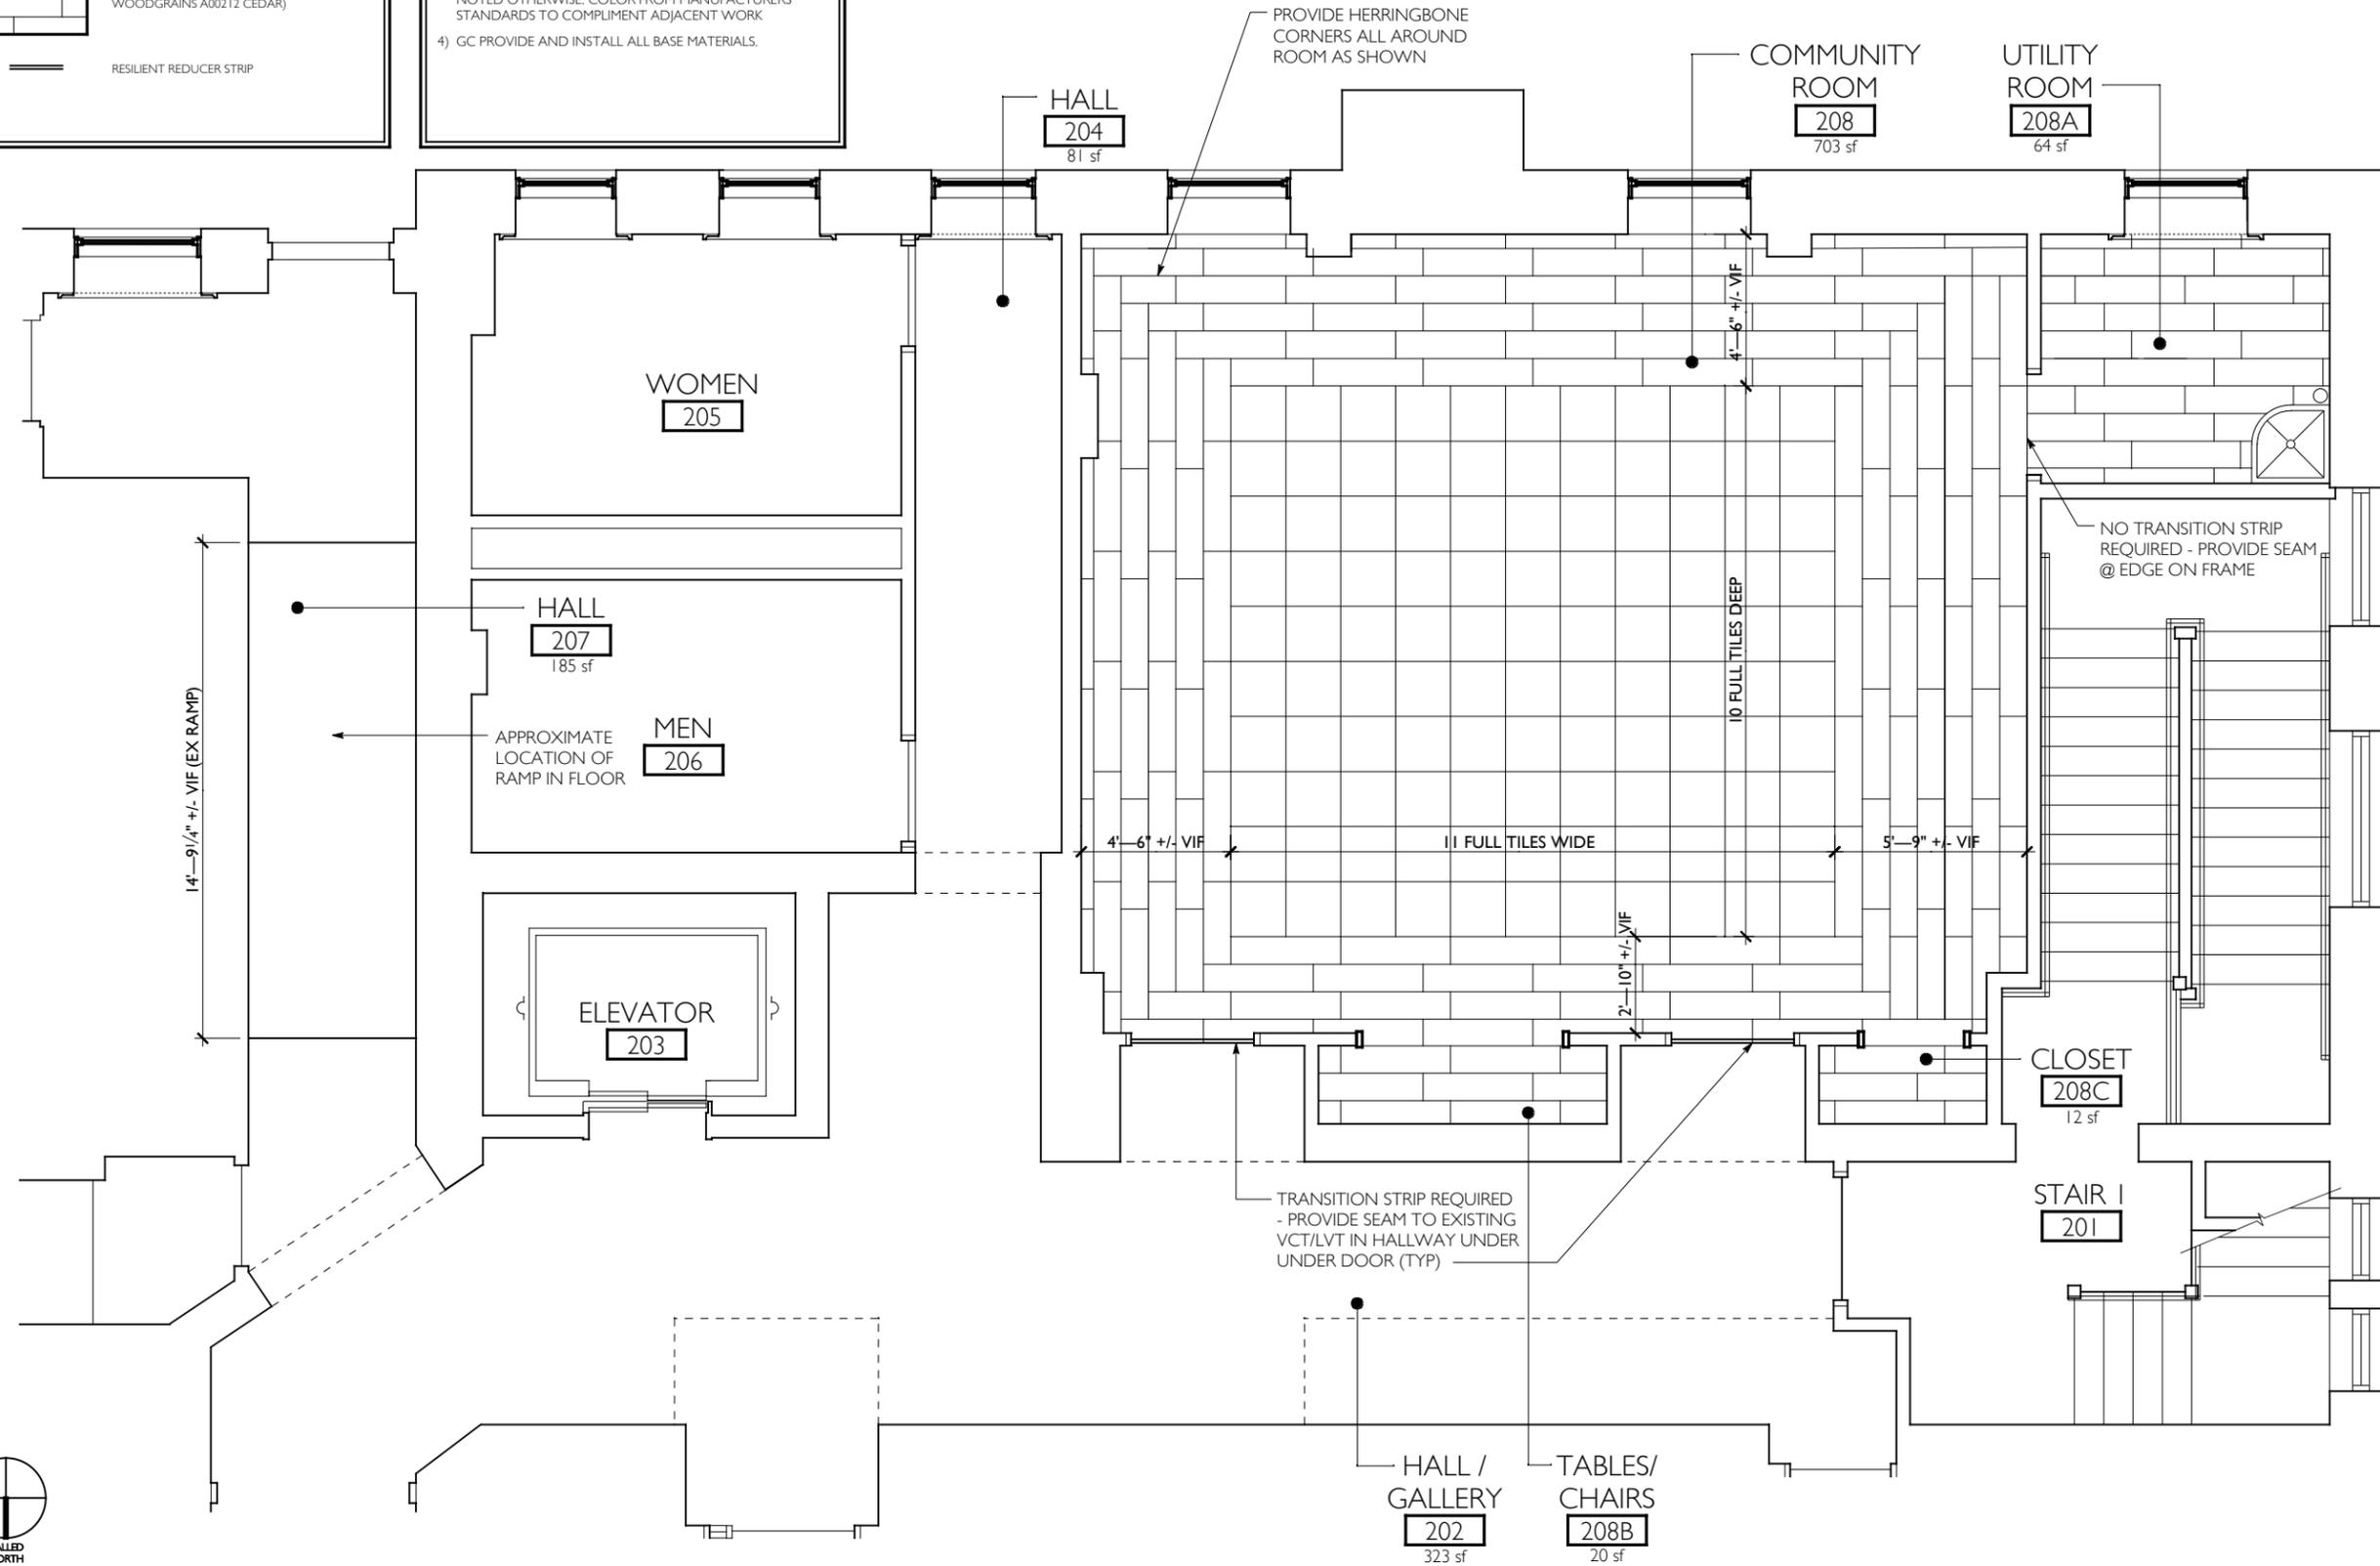

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 REVIEW SET: 19 AUGUST 2022
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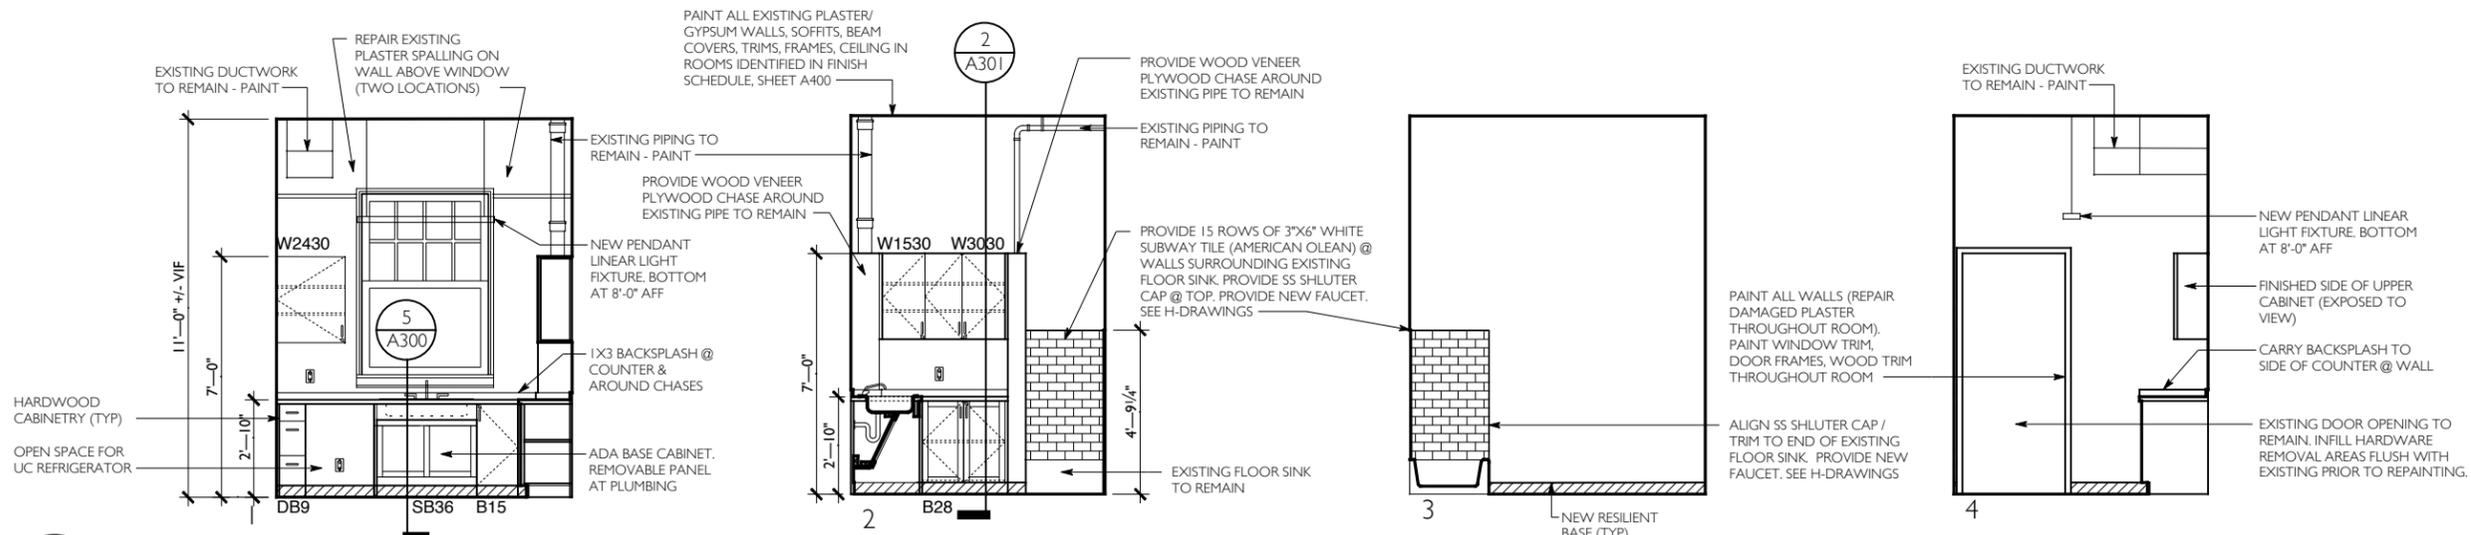


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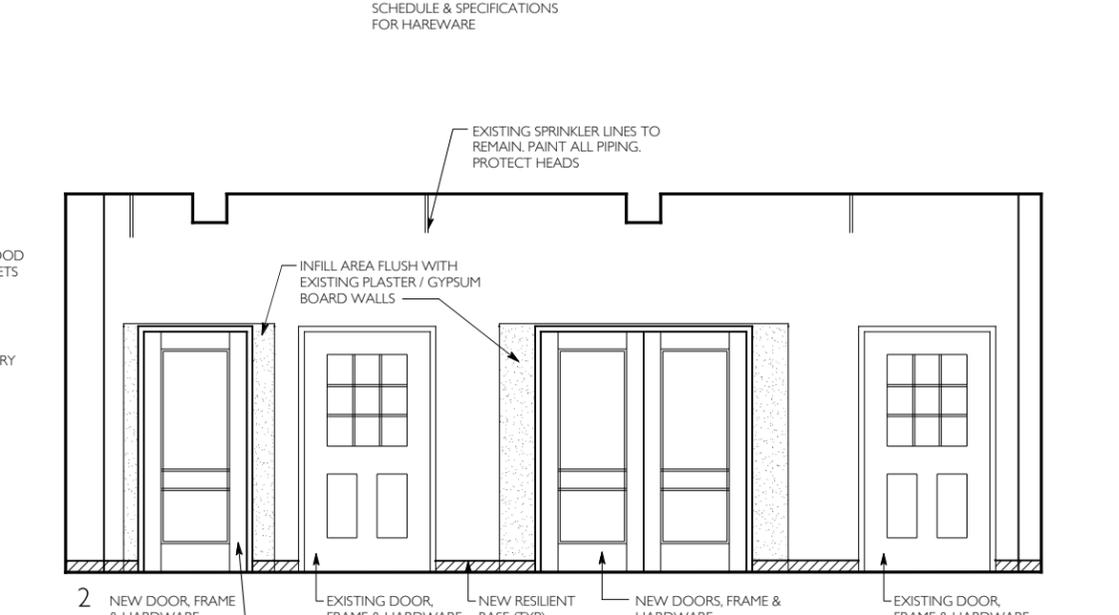
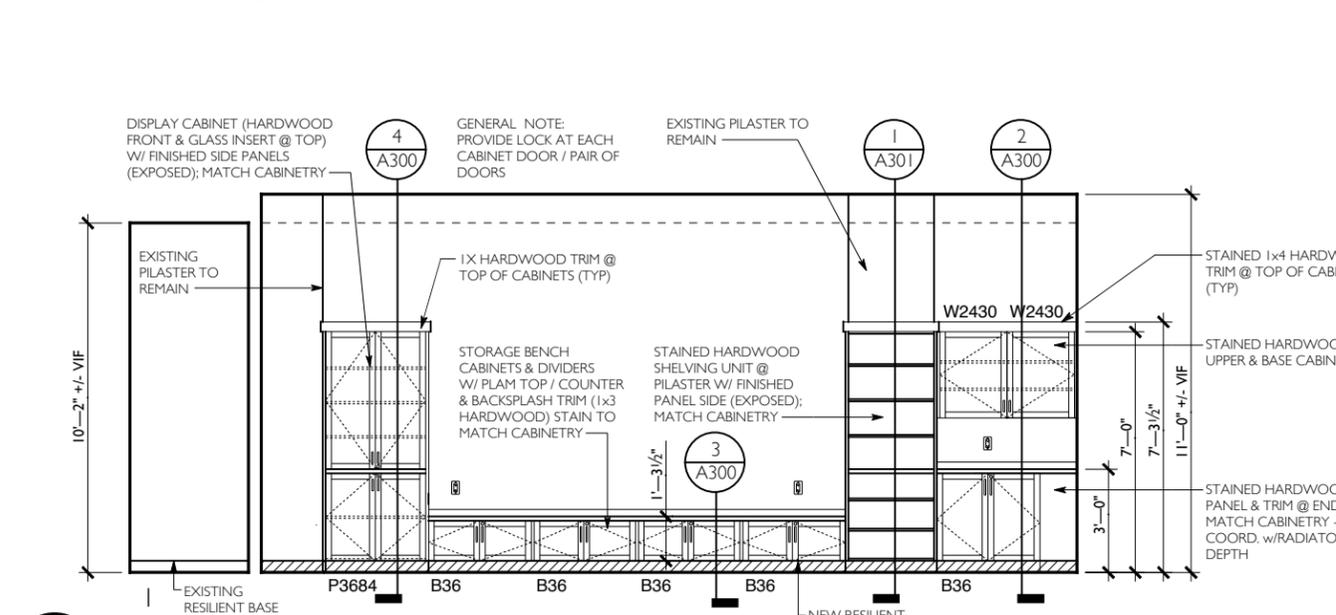
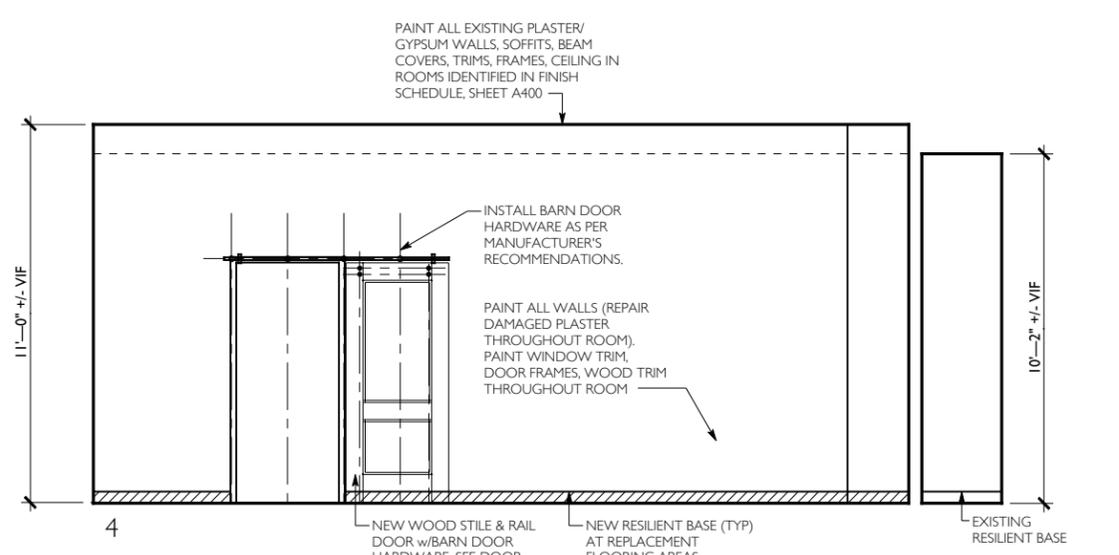
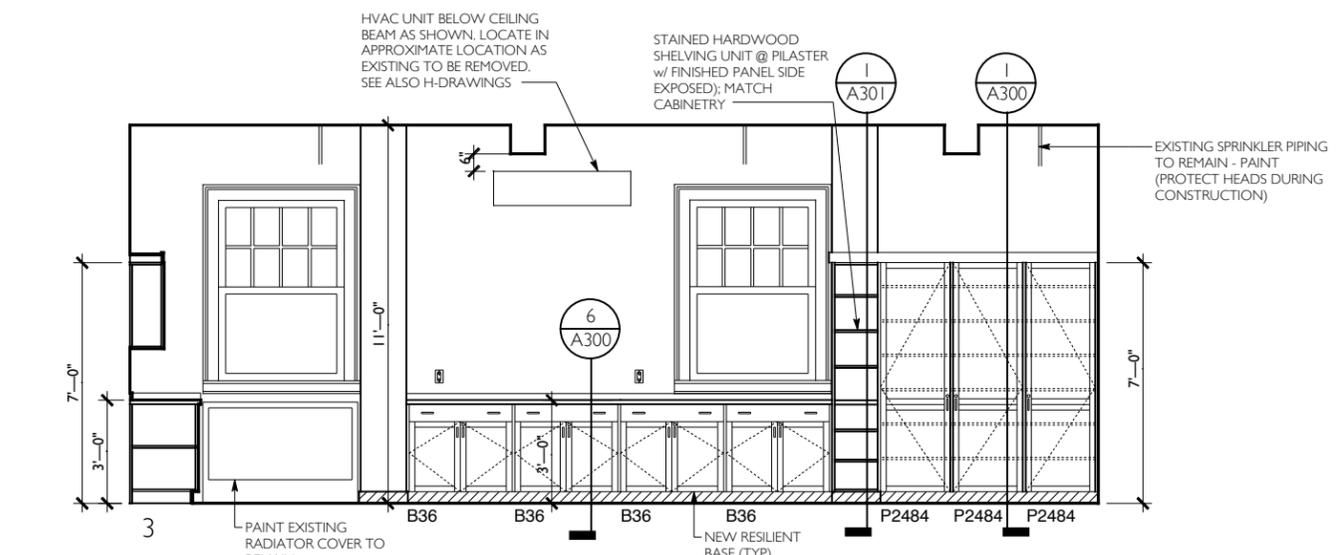
ENLARGED PARTIAL
SECOND FLOOR
FINISH PLAN - NEW WORK

TITLE
A102
 DWG. NO.






2 UTILITY ROOM ELEVATIONS
A200 SCALE: 3/16" = 1'-0"



1 COMMUNITY ROOM ELEVATION
A200 SCALE: 3/16" = 1'-0"
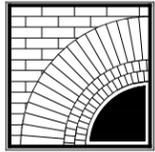
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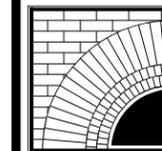
ELEVATIONS
 TITLE
A200
 DWG. NO.

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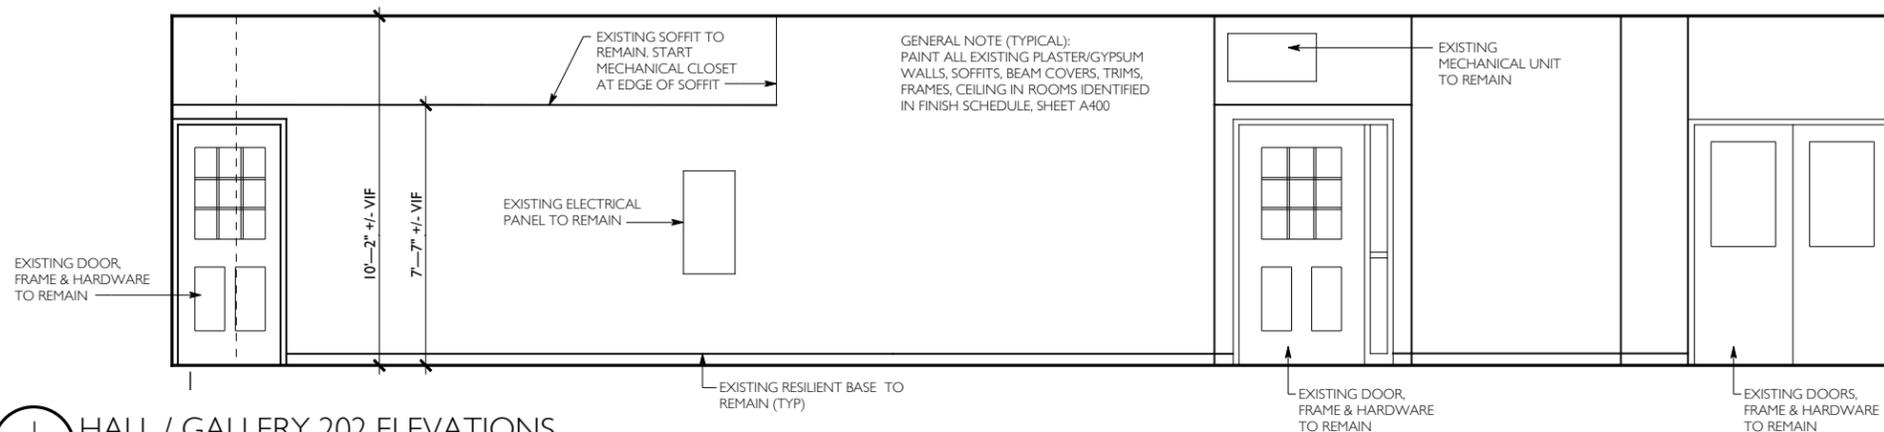
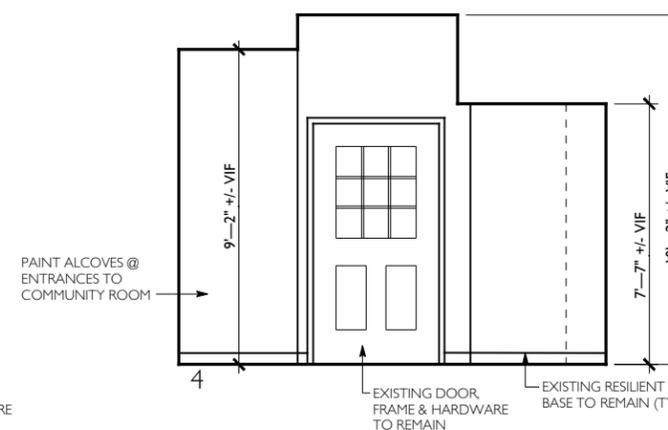
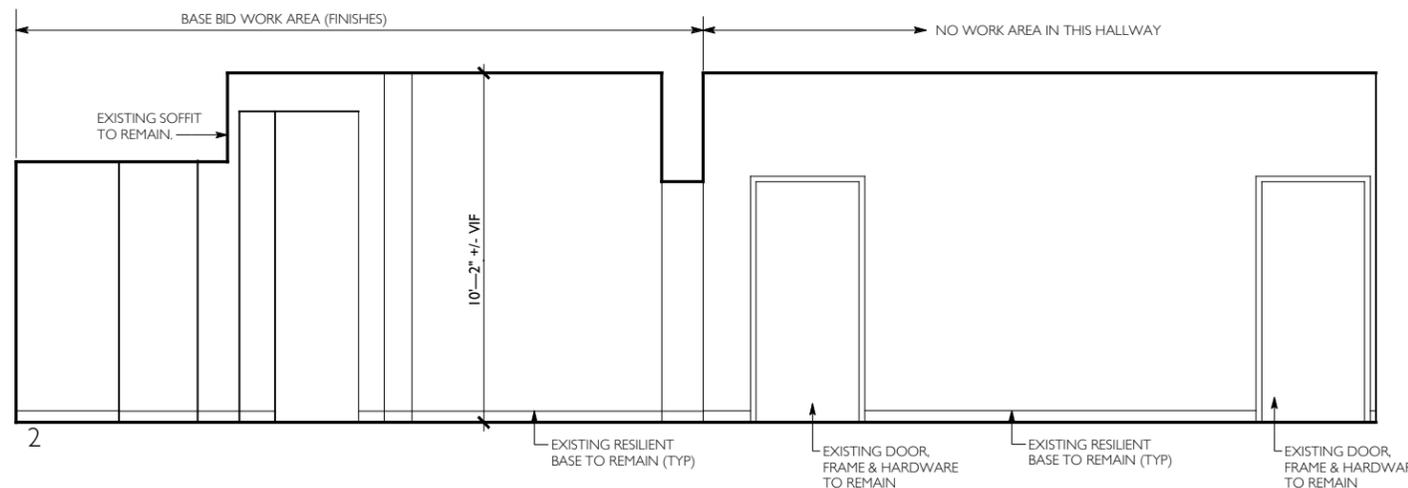
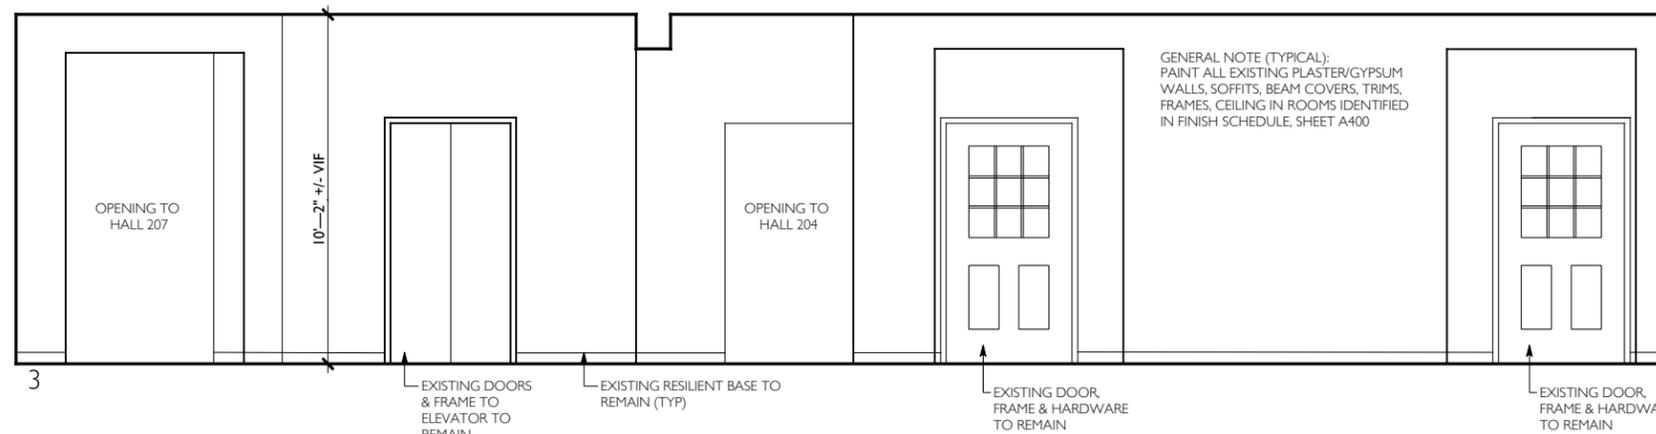
DWN. BY: LMH
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JOB NO.: 19.42.17A
DATE: 10.10.2022


ELEVATIONS

TITLE

A201


DWG. NO.



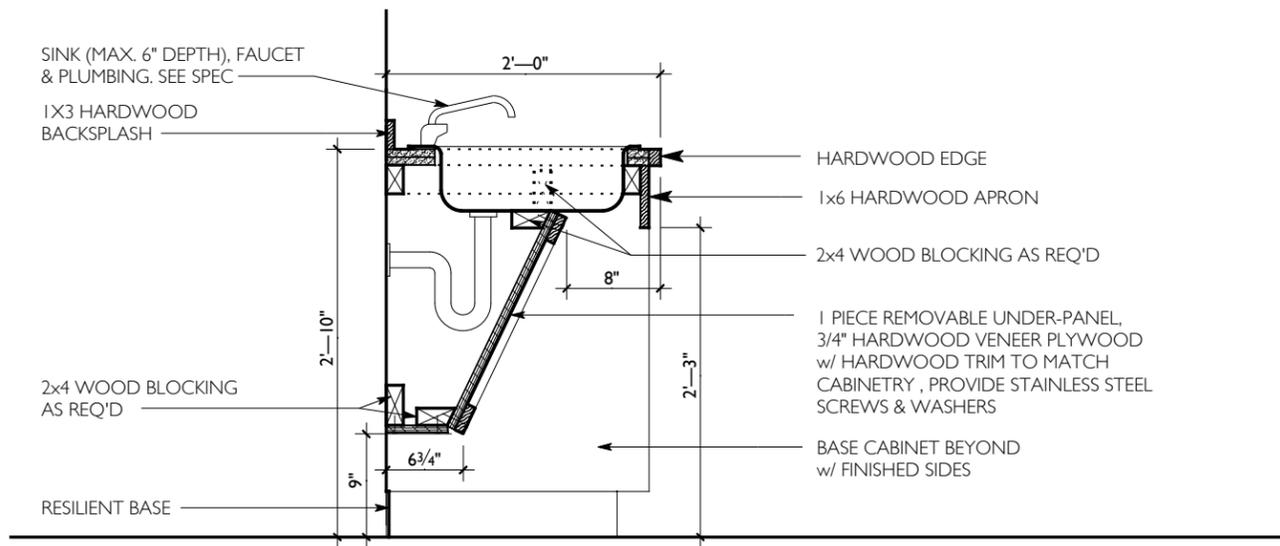


5 UTILITY ROOM SINK CABINET

A300 SCALE: 3/4" = 1'-0"

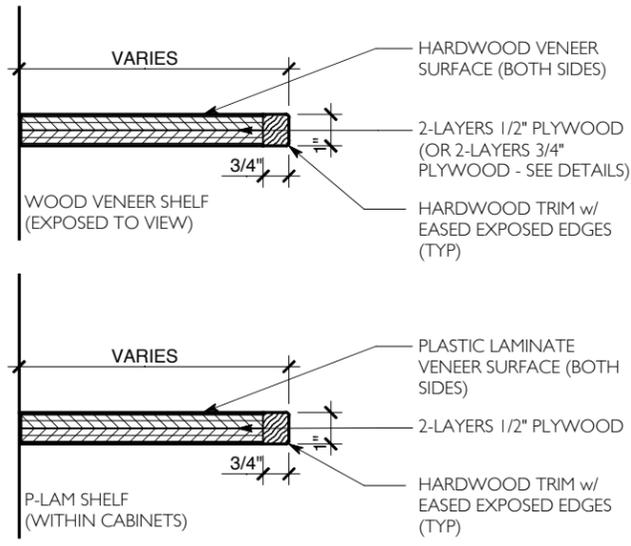


7 SHELF DETAILS

A300 SCALE: 3" = 1'-0"

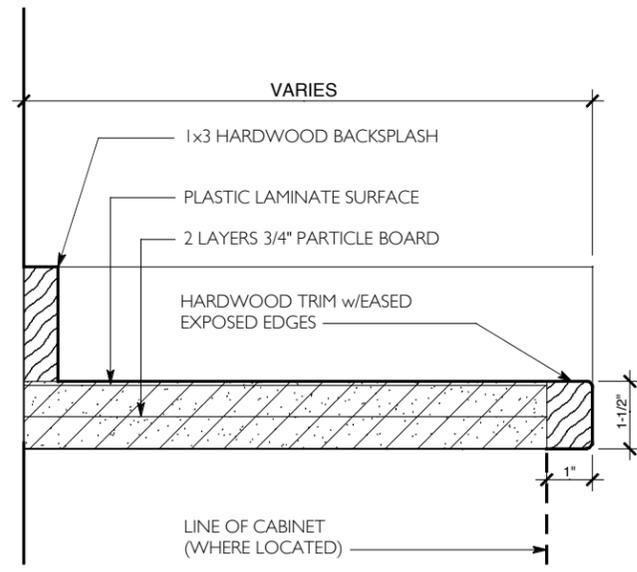


8 COUNTERTOP DETAIL

A300 SCALE: 3" = 1'-0"

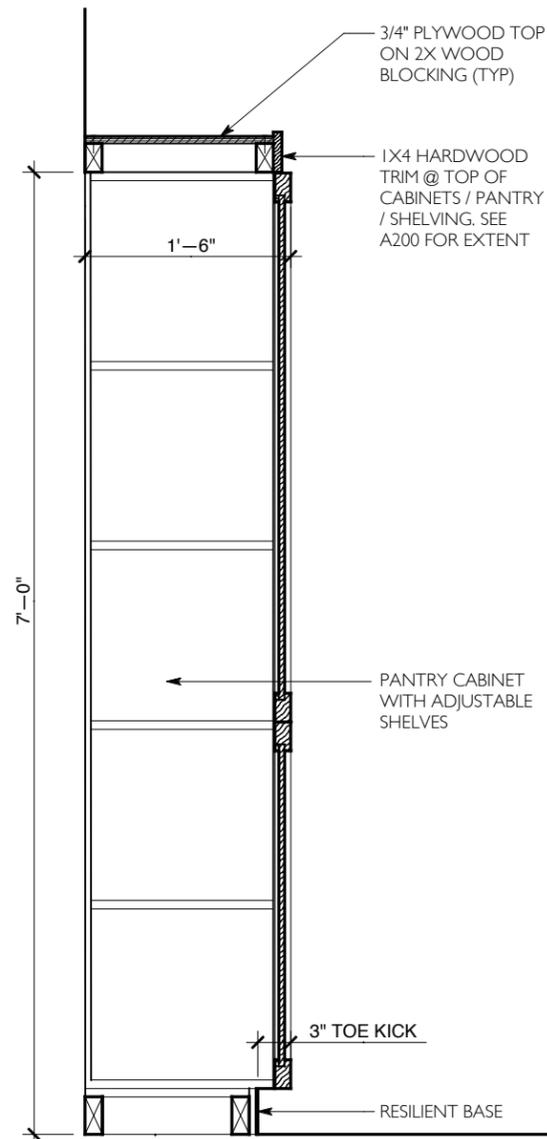


1 PANTRY SECTION

A300 SCALE: 3/4" = 1'-0"

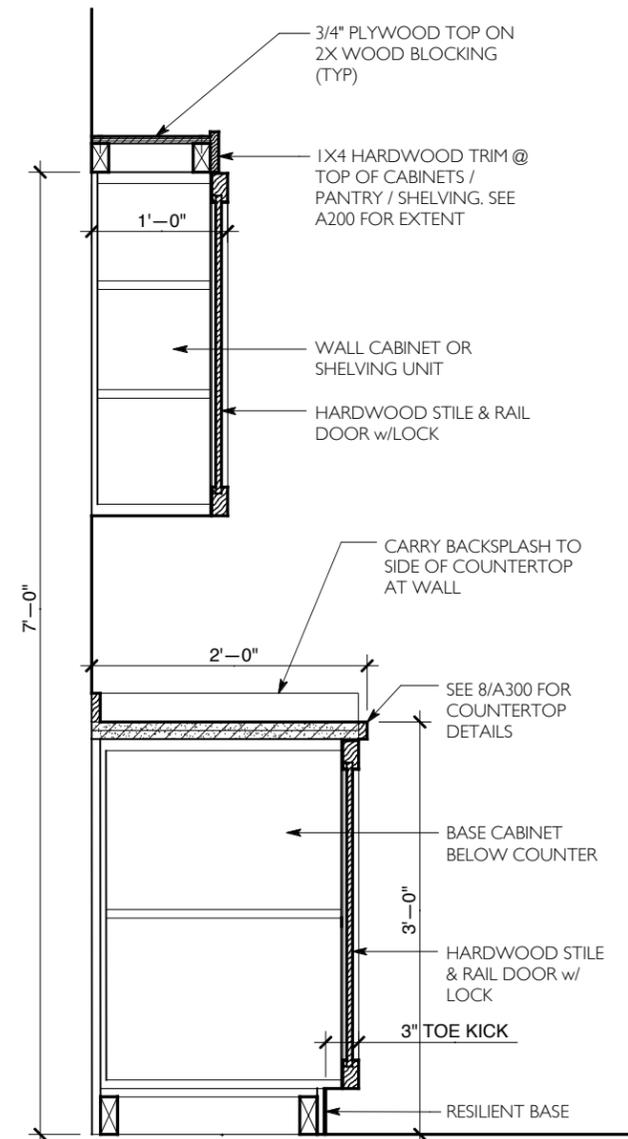


2 BASE / UPPER SECTION

A300 SCALE: 3/4" = 1'-0"

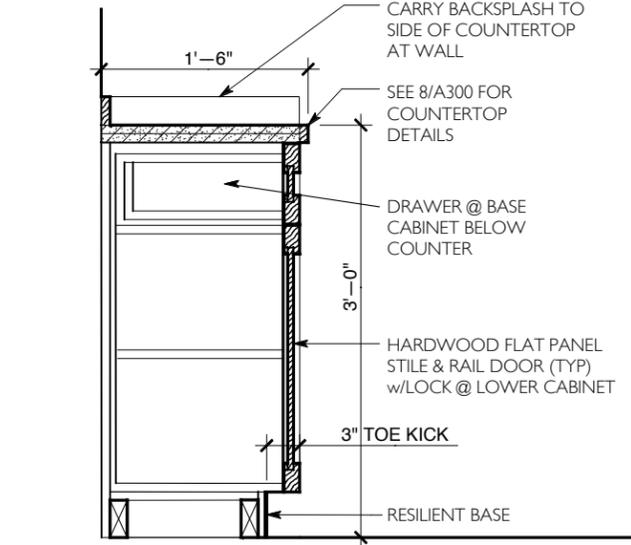


6 BASE SECTION

A300 SCALE: 3/4" = 1'-0"

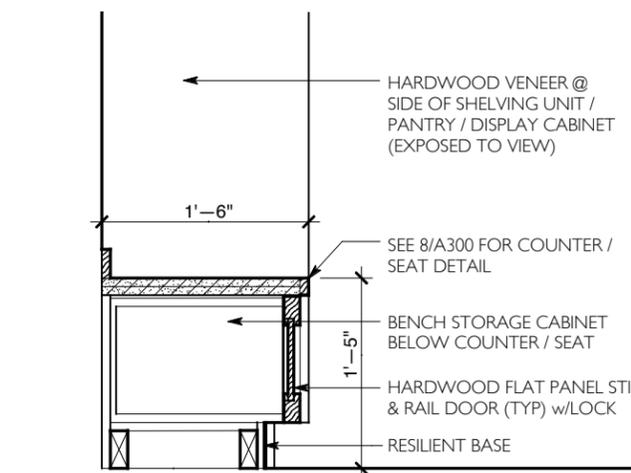

3 BENCH SECTION

A300 SCALE: 3/4" = 1'-0"

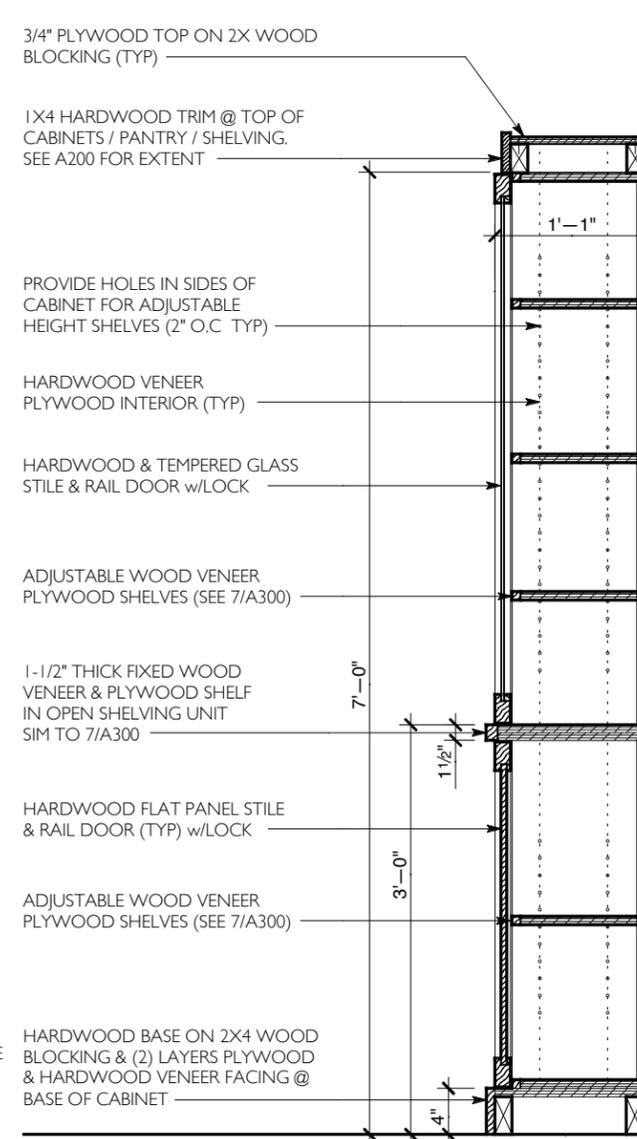

4 DISPLAY SECTION

A300 SCALE: 3/4" = 1'-0"

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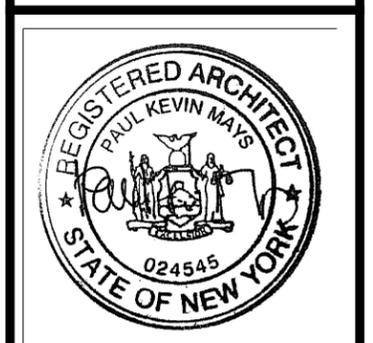
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DWN. BY: LMH
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JOB NO.: 19.42.17A
DATE: 10.10.2022

CABINET DETAILS

TITLE

A300


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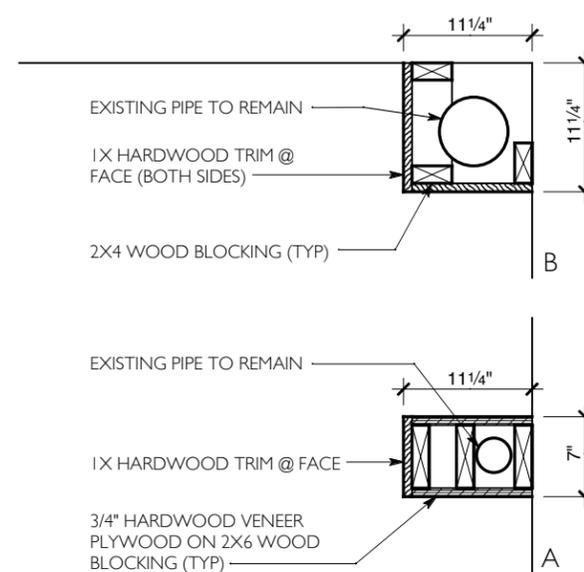
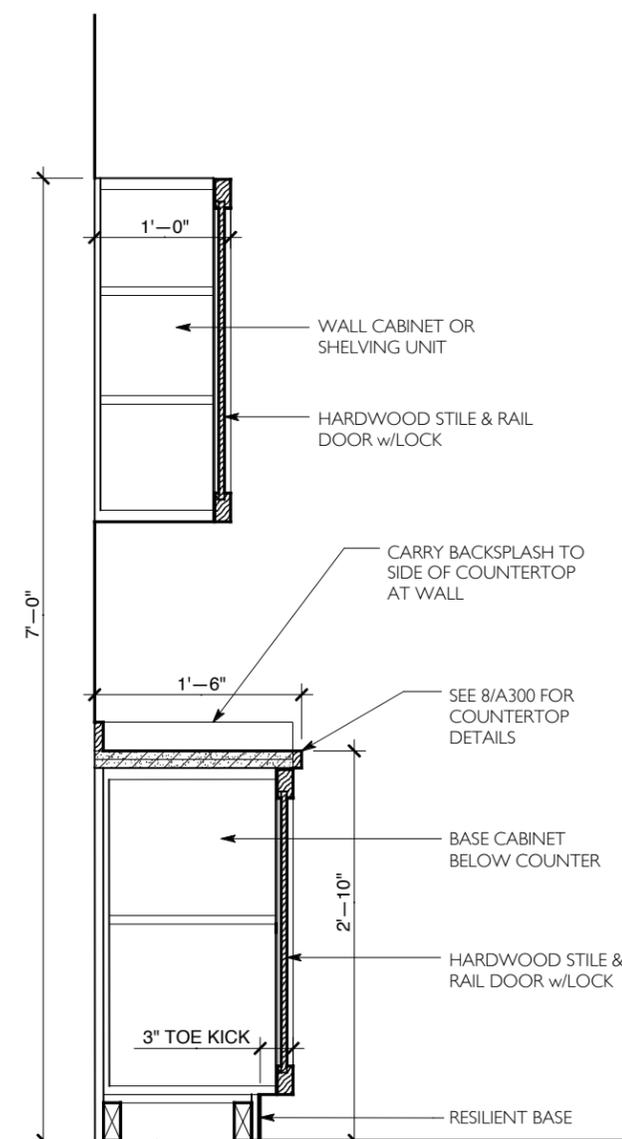
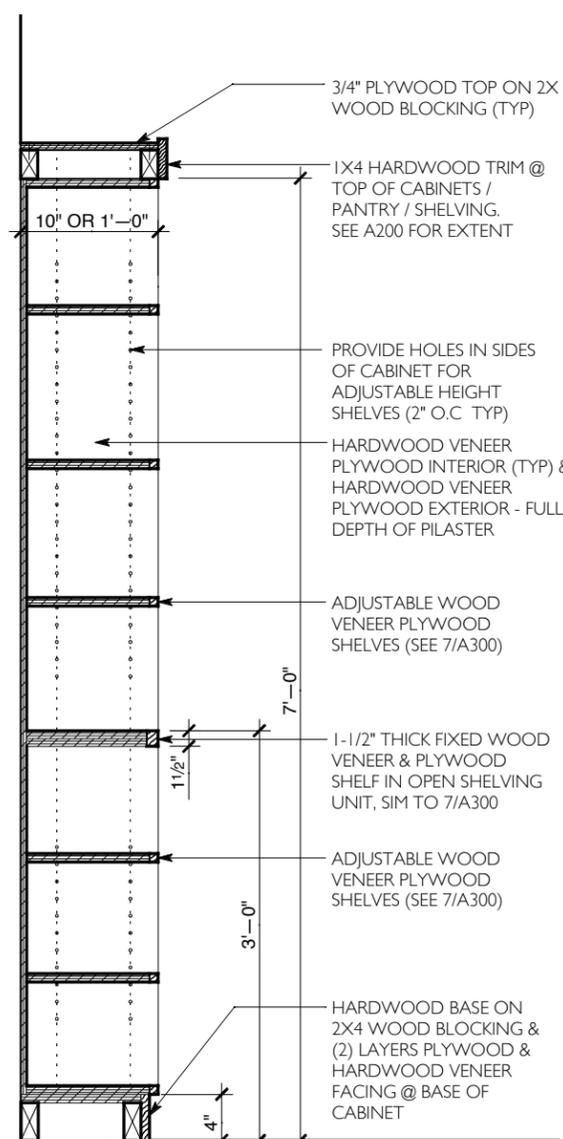
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DATE: 10.10.2022

CABINET DETAILS

TITLE

A301

DWG. NO.

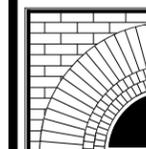

1 SHELVING SECTION
A301 SCALE: 3/4" = 1'-0"

2 BASE / UPPER SECTION
A301 SCALE: 3/4" = 1'-0"

3 PLAN DETAILS
A301 SCALE: 3/4" = 1'-0"

FINISH SCHEDULE


ROOM No.	ROOM NAME	FLOOR	BASE	WALLS								CEILING / SOFFIT			REMARKS
				NORTH		EAST		SOUTH		WEST		HEIGHT	MAT.	FIN.	
				MAT.	FIN.	MAT.	FIN.	MAT.	FIN.	MAT.	FIN.				
201	STAIR I														NO WORK IN THIS SPACE
202	HALL / GALLERY	EX LVT	ERB	XGP/GWB	P	XGP	P	XGP	P	XGP	P	EX	XGP	P	
203	ELEVATOR														NO WORK IN THIS SPACE
204	HALL														NO WORK IN THIS SPACE
205	WOMEN'S RESTROOM														NO WORK IN THIS SPACE
206	MEN'S RESTROOM														NO WORK IN THIS SPACE
207	HALL														NO WORK IN THIS SPACE
208	COMMUNITY MEETING ROOM	CPT	RB	XGP/GWB	P	XGP	P	XGP	P	XGP	P	EX	XGP	P	
208A	UTILITY ROOM	LVT	RB	XGP	P	XGP	P	XGP	P	XGP	P	EX	XGP	P	
208B	TABLES & CHAIRS	CPT	RB	XGP	P	XGP	P	XGP/GWB	P	XGP	P	EX	XGP	P	
208C	CLOSET	CPT	RB	XGP	P	XGP	P	XGP/GWB	P	XGP	P	EX	XGP	P	

Finish Schedule Key	Finish Schedule Notes										
<table style="width: 100%; border: none;"> <tr> <td style="width: 50%;">CPT CARPET TILE</td> <td style="width: 50%;">RB RESILIENT BASE</td> </tr> <tr> <td>EX EXISTING</td> <td>WD WOOD</td> </tr> <tr> <td>GWB GYPSUM WALL BOARD</td> <td>XGP EXISTING GYSPUM BOARD/ PLASTER</td> </tr> <tr> <td>LVT LUXURY VINYL TILE</td> <td>XLVT EXISTING LUXURY VINYL TILE</td> </tr> <tr> <td>P PAINTED</td> <td>XRB EXISTING RESILEIINT BASE</td> </tr> </table>	CPT CARPET TILE	RB RESILIENT BASE	EX EXISTING	WD WOOD	GWB GYPSUM WALL BOARD	XGP EXISTING GYSPUM BOARD/ PLASTER	LVT LUXURY VINYL TILE	XLVT EXISTING LUXURY VINYL TILE	P PAINTED	XRB EXISTING RESILEIINT BASE	<ol style="list-style-type: none"> 1) SEE A102 FOR FLOOR FINISH LAYOUT 2) SEE A101 FOR REFLECTED CEILING PLAN LAYOUT 3) SEE A200 FOR ENLARGED ELEVATIONS
CPT CARPET TILE	RB RESILIENT BASE										
EX EXISTING	WD WOOD										
GWB GYPSUM WALL BOARD	XGP EXISTING GYSPUM BOARD/ PLASTER										
LVT LUXURY VINYL TILE	XLVT EXISTING LUXURY VINYL TILE										
P PAINTED	XRB EXISTING RESILEIINT BASE										


DOOR SCHEDULE

DOOR No.	DOOR						FRAME				DETAILS				REMARKS	NOTES	HARD WARE SET#
	TYPE	WIDTH	HT	LAB.	MAT.	FIN.	TYPE	WIDTH	MAT.	FIN.	HEAD	JAMB	SILL	OTHER			
01	I	3'-0"	7'-0"	--	WD	FF	EX	3'-4"	EX	PT	---	---	---	---	BARN DOOR HARDWARE. SEE I/A200 ELEV 4	1	1
02	I	3'-0"	7'-0"	--	WD	FF	A	3'-4"	HM	PT	I	2	---	---	DETAILS SHOWN SHEET A400	2, 3	2
03	I	2(3'-0")	7'-0"	--	WD	FF	A	6'-4"	HM	PT	I	2	---	---	DETAILS SHOWN SHEET A400	2, 3	3


Door Schedule Key	Door Schedule Notes								
<table style="width: 100%; border: none;"> <tr> <td style="width: 50%;">EX EXISTING</td> <td style="width: 50%;">SIM SIMILAR</td> </tr> <tr> <td>FF FACTORY FINISH</td> <td>WD WOOD</td> </tr> <tr> <td>HM HOLLOW METAL</td> <td></td> </tr> <tr> <td>PT PAINT</td> <td></td> </tr> </table>	EX EXISTING	SIM SIMILAR	FF FACTORY FINISH	WD WOOD	HM HOLLOW METAL		PT PAINT		<ol style="list-style-type: none"> 1) BARN DOOR HARDWARE 2) FLOOR TRANSITION PIECES TO BE PLACED UNDER DOOR 3) SEE SHEET A400 FOR DOOR / FRAME TYPES & DETAILS
EX EXISTING	SIM SIMILAR								
FF FACTORY FINISH	WD WOOD								
HM HOLLOW METAL									
PT PAINT									

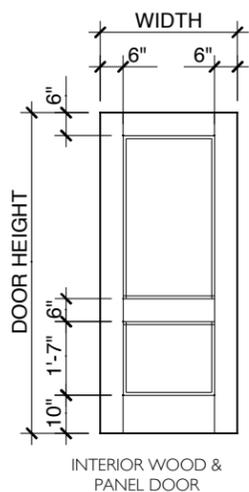


DOOR TYPE I

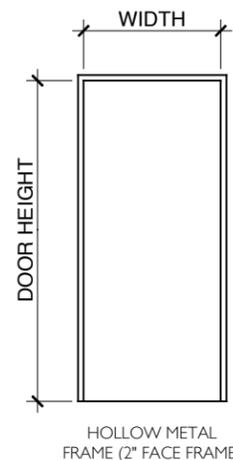

FRAME TYPE A

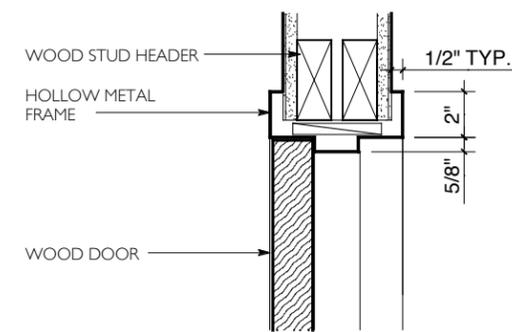

1 HEAD DETAIL
A400 SCALE: 1-1/2" = 1'-0"

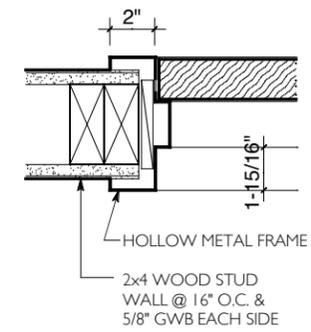

2 JAMB DETAIL
A400 SCALE: 1-1/2" = 1'-0"

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FINISH & DOOR SCHEDULES,
TYPES & DETAILS

TITLE


A400

DWG. NO.

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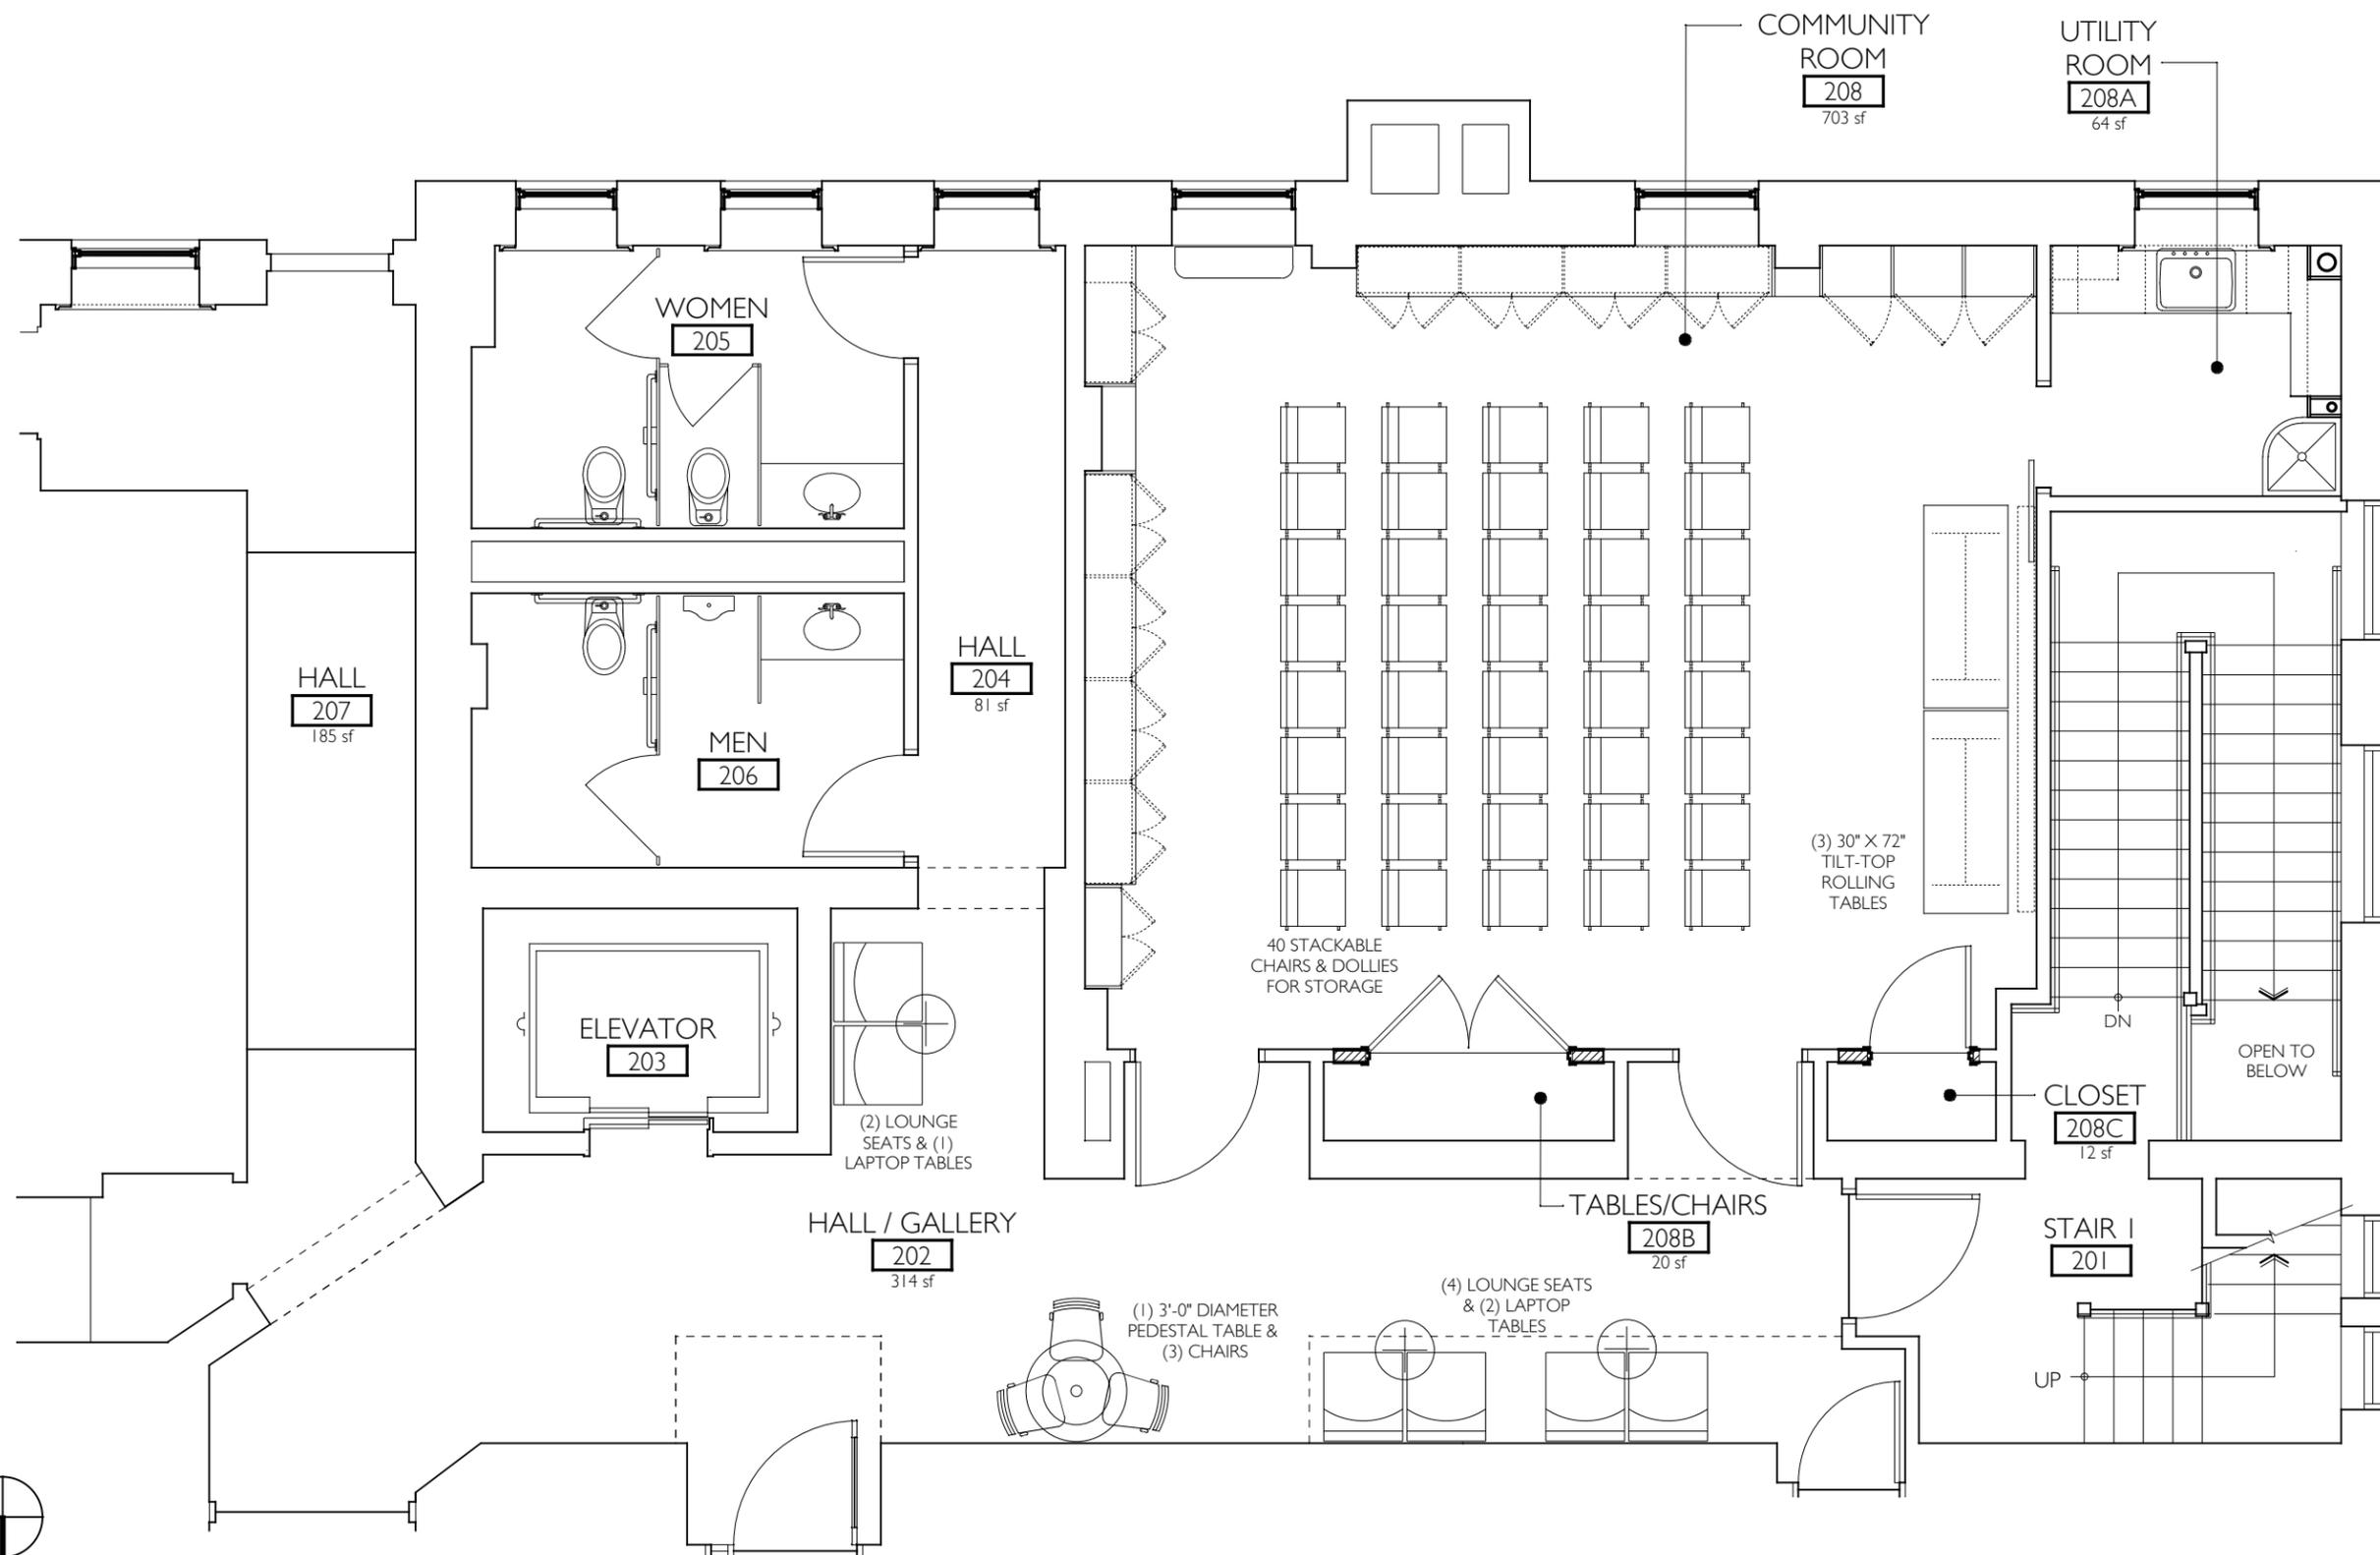
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I ENLARGED PARTIAL SECOND FLOOR PLAN - FURNITURE PLAN

F100 SCALE: 3/16" = 1'-0"

DWN. BY: LMH
SCALE: AS NOTED
JOB NO.: 19.42.17A
DATE: 10.10.2022

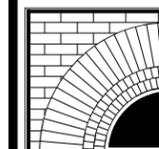ENLARGED PARTIAL
SECOND FLOOR PLAN -
FURNITURE PLAN
FOR REFERENCE ONLY

TITLE

F100

DWG. NO.

LEGEND:

	SUPPLY, OUTSIDE AIR DUCT OR CEILING DIFFUSER
	RETURN, EXHAUST AIR DUCT OR RETURN AIR DIFFUSER
	SPACE SENSOR - MH-48\"AFF
	POINT OF CONNECTION
	POINT OF DISCONNECTION
	VOLUME DAMPER
	REMOVALS

ABBREVIATIONS:

AFG	ABOVE FINISHED GRADE
CFM	CUBIC FEET PER MINUTE
SD	SUPPLY DIFFUSER
DN	DOWN
EX.	EXISTING
MIN	MINIMUM
MAX	MAXIMUM
OA	OUTSIDE AIR
RG	RETURN GRILLE
RR	RETURN REGISTER
SD	SUPPLY DIFFUSER
SR	SUPPLY REGISTER

SCOPE OF WORK:

1. THE CONTRACTOR SHALL PROVIDE ALL LABOR, MATERIALS AND EQUIPMENT NECESSARY TO COMPLETE ALL WORK SHOWN OR INFERRED ON THESE CONTRACT DRAWINGS AND DOCUMENTS. THE WORK SHALL INCLUDE, BUT NOT NECESSARILY BE LIMITED TO THE FOLLOWING PRINCIPLE ITEMS OF WORK:
 1. PROVIDE REMOVAL OF HVAC EQUIPMENT INCLUDING RECOVERY OF REFRIGERANT FROM CONDENSER.
 2. PROVIDE REMOVAL OF LPS RADIATOR. TURN RADIATOR OVER TO OWNER.
 3. PROVIDE ONE DUCTLESS FANCOIL / CONDENSER SYSTEM AS SCHEDULED AND DETAILED.
 4. PROVIDE ALL EQUIPMENT AS SCHEDULED OR EQUAL. EQUAL SHALL BE APPROVED BY ENGINEER DURING SUBMITTAL PROCESS. PROVIDE SUBMITTALS FOR ALL SCHEDULED EQUIPMENT.
 5. PROVIDE KITCHEN SINK AS ELKAY LUSTERTONE Q252255. COORDINATE INSTALLATION WITH GC FOR MILLWORK. PROVIDE FAUCET AS AMERICAN STANDARD MONTERREY 2 HANDLE WRIST BLADE STYLE 7500.174. PROVIDE SINK AND FAUCET HW, CW, AND DRAINAGE PIPING CONNECTIONS TO EXISTING UTILITIES.

GENERAL MECHANICAL NOTES:

1. IN CERTAIN AREAS OF THE CONTRACT DRAWINGS, DIMENSIONS AND ARE SHOWN DUCTWORK. THE DUCTWORK LAYOUT SHALL BE FIELD VERIFIED PRIOR TO FABRICATION. THE CONTRACTOR MAY MODIFY ELEVATIONS AND LOCATIONS AS NECESSARY TO AVOID INTERFERENCE'S WITH EXISTING AND NEW SERVICES. THE CONTRACTOR SHALL NOT SCALE OFF THESE DRAWINGS FOR THE PURPOSE OF CONSTRUCTION.
2. CONTRACTOR SHALL VISIT THE SITE, BECOME FAMILIAR WITH THE EXISTING FIELD CONDITIONS, AND MAKE HIS OWN ESTIMATE OF THE DIFFICULTIES ATTEMPTING THE EXECUTION OF THE WORK PRIOR TO SUBMITTING HIS BID. NO COMPENSATION WILL BE AWARDED TO THE CONTRACTOR BASED ON A CLAIM OF LACK OF KNOWLEDGE OF EXISTING FIELD CONDITIONS.
3. COORDINATE WITH OWNER REPRESENTATIVE PRIOR TO DOING ANY WORK AFFECTING ANY OPERATIONAL AREA ADJACENT TO THE AREA OF WORK.
4. THE CONTRACTOR SHALL REPORT ALL CHANGES IN THE WORK TO THE OWNER REPRESENTATIVE.
5. IN THIS CONTRACT THE WORK "PROVIDE" SHALL MEAN "FURNISH AND INSTALL."
6. THE CONTRACTOR SHALL CAREFULLY PLAN AND PERFORM ALL WORK TO PREVENT DAMAGE TO EXISTING. PROVIDE PROTECTION DEVICES REQUIRED TO PROTECT EXISTING FACILITIES AND EQUIPMENT DURING THE CONSTRUCTION OF THIS PROJECT. ANY DAMAGE TO EXISTING FACILITIES OR EQUIPMENT RESULTING FROM THE WORK OF THIS CONTRACT SHALL BE REPAIRED OR REPLACED AT THE CONTRACTOR'S EXPENSE TO THE SATISFACTION OF OWNER. THE CONTRACTOR SHALL NOTIFY OWNER IMMEDIATELY OF ANY DAMAGE TO THE NEW EQUIPMENT OR TO EXISTING FACILITIES OR EQUIPMENT.
7. ALL WORK PERFORMED SHALL BE IN ACCORDANCE WITH THE BEST CONSTRUCTION PRACTICES AND AS A MINIMUM SHALL CONFORM TO THE CODES AND STANDARDS OF THE ORGANIZATIONS LISTED BELOW.
 - A. OCCUPATION SAFETY AND HEALTH ADMINISTRATION (OSHA)
 - B. AMERICAN SOCIETY OF MECHANICAL ENGINEERS (ASME)
 - C. AMERICAN NATIONAL STANDARDS (ANSI)
 - D. SHEET METAL AND AIR CONDITIONING CONTRACTORS NATIONAL ASSOCIATION (SMACNA)
 - E. NEW YORK STATE CODE RULES AND REGULATIONS
 - F. NEW YORK STATE ENERGY CONSERVATION CODE RULES AND REGULATIONS
8. THE CONTRACTOR SHALL FIELD VERIFY ALL EXISTING CONDITIONS, LOCATIONS, ELEVATIONS AND DIMENSIONS PRIOR TO START OF WORK AND NOTIFY THE OWNER OF ANY DISCREPANCIES OF PROBLEMS WHICH WOULD INTERFERE WITH THE SATISFACTORY COMPLETION OF THE WORK.
9. ANY DAMAGE TO ANY EXISTING UTILITIES CAUSED BY CONTRACTOR'S WORK SHALL BE IMMEDIATELY REPAIRED BY QUALIFIED PERSONNEL AT CONTRACTOR'S EXPENSE.


MATERIAL SPECIFICATIONS

1. REFRIGERANT PIPING: ACR TUBE: ASTM B 280, WROT COPPER TUBE FITTINGS, SOLDER JOINT: ASME B16.22.CAST COPPER ALLOY TUBE FITTINGS, SOLDER JOINT: ASME B16.18. BRAZING ALLOYS, TYPE 1: AWS A5.8, CLASS BCUP-5, FOR BRAZING COPPER TO BRASS, BRONZE, OR COPPER; ENGELHARD'S SILVALOY 15, J.W. HARRIS CO. INC.'S STAY-SILV 15, AND HANDY & HARMAN'S SIL-FOS. TYPE 2: AWS A5.8, CLASS BAG-7, FOR BRAZING COPPER TO STEEL OR STAINLESS STEEL; ENGELHARD'S SILVALOY-56T, J.W. HARRIS CO. INC.'S SAFETY-SILV 56, AND HANDY & HARMAN'S BRAZE 560.
2. CONDENSATE - COPPER TUBE, PVC SCHEDULE 40 PIPE AND FITTINGS.
3. REFRIGERANT PIPING INSULATION: FLEXIBLE ELASTOMERIC FOAM INSULATION: FM TESTED AND APPROVED, MAXIMUM WATER VAPOR TRANSMISSION 0.10 PERM - INCH BASED ON ASTM E 96, PROCEDURE, K OF 0.27 AT 75 DEGREES F BASED ON ASTM C 518 OR C 177. FIRE SPREAD/SMOKE DEVELOPED RATING: 25/50 OR LESS BASED ON ASTM E 84, ASTM C 534, TYPE I. POLYETHYLENE AND POLYOLEFIN INSULATION IS NOT ACCEPTABLE.

BID SET: 10 OCTOBER 2022

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ARCHITECTS, LLP

57 West High Street
Ballston Spa
New York 12020

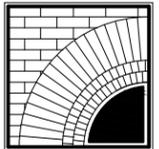PH: 518 Y 885 Y 1255
FAX: 518 Y 885 Y 1266
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Renovation for the**

**Josephine-Louise
Public Library**



DWN. BY: RWW
SCALE: AS NOTED
JOB NO.: 19.42.17
DATE: 10.10.2022

**LEGEND, SYMBOLS,
ABBREVIATIONS AND
SPECIFICATIONS**


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CONDENSING UNIT SCHEDULE

TAG	SERVICE	COOLING				HEATING		ELECTRICAL					MFG. AND MODEL	REMARKS
		COND. EAT DB (DEG. F)	EVAP. EAT WB (DEG. F)	SENS. CAP. (BTUH)	TOTAL CAP. (BTUH)	COND. EAT DB (DEG. F)	TOTAL CAP. (BTUH)	VOLTS	PHASE	HZ	MCA	MOCP		
ACCU-1	FC-1	91	62.5	24.0	30.7	-4	32.5	208/230	1	60	28	35	CARRIER 38MARBQ36AA3	1,2

1. SEE DETAIL 1/H003 FOR INSTALLATION.
2. PROVIDE AS INVERTER SYSTEM.

FAN COIL UNITS

TAG	SERVICE	STYLE	CFM	SPEED CONTROL	MBH COOLING	MBH HEATING	MOUNTING	ELECTRICAL					MANUFACTURER	REMARKS
								VOLTS	PHASE	HZ	MCA	FLA		
								FANCOIL						
FC-1	COMMUNITY ROOM	HIGH WALL	382-843	VARIABLE	9.3-38.8	11.57-37	HIGH WALL	208/230	1	60	.63	0.5	CARRIER 40MAHBQ36XA3	1

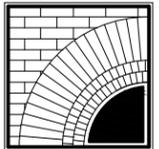1. SEE DETAIL 1/H003 FOR INSTALLATION.

ELECTRIC CABINET UNIT HEATER SCHEDULE

TAG	LOCATION / SERVICE	CAPACITY (KW)	LENGTH X WIDTH X HEIGHT (IN. X IN. X IN.)	ELECTRICAL		BASIS OF DESIGN MANUFACTURER & MODEL NO.	REMARKS
				VOLTS	PHASE		
EWH-1	KITCHEN	1.5	10.5 X 5 X 12.5	120	1	BERKO SRA1512DSAF	1,2,3

1. PROVIDE WITH SURFACE MOUNTING FRAME.
2. PROVIDE WITH FACTORY INTEGRAL MOUNTED THERMOSTAT. INITIAL SETTING OF 65 DEGREES.
3. MOUNT WALL HEATER HIGH ON WALL MINIMUM OF 84".



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SCHEDULES

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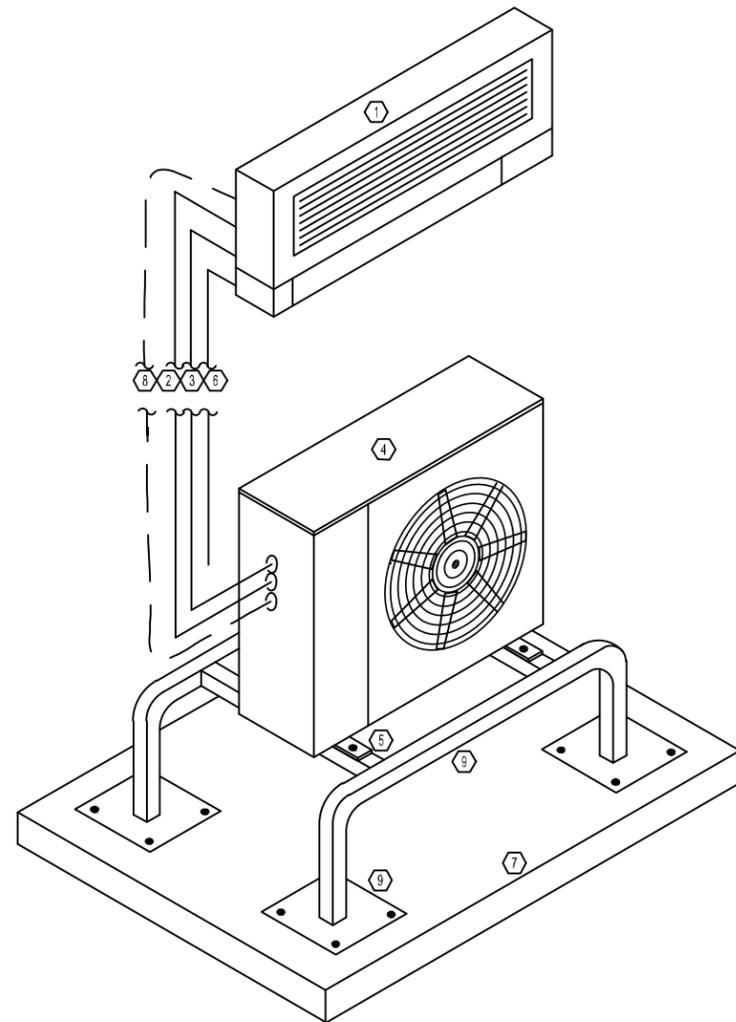
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JOB NO.: 19.42.17
DATE: 10.10.2022

DETAILS

TITLE

H003

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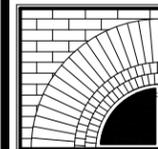


- ① FAN COIL UNIT (TYP). WALL MOUNT SHOWN
SUPPORT AND SPACE AS NECESSARY FOR REFRIGERANT AND CONDENSATE
PIPING CONNECTIONS.
- ② REFRIGERANT LIQUID LINE (TYPE L DRAWN TEMPERED COPPER WITH
ELASTOMERIC INSULATION)
- ③ REFRIGERANT SUCTION LINE (TYPE L DRAWN TEMPERED COPPER WITH
ELASTOMERIC INSULATION)
- ④ CONDENSING UNIT
- ⑤ CONDENSING UNIT ANCHOR POINT
(ANCHOR TO EQUIPMENT STAND TYP 4)
- ⑥ INSULATED CONDENSATE DRAIN LINE. 12" AFG
- ⑦ CONCRETE EQUIPMENT PAD
- ⑧ CONTROL WIRING/POWER WIRING TO EVAPORATOR
- ⑨ HEAT PUMP STAND (MIN 16" AFG)
ANCHOR TO CONCRETE PAD (TYP 16)

1 HIGHWALL DUCTLESS SPLIT SYSTEM DETAIL (ACCU-1, FC-1)
H003 SCALE: NTS

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Ballston Spa
New York 12020

PH: 518.788.1255
FAX: 518.788.1266
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**MECHANICAL SECOND FLOOR
REMOVAL PLAN**


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HR001

DWG. NO.

KEYED NOTES:

- ① VERIFY CONDENSER SERVES AC-5. RECOVER REFRIGERANT AS PER EPA GUIDELINES. REMOVE CONDENSER. REMOVE CONTROL WIRING AND REFRIGERANT PIPING BACK BEYOND PENETRATION INTO BUILDING. SEAL PENETRATION.
- ② REMOVE AC HIGH WALL MOUNT FANCOIL UNIT. REMOVE CONTROL WIRING, CONDENSATE PIPING AND REFRIGERATION PIPING BEYOND WALL PENETRATION. SEAL CONDENSATE PIPING END. CRIMP AND SEAL REFRIGERATION PIPING ENDS. COORDINATE WITH GC FOR PATCHING AND PAINTING OF WALL.
- ③ REMOVE LPS RADIATOR, FITTINGS, VALVES AND PIPING. TURN RADIATOR OVER TO BUILDING OWNER. CAP PIPING AT FLOOR LEVEL TO ALLOW FOR MILLWORK INSTALLATION.

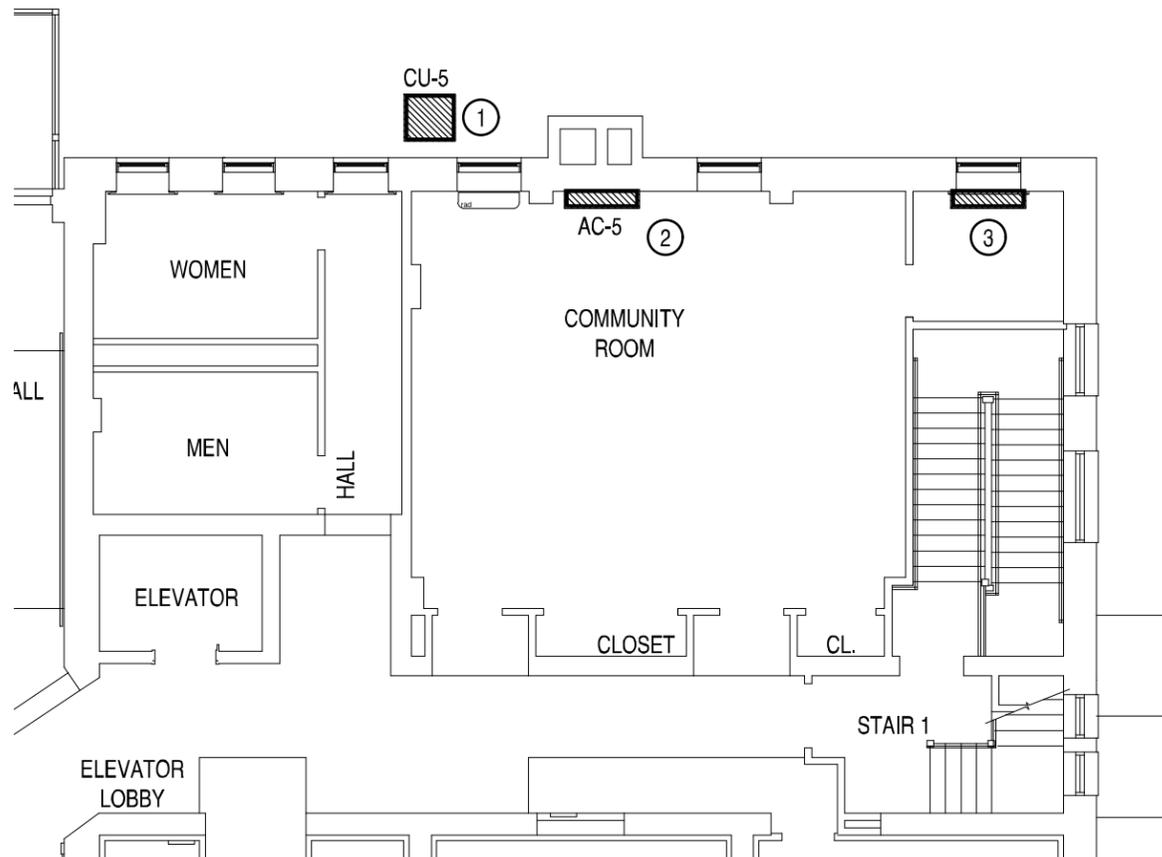

1 MECHANICAL SECOND FLOOR REMOVAL PLAN
HR001 SCALE: 3/32" = 1'-0"

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Ballston Spa
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PH: 518 Y 885 Y 1255
FAX: 518 Y 885 Y 1266
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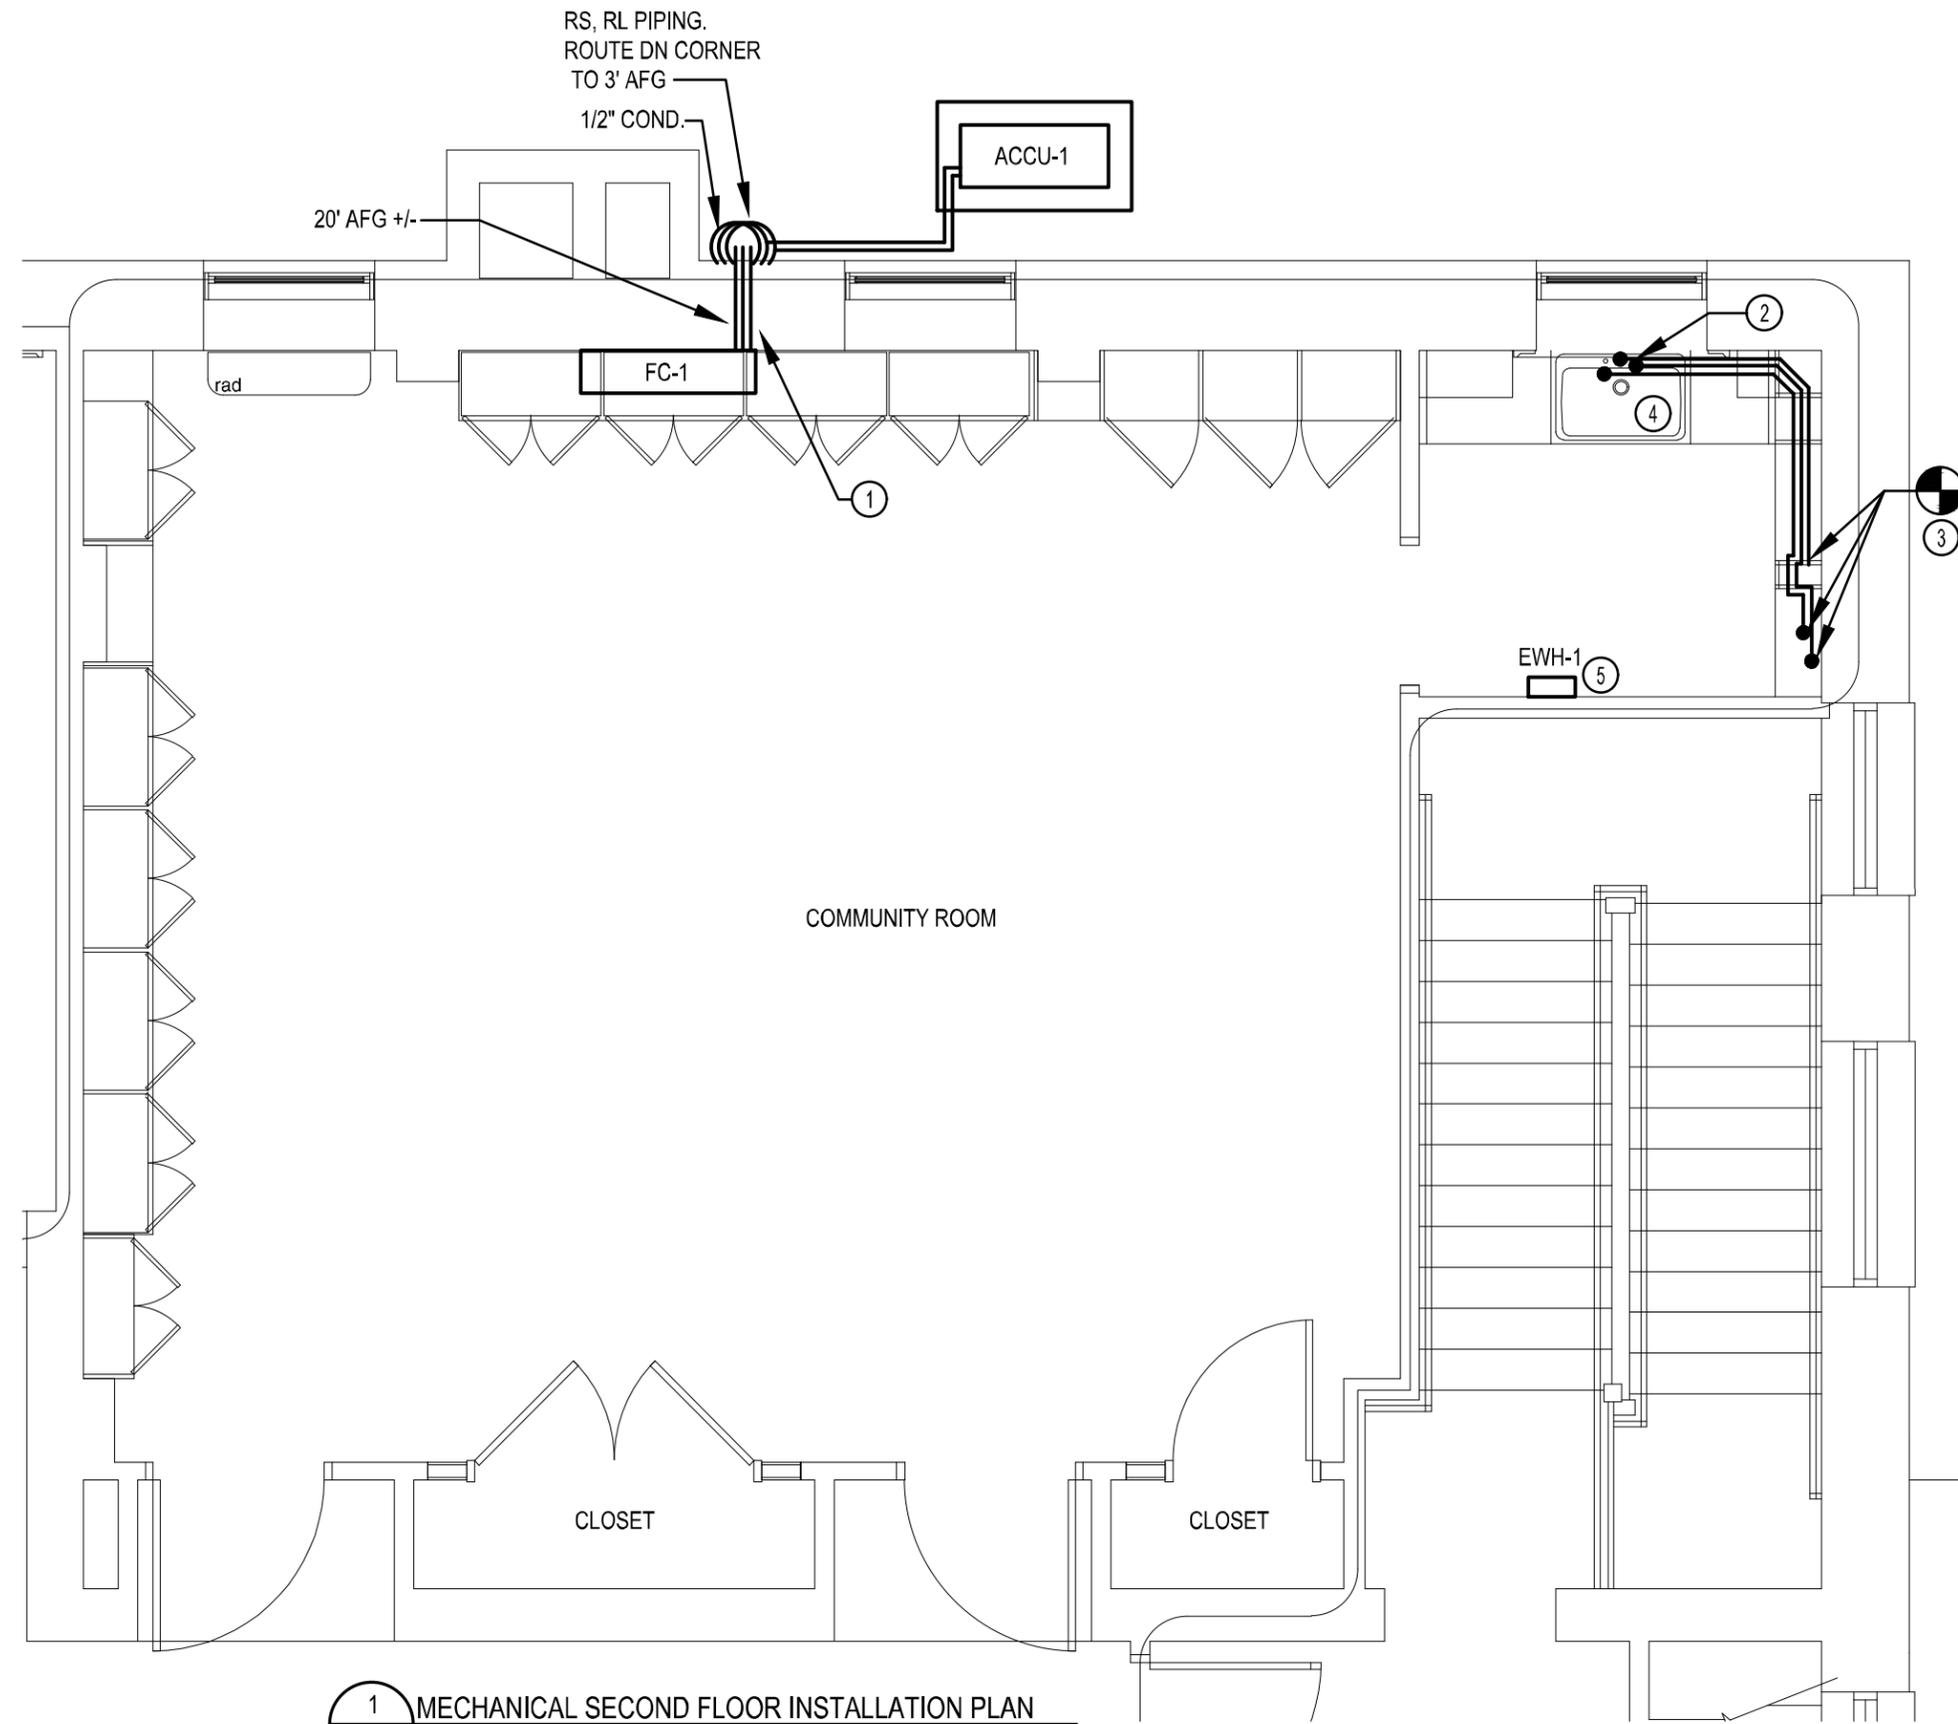
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**MECHANICAL SECOND
FLOOR INSTALLATION
PLAN**

TITLE

H101

DWG. NO.



KEYED NOTES:


- ① PROVIDE CORE DRILLING OF MASONRY WALLS. COORDINATE DUCT WALL PENETRATIONS WITH GENERAL CONTRACTOR (TYP 5)
- ② PROVIDE HW & CW L COPPER PIPING, HW & CW STOPS, FLEXIBLE FAUCET CONNECTIONS. PROVIDE P-TRAP, 1 1/2" DRAINAGE PIPING, WITH AIR ADMITTANCE VALVE.
- ③ PROVIDE 2"x2"x1 1/2" NO HUB WYE IN EXISTING CAST IRON STACK. CONNECT DRAINAGE LINE FROM SINK. COORDINATE STACK WORK WITH BUILDING OCCUPANTS.
- ④ PROVIDE SINK AS TOP MOUNT SINGLE BOWL ELKAY LUSTERTONE Q252255 WITH DRAIN STRAINER. PROVIDE FAUCET AS AMERICAN STANDARD MONTERREY 2 HANDLE WRIST BLADE STYLE 7500.174
- ⑤ PROVIDE ELECTRIC CABINET HEATER AS SURFACE MOUNTED. MOUNT 84" AFF. SET INTIAL TEMPERATURE TO 65° F.

1 MECHANICAL SECOND FLOOR INSTALLATION PLAN
H101 SCALE: 1/4" = 1'-0"

ABBREVIATIONS: (SOME ABBREVIATIONS MAY NOT BE USED)

A	AMP	ES	ELECTRIC STRIKE	MS	MOTOR STARTING	SFL	SUB-FEED LUGS
AC	ABOVE COUNTER	EXR	EXISTING TO REMAIN	MTG	MOUNTING	SH	SHIELDED
AFCI	ARC FAULT CIRCUIT INTERRUPTER	FLA	FULL LOAD AMPS	NEC	NATIONAL ELECTRIC CODE	SM	SINGLE MODE FIBER OPTIC CABLE
AFF	ABOVE FINISHED FLOOR	FTL	FEED-THRU LUGS	NL	NIGHT LIGHT	TBD	TO BE DETERMINED
AFG	ABOVE FINISHED GRADE	FVNR	FULL VOLTAGE NON-REVERSING	NO/NC	NORMALLY OPEN/NORMALLY CLOSED	TSP	TWISTED SHIELDED PAIR
AWG	AMERICAN WIRE GAGE	G	GROUND	OL'S	THERMAL OVERLOAD UNITS	TW	TWISTED
C	CONDUIT	GFI	GROUND FAULT CIRCUIT INTERRUPTER	P	POLE	TYP	TYPICAL
CAT	CATEGORY	HOA	HAND-OFF-AUTO SWITCH	PH	PHASE	UG	UNDERGROUND
CB	CIRCUIT BREAKER	HP	HORSEPOWER	PR	PAIR	UON	UNLESS OTHERWISE NOTED
CKT	CIRCUIT	IG	ISOLATED GROUND	PVC	POLYVINYL CHLORIDE	UPS	UNINTERRUPTIBLE POWER SUPPLY
CU	COPPER	JB	JUNCTION BOX	RECEPT	RECEPTACLE	UTP	UNSHIELDED TWISTED PAIR
DWGS	DRAWINGS	K	KILO	REL	RELOCATE	V	VOLT
ECB	ENCLOSED CIRCUIT BREAKER	KVA	KILO-VOLT AMPERE	REM	REMOVE	W	WATT
EM	EMERGENCY	LV	LOW VOLTAGE	REP	REPLACE	W/	WITH
EMT	ELECTRICAL METALLIC TUBING	MLO	MAIN LUGS ONLY	RGS	RIGID GALVANIZED STEEL	WP	WEATHERPROOF
ELU	EMERGENCY LIGHTING UNIT	MM	MULTIMODE FIBER OPTIC CABLE	SCH	SCHEDULE	XFMR	TRANSFORMER

SYMBOLS:

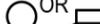	RECESSED PANEL		SPECIAL RECEPTACLE, TYPE AS INDICATED		FIRE ALARM PULL STATION
	SURFACE MOUNTED PANEL		NEMA 1 NON-FUSED DISCONNECT UON 'XX'- INDICATES DISCONNECT SIZE 'Y'- NUMBER OF POLES		SMOKE DETECTOR. PHOTOELECTRIC UON 'A'-INDICATES AUDIBLE BASE
	JUNCTION BOX 'P' INDICATES FURNITURE POWER CONNECTION 'D' INDICATES FURNITURE DATA CONNECTION		VFD VARIABLE FREQUENCY DRIVE. HP AS INDICATED		WALL MOUNTED FIRE ALARM COMBINATION SPEAKER/STROBE. 15 CANDELA UNLESS NOTED OTHERWISE 'X' INDICATES CANDELA RATING STROBE UON.
	HOME RUN TO PANEL. 2#12, #12G, 3/4"C UNLESS OTHERWISE NOTED. PROVIDE SEPARATE GROUND AND NEUTRAL FOR EACH BRANCH CIRCUIT. 'X'-INDICATES PANEL 'Z, Y'-INDICATES CIRCUIT NUMBERS		VFD COMBINATION NON-FUSED DISCONNECT VARIABLE FREQUENCY DRIVE. HP AS INDICATED		
	CIRCUIT CONTINUATION WITH 'Y' INDICATING DEVICE OR AREA DESCRIPTION 'X'-INDICATES PANEL 'Z, Y'-INDICATES CIRCUIT NUMBERS		SINGLE POLE SWITCH, 20 AMP 120/277 UNLESS NOTED OTHERWISE 'MS'-INDICATES 1HP RATED GENERAL USE 'SNAP SWITCH' WITH OVERLOADS SIZED FOR EQUIPMENT AND LOCKABLE HASP '3MS'-INDICATES 3 POLE 600 VOLT 30 AMP 3HP RATED GENERAL USE 'SNAP SWITCH' WITH OVERLOADS SIZED FOR EQUIPMENT AND LOCKABLE HASP 'WP'-INDICATES WEATHER PROOF 'OS' OCCUPANCY VACANCY SENSOR SWITCH 'VS' INDICATES VACANCY SENSOR SWITCH 'LV' INDICATES LOW VOLTAGE MOMENTARY SWITCH		
	CIRCUIT CONSISTING OF GROUND, NEUTRAL AND PHASE CONDUCTORS. ADDITIONAL SLASH MARKS INDICATE SWITCHING OR TRAVELER CONDUCTORS, AND A LONG SOLID LINE INDICATES NEUTRAL. A SEPARATE GREEN GROUND CONDUCTOR SHALL BE PLACED IN ALL NEW CIRCUITS		CEILING MOUNTED OCCUPANCY SENSOR. DUAL TECHNOLOGY ULTRASONIC/PIR UNLESS NOTED OTHERWISE. 'MP'-INDICATES MICROPHONICS 'XR'-INDICATES EXTENDED RANGE		
	LINE TYPE SHOWING WIRING BETWEEN LIGHTING POWER PACKS AND OCCUPANCY SENSORS		OCCUPANCY SENSOR POWER PACK		
	CONNECTION POINT		OR SHADING ADDED TO A LIGHT FIXTURE INDICATES EMERGENCY BATTERY PACK (NON-GENERATOR) 'NL'-INDICATES NIGHT LIGHT CIRCUIT		
	CONDUIT TURNED UP		OR CEILING OR WALL MOUNTED LED EXIT SIGN, NON BATTERY. PROVIDE DIRECTIONAL ARROWS AS SHOWN ON DRAWINGS.		
	CONDUIT TURNED DOWN		OR CEILING OR WALL MOUNTED EMERGENCY LIGHTING UNIT		
	CAPPED CONDUIT		LINEAR PENDANT MOUNT FIXTURE TYPE 'L1' 24" BELOW FINISHED CEILING. AXIS LIGHTING #SLLED-SL25/75-1000-80-35-PL-4-W-120-DP-1-CA, 1000 LUMENS/FT, 3500K, 75%UP/25%DOWN, FLAT BLADE LOUVER, 0-10 VOLT DIMMING, WHITE FINISH, CABLE MOUNT.		
	SIMPLEX RECEPTACLE		6" RECESSED LED DOWNLIGHT TYPE 'D1' COOPER LIGHTING #PD6 10 ED010 PDM6A 835 61V C, 1.1W, 1000 LUMENS/FT, 3500K		
	DUPLEX RECEPTACLE, 'GFI'-INDICATES GROUND FAULT CIRCUIT INTERRUPTER 'AFI'-INDICATES ARC FAULT CIRCUIT INTERRUPTER 'WP'-WEATHER-PROOF 'AC'-INDICATES ABOVE COUNTER		4' LED INDUSTRIAL FIXTURE TYPE 'F1' COOPER LIGHTING #4SNLED-LD5-30SL-LN-UNV-L835-HCD1-U, 22.1W, 3199 LUMENS/FT, 3500K		
	DUPLEX RECEPTACLE WITH 2-USB CHARGING PORTS, 3.6 AMP SMART OUTPUT. LEVITON T5832 OR EQUAL				
	ABOVE COUNTER GFI DUPLEX RECEPTACLE				
	DATA OUTLET. PROVIDE BOX ABOVE CEILING AND 1" CONDUIT WITH BUSHING AND PULLSTRING FOR INSTALLATION OF CABLE BY OTHERS				
	CEILING MOUNTED WIFI ANTENNA. PROVIDE BOX ABOVE CEILING AND 1" CONDUIT WITH BUSHING AND PULLSTRING FOR INSTALLATION OF CABLE BY OTHERS				

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PH: 518 885 1255 FAX: 518 885 1266 www.brmaarchitects.com



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LEGEND

TITLE

E001


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GENERAL NOTES:

1. REMOVAL DRAWINGS INDICATE DEVICE LOCATIONS, EQUIPMENT CONNECTIONS, AND PANEL LOCATIONS AS OBSERVED IN THE FIELD. EXISTING PANEL INFORMATION IS BASED ON FIELD OBSERVATION AND AS BUILT DRAWINGS. REMOVE ALL ELECTRICAL EQUIPMENT AND DEVICES SHOWN ON THIS DRAWING, UNLESS OTHERWISE INDICATED. REMOVE ALL ASSOCIATED BOXES, CONDUIT, WIRING, ETC BACK TO SOURCE. VERIFY CIRCUITING IN FIELD PRIOR TO REMOVAL.
2. PROVIDE LIFTS, LADDERS AND OTHER EQUIPMENT REQUIRED TO GAIN ACCESS FOR ALL ELEVATED WORK. OWNER'S LIFTS AND LADDERS SHALL NOT BE USED.
3. COORDINATE REMOVALS WITH THE ARCHITECTURAL PHASING PLANS.
4. COORDINATE ALL SHUTDOWNS IN ADVANCE WITH OWNER AND SUBJECT TO OWNER APPROVAL.
5. MAINTAIN CIRCUIT CONTINUITY TO SYSTEMS AND ROOMS ADJACENT TO RENOVATION AND CONSTRUCTION AREAS. PERMANENTLY REPAIR CIRCUITS OR WIRING DISTURBED, MODIFIED, OR DISPLACED BY THE WORK.
6. EXTEND CONDUITS AND CONDUCTORS TO MAINTAIN ELECTRICAL CONTINUITY OF ELECTRICAL EQUIPMENT SERVING AREAS NOT DEMOLISHED AS REQUIRED. THIS APPLIES TO BOTH POWER AND COMMUNICATIONS (DATA AND TELEPHONE) CIRCUITS.
7. UNLESS OTHERWISE NOTED, REMOVE ALL CONDUCTORS AND CONDUIT TO EQUIPMENT BRANCH CIRCUIT BEING REMOVED OR RELOCATED.
8. REPAIR ALL OPEN PENETRATIONS CREATED BY REMOVAL OF ELECTRICAL RACEWAYS.
9. PROVIDE COVERPLATES FOR ABANDONED FLUSH MOUNTED DEVICES.
10. DO NOT ALLOW FIRE ALARM CONTROL PANEL TO REMAIN IN 'TROUBLE' DURING REMOVALS. AFTER COMPLETION OF EACH DAY'S WORK REPROGRAM PANEL OR MAKE REPAIRS TO PLACE PANEL IN 'NORMAL' CONDITION.

KEYED NOTES:

- ① MAINTAIN EXISTING CIRCUIT HOMERUN WHILE REWORKING RECEPTACLE AND WIRING LOCATIONS PER NEW LAYOUT ON POWER PLAN INSTALLATION

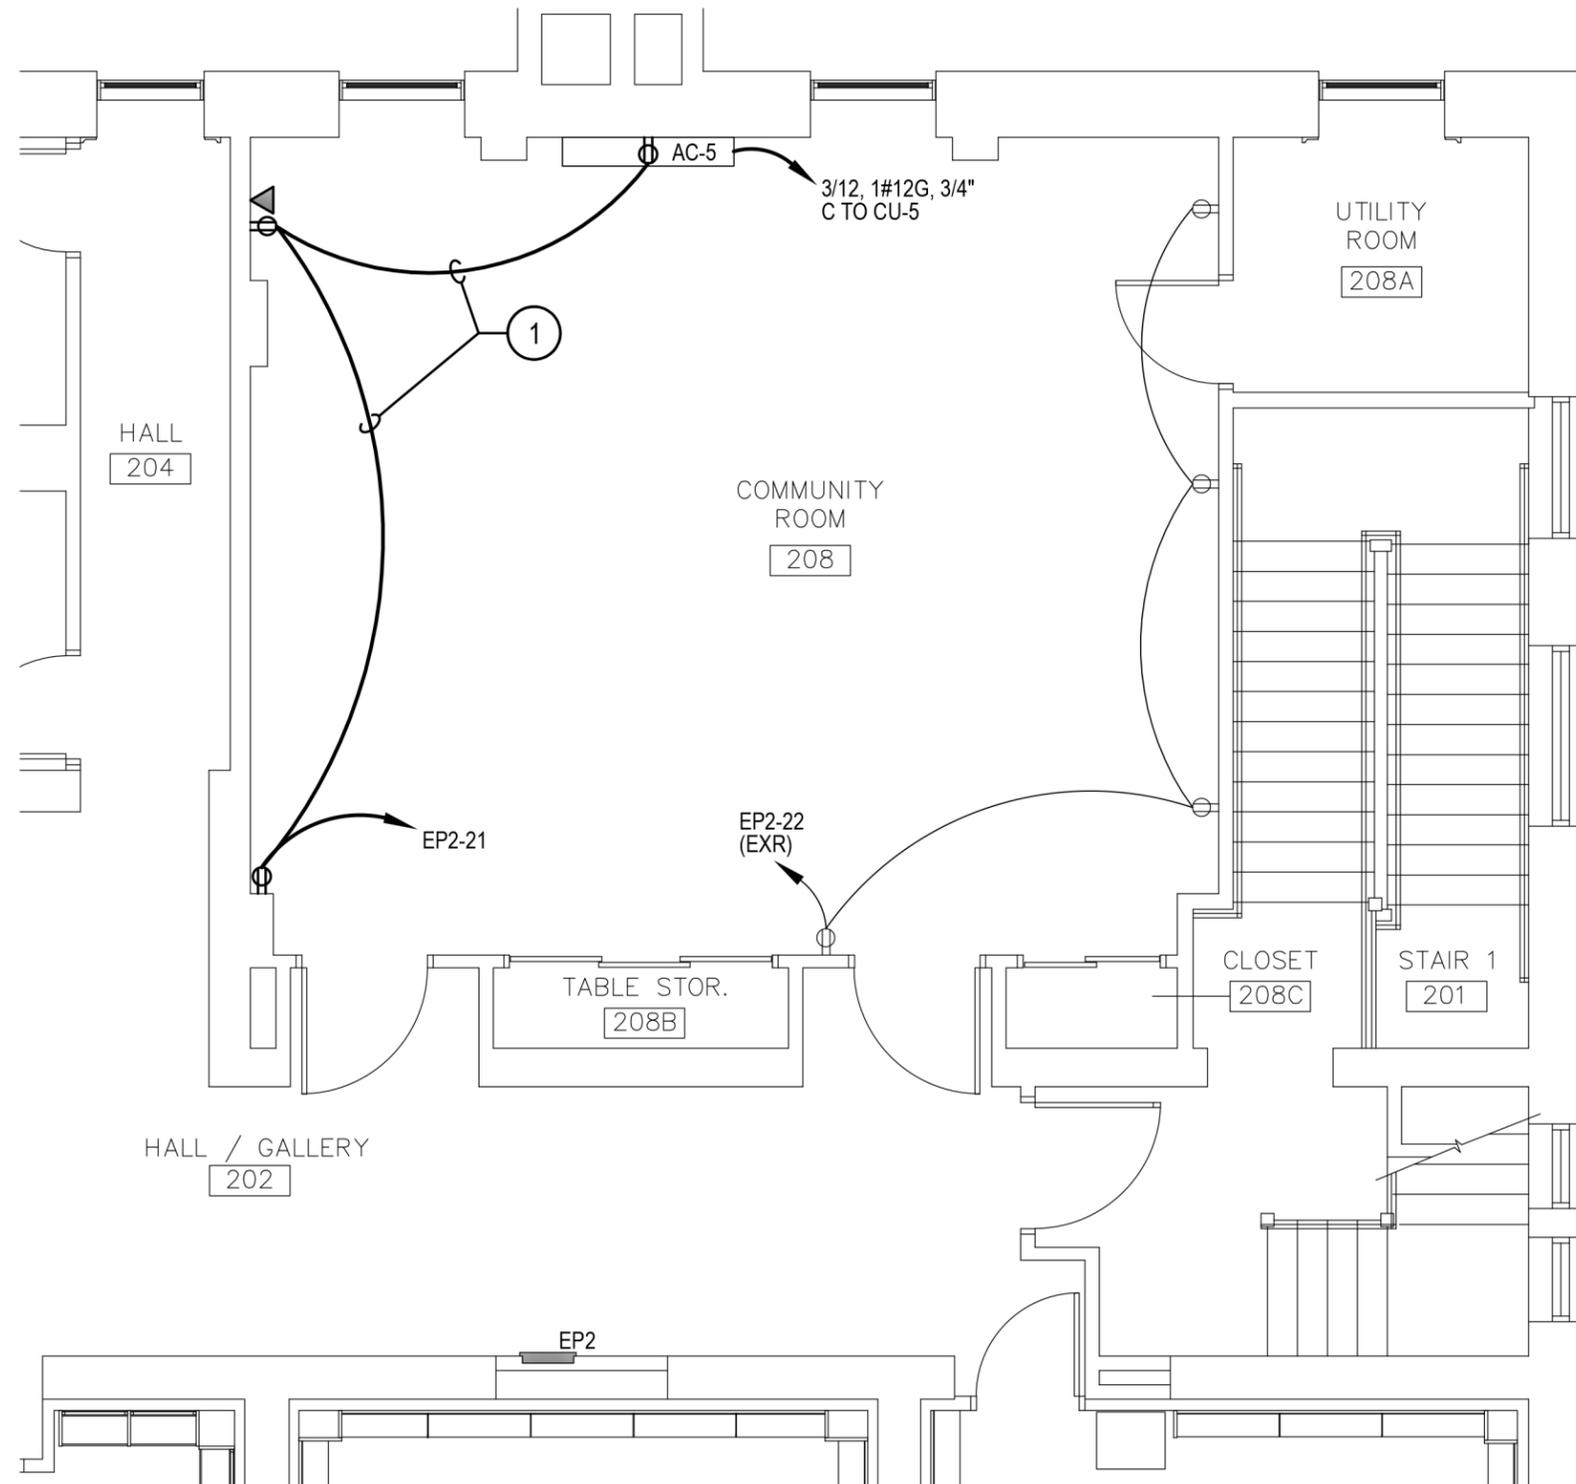

① ENLARGED SECOND FLOOR REMOVAL PLAN - POWER
 ER101 SCALE: 3/16" = 1'-0"

BID SET: 10 OCTOBER 2022

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57 West High Street
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 New York 12020
 PH: 518 785 1255
 FAX: 518 785 1266
 www.brmaarchitects.com



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 9 COLUMBIA CIRCLE
 ALBANY, NY 12203
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ENLARGED SECOND FLOOR REMOVAL PLAN - POWER

TITLE

ER101


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GENERAL NOTES:

- SEE SHEET ER201 FOR GENERAL REMOVAL NOTES

KEYED NOTES:

- DISCONNECT POWER SERVING HVAC EQUIPMENT DESIGNATED FOR REMOVAL. REMOVE ASSOCIATED ELECTRICAL E EQUIPMENT (DISCONNECT, CONDUCTORS, CONDUIT WHERE ACCESSIBLE) BACK TO SOURCE. TURN BREAKERS OFF AND LABEL AS SPARES.

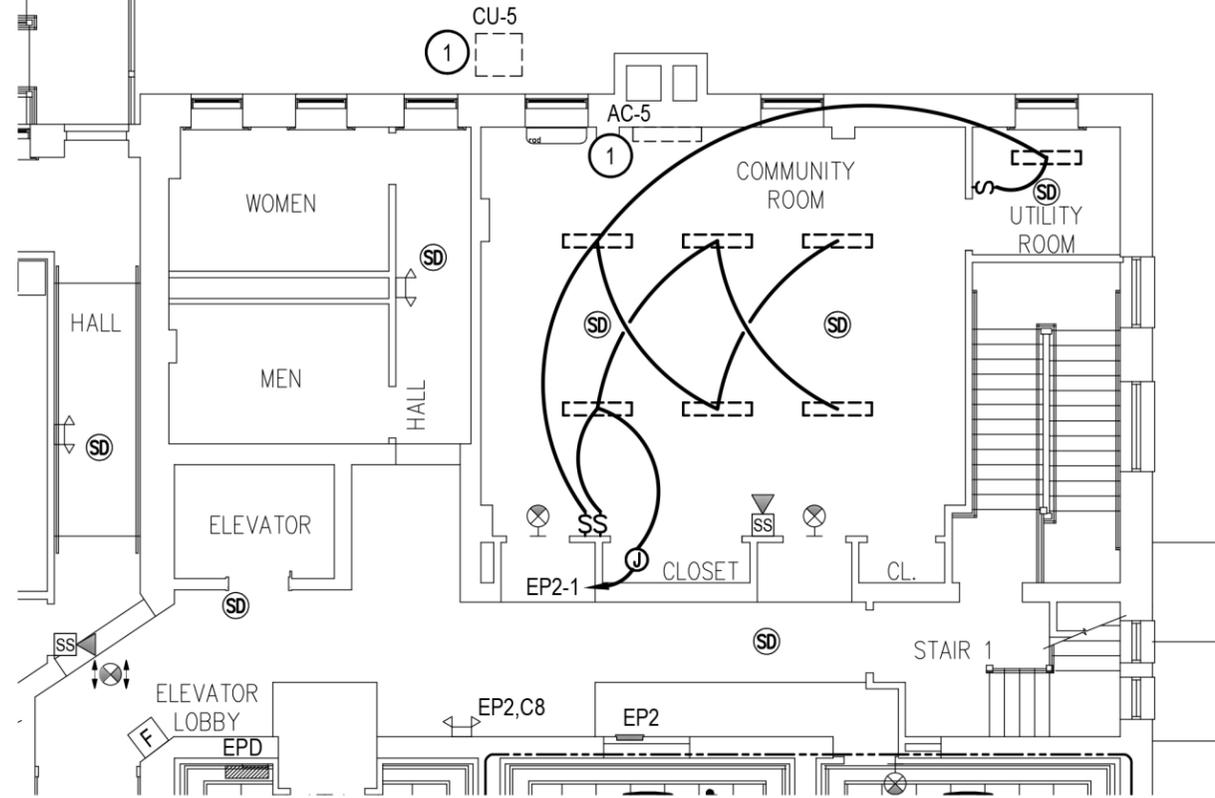

1 OVERALL SECOND FLOOR REMOVAL PLAN – POWER, LIGHTING, AND FIRE ALARM
ER201 SCALE: 3/32" = 1'-0"

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**OVERALL SECOND FLOOR
REMOVAL PLAN - LIGHTING
AND FIRE ALARM**

TITLE

ER201


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GENERAL NOTES:

1. LOCATIONS BASED UPON AVAILABLE DOCUMENTATION AND CASUAL FIELD OBSERVATION. CONFIRM ALL LOCATIONS WITH FIELD OBSERVATIONS, MEASUREMENTS AND INVESTIGATION.
2. OBTAIN SCHEDULE OF ROUTINE DAILY ACTIVITIES AND OF INDIVIDUAL EVENTS FOR THE WORK AREA. SEQUENCE WORK AROUND THE OWNER'S SCHEDULE.
3. PROVIDE LIFTS, LADDERS AND OTHER EQUIPMENT REQUIRED TO GAIN ACCESS FOR ALL ELEVATED WORK. OWNER'S LIFTS AND LADDERS SHALL NOT BE USED.
4. PROVIDE ACCURATE, TYPED, PANEL DIRECTORY FOR ALL PANELS INSTALLED OR MODIFIED AS PART OF THE WORK.
5. FIRESTOP ALL PENETRATIONS THROUGH RATED WALLS AND FLOOR WITH A LISTED FIRESTOP METHOD MATCHING THE F AND T RATINGS OF THE PENETRATED MEDIUM.
6. SEAL ALL PENETRATIONS THROUGH EXTERIOR WALLS OR THROUGH WALLS OR ROOFS SUBJECT TO MOISTURE.
7. COORDINATE WITH OTHER CONTRACTS LOCATIONS OF DISCONNECTS, MOTOR CONTROLLERS AND OTHER ELECTRICAL EQUIPMENT TO PROVIDE REQUIRED CLEARANCES.
8. PROVIDE MOUNTING HARDWARE AND MANUFACTURER'S ACCESSORIES FOR LIGHTING FIXTURES AS REQUIRED FOR A COMPLETE INSTALLATION.
9. CLEAN FIXTURES AND LENSES, AND RELAMP ALL EXISTING FIXTURES TO REMAIN. PROVIDE LAMPS MATCHED TO FACILITY'S EXISTING STANDARD FOR COLOR INDEX. PROVIDE SAME COLOR FOR ALL LAMPS.
10. OBTAIN SERVICES OF FIRE ALARM VENDOR FOR PROGRAMMING, COMMISSIONING, AND INSTALL OF FIRE ALARM SYSTEM.
11. CONNECT EXIT SIGNS AND EMERGENCY LIGHTING UNITS (ELU'S) AHEAD OF LOCAL SWITCHING TO THE SAME CIRCUIT AS THE AREA'S GENERAL LIGHTING.

KEYED NOTES:

1. PROVIDE POWER CONDUCTORS AND A 3 CONDUCTOR #18, UNSHIELDED TWISTED CABLE FOR COMMUNICATIONS FROM THE OUTDOOR UNIT TO THE INDOOR UNIT. PROVIDE A 40A/2P CIRCUIT BREAKER AND A (2) #8, #8 N, #10 G IN 3/4" C CIRCUIT TO FEED SPLIT SYSTEM UNITS.

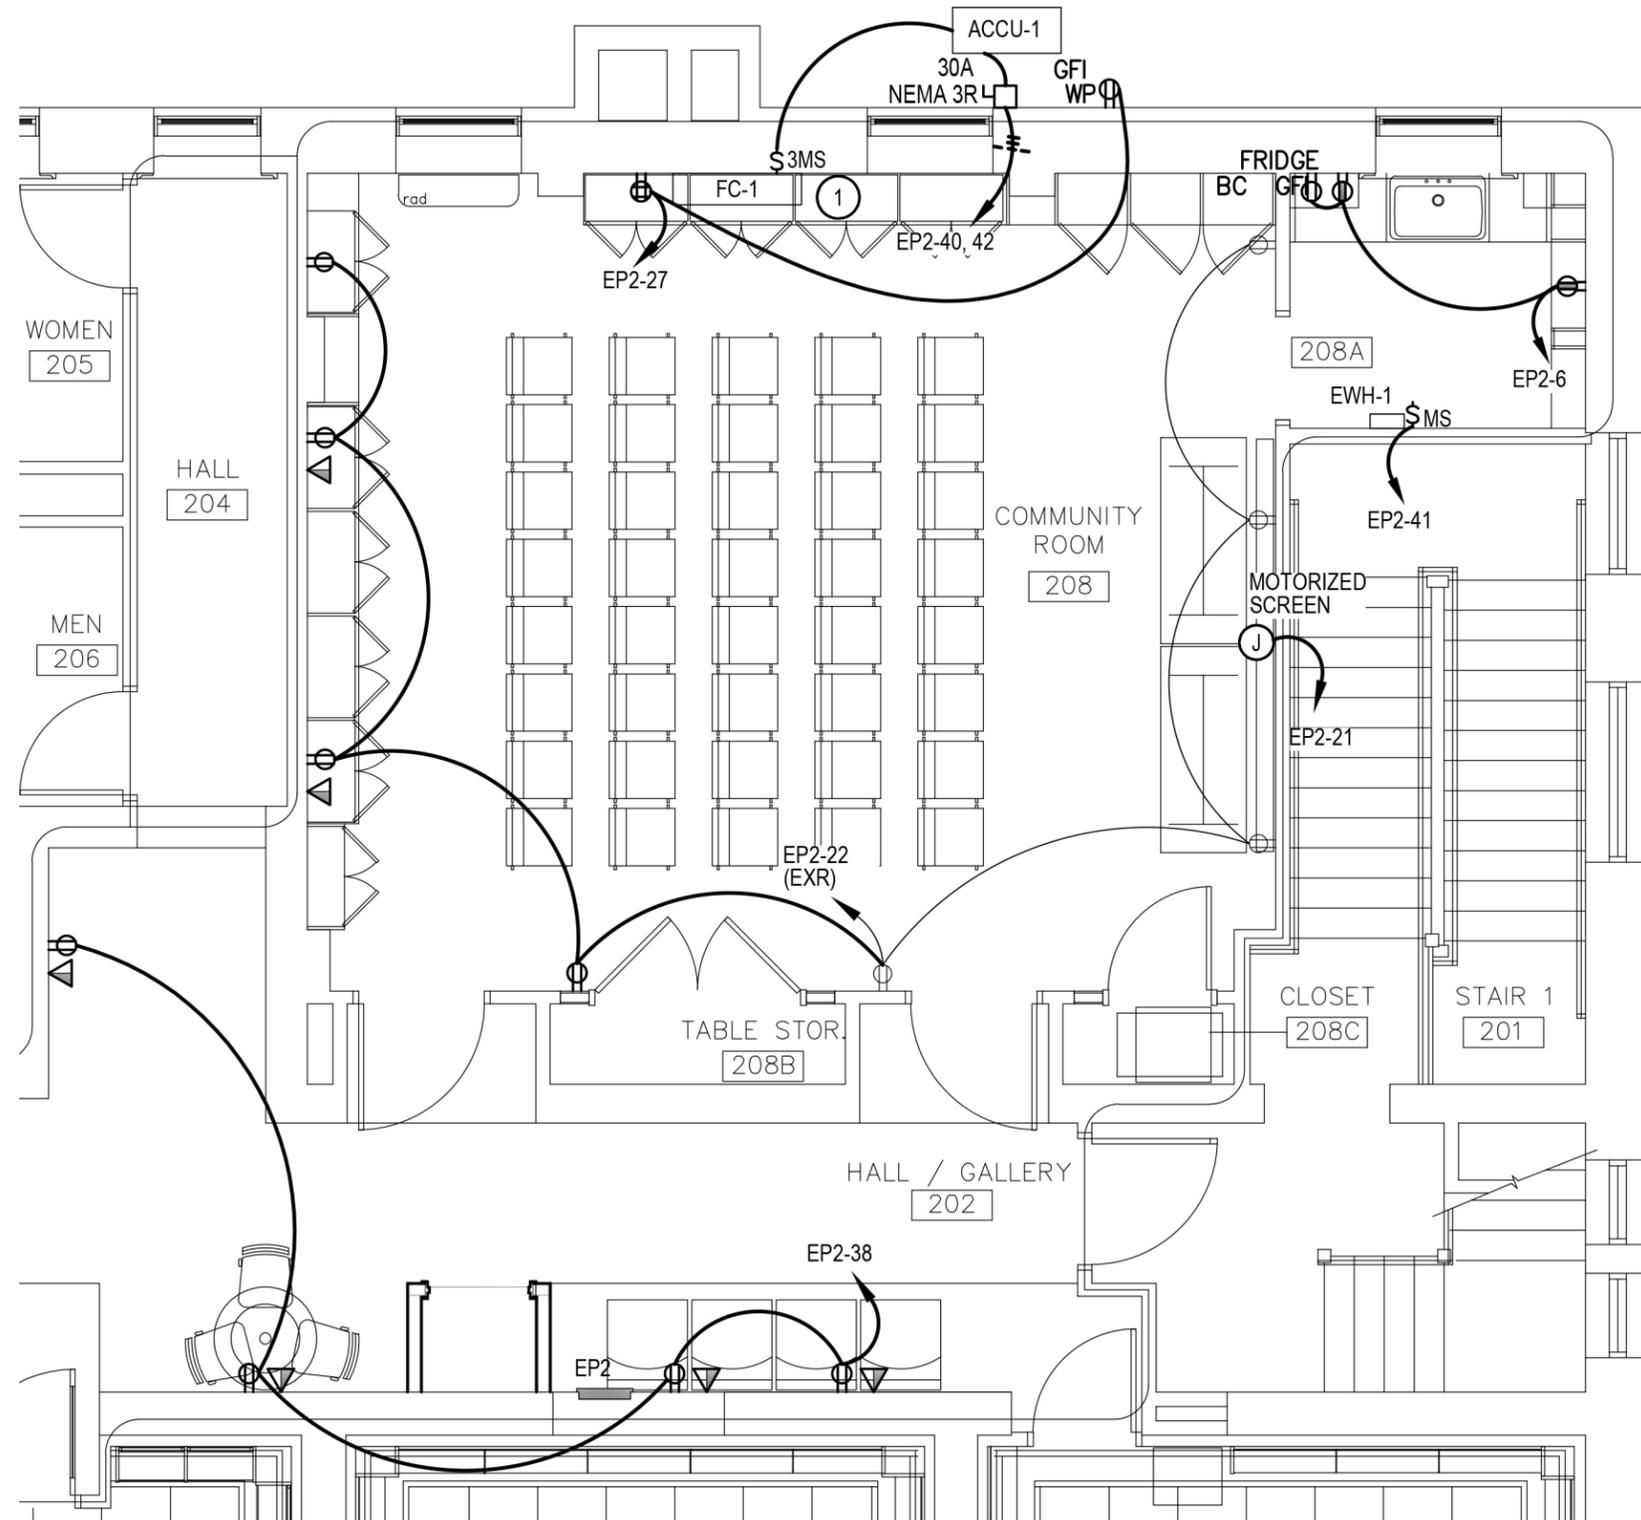

1 ENLARGED SECOND FLOOR PLAN - POWER
E101 SCALE: 3/16" = 1'-0"

BID SET: 10 OCTOBER 2022

ISSUES and REVISIONS

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57 West High Street
Ballston Spa
New York 12020
PH: 518 785 1255
FAX: 518 785 1266
www.brmaarchitects.com



SAGE ENGINEERING
ASSOCIATES, LLP

9 COLUMBIA CIRCLE
ALBANY, NY 12203
(518)453-6091 FAX(518)453-6092

Second Floor
Community
Room
Renovation for
the
**Josephine-Louise
Public Library**



DRAWN BY: AZ
SCALE: AS NOTED
JOB NO.: 19.42.17A
DATE: 10.10.2022

**ENLARGED SECOND
FLOOR PLAN - POWER**


TITLE

E101

DWG. NO.

GENERAL NOTES:

- SEE SHEET E101 FOR GENERAL INSTALLATION NOTES.

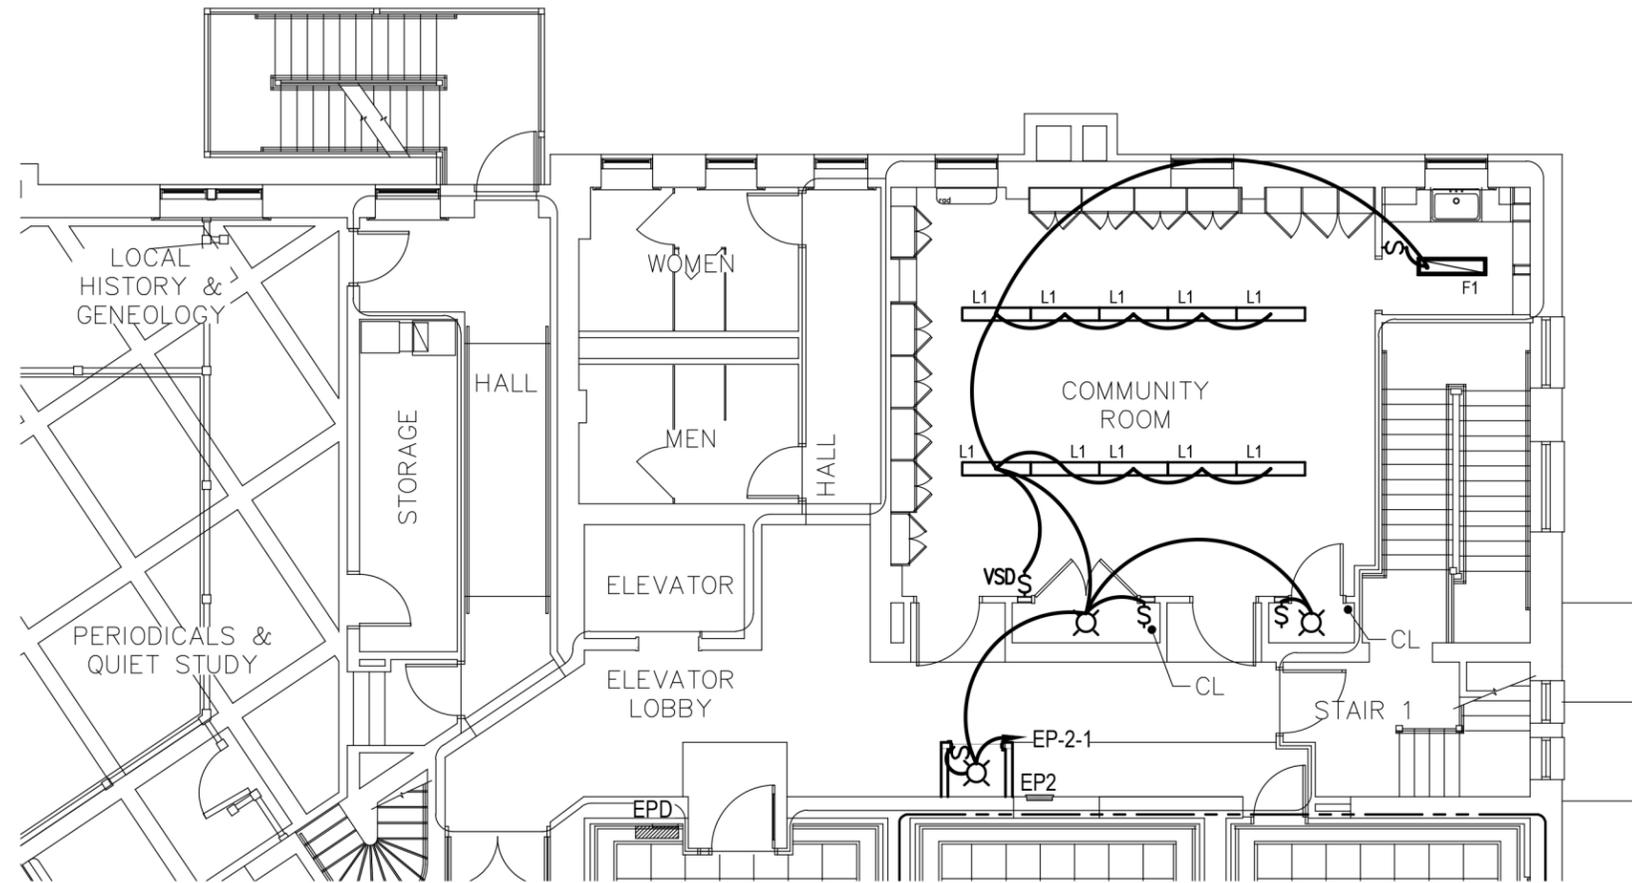

1 OVERALL SECOND FLOOR PLAN – LIGHTING AND FIRE ALARM
 E201 SCALE: 3/32" = 1'-0"

BID SET: 10 OCTOBER 2022

ISSUES and REVISIONS

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 9 COLUMBIA CIRCLE
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**OVERALL SECOND FLOOR
 PLAN - LIGHTING AND FIRE
 ALARM**

TITLE

E201

DWG. NO.