	1	2			3	
	PLUMBING GENERAL NO	TES:	27.	FOR FUTURE FIXTURES FOR #16, ³ ⁄ ₄ " C.W., ³ ⁄ ₄ " H.V	IN UTILITY ROOMS PROVIDE PLU N. FOR #18 AND #20.	JMBIN
1	DRAWINGS ARE DIAGRAMMATIC AND INDIO SYSTEMS AND WORK. FOLLOW DRAWING DRAWINGS OF OTHER TRADES TO VERIFY HEADROOM AND SPACE CONDITIONS.	IN LAYING OUT WORK AND CHECH	20.	REQUIREMENTS OF THE	R INSTALLED IN STRICT CONFOR E NEW YORK CITY PLUMBING CO OS GOVERNING WATER WORK.	
	2. EXACT LOCATIONS OF ALL PLUMBING FIXT EQUIPMENT, AND ACCESSORIES SHALL BE AND/OR PLUMBING DRAWINGS. REFER TO	E AS INDICATED ON ARCHITECTUR			SHALL BE IN STRICT ACCORDANC QUIREMENTS INCLUDING THE RP .IES.	
	FOR DIMENSIONED LOCATIONS. 3. VERIFY LOCATIONS OF FIXTURES, DEVICE ARCHITECTURAL DRAWINGS OF INTERIOR	,	30. NG	PROVIDED WITH APPRO	HALL BE OVER THE RIM SUPPLY VED TYPE VACUUM BREAKERS I , INCLUDING, HOSE BIBB CONNE	INCLU
	OUTLETS AND DEVICES, ALLOW FOR OVER MECHANICAL EQUIPMENTS, VARIATIONS IN WINDOW AND DOOR TRIM, PANELING, HUN CORRECT ANY INACCURACY RESULTING F	N FIREPROOFING AND PLASTERIN NG CEILINGS AND THE LIKE.		OF 8 FEET PER SECOND	LL BE SIZED TO PRODUCE VELO AND SHALL HAVE A MINIMUM O RWISE DIRECTED OR NOTED.	
	EXPENSE TO OWNER. ALL ACCESS DOOR LOCATIONS SHALL BE	REVIEWED BY ARCHITECT PRIOR	32. TO	EXPANSION LOOPS AND HW AND HOT RECIRCUL) ANCHORS SHALL BE PROVIDED ATING PIPING LINES.) FOR
Į	INSTALLATION.	D TO V.A. SPECIFICATIONS AND	33.	ALL CONNECTIONS TO E PROVIDED WITH DIELEC	EQUIPMENT OF DISSIMILAR MATE TRIC UNIONS.	ERIAL
(EXISTING TO BROUGHT UP TO CODE OR O ANY ISSUES WITH NEW LOCATIONS TO BE ATTENTION VERBALLY AND IN WRITING. A	THERWISE SPECIFIED IN WRITING BROUGHT TO ENGINEERING'S	^{9.} 34.	INCLUDING BRANCH FRO	L BRANCH LINES TO EACH FIXTU OM MAINS, AND FROM RISERS. A TH VALVES. ALL EXPOSED VALV	ALL RI
-	APPROVED BY ENGINEERING SERVICE PR CONTRACTOR SHALL PERFORM ALL PLUM LATEST EDITION OF THE NATIONAL PLUME	BING IN ACCORDANCE WITH THE BING CODE, ALL FEDERAL, STATE	35.	WHERE BRANCH SUPPL BRANCH OR MAINS SUP	IES ARE TRAPPED, AT LOW POIN PLY FIXTURES OR EQUIPMENT A OVIDE DRAIN BIBBS ON LINE.	
ş	LOCAL RULES, LAWS, REGULATIONS, VE SPECIFICATION. CONTRACTOR SHALL INSTALL "K" COPPER		36.	PRESSURE REDUCING V WHERE THE PRESSURE	/ALVES SHALL BE PROVIDED ON EXCEEDS 85 P.S.I. TENANT FOF	
(WATER LINES INSTALLE INSTALL IN COPPER WATER LINES INSTALLED AS PART OF THIS DESIGNATED ELSEWHERE IN THE PLANS, S CONTRACTING OFFICER.	S PROJECT, UNLESS SPECIFICALL	Y 37.	ALL VALVES, SHOCK AB CONCEALED SHALL BE F	OWN PRV ASSEMBLY TO SUIT. SORBERS, EXPANSION LOOPS A PROVIDED WITH ACCESS DOORS	
	CONTRACTOR SHALL SOLDER USING LEADCONTRACTOR SHALL CORE DRILL ANY OP		38.		ID FIXTURES FURNISHED BY OTH ERIFY EXACT LOCATION AND PIP	
	DIAMOND CORE DRILL. CONTRACTOR SHA APPROPRIATE WET VACS, DROP CLOTHS, PROTECT GOVERNMENT PROPERTY DURI	OR ANY OTHER DEVICE TO	39.	FABRICATION OR INSTA		
	CONTRACTOR SHALL BE FURTHER ADVISE EXTENDED TO THE FLOOR BELOW.	ED THAT THIS PROTECTION IS	40.	RECESSED CABINETS A	ND EQUIPMENT LOCATED IN PAF N SHALL BE INSTALLED IN STRIC	RTITIC
1	1. CONTRACTOR SHALL INSTALL SLEEVES (B OPENINGS. THIS SLEEVE SHALL BE WIDE WILL BE CONTINUOUS THRU THE SLEEVE.		41.	THE NYS CROSS CONNE	ECTION CONTROL. REFER TO FLOOR PLANS OR SIM	IILAR
1	2. CONTRACTOR SHALL INSULATE ALL HOT V CONDENSATE RETURN, HOT WATER RETU WITH SPECIFIED INSULATION. ELBOWS, TE PLASTIC COVERS FILLED WITH FIBERGLAS ASJ, BANDED AND STAPLED, EXCEPT AS (AND SPECIFICATIONS.	IRN PIPING, INCLUDING ALL FITTIN EE'S, SHALL BE INSULATED WITH SS INSULATION. JACKET SHALL BE	E	SIZES.		
1	3. CONTRACTOR SHALL LABEL ALL PIPING TO CONTENT.	O INDICATE FLOW DIRECTION AND				
1	4. CONTRACTOR SHALL INSTALL 3 PIECE FUL SHUTOFFS.	L PORT BALL VALVES FOR				
1	5. CONTRACTOR SHALL NUMBER AND LABEL THIS CONTRACT WITH BRASS TAGS. NUM THE CONTRACTING OFFICER. CONTRACT CONTRACTING OFFICER A TYPED LIST (4 C AS PART OF THIS PROJECT. THIS LIST SH/ A MINIMUM, THE FOLLOWING INFORMATIO MARK-LOCATION-SIZE-TYPE-MANUFACTUF	BERS SHALL BE AS DESIGNATED E OR SHALL SUBMIT TO THE COPIES) OF ALL VALVES INSTALLE ALL BE INCLUSIVE AND INCLUDE, A N IN TABULAR FORM: VALVE	BY D			
1	6. CONTRACTOR SHALL INSTALL ALL PIPING INDEPENDENTLY SUPPORTED FROM OTHE		ER,			
1	7. CONTRACTOR SHALL USE EXPANSION BOI ANCHORING INTO CONCRETE. USE OF EX WHEN ANCHORING INTO CONCRETE.	· · · · · ·	1			
1	8. CONTRACTOR SHALL SAW CUT ANY INTER ASPHALT BEFORE REMOVING SAME.	RIOR OR EXTERIOR CONCRETE OR				
1	9. CONTRACTOR SHALL INSTALL KEYLESS SI FIXTURES AND TURN OVER TO THE CONTE FOR EACH FIXTURE.		S			
	20. CONTRACTOR SHALL, PRIOR TO THE INST CARRIER, SUBMIT FOR APPROVAL, MANUF ITEMS.					
2	21. CONTRACTOR SHALL TEST, IN THE PRESE OFFICER, ALL PIPING AND SUBMIT TO THE OF THE TESTING REPORT. TESTING SHAL CONTRACT SPECIFICATIONS.	CONTRACTING OFFICER 4 COPIES	6			
	22. CONTRACTOR SHALL SUPPLY AND INSTAL THERMOMETERS, ETC., FOR EASY REMOV		ES,			
2	23. CONTRACTOR SHALL INSTALL DIELECTRIC METALS AND ON ALL FERROUS, NON-FERF					
2	24. CONTRACTOR SHALL ADVISE THE CONTRA MINIMUM OF 48 HOURS PRIOR TO THE SHU THE CONTRACTOR SHALL BE ADVISED THA RESPONSIBLE FOR OPERATING ANY EXIST CONTRACTOR SHALL BE RESPONSIBLE TO ADDITIONAL COST TO THE GOVERNMENT, EXERCISE VALVES WITHOUT THE PROPER	JTOFF OF ANY PLUMBING SYSTEM AT THE VETERANS AFFAIRS IS FING UTILITY VALVE. THE OREPLACE ANY FAILED VALVE AT SHOULD THE CONTRACTOR				
	25. "THERMO VALVE" INDICATES THERMOSTA VALVE.	TIC WATER TEMPERATURE CONTR	ROL			
2	26. DRAINS TO CONSIST OF $\frac{3}{4}$ " GLOBE VALVE	WITH HOSE NIPPLE.				
			NSUL	TANTS:	ARCI	
95% Wo 65% Wo 35% Wo	orking Drawing Submission rking Drawing Submission rking Drawing Submission rking Drawing Submission	08-16-2021 05-21-2021 02-26-2021 06-25-2021				
Revisio		10-05-2018 Date:				
VA EODM	08_6231 OCT 1978					

	4		5			6		
JMBING TEES - 1" C.W.	GENER	۹L	HP	_	AUTOMATIC HOURSE POWER	VP VTR	-	VAPOR PROOF VENT THROUGH
MITY WITH ALL	ABBRE\	/IATIONS:	HT HV	-	HEIGHT HIGH VOLTAGE			ROOF
DE AND ALL PERTINENT	ABV.	ABOVE	HVAC	-	HEATING,	W	-	WIRE
	100	AUTOMATIC DOOR			VENTILATION, & AIR CONDITIONING	W/ WC	-	WITH WATER CLOSET
CE WITH THE BUREAU	A/C	OPENER AIR CONDITIONING	HW	-	HOT WATER	WCO WH	-	WALL CLEAN OUT WALL HYDRANT
Z INSTALLATION AND		ACOUSTICAL CEILING	HWR HWRC	-	HOT WATER RETURN HOT WATER RETURN	WHA	-	WALL HYDRANT WATER HAMMER
OR SHALL BE	A.F	TILE AMPERE FRAME			CIRCULATION	WM	_	ARRESTER WIRE MESH
NCLUDING ALL WATER	A.F.F.	ABOVE FINISHED FLOOR	IN.	-	INCH	WP	-	WASTE PIPE
CTIONS.		AIR HANDLING UNIT	INV EL IW	-	INVERT ELEVATION ICE WATER	WT	-	WATER TIGHT
CITIES NOT IN EXCESS F 20 P. S. I. AT EVERY		ALUMINUM APPROXIMATE	IWR	-	ICE WATER RETURN	XFMR	-	TRANSFORMER
F 20 F. S. I. AI EVERT	1001/	ACID RESISTANT ASSEMBLY						
FOR EXPANSION IN	AT -	AMPERE TRIP	INCAND INTR	-	INCANDESCENT INTERIOR			
	ATS -	AUTOMATIC TRANSFER SWITCH	JB	-	JUNCTION BOX			
ERIAL SHALL BE	AVG.	AVERAGE	LAV	-	LAVATORY			
	BC -		LTCP	-	LOCAL TEMPERATURE			
	BRIP -	BOILER PLANT			CONTROL PANEL			
ALL RISERS AND MAINS (ES & HANDLES SHALL		PANEL	LTG LTS	-	LIGHTING LIGHTS			
	BFP -	BACK FLOW PREVENTER	LV	-	LOW VOLTAGE			
ITS, AND WHERE		BUILDING BACK WATER VALVE	MATV	-	MASTER ANTENNA			
RE LOCATED HIGHER			MCB	_	TELEVISION MAIN CIRCUIT			
	C - CA -	CONDUIT COMPRESSED AIR			BREAKER			
ALL WATER LINES REACH RETAIL SPACES	CCTV -	CLOSED CIRCUIT T.V.	MCC	-	MOTOR CONTROL CENTER			
	CB, C/B CFS -	CIRCUIT BREAKER	MDP	-	MAIN DISTRIBUTION PANEL			
ND OTHER ITEMS	CI -	SECOND CAST IRON	MLO	-	MAIN LUGS ONLY			
S FOR ACCESSIBILITY	CKT -	CIRCUIT	MH MIN	-	MANHOLE MINIMUM			
HERS, THIS	CLG C.M.U.	CEILING ONCRETE MASONRY	MO MTD	-	MASONRY OPENING MOUNTED			
E SIZES PRIOR TO	CO -	UNIT CLEAN OUT	MTG HT	-	MOUNTING HEIGHT			
	CONN -	CONNECTION	Ν	_	NORTH			
Y TO CLEAR ALL	0011	CONTINUED COLD WATER	N/A	-	NOT APPLICABLE			
RTITIONS.		COLD WATER	NC NFSS	-	NEW CONNECTION NON-FUSED SAFETY			
T ACCORDANCE WITH		RETURN	NIC	_	SWITCH NOT IN CONTRACT			
		DIRECT BURIAL	NL	-	NON-CONTROLLED			
ILAR PIPING FOR PIPE	DN -	DOWN SPOUT	NUMB	-	24HR LIGHT NUMBER			
	DROP -	NOZZLE PIPING BETWEEN	NTS	-	NOT TO SCALE			
		FLOORS	OPP	-	OPPOSITE			
	DS - DU -		Р	-	POLE			
	DWO	DISH WASHER DRAWING	PB	-	PULL BOX			
	DINTO	DUMB WAITER	PBPU	-	PREFABRICATED BEDSIDE PATIENT			
	EC -	EMPTY CONDUIT	PIV		POWER UNIT PREVENTATIVE			
		FLOOR DRAIN EMERGANCY EYE		-	INFLUX VALVE			
		WASH	PLBG PNL	-	PLUMBING PANEL			
		EQUIPMENT GROUND	POD	-	POWER OPERATED			
	ELEC.		PRV	-	PRESSURE REDUCING VALVE			
	ELEV. EMERG	ELEVATOR EMERGENCY	PS PTRV	-	PIPE SLEEVE POWER TYPE ROOF			
		EQUIPMENT EXPANSION PROOF			VENTILATION			
	EXT.	EXTERIOR	PWR	-	POWER			
		EXISTING ELECTRIC WATER	RECEPT RGIP	-	RECEPTACLE REMOTE GROUND			
		COOLER			INDICATOR PANEL			
	FA -		RD RISE	- -	ROOF DRAIN PIPE RISE BETWEEN			
	FACP -	FIRE ALARM	RM		FLOORS ROOM			
			RPZ	-	REDUCE PRESSURE			
	FF -	FLOOR DRAIN FINISH FLOOR			ZONE			
	FHR - FI -	FIRE HOSE & RACK	S SC	-	SANITARY SHOWER CURTAIN			
	F 1	FIXTURE FLOOR	SH	-	SHOWER HEAD			
	FLUOR -	FLUORESCENT	SHR SIG	-	SHOWER SIGNAL			
	5005	FIRE RISER	SP	-	SOIL PIPE			
		CONTROL SWITCH	SS STA	-	SAFETY SWITCH STATION			
	FSS -	FUSED SAFETY SWITCH	SQ FT	-	SQUARE FEET			
	G -	GAS	TC	-	TERRA COTTA			
	GEN.	GENERATOR	TMV	-	THERMOSTATIC MIXING VALVE			
	GFI -	GROUND FAULT	TH./THK. TW	-	THICKNESS TEMPERED WATER			
		GROUND GALLONS PER HOUR	TWRC	-	TEMPERED WATER			
		GALLONS PER			RETURN CIRCULATION			
	GTB -	MINUTE GROUND TERMINAL	TYP	-	TYPICAL			
	BOX		UH	-	UNIT HEATER			
		GYPSUM GYPSUM WALL	UON	-	UNLESS OTHERWISE NOTED			
		BOARD	UR	-	URINAL			
	HACR -		V	-	VENT			
		CONDITION REFRIGERATION	VB VCT	-	VACUUM BREAKER VINYIL COMPOSITE			
		HOSE BIBB		-	TILE			
	HM -	HOLLOW METAL	VENT VEST	-	VENTILATION VESTIBULE			
	HOA -	HAND OFF	VIF	-	VERIFY IN FIELD			

ITECT/ENGINEERS:	NORTH:	APPROVED:	APPROVED:
	S	APPROVED:	APPROVED:
		APPROVED:	APPROVED:
	*	APPROVED:	APPROVED:

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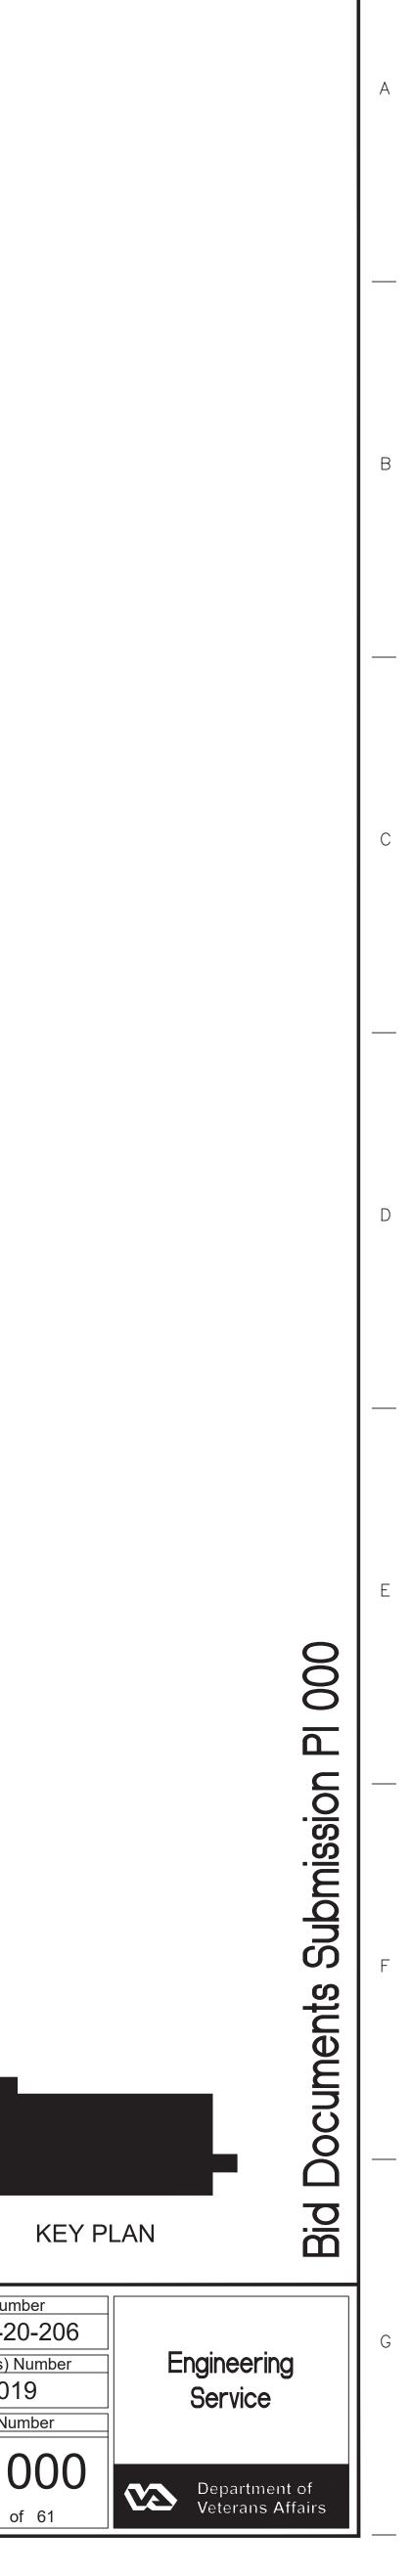
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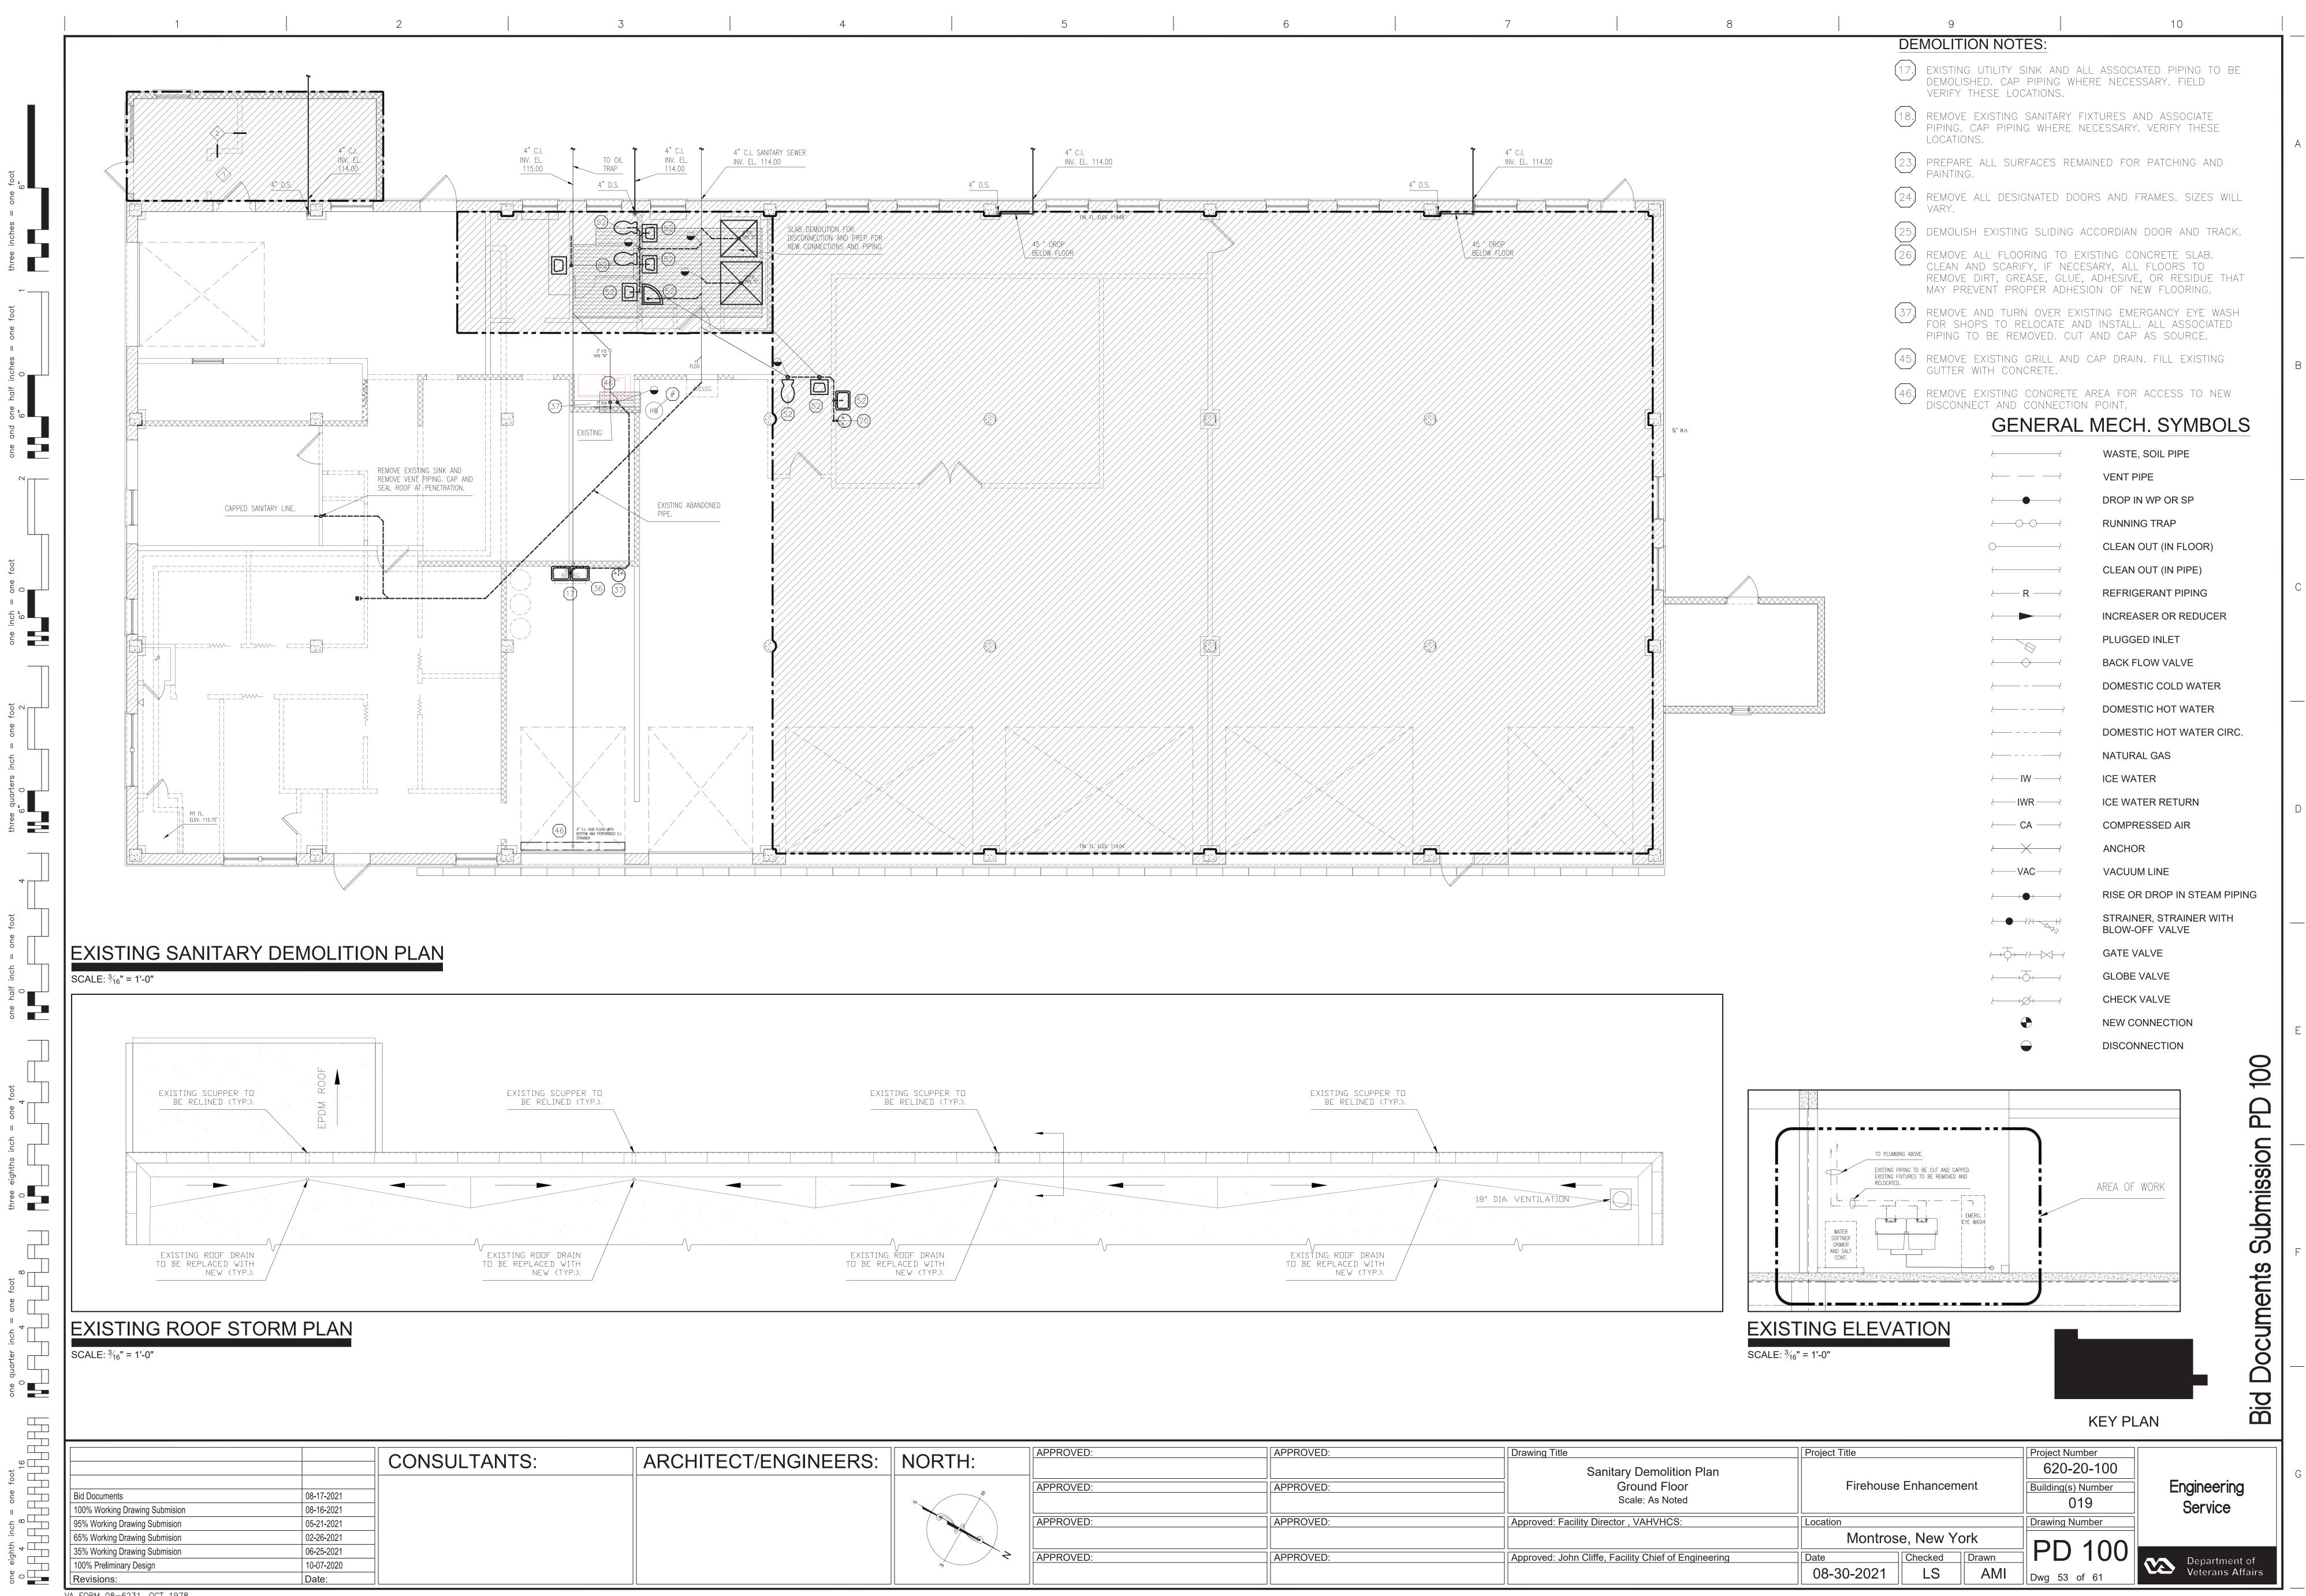
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GENERAL PLI	JMB. SYMBOLS
<u>}</u>	WASTE, SOIL PIPE
<u>}</u>	VENT PIPE
}	DROP IN WP OR SP
·	RUNNING TRAP
$\bigcirc \longrightarrow \\$	CLEAN OUT (IN FLOOR)
├ ──── `	CLEAN OUT (IN PIPE)
<u> </u>	REFRIGERANT PIPING
<i>≿</i> }	INCREASER OR REDUCER
~~~~~~~~~~~~~~~~~~~~~~~~~~~~~~~~~~~~~~~	PLUGGED INLET
	BACK FLOW VALVE
<u>}</u>	DOMESTIC COLD WATER
	DOMESTIC HOT WATER
<u>}</u>	DOMESTIC HOT WATER CIRCULATION
	NATURAL GAS
⊱	ICE WATER
₩R	ICE WATER RETURN
← CA − →	COMPRESSED AIR
X	ANCHOR
<u>}</u> +●+}	RISE OR DROP IN STEAM PIPING
	STRAINER, STRAINER WITH BLOW-OFF VALVE
╧┿╤	GATE VALVE
;+ <u>↓</u> ++	GLOBE VALVE
<i>}</i> →→	CHECK VALVE
	$\prec$ PRESSURE REDUCING VALVE AND BYPASS
×++++++++++++++++++++++++++++++++++++	AUTOMATIC ZONE CONTROL VALVE AND
<	THERMOSTATIC STEAM TRAP
·+⊗+	FLOAT AND THERMOSTATIC STEAM TRAP
	TWO-WAY TEMPERATURE CONTROL (MODULATING) VALVE
<i>↓</i>	THERMOMETER
	PRESSURE GAUGE WITH NEEDLE VALVE COCK.
	DISCONNECTION POINT
	NEW CONNECTION POINT
CO	CARBON MONOXIDE GAS SENSOR
$(CO_2)$	CARBON DIOXIDE GAS SENSOR
$\langle S \rangle$	SMOKE DETECTOR
ALD	AUTOMATIC ELECTRICAL OPERATING DAMPER
$\checkmark$	PRESSURE GAUGE
	VOLUME DAMPER
T	THERMOSTAT - ELECTRIC (24V) - NON-PROGRAMMABLE
(17)	THERMOSTAT - 7 DAY PROGRAMMABLE
TS	TEMPERATURE SENSOR
H	SPACE HUMIDISTAT
HP	SPACE HUMIDITY SENSOR
CSP	UNIT CONTROL SYSTEM PILOT
	LOW/HIGH LIMIT DUCT THERMOSTAT
(PSH)	PRESSURE SENSOR SWITCH HIGH
PSL	

Drawing Title	Project Title			Project Numb
Plumbing Notes, Abbrev., & Symbols Legend	Firehouse Enhancement			620-20
Ground Floor				Building(s) N
Scale: As Noted				
Approved: Facility Director , VAHVHCS:	Location			Drawing Nun
	Montrose, New York			
Approved: John Cliffe, Facility Chief of Engineering	Date	Checked	Drawn	
	08-30-2021	LS	AMI	Dwg 50 of






		CONSULTANTS:	ARCH
Bid Documents	08-17-2021		
100% Working Drawing Submision	08-16-2021		
95% Working Drawing Submision	05-21-2021		
65% Working Drawing Submision	02-26-2021		
35% Working Drawing Submision	06-25-2021		
100% Preliminary Design	10-07-2020		
Revisions:	Date:		

HITECT/ENGINEERS:	NORTH:	APPROVED:	APPROVED:
	6 <b>1</b>	APPROVED:	APPROVED:
		APPROVED:	APPROVED:
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Drawing Title	Project Title	Project Title		
 Ground Floor Scale: As Noted	Firehouse	e Enhancem	nent	620- Building(s
Approved: Facility Director , VAHVHCS:	Location			Drawing I
	Montros	Montrose, New York		
Approved: John Cliffe, Facility Chief of Engineering	Date 08-30-2021	Checked LS	Drawn AMI	Dwg 53

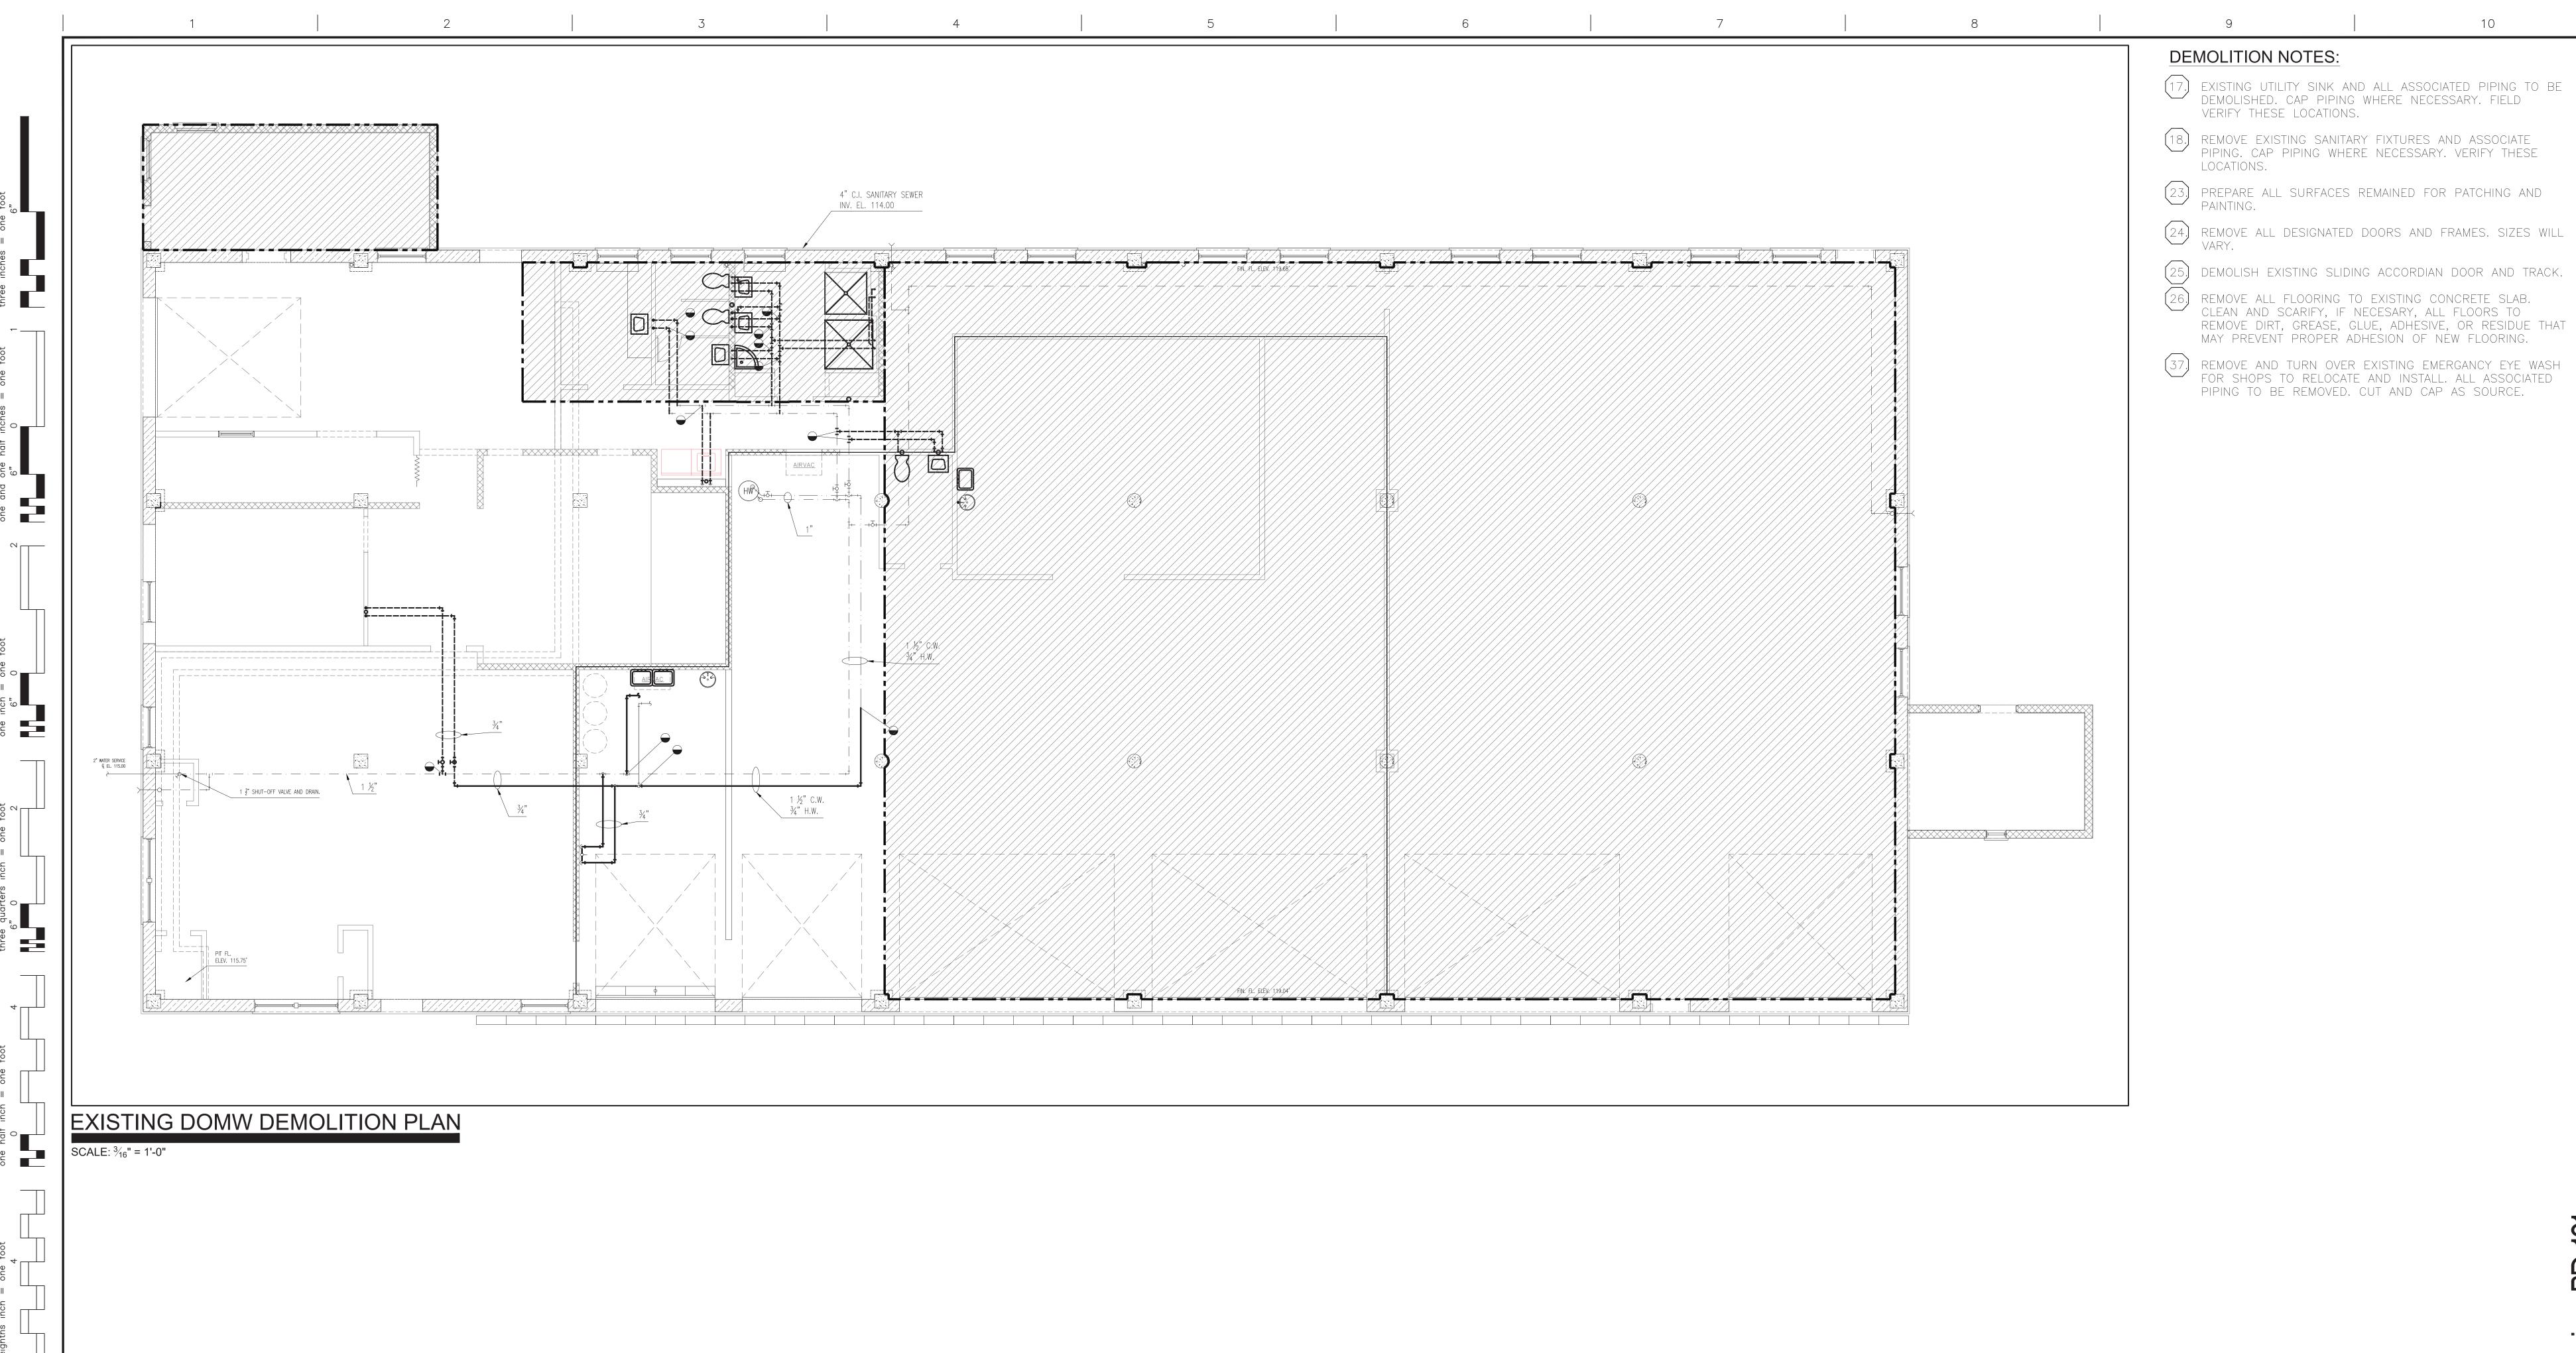


		CONSULTANTS:	ARCHITECT/ENGINEERS:	NORTH:	APPROVED:	APPROVED
Bid Documents	08-17-2021			~ ~ ~	APPROVED:	APPROVED
100% Working Drawing Submission	08-16-2021					
95% Working Drawing Submission	05-21-2021				APPROVED:	APPROVED
65% Working Drawing Submission	02-26-2021					
35% Working Drawing Submission	06-25-2018				APPROVED:	APPROVEI

ine foot

Drawing Title	Project Title	Project Title		
Existing DOMW Demolition Plan Ground Floor Scale: As Noted	Firehouse Enhancement		620-2 Building(s)	
Approved: Facility Director , VAHVHCS:	Location			Drawing N
	Montrose, New York			
Approved: John Cliffe, Facility Chief of Engineering	Date	Checked	Drawn	
	08-30-2021	LS	AMI	Dwg 52

VHERE NECESSARY. FIELD
FIXTURES AND ASSOCIATE NECESSARY, VERIFY THESE
EMAINED FOR PATCHING AND
OORS AND FRAMES. SIZES WILL
G ACCORDIAN DOOR AND TRACK
EXISTING CONCRETE SLAB. ICESARY, ALL FLOORS TO JE, ADHESIVE, OR RESIDUE THA IESION OF NEW FLOORING.
EXISTING EMERGANCY EYE WASH AND INSTALL. ALL ASSOCIATED UT AND CAP AS SOURCE

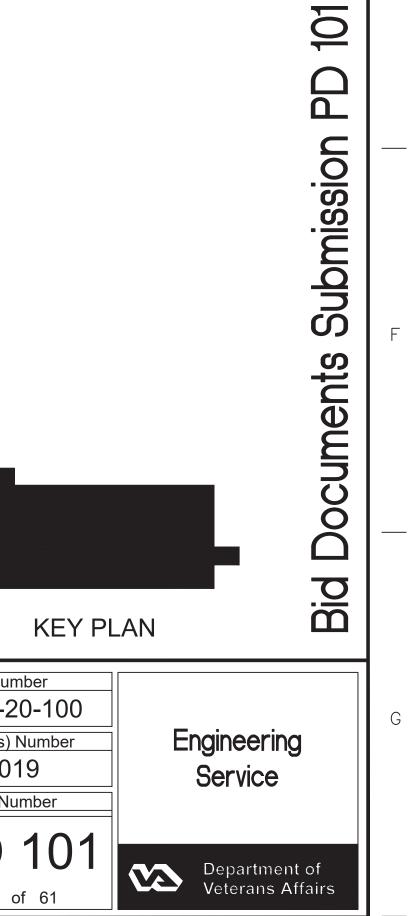





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Drawing Title	Project Title			Project Numb
Existing Plumbing Details Demolition				620-20
Ground Floor	Firehouse	e Enhancem	nent	Building(s) N
Scale: As Noted				01
Approved: Facility Director , VAHVHCS:	Location			Drawing Num
	Montros	se, New Y	ork	
Approved: John Cliffe, Facility Chief of Engineering	Date	Checked	Drawn	
	08-30-2021	LS	AMI	Dwg 53 of



NEW SANITARY PLUMBING PLAN

SCALE: ³/₁₆" = 1'-0"
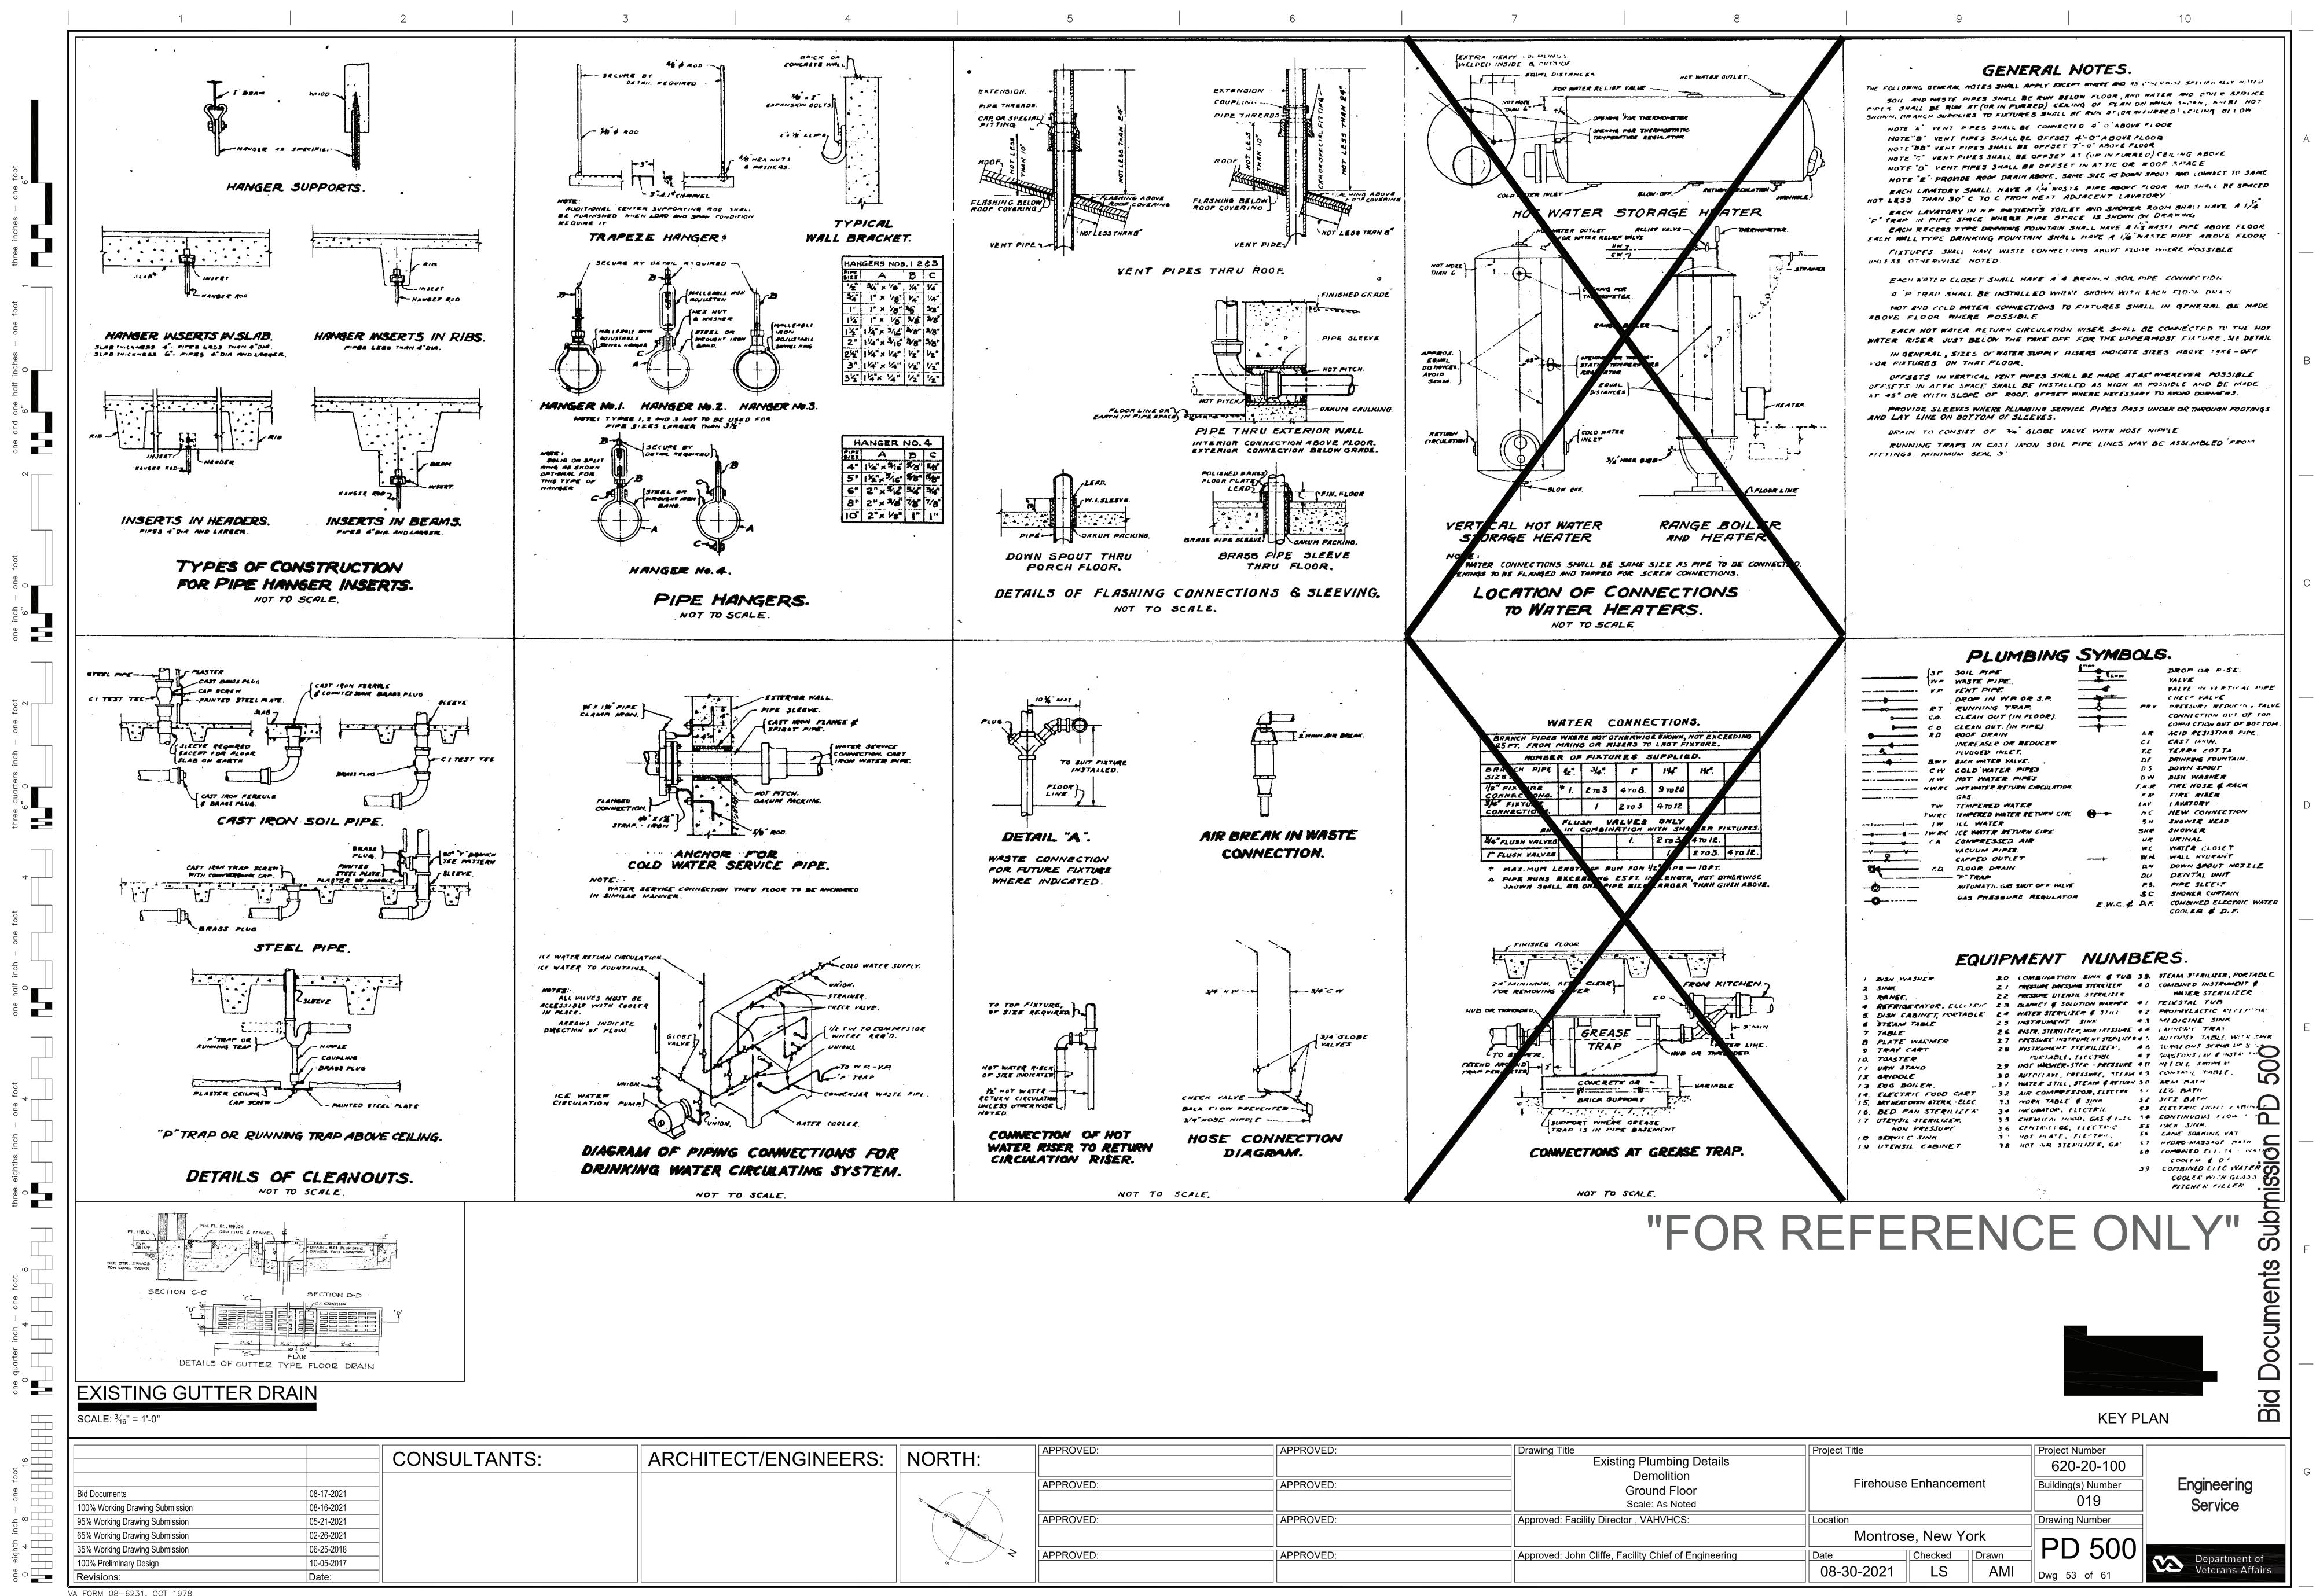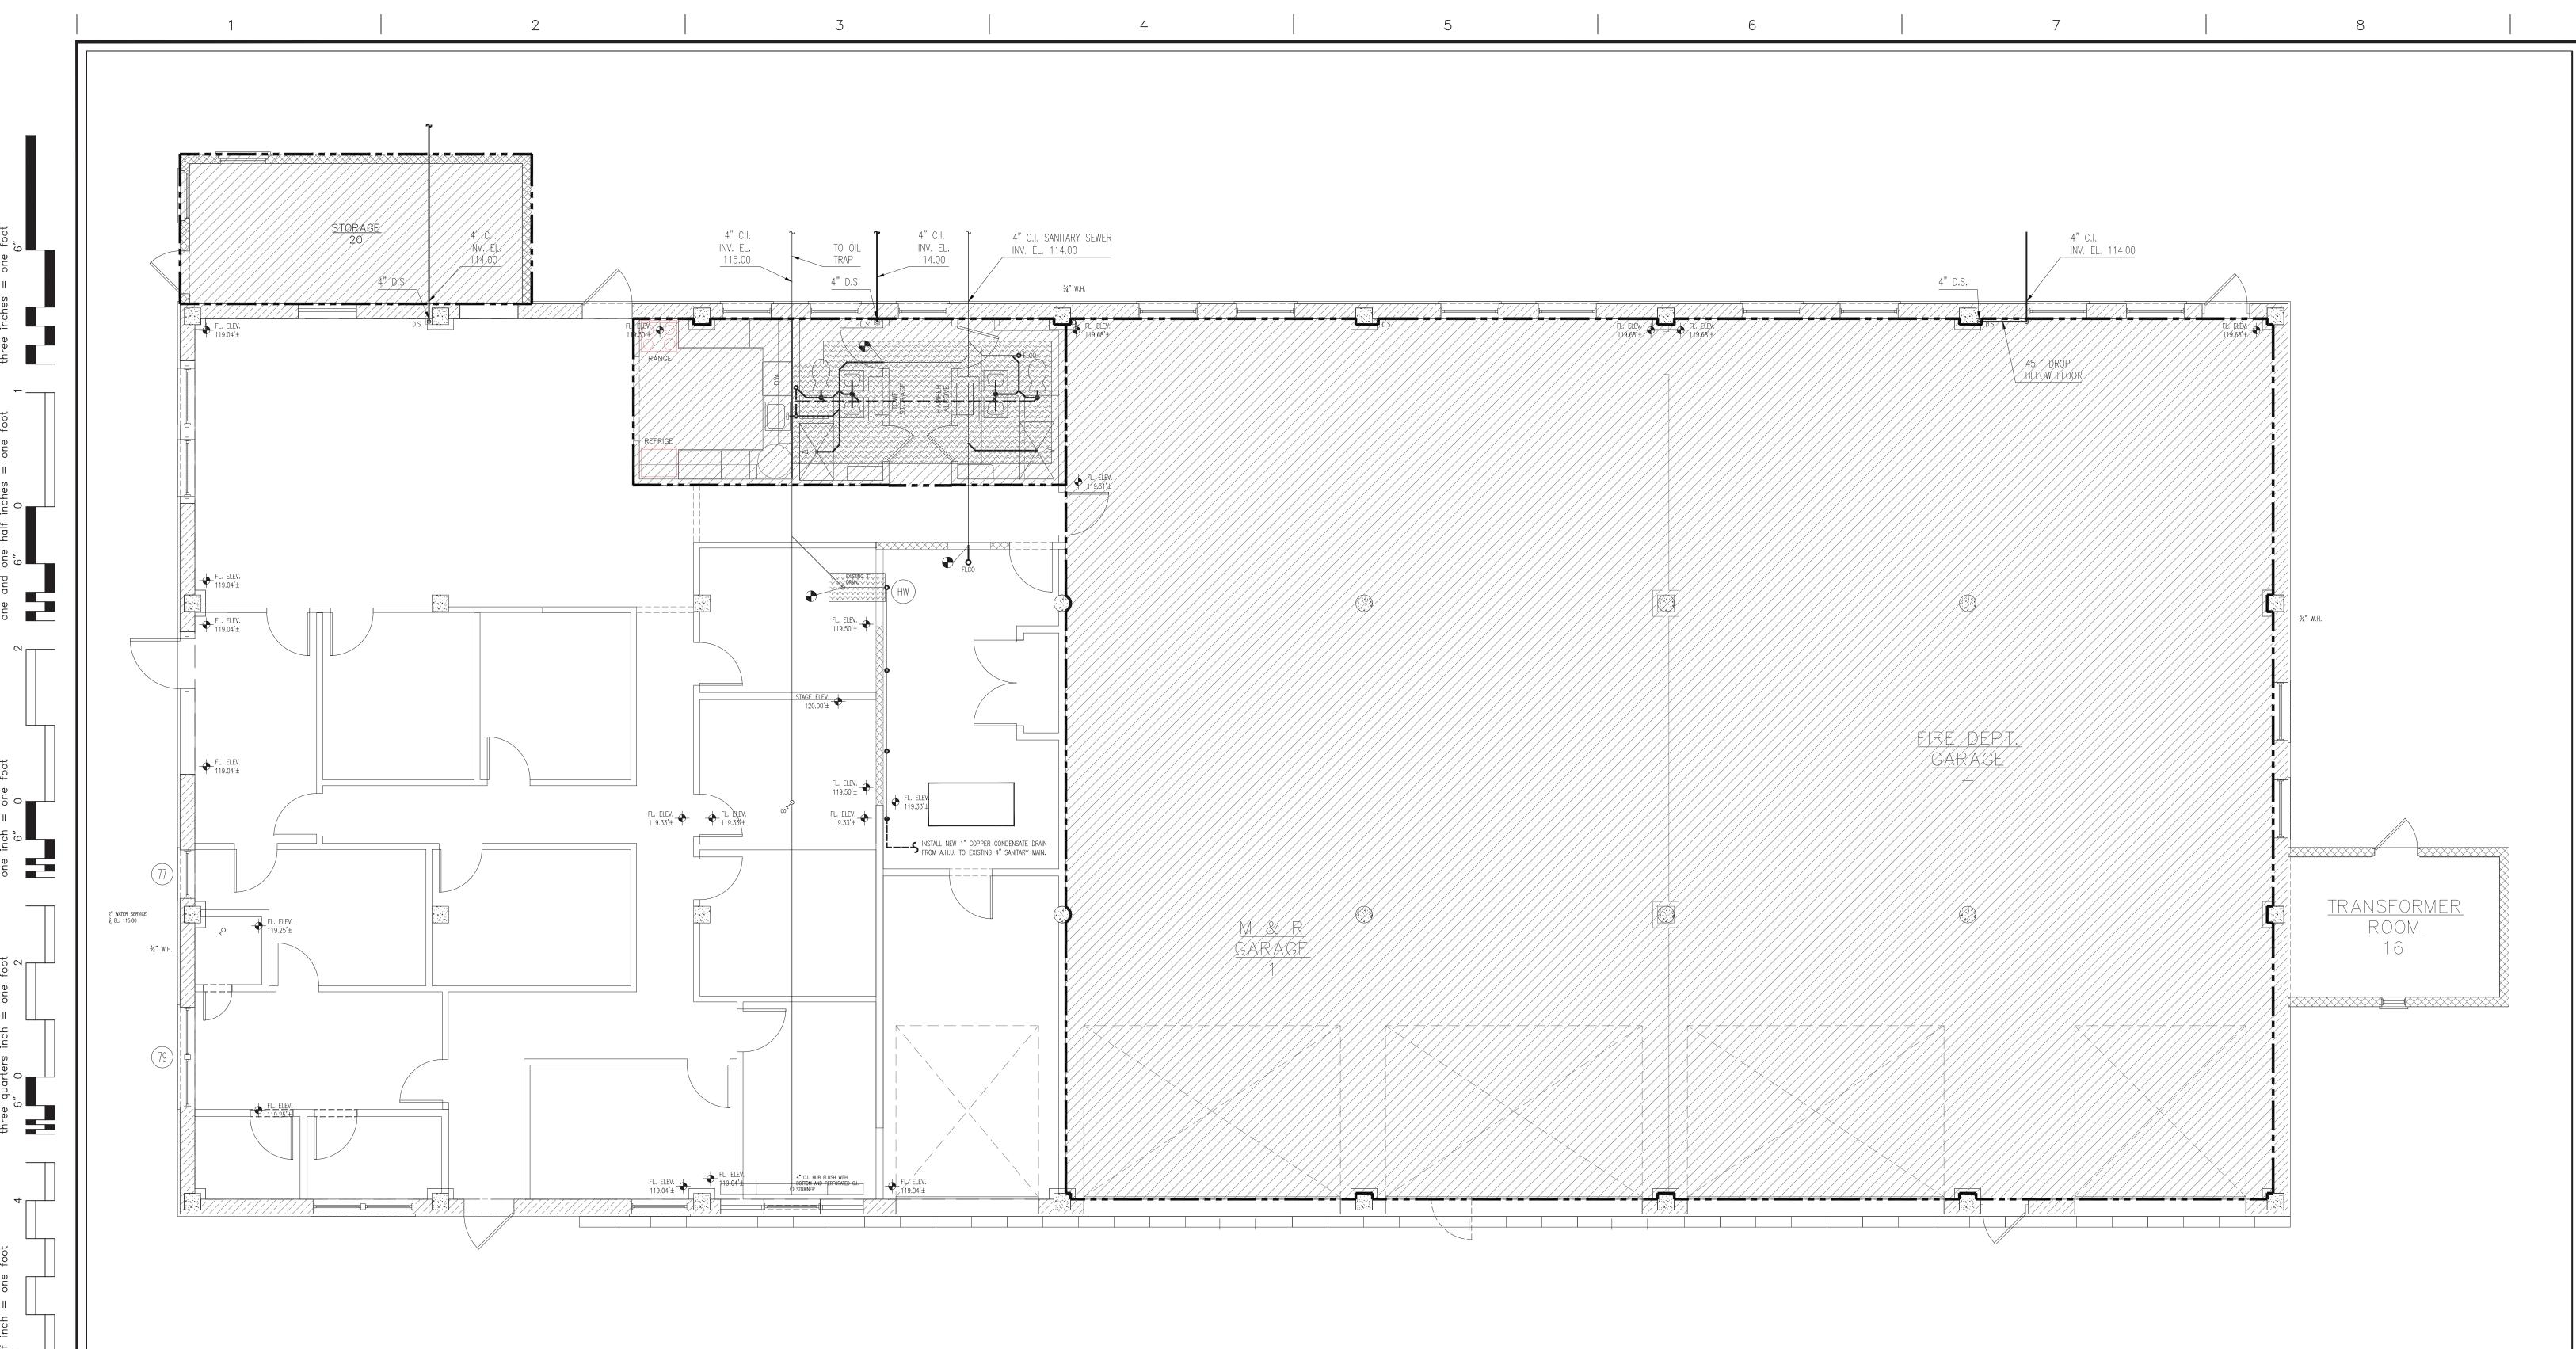
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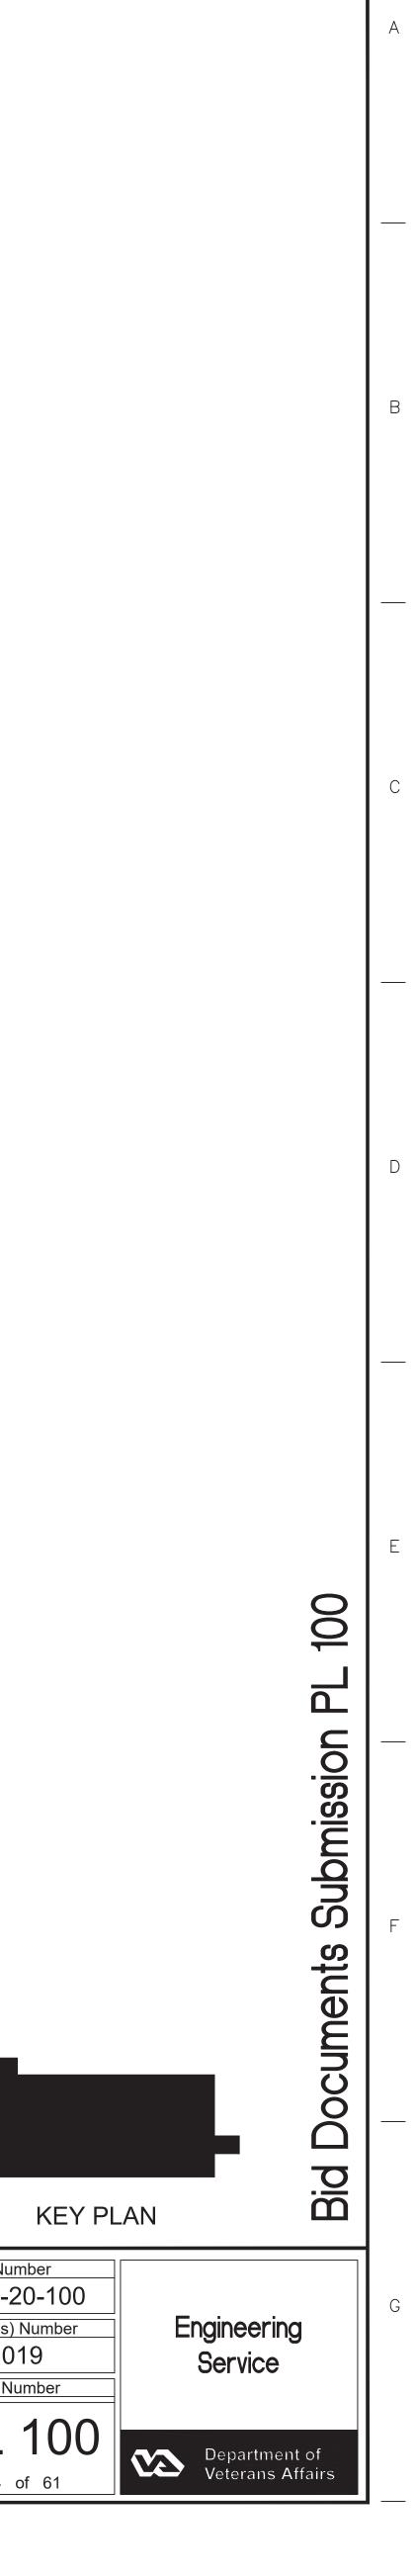
Larter inch = one foot


oue one

one eighth inch = one foot $0 \quad 4 \quad 8 \quad 16$ $0 \quad 4 \quad 8 \quad 16$

		CONSULTANTS:	ARCHITECT/ENGINEERS:	NORTH:	APPROVED:	APPROVED:
Bid Documents	08-17-2021	_		× *	APPROVED:	APPROVED:
100% Working Drawing Submission	08-16-2021					
95% Working Drawing Submission	05-21-2021				APPROVED:	APPROVED:
65% Working Drawing Submission	02-26-2021					
35% Working Drawing Submission	06-25-2018				APPROVED:	APPROVED:
100% Preliminary Design	10-07-2017				AFFROVED.	AFFROVED.
Revisions:	Date:					


Drawing Title	Project Title	Project Title				
New Sanitary Connections Plan				620-2		
Ground Floor	Firehouse	e Enhancen	nent	Building(s)		
Scale: As Noted				0		
Approved: Facility Director , VAHVHCS:	Location			Drawing N		
	Montros	se, New Y	ork			
Approved: John Cliffe, Facility Chief of Engineering	Date	Checked	Drawn			
	08-30-2021	LS	AMI	Dwg 54		




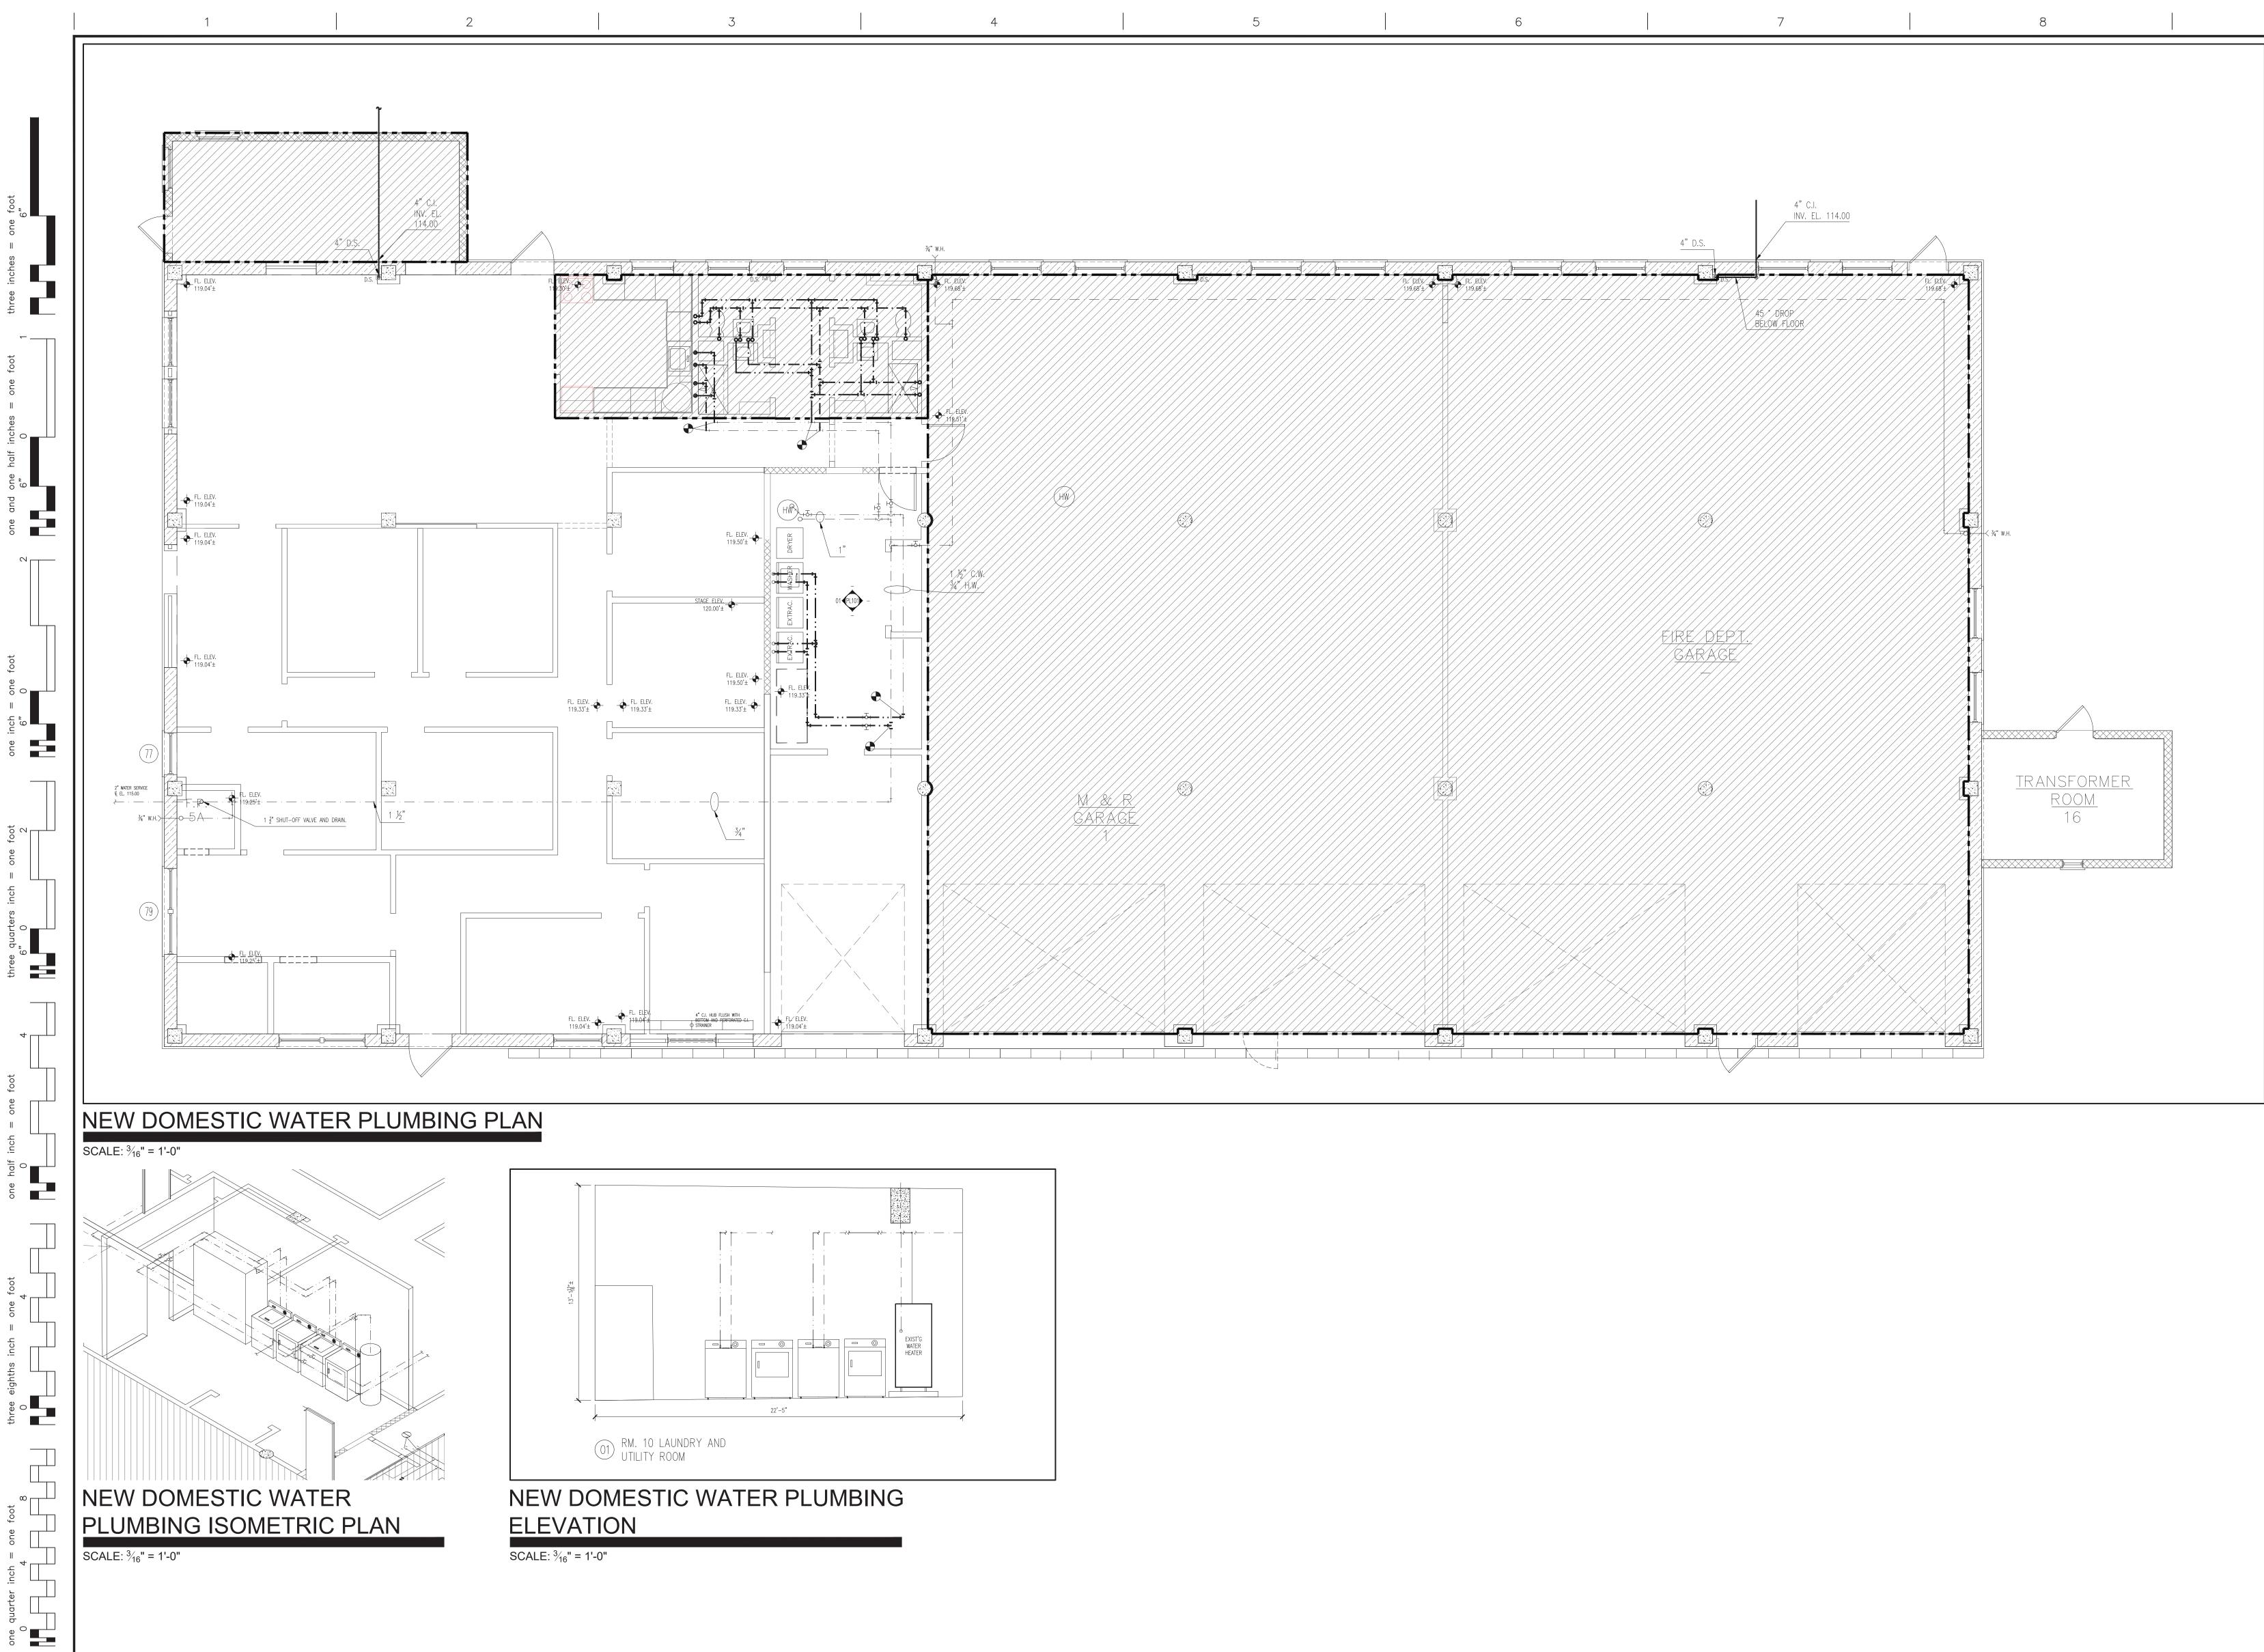

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Did Decumente	09.17.2021				APPROVED:	APPROVEI
Bid Documents 100% Working Drawing Submision	08-17-2021					
95% Working Drawing Submision	05-21-2021				APPROVED:	APPROVEI
65% Working Drawing Submision	02-26-2021					
35% Working Drawing Submision	06-25-2018				APPROVED:	APPROV

Drawing Title	Project Title	Project Nu			
New Domestic Water Plumbing Plan Ground Floor Scale: As Noted	Firehouse Enhancement				
Approved: Facility Director , VAHVHCS:	Location Montros	′ork	Drawing N		
Approved: John Cliffe, Facility Chief of Engineering	Date 08-30-2021	Checked LS	Drawn AMI	Dwg. 55	

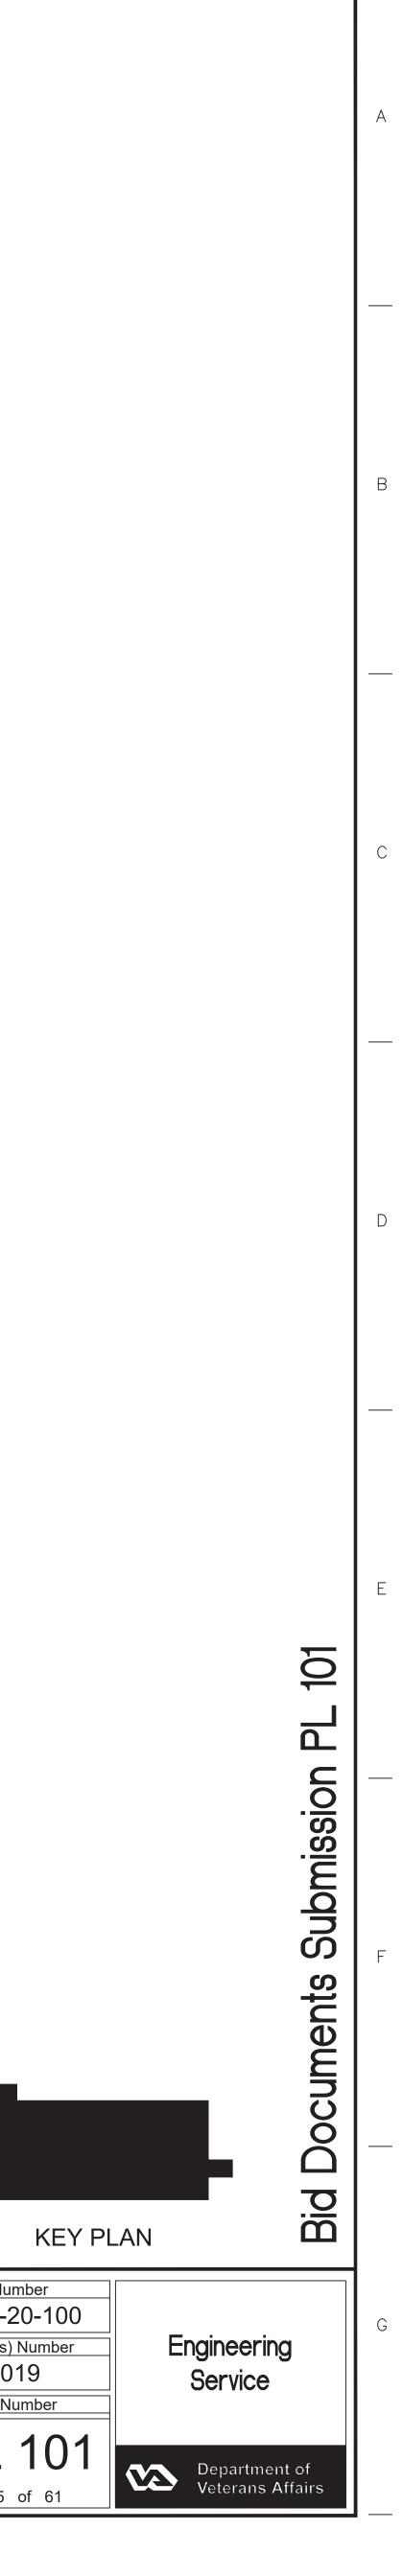

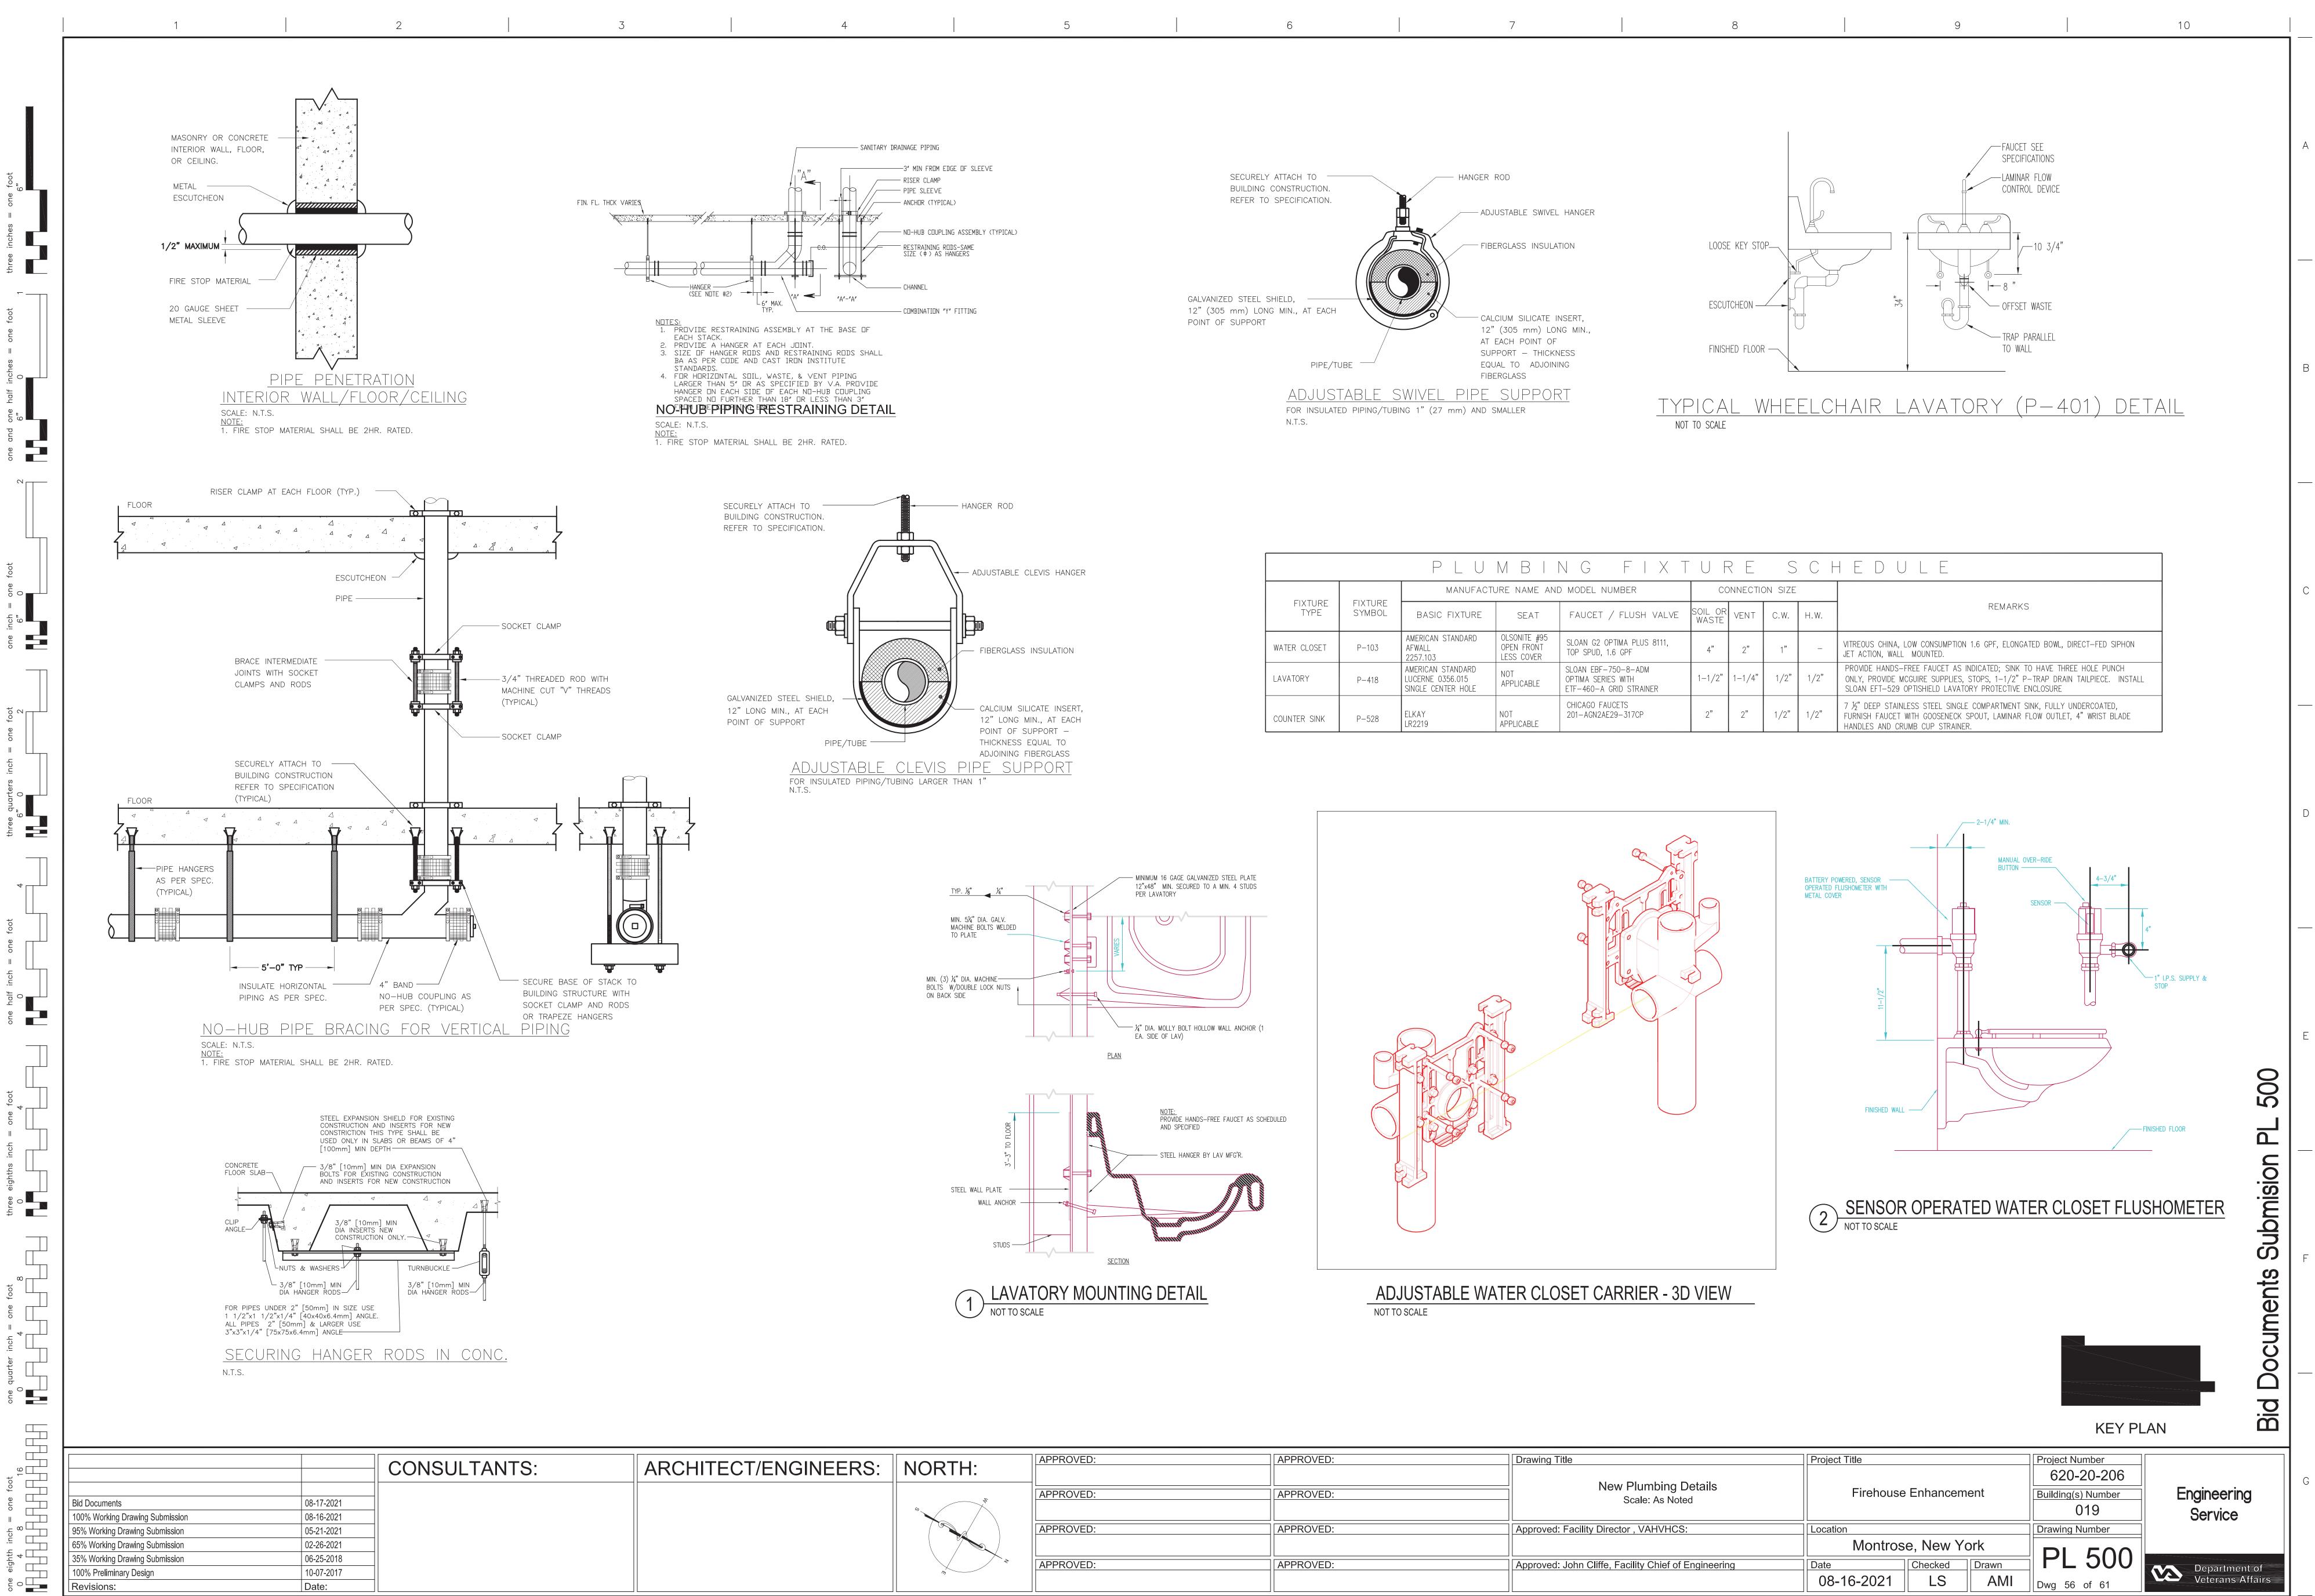

HITECT/ENGINEERS:	NORTH:	APPROVED:	APPROVED:
	S N	APPROVED:	APPROVED:
		APPROVED:	APPROVED:
		APPROVED:	APPROVED:

	PL U	M B I	NG FIXT	U F	R E	S	C F	H E D U L E
	MANUFACTURE NAME AND MODEL NUMBER				NNECTIO	ON SIZE		
JRE BOL	BASIC FIXTURE	SEAT	FAUCET / FLUSH VALVE	SOIL OR WASTE	VENT	C.W.	H.W.	REMARKS
)3	AMERICAN STANDARD AFWALL 2257.103	OLSONITE #95 OPEN FRONT LESS COVER	SLOAN G2 OPTIMA PLUS 8111, TOP SPUD, 1.6 GPF	4"	2"	1"	_	VITREOUS CHINA, LOW CONSUMPTION 1.6 GPF, ELONGATED BOWL, DIRE JET ACTION, WALL MOUNTED.
8	AMERICAN STANDARD LUCERNE 0356.015 SINGLE CENTER HOLE	NOT APPLICABLE	SLOAN EBF-750-8-ADM OPTIMA SERIES WITH ETF-460-A GRID STRAINER	1-1/2"	1-1/4"	1/2"	1/2"	PROVIDE HANDS-FREE FAUCET AS INDICATED; SINK TO HAVE THREE ONLY, PROVIDE MCGUIRE SUPPLIES, STOPS, 1–1/2" P-TRAP DRAIN T SLOAN EFT-529 OPTISHIELD LAVATORY PROTECTIVE ENCLOSURE
28	ELKAY LR2219	NOT APPLICABLE	CHICAGO FAUCETS 201-AGN2AE29-317CP	2"	2"	1/2"	1/2"	7 ½" DEEP STAINLESS STEEL SINGLE COMPARTMENT SINK, FULLY UND FURNISH FAUCET WITH GOOSENECK SPOUT, LAMINAR FLOW OUTLET, 4 HANDLES AND CRUMB CUP STRAINER.

Drawing Title	Project Title			Projec	
New Plumbing Details					
Scale: As Noted	Firehouse	e Enhancen	nent	Buildin	
Approved: Facility Director , VAHVHCS:	Location			Drawir	
	Montros	se, New Y	ork		
Approved: John Cliffe, Facility Chief of Engineering	Date	Checked	Drawn		
	08-16-2021	LS	AMI	Dwg	