

ARCHITECTURAL ABBREVIATIONS					
ABBREVIATION	FULL WORD/TERM	ABBREVIATION	FULL WORD/TERM	ABBREVIATION	FULL WORD/TERM
A	MEDICAL AIR	GYP.	GYPSUM	S.S.	STAINLESS STEEL
A.C.T.	ACOUSTIC CEILING TILE	HGT.	HEIGHT	SECT.	SECTION
ADJ.	ADJUSTABLE	H.M.	HOLLOW METAL	SIM.	SIMILAR
A.F.F.	ABOVE FINISH FLOOR	H.R.	HANDRAIL	SOIL.	SOILED
ALUM.	ALUMINUM	H.W.	HOT WATER	SPEC.	SPECIFICATION
BD.	BOARD	IN.	INCH	SPRK.	SPRINKLER
CAB.	CABINET	INFO.	INFORMATION	STO./STOR.	STORAGE
CL.CLOS.	CLOSET	INT.	INTERIOR	STRUC.	STRUCTURAL
CLG.	CEILING	ISO.	ISOLATION	SUPR.	SUPERVISOR
CLR.	CLEAR	K.D.	KNOCK DOWN	S.V.	SHEET VINYL
COL.	COLUMN	K.O.	KNOCK OUT	TLT.	TOILET
COMM.	COMMUNICATION	LAB.	LABORATORY	TELE.	TELEPHONE
CONC.	CONCRETE	LVT.	LUXURY VINYL TILE	TREAT.	TREATMENT
CONST.	CONSTRUCTION	MANUF.	MANUFACTURER	TYP.	TYPICAL
CONT.	CONTINUOUS	MAT.	MATERIAL	U.L.	UNDERWRITER'S LAB.
C.J.	CONTROL JOINT	MAX.	MAXIMUM	U.O.N.	UNLESS OTHERWISE NOTED
CORR.	CORRIDOR	MECH.	MECHANICAL	UTIL.	UTILITY
C.M.	CONSTRUCTION MANAGEMENT	MED.	MEDICINE/MEDICATION	V.	VACUUM
CPT.	CARPET	MEP.	MECH./ELEC./PLUMB.	V.C.T.	VINYL COMPOSITION TILE
C.T.	CERAMIC TILE	MIN.	MINIMUM	VERT.	VERTICAL
CTR.	CENTER	MISC.	MISCELLANEOUS	VEST.	VESTIBULE
DBL.	DOUBLE	MTL.	METAL	V.I.F.	VERIFY IN FIELD
DEPT.	DEPARTMENT	N.I.C.	NOT IN CONTRACT	W/	WITH
D.F.	DRINKING FOUNTAIN	NO.	NUMBER	W/O	WITHOUT
DIA.	DIAMETER	N/S	NURSE STATION		
DIM./DIMEN.	DIMENSION	N.T.S.	NOT TO SCALE		
DN	DOWN	O2	OXYGEN		
DWG.	DRAWING	O.C.	ON CENTER		
ELEC.	ELECTRICAL	OFF.	OFFICE		
ELEV.	ELEVATOR/ELEVATION	PAT.	PATIENT		
EVS.	ENVIRONMENTAL SERVICES CL.	PERF.	PERFORATED		
EQ.	EQUAL	P.LAM.	PLASTIC LAMINATE		
EQUIP.	EQUIPMENT	PLUMB.	PLUMBING		
EXIST.	EXISTING	PLY.	PLYWOOD		
E.J.	EXPANSION JOINT	PT.	PAINT		
F.D.	FLOOR DRAIN	RCP.	REFLECTED CEILING PLAN		
FLR.	FLOOR	REF.	REFRIGERATOR		
F.R.R.	FIRE RESISTANCE RATED	REINF.	REINFORCED		
G.A.	GAUGE	REQ.	REQUIRED		
GALV.	GALVANIZED	RM.	ROOM		
GC	GENERAL CONTRACTOR	R.D.	ROOF DRAIN		
G.W.B.	GYPSUM WALLBOARD	S.	SLIDE		

ELECTRICAL SYMBOLS	
SYMBOL	DESCRIPTION
⊙	FLOOR OUTLET
⊕	DUPLEX POWER RECEPTACLE
⊕	QUADRAPLEX POWER RECEPTACLE
⊕	COMBINATION DUPLEX POWER/USB RECEPTACLE
⊕	USB RECEPTACLE
⊕	TELEPHONE RECEPTACLE
⊕	DATA/TELE RECEPTACLE
▼	DATA
⊙	JUNCTION BOX
⊕	SINGLE SWITCH
⊕	3-WAY SWITCH
⊕	4-WAY SWITCH
⊕	SINGLE SWITCH WITH DIMMER
⊕	THERMOSTAT
⊕	HUMIDISTAT

ARCHITECTURAL SYMBOLS			
FUNCTION	DESCRIPTION	FUNCTION	DESCRIPTION
ROOM IDENTIFIER	ROOM NAME ROOM NUMBER CEILING TYPE FINISH TYPE ROOM NUMBER	INTERIOR ELEVATION IDENTIFIER	DRAWING REFERENCE PAGE REFERENCE
DOOR OR CASING OPENING IDENTIFIER	DOOR OR CASING OPENING NUMBER SEE DOOR SCHEDULE	MULTIPLE INTERIOR ELEVATION IDENTIFIER	ELEVATION NUMBER REFERENCE DRAWING REFERENCE PAGE REFERENCE
WALL SECTION OR CROSS SECTION	DRAWING REFERENCE PAGE REFERENCE	HANDRAIL OR CRASHRAIL IDENTIFIER	HANDRAIL, GUARDRAIL, OR OTHER WALL PROTECTION. REFER TO EQUIPMENT MANUAL AND DETAILS FOR INFORMATION
WINDOW IDENTIFIER	WINDOW NUMBER SEE WINDOW SCHEDULE	CORNER GUARD IDENTIFIER	CORNER GUARD PROTECTION. REFER TO EQUIPMENT MANUAL AND DETAILS FOR INFORMATION
INTERIOR PARTITION IDENTIFIER	PARTITION TYPE. SEE DETAILS	EQUIPMENT IDENTIFIER	EQUIPMENT IDENTIFIER TAG. REFER TO EQUIPMENT MANUAL AND DETAILS FOR INFORMATION
PLAN DETAIL IDENTIFIER	DETAIL REFERENCE DRAWING REFERENCE PAGE REFERENCE	COLUMN GRIDLINE IDENTIFIER	STRUCTURAL COLUMN GRID IDENTIFIER. REFER TO STRUCTURAL DRAWINGS WHERE NECESSARY
ENLARGED PART PLAN IDENTIFIER	DRAWING REFERENCE PAGE REFERENCE	CEILING HEIGHT IDENTIFIER	CEILING HEIGHT IDENTIFIER TAG. REFER TO REFLECTED CEILING PLAN FOR INFORMATION


FINISH SCHEDULE					
TYPE	MATERIAL	SPECIFICATION	MANUFACTURER	COLOR AND STYLE	REMARKS
1	FLOOR	LUXURY VINYL TILE	PATCRAFT	-	STAIR 100, 145, 163, CORRIDOR 100A, 100B, 100C, 100D, 100E, 100F, 100G, LOBBY 001, 101, SHARED WAITING 102, ELEV 103, CLOSET 104, 131, VESTIBULE 115, MA STATION 110, 133, 150, RECEPTION 109, 146, CLEAN HOLD 117 & 151
	BASE	VINYL COVE BASE, 4.25" HIGH	JOHNSONITE BY TARKETT	-	
	WALL PAINT	PAINT, EGGSHELL FINISH.	SHERWIN WILLIAMS	-	
2	FLOOR	LUXURY VINYL TILE	PATCRAFT	-	EXAM ROOMS 119, 120, 121, 126, 127, 128, 136, 138, 140, 141, 142, 143, 154, 156, 157, 159, 160, 161, NP EXAM 130 & 135
	BASE	VINYL COVE BASE, 4" HIGH	JOHNSONITE BY TARKETT	-	
	WALL PAINT	PAINT, EGGSHELL FINISH.	BENJAMIN MOORE	-	
3	FLOOR	LUXURY VINYL TILE	MANNINGTON COMMERCIAL	-	STAFF LOUNGE 116
	BASE	VINYL COVE BASE, 4" HIGH	JOHNSONITE BY TARKETT	-	
	WALL PAINT	PAINT, EGGSHELL FINISH.	BENJAMIN MOORE	-	
4	FLOOR	CARPET TILE, 24" X 24"	MANNINGTON COMMERCIAL	-	BUSINESS OFFICE 107, PRACTICE MANAGER 108, LPN 118, 153, PROVIDER OFFICE 123, 129, 137, 139, NURSE PRACTITIONER 134, SUPERVISOR OFFICE 147, MD CONSULT 155 & 158
	BASE	VINYL STRAIGHT BASE, 4.25" HIGH	JOHNSONITE BY TARKETT	-	
	WALL PAINT	PAINT, EGGSHELL FINISH.	BENJAMIN MOORE	-	
5	FLOOR	PORCELAIN CERAMIC TILE, 12" X 24"	DALTILE	-	TOILETS / WET WALL CONDITIONS, INCLUDING THOSE ON EITHER SIDE OF THE TOILET AND SURROUNDING THE HAND-WASHING SINK SHALL RECEIVE FULL HEIGHT CERAMIC TILE. ALL OTHER WALLS TO BE PAINTED WITH INTEGRAL CERAMIC COVE BASE. USE ALL MANUFACTURERS JOLLY TRIMS FOR ANY OUTSIDE CORNERS. VISITOR TOILET 105, STAFF TOILET 106, 125, 148, PATIENT TOILET 112, 124, 144 & 149
	BASE	PORCELAIN CERAMIC TILE BASE, 3" X 12"	DALTILE	-	
	WALL PAINT	PAINT, EGGSHELL FINISH	BENJAMIN MOORE	-	
6	FLOOR	HOMOGENEOUS VINYL	TARKETT	-	BLOOD DRAW 111, IT 114, EVS 113, LAB 132, 152 & ELEC 162
	BASE	INTEGRAL COVE BASE, 6" HIGH	TARKETT	-	
	WALL PAINT	PAINT, EGGSHELL FINISH	SHERWIN WILLIAMS	-	

CEILINGS		
TYPE	MATERIAL	SPECIFICATION
A	ACOUSTICAL TILE	USG TILES, STYLE: GLACIER #707 WHITE, 24" X 24"
B	GYPSUM WALLBOARD	5/8" GYPSUM WALL BOARD ON USG STANDARD SUSPENSION SYSTEM (NON-COMBUSTIBLE)


FINISH SCHEDULE AND MATERIAL NOTES:

- INTERIOR FLOOR FINISH: CLASS I OR II AS SPECIFIED IN NFPA 101, BASED ON TEST RESULTS FROM NFPA 253. ALL FLOOR FINISHES SHALL COMPLY WITH DOC FF-1 "PILL TEST"
- VINYL WALL BASE: CLASS 'C', FLAME SPREAD 76-200, SMOKE DEVELOPMENT 0-450, BASED ON TEST RESULTS FROM NFPA 253.
- ALL THRESHOLDS SHALL BE ICC/ANSI A117.1 - 2003 COMPLIANT. CHANGES IN LEVEL OF UP TO 1/4" MAY BE VERTICAL. CHANGES IN LEVEL FROM 1/4" UP TO 1/2" MUST BE BEVELED AT EDGES, WITH A SLOPE NOT STEEPER THAN 1:2. CHANGES IN LEVEL BEYOND 1/2" IN HEIGHT MUST BE RAMPED.
- REFER TO SILL TYPES DRAWING FOR DETAILS FOR TRANSITIONS BETWEEN DISSIMILAR FLOOR MATERIALS.
- UNLESS OTHERWISE INDICATED, ALL EXISTING FINISHES SHALL BE REPLACED. CONTRACTOR SHALL PATCH-TO-MATCH AND REPAIR AS REQUIRED BY NEW WORK.
- WHERE THERE IS A QUESTION AS TO THE ACCEPTABLE LEVEL OF QUALITY FOR THE INSTALLATION OF ANY FINISHED MATERIALS, THE ARCHITECT SHALL ACT AS THE MEDIATOR.
- COMPLIANCE WITH THE MANUFACTURERS REQUIREMENTS FOR STORAGE, HANDLING, INSTALLATION AND PROTECTION IS THE EXCLUSIVE RESPONSIBILITY OF THE CONSTRUCTION MANAGER AND ITS RESPECTIVE INSTALLERS.
- CONTRACTOR SHALL SUBMIT (2) 12" X 12" SAMPLES OF ALL FINISHES TO ARCHITECT FOR WRITTEN APPROVAL. PROCUREMENT OF ALL MATERIALS IS NOT TO PROCEED UNTIL SUCH SAMPLES HAVE BEEN APPROVED.
- WALLS AND SURFACES RECEIVING PAINT AND WALL COVERING ECT. SHALL BE PROPERLY PREPARED ACCORDING TO MANUFACTURERS SPECIFICATIONS.
- PRIMER ON WALLS AND CEILINGS SHALL BE BENJAMIN MOORE LATEX ENAMEL UNDERCOATER AND PRIMER SEALER #253 OR APPROVED EQUAL.
- PRIMER ON METALS SHALL BE BENJAMIN MOORE IRONCLAD ALKYD LOW-LUSTRE METAL AND WOOD ENAMEL #C163 OR APPROVED EQUAL.
- UNLESS OTHERWISE INDICATED, GYPSUM WALL BOARD FINISH SHALL BE LEVEL 4; PAINT APPLICATION SHALL BE FINISH LEVEL 4, ONE PRIME AND TWO FINISH COATS.
- PARTITIONS CONCEALED WITH MILLWORK ARE TO BE TAPED, MUDDERED, SANDED SMOOTH, PRIMED AND PAINTED WITH ONE COAT OF SCHEDULED PAINT.
- ALL FLOORING SURFACES SHALL BE PREPARED PRIOR TO FINISH INSTALLATION AND IN ACCORDANCE WITH THE MANUFACTURERS SPECIFICATIONS.
- ALL SHEET GOODS TO BE WELDED WITH COLOR-MATCHED WELDING RODS. ALL INTEGRAL COVES TO BE INSTALLED WITH CAP STRIPS COLOR MATCHED TO THE WELDING RODS.
- FLOORING CONTRACTOR TO SUBMIT SEAMING PLAN FOR ALL SEAMLESS FLOOR LOCATIONS.
- FINISHES CALLED FOR SHALL EXTEND UNDER, OVER AND/OR BEHIND ANY BUILT-IN MILLWORK, EQUIPMENT, MIRRORS, ETC. AS INDICATED ON DRAWINGS.
- REFER TO INTERIOR DESIGN DRAWINGS FOR MORE INFORMATION.

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ADD. #03

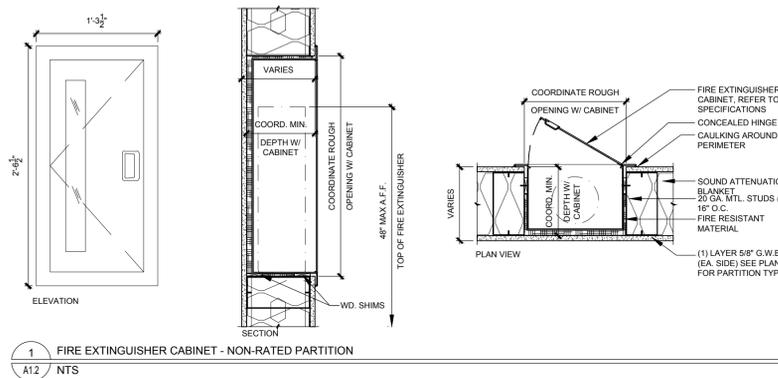

- ACCESSIBLE SIGNAGE NOTES:**
- ALL ACCESSIBLE SIGNAGE SHALL MEET ALL OF THE REQUIREMENTS OF ICC/ANSI A117.1-2003, CHAPTER 7 - COMMUNICATION ELEMENTS AND FEATURES.
 - VISUAL AND TACTILE SIGNS SHALL BE PROVIDED AT EACH ACCESSIBLE TOILET ROOM DOOR, EACH EXIT DOOR, AND AS INDICATED ON THE PLAN
 - PROVIDE UNISEX ACCESSIBLE SIGN AT ALL TOILETS.
 - ALL SIGN SIZES, SYMBOL SIZES, BRAILLE CONFIGURATIONS AND OTHER GRAPHICAL INFORMATION MUST STRICTLY CONFORM TO THE 2010 ADA CRITERIA.
 - CHARACTERS MUST BE NO LONGER THAN 48" AND NO HIGHER THAN 60" AFF.
- NOTE: ALL WALL MOUNTED ACCESSIBLE SIGNAGE MOUNTED AT 42" TO CENTER OF MOUNTING POINT.

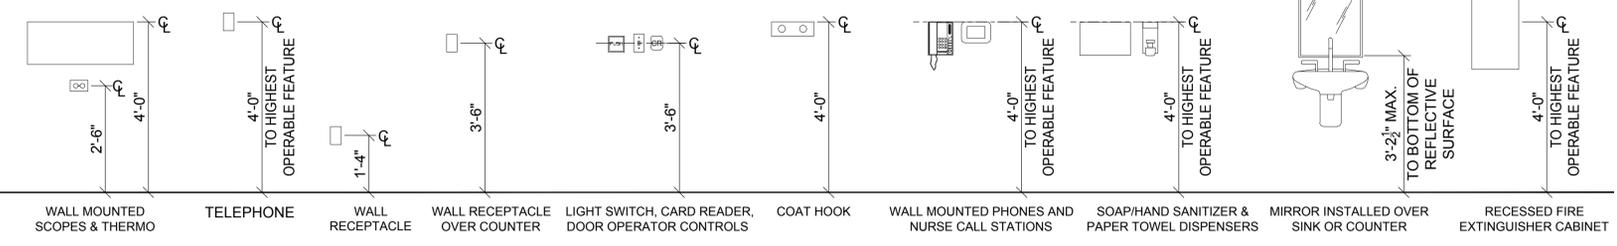

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MONTEFIORE HEALTH SYSTEM
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HIGHLAND MEDICAL
PRIMARY HEALTH CLINICS
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KEY PLAN: NOT TO SCALE
FIRST FLOOR

AREA OF WORK

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ISSUED DOCUMENTS:

No.	Date	Description
1	02.15.2022	BID ISSUE
2	03.16.2021	ADDENDA #03

SEAL

IT IS A VIOLATION OF THE LAW FOR ANY PERSON, UNLESS ACTING UNDER THE DIRECTION OF A LICENSED ARCHITECT, TO ALTER THIS DOCUMENT IN ANY WAY. IF ALTERED, THE ALTERING ARCHITECT SHALL AFFIX HIS SEAL AND THE NOTATION "ALTERED BY" FOLLOWED BY HIS SIGNATURE AND THE DATE OF SUCH ALTERATION, AND A SPECIFIC DESCRIPTION OF THE ALTERATION.

DRAWING TITLE:
ABBREVIATION, SYMBOL LEGEND, MOUNTING AND FINISH SCHEDULE

PROJECT NUMBER
21019

DATE
2/15/2022

SCALE
AS NOTED


DRAWING NUMBER

A1.2


BARRIER FREE NOTES:

BARRIER-FREE STANDARDS INDICATED HEREIN ARE TYPICAL. DIMENSIONS SHOWN ARE TYPICAL UNLESS INDICATED OTHERWISE ELSEWHERE IN THE DRAWINGS.


- REFER TO COVER SHEET FOR APPLICABLE CODES, STANDARDS, AND GUIDELINES.
- THE CLEAR WIDTH OF A PASSAGEWAY FOR A SINGLE WHEELCHAIR SHALL BE 32 INCHES FOR A PASSAGEWAY OF 24 INCHES OR LESS AND 36 INCHES FOR A PASSAGEWAY LONGER THAN 24 INCHES.
- THE CLEAR FLOOR SPACE REQUIRED FOR A SINGLE WHEELCHAIR SHALL BE 30 INCHES BY 48 INCHES.
- THE CLEAR WIDTH OF AN ACCESSIBLE ROUTE SHALL BE 36 INCHES.
- HANDRAILS: THE TOP OF GRIPPING SURFACE OF HANDRAILS SHALL BE 34 INCHES MINIMUM AND 38 INCHES MAXIMUM VERTICALLY ABOVE THE STAIR NOSING OR RAMP SURFACE. CLEAR SPACE BETWEEN HANDRAILS AND WALL SURFACE SHALL BE 1 1/2" MINIMUM.
- PROTRUDING OBJECTS: OBJECTS WITH LEADING EDGES LOCATED MORE THAN 27 INCHES AND NOT MORE THAN 80 INCHES ABOVE THE FLOOR SHALL PROTRUDE NOT MORE THAN 4 INCHES FROM THE WALL.
- GUARDRAILS OR OTHER BARRIERS SHALL BE PROVIDED WHEN VERTICAL CLEARANCE OF AN AREA ADJOINING AN ACCESSIBLE ROUTE IS LESS THAN 80 INCHES HIGH.
- CHANGES IN LEVEL: A CHANGE IN LEVEL OF 1/4 INCH HIGH MAXIMUM SHALL BE PERMITTED TO BE VERTICAL AND WITHOUT EDGE TREATMENT. A CHANGE IN LEVEL OF BETWEEN 1/4 INCH AND 1/2 INCH HIGH MAXIMUM SHALL BE BEVELED WITH A SLOPE NOT STEEPER THAN 1:2.
- RAMPS SHALL HAVE A SLOPE NOT STEEPER THAN 1:12. THE MAXIMUM RISE FOR ANY RAMP WITHOUT A LANDING IS 30 INCHES. THE RAMP SHALL HAVE A CLEAR WIDTH OF 36 INCHES. LANDING LENGTH SHALL BE A MINIMUM OF 60 INCHES.
- STAIR TREADS AND RISERS SHALL BE AS FOLLOWS: STAIR TREADS SHALL BE MINIMUM OF 11 INCHES DEEP, STAIR RISERS SHALL BE A MAXIMUM OF 7 INCHES HIGH.
- DOOR CLOSERS SHALL BE ADJUSTED SO THAT FROM AN OPEN POSITION OF 90 DEGREES, THE TIME REQUIRED TO MOVE THE DOOR TO AN OPEN POSITION OF 12 DEGREES WILL BE 5 SECONDS MINIMUM.
- DOOR OPENING FORCE WHERE CLOSERS ARE USED SHALL BE 5 POUNDS MAXIMUM.
- THE BOTTOM 12 INCHES OF ALL DOORS EXCEPT AUTOMATIC DOORS SHALL HAVE A SMOOTH UNINTERRUPTED SURFACE TO ALLOW THE DOOR TO BE OPENED BY A WHEELCHAIR FOOTREST WITHOUT CREATING A TRAP OR HAZARDOUS CONDITION.
- POWER ASSISTED DOORS: THE TIME REQUIRED FOR SUCH DOORS TO OPEN TO A BACK CHECK POSITION SHALL BE 3 SECONDS MINIMUM. THE FORCE REQUIRED TO STOP DOOR MOVEMENT SHALL BE 15 POUNDS MAXIMUM.
- EXPOSED PIPES AND SURFACES UNDER LAVATORIES AND SINKS SHALL BE INSULATED OR OTHERWISE CONFIGURED TO PROTECT AGAINST CONTACT.
- GRAB BARS SHALL HAVE A DIAMETER OR WIDTH OF GRIPPING SURFACE FROM 1 1/4 TO 2 INCHES. THE CLEAR SPACE BETWEEN THE GRAB BAR SURFACE AND THE WALL SURFACE SHALL BE 1-1/2 INCHES MINIMUM.
- STRUCTURAL STRENGTH: ALLOWABLE STRESSES IN BENDING, SHEAR AND TENSION SHALL NOT BE EXCEEDED FOR MATERIALS USED WHERE A VERTICAL OR HORIZONTAL FORCE OF 250 POUNDS IS APPLIED AT ANY POINT ON THE GRAB BAR OR SEAT, FASTENER MOUNTING DEVICE OR SUPPORTING STRUCTURE.

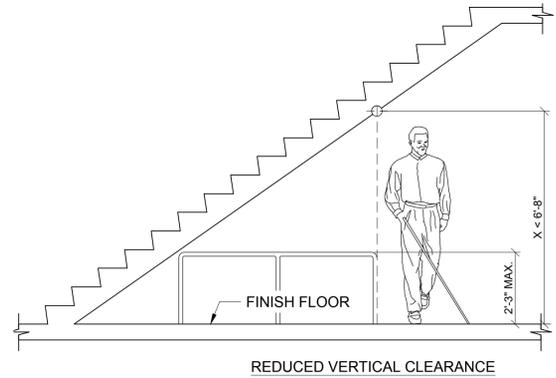

4 PROTRUDING OBJECTS
A1.3 NOT TO SCALE

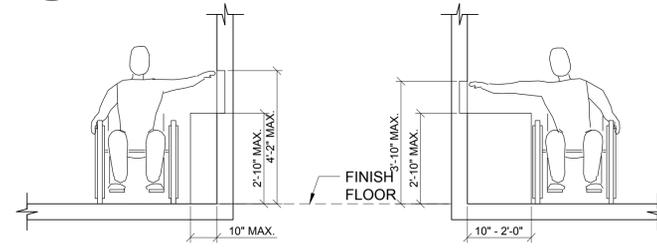

5 REACH / MOUNTING HEIGHTS
A1.3 NOT TO SCALE

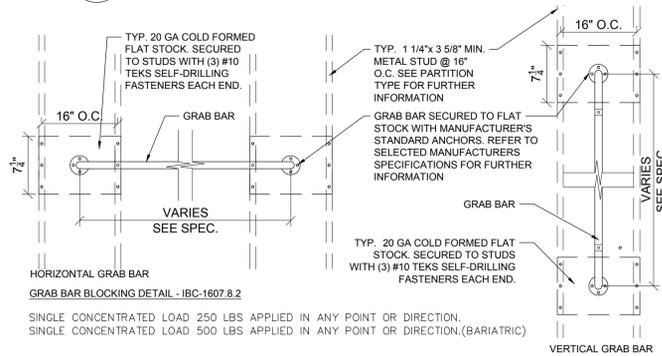


6 TYPICAL GRAB BAR ANCHORAGE DETAILS - HORIZONTAL & VERTICAL GRAB BARS
A1.3 NOT TO SCALE

MANEUVERING CLEARANCES AT MANUAL SWINGING DOORS


APPROACH DIRECTION	DOOR SIDE	MINIMUM MANEUVERING CLEARANCES	
		PERPENDICULAR TO DOORWAY	PERPENDICULAR TO DOORWAY (BEYOND LATCH UNLESS NOTED)
FROM FRONT	PULL	60 INCHES	18 INCHES
FROM FRONT	PUSH	48 INCHES	0 INCHES (NOTE 3)
FROM HINGE SIDE	PULL	60 INCHES	36 INCHES
FROM HINGE SIDE	PUSH	54 INCHES	42 INCHES
FROM HINGE SIDE	PULL	42 INCHES (NOTE 1)	22 INCHES (NOTE 3 AND 4)
FROM HINGE SIDE	PUSH	48 INCHES (NOTE 2)	24 INCHES
FROM LATCH SIDE	PULL	48 INCHES (NOTE 2)	24 INCHES
FROM LATCH SIDE	PUSH	42 INCHES (NOTE 2)	24 INCHES

- NOTES:**
- ADD 6" IF CLOSER AND LATCH PROVIDED.
 - ADD 6" IF CLOSER PROVIDED.
 - ADD 12" BEYOND LATCH IF CLOSER AND LATCH PROVIDED.
 - BEYOND HINGE SIDE.


7 MANEUVERING CLEARANCES
A1.3 NOT TO SCALE

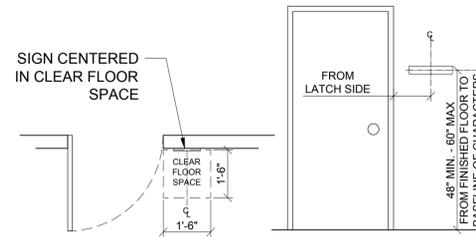

8 TACTILE INTERIOR SIGN
A1.3 NOT TO SCALE

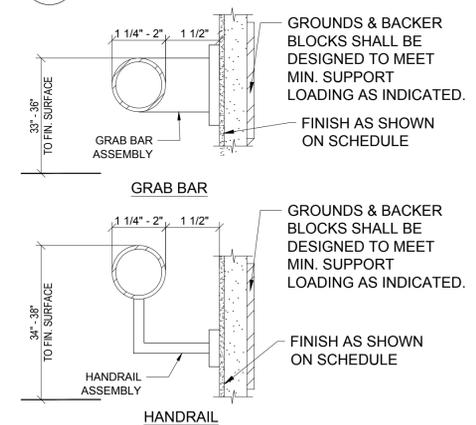


9 GRAB BARS AND HANDRAILS
A1.3 NOT TO SCALE

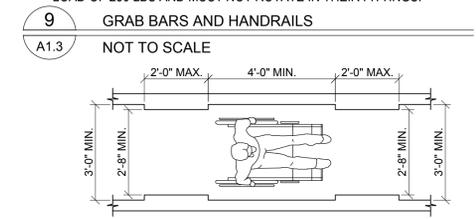


SEGMENT LENGTH	MINIMUM SEGMENT WIDTH
≤ 24 INCHES	32 INCHES
> 24 INCHES	36 INCHES


10 ACCESSIBLE ROUTE
A1.3 NOT TO SCALE

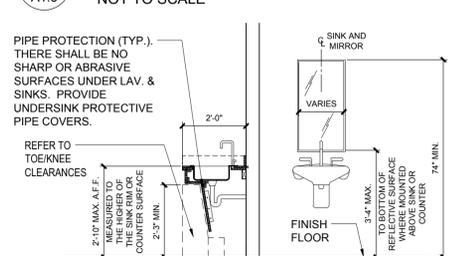


11 LAVATORIES AND SINKS
A1.3 NOT TO SCALE

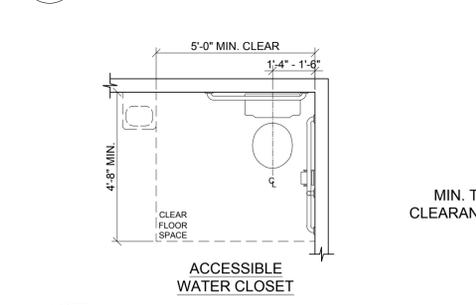


12 WATER CLOSET PLANS
A1.3 NOT TO SCALE

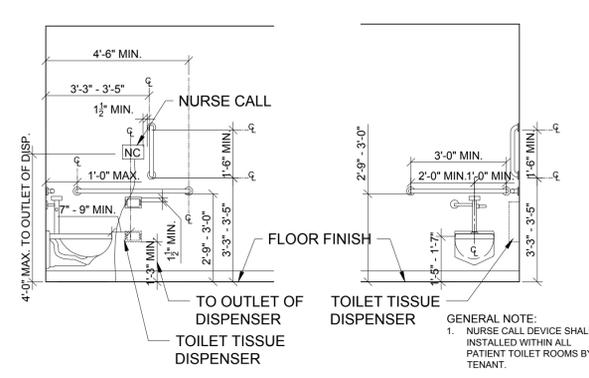


13 WATER CLOSET ELEVATIONS
A1.3 NOT TO SCALE

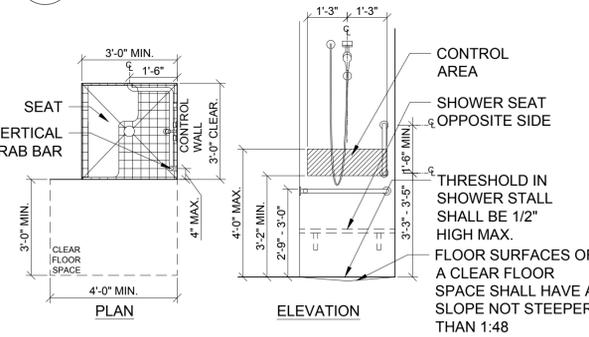


14 TRANSFER-TYPE SHOWERS
A1.3 NOT TO SCALE

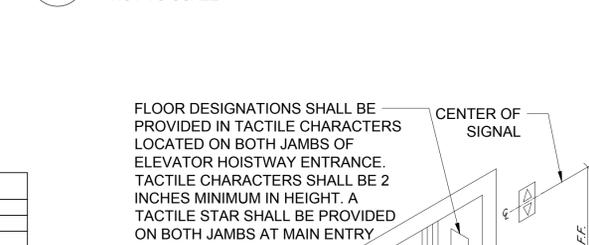


15 ELEVATOR ENTRANCE
A1.3 NOT TO SCALE

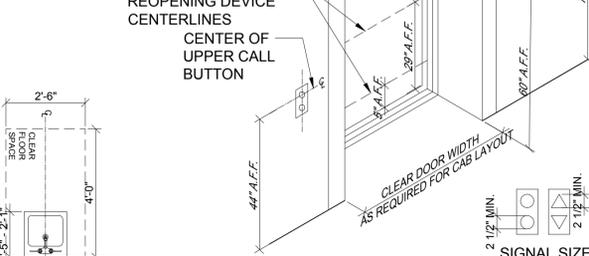


16 ACCESSIBLE COMPARTMENT
A1.3 NOT TO SCALE

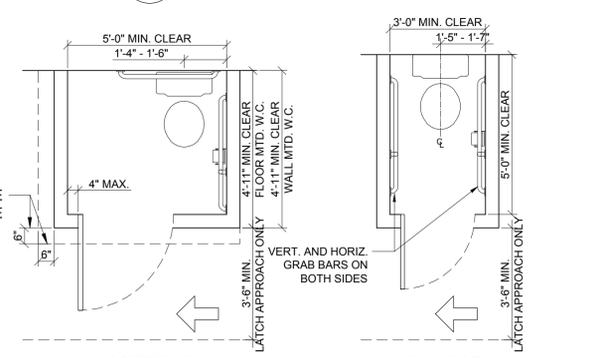


17 AMBULATORY COMPARTMENT
A1.3 NOT TO SCALE

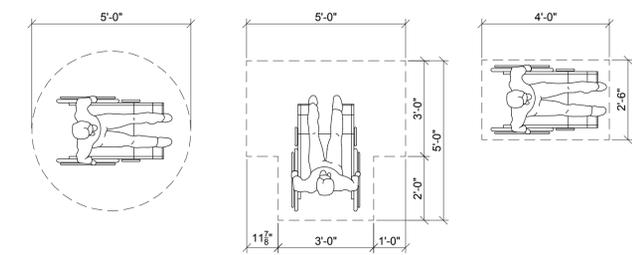

1 ACCESSIBILITY NOTES AND INFO
A1.3 NOT TO SCALE

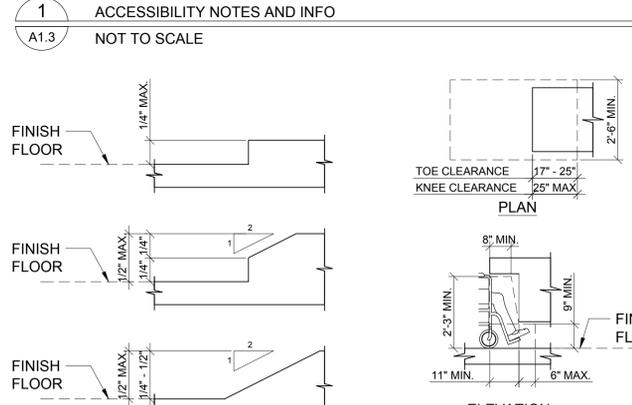

2 LEVEL CHANGES - (UP TO 1/2")
A1.3 NOT TO SCALE

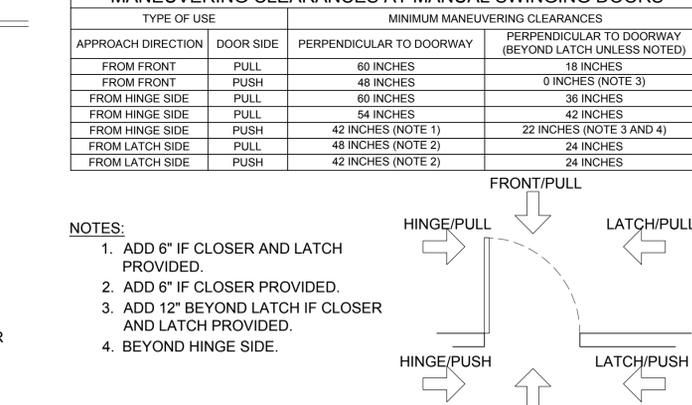

3 TOE / KNEE CLEARANCES
A1.3 NOT TO SCALE

12 WATER CLOSET PLANS
A1.3 NOT TO SCALE


Montefiore

MONTEFIORE HEALTH SYSTEM
NYACK CAMPUS

160 NORTH MIDLAND AVENUE
NYACK, NY 10960

HIGHLAND MEDICAL
PRIMARY HEALTH CLINICS
FIRST FLOOR
350 S MAIN ST
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KEY PLAN: NOT TO SCALE
FIRST FLOOR

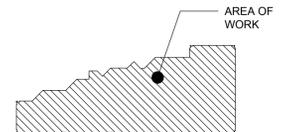

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ISSUED DOCUMENTS:

No.	Date	Description
1	02.15.2022	BID ISSUE
2	03.16.2021	ADDENDA #03

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DRAWING TITLE:
BARRIER FREE NOTES & DETAILS

PROJECT NUMBER
21019
DATE
2/15/2022
DRAWING NUMBER
AS NOTED

A1.3

GENERAL NOTES

- IN ACCORDANCE WITH NFPA 101, SECTION 38.3.1, ALL CORRIDOR WALLS AND PARTITIONS ENCLOSING EXIT ACCESS CORRIDORS SHALL FORM A BARRIER TO LIMIT THE TRANSFER OF SMOKE. CONTRACTOR SHALL EVALUATE EXISTING PARTITIONS THROUGHOUT THE ENTIRE WORK SCOPE AND ADJACENCIES TO PROVIDE CLOSURE WHEREVER NECESSARY TO MAINTAIN BARRIER TO LIMIT THE TRANSFER OF SMOKE. CLOSURE MAY INCLUDE, BUT IS NOT NECESSARILY LIMITED TO, THE INSTALLATION OF SAFING MATERIAL OR SEALANT AROUND EXISTING PENETRATIONS. EXTENSION OF EXISTING PARTITIONS, WALLS OR DRYWALL ABOVE ADJACENT CEILINGS.
- OCCUPANT LOADS LISTED ARE FOR VENTILATION SCHEDULE CALCULATIONS. EGRESS BASED ON S.F. OCCUPANT CALCULATIONS.

CODES AND STANDARDS

- BUILDING CODE: 2020 NEW YORK STATE BUILDING CODE
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- ENERGY CODE: 2020 ENERGY CONSERVATION CONSTRUCTION CODE OF NEW YORK STATE
- MECHANICAL CODE: 2020 NEW YORK STATE MECHANICAL CODE
- FUEL GAS CODE: 2020 NEW YORK STATE FUEL GAS CODE
- PLUMBING CODE: 2020 NEW YORK STATE PLUMBING CODE
- ELECTRICAL CODE: THE NATIONAL ELECTRICAL CODE, 2017
- LIFE SAFETY CODE: LIFE SAFETY CODE NFPA 101, 2018
- SPRINKLER CODE: 2020 NEW YORK STATE FIRE CODE
- BARRIER FREE REQUIREMENTS: 2009 ICC/ANCI A117.1 & 2010 ADA STANDARDS FOR ACCESSIBLE DESIGN (ADAAG)

OCCUPANCY INFORMATION	
OCCUPANCY TYPE (NYS BC) (NFPA 101)	B - BUSINESS
OCCUPANCY USE (NYS BC) (NFPA 101)	BUSINESS
NO. OF BUILDING STORIES	2
CONSTRUCTION TYPE (NYS BC) (NFPA 101)	TYPE III (211)
OCCUPANT LOAD FACTOR TABLE 1004.1.1	100 GROSS SQ. FT. PER PERSON
CONSTRUCTION TYPE	TYPE 3B
TOTAL WORK AREA	9,797 SQ. FT.
RENOVATION WORK AREA	9,797 SQ. FT.
NEW WORK AREA	0 SQ. FT.
AUTOMATIC SPRINKLER SYSTEM	
THROUGHOUT BUILDING	FULLY PROTECTED
LIMITED AREAS	

BUILDING CODE OF NEW YORK STATE - TABLE 601	
BUILDING ELEMENTS	TYPE 3B
STRUCTURAL FRAME	0
BEARING WALLS EXTERIOR	2 HOUR
INTERIOR	0 HOUR
NONBEARING WALL/PARTITION EXTERIOR	SEE TABLE 602
NONBEARING WALL/PARTITION INTERIOR	0
FLOOR CONSTRUCTION	0
ROOF CONSTRUCTION	0

INTERIOR FINISH CLASSIFICATIONS

- WALL AND CEILING FINISHES, WHEN TESTED IN ACCORDANCE WITH NFPA 255
 - CLASS 'A': FLAME SPREAD 0-25; SMOKE DEVELOPMENT 0-450
 - CLASS 'B': FLAME SPREAD 26-75; SMOKE DEVELOPMENT 0-450
 - CLASS 'C': FLAME SPREAD 76-200; SMOKE DEVELOPMENT 0-450
- FLOOR FINISHES, WHEN TESTED IN ACCORDANCE WITH NFPA 253
 - CLASS I: CRITICAL RADIANT FLUX MINIMUM OF 0.45 W/SQ. CM
 - CLASS II: CRITICAL RADIANT FLUX MINIMUM OF 0.22 W/SQ. CM

FIRE PROTECTION AND MEANS OF EGRESS SYMBOL LEGEND

MARK	DESCRIPTION
←	POINT OF EXIT ACCESS AND DIRECTION OF EGRESS TRAVEL
●	REMOTE POINT OF EXIT ACCESS TRAVEL
— (50') —	DISTANCE OF TRAVEL FROM REMOTE POINT TO POINT OF EXIT ACCESS
■	SMOKE BARRIER (1-HOUR FIRE RESISTANCE-RATED CONSTRUCTION)
■ ■ ■ ■	SMOKE PARTITION (SMOKE-LIMITING)
■ ■ ■ ■	SUITE SEPARATION PARTITION (SMOKE-LIMITING)
■ ■ ■ ■	1-HOUR FIRE RESISTANCE-RATED CONSTRUCTION
■ ■ ■ ■	2-HOUR FIRE RESISTANCE-RATED CONSTRUCTION
■ ■ ■ ■	FIRE HOSE CABINET
■ ■ ■ ■	FIRE EXTINGUISHER IN CABINET
■ ■ ■ ■	FIRE EXTINGUISHER ON HOOK (EX = EXISTING)
■ ■ ■ ■	FIRE ALARM HORN/STROBE (EX = EXISTING)
■ ■ ■ ■	FIRE ALARM MANUAL PULL (EX = EXISTING)
○	EXIT SIGNAGE (FILL INDICATES DIRECTION TO EXIT)
■ ■ ■ ■	HAZARDOUS AREA: SMOKE / PARTITION ENCLOSURE REQUIRED (DOORS SHALL BE SELF-CLOSING OR AUTOMATIC CLOSING)
□	AREA NOT IN THE SCOPE U.N.O.

CODE KEY NOTES:

- SEE FLOOR ABOVE FOR EXIT TRAVEL INFORMATION TO PUBLIC WAY THIS LEVEL.
- SEE STRUCTURAL DETAILS FOR COLUMN REPAIRS AND LOCATIONS (MULTIPLE).
- SITE AND ACCESS - SEE SITE PLAN (N.I.C).
- LINE OF STRUCTURE ABOVE.

EXITING DATA, CALCULATIONS, AND FIRE PROTECTION REQUIREMENTS (CH. 38 NFPA 101)

ITEM/ DESCRIPTION	REQUIRED		PROVIDED	REMARKS/SECT. REFERENCE
	CALCULATED	ACTUAL		
TOTAL OCCUPANT LOAD SERVED, BASED ON 100 SQ. FT./PERSON	98 PERSONS	SEE PLANS	EGRESS TOTAL CAPACITY FOR 397 OCCUPANTS	7.3.1.2 NOTE: ACTUAL NUMBER OF PERSONS IS AN ESTIMATE AND INCLUDES COHABITATION
NUMBER OF EXITS	2 SEPARATE		- SEPARATE	38.2.4
EGRESS WIDTH PER OCCUPANT				
LEVEL COMPONENTS	0.2 INCHES		COMPLIES	38.2.3.1
STAIRS, RAMPS	0.3 INCHES		COMPLIES	38.2.3.1
MINIMUM CORRIDOR WIDTH	44 INCHES		COMPLIES	38.2.3.2
MINIMUM EXIT ACCESS DOOR WIDTH	32 INCHES CLEAR		COMPLIES	38.2.2.2
MAXIMUM DEAD END CORRIDOR	50 FEET		COMPLIES	38.2.5.2.1
REQUIRED RESISTANCE RATING: -ENCLOSURE CONNECTING 4 OR MORE STORIES -OTHER ENCLOSURES IN NEW CONSTRUCTION -EXISTING BARRIERS IN EXISTING BUILDING		REQUIRED FIRE BARRIER (HOURS)	COMPLIES	38.3.1
MAXIMUM DISTANCE BETWEEN ANY POINT IN A NON-SLEEPING SUITE TO AN EXIT	300 FEET		COMPLIES - SEE PLANS	38.2.6.3
PROTECTION OF VERTICAL OPENINGS, SHAFTS, CHUTES, HOISTWAYS, STAIRWAYS, ETC.		1 - HOUR FIRE RESISTANCE RATING SEPARATING THE EXIT STAIR CONNECTING 3 OR LESS FLOOR IN NEW CONSTRUCTION. 1/2-HOUR FIRE RESISTANCE RATING IN EXISTING BUILDING	COMPLIES	38.3.2.1
HAZARDOUS AREAS		1 - HOUR FIRE RESISTANCE RATING OR SPRINKLER PROTECTION AND SMOKE RESISTING PARTITION	COMPLIES	38.3.1
FIRE ALARM	YES		COMPLIES	38.3.4.1
CORRIDOR WALLS AND SUITES, MINIMUM FIRE RESISTANCE RATING	MULTIPLE TENANTS -	1 HOUR	COMPLIES	38.3.6.1
SMOKE BARRIER	NOT REQUIRED		N/A	38.3.7
INTERIOR WALL AND CEILING FINISH REQUIREMENTS	CLASS A OR B IN EXITS AND EXIT ACCESS CORRIDOR / CLASS A, B, OR C IN OTHER AREA		COMPLIES	38.3.3.2
INTERIOR FLOOR FINISH REQUIREMENTS	CLASS I OR II IN EXIT ENCLOSURES		COMPLIES	38.3.3.3


Montefiore

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FIRST FLOOR
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KEY PLAN: NOT TO SCALE
GROUND FLOOR



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DRAWING TITLE:
EGRESS AND LIFE SAFETY PLAN - GROUND FLOOR

PROJECT NUMBER
21019

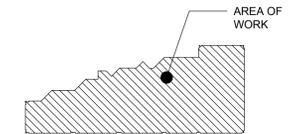
DATE
2/15/2022

SCALE
AS NOTED

DRAWING NUMBER

A2.1

2
ADD. #03

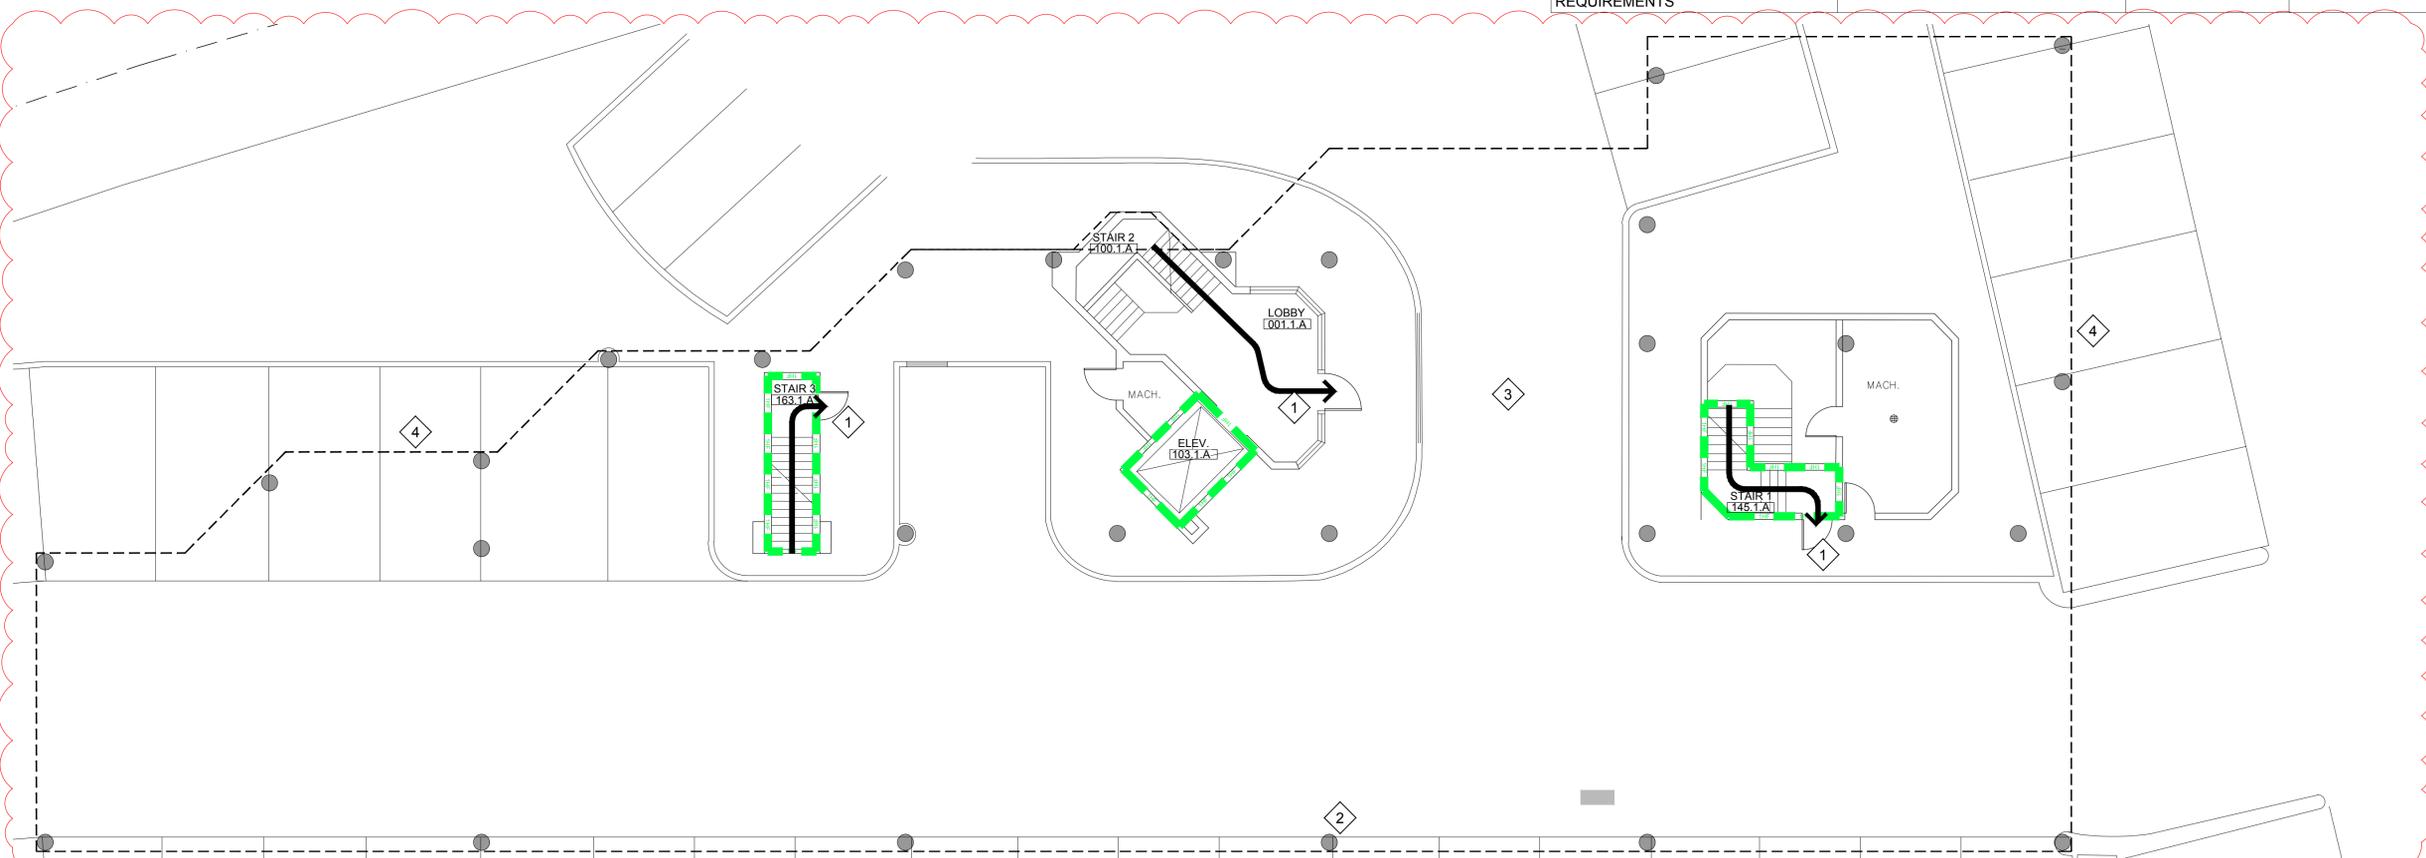

EGRESS AND LIFE SAFETY PLAN - GROUND FLOOR
SCALE: 1/8" = 1'-0"
Scale: 1/8" = 1'-0"
AREA NOT IN SCOPE U.N.O.

GENERAL NOTES

- IN ACCORDANCE WITH NFPA 101, SECTION 38.3.1, ALL CORRIDOR WALLS AND PARTITIONS ENCLOSING EXIT ACCESS CORRIDORS SHALL FORM A BARRIER TO LIMIT THE TRANSFER OF SMOKE. CONTRACTOR SHALL EVALUATE EXISTING PARTITIONS THROUGHOUT THE ENTIRE WORK SCOPE AND ADJACENCIES TO PROVIDE CLOSURE WHEREVER NECESSARY TO MAINTAIN BARRIER TO LIMIT THE TRANSFER OF SMOKE. CLOSURE MAY INCLUDE, BUT IS NOT NECESSARILY LIMITED TO, THE INSTALLATION OF SAFING MATERIAL OR SEALANT AROUND EXISTING PENETRATIONS. EXTENSION OF EXISTING PARTITIONS, WALLS OR DRYWALL ABOVE ADJACENT CEILINGS.
- OCCUPANT LOADS LISTED ARE FOR VENTILATION SCHEDULE CALCULATIONS. EGRESS BASED ON S.F. OCCUPANT CALCULATIONS.

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OCCUPANCY INFORMATION	
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OCCUPANCY USE (NYS BC) (NFPA 101)	BUSINESS
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OCCUPANT LOAD FACTOR TABLE 1004.1.1	100 GROSS SQ. FT. PER PERSON
CONSTRUCTION TYPE	TYPE 3B
TOTAL WORK AREA	9,797 SQ. FT.
RENOVATION WORK AREA	9,797 SQ. FT.
NEW WORK AREA	0 SQ. FT.
AUTOMATIC SPRINKLER SYSTEM	
THROUGHOUT BUILDING	FULLY PROTECTED
LIMITED AREAS	

BUILDING CODE OF NEW YORK STATE - TABLE 601	
BUILDING ELEMENTS	TYPE 3B
STRUCTURAL FRAME	0
BEARING WALLS EXTERIOR	2 HOUR
BEARING WALLS INTERIOR	0 HOUR
NONBEARING WALL/PARTITION EXTERIOR	SEE TABLE 602
NONBEARING WALL/PARTITION INTERIOR	0
FLOOR CONSTRUCTION	0
ROOF CONSTRUCTION	0

INTERIOR FINISH CLASSIFICATIONS

- WALL AND CEILING FINISHES, WHEN TESTED IN ACCORDANCE WITH NFPA 255
- CLASS 'A':
- FLAME SPREAD 0-25;
- SMOKE DEVELOPMENT 0-450
- CLASS 'B':
- FLAME SPREAD 26-75;
- SMOKE DEVELOPMENT 0-450
- CLASS 'C':
- FLAME SPREAD 76-200;
- SMOKE DEVELOPMENT 0-450
- FLOOR FINISHES, WHEN TESTED IN ACCORDANCE WITH NFPA 253
- CLASS I:
- CRITICAL RADIANT FLUX MINIMUM OF 0.45 W/SQ. CM
- CLASS II:
- CRITICAL RADIANT FLUX MINIMUM OF 0.22 W/SQ. CM

FIRE PROTECTION AND MEANS OF EGRESS SYMBOL LEGEND	
MARK	DESCRIPTION
←	POINT OF EXIT ACCESS AND DIRECTION OF EGRESS TRAVEL
●	REMOTE POINT OF EXIT ACCESS TRAVEL
— (50') —	DISTANCE OF TRAVEL FROM REMOTE POINT TO POINT OF EXIT ACCESS
— (1-HR) —	SMOKE BARRIER (1-HOUR FIRE RESISTANCE-RATED CONSTRUCTION)
— (SMOKE) —	SMOKE PARTITION (SMOKE-LIMITING)
— (SUITE) —	SUITE SEPARATION PARTITION (SMOKE-LIMITING)
— (1-HR) —	1-HOUR FIRE RESISTANCE-RATED CONSTRUCTION
— (2-HR) —	2-HOUR FIRE RESISTANCE-RATED CONSTRUCTION
FHC	FIRE HOSE CABINET
FEC	FIRE EXTINGUISHER IN CABINET
FE	FIRE EXTINGUISHER ON HOOK (EX = EXISTING)
FEA	FIRE ALARM HORN/STROBE (EX = EXISTING)
FEI	FIRE ALARM MANUAL PULL (EX = EXISTING)
EXIT	EXIT SIGNAGE (FILL INDICATES DIRECTION TO EXIT)
HAZ	HAZARDOUS AREA: SMOKE / PARTITION ENCLOSURE REQUIRED (DOORS SHALL BE SELF-CLOSING OR AUTOMATIC CLOSING)
□	AREA NOT IN THE SCOPE U.N.O.

KEY NOTES:


- EXIT STAIR #1
36" DOOR, 160 OCCUPANTS
38" STAIR, 127 OCCUPANTS
- EXIT STAIR #2
41" STAIR, 137 OCCUPANTS
- EXIT STAIR #3
36" DOOR, 160 OCCUPANTS
40" STAIR, 133 OCCUPANTS

EXITING DATA, CALCULATIONS, AND FIRE PROTECTION REQUIREMENTS (CH. 38 NFPA 101)			
ITEM/ DESCRIPTION	REQUIRED		REMARKS/SECT. REFERENCE
	CALCULATED	ACTUAL	
TOTAL OCCUPANT LOAD SERVED, BASED ON 100 SQ. FT./PERSON	98 PERSONS	SEE PLANS	EGRESS TOTAL CAPACITY FOR 397 OCCUPANTS
NUMBER OF EXITS	2 SEPARATE		- SEPARATE
EGRESS WIDTH PER OCCUPANT			
LEVEL COMPONENTS	0.2 INCHES		COMPLIES 38.2.3.1
STAIRS, RAMPS	0.3 INCHES		COMPLIES 38.2.3.1
MINIMUM CORRIDOR WIDTH	44 INCHES		COMPLIES 38.2.3.2
MINIMUM EXIT ACCESS DOOR WIDTH	32 INCHES CLEAR		COMPLIES 38.2.2.2
MAXIMUM DEAD END CORRIDOR	50 FEET		COMPLIES 38.2.5.2.1
REQUIRED RESISTANCE RATING: -ENCLOSURE CONNECTING 4 OR MORE STORIES -OTHER ENCLOSURES IN NEW CONSTRUCTION -EXISTING BARRIERS IN EXISTING BUILDING		REQUIRED FIRE BARRIER (HOURS) -2 HOUR -1 HOUR -1/2 HOUR	COMPLIES 38.3.1
MAXIMUM DISTANCE BETWEEN ANY POINT IN A NON-SLEEPING SUITE TO AN EXIT	300 FEET		COMPLIES - SEE PLANS 38.2.6.3
PROTECTION OF VERTICAL OPENINGS, SHAFTS, CHUTES, HOISTWAYS, STAIRWAYS, ETC.		1 - HOUR FIRE RESISTANCE RATING SEPARATING THE EXIT STAIR CONNECTING 3 OR LESS FLOOR IN NEW CONSTRUCTION. 1/2-HOUR FIRE RESISTANCE RATING IN EXISTING BUILDING	COMPLIES 38.3.2.1
HAZARDOUS AREAS		1 - HOUR FIRE RESISTANCE RATING OR SPRINKLER PROTECTION AND SMOKE RESISTING PARTITION	COMPLIES 38.3.1
FIRE ALARM	YES		COMPLIES 38.3.4.1
CORRIDOR WALLS AND SUITES, MINIMUM FIRE RESISTANCE RATING	MULTIPLE TENANTS -	1 HOUR	COMPLIES 38.3.6.1
SMOKE BARRIER	NOT REQUIRED		N/A 38.3.7
INTERIOR WALL AND CEILING FINISH REQUIREMENTS		CLASS A OR B IN EXITS AND EXIT ACCESS CORRIDOR / CLASS A, B, OR C IN OTHER AREA	COMPLIES 38.3.3.2
INTERIOR FLOOR FINISH REQUIREMENTS		CLASS I OR II IN EXIT ENCLOSURES	COMPLIES 38.3.3.3

Montefiore

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PRIMARY HEALTH CLINICS
FIRST FLOOR
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NEW CITY, NY 10956

KEY PLAN: NOT TO SCALE
FIRST FLOOR

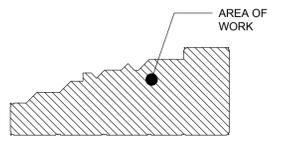

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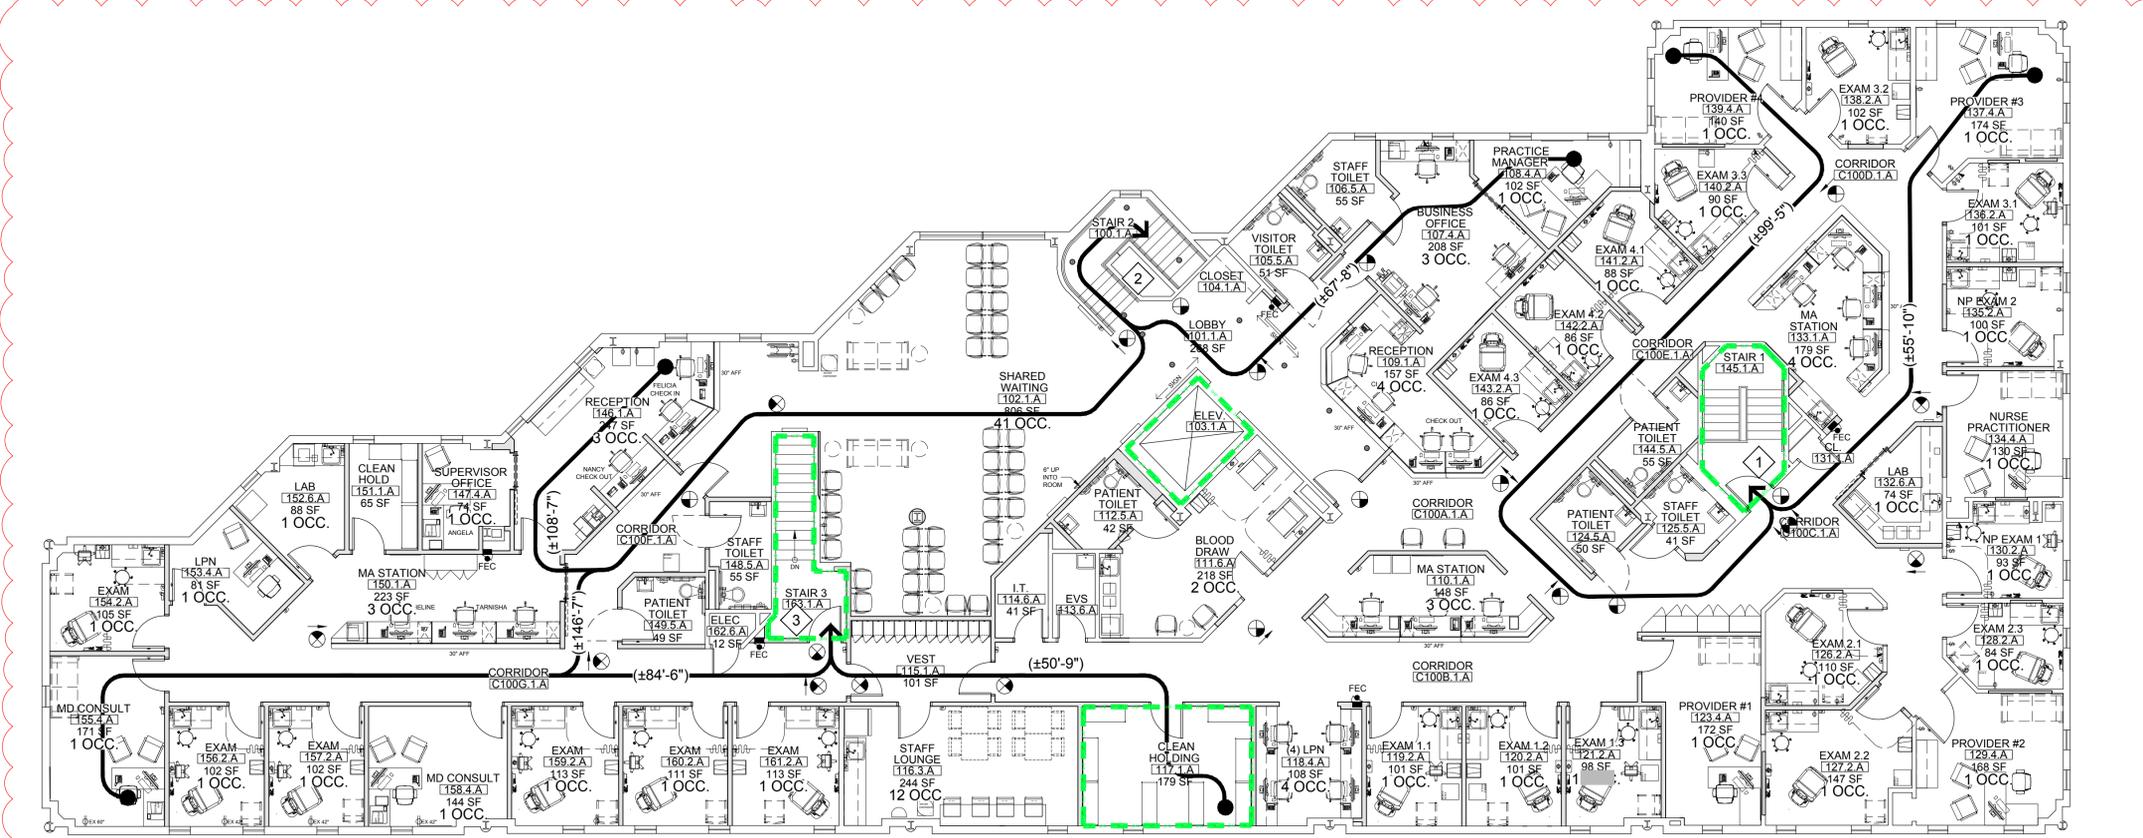
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DRAWING TITLE:
EGRESS AND LIFE SAFETY PLAN - FIRST FLOOR

PROJECT NUMBER
21019
DATE
2/15/2022
SCALE
AS NOTED
DRAWING NUMBER

A2.2

2
ADD.#03



1 EGRESS AND LIFE SAFETY PLAN - FIRST FLOOR
A2.1 SCALE: 1/8" = 1'-0"
Scale: 1/8" = 1'-0"
AREA NOT IN SCOPE U.N.O.

Montefiore

MONTEFIORE HEALTH SYSTEM
NYACK CAMPUS

160 NORTH MIDLAND AVENUE
NYACK, NY 10960

HIGHLAND MEDICAL
PRIMARY HEALTH CLINICS
FIRST FLOOR
350 S MAIN ST
NEW CITY, NY 10956

KEY PLAN: NOT TO SCALE
FIRST FLOOR


DEMOLITION LEGEND	
MARK	DESCRIPTION
	EXISTING PARTITION TO REMAIN
	PARTITION TO BE REMOVED. PATCH AND REPAIR AS REQUIRED.
	EXISTING DOOR TO REMAIN.
	EXISTING DOOR TO BE REMOVED.
	EXISTING MILLWORK AND FIXTURES TO REMAIN.
	MILLWORK AND FIXTURES TO BE REMOVED.

GENERAL DEMO NOTES:

- ALL FINISHES WILL BE REPLACED WITH NEW. PREP WALLS AS REQUIRED. REMOVE ALL EXISTING HARDWARE, FASTENERS, ACCESSORIES, ETC.
- SEE MEP DRAWING FOR MORE REQUIREMENTS.

DEMOLITION PLAN KEY NOTES:

- EXISTING SKYLIGHTS TO REMAIN.
- REMOVE EXISTING PARTITIONS. SAFE OFF AND CAP ALL ELECTRICAL AND PLUMBING LINES BACK TO NEAREST CONNECTION. COORDINATE WITH MEP DRAWINGS.
- REMOVE EXISTING CASEWORK SINKS.
- REMOVE EXISTING DOORS AND FRAMES.
- REMOVE EXISTING PLUMBING FIXTURE(S). CAP SUPPLY AND WASTE LINES. SEE MEP DRAWINGS
- REMOVE EXISTING CEILING AND FLOOR FINISHES AS REQUIRED FOR INSTALLATION OF NEW WORK. REFER TO FLOOR PLAN.
- REMOVE EXISTING WINDOW TREATMENT THROUGHOUT.
- REMOVE CURB AND EXPOSE STRUCTURAL COLUMN.
- REMOVE EXISTING HANDRAILS AND REPLACE WITH NEW. REFURBISH WOOD CAP.
- CONTRACTOR TO:
 - REMOVE EXISTING DOOR AND FRAME.
 - REMOVE EXISTING PLUMBING FIXTURE(S). CAP SUPPLY AND WASTE LINES. REFER TO MEP DRAWINGS FOR FURTHER INFORMATION.
- CONTRACTOR TO:
 - REMOVE EXISTING DOOR AND FRAME.
 - REMOVE EXISTING CASEWORK AND SINK. MODIFY/CUT/CAP PIPING AS REQUIRED BY NEW WORK. REFER TO MEP DRAWINGS FOR FURTHER INFORMATION.
- REMOVE ALL EXISTING FINISHES & PREPARE FOR INSTALLATION OF NEW. EXISTING CERAMIC TILE TO REMAIN. CEILING GRID TO REMAIN. LIGHTING TO REMAIN. FLOAT WALLS FOR PAINT AS REQ.
- REMOVE EXISTING CARPET TILE & STAIR NOSING & PREPARE FOR NEW.
- REMOVED RAISED PLATFORM CONDITION

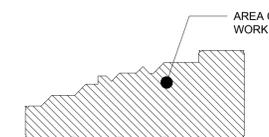

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DRAWING TITLE:

**DEMOLITION PLAN -
GROUND AND FIRST
FLOOR**


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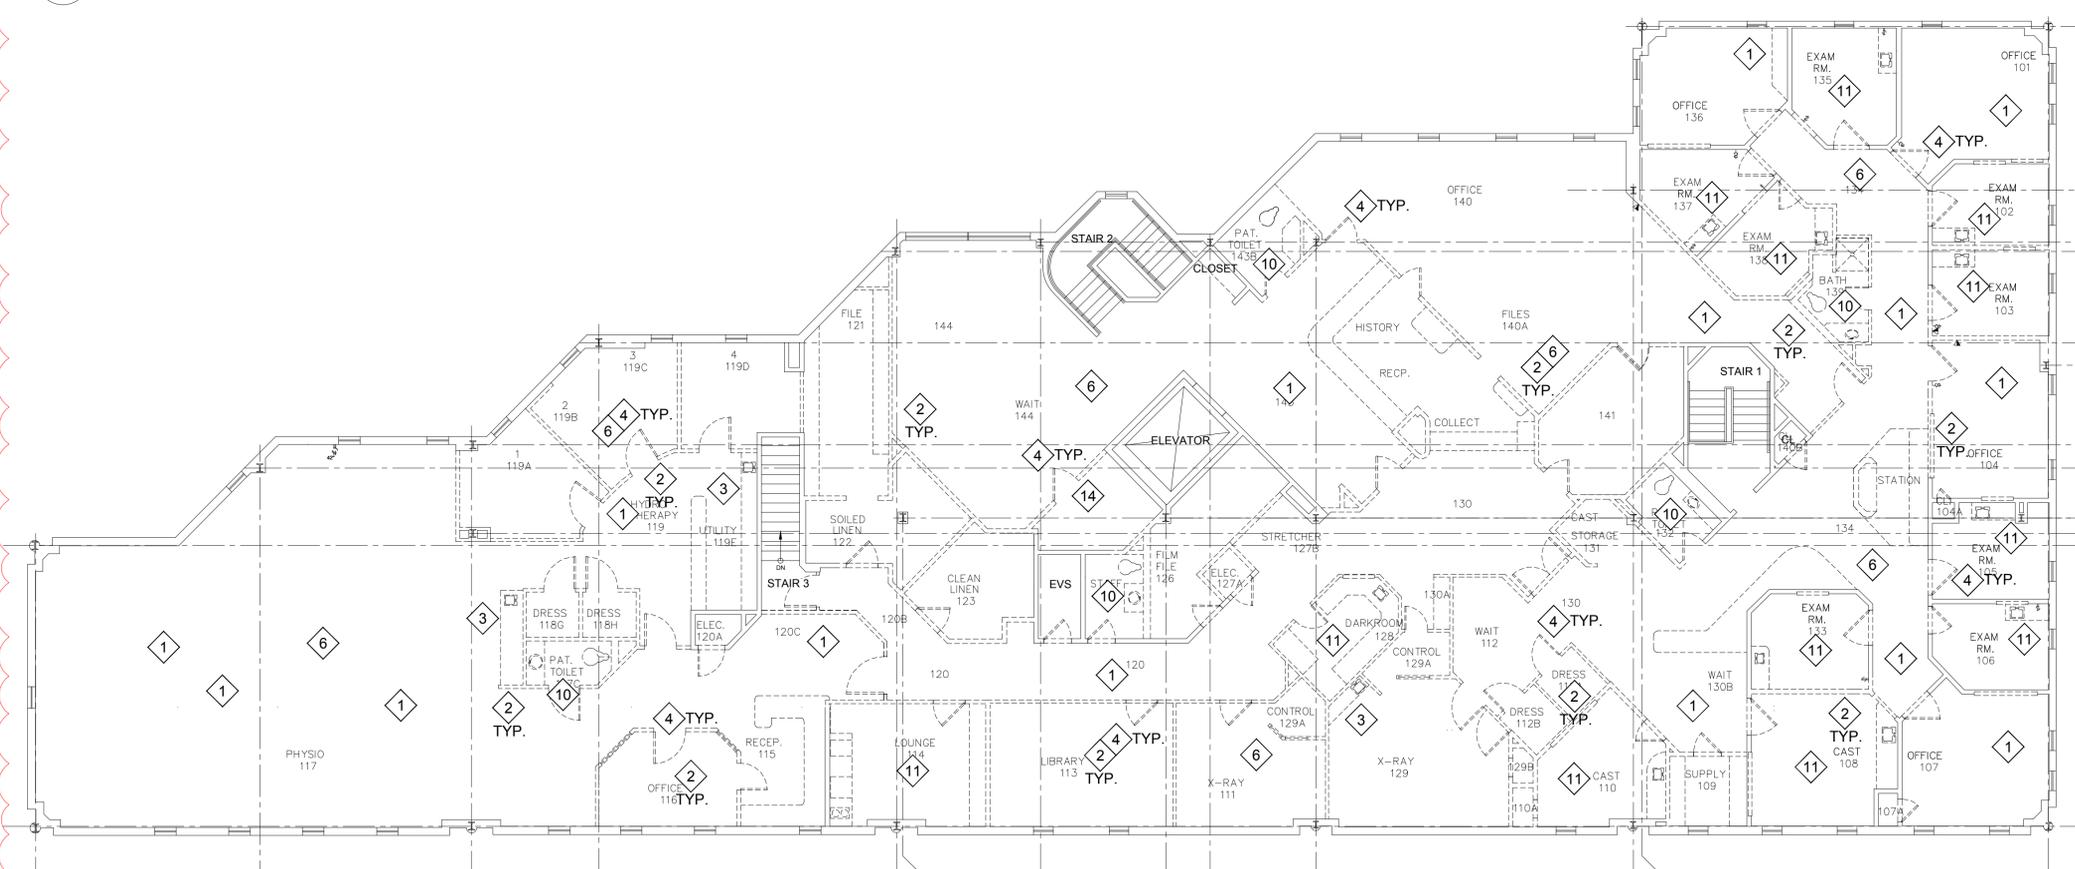
DRAWING NUMBER

SCALE
AS NOTED

A3.1



1 DEMOLITION PLAN - GROUND FLOOR
A3.1 SCALE: 1/8" = 1'-0"

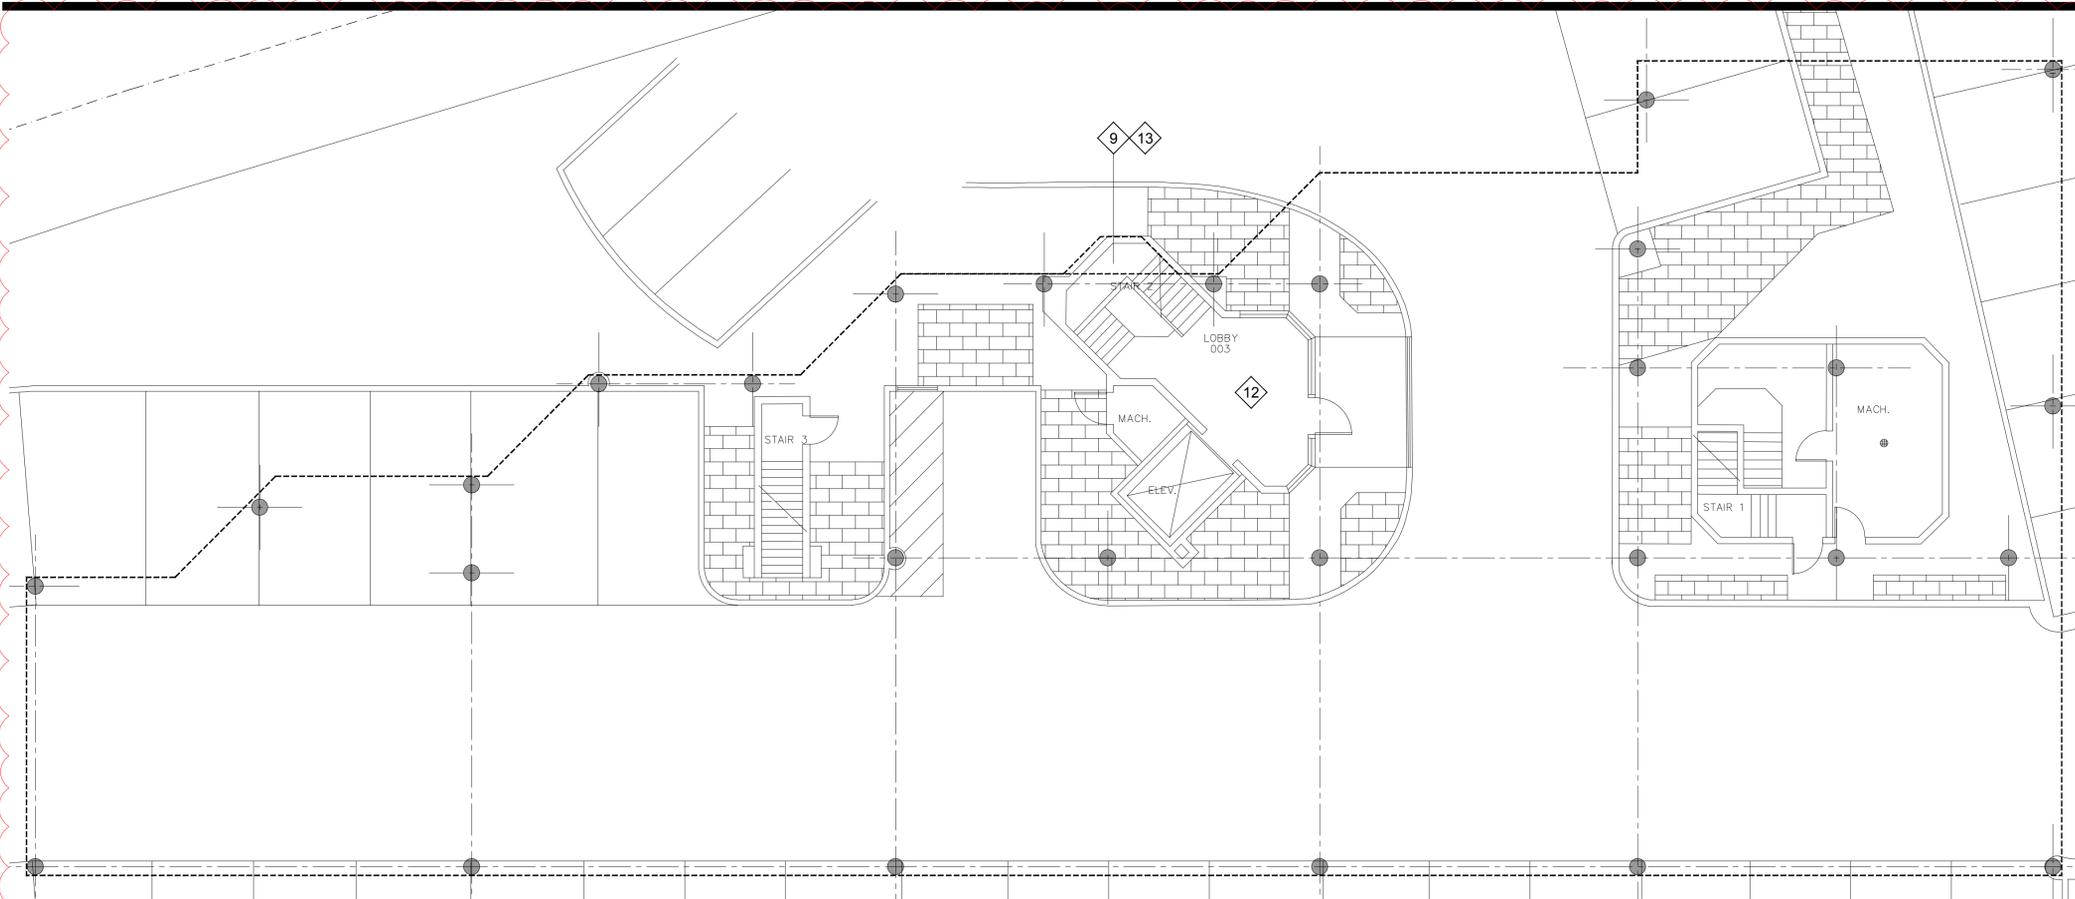

2 DEMOLITION PLAN - FIRST FLOOR
A3.1 SCALE: 1/8" = 1'-0"

2
ADD. #03

2
ADD. #03


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HIGHLAND MEDICAL
PRIMARY HEALTH CLINICS
FIRST FLOOR
350 S MAIN ST
NEW CITY, NY 10956

KEY PLAN: NOT TO SCALE
FIRST FLOOR



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DRAWING TITLE:
**FIRST FLOOR
CONSTRUCTION AND
EQUIPMENT PLAN**

PROJECT NUMBER
21019

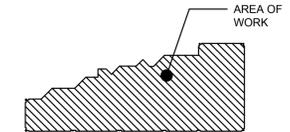DATE
2/15/2022

DRAWING NUMBER

SCALE
AS NOTED

A4.1

FLOOR PLAN KEY NOTES:

- 1 EXISTING SIDE APPROACH PASS WINDOW TO REMAIN.
- 2 COORDINATE BOXOUT WITH DEPTH OF LOCKERS
- 3 PATCH & REPAIR EXISTING FINISHES WITH LIKE KIND.
- 4 TOP OUT EXISTING PARTITION AS REQUIRED BOTH SIDES. PROVIDE SOUND ATTENUATION BATTS.
- 5 PAD OUT WALL.
- 6 NEW WINDOW TREATMENT. (TYPICAL ALL WINDOWS ON FLOOR)
- 7 REPLACE HANDRAIL WITH NEW SEE DETAIL REFURBISH WOOD CAP TRIM.
- 8 OPEN WALL AND STALL SOLID FOR PLYWOOD AREA 3'-0"x5'-0" LONG TL FOR BLOCKING TO SUPPORT SIGN INSTALLED BY OTHERS. SEE 11/A11.1 FOR ADDED DETAIL.
- 9 PACK OUT PATCH & REPAIR FOR FLUSH CONDITION.
- 10 COORDINATE POWER & DATA DROPS AND PLYWOOD PANEL BLOCKING REQUIREMENTS WITH MNH IT.
- 11 INSTALL NEW LVT TILE AND RUBBER NOSING ON STAIR TREADS. INSTALL MATCHING LVT TILE ON STAIR RISERS. SEE INTERIOR DESIGN DRAWINGS FOR SECTIONS.
- 12 INSTALL NEW LVT FLOOR IN ELEVATOR.
- 13 COORDINATE FRAMING & FINISH OPENING WITH LOCKERS, LEAVE 1"-2" SCRIBE ON EACH SIDE.
- 14 PRIVACY CURTAIN TYPICAL ALL EXAM ROOMS AS NOTED.


GENERAL NOTES:

1. ALL PARTITIONS ARE ETR, UNLESS OTHERWISE NOTED.
2. SEE EQUIP. PLAN FOR MILLWORK ELEV. REFERENCES.


ARCHITECTURAL SYMBOLS	
FUNCTION	DESCRIPTION
EQUIPMENT IDENTIFIER	EQUIPMENT IDENTIFIER TAG. REFER TO EQUIPMENT MANUAL AND DETAILS FOR INFORMATION.

2
ADD. #03

2 HAND RAIL DETAIL
A4.1 1 1/2" = 1'-0"

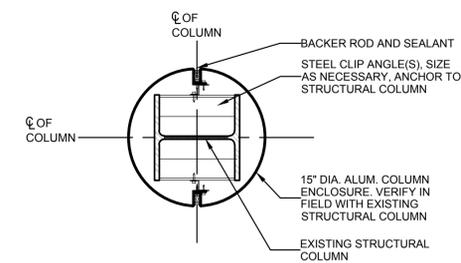

3 PLAN DETAIL OF TYP. COL. ENCLOSURE
A4.1 1 1/2" = 1'-0"

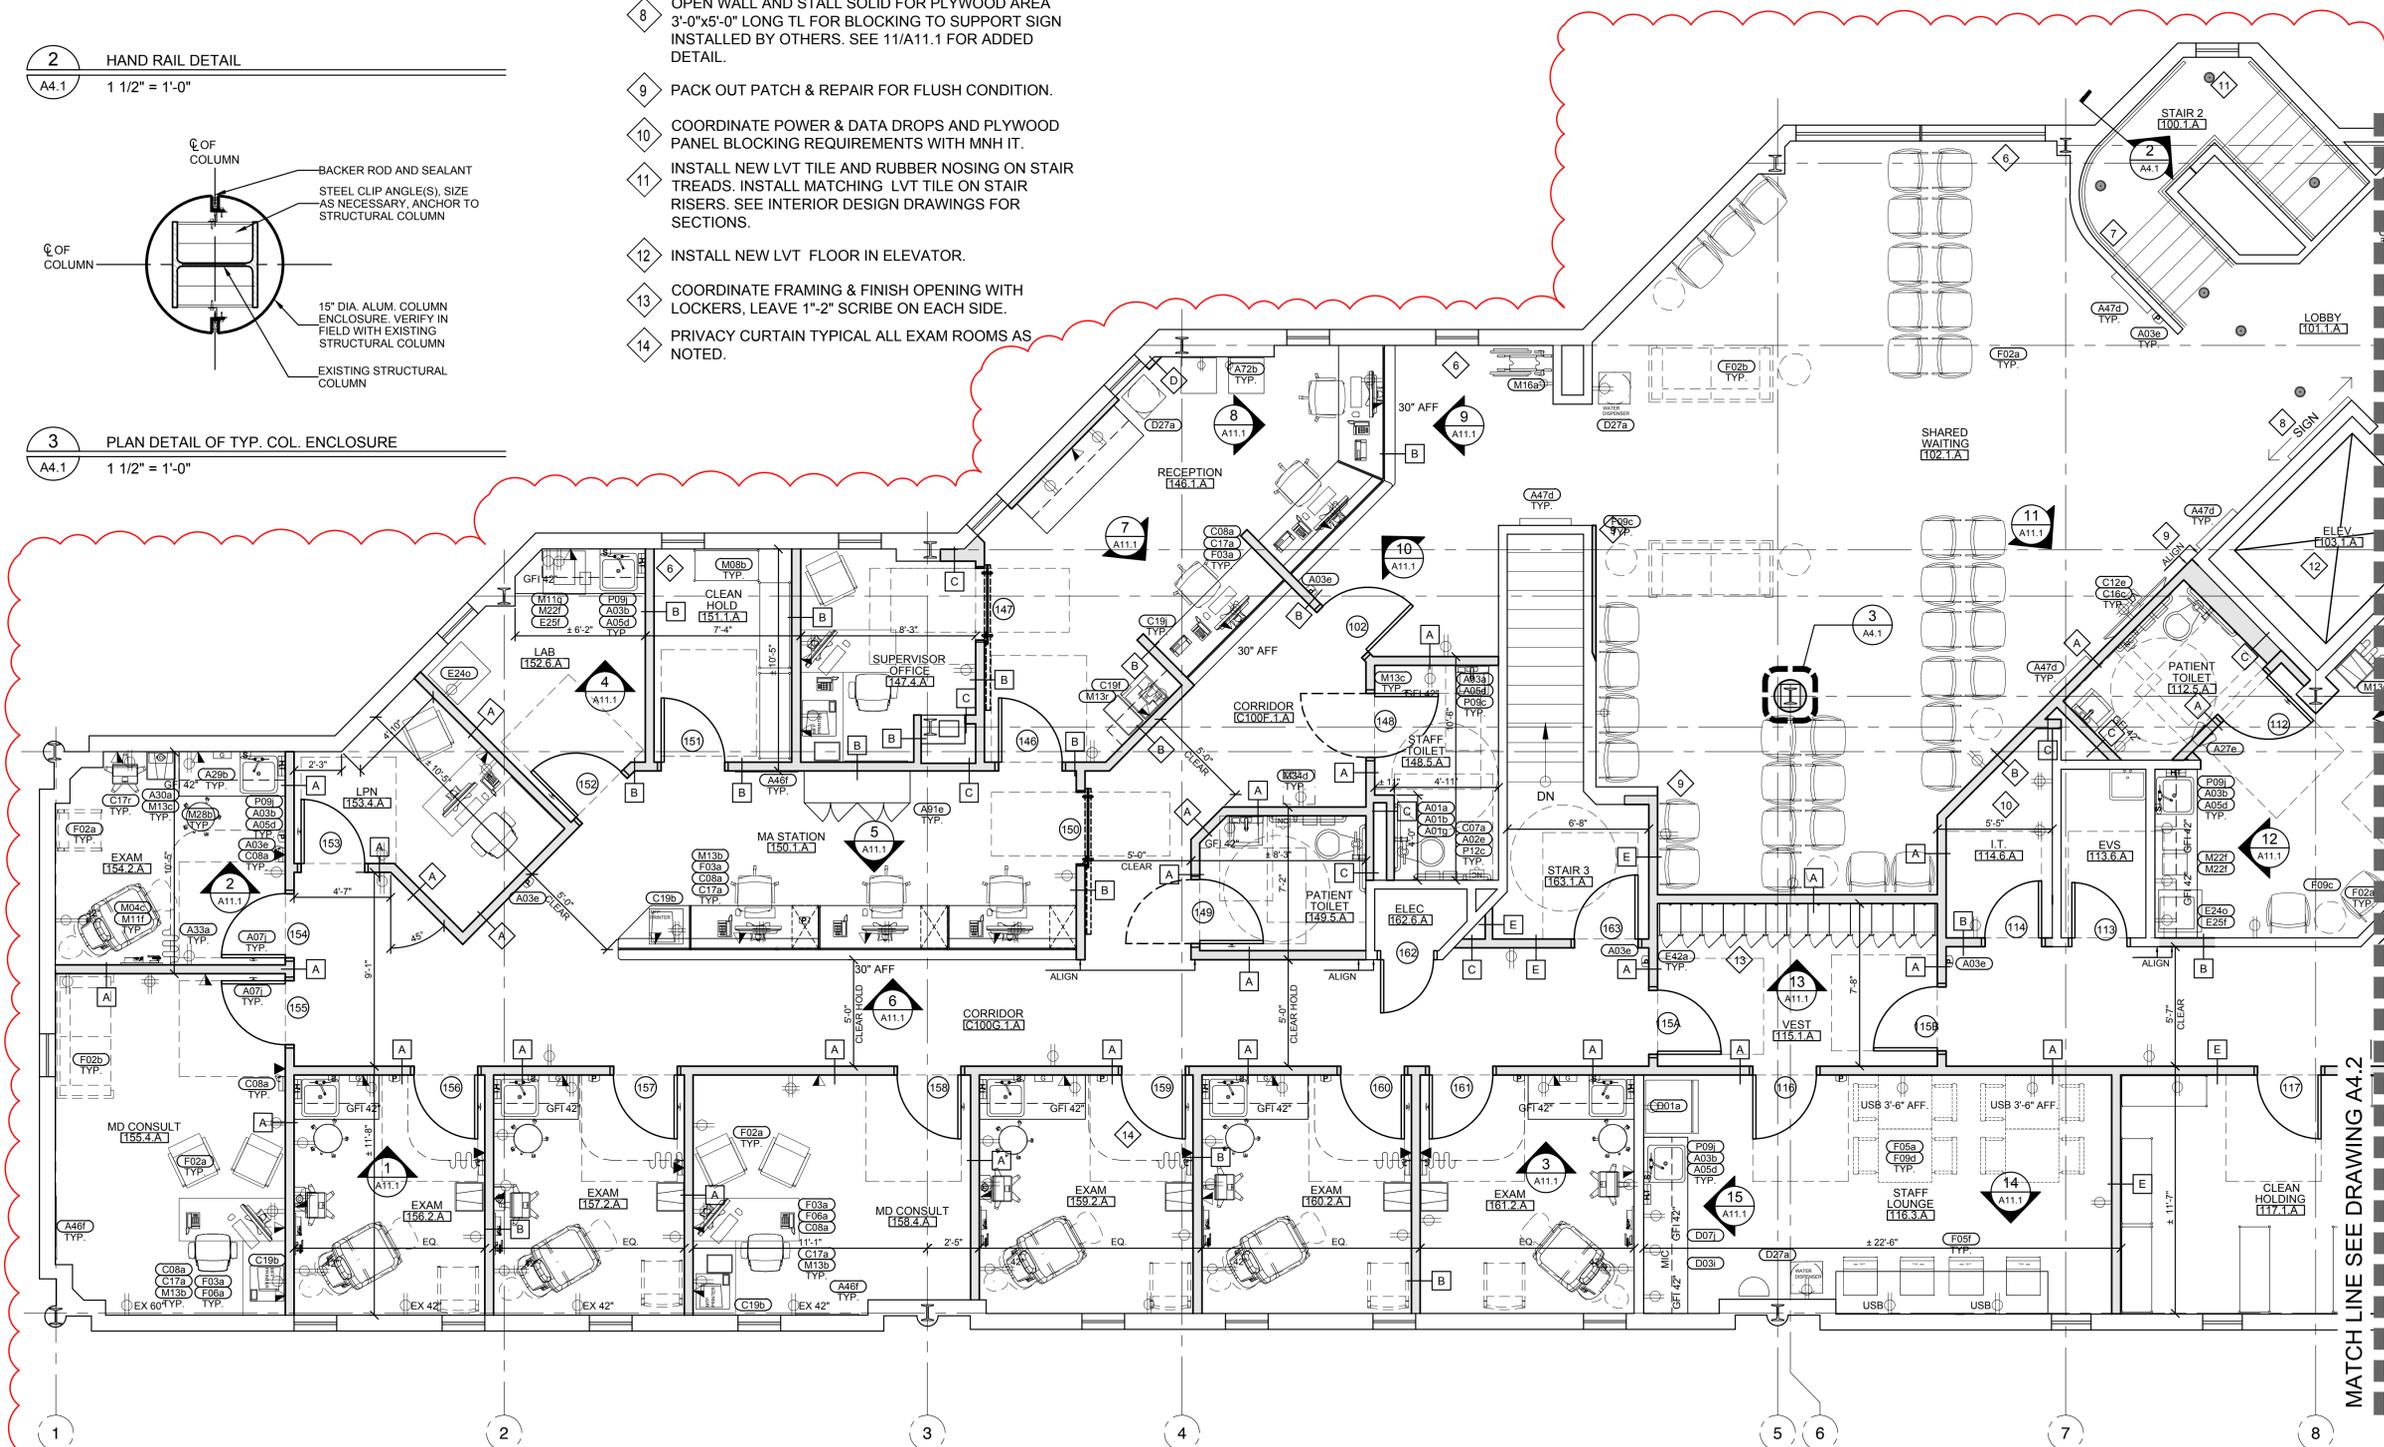

1 FIRST FLOOR CONSTRUCTION AND EQUIPMENT PLAN
A4.1 SCALE: 1/4" = 1'-0"


Scale: 1/4" = 1'-0" AREA NOT IN SCOPE U.N.O.

GENERAL NOTES:

1. ALL PARTITIONS ARE TO BE REMOVED UNLESS OTHERWISE NOTED. SEE DEMO DWG. A3.1
2. SEE MILLWORK ELEVATIONS FOR ADDITIONAL REQUIREMENTS FOR LOCATIONS AND HEIGHTS OF DEVICES.
3. SEE INTERIOR DESIGN DRAWINGS FOR ADDITIONAL FINISH INFORMATION.
4. COORDINATE ALL LOW VOLTAGE WORK WITH MNH IT.
5. CLEAN ALL SKYLIGHTS AT ROOF LEVEL AND PAINT ALL SKYLIGHT WELLS ON INTERIOR. PATCH, REPAIR, FLOAT ALL EXISTING EXTERIOR WALLS AS REQUIRE BY REMOVAL OF WALL COVERING AND NEW WORK.

FLOOR PLAN KEY NOTES:

- 1 PROVIDE BLOCKING FOR SIGN BY OTHERS.
- 2 CLEAN AND REPAIR HANGER ROD & SHELF AS REQUIRE TO MATCH NEW WORK.
- 3 GLASS SNEEZE GUARD, TYPICAL AT ALL PROVIDER STATIONS.
- 4 PRIVACY CURTAIN TYPICAL ALL EXAM ROOMS AS NOTED.

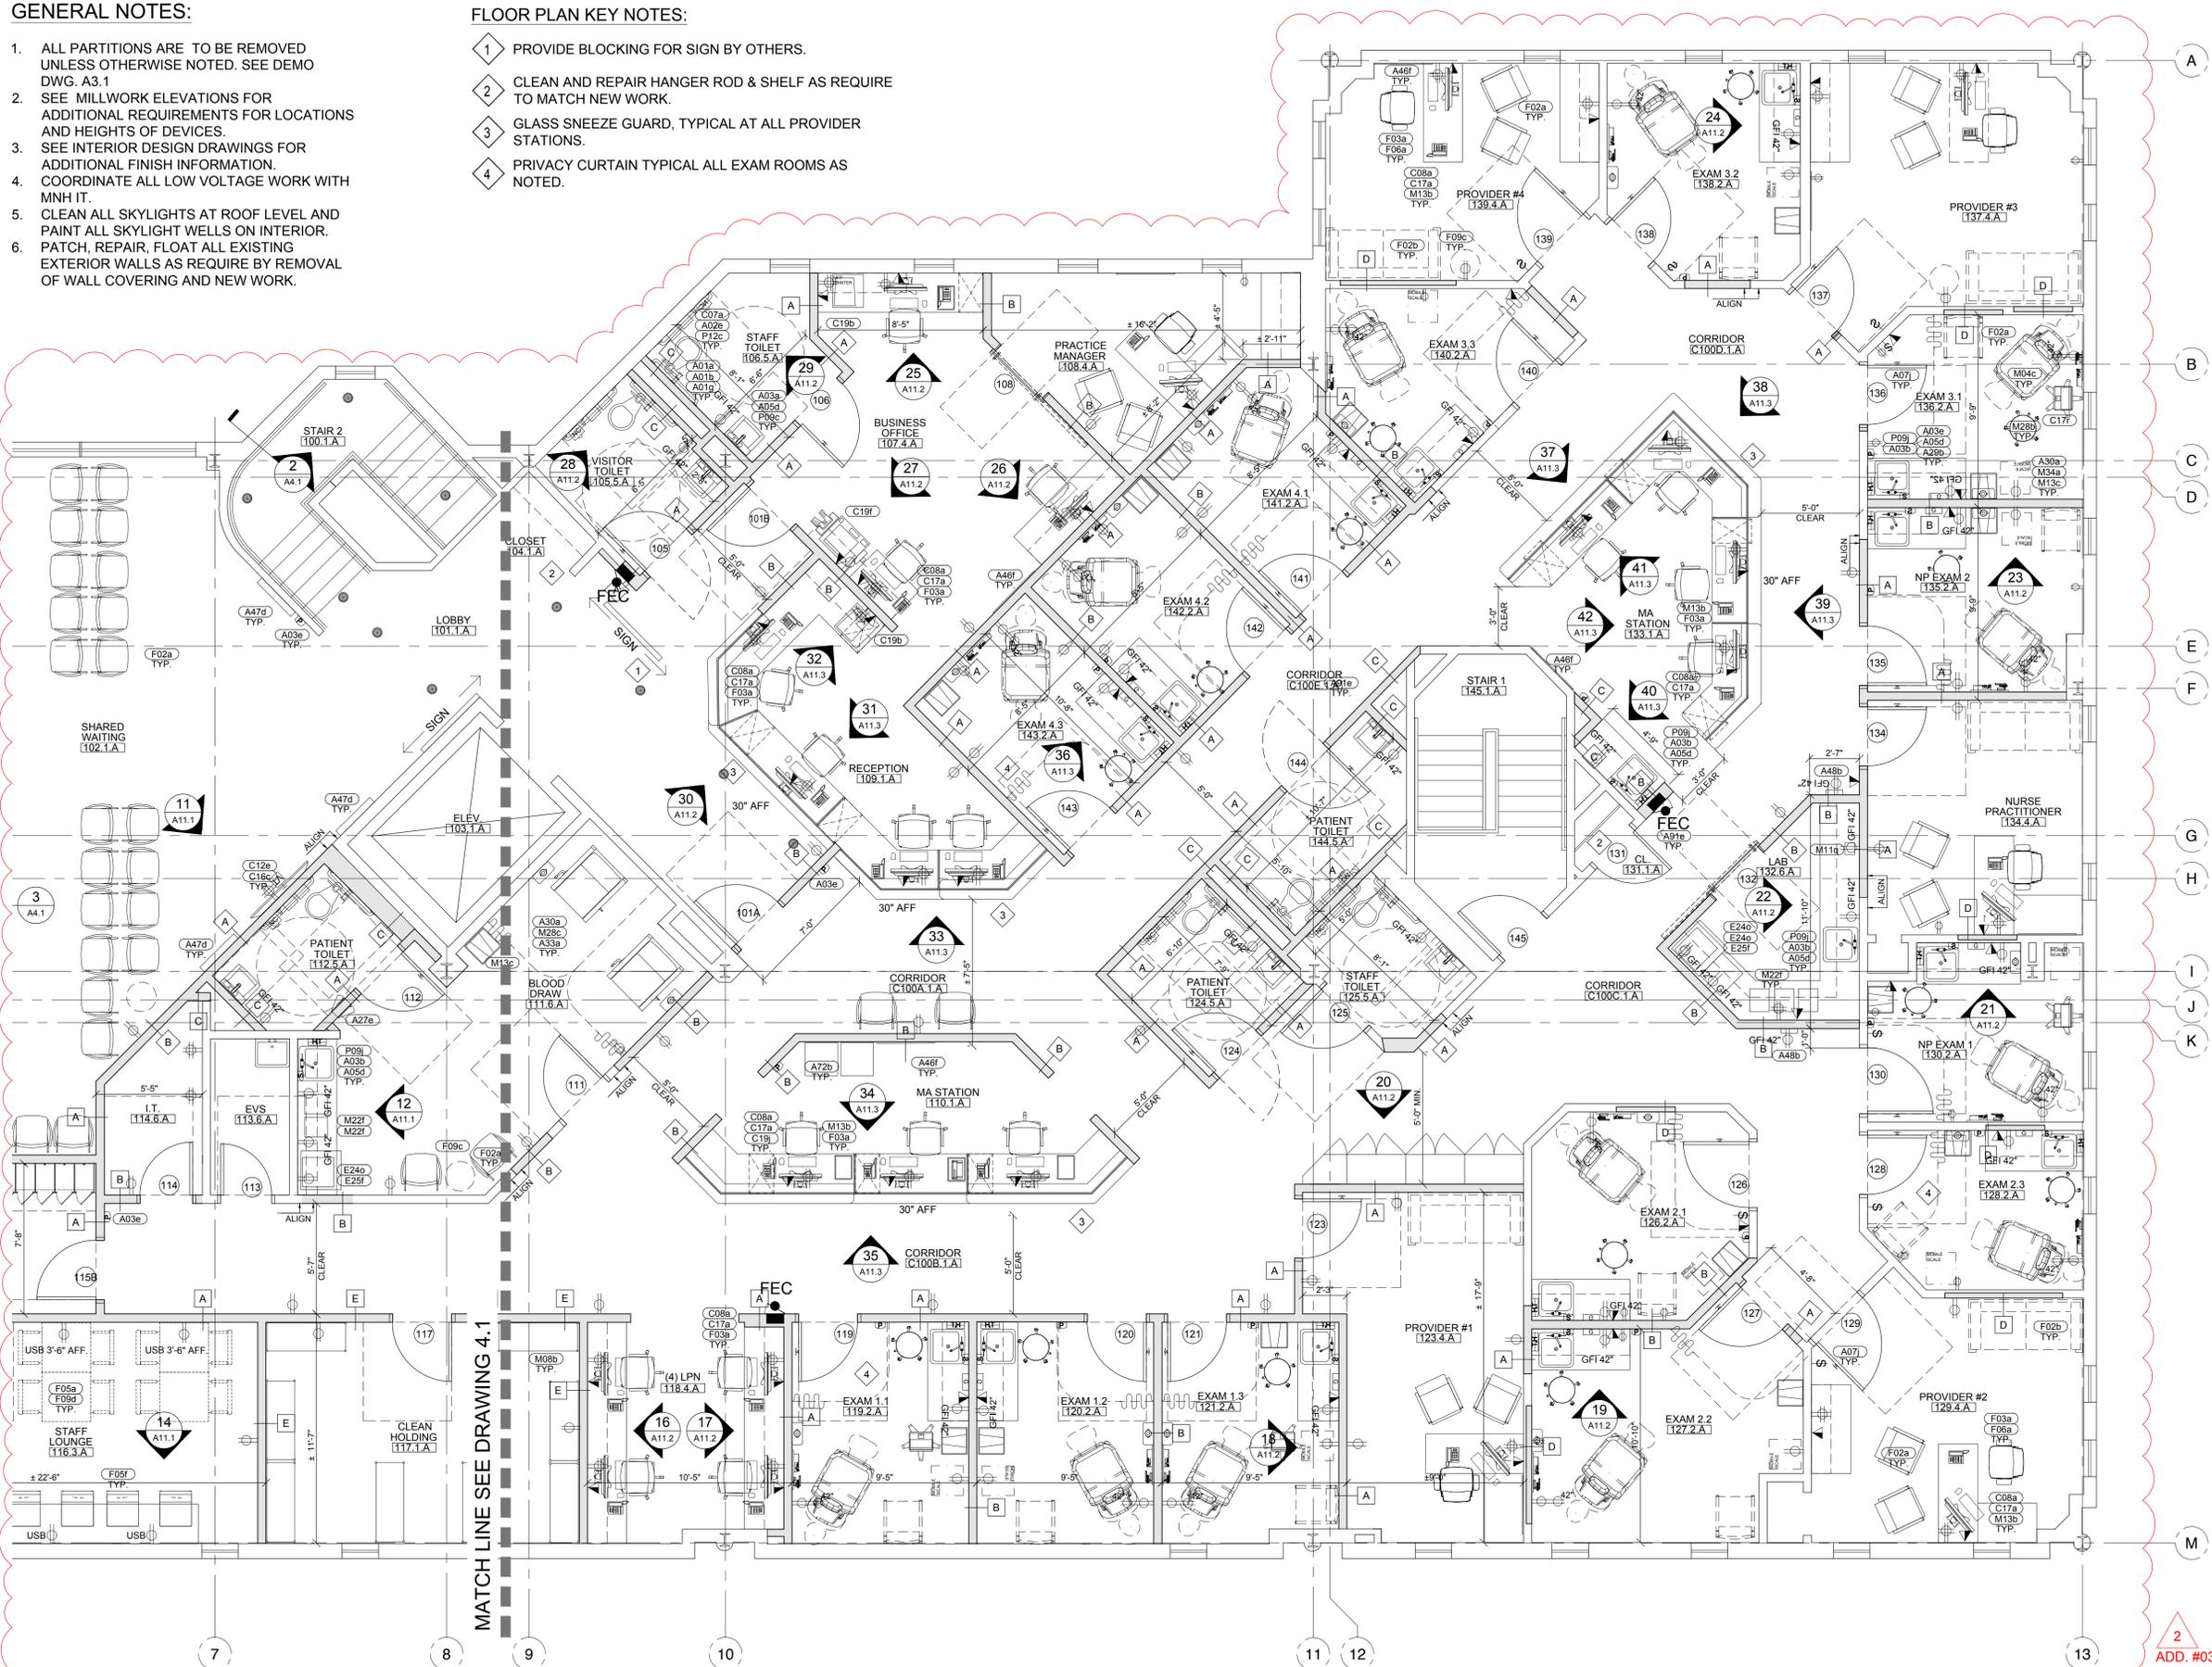


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EQUIPMENT PLAN**

PROJECT NUMBER
21019

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DRAWING NUMBER

SCALE
AS NOTED

A4.2

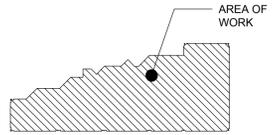1 FIRST FLOOR CONSTRUCTION AND EQUIPMENT PLAN
A4.2 1/4" = 1'-0"

Scale: 1/4" = 1'-0" AREA NOT IN SCOPE U.N.O.

2
ADD.#03


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**GROUND FLOOR
CONSTRUCTION PLAN**

PROJECT NUMBER
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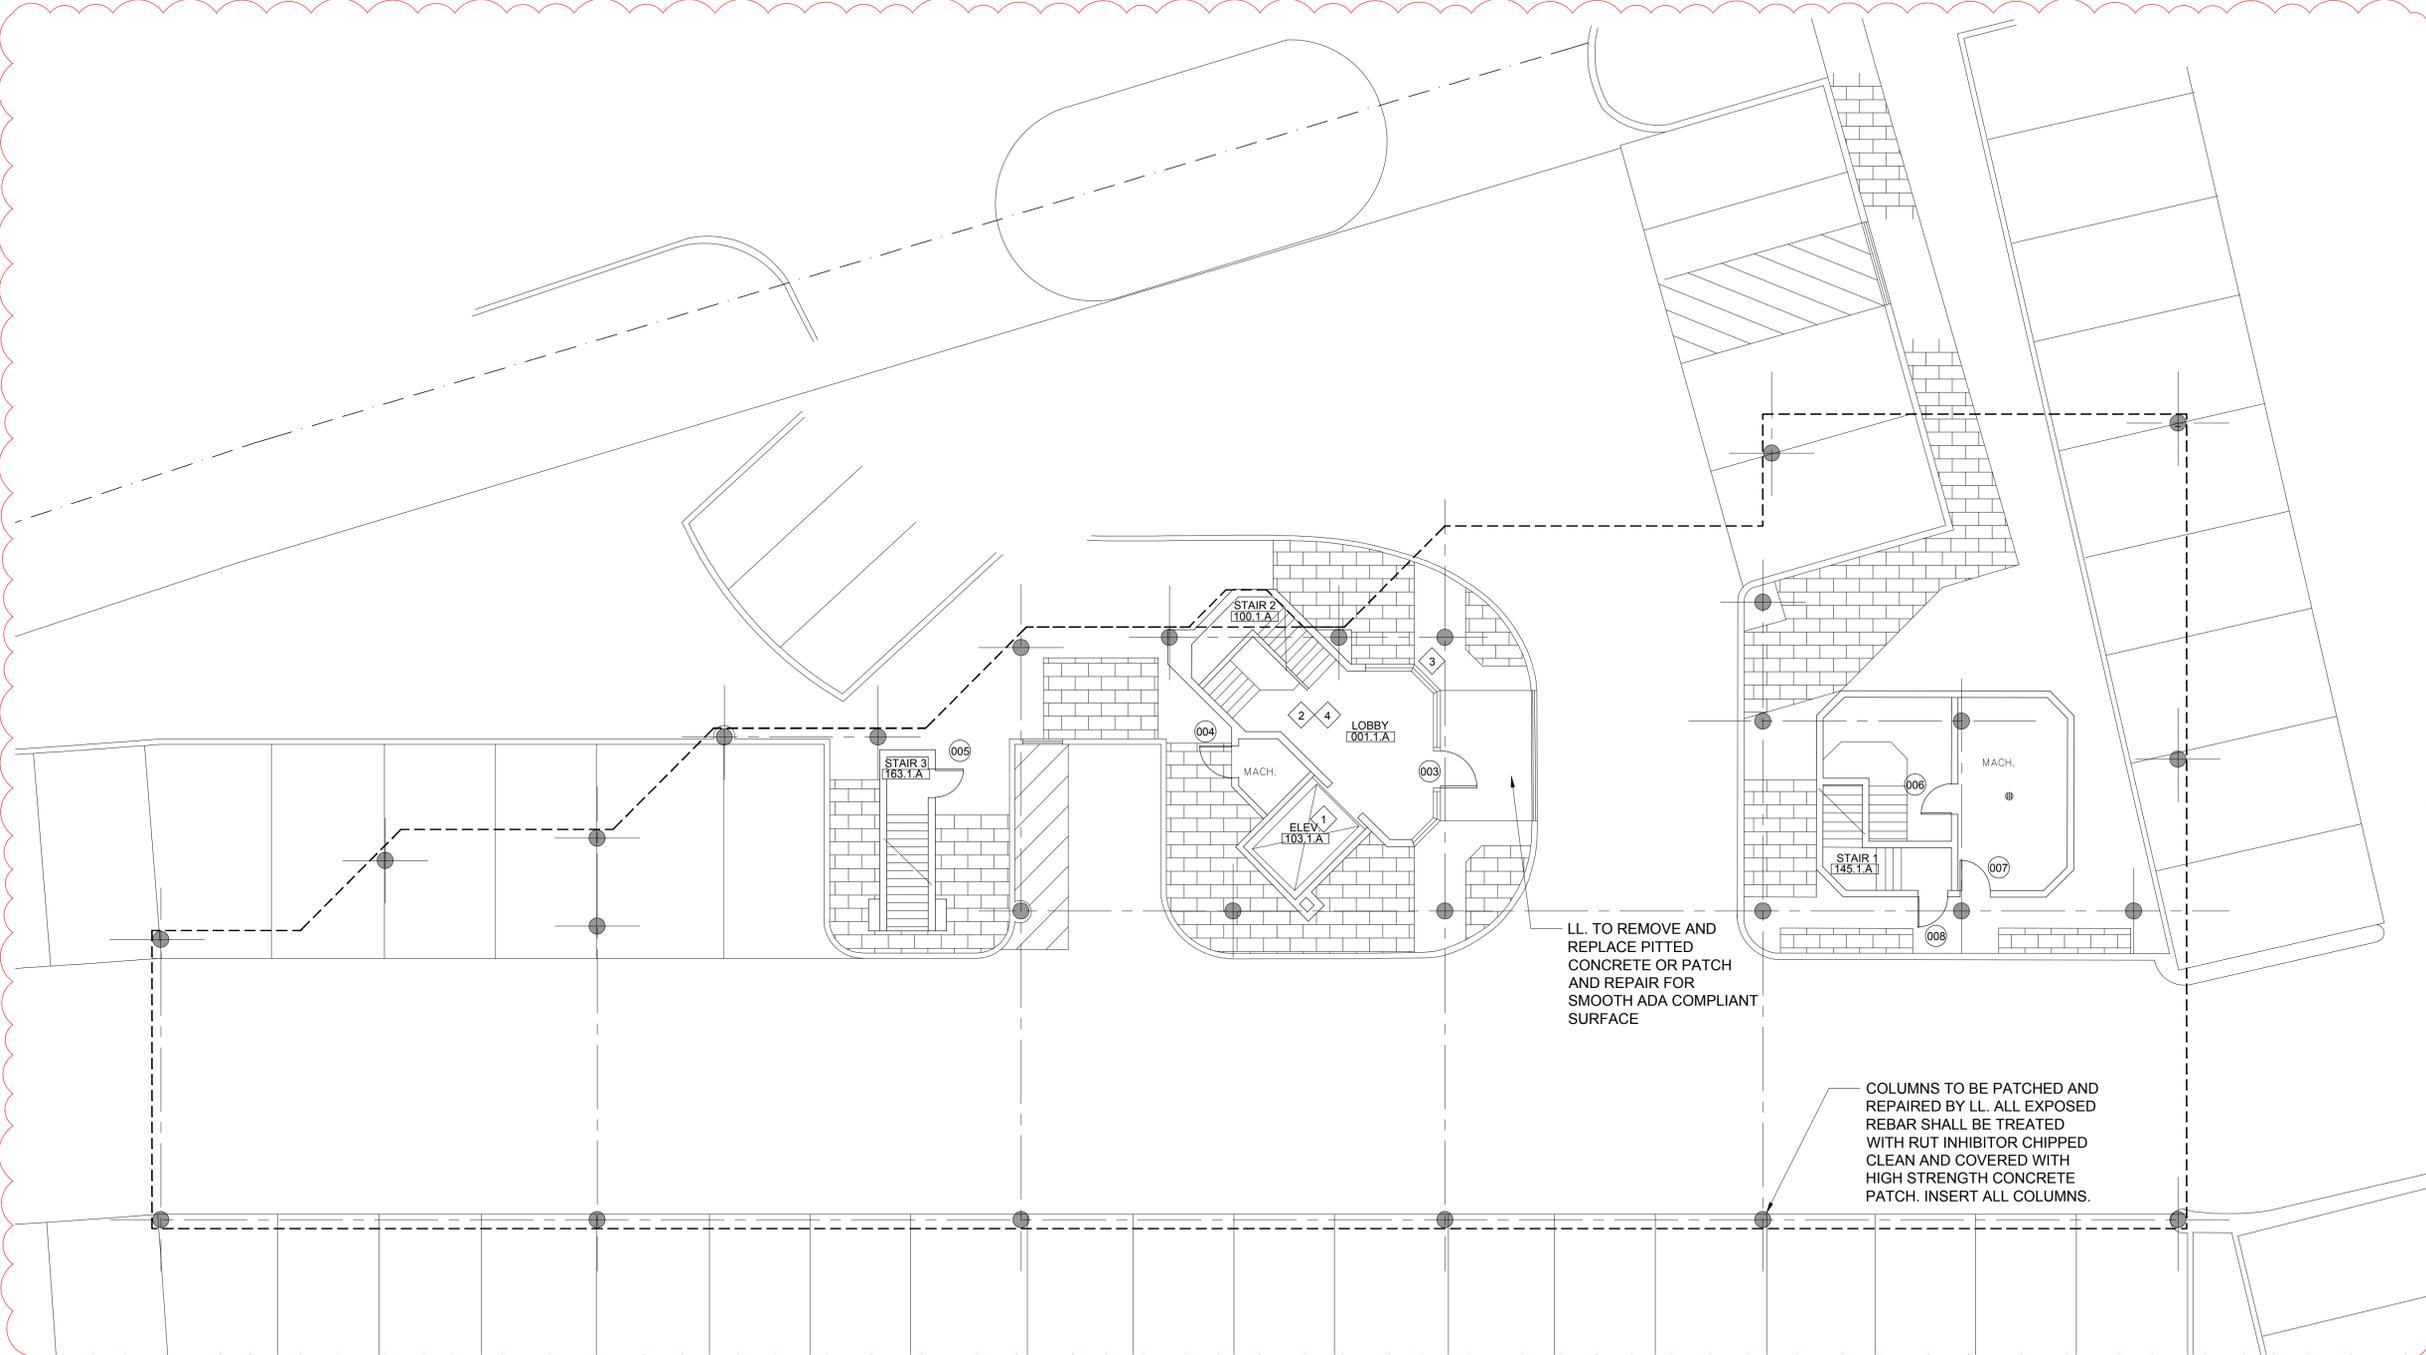
DRAWING NUMBER

A4.3

FLOOR PLAN KEY NOTES:

- 1 REMOVE EXISTING FLOOR IN ELEVATOR AND INSTALL NEW LVT SEE FINISH SCHEDULE. CHECK ALL LIGHTS AND RE-LAMP AS REQUIRED. REMOVE ANY MISC. SIGNS, CLEAN ALL SURFACES.
- 2 EXISTING C.T. FLOOR TO REMAIN. EXIST. CEILING GRID AND LIGHTING TO REMAIN, INSTALL NEW CEILING TILES. SEE 4.1 FOR STAIR REFURBISHMENT REQUIREMENTS.
- 3 REMOVE ALL EXISTING WINDOW SIGNS, CLEAN GLASS.
- 4 REMOVE ALL EXISTING WALL COVERINGS, FLOAT AND PATCH AS REQUIRED FOR NEW PAINT.

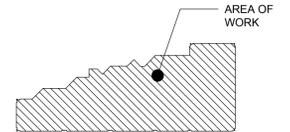2
ADD. #03



1 GROUND FLOOR CONSTRUCTION PLAN
A4.3 1/8" = 1'-0"

Scale: 1/4" = 1'-0"

AREA NOT IN SCOPE U.N.O.

REFLECTED CEILING PLAN KEY NOTES:

- 1 UNDERCABINET TASK LIGHT LOCATION. TYPICAL ALL OVERHEAD CABINETS IN EXAM ROOMS AND LABS.
- 2 EXISTING LIGHTING TO REMAIN IN STAIR WELL AND MAIN SKYLIGHT SURROUND. INSTALL NEW LED LAMPS.
- 3 REPLACE EXISTING BATTERY POWERED LIGHT THIS LOCATION WITH NEW.
- 4 REPLACE EXIT SIGN THIS LOCATION WITH NEW.
- 5 EXISTING SKYLIGHT, CLEAN UNIT & PAINT ENCLOSURE WELL.
- 6 EXISTING LIGHT FIXTURE TO REMAIN

REFLECTED CEILING PLAN GENERAL NOTES:

1. ALL WALL CABINETS TO HAVE SLOPED P.L.A.M. TOPS.
2. ELECTRICAL CONTRACTOR TO FIELD VERIFY VOLTAGES BEFORE SUBMITTING SHOP DRAWINGS FOR ANY FIXTURE.
3. ALL ACOUSTICAL CEILING TILES TO BE CENTERED EQUALLY IN ROOM, UNLESS OTHERWISE NOTED.
4. SEE FINISH SCHEDULE FOR FINISH TYPES.
5. ALL DIMENSIONS ARE TO CENTERLINE OF LIGHT FIXTURE UNLESS OTHERWISE NOTED.
6. REFER TO MEP DRAWINGS FOR ADDITIONAL INFORMATION.
7. REFER TO ARCHITECTURAL DRAWINGS, INCLUDING INTERIOR ELEVATIONS AND EQUIPMENT PLANS FOR ADDITIONAL INFORMATION REGARDING LAYOUT AND EXTENT OF WORK REQUIRED.
8. ALL CEILINGS TO BE 9'-0" A.F.F. UNLESS NOTED OTHERWISE.

SYMBOL	SPECIFICATION
	LITHONIA LIGHTING 2TL - 2X2' FLUSH LED LAY-IN FIXTURE
	OXYGEN FUGIT, SURFACE MOUNTED LED VANITY FIXTURE
	6" HALO COMMERCIAL RECESSED LED DOWNLIGHT, SPECTACULAR CLEAR FINISH (C)
	MARK - 4"X6" SLOT LED RECESSED LINEAR
	MARK - 4"X4" SLOT LED RECESSED LINEAR
	JUNO 22" UNDER CABINET LED DIMMING TASK LIGHT WITH MOTION SENSOR
	EXIT SIGN
	NURSE CALL DOME LIGHT
	SECURITY/OBSERVATION CAMERA, CEILING MOUNTED & WALL MOUNTED
	CEILING MOUNTED DATA FOR WIRELESS ACCESS POINT
	CEILING MOUNTED DUPLEX FOR CEILING MOUNTED MONITOR OR TELEVISION
	SUPPLY AIR GRILLE
	RETURN AIR GRILLE
	SPRINKLER HEAD
	SPEAKER (EXISTING SPEAKER WITH NEW COVERS)



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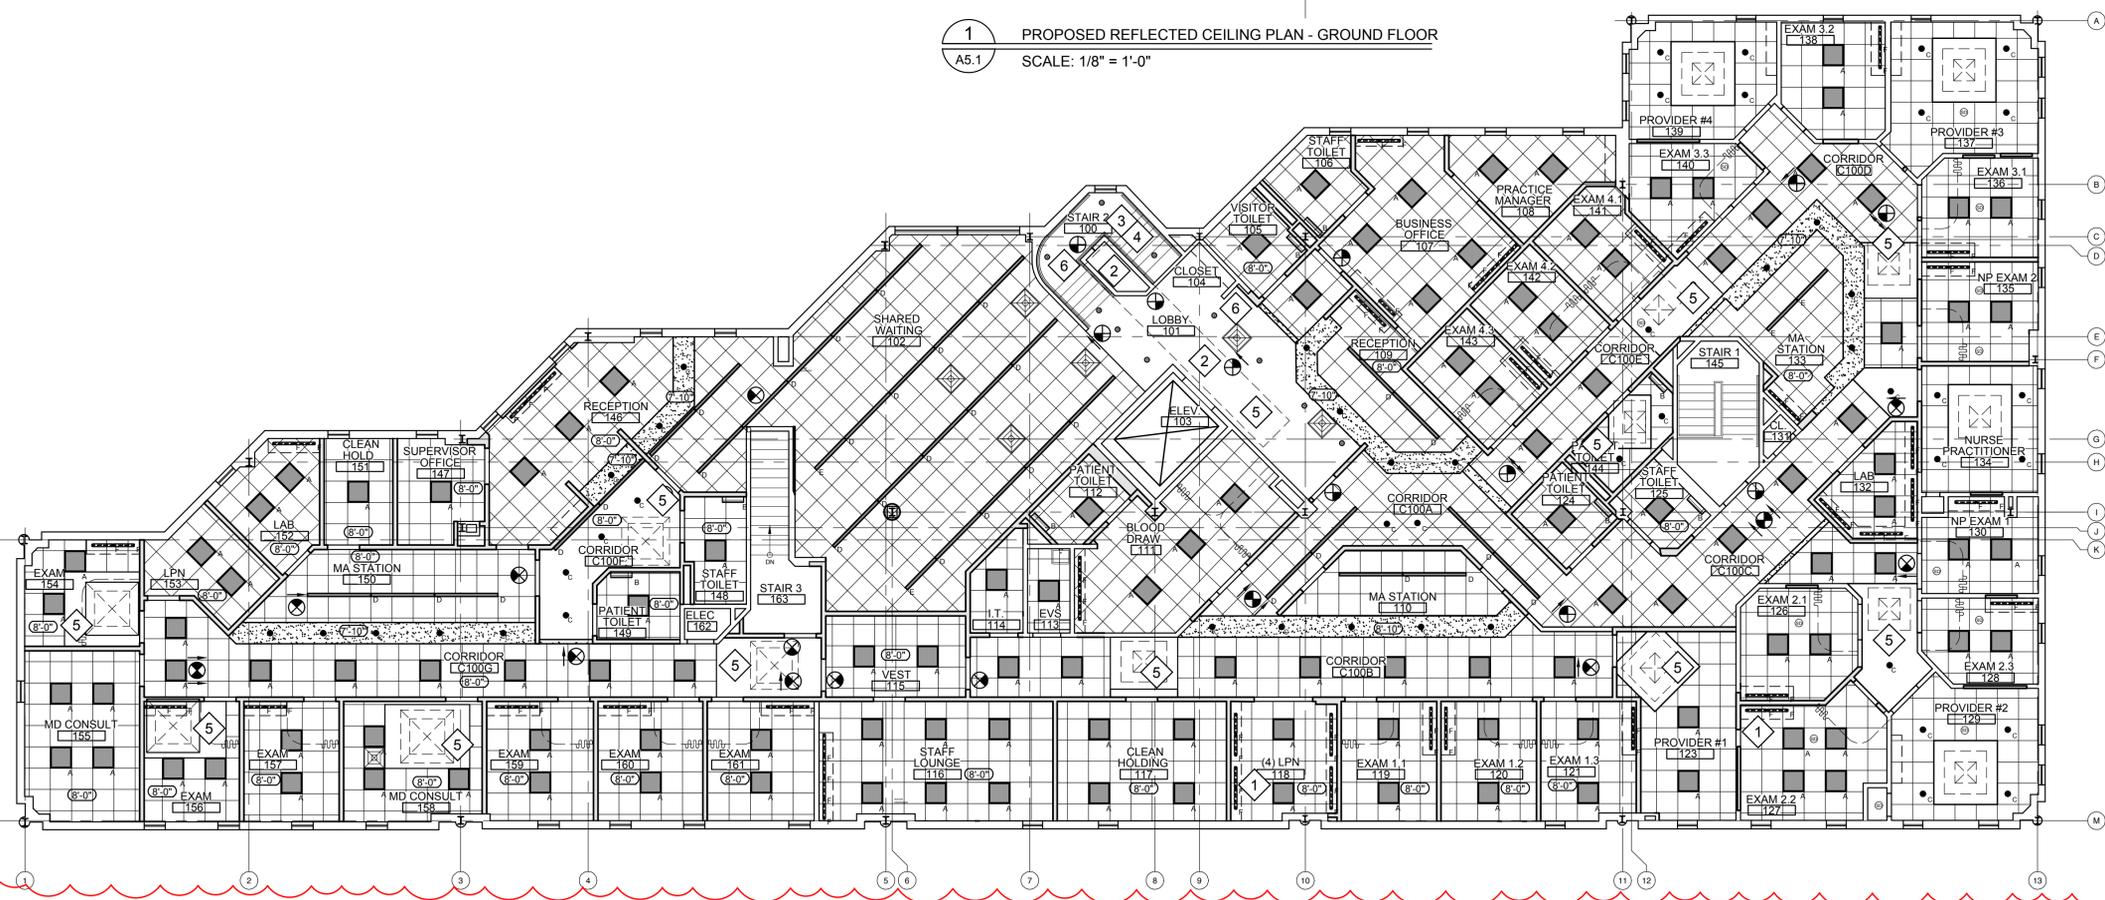
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FIRST FLOOR
350 S MAIN ST
NEW CITY, NY 10956

KEY PLAN: NOT TO SCALE
FIRST FLOOR



1 PROPOSED REFLECTED CEILING PLAN - GROUND FLOOR
A5.1 SCALE: 1/8" = 1'-0"

2
ADD.#03

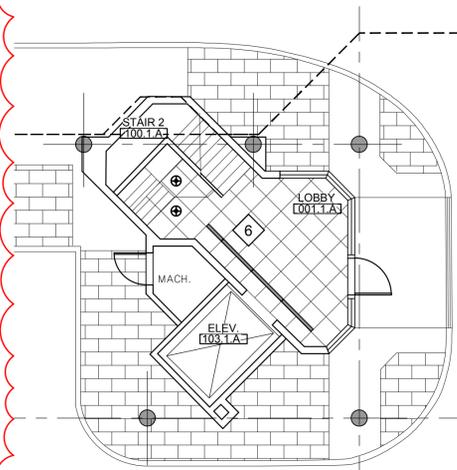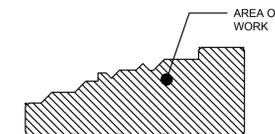

2 PROPOSED REFLECTED CEILING PLAN - FIRST FLOOR
A5.1 SCALE: 1/8" = 1'-0"

Scale: 1/8" = 1'-0"
AREA NOT IN SCOPE U.N.O.

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PROPOSED REFLECTED CEILING PLAN - GROUND AND FIRST FLOOR

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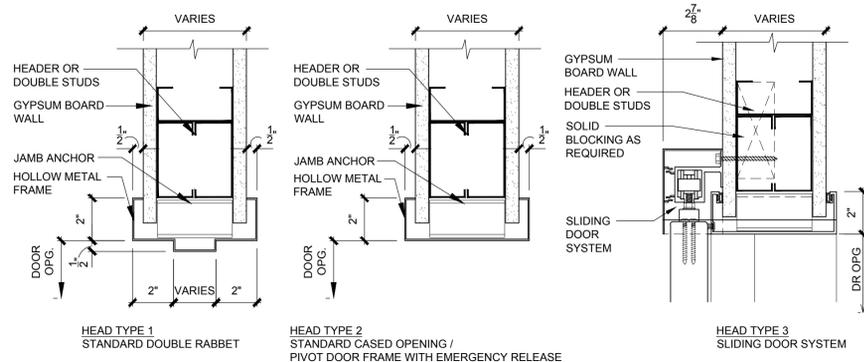
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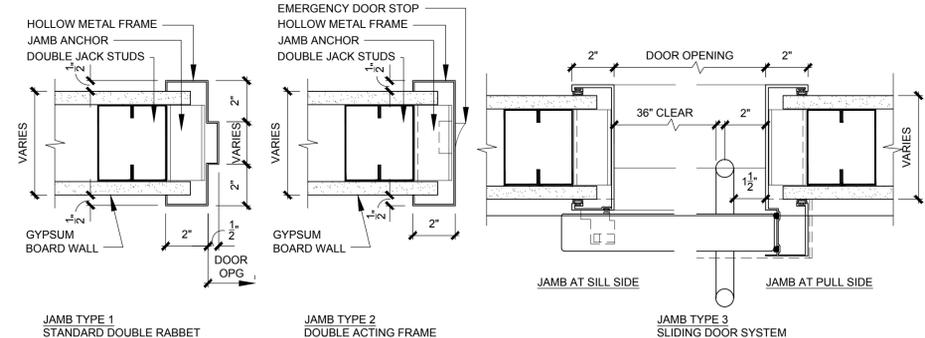
SCALE
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A5.1


HEAD TYPES:



JAMB TYPES:



DOOR TYPES

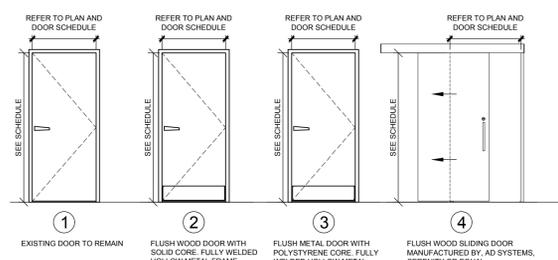

FIRE RATED DOOR LABELS / RATINGS:
DOORS AND FRAMES ARE RATED AND GIVEN A LABEL AFTER EXTENSIVE TESTING BY THE UNDERWRITERS LABORATORY. RATED DOORS MUST BE SELF-CLOSING AND MUST HAVE A POSITIVE LATCH.

UL LABEL RATING	RATING	MAX. GLASS AREA
A	3 HR. (180 MIN.)	NO GLAZING PERMITTED
B	1-1/2 HR. (90 MIN.)	100 SQ. IN. PER LEAF
C	3/4 HR. (45 MIN.)	1296 SQ. IN. PER LITE
D	(20 MIN.)	-

DOOR AND HARDWARE SCHEDULE:

NO.	TYPE	SIZE	ROOM NAME	LABEL	HEAD	JAMB	SILL	STOP	CLOSER	HARDWARE	FUNCTION	REMARKS	ACCESS CONTROL
003	1	E.T.R.	LOBBY	-	-	-	-	-	-	98.0	-	EXISTING TO REMAIN	-
004	1	E.T.R.	MACHINE ROOM	-	-	-	-	-	-	98.0	-	EXISTING TO REMAIN	-
005	1	E.T.R.	STAIR	-	-	-	-	-	-	98.0	-	EXISTING TO REMAIN	-
006	1	E.T.R.	STORAGE	-	-	-	-	-	-	98.0	-	EXISTING TO REMAIN	-
007	1	E.T.R.	UTILITY	-	-	-	-	-	-	98.0	-	EXISTING TO REMAIN	-
008	1	E.T.R.	STAIR	-	-	-	-	-	-	98.0	-	EXISTING TO REMAIN	-
101A	2	3'-0" X 7'-0"	LOBBY	-	1	1	-	WALL	ADA LOW VELOCITY	3.0	CLASSROOM	-	-
101B	2	3'-0" X 7'-0"	LOBBY	-	1	1	-	WALL	ADA LOW VELOCITY	1.0	CLASSROOM	-	-
102	2	3'-0" X 7'-0"	SHARED WAITING	-	1	1	-	O.H.	ADA LOW VELOCITY	4.0	CLASSROOM	-	-
105	2	3'-0" X 7'-0"	VISITOR TOILET	-	1	1	-	O.H.	-	10.0	PRIVACY W/ EMERGENCY EGRESS	-	-
106	2	3'-0" X 7'-0"	STAFF TOILET	-	1	1	-	O.H.	-	6.0	PRIVACY	-	-
108	4	3'-0" X 7'-0"	PRACTICE MANAGER	-	3	3	-	O.H.	SOFT CLOSE	99.0	CLASSROOM	-	-
111	2	3'-0" X 7'-0"	BLOOD DRAW	-	1	1	-	O.H.	-	12.0	PASSAGE	-	-
112	2	3'-0" X 7'-0"	PATIENT TOILET	-	1	1	-	O.H.	-	6.0	PRIVACY	-	-
113	2	3'-0" X 7'-0"	JANITOR CLOSET	-	1	1	-	WALL	-	7.0	STOREROOM	-	-
114	2	3'-0" X 7'-0"	I.T. CLOSET	-	1	1	-	WALL	-	7.0	STOREROOM	-	-
115A	2	3'-0" X 7'-0"	VESTIBULE	-	1	1	-	O.H.	ADA LOW VELOCITY	4.0	CLASSROOM	-	-
115B	2	3'-0" X 7'-0"	VESTIBULE	-	1	1	-	O.H.	ADA LOW VELOCITY	4.0	CLASSROOM	-	-
116	2	3'-0" X 7'-0"	STAFF LOUNGE	-	1	1	-	O.H.	-	12.0	PASSAGE	-	-
117	2	3'-0" X 7'-0"	CLEAN HOLDING	-	1	1	-	O.H.	-	8.0	STOREROOM	-	-
119	2	3'-0" X 7'-0"	EXAM 1.1	-	1	1	-	WALL	-	11.0	PASSAGE	-	-
120	2	3'-0" X 7'-0"	EXAM 1.2	-	1	1	-	WALL	-	11.0	PASSAGE	-	-
121	2	3'-0" X 7'-0"	EXAM 1.3	-	1	1	-	WALL	-	11.0	PASSAGE	-	-
123	2	3'-0" X 7'-0"	PROVIDER #1	-	1	1	-	WALL	-	1.0	CLASSROOM	-	-
124	2	3'-0" X 7'-0"	PATIENT TOILET	-	1	1	-	WALL	-	9.0	PRIVACY W/ EMERGENCY EGRESS	-	-
125	2	3'-0" X 7'-0"	STAFF TOILET	-	1	1	-	O.H.	-	6.0	PRIVACY	-	-
126	2	3'-4" X 7'-0"	EXAM 2.1	-	1	1	-	O.H.	-	12.0	PASSAGE	-	-
127	2	3'-0" X 7'-0"	EXAM 2.2	-	1	1	-	WALL	-	11.0	PASSAGE	-	-
128	2	3'-0" X 7'-0"	EXAM 2.3	-	1	1	-	WALL	-	11.0	PASSAGE	-	-
129	2	3'-4" X 7'-0"	PROVIDER #2	-	1	1	-	O.H.	-	2.0	CLASSROOM	-	-
130	2	3'-4" X 7'-0"	NP EXAM 1	-	1	1	-	WALL	-	11.0	PASSAGE	-	-
131	2	3'-0" X 7'-0"	CLOSET	-	1	1	-	O.H.	-	6.0	STOREROOM	-	-
132	4	3'-0" X 7'-0"	LAB	-	3	3	-	O.H.	SOFT CLOSE	99.0	CLASSROOM	PUNCH CODE	-
134	2	3'-0" X 7'-0"	NURSE PRACTITIONER	-	1	1	-	WALL	-	1.0	CLASSROOM	-	-
135	2	3'-0" X 7'-0"	NP EXAM 2	-	1	1	-	WALL	-	11.0	PASSAGE	-	-
136	2	3'-0" X 7'-0"	EXAM 3.1	-	1	1	-	O.H.	-	12.0	PASSAGE	-	-
137	2	3'-0" X 7'-0"	PROVIDER #3	-	1	1	-	O.H.	-	2.0	CLASSROOM	-	-
138	2	3'-0" X 7'-0"	EXAM 3.2	-	1	1	-	O.H.	-	12.0	PASSAGE	-	-
139	2	3'-0" X 7'-0"	PROVIDER #4	-	1	1	-	O.H.	-	2.0	CLASSROOM	-	-
140	2	3'-0" X 7'-0"	EXAM 3.3	-	1	1	-	O.H.	-	12.0	PASSAGE	-	-
141	2	3'-0" X 7'-0"	EXAM 4.1	-	1	1	-	WALL	-	11.0	PASSAGE	-	-
142	2	3'-0" X 7'-0"	EXAM 4.2	-	1	1	-	WALL	-	11.0	PASSAGE	-	-
143	2	3'-0" X 7'-0"	EXAM 4.3	-	1	1	-	WALL	-	11.0	PASSAGE	-	-
144	2	3'-0" X 7'-0"	PATIENT TOILET	-	2	2	-	O.H.	-	10.0	PRIVACY W/ EMERGENCY EGRESS	-	-
145	1	E.T.R.	STAIR #1	-	-	-	-	-	-	98.0	-	EXISTING TO REMAIN	-
146	2	3'-0" X 7'-0"	RECEPTION	-	1	1	-	-	-	12.0	PASSAGE	-	-
147	4	3'-6" X 7'-0"	SUPERVISOR OFFICE	-	3	3	-	-	SOFT CLOSE	99.0	CLASSROOM	-	-
148	2	3'-0" X 7'-0"	STAFF TOILET	-	2	2	-	O.H.	-	10.0	PRIVACY W/ EMERGENCY EGRESS	-	-
149	2	3'-0" X 7'-0"	PATIENT TOILET	-	2	2	-	WALL	-	9.0	PRIVACY W/ EMERGENCY EGRESS	-	-
150	4	3'-6" X 7'-0"	MA STATION	-	3	3	-	-	SOFT CLOSE	99.0	PASSAGE	-	-
151	2	3'-0" X 7'-0"	CLEAN HOLD	-	1	1	-	WALL	-	7.0	STOREROOM	-	-
152	2	3'-0" X 7'-0"	LAB	-	1	1	-	WALL	-	5.0	CLASSROOM	PUNCH CODE	-
153	2	3'-0" X 7'-0"	LPN	-	1	1	-	WALL	-	1.0	CLASSROOM	-	-
154	2	3'-0" X 7'-0"	EXAM	-	1	1	-	WALL	-	11.0	PASSAGE	-	-
155	2	3'-0" X 7'-0"	MD CONSULT	-	1	1	-	WALL	-	1.0	CLASSROOM	-	-
156	2	3'-0" X 7'-0"	EXAM	-	1	1	-	WALL	-	11.0	PASSAGE	-	-
157	2	3'-0" X 7'-0"	EXAM	-	1	1	-	WALL	-	11.0	PASSAGE	-	-
158	2	3'-0" X 7'-0"	MD CONSULT	-	1	1	-	WALL	-	1.0	CLASSROOM	-	-
159	2	3'-0" X 7'-0"	EXAM	-	1	1	-	WALL	-	11.0	PASSAGE	-	-
160	2	3'-0" X 7'-0"	EXAM	-	1	1	-	WALL	-	11.0	PASSAGE	-	-
161	2	3'-0" X 7'-0"	EXAM	-	1	1	-	WALL	-	11.0	PASSAGE	-	-
162	2	3'-0" X 7'-0"	ELECTRICAL CLOSET	-	1	1	-	O.H.	-	8.0	STOREROOM	-	-
163	3	3'-0" X 7'-0"	STAIR #3	C	1	1	-	O.H.	ADA LOW VELOCITY	13.0	PASSAGE W/ EMER. EGRESS	-	-


DOOR GENERAL NOTES:

- REFER TO DOOR/HARDWARE SPECIFICATIONS IN SPECIFICATION MANUAL FOR DOOR HARDWARE SCHEDULE AND ADDITIONAL REQUIREMENTS.
- ALL FRAMES SHALL BE FULLY WELDED UNLESS OTHERWISE NOTED.
- ALL DOORS SHALL BE SOLID CORE UNLESS OTHERWISE NOTED.
- IT IS THE RESPONSIBILITY OF THE CONTRACTOR TO COORDINATE FRAME MODIFICATIONS OR ELEC. ACCESS CONTROL DEVICES.
- PROVIDE SAFETY GLAZING IN ALL LOCATIONS DEEMED TO BE HAZARDOUS, IN ACCORDANCE WITH IBC SECTION 2406 "SAFETY GLAZING." SPECIFIC LOCATIONS INCLUDE, BUT ARE NOT LIMITED TO: GLAZING IN DOORS, GLAZING ADJACENT TO DOORS, GLAZING IN PANES 9 SQ. FT. OR GREATER, WHERE BOTTOM EDGE IS LESS THAN 18 INCHES ABOVE FLOOR. PROVIDE FIRE RATED GLAZING LITES IN ALL FRR DOOR ASSEMBLIES. ALL GLAZING MUST HAVE APPROPRIATE, VISIBLE LABEL.
- ALL THRESHOLDS SHALL BE ICC/ANSI A117.1 - 2003 COMPLIANT. CHANGES IN LEVEL OF UP TO 1/4" MAY BE VERTICAL. CHANGES FROM 1/4" UP TO 1/2" MUST BE BEVELED AT EDGES, WITH SLOPE NOT STEEPER THAN 1:2. CHANGES IN BEYOND 1/2" IN HEIGHT MUST BE RAMPED. SEE ALSO A2 SERIES DRAWINGS FOR ADDITIONAL DETAIL AND REQUIREMENTS.
- COORDINATE PLACEMENT OF ARMOUR PLATES SUCH THAT PLATES ARE LOCATED ON THE ACTIVE SIDE OF THE DOOR.
- DOORS, FRAMES AND HARDWARE MUST NOT GO INTO FABRICATION OR PROCUREMENT UNTIL ALL SHOP DRAWINGS AND SUBMITTALS HAVE BEEN APPROVED.
- IT IS THE CONSTRUCTION MANAGERS RESPONSIBILITY TO FULLY COORDINATE ALL FRAME THROAT DEPTHS WITH FIELD CONDITIONS.
- ALL FIRE RATED DOORS AND FRAMES MUST BEAR A UL LISTED LABEL WHICH MUST REMAIN FIXED TO THE DOOR AND VISIBLE AT ALL TIMES.
- REFER TO ELEC. DRAWINGS FOR CUTOUTS REQUIRED IN BUCKS FOR ELEC. AND MECH. DEVICES.
- CONTRACTOR SHALL PROVIDE BACK-BOXES, CONDUIT STUBS, RACEWAYS, PUSH BUTTONS, LOCKS, AND ELECTRIC STRIKES IN DOOR FRAMES AS PART OF BASE SCOPE. COORDINATION WITH HOSPITAL AS REQUIRED FOR NEW INSTALLATION.
- CORING REQUIREMENTS SHALL BE CORBIN-RUSSWIN 6 PIN L4 SYSTEM.

HARDWARE SETS:

- PASSAGE LATCH; 1-1/2 PAIR BUTTS; CLOSER; WALL STOP; SILENCERS.
- STORE ROOM LATCH; 1-1/2 PAIR BUTTS; WALL STOP; SILENCERS
- PASSAGE LATCH; 1-1/2 PAIR BUTTS; WALL STOP; SILENCERS.
- PRIVACY LATCH; 1-1/2 PAIR BUTTS; CLOSER; WALL STOP; SILENCERS.
- PASSAGE LATCH; 1-1/2 PAIR BUTTS; OVERHEAD STOP; SILENCERS.
- CLASSROOM LATCH; 1-1/2 PAIR BUTTS; WALL STOP; SILENCERS.
- PRIVACY LATCH; 1-1/2 PAIR BUTTS EMERGENCY EGRESS STRIKE; CLOSER; WALL STOP; SILENCERS.
- CLASSROOM LATCH; 1-1/2 PAIR BUTTS. CLOSER; SILENCERS.
- ENTRY LATCH 1-1/2 PAR BUTTS, CLOSER, SILENCERS, WALLSTOP

PARTITION TYPES

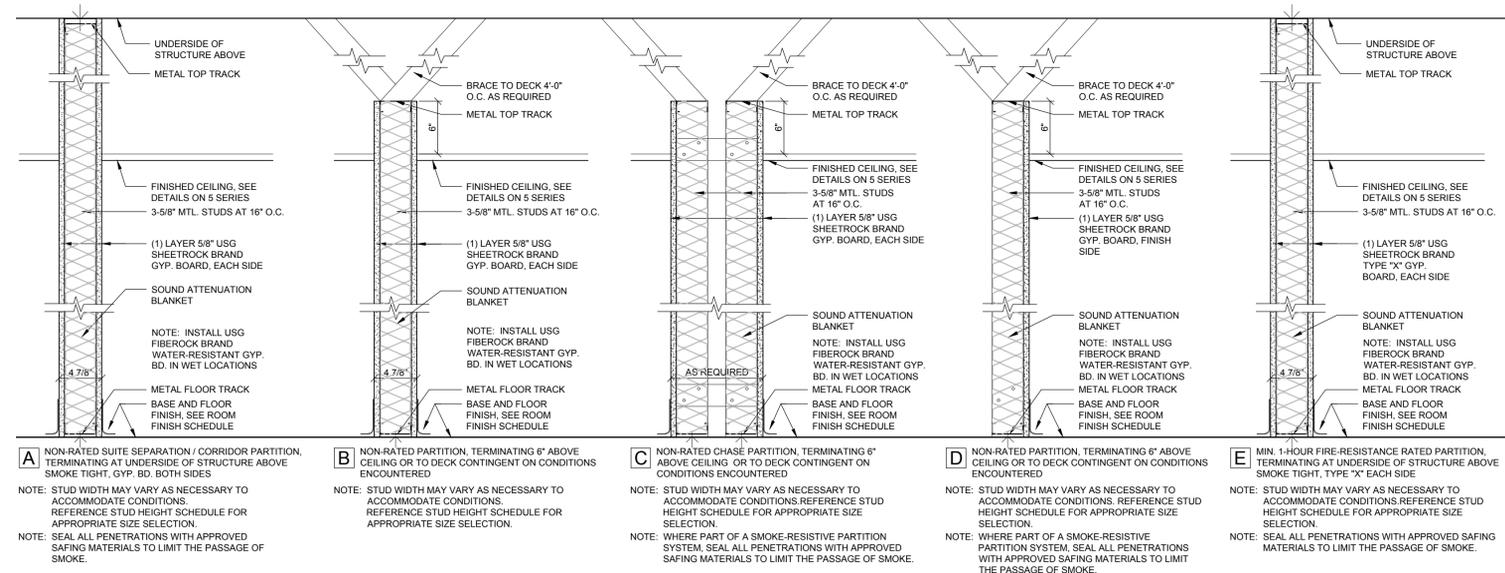


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1	02.15.2022	BID ISSUE
2	03.16.2021	ADDENDA #03

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DRAWING TITLE:
DOOR & HARDWARE SCHEDULE AND MISCELLANEOUS DETAILS

PROJECT NUMBER
21019

DATE
2/15/2022

DRAWING NUMBER

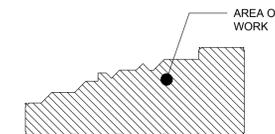SCALE
AS NOTED

A9.1


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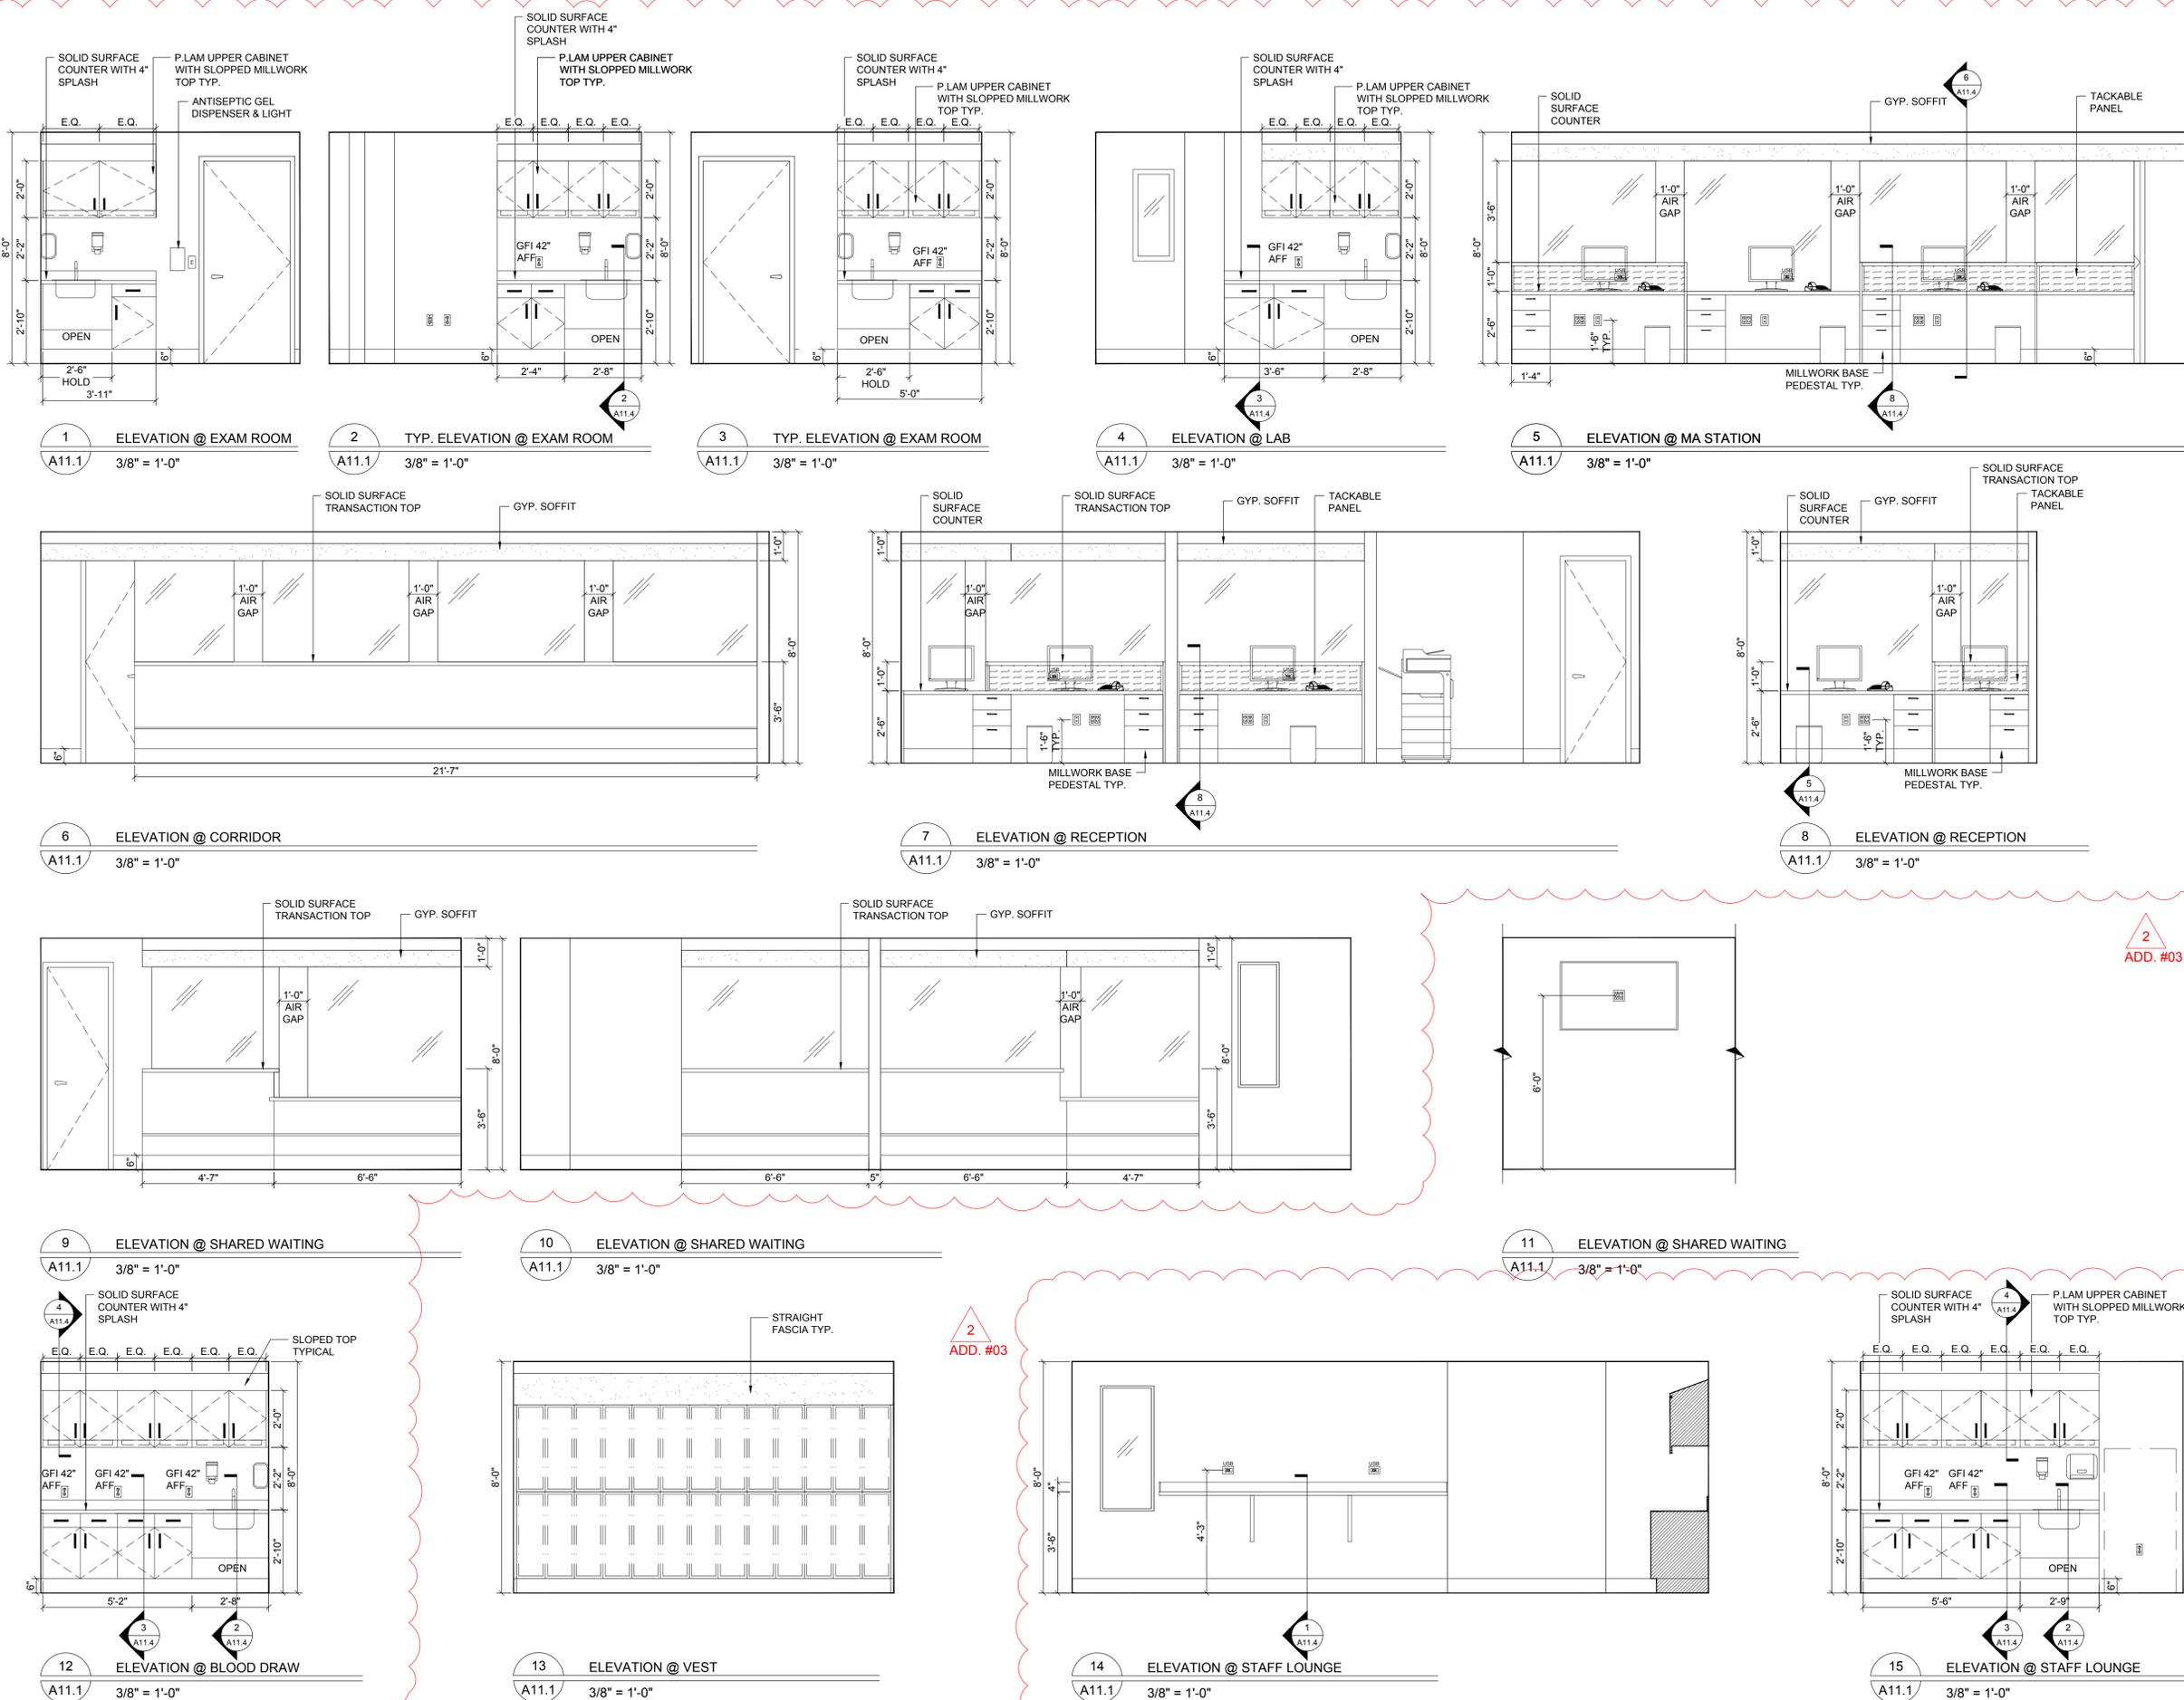
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INTERIOR ELEVATIONS

PROJECT NUMBER
21019
DATE
2/15/2022
DRAWING NUMBER

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A11.1




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PROJECT NUMBER
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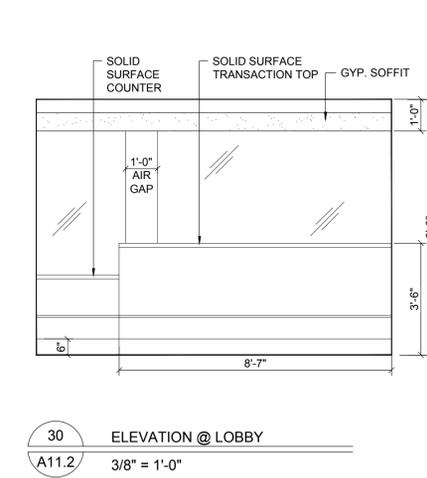
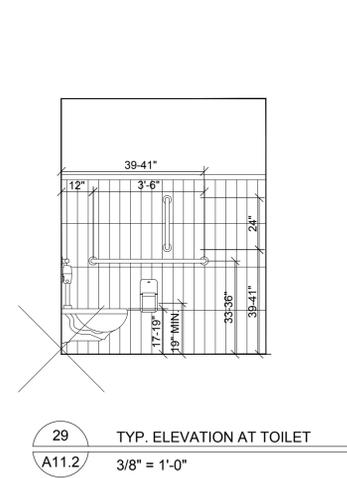
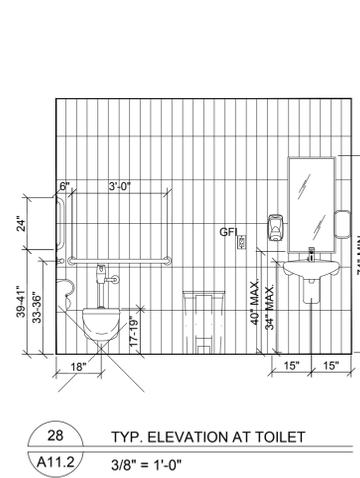
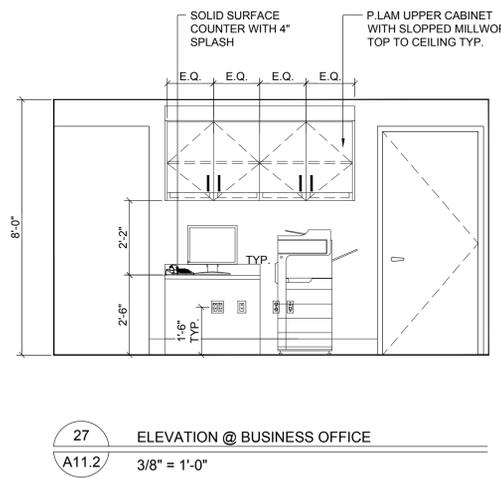
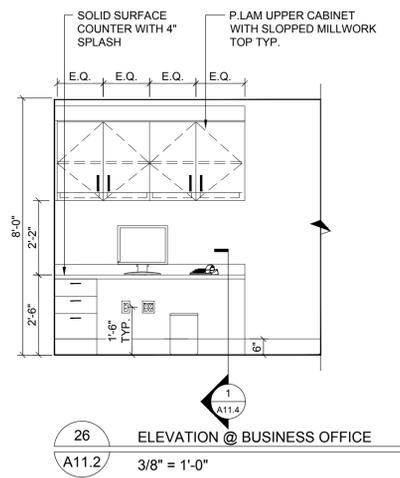
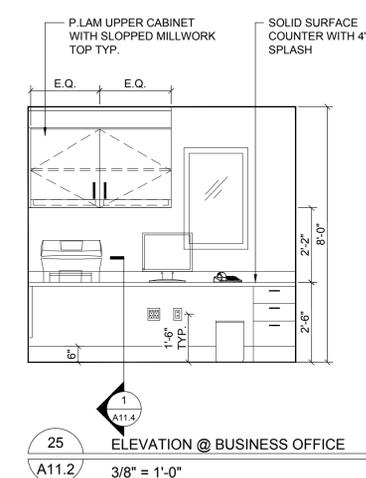
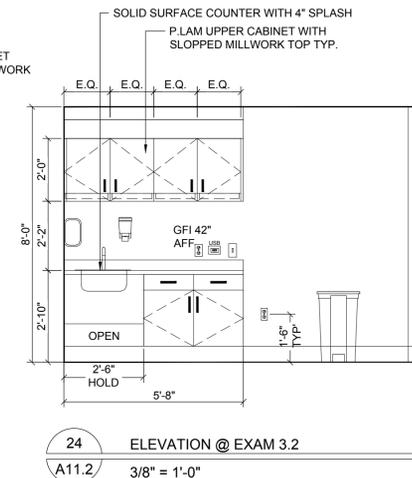
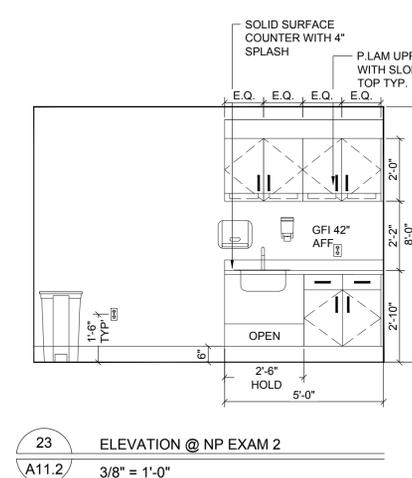
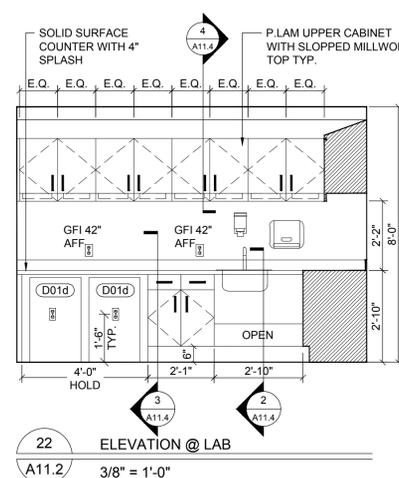
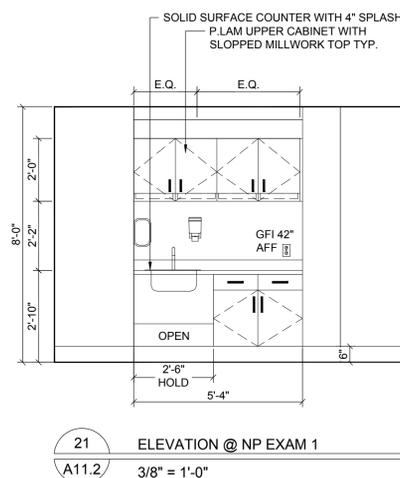
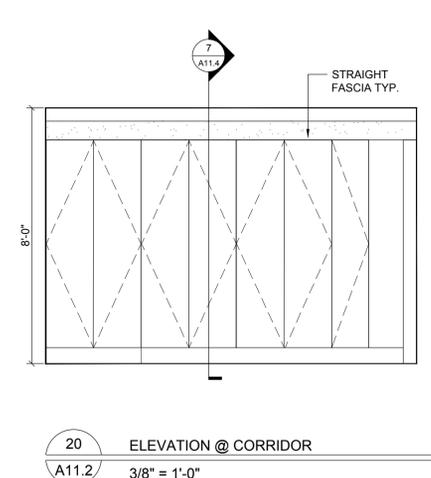
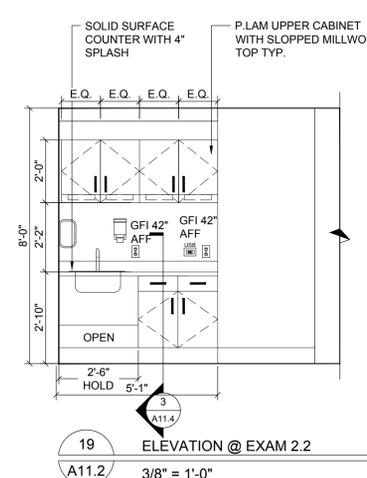
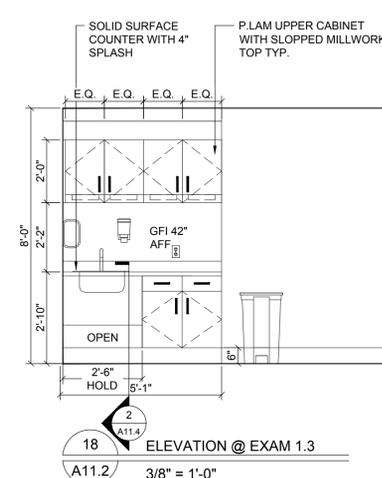
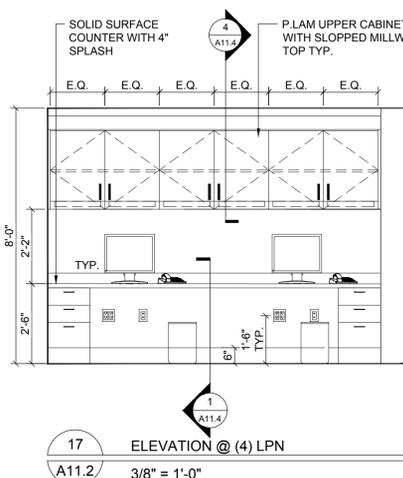
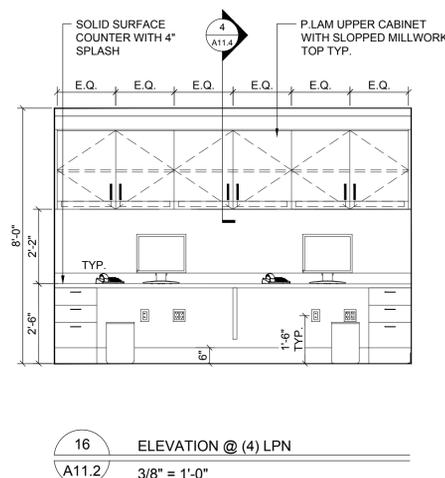
DATE
2/15/2022

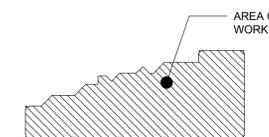DRAWING NUMBER

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2
ADD. #03

A11.2

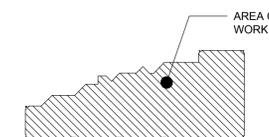


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DRAWING TITLE:
INTERIOR ELEVATIONS

PROJECT NUMBER
21019


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2/15/2022

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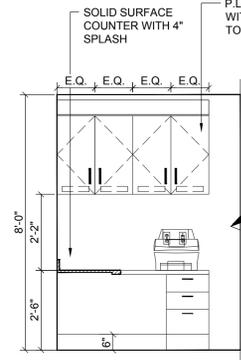
SCALE
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A11.3


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ADD. #03

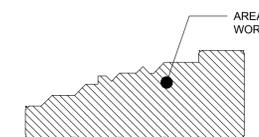


31 TYP. ELEVATION @ RECEPTION
A11.3 3/8" = 1'-0"

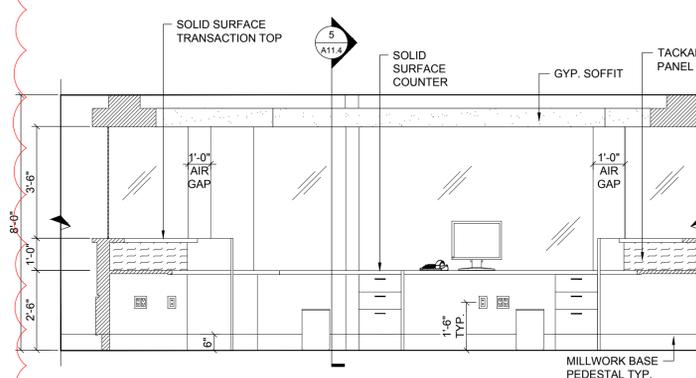


32 TYP. ELEVATION @ RECEPTION
A11.3 3/8" = 1'-0"

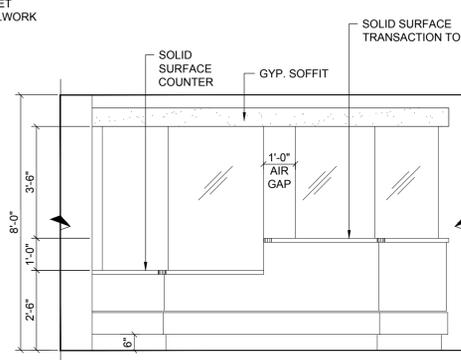


33 TYP. ELEVATION @ RECEPTION (CHECK OUT)
A11.3 3/8" = 1'-0"

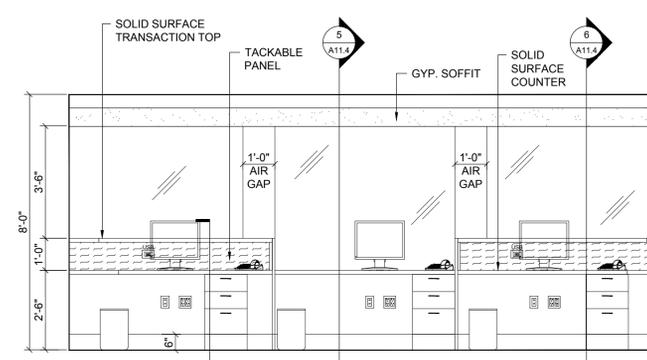


34 TYP. ELEVATION @ MA STATION
A11.3 3/8" = 1'-0"

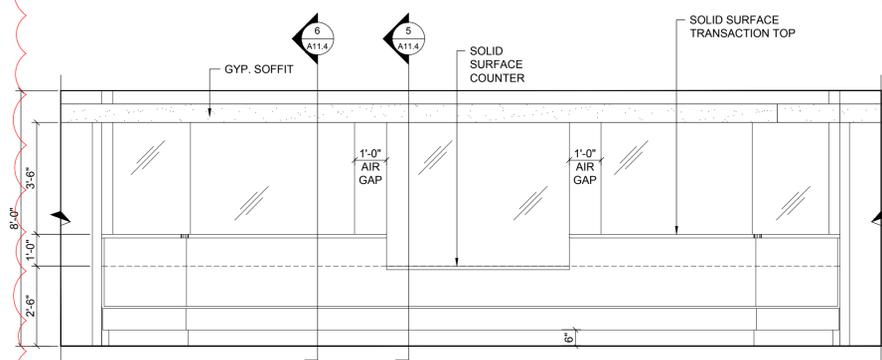


35 TYP. ELEVATION @ MA STATION
A11.3 3/8" = 1'-0"

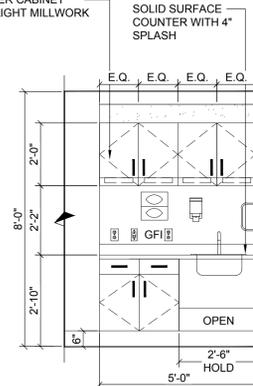


36 ELEVATION @ EXAM RM.
A11.3 3/8" = 1'-0"

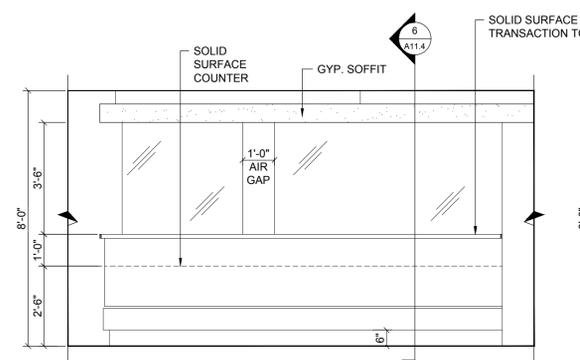


37 TYP. ELEVATION @ MA STATION
A11.3 3/8" = 1'-0"

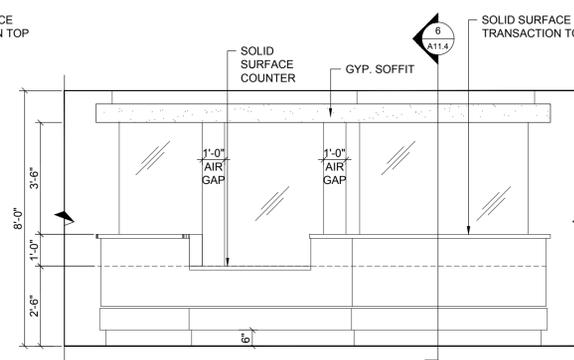


38 TYP. ELEVATION @ EXAM ROOM
A11.3 3/8" = 1'-0"

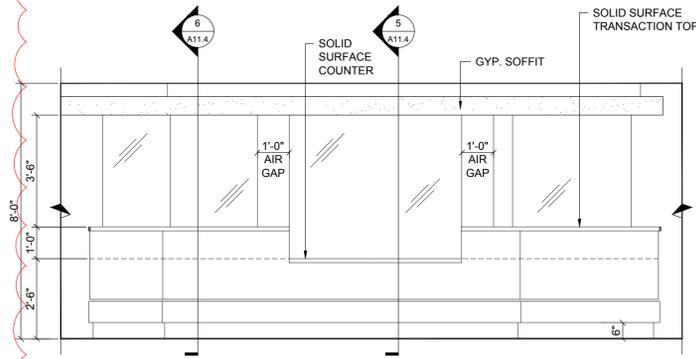


39 TYP. ELEVATION @ MA STATION
A11.3 3/8" = 1'-0"

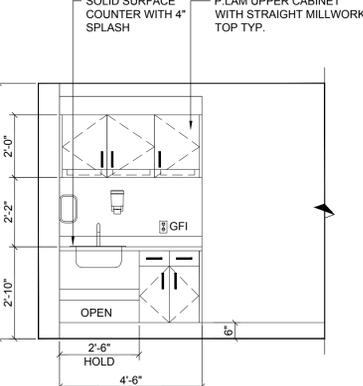



40 ELEVATION @ MA STATION
A11.3 3/8" = 1'-0"

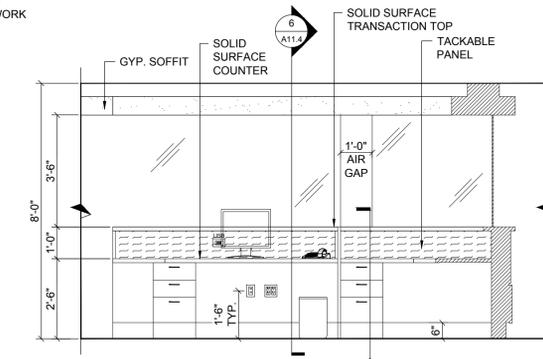


41 TYP. ELEVATION @ MA STATION
A11.3 3/8" = 1'-0"

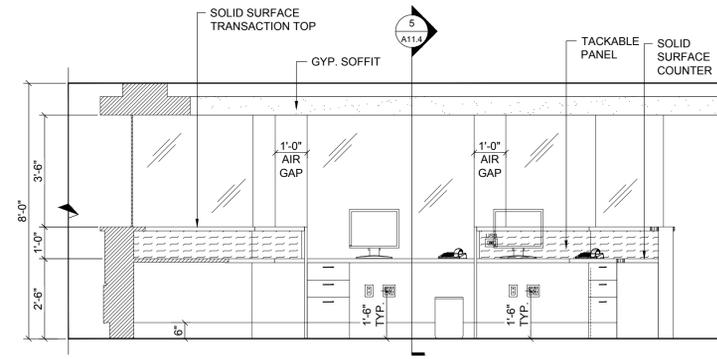


42 TYP. ELEVATION @ MA STATION
A11.3 3/8" = 1'-0"

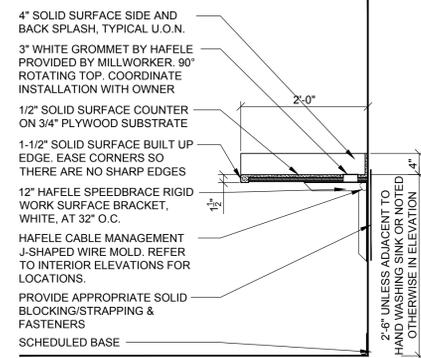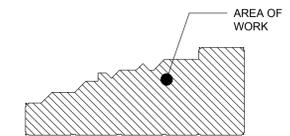


1 TYPICAL COUNTER AND SUPPORT BRACKET DETAIL
A11.4 3/4" = 1'-0"

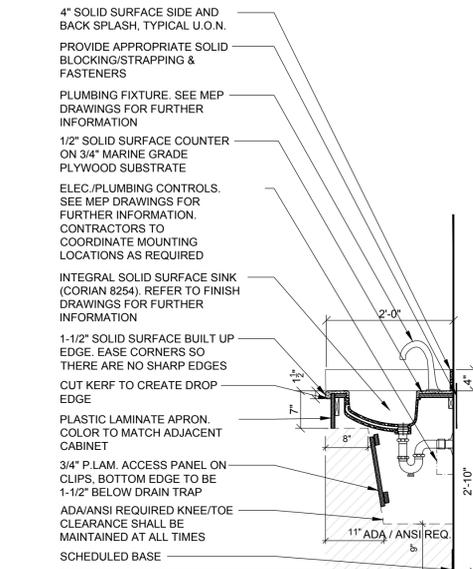


2 HAND-WASHING SINK DETAIL
A11.4 3/4" = 1'-0"

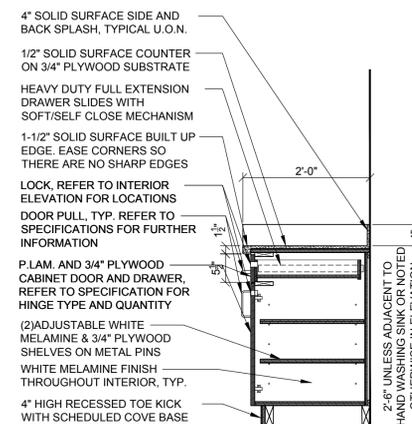


3 BASE CABINET W/ DRAWER AND DOOR DETAIL
A11.4 3/4" = 1'-0"

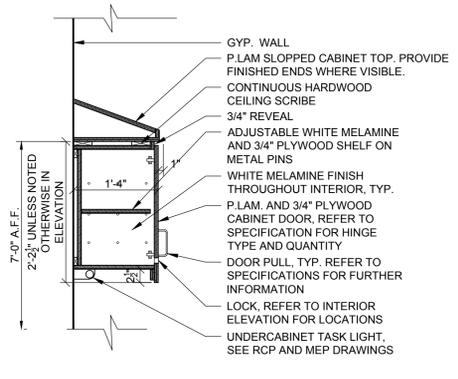


4 UPPER CABINET WITH SLOPED TOP
A11.4 3/4" = 1'-0"

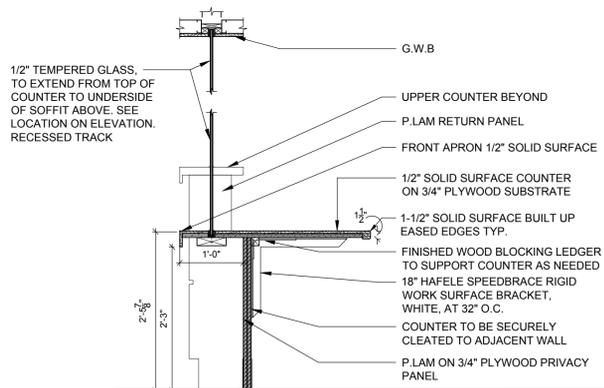


5 RECEPTION DESK MILLWORK DETAIL (LOW)
A11.4 3/4" = 1'-0"

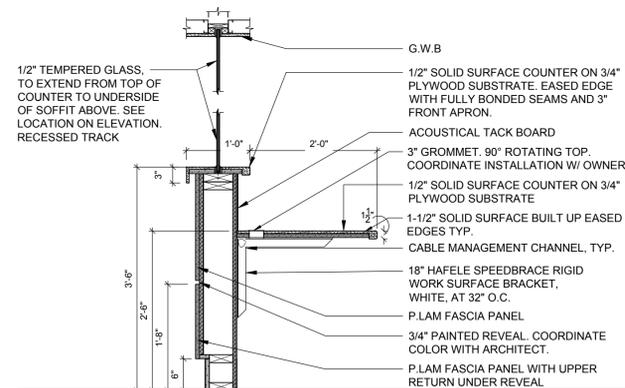

6 RECEPTION DESK MILLWORK DETAIL (HIGH)
A11.4 3/4" = 1'-0"

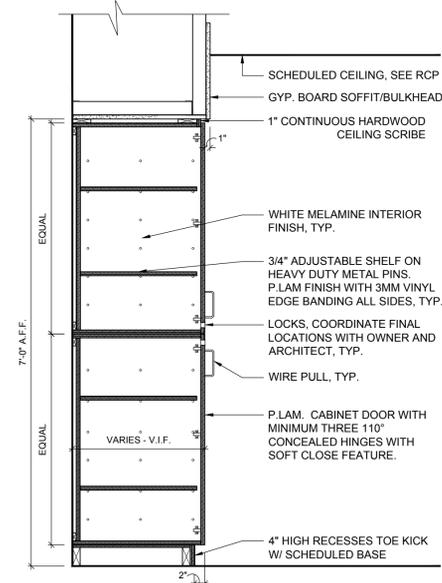

7 FULL HEIGHT STORAGE CABINET DETAIL
A11.4 3/4" = 1'-0"

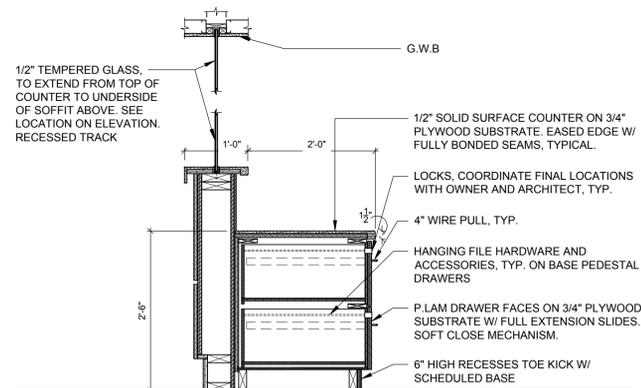

8 RECEPTION DESK AND BASE PEDESTAL DETAIL
A11.4 3/4" = 1'-0"

2
ADD. #03

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ISSUED DOCUMENTS:

No.	Date	Description
1	02.15.2022	BID ISSUE
2	03.16.2021	ADDENDA #03

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DRAWING TITLE:
MILLWORK SECTIONS

PROJECT NUMBER
21019
DATE
2/15/2022
SCALE
AS NOTED
DRAWING NUMBER

A11.4