
UNIVENT REPLACEMENT AT HAVERSTRAW ELEMENTARY


HAVERSTRAW ELEMENTARY SCHOOL **16 Grant Street** Haverstraw, NY 10927 SED# 50-02-01-06-0-009-018

OWNER: NORTH ROCKLAND CENTRAL SCHOOL DISTRICT 65 Chapel Street Garnerville, NY 10923

ARCHITECT: MICHAEL SHILALE ARCHITECTS, LLP 140 Park Avenue New City, NY 10956

> PME ENGINEER: GREENMAN-PEDERSON, INC. 400 Rella Boulevard, Suite 207 Montabello, NY 10901

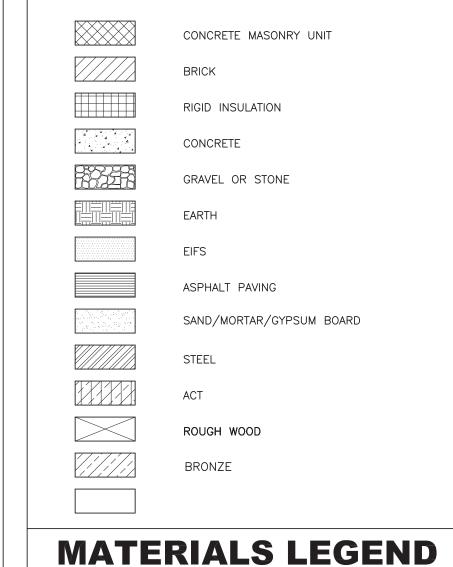

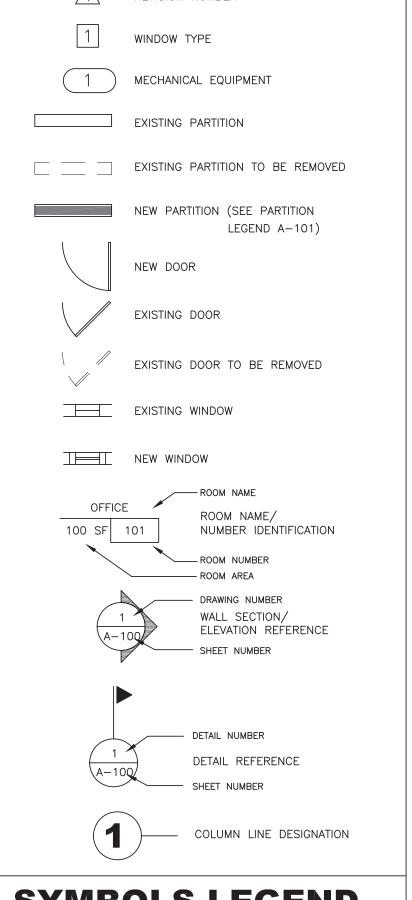

SYMBOLS LEGEND

TO THE FINISHED FACE OF AN ELEMENT OR WALL WILL BE DESIGNATED WITH AN "F" AS SHOWN.

GENERAL NOTES

ALTERNATES

NO ALTERNATES AT THIS TIME.


DRAWING No.	DRAWING TITLE	DATE
A-000	COVER SHEET	(01-14-22)
B-100	CODE ANALYSIS	12-17-21
S-101	ROOF PLAN & GENERAL NOTES	12-17-21 (2)
S-102	ROOF PARTIAL PLANS	12-17-21
S-103	SECTIONS & TYPICAL DETAILS	12-17-21
S-104	SECTIONS & TYPICAL DETAILS S-2	12-17-21
D-101	FIRST FLOOR DEMO PLAN	12-17-21
D-102	SECOND FLOOR DEMO PLAN	12-17-21
D-103	THIRD FLOOR DEMO PLAN	12-17-21
D-104	ROOF DEMO PLAN	12-17-21
A-101	PROPOSED FIRST FLOOR PLAN	01-14-22
A-102	PROPOSED SECOND FLOOR PLAN	01-14-22
A-103	PROPOSED THIRD FLOOR PLAN	01-14-22
A-103 A-104	PROPOSED ROOF PLAN	12-17-21
A-400	REFLECTED CEILING PLAN	
	DETAILS	12-17-21 /4
A-500	UNIT ELEVATIONS	12-17-21
A-501	UNIT ELEVATIONS UNIT ELEVATIONS	12-17-21
A-501.1		12-17-21
A-502	DETAILS	12-17-21
A-503	DETAILS	12-17-21
M-001	MECHANICAL NOTES	12-17-21
M-002	MECHANICAL SCHEDULES	12-17-21
M-003	MECHANICAL SCHEDULES 2	12-17-21
M-004	CONTROLS	12-17-21
M-005	VENTILATION SCHEDULE	12-17-21
M-006	UV SCHEDULE	12-17-21
M-061	HVAC DEMO FIRST FLOOR PLAN	12-17-21
M-062	HVAC DEMO SECOND FLOOR PLAN	12-17-21
M-063	HVAC DEMO THIRD FLOOR PLAN	12-17-21
M-101	FIRST FLOOR PLAN MECHANICAL	12-17-21
M-102	SECOND FLOOR PLAN MECHANICAL	12-17-21
M-103	THIRD FLOOR PLAN MECHANICAL	12-17-21
M-104	ROOF PLAN MECHANICAL	12-17-21
M - 301	HVAC PIPING - 1ST FLOOR PLAN	12-17-21
M - 302	HVAC PIPING - 2ND FLOOR PLAN	12-17-21
M - 303	HVAC PIPING - 3RD FLOOR PLAN	12-17-21
M-401	VRF PIPING RISERS	12-17-21
M-501	MECHANICAL DETAILS	12-17-21
M-502	MECHANICAL DETAILS 2	12-17-21
FA-001	FIRE ALARM SYSTEM COVER SHEET	12-17-21
FA-101	THIRD FLOOR PLAN FIRE ALARM	12-17-21
FA-101	ROOF PLAN FIRE ALARM	12-17-21
E-001	ELECTRICAL COVER SHEET	12-17-21
E-060	BASEMENT DEMO PLAN ELECTRICAL	12-17-21
E-060 E-061	FIRST FLOOR ELECTRICAL DEMO PLAN	
		12-17-21
E-062	SECOND FLOOR ELECTRICAL DEMO PLAN	12-17-21
E-063	THIRD FLOOR ELECTRICAL DEMO PLAN	12-17-21
E-100	BASEMENT PLAN ELECTRICAL	12-17-21
E-101	FIRST FLOOR PLAN ELECTRICAL	12-17-21
E-102	SECOND FLOOR PLAN ELECTRICAL	12-17-21
E-103	THIRD FLOOR PLAN ELECTRICAL	12-17-21
E-104	ROOF PLAN ELECTRICAL	12-17-21
E-201	ELECTRICAL SCHEDULES & RISER	12-17-21
E-301	ELECTRICAL DETAILS	12-17-21


LIST OF DRAWINGS


LIGI OI DIVAVIIIO		
ACT	ACOUSTICAL CEILING TILE	ALLOWANCE NO. 1: PROVIDE ALLOWANCE TO CLEAN EXISTING MAIN DUCTWORK FOR 20 LINEAR
A.F.F. ASPH	ABOVE FINISH FLOOR ASPHALT	FEET PER UNIT.
3LK	BLOCK	ALLOWANCE NO. 2: PROVIDE ALLOWANCE TO REPLACE
BLK'G	BLOCKING	EXISTING SUPPLY AND RETURN PIPING AND
3UR	BUILT UP ROOFING	
CLG	CEILING	INSULATION FOR 20 LINEAR FEET PER UNIT.
CONC	CONCRETE	ALLOWANCE NO. 3: PROVIDE A PROPOSAL FROM A THIRD
CONT C.J.	CONTINUOUS CONTROL JOINT	PARTY HVAC COMMISSIONING AGENT
ON	DOWN	CONTRACTOR IS TO INCLUDE THIS AMOUNT IN
OIA	DIAMETER	THEIR BASE BID. CONTRACTOR WILL ISSUE A
OWG	DRAWING	CREDIT CHANGE ORDER TO THE OWNER FOR
E.F. EIFS	EACH FACE	THE COMMISSIONING PROPOSAL AMOUNT,
LIFS	EXTERIOR INSULATION AND FINISH SYSTEM	OWNER WILL CONTRACT DIRECTLY WITH THE
Ξ.W.	EACH WAY	COMMISIONING AGENT.
=.w. E.W.C.	ELECTRICAL WATER COOLER	ALLOWANCE NO. 4: PROVIDE ALLOWANCE FOR THE
EL	ELEVATION	RELOCATION OF 40 ELECTRICAL DEVICES
ELC	ELECTRICAL CONTRACTOR	THAT REQUIRE RELOCATION DUE TO THE
EXIST	EXISTING	INCREASED SIZE OF THE NEW UNIT
EXP EXT ' G	EXPANSION EXISTING	VENTUATORS.
EXTR	EXTERIOR	ALLOWANCE NO. 5: CONTRACTOR TO INCLUDE ALLOWANCE
-711X -P	FIREPROOF	
FIN.	FINISH(ED)	FOR LF OF LINE SET ENCLOSURE NOTED ON
GA	GAUGE` ´	DRAWINGS.
GC	GENERAL CONTRACTOR	ALLOWANCE NO. 6: CONTRACTOR SHALL INCLUDE IN THEIR
GALV GL	GALVANIZED GLASS	BID AN ALLOWANCE FOR 10' OF PIPING/
GWB	GYPSUM WALL BOARD	INSULATION FOR EACH UV AND 20' AT EACH
HM	HOLLOW METAL	RTU. SEE DRAWINGS 3/M-501 AND
H.P.	HIGH POINT	4/M-501.
HAC	HEATING & A/C CONTRACTOR	ALLOWANCE NO. 7: CONTRACTOR TO INCLUDE ALLOWANCE
TR JT	INDIVIDUAL TREATMENT ROOM JOINT	FOR LF OF WIRE MOLD NOTED ON DRAWINGS.
_AM	LAMINATE	
_AV	LAVATORY	
_P	LOW POINT	
MAX	MAXIMUM	/4\
MFR	MANUFACTURER	ALLOWANCES
MTL	METAL MINIMUM	ALLOWANCES
MIN MO	MASONRY OPENING	
V.I.C.	NOT IN CONTRACT	
VO.	NUMBER	
oc .	ON CENTER	LINUT BRIDE NO. 4
OPN'G	OPENING CONTRACTOR	UNIT PRICE NO. 1:
PBC	PLUMBING CONTRACTOR	PROVIDE UNIT PRICE TO INCREASE OR
PLAS.LAM. PL	PLASTIC LAMINATE PLATE	REDUCE BY 10'-0" THE LINE SET COVER.
⊃ĽY'D	PLYWOOD	SEE DETAIL 5/A-500.
RAD	RADIUS	UNIT PRICE NO. 2:
REF.CLG.	REFLECTED CEILING	PROVIDE UNIT PRICE PER SQUARE FOOT OF
REQ'D	REQUIRED	VCT REPLACEMENT.
RO SIM	ROUGH OPENING SIMILAR	UNIT PRICE NO. 3:
STL	STEEL	PROVIDE A UNIT PRICE FOR LF OF WOOD
SUSP.CLG.	SUSPENDED CEILING	BASE REPLACEMENT.
Г.О.М.	TOP OF MASONRY	UNIT PRICE NO. 4:
Γ.O.S.	TOP OF STEEL	
TYP	TYPICAL	PROVIDE A UNIT PRICE TO INCREASE OR
J.O.N. √.I.F.	UNLESS OTHERWISE NOTED VERIFY IN FIELD	REDUCE BY 10'-0" OF WIRE MOLD.
v.i.i . VCT	VINYL COMPOSITE TILE	UNIT PRIČE NO. 5:
N /	WITH	/ PROVIDE A UNIT PRICE TO INCREASE OR \

UNIT PRICES

ABBREVIATIONS

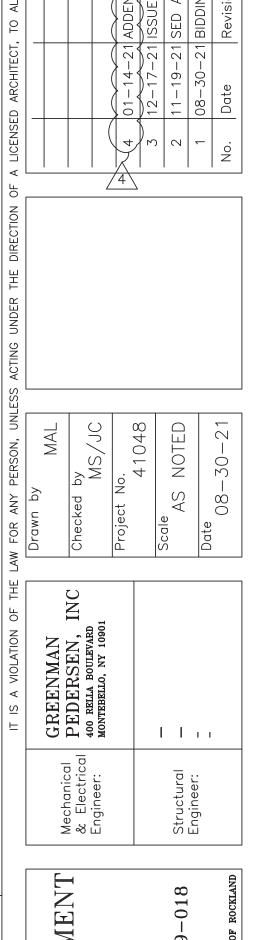


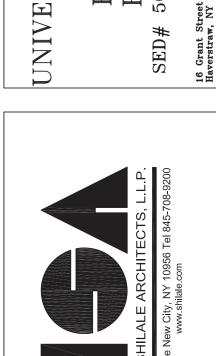

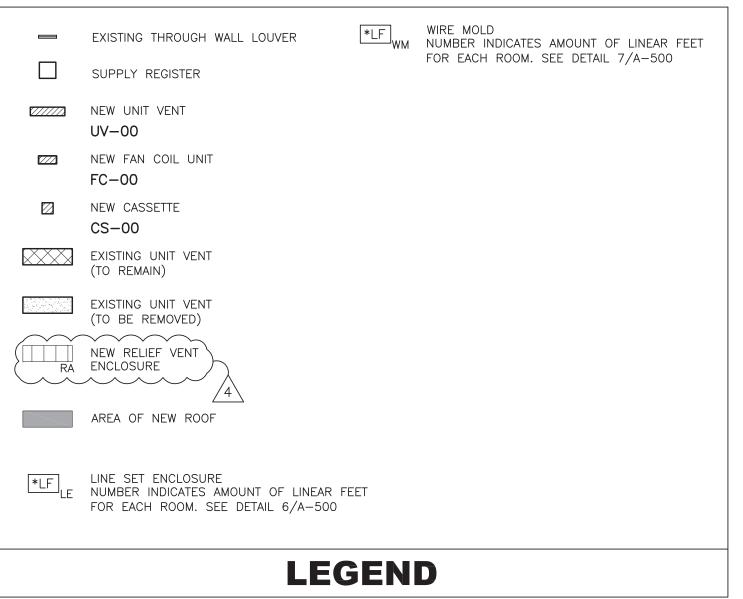



- (A1) INSTALL NEW UNIT VENTILATORS.
- (A2) INSTALL NEW CEILING AS REQUIRED: 095113. INSTALL DUCTS AND REGISTERS AS REQUIRED.
- REMOVE EXISTING CEILING TO ACCESS DUCT WORK. REPLACE WITH NEW CLG TILE: 095113
- (A4) PROVIDE NEW FIN TUBE ENCLOSURES IN ENTIRE ROOM.
- A5 VOID
- ______ (A6) REROUTE EXISTING ELECTRICAL SUPPLY TO NEW CEILING MOUNTED UNIT.
- PROVIDE METAL STUD AND GYPSUM ENCLOSURE AROUND NEW INTAKE AIR DUCT AT FLOOR LEVEL AND DUCT TO CEILING. MODIFY GYPSUM CEILING FOR NEW DUCT.
- CONSTRUCT GYPSUM ENCLOSURE TO COVER RELIEF AIR DUCT. COORDINATE WITH MECHANICAL DRAWINGS AND DRAWING 5/A-500.
- A9 INSTALL NEW GYPSUM SOFFIT FOR NEW CEILING MOUNTED UNIT VENTILATORS. SEE DRAWINGS 1/A-502 AND 2/A-502.
- (A10) INSTALL NEW ACCESS PANEL IN PLASTER CEILING.
- (A11) PATCH EXISTING MASONRY AT DUCTWORK PENETRATIONS IN FAN ROOM.
- (A12) PATCH AND PAINT EXISTING PLASTER CEILING WHERE NEW UNIT IS MOUNTED IN CEILING.
- A13 INSTALL LINESET AND POWER ABOVE CEILING AND IN TO CHASE FOR HVAC UNITS. ALL WIRE AND MECHANICAL EQUIPMENT SHALL BE CONCEALED.
- A14 REINSTALL EXISTING DOORS TO SWING IN DIRECTION OF EGRESS.
- INSTALL NEW HOLLOW METAL DOOR AT BOILER ROOM. PROVIDE 1 1/2" HR LABEL DOOR WITH CLOSER. INSTALL NEW HOLLOW METAL DOOK AT BUILER ROUM. PROVIDE 1 /2 THE LABEL BOOK SEED AT STATE OF THE PROPERTY OF THE PROPERTY
- (A16) PROVIDE AND INSTALL (1) 10 LB FIRE EXTINGUISHER AT SELECTED LOCATION.
- SAW CUT PLASTER CEILING FOR INSTALLATION OF HVAC COMBINER BOX. REINSTALL EXISTING CEILING TILE.
- (A18) PATCH WALL WHERE EXISTING UNIVENT IS REMOVED. PAINT TO MATCH EXISTING.
- REMOVE EXISTING DOOR TO UNDERCUT EXISTING DOOR TO ALLOW FOR 2" AIR SPACE. REINSTALL DOOR.
- GLAZING PANEL IN AREA TO BE REMOVED AND TESTED TO DETERMINE THAT IT IS SAFETY GLAZING. GLAZING TO BE REPLACED WITH LAMINATED GLAZING. OWNER AND ARCHITECT TO DETERMINE WHICH PANELS TO BE REMOVED.
- CONSTRUCT NEW CLOSET TO HOUSE NEW AC UNIT. COORDINATE CLOSET SIZING WITH UNIT. PROVIDE NEW DOOR AND FINISHES. CONFIRM SIZE AND COLOR WITH OWNER AND ARCHITECT.


KEY NOTES

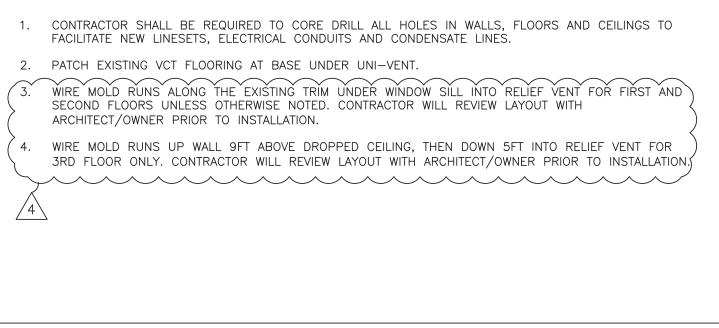





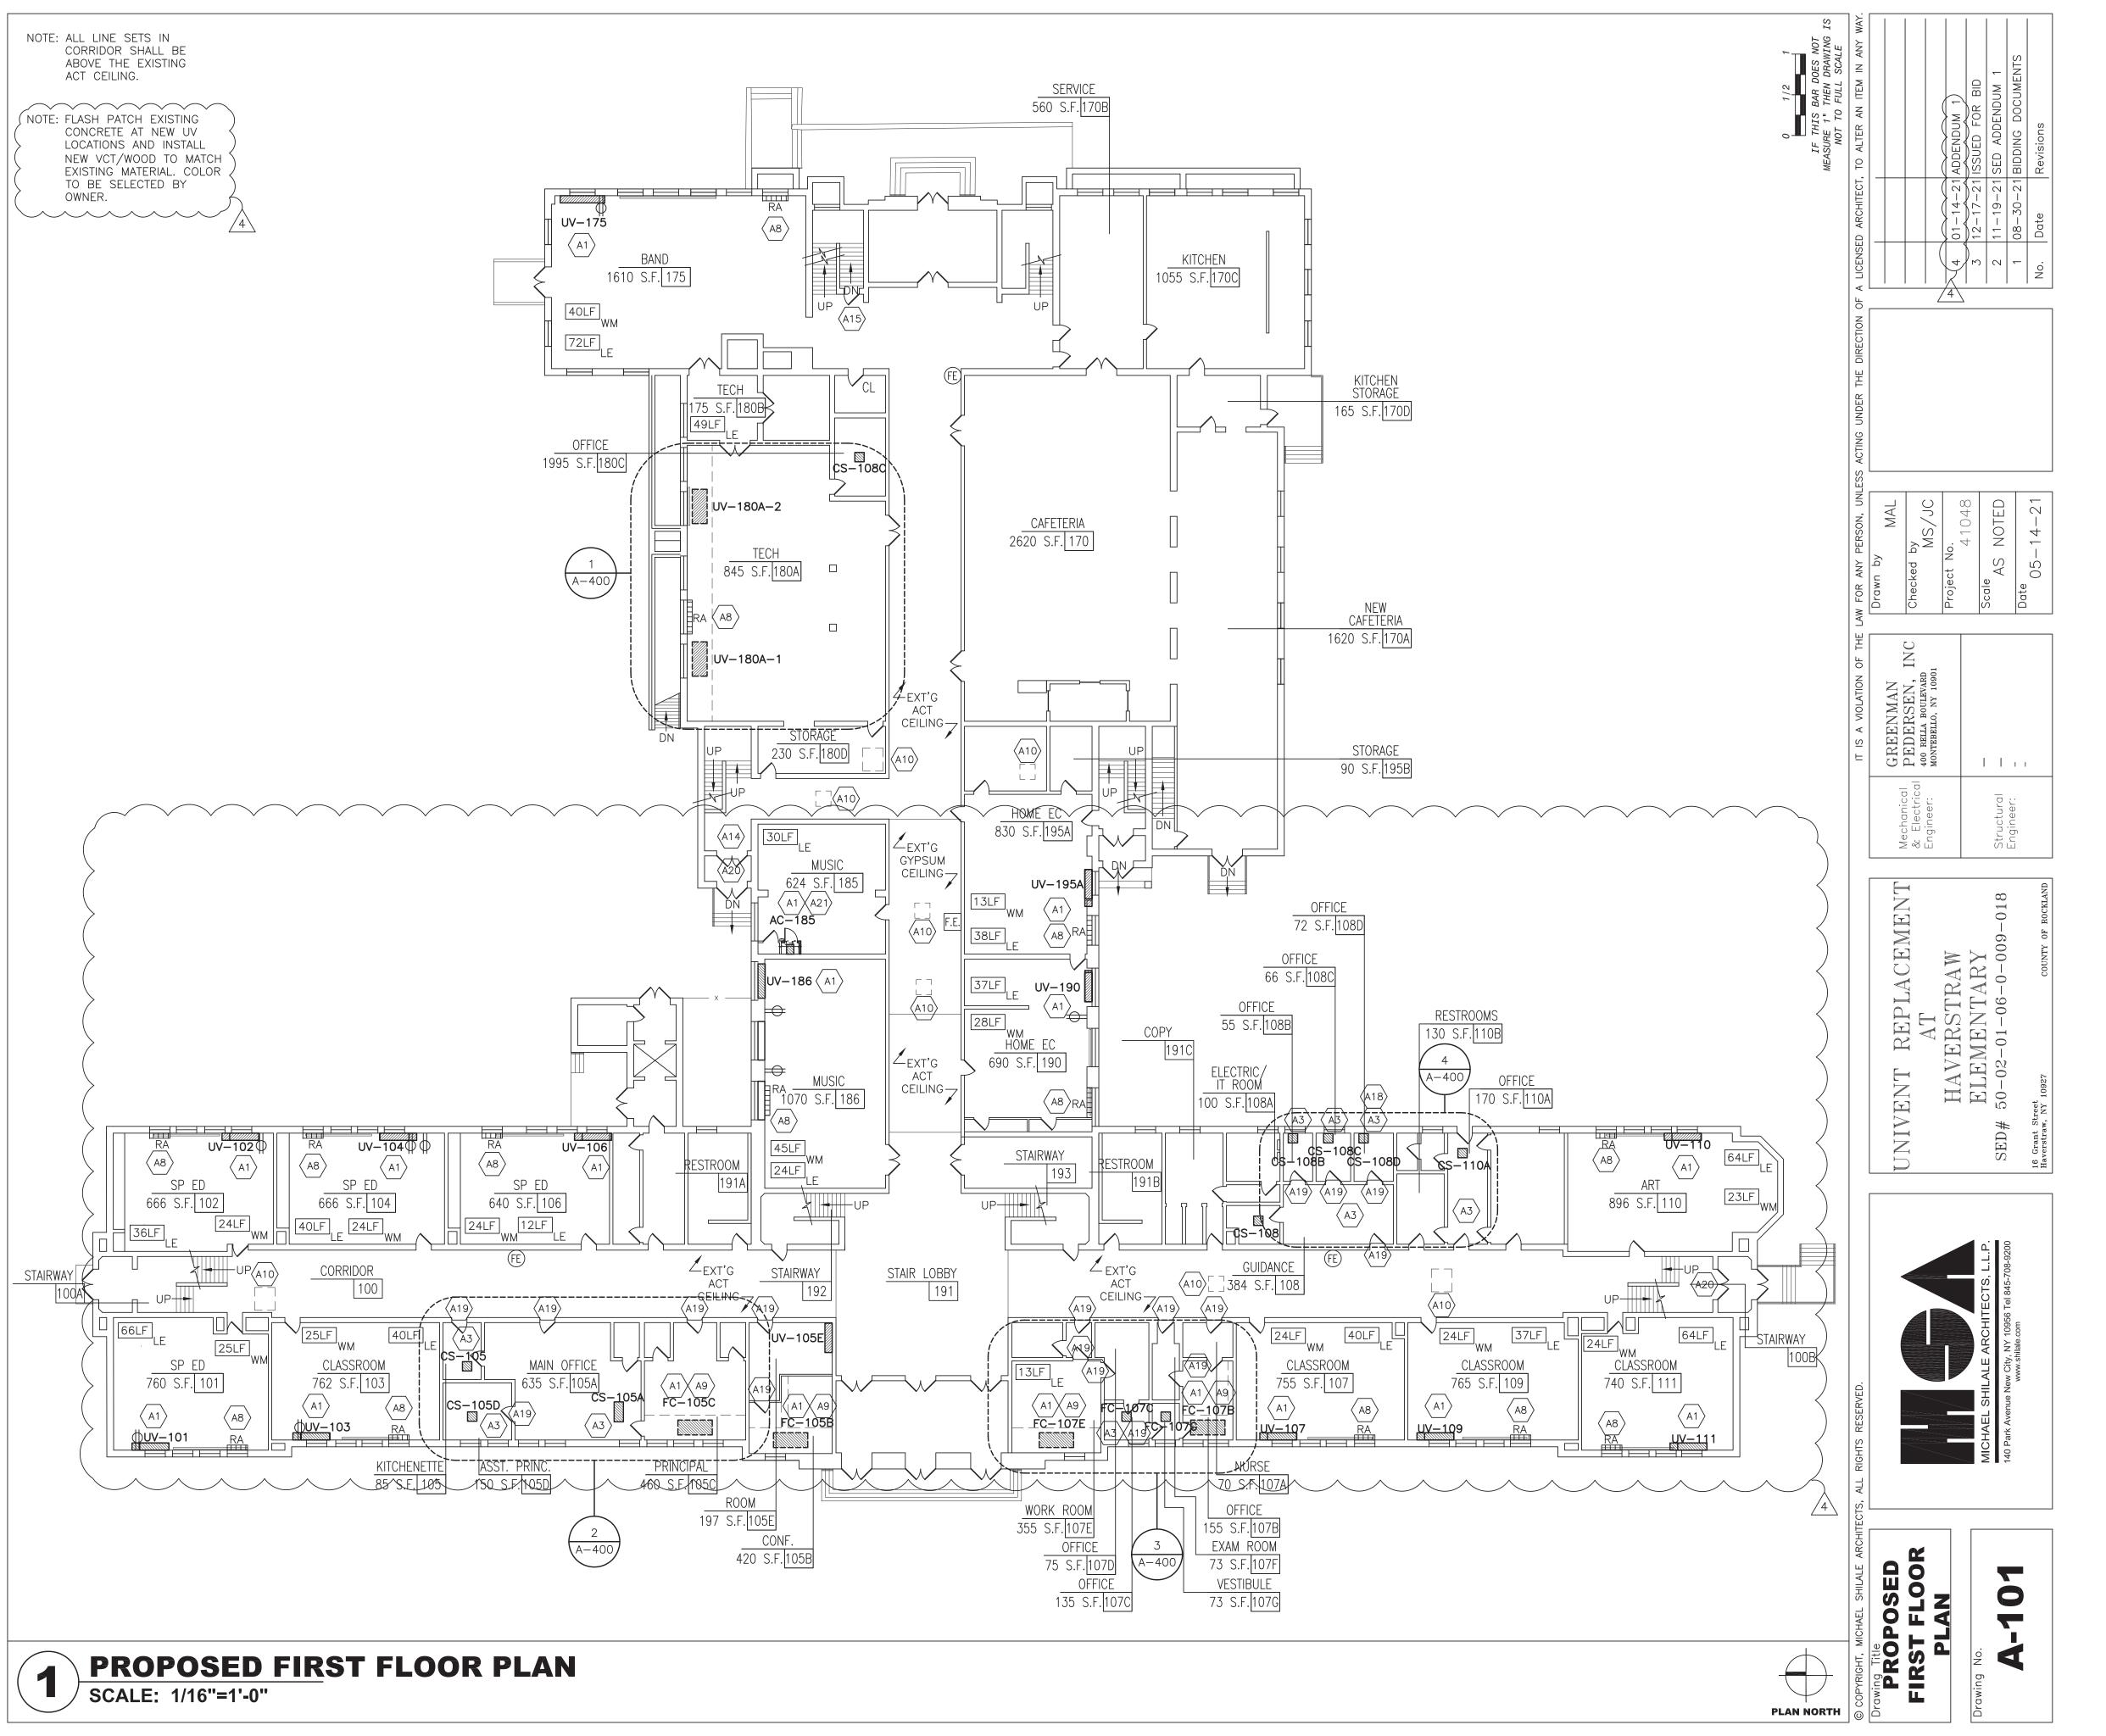

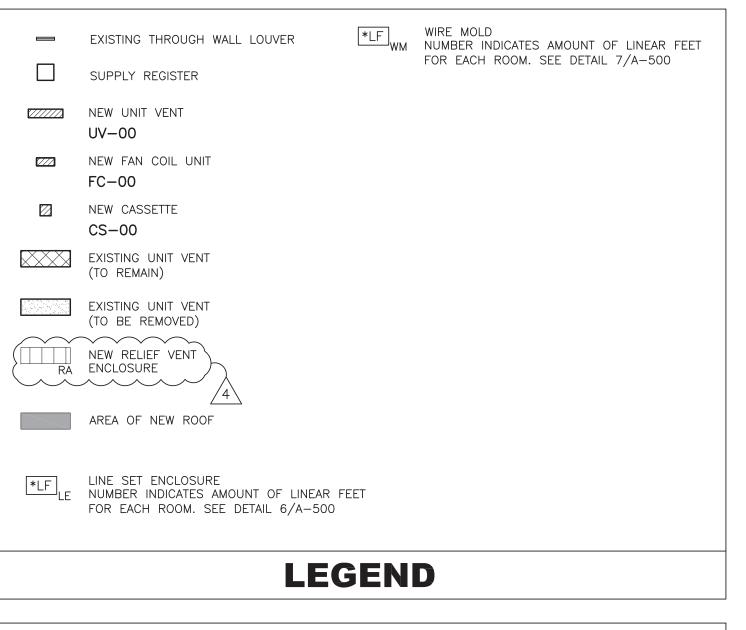


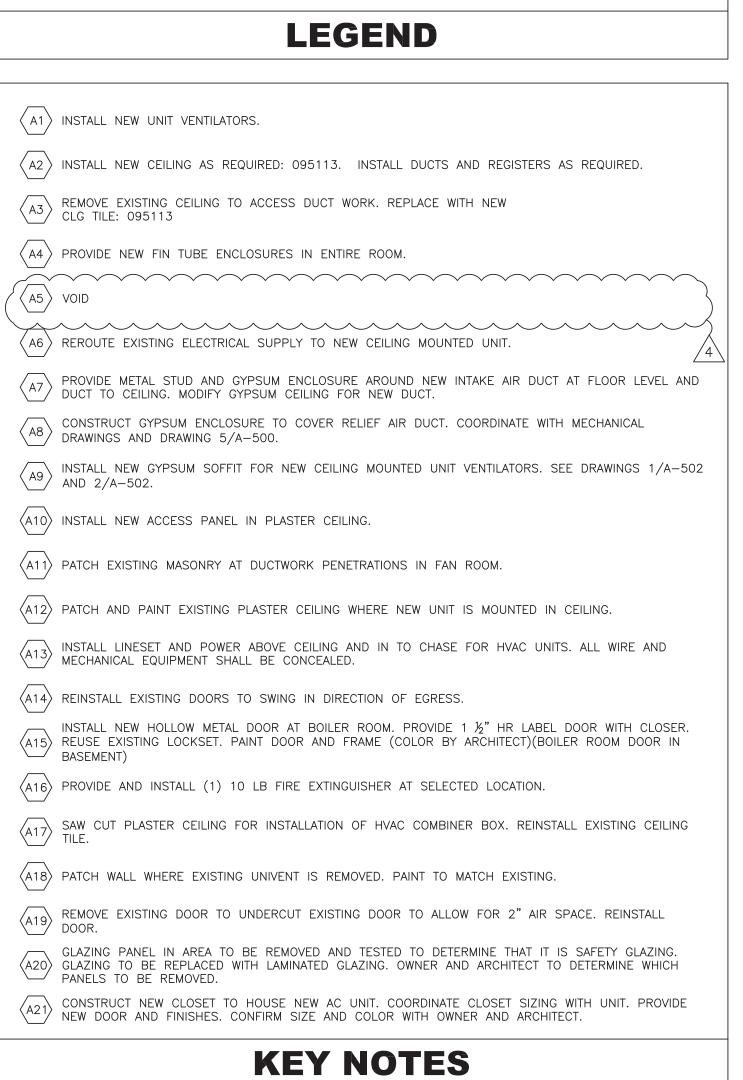

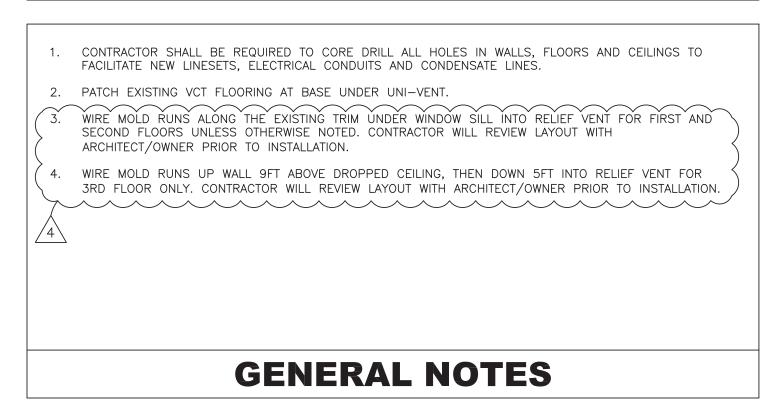

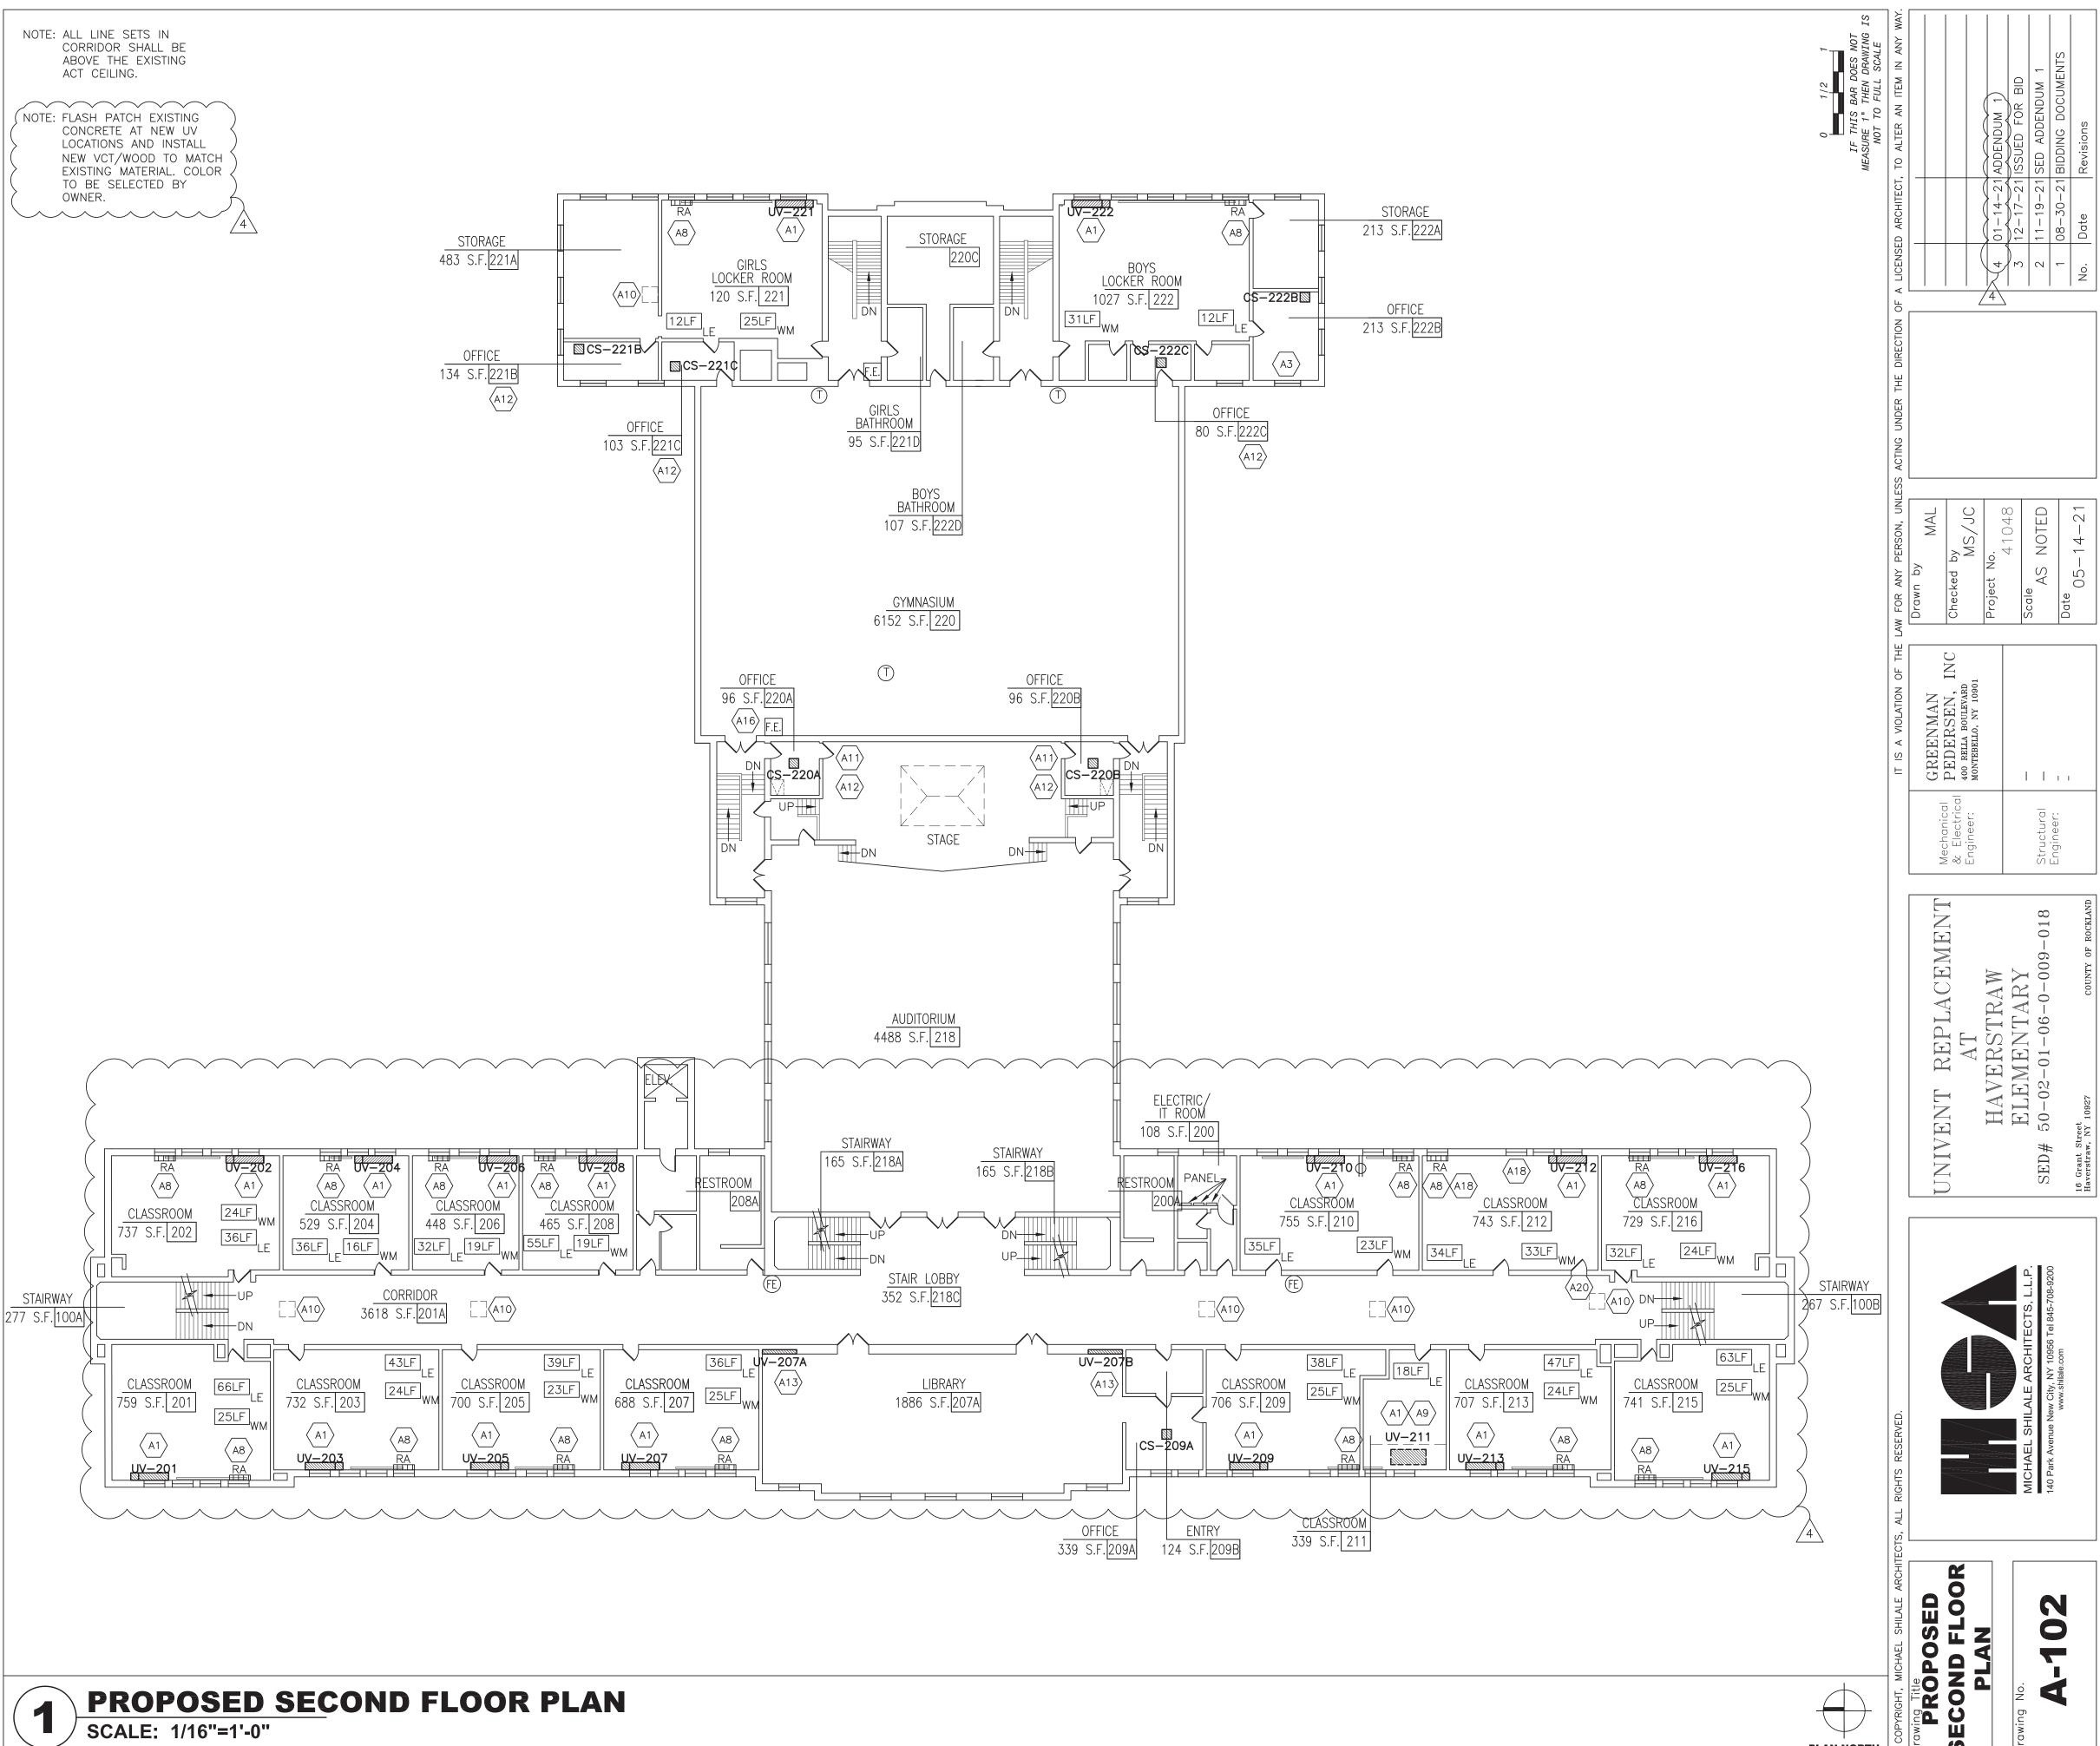

PLAN NORTH

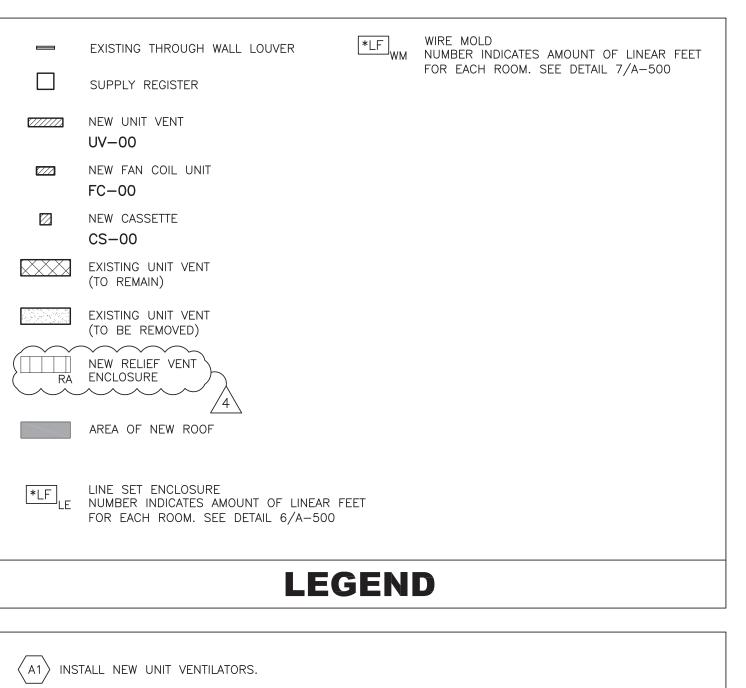


NOTE: FLASH PATCH EXISTING

CONCRETE AT NEW UV


LOCATIONS AND INSTALL


SCALE: 1/16"=1'-0"

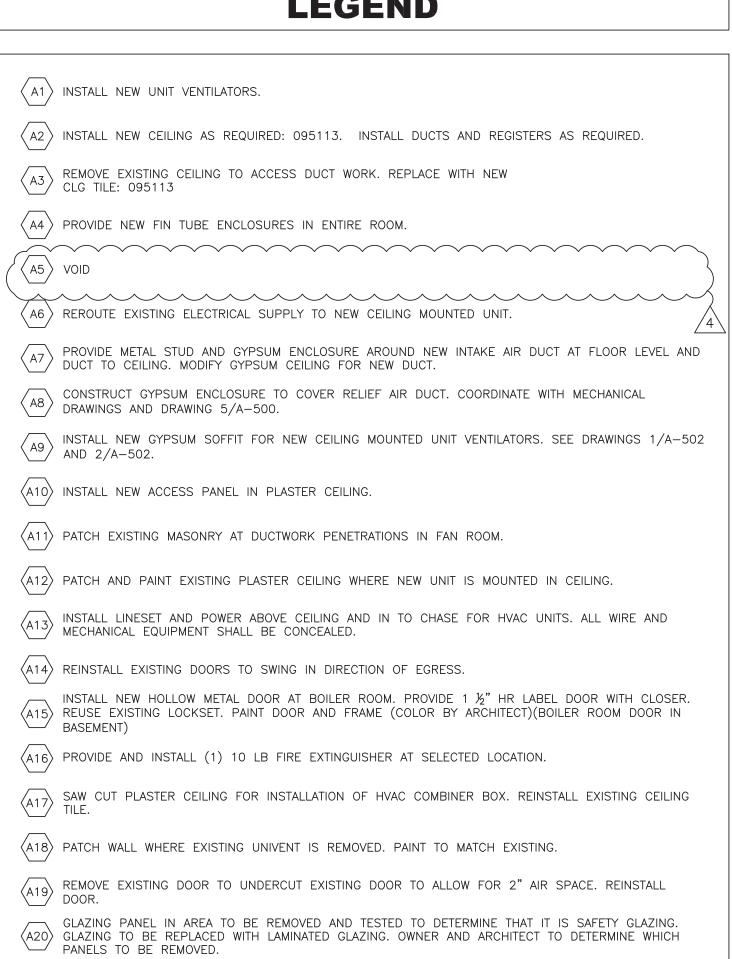

KEY NOTES

CONSTRUCT NEW CLOSET TO HOUSE NEW AC UNIT. COORDINATE CLOSET SIZING WITH UNIT. PROVIDE NEW DOOR AND FINISHES. CONFIRM SIZE AND COLOR WITH OWNER AND ARCHITECT.

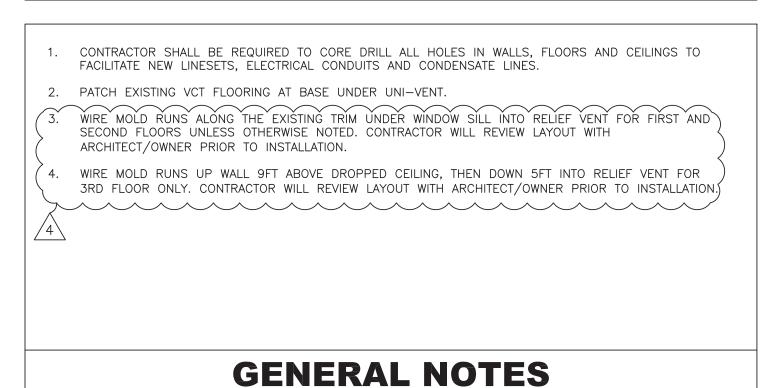

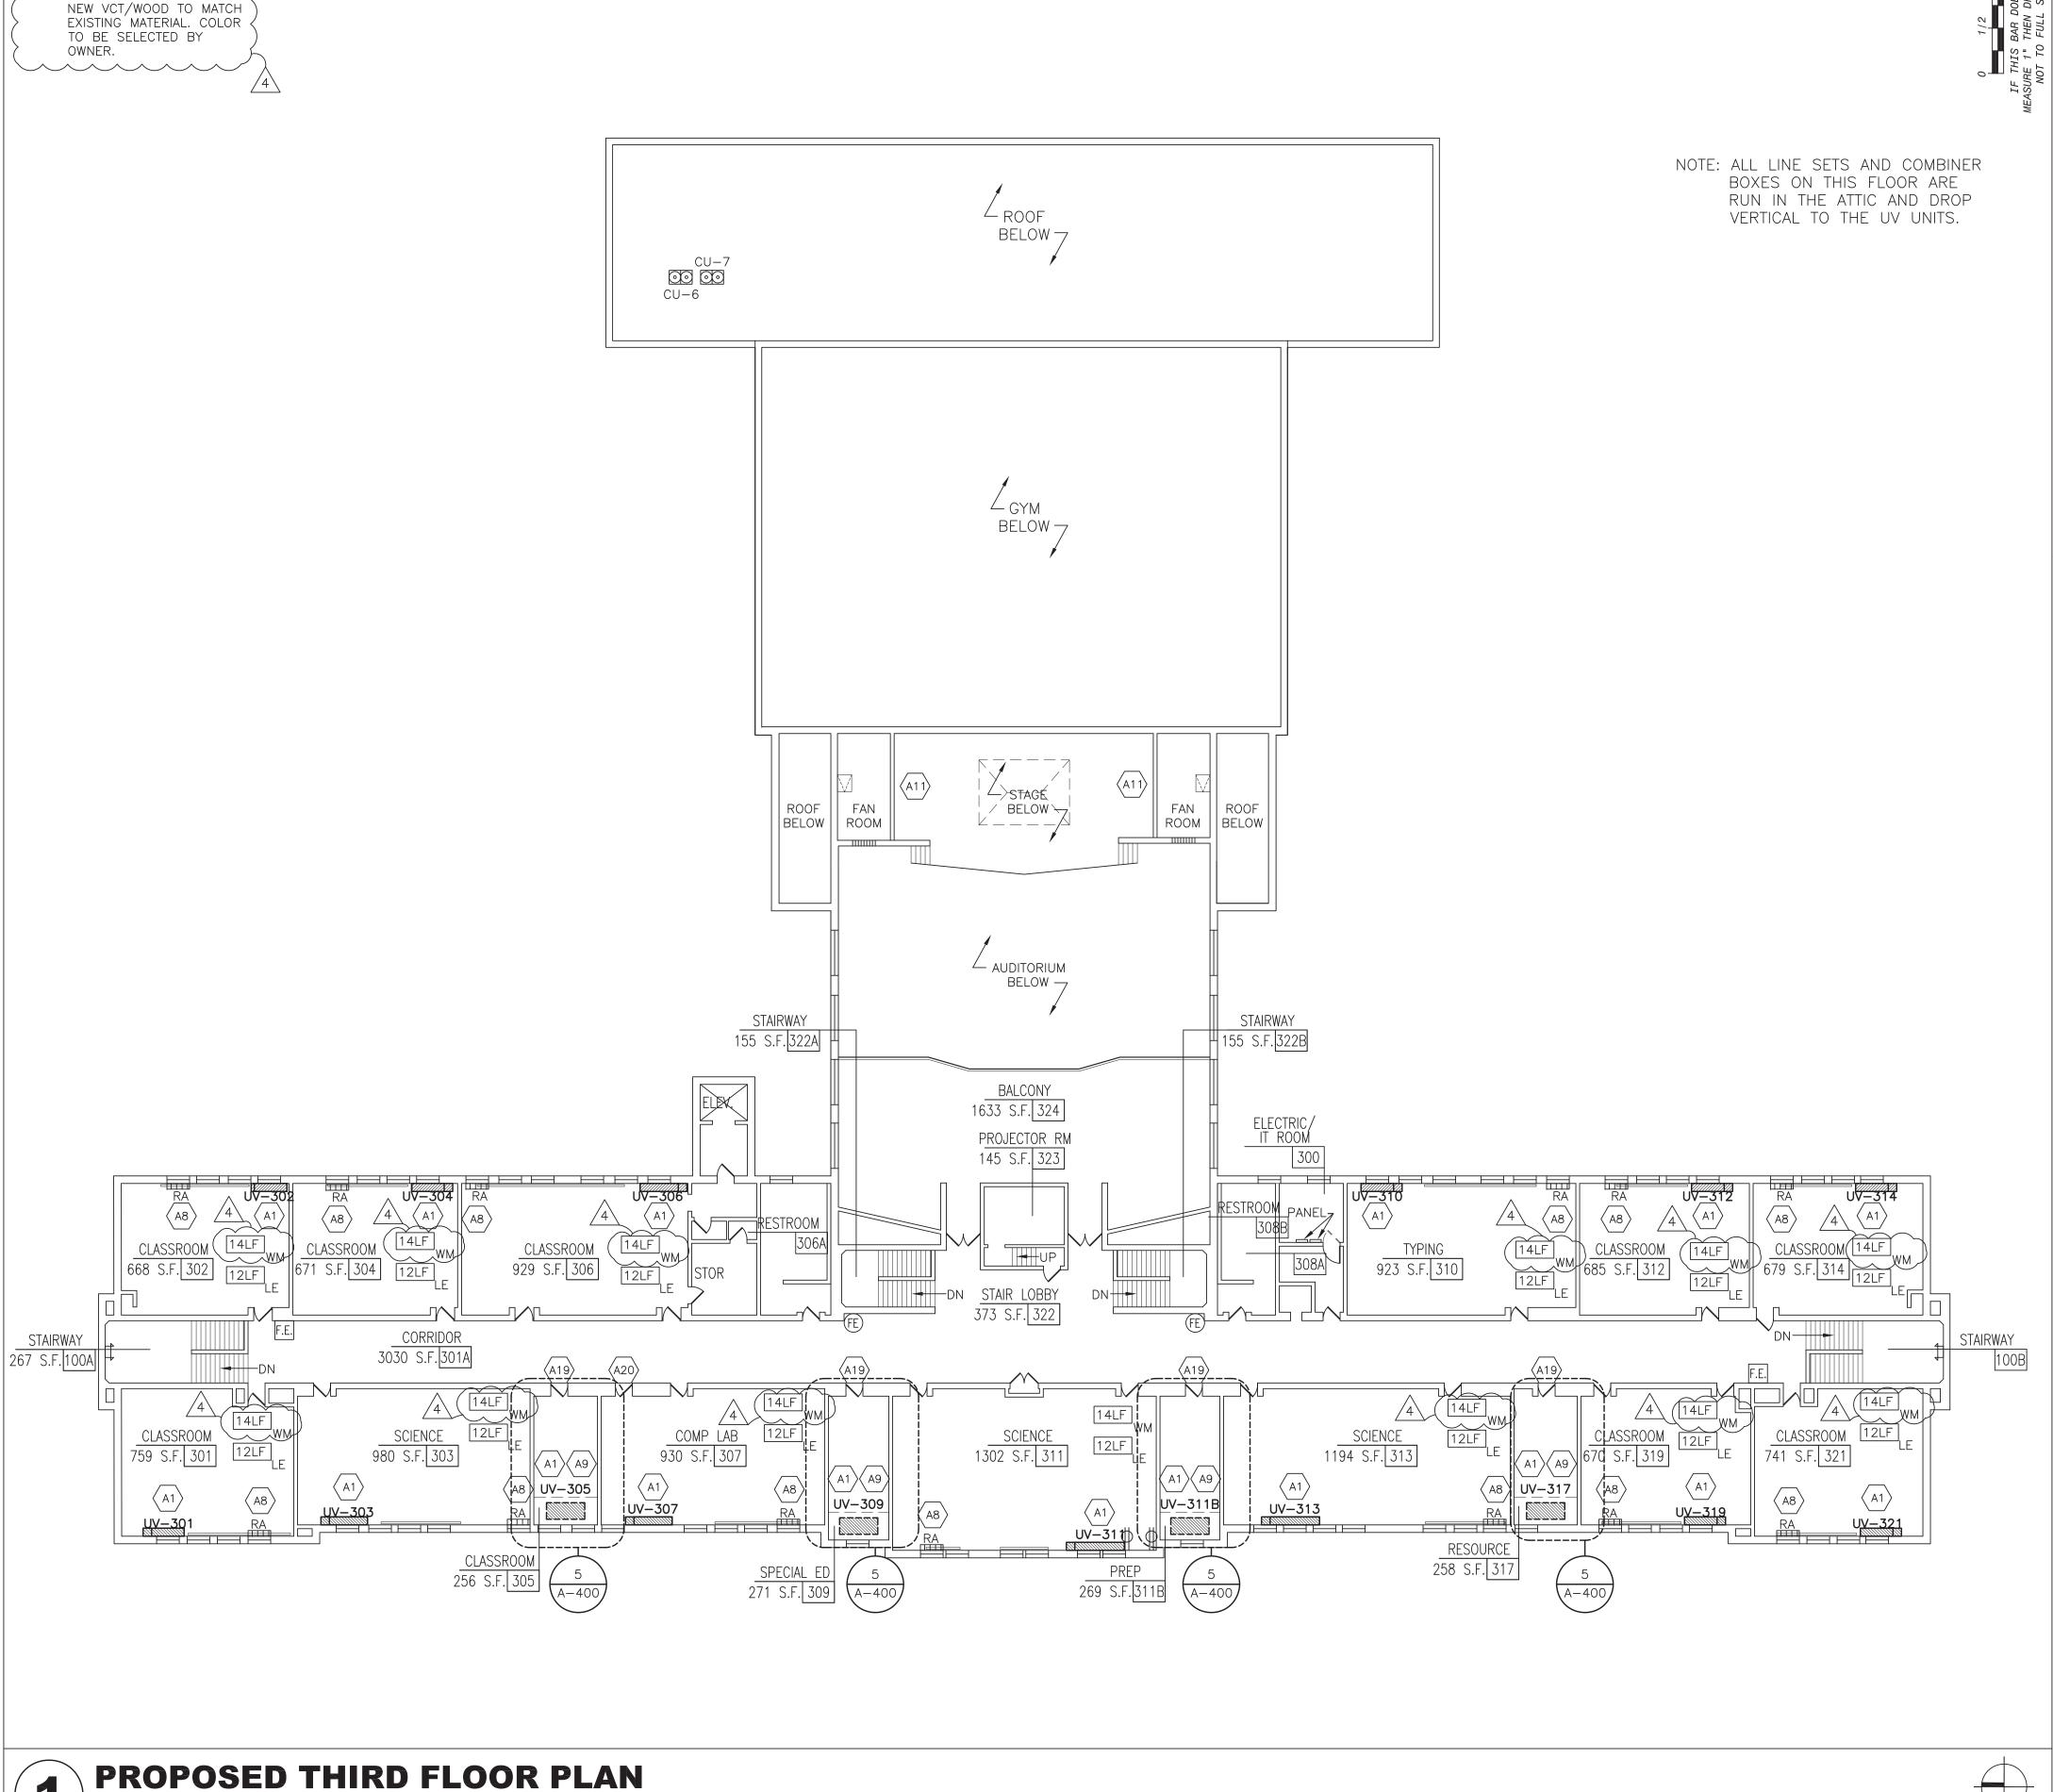

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PROPOSED
THIRD FLOOR
PLAN

PLAN NORTH

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