
# ABBREVIATIONS

AFF	ABOVE FINISH FLOOR	FAB	FABRIC	MAINT	MAINTAIN/MAINTENANCE	S
		FTF				SCHED
ACM	ASBESTOS CONTAINING MATERIAL		FACE TO FACE	MAX	MAXIMUM	
ACPL	ACOUSTIC PANEL	FIN	FINISHED	MFG	MANUFACTURER	SECT
ACT	ACOUSTIC CEILING TILE	FA	FIRE ALARM	MSNRY	MASONRY	SFB
ADJ	ADJUSTABLE	FD	FLOOR DRAIN	MO	MASONRY OPENING	SH
AC	AIR CONDITIONING		FIRE DAMPER	MATL	MATERIAL	SIM
				MECH		SL
AESS	ARCHITECTURAL EXPOSED STRUCTURAL STEEL	FE	FIRE EXTINGUISHER		MECHANICAL	
AHAP	AS HIGH AS POSSIBLE	FEC	FIRE EXTINGUISHER CABINET	MTL	METAL	STC
ALUM	ALUMINUM	FF	FACTORY FINISH	MCP	METAL COMPOSITE PANEL	SPEC
AMP	ACRYLIC MODIFIED POLYESTER	FHC	FIRE HOSE CABINET	MCB	METAL CORNER BEAD	SQFT
	APPROXIMATE	FHVC	FIRE HOSE VALVE CABINET	MS	METAL STUD	ST
AFFINOZ						
		FR	FIRE RATED	MLWK	MILL WORK	STSTL
BEPO	BROADCAST EPOXY	FRD	FRENCH DRAIN	MIN	MINIMUM	STL
BTW	BETWEEN	FFSC	FIRE RATED ASSEMBLY (DOORS)	MISC	MISCELLANEOUS	STR
BLKG	BLOCKING	FRTD	FIRE RETARDANT	MLDG	MOLDING	SUSP
BOT	BOTTOM	FIX	FIXTURE	MTG	MOUNTING	0001
				WIG	MOUNTING	-
BLDG	BUILDING		FLOOR			Т
BL	BUILDING LINE	FLUOR	FLUORESCENT	NIC	NOT IN CONTRACT	TB
		FI MTD	FLUSH MOUNTED	NTS	NOT TO SCALE	TBD
CAB	CABINET	FT	FOOT/FEET	NO	NUMBER	TERR
				NO	NUMBER	
CB	CEMENT BOARD	FDN	FOUNDATION			TFF
CI	CAST IRON	FRITZ	FRITZ FLOOR (RTT) TILE	OC	ON CENTER	TMP GL
CLG	CEILING			OPNG	OPENING	THERMO
CL	CENTER LINE	GALV	GALVANIZED	OPP	OPPOSITE	T&B
CMU	CONCRETE MASONRY UNIT	GFB	GROUND FACE BLOCK	OH	OPPOSITE HAND	TO
COL	COLUMN	GFRG	GLASS FIBER REINFORCED GYPSUM	OTS	OPEN TO STRUCTURE	TOS
CONC	CONCRETE	GL	GLASS	OUT	OUTLET	TOSS
CONF	CONFERENCE	GOG	GOGGLE	OD	OUTSIDE DIAMETER	TOES
	CONSTRUCTION	GWB	GYPSUM WALLBOARD	OF		TRT
		GVVB	GIPSUM WALLBUARD	UF	OUTSIDE FACE	
	CONTRACTOR					TYP
CONT	CONTINUOUS	Н	HEIGHT AFF	Р	PAINTED	
CPT	CARPET	HDW	HARDWARE	PT	PORCELAIN TILE	UNFIN
CT	CERAMIC TILE	HDWD	HARDWOOD	PTB	PORCELAIN TILE BASE	UNO
СТВ	CERAMIC TILE BASE	HD	HEAD	PR	PAIR	UR
		HDR	HEADER	PNL	PANEL	UTIL
DA	DEVICE ARRANGEMENT	HVAC	HEATING, VENTILATING, AIR CONDITIONING	PTN	PARTITION	
DET	DETAIL	HR	HOUR	PL	PROPERTY LINE	VAT
DF	DRINKING FOUNTAIN	HT	HEIGHT	PLAM	PLASTIC LAMINATE	VCT
DIM	DIMENSION	HM	HOLLOW METAL	PLMB	PLUMBING	VEN
DR	DOOR	HMFR	HOLLOW METAL FRAME	PLYWD	PLYWOOD	VERT
DN	DOWN		HORIZONTAL	PTWD		
DWG	DRAWING	HC	HANDICAP			VIF
DWG	DRAWING	ПС	HANDICAF	от		
				QT	QUARRY TILE	VRS
EE	EACH END	IF	INSIDE FACE	QTB	QUARRY TILE BASE	VT
EIFS	EXTERIOR INSULATION FINISH SYSTEM	IN	INCH/INCHES	QTY	QUANTITY	VWC
EJ	EXPANSION JOINT	INCL	INCLUDE/INCLUSIVE			
			INFORMATION	RCP		
ELEC	ELECTRIC/ELECTRICAL	INFO			REFLECTED CEILING PLAN	WB
	ELEVATION	INSUL	INSULATION	REFL	REFLECTED	WC
ENCL	ENCLOSURE	INT	INTERIOR	REQD	REQUIRED	WF
EOD	EDGE OF DECK			RB	RUBBER BASE	WGL
EOS	EDGE OF SLAB	JC	JANITOR'S CLOSET	RTN	RETURN	W/
EPO	EPOXY	JT	JOINT	RA	RETURN AIR	W/C
EPS	EDGE OF POUR STOP			REV	REVISED/REVISION	W/O
EQ	EQUAL	KPL	KICK PLATE	RFI	REQUEST FOR INFORMATION	WOM
ES	EACH SIDE	KD	KNOCKDOWN	RO	ROUGH OPENING	WD
	EXISTING	KO			RUBBER TREATD/TILE	
EXST		ΝŪ	KNOCKOUT	RT		WD BLK
ETR	EXISTING TO REMAIN			RTB	RUBBER TREAD BASE	WD DR
ETRE	EXISTING TO BE RELOCATED	LAM	LAMINATED	RTT	RESILIENT TERRAZZO TILE	WP
	EXPANSION JOINT	LAMGL		RW	RESCUE WINDOW	WR
EXT	EXTERIOR	LT	LIGHT			WW
						** **
EW	EACH WAY	LTG	LIGHTING			
		LWC	LIGHT WEIGHT CONCRETE			YD
		LIN	LINOLEUM			YCO
						ZCC
						200

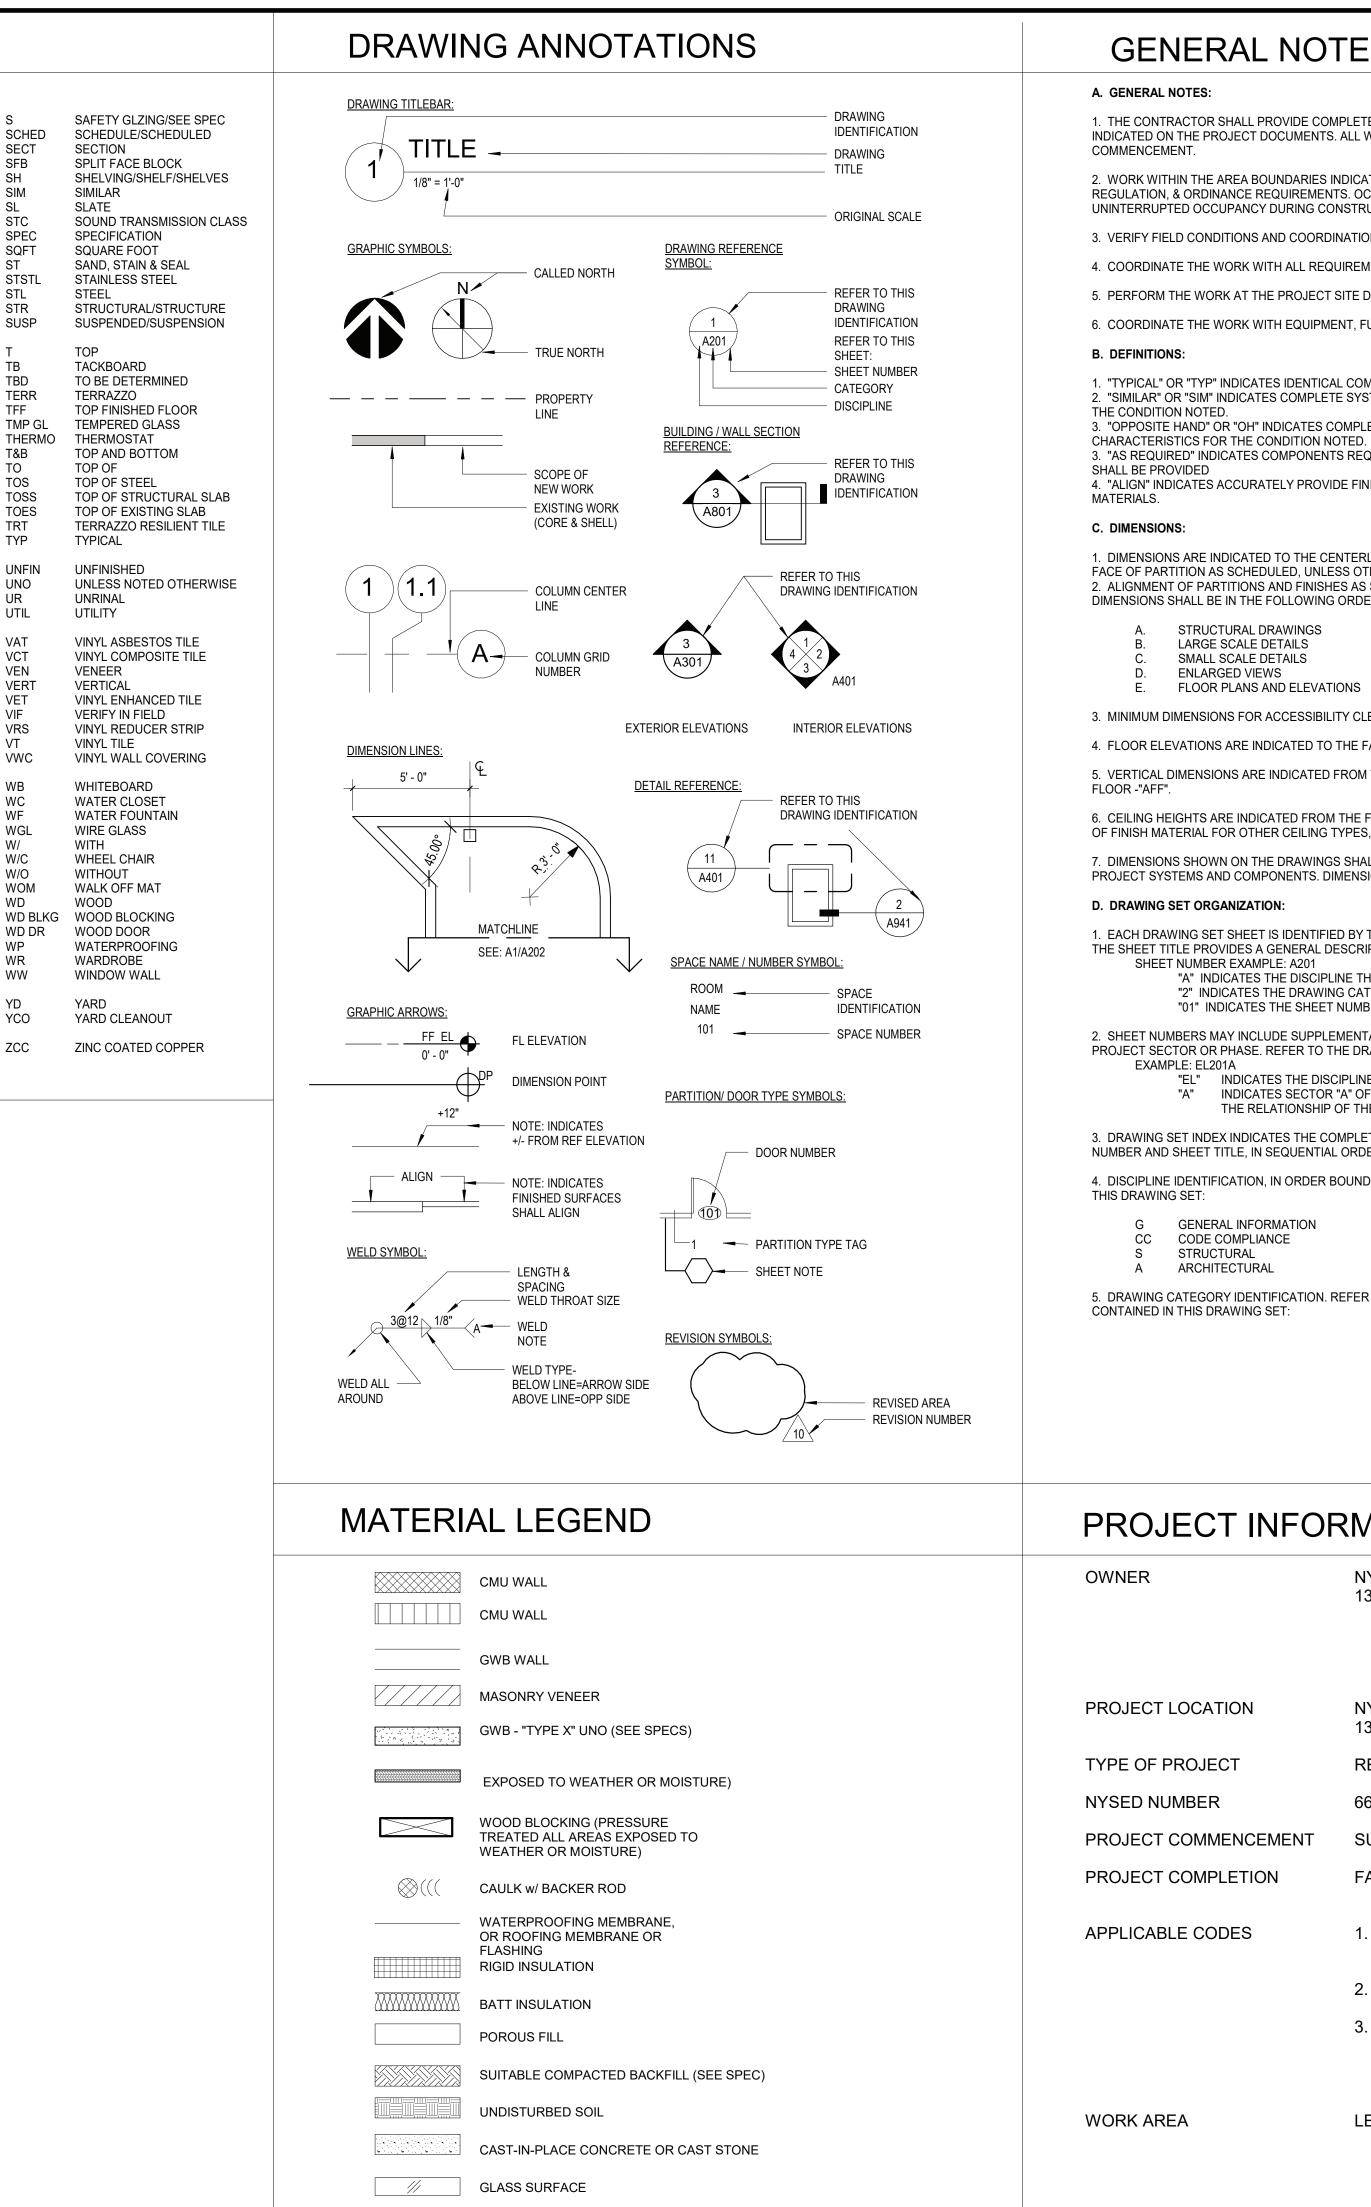

# **GENERAL NOTES**

1. THE CONTRACTOR SHALL PROVIDE COMPLETE PROJECT SYSTEMS AND COMPONENTS AND COMPLY WITH ALL REQUIREMENTS INDICATED ON THE PROJECT DOCUMENTS. ALL WORK TO BE COMPLETED IN MANNER TO PROVIDE OCCUPANCY PERMIT PRIOR TO LEASE

2. WORK WITHIN THE AREA BOUNDARIES INDICATED IN THE PROJECT DOCUMENTS, SHALL COMPLY WITH ALL APPLICABLE BUILDING CODE, REGULATION, & ORDINANCE REQUIREMENTS. OCCUPANTS ADJACENT TO THE PROJECT AREA BOUNDARIES SHALL CONTINUE UNINTERRUPTED OCCUPANCY DURING CONSTRUCTION OF THE PROJECT.

3. VERIFY FIELD CONDITIONS AND COORDINATION WITH THE PROJECT DOCUMENTS PRIOR TO PROCEEDING WITH THE WORK.

4. COORDINATE THE WORK WITH ALL REQUIREMENTS INDICATED IN THE PROJECT DOCUMENTS.

5. PERFORM THE WORK AT THE PROJECT SITE DURING NORMAL BUSINESS HOURS, UNLESS OTHERWISE NOTED.

6. COORDINATE THE WORK WITH EQUIPMENT, FURNISHINGS, AND SYSTEMS.

1. "TYPICAL" OR "TYP" INDICATES IDENTICAL COMPLETE SYSTEM SHALL BE PROVIDED FOR EACH OCCURRENCE OF THE CONDITION NOTED. 2. "SIMILAR" OR "SIM" INDICATES COMPLETE SYSTEM AND COMPONENTS SHALL BE PROVIDED COMPARABLE TO THE CHARACTERISTICS FOR 3. "OPPOSITE HAND" OR "OH" INDICATES COMPLETE SYSTEM AND COMPONENTS SHALL BE PROVIDED AS A MIRROR IMAGE TO THE 3. "AS REQUIRED" INDICATES COMPONENTS REQUIRED TO COMPLETE THE NOTED SYSTEM, AS INDICATED IN THE PROJECT DOCUMENTS, 4. "ALIGN" INDICATES ACCURATELY PROVIDE FINISH FACES OF MATERIALS IN STRAIGHT, TRUE, AND PLUMB RELATION TO ADJACENT

1. DIMENSIONS ARE INDICATED TO THE CENTERLINE OF THE STRUCTURAL GRID, FACE OF CONCRETE WALL, NOMINAL FACE OF CMU WALL FACE OF PARTITION AS SCHEDULED, UNLESS OTHERWISE NOTED. 2. ALIGNMENT OF PARTITIONS AND FINISHES AS SCHEDULED SHALL BE STRAIGHT, TRUE & PLUMB. THE PRIORITY FOR PROJECT DIMENSIONS SHALL BE IN THE FOLLOWING ORDER:

> STRUCTURAL DRAWINGS LARGE SCALE DETAILS SMALL SCALE DETAILS

FLOOR PLANS AND ELEVATIONS

3. MINIMUM DIMENSIONS FOR ACCESSIBILITY CLEARANCES AND BUILDING CODE REQUIREMENTS SHALL BE MAINTAINED.

4. FLOOR ELEVATIONS ARE INDICATED TO THE FACE OF THE STRUCTURAL SLAB, UNLESS OTHERWISE NOTED.

5. VERTICAL DIMENSIONS ARE INDICATED FROM THE FLOOR ELEVATION TO FACE OF FINISHED MATERIAL, UNLESS NOTED ABOVE FINISH

6. CEILING HEIGHTS ARE INDICATED FROM THE FLOOR ELEVATION TO THE FACE OF SUSPENDED ACOUSTIC PANEL CEILING GRID OR FACE OF FINISH MATERIAL FOR OTHER CEILING TYPES, UON.

7. DIMENSIONS SHOWN ON THE DRAWINGS SHALL INDICATE THE REQUIRED SIZE, CLEARANCE, AND DIMENSIONAL RELATIONSHIP BETWEEN PROJECT SYSTEMS AND COMPONENTS. DIMENSIONS SHALL NOT BE DETERMINED BY SCALING THE DRAWINGS.

1. EACH DRAWING SET SHEET IS IDENTIFIED BY THE SHEET NUMBER IN THE LOWER RIGHT HAND CORNER OF THE DRAWING TITLE BLOCK. THE SHEET TITLE PROVIDES A GENERAL DESCRIPTION OF THE CONTENTS OF THE SHEET. "A" INDICATES THE DISCIPLINE THAT CREATED THE DRAWING

"2" INDICATES THE DRAWING CATEGORY CONTAINED ON THE SHEET "01" INDICATES THE SHEET NUMBER

2. SHEET NUMBERS MAY INCLUDE SUPPLEMENTAL CHARACTERS TO PROVIDE ADDITIONAL INFORMATION, SUCH AS DRAWING CONTENT, PROJECT SECTOR OR PHASE. REFER TO THE DRAWING INDEX FOR A COMPLETE LIST OF SHEETS INCLUDED IN THE DOCUMENT SET.

"EL" INDICATES THE DISCIPLINE THAT CREATED THE DRAWING AND THE DRAWING CONTENT = ELECTRICAL LIGHTING "A" INDICATES SECTOR "A" OF PLAN SHEET "201". REFER TO THE PROJECT KEY PLAN OR COMPOSITE PLAN INDICATING THE RELATIONSHIP OF THE SECTORS.

3. DRAWING SET INDEX INDICATES THE COMPLETE LIST OF SHEETS CONTAINED IN THE DRAWING SET. INDEXED BY DISCIPLINE, SHEET NUMBER AND SHEET TITLE, IN SEQUENTIAL ORDER. NOTE THAT ALL SEQUENTIAL SHEET NUMBERS MAY BE NOT USED IN THE DRAWING SET 4. DISCIPLINE IDENTIFICATION, IN ORDER BOUND IN THE DRAWING SET. REFER TO THE DRAWING SET INDEX FOR DISCIPLINE CONTAINED IN

INFORMATION	М	MECHANICAL
/IPLIANCE	E	ELECTRICAL
RAL	Р	PLUMBING

5. DRAWING CATEGORY IDENTIFICATION. REFER TO THE DRAWING SET INDEX FOR DISCIPLINES, CATEGORIES, AND SHEET NUMBERS


## **PROJECT INFORMATION**

	NYACK PUBLIC SCHOOLS 13A DICKINSON AVE, NYACK, NY 10960								
		TELEPHONE: FAX:	845.353.7000 845.353.7019						
ON		CK PROFESSIONA DICKINSON AVE, N	L DEVELOPMENT CENTER IYACK, NY 10960						
T	REN	OVATION							
	66-23-00-01-0-008-011								
NCEMENT	SUMMER 2022								
ETION	FALL 2022								
ES	1.	2020 NEW YORK AND BUILDING C	STATE UNIFORM FIRE PREVENTION						
	2.	2020 UNIFORM C	ODE SUPPLEMENTS						
	3.		F PLANNING STANDARDS, THE THE STATE OF NEW YORK, THE STATE PARTMENT						
	LEVE	EL 2							

# PROFESSIONAL DEVELOPMENT CENTER

### NYACK UFSD

**13A DICKINSON AVENUE** NYACK, NY 10960

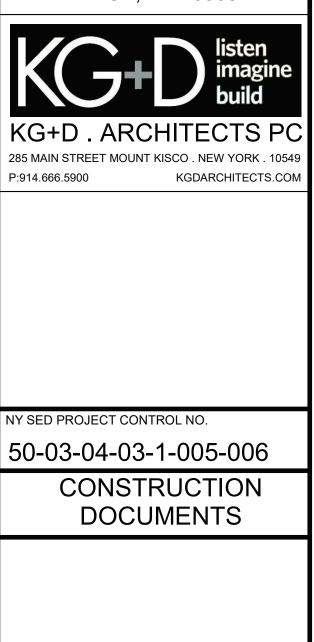

KEY PLAN

RESENTED BY THIS DRAWING ARE OWNED BY AND ARE THE PROPERTY YER, GARMENT, & DAVIDSON ARCHITECTS, PC (KG&D), AND WERE CREA R USE ON THIS PROJECT, NONE OF SUCH IDEAS, DESIGNS, ARRANGEME R PLANS SHALL BE USED BY OR DISCLOSED TO ANY PURPOSE WHATSOEVER HOUT THE WRITTEN PERMISSION OF (KG&D).

FE: ALL IDEAS, DESIGNS, ARRANGEMENTS AND PLANS INDICATED OR

ITEN DIMENSIONS ON THIS DRAWING SHALL HAVE PRECEDENCE OVER LED DIMENSIONS. CONTRACTOR SHALL VERIFY ALL ACTUAL DIMENSIONS CONDITIONS ON THE JOB AND THE ARCHITECT MUST BE NOTIFIED OF AI ATIONS FROM DIMENSIONS AND CONDITIONS SHOWN. SHOP DETAILS MU SUBMITTED TO THIS OFFICE FOR APPROVAL BEFORE PROCEEDING WITH ABRICATION.

TERATIONS BY ANY PERSON, IN ANY WAY, OF ANY ITEM CONTAINED ON THI OCUMENT, UNLESS ACTING UNDER THE DIRECTION OF THE LICENCED CHITECT WHOSE PROFESSIONAL SEAL IS AFFIXED HERETO, IS A VIOLATION F TITLE VII. SECT. 69.5 (b) OF NEW YORK STATE LAW. PYRIGHT KAEYER, GARMENT + DAVIDSON ARCHITECTS & ENGINEERS, PC RIGHTS RESERVED

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4	2022-08-03	BID ADDENDUM #3
2	2022-07-12	ISSUE FOR BID
1	2022-03-24	CONSTRUCTION DOCUMENTS
No.	Date	Issue
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Job No.


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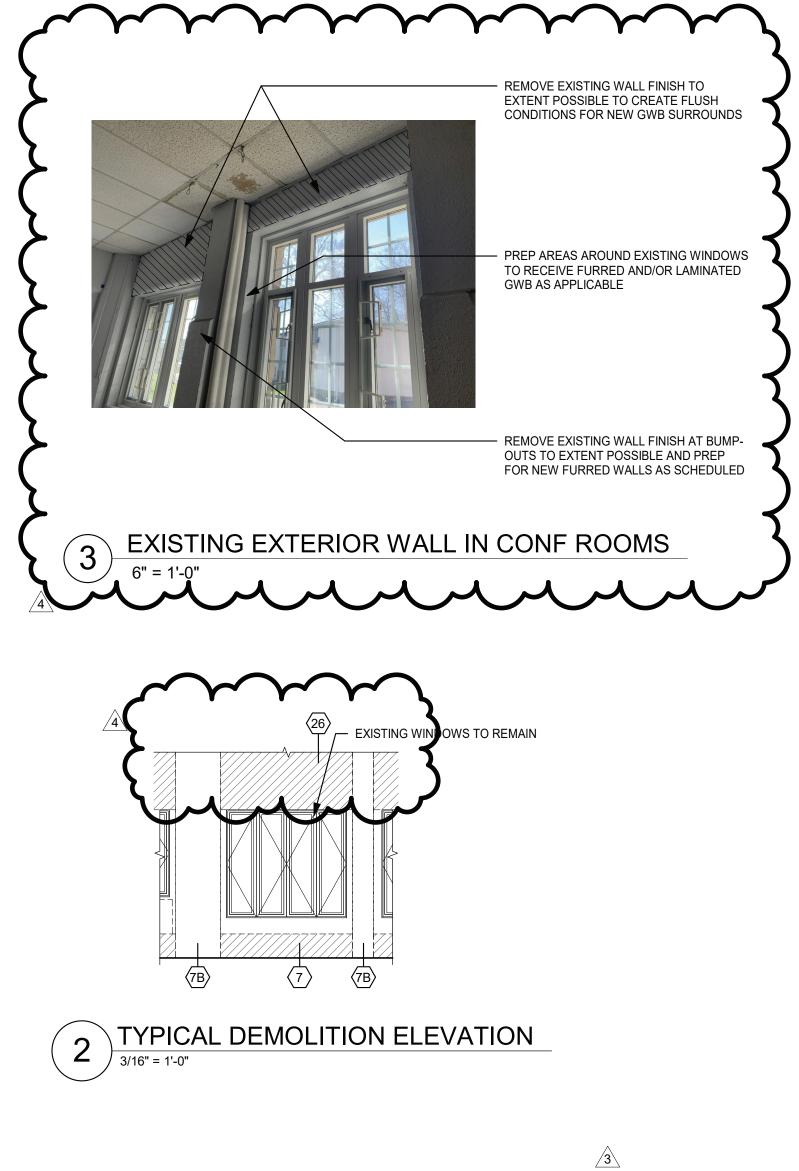
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Author Checker





1. THIS PROJECT REQUIRES REMOVAL OF HAZARDOUS MATERIALS. SEE SPECIFICATIONS FOR THE REPORT WHICH INCLUDES THE TYPES, EXPECTED LOCATIONS, HANDLING, REMOVAL PROCEDURES & OTHER INFO.

2. DEMOLITION &/OR TIE-INS TO EXISTING M.E.P. SYSTEMS MAY ENCOUNTER CONCEALED HAZARDOUS MATERIAL. NOTIFY THE ARCHITECT IMMEDIATELY SHOULD SUCH MATERIALS BE SUSPECTED & DO NOT DISTURB SUCH MATERIAL
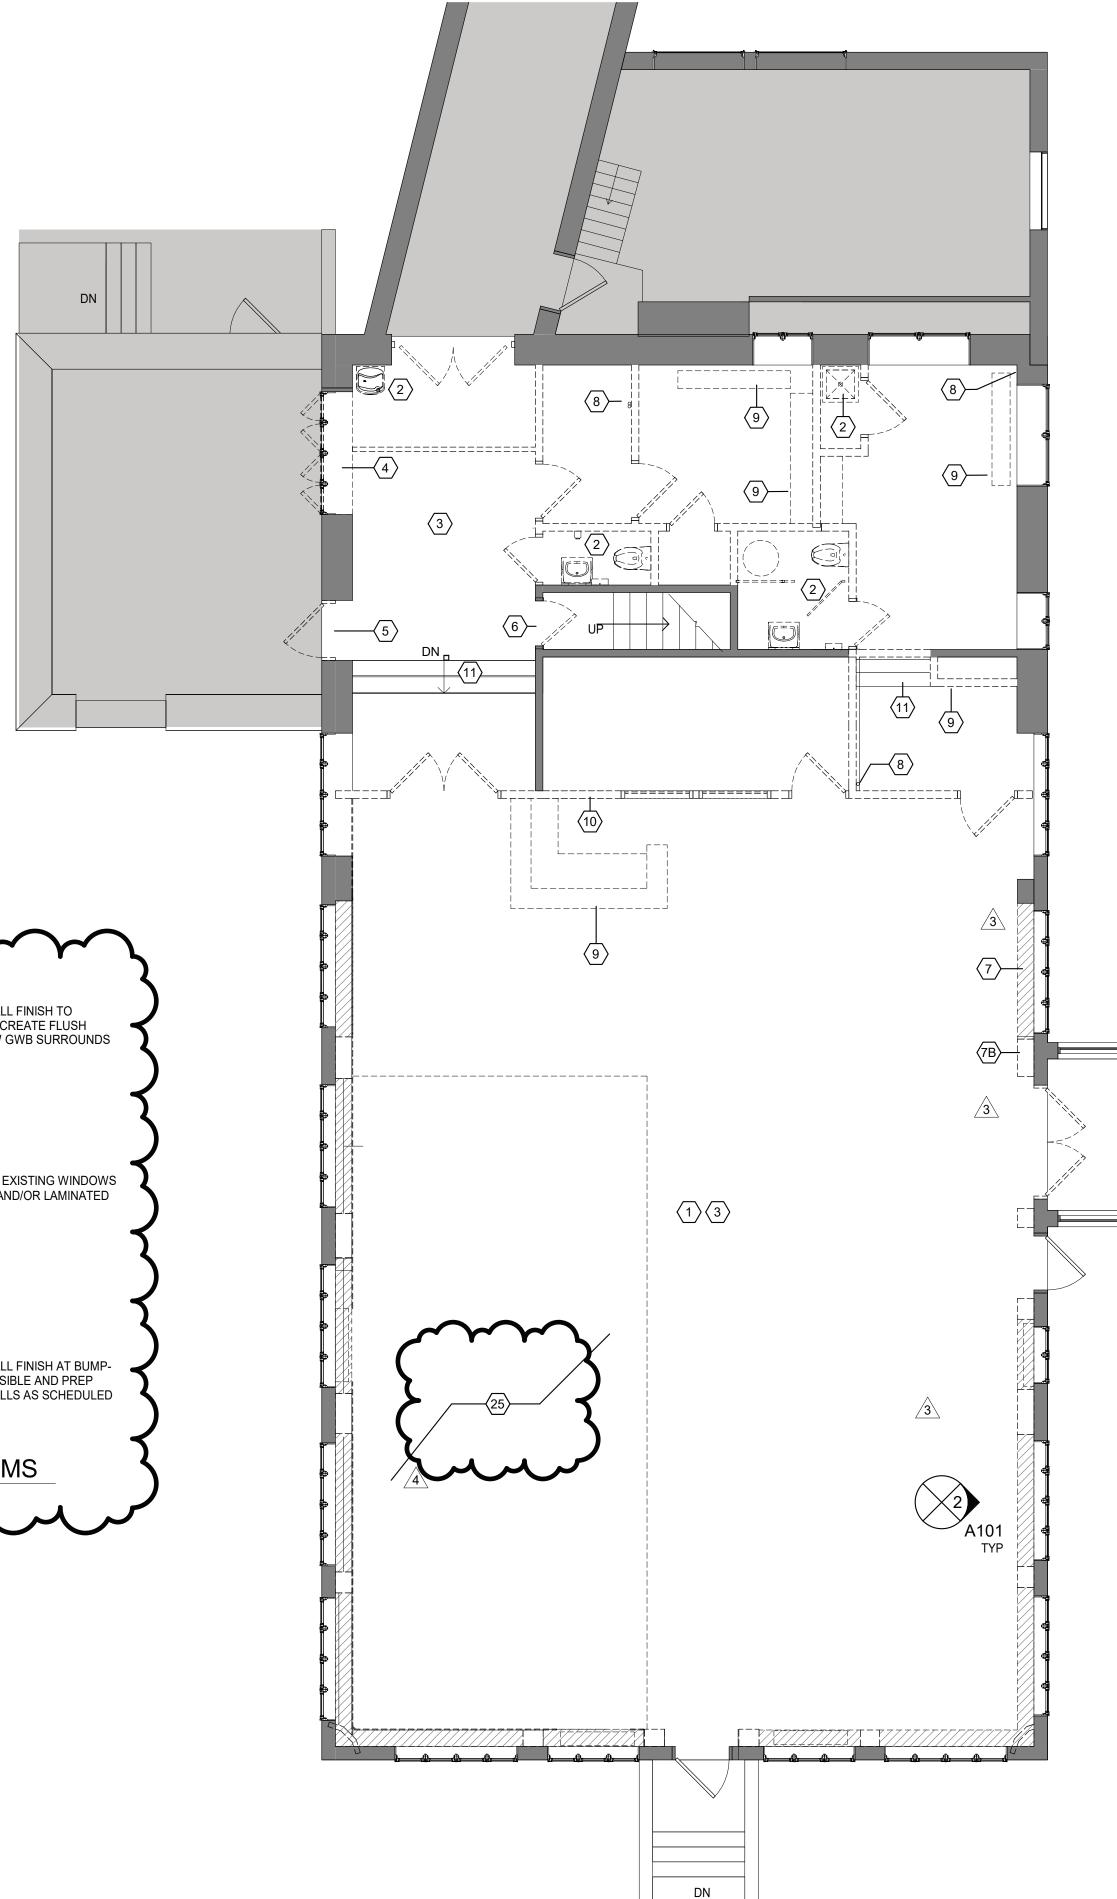
### GENERAL DEMOLITION NOTES:

1. DEMOLITION IS NOT NECESSARYILY LIMITED TO WHAT IS SHOWN ON DRAWINGS. THE INTENT IS TO INDICATE THE GENERAL SCOPE OF DEMOLITION REQUIRED TO COMPLETE THE WORK IN ACCORDANCE WITH THE CONTRACT DRAWINGS. PRIOR TO ANY DEMOLITION CONTRACTORS ARE REQUIRED TO VISIT SITE AND FAMILIARIZE THEMSELVES WITH EXISTING CONDITIONS AND NOTE ANY DISCREPENCIES IN WRITING TO ARCHITECT.

2. COORDINATE ALL DEMOLITION w/ M.E.P. REMOVALS. NOTE: ALL WIRING, DEVICES & M.E.P. SYSTEMS NOT BEING REMOVED AS PART OF THE WORK, WHICH RUN THROUGH THE WORK AREA, SHALL BE TESTED, LABELED & PROTECTED FROM DISTURBANCE SO THEY REMAIN OPERATIONAL THROUGHOUT THE PROJECT.

3. BEFORE STARTING DEMOLITION OPERATIONS CONTRACTOR SHALL REVIEW ABATEMENT SPECIFICATIONS & DRAWINGS, WHICH IDENTIFIED AREAS & MATERIALS THAT ARE ASBESTOS CONTAINING MATERIALS & LEAD PAINT. CONTRACTOR SHALL FOLLOW PROCEDURES AS SET FORTH IN ABATEMENT SPECIFICATIONS AND BALANCE OF SPECIFICATIONS. ALL ABATEMENT WORK SHALL BE PART GENERAL TRADES CONTRACTORS BASE BID.

4. AT ANY SPACE BEING RENOVATED CONTRACTOR SHALL REMOVE EQUIPMENT AND MISCELLANEOUS ITEMS SUCH AS PLAQUES, SIGNAGE, DISPLAY BOARDS, TACK BOARDS, INTERCOMS, SPEAKERS, AND THE LIKE, AND TURN OVER TO THE OWNER.

5. ALL FLOOR AND WALL BASE TO BE REMOVED IN AREAS SHOWN IN CONTRACT.

6. ALL CEILING AND LIGHTING TO BE REMOVED IN AREAS SHOWN IN CONTRACT, UNO.

7. RETURN ALL EXISTING AV EQUIPMENT (I.E. PROJECTORS, SCREENS, MONITORS, AND SPEAKERS) TO OWNER.

8. DEMOLITION OF DOOR ASSEMBLIES TYPICALLY SHALL INCLUDE DEMO OF DOOR(S), FRAME SIDELITES (IF PRESENT), TRANSOMS (IF PRESENT), DOOR SADDLE, HARDWARE, AND RELATED ACCESSORIES. PATCH WALL, FLOOR, & HEAD. PREP FOR NEW DOOR ASSEMBLY (IF APPLICABLE)

9. DEMOLITION OF WINDOW ASSEMBLIES TYPICALLY SHALL INCLUDE DEMO OF WINDOW(S), FRAME, GLAZING, FLASHING, SILL TRIM/SURROUND/RETURN, HARDWARE, AND RELATED ACCESSORIES. PATCH ADJACENT AREAS. PREP FOR NEW WINDOW ASSEMBLY (IF APPLICABLE).

DEMOLITION PLAN 3/16" = 1'-0"

## HAZARDOUS MATERIAL NOTES:

10. WHEN DEMOLISHING PORTIONS OF THE WALLS OR ROOFS. CONTRACTOR SHALL PROVIDE TEMPORARY SHORING AND SUPPORT LINTELS. REGARDLESS OF WHETHER OPENING SPECIFICALLY CALLS OUT FOR A NEW LINTEL OR NOT. ALL MASONRY OPENINGS THAT CONTRACTOR CUTS IN SHALL RECEIVE A SUPPORT LINTEL. SEE STRUCTURAL DRAWINGS FOR DETAILS ON LINTEL TYPES & SIZES.

11. WHEN DEMOLISHING PORTIONS OF MASONRY WALLS IN AREAS VISIBLE TO THE PUBLIC CONTRACTOR SHALL "SAW CUT" AT MASONRY WALLS AND "TOOTH IN" AT ANY PATCHING OF MASONRY WALLS. ALL SCARS TO CEILINGS, ADJACENT WALLS, AND FLOORS SHALL BE PATCHED & RESTORED TO MATCH EXISTING ADJACENT MATERIALS.

12. BEFORE CUTTING AND OPENING/HOLE/TRENCH SPECIFICALLY FOR OTHER TRADE, CONTRACTOR SHALL REVIEW & VERIFY EXACT SIZE & LAYOUT WITH THAT TRADE CONTRACTOR.

13. WHEN DEMOLISHING PORTIONS OF EXTERIOR WALLS, CONTRACTOR SHALL SAVE PORTIONS OF DEMOLISHED MASONRY AND USE MASONRY INFILL OPENINGS AND TOOTH-IN AROUND ALL NEW OPENINGS.


14. WHEN DEMOLISHING FLOORS CONTRACTORS SHALL REMOVE FINISH FLOORING & SCRAPE SLAB/SUB-FLOORINGCLEAN. SUB-FLOOR SHALL BE LEVELED PRIOR TO INSTALLATION OF NEW SCHEDULED FINISH FLOOR. ANY DAMAGE TO ADJ. FLOORS SHALL BE PATCHED.

15. AFTER DEMOLITION OPERATIONS, WHEN FINISH PATCHING IF SPECIFIC FINISH/MATERIAL IS NOT CALLED OUT, CONTRACTOR SHALL MATCH EXISTING ADJACENT MATERIALS

16. AFTER DEMOLITION, WHERE SPECIFICALLY CALLED OUT OR NO, CONTRACTOR SHALL REPAIR ALL SCARS TO EXISTING ADJACENT MATERIALS AND RESTORE TO PRIOR CONDITION.

17. OWNER HAS RIGHT OF FIRST REFUSAL OF ANY MATERIAL ABATEMENT NOTES: SEE HAZARDOUS MATERIALS SURVEY REPORT, SPECIFICATIONS, AND DRAWINGS.

	GENERAL KEYNOTES
1	PATCH AND REPAIR AS REQUIRED IN PREPARATION FOR NEW CONSTRUCTION
2	GC TO COORDINATE PLUMBING TERMINATION BACK TO SOURCE
3	REMOVE EXISTING FLOORING MATERIAL AND PREPARE FLOOR SUBSTRATE FOR NEW CONSTRUCTION
4	REMOVE EXISTING WINDOWS, FRAMES AND ALL ASSOCIATED TRIM & HARDWARE - PREPARE MASONRY OPENING FOR NEW STOREFRONT AND DOOR. REMOVE EXISTING WINDOW TREATMENT.
5	REMOVE EXISTING DOOR, FRAME, AND ALL ASSOCIATED HARDWARE. INFILL WALL TO MATCH EXISTING FINISHES.
6	REMOVE EXISTING DOOR FRAME AND ALL ASSOCIATED HARDWARE. PREP AREA TO RECEIVE NEW DOOR AS SCHEDULED.
7	REMOVE LOWER WALL BETWEEN COLUMN FURRINGS AND PREP FOR NEW WORK - PATCH & MATCH EXISTING ADJACENT WALLS - TYP AT HATCH PATTERN IN MEETING ROOM - SEE DEMO ELEVATION
7B	REMOVE PLASTER WALL TO EXTENT POSSIBLE AT ALL COLUMN LOCATIONS IN MEETING ROOM AND PREP FOR NEW WORK - STRUCTURE TO REMAIN - SEE DEMO ELEVATION
8	REMOVE EXPOSED PIPING. COORDINATE WITH PLUMBING DRAWINGS.
9	COORDINATE REMOVAL OF BUILT-IN MILLWORK AND FURNITURE W/DISTRICT. LOOSE FURNITURE TO BE REMOVED BY OWNER. BUILT-IN MILLWORK TO BE REMOVED BY CONTRACTOR.
10	REMOVE STEEL SLAT ROLL UP DOOR
11	STAIRS TO REMAIN. PREP TO RECEIVE NEW FINISHES AS SCHEDULED.
25	LOCATION OF EXISTING RUBBER FLOORING ON +/- 1" HIGH ELEVATED WOOD PLATFORM TO BE REMOVED. GC TO COORDINATE DEMOLITION AND ABATEMENT AS REQUIRED PER SPECIFICATIONS.
26	REMOVE EXISTING PLASTER TO EXTENT POSSIBLE TO CREATE FLUSH CONDITION ABLE TO RECEIVE GYP BOARD IN WALL RECESS.
	DEMOLITION LEGEND
	DENOTES AREA OF NO MAJOR ARCHITECTURAL WORK. SPECIFIC WORK MAY BE SHOWN ELSEWHERE INCLUDING WORK THAT MAY REQUIRE ACCESS, PATCHING & RESTORATION, REFER TO STRUCTURAL & M F. P. DWGS

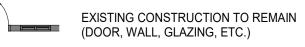



EXISTING CONSTRUCTION TO BE REMOVED (DOOR, WALL, GLAZING, ETC.) 

KEYNOTES

 $\bigcirc$ 

PROFES DEVELO CEN	PMENT
NYACK 13A DICKINS( NYACK, N	ON AVENUE
KG+D.ARCH 285 MAIN STREET MOUNT K P:914.666.5900	
KEY PLAN	
NOTE: ALL IDEAS, DESIGNS, ARRANGEMEN REPRESENTED BY THIS DRAWING ARE OW KAEYER, GARMENT, & DAVIDSON ARCHITE FOR USE ON THIS PROJECT. NONE OF SUC OR PLANS SHALL BE USED BY OR DISCLOS WITHOUT THE WRITTEN PERMISSION OF (K WRITTEN DIMENSIONS ON THIS DRAWING S SCALED DIMENSIONS. CONTRACTOR SHAL AND CONDITIONS ON THE JOB AND THE AR VARIATIONS FROM DIMENSIONS AND CONE BE SUBMITTED TO THIS OFFICE FOR APPRO FABRICATION. ALTERATIONS BY ANY PERSON, IN ANY WA DOCUMENT, UNLESS ACTING UNDER THE D ARCHITECT WHOSE PROFESSIONAL SEAL I OF TITLE VII, SECT. 69.5 (b) OF NEW YORK S COPYRIGHT KAEYER, GARMENT + DAVIDSC	NED BY AND ARE THE PROPERTY OF CTS, PC (KG&D), AND WERE CREATED H IDEAS, DESIGNS, ARRANGEMENTS ED TO ANY PURPOSE WHATSOEVER (G&D). SHALL HAVE PRECEDENCE OVER L VERIFY ALL ACTUAL DIMENSIONS CHITECT MUST BE NOTIFIED OF ANY DITIONS SHOWN. SHOP DETAILS MUST DVAL BEFORE PROCEEDING WITH Y, OF ANY ITEM CONTAINED ON THIS DIRECTION OF THE LICENCED S AFFIXED HERETO, IS A VIOLATION STATE LAW.
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Job No. 2021-1048	Date 09/10/2021
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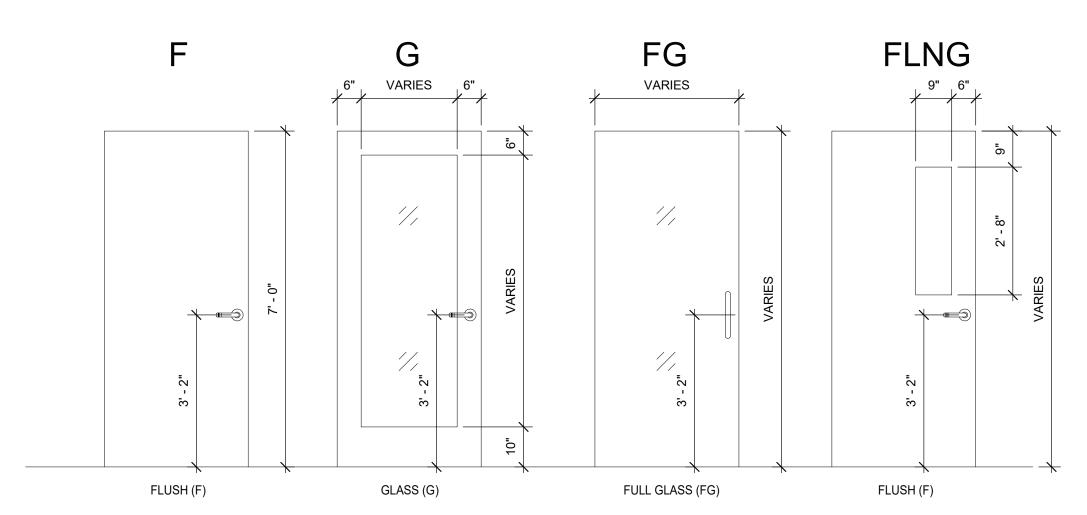
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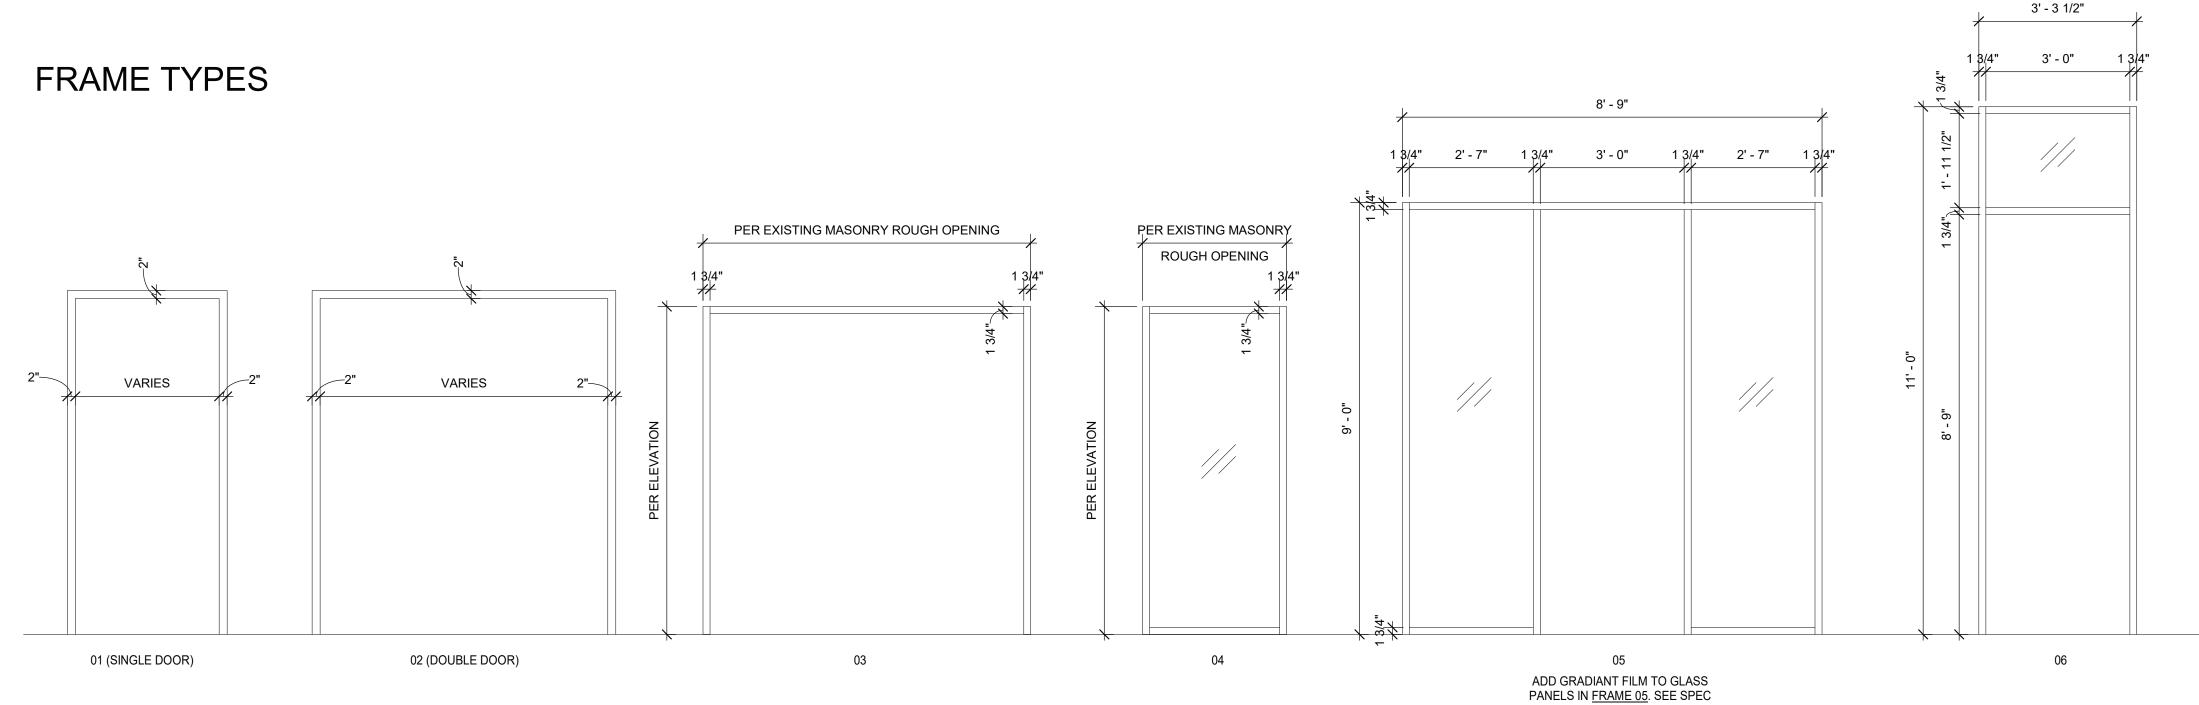
CORRIDOR

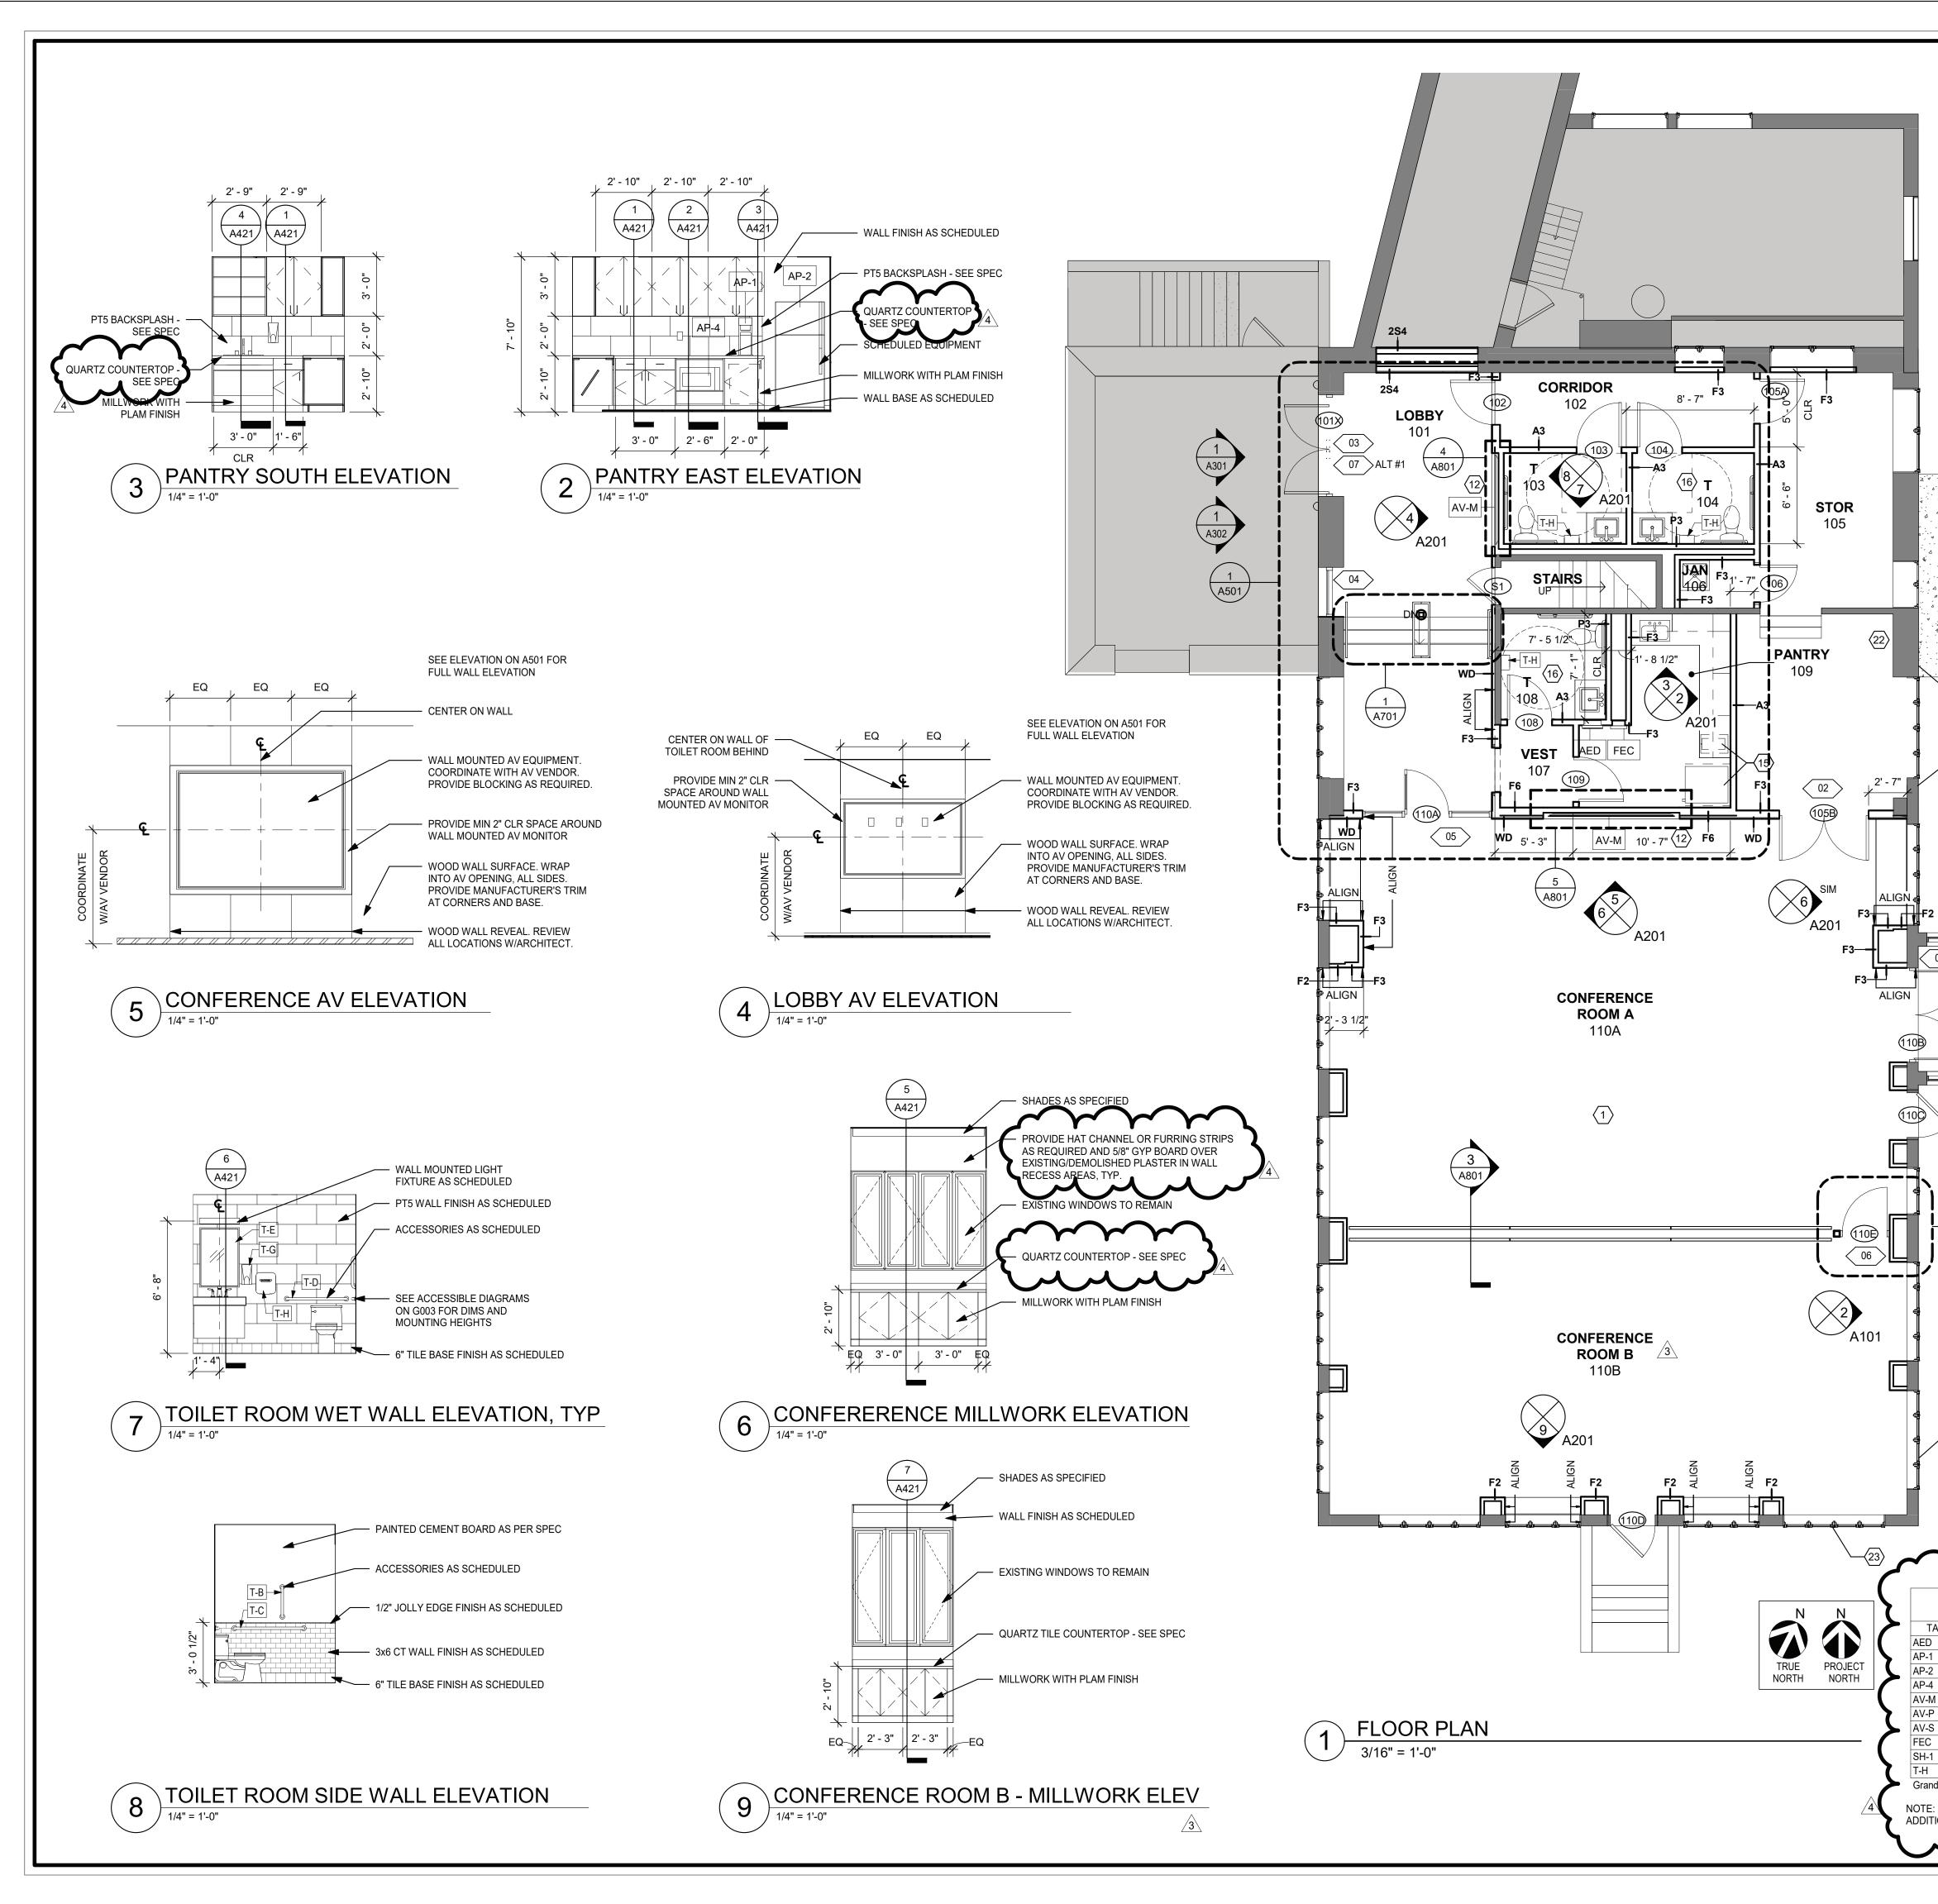
TAG QTY

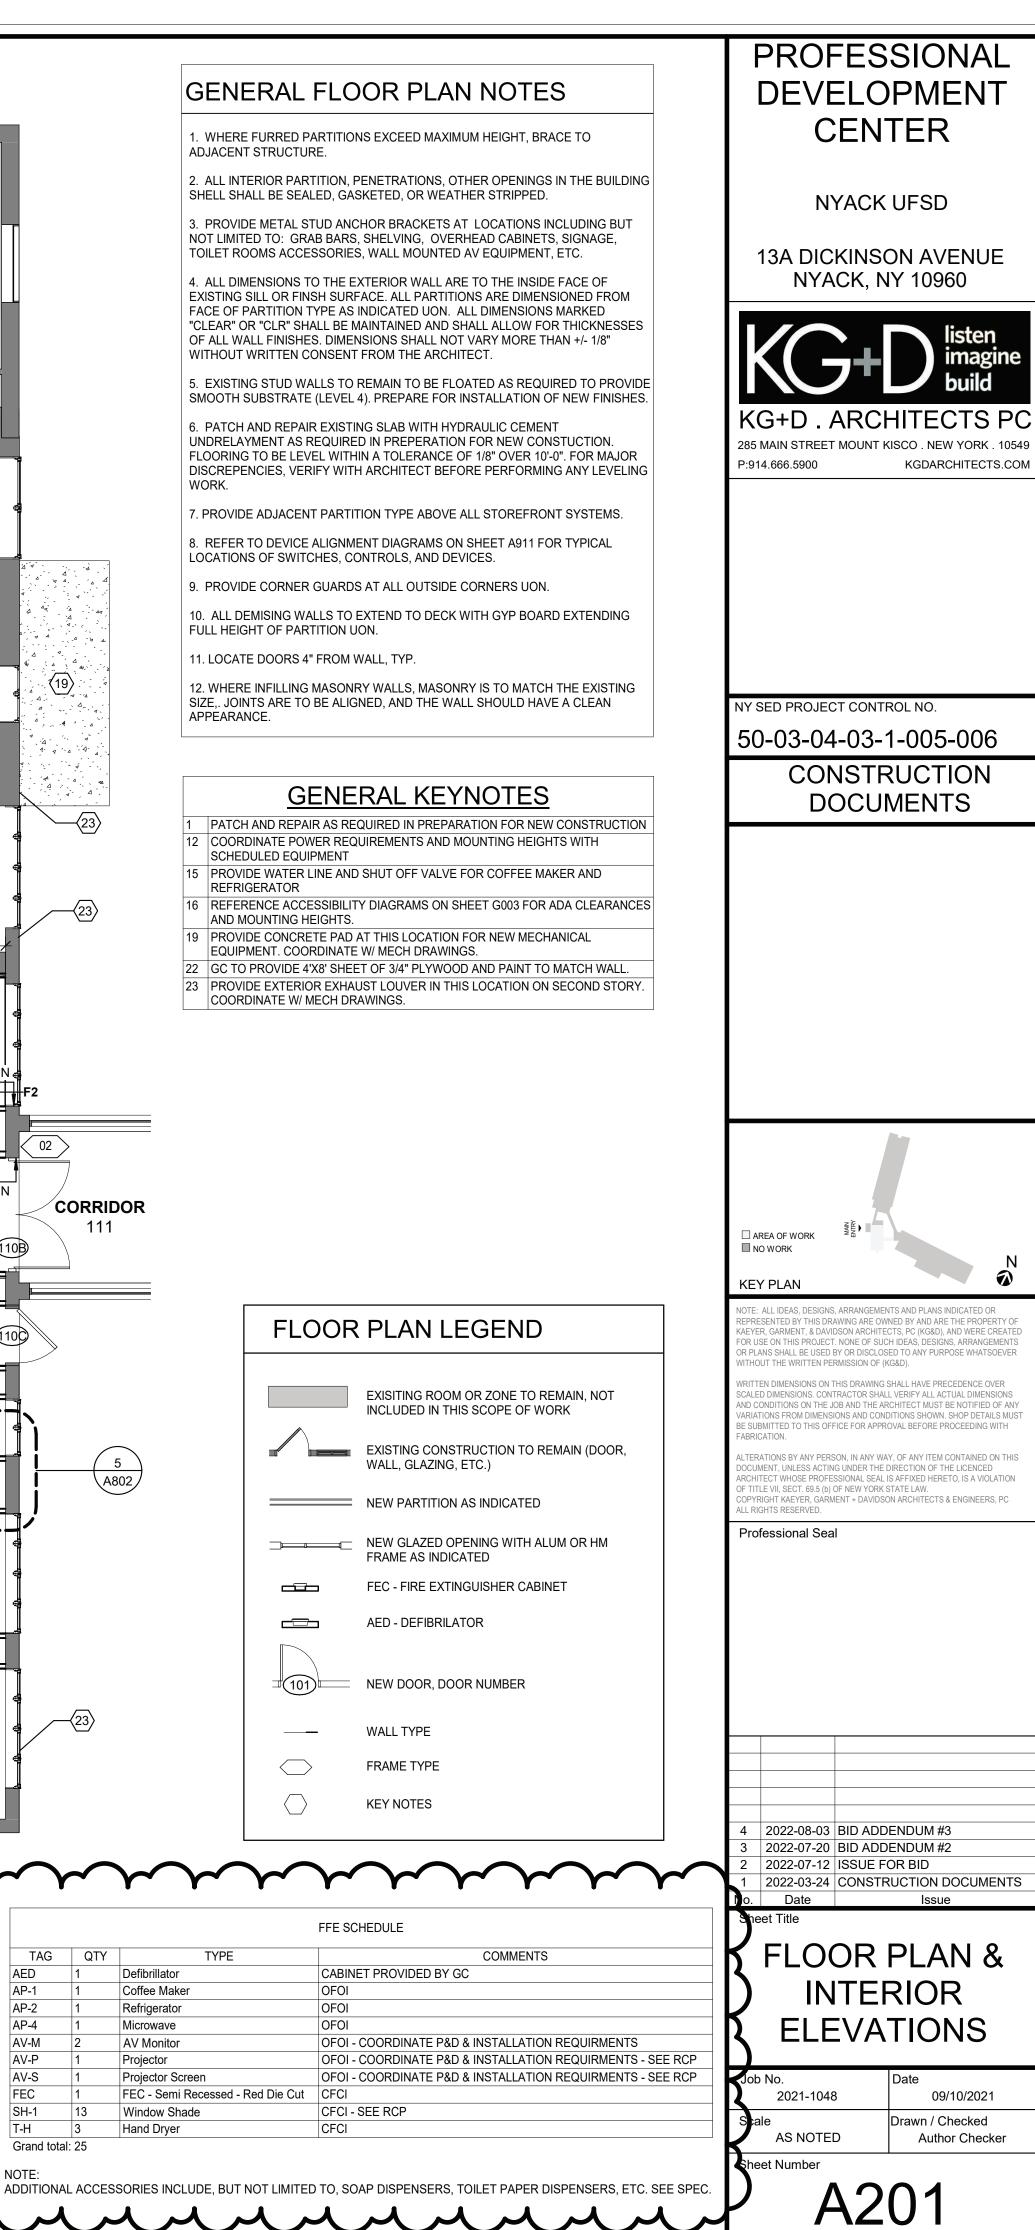Door Schedule																
Level	Mark	From Room	From #	To Room	# LEA VES		НТ	ELEV	Door Mat	Door Fin	Frame Mat	Frame Fin	Fire Label	Saddle	HDWE SET	Comments
1ST FLOOR ENTRY	101X	LOBBY	101		2	3' - 3'	' 6' - 8"	G								DOOR IS PART OF ALTERNATE #1
IST FLOOR ENTRY	102	LOBBY	101	CORRIDOR	1	3' - 0'	' 7' - 0"	F	WD	WD	HM	Р			6.0	DOOR TO BE INTEGRAL TO WOOD FEATURE WALL
IST FLOOR ENTRY	103	CORRIDOR	102	Т	1	3' - 0'	' 7' - 0"	F	WD	WD	HM	Р		SL	5.0	
1ST FLOOR ENTRY	104	CORRIDOR	102	Т	1	3' - 0'	' 7' - 0"	F	WD	WD	HM	Р		SL	5.0	
1ST FLOOR ENTRY	105A	CORRIDOR	102	STOR	1	3' - 0'	' 7' - 0"	F	HM	PTD	HM	Р			4.0	
1ST FLOOR ENTRY	106	STOR	105	JAN	1	2' - 6'	' 7' - 0"	F	HM	PTD	HM	Р			4.0	
IST FLOOR ENTRY	S1	LOBBY	101	STAIRS	1	2' - 6'	' 7' - 0"	F	WD	WD	HM	Р			7.0	DOOR TO BE INTEGRAL TO WOOD FEATURE WALL
IST FLOOR	105B	CONFERENCE ROOM A	110A	STOR	2	3'-0	" 7' - 0"	F	WD	WD	HM	Р			3.0	DOOR TO BE INTEGRAL TO WOOD FEATURE WALL
1ST FLOOR	108	VEST	107	Т	1	3' - 0'	' 7' - 0"	F	HM	PTD	HM	Р		SL	5.0	
1ST FLOOR	109	VEST	107	PANTRY	1	3' - 0'	' 7' - 0"	F	HM	PTD	HM	Р			6.0	
IST FLOOR	110A	CONFERENCE ROOM A	110A	LOBBY	1	3' - 0'	' 8' - 10	' G	AL	FF	AL	FF			2.0	ADD GRADIANT FILM TO GLASS PANEL. SEE SPEC
1ST FLOOR	110B	CONFERENCE ROOM A	110A	CORRIDOR	2	3' - 0'	' 7' - 0"	FLNG	HM	PTD	HM	Р	90 MIN		1.0	
IST FLOOR	110C	CONFERENCE ROOM A	110A		1	3' - 0'	' 7' - 0"	ETR	ETR	PTD	ETR	Р			8.0	PAINT EXISTING DOOR AND FRAME. ADD FROSTED FILM TO TRANSOM GLASS.
IST FLOOR	110D	CONFERENCE ROOM B	110B		1	3' - 0'	' 7' - 0"	ETR	ETR	PTD	ETR	P			8.0	PAINT EXISTING DOOR AND FRAME. REPLACE SOLID TRANSOM PANEL WITH GLASS AND FROSTED FILM.
1ST FLOOR	110E	CONFERENCE ROOM B	110B	CONFERENCE ROOM A	1	3' - 0'	' 8' - 9"	FG	GL-1	GL-1	AL	FF			9.0	

DOOR TYPES





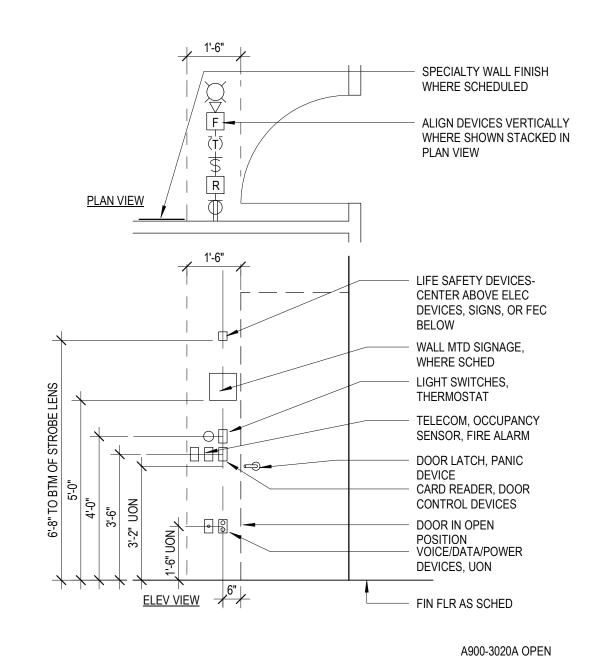



### **GLASS NOTES:**

PLAN VIEW

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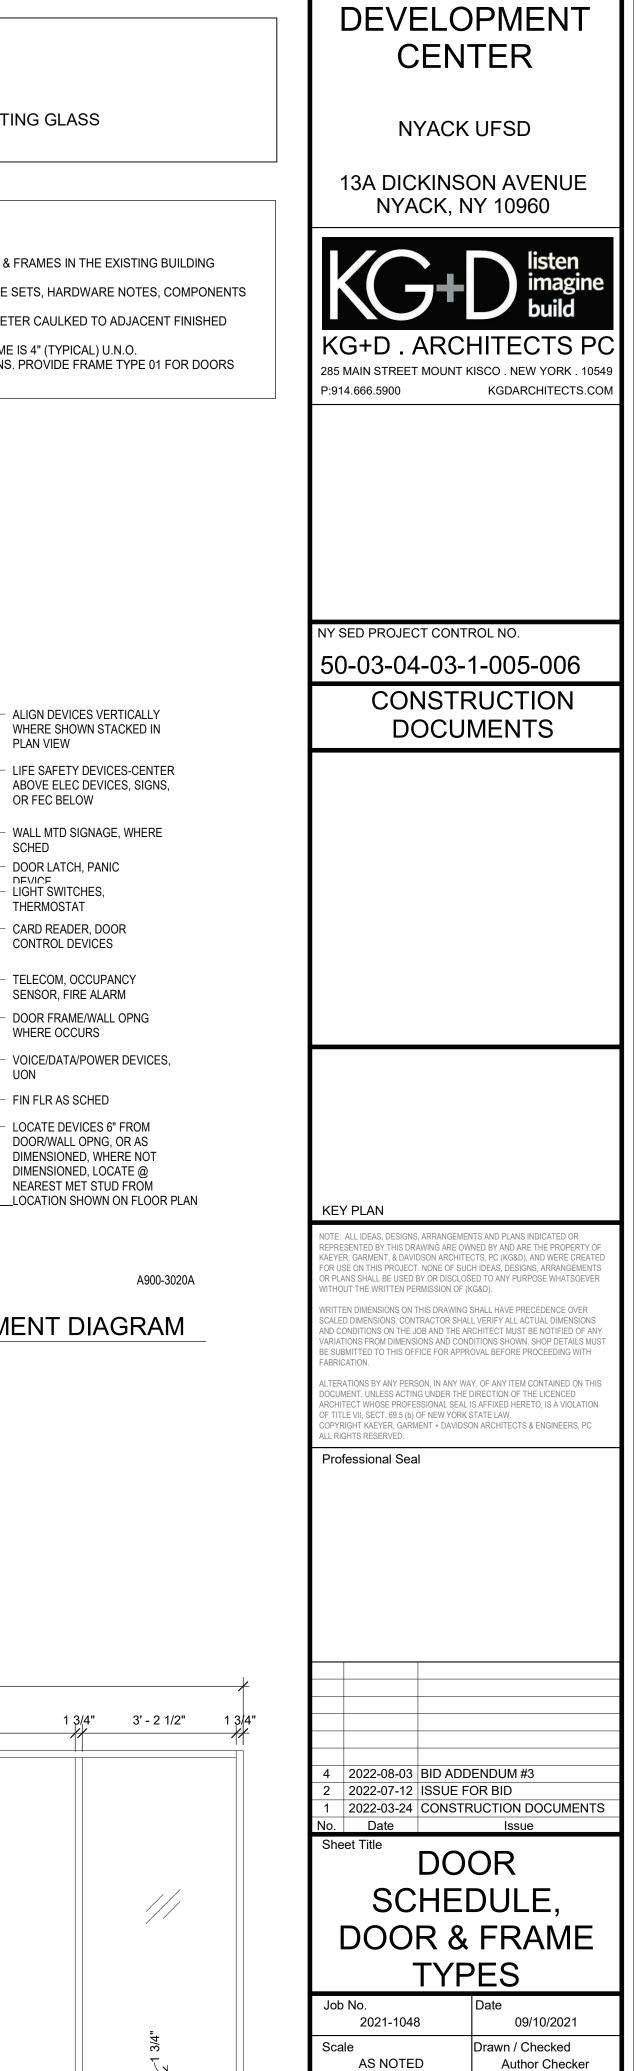
GL-1 = 1/4" TEMPERED

GL-2 = LOW-E COATED, CLEAR INSULATING GLASS

### **GENERAL NOTES**

- G.C. SHALL VERIFY SIZE OF REPLACEMENT DOORS & FRAMES IN THE EXISTING BUILDING 1.
- BEFORE ORDERING. SEE SPEC. SECTION 08 71 00 FOR DOOR HARDWARE SETS, HARDWARE NOTES, COMPONENTS 2. & OTHER INFORMATION.
- EXTERIOR DOOR SYSTEMS SHALL BE FULLY PERIMETER CAULKED TO ADJACENT FINISHED SURFACES, BOTH INTERIOR & EXTERIOR TYP.
- FACE OF ADJACENT WALL TO EDGE OF DOOR FRAME IS 4" (TYPICAL) U.N.O. SEE A201 FLOOR PLAN FOR FRAME TYPE LOCATIONS. PROVIDE FRAME TYPE 01 FOR DOORS 5. SEE A201 FLOOR PLAN FOR THAT ARE UNLABELED.

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Sheet Number

A911

PROFESSIONAL

