



Principals:

Mark D. Fellenzer, P.E., LEED AP John D. Fellenzer, P.E., MBA, LEED Green Associate Founder: Archie D. Fellenzer, Jr., P.E. (1924 - 2014)

PRE-BID ADDENDUM NO. # 1

The information contained herein, revises, supplements, and/or supersedes the specific parts of the documents referred to and shall be attached to and become part of such documents as if originally forming a part thereof. Except as herein modified, all other provisions of the documents shall remain in full force as originally set forth.

ISSUED TO: ALL BIDDERS

PROJECT: Orange County Community College

Physical Education Center HVAC Roof Top Unit #7-12 Replacement

OCCC Project No. ITB-OCCC-2023-19

F.E. Project No. 22-059

DATE: October 26, 2022

ISSUED BY: Eric D. Fellenzer, P.E.

PAGES: 2

ATTACHMENT:

1. Sketches SKHE-100.1, SKHED-104.1, SKHED-104.2, SKHE-102.1, SKHE-103.1, SKHE-104.1, SKHE-104.2, SKHE-104.3, SKHE-701.1, SKHE-701.2 and SKHE-702.1.

RFI Items: NONE

Additional Amendment to Drawings and Specifications:


- 1. See attached sketches SKHE-100.1, SKHED-104.1, SKHED-104.2, SKHE-102.1, SKHE-103.1, SKHE-104.1, SKHE-104.2, SKHE-104.3, SKHE-701.1, SKHE-701.2 and SKHE-702.1.
- 2. RT-7, 8 and 9 have been removed from the project's scope of work. The revisions are shown on sketches SKHE-100.1, SKHED-104.1, SKHED-104.2, SKHE-104.1 and SKHE-104.2.
- 3. Installation of new conduit and wire feeding RT-7 was removed. See sketches SKHE-102.1 and SKHE-103.1.
- 4. Details on drawings HE-701 have been revised to reflect the omission of RT-7, 8 and 9 from project scope. See sketches SKHE-701.1 and SKHE-701.2

PRE-BID ADDENDUM #1 –	OCCC - Physical Ed	ucation Center HVAC	C RTU Replacement (ITI	}-
OCCC-2023-19)	•		<u>-</u>	

5.	Roof Top Unit Schedule and PP-HVAC panel schedule on sketch SKHE-702.1 have both been
	revised to reflect the omission of RT-7, 8 and 9 from project scope.

Please sign and date this addendum E-mail back to jdd@fellp.com and CC edf@fellp.com and com and include it with the bid submission.

Company Name:	Joe Lombardo Plumbing & Heating of Rockland Inc	
Address:	321 Spook Rock Road Suite 109A Suffern, New York 1	0901
Company Officer:	Ronald J. Lombardo	
Date:	October 28, 2022	
	END OF ADDENDUM	

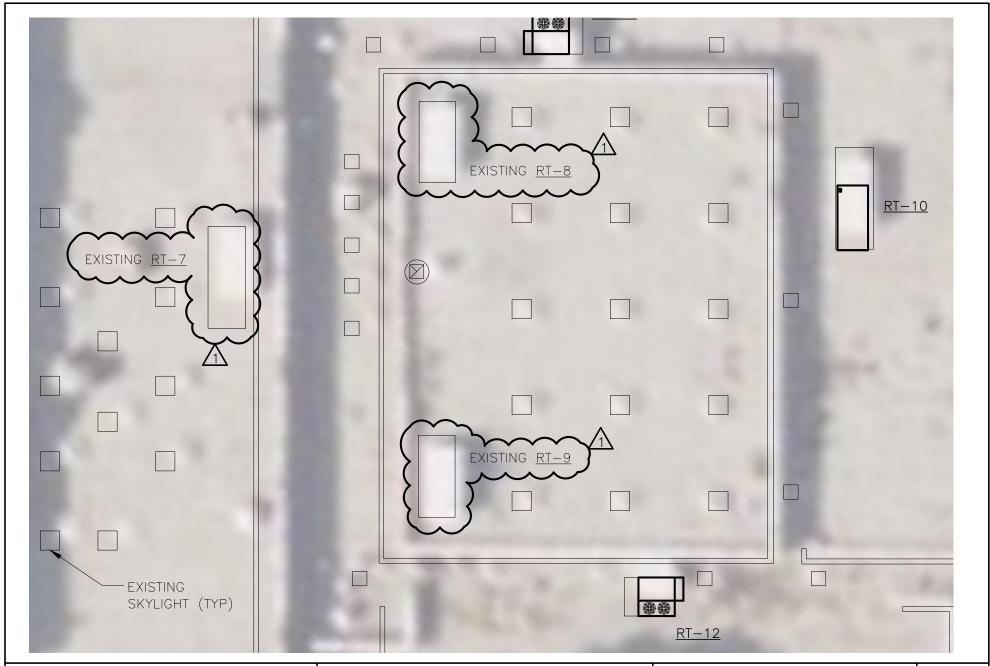

FELLENZER III ENGINEERING LLP

www.fellp.com

22 Mulberry St., Suite 2A, Middletown, NY 10940 t 845-343-1481 fx 855-320-8735

181 Church St., Suite 100, Poughkeepsie, NY 12601 t 845-454-9704; fx 855-320-8735

OCCC PE ROOFTOP PROJECT TITLE: **UNIT REPLACEMENT**

COUNTY JOB NO.: OCCC-2023-19

FE PROJECT No: 22-059 SCALE: REF. DWG.: . 1"=20'-0" HE-100 DESIGNED BY: DRAWN BY: CHECKED BY: JDD SRB EDF


GENERAL REVISION #1


REF. DWG. TITLE:
PARTIAL SITE PLAN

SKETCH No:

SKHE-100.1 ISSUE DATE:

10/26/22

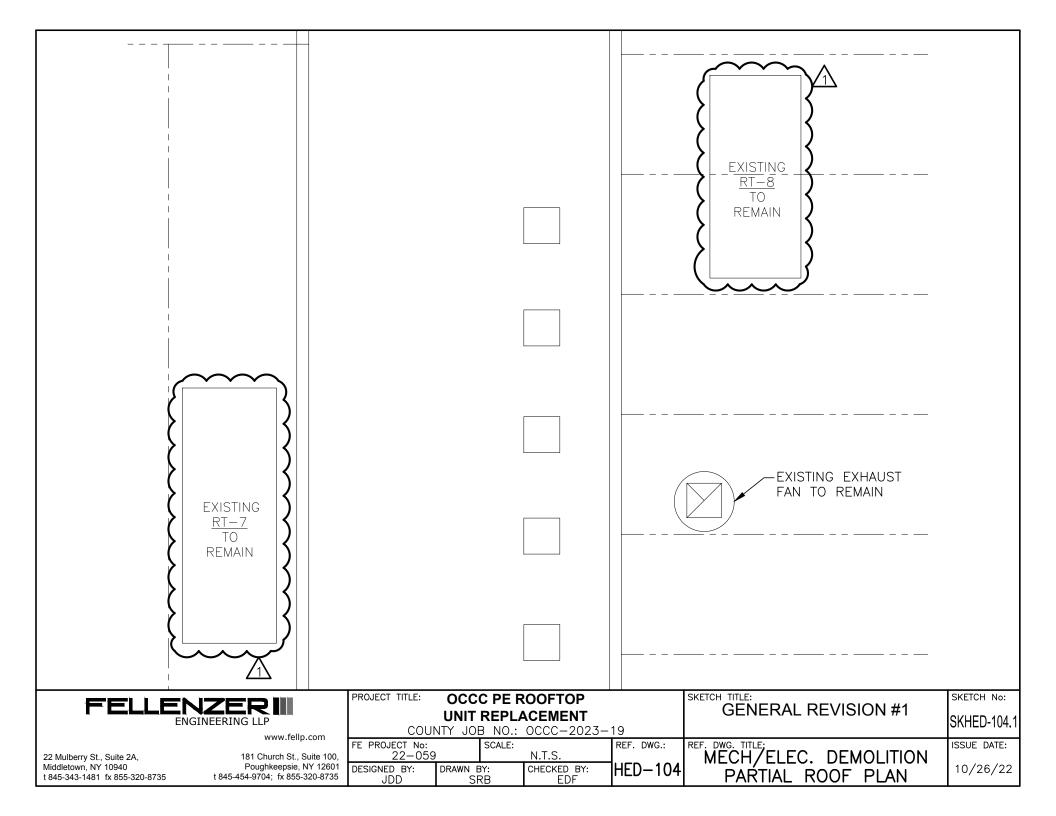

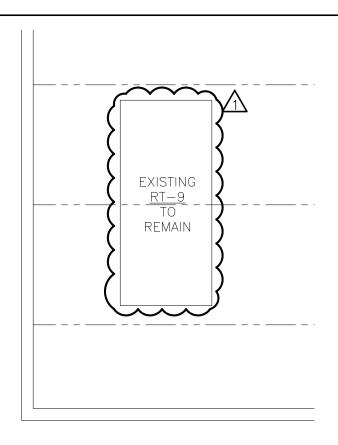

MECHANICAL DEMOLITION NOTES:


- 1. ALL LOCATIONS SHOWN ARE APPROXIMATE. IT IS THE RESPONSIBILITY OF THE HVAC CONTRACTOR TO VERIFY LOCATIONS OF UNITS, PIPING, AND DUCTWORK PRIOR TO ANY DEMOLITION WORK.
- 2. REMOVE ALL EQUIPMENT AS INDICATED ON PLAN. REMOVALS SHALL INCLUDE ALL SUPPORTS, DAMPERS, VALVES, FITTINGS, CONTROLS AND ALL ASSOCIATED LOW VOLTAGE WIRING, AND ANY OTHER ASSOCIATED ACCESSORIES WHICH PERTAIN TO THE EQUIPMENT TO BE REMOVED.
- REMOVAL OF ALL POWER CONNECTIONS TO DEMOLITION ITEMS SHALL BE BY THE HVAC CONTRACTOR.
- 4. ANY DISCREPANCIES BETWEEN DEMOLITION PLANS AND ACTUAL FIELD CONDITIONS SHALL BE BROUGHT TO THE ATTENTION OF THE ENGINEER. ANY DEMOLITION WORK WHICH MAY BE QUESTIONABLE DUE TO UNFORESEEN FIELD CONDITIONS SHALL NOT BE REMOVED UNTIL REVIEWED BY THE ENGINEER OR BUILDING FACILITIES MANAGER.
- 5. DEMOLITION WORK SHALL INCLUDE THE PREPARATION OF EXISTING EQUIPMENT FOR CONNECTION TO NEW EQUIPMENT. COORDINATE DEMOLITION WORK WITH THE CONSTRUCTION PLANS.
- 6. ALL EQUIPMENT REMOVALS SHALL BECOME THE PROPERTY OF THIS CONTRACTOR. THIS CONTRACTOR SHALL BE RESPONSIBLE FOR THE PROPER REMOVAL AND DISPOSAL OF DEMOLITION ITEMS OFF—SITE, UNLESS OTHERWISE NOTED.
- 7. ALL CUTTING AND PATCHING NECESSARY FOR DEMOLITION WORK SHALL BE THE RESPONSIBILITY OF THE HVAC CONTRACTOR.
- 8. THE SCOPE OF THIS PROJECT INCLUDES THE REPLACEMENT OF (RT-10) THROUGH RT-12.
- 9. THE PLANS ARE INTENDED TO CONVEY THE EXTENT AND SCOPE OF THE DEMOLITION WORK. EVERY ITEM INTENDED FOR REMOVAL MAY NOT BE SHOWN. THE CONTRACTOR IS ADVISED TO ATTEND THE OWNER'S SPECIFIED WALK-THROUGH OF THE PROJECT SITE BEFORE SUBMITTING A BID FOR DEMOLITION WORK.
- 10. IT IS THE RESPONSIBILITY OF THE HVAC CONTRACTOR FOR THE DRAINING, FILLING & CHEMICAL WATER TREATMENT PER BOILER MANUFACTURER'S REQUIREMENTS.





www.fellp.com


22 Mulberry St., Suite 2A, Middletown, NY 10940 t 845-343-1481 fx 855-320-8735 181 Church St., Suite 100, Poughkeepsie, NY 12601 t 845-454-9704; fx 855-320-8735

ı	PROJECT TITLE:	occ	C PE R	COOFTOP		GENERAL REVISION #1	SKETCH No:
	COUN	_		ACEMENT OCCC-2023-	19	GENERAL REVISION #1	SKHED-104.2
ſ	FE PROJECT No:		SCALE:		REF. DWG.:		ISSUE DATE:
ļ	22-059			N.T.S.	4	MECH/ELEC. DEMOLITION	l
١	DESIGNED BY: JDD	DRAWN E	BY: RB	CHECKED BY: EDF	HED-104	PARTIAL ROOF PLAN	10/26/22

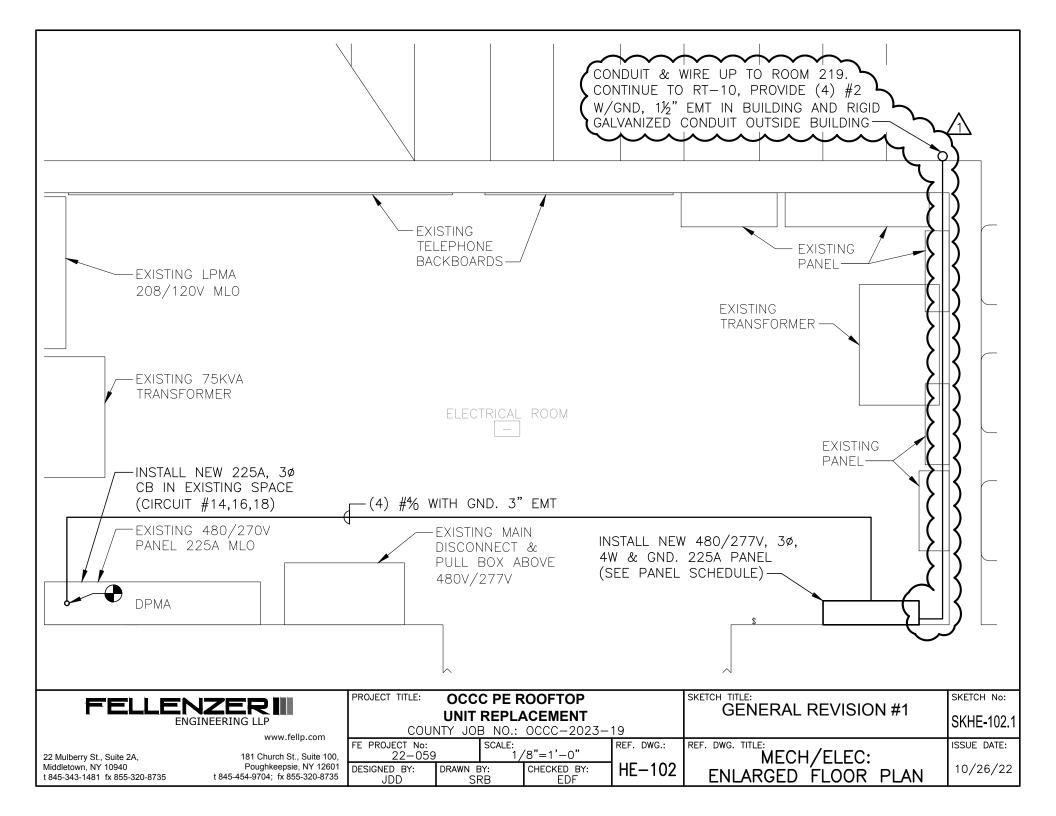

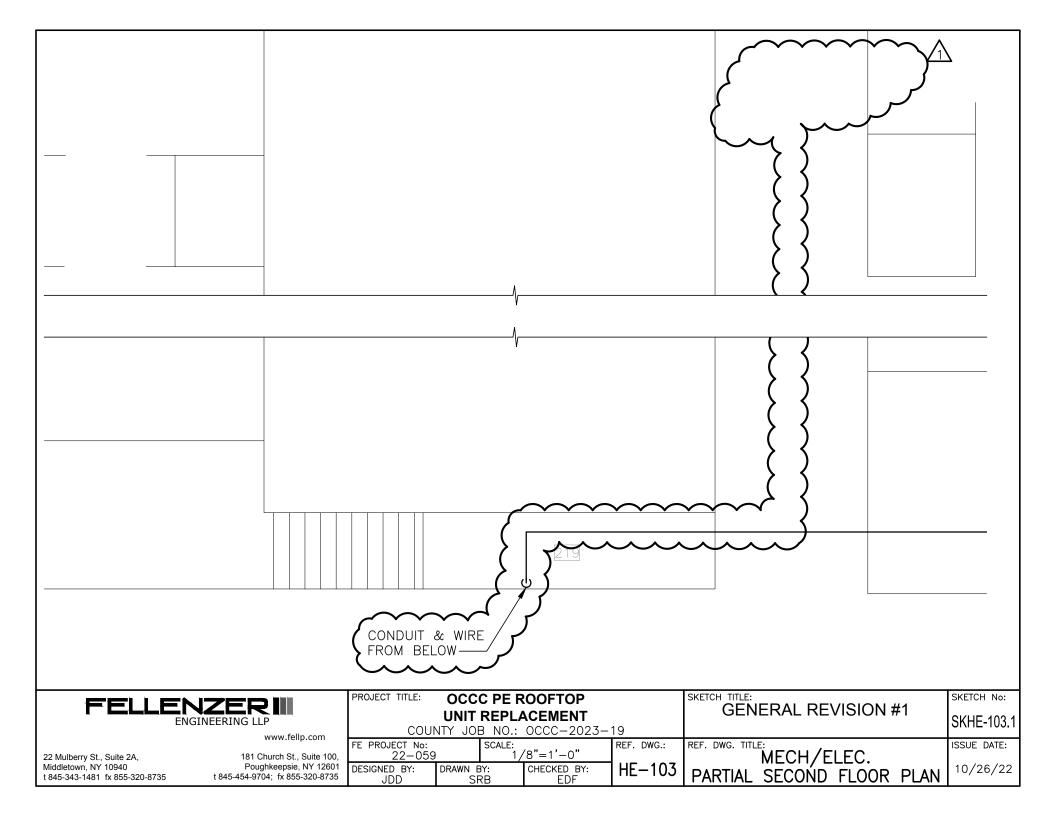

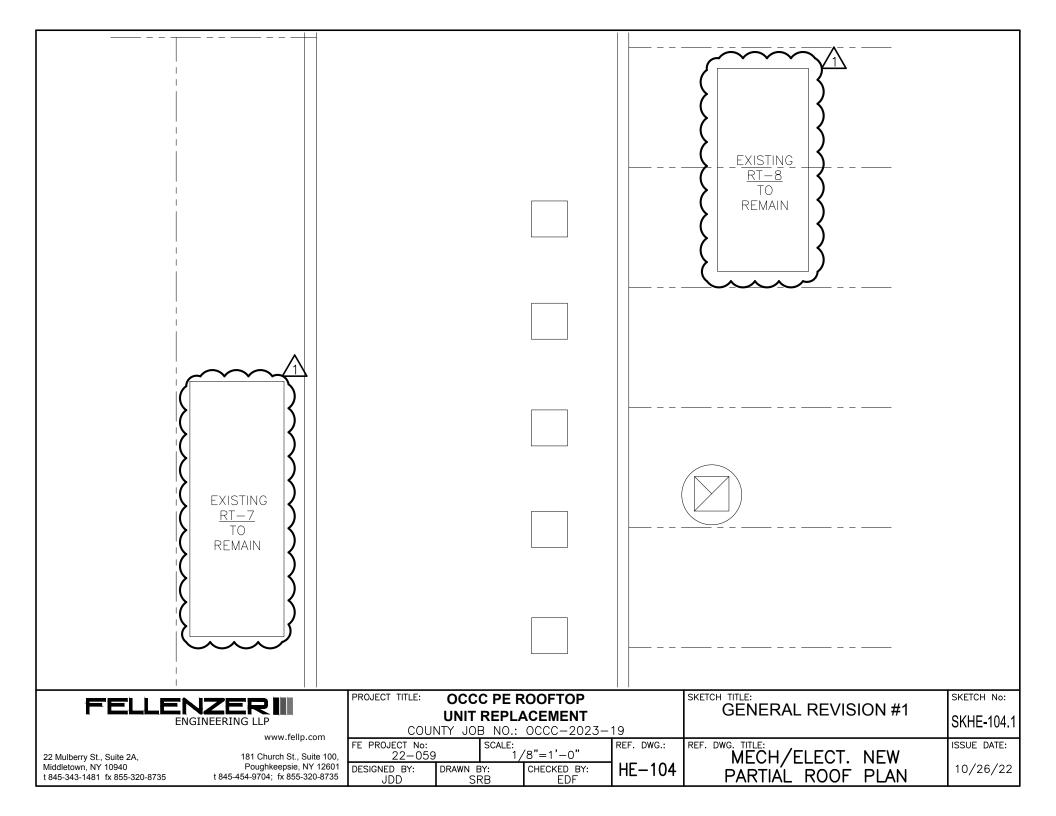

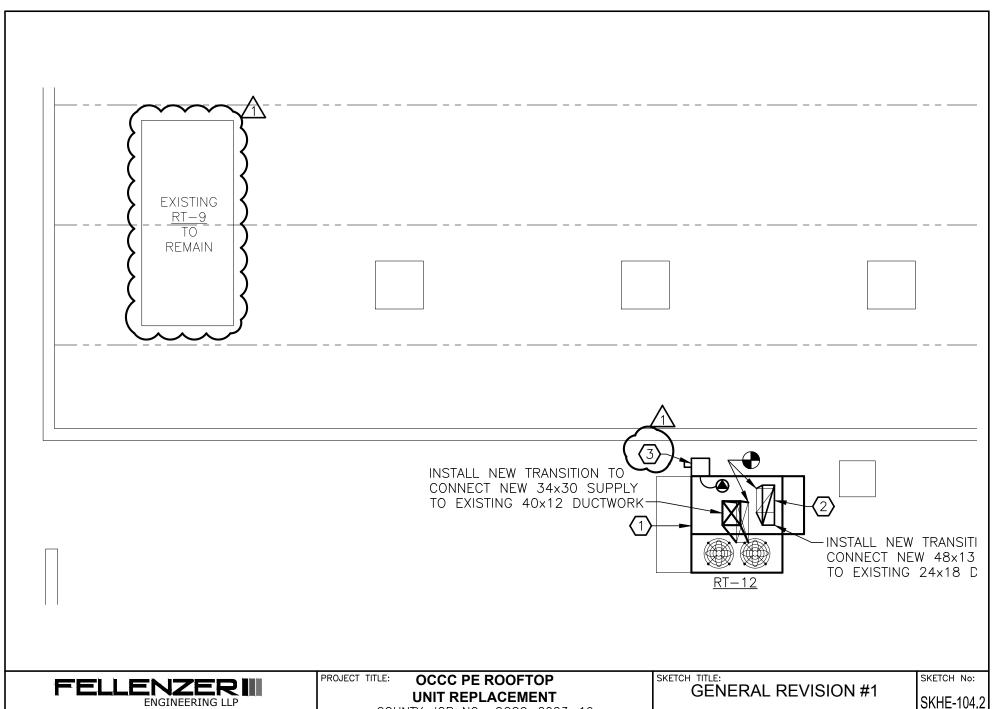


www.fellp.com

22 Mulberry St., Suite 2A, Middletown, NY 10940 t 845-343-1481 fx 855-320-8735

181 Church St., Suite 100, Poughkeepsie, NY 12601 t 845-454-9704; fx 855-320-8735

	PROJECT TITLE:	UNIT REPLA	ACEMENT		GENERAL REVISION #7	SKHE-104.2
			OCCC-2023-			
	FE PROJECT No: 22-059	SCALE:	/8"=1'-0"	REF. DWG.:	REF. DWG. TITLE:	ISSUE DATE:
i		DRAWN BY:	CHECKED BY:	HE-104	MECH/ELECT. NEW	10/26/22
,	JDD	SRB	EDF		PARTIAL ROOF PLAN	10/20/22

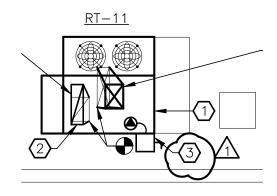

KEYED NOTES:

- INSTALL NEW ROOFTOP UNIT ON EXISTING ROOF CURB USING CUSTOM INSULATED TRANSITION CURBING. MAKE ALL NECESSARY CONNECTIONS TO GLYCOL SUPPLY AND RETURN PIPING, RELOCATE ALL PIPING AS NECESSARY, CONTRACTOR TO SUBMIT SHOP DRAWINGS OF TRANSITION CURBING TO ENGINEER FOR APPROVAL.
- DUCT SMOKE DETECTORS SHALL BE FURNISHED AND INSTALLED BY THE COLLEGE'S FIRE ALARM CONTRACTOR. DUCT SMOKE DETECTORS SHALL BE INSTALLED IN COMMON SECTION OF SUPPLY AND RETURN AIR DUCT DIRECTLY BELOW ROOFTOP UNIT AND CONNECTED TO THE EXISTING FIRE ALARM SYSTEM. CONNECT ROOFTOP UNIT TO EXISTING FIRE ALARM SYSTEM FOR FAN SHUTDOWN.

DISCONNECT EXISTING POWER FEEDER. EXTEND WIRE AND CONDUIT FROM EXISTING DISCONNECTION POINT TO NEW NON-FUSED DISCONNECT SWITCH. PROVIDE WIRE AND CONDUIT FOR CONNECTION FROM DISCONNECT SWITCH TO NEW RTU'S.

INSTALLATION NOTES:

- 1. ALL LOCATIONS SHOWN ARE APPROXIMATE. VERIFY LOCATIONS OF ROOFTOP UNITS, PIPING, AND DUCTWORK IN FIELD.
- INSTALL NEW ROOFTOP UNITS AT LOCATIONS SHOWN ON PLANS. RECONNECT TO EXISTING PIPING AND DUCTWORK.
- CONNECT NEW ROOFTOP UNITS TO EXISTING ELECTRICAL WIRING. EXTEND CABLE AND USE JUNCTION BOXES AS NECESSARY TO MAKE THE CONNECTION.
- 4. ALL UNITS SHALL BE SUPPLIED WITH A FACTORY INSTALLED DISCONNECT SWITCH, CONVENIENCE RECEPTACLE AND LIGHT.
- 5. REPORT ANY DEFECTS IN EXISTING DUCTWORK, POWER WIRING, AND HYDRONIC PIPING TO SUNY ORANGE REPRESENTATIVES.
- 6. EXISTING CURBING MAY BE REUSED IF NEW UNIT FITS THE EXISTING CURB. CONTRACTOR TO PROVIDE SHOP DRAWINGS TO ENGINEER FOR APPROVAL.
- 7. THE SCOPE OF THIS PROJECT INCLUDES THE REPLACEMENT OF (RT-10)THROUGH RT-12.




22 Mulberry St., Suite 2A.


Middletown, NY 10940

www.fellp.com

181 Church St., Suite 100, Poughkeepsie, NY 12601 t 845-454-9704; fx 855-320-8735 t 845-343-1481 fx 855-320-8735

	22-059 1/8"=1'-0"				GENERAL REVISION #	SKHE-104.3
),					REF. DWG. TITLE: MECH/ELECT. NEW	ISSUE DATE:
1 5	DESIGNED BY: JDD	DRAWN BY: SRB	CHECKED BY: EDF	HE-104	PARTIAL ROOF PLAN	10/26/22

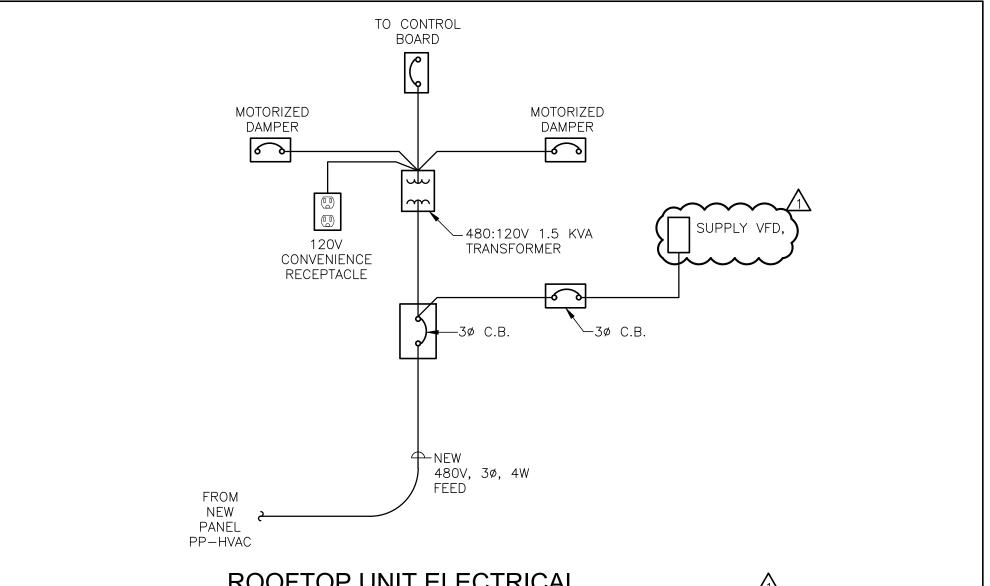

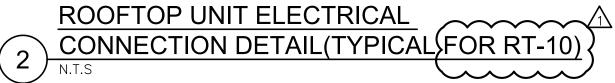

ENGINEERING LLP

www.fellp.

22 Mulberry St., Suite 2A, 181 Church St., St Middletown, NY 10940 Poughkeepsie, N t 845-343-1481 fx 855-320-8735 t 845-454-9704; fx 855-32

.com	
COIII	FE PROJECT
uite 100,	22-
IY 12601	DESIGNED BY
20-8735	ממו. ו

PROJECT TITLE:

	_									
UNIT REPLACEMENT										
COU	NTY JOE	3 NO.:	OCCC-2023-	19						
E PROJECT No:		SCALE:		REF. DWG.:						
22-059			N.T.S.	1						
DESIGNED BY: JDD	DRAWN E	RY: RB	CHECKED BY: EDF	HE-70						

OCCC PE ROOFTOP

SKETCH TITLE:
GENERAL REVISION #1

SKHE-701.1

SKETCH No:

REF. DWG. TITLE: MECH/ELEC. **DETAILS**

ISSUE DATE:

10/26/22

NOTES:

- 1. REPLACE EXISTING ROOF TOP UNITS ((3 TOTAL))AT LOCATIONS SHOWN ON PLANS
- 2. REPLACE ALL EXISTING ROOF CURBS FOR ALL (3) UNITS. MODIFY EXISTING ROOF ROOF MEMBRANE AND SUB-ROOFING IN ACCORDANCE WITH ROOFING MANUFACTURERS REQUIREMENTS AND IN COMPLIANCE WITH EXISTING WARRANTY. SUBMIT SHOP DRAWINGS.
- 3. LOCATIONS OF EXISTING DUCTWORK, PIPING AND ROOFTOP UNIT LOCATIONS ARE APPROXIMATE, VERIFY EXACT LOCATION IN FIELD.
- 4. REMOVE ALL EXISTING EQUIPMENT TO AN OFFSITE LOCATION AND DISPOSE OF IN A MANNER ACCEPTABLE TO LOCAL, COUNTY, STATE AND FEDERAL REGULATIONS.
- ALL UNITS SHALL BE SUPPLIED WITH A FACTORY INSTALL DISCONNECT SWITCH, CONVENIENCE RECEPTACLE AND LIGHT.
- 6. DISCONNECTION AND RECONNECTION OF ENERGY MANAGEMENT SYSTEM FOR ALL ROOFTOP UNITS MUST BE CLOSELY COORDINATED WITH EUA-DAY CONTROLS AT (914-227-8120) CONTACT EUA-DAY 3 WORKING DAYS BEFORE REMOVAL OF EACH ROOFTOP UNIT. THIS SHOULD BE AT NO COST TO THE BIDDING HVAC CONTRACTOR.

FELLENZER III	
ENGINEERING LLP	

22 Mulberry St., Suite 2A.

t 845-343-1481 fx 855-320-8735

Middletown, NY 10940

www.fellp.com

181 Church St., Suite 100, Poughkeepsie, NY 12601 t 845-454-9704; fx 855-320-8735

	PROJECT TITLE:	UNIT	REPL/	ROOFTOP ACEMENT OCCC-2023-	19	GENERAL REVISION #1	SKHE-701.2
	FE PROJECT No:		SCALE:		REF. DWG.:	REF. DWG. TITLE:	ISSUE DATE:
0,	22-059			N.T.S.		MECH/ELEC.	
)1 5	DESIGNED BY:	DRAWN E	3Y:	CHECKED BY:	HE-701	DETAILS	10/26/22

ROOFTOP UNIT SCHEDULE HEATING COIL DATA (40% E.G. SOL.) UNIT MANUFACTURER MAX. WEIGHT CFM E.S.P. COOLING COIL DATA ACCESSORIE MODEL NUMBER AREA SERVED TYPE (OR APPROVED EQUAL) NUMBER (LBS) (S.A.) (S.A.) TOTAL (MBH) SENS. (MBH) TYPE IEER FLUID ENT/LVG MBH GPM FILTER RT-10 DAIKIN DPS020A 3786 HEATING & COOLING 257.742 140.8 °F 40 2" DISP. HANDBALL COURTS 9,000 0.5 218.77 4 ROW 20.4 180°F 713.1 DAIKIN DPS010A 2218 HEATING & COOLING RT-11 CLASSROOMS & NURSE 3,200 0.5 120 86.7 2 ROW 19.3 180°F 142°F 187 11 2" DISP. RT-12 DAIKIN DPS010A 2218 ADMIN. AREA HEATING & COOLING 3,200 0.5 120 86.7 2 ROW 19.3 180°F 142°F 187 11 2" DISP.

	ROOFTOP UNIT SCHEDULE (CONT'D)												
UNIT ELECTRICAL CONNECTION								SUPPLY FAN		N FAN	COND. FAN MOTORS	COMPRESSOR MTRS	REMARKS
NUMBER	VOLTS/HZ/PHASE	EXISTING FUSE DISCONNECT	FLA (AMPS)	MCA (AMPS)	MROPD (AMPS)		RA/LRA	HP	RA/LRA	HP	RATED AMPS	RATED AMPS	REMARKS
RT-10	460/60/3	70 A	57.2	64.7	90	-	N/A	10	N/A	(2) 4	(2) 2.6, 5.2 TOTAL	30.1	SEE NOTES 1, 2, 3, 4, 5, 6, 7 & 8
RT-11	460/60/3	30 A	20.5	22.5	30	-	4	4	2.3	2.3	(2) 0.9, 1.8 TOTAL	4.5/7.9	SEE NOTES 1, 2, 3, 4, 5, 6, 7 & 8
RT-12	460/60/3	30 A	20.5	22.5	30	-	4	4	2.3	2.3	(2) 0.9, 1.8 TOTAL	4.5/7.9	SEE NOTES 1, 2, 3, 4, 5, 6, 7 & 8

NOTES:

- 1. EXISTING CONDUIT AND CONDUCTORS MAY BE USED IF OF ADEQUATE SIZE AND IN GOOD CONDITION.
- 2. UNIT TO BE CONNECTED TO THE EXISTING BMS. ALL CONNECTIONS TO EXISTING BY DAY AUTOMATION.
- 3. PROVIDE UNIT WITH BACNET IP CARD.
- 4. PROVIDE UNIT WITH THE FOLLOWING FACTORY INSTALLED SENSORS: LEAVING COIL/ENTERING FAN TEMPERATURE SENSOR, DUCT HIGH LIMIT SWITCH, BACNET/IP CARD, RETURN AIR TEMPERATURE SENSOR, DISCHARGE AIR TEMPERATURE SENSOR, OUTSIDE AIR TEMPERATUR SENSOR, RETURN AIR ENTHALPY SENSOR, OUTSIDE AIR TEMPERATUR SENSOR.
- 5. PROVIDE UNIT WITH MOTORIZED DAMPERS AND VFD'S. CONTROL WIRING TO BE INSTALLED BY DAY AUTOMATION.
- 6. PROVIDE UNITT WITH FACTORY INSTALLED NON-FUSED DISCONNECT SWITCH.
- 7. PROVIDED UNIT WITH POWERED 115V GFI OUTLET.
- 8. PROVIDE UNIT WITH ENTHALPY ECONOMIZER.

LOAD	CONDUCTORS	C.B.	C.	B. CONDUCTORS	LOAD
SPARE		20	├ ॔ ┰╥┰ ┋ ┚	0 (4)#2 WITH GND.,1½" C	RTU-10
				+	
SPARE		20	Z↑ ↑ ↑ 2)	SPARE
			╚┸╫┸╩□		
<u> </u>	<u> </u>	1		+	<u>†</u>
SPARE 		20	15 / 16		SPACE
+	•	+			
SPACE		<u> </u>	<u>19</u>		
			21 22 22		
			25 26		
			27 28	+ + +	
- 	 	\rightarrow	29 / / 30	 	

POWER PANEL - (PP-HVAC)

TYPE: RATING: MAINS: BRACING:

SQUARE D 277/480V,3ø 4W MLO 22 KAIC

ENCLOSURE: NEMA 1 SURFACE MOUNT
POLES: 30

NOTES:

- 1. ALL WIRE SHALL BE DUAL RATED THHN/THWN COPPER CONDUCTOR UNLESS OTHERWISE NOTED.
- 2. ALL CIRCUITS SHALL HAVE FULL SIZE INSULATED GREEN GROUND UNLESS OTHERWISE NOTED.

FELLENZER III ENGINEERING LLP

22 Mulberry St., Suite 2A,

t 845-343-1481 fx 855-320-8735

Middletown, NY 10940

www.fellp.com

181 Church St., Suite 100, Poughkeepsie, NY 12601 t 845-454-9704; fx 855-320-8735

UNIT REPLACEMENT COUNTY JOB NO.: OCCC-2023-19				GENERAL REVISION #1	SKHE-702.1
FE PROJECT No: 22-059		CALE: N.T.S.		MFCH/FLFC.	ISSUE DATE:
DESIGNED BY: JDD	DRAWN BY: SRB		☐ HE-702	SCHEDULES	10/26/22