

2021 COVID RELATED CAPITAL PROJECTS

171 OSCAWANA LAKE ROAD, PUTNAM VALLEY, NY 10579

OWNER
Putnam Valley Central School District


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JUNE 24, 2022

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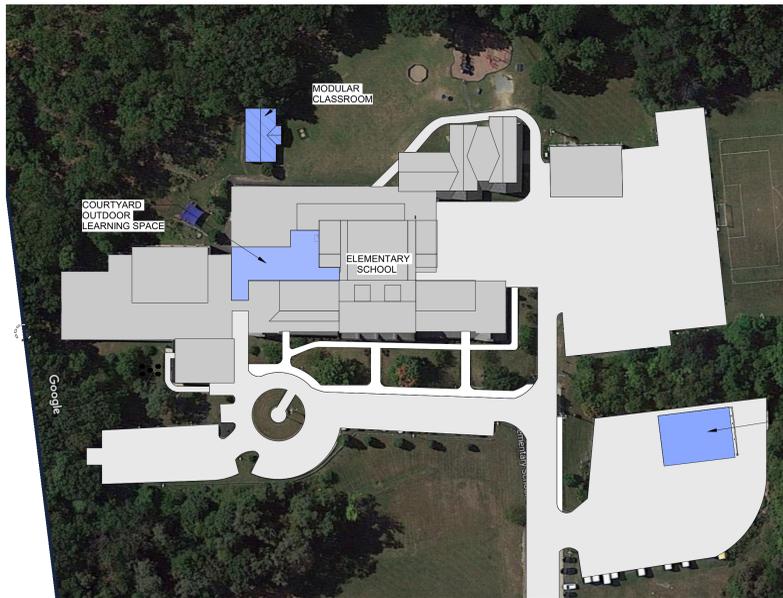
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KG+D Project No.
2021-1067

NY SED Project No.
E.S. 48-05-03-04-0-001-013
E.S. MODULAR 48-05-03-04-0-007-002
H.S. 48-05-03-04-0-010-006
TRANSP. FAC. 48-05-03-04-5-012-003



2 PUTNAM VALLEY HIGH SCHOOL - AREAS OF WORK
1" = 80'-0"

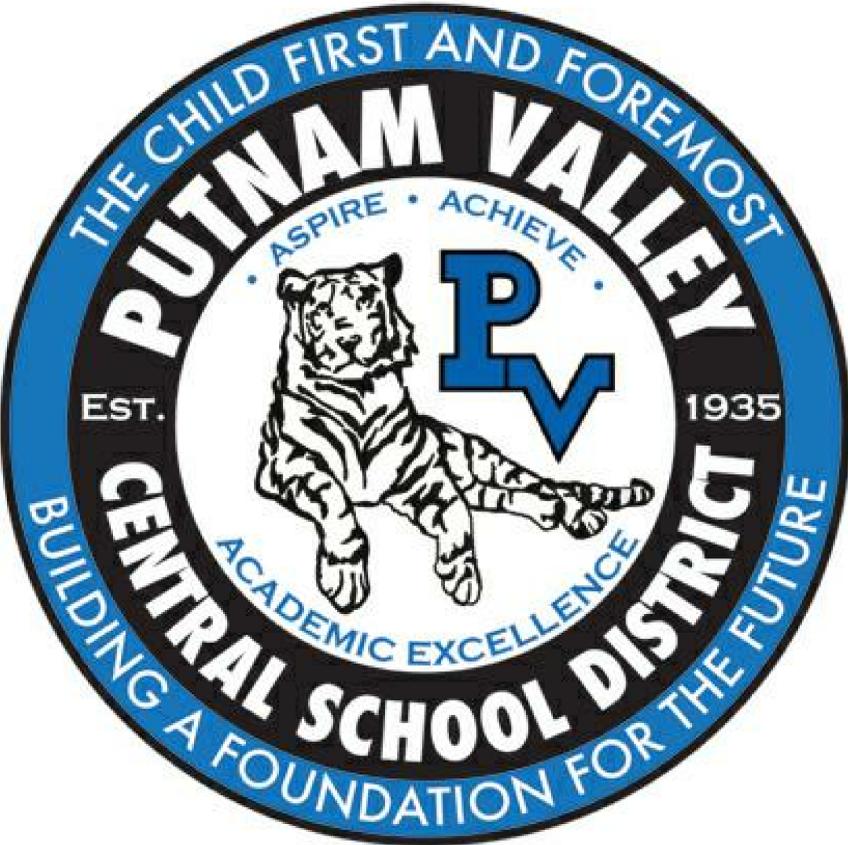

1 PUTNAM VALLEY ELEMENTARY SCHOOL - AREAS OF WORK
1" = 80'-0"

ABBREVIATIONS

AFF ABOVE FINISH FLOOR	FAB FABRIC	MAINT MAINTENANCE/MAINTENANCE	S SAFETY GLZING/SEE SPEC
ACM ASBESTOS CONTAINING MATERIAL	FTF FACE TO FACE	MAX MAXIMUM	SCHED SCHEDULE/SCHEDULED
ACPL ACOUSTIC PANEL	FIN FINISHED	MFG MANUFACTURER	SECT SECTION
ACT ACOUSTIC CEILING TILE	FA FIRE ALARM	MNSRY MASONRY	SFB SPLIT FACE BLOCK
ADJ ADJUSTABLE	FD FLOOR DRAIN	MO MASONRY OPENING	SHR SHELVING/SHELF/SHELVES
AC AIR CONDITIONING	FDMFR FIRE DAMPER	MATL MATERIAL	SIMLAR SIMILAR
AESS ARCHITECTURAL EXPOSED STRUCTURAL STEEL	FE FIRE EXTINGUISHER	MECH MECHANICAL	SIM SLATE
AHAP AS HIGH AS POSSIBLE	FEC FIRE EXTINGUISHER CABINET	METAL METAL	STC SOUND TRANSMISSION CLASS
ALUM ALUMINUM	MCP METAL COMPOSITE PANEL	MCP METAL CORNER BEAD	SPEC SPECIFICATION
AMP ACRYLIC MODIFIED POLYESTER APPROX APPROXIMATE	FHC FIRE HOSE CABINET	MS METAL STUD	SQFT SQUARE FOOT
	FHVFC FIRE HOSE VALVE CABINET	MS METAL STUD	SQ STAINLESS STEEL
	FR FIRE RATED	MLWK MILL WORK	STL STEEL
	FRD FRENCH DRAIN	MIN MINIMUM	STR STRUCTURAL/STRUCTURE
BEPO BROADCAST EPOXY	FFSC FIRE RATED ASSEMBLY (DOORS)	MISC MISCELLANEOUS	SUSP SUSPENDED/SUSPENSION
BTW BETWEEN	FRTD FIRE RETARDANT	MLDG MOUNTING	T TOP
BLKG BLOCKING	FLOR FLOOR	NIC NOT IN CONTRACT	TB TACKBOARD
BOT BOTTOM	FLMTD FLUSH MOUNTED	NTS NOT TO SCALE	TBO TO BE DETERMINED
BLDG BUILDING	FT FOOT/FEET	NO NUMBER	TERR TERRAZZO
BL BUILDING LINE	FDN FOUNDATION	OC ON CENTER	TFF TOP FINISHED FLOOR
CAB CABINET	FRTZ FRITZ FLOOR (RTT) TILE	OPN OPENING	TMP GL TEMPERED GLASS
CB CEMENT BOARD	FLOR FLUORESCENT	OPOS OPOSITE	THERMO THERMOSTAT
CI CAST IRON	FLMTD FLUSH MOUNTED	OH OPOSITE HAND	TOS TOP OF
CLG CEILING	FT FOOT/FEET	OTS OPEN TO STRUCTURE	TOS TOP OF STEEL
CL CENTER LINE	FRD FRENCH DRAIN	OUT OUTLET	TOS TOP OF STRUCTURAL SLAB
CMU CONCRETE MASONRY UNIT	FRD FRENCH DRAIN	OD OUTSIDE DIAMETER	TOES TOP OF EXISTING SLAB
COL COLUMN	GALV GALVANIZED	OF OUTSIDE FACE	TRT TERRAZZO RESILIENT TILE
CONC CONCRETE	GFB GROUND FACE BLOCK	P PAINTED	TYP TYPICAL
CONF CONFERENCE	GFRG GLASS FIBER REINFORCED GYPSUM	PF PORCELAIN TILE	UNFIN UNFINISHED
CONST CONSTRUCTION	GOG GOGGLE	PNL PANEL	UNO UNLESS NOTED OTHERWISE
CONTR CONTRACTOR	GWB GYPSUM WALLBOARD	PTN PARTITION	UR UNRINAL
CONT CONTINUOUS	H HEIGHT AFF	PL PROPERTY LINE	UTL UTILITY
CPT CARPET	HDW HARDWARE	PLM PLASTIC LAMINATE	VAT VINYL ASBESTOS TILE
CT CERAMIC TILE	HDWD HARDWOOD	PLMB PLUMBING	VCT VINYL COMPOSITE TILE
CTB CERAMIC TILE BASE	HD HEAD	PLYWD PLYWOOD	VEN VENEER
DA DEVICE ARRANGEMENT	HDR HEADER	PTWD PRESERVATIVE TREATED WOOD VET	VIF VERIFY IN FIELD
DET DETAIL	HVAC HEATING, VENTILATING, AIR CONDITIONING	QT QUARRY TILE	VRS VINYL REDUCER STRIP
DF DRINKING FOUNTAIN	HR HOUR	QTB QUARRY TILE BASE	VT VINYL TILE
DM DIMENSION	HT HEIGHT	QTY QUANTITY	WVC VINYL WALL COVERING
DR DOOR	HIM HOLLOW METAL	REF REFLECTED CEILING PLAN	WB WHITEBOARD
DN DOWN	HIMR HOLLOW METAL FRAME	REF REFLECTED	WC WATER CLOSET
DWG DRAWING	HORIZ HORIZONTAL	REQ REQUIRED	WF WATER FOUNTAIN
	HC HANDICAP	RET RETURN	WGL WIRE GLASS
		RA RETURN AIR	WTH WITH
		REV REVISED/REVISION	W/W WHEEL CHAIR
		REQ REQUEST FOR INFORMATION	W/O W/O
		RO ROUGH OPENING	WOM W/O
		RT RUBBER TREAD TILE	WD WOOD
		RTB RUBBER TREAD BASE	WD WOOD BLOCKING
		RTT RESILIENT TERRAZZO TILE	WD DR WOOD DROPPING
		RW RESCUE WINDOW	WF WATERPROOFING
			WR WARDROBE
			WR WINDOW WALL
			WW WINDOW
			YD YARD
			YD YARD CLEANOUT
			YCO YARD
			ZCC ZINC COATED COPPER

SHEET IDENTIFICATION LEGEND

DISCIPLINE DESIGNATOR
SHEET TYPE DESIGNATOR
SEQUENCE NUMBER

A101

DISCIPLINE DESIGNATORS	SHEET TYPE DESIGNATOR
G GENERAL	G GENERAL
CC CODE COMPLIANCE	1 DEMOLITION
PH PHASING	2 PLANS
HM HAZARDOUS MATERIAL	3 EXTERIOR ELEVATIONS & BUILDING SECTIONS
AB ABATEMENT	4 ENLARGED PLANS & INTERIOR ELEVATIONS
C CIVIL	5 FINISHES
L LANDSCAPE	6 REFLECTED CEILING PLANS
S STRUCTURAL	7 VERTICAL CIRCULATION
A ARCHITECTURAL	8 WALL SECTIONS & ENLARGED DETAILS
F FIRE PROTECTION	9 TYPICAL DETAILS
M MECHANICAL	
E ELECTRICAL	

MATERIAL LEGEND

	CMU WALL
	CMU WALL
	GWB WALL
	MASONRY VENEER
	"GWB - 'TYPE X' UNO (SEE SPECS)
	EXPOSED TO WEATHER OR MOISTURE
	WOOD BLOCKING (PRESSURE TREATED ALL AREAS EXPOSED TO WEATHER OR MOISTURE)
	CAULK w/ BACKER ROD
	WATER PROOFING MEMBRANE, OR ROOFING MEMBRANE OR FLASHING
	RIGID INSULATION
	BATT INSULATION
	PORUS FILL
	SUITABLE COMPACTED BACKFILL (SEE SPEC)
	UNDISTURBED SOIL
	CAST IN PLACE CONCRETE OR CAST STONE
	GLASS SURFACE

SYMBOLS LEGEND

ROOM NAME 101 150 SF	ROOM TAG (NAME, NUMBER, & AREA)		DENOTES EXISTING AREA OF THE BUILDING TO REMAIN (NO MAJOR GENERAL CONSTRUCTION).
	WALL TYPE & FIRE RATING TAG		DENOTES EXISTING WALL TO REMAIN
	WINDOW TYPE TAG		DENOTES EXISTING WALL TO BE DEMOLISHED
	CONTROL JOINT		DENOTES 1hr OR NON-RATED WALL
	COLUMN LINE		DENOTES 2hr RATED WALL
	EXTERIOR ELEVATION		DENOTES WALL TYPE & FIRE RATING
	INTERIOR ELEVATION		DENOTES HOLLOW METAL FRAME w/ SIDELITE OR TRANSOM
	WALL OR BUILDING SECTION		DENOTES NEW DOOR AND/OR FRAME. SEE DOOR SCHEDULE
			DENOTES EXISTING DOOR

UNIFORM SAFETY STANDARDS FOR SCHOOL CONSTRUCTION AND MAINTENANCE PROJECTS PER SECTION 155.5 REGULATIONS OF THE COMMISSIONER OF EDUCATION

THE OCCUPIED PORTION OF THE EXISTING SCHOOL BUILDING SHALL ALWAYS COMPLY WITH THE MINIMUM REQUIREMENTS NECESSARY TO MAINTAIN A CERTIFICATE OF OCCUPANCY.

ALL SCHOOL AREAS TO BE DISTURBED DURING RENOVATION OR DEMOLITION HAVE BEEN OR WILL BE TESTED FOR LEAD AND ASBESTOS.

GENERAL SAFETY AND SECURITY STANDARDS FOR CONSTRUCTION PROJECTS:

- (A) ALL CONSTRUCTION MATERIALS SHALL BE STORED IN A SAFE AND SECURE MANNER.
- (B) FENCES AROUND CONSTRUCTION SUPPLIES OR DEBRIS SHALL BE MAINTAINED.
- (C) GATES SHALL ALWAYS BE LOCKED UNLESS A WORKER IS IN ATTENDANCE TO PREVENT UNAUTHORIZED ENTRY.
- (D) DURING EXTERIOR RENOVATION WORK, OVERHEAD PROTECTION SHALL BE PROVIDED FOR ANY SIDEWALKS OR AREAS IMMEDIATELY BENEATH THE WORK SITE OR SUCH AREAS SHALL BE FENCED OFF AND PROVIDED WITH WARNING SIGNS TO PREVENT ENTRY.
- (E) WORKERS SHALL BE REQUIRED TO WEAR PHOTO-IDENTIFICATION BADGES AT ALL TIMES FOR IDENTIFICATION AND SECURITY PURPOSES WHILE WORKING AT OCCUPIED SITES.

SEPARATION OF CONSTRUCTION AREAS FROM OCCUPIED SPACES:

CONSTRUCTION AREAS WHICH ARE UNDER THE CONTROL OF A CONTRACTOR AND THEREFORE NOT OCCUPIED BY DISTRICT STAFF OR STUDENTS SHALL BE SEPARATED FROM OCCUPIED AREAS. PROVISIONS SHALL BE MADE TO PREVENT THE PASSAGE OF DUST AND CONTAMINANTS INTO OCCUPIED PARTS OF THE BUILDING. PERIODIC INSPECTION AND REPAIRS OF THE CONTAINMENT BARRIERS MUST BE MADE TO PREVENT EXPOSURE TO DUST OR CONTAMINANTS. GYPSUM BOARD MUST BE USED IN EXIT WAYS OR OTHER AREAS THAT REQUIRE FIRE RATED SEPARATION. HEAVY DUTY PLASTIC SHEETING MAY BE USED ONLY FOR A VAPOR, FINE DUST OR AIR INFILTRATION BARRIER, AND SHALL NOT BE USED TO SEPARATE OCCUPIED SPACES FROM CONSTRUCTION AREAS.

- (A) LARGE AMOUNTS OF DEBRIS MUST BE REMOVED BY USING ENCLOSED CHUTES OR A SIMILAR SEALED SYSTEM. THERE SHALL BE NO MOVEMENT OF DEBRIS THROUGH HALLS OF OCCUPIED SPACES OF THE BUILDING. NO MATERIAL SHALL BE DROPPED OR THROWN OUTSIDE THE WALLS OF THE BUILDING.
- (B) ALL OCCUPIED PARTS OF THE BUILDING AFFECTED BY RENOVATION ACTIVITY SHALL BE CLEANED AT THE CLOSE OF EACH WORKDAY. SCHOOL BUILDINGS OCCUPIED DURING A CONSTRUCTION PROJECT SHALL MAINTAIN REQUIRED HEALTH, SAFETY AND EDUCATIONAL CAPABILITIES AT ALL TIMES THAT CLASSES ARE IN SESSION.

A PLAN DETAILING HOW EXITING REQUIRED BY THE APPLICABLE BUILDING CODE WILL BE MAINTAINED.

A PLAN DETAILING HOW ADEQUATE VENTILATION WILL BE MAINTAINED DURING CONSTRUCTION.

CONSTRUCTION AND MAINTENANCE OPERATIONS SHALL NOT PRODUCE NOISE IN EXCESS OF 60 DBA IN OCCUPIED SPACES OR SHALL BE SCHEDULED FOR TIMES WHEN THE BUILDING OR AFFECTED SPACES ARE NOT OCCUPIED OR ACOUSTICAL ABATEMENT MEASURES SHALL BE TAKEN.

THE CONTRACTOR SHALL BE RESPONSIBLE FOR THE CONTROL OF CHEMICAL FUMES, GASES, AND OTHER CONTAMINANTS PRODUCED BY WELDING, GASOLINE OR DIESEL ENGINES, ROOFING, PAVING, PAINTING, ETC. TO ENSURE THEY DO NOT ENTER OCCUPIED PORTIONS OF THE BUILDING OR AIR INTAKES.

THE CONTRACTOR SHALL BE RESPONSIBLE TO ENSURE THAT ACTIVITIES AND MATERIALS WHICH RESULT IN "OFF-GASSING" OF VOLATILE ORGANIC COMPOUNDS SUCH AS GLUES, PAINTS, FURNITURE, CARPETING, WALL COVERING, DRAPERY, ETC. ARE SCHEDULED, CURED OR OTHERWISE TREATED IN ACCORDANCE WITH MANUFACTURERS RECOMMENDATIONS BEFORE A SPACE CAN BE OCCUPIED.

LARGE AND SMALL ASBESTOS ABATEMENT PROJECTS AS DEFINED BY 12NYCRR56 SHALL NOT BE PERFORMED WHILE THE BUILDING IS OCCUPIED. NOTE, IT IS OUR INTERPRETATION THAT THE TERM "BUILDING", AS REFERENCED IN THIS SECTION, MEANS A WING OR MAJOR SECTION OF A BUILDING THAT CAN BE COMPLETELY ISOLATED FROM THE REST OF THE BUILDING WITH SEALED NON-COMBUSTIBLE CONSTRUCTION. THE ISOLATED PORTION OF THE BUILDING MUST CONTAIN EXITS THAT DO NOT PASS THROUGH THE OCCUPIED PORTION AND VENTILATION SYSTEMS MUST BE PHYSICALLY SEPARATED AND SEALED AT THE ISOLATION BARRIER. EXTERIOR WORK SUCH AS ROOFING, FLASHING, SIDING, OR SOFFIT WORK MAY BE PERFORMED ON OCCUPIED BUILDINGS PROVIDED PROPER VARIANCES ARE IN PLACE AS REQUIRED, AND COMPLETE ISOLATION OF VENTILATION SYSTEMS AND AT WINDOWS IS PROVIDED. CARE MUST BE TAKEN TO SCHEDULE WORK SO THAT CLASSES ARE NOT INTERRUPTED BY NOISE OR VISUAL DISTRACTION.

SURFACES THAT WILL BE DISTURBED BY RECONSTRUCTION MUST HAVE A DETERMINATION MADE AS TO THE PRESENCE OF LEAD. PROJECTS WHICH DISTURB SURFACES THAT CONTAIN LEAD SHALL HAVE IN THE SPECIFICATIONS A PLAN PREPARED BY A CERTIFIED LEAD RISK ASSESSOR OR SUPERVISOR WHICH DETAILS PROVISIONS FOR OCCUPANT PROTECTION, WORKSITE PREPARATION, WORK METHODS, CLEANING AND CLEARANCE TESTING WHICH ARE IN GENERAL ACCORDANCE WITH THE HUD GUIDELINES.

PROJECT INFORMATION

OWNER	PUTNAM VALLEY CENTRAL SCHOOLS 171 OSCAWANA LAKE ROAD PUTNAM VALLEY, NY 10579	
	TELEPHONE:	845.528.8143
PROJECT LOCATION	P.V. ELEMENTARY SCHOOL 171 OSCAWANA LAKE RD PUTNAM VALLEY, NY 10579	P.V. HIGH SCHOOL 146 PEEKSKILL HOLLOW RD PUTNAM VALLEY, NY 10579
PROJECT DESCRIPTION	INTERIOR RENOVATION & SITE WORK	
NYSED NUMBER	E.S. 48-05-03-04-0-001-13 MODULAR 48-05-03-04-0-007-002 TRANSP. FAC. 48-05-03-04-5-012-003 H.S. 48-05-03-04-0-010-006	
PROJECT COMMENCEMENT	SUMMER 2022	
PROJECT COMPLETION	FALL 2022	
APPLICABLE CODES	2020 UNIFORM FIRE PREVENTION & BUILDING CODE NEW YORK STATE ENERGY CONSERVATION CONSTRUCTION	
PROJECT TYPE	E.S. MODULAR BUILDING TRANSPORTATION BUILDING	ALTERATION LEVEL 1 ALTERATION LEVEL 2

2021 COVID RELATED CAPITAL PROJECTS

2021 COVID RELATED CAPITAL PROJECTS
171 OSCAWANA LAKE ROAD,
PUTNAM VALLEY, NY 10579



NY SED PROJECT CONTROL NO.
ELEMENTARY SCHOOL 48-05-03-04-0-001-013
E.S. MODULAR 48-05-03-04-0-007-002
HIGH SCHOOL 48-05-03-04-0-010-006
TRANSPORT FACILITY 48-05-03-04-5-012-003

CONSTRUCTION DOCUMENTS

Key Plan

NOTE: ALL LEGAL DESIGN, ARRANGEMENTS AND PLANS INDICATED ON REPRESENTED BY THIS DRAWING ARE OWNED BY AND ARE THE PROPERTY OF KGDARCHITECTS PC. NO PART OF THIS DRAWING SHALL BE REPRODUCED OR TRANSMITTED IN ANY FORM OR BY ANY MEANS, ELECTRONIC OR MECHANICAL, INCLUDING PHOTOCOPYING, RECORDING, OR BY ANY INFORMATION STORAGE AND RETRIEVAL SYSTEM, WITHOUT THE WRITTEN PERMISSION OF KGDARCHITECTS PC.

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ALTERATIONS BY ANY PERSON, IN ANY WAY, OF ANY ITEM CONTAINED ON THIS DRAWING SHALL BE AT THE RISK OF THE USER. THE CONTRACTOR SHALL BE RESPONSIBLE FOR OBTAINING ALL NECESSARY PERMITS AND APPROVALS FROM THE APPROPRIATE AGENCIES.

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GENERAL INFORMATION

Job No.	2021-1067	Date	MARCH 11 2022
Scale	As indicated	Drawn / Checked	MA WH
Sheet Number	G001		

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CONSTRUCTION DOCUMENTS

CODE COMPLIANCE SUMMARY

USE & OCCUPANCY CLASSIFICATION NYS BC 302.1

OCCUPANCY EDUCATIONAL GROUP E

CONSTRUCTION TYPE NYS BC 602.5

TRANSPORTATION BUILDING VB

BUILDING HEIGHT & AREA NYS BC TABLES 504.3 / 504.4 / 506.2

SPRINKLERED: NO	(MODULAR) PERMITTED	(MODULAR) EXISTING	(MODULAR) PROPOSED
HEIGHT	40' - 0"	26' - 0"	NO CHANGE
STORIES	1	1	NO CHANGE
FLOOR AREA PER STORY	9,500 SF	1,985 SF	NO CHANGE
		SF TOTAL	NO CHANGE

FIRE RESISTANCE RATING VB CONSTRUCTION: NYS BC TABLES 601 / 602

STRUCTURAL FRAME:	0-HOUR
BEARING WALLS:	
EXTERIOR	0-HOUR
INTERIOR	0-HOUR
NON BEARING WALLS & PARTITIONS:	
EXTERIOR	1-HOUR
	X < 5'
	5' ≤ X < 10'
	10' ≤ X < 30'
	X ≥ 30'
INTERIOR	0-HOUR
FLOOR CONSTRUCTION	0-HOUR
ROOF CONSTRUCTION	0-HOUR

FIRE RESISTANCE-RATED CONSTRUCTION
IBC TABLES 508.2 / 708.1 / 708.3 / 1020.1

ASSEMBLY	FIRE-RESISTANCE RATING	LOCATION
FIRE PARTITION	1-HOUR	VESTIBULE (UNSPRINKLERED)

SEE DRAWINGS FOR LOCATION OF FIRE-RESISTANCE-RATED STRUCTURE IN AREAS OF WORK PROVIDED: PORTABLE FIRE EXTINGUISHERS, FIRE ALARM AND DETECTION SYSTEMS.

PLUMBING FIXTURE COUNT NYS BC CHAPTER 29

TYPE	REQ. FIXTURES		PROVIDED FOR MEN	PROVIDED FOR WOMEN	PROVIDED UNISEX
	MEN	WOMEN			
TOILET	1	-	-	-	2
URINAL	-	-	-	-	-
LAVATORY	1	1	-	-	2
WATER FOUNTAIN	1 REQUIRED, 2 PROVIDED				

MEANS OF EGRESS NYS BC CHAPTER 10

	YES	YES
EXIT SIGNS	YES	YES
MEANS OF EGRESS ILLUMINATION	YES	YES
PANIC HARDWARE	YES	YES
ACCESSIBLE MEANS OF EGRESS	YES	YES

EXIT TRAVEL DISTANCE: NYS BC TABLE 1016.1
200' MAX NON-SPRINKLERED

SED MANUAL OF PLANNING STANDARDS: 150' MAX TO EXTERIOR DOOR
120' MAX TO STAIR ENCLOSURE
50' MAX TO EXIT FROM ALL ROOMS 1500 SF & UNDER

OCCUPANCY LOADS: CLASSROOMS: NYS BC TABLE 1004.1.2
20 NET SF/PERSON

EXIT WIDTH: STAIR WIDTH: NYS BC 1005.3
OTHER EGRESS COMPONENTS: 3" OCCUPANT
2" OCCUPANT


EGRESS CAPACITY CALCULATIONS:

PER BC NYS	SPACE	AREA	OCC LOAD	REQUIRED		PROVIDED	
				EGRESS OTHER	# EXITS	EGRESS OTHER	# EXITS
CLASSROOM	101	825 SF	41	8.4" (42' x 0.2")	2	68"	2
CLASSROOM	102	830 SF	42	8.4" (42' x 0.2")	2	68"	2

** TRAVEL DISTANCE/COMMON PATH OF TRAVEL DISTANCE

ENERGY CODE COMPLIANCE

	REQ'D	PROVIDED
COUNTY:	PUTNAM	
CLIMATE ZONE:	5A	
OPAQUE THERMAL ENVELOPE REQUIREMENTS	TABLE C402.1.4	
ROOF: ATTIC AND OTHER	R-38	N/A
ROOF: INSULATION ENTIRELY ABOVE DECK	R-30	N/A
WALLS - ABOVE GRADE: METAL FRAMED	R-13 + R-7.5ci	N/A
WALLS - BELOW GRADE: MASS	R-7.5ci	N/A
FLOORS: MASS	R-10ci	N/A
SLAB ON GRADE FLOORS	R-15 FOR 24"	N/A
OPAQUE DOORS: SWINGING	U-0.61	----
VERTICAL FENESTRATION	TABLE C402.4	
FIXED FENESTRATION	U-0.38	----
OPERABLE FENESTRATION	U-0.45	----
ENTRANCE DOORS	U-0.77	----
SHGC (0.2 < PF < 0.5)	SEW U-0.48	----
	N U-0.58	----
SHGC (PF ≥ 0.5)	SEWN U-0.64	----

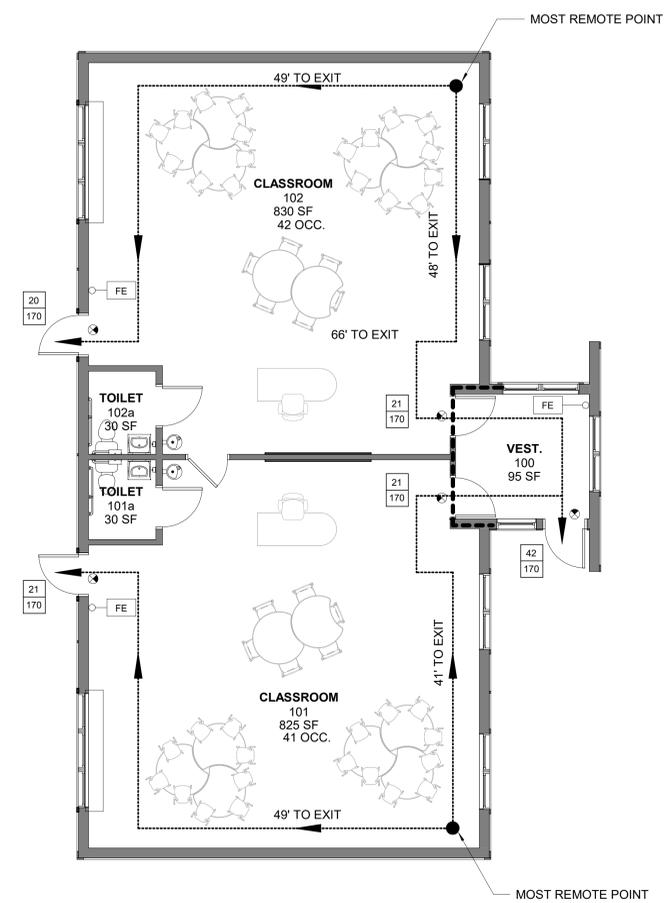

SYMBOL LEGEND

- ASSUMED 1 HR FIRE PARTITION
- MEANS OF EGRESS PATHWAY
- EGRESS LOAD
- MAX CAPACITY
- FE FIRE EXTINGUISHER
- ⊙ EXIT SIGN DIRECTION AS INDICATED

DOOR CAPACITY CALCULATIONS (GENERAL)
AT 36" WIDE SINGLE DOORS, 34" CLEAR EGRESS WIDTH SHALL BE PROVIDED
34" / 0.2" PER OCCUPANT = 170 OCCUPANT CAPACITY


AT 72" WIDE DOUBLE DOORS, 68" CLEAR EGRESS WIDTH SHALL BE PROVIDED
68" / 0.2" PER OCCUPANT = 340 OCCUPANT CAPACITY

DOOR CAPACITY CALCULATIONS (OVERALL)
AREA OF WORK: 1,985 SF
REQUIRED: 84 OCCUPANTS X 0.2" PER OCCUPANT = 16.8"
PROVIDED: 102"

MODULAR BUILDING OCCUPANCY TABLE

Level	ROOM NAME	ROOM #	AREA	OCCUPANCY USE	CODE FACTOR	OCCUPANT LOAD
EDUCATION	CLASSROOM	101	825 SF	EDUCATION	20	41
GROUND LEVEL	CLASSROOM	102	831 SF	EDUCATION	20	42
EDUCATION: 2			1655 SF			83

1 MODULAR CLASSROOM BLDG. CODE COMPLIANCE
3/16" = 1'-0"

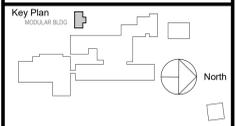

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2	06/24/2022	ISSUE FOR BID
1	03/11/2022	CONSTRUCTION DOCUMENTS
No.	Date	Issue

ES MODULAR BLDG CODE COMPLIANCE INFORMATION

Job No.	2021-1067	Date	MARCH 11 2022
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CONSTRUCTION DOCUMENTS

CODE COMPLIANCE SUMMARY

USE & OCCUPANCY CLASSIFICATION NYS BC 302.1
OCCUPANCY STORAGE GROUP S1

CONSTRUCTION TYPE NYS BC 602.5
TRANSPORTATION BUILDING IIB

BUILDING HEIGHT & AREA NYS BC TABLES 504.3 / 504.4 / 506.2

SPRINKLERED:	NO	(TRANSP.) PERMITTED	(TRANSP.) EXISTING	(TRANSP.) PROPOSED
HEIGHT	40' - 0"	24' - 0"	1	NO CHANGE
STORIES	3	GROUND FL.	4,547 SF	NO CHANGE
FLOOR AREA PER STORY	17,500 SF	MEZZANINE	952 SF	NO CHANGE
		SF TOTAL	NO CHANGE	

MODULAR CLASSROOM BLDG.
1962 ADDITION
1956 ADDITION
2008 ADDITION
1935 BUILDING
TRANSPORTATION FACILITY BLDG.

FIRE RESISTANCE RATING VB CONSTRUCTION: NYS BC TABLES 601 / 602

STRUCTURAL FRAME:	0-HOUR
BEARING WALLS	0-HOUR
EXTERIOR	0-HOUR
INTERIOR	0-HOUR
NON BEARING WALLS & PARTITIONS:	
EXTERIOR	X < 5' 2-HOUR
	5' ≤ X < 10' 1-HOUR
	10' ≤ X < 30' 0-HOUR
	X ≥ 30' 0-HOUR
INTERIOR	0-HOUR
FLOOR CONSTRUCTION	0-HOUR
ROOF CONSTRUCTION	0-HOUR

FIRE RESISTANCE-RATED CONSTRUCTION IBC TABLES 508.2 / 708.1 / 708.3 / 1020.1

ASSEMBLY	FIRE-RESISTANCE RATING	LOCATION
FIRE PARTITION	1-HOUR	N/A

SEE DRAWINGS FOR LOCATION OF FIRE-RESISTANCE-RATED CONSTRUCTION IN AREAS OF WORK PROVIDED: PORTABLE FIRE EXTINGUISHERS, FIRE ALARM AND DETECTION SYSTEMS.

PLUMBING FIXTURE COUNT NYS BC CHAPTER 29

TYPE	REQ. FIXTURES		PROVIDED FOR MEN	PROVIDED FOR WOMEN	PROVIDED UNISEX
	MEN	WOMEN			
TOILET	1	1	-	-	2
URINAL	-	-	-	-	-
LAVATORY	1	1	-	-	2
WATER FOUNTAIN	1 REQUIRED, 2 PROVIDED				

MEANS OF EGRESS NYS BC CHAPTER 10

EXIT SIGNS	YES	YES
MEANS OF EGRESS ILLUMINATION	YES	YES
PANIC HARDWARE	YES	YES
ACCESSIBLE MEANS OF EGRESS	YES	YES

EXIT TRAVEL DISTANCE NYS BC TABLE 1016.1
200' MAX NON-SPRINKLERED

SED MANUAL OF PLANNING STANDARDS 150' MAX TO EXTERIOR DOOR
120' MAX TO STAIR ENCLOSURE
50' MAX TO EXIT FROM ALL ROOMS 1500 SF & UNDER

OCCUPANCY LOADS: STORAGE NYS BC TABLE 1004.1.2
300 NET SF/PERSON


EXIT WIDTH NYS BC 1005.3
STAIR WIDTH 3' OCCUPANT
OTHER EGRESS COMPONENTS 2' OCCUPANT

EGRESS CAPACITY CALCULATIONS:


PER BC NYS		REQUIRED		PROVIDED	
SPACE	AREA	OCC LOAD	EGRESS OTHER	# EXITS	MAX TRAV DISTANCE**
STORAGE A-01	952 SF	3	.6" (3' x 0.2')	2	200'
				68"	2
					86'

ENERGY CODE COMPLIANCE

	REQ'D	PROVIDED
COUNTY:	PUTNAM	
CLIMATE ZONE:	5A	
OPAQUE THERMAL ENVELOPE REQUIREMENTS	TABLE C402.1.4	
ROOF: ATTIC AND OTHER	R-38	N/A
ROOF: INSULATION ENTIRELY ABOVE DECK	R-30	N/A
WALLS - ABOVE GRADE: METAL FRAMED	R-13 + R-7.5ci	N/A
WALLS - BELOW GRADE: MASS	R-7.5ci	N/A
FLOORS: MASS	R-10ci	N/A
SLAB ON GRADE FLOORS	R-15 FOR 24"	N/A
OPAQUE DOORS: SWINGING	U-0.61	----
VERTICAL FENESTRATION	TABLE C402.4	
FIXED FENESTRATION	U-0.38	----
OPERABLE FENESTRATION	U-0.45	----
ENTRANCE DOORS	U-0.77	----
SHGC (0.2 < PF < 0.5)	SEW U-0.48	----
	N U-0.58	----
SHGC (PF ≥ 0.5)	SEWN U-0.64	----

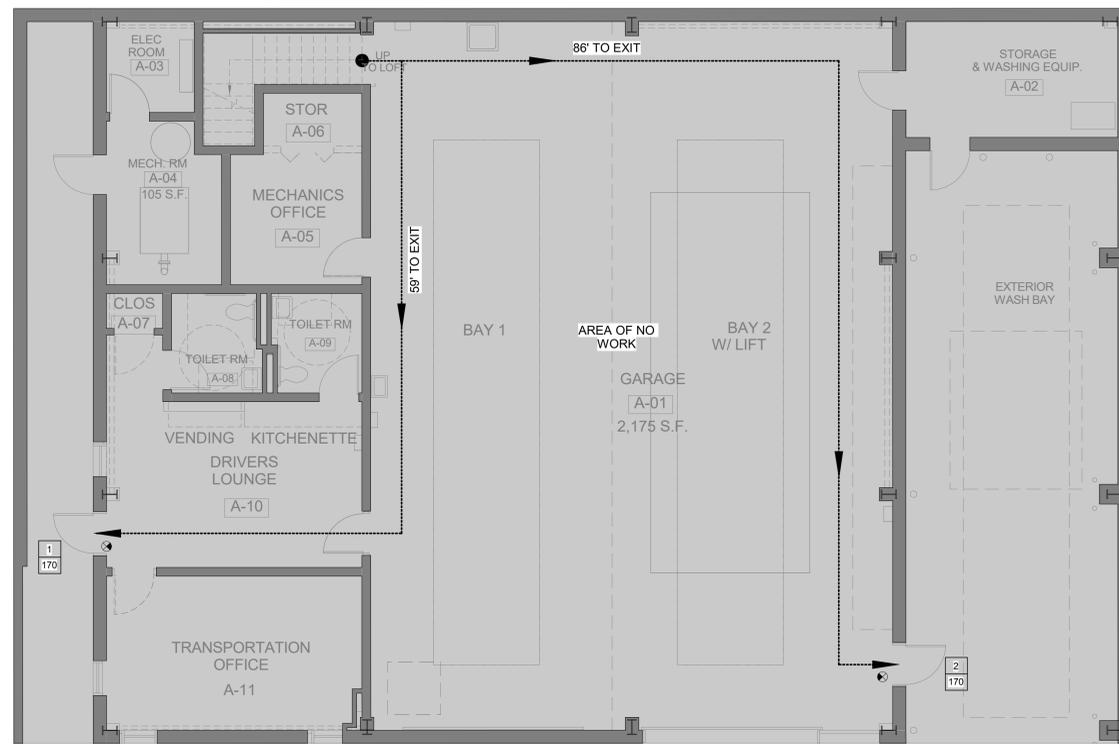

2 TRANSP. GROUND
3/16" = 1'-0"

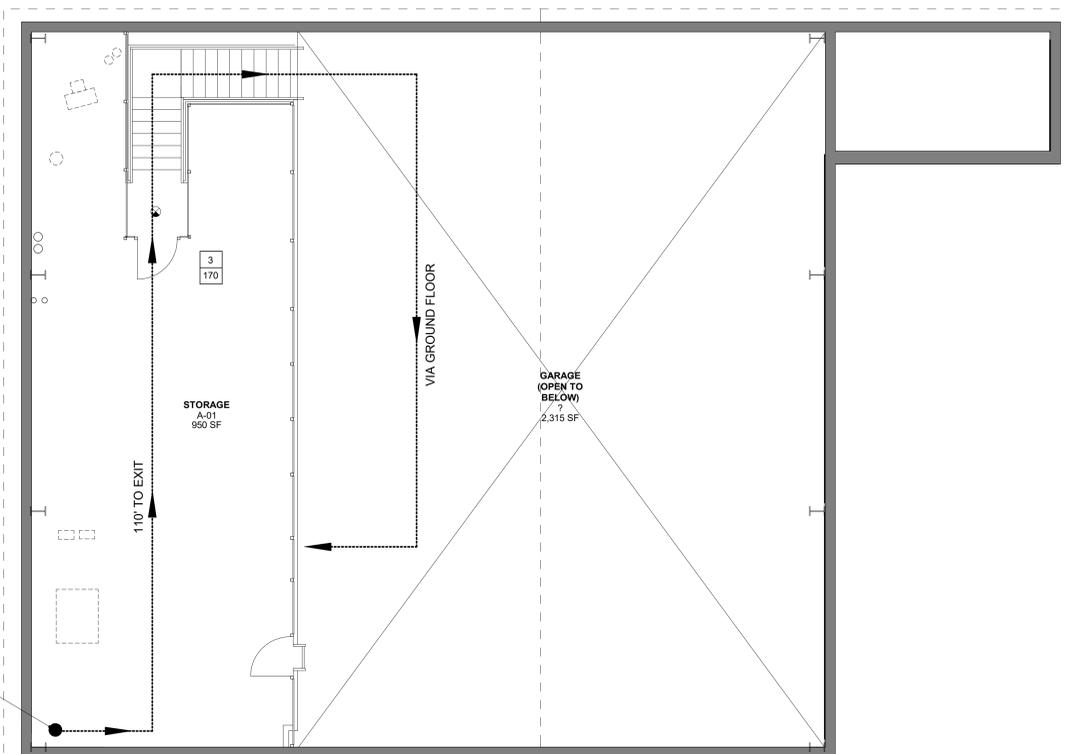

1 MEZZANINE
3/16" = 1'-0"

SYMBOL LEGEND

- ASSUMED 1 HR FIRE PARTITION
- MEANS OF EGRESS PATHWAY
- 0.0 EGRESS LOAD
- 0.0 MAX CAPACITY
- FE FIRE EXTINGUISHER
- EXIT SIGN DIRECTION AS INDICATED


DOOR CAPACITY CALCULATIONS (GENERAL)
AT 36" WIDE SINGLE DOORS: 34" CLEAR EGRESS WIDTH SHALL BE PROVIDED
34" / 0.2" PER OCCUPANT = 170 OCCUPANT CAPACITY

AT 72" WIDE DOUBLE DOORS: 68" CLEAR EGRESS WIDTH SHALL BE PROVIDED
68" / 0.2" PER OCCUPANT = 340 OCCUPANT CAPACITY

DOOR CAPACITY CALCULATIONS (OVERALL)
AREA OF WORK: 952 SF
REQUIRED: 3 OCCUPANTS X 0.2" PER OCCUPANT = 6"
PROVIDED: 68"

TRANSPORTATION BUILDING OCCUPANCY TABLE

Level	ROOM NAME	ROOM #	AREA	OCCUPANCY USE	CODE FACTOR	OCCUPANT LOAD
STORAGE	STORAGE	A-01	952 SF	STORAGE	300	3
MEZZANINE	STORAGE	A-01	952 SF	STORAGE	3	3

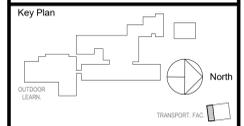

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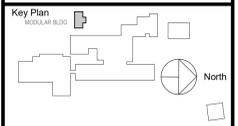
Professional Seal

2 / 06/24/2022 ISSUE FOR BID
1 / 03/11/2022 CONSTRUCTION DOCUMENTS
No. Date Issue
Sheet Title

TRANSPORTATION BLDG CODE COMPLIANCE INFORMATION

Job No. 2021-1067 Date MARCH 11 2022
Scale As indicated Drawn / Checked Author Checker
Sheet Number

	AREA OF NO MAJOR ARCHITECTURAL WORK. SPECIFIC WORK MAY BE SHOWN ELSEWHERE INCLUDING WORK THAT MAY REQUIRE ACCESS, PATCHING & RESTORATION.
	EXISTING WALL TO REMAIN
	EXISTING WALL TO BE DEMOLISHED
	NEW PARTITION
	NEW DOOR, DOOR NUMBER
	KEY NOTES
	WB WHITEBOARD
	DF DRINKING FOUNTAIN
	FE FIRE EXTINGUISHER



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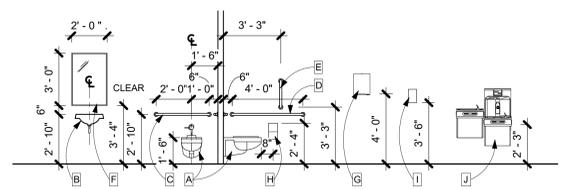
Professional Seal

2	06/24/2022	ISSUE FOR BID
1	03/11/2022	CONSTRUCTION DOCUMENTS
No.	Date	Issue
Sheet Title		

ES MODULAR BLDG DEMO & NEW WORK


Job No.	2021-1067	Date	MARCH 11 2022
Scale	As indicated	Drawn / Checked	MA / WH
Sheet Number			

NOTE TO BIDDERS:
SCOPE OF WORK ON THIS SHEET IS LIMITED TO THAT REQUIRED FOR REPLACEMENT OF WINDOWS & DOORS ONLY.
ALL OTHER WORK, N.I.C.




- A ADA WALL-HUNG TOILET
 - B LAVATORY
 - C REAR TOILET GRAB BAR
 - D SIDE TOILET GRAB BAR
 - E SIDE TOILET VERTICAL GRAB BAR
 - F **WALL MIRROR W/ FRAME
 - G **SURFACE MOUNTED TOWEL DISPENSER
 - H **TOILET PAPER ROLL DISPENSER
 - I **LIQUID SOAP DISPENSER
 - J WALL-HUNG BI-LEVEL DRINKING FOUNTAIN
- NOTES:
**ALL MIRRORS SHALL USE TEMPERED GLASS
**ACCESSORIES G, H, I ARE SUPPLIED BY OWNER, INSTALLED BY GC.


TOILET ROOM ACCESSORIES SCHEDULE
1/4" = 1'-0"

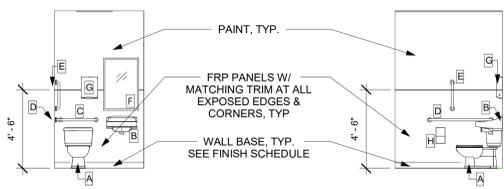


13 TOILET RM ELEVATION
1/4" = 1'-0"

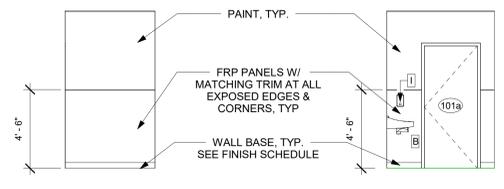


12 TOILET RM ELEVATION
1/4" = 1'-0"

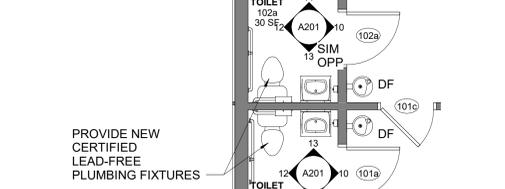

11 TOILET RM ELEVATION
1/4" = 1'-0"

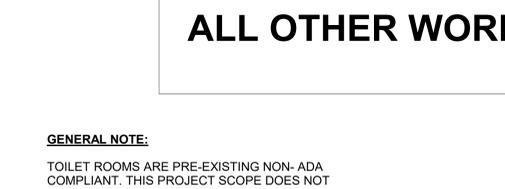


10 TOILET RM ELEVATION
1/4" = 1'-0"

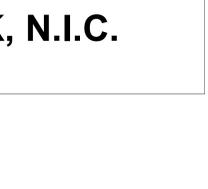


9 TOILET ROOM ENLARGED PLANS
1/4" = 1'-0"

GENERAL NOTE:
TOILET ROOMS ARE PRE-EXISTING NON-ADA COMPLIANT. THIS PROJECT SCOPE DOES NOT INCLUDE RECONFIGURATION OF SPACE TO MEET ADA REQUIREMENTS.

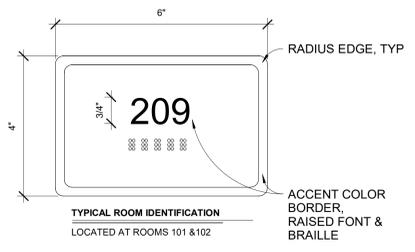


GENERAL NOTE:
ROOM NUMBERS ON SIGNAGE TBD
SIGNAGE MOUNTING TO COMPLY WITH 2010 ADA STANDARDS FOR ACCESSIBLE DESIGN SECTION 703.4 UNO - SEE ARCHITECT FOR FINAL LOCATIONS

14 SIGNAGE TYPES MAIN
6" = 1'-0"

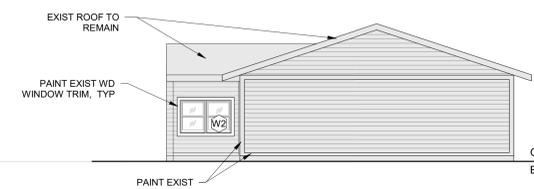


8 WEST FACADE ELEVATION
1/8" = 1'-0" (LOOKING EAST)

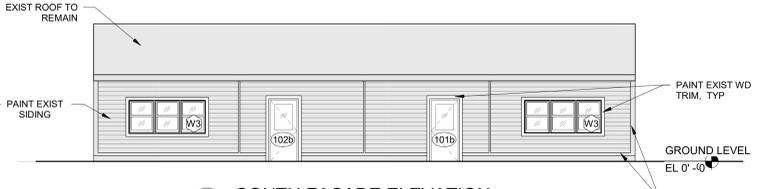


7 SOUTH FACADE ELEVATION
1/8" = 1'-0" (LOOKING NORTH)




6 EAST FACADE ELEVATION
1/8" = 1'-0" (LOOKING WEST)

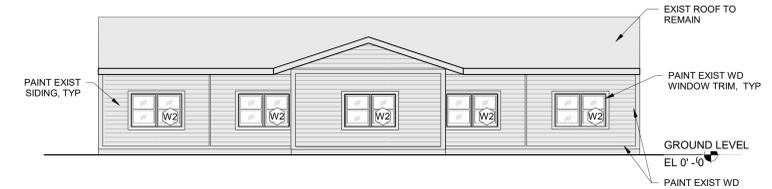


5 NORTH FACADE ELEVATION
1/8" = 1'-0" (LOOKING SOUTH)

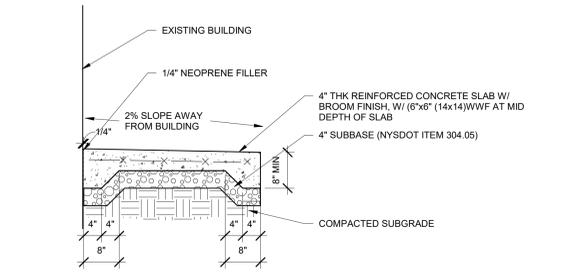


4A CONCRETE PAD DETAIL
3/4" = 1'-0"

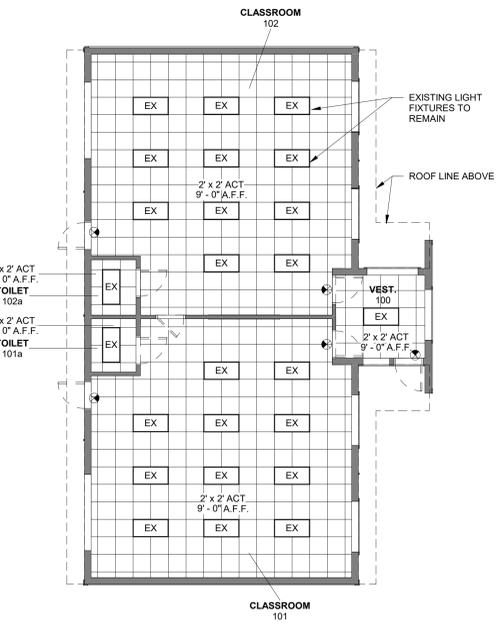

3 CLASSROOM CEILING PLAN
1/8" = 1'-0"

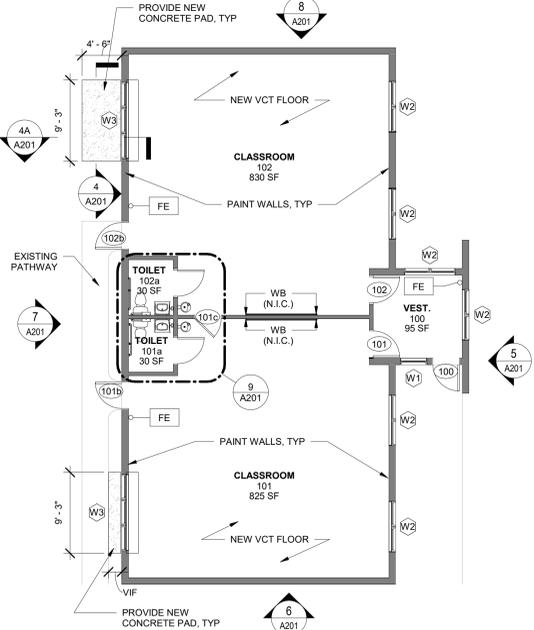

2 CLASSROOM FLOOR PLAN
1/8" = 1'-0"

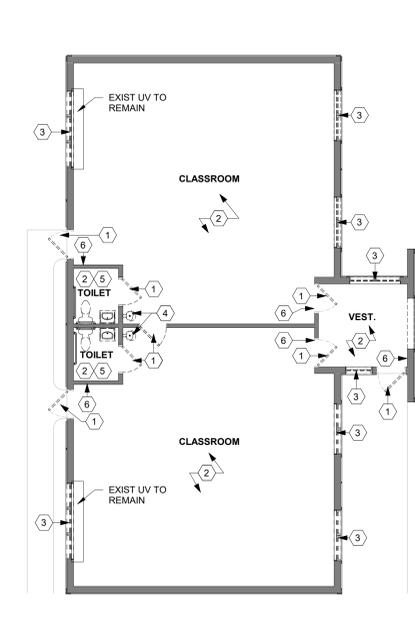

1 CLASSROOM DEMO PLAN
1/8" = 1'-0"

CEILING LEGEND

	GWB CEILING / SOFFIT
	2X2 ACT CEILING SYSTEM
	EXISTING 2' x 4' LAY IN FIXTURE
	EXIT SIGN

GENERAL DEMOLITION NOTES:

- DEMOLITION IS NOT NECESSARILY LIMITED TO WHAT IS SHOWN ON DRAWINGS. THE INTENT IS TO INDICATE THE GENERAL SCOPE OF DEMOLITION REQUIRED TO COMPLETE THE WORK IN ACCORDANCE WITH THE CONTRACT DRAWINGS. PRIOR TO ANY DEMOLITION CONTRACTORS ARE REQUIRED TO VISIT SITE AND FAMILIARIZE THEMSELVES WITH EXISTING CONDITIONS AND NOTE ANY DISCREPANCIES IN WRITING TO ARCHITECT.
- COORDINATE ALL DEMOLITION W/ M.E.P. REMOVALS. NOTE: ALL WIRING, DEVICES & M.E.P. SYSTEMS NOT BEING REMOVED AS PART OF THE WORK, WHICH RUN THROUGH THE WORK AREA, SHALL BE TESTED, LABELED & PROTECTED FROM DISTURBANCE SO THEY REMAIN OPERATIONAL THROUGHOUT THE PROJECT.
- BEFORE STARTING DEMOLITION OPERATIONS CONTRACTOR SHALL REVIEW ABATEMENT SPECIFICATIONS & DRAWINGS WHICH IDENTIFIED AREAS & MATERIALS THAT ARE ASBESTOS CONTAINING MATERIALS & LEAD PAINT. CONTRACTOR SHALL FOLLOW PROCEDURES AS SET FORTH IN ABATEMENT SPECIFICATIONS AND BALANCE OF SPECIFICATIONS. ALL ABATEMENT WORK SHALL BE PART GENERAL TRADES CONTRACTORS BASE BID.
- AT ANY SPACE BEING RENOVATED CONTRACTOR SHALL REMOVE EQUIPMENT AND MISCELLANEOUS ITEMS SUCH AS PLACES, SIGNAGE, DISPLAY BOARDS, TACK BOARDS, INTERCOMS, SPEAKERS, AND THE LIKE, AND TURN OVER TO THE OWNER.
- RETURN ALL EXISTING AV EQUIPMENT (I.E. PROJECTORS, SCREENS, MONITORS, AND SPEAKERS) TO OWNER.
- DEMOLITION OF DOOR ASSEMBLIES TYPICALLY SHALL INCLUDE DEMO OF DOOR(S), FRAME SIDELITES (IF PRESENT), TRANSOMS (IF PRESENT), DOOR SADDLE, HARDWARE, AND RELATED ACCESSORIES. PATCH WALL, FLOOR, & HEAD. PREP FOR NEW DOOR ASSEMBLY (IF APPLICABLE).
- DEMOLITION OF WINDOW ASSEMBLIES TYPICALLY SHALL INCLUDE DEMO OF WINDOWS(S), FRAME, GLAZING, FLASHING, SILL TRIM/SURROUND/RETURN, HARDWARE, AND RELATED ACCESSORIES. PATCH ADJACENT AREAS. PREP FOR NEW WINDOW ASSEMBLY (IF APPLICABLE).
- WHEN DEMOLISHING FLOORS CONTRACTORS SHALL REMOVE FINISH FLOORING & SCRAPE SLAB/SUB-FLOORING CLEAN. SUB-FLOOR SHALL BE LEVELLED PRIOR TO INSTALLATION OF NEW SCHEDULED FINISH FLOOR. ANY DAMAGE TO ADJ. FLOORS SHALL BE PATCHED.
- AFTER DEMOLITION OPERATIONS, WHEN FINISH PATCHING IF SPECIFIC FINISH MATERIAL IS NOT CALLED OUT, CONTRACTOR SHALL MATCH EXISTING ADJACENT MATERIALS.

DEMO KEYNOTES

- REMOVE EXIST DOOR AND ALL ASSOCIATED FRAMES & HARDWARE, INCLUDING ALL WALL BASES. CLEAN AND FLASH PATCH SLABS AS REQUIRED TO RECEIVE NEW FLOOR FINISH. REMOVE ALL EXISTING FINISH CEILINGS & GRIDS IN THEIR ENTIRETY. REMOVE & PROTECT ALL EXISTING LIGHTING & CEILING MOUNTED EQUIPMENT, & REINSTALL IN NEW CONSTRUCTION.
- REMOVE EXISTING WINDOWS IN THEIR ENTIRETY, INCLUDING SHADERS, TRIM, AND SILL. PROTECT EXISTING SHADERS & TRIM FOR ADJACENT SURFACES. PREP OPENING FOR NEW WINDOW SYSTEM. COORD. INFILL W/ NEW CONSTRUCTION.
- REMOVE & DISPOSE OF EXISTING WATER FOUNTAINS & ASSOCIATED ACCESSORIES AS REQUIRED.
- REMOVE & DISPOSE OF EXISTING PLUMBING FIXTURES.
- REMOVE EXISTING EXIT SIGNS & FIRE ALARMS, KEEP SAFE, & REINSTALL IN NEW CONSTRUCTION.



KG+D . ARCHITECTS PC
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P:914.666.5900 KIDARCHITECTS.COM

NY SED PROJECT CONTROL NO.
ELEMENTARY SCHOOL 48-05-03-04-0-001-013
E.S. MODULAR 48-05-03-04-0-007-002
HIGH SCHOOL 48-05-03-04-0-010-006
TRANSPORT FACILITY 48-05-03-04-5-012-003

CONSTRUCTION DOCUMENTS

GENERAL NOTES

- GLAZING IN FIRE RATED DOORS SHALL BE FIRE RATED PLUS TO MEET THE FIRE RATING SCHEDULED, UNLESS NOTED OTHERWISE.
- G.C. SHALL VERIFY SIZE OF REPLACEMENT DOORS & FRAMES IN THE EXISTING BUILDING BEFORE ORDERING.
- SEE SPEC. SECTION 08 71 00 FOR DOOR HARDWARE SETS, HARDWARE NOTES, COMPONENTS & OTHER INFORMATION.
- INTERIOR DOOR PAIRS SHALL HAVE AN HOLLOW METAL KEYED REMOVABLE MULLION WITH RIM CYLINDER EXIT DEVICE W/KEYED CYLINDER DOGGING. EXCEPTION IS CROSS-CORRIDOR DOOR PAIRS & DOORS INTO STAIRS.
- FACE OF ADJACENT WALL TO EDGE OF DOOR FRAME IS 4" (TYPICAL) U.N.O. SEE DETAIL 4A ON A911

Room #	Room	WI	HT	TYPE	Door Mat	Door Fin	Frame Mat	Frame Fin	Fire Label	Saddle	HDWR SET	Comments
100	VEST.	3' - 0"	7' - 0"	FG1	HM	PTD	AL	PTD				
101	VEST.	3' - 0"	7' - 0"	FG1	WD	FF	HM	PTD	45 MIN	3A	EA	
101a	TOILET	3' - 0"	7' - 0"	F	WD	FF	HM	PTD			TS	
101b	CLASSROOM	3' - 0"	7' - 0"	FG1	HM	PTD	AL	PTD		3A	EA	
101c	CLASSROOM	3' - 0"	7' - 0"	FG1	WD	FF	HM	PTD			CL	
102	VEST.	3' - 0"	7' - 0"	FG1	WD	FF	HM	PTD	45 MIN		CL	
102a	TOILET	3' - 0"	7' - 0"	F	WD	FF	HM	PTD			TS	
102b	CLASSROOM	3' - 0"	7' - 0"	FG1	HM	PTD	AL	PTD		3A	EA	
A-01	STORAGE	3' - 0"	7' - 0"	S								SECURITY WIRE PARTITION DOOR
A-02	STORAGE	3' - 0"	7' - 0"	S								SECURITY WIRE PARTITION DOOR


DOOR FINISH SCHEDULE ABBREV.

AL	ALUMINUM	FNG	FLUSH NARROW GLASS	SA	SECURE ACCESS	TM	TOLIET, MULTIUSER
CL	CLASSROOM	HM	HOLLOW METAL	SE	SECURE (STORAGE/JANITOR/MECH./ETC.)	TS	TOLIET, SINGLE USER
CS	CORRIDOR, SMOKE, & FIRE DOORS (RATED)	MBL	MARBLE	SS	STAINLESS STEEL	WD	WOOD
EA	EXTERIOR, ALUMINUM	OF	OUTSIDE FACE	ST	STAIN & SEAL	WS1	WIDE STYLE
FF	FACTORY FINISH	PTD	PAINTED	SW	STAIRWAY DOOR		
FG1	FLUSH GLASS						
FLNG	FLUSH LONG NARROW GLASS						

CHART OF DOOR RATINGS & UL LABEL


UL LABEL	RATING	RATING	MAX GLASS AREA
B	1 1/2 HR	90 MIN	100 SQ INCHES PER LEAF
C	3/4 HR	45 MIN	1296 SQ INCHES PER LEAF
S		SMOKE	

NOTE: GLAZING AND GLASS SIZES FOR INTERIOR DOORS AND WINDOWS ARE TO COMPLY WITH NFPA 80 OR ASTM E119 - TYP.

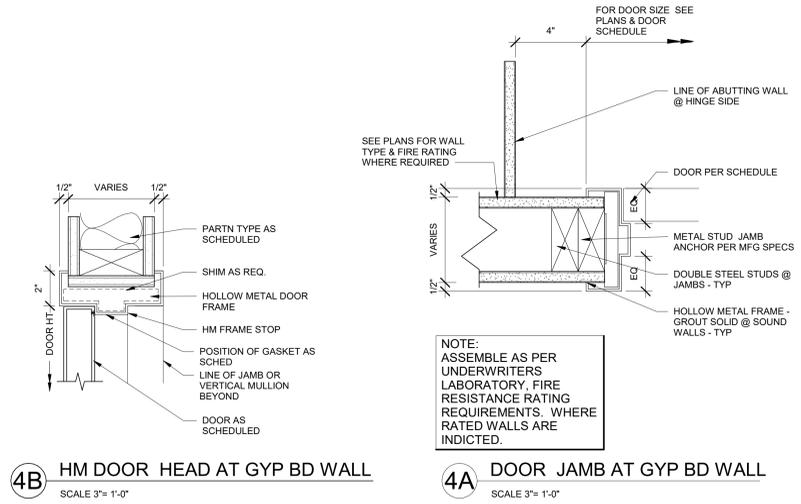


4B HM DOOR HEAD AT GYP BD WALL
SCALE 3/8" = 1'-0"

4A DOOR JAMB AT GYP BD WALL
SCALE 3/8" = 1'-0"

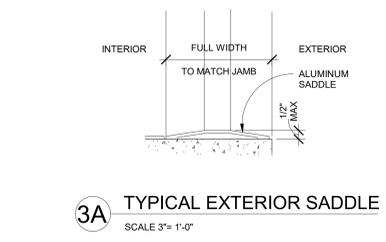


3A TYPICAL EXTERIOR SADDLE
SCALE 3/8" = 1'-0"

- SADDLE NOTES:**
- COORDINATE DOOR UNDERCUT WITH SADDLE & OTHER UNDERCUTTING REQ. SEE DOOR SCHEDULE & SADDLE DETAILS ON THIS SHEET.
 - SADDLES ARE TO BE FULL WIDTH OF DOOR FRAME
 - SADDLES MAY BE OMITTED WHERE MATERIALS OF SIMILAR THICKNESS MEET WITH THE WRITTEN APPROVAL OF THE ARCHITECT. DOOR UNDERCUTS MUST BE COORDINATED.

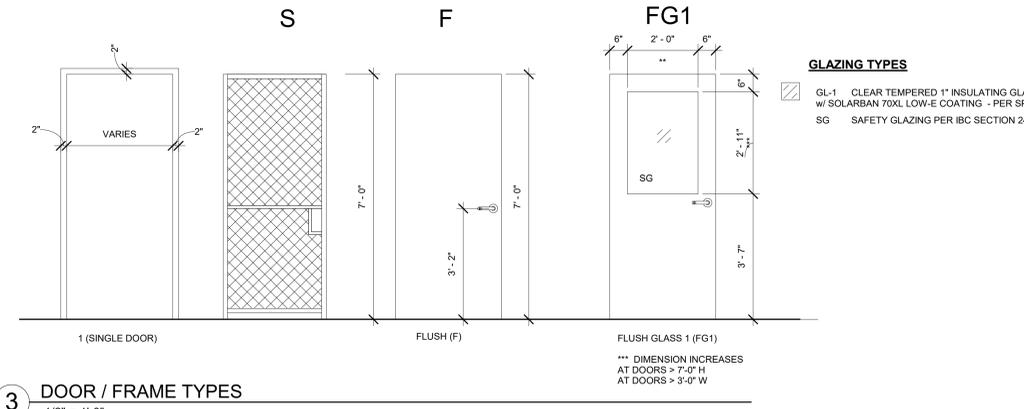

3 DOOR / FRAME TYPES
1/2" = 1'-0"

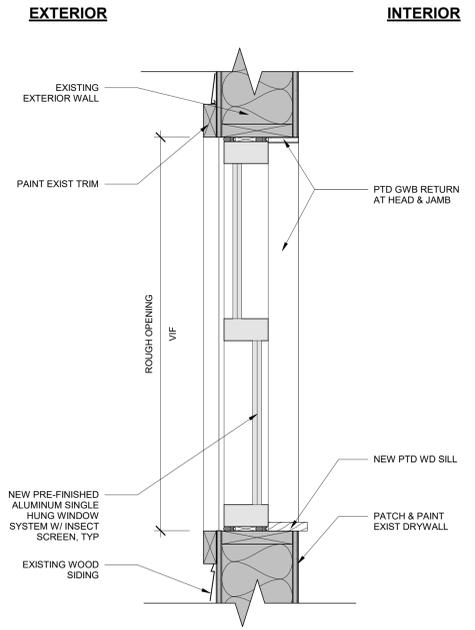


2 WINDOW HEAD & SILL DETAIL
1 1/2" = 1'-0"

Finish Schedule


ROOM #	ROOM NAME	FLOOR										CEILING				
		FIN	BASE	MAT	FIN	MAT	FIN	MAT	FIN	MAT	FIN	MAT	FIN	HT		
	GARAGE (OPEN TO BELOW)															
100	VEST.	VCT	RB	EXIST	PTD	EXIST	PTD	EXIST	PTD	EXIST	PTD	ACT	FF	9'-0"		
101	CLASSROOM	VCT	RB	EXIST	PTD	EXIST	PTD	EXIST	PTD	EXIST	PTD	ACT	FF	9'-0"		
101a	TOILET	VCT	RB	EXIST	FRP 4'-6" H / PTD	GWB	EPO	9'-0"								
102	CLASSROOM	VCT	RB	EXIST	PTD	EXIST	PTD	EXIST	PTD	EXIST	PTD	ACT	FF	9'-0"		
102a	TOILET	VCT	RB	EXIST	FRP 4'-6" H / PTD	GWB	EPO	9'-0"								
A-01	STORAGE															

ABBREVIATIONS:

ACT	ACOUSTIC CEILING TILE
AWD	ACOUSTIC WOOD CEILING SYSTEM
CMU	CONCRETE MASONRY UNIT
OPT	CARPET
EXIST	EXISTING
FF	FACTORY FINISH
GWB	GLASS
LVT	GYPSUM WALLBOARD
PTD	LUXURY VINYL TILE
P-VCT	PATCH VINYL COMPOSITE TILE
RB	RUBBER BASE
VCT	VINYL COMPOSITE TILE

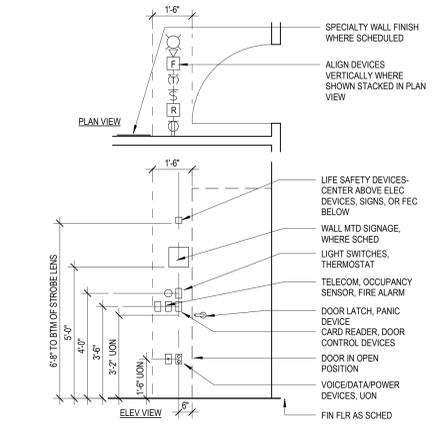

1 DEVICE ALIGNMENT
3/8" = 1'-0"

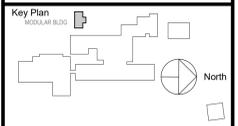

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Job No.	2021-1067	Date	MARCH 11 2022
Scale	As indicated	Drawn / Checked	MA WH
Sheet Number	A202		

DOOR & WINDOW SCHEDULES & DETAILS

Issue	06/24/2022	ISSUE FOR BID
Issue	03/11/2022	CONSTRUCTION DOCUMENTS


2021 COVID RELATED CAPITAL PROJECTS

2021 COVID RELATED CAPITAL PROJECTS
171 OSCAWANA LAKE ROAD,
PUTNAM VALLEY, NY 10579




NY SED PROJECT CONTROL NO.
ELEMENTARY SCHOOL 48-05-03-04-0-001-013
E.S. MODULAR 48-05-03-04-0-007-002
HIGH SCHOOL 48-05-03-04-0-010-006
TRANSPORT FACILITY 48-05-03-04-5-012-003


CONSTRUCTION DOCUMENTS

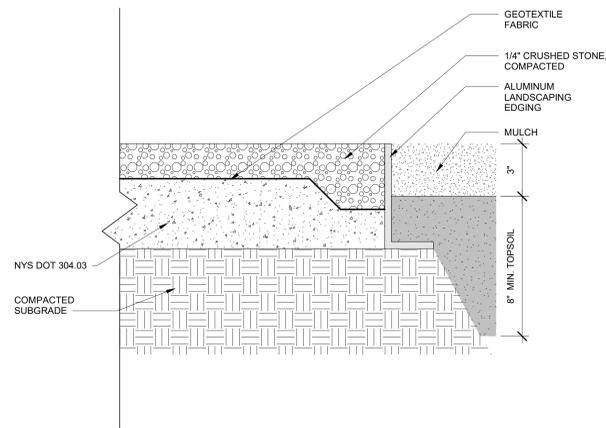


4 TYPICAL GRAVEL AND MULCH
3" = 1'-0"

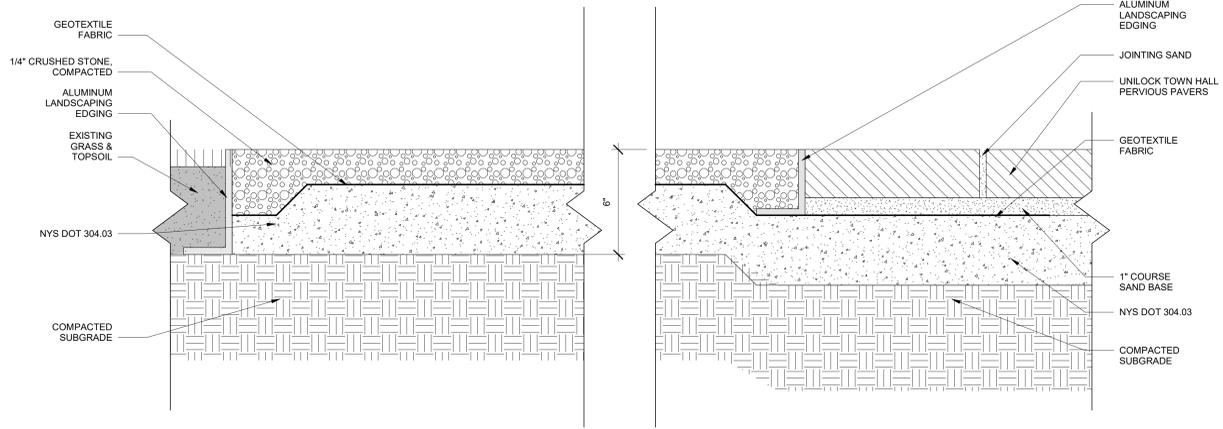


2 TYPICAL GRAVEL AND PAVER
3" = 1'-0"

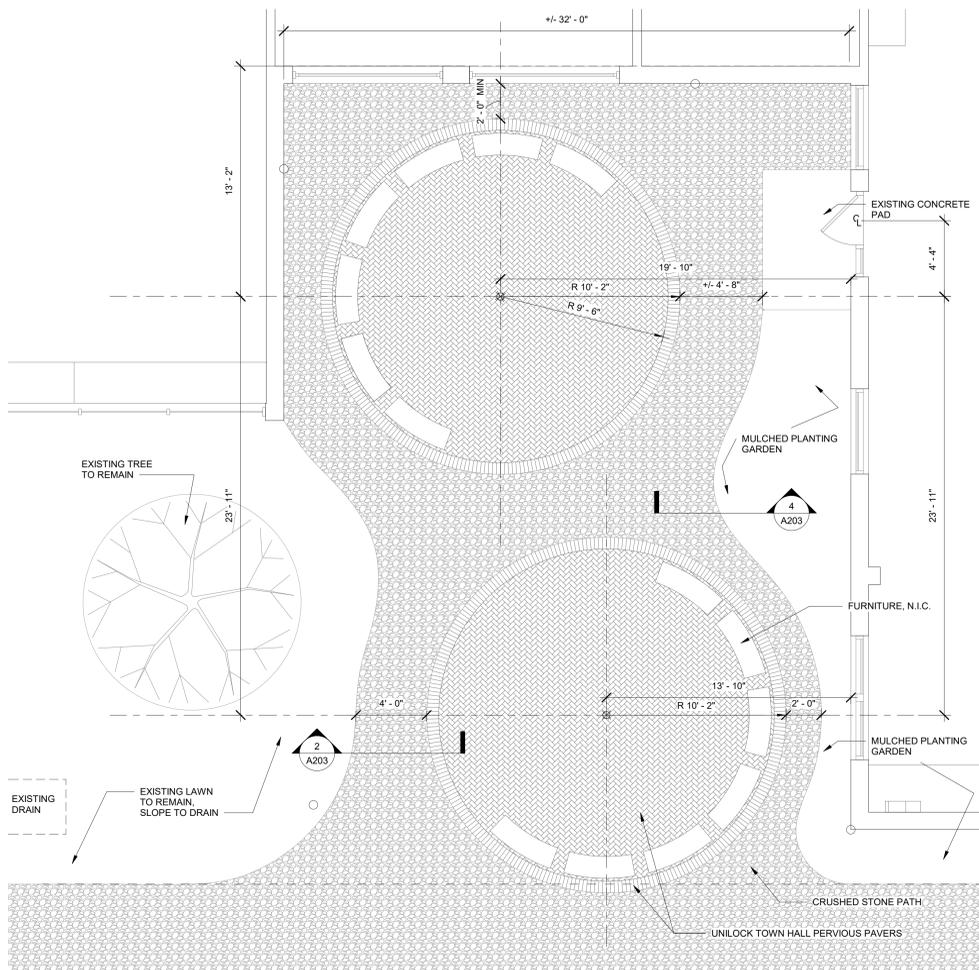

3 ENLARGED OUTDOOR LEARNING SPACE PLAN
1/4" = 1'-0"

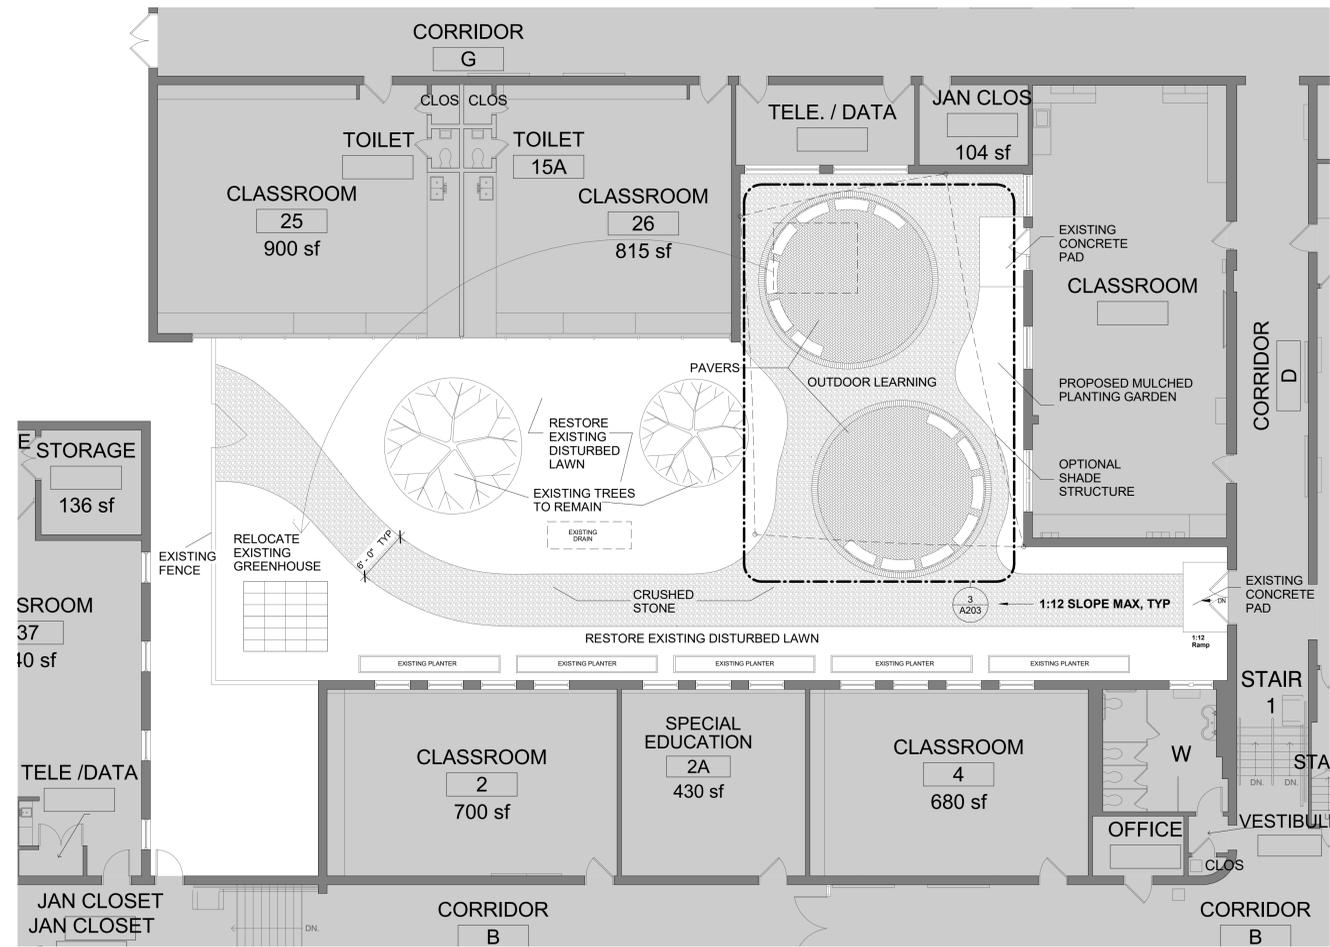

1 OUTDOOR LEARNING SPACE PLAN
1/8" = 1'-0"

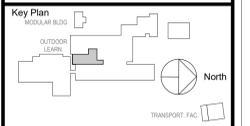

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Professional Seal

2	06/24/2022	ISSUE FOR BID
1	03/11/2022	CONSTRUCTION DOCUMENTS
No.	Date	Issue
Sheet Title		

ES OUTDOOR LEARNING SPACE PLANS AND DETAILS

Job No.	2021-1067	Date	JUNE 24, 2022
Scale	As indicated	Drawn / Checked	
Sheet Number	A203		

2021 COVID RELATED CAPITAL PROJECTS

171 OSCAWANA LAKE ROAD,
PUTNAM VALLEY, NY 10579




NY SED PROJECT CONTROL NO.
ELEMENTARY SCHOOL 48-05-03-04-0-001-013
E.S. MODULAR 48-05-03-04-0-007-002
HIGH SCHOOL 48-05-03-04-0-010-006
TRANSPORT FACILITY 48-05-03-04-5-012-003

CONSTRUCTION DOCUMENTS

FLOOR PLAN LEGEND

- AREA OF NO MAJOR ARCHITECTURAL WORK. SPECIFIC WORK MAY BE SHOWN ELSEWHERE INCLUDING WORK THAT MAY REQUIRE ACCESS, PATCHING & RESTORATION.
- EXISTING WALL TO REMAIN
- EXISTING WALL TO BE DEMOLISHED
- NEW PARTITION
- NEW DOOR, DOOR NUMBER

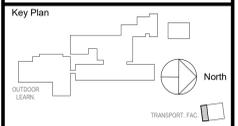

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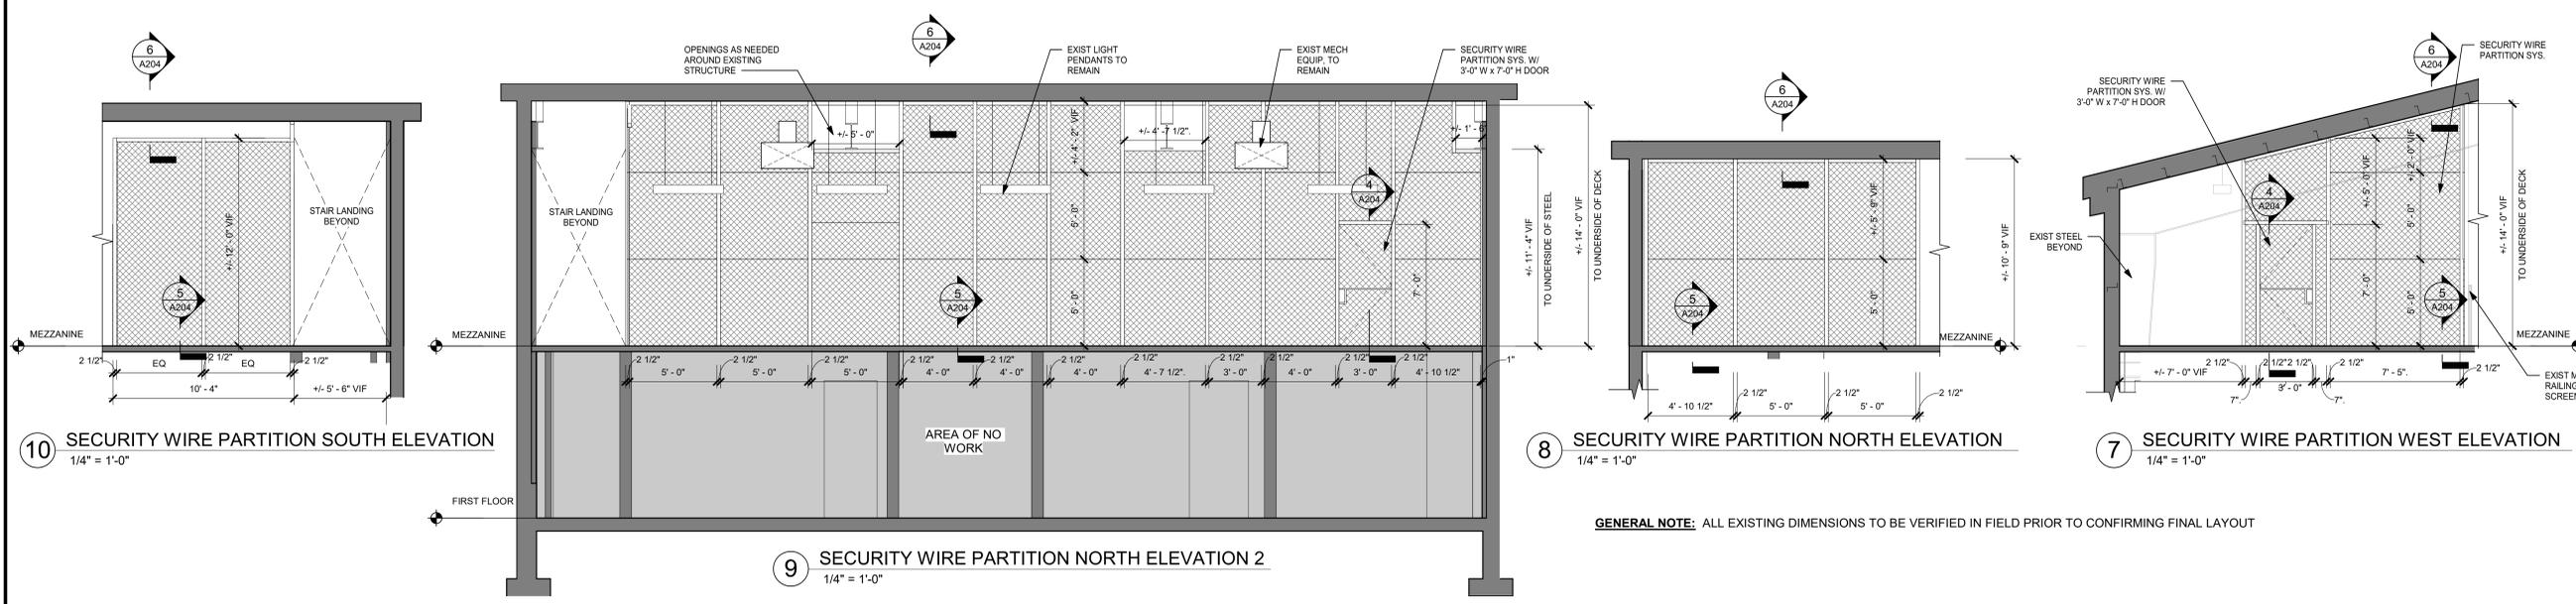
Professional Seal

2	06/24/2022	ISSUE FOR BID
1	03/11/2022	CONSTRUCTION DOCUMENTS
No.	Date	Issue




TRANSPORTATION BUILDING PLANS & INTERIOR DETAILS


Job No. 2021-1067 Date MARCH 11 2022
 Scale As indicated Drawn / Checked
 Sheet Number

A204




GENERAL NOTE: ALL EXISTING DIMENSIONS TO BE VERIFIED IN FIELD PRIOR TO CONFIRMING FINAL LAYOUT

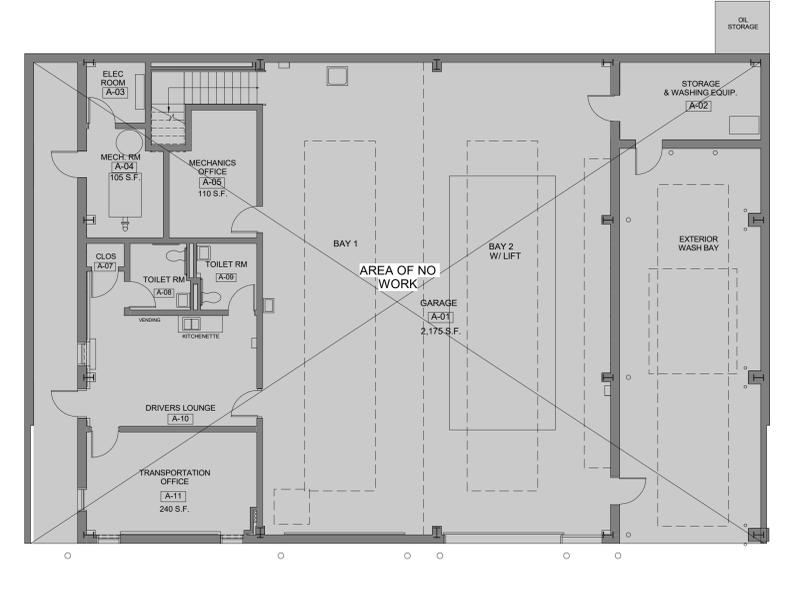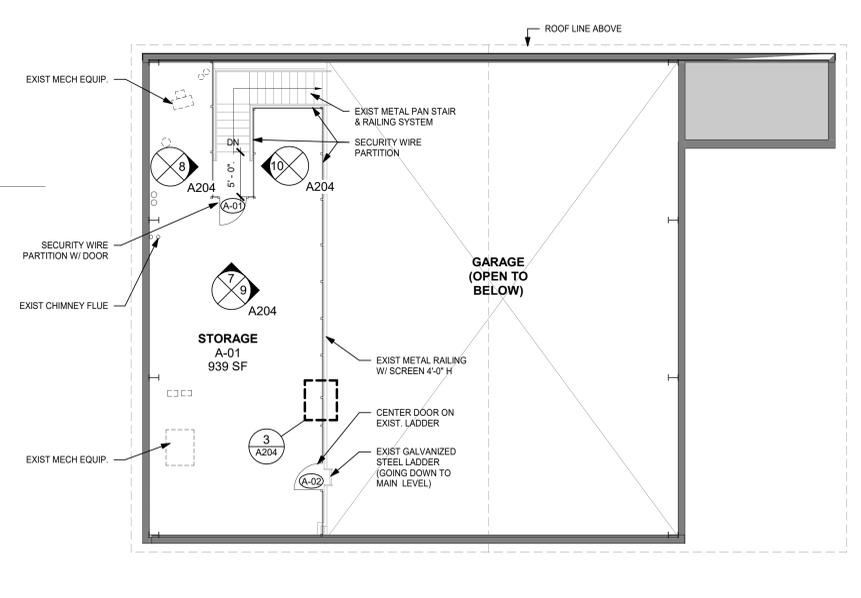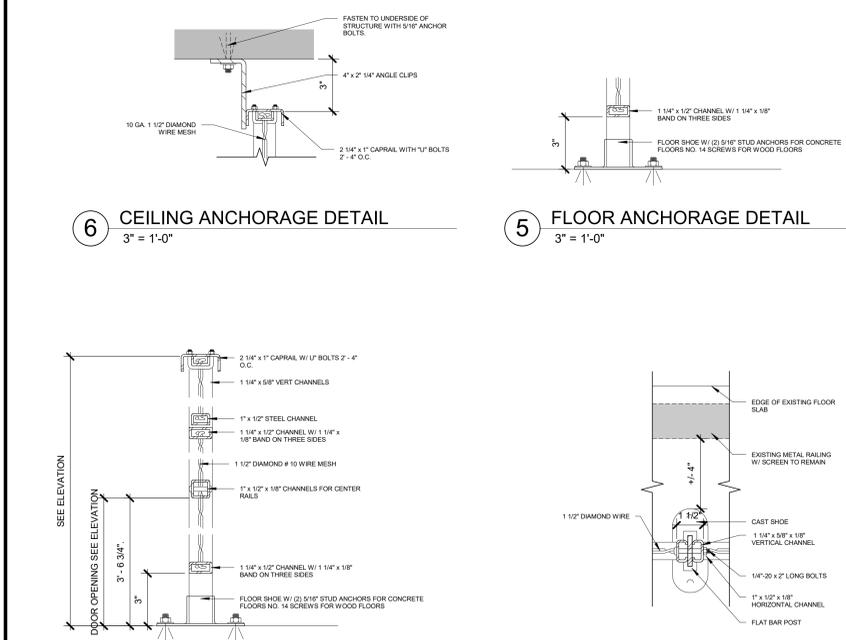


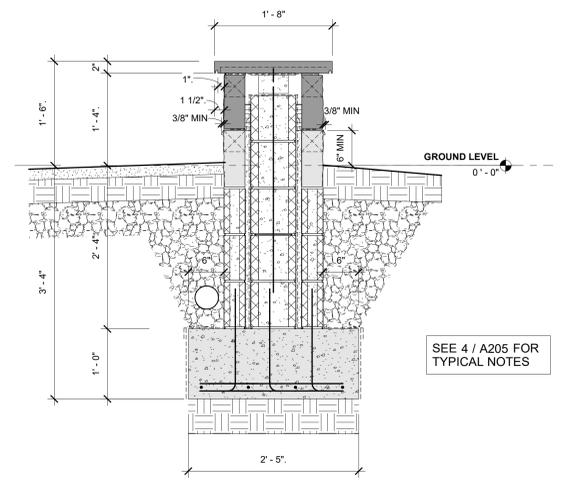


6 LEARNING WALL SINGLE TIER SECTION
 1" = 1'-0"

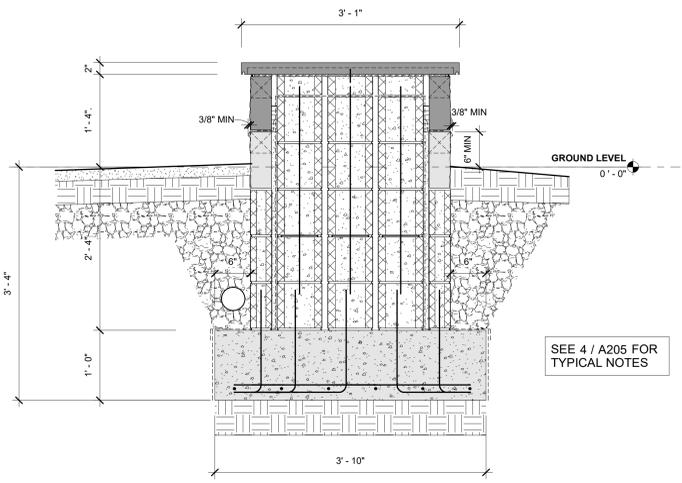


5 LEARNING WALL SINGLE TIER SECTION
 1" = 1'-0"

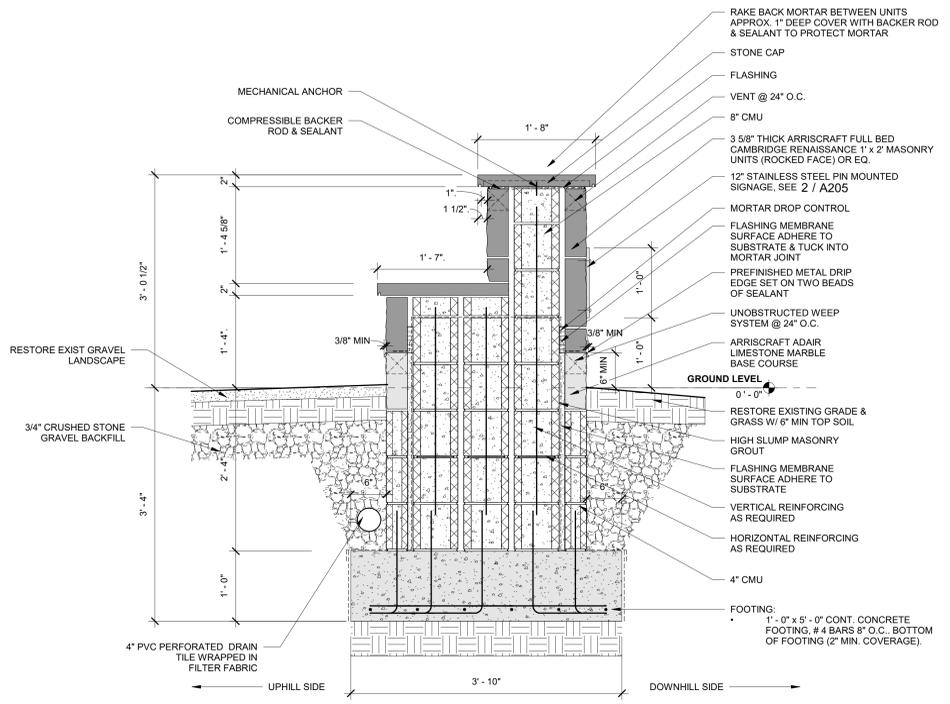


4 LEARNING TWO-TIERED SECTION
 1" = 1'-0"

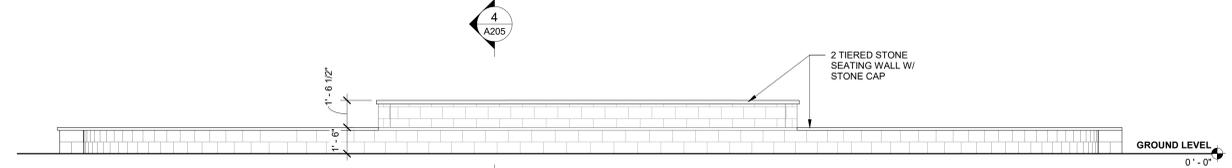


3 SOUTH COURTYARD LEARNING WALL ELEVATION
 1/4" = 1'-0"

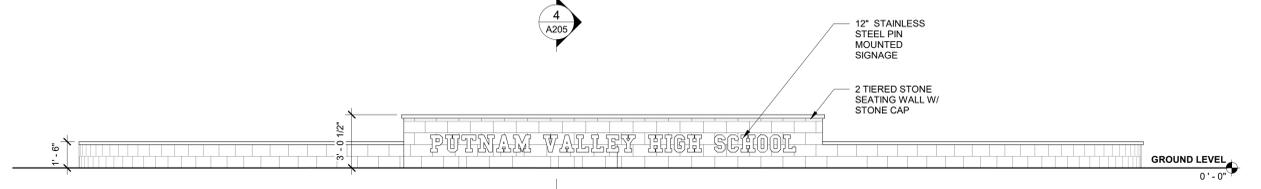

2 NORTH COURTYARD LEARNING WALL ELEVATION
 1/4" = 1'-0"

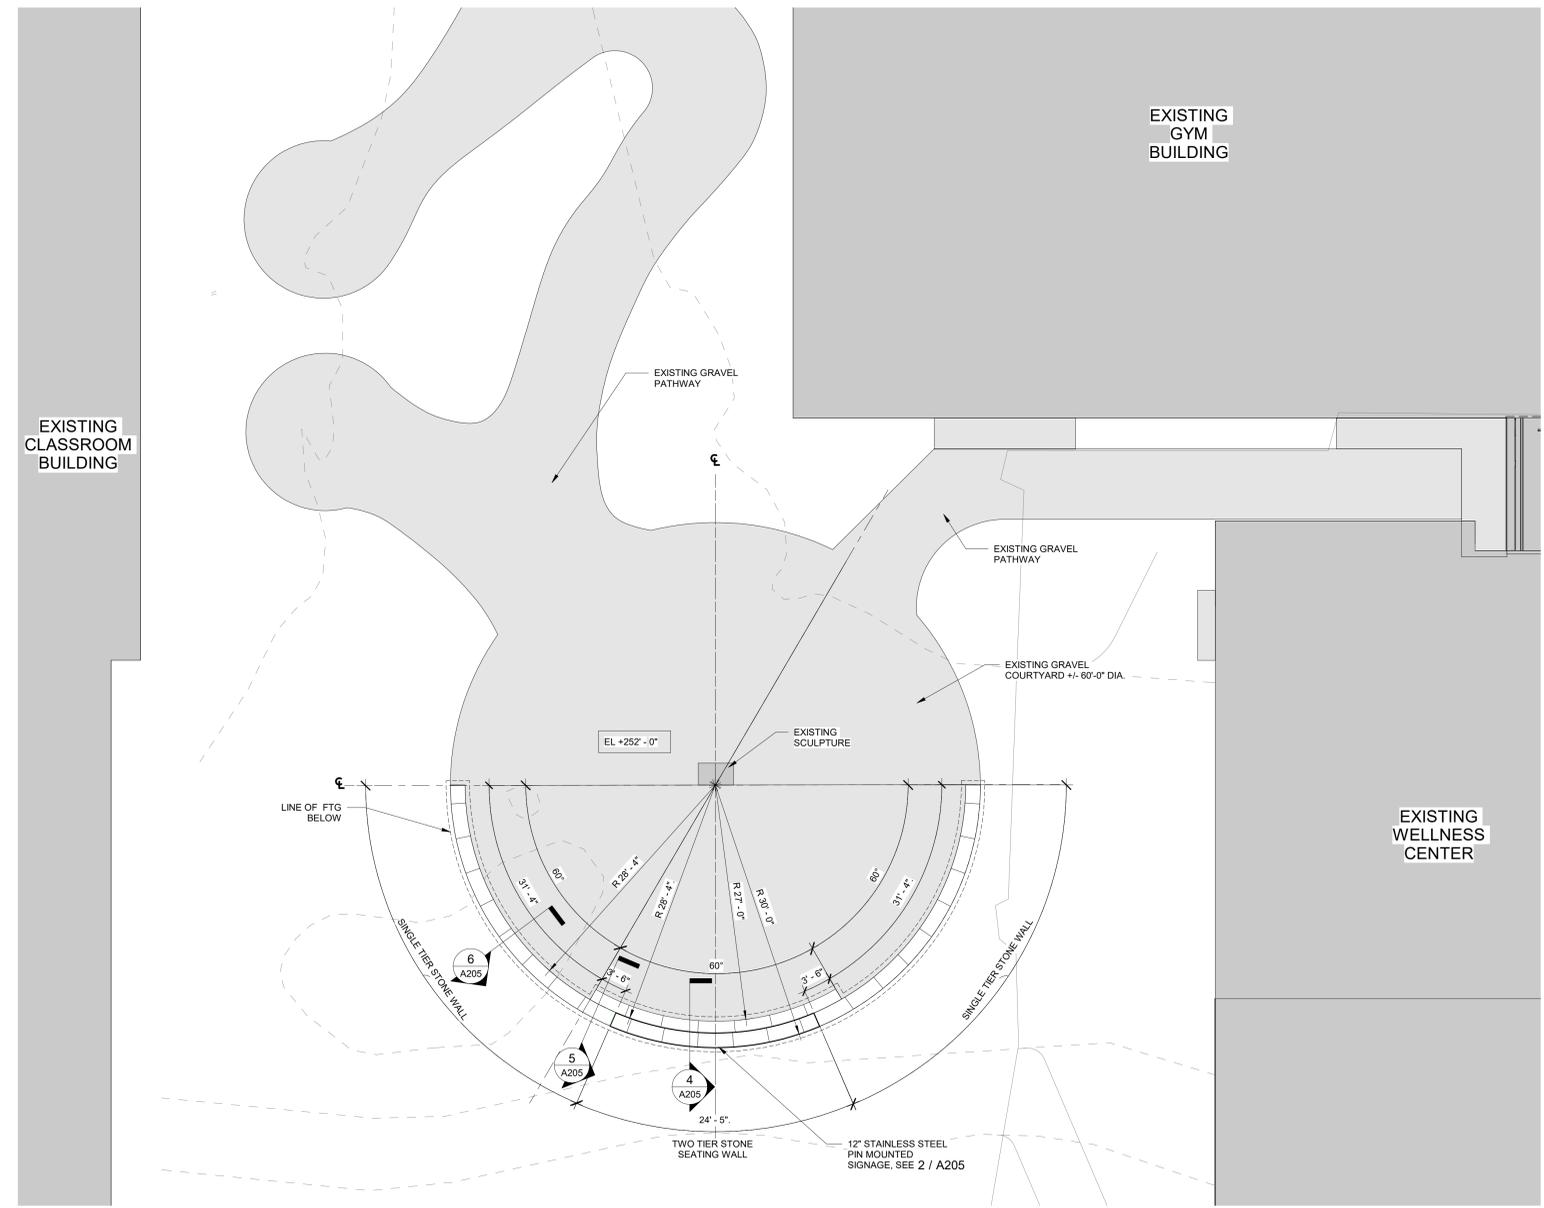

1 HIGH SCHOOL COURTYARD PLAN
 1/8" = 1'-0"

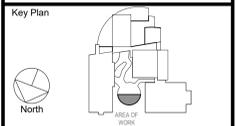

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Professional Seal	
Job No.	2021-1067
Date	MARCH 11 2022
Scale	As indicated
Drawn / Checked	
Sheet Number	A205

HS EXTERIOR LEARNING WALL PLAN & DETAILS

Job No.	2021-1067	Date	MARCH 11 2022
Scale	As indicated	Drawn / Checked	
Sheet Number	A205		