

POCANTICO HILLS CSD PHASE 1A - CAPITAL IMPROVEMENTS

599 BEDFORD RD, SLEEPY HOLLOW, NY 10591
CONTRACT DOCUMENTS

LIST OF DRAWINGS:

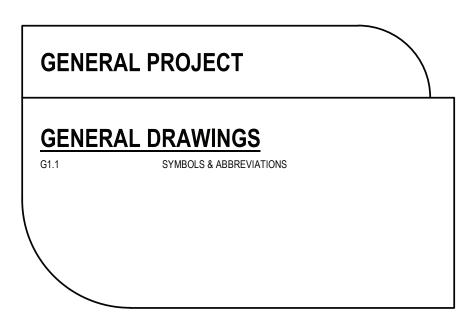

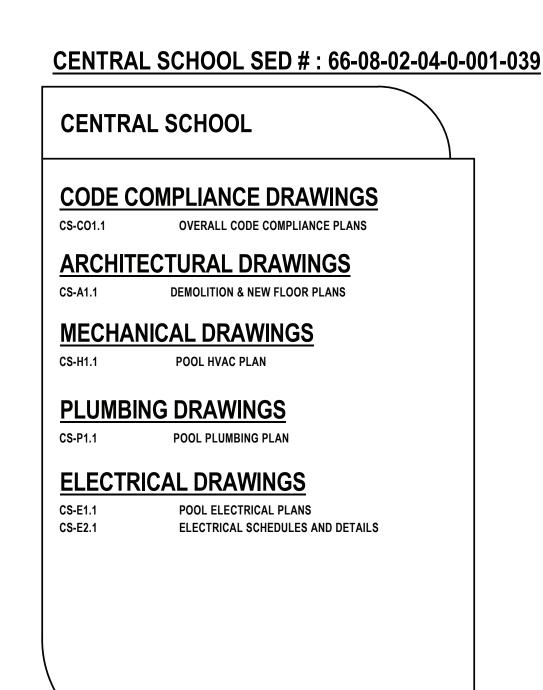



MAINTENANCE STORAGE BUILDING SED #: 66-08-02-2-006-001 MAINTAINENCE STORAGE BUILDING **CODE COMPLIANCE DRAWINGS** SITE CODE COMPLIANCE PLAN SITE DEMOLITION PLAN SITE IMPROVEMENT PLAN SITE UTILITY PLAN **OVERALL SITE UTILITY PLAN** SITE DETAILS MS-L6.2 STRUCTURAL DRAWINGS STRUCTURAL GENERAL NOTES, PLANS AND DETAILS ARCHITECTURAL DRAWINGS **ROOF AND CEILING PLAN** EXTERIOR ELEVATIONS **BUILDING SECTIONS AND DETAILS** DOOR AND WINDOW SCHEDULES PLUMBING DRAWINGS MORTON BUILDING PLUMBING PLAN **ELECTRICAL DRAWINGS** MORTON BUILDING ELECTRICAL PLANS **ELECTRICAL SCHEDULES AND DETAILS**





LEARNING • ACHIEVEMENT • GROWTH • DIRECTION

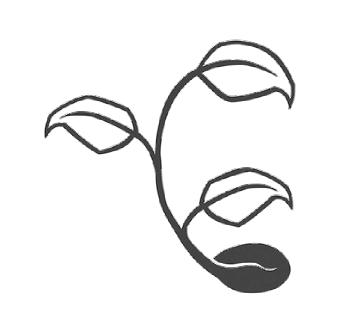

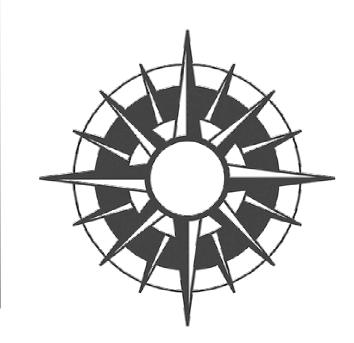



ISSUED FOR BID: 11/14/2022 HUNT PROJECT NUMBER: 3288.004

CENTRAL SCHOOL SED # : 66-08-02-04-0-001-039 MAINTENANCE STORAGE BUILDING SED # : 66-08-02-04-2-006-001

HUNT ENGINEERS | ARCHITECTS | SURVEYORS

1 Elizabeth Street, Suite 12, Towanda, PA 18848 P: 570-265-4868 F: 570-265-4872

Offices: Horseheads | Rochester | Towanda

PSI POUNDS PER SQUARE INCH

PTD PAPER TOWEL DISPENSER

PT POINT

SSK SERVICE SINK

STC SOUND TRANSMISSION COEFFICIENT

STA STATION

CJ CONTROL JOINT

CK CAULK(ING)

CLG CEILING

EWC ELECTRICAL WATER COOL

EWF ELECTRIC WALL FAN

EXC EXCAVATE

HM HOLLOW METAL

HOR HORIZONTAL

HP HORSEPOWER

MKBD MARKERBOARD

MMB MEMBRANE

MLD MOULDING, MOLDING

S H \mathcal{C} \forall \sim H H \mathbf{Z} \blacksquare Ŋ Z

DRAWN BY:

DATE

SCALE:

CHECKED BY:

JJH

KES

10/12/2022

12" = 1'-0"

& ABBREVIATIONS CAPITAL SYMBOLS & / PHASE 1A - C POCANTICO !


G1.1

PROJECT NO: 3288.004

WDW WINDOW

WF WALL FIN RADIATION

WG WIRE(ED) GLASS

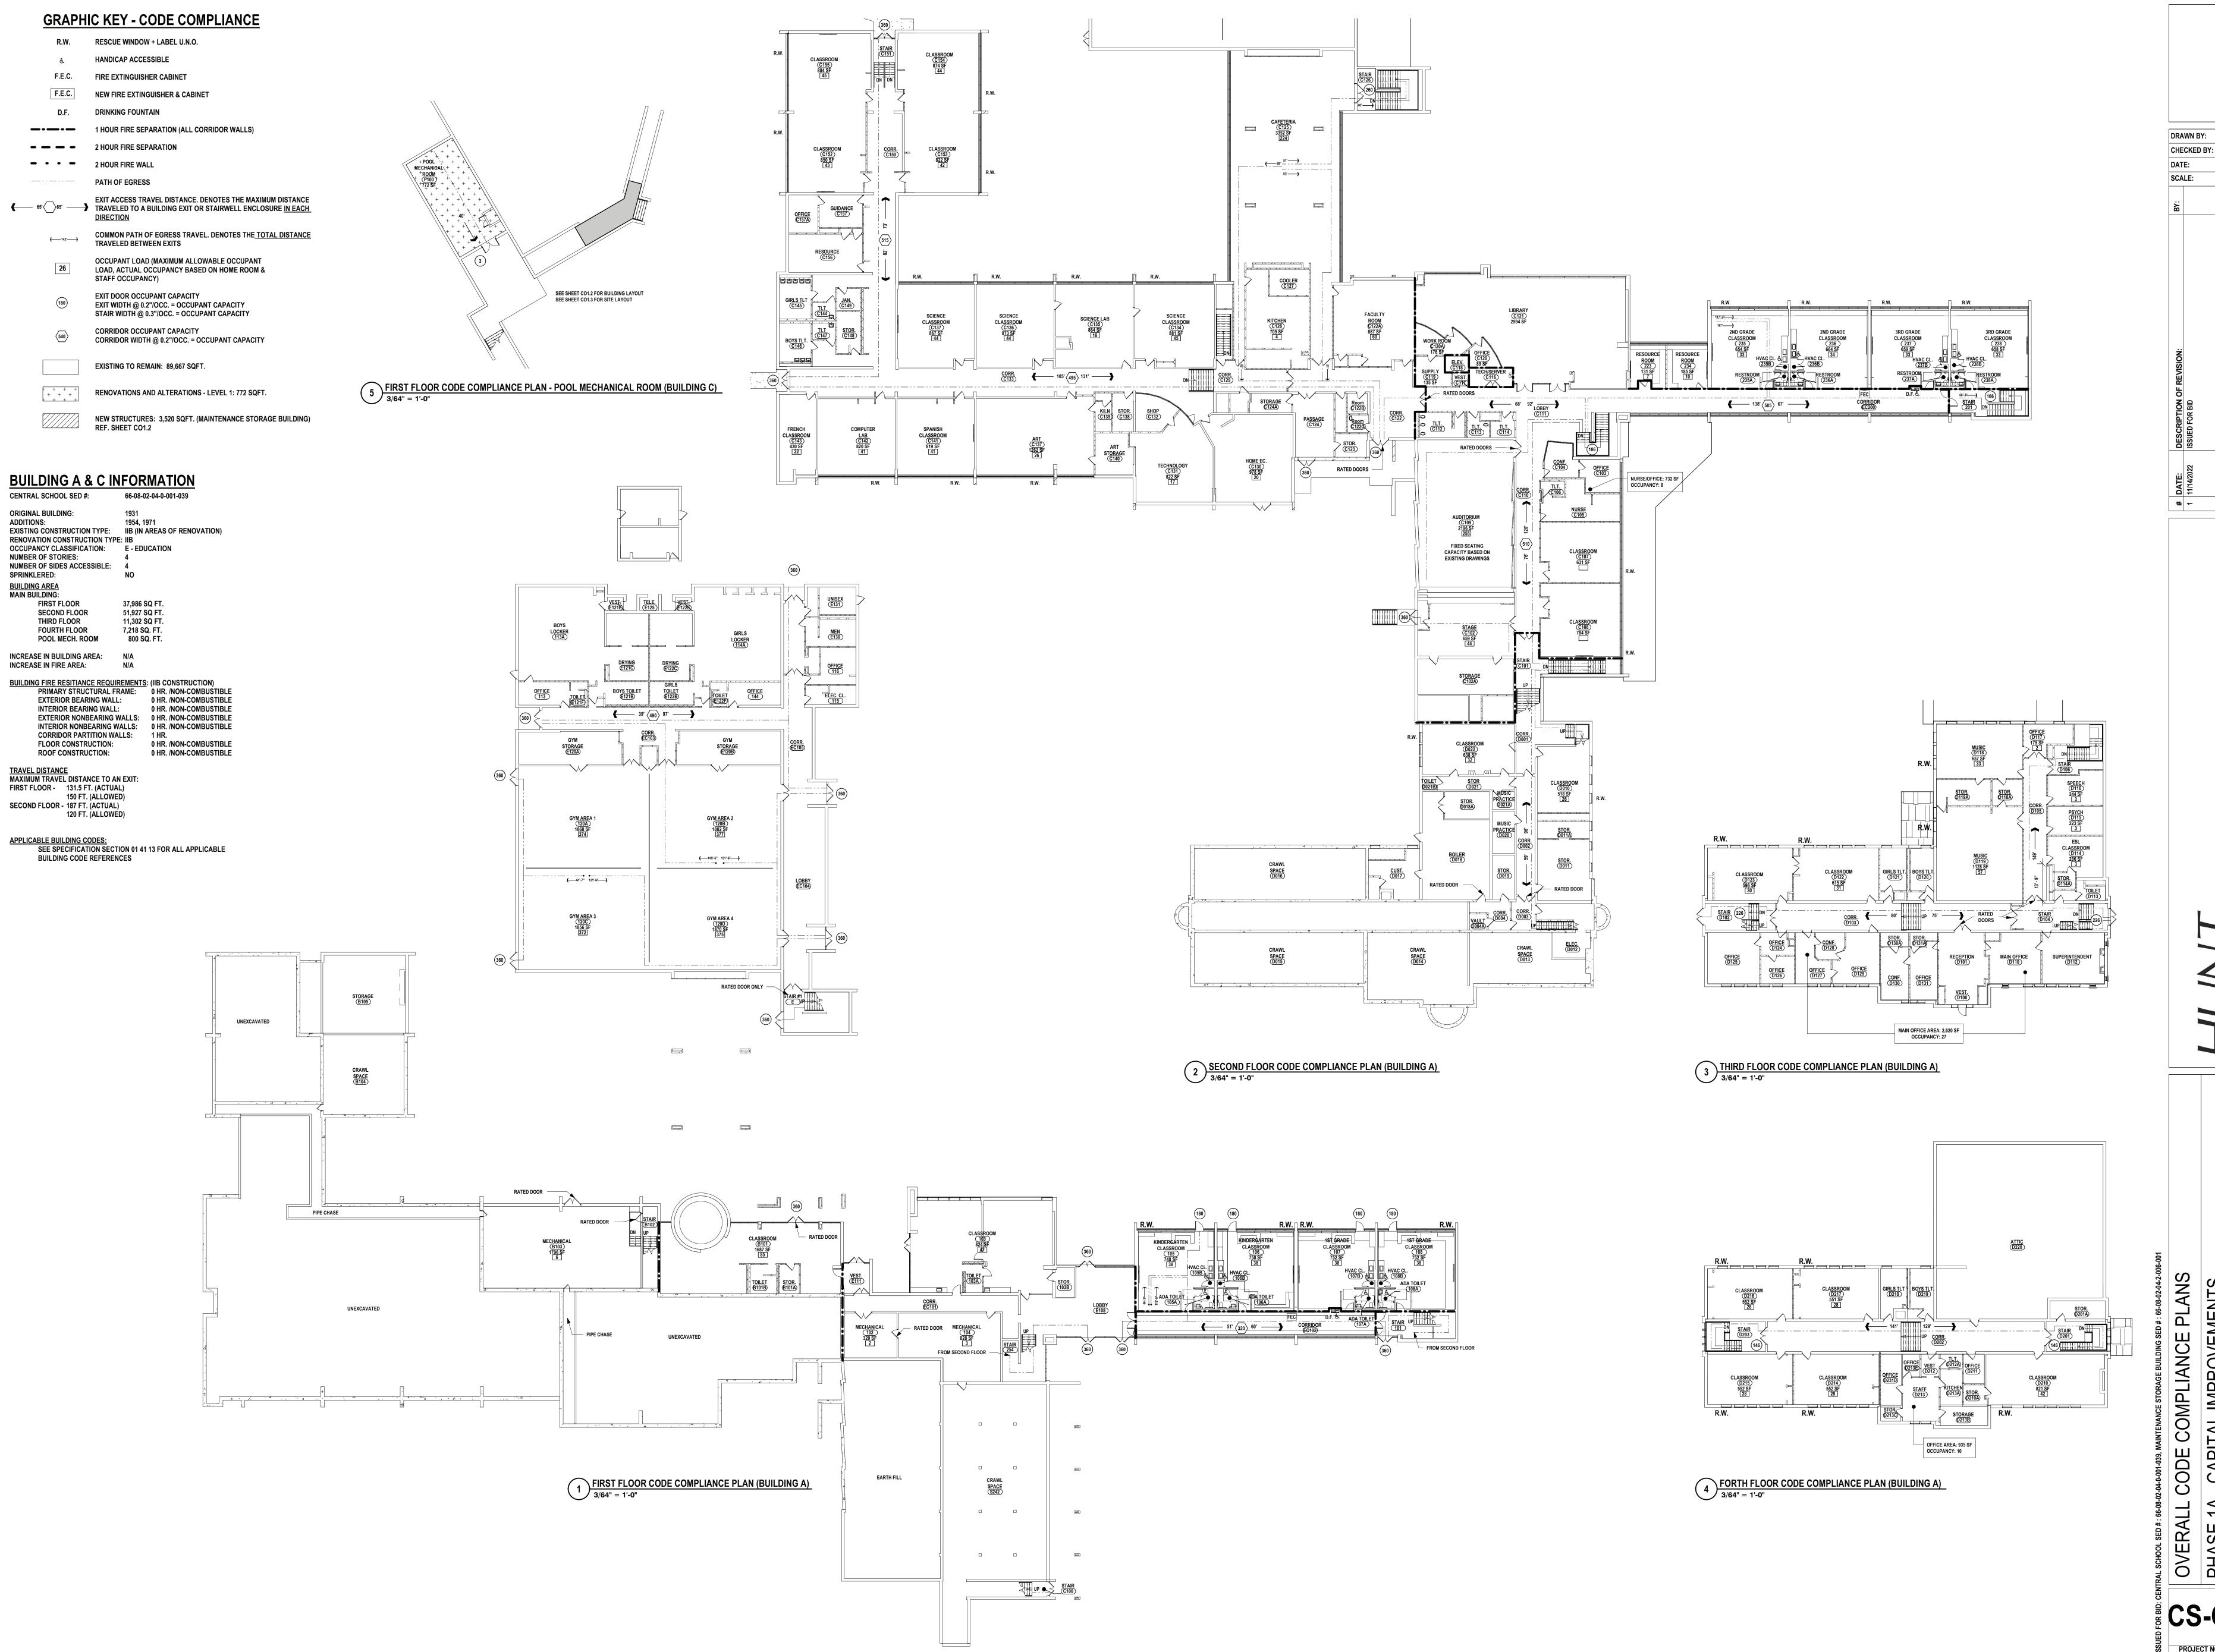

Z

10/12/2022

As indicated

© CS-CO1.1 PROJECT NO: 3288.004

MATERIAL NOT SCHEDULED IS ENCOUNTERED, STOP WORK IMMEDIATELY, DO NOT DISTURB THE MATERIAL AND NOTIFY THE OWNER'S REPRESENTATIVES. B CONTRACTOR TO PROVIDE PROTECTIVE BARRIER AT ALL AREAS OF DEMOLITION. KEEP ALL EXITS FREE AND CLEAR AT

ALL TIMES DURING FACILITY OPERATIONS.

C THE OWNER RESERVES THE RIGHT TO RETAIN ANY REMOVED ITEMS AFTER CONTRACTOR REMOVAL. THE CONTRACTOR SHALL REMOVE FROM THE SITE AND DISPOSE OF ALL REMOVED ITEMS THE OWNER DOES NOT WISH TO RETAIN. D CONTRACTOR SHALL PROTECT EXISTING CONSTRUCTION TO REMAIN AS REQUIRED DURING DEMOLITION. PATCH,

REPAIR, PAINT OR RE-FINISH EXISTING CONSTRUCTION MATERIALS AND FINISHES DAMAGED DURING DEMOLITION TO THIER ORIGINAL CONDITION.

DRAWN BY:

SCALE:

CHECKED BY:

KES/MWJ

10/12/2022

As indicated

S

H

 \sim

Z

5

E CONTRACTOR TO COORDINATE THE WORK OF THIS CONTRACT WITH THE WORK OF ALL OTHER CONTRACTED WORK AND WORK PERFORMED BY THE OWNER. F DIMENSIONS SHOWN FOR ALL NEW OPENINGS IN EXISTING CONSTRUCTION SHOULD BE COORDINATED WITH THE NEW PLANS AND EXISTING CONDITIONS IN THE FIELD.

G ITEMS SHOWN ARE INTENDED TO GIVE APPROXIMATE QUANTITY, LOCATION AND TYPE. CONTRACTOR IS RESPONSIBLE FOR VERIFYING ACTUAL QUANTITIES AND EXISTING FIELD CONDITIONS IN ORDER TO COMPLETE THE WORK. H COORDINATE ANY WALL/FLOOR REPAIR/INFILL THAT IS CAUSED BY THE REMOVAL OF EQUIPMENT BY OTHER PRIME CONTRACTORS AND PREPARE SURFACE TO RECEIVE NEW FINISHES.

I MAINTAIN EXISTING STRUCTURAL SYSTEMS AT ALL TIMES. PROVIDE TEMPORARY SHORING AND BRACING AT LOCATIONS WHERE THE EXISTING STRUCTURE IS BEING MODIFIED. PROTECT THE EXISTING STRUCTURE SCHEDULED TO REMAIN FROM DAMAGE DURING DEMOLITION. MAINTAIN SHORING AND BRACING UNTIL THE NEW STRUCTURE IS INSTALLED AND READY TO ACCEPT LOADS.

J GRINDING OF CONCRETE FLOORS AND SUBSTRATES OF DIFFERENT HEIGHTS IN THE SAME AREA IS REQUIRED AT WALL REMOVALS AND NEW DOORS IN EXISTING WALLS TO ALLOW THE NEW FINISHES TO ALIGN BETWEEN ADJACENT ROOMS AND ADJACENT ROOMS THAT BECOME ONE ROOM.

K ROOM NUMBERS INDICATED ARE EXISTING BUILDING NUMBERS. REFER TO NEW FLOOR PLANS FOR NEW ROOM

DEMOLITION NOTES:

D1 ALTERNATE 5: REMOVE EXISTING METAL DOORS, FRAME AND HARDWARE IN THEIR ENTIRETY.

D2 ALTERNATE 5: SCRAPE WALL, CEILING, AND FLOOR. PREP FOR WATERPROOFING AFTER REMOVAL OF EXISTING

MECHANICAL AND ELECTRIC EQUIPMENT.

FRAME TO RECIEVE NEW LOUVER.

D3 REMOVE INFILL PANEL ABOVE DOOR. CLEAN, AND/OR LIGHTLY SAND EXISTING FRAME TO REMOVE DEBRIS. PREPARE

D4 REMOVE CONCRETE PLATFORM UNDER PLUMBING EQUIPMENT. PREPARE AREA TO RECEIVE NEW CONCRETE PLATFORM. SEE NEW WORK PLAN FOR DETAILS


1 DEMOLITION PLAN - POOL MEHCANICAL ROOM
1/4" = 1'-0"

POOL

MECHANICAL

10' - 0"

MECHANICAL

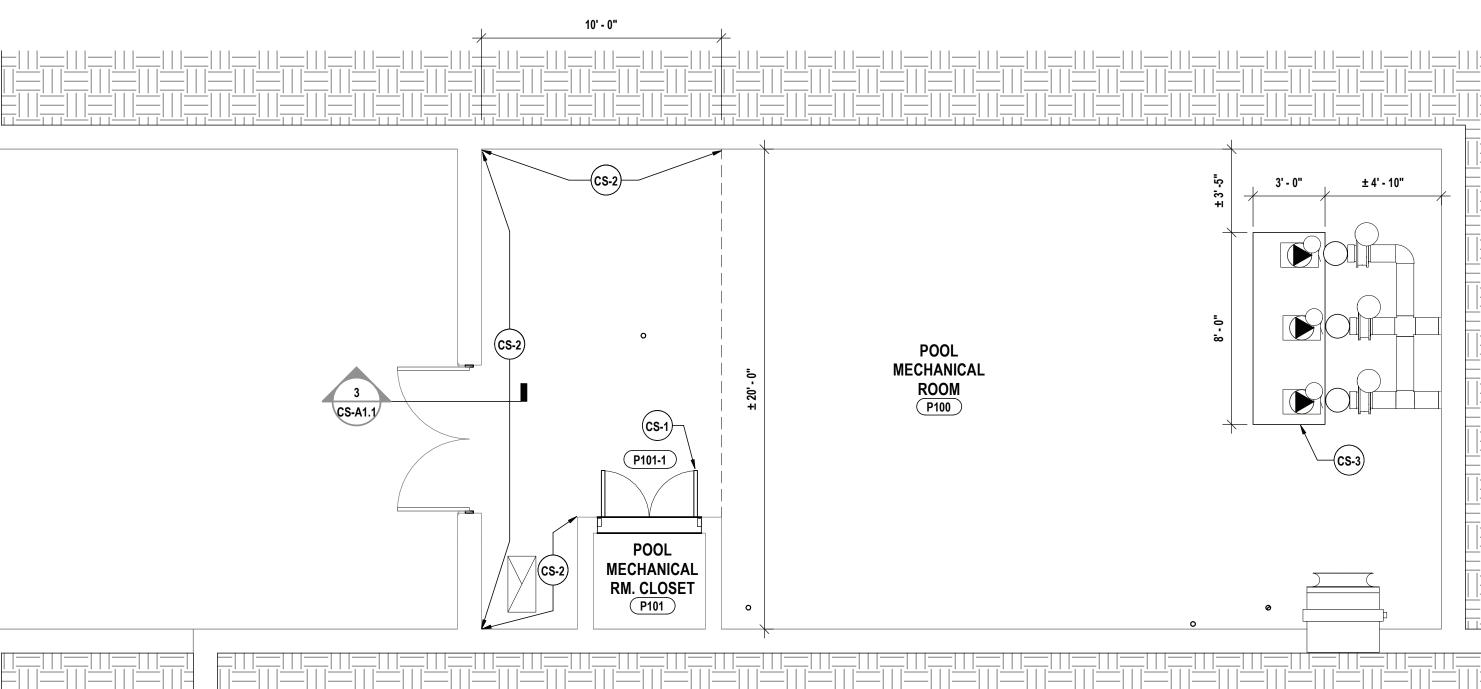

2 FLOOR PLAN - POOL MECHANICAL ROOM
1/4" = 1'-0"

GENERAL NOTES:

A THE CONTRACTOR IS RESPONSIBLE FOR ALL WORK REQUIRED TO IMPLEMENT THE WORK OF THE CONTRACT, REGARDLESS OF WHETHER SPECIFICALLY INDICATED OR NOT, UNLESS NOTED OTHERWISE.

B THE CONTRACTOR SHALL VERIFY ALL DIMENSIONS AND EXISTING CONDITIONS IN THE FIELD PRIOR TO COMMENCING ANY WORK AND NOTIFY ARCHITECT IMMEDIATELY IF ANY DISCREPANCIES ARE FOUND. C THE CONTRACTOR SHALL COORDINATE THE WORK OF THIS CONTRACT WITH THE WORK OF ALL OTHER CONTRACTED WORK AND

WORK PERFORMED BY THE OWNER. D ALL NEW DOOR FRAMES INSTALLED IN METAL STUD OR MASONRY PARTITIONS SHALL BE MOUNTED 4" FROM ADJACENT WALLS (6" TO DOOR). TOOTH IN CMU BLOCK AND ANCHORS AT DOORS IN EXISTING CMU WALLS, UNLESS NOTED OR DETAILED

E PROVIDE SOLID WOOD BLOCKING OR METAL STRAPPING AS REQUIRED IN METAL STUD WALLS AT ALL WALL MOUNTED EQUIPMENT AND ACCESSORIES INCLUDING FURNITURE FIXTURES AND EQUIPMENT. COORDINATE WITH THE WORK OF ALL OTHER CONTRACTED WORK AND WORK PERFORMED BY THE OWNER. F ITEMS SHOWN ARE INTENDED TO GIVE APPROXIMATE QUANTITY, LOCATION & TYPE. THE CONTRACTOR IS RESPONSIBLE FOR

VERIFYING ACTUAL QUANTITY & EXISTING FIELD CONDITIONS. G ALL DIMENSIONS ARE TAKEN FROM FACE OF WALL TO FACE OF WALL. UNLESS NOTED OTHERWISE. H THERE SHALL BE A MINIMUM OF 1'-6" CLEAR FLOOR SPACE ON THE PULL SIDE OF ALL NEW DOORS; THERE SHALL BE A MINIMUM

I THE WHEELCHAIR SYMBOL INDICATES HANDICAP ACCESSIBLE MOUNTED FIXTURE ELEVATION AND SHALL CONFORM WITH CABO/ANSI A117.1 AND ADAAG. J ALL FINISHED ASSEMBLIES ARE REQUIRED TO BE PROTECTED DURING THE COURSE OF CONSTRUCTION. ALL FINISHED ASSEMBLIES DAMAGED DURING THE COURSE OF CONSTRUCTION ARE REQUIRED TO BE REPLACED OR REPAIRED AT THE

CS-1 ALTERNATE 5: PROVIDE NEW METAL DOORS, FRAME, AND HARDWARE, SEE DOOR SCHED. FOR MORE INFO CS-2 ALTERNATE 5: PROVIDE NEW CRYSTALLINE WATERPROOFING ON WALLS, FLOOR, AND CEILING BEFORE INSTALLATION OF NEW MECHANICAL AND ELECTRICAL EQUIPMENT.

DETAILS, COORDINATE WITH PLUMBING CONOTRACTOR FOR EXACT LOCATION.

CS-A1.1

PROJECT NO: 3288.004

DOOR TYPE FRAME TYPE DOOR & FRAME ELEVATIONS

1/4" = 1'-0" **DOOR SCHEDULE** DOOR **FRAME DETAIL NOTES** SET TYPE MATL. FINISH HEAD JAMB SILL PR @ 2' - 0" x 7' - 0" 1 3/4" SS

- EXHAUST FAN, SEE H-DWGS.

- POOL MAIN GRADE

EXG. 12" CONCRETE WALL (BEYOND) -

INSTALL LOUVER FURNISHED BY

+/- 1' - 0"


3 POOL FILTER RM SOUTH DOOR SECTION
3/4" = 1'-0"

A

HC, SEAL AROUND EDGES OF

EXG. STAINLESS STEEL

EXG. DOOR -

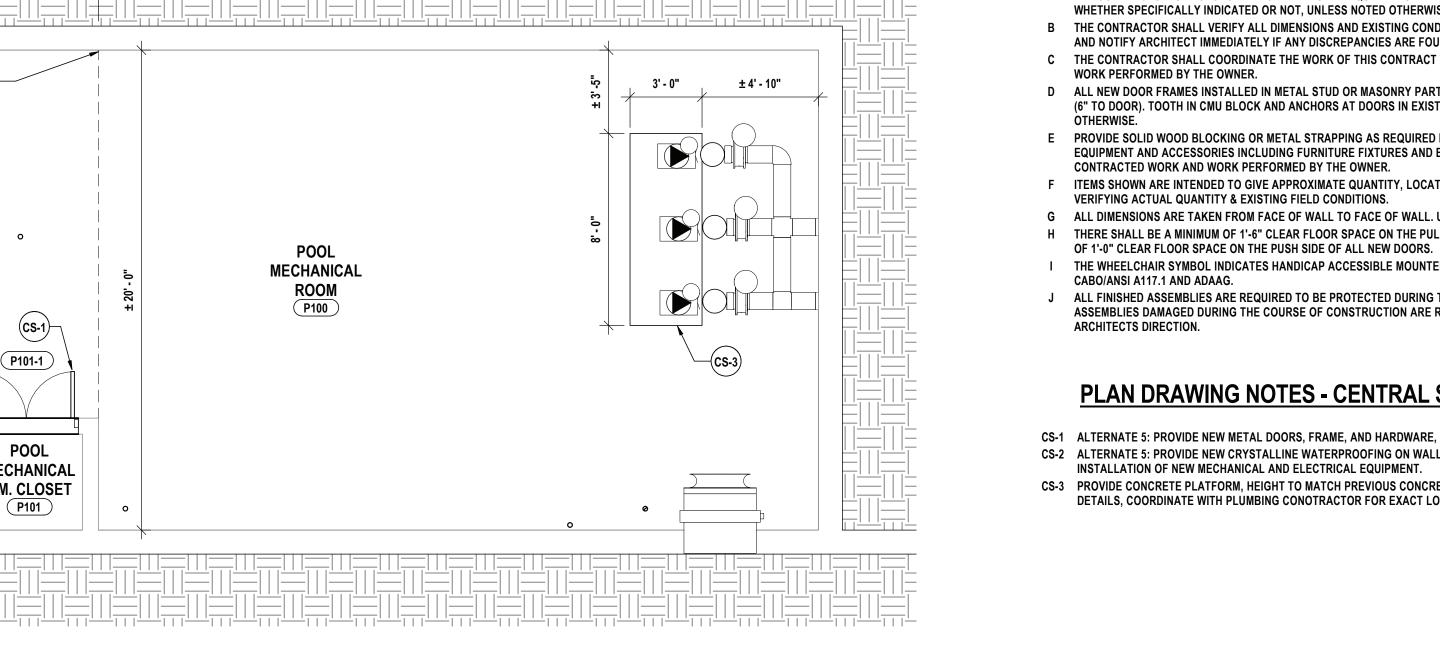

PLAN DRAWING NOTES - CENTRAL SCHOOL:

CS-3 PROVIDE CONCRETE PLATFORM, HEIGHT TO MATCH PREVIOUS CONCRETE PLATFORM, SEE S-DWGS FOR

				ELEC1	TRIC UNIT	HEAT	ER SO	CHEDUI	LE			
UNIT			HTG. CO	OIL DATA			ELECTRICA	A L				
NUMBER	LOCATION	CFM	MBH	TEMP RISE	AIR THROW (FT)	CONTROL VOLTAGE	VOLTS	PHASE	AMPS	MANUFACTURER/MODEL	REMARKS & NOTES	
UH-1	CS-H1.1	580	25.6	41.4	24	24	480	3	9.7	TRANE UHXA	TRANE 1,2,3	


1. PROVIDE WITH WALL MOUNTED LOW VOLTAGE THERMOSTAT. 2. PROVIDE FACTORY INSTALLED AND WIRED DISCONNECT MOUNTED TO HEATER W/ SINGLE POINT POWER CONNECTION. 3. PROVIDE MANUFACTURERS MOUNTING HARDWARE FOR CEILING MOUNTING & 1/2" PIPE, CUT AND THREADED FOR INSTALLATION.

			FA	N SC	HEDL	JLE				
FAN	LOCATION	CFM	MODEL	RPM	ELE	CTRICAL	SONES	SP	DRIVE	REMARKS & NOTES
.,,,,	200/111011	0	1110522	1.0.10	HP	V/PH.	001120	5 i	514172	TEMP II ING GITTO I EG
EF-1	CS-H1.1	150	8CV15D	1342	0.05	120/1	4	0.25	DIRECT	1,2,3,4
EF-2	CS-H1.1	2850	16CV17D	1280	2	208/3	20	0.50	DIRECT	2,3,4,6
EF-3	CS-H1.1	3000	24EW412D11	1073	1	208/3	16	0.15	DIRECT	2,3,4,5,7

- NOTES:
 - PROVIDE ECM MOTOR. 2. PROVIDE FACTORY WIRED & MOUNTED DISCONNECT.
 - 3. PROVIDE MOTORIZED BACKDRAFT DAMPER. START/STOP BY DDC. 5. PROVIDE WALL SLEEVE, FAN GUARD, RAIN HOOD & VFD.
 - PROVIDE VFD. 7. INTERLOCK AAD WITH EF-1 & EF-2.

66"x18" EXHAUST LOUVER EF-2 28"x14"- 28"x14" DOWN			POOL MECHANICAL ROOM P100	<u>EF-3</u>
TO 12" AFF	OED	UH-1		AAD AAD

1 POOL FILTER RM. HVAC PLAN
1/4" = 1'-0"

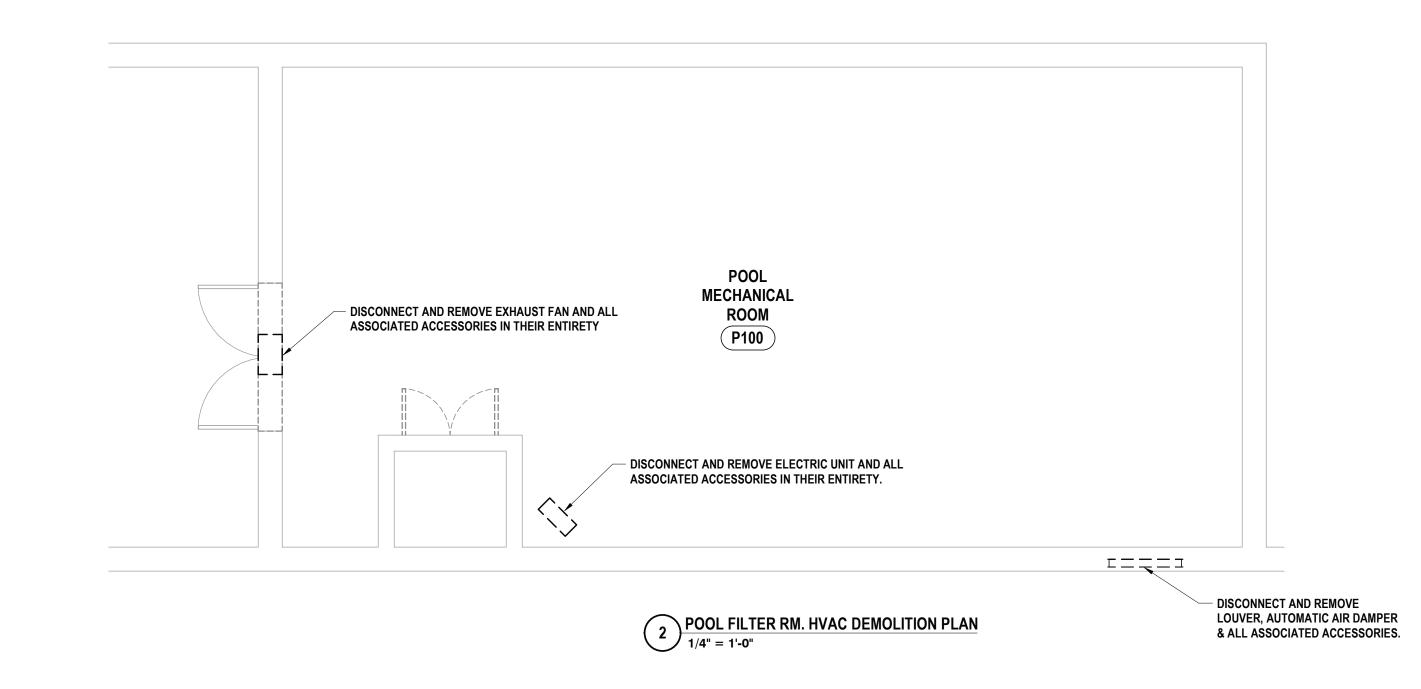

GENERAL NOTES - MECHANICAL


A ALL EQUIPMENT INTENDED TO BE TURNED OVER TO THE OWNER, SHALL BE BALANCED, FULLY CONTROLLED & FUNCTIONALLY TESTED REGARDLESS OF SUBSTANTIAL COMPLETION DATE.

C ALL ITEMS SCHEDULED FOR DEMOLITION ARE THE PROPERTY OF

- B THIS DRAWING IS INTENDED TO SHOW THE GENERAL SCOPE OF ITEMS TO BE REMOVED. IT IS NOT INTENDED TO BE ALL INCLUSIVE. THE CONTRACTOR SHALL FIELD VERIFY ALL ITEMS TO BE REMOVED. ANY ITEM IN QUESTION SHOULD BE VERIFIED WITH THE ENGINEER PRIOR TO REMOVAL.
- THE OWNER. THE CONTRACTOR SHALL PLACE WANTED EQUIPMENT IN AREA DESIGNATED, ON SITE BY THE OWNER. ANY ITEM THE OWNER WISHES NOT TO KEEP SHALL BE DISPOSED OF BY THE CONTRACTOR. D THE CONTRACTOR WILL BE RESPONSIBLE FOR ALL CUTTING AND PATCHING UNLESS CLEARLY INDICATED TO BE PART OF ANOTHER
- PRIME CONTRACT. CONTRACTOR TO PATCH TO MATCH ALL EXISTING FINISHES RESULTING FROM DEMOLITION WORK UNLESS INDICATED TO BE PART OF ANOTHER PRIME CONTRACT. E THE CONTRACTOR SHALL REMOVE, PROTECT, REPLACE AND/OR REINSTALL ANY CEILING OR GRID DAMAGED OR REMOVED AS A
- RESULT OF EXECUTION OF CONTRACT SCOPE. UNLESS INDICATED TO BE PART OF ANOTHER PRIME CONTRACT. F COORDINATE ALL NEW ROOF, WALL, AND FLOOR PENETRATIONS
- WITH OTHER TRADES. G PRIOR TO CONSTRUCTION AND INSTALLATION OF NEW WORK, THE CONTRACTOR SHALL FIELD VERIFY ALL EXISTING CONDITIONS (FRAMING, ELECTRICAL, PLUMBING, HVAC, ETC.).

MODIFICATION TO NEW HVAC SYSTEM INSTALLATION.

NOTIFY ARCHITECT/ENGINEER OF ANY CONFLICTS THAT REQUIRE

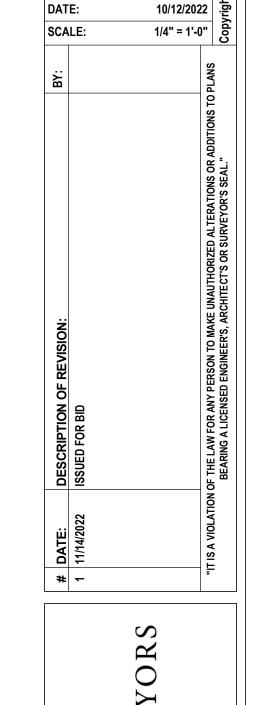

DRAWN BY:

CHECKED BY:

MAC

JDG

 Γ S 6

CS-H1.1

S

H

— ≥ \sim

EE

Z

GI

 \mathbf{Z}

TO BE PART OF ANOTHER CONTRACT. THESE DRAWINGS ARE INTENDED TO SHOW THE GENERAL SCOPE OF ITEMS TO BE REMOVED. IT IS NOT INTENDED TO

BE ALL INCLUSIVE. THE CONTRACTOR SHALL FIELD VERIFY ALL ITEMS TO BE REMOVED. ANY ITEM IN QUESTION SHOULD BE VERIFIED WITH ENGINEER PRIOR TO REMOVAL C ALL ITEMS SCHEDULED FOR DEMOLITION ARE THE PROPERTY OF THE OWNER. THE CONTRACTOR SHALL PLACE WANTED EQUIPMENT IN AREA DESIGNATED ON SITE

SHALL BE PROPERLY DISPOSED OF BY THE CONTRACTOR. THE CONTRACTOR SHALL REMOVE, PROTECT, REPLACE AND/OR REINSTALL ANY CEILING OR GRID DAMAGED OR REMOVED AS A RESULT OF EXECUTION OF CONTRACT

SCOPE. UNLESS OTHERWISE INDICATED TO BE PART OF ANOTHER PRIME CONTRACT. THE PLUMBING CONTRACTOR SHALL FIELD VERIFY ALL **EXISTING CONDITIONS (FRAMING, ELECTRICAL, PLUMBING,** HVAC, ETC) PRIOR TO CONSTRUCTION AND INSTALLATION

PLUMBING SYSTEM INSTALLATION. THE CONTRACTOR IS TO REINSULATE ALL PORTIONS OF

EXECUTION OF CONTRACT SCOPE. G THE PLUMBING CONTRACTOR WILL BE RESPONSIBLE FOR ALL NEW FLOOR OPENINGS, EXCAVATIONS OF EXISTING SUBSTRATES AND WALL PENETRATIONS TO INSTALL NEW PIPING. UNLESS OTHERWISE NOTED, ALL PIPE

H UNLESS NOTED OTHERWISE THE PLUMBING CONTRACTOR 5 FEET FROM BUILDING. COORDINATE CONNECTIONS. THE PLUMBING CONTRACTOR WILL BE RESPONSIBLE FOR

OTHERWISE NOTED. J THE PLUMBING CONTRACTOR TO COORDINATE ALL NEW ROOF, WALL & FLOOR PENETRATIONS.

STEEL STRUCTURE AS POSSIBLE. M THE CONTRACTOR WILL BE RESPONSIBLE FOR FINAL CONNECTION OF PLUMBING UTILITIES TO ALL EQUIPMENT

BY OTHERS. COORDINATE AS REQUIRED. THE CONTRACTOR IS TO PROVIDE ADA COMPLIANT VINYL PIPE COVER ON EXPOSED COLD WATER, HOT WATER AND SANITARY PIPING BELOW ADA LAVATORY/SINK. SANITARY PIPE COVER SHALL BE INSTALLED UP TO BOTTOM OF

O REFER TO ARCH DRAWINGS FOR INDICATION OF ADA FIXTURES & ACCESSORIES, & ASSOCIATED MOUNTING

DEMOLITION NOTES - PLUMBING

DISCONNECT AND REMOVE CORRODED STRUT CHANNEL AND FASTENERS, PREPARE FOR CONNECTION OF NEW. COORDINATE WITH ELECTRICAL CONTRACTOR.

BACK TO POINT INDICATED.

D2 DISCONNECT AND REMOVE CORRODED VENT PIPING IN ITS ENTIRETY. PREPARE FOR NEW. D3 DISCONNECT AND REMOVE EXISTING VALVE, PREPARE FOR CONNECTION OF NEW. COORDINATE WITH ELECTRICAL CONTRACTOR.

D4 EXISTING FASTENERS TO BE REPLACED, REFER TO P1.2/3 FOR DETAILS. D5 DISCONNECT AND REMOVE DOMESTIC WATER PIPING, ISOLATION

VALVES, & PIPE SUPPORTS BACK TO POINTS INDICATED. DISCONNECT, RETAIN, AND PROTECT PUMPS AND FILTER FOR REINSTALLATION. DISCONNECT AND REMOVE VALVES AND PIPING

REMOVE EXISTING HOUSE KEEPING PAD IN ITS ENTIRETY. PREPARE FOR INSTALLATION OF NEW.

CONSTRUCTION NOTES - PLUMBING

1 PROVIDE NEW DOMESTIC WATER PIPING, ISOLATION VALVES, & PIPE SUPPORTS BETWEEN EXISTING INCOMING DOMESTIC WATER AND EXISTING RPZ ALL SIZED TO MATCH EXISTING. EXISTING WATER METER

TO BE RE-USED. 2 PROVIDE NEW STRUT CHANNEL AND FASTNERS TO MATCH EXISTING, COORDINATE WITH ELECTRICAL CONTRACTOR. PROVIDE NEW FASTNERS ON ALL FLANGES ASSOCIATED WITH PUMP, QTY (50) FASTNERS SIZED TO MATCH EXISTING. 3 PROVIDE NEW ELECTRONICALLY ACTUATED VALVE SIZED TO MATCH

EXISTING. COORDINATE WITH ELECTRICAL CONTRACTOR. 4 PROVIDE NEW PVC VENT PIPING IN SAME LOCATION & SIZE AS DEMOED


5 SEWER MANHOLE COVER TO BE CLEANED AND RE-COATED. 6 PROVIDE NEW FASTNERS ON ALL FLANGES ASSOCIATED WITH THE FILTER INFLUENT AND EFFLUENT ASSEMBLY, QTY. NINE (9) FLANGES, QTY EIGHT (8) FASTNERS PER FLANGE. TYP. 3

7 PROVIDE NEW FILTER MEDIA FOR EXISTING SAND FILTER. 8 PROVIDE NEW FASTNERS ON ALL FLANGES ASSOCIATED WITH EACH PUMP, QTY (120) FASTNERS SIZED TO MATCH EXISITNG. 9 PROVIDE NEW HOUSE KEEPING FOR THREE (3) PUMPS, TWO (2) EXISITNG AND ONE (1) NEW.

10 REINSTALL EXISTING PUMPS & FILTERS AS SHOWN, ALL NEW PIPING, FITTINGS, AND VALVES SHALL BE SIZED TO MATCH EXISTING.





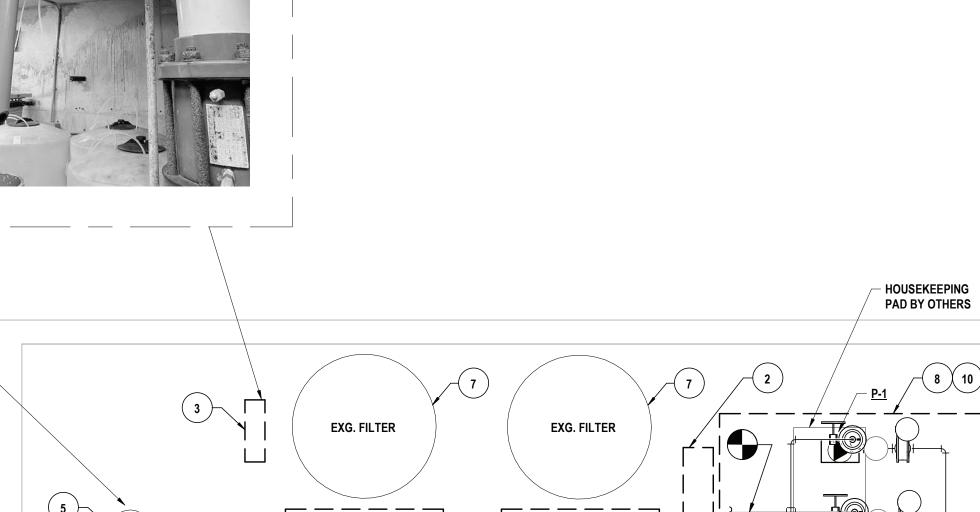

EXG. FILTER

UNIT NO.

LOCATION


POOL FILTER ROOM

NOTES 1. PUMP MUST BE SUITABLE FOR CHLORINE SERVICE.

GPM

REFER TO PIPING ISOMETRIC —/ FOR DETAILS, P1.1/1

HEAD FEET

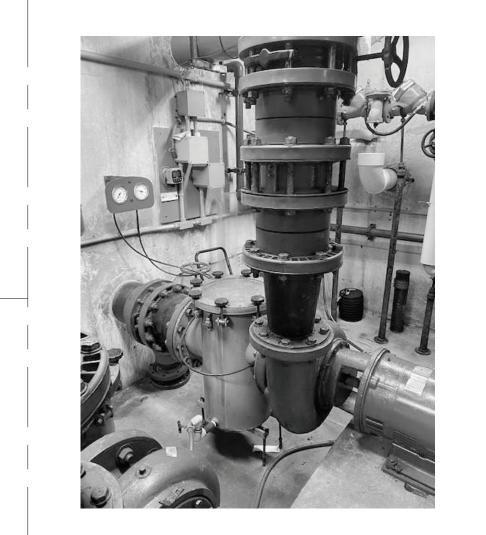



NOTES

MAKE & MODEL NO.

GRUNDFOS LC 60951



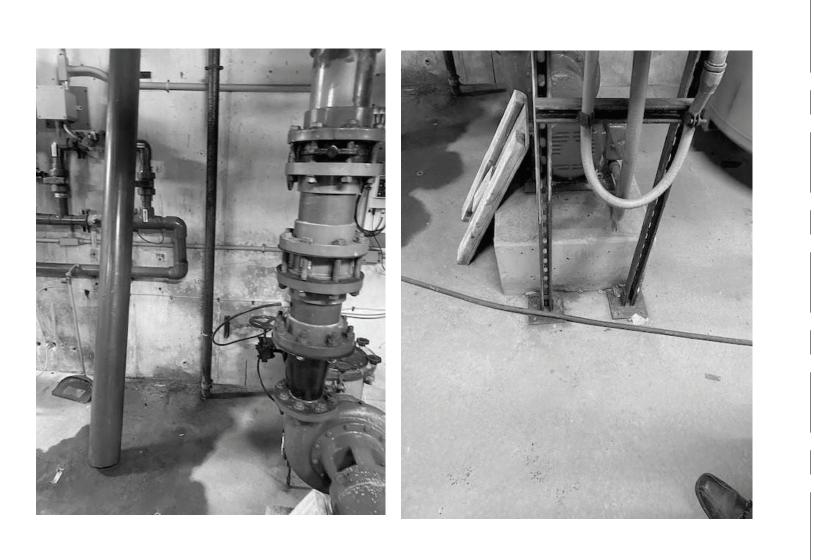

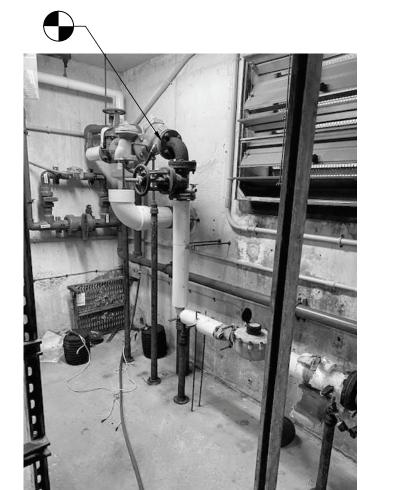

PUMP SCHEDULE

RPM


1750


MOTOR


VOLTS PHASE

460



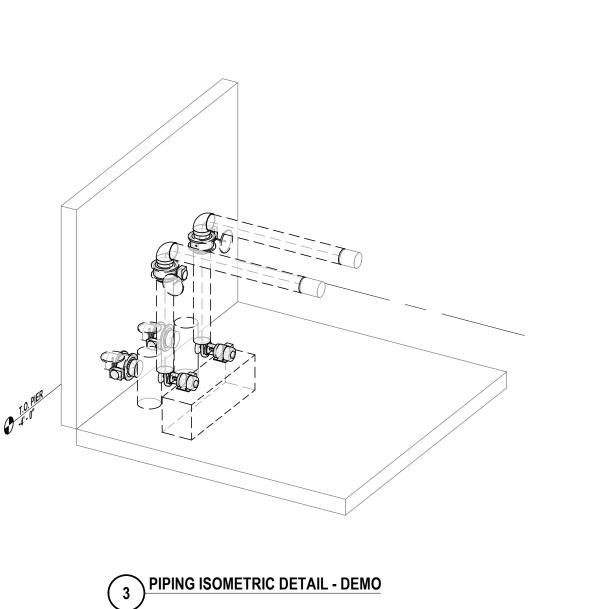


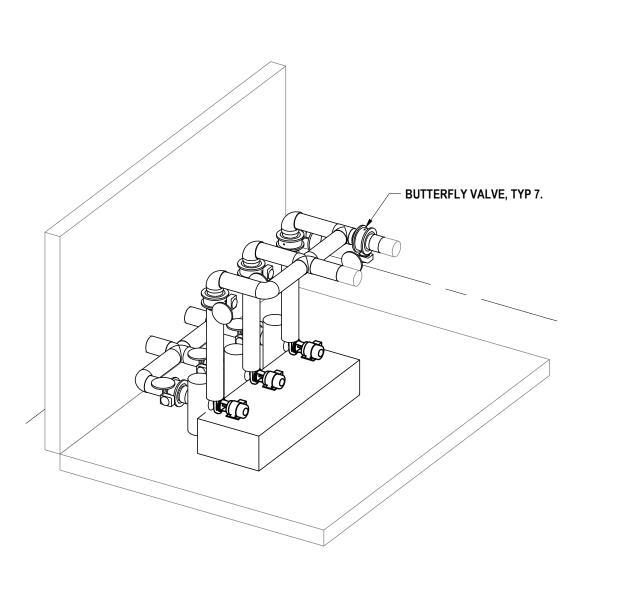

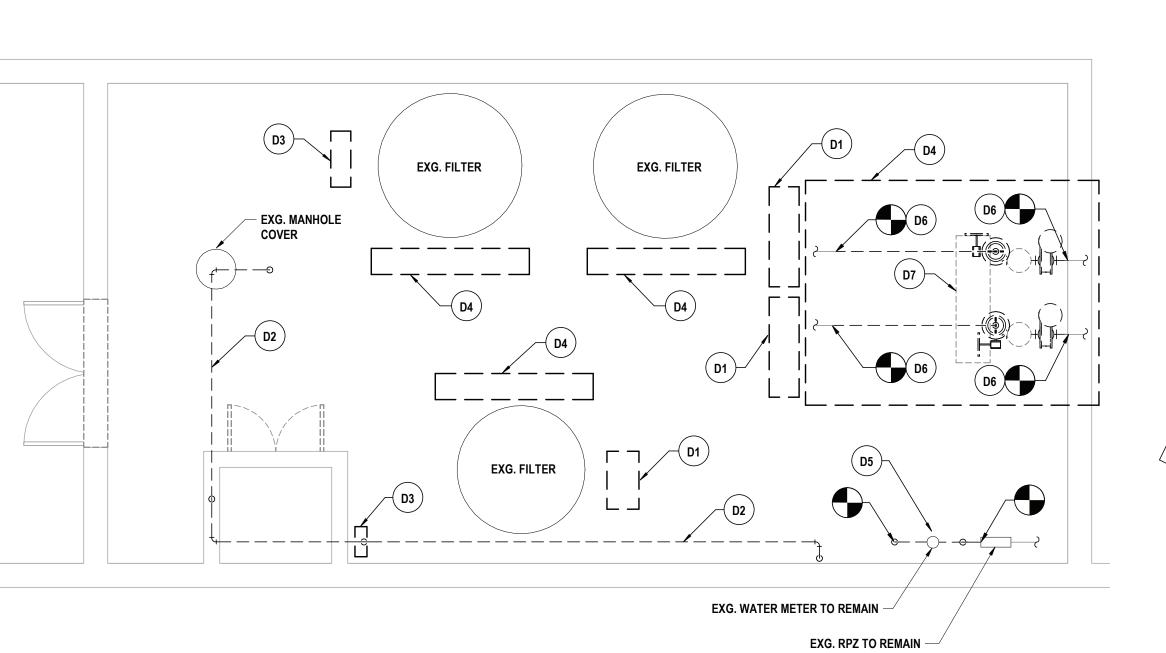


POOL FILTER RM. PLUMBING DEMO PLAN

1/4" = 1'-0"

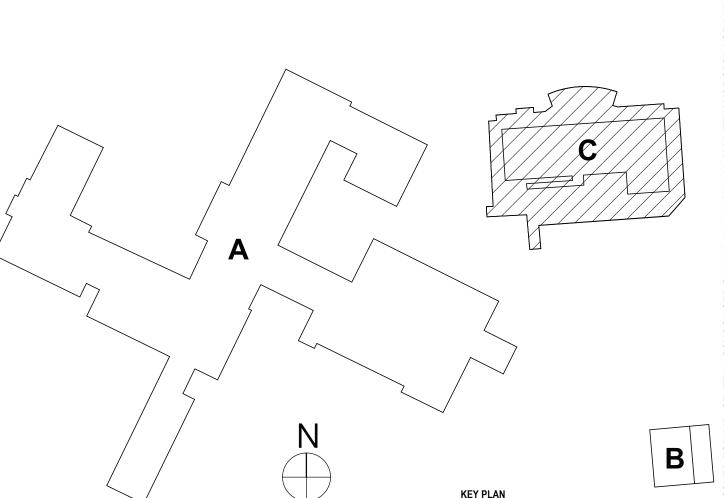

CS-P1.1 PROJECT NO: 3288.004

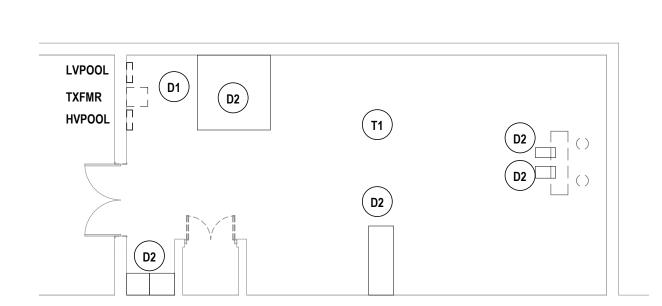

1 FIRST FLOOR ELECTRICAL DEMOLITION PLAN - POOL 1/8" = 1'-0"

GENERAL NOTES - ELECTRICAL

- CONTRACTOR IS RESPONSIBLE FOR ALL WORK ON THIS DRAWING UNLESS CLEARLY INDICATED TO BE PART OF ANOTHER PRIME CONTRACT. CONTRACTOR SHALL VERIFY EXISTING CONDITIONS PRIOR TO CONSTRUCTION AND INSTALLATION AND NOTIFY ENGINEER/ARCHITECT OF CONFLICTS AND CONDITIONS WHICH INTERFERE WITH INSTALLATION AS SET FORTH IN CONTRACT DOCUMENTS.
- CONTRACTOR IS RESPONSIBLE FOR ALL NEW WALL OPENINGS, EXCAVATIONS, AND PENETRATIONS, UNLESS SPECIFICALLY NOTED. UPON COMPLETION, ALL PENETRATIONS TO BE SEALED TO MAINTAIN FIRE RATING AS SPECIFIED ON ARCHITECTURAL DRAWINGS.
- CONTRACTOR IS RESPONSIBLE FOR ALL CUTTING AND PATCHING UNLESS CLEARLY INDICATED AS PART OF ANOTHER PRIME CONTRACT. MINIMUM CONDUIT SIZE USED ON THIS PROJECT SHALL BE 3/4" UNLESS OTHERWISE NOTED.
- MINIMUM WIRE SIZE USED ON THIS PROJECT SHALL BE #12 THHN/THWN UNLESS OTHERWISE NOTED. ALL CABLING INSTALLATIONS AND TERMINATIONS TO ADHERE TO CURRENT NEC CODES AND RELATED ANSI/TIA/EIA STANDARDS.
- DURING DEMOLITION OF EXISTING CABLING, ANY DAMAGE TO FUNCTIONING CABLING SYSTEM IS THE RESPONSIBILITY OF AND WILL BE REPAIRED BY CONTRACTOR SHALL BE AWARE OF THE PRESENCE OF EXISTING ASBESTOS CONTAINING MATERIAL SCHEDULED TO REMAIN IN PLACE WITHIN THE PROJECT SCOPE. ANY WORK REQUIRED THAT HAS THE POTENTIAL TO DISTURB HAZARDOUS MATERIALS SHALL BE COORDINATED DIRECTLY WITH
- ALL ELECTRICAL DEVICES, MATERIALS, AND PACKAGED EQUIPMENT SHALL BE LISTED AND LABELED BY UNDERWRITERS LABORATORIES INC. (UL). NEW CIRCUIT BREAKER(S) THAT ARE TO BE ADDED TO EXISTING PANELBOARD(S) SHALL BE LISTED/LABELED FOR USE WITH THE EXISTING
- THE SHORT-CIRCUIT RATINGS OF ALL PROTECTIVE DEVICES SHALL BE EQUAL TO OR EXCEED THE AVAILABLE SHORT-CIRCUIT CURRENT.
- ALL WORK TO CONFORM TO CURRENT NEC AND ALL APPLICABLE CODES. CONTRACTOR TO NOTIFY ELECTRICAL ENGINEER FOR INSPECTION OF ALL INSTALLATIONS BEFORE BEING BURIED OR COVERED.
- ALL ELECTRICAL DEVICES AND EQUIPMENT SCHEDULED FOR REMOVAL ARE CONSIDERED PROPERTY OF THE OWNER. ELECTRICAL DEVICES AND EQUIPMENT SHALL BE PLACED IN AN AREA DESIGNATED BY THE OWNER. ANY DEVICE OR EQUIPMENT THE OWNER WISHES NOT TO KEEP SHALL BE DISPOSED OF BY THE CONTRACTOR.
- CONTRACTOR IS RESPONSIBLE FOR DISCONNECTING POWER TO ANY EQUIPMENT SCHEDULED TO BE REMOVED OR REPLACED. COORDINATE WORK WITH OTHER PRIME CONTRACTORS AND DRAWINGS. Q CONTRACTOR IS RESPONSIBLE FOR PROVIDING POWER TO ANY EQUIPMENT SCHEDULED TO BE NEWLY INSTALLED. COORDINATE WORK WITH OTHER
- PRIME CONTRACTORS AND DRAWINGS. CONTRACTOR IS RESPONSIBLE FOR COORDINATING ALL CONDUIT LOCATIONS IN FIREWALLS. A MAXIMUM OF ONE PIECE OF CONDUIT IS ALLOWED IN A NON-REINFORCED CORE. NO CONDUIT SHALL BE PLACED IN A VERTICALLY REINFORCED CORE IN A FIREWALL.
- S ALL NEW ELECTRICAL DEVICES SUCH AS, BUT NOT LIMITED TO, FIRE ALARM DEVICES, SMOKE DETECTORS, LIGHT FIXTURES, EXIT SIGNS, OCCUPANCY/VACANCY SENSORS, AND NON-KEYED SWITCHES ARE REQUIRED TO HAVE IMPACT PROTECTION THROUGH MEANS OF IMPACT RESISTANT COVERS, OR WIRE GUARDS IN LOCKER ROOMS, GYMNASIUMS, WEIGHT ROOMS, FITNESS CENTERS, WRESTLING ROOMS, AND CAFETERIAS.

DEMOLITION NOTES - ELECTRICAL

- DISCONNECT AND REMOVE EXISTING PANELS HVPOOL AND LVPOOL WITH ASSOCIATED TRANSFORMER. MAINTAIN EXISTING HOMERUN CIRCUITRY NOT CALLED OFF TO BE REMOVED IN NOTE D2. SECURE EXISTING FEEDERS FROM MAIN BUILDING.
- D2 REMOVE EXISTING COMBO STARTERS/DISCONNECTS FROM UNITS. REMOVE ALL CONDUIT AND WIRE BACK TO PANEL.

CONSTRUCTION NOTES - POWER

- P1 NOT USED.
- FROM PANEL HVPOOL. PROVIDE NEW FEED WITH NEW ALUMINUM CONDUIT TO EQUIPMENT LOCATION 3#8, 1#10G, 1"C. PROVIDE NEW COMBO STARTER
- PROVIDE NEW NEMA 3R OUTDOOR RATED PANELS & TRANSFORMER. EXTEND EXISTING CIRCUITRY TO BE MAINTAINED BACK TO PANEL. PROVIDE TROUGH BELOW
- PANELS FOR FEEDING BACK INTO BUILDING. HVPOOL TO BE 225MCB 48 SPACE WITH 8 3P BREAKERS. TRANFORMER TO BE 45KVA NEMA 3R. PANEL LVPOOL TO BE 100A 30 SPACE WITH 20 1P BREAKERS.
- P4 FROM PANEL HVPOOL. REFEED WITH NEW ALUMINUM CONDUIT TO EQUIPMENT LOCATION. 3#12, 1#12G, 3/4"C.
- FROM PANEL HVPOOL. REFEED WITH NEW ALUMINUM CONDUIT TO EQUIPMENT LOCATION 3#10, 1#12G, 3/4"C.
- FROM PANEL HVPOOL. REFEED WITH NEW ALUMINUM CONDUIT TO EQUIPMENT LOCATION 3#8, 1#10G, 1"C. PROVIDE NEW COMBO STARTER
- FROM PANEL HVPOOL. REFEED WITH NEW ALUMINUM CONDUIT TO EQUIPMENT LOCATION 3#6, 1#10G, 1"C. PROVIDE NEW COMBO STARTER.
- FROM PANEL HVPOOL. REFEED WITH NEW ALUMINUM CONDUIT TO EQUIPMENT LOCATION 3#4, 1#8G, 1"C. PROVIDE NEW COMBO STARTER.

CONSTRUCTION NOTES - TECHNOLOGY

T1 REMOVE AND REINSTALL TECHNOLOGY CONNECTIONS AS NEEDED BY OTHERS.

DRAWN BY:

CHECKED BY:

SCALE:

TAWC

10/12/2022 ្ត្រី

1/8" = 1'-0"

GJB

S H \sim Z

POOL ELECTRICAL PLANS


CS-E1.1

	EQUIPMEN	IT CON	NECTIO	N AN	D C	ONTROL	SCHED	ULE	
	EQUIPMENT							SUPPLY	
UNIT IDENTIFICATION	DESCRIPTION	LOCATION (ROOM #)	LOAD (HORSEPOWER / WATTS / FLA / MCA)	VOLTAGE	PHASE	PANEL OR CONTROL CENTER	CIRCUIT BREAKER	WIRE & CONDUIT	REFERENCE NOTES
EF-1	EXHAUST FAN	-	.05HP	120	1	LVPOOL	20A	(2)-#12 , (1)-#12 G IN 3/4"C	А
EF-2	EXHAUST FAN	-	2HP	208	3	LVPOOL	20A	(3)-#12 , (1)-#12 G IN 3/4"C	В
EF-3	EXHAUST FAN	-	1HP	208	3	LVPOOL	20A	(3)-#12 , (1)-#12 G IN 3/4"C	В
UH-1	UNIT HEATER	-	9.7FLA	480	3	HVPOOL	20A	(3)-#12 , (1)-#12 G IN 3/4"C	-

NOTE: ALL DEVICES / EQUIPMENT / HARDWARE SHALL BE SUITABLE FOR USE IN THE ENVIRONMENT INSTALLED, SEE SPECIFICATIONS FOR FURTHER INFORMATION. MECHANICAL EQUIPMENT CONNECTION AND CONTROL SCHEDULE REFERENCE NOTES:

A. PROVIDE 20A 1PHASE DISCONNECT AT UNIT.B. PROVIDE 20A 3PHASE DISCONNECT AT UNIT.

UNDERGROUND TO MAIN BLDG

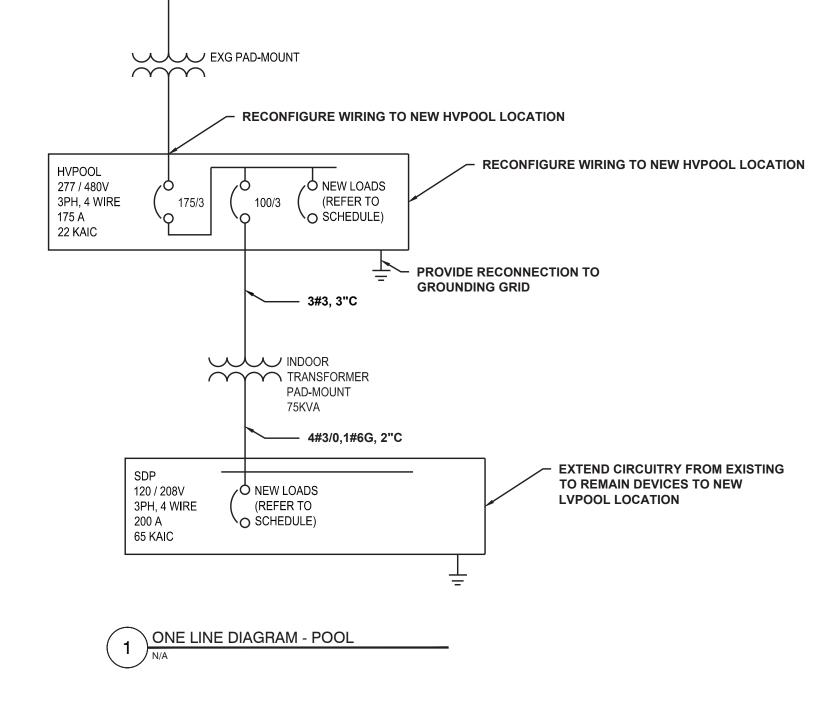

		P/	ANEL HVPO	OL		
CIRC.	DESCRIPTION	AMP	CIRCUIT BREAKERS	AMP	DESCRIPTION	CIRC #
1	EXHAUST FAN	25 -		- 25	PUMP-2	2
3	EXHAUST FAN	25		25	PUMP-2	4
5	EXHAUST FAN	25 -		25	PUMP-2	6
7	PUMP-1	40 -	П	- 60	PUMP-4	8
9	PUMP-1	40		60	PUMP-4	10
11	PUMP-1	40 -		- 60	PUMP-4	12
13	PUMP-3	80 -	П	40	PUMP-5	14
15	PUMP-3	80		40	PUMP-5	16
17	PUMP-3	80 -		40	PUMP-5	18
19	UH-1	20 -				20
21	UH-1	20				22
23	UH-1	20 -				24
25						26
27						28
29						30
31						32
33	SPARE	20		20	SPARE	34
35	SPARE	20		20	SPARE	36
37	LVPOOL	100 -		20	SPARE	38
39	LVPOOL	100		20	SPARE	40
41	LVPOOL	100 -		- 20	SPARE	42
VOL	ΓS: 277/480V 3Ø	SPA	ACES: 48		REMARKS:	·
WIRE	≣: 4W	МО	UNTING: SURFAC	E NEMA	4X ALL CONNECTIONS TO MAI	INTAIN
MAIN	I: 175A MCB	FEE	ED: MAIN BLDG MD	P	NEC 680 GROUNDING REQ	UIREMEN
AIC:	65,000 MAX AMPS	LOC	CATION: POOL			

CIRC. #	DESCRIPTION	AMP	CIRCUIT BREAKERS		AMP	DESCRIPTION	CIRC.		
1	CONV RECEPTS. UPPER POOL(EXG)	20	1 , 2				20	CONV RECEPTS. FILTER ROOM(EXG)	2
3	ALARM SYSTEM(EXG)	20		3	4		20	ALARM SYSTEM RECEPTACLES(EXG)	4
5	FILTER FEED RECEPT	20			5	6	20	EXTERIOR RECEPT(EXG)	6
7	FILTER FEED RECEPT	20	7	8		Г	20	EXHAUST FAN	8
9	DISPENSER (MICRO FEED)	20		9	10		20	EXHAUST FAN	10
11	SUBMERSIBLE PUMP	20			11	12	- 20	EXHAUST FAN	12
13	LIGHTING MECHANICAL ROOM(EXG)	20	13	14			20	LIGHTING POOL DECK(EXG)	14
15	SCOREBOARD	20		15	16	Г	- 20	EXHAUST FAN	16
17	EXHAUST FAN	20			17	18	20	EXHAUST FAN	18
19			19	20		L	- 20	EXHAUST FAN	20
21				21	22				22
23					23	24			24
25	SPARE	20	25	26			20	SPARE	26
27	SPARE	20		27	28		20	SPARE	28
29	SPARE	20			29	30	20	SPARE	30
VOLT	TS: 120/208V 3Ø	SPA	ACES:		30			REMARKS:	
WIRE	E: 4W	МО	UNTIN	IG:	SU	RFAC	E NEMA	4X ALL CONNECTIONS TO MAINT	ΓΑΙΝ

AS SHOWN 🗟 # - 264501

> **—** ≥ Z

OL SED#: 66-08-02-04-0-001-039, MAINTENANCE STORAGE BUILDING SED#: 66-08-02-04-2-006-001

ELECTRICAL SCHEDULES & DETAILS
PHASE 1A - CAPITAL IMPROVEMENTS
POCANTICO HILLS CSD
599 BEDFORD RD, SLEEPY HOLLOW, NY 10591

CS-E2.1 PROJECT NO: 3288.004