

HON. EDWIN J. DAY **COUNTY EXECUTIVE** ROBERT H. GRUFFI, P.E., LEED AP DIRECTOR, FACILITIES MANAGEMENT

CAPITAL PROJECT 2110

BUILDING F INTERIOR & EXTERIOR RENOVATIONS & IMPROVEMENTS

BATHROOM RENOVATION

DR. ROBERT L. YEAGER HEALTH CENTER **BUILDING F** POMONA, NEW YORK 10970

DRAWING LIST:

ARCHITECTURAL

TITLE SHEET DRAWING LIST

GENERAL NOTES

FIRST FL. NORTH BATHROOM DEMOLITION PLAN CONSTRUCTION PLAN REFLECTED CEILING PLAN

FIRST FL. SOUTH BATHROOM DEMOLITION PLAN CONSTRUCTION PLAN

FIRST FL. SOUTH BATHROOM REFLECTED CEILING PLAN PARTITION TYPES

SECOND FL. NORTH BATHROOM SECOND FL. EAST BATHROOM DEMOLITION PLANS CONSTRUCTION PLANS REFLECTED CEILING PLANS

SECOND FL. SOUTH BATHROOM DEMOLITION PLAN CONSTRUCTION PLAN REFLECTED CEILING PLAN

INTERIOR ELEVATIONS

INTERIOR ELEVATIONS


A-6.3 INTERIOR ELEVATIONS

FINISH, DOOR, TOILET ACCESSORY, AND PLUMBING SCHEDULES

INTERIOR ELEVATIONS



ROBERT H. GRUFFI, P.E., LEED AP DIRECTOR FACILITIES MANAGEMENT

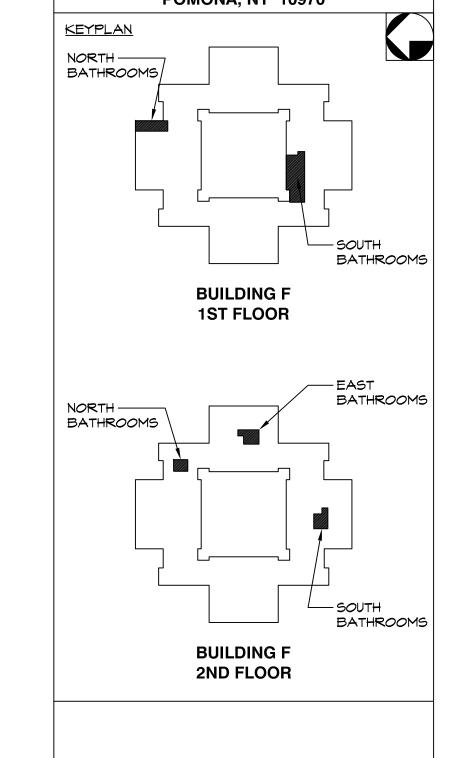

1	02.09.2022	ISSUED FOR BID
ISSUE NO.	DATE	DESCRIPTION

PROJECT NAME

CAPITAL PROJECT 2110

BATHROOM RENOVATION

DR. ROBERT L. YEAGER HEALTH CENTER **BUILDING F POMONA, NY 10970**


SHEET TITLE

TITLE SHEET **DRAWING LIST**

DWG NO.

SCALE	AS NOTED
 PRJ. NO.	2110
DRAWN	AMN
CHECKED	RHG
DATE	2.9.2022

DWG INFO.

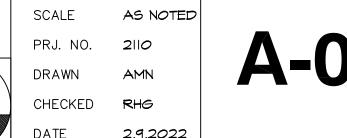

<u>DIVISION 5 - METALS</u>

5.I METAL FABRICATIONS:

- A. FURNISH AND INSTALL THE FOLLOWING ITEMS:
- I. ALL MISCELLANEOUS FABRICATIONS NOT DETAILED ON STRUCTURAL STEEL
- 3. ALL SUPPORTS NOT IDENTIFIED AS STRUCTURAL STEEL ON STRUCTURAL STEEL DRAWINGS
- B. LOOSE LINTELS

2. LOOSE LINTELS

- FURNISH STEEL LINTELS WHERE CALLED FOR ON DRAWINGS AN AS REQUIRED TO SUPPORT MASONRY ABOVE ALL OPENINGS OVER 10" WIDE, SUCH AS OVER DOORWAYS, LOUVERS, DUCTWORK, CONVECTORS, PANEL BOXES, GRILLES, SHOWN ON THE DRAWINGS OR REQUIRED FOR MECHANICAL TRADES. NO LINTELS WILL BE REQUIRED FOR OPENINGS IN 4" OR 6" BLOCK PARTITIONS
- HAVING HOLLOW METAL FRAMES WHICH ARE 3'-O" WIDE OR LESS 2. LINTELS SHALL BE 12 INCHES LONGER THAN THE WIDTH OF THE OPENING SIZED AS REQUIRED FOR SPANS, AND ARRANGED TO BE CONCEALED WITHIN THE MASONRY, UNLESS OTHERWISE INDICATED ON DRAWINGS. MINIMUM BEARING ON THE MASONRY SHALL BE 6 INCHES AT EACH END

5.2 COLD-FORMED METAL FRAMING:

- A. ENGINEER, FABRICATE, AND ERECT COLD-FORMED METAL FRAMING (WITH THE FOLLOWING MINIMUM PHYSICAL AND STRUCTURAL PROPERTIES)
- I. INTERIOR LOAD BEARING WALLS: LATERAL DEFLECTION OF L/360 B. CALCULATE STRUCTURAL CHARACTERISTICS OF COLD-FORMED FRAMING ACCORDING TO AISI'S "SPECIFICATION FOR THE DESIGN OF COLD-FORMED STEEL STRUCTURAL MEMBERS.
- C. COMPLY WITH AWS DI.I "STRUCTURAL WELDING CODE STEEL," AND AWS DI.3, "STRUCTURAL WELDING CODE-SHEET STEEL
- D. STEEL STUDS AND TRACK: FABRICATE WITH FLANGE WIDTH OF 1-5/8" DESIGN
- UNCOATED STEEL THICKNESS OF 0.0566 INCH, AND OF DEPTHS INDICATED. E. STEEL SHAPES AND CLIPS: (ASTM A36, HOT DIPPED GALVANIZED ACCORDING TO ASTM A 153): GRADE 33.
- F. MECHANICAL FASTENERS: CORROSION RESISTANT COATED, SELF DRILLING, SELF-THREADING STEEL DRILL SCREWS.
- G. INSULATION: ASTM C 665, TYPE I, UNFACED MINTERAL-FIBER BLANKETS
- H. GALVANIZING REPAIR PAINT: SSPC PAINT OR DOD-P-21035
- I. INSTALL FRAMING AND ACCESSORIES LEVEL, PLUMB, SQUARE, AND TRUE TO
- LINE, AND SECURELY FASTENED. TEMPORARILY BRACE FRAMING. J. FASTEN FRAMING MEMBERS BY WELDING OR SCREW FASTENING. K. STUDS: INSTALL ALIGN, AND SECURELY ANCHOR CONTINUOUS TRACKS TO
- SUPPORTING STRUCTURE. SQUARELY SEAT STUDS AGAINST WEBS OF TOP AND BOTTOM TRACKS. SPACE STUDS AS INDICATED; PLUMB, ALIGN AND FASTEN BOTH FLANGES OF STUDS TO TOP AND BOTTOM TRACK. I. INSTALL AND FASTEN HORIZONTAL BRIDGING IN STUD SYSTEM, SPACED IN
- ROWS NOT MORE THAN 48 INCHES APART. 2. INSTALL MISCELLANEOUS CONNECTIONS, ACCESSORIES, AND
- SUPPLEMENTARY FRAMING
- 3. ISOLATE CURTAIN WALL FRAMING FROM BUILDING STRUCTURE USING SLIDE CLIPS OR DEFLECTION TRACK TO PREVENT TRANSFER OF VERTICAL LOADS WHILE PROVIDING LATERAL SUPPORT.

DIVISION 7 - THERMAL & MOISTURE PROTECTION

- A. FURNISH AND INSTALL THE FOLLOWING ITEMS:
- I. BUILDING INSULATION a. BATT INSULATION FOR FILLING PERIMETER WINDOW AND DOOR SHIM SPACES,
 - CREVICES IN EXTERIOR WALL AND ROOF ASSEMBLY b. SOUND PARTITION BATTS FOR INTERIOR WALLS
- 2. MANUFACTURERS:
- a. JOHNS-MANVILLE b. OWENS-CORNING FIBERGLASS
- c. DOW STYROFOAM 5M BRAND INSULATION
- 3. MATERIALS:
- a. ASTM C 665 SOUND BATT TYPE I UN-FACED, CLASS C $3\frac{1}{2}$ " b. DEFINITION OF R-VALVE DESIGNATION: THERMAL RESISTANCE OF INSULATION ONLY, NOT INCLUDING ALLEGED AIR SPACES OR OTHER
- FACTORS ASSUMED TO RESULT IN HIGHER R-VALUES. c. NAILS OR STAPLES: STEEL WIRE; GALVANIZED; TYPE AND SIZE TO SUIT APPLICATION.
- 4. PREPARATION:
- a. VERIFY ADJACENT MATERIALS ARE DRY AND READY TO RECEIVE
- b. VERIFY MECHANICAL AND ELECTRICAL SERVICES WITHIN WALLS HAVE BEEN INSTALLED AND TESTED
- 5. INSTALLATION (BATT):
- a. INSTALL BATT INSULATION IN ACCORDANCE WITH MANUFACTURER'S INSTRUCTIONS
- b. INSTALL BATT INSULATION IN EXTERIOR WALLS AND SOFFIT SPACES WITHOUT GAPS OR VOIDS
- c. TRIM INSULATION NEATLY TO FIT SPACES. USE BATTS FREE OF DAMAGE
- d. FIT INSULATION TIGHT IN SPACES AND TIGHT TO EXTERIOR SIDE OF MECHANICAL AND ELECTRICAL SERVICES WITHIN THE PLANE OF INSULATION. LEAVE NO GAPS OR VOIDS
- e. INSTALL INSULATION WITH FACTORY APPLIED MEMBRANE FACING WARM SIDE OF BUILDING SPACES. LAP ENDS AND SIDE FLANGES OF MEMBRANE BETWEEN FRAMING MEMBERS. STAPLE OR NAIL IN PLACE AT MAXIMUM 6 INCHES OC

7.2 FIRESTOPPING:

- A. PROVIDE APPROVED FIRESTOPPING AT THE LOCATIONS LISTED BELOW: CONCEALED WALL SPACE: FIRESTOPPING SHALL BE PROVIDED IN CONCEALED SPACES OF STUD WALLS AND PARTITIONS, INCLUDING FURRED SPACES, AT THE CEILING AND FLOOR LEVELS.
- 2. CONNECTIONS BETWEEN HORIZONTAL AND VERTICAL SPACES FIRESTOPPING SHALL BE PROVIDED AT ALL INTERCONNECTIONS BETWEEN VERTICAL AND HORIZONTAL SPACES SUCH AS OCCUR AT SOFFITS OVER CABINETS, DROP CEILINGS, COVE CEILINGS AND SIMILAR LOCATIONS.
- 3. EXCEPT WHERE SPECIFICALLY INDICATED ABOVE AND IN SECTION 7.4, FIRESTOPS SHALL CONSIST OF APPROVED NONCOMBUSTIBLE MATERIALS OR OF MATERIALS OF TWO THICKNESSES OF LUMBER WITH BROKEN LAP-JOINT, OR ONE THICKNESS OF 23/32" PLYWOOD WITH JOINTS BACKED BY 23/32 PLYWOOD, OR OF 2"LUMBER INSTALLED WITH TIGHT JOINTS. THE INTEGRITY OF ALL FIRESTOPPING SHALL BE CONTINUOUSLY MAINTAINED. FIRESTOPPING SHALL NOT BE CONCEALED FROM VIEW UNTIL INSPECTED AND APPROVED.

7.3 FIRESTOPPING & SMOKESTOPPING (PENETRATIONS THRU FIRE RELATED CONSTRUCTION:

A. PROVIDE THROUGH-PENETRATION SYSTEMS AT ALL PENETRATIONS THROUGH FIRE-RATED PARTITIONS AND SMOKE STOPPING AT ALL PENETRATIONS THROUGH SMOKE BARRIERS. PENETRATIONS INCLUDE, BUT ARE NOT LIMITED TO

- PIPES, DUCTS, CONDUIT, CABLES/WIRES NOT IN CONDUIT, & THE JOINTS BETWEEN FIRE RATED PARTITIONS & OTHER CONSTRUCTION.
- B. ALL ASSEMBLIES SHALL BE TESTED AND LABELED BY UNDERWRITERS LABORATORIES INC. OR FACTORY MUTUAL AND UNLESS NOTED OTHERWISE, SHALL BEAR A RATING AT LEAST AS HIGH AS THAT OF THE FIRE-RATED ASSEMBLY PENETRATED.
- C. IT IS THE CONTRACTOR'S RESPONSIBILITY TO DETERMINE THE TYPES OF PENETRATIONS TO BE SEALED AND TO SELECT APPROPRIATE FIRESTOPPING ASSEMBLIES. CONTRACTOR SHALL COORDINATE INSTALLATION OF SLEEVES AND OTHER COMPONENTS OF THE FIRESTOPPING WITH RELATED TRADES. ALLOW FOR NORMAL EXPANSION AND CONTRACTION MOVEMENT OF THE PENETRATING ITEM WITHOUT FAILURE OF THE SEAL.
- D. WALL PENETRATION (DUCTS): PROVIDE APPROVED RATED FIRE DAMPERS (UL 555) AT DUCT PENETRATIONS LOCATED WITHIN THE FIRE-RATED WALL ASSEMBLIES. PROVIDE FUSIBLE-LINK DAMPERS WHICH ACTIVATE TO CLOSE IN THE EVENT OF A FIRE. ACCESS SHALL BE PROVIDED TO FIRE DAMPERS FOR INSPECTION AND SERVICING.
- E. CEILING PENETRATIONS: FOR PENETRATION OF THE CEILING MEMBRANE OF A FLOOR/CEILING ASSEMBLY, OPENINGS TO ACCOMMODATE NONCOMBUSTIBLE CONDUITS, PIPES, TUBES, ELECTRICAL OUTLETS, OR AIR DUCTS ARE PERMITTED PROVIDED THAT ALL OF THE FOLLOWING APPLY: (1) THE AGGREGATE AREA OF SUCH OPENINGS IS LESS THAN 100 SQ. INCHES IN ANY 100 SQ. FEET OF CEILING AREA; (2) THE SPACE AROUND THE CEILING PENETRATION IS FIRESTOPPED WITH APPROVED MATERIALS; AND (3) LABELED CEILING DAMPERS SHALL BE INSTALLED AT THE CEILING LINE WHERE NONCOMBUSTIBLE AIR DUCT PENETRATE THE CEILING. WHERE ANY OF THE ABOVE CONDITIONS ARE NOT MET, FOLLOW THE REQUIREMENTS FOR WALL PENETRATIONS ABOVE (SEE ITEM 7.4/E)

7.4 JOINT SEALANTS:

- A. INTERIOR JOINTS: ELASTOMERIC, ONE-PART, NON-SAG, MILDEW RESISTANT, PAINTABLE, ACRYLIC-EMULSION LATEX SEALANT.
- B. JOINT FINISH: CONCAVE FRAMES TOO LARGE TO SHIP IN ONE PIECE, LOCATED AND DETAIL FIELD
- SPLICE JOINTS AND INDICATED COMPLETE INSTRUCTIONS FOR MAKING FIELD SPLICES
- 2. DETAIL JOINTS REQUIRED TO ACCOMMODATE EXPANSION JOINT MOVEMENT
- D. FRAMES (EXCEPT AS OTHERWISE REQUIRED FOR LABELED FRAMES) FRAMES SHALL BE COMBINATION BUCK, FRAME AND TRIM TYPE
- 2. MINIMUM GAGES: 16 INTERIOR, 14 EXTERIOR
- 3. BRAKE-FORM STEEL SHEETS:
- a. PROVIDE PROFILES AND SHAPES FREE OF WARP, BUCKLES, FRACTURES, OR OTHER DEFECTS b. FORM STOPS INTEGRAL WITH FRAMES UNLESS OTHERWISE SHOWN
- 4. CORNERS AND CONNECTIONS SHALL BE MITERED AND WELDED WITH
- EXPOSED WELDS GROUND FLUSH AND SMOOTH 5. ANCHORS:
- a. PROVIDE AN ANCHOR AT EACH JAMB FOR EACH 2 FEET 6 INCHES OF
- DOOR HEIGHT OF FRACTION THEREOF b. VARY ANCHOR TYPES TO PROVIDE POSITIVE FASTENING TO ADJACENT CONSTRUCTION
- c. SECURE A METAL CLIP ANGLE AT BOTTOM OF EACH JAMB MEMBER FOR
- ANCHORING TO FLOOR, WITH A MINIMUM OF TWO FASTENERS 6. STOPS:
- a. APPLIED STOPS SHALL BE FORMED OF 18 GAGE STEEL, CORNERS MADE TO A CLOSE NEAT FIT, AND SECURED AT 12 INCH INTERVALS WITH COUNTERSUNK SHEET METAL SCREWS
- COLOR: CLOSELY MATCH ADJACENT FINISHES
- PRIMER: AS RECOMMENDED BY SEALANT MANUFACTURER.
- SEALANT BACKERS: AS RECOMMENDED BY SEALANT MANUFACTURER. PREFORMED, FLEXIBLE, NON-ABSORBANT, COMPRESSIBLE POLYURETHANE FOAM (NON-GASSING) OR SELF ADHESIVE PLASTIC TAPE.

DIVISION 8 - DOORS & WINDOWS

8.1 HOLLOW METAL DOORS AND FRAMES

A. FURNISH:

- HOLLOW METAL DOORS
- 2. HOLLOW (PRESSED) METAL FRAMES FOR DOORS AND TRIMMED OPENINGS
- 3. SHOP DRAWINGS
- 4. CERTIFICATIONS 5. WARRANTY
- B. MANUFACTURER: ONE OF THE FOLLOWING, OR AN APPROVED SUBSTITUTE:
- ACME & DORF METAL DOOR CORP, NJ
- 2. ACME STEEL DOOR CORP, NY, NY
- 3. BUILT-RITE STEEL BUCK CO, WESTBURY, NY
- 4. PIONEER FIREPROOF DOOR CORP, CARLSTADT, NJ
- 5. WILLIAMSBURGH STEEL PRODUCTS CO, BROOKLYN, NY
- 6. APPROVED EQUAL C. SHOP DRAWINGS
- SUBMIT SHOP DRAWINGS COVERING EACH TYPE OF DOOR AND FRAME, FRAME CONDITIONS, AND COMPLETE ANCHORAGE DETAILS, SUPPLEMENTED BY SUITABLE SCHEDULES COVERING DOORS AND FRAMES
- 2. SHOW GLASS AND LOUVER OPENING SIZES AND LOCATIONS IN DOORS 3. DETAIL CONNECTIONS OF HOLLOW METAL WORK TO STRUCTURAL STEEL
- FRAMING CONCEALED IN HOLLOW METAL WORK
- D. DOORS (EXCEPT AS REQUIRED FOR LABELED DOORS)
- FACE SHEETS SHALL BE OF 18 GAGE STEEL
- 2. DOORS SHALL BE I 3/4" THICK UNLESS OTHERWISE INDICATED
- 3. TOPS AND SIDES OF DOORS SHALL BE CLOSED FLUSH WITH EDGE OF DOOR 4. INTERNAL STIFFENERS:
- a. MINIMUM 20 GAGE STEEL
- b. SPACE AT NOT OVER 6" CENTERS
- c. SPOT WELD TO FACE PANELS AT A MAXIMUM 5 INCH INTERVALS 5. VERTICAL AND TOP EDGES OF FACE PANELS SHALL BE JOINTED AND WELDED ON MAXIMUM 6 INCH CENTERS, THEN GROUND SMOOTH AND FILLED WITH MINERAL FILLER TO CONCEAL SEAMS
- 6. SOUND DEADENING: INTERIOR SURFACES SHALL BE TREATED WITH A SOUND-DEADENING MATERIAL TO ELIMINATE METALLIC RING INSULATION: EXTERIOR DOORS SHALL BE INSULATED TO PROVIDE A
- U-VALUE OF 0.59 OR LESS F. LABELED FIRE DOORS, DOOR LOUVERS AND FRAMES
- I. DOORS, DOOR LOUVERS AND FRAMES DESIGNATED TO BE LABELED SHALL BEAR UNDERWRITERS LABORATORIES, INC LABEL 2. WHERE LABEL IS NOT REQUIRED, SUBMIT MANUFACTURER'S CERTIFICATE

THAT CONSTRUCTION CONFORMS TO TESTING AGENCIES REQUIREMENTS FOR

8.2 FLUSH WOOD DOORS:

- INTERIOR (LABELED AND NON-LABELED) SOLID CORE FLUSH WOOD DOORS 2. SAMPLES AND SHOP DRAWINGS
- 3. CERTIFICATIONS

LABEL INDICATED

- 4. WARRANTY
- B. SUBMIT SHOP DRAWINGS FOR EACH SPECIFIC ITEM, TO SHOW LAYOUT OF THE ITEM AND CONSTRUCTION DETAILS, SUCH AS SNAPS AND SIZES OF PARTS, METHODS OF CONSTRUCTION, ATTACHMENT, SETTING, ETC
- C. SUBMIT SAMPLES AS REQUIRED. SUBMIT FACE VENEER SAMPLES FOR EACH SPECIES SPECIFIED. SAMPLES SHALL REPRESENT THE FULL RANGE OF COLOR, GRAIN PATTERN AND FIGURE OF MATERIALS TO BE USED. ALL SAMPLES MUST BE APPROVED BY THE ARCHITECT BEFORE ORDER IS PLACED FOR THE FULL

QUANTITIES OF THE VARIOUS MATERIALS

- I. ACCEPTABLE MANUFACTURER'S SHALL BE WEYERHAEUSER CO, EGGERS HARDWOOD PRODUCTS CORP, MOHAWK FLUSH DOORS, INC, CRAFTMASTER OR APPROVED EQUAL
- 2. CORE CONSTRUCTION 3. FIRE-RATED SOLID CORE DOORS
- 4. FACES AND AWI GRADE: PROVIDE FACES AND GRADE TO MATCH NON-RATED DOORS IN SAME AREA OF BUILDING, UNLESS OTHERWISE
- 5. CORE CONSTRUCTION: MANUFACTURER'S STANDARD CORE CONSTRUCTION AS REQUIRED TO PROVIDE FIRE-RESISTANCE RATING INDICATED
- 6. EDGE CONSTRUCTION: PROVIDE MANUFACTURER'S STANDARD LAMINATE EDGE CONSTRUCTION FOR IMPROVED SCREW-HOLDING CAPABILITY AND SPLIT RESISTANCE OVER EDGES COMPOSED OF A SINGLE LAYER OF

TREATED LUMBER E. FINISHES:

- I. PROVIDE PREMIUM GRADE VENEERS ACCORDING TO CS 171-58. ALL EXPOSED VENEERS SHALL BE PLAIN SLICED RED OAK, STAIN GRADE a. FLITCHES SHALL EXTEND THE FULL LENGTH OF VENEERED SURFACE IN
- b. SIDE EDGE STRIPS OF DOORS SHALL BE SAME SPECIES AS EXPOSED
- c. FACTORY SEAL ALL EDGES

8.3 HARDWARE AND SPECIALITIES:

- I. ALL FINISH HARDWARE AND SPECIALTIES REQUIRED (EXCEPT AS SPECIFIED
- UNDER WORK OF OTHER SECTIONS) 2. HARDWARE SCHEDULE AND KEYING CHART
- 3. TEMPLATES TO THE VARIOUS TRADES FOR ACCURATE SETTING AND FITTING
- 4. HARDWARE SCHEDULE B. MATERIALS:
- I. FINISH HARDWARE SHALL BE AS CALLED FOR IN THE APPROVED HARDWARE SCHEDULE
- 2. MANUFACTURER'S SPECIFIED ARE USED FOR REFERENCE AS TO CONSTRUCTION, QUALITY, UTILITY, AND ARRANGEMENT. OTHER MANUFACTURER'S OF EQUAL QUALITY, UTILITY, ETC. WILL BE ACCEPTABLE SUBJECT TO THE APPROVAL OF ARCHITECT
- 3. LOCKSETS AND LATCHSETS SHALL BE A MINIMUM 2 3/4" BACK SET REGULAR WEIGHT (NOT RESIDENTIAL WEIGHT) UNLESS HEAVIER WEIGHT IS REQUIRED FOR SPECIAL APPLICATIONS SUCH AS HIGH TRAFFIC AND LABELED DOORS
- C. ACCEPTABLE MANUFACTURER'S: SCHLAGE: LOCKSETS & LATCHSETS
- 2. MCKINNEY: HINGES
- 3. NORTON: CLOSERS
- 4. IVES: HOLDERS, SILENCERS, STOPS 5. QUALITY: PUSH, PULL, KICKPLATES
- D. FINISH: US26D SATIN CHROME: HARDWARE IN GENERAL
- 2. USP PRIME COAT: BUTTS H.M. DOORS
- E. INSTALLATION: I. ALL LOCKSETS SHALL HAVE TWO (2) KEYS EACH. FURNISH (4) MASTER KEYS
- PER SET. DELIVER TO OWNER 2. FURNISH (6) CONSTRUCTION MASTER KEYS. (SEND REGISTERED MAIL TO PROJECT MANAGER OF GENERAL CONTRACTOR)
- 3. PROVIDE SILENCERS, GJ#64, FOR ALL HOLLOW METAL FRAMES, TWO FOR DOUBLE OPENINGS AND THREE FOR EACH SINGLE OPENING, EXCEPT
- 4. WEATHERSTRIP FOUR SIDES OF EXTERIOR HOLLOW METAL DOORS MANUFACTURER SHALL BE ZERO WEATHERSTRIPPING CO, OR APPROVED
- EQUAL 5. KEYS - EACH KEY SHALL BE FACTORY CODED AND DIE STAMPED WITH ITS FACTORY CODE, AND FACTORY TAGGED WITH CORRESPONDING CODE, ITEMS AND KEY SET SYSTEMS. KEYS SHALL BE NICKEL SILVER MATERIALS

8.4 ACCESS DOORS:

A. PROVIDE FLUSH ACCESS DOORS AS INDICATED ON THE DRAWINGS AND AS REQUIRED TO SERVICE INSTALLED EQUIPMENT. ALL ACCESS DOORS IN FIRE-RATED PARTITIONS SHALL BE TESTED AND LABELED BY UNDERWRITERS

8.5 ALUMINUM ENTRANCE DOORS:

LABORATORIES INC.

A. ALUMINUM/GLASS ENTRANCE DOORS TO BE MEDIUM STILE "350" DOORS SET IN FULL FRAMES: COLOR TO BE DARK BRONZE ANODIZED: HARDWARE SHALL INCLUDE STYLE "T" PUSH/PULL HARDWARE. PIVOTS TO BE SINGLE ACTING, OFFSET TYPE PIVOTING WITH CONCEALED OVERHEAD CLOSER WITH 90 DEGREE HOLD OPEN DEVICE. SADDLES TO BE EXTRUDED FLUTED ALUMINUM IN ONE PIECE OVER FULL WIDTH OF JAMB. SET SADDLE IN MASTIC, FASTEN WITH COUNTERSUNK EXPANSION BOLTS 15" O.C. DOORS SHALL BE GLAZED WITH

TEMPERED, POLISHED 1/4" SAFETY GLASS. DIVISION 9 - FINISHES

9.1 <u>GYPSUM BOARD SYSTEMS</u>

- A. EXCEPT WHERE MANUFACTURER'S STANDARDS OR SPECIFIED REQUIREMENTS ARE MORE STRINGENT, FOLLOW INSTALLATION RECOMMENDATIONS AND
- DETAILS IN THE USG GYPSUM CONSTRUCTION HANDBOOK. B. AT ALL APPLICABLE PARTITION, WALLS, AND CEILINGS, WHICH ARE INDICATED OR REQUIRED TO BE FIRE-RATED, PROVIDE ASSEMBLIES WHICH ARE LISTED BY
- UNDERWRITERS LABORATORIES INC. OR FACTORY MUTUAL C. EXCEPT AT EXTERIOR WALLS AND AT FIRE RATED ASSEMBLIES, PROVIDE 5/8 INCH GYPSUM BOARD EACH SIDE. INCLUDE CORNER BEADS, EDGE TRIM, AND
- OTHER TRIM UNITS NECESSARY FOR PROJECT CONDITIONS. D. PROVIDE WATER RESISTANT GYPSUM BOARD AT ALL AREAS SUBJECT TO MOISTURE. PROVIDE GLASS MESH MORTAR UNITS (WONDERBOARD OR EQUAL)
- BELOW TILE AT ALL WET AREAS. E. ALL GYPSUM BOARD WALLS SHALL BE TAPED & SPACKLED AND READY FOR APPLICATION OF INTERIOR FINISHES. PROVIDE THREE COATS, SAND AND SPACKLE WORK SMOOTH BETWEEN COATS AND AFTER THIRD COAT. FEATHER JOINTS WITH SUCCESSIVE COATS TO PROVIDE A SMOOTH SURFACE.

9.2 ACOUSTICAL CEILINGS

- A. FURNISH AND INSTALL THE FOLLOWING ITEMS: 4. EXPOSED GRID SUSPENSION SYSTEMS, 2 X 2 FT WHERE INDICATED ON
- DRAWINGS 5. "BEVELED TEGULAR" ACOUSTICAL LAY-IN PANELS IN EXPOSED GRIDS 6. ANY SPECIAL ARRANGEMENT OF HANGERS, CHANNELS AND SUSPENSION

MEMBERS TO ACCOMMODATE LIGHTING FIXTURES, REGISTERS, DIFFUSERS,

- ETC AS REQUIRED B. ACCEPTABLE MANUFACTURERS:
- I. SUSPENSION SYSTEMS: a. USG INTERIORS
- b. ARMSTRONG CEILINGS c. CELOTEX d. AN APPROVED EQUAL

2. ACOUSTICAL MATERIALS:

- a. ARMSTRONG
- b. CELOTEX c. JOHNS-MANVILE
- d. UNITED STATES GYPSUM e. AN APPROVED EQUAL
- 3. NOTE: SUBSTITUTION OF ANOTHER MANUFACTURER'S PRODUCT FOR A PROPRIETARY ACOUSTICAL MATERIAL SPECIFIED HEREIN IS SUBJECT TO THE ARCHITECT'S APPROVAL. IT MAY BE DETERMINED BY THE ARCHITECT
- THAT NO OTHER MANUFACTURER'S ACOUSTICAL PRODUCT IS ACCEPTABLE. C. SUSPENSION SYSTEMS
- I. STEEL EXPOSED TEE GRID SIMILAR AS APPROVED TO ARMSTRONG

PRELUDE

- EXPOSED TEE SYSTEM D. ACOUSTICAL UNITS I. "ULTIMA" BEVELED TEGULAR ACOUSTICAL PANELS
 - a. FS SS-S-118B b. TYPE: IV (MINERAL FIBER COMPOSITION) c. PATTERN: E - FINELY PERFORATED
 - d. CLASS 25 e. PERFORMANCE:
- SOUND TRANSMISSION CLASS (STC): 35, ASTM E90 NOISE REDUCTION CLASS (NRC): .70, ASTM C423
- LIGHT REFLECTANCE: .089, LR GRADE I, I 523 2. SIZE (NOMINAL): 3/4" THICK BY 2 x 4 FEET OR AS SCHEDULED ON
 - 3. FINISH: WHITE, FACTORY APPLIED
 - 4. EDGE: BEVELED TEGULAR

2ND COAT

PRIMER

PRIMER

IST COAT

IST COAT

2ND COAT

2ND COAT

- A. ALL EXTERIOR AND INTERIOR SURFACES WHICH ARE NOT FACTORY
- PRE-FINISHED SHALL BE PAINTED. INTERIOR PAINT SHALL BE EGGSHELL FINISH.
- B. PROVIDE FINISH COATS WHICH ARE COMPATIBLE WITH PRIME COATS USED MANUFACTURER APPROVED BARRIER COATS OVER INCOMPATIBLE PRIMERS, OR
- AND REPRIME AS REQUIRED. C. NOTIFY ARCHITECT OF ANY ANTICIPATED PROBLEMS USING SPECIFIED COATING SYSTEMS WITH SUBSTRATES PREPARED BY OTHERS.
- D. PREPARATION: PREPARE AND CLEAN EACH SUBSTRATE IN ACCORDANCE WITH MANUFACTURER'S INSTRUCTIONS. REMOVE ELECTRICAL PLATES, HARDWARE, LIGHT FIXTURES TRIM, AND FITTINGS PRIOR TO PREPARING OR FINISHING SURFACES. THESE ITEMS ARE TO BE CAREFULLY STORED, CLEANED, AND REPLACED ON COMPLETION OF
- WORK IN EACH AREA. E. APPLY COATING IN ACCORDANCE WITH COATING MANUFACTURER'S
- SURFACES TO BE COATED. F. PROVIDE SHERWIN WILLIAMS "ARMORSEAL FLOOR-PLEX 71 PRIMER" AND

USING APPLICATION METHOD BEST SUITED FOR OBTAINING FULL, UNIFORM COVERAGE

- IK WB URETHANE FLOOR ENAMEL" GLOSS FINISH IN FILE RM. #112 AND HALL #111, #113, AND #IIT.
- MANUFACTURED BY 'SHERWIN WILLIAMS', OTHER ACCEPTABLE MANUFACTURERS ARE 'BENJAMIN MOORE

'CON LUX', AND 'PPG'. APPLICATION SHALL BE BY BRUSH OR ROLLER. SPRAY

G. PAINTING SCHEDULE BELOW REFERS TO PAINTING PRODUCTS AS

APPLICATION ONLY UPON ACCEPTANCE BY ARCHITECT

EXTERIOR FERROUS METAL WORK (SEMI-GLOSS) PRIMER PRO INDUSTRIAL PRO-CRYL UNIVERSAL PRIMER IST COAT PRO INDUSTRIAL ZERO VOC ACRYLIC SEMI-GLOSS

INTERIOR FERROUS METAL WORK (SEMI-GLOSS)

IST COAT PRO INDUSTRIAL ZERO VOC ACRYLIC SEMI-GLOSS PRO INDUSTRIAL ZERO VOC ACRYLIC SEMI-GLOSS 2ND COAT INTERIOR GYPSUM WALLBOARD (EGGSHELL-FINISH LATEX)

PRO INDUSTRIAL ZERO VOC ACRYLIC SEMI-GLOSS

PRO INDUSTRIAL PRO-CRYL UNIVERSAL PRIMER

PROMAR 200 ZERO VOC INTERIOR LATEX PRIMER

PRO INDUSTRIAL ZERO VOC ACRYLIC SEMI-GLOSS

PROMAR 200 ZERO VOC INTERIOR EG-SHEL

PROMAR 200 ZERO VOC EG-SHEL IST COAT PROMAR 200 ZERO VOC EG-SHEL 2ND COAT

INTERIOR WOOD (SEMI-GLOSS) PREMIUM WALL AND WOOD PRIMER PRIMER PRO INDUSTRIAL ZERO VOC ACRYLIC SEMI-GLOSS

CMU-CONCRETE MASONRY UNITS (EGGSHELL-FINISH) LOXON BLOCK SURFACER PRIMER PROMAR 200 ZERO VOC INTERIOR EG-SHEL

- 9.4 VINYL COMPOSITION FLOOR TILE
- A. VINYL COMPOSITION FLOOR TILE: PRODUCTS COMPLYING WITH ASTM F 1066 BY ARMSTRONG, AZROCK OR APPROVED EQUAL.
- B. VINYL COMPOSITION FLOOR TILE: I. CLASS: CLASS I (SOLID-COLOR TILE)

4. SIZE: 12 BY 12 INCHES (304.8 BY 304.8 MM)

2. WEARING SURFACE: SMOOTH 3. THICKNESS: I/8 INCH (3.2 MM)

5. COLORS AND PATTERNS: TO BE SELECTED BY ARCHITECT.

9.5 VINYL WALL BASE:

I. PRODUCTS: PROVIDE VINYL WALL BASE AS MANUFACTURED BY

- A. VINYL WALL BASE: PROVIDE VINYL WALL BASE COMPLYING WITH THE FOLLOWING:
- JOHNSONITE, INC., OR EQUAL PRODUCTS BY ONE OF THE FOLLOWING:
- b. MARLEY FLEXCO. 2. COLOR AND PATTERN: AS SELECTED BY ARCHITECT FROM MANUFACTURER'S FULL

6. LENGTHS: COILS IN LENGTHS STANDARD WITH MANUFACTURER, BUT NOT

- RANGE OF COLORS AND PATTERNS PRODUCED FOR VINYL WALL BASE COMPLYING
- REQUIREMENTS INDICATED. 3. STYLE: COVE WITH TOP-SET TOE.
- 4. MINIMUM THICKNESS: 1/8" (3.2 MM) 5. HEIGHT: 6 INCHES (100 MM).
- 96 FEET (29.26 M) 7. OUTSIDE CORNERS: PREMOLDED
- 8. INSIDE CORNERS: PREMOLDED. 9. SURFACE: SMOOTH.


LESS THAN

a. ROPPE CORP.

Rockland County


ROBERT H. GRUFFI, P.E., LEED AP DIRECTOR **FACILITIES MANAGEMENT**

DR. ROBERT L. YEAGER HEALTH CENTER **50 SANATORIUM ROAD BUILDING A, 2ND FLOOR**

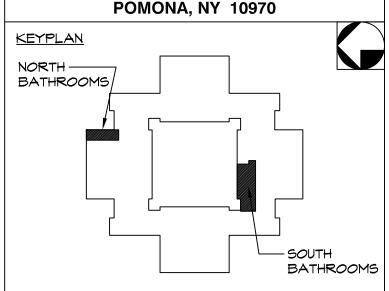

BUILDING F

1ST FLOOR

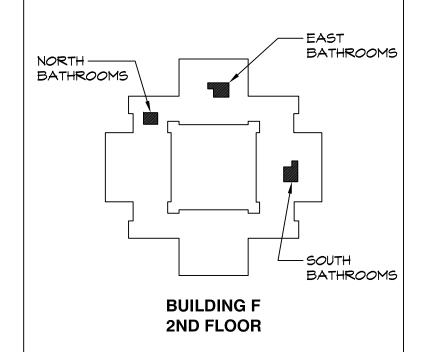

02.09.2022 | ISSUED FOR BID DATE ISSUE NO. DESCRIPTION

CAPITAL PROJECT 2110

BATHROOM RENOVATION DR. ROBERT L. YEAGER HEALTH CENTER **BUILDING F**

POMONA, NY 10970

SHEET TITLE


PROJECT NAME

GENERAL NOTES

DWG NO. SCALE AS NOTED PRJ. NO. 2110 DRAWN AMN CHECKED RHG

2.9.2022

DWG INFO.

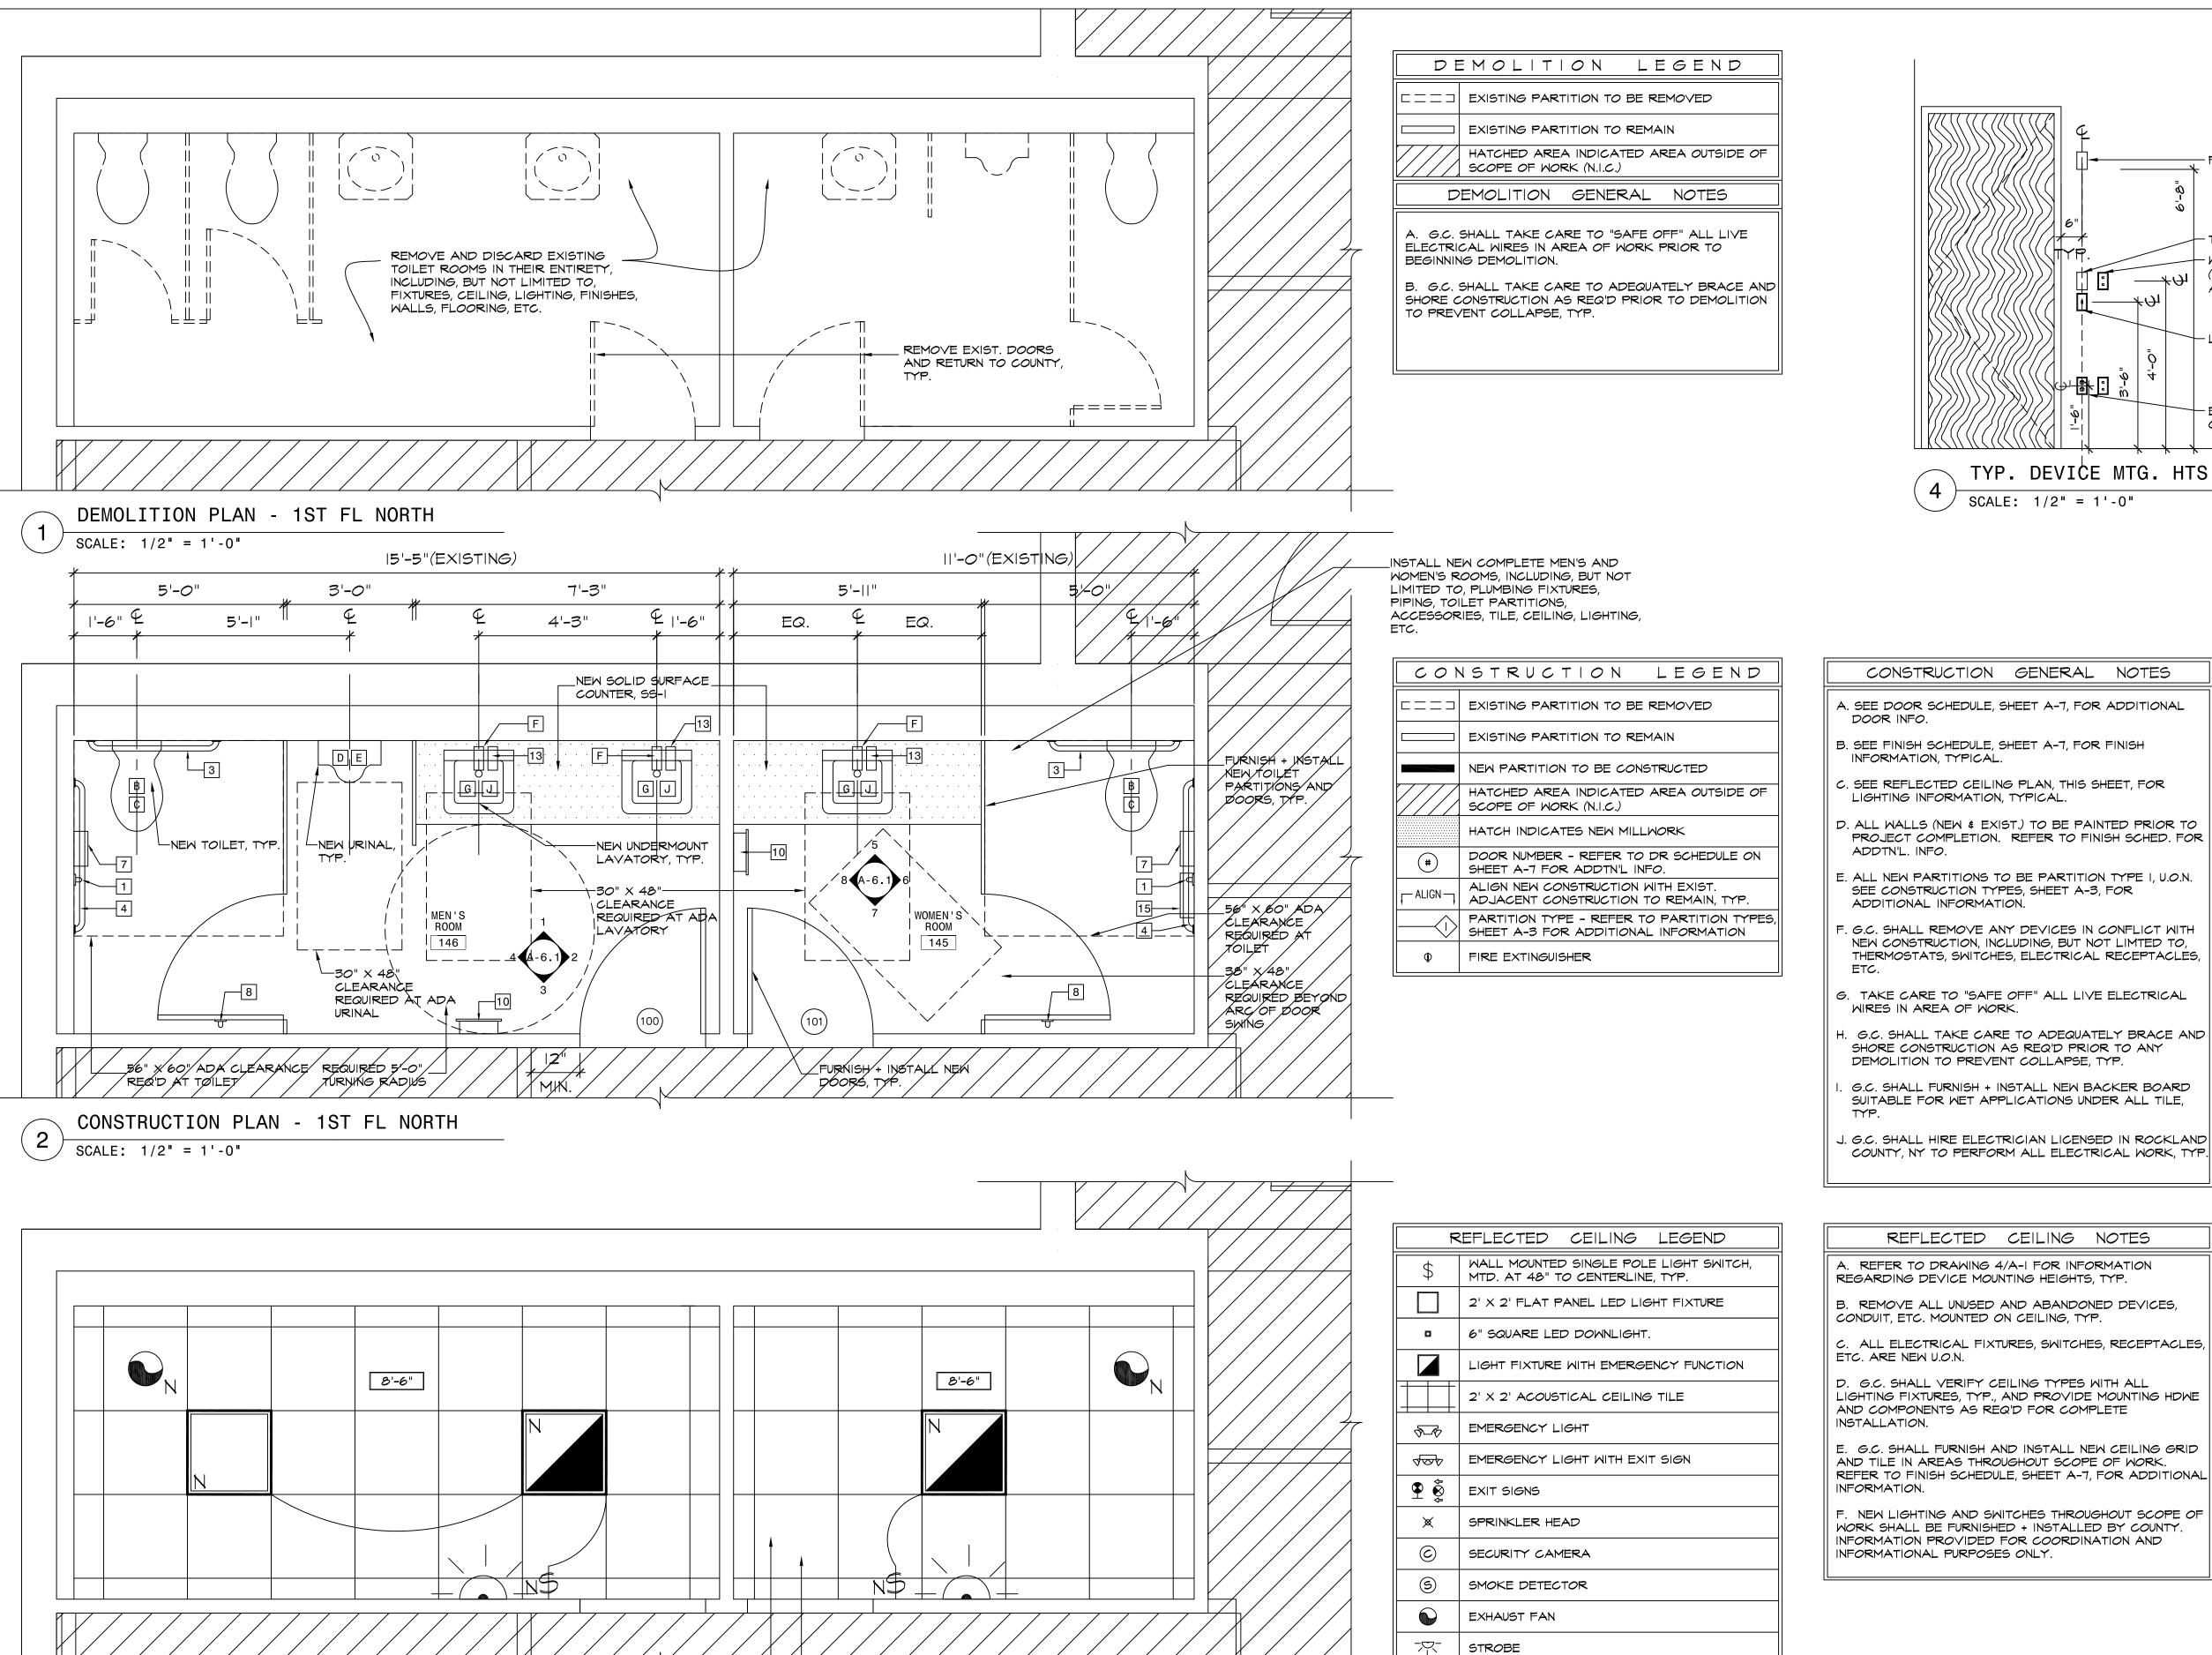

_NEW CEILING GRID AND

CENTER NEW GRIDS IN

TILE, TYP.

ROOMS, U.O.N.


REFLECTED CLG. PLAN - 1ST FL NORTH

SCALE: 1/2" = 1'-0"

NEW ITEM

8'-0" | CEILING HEIGHT AFF

EXISTING ITEM TO REMAIN

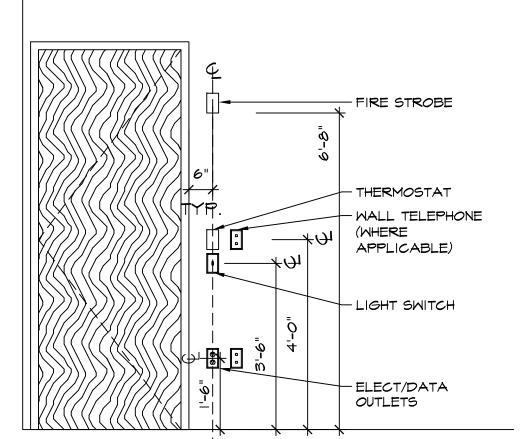

TYP. DEVICE MTG. HTS. SCALE: 1/2" = 1'-0"

CONSTRUCTION GENERAL NOTES

- A. SEE DOOR SCHEDULE, SHEET A-7, FOR ADDITIONAL DOOR INFO.
- B. SEE FINISH SCHEDULE, SHEET A-7, FOR FINISH INFORMATION, TYPICAL.
- C. SEE REFLECTED CEILING PLAN, THIS SHEET, FOR LIGHTING INFORMATION, TYPICAL.
- D. ALL WALLS (NEW & EXIST.) TO BE PAINTED PRIOR TO PROJECT COMPLETION. REFER TO FINISH SCHED. FOR
- E. ALL NEW PARTITIONS TO BE PARTITION TYPE I, U.O.N. SEE CONSTRUCTION TYPES, SHEET A-3, FOR ADDITIONAL INFORMATION.
- . G.C. SHALL REMOVE ANY DEVICES IN CONFLICT WITH NEW CONSTRUCTION, INCLUDING, BUT NOT LIMTED TO, THERMOSTATS, SWITCHES, ELECTRICAL RECEPTACLES
- G. TAKE CARE TO "SAFE OFF" ALL LIVE ELECTRICAL WIRES IN AREA OF WORK.
- H. G.C. SHALL TAKE CARE TO ADEQUATELY BRACE AND SHORE CONSTRUCTION AS REQ'D PRIOR TO ANY DEMOLITION TO PREVENT COLLAPSE, TYP.
- G.C. SHALL FURNISH + INSTALL NEW BACKER BOARD SUITABLE FOR WET APPLICATIONS UNDER ALL TILE,
- J. G.C. SHALL HIRE ELECTRICIAN LICENSED IN ROCKLAND|| COUNTY, NY TO PERFORM ALL ELECTRICAL WORK, TYP.


HOT WATER HEATER NOTES


- A. PLUMBING CONTRACTOR SHALL REMOVE AND REPLACE EXISTING ELECTRIC 208Y 5KW 65 GALLON HOT WATER HEATER. HEW HOT WATER HEATER TO BE MOUNTED ATOP NEW 4" CONCRETE HOUSEKEEPING PAD. (RHEEM-RUDD MN: ELD66-C FOR REFERENCE). LOCATION OF HOT WATER HEATER IS IN FIRST FLOOR EAST MECHANICAL
- B. PLUMBING CONTRACTOR SHALL PROVIDE NEW STAINLESS HOT WATER RECIRC PUMP AND AQUA STAT.
- C. GENERAL CONTRACTOR SHALL FABRICATE AND INSTALL NEW 4" HIGH X 36" SQUARE CONCRETE HOUSEKEEPING PAD FOR NEW DOMESTIC HOT WATER HEATER.


Rockland County

ROBERT H. GRUFFI, P.E., LEED AP DIRECTOR **FACILITIES MANAGEMENT**

DR. ROBERT L. YEAGER HEALTH CENTER **50 SANATORIUM ROAD BUILDING A, 2ND FLOOR POMONA, NY 10970**

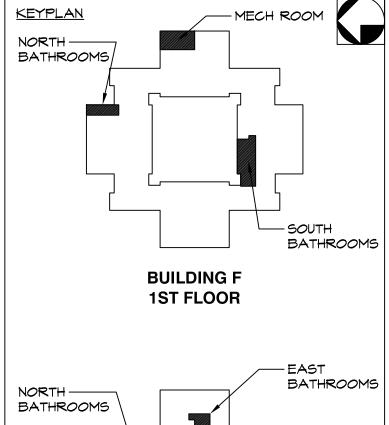

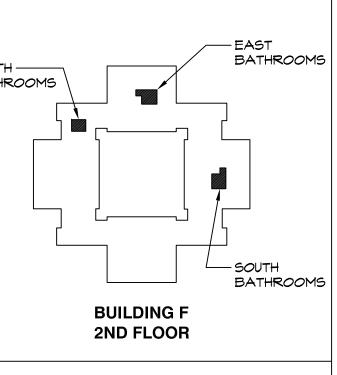

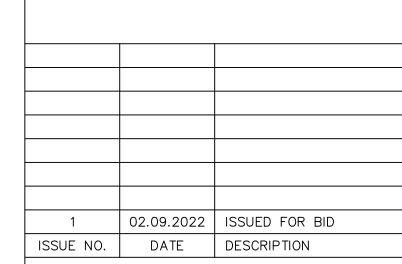

PROJECT NAME

CAPITAL PROJECT 2110

BATHROOM RENOVATION

DR. ROBERT L. YEAGER HEALTH CENTER **BUILDING F POMONA, NY 10970**


SHEET TITLE


FIRST FL. NORTH **BATHROOM**


DEMOLITION PLAN CONSTRUCTION PLAN REFLECTED CLG. PLAN

SCALE PRJ. NO. DRAWN CHECKED

DWG NO. DWG INFO. AS NOTED 2110 RHG 2.9.2022

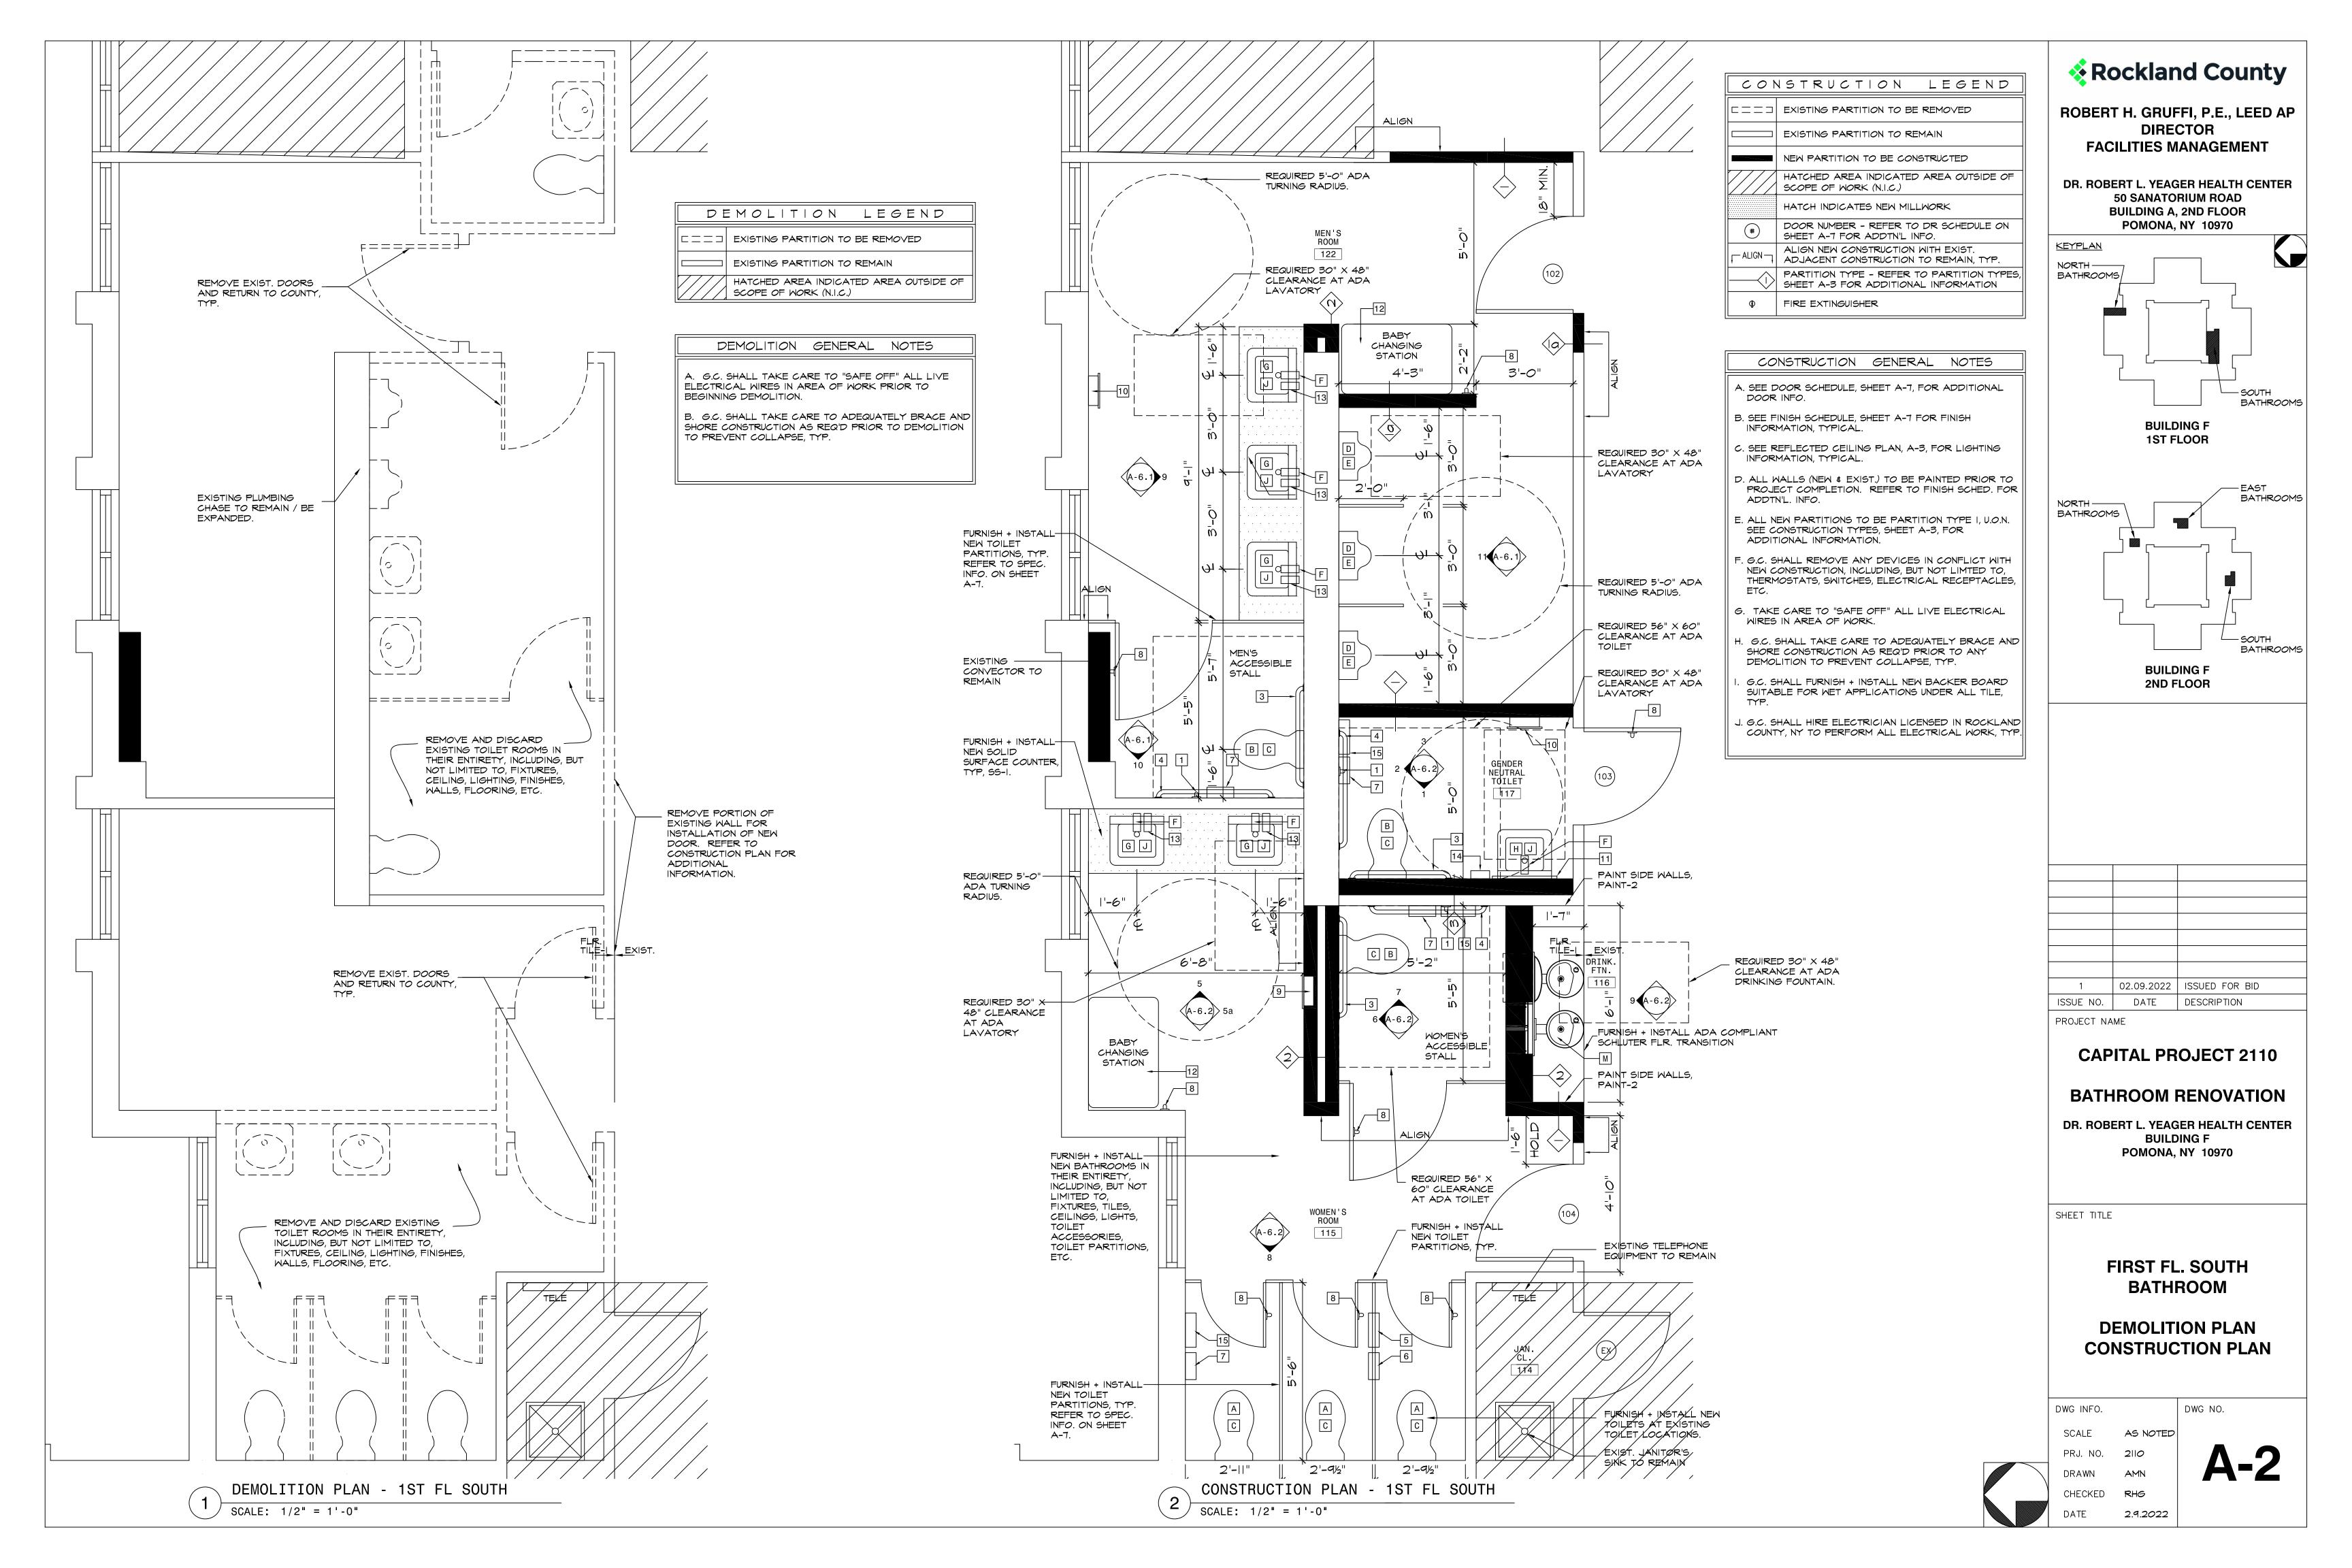

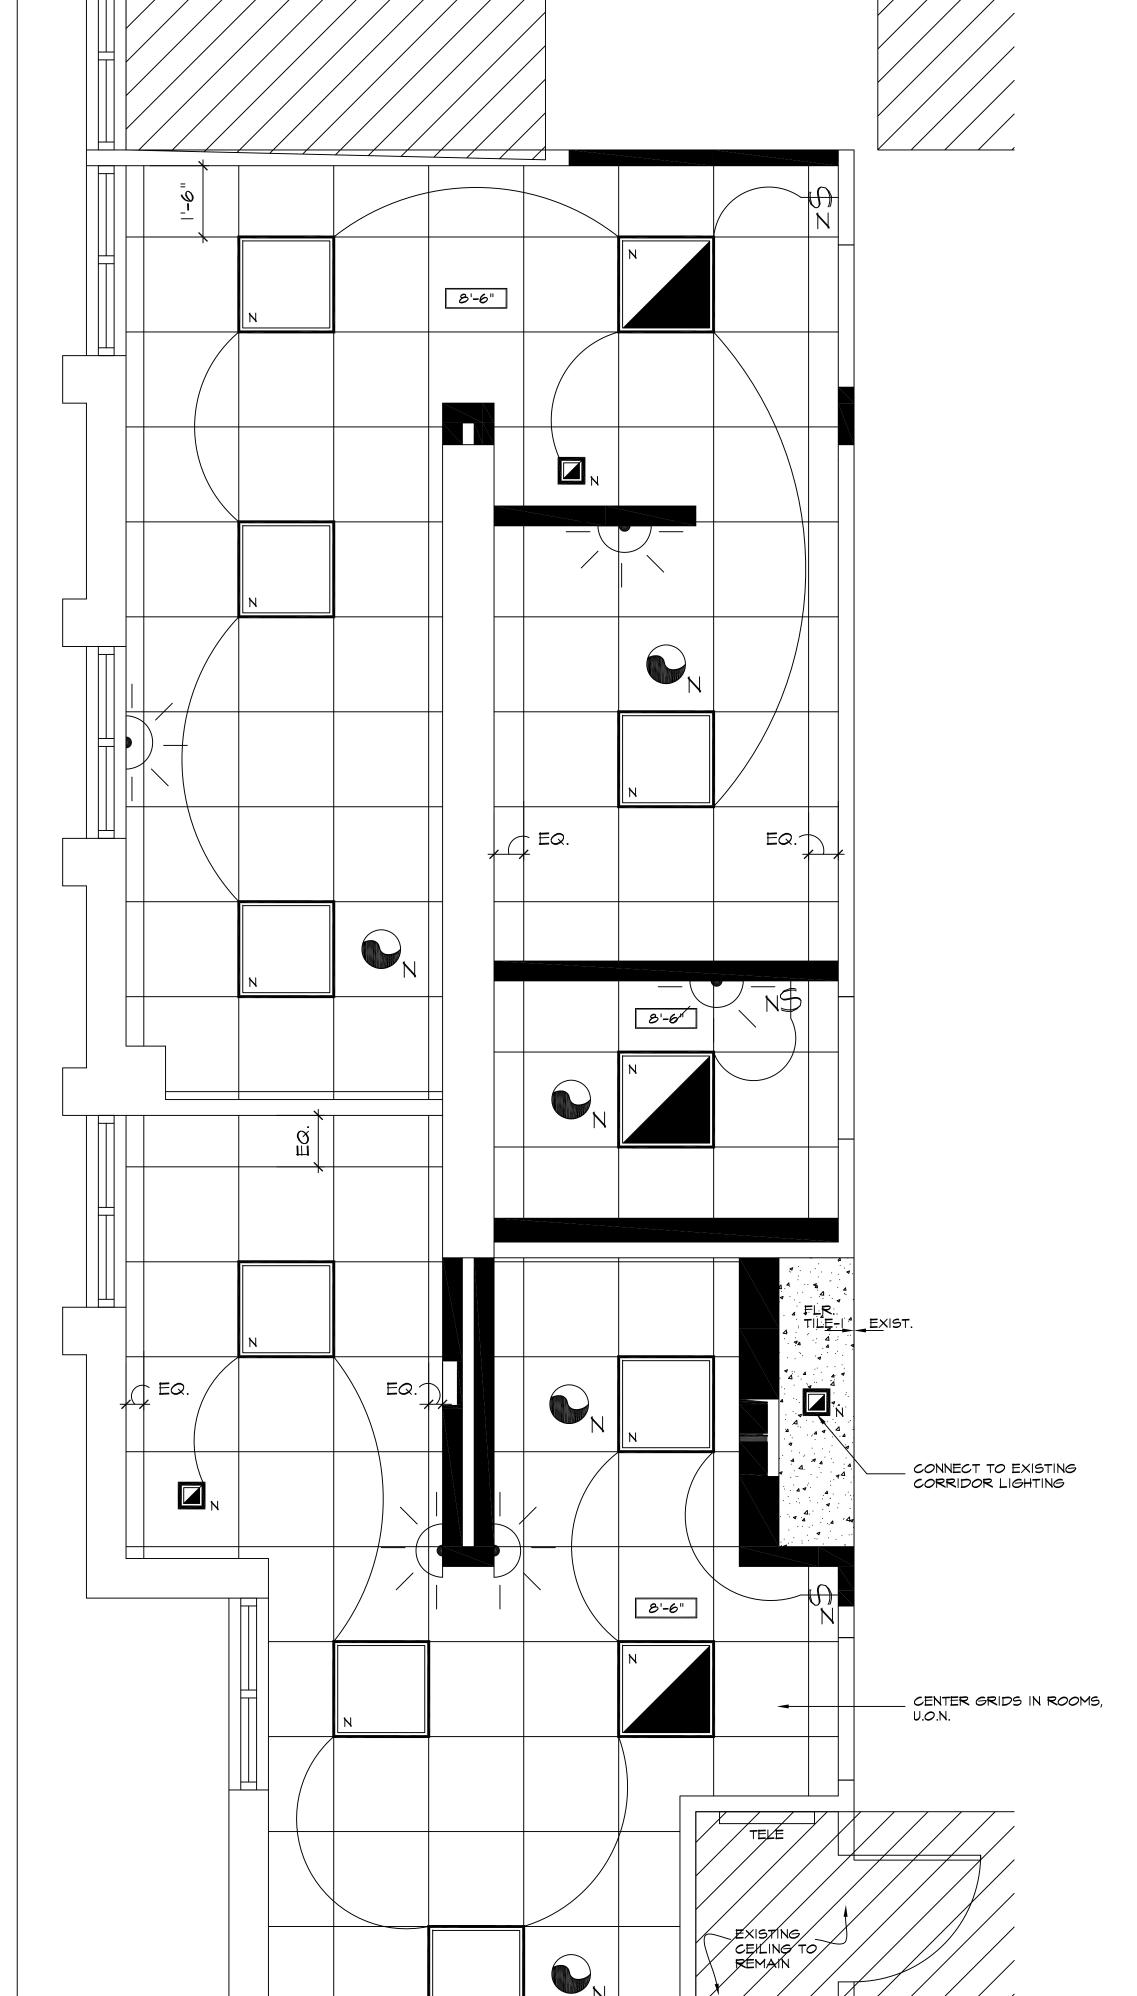

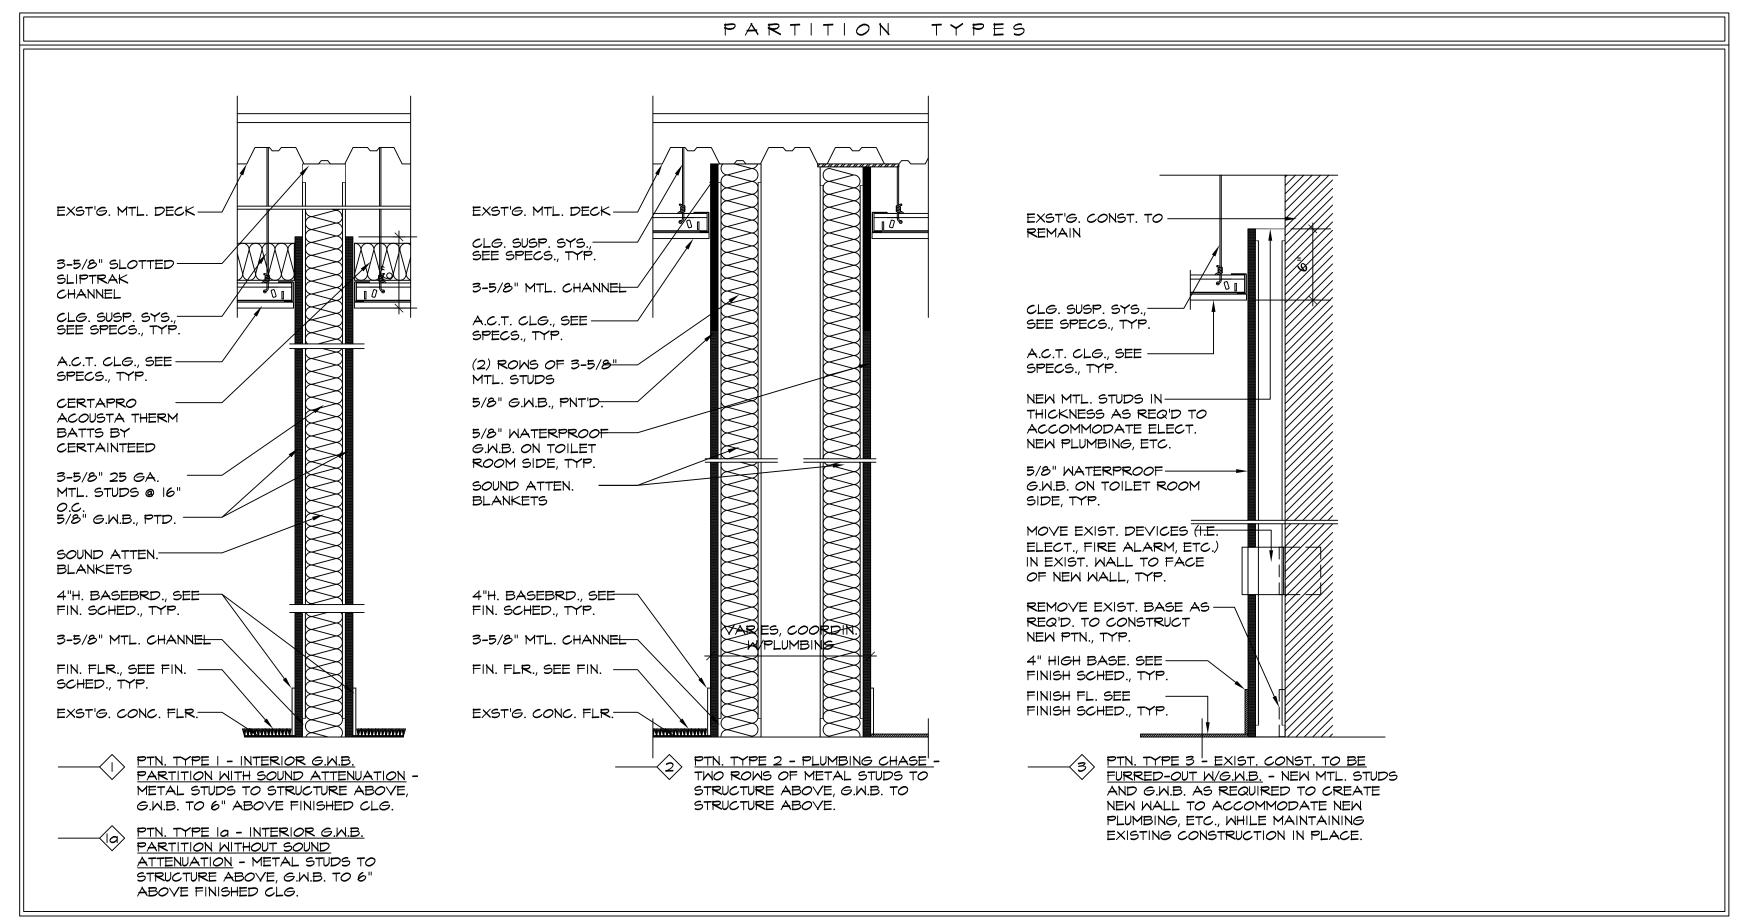



F	REFLECTED CEILING LEGEND	
\$	MALL MOUNTED SINGLE POLE LIGHT SWITCH, MTD. AT 48" TO CENTERLINE, TYP.	
	2' X 2' FLAT PANEL LED LIGHT FIXTURE	
0	6" SQUARE LED DOWNLIGHT.	
	LIGHT FIXTURE WITH EMERGENCY FUNCTION	
	2' X 2' ACOUSTICAL CEILING TILE	
₽ ₽	EMERGENCY LIGHT	
400	EMERGENCY LIGHT WITH EXIT SIGN	
\$ \$	EXIT SIGNS	
×	SPRINKLER HEAD	
0	SECURITY CAMERA	
(5)	SMOKE DETECTOR	
	EXHAUST FAN	
不	STROBE	
N	NEW ITEM	
E	EXISTING ITEM TO REMAIN	
8'-0"	CEILING HEIGHT AFF	

REFLECTED CEILING NOTES				
A. REFER TO DRAWING 4/A-I FOR INFORMATION REGARDING DEVICE MOUNTING HEIGHTS, TYP.				
B. REMOVE ALL UNUSED AND ABANDONED DEVICES, CONDUIT, ETC. MOUNTED ON CEILING, TYP.				
C. ALL ELECTRICAL FIXTURES, SWITCHES, RECEPTACLES, ETC. ARE NEW U.O.N.				
D. G.C. SHALL VERIFY CEILING TYPES WITH ALL LIGHTING FIXTURES, TYP., AND PROVIDE MOUNTING HOWE AND COMPONENTS AS REQ'D FOR COMPLETE INSTALLATION.				
E. G.C. SHALL FURNISH AND INSTALL NEW CEILING GRID AND TILE IN AREAS THROUGHOUT SCOPE OF WORK. REFER TO FINISH SCHEDULE, SHEET A-7, FOR ADDITIONAL INFORMATION.				
F. NEW LIGHTING AND SWITCHES THROUGHOUT SCOPE OF WORK SHALL BE FURNISHED + INSTALLED BY COUNTY. INFORMATION PROVIDED FOR COORDINATION AND INFORMATIONAL PURPOSES ONLY.				

ROBERT H. GRUFFI, P.E., LEED AP DIRECTOR FACILITIES MANAGEMENT

DR. ROBERT L. YEAGER HEALTH CENTER **50 SANATORIUM ROAD BUILDING A, 2ND FLOOR POMONA, NY 10970**

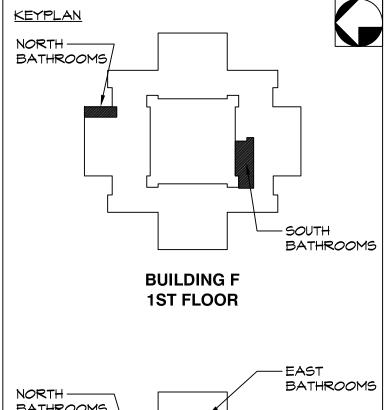

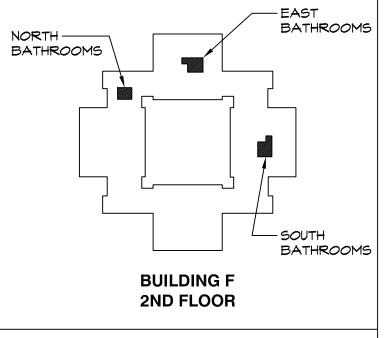

1	02.09.2022	ISSUED FOR BID
ISSUE NO.	DATE	DESCRIPTION

PROJECT NAME

CAPITAL PROJECT 2110

BATHROOM RENOVATION

DR. ROBERT L. YEAGER HEALTH CENTER BUILDING F POMONA, NY 10970

SHEET TITLE

DWG INFO.

FIRST FL. SOUTH **BATHROOM**


REFLECTED CLG. PLAN


PARTITION TYPES


2.9.2022


SCALE DRAWN

DWG NO. AS NOTED PRJ. NO. 211*0* CHECKED RHG

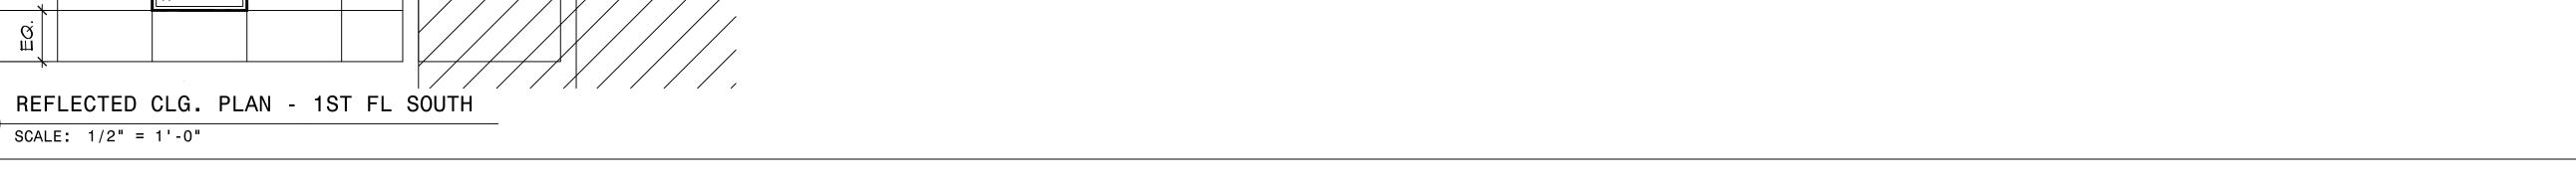

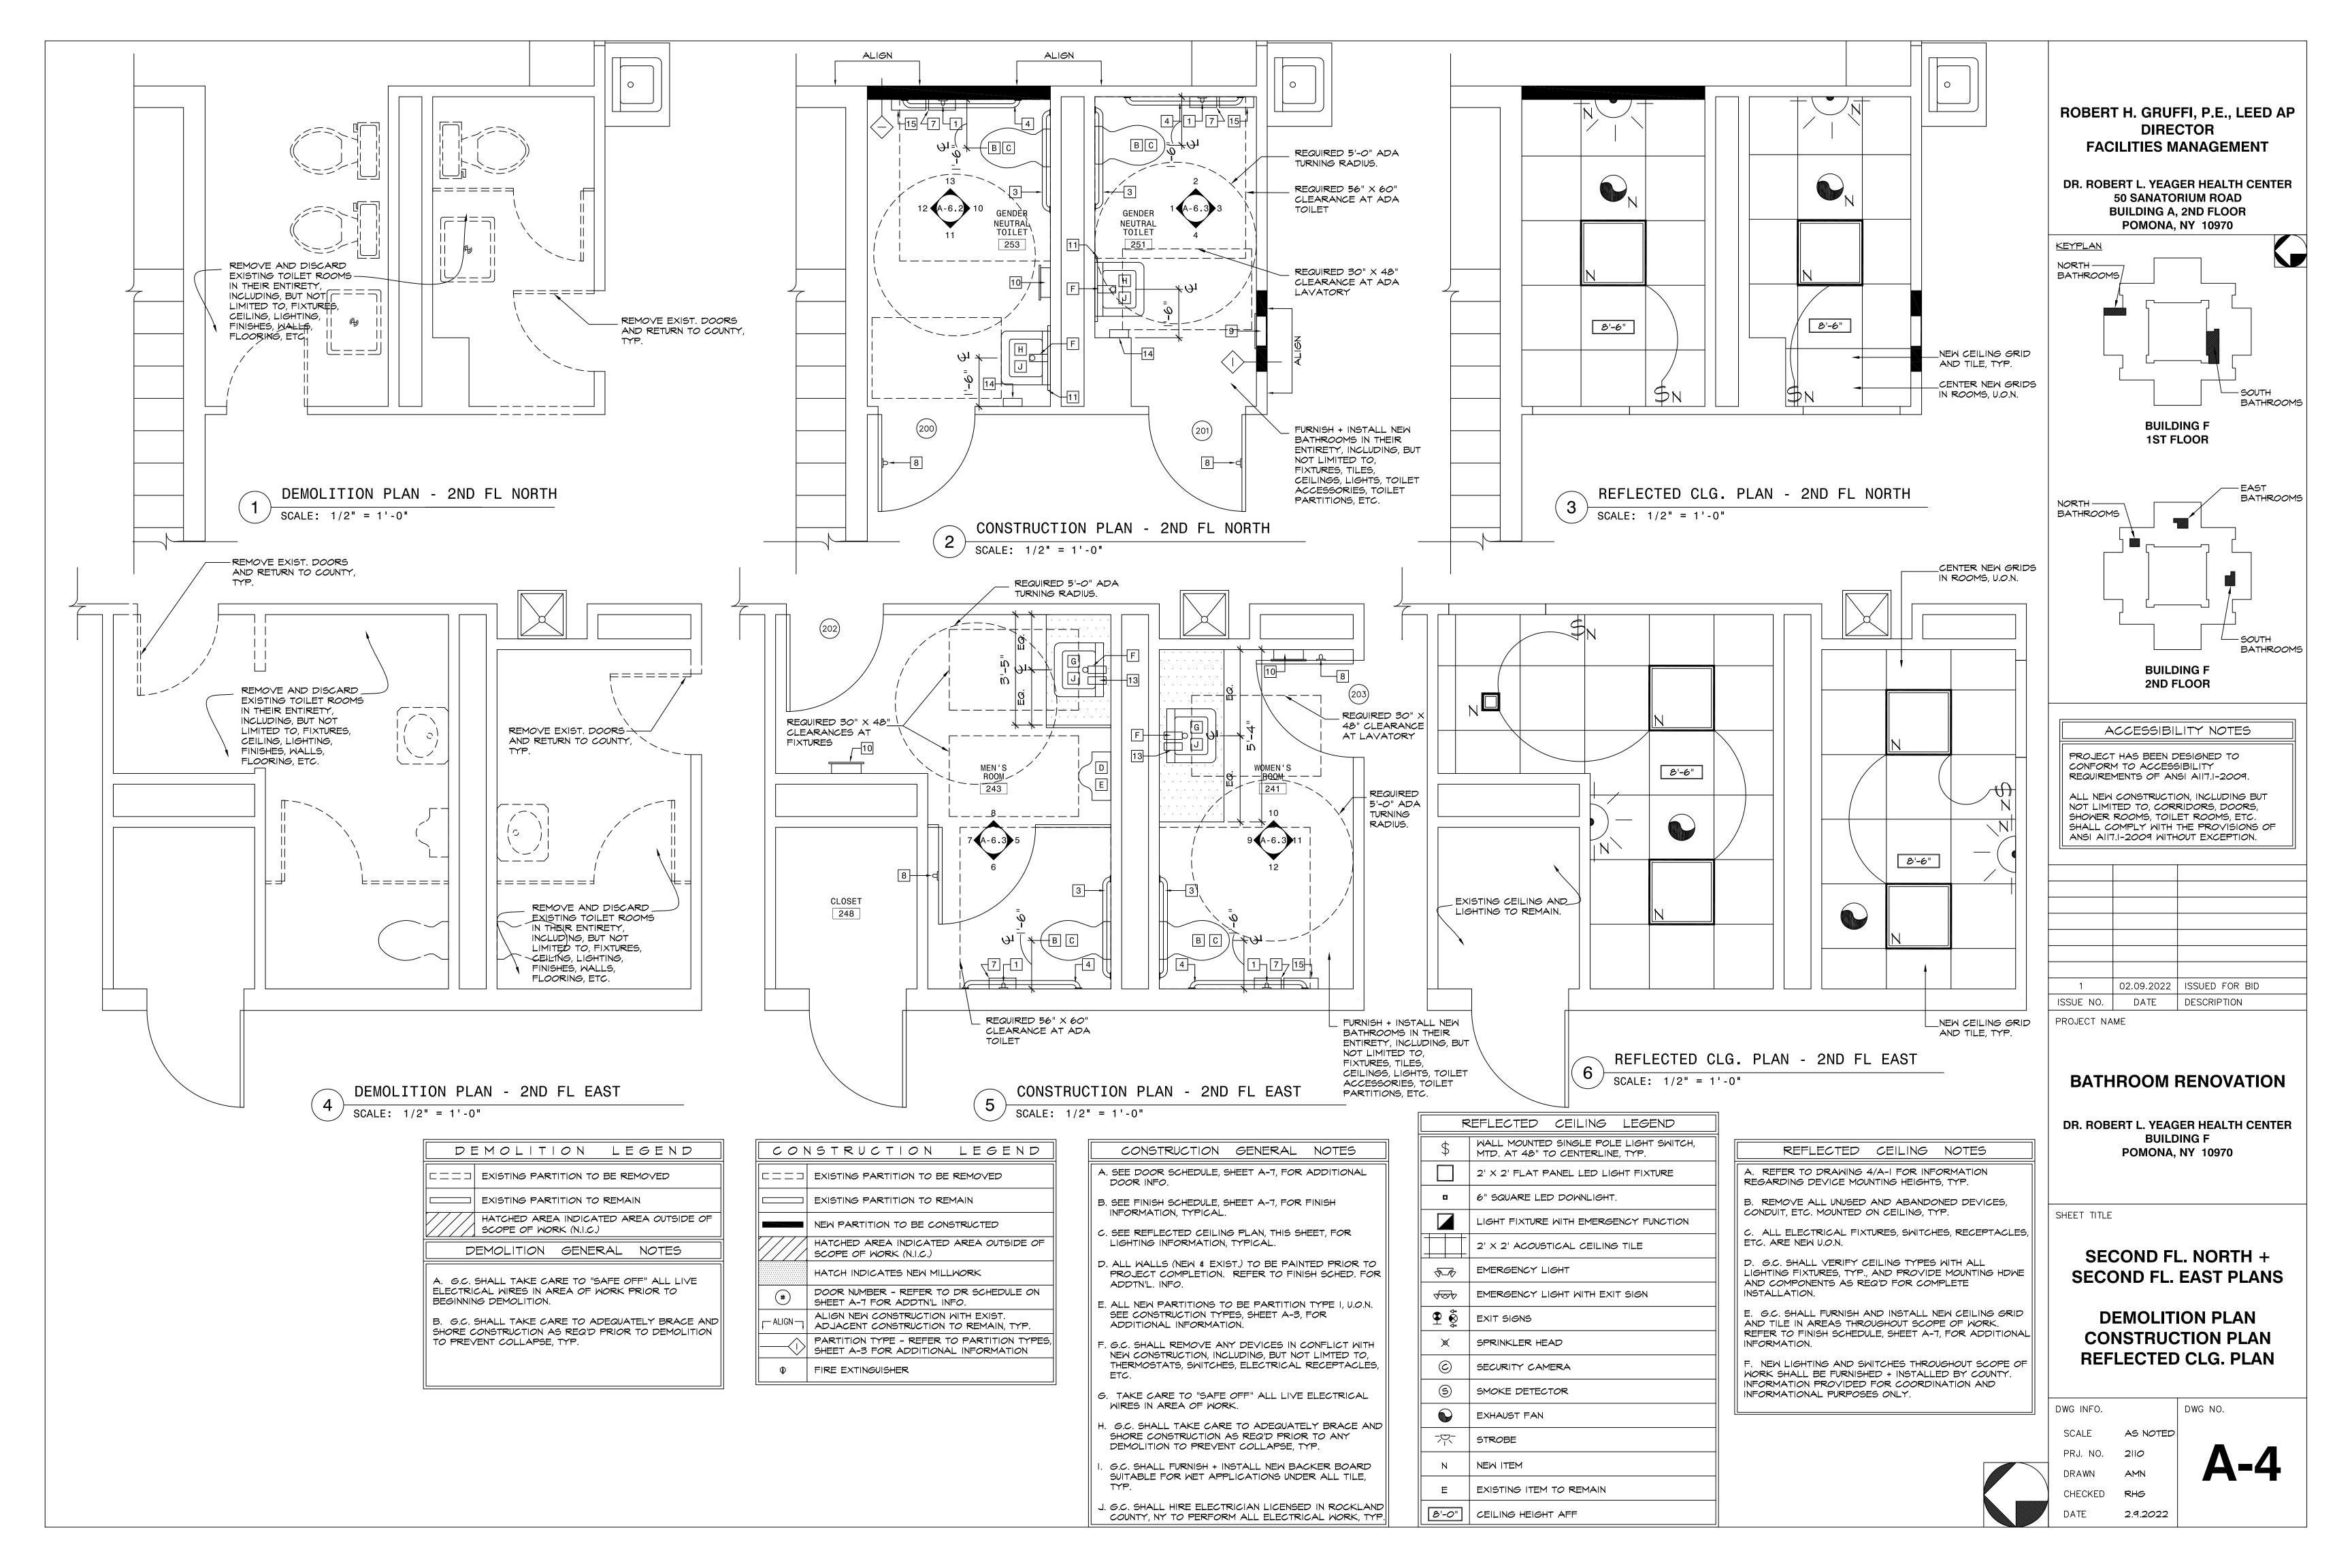

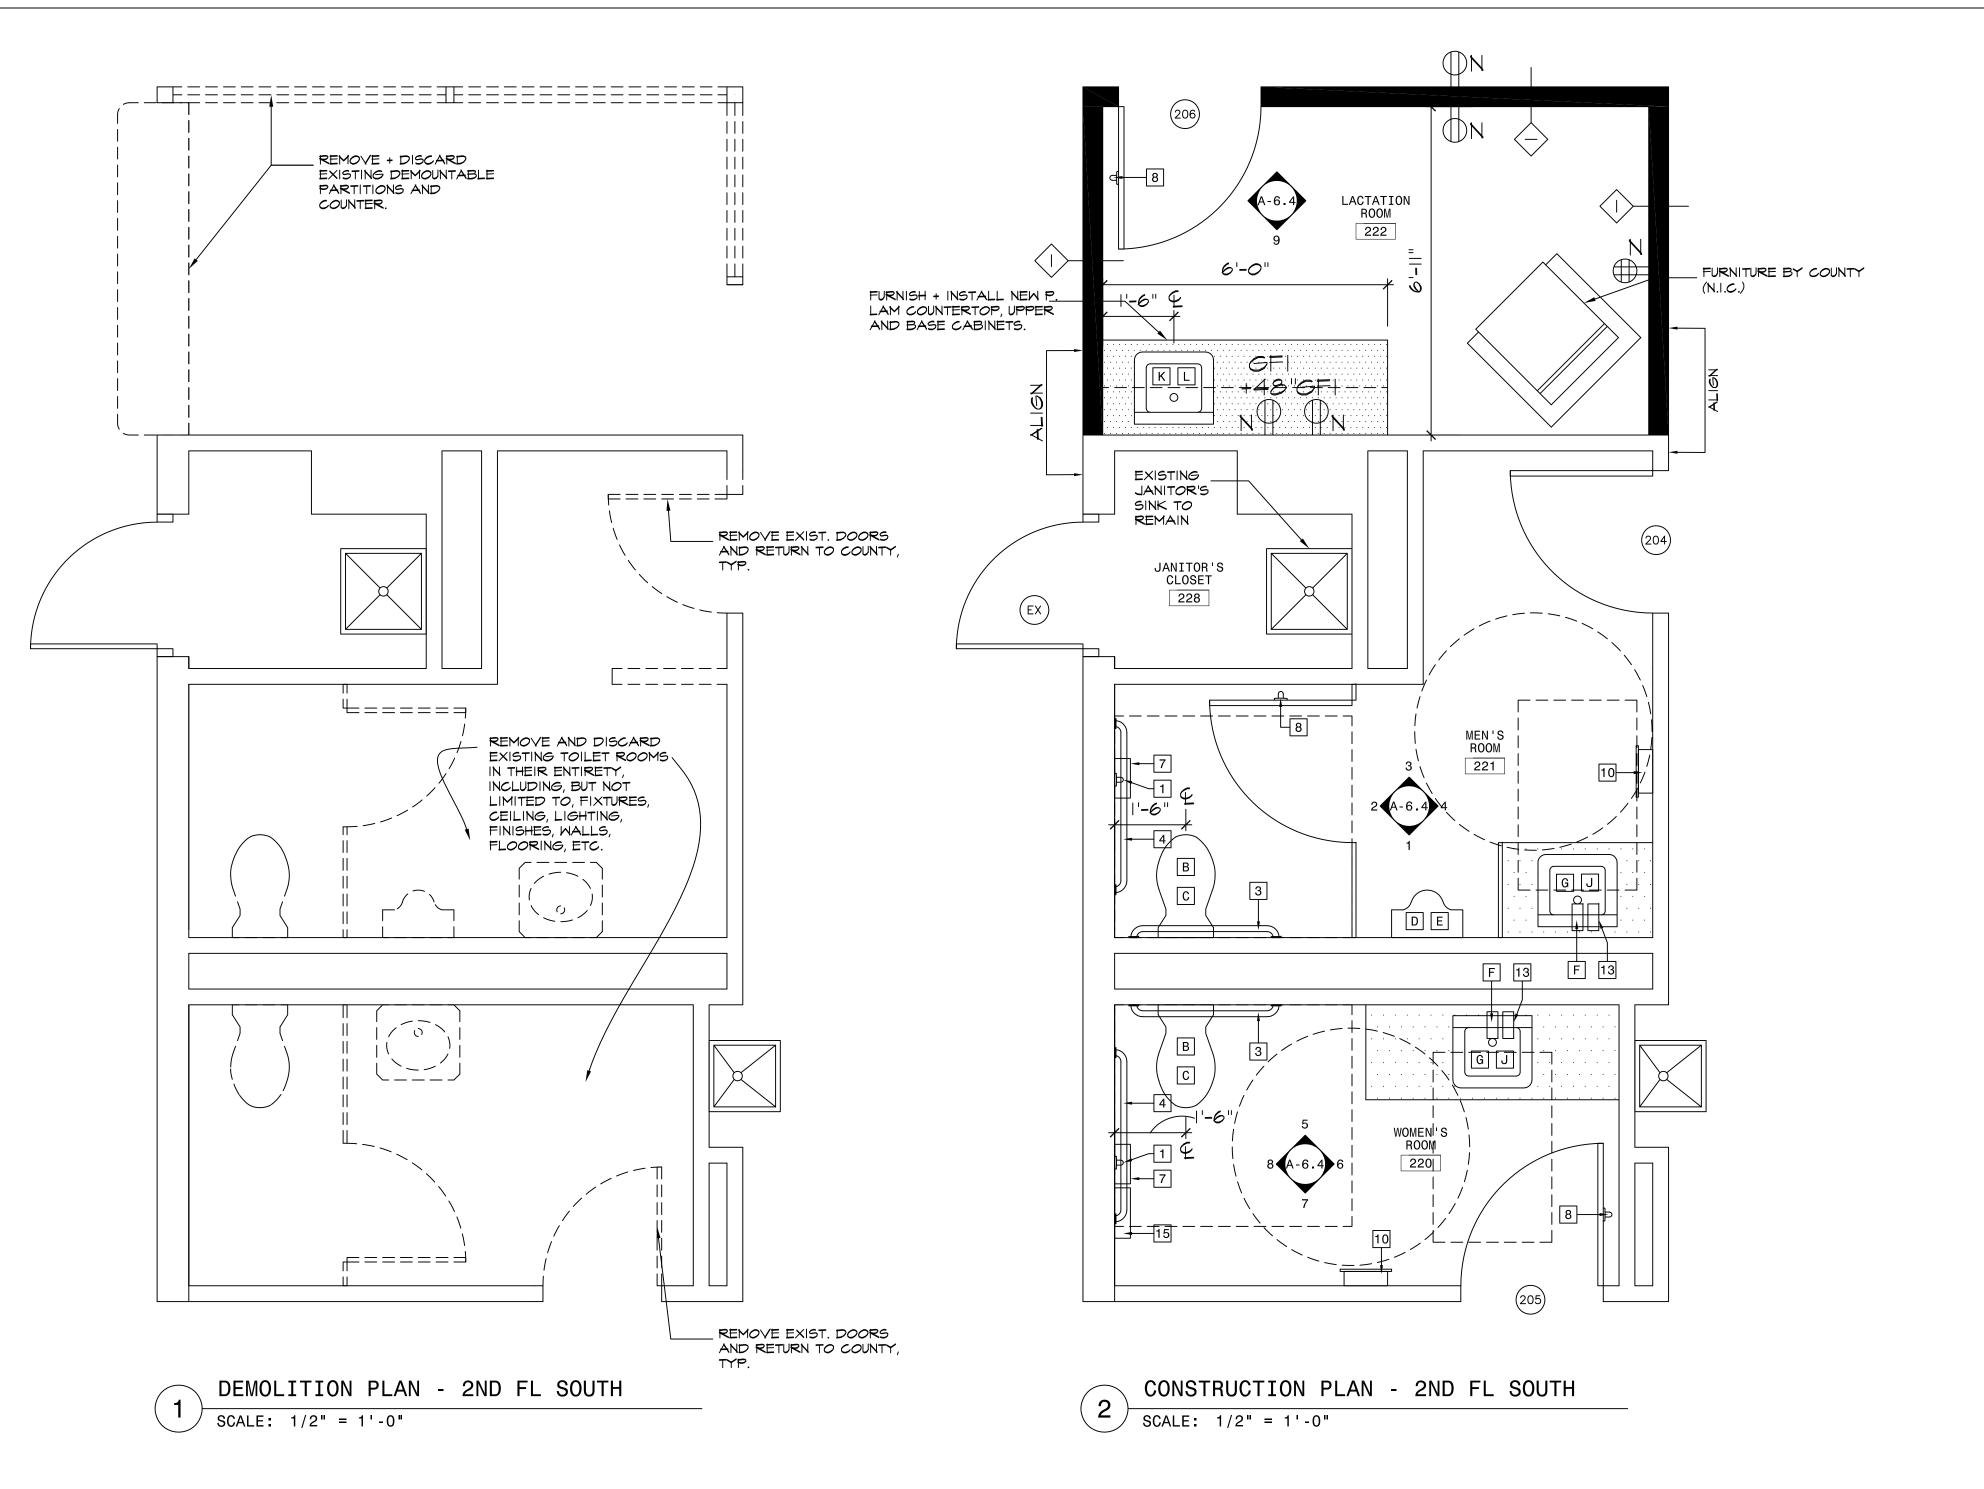

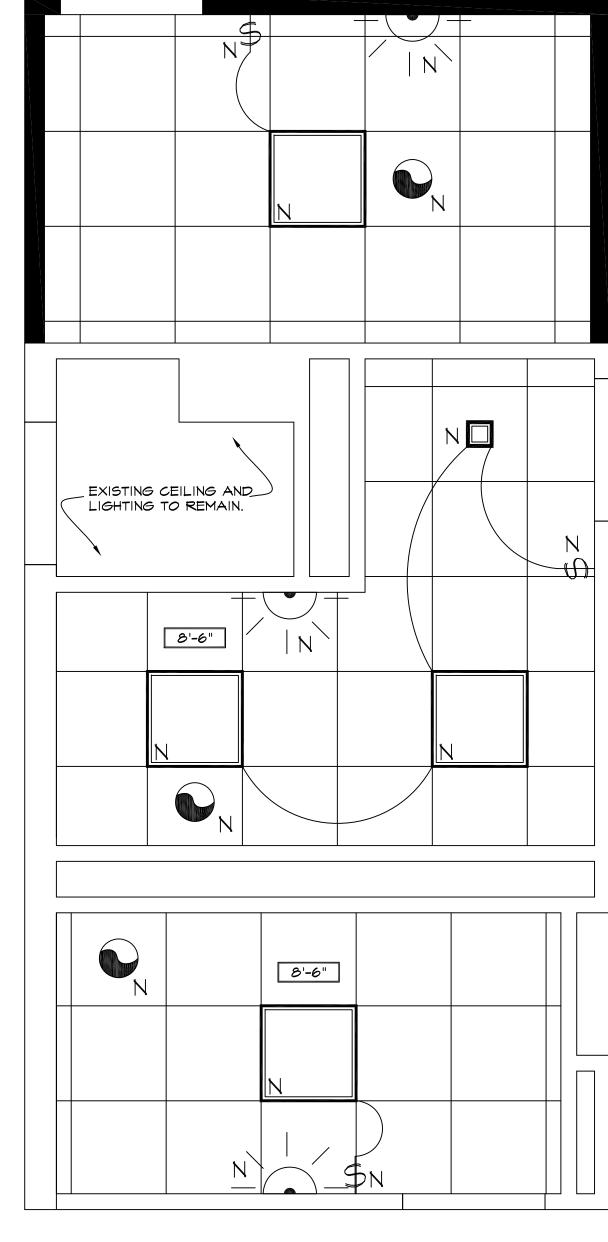

REFLECTED CLG. PLAN - 2ND FL SOUTH SCALE: 1/2" = 1'-0"

DEMOLITION LEGEND EXISTING PARTITION TO BE REMOVED EXISTING PARTITION TO REMAIN HATCHED AREA INDICATED AREA OUTSIDE OF / SCOPE OF WORK (N.I.C.) DEMOLITION GENERAL NOTES A. G.C. SHALL TAKE CARE TO "SAFE OFF" ALL LIVE ELECTRICAL WIRES IN AREA OF WORK PRIOR TO

BEGINNING DEMOLITION. B. G.C. SHALL TAKE CARE TO ADEQUATELY BRACE AND

SHORE CONSTRUCTION AS REQ'D PRIOR TO DEMOLITION TO PREVENT COLLAPSE, TYP.

C O 1	CONSTRUCTION LEGEND				
	EXISTING PARTITION TO BE REMOVED				
	EXISTING PARTITION TO REMAIN				
	NEW PARTITION TO BE CONSTRUCTED				
	HATCHED AREA INDICATED AREA OUTSIDE OF SCOPE OF WORK (N.I.C.)				
	HATCH INDICATES NEW MILLWORK				
#	DOOR NUMBER - REFER TO DR SCHEDULE ON SHEET A-7 FOR ADDTN'L INFO.				
ALIGN ─	ALIGN NEW CONSTRUCTION WITH EXIST. ADJACENT CONSTRUCTION TO REMAIN, TYP.				
	PARTITION TYPE - REFER TO PARTITION TYPES, SHEET A-3 FOR ADDITIONAL INFORMATION				
Φ	FIRE EXTINGUISHER				

] [L
OVED	
TED	
A OUTSIDE OF	
CHEDULE ON	
EXIST. MAIN, TYP.	
RTITION TYPES, ORMATION	

CONSTRUCTION GENERAL NOTES

J. G.C. SHALL HIRE ELECTRICIAN LICENSED IN ROCKLAND COUNTY, NY TO PERFORM ALL ELECTRICAL WORK, TYP.

	11		
INFORMATION, TYPICAL.			6" SQUARE LED DOWNLIGHT.
C. SEE REFLECTED CEILING PLAN, THIS SHEET, FOR LIGHTING INFORMATION, TYPICAL.			LIGHT FIXTURE WITH EMERGENCY FUNCTION
D. ALL WALLS (NEW & EXIST.) TO BE PAINTED PRIOR TO PROJECT COMPLETION. REFER TO FINISH SCHED. FOR			2' X 2' ACOUSTICAL CEILING TILE
ADDTN'L. INFO.		₹	EMERGENCY LIGHT
E. ALL NEW PARTITIONS TO BE PARTITION TYPE I, U.O.N. SEE CONSTRUCTION TYPES, SHEET A-3, FOR ADDITIONAL INFORMATION.		400	EMERGENCY LIGHT WITH EXIT SIGN
F. G.C. SHALL REMOVE ANY DEVICES IN CONFLICT WITH		\$ \$	EXIT SIGNS
NEW CONSTRUCTION, INCLUDING, BUT NOT LIMTED TO, THERMOSTATS, SWITCHES, ELECTRICAL RECEPTACLES, ETC.		×	SPRINKLER HEAD
G. TAKE CARE TO "SAFE OFF" ALL LIVE ELECTRICAL		©	SECURITY CAMERA
WIRES IN AREA OF WORK.		(5)	SMOKE DETECTOR
H. G.C. SHALL TAKE CARE TO ADEQUATELY BRACE AND SHORE CONSTRUCTION AS REQ'D PRIOR TO ANY DEMOLITION TO PREVENT COLLAPSE, TYP.		•	EXHAUST FAN
I. G.C. SHALL FURNISH + INSTALL NEW BACKER BOARD		不	STROBE
SUITABLE FOR WET APPLICATIONS UNDER ALL TILE, TYP.		N	NEW ITEM

F	REFLECTED CEILING LEGEND			
\$ WALL MOUNTED SINGLE POLE LIGHT SWITCH, MTD. AT 48" TO CENTERLINE, TYP.				
	2' X 2' FLAT PANEL LED LIGHT FIXTURE			
0	6" SQUARE LED DOWNLIGHT.			
	LIGHT FIXTURE WITH EMERGENCY FUNCTION			
	2' X 2' ACOUSTICAL CEILING TILE			
50 EMERGENCY LIGHT				
400	EMERGENCY LIGHT WITH EXIT SIGN			
₹ Š EXIT SIGNS				
X SPRINKLER HEAD				
© SECURITY CAMERA				
9	SMOKE DETECTOR			
	EXHAUST FAN			
不	STROBE			
N	NEW ITEM			
E	EXISTING ITEM TO REMAIN			
8'-0"	CEILING HEIGHT AFF			

REFLECTED CEILING NOTES				
A. REFER TO DRAWING 4/A-I FOR INFORMATION REGARDING DEVICE MOUNTING HEIGHTS, TYP.				
B. REMOVE ALL UNUSED AND ABANDONED DEVICES, CONDUIT, ETC. MOUNTED ON CEILING, TYP.				
C. ALL ELECTRICAL FIXTURES, SWITCHES, RECEPTACLES, ETC. ARE NEW U.O.N.				
D. G.C. SHALL VERIFY CEILING TYPES WITH ALL LIGHTING FIXTURES, TYP., AND PROVIDE MOUNTING HDWE AND COMPONENTS AS REQ'D FOR COMPLETE INSTALLATION.				
E. G.C. SHALL FURNISH AND INSTALL NEW CEILING GRID AND TILE IN AREAS THROUGHOUT SCOPE OF WORK. REFER TO FINISH SCHEDULE, SHEET A-7, FOR ADDITIONAL INFORMATION.				


F. NEW LIGHTING AND SWITCHES THROUGHOUT SCOPE OF

WORK SHALL BE FURNISHED + INSTALLED BY COUNTY. INFORMATION PROVIDED FOR COORDINATION AND

INFORMATIONAL PURPOSES ONLY.


ROBERT H. GRUFFI, P.E., LEED AP **DIRECTOR FACILITIES MANAGEMENT**

DR. ROBERT L. YEAGER HEALTH CENTER **50 SANATORIUM ROAD BUILDING A, 2ND FLOOR**

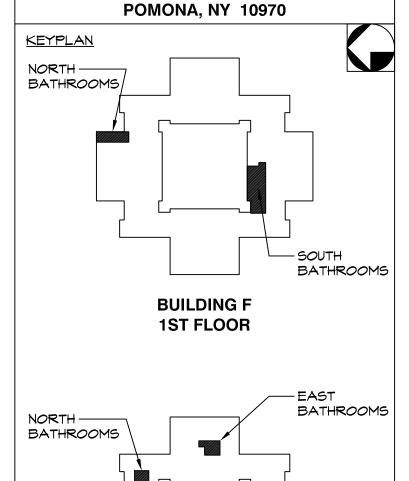

- SOUTH

BATHROOMS

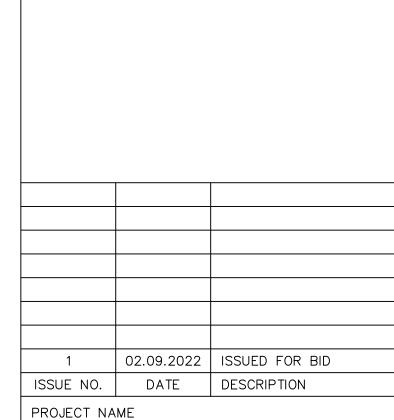

BUILDING F 2ND FLOOR

BATHROOM RENOVATION

DR. ROBERT L. YEAGER HEALTH CENTER **BUILDING F POMONA, NY 10970**

SHEET TITLE


SECOND FL. SOUTH PLANS


DEMOLITION PLAN CONSTRUCTION PLAN REFLECTED CLG. PLAN

DWG NO.

SCALE	AS NOTED
PRJ. NO.	2110
DRAWN	AMN
CHECKED	RHG
DATE	2.9.2022


DWG INFO.

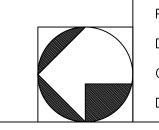


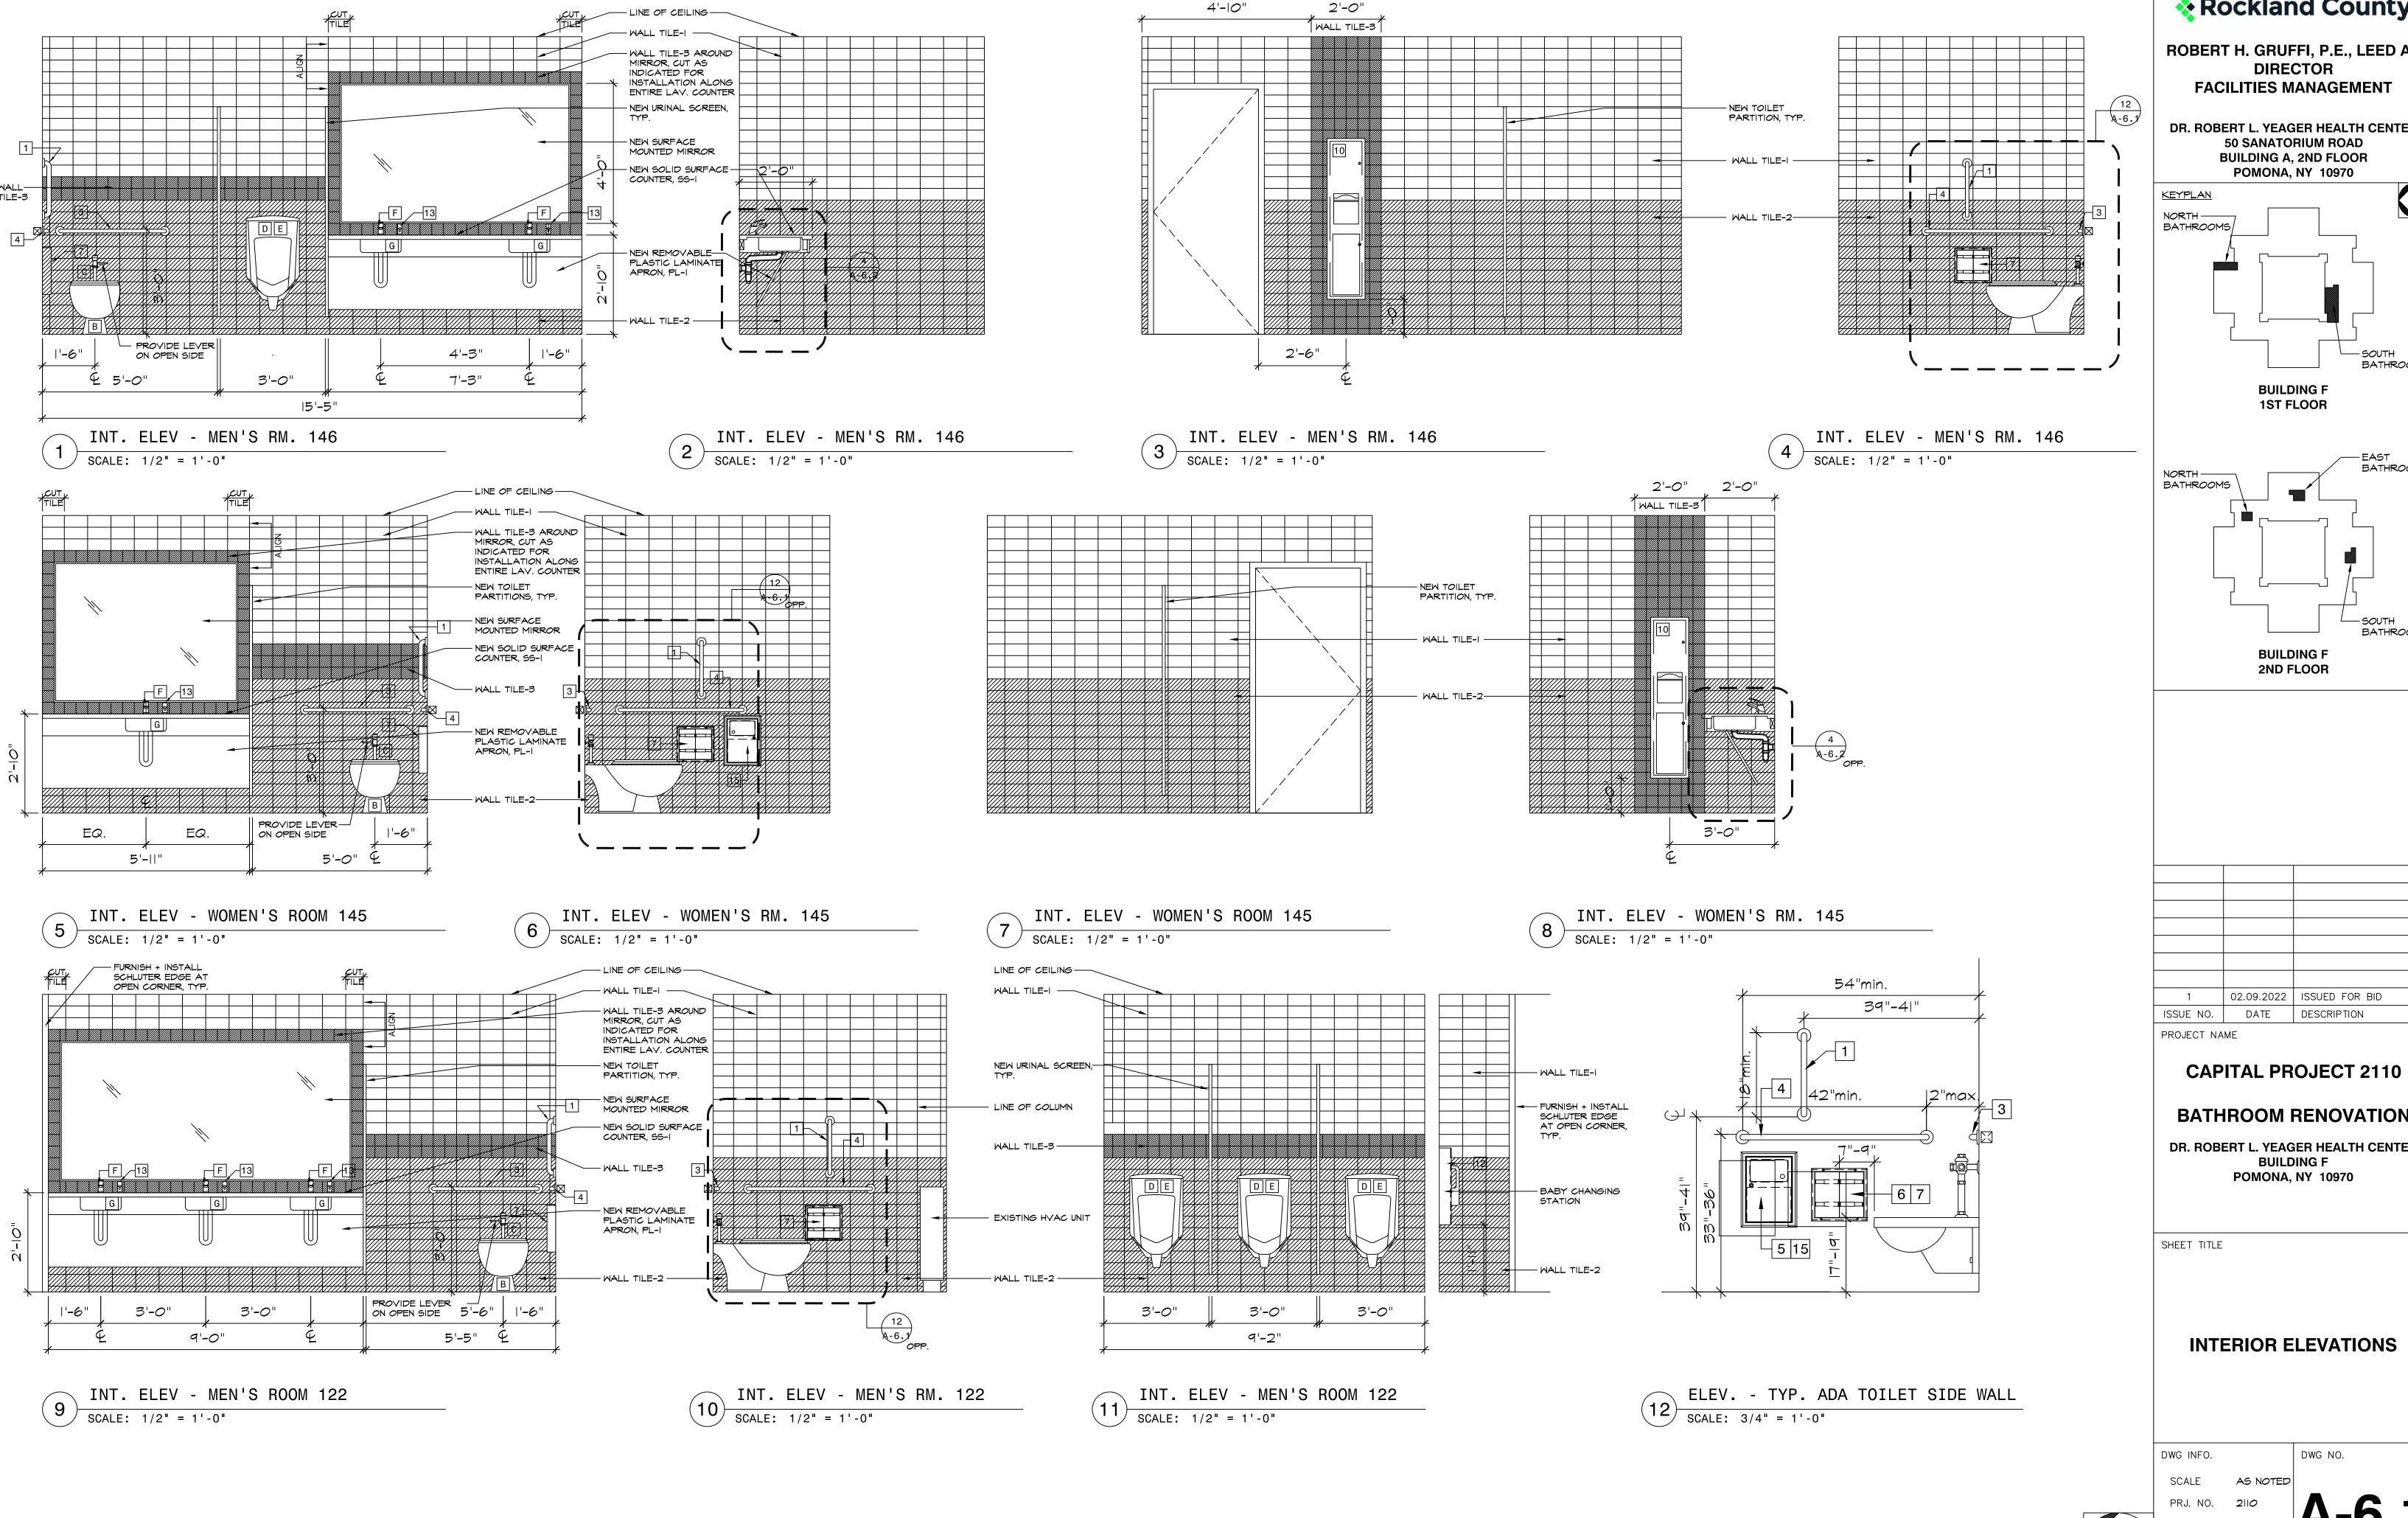


ROBERT H. GRUFFI, P.E., LEED AP DIRECTOR

DR. ROBERT L. YEAGER HEALTH CENTER **50 SANATORIUM ROAD BUILDING A, 2ND FLOOR**

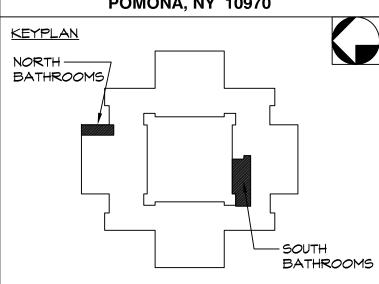

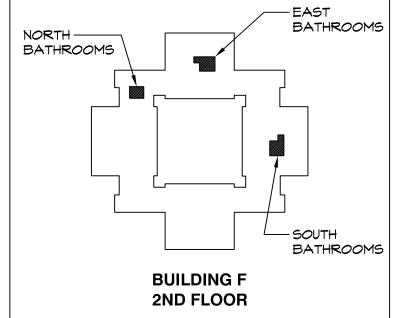

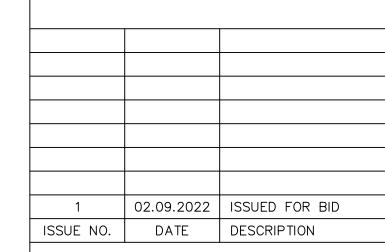

BATHROOM RENOVATION


DR. ROBERT L. YEAGER HEALTH CENTER **BUILDING F POMONA, NY 10970**

INTERIOR ELEVATIONS

DWG NO. DRAWN CHECKED RHG


2.9.2022


DATE

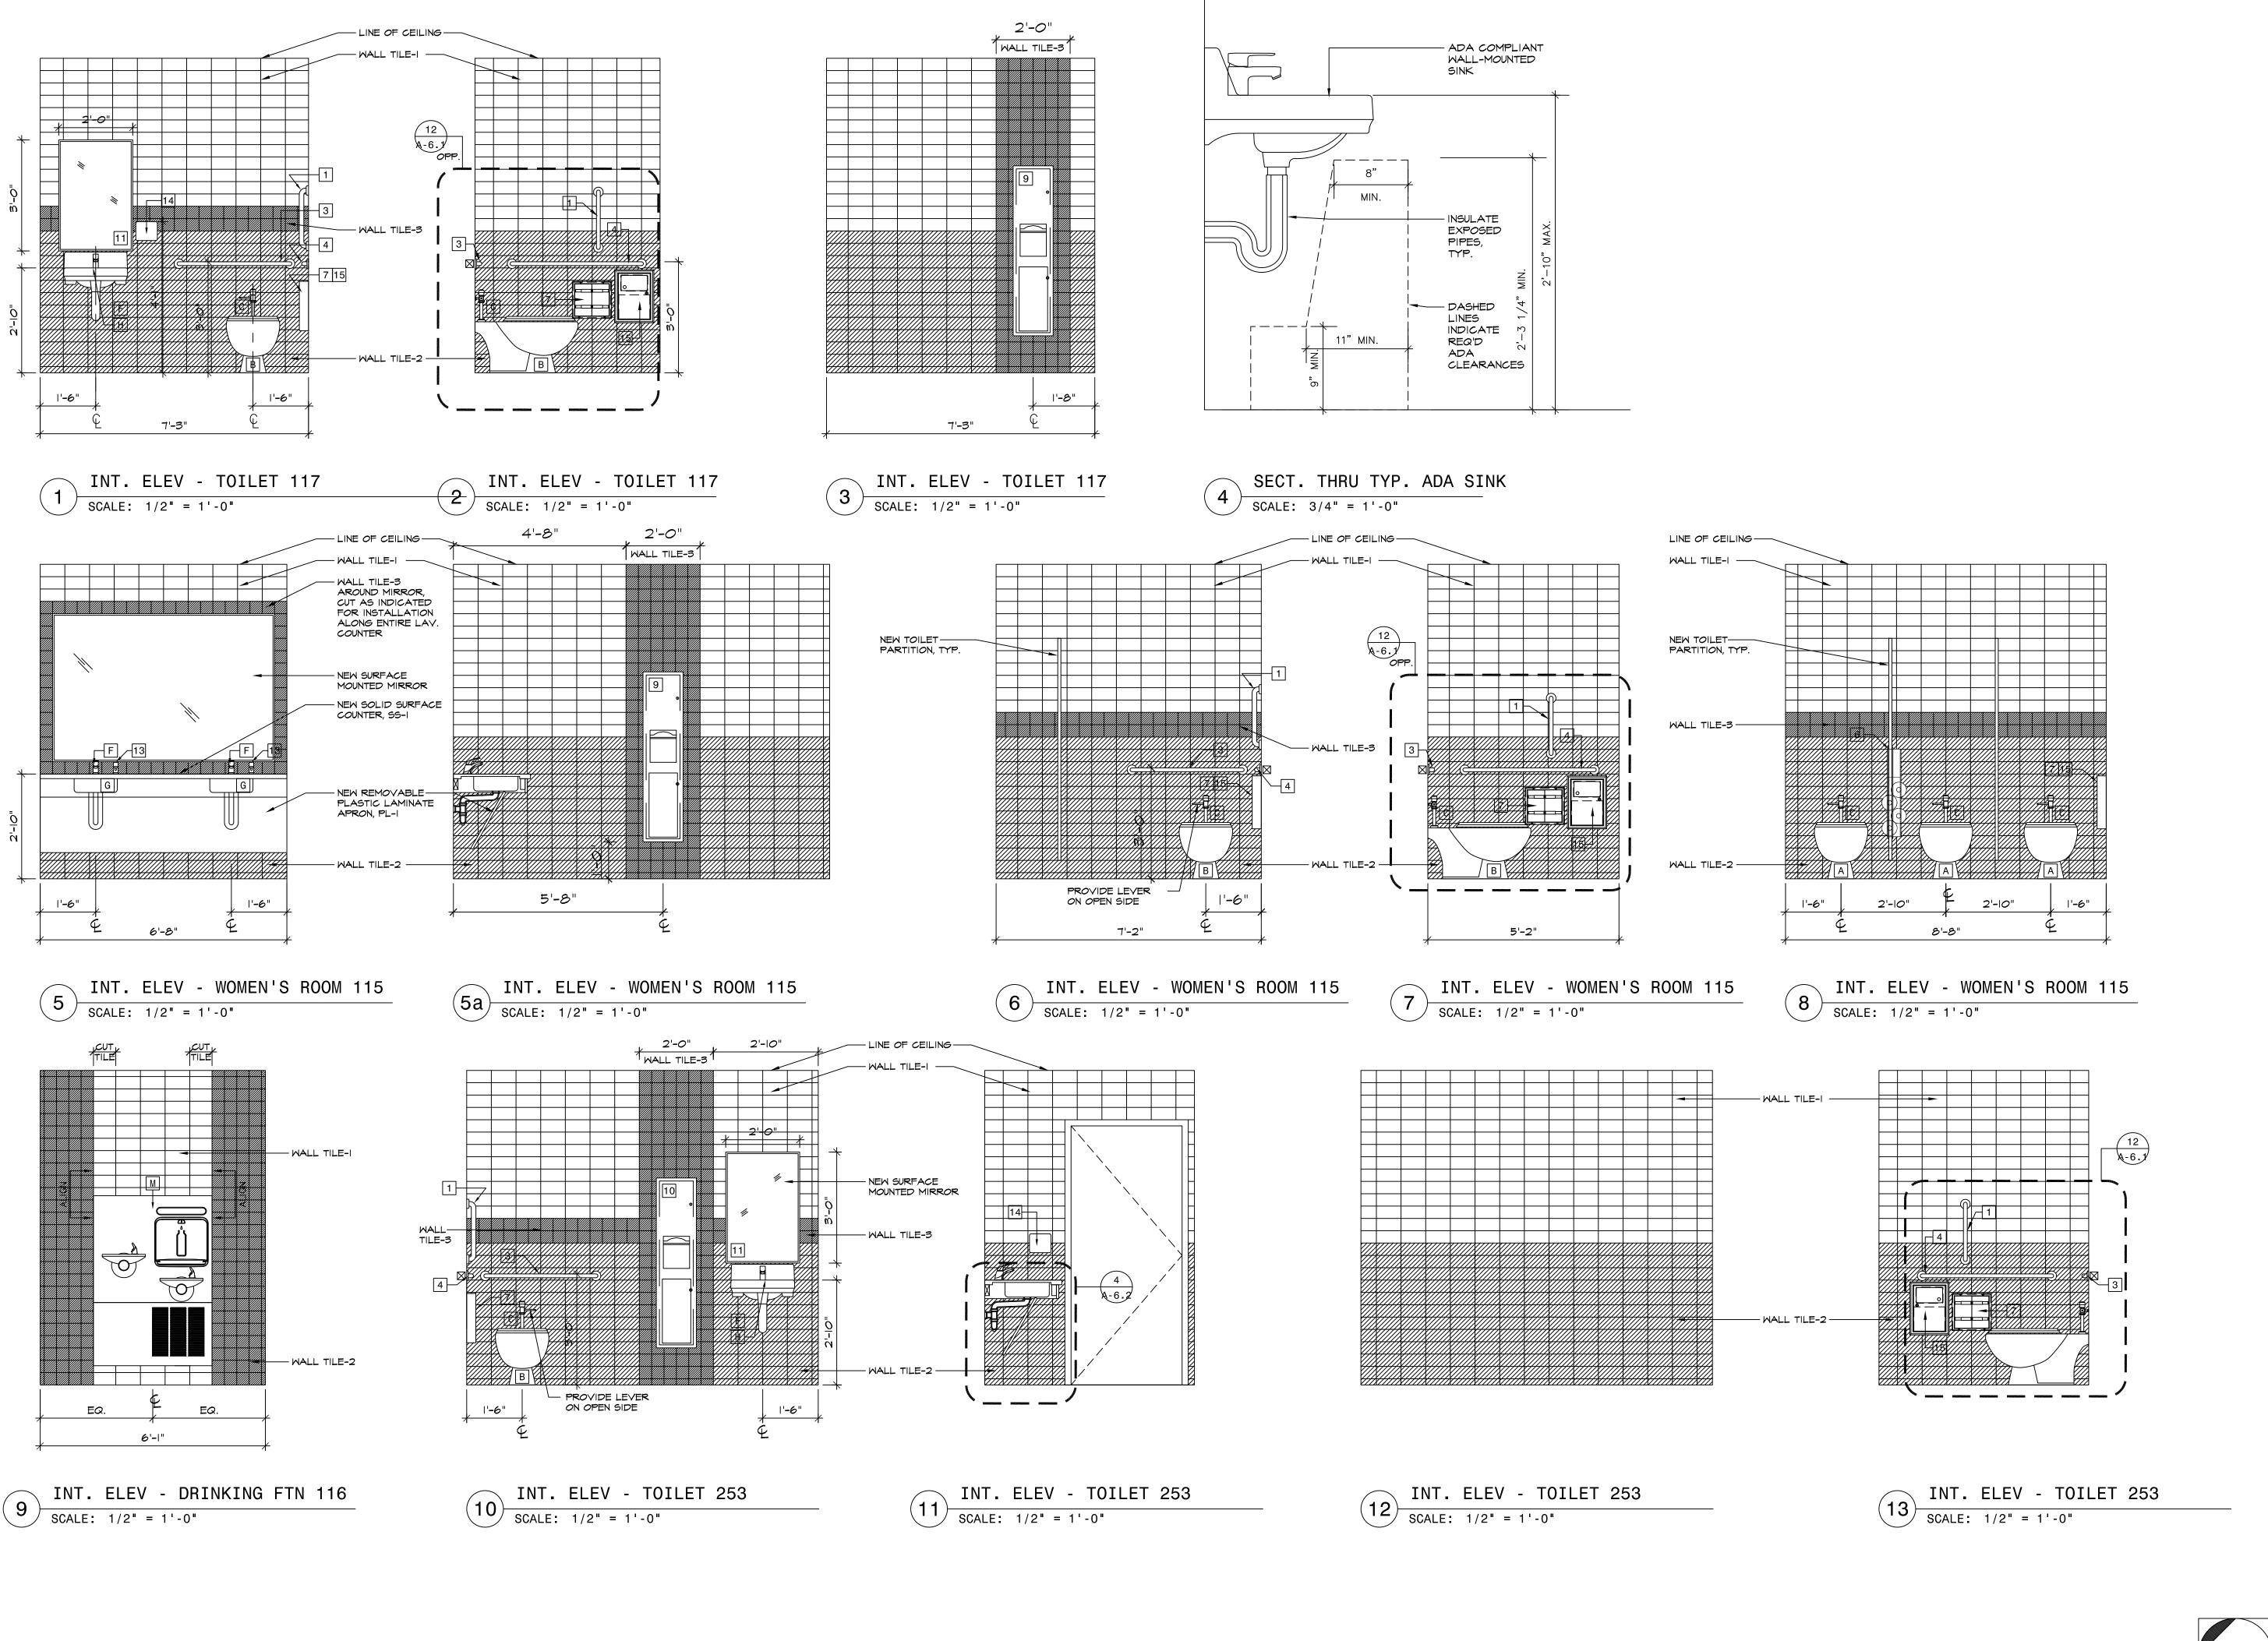

ROBERT H. GRUFFI, P.E., LEED AP DIRECTOR FACILITIES MANAGEMENT

DR. ROBERT L. YEAGER HEALTH CENTER
50 SANATORIUM ROAD
BUILDING A, 2ND FLOOR

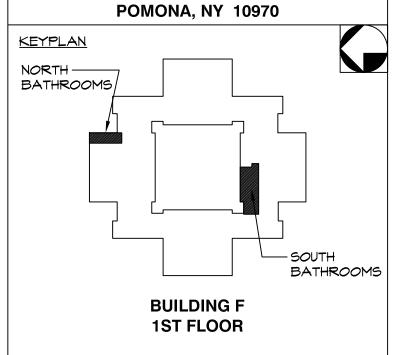

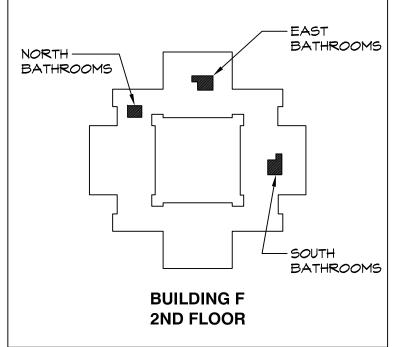

1	02.09.2022	ISSUED FOR BID
ISSUE NO.	DATE	DESCRIPTION

PROJECT NAME

CAPITAL PROJECT 2110


BATHROOM RENOVATION

DR. ROBERT L. YEAGER HEALTH CENTER BUILDING F POMONA, NY 10970

SHEET TITLE


INTERIOR ELEVATIONS


	DWG INFO.		DWG NO.
	SCALE	AS NOTED	
	PRJ. NO.	2110	A 6 9
\	DRAWN	AMN	H-0.2
)	CHECKED	RHG	

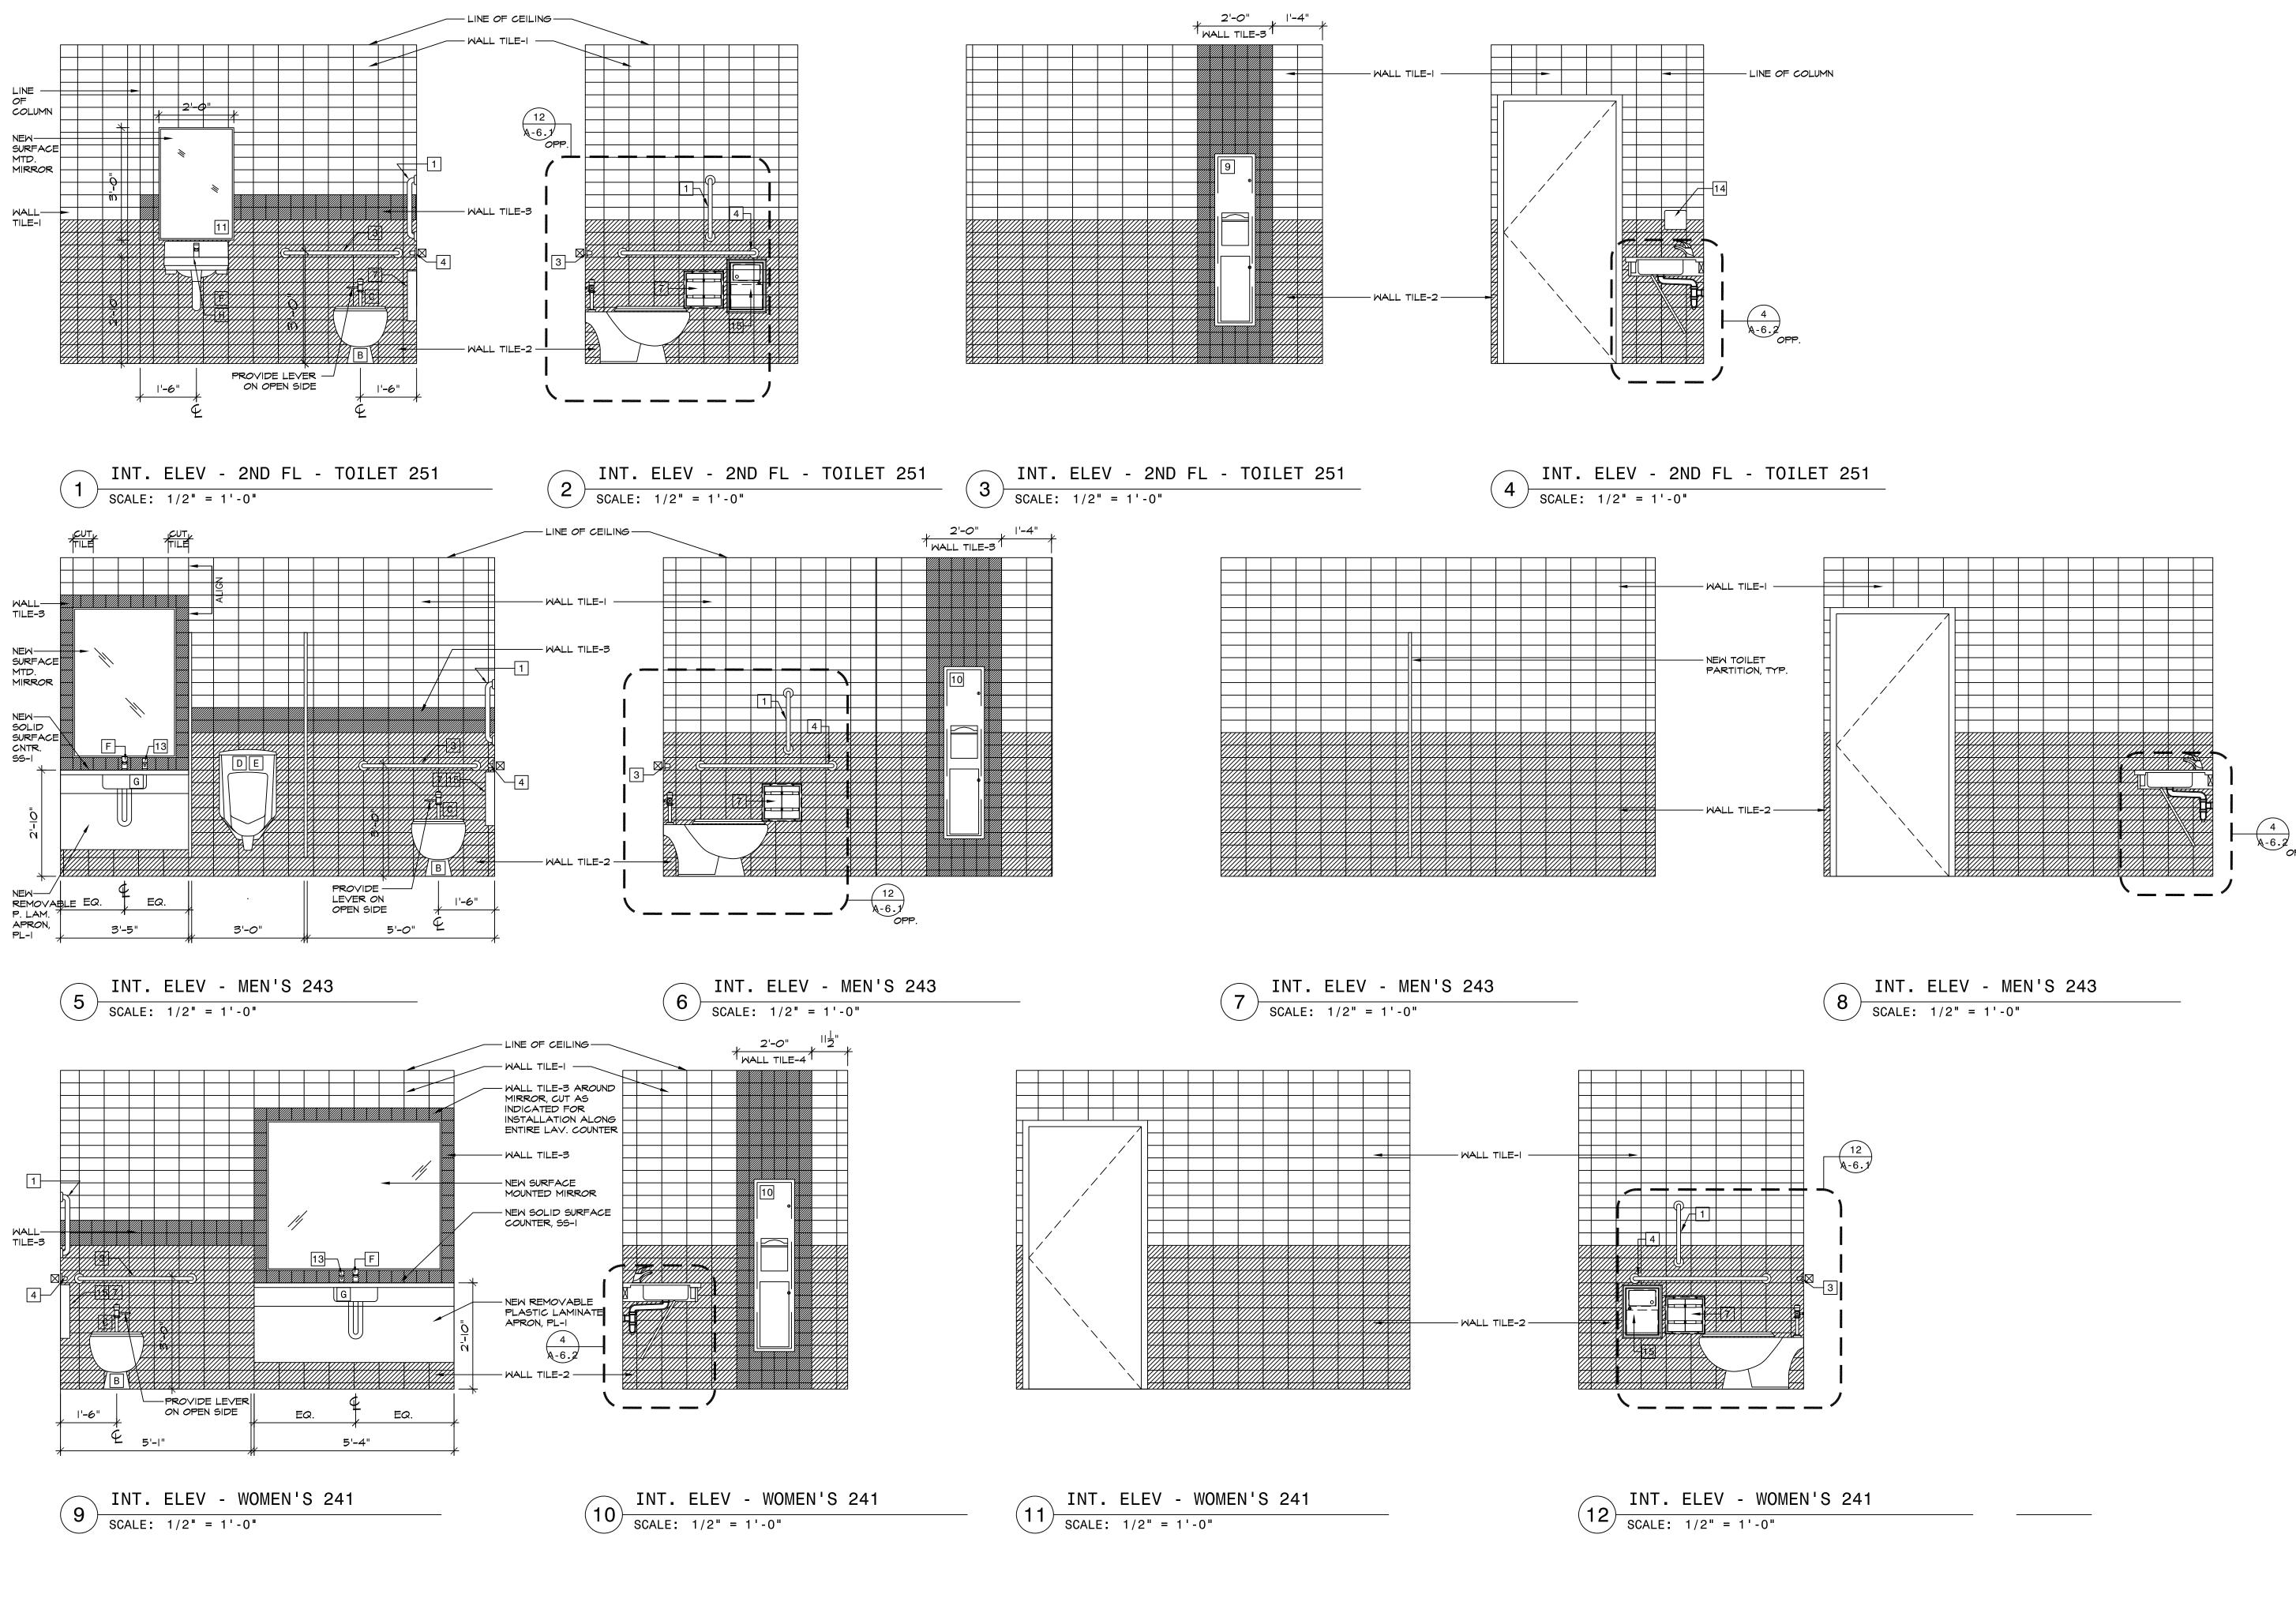


ROBERT H. GRUFFI, P.E., LEED AP DIRECTOR FACILITIES MANAGEMENT

DR. ROBERT L. YEAGER HEALTH CENTER 50 SANATORIUM ROAD BUILDING A, 2ND FLOOR

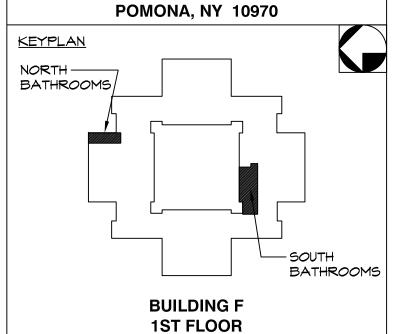

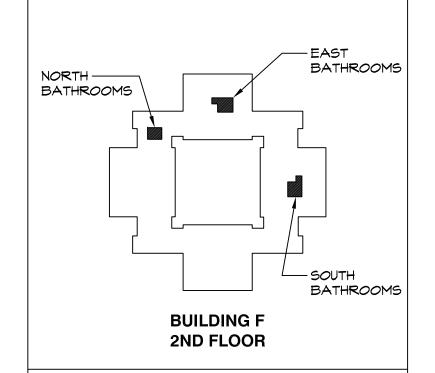

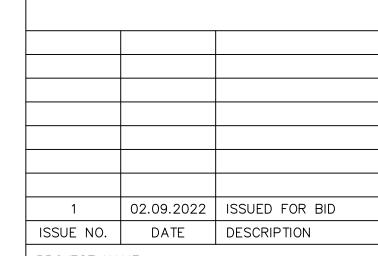

PROJECT NAME

CAPITAL PROJECT 2110

BATHROOM RENOVATION

DR. ROBERT L. YEAGER HEALTH CENTER BUILDING F POMONA, NY 10970


SHEET TITLE

DWG INFO.

INTERIOR ELEVATIONS


DWG NO.

SCALE AS NOTED
PRJ. NO. 2110
DRAWN AMN
CHECKED RHG

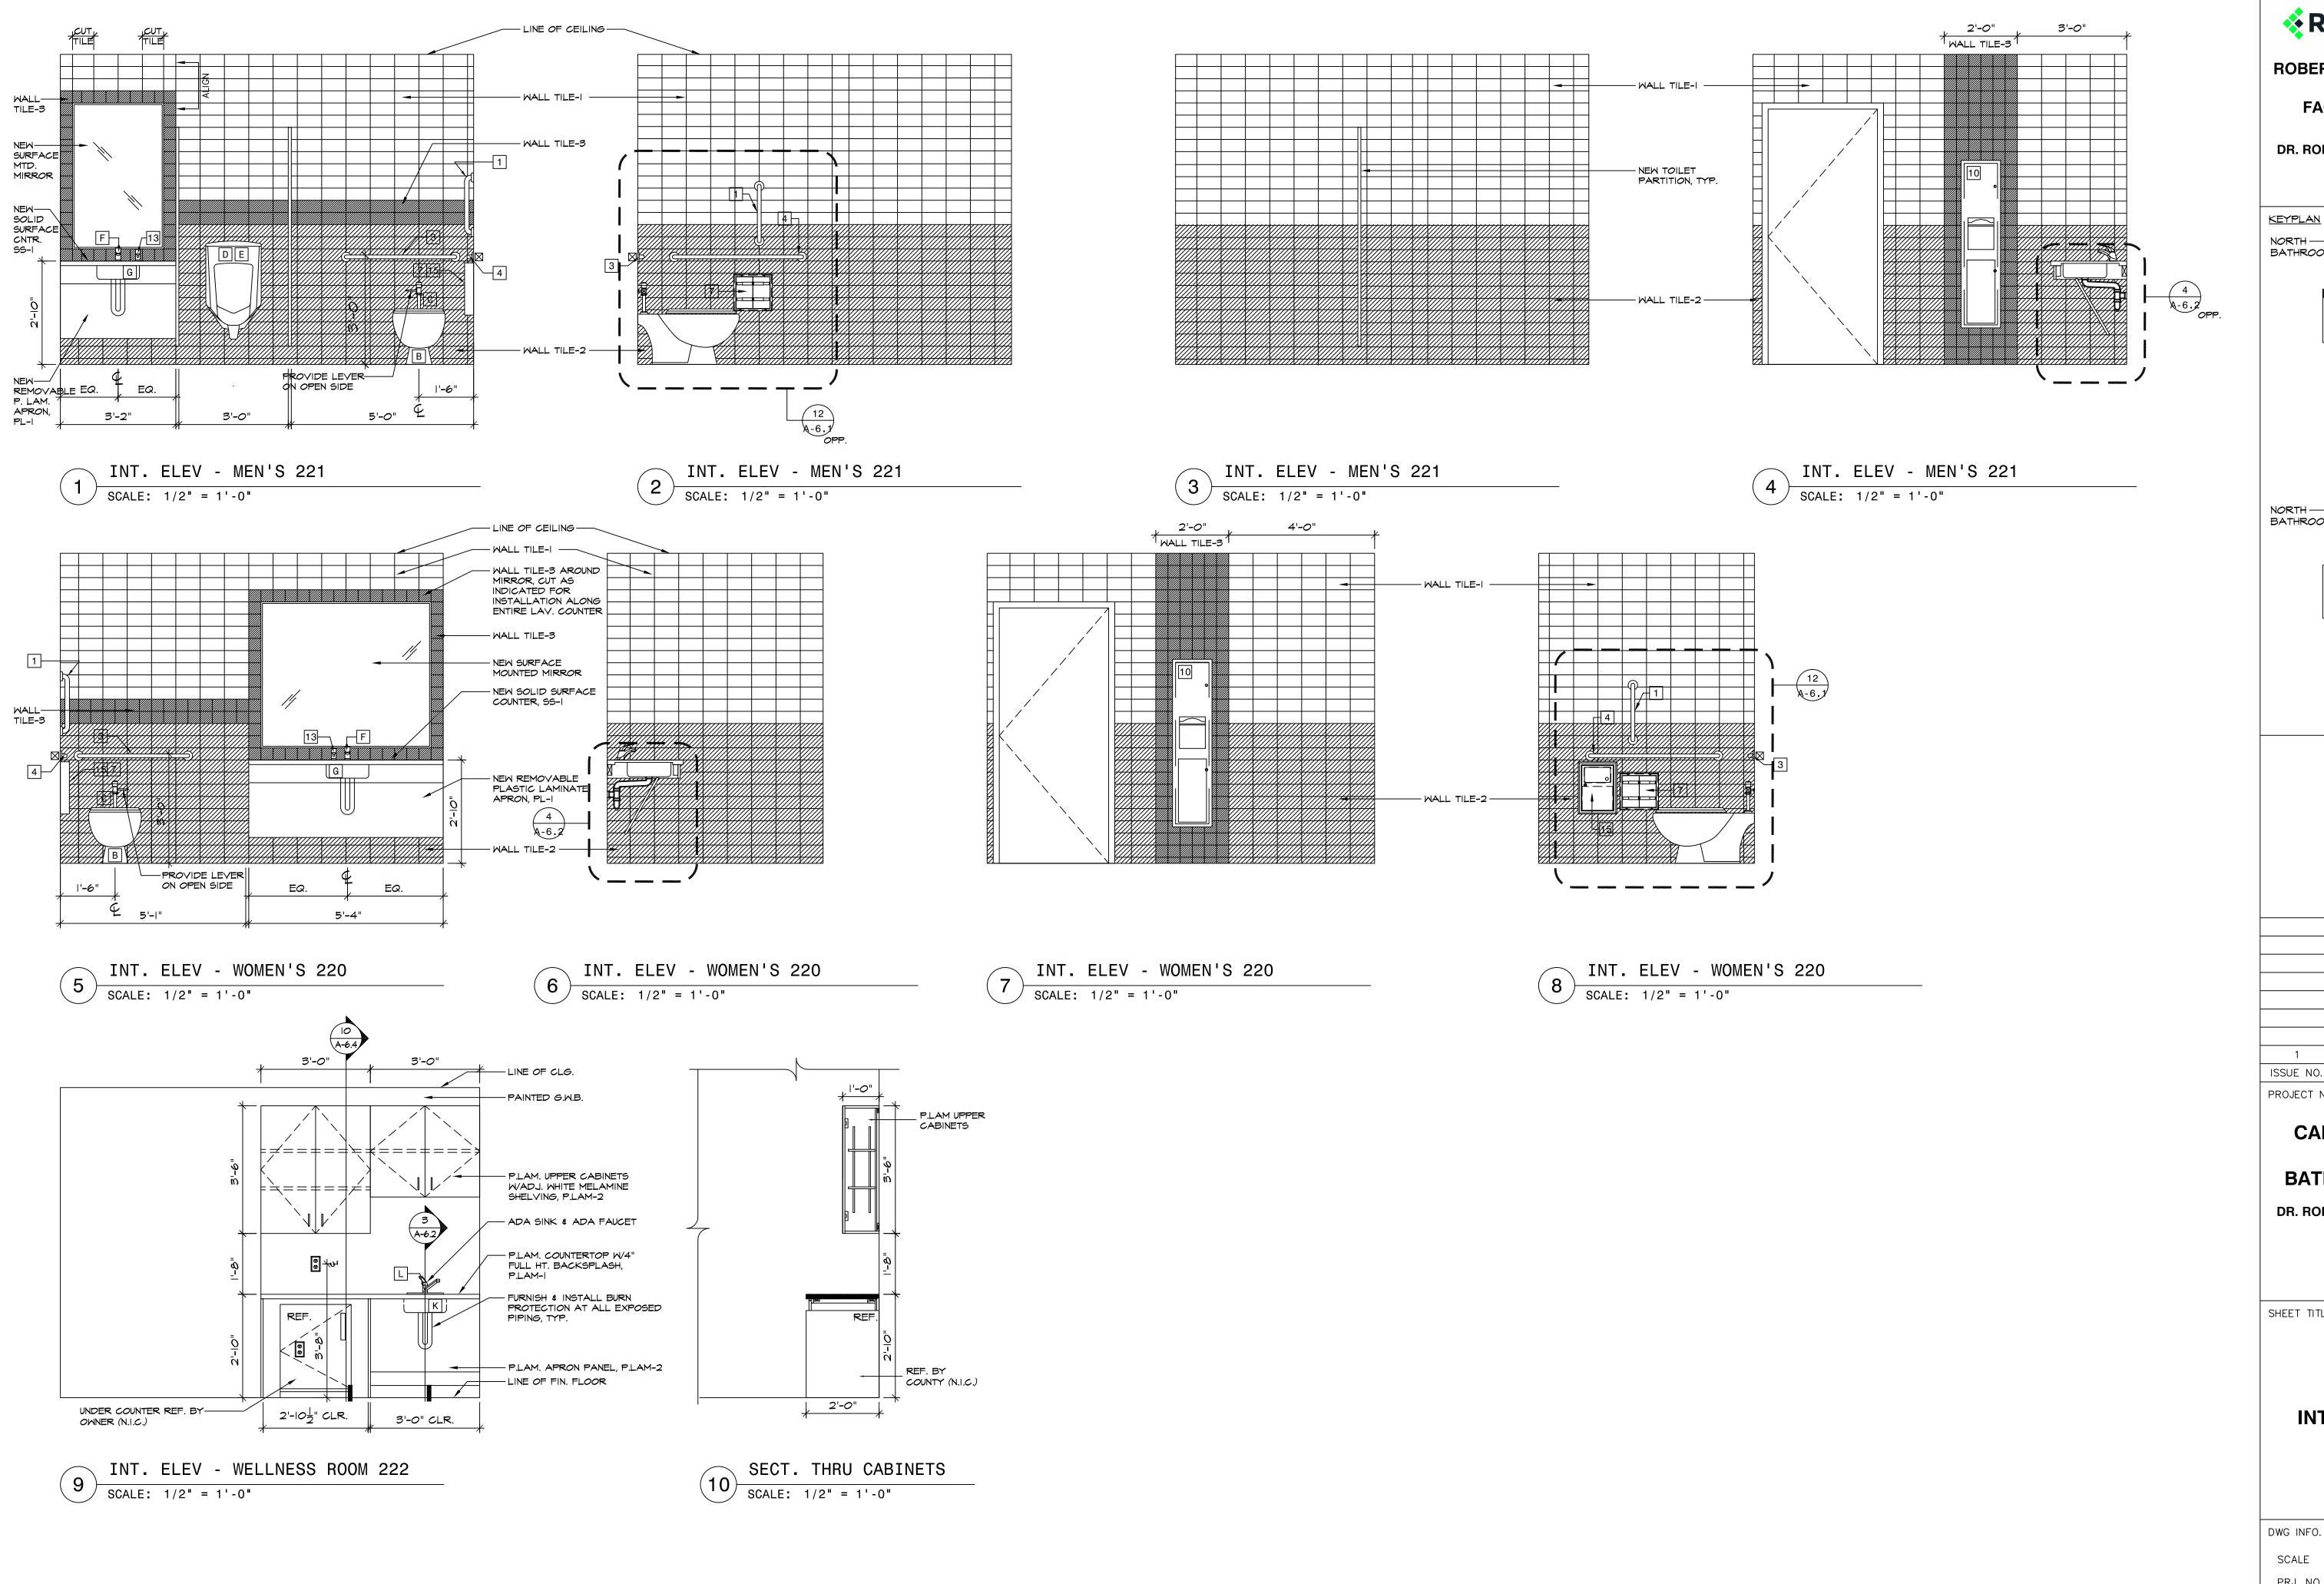


ROBERT H. GRUFFI, P.E., LEED AP DIRECTOR FACILITIES MANAGEMENT

DR. ROBERT L. YEAGER HEALTH CENTER **50 SANATORIUM ROAD BUILDING A, 2ND FLOOR**

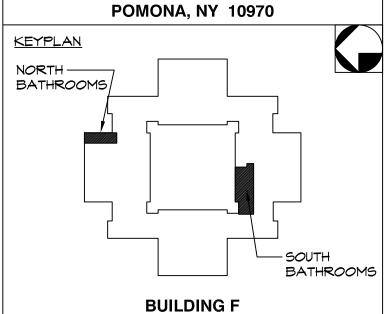

1ST FLOOR

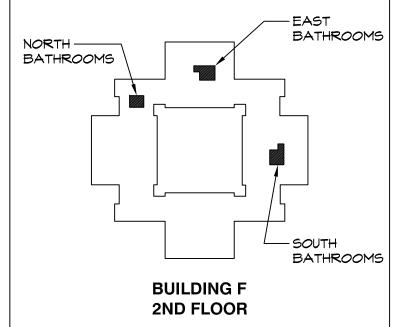

1	02.09.2022	ISSUED FOR BID
ISSUE NO.	DATE	DESCRIPTION
DDO IFOT NA		

PROJECT NAME

CAPITAL PROJECT 2110

BATHROOM RENOVATION

DR. ROBERT L. YEAGER HEALTH CENTER **BUILDING F POMONA, NY 10970**

SHEET TITLE

INTERIOR ELEVATIONS

DWG INFO.		DWG NO.
SCALE	AS NOTED	
PRJ. NO.	2110	$\Lambda \subset \Lambda$
DRAWN	AMN	H-0.4
CHECKED	RHG	
DATE	292022	

		<u> </u>	= N S H	SCH	EDULE		
	ROOM NUMBER	ROOM NAME	CEILING	WALLS	WALL BASE	FLOORS	NOTES
	114	JANITOR'S CLOSET	EXISTING	EXISTING	EXISTING	EXISTING	
<u>П</u>	II5	WOMEN'S ROOM	ACT-2	MALL TILES- 1/2/3	TILE BASE-2	FLR TILE-I	
-	116	DRINKING FOUNTAIN	PAINT-I	NALL TILE-1/2 PT-3	1/2	FLR TILE-I	PROVIDE METAL SCHLUTER TRANSITION STRIP
N	117	GENDER NEUTRAL TOIL.	ACT-2	MALL TILES- 1/2/3	TILE BASE-2	FLR TILE-I	
<u>0</u> ′	145	MOMEN'S ROOM	ACT-2	MALL TILES- 1/2/3	TILE BASE-2	FLR TILE-I	
Щ	146	MEN'S ROOM	ACT-2	MALL TILES- 1/2/3	TILE BASE-2	FLR TILE-I	
	220	MOMEN'S ROOM	ACT-2	MALL TILES- 1/2/3	TILE BASE-2	FLR TILE-I	
	221	MEN'S ROOM	ACT-2	MALL TILES- 1/2/3	TILE BASE-2	FLR TILE-I	
╙	222	WELLNESS ROOM	ACT-I	PAINT-2	VINYL	LVT	
^	228	JANITOR'S CLOSET	EXISTING	EXISTING	EXISTING	EXISTING	
Z U	241	WOMEN'S ROOM	ACT-2	MALL TILES- 1/2/3	TILE BASE-2	FLR TILE-I	
0 0	243	MEN'S ROOM	ACT-2	MALL TILES- 1/2/3	TILE BASE-2	FLR TILE-I	
Ш	248	CLOSET	EXISTING	EXISTING	EXISTING	EXISTING	
w -	251	GENDER NEUTRAL TOIL.	ACT-2	MALL TILES- 1/2/3	TILE BASE-2	FLR TILE-I	
	253	GENDER NEUTRAL TOIL.	ACT-2	MALL TILES- 1/2/3	TILE BASE-2	FLR TILE-I	

MALL SPECIFICATIONS:

MFR.:

FINISH:

FINISH:

TOILET ROOMS

MFR.: DAL TILE

SIZE: 4" × 8"

TOILET ROOMS

MFR.: DAL TILE

SIZE: 4" × 8"

PAINT-2: GENERAL PAINT FOR USE THROUGHOUT.

PAINT-3: GENERAL PAINT FOR USE ON DOOR FRAMES,

WALL TILE-I: CERAMIC TILE FOR USE ON WALLS IN

WALL TILE-2: CERAMIC TILE FOR USE ON WALLS IN

CONVECTOR COVERS, MISCELLANEOUS METAL SURFACES.

BENJAMIN MOORE

STYLE: ULTRA SPEC SCUFF-X (485)

BENJAMIN MOORE

COLOR: SILVER LAKE 1598

EGGSHELL

STYLE: ULTRA SPEC 500

COLOR: TIMBER WOLF 1600

SEMI-GLOSS

STYLE: MODERN DIMENSIONS

COLOR: ARCTIC WHITE 0190

STYLE: MODERN DIMENSIONS

COLOR: DESERT GRAY XII4

ACT-I: ACOUSTICAL CEILING TILE-I - ACOUSTICAL CEILING TILE FOR USE IN OFFICES THROUGHOUT MFR.: ARMSTRONG STYLE:

ULTIMA HIGH NRC TEGULAR FINE TEXTURE SIZE: 24" X 24" PROFILE: TEGULAR

GRID: EXISTING 15/16" GRID TO REMAIN, OR BE PATCHED / REPAIRED / EXTENDED AS REQUIRED BASED ON NEW LAYOUT

COLOR: WHITE MDL.:

ACT-2: ACOUSTICAL CEILING TILE-2 - ACOUSTICAL CEILING TILE FOR USE IN TOILETS ROOMS MFR.: ARMSTRONG

STYLE: ULTIMA HEALTH ZONE HIGH NRC SIZE: 24" X 24" PROFILE: BEVELED TEGULAR

GRID: NEW 15/16" GRID, PRELUDE COLOR: WHITE MDL.: 1447

PAINT-I: PAINT FOR USE ON G.W.B. SOFFITS / CEILINGS. BENJAMIN MOORE MFR.:

COLOR: CEILING WHITE FINISH: FLAT

CEILING SPECIFICATIONS:

WALL TILE-3: CERAMIC TILE FOR USE AS ACCENT ON WALLS IN TOILET ROOMS MFR.: DAL TILE STYLE: SEMI-GLOSS + MATTE GLAZED CERAMIC

SIZE: 4" X 4" COLOR: OCEAN BLUE 1049

MFR.: DAL TILE

WALL BASE: TILE BASE-I: CERAMIC TILE COVE BASE FOR USE WITH WALL TILE-I:

STYLE: MODERN DIMENSIONS SIZE: 4" × 8" COLOR: ARCTIC WHITE 0190 PROFILE: FLAT TOP COVE BASE A-3481

TILE BASE-2: CERAMIC TILE COVE BASE FOR USE WITH MOORE. OTHER ACCEPTABLE MANUFACTURERS ARE WALL TILE-2

MFR.: DAL TILE STYLE: MODERN DIMENSIONS SIZE: 4" X 8" COLOR: DESERT GRAY XII4

PROFILE: FLAT TOP COVE BASE A-3481

VINYL-I: VINYL COVE BASE FOR USE THROUGHOUT MFR .: JOHNSONITE OR APPROVED EQUAL. COLOR: STORM CLOUD 71. SIZE: 4" HIGH X CONTINUOUS ROLL

FLOORING SPECIFICATIONS:

FLOOR TILE-I: PORCELAIN TILE FOR USE ON TOILET + SHOWER ROOM FLOORS.

MFR.: FLORIDA TILE STYLE: LEVEL 10 SIZE: 18" X 18"

COLOR: PLATINUM SUITE 33315 LVT: LUXURY VINYL TILE FOR USE IN WELLNESS ROOM. MFR.: PATCRAFT

STYLE: TIMBER GROVE II COLOR: PERGOLA SOLID SURFACES:

SS-I: SOLID SURFACE MATERIAL FOR USE AS COUNTERTOP IN TOILET + SHOWER ROOMS MFR: DUPONT

COLOR: NATURAL GRAY

STYLE: CORIAN

LAMINATES:

STYLE: T.B.D.

P. LAM-I: PLASTIC LAMINATE FOR USE AS COUNTERTOPS MFR.: FORMICA, WILSONART OR NEVAMAR

COLOR: T.B.D. P. LAM-2: PLASTIC LAMINATE FOR USE AS BASE AND UPPER CABINETS

MFR.: FORMICA, WILSONART OR NEVAMAR STYLE: T.B.D. COLOR: T.B.D.

FINISHES: GYPSUM WALL BOARD TO BE 48" WIDE X MAXIMUM LENGTH AVAILABLE TO MINIMZE JOINTS. THICKNESS AND TYPE PER PLANS. "US GYPSUM." "GEORGIA PACIFIC," OR EQUAL LISTED AS ACCEPTABLE BY TESTING LABS. PROVIDE FIRE-RATE GYPSUM BOARD WITHIN FIRE ASSEMBLIES. PROVIDED WATER RESISTANT PRODUCT AT ALL WET AREAS. GYPSUM BOARD SCREW ATTACHED TO STEEL FRAME. PROVIDE CORNER BEADS, EDGE TRIM AND CONTROL JOINTS.

FINISH SPEC'S (CON'TD.) | FINISH GENERAL NOTES

2. JOINT TREATMENT: TAPE AND SPACKLE ALL JOINTS, 3 COATS, SAND AND SPACKLE WORK SMOOTH BETWEEN COATS AND AFTER THIRD COAT. FEATHER JOINTS WITH SUCCESSIVE COATS TO PRODUCE A SMOOTH SURFACE.

3. PAINTING: PAINTING SCHEDULE BELOW REFERS TO PAINTING PRODUCTS AS MANUFACTURERD BY BENJAMIN SHERWIN WILLIAMS, CON LUX AND PPG. APPLICATION SHALL BE BY BRUSH OR ROLLER. SPRAY APPLICATION ONLY UPON ACCEPTANCE BY ARCHITECT.

INTERIOR FERROUS METAL WORK - SEMI GLOSS IRON CLAD RETARDO RUST INHIBITIVE PAINT

2ND COAT ULTRA SPEC500 SEMI-GLOSS 3RD COAT ULTRA SPEC500 SEMI-GLOSS

INTERIOR GYPSUM WALLBOARD - EGGSHELL LATEX FINISH IST COAT LATEX QUICK DRY PRIME SEAL 2ND COAT ULTRA SPEC SCUFF-X

3RD COAT ULTRA SPEC SCUFF-X INTERIOR WOOD - SEMI-GLOSS ALKYD IST COAT ALKYD ENAMEL UNDERBODY

2ND COAT REGAL AQUAGLO 3RD COAT REGAL AQUAGLO INTERIOR WOOD - CLEAR FINISH

IST COAT INTERIOR WOOD LATEX URETHANE ACRYLIC FINISH INTERIOR WOOD LATEX URETHANE 2ND COAT ACRYLIC FINISH

GEN. FINISH REQUIREMENTS

A. ALL SELECTED WALL AND CEILING FINISHES SHALL BE CLASS C MINIMUM PER TABLE 803.13 OF THE 2020 BUILDING CODE OF NEW YORK STATE.

	TOILET A	CCESS	ORY S	SCHED	ULE
NUMBER	ITEM	MFR.	MODEL #	FINISH	NOTES
1	GRAB BAR - 18" LONG	BOBRICK	B-6806XI8	SATIN	SURFACE MOUNTED PROVIDE REQUIRED BLOCKING
2	GRAB BAR - 30" LONG	BOBRICK	B-6806X30	SATIN	SURFACE MOUNTED PROVIDE REQUIRED BLOCKING
3	GRAB BAR - 36" LONG	BOBRICK	B-6806X36	SATIN	SURFACE MOUNTED PROVIDE REQUIRED BLOCKING
4	GRAB BAR - 42" LONG	BOBRICK	B-6806X42	SATIN	SURFACE MOUNTED PROVIDE REQUIRED BLOCKING
5	SANITARY NAPKIN DISPOSAL	BOBRICK	B-354	SATIN	PARTITION MOUNTED (SERVES 2 TOILET COMPARTMENTS)
6	TOILET TISSUE DISPENSER	BOBRICK	B-386	SATIN	PARTITION MOUNTED (SERVES 2 TOILET COMPARTMENTS)
7	TOILET TISSUE DISPENSER	BOBRICK	B-3588	SATIN	SURFACE MOUNTED
8	ROBE HOOK	BOBRICK	B-677	SATIN	WALL OR PARTITION MOUNTED
9	PAPER TOWEL DISPENSER AND WASTE RECEPTACLE	BOBRICK	B-38034	SATIN	RECESSED
10	PAPER TOWEL DISPENSER AND WASTE RECEPTACLE	BOBRICK	B-380349	SATIN	SURFACE MOUNTED
11	WALL-MOUNTED MIRROR	BOBRICK	B-290	SATIN	SEE ELEVATIONS FOR SIZE
12	BABY CHANGING STATION	KOALA KARE	KB310-SSWM	STAINLESS STEEL	SURFACE MOUNTED
13	SOAP DISPENSER	KOHLER	K-1895-C	POLISHED CHROME	COUNTER MOUNTED
14	SOAP DISPENSER	BOBRICK	B-818615	SATIN	WALL MOUNTED
15	SANITARY NAPKIN DISPOSAL	BOBRICK	B-254	SATIN	SURFACE MOUNTED

TOILET ROOM NOTES

A. PROJECT STANDARD TOILET PARTITIONS AND URINAL SCREENS SHALL BE SOLID PHENOLIC PARTITIONS, MANUFACTURER'S STANDARD HEIGHT OVERHEAD-BRACED, WITH GAP-FREE PRIVACY DESIGN, HEAVY-DUTY CONTINUOUS BRACKETS, HINGES AND HARDWARE. COLOR T.B.D. BY COUNTY FROM MANUFACTURER'S STANDARD SELECTION. BASIS OF DESIGN IS BOBRICK, DURALINE 1080 SERIES, COMPACT LAMINATE (CL PHENOLIC), OR EQUAL.

PLUMBING NOTES

- A. PLUMBING AS-BUILT DRAWINGS ARE PROVIDED. B. PLUMBER RESPONSIBLE FOR SLOTTING AND TRENCHING FLOORS WHERE NEEDED TO EXTEND, CUT-BACK, CAP, RELOCATE SANITARY WASTE LINES
- C. GENERAL CONTRACTOR RESPONSIBLE FOR BACKFILLING AND FINISHING CONCRETE WORK IN DISTURBED FLOORS.

WHERE NEEDED.

D. PLUMBING CONTRACTOR SHALL CUT BACK ALL DOMESTIC WATER PIPING TO CEILING AND CAP PIPING FOR PIPING WHERE FIXTURES ARE TO BE REMOVED OR RELOCATED TO ENSURE DOMESTIC WATER SERVICE TO BUILDING IS MAINTAINED DURING CONSTRUCTION.

TOILET ACCESS. NOTES

- A. G.C. SHALL FURNISH + INSTALL ALL TOILET ACCESSORIES AND PLUMBING FIXTURES, AS WELL AS COMPONENTS NECESSARY FOR COMPLETE OPERATION, TYP.
- B. G.C. SHALL FURNISH + INSTALL ALL APPROPRIATE BLOCKING NECESSARY FOR PROPER AND SOLID INSTALLATION OF ALL WALL-HUNG ITEMS, INCLUDING, BUT NOT LIMITED TO, TOILET ACCESSORIES, SHELVING, FIXTURES, ETC.

PLUMBING FIXTURE SCHEDULE							
LETTER	ITEM	MFR.	MODEL #	FINISH	NOTES		
Α	FLOOR MOUNTED TOILET	KOHLER	96053-0	MHITE	STYLE: WELLCOMME PROVIDE SEAT 4731-C-O		
В	FLOOR MOUNTED TOILET - ADA	KOHLER	96057-0	WHITE	STYLE: HIGHCLIFF PROVIDE SEAT 4731-C-0		
С	TOILET FLUSHOMETER	KOHLER	K-7531	POLISHED CHROME	STYLE: TRIPOINT		
D	WALL-HUNG HIGH-EFFICIENCY URINAL	KOHLER	4991-ET-0	MHITE	STYLE: BARDON		
E	URINAL FLUSHOMETER	KOHLER	B-38034	POLISHED CHROME			
F	LAVATORY FAUCET	KOHLER	K-97283-4	POLISHED CHROME	STYLE:JULY SINGLE-HOLE		
G	UNDER-MOUNT BATHROOM SINK	KOHLER	K-2882-95	ICE GREY	STYLE: VERTICYL		
Н	WALL-MOUNT BATHROOM SINK	KOHLER	K-2031	MHITE	PROVIDE K-8998 (P-TRAP) + K-1808-P (BRACKETS)		
J	LAVATORY DRAINS	KOHLER	K-7129-A-VS	VIBRANT STAINLESS			
K	KITCHEN SINK	ELKAY	LRADI91588	STAINLESS STEEL	STYLE: LUSTERTONE CLASSIC; SIZE: 19" X 18" X 5-1/2" DEEP		
L	KITCHEN FAUCET	DELTA	1980-DST	POLISHED CHROME	STYLE: PILAR BAR / PREP FAUCET		
М	HI-LOW DRINKING FOUNTAIN WITH BOTTLE FILLING STATION	ELKAY	LZWS- LRPBM28K	STAINLESS	REFRIGERATED AND FILTERED		

BATHROOMS **BUILDING F 1ST FLOOR** -EAST BATHROOMS NORTH -BATHROOMS - SOUTH BATHROOMS **BUILDING F** 2ND FLOOR

Rockland County

ROBERT H. GRUFFI, P.E., LEED AP

DIRECTOR

FACILITIES MANAGEMENT

DR. ROBERT L. YEAGER HEALTH CENTER

50 SANATORIUM ROAD

BUILDING A, 2ND FLOOR

POMONA, NY 10970

— SOUTH

<u>KEYPLAN</u>

NORTH ---

BATHROOMS/

1	02.09.2022	ISSUED FOR BID				
ISSUE NO.	DATE	DESCRIPTION				
PROJECT NAME						

CAPITAL PROJECT 2110

BATHROOM RENOVATION

DR. ROBERT L. YEAGER HEALTH CENTER **BUILDING F POMONA, NY 10970**

SHEET TITLE

FINISH, DOOR, TOILET **ACCESSORY AND** PLUMBING SCHEDULES

SCALE PRJ. NO. DRAWN CHECKED

DWG INFO. DWG NO. AS NOTED 2110 RHG 2.9.2022

DOOR SCHEDI								. E
	DOOR NUMBER	DOOR TYPE	DOOR SIZE	RATING	FRAME	SADDLE	HARDWARE	NOTES
•	EX	EXISTING	EXISTING	EXISTING	EXISTING	EXISTING	EXISTING	
→ [(100)	А	3'-0"X7'-0"	NONE	PTD. H.M.	MARBLE	02	
⊢ [(101)	A	3'-0"X7'-0"	NONE	PTD. H.M.	MARBLE	02	
N	(102)	A	3'-0"X7'-0"	NONE	PTD. H.M.	MARBLE	02	
<u></u>	(103)	A	3'-0"X7'-0"	NONE	PTD. H.M.	MARBLE	01	
I L	(104)	A	3'-0"X7'-0"	NONE	PTD. H.M.	MARBLE	02	
	200	A	3'-0"X7'-0"	NONE	PTD. H.M.	MARBLE	01	
→ [201)	A	3'-0"X7'-0"	NONE	PTD. H.M.	MARBLE	01	
	202)	А	3'-0"X7'-0"	NONE	PTD. H.M.	MARBLE	02	
Z	203	A	3'-0"X7'-0"	NONE	PTD. H.M.	MARBLE	01	
0	204)	А	3'-0"X7'-0"	NONE	PTD. H.M.	MARBLE	02	
ш	205)	А	3'-0"X7'-0"	NONE	PTD. H.M.	MARBLE	01	
w -	206	А	3'-0"X7'-0"	NONE	PTD. H.M.	VINYL	01	
SADDLE NOTES HARDWARE NOTES						HARDWARE SETS		
A. ALL SADLES SHALL BE ADA COMPLIANT WITH A. ALL DOOR HARDWARE SHALL BE						HARDWARE SET 02 - HARDWARE SET 02 -		

LEVERS AND WALL-MOUNTED DOOR

E. G.C. SHALL COORDINATE ALL

HARDWARE REQUIREMENTS WITH

F. G.C. SHALL PROVIDE ALL

INDICATE ITEMS REQUIRED FOR

ORDERING HARDWARE.

ANY ORDERING.

DESIGN INTENT ONLY.

D. KEYING REQUIREMENTS SHAALL BE COORDINATED WITH COUNTY PRIOR TO

COUNTY'S SECURITY VENDOR PRIOR TO

HARDWARE REQUIRED FOR PROPER

DOOR OPERATION. HARDWARE SETS

B. VINYL - FURNISH + INSTALL VINYL REDUCING STRIP @ ALL CHANGES IN FLOOR MATERIAL FROM CARPET TO LVT, TYP. C. ALL DOORS AT TOILET ROOMS SHALL BE WITH NEW HINGES, SILENCERS, STRIKES,

DOOR NOTES

PROVIDED WITH ADA COMPLAINT MARBLE SADDLE

RISE OF 1/4" MAXIMUM.

TO MATCH FLOOR TILE, TYP.

DOWN TYPE, TYP.

A. ALL NEW DOORS SHALL MATCH EXISTING SOLID CORE WOOD DOORS TO REMAIN, INCLUDING, BUT NOT LIMITED TO, SPECIES, SIZE, THICKNESS, STAIN, FINISH, ETC.

B. NEW DOORS SHALL BE ORDERED FACTORY FINISHED.

C. G.C. SHALL SUBMIT SAMPLES TO COUNTY FOR SELECTION PRIOR TO PLACING ORDER, TYP. D. NEW HOLLOW METAL FRAMES SHALL BE KNOCK

<u>HARDWARE SET 02 -</u> <u>PASSAGE SET WITH CLOSER</u> A. ALL DOOR HARDWARE SHALL BE NEW, U.O.N. I-I/2 PAIR HINGES B. NEW LEVERS SHALL MATCH SET PUSH/PULL HARDWARE BUILDING STANDARD, TYP. KICKPLATE WALL/FLOOR STOP C. ALL DOORS SHALL BE EQUIPPED

HARDWARE SET 02 -PASSAGE SET WITH CLOSER -1/2 PAIR HINGES SET PUSH/PULL HARDWARE KICKPLATE WALL/FLOOR STOP 3 SILENCERS 3 SILENCERS CONCEALED CLOSER I CONCEALED CLOSER

DOOR TYPES

