

KEY OF SYMBOLS

NOTE: THE KEY OF SYMBOLS INDICATED IS FOR CONVENIENCE ONLY AND ITEMS INDICATED ARE NOT NECESSARILY WITHIN THE SCOPE OF THE WORK.

	SOIL OR WASTE PIPING (S) (W)	A.B.D.	AUTOMATIC BALL DRIP
	SOIL OR WASTE PIPING BELOW GROUND	A.D.	ACCESS DOOR
	LEADER (L) (LDR)	A. DR.	AREA DRAIN
	INDIRECT WASTE	B.T.	BATH TUB
	VENT PIPING	C.D.	CANOPY DRAIN
	EXISTING PIPING TO BE REMOVED	CLG.	CEILING
	EXISTING PIPING TO REMAIN	C.O.	CLEANOUT
	COLD WATER PIPING (C.W.)	C.O.D.P.	CLEAN OUT DECK PLATE
	HOT WATER PIPING (H.W.)	C.V.	CHECK VALVE
	HOT WATER CIRCULATING PIPING (H.W.C.)	C.V.B.	CHECK VALVE BOX
	GAS PIPING (G)	D.I.	DROP INLET
	GATE VALVE (G.V.)	D.F.	DRINKING FOUNTAIN
	LOCKSHIELD VALVE (GLOBE VALVE)	DN.	DOWN
	PLUG COCK	EL.	ELEVATION
	CHECK VALVE (C.V.)	E.W.C.	ELECTRIC WATER COOLER
	HOSE BIBB (H.B.) SILL COCK (S.C.)	F.A.I.	FRESH AIR INLET
	VACUUM BREAKER (V.B.)	F.D.	FLOOR DRAIN
	PRESSURE RELIEF VALVE PRESS. & TEMP. RELIEF VALVE	FL. DR.	FLOOR DRAIN
	PRESSURE REGULATING VALVE	F.F.D.	FUNNEL DRAIN
	STRAINER	FL.	FLOOR
	"P" TRAP FOR LAV., SINK, ETC.	F.O.	FLOOR OUTLET
	CLEANOUT DECK PLATE (C.O.D.P.)	F.U.	FIXTURE UNITS
	SHOCK ABSORBER	F.V.	FLUSH VALVE FLUSHOMETER
	ANCHOR	G.V.	GATE VALVE
	GUIDE	H.C.	HUNG CEILING
	PRESSURE GAUGE	H.R.	HOSE RACK
	THERMOMETER	INV.	INVERT
	TEMPERATURE REGULATOR	LAV.	LAVATORY
	WALL HYDRANT (W.H.)	MH.	MANHOLE
	YARD HYDRANT (Y.H.) (D.H.)	M.S.	MOP SINK
	PIPING COVERED WITH ELECTRIC HEAT TRACING CABLE AND INSULATION	N.I.C.	NOT IN CONTRACT
	UNION CONNECTION	O.S.&Y.	OUTSIDE SCREW & YOKE
	EXPANSION JOINT	P.C.	PLUG COCK
		P.O.	PLUGGED OUTLET
		R.P.B.	REDUCED PRESSURE BACKFLOW PREVENTER
		F.P.	REDUCED PRESSURE BACKFLOW PREVENTER
		R.D.	ROOF DRAIN
		R.T.	RUNNING TRAP
		R.C.V.	RISER CONTROL VALVE
		S.P.O.	SOIL PLUGGED OUTLET
		S.H.	SHOWER HEAD
		SH.-SHWR.	SHOWER
		SK.	SINK
		S.S.	SERVICE SINK
		S.E.	SEWAGE EJECTOR
		T.D.	TERRACE DRAIN
		T.E.	TERRACE ELEVATION
		T.P.	TRAP PRIMER
		T.S.	TAMPER SWITCH
		UR.	URINAL
		U.O.S.W.	UNDER ANOTHER SECTION OF THE WORK
		VAL. O. V.O.	VALVED OUTLET
		V.T.R.	VENT THRU ROOF
		V.P.O.	VENT PLUGGED OUTLET
		W.C.	WATER CLOSET

PLUMBING INSTALLATION CRITERIA

EACH BIDDER SHALL VISIT THE SITE AND BECOME INFORMED AS TO THE CONDITION OF THE PREMISES AND THE EXTENT AND CHARACTER OF WORK REQUIRED. NO ADDITIONAL COMPENSATION WILL BE APPROVED DUE TO FIELD CONDITIONS.

- PROVIDE ROUGH-IN AND FINAL CONNECTIONS FOR ALL PLUMBING FIXTURES INCLUDING WASTE, VENTS, HOT AND COLD WATER, AND PROVIDE ALL PLUMBING WORK NECESSARY TO MAKE THE PANTRY, ELECTRIC WATER COOLERS(BATH, ETC. ENTIRELY OPERABLE AND ACCEPTABLE TO LOCAL HEALTH AND BUILDING OFFICIALS.
 - PLUMBING CONTRACTOR SHALL LOCATE ALL PIPING AND PLUMBING ROUGH-IN FOR PLUMBING FIXTURES IN ACCORDANCE WITH ROUGH-IN DRAWINGS PROVIDED BY EQUIPMENT MANUFACTURERS.
 - ALL VISIBLY EXPOSED PIPE TO EQUIPMENT SHALL BE CHROME PLATED BRASS.
 - PROVIDE SHUT-OFF VALVES FOR EACH PLUMBING FIXTURE AND PIECE OF EQUIPMENT.
 - PROVIDE TRAPS ON ALL WASTE PIPING FROM PLUMBING FIXTURES AND PIECE OF EQUIPMENT.
 - COORDINATE POSITION OF SLEEVES AND OPENINGS THROUGH FLOOR WITH THE GENERAL CONTRACTOR.
 - PROVIDE VACUUM BREAKERS AND CHECK VALVES FOR THE PLUMBING FIXTURES WHERE AND WHEN REQUIRED BY CODE.
 - ALL PIPING AND EQUIPMENT SHALL BE SUBSTANTIALLY SUPPORTED FROM THE BUILDING STRUCTURE. HANGER AND SUPPORTS SHALL BE SPECIFICALLY APPROVED FOR USE IN PLUMBING SYSTEMS.
- A. WHERE OVERHEAD CONSTRUCTION DOES NOT PERMIT FASTENING OF HANGER RODS IN REQUIRED LOCATIONS, PROVIDE ADDITIONAL STEEL FRAMING AS REQUIRED AND APPROVED.
- B. NO PLUMBING PIPING SHALL BE HUNG FROM THE PIPING OF OTHER TRADES OR DUCTWORK. HANGERS SHALL BE OF HEAVY CONSTRUCTION, SUITABLE FOR THE SIZE OF PIPE TO BE SUPPORTED.
- PLUMBING FIXTURES TO BE APPROVED BY THE GENERAL CONTRACTOR AND INSTALLED BY THE PLUMBING CONTRACTOR. ID. PLUMBING FIXTURES SHALL BE AS SPECIFIED BY ARCHITECT.
 - ALL PLUMBING FIXTURES SPECIFIED BY THE ARCHITECT. SEE ARCHITECTURAL DRAWINGS, SPECIFICATIONS, DETAILS AND ELEVATIONS OF THE PANTRY, BATH, ETC. FOR REQUIRED PLUMBING CONNECTIONS.

DRAWING LIST

SHEET	TITLE	SCALE
P-000	PLUMBING SYMBOLS, ABBREVIATIONS, NOTES AND DRAWING LIST	NTS
P-100	PLUMBING UNDERGROUND PLAN	1/8" = 1'-0"
P-101	PLUMBING 1ST FLOOR PLAN	1/8" = 1'-0"
P-102	PLUMBING ROOF PLAN	1/8" = 1'-0"
P-500	PLUMBING DETAILS	NTS
P-600	PLUMBING SCHEDULES	NTS
P-700	PLUMBING RISER DIAGRAMS	NTS

BUILDING DEPARTMENT PLUMBING NOTES

THE PLUMBING SYSTEMS (SANITARY, WASTE, VENT, STORM, AND WATER DISTRIBUTION) AND ALL ASSOCIATED EQUIPMENT WILL BE INSTALLED AND MAINTAINED IN ACCORDANCE WITH THE FULL REQUIREMENTS OF THE PLUMBING CODE. COMPLIANCE WITH THE FULL PROVISIONS OF ALL BUILDING AND PLUMBING CODE ACCESSIBILITY REQUIREMENTS AND PLUMBING FIXTURE FLOW REQUIREMENTS OF THE PLUMBING CODE.

- THE SANITARY SYSTEM SHALL BE PROVIDED IN FULL ACCORDANCE WITH THE GENERAL PROVISIONS OF SECTION PC301.
- THE MATERIALS USED IN THE PLUMBING SYSTEMS WILL BE PROVIDED IN FULL ACCORDANCE WITH SECTIONS PC302 AND PC303.
- EQUIPMENT HOOK-UP AND THE JOINING WILL BE FULL COMPLIANCE WITH SECTIONS PC605 AND PC705.
- THE INSTALLATION OF FIXTURES WILL BE IN FULL ACCORDANCE WITH PC CHAPTER 4.
- TRAPS FOR FIXTURES AND DRAIN LINES WILL BE PROVIDED AND CLEANOUTS INSTALLED IN FULL COMPLIANCE WITH SECTIONS PC412, PC708 AND PC CHAPTER 10.
- VERTICAL AND HORIZONTAL PIPING WILL BE HUNG AND SUPPORTED AS DIRECTED IN SPECIFICATIONS AND WITH THE FULL COMPLIANCE WITH SECTION PC308.
- THE WATER SUPPLY SYSTEMS OF THE SUBJECT BUILDING SHALL BE INSTALLED AND MAINTAINED IN FULL COMPLIANCE WITH PC CHAPTER 6.
- SHOCK ABSORBERS SHALL BE PROVIDED IN FULL COMPLIANCE WITH PC 604.9 WHERE ALL QUICK CLOSING VALVES ARE INSTALLED AND ALL EQUIPMENT CONTAINING QUICK CLOSING SOLENOID VALVES SUCH AS ICE MAKERS, COFFEE MACHINES, DISHWASHERS, CLOTHES WASHERS, ELECTRONIC OPERATED FLUSH VALVES AND FAUCETS, AND SHOWER MIXING VALVES THAT HAVE A SINGLE LEVER HANDLE.
- THE SANITARY DRAINAGE SYSTEM WILL BE SIZED AND INSTALLED IN FULL COMPLIANCE WITH PC CHAPTER 7.
- THE VENT PIPING FOR THE SANITARY DRAINAGE SYSTEM OF THE SUBJECT BUILDING WILL BE INSTALLED IN FULL COMPLIANCE WITH SECTION PC702 & PC CHAPTER 9.
- THE STORM DRAINAGE SYSTEM AND PIPING WILL BE INSTALLED IN FULL COMPLIANCE WITH PC CHAPTER 11.
- ALL TRENCHING SHALL BE DONE IN ACCORDANCE WITH THE REQUIREMENTS OF SECTION PC306.
- RAT PROOFING SHALL BE IN ACCORDANCE WITH SECTION PC304.
- TEMPORARY TOILET FACILITIES SHALL BE PROVIDED FOR CONSTRUCTION PERSONNEL AS PER SECTION PC311.

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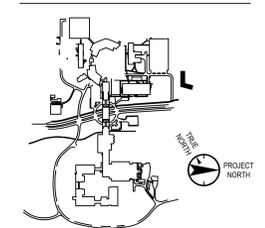
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Key Plan



No. Date Description

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Professional Seal and Signature

Vendor Name: COSENTINI
Vendor Project No.: 151-210104
Discipline: PLUMBING Drawn By: DH

PLUMBING
SYMBOLS, ABBREVIATIONS,
AND DRAWING LIST

Scale: NTS Floor: N/A

TO THE BEST OF MY KNOWLEDGE, BELIEF AND PROFESSIONAL JUDGMENT, THESE PLANS AND SPECIFICATIONS ARE IN COMPLIANCE WITH THE 2020 ENERGY CONSERVATION CODE OF NYS

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P-000

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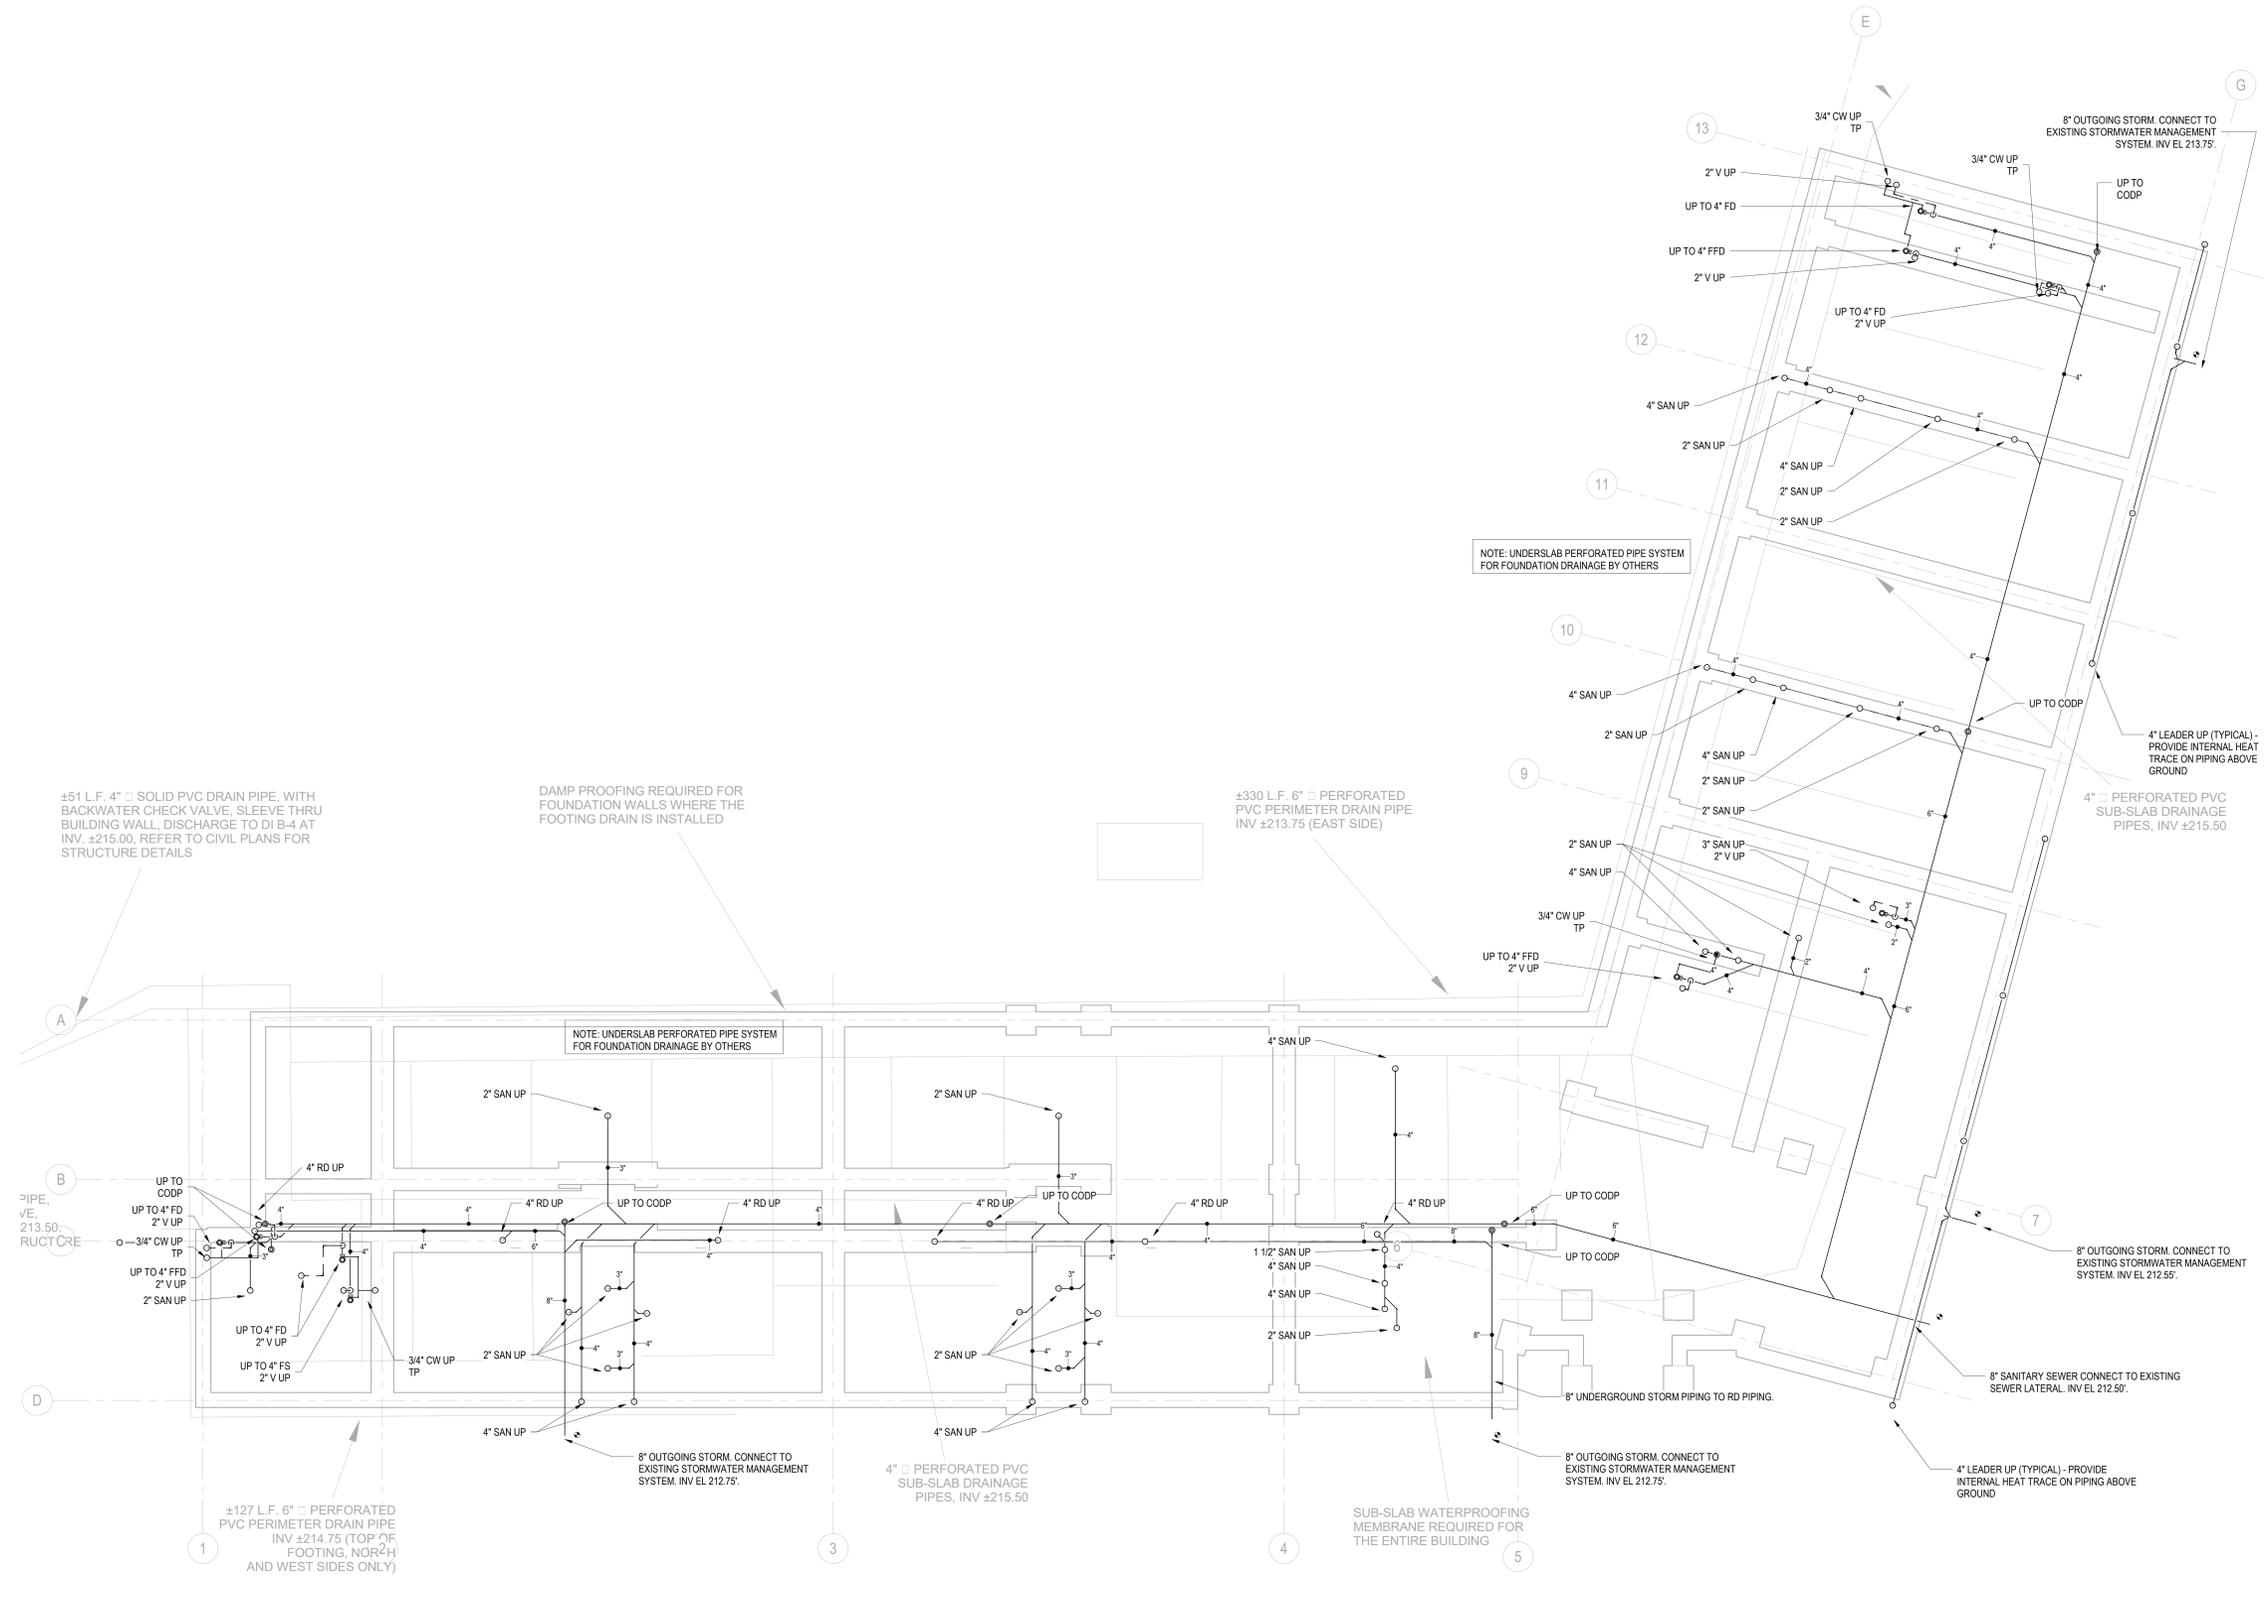
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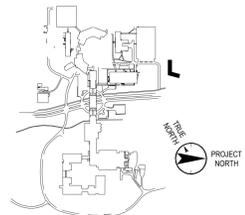
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1 UNDERGROUND PLUMBING PLAN
1/8" = 1'-0"

Key Plan



No.	Date	Description
0	05.20.2022	ISSUED FOR PERMIT

Plot Date: 11/23/21
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Vendor Name: COSENTINI
Vendor Project No.: 151-210104
Discipline: PLUMBING Drawn By: DH
PLUMBING UNDERGROUND PLAN

Scale: 1/8" = 1'-0" Floor: UNDERSLAB

P-100

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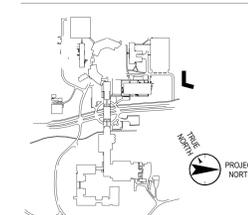
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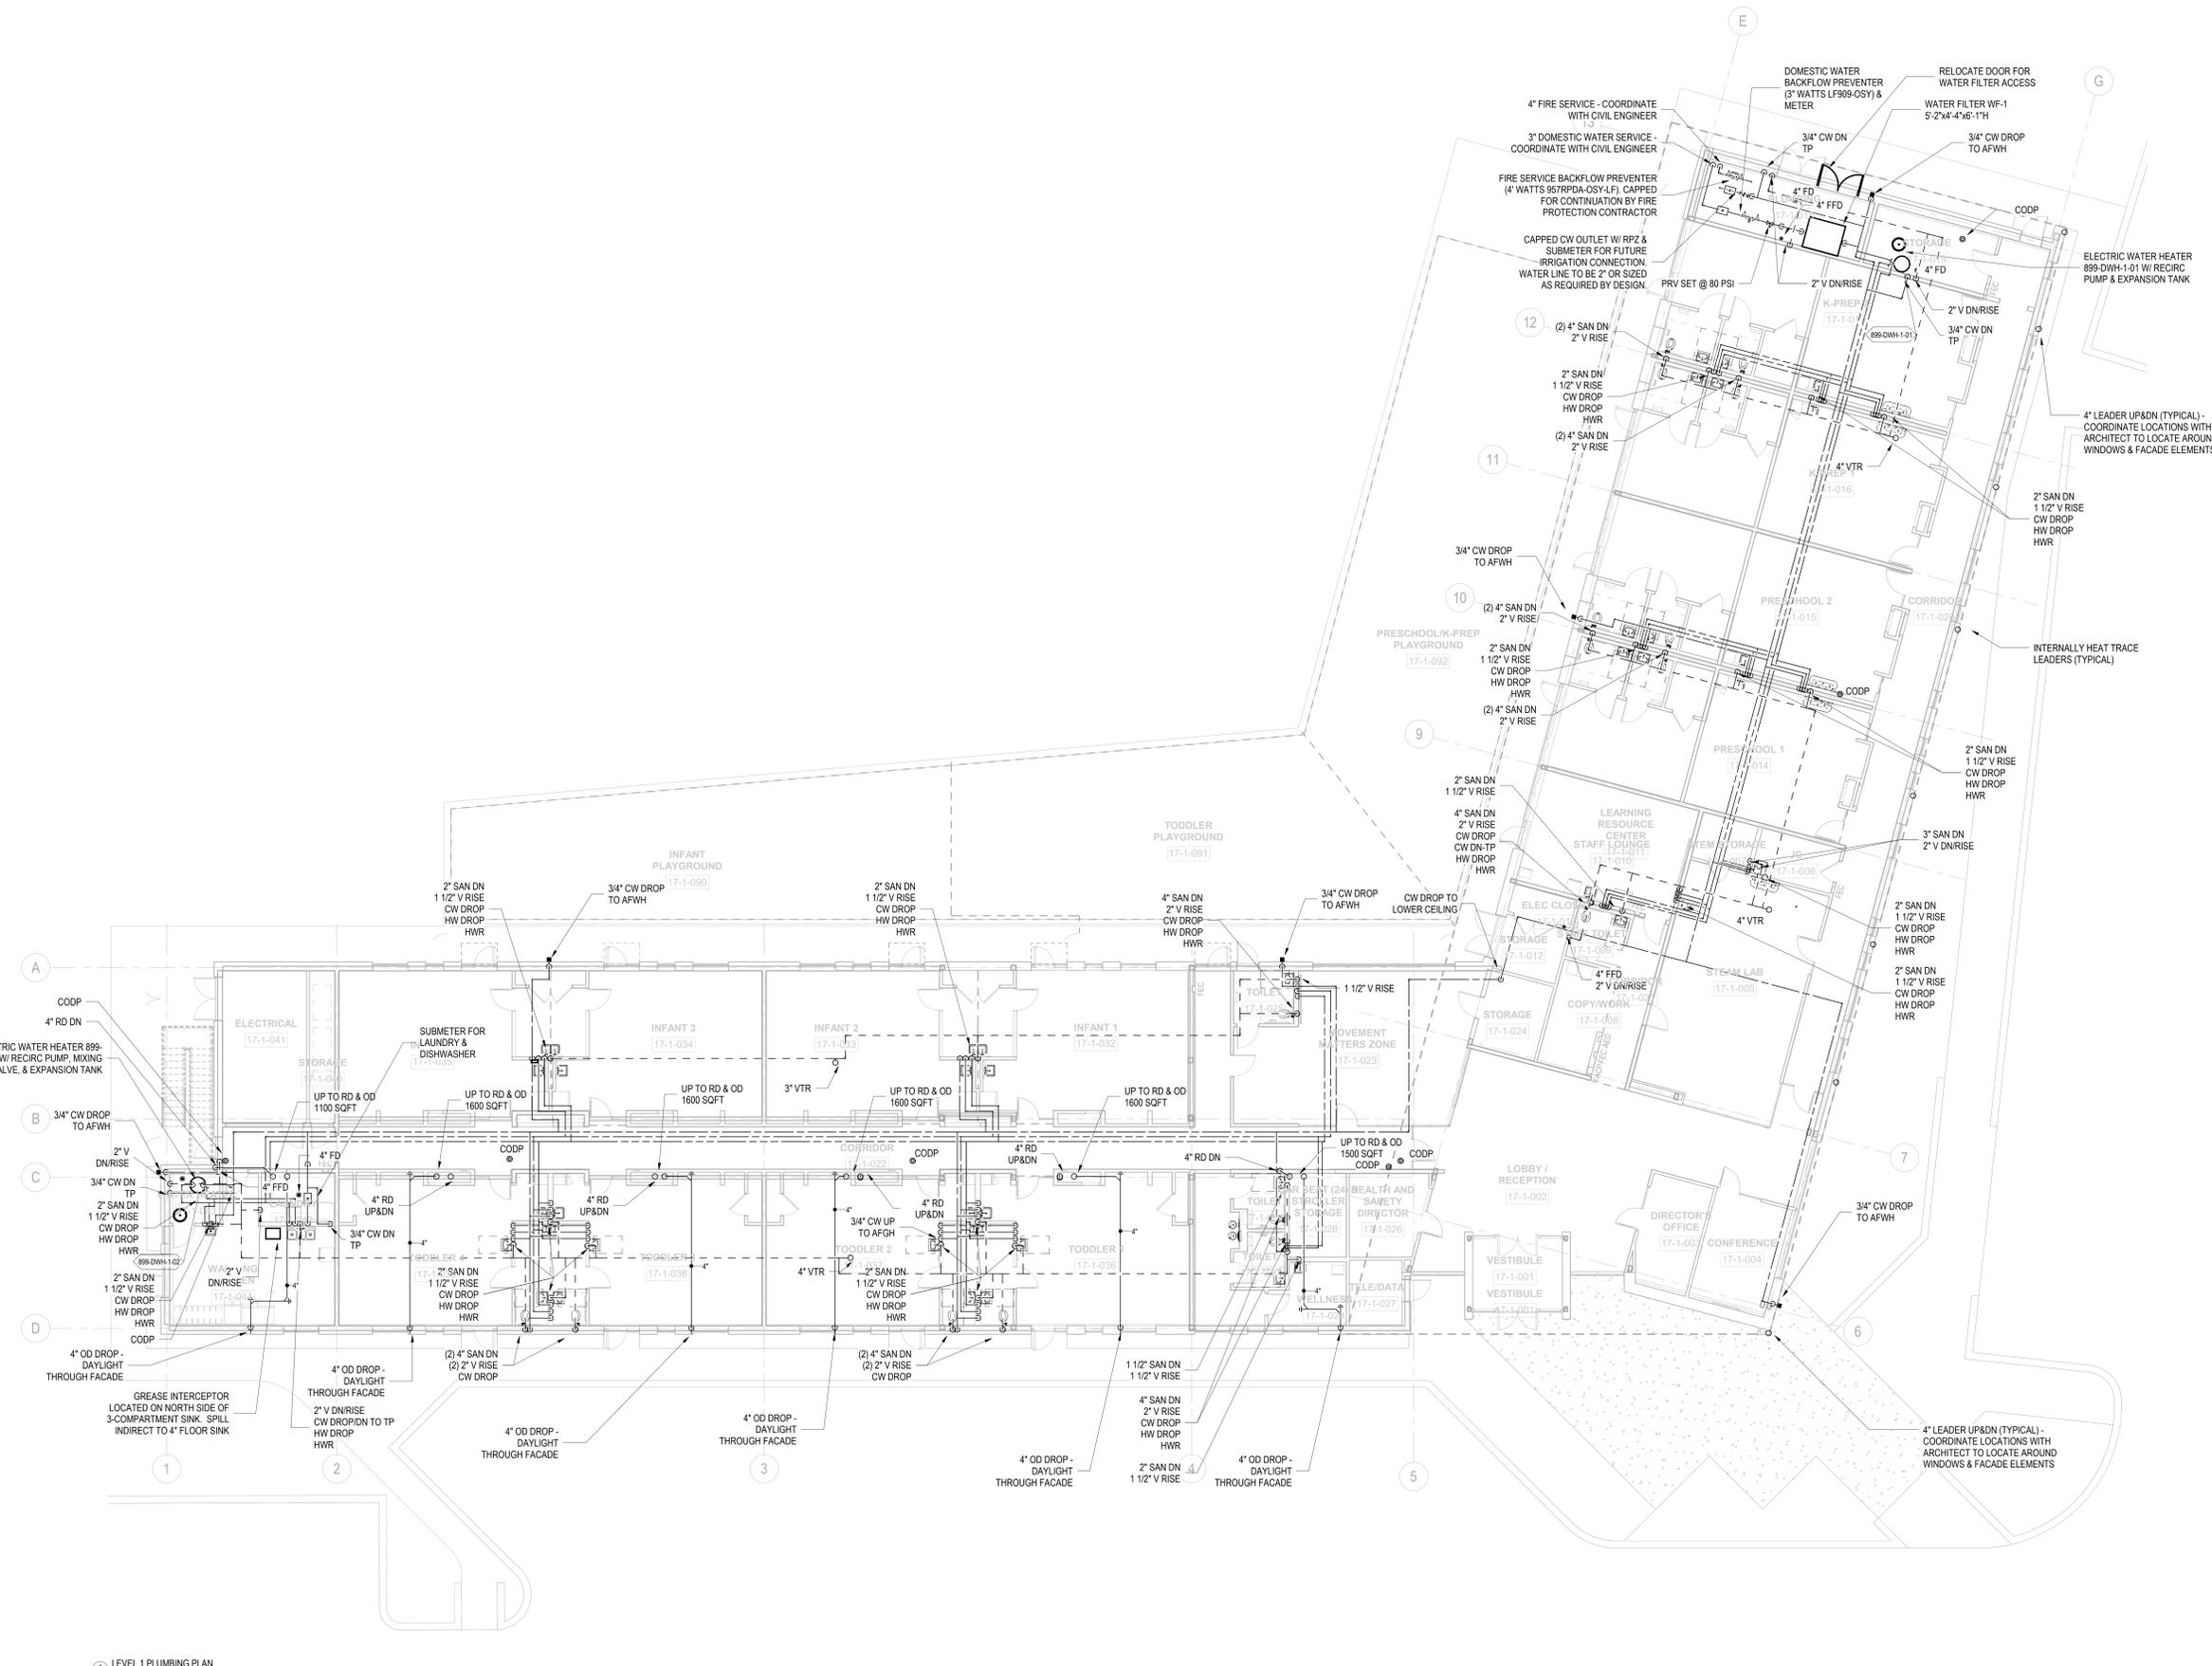
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Vendor Name: COSENTINI
Vendor Project No.: 151-210104
Discipline: PLUMBING Drawn By: DH
PLUMBING 1ST FLOOR PLAN

Scale: 1/8" = 1'-0" Floor: 1ST

P-101



1 LEVEL 1 PLUMBING PLAN
1/8" = 1'-0"

TO THE BEST OF MY KNOWLEDGE, BELIEF AND PROFESSIONAL JUDGMENT, THESE PLANS AND SPECIFICATIONS ARE IN COMPLIANCE WITH THE 2020 ENERGY CONSERVATION CODE OF NYS

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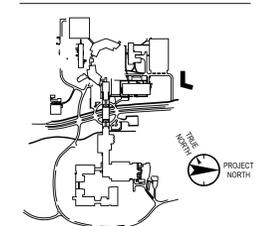
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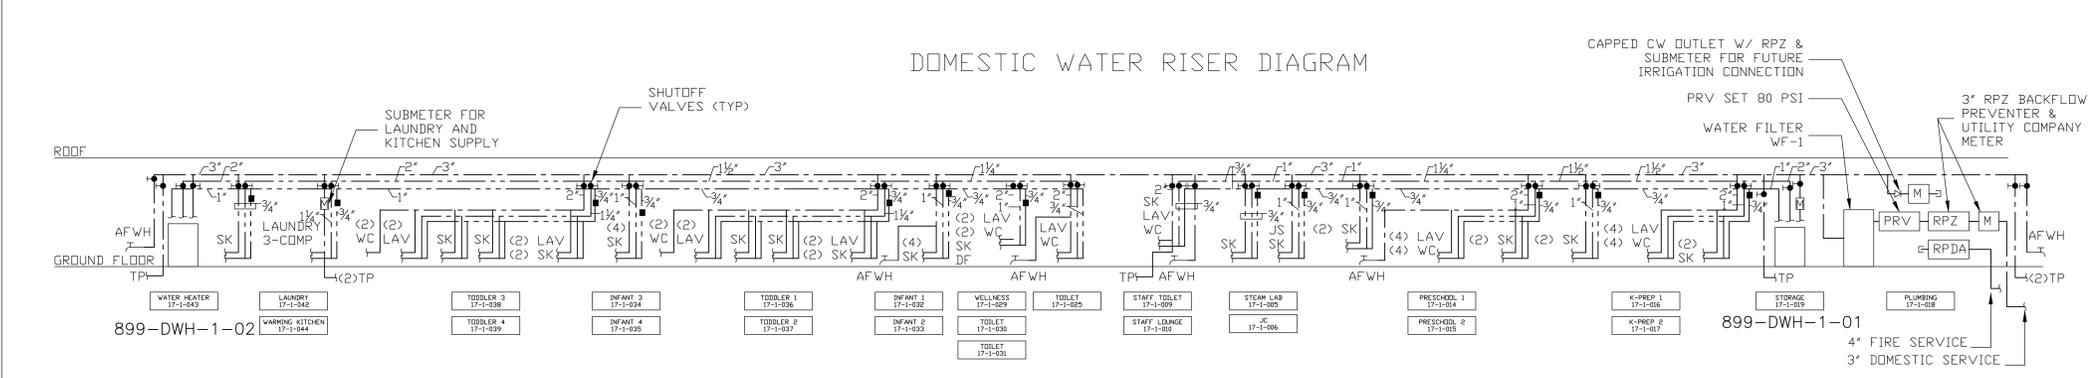
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Vendor Name: COSENTINI
Vendor Project No.: 151-210104
Discipline: PLUMBING Drawn By: DH
PLUMBING
RISER DIAGRAMS

Scale: NTS Floor: N/A

P-700

DOMESTIC WATER RISER DIAGRAM



Main Line Fire Protection Corp.
Automatic Sprinkler Systems
541 N. Highland Ave. Upper West, NY 10906
Tel: 914.847.3131 Fax: 914.847.3130


Hydrant Flow Test Report

Job: T100_B17
Job Location: Regeneron North Campus - Town of Mt Pleasant, NY
Test Date: 11/5/2021
Control Hydrant Location: Outside loading dock building 8
Elev. Hydrant Location: 600 ft east of control hydrant.


Diffuser: 2.5
Static: 185 PSI
Residual: 125 PSI
Gallons per Minute: 1200 GPM

Should you have any questions feel free to call.
Sincerely Yours,
Michael J. Javak
Michael Javak


STORM RISER DIAGRAM

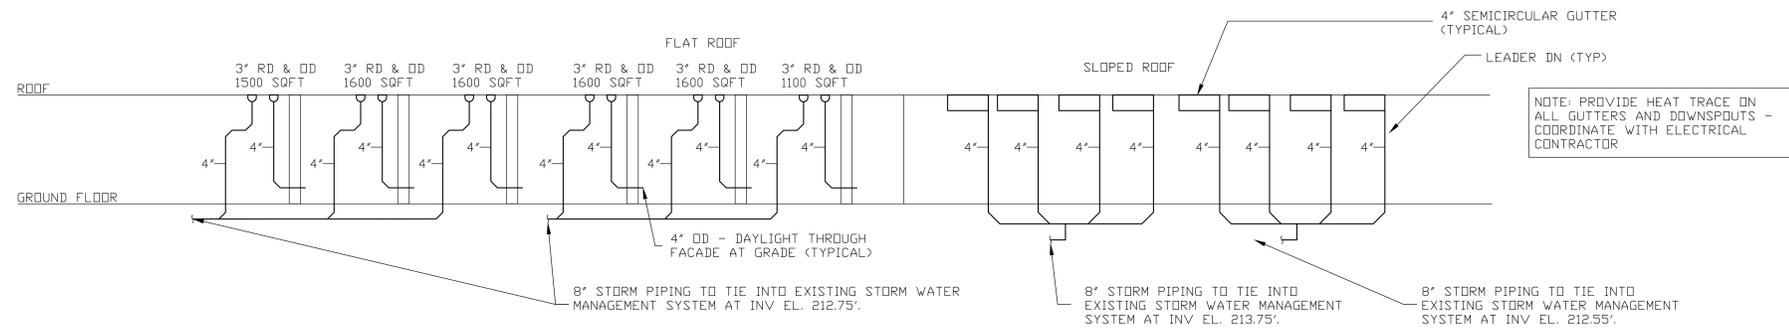

SANITARY RISER DIAGRAM - NORTH WING

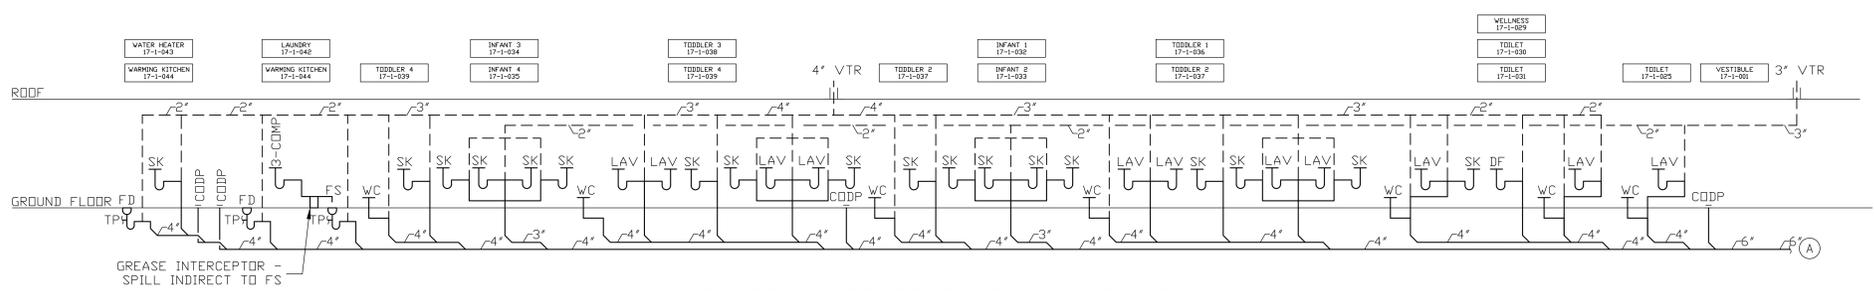

SANITARY RISER DIAGRAM - EAST WING

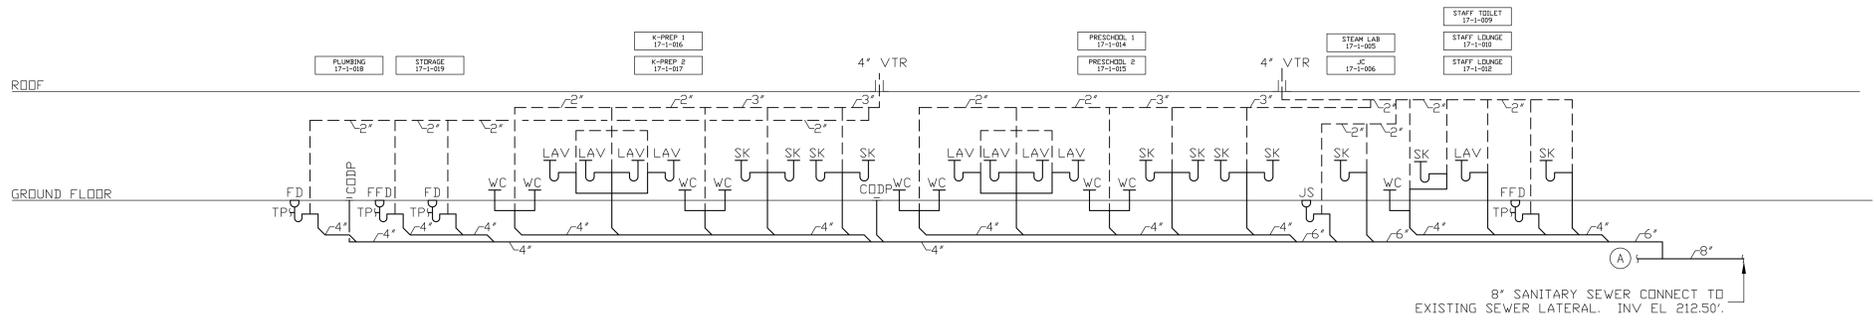

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