SOUTH ORANGETOWN CENTRAL SCHOOL DISTRICT

2022 CAPITAL IMPROVEMENTS PROJECT

TAPPAN ZEE HIGH SCHOOL S.E.D. NO. 50-03-01-06-0-006-031

160 VAN WYCK ROAD, BLAUVELT, NEW YORK 10913 COTTAGE LANE ELEMENTARY S.E.D. NO. 50-03-01-06-0010-021 SOUTH ORANGETOWN MIDDLE SCHOOL S.E.D. NO. 50-03-01-06-0-013-028

SO. ORANGETOWN CENTRAL SCHOOL DISTRICT 160 VAN WYCK ROAD BLAUVELT, NEW YORK 10913

OWNER

PHONE: 845-680-1000

ARCHITECT

50 FRONT STREET, SUITE 202 NEWBURGH, NEW YORK 12550

PHONE: 800-274-9000

LOCATION MAP DRAWING LIST

SOUTH ORANGETOWN MIDDLE SCHOOL 160 VAN WYKE ROAD, BLAUVELT, NEW YORK 10913 TAPPAN ZEE HIGH SCHOOL 15 DUTCH HILL ROAD, ORANGEBURG, NEW YORK 10962 COTTAGE LANE ELEMENTARY SCHOOL 120 COTTAGE LANE, BLAUVELT NEW YORK 10983 Blauvelt Rd Clausland Mountain County Park Convent Rd Orangeburg Course Old Orangeburg Rd © 2018 HERE

GENERAL:

TITLE SHEET GEN-T001

CLES OVERALL FLOOR CODE PLAN SOMS OVERALL GROUND FLOOR CODE PLAN

SOMS-UO2 SOMS OVERALL FIRST FLOOR CODE PLAN TZHS OVERALL FIRST FLOOR CODE PLAN

ASBESTOS ABATEMENT:

CLES-HZ101 CLES ABATEMENT FLOOR PLAN

SOMS-HZ101 SOMS GROUND AND FIRST FLOOR ABATEMENT PLANS TZHS FIRST AND SECOND FLOOR ABATEMENT PLANS

TZHS OVERALL SECOND FLOOR CODE PLAN

ARCHITECTURAL:

CLES DEMOLITION AND RECONSTRUCTION PLANS AND ELEVATIONS

SOMS GROUND FLOOR DEMOLITION AND RECONSTRUCTION PLANS AND ELEVATIONS SOMS FIRST FLOOR DEMOLITION AND RECONSTRUCTION PLANS AND ELEVATIONS SOMS-A102

TZHS FIRST AND SECOND FLOOR DEMOLITION PLANS

TZHS-A201 TZHS FIRST AND SECOND FLOOR RECONSTRUCTION PLANS

TZHS FIRST AND SECOND FLOOR CEILING PLANS TZHS-A601 TZHS TOILET ROOM ELEVATIONS TZHS-A701

TZHS TOILET ROOM ELEVATIONS TZHS-A702 SCHEDULES, DETAILS AND WALL TYPES

IT IS A VIOLATION OF THE LAW FOR ANY PERSON, UNLESS ACTING UNDER THE DIRECTION OF A

ARCHITECT IS ALTERED, THE ALTERING ARCHITECT SHALL FIX TO HIS ITEM THE SEAL AND THE

AND A SPECIFIC DESCRIPTION OF THE ALTERATION

MECHANICAL

HVAC SYMBOLS LIST AND GENERAL NOTES

TOILET ROOM HVAC DEMOLITION AND NEW WORK PLAN TOILET ROOM HVAC DEMOLITION AND NEW WORK PLAN

TOILET ROOM HVAC PARTIAL FIRST AND SECOND FLOOR DEMOLITION PLAN

TOILET ROOM HVAC FIRST FLOOR NEW WORK PLAN

HVAC DETAILS

HVAC SCHEDULES AND CONTROLS DIAGRAM

PLUMBING LEGENDS, ABBREVIATIONS, NOTES, DETAILS AND SCHEDULES

CLES TOILET ROOMS - PLUMBING DEMOLITION AND NEW WORK PLAN

SOMS PLUMBING DEMO PLAN

SOMS PLUMBING SANITARY & DOMESTIC PLANS

TZHS PLUMBING DEMO PLAN

TZHS PLUMBING SANITARY & DOMESTIC PLANS

TZHS PLUMBING DOMESTIC PLAN

ELECTRICAL:

ELECTRICAL SYMBOLS AND ABBREVIATIONS COTTAGE LANE FIRST FLOOR DEMOLITION PLAN CLES-E201 COTTAGE LANE FIRST FLOOR NEW WORK PLAN

S.O. MIDDLE SCHOOL GROUND AND FIRST FLOOR DEMOLITION PLANS SOMS-E101 S.O. MIDDLE SCHOOL GROUND AND FIRST FLOOR NEW WORK PLANS TZHS-E101 TAPPAN ZEE HS FIRST AND SECOND FLOOR DEMOLITION PLANS TAPPAN ZEE HS SECOND FLOOR DEMOLITION PLANS

TZHS-E201 TAPPAN ZEE HS FIRST AND SECOND FLOOR NEW WORK PLANS TZHS-E202 TAPPAN ZEE HS SECOND FLOOR NEW WORK PLANS

GEN-E900 SCHEDULES

NOTATION "ALTERED BY" FOLLOWED BY HIS SIGNATURE AND THE DATE OF SUCH ALTERATION

GENERAL NOTES

THE DESIGN OF THIS PROJECT CONFORMS TO ALL APPLICABLE PROVISIONS OF NEW YORK STATE UNIFORM FIRE PREVENTION AND BUILDING CODE, THE NEW YORK STATE ENERGY CONSERVATION CODE, AND THE BUILDING STANDARDS OF THE NEW YORK STATE EDUCATION DEPARTMENT.




FAX (845) 567-9614

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SNS	DATE	
REVISIONS	NO.	

SCALE AS NOTED TITLE SHEET

14457.16

GEN TOO 1

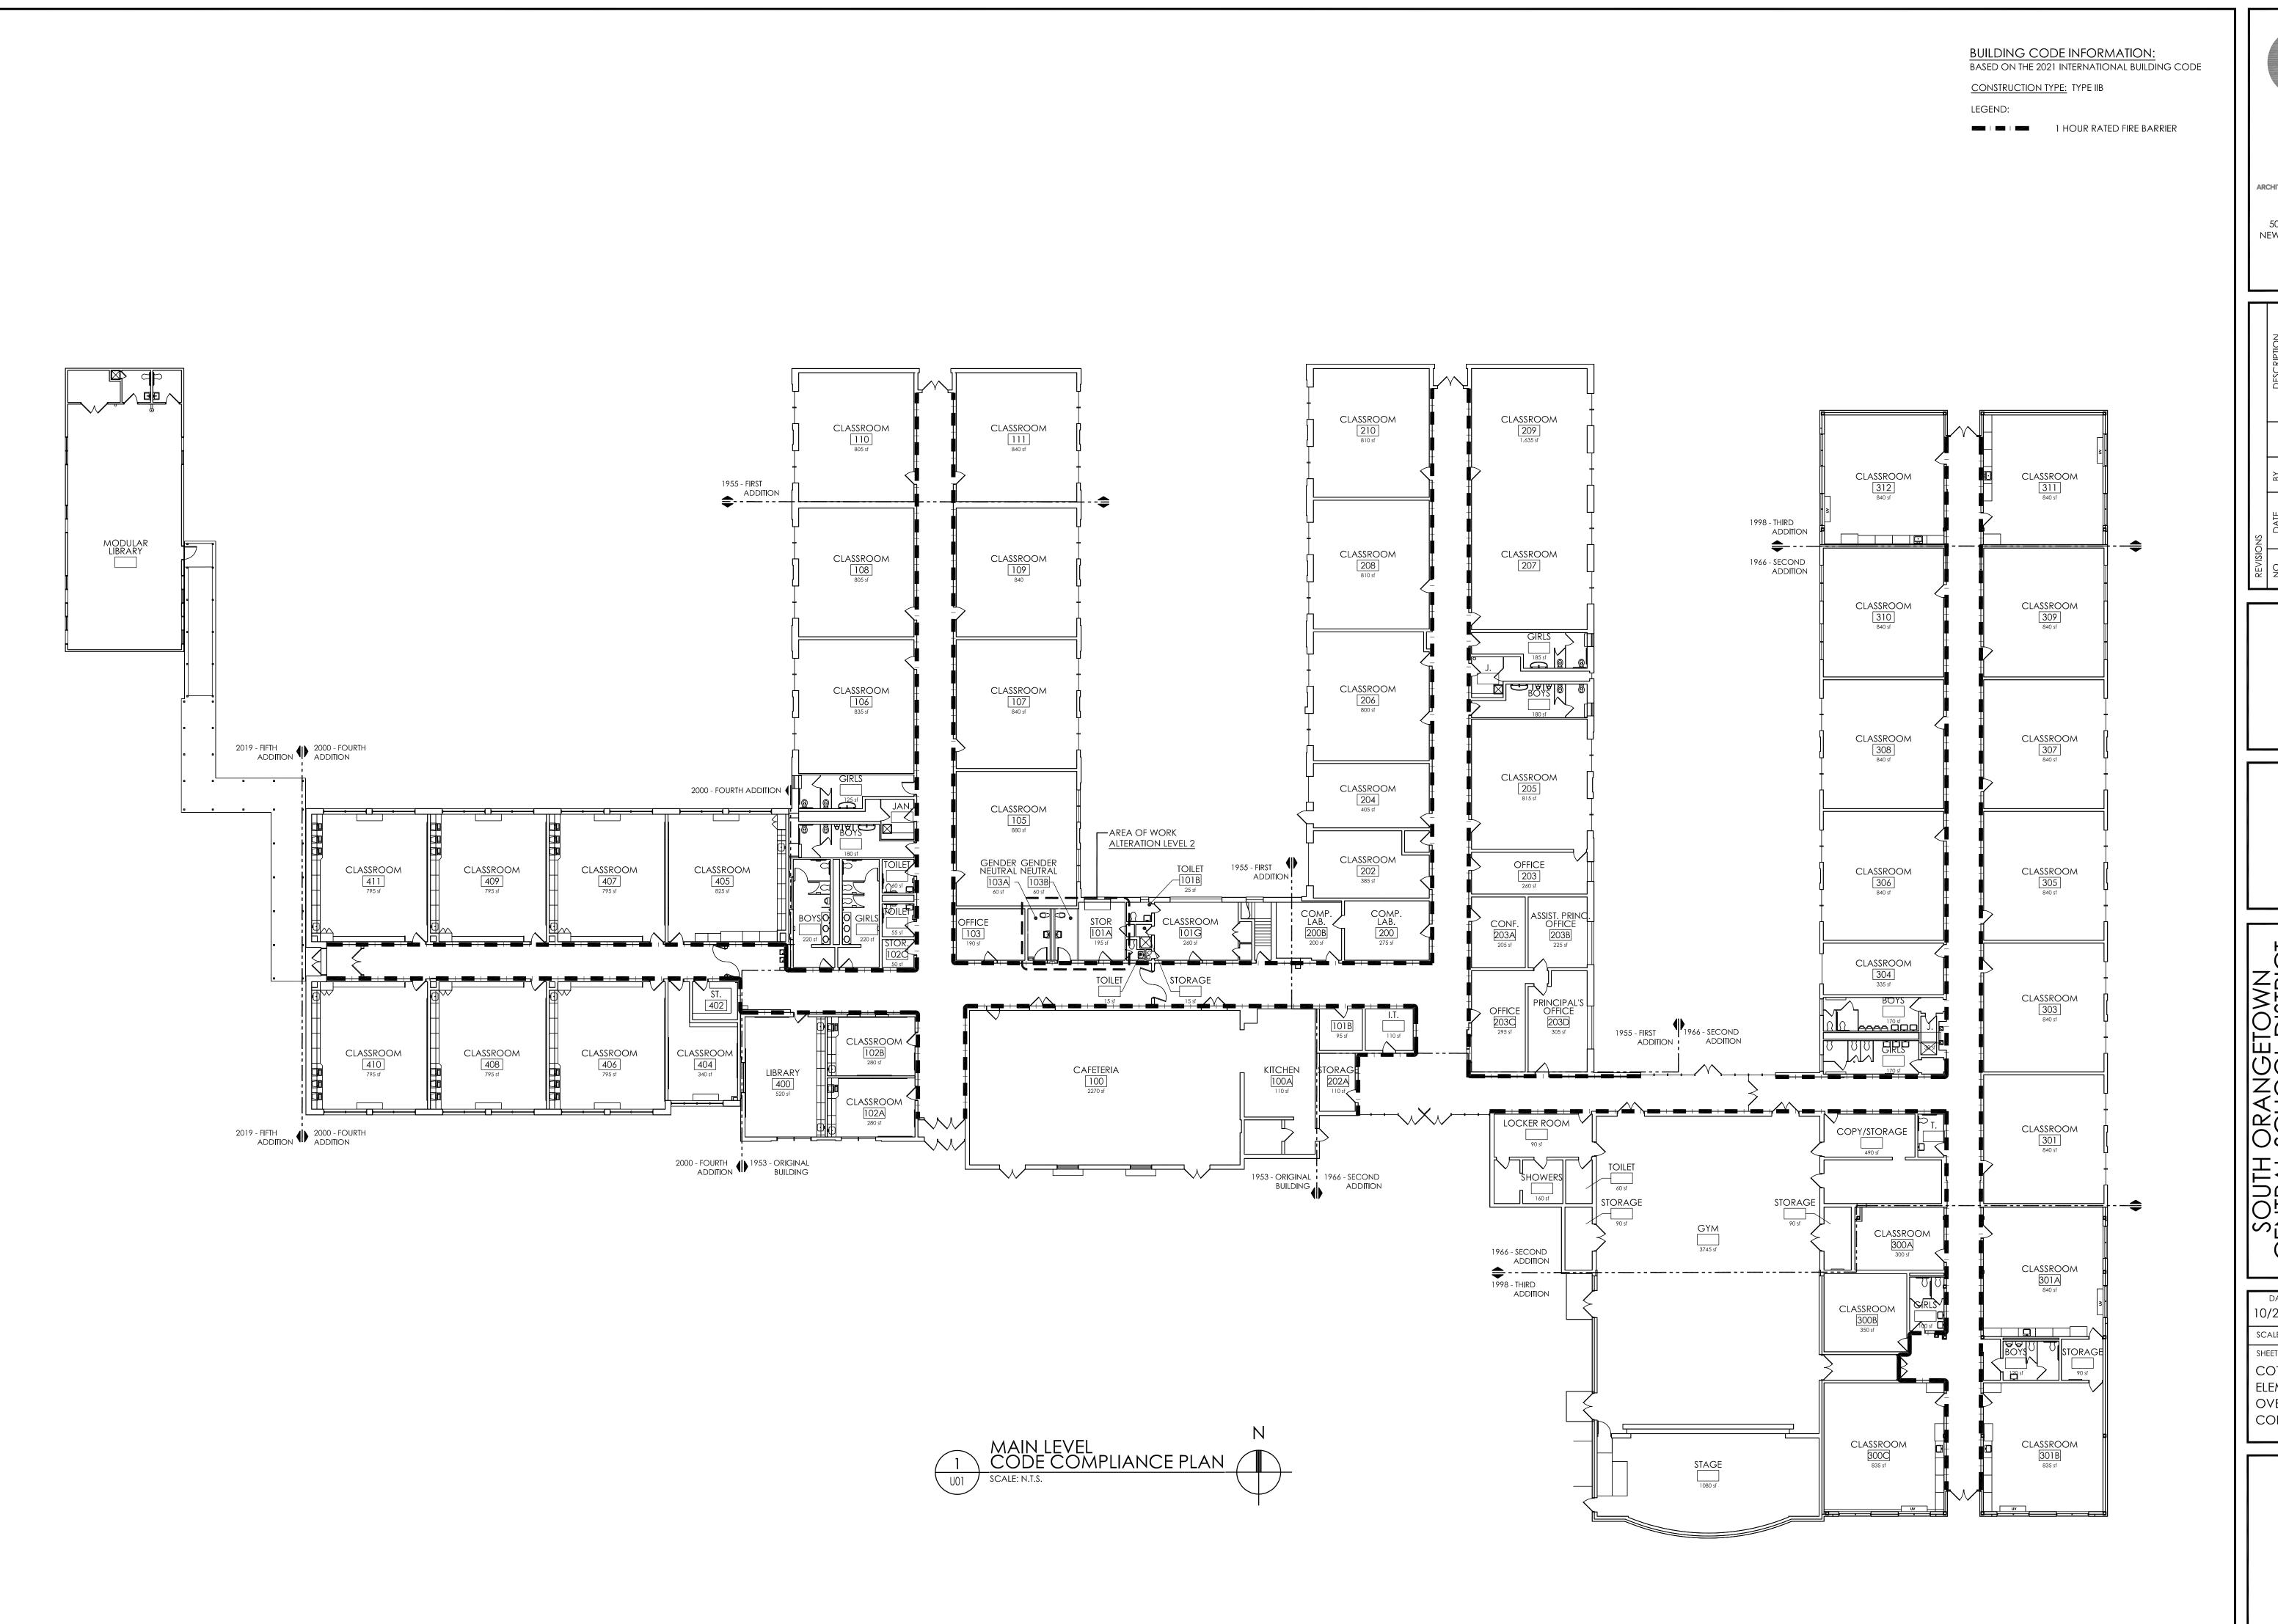

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CENTRAL SCHOOL DISTRICATION CAPITAL IMPROVEMENT PROJECT 2022
160 VAN WYCK RD, BLAUVELT, NY 1
COTTAGE LANE ELEMENTARY - SED# 50-03-01-06-0-05.0. MIDDLE SCHOOL - SED# 50-03-01-06-0-013-05.0. MIDDLE SCHOOL - SED# 50-03-01-06-0-013-05.0.

DATE DRAWN CHECKED 10/20/22 TLB LT

SCALE N.T.S.

SHEET TITLE


COTTAGE LANE

SHEET TITLE

COTTAGE LANE
ELEMENTARY SCHOOL
OVERALL FLOOR
CODE PLAN

14457.16

CLES U01

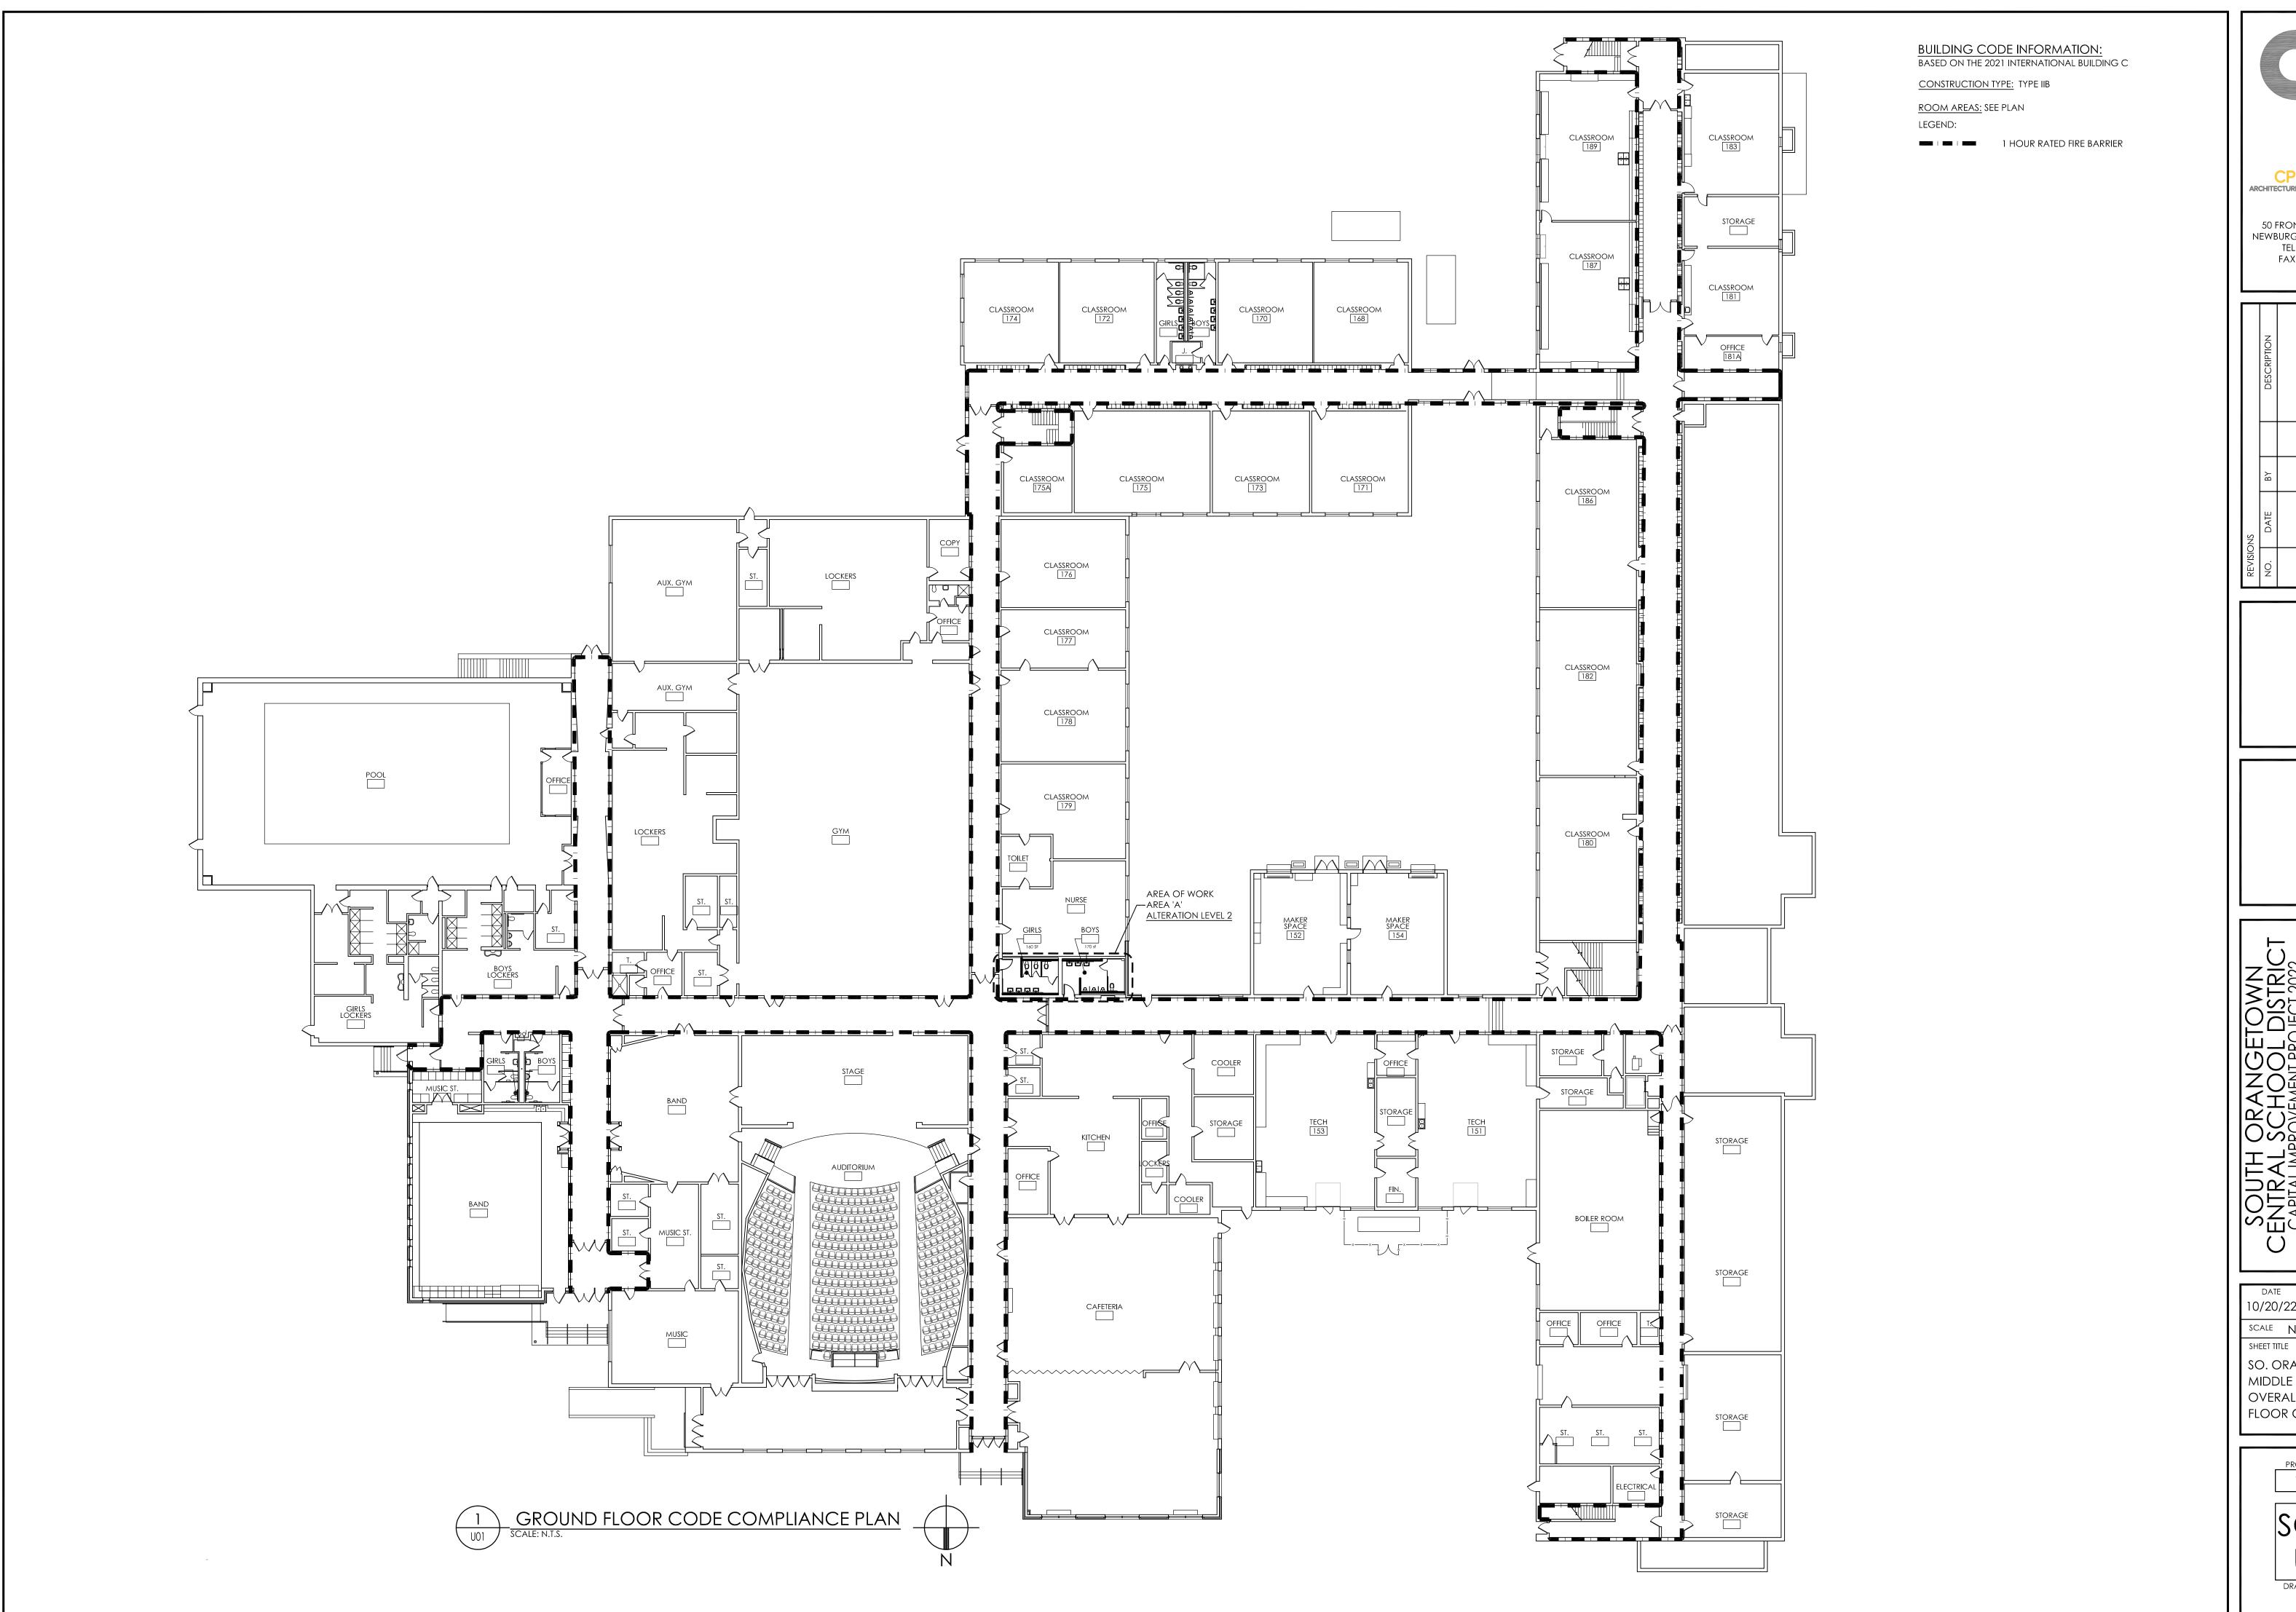

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Any way, if an item bearing the seal of an architect, engineer or surveyor is altered


CENTRAL SCHOOL DISTRIC
CAPITAL IMPROVEMENT PROJECT 2022
60 VAN WYCK RD, BLAUVELT, NY 109
COTTAGE LANE ELEMENTARY - SED# 50-03-01-06-0-010-08.0. MIDDLE SCHOOL - SED# 50-03-01-06-0-013-028
TAPPEN ZEE HIGH SCHOOL - SED#50-03-01-06-0-003-028

DATE DRAWN CHECK 10/20/22 TLB LT SCALE N.T.S.

SO. ORANGETOWN
MIDDLE SCHOOL
OVERALL GROUND
FLOOR CODE PLAN

PROJECT NUMBER

SOMS U01 DRAWING NUMBER

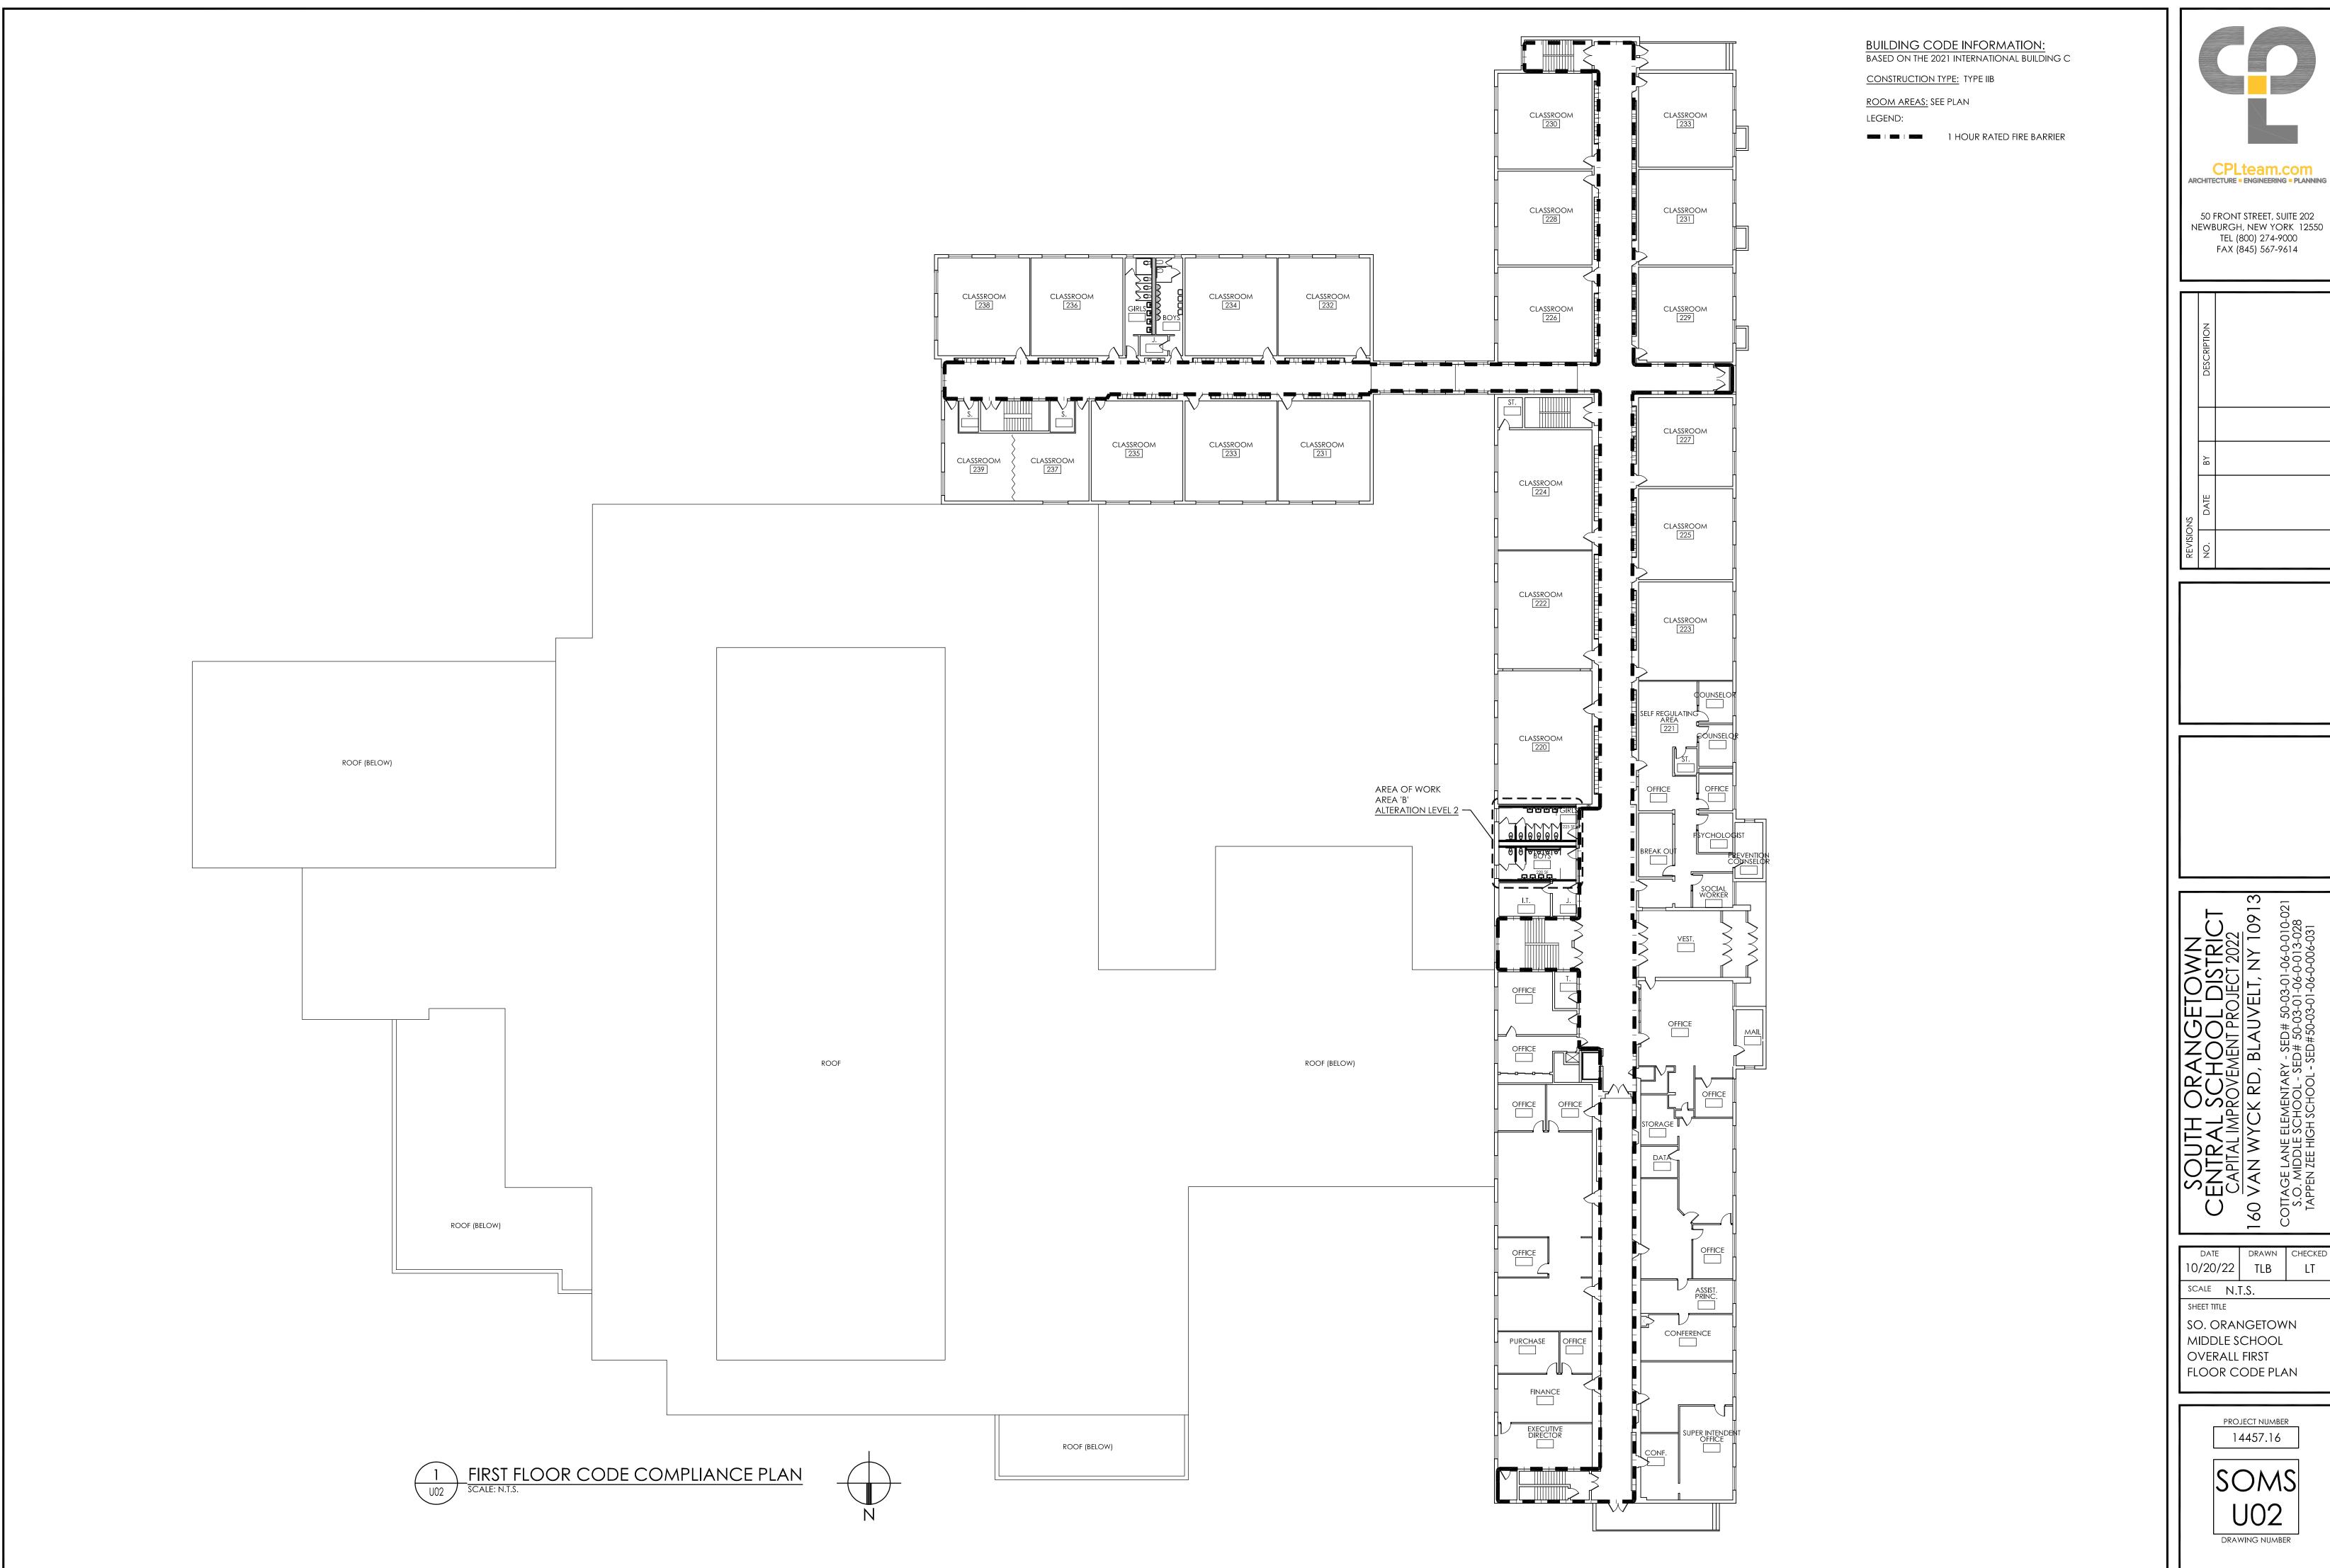


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10/20/22 TLB SCALE N.T.S. SHEET TITLE

SO. ORANGETOWN MIDDLE SCHOOL OVERALL FIRST FLOOR CODE PLAN


> PROJECT NUMBER 14457.16

> > DRAWING NUMBER

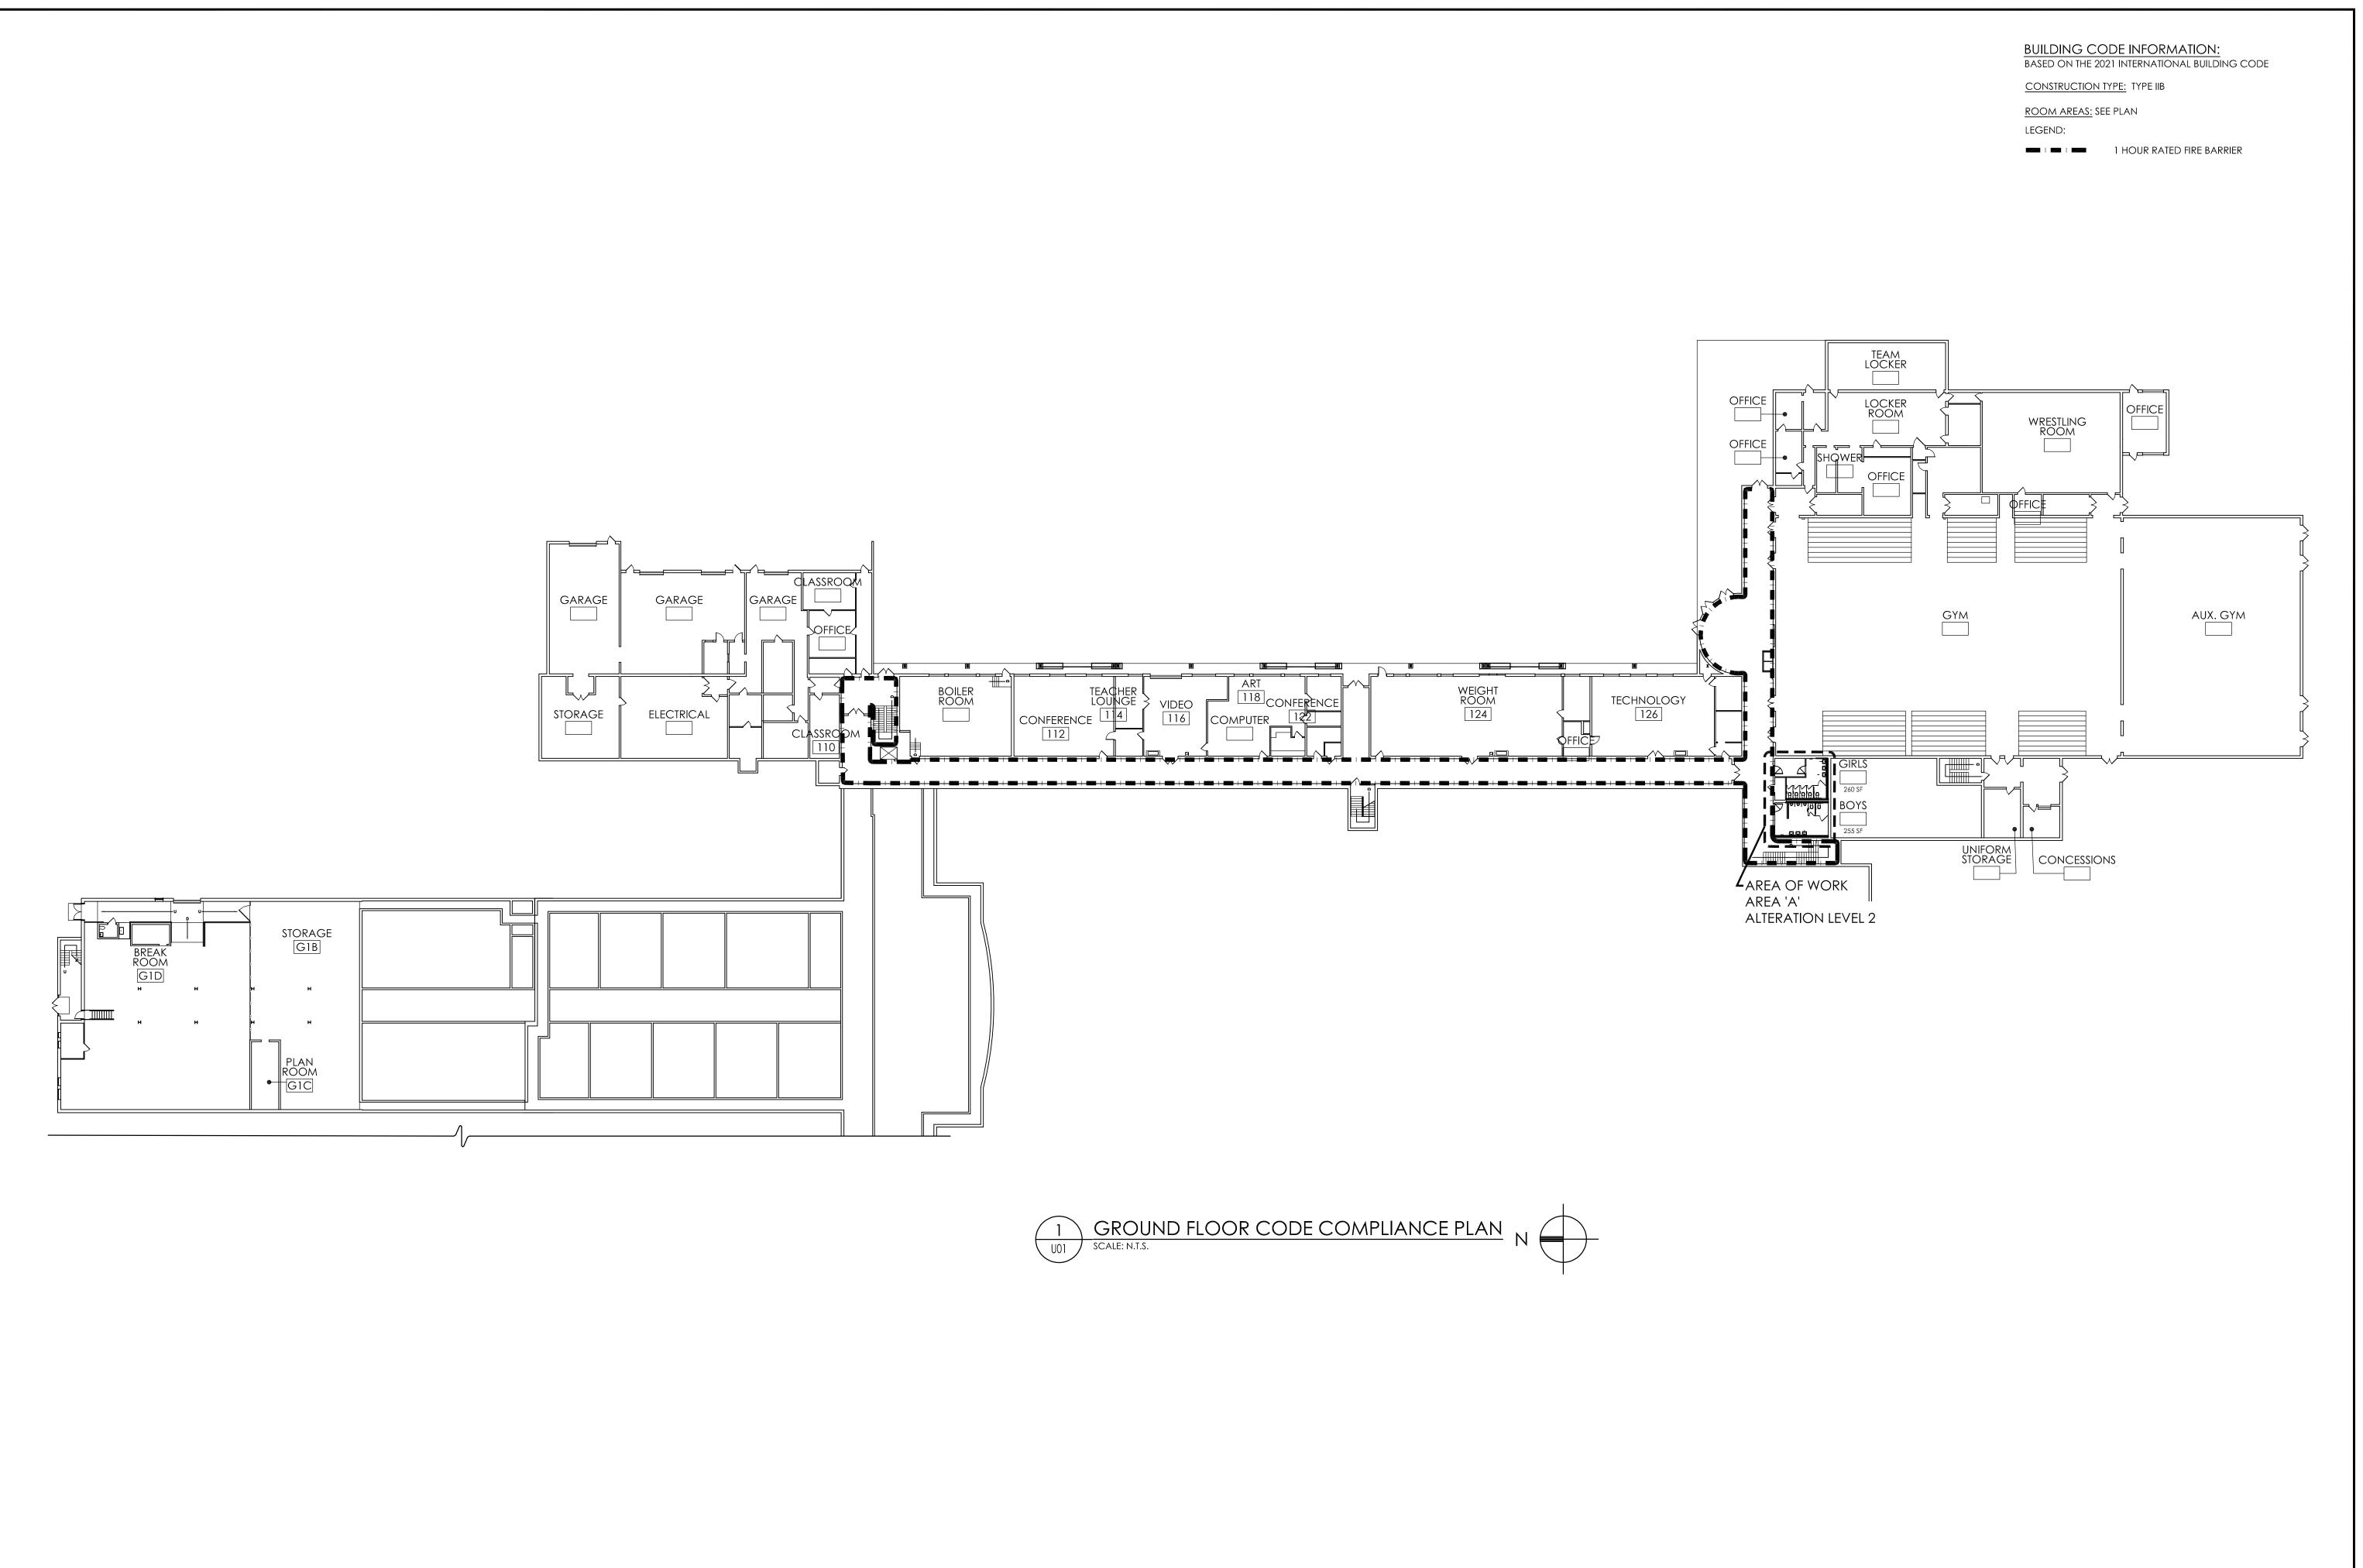

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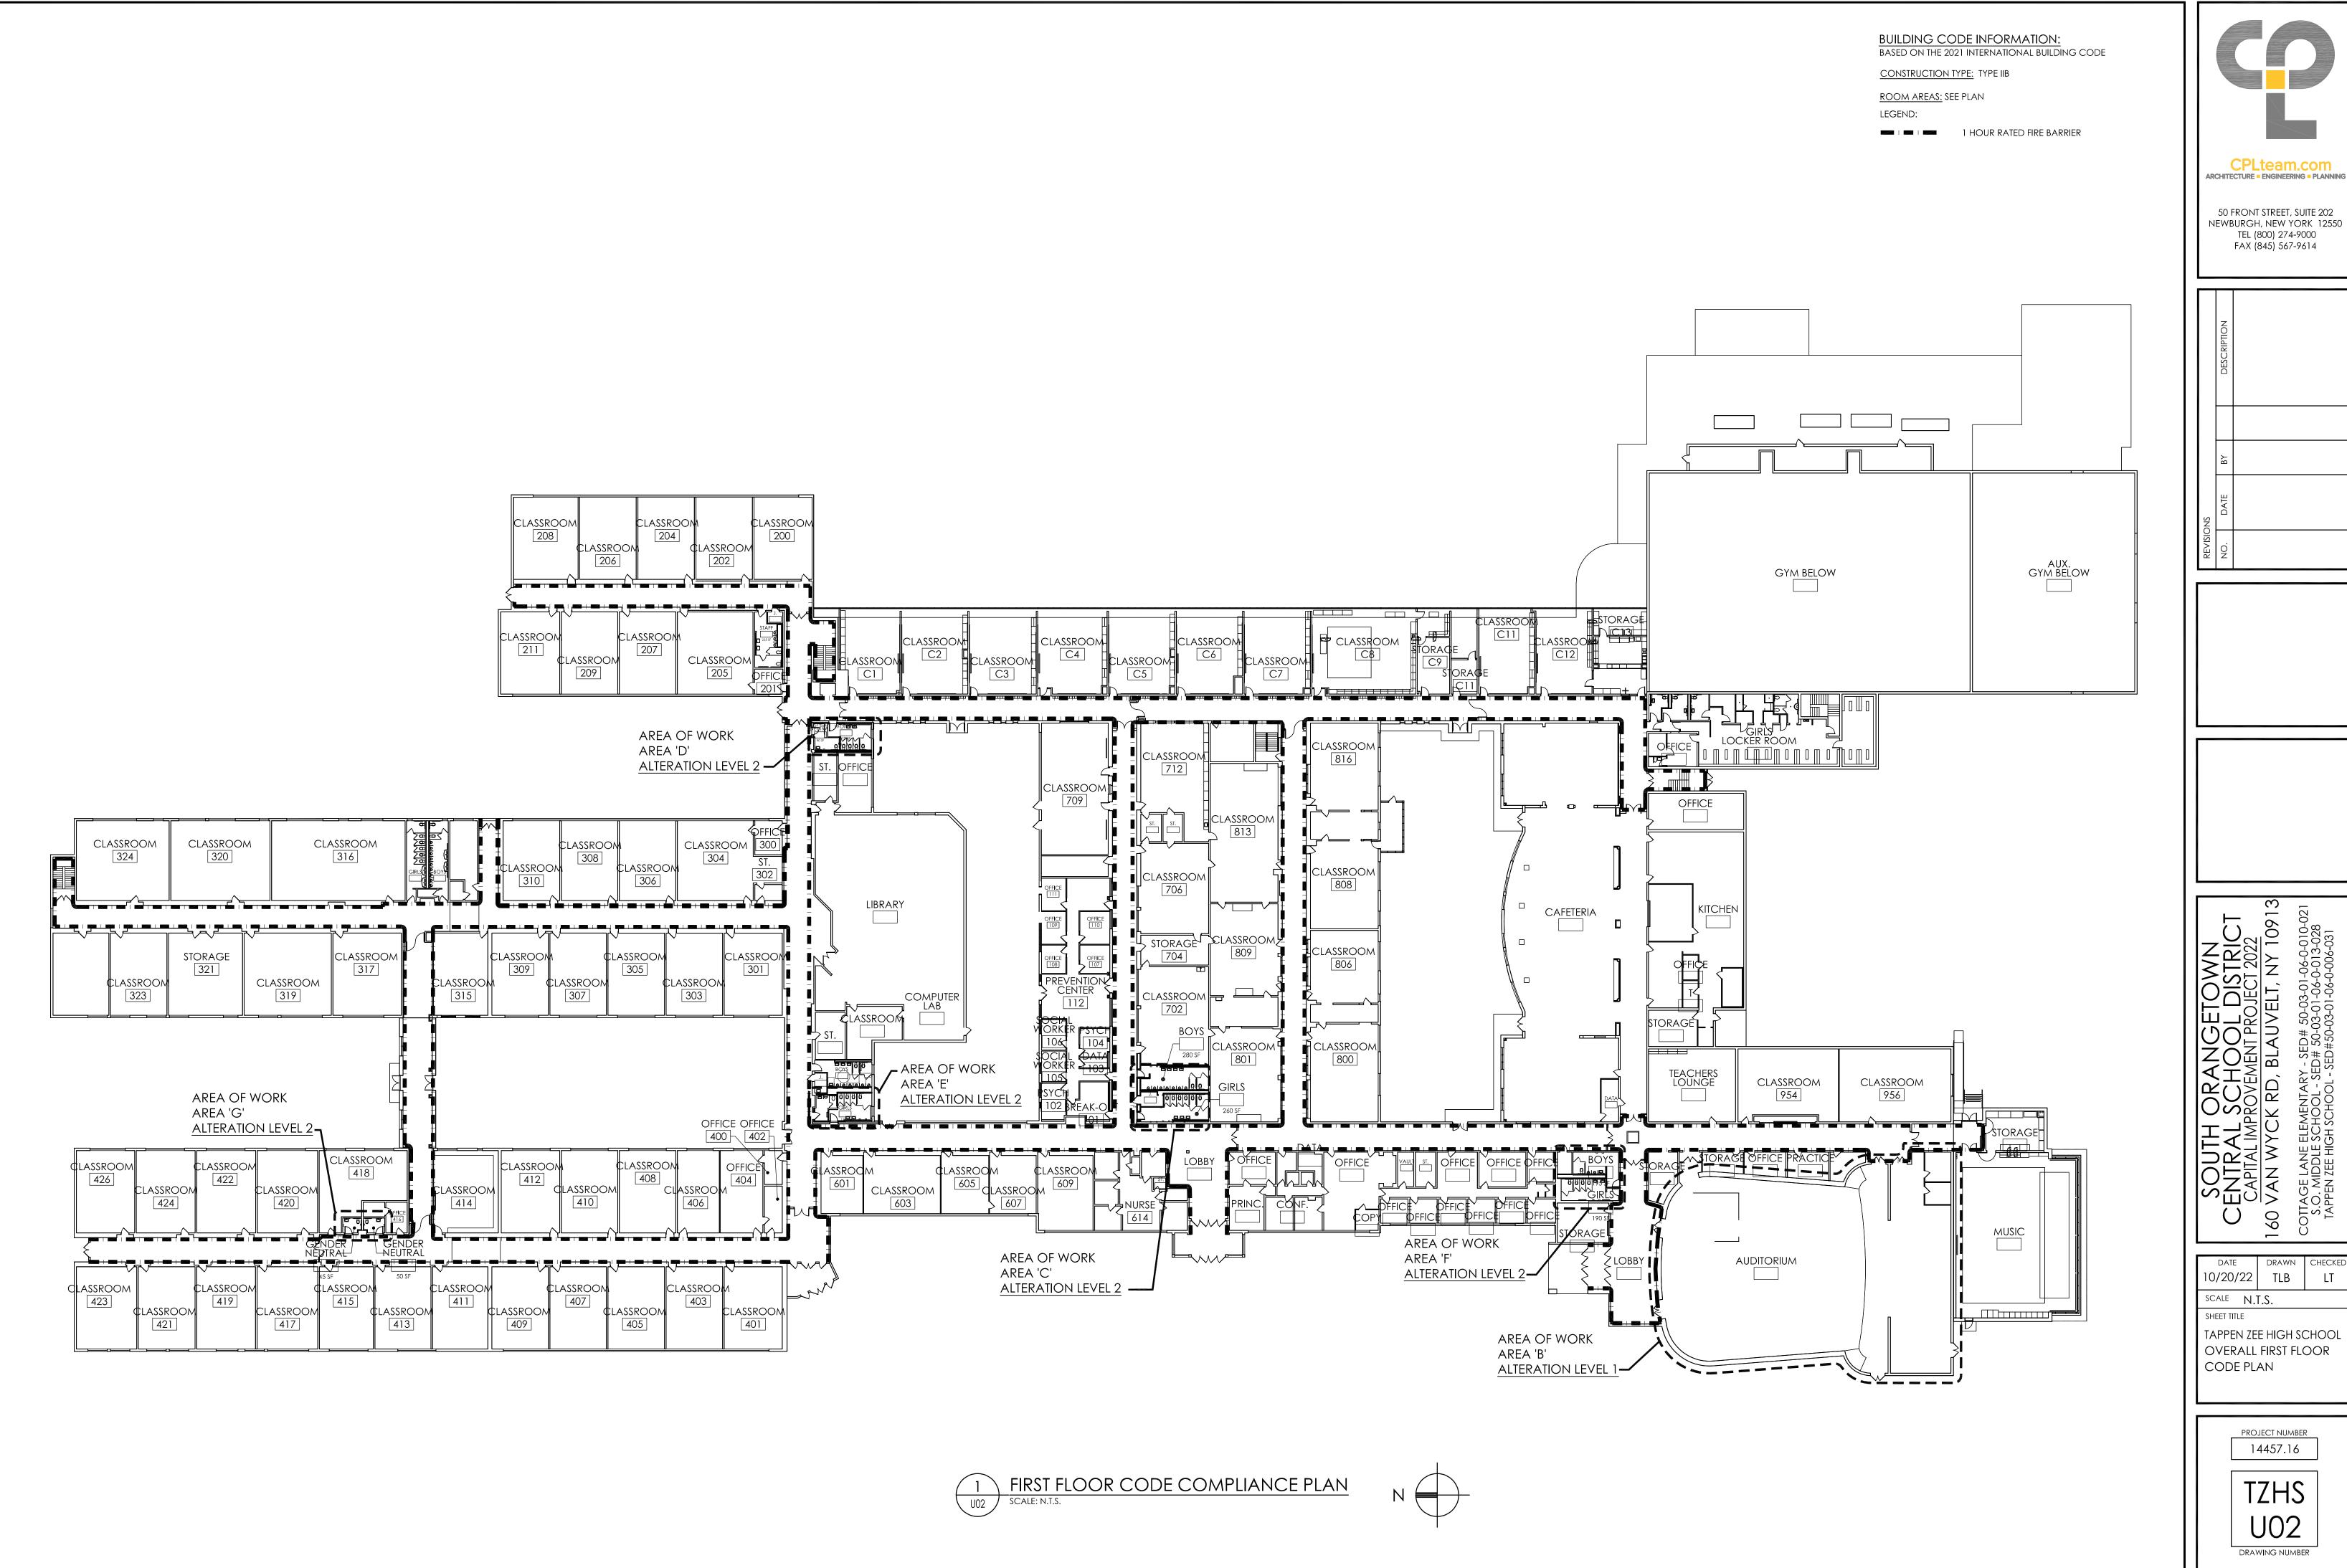
DATE DRAWN 10/20/22 TLB

SCALE N.T.S.
SHEET TITLE

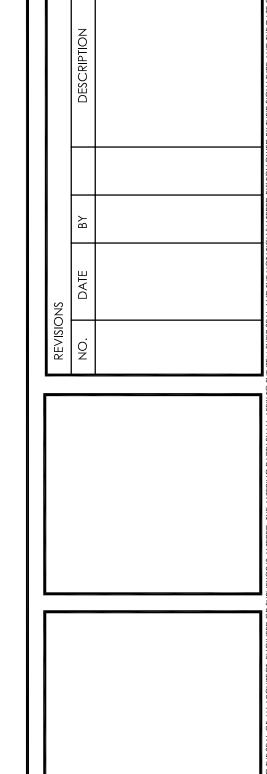TAPPEN ZEE HIGH SCHOOL
OVERAL GROUND
FLOOR CODE PLAN

PROJECT NUMBER 14457.16

> TZHS U01 DRAWING NUMBER



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TAPPEN ZEE HIGH SCHOOL OVERALL FIRST FLOOR CODE PLAN

> PROJECT NUMBER 14457.16

> > TZHS DRAWING NUMBER

GENERAL ABATEMENT NOTES:


- 1. ALL DRAWINGS ARE GRAPHIC REPRESENTATION OF APPROXIMATE LOCATIONS OF EXISTING AND NEW MATERIALS TO BE ABATED. IF THERE ARE ANY DISCREPANCIES WITH WHAT EXISTS TO WHAT IS INDICATED IN THE CONTRACT DOCUMENTS, THE CONTRACTOR SHALL REPORT SAID INTENT OF THIS PROJECT IS TO COMPLETELY REMOVE ASBESTOS CONTAINING MATERIALS INDICATED AND TO PROVIDE A CLEAN, ACM-FREE WORK AREA POST ABATEMENT.
- ALL ABATEMENT PROCEDURES TO BE IN ACCORDANCE WITH STANDARDS SET FORTH BY NEW YORK STATE DEPARTMENT OF LABOR INDUSTRIAL CODE RULE 56 AND ALL APPLICABLE REGULATIONS.
- 3. THE CONTRACTOR SHALL PATCH TO MATCH ANY DISTURBED AREAS AND FINISHES AS A RESULT OF THEIR ABATEMENT WORK, ANY DAMAGE SHALL BE REPAIRED TO THE OWNER'S AND ARCHITECT'S SATISFACTION AT NO ADDITIONAL COST TO THE OWNER.
- 4. THE CONTRACTOR SHALL COORDINATE THE LOCATION OF THE ASBESTOS DUMPSTER WITH THE OWNER.
- 5. THE CONTRACTOR MAY APPLY FOR PROJECT SPECIFIC VARIANCES. USE OF SUCH VARIANCES ARE SUBJECT TO APPROVAL BY THE OWNER AND ARCHITECT.

ABATEMENT LEGEND:

REMOVE VAT FLOOR TILE, MASTIC AND RUBBER WALL BASE, IN ITS ENTIRETY. PREP SUBSTRATE FOR NEW CONSTRUCTION

ABATEMENT KEYNOTES:

- REMOVE ASBESTOS CONTAINING PIPE FITTING INSULATION PER QUANTITY SHOWN.
- REMOVE ASBESTOS CONTAINING PIPE INSULATION <u>PER QUANTITY</u> <u>SHOWN.</u>
- A3 REMOVE EXISTING 4" CMU CHASE WALL IN ITS ENTIRETY.

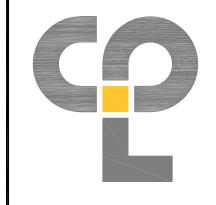

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NO. DATE BY DESCRIPTION

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SCHOOL DISTRICT

APROVEMENT PROJECT 2022

CK RD, BLAUVELT, NY 10913

EMENTARY - SED# 50-03-01-06-0-013-028
SCHOOL - SED# 50-03-01-06-0-003-01

DATE DRAWN CHECK
10/20/22 TLB LT

SCALE AS NOTED

SHEET TITLE

COTTAGE LANE
ELEMENTARY SCHOOL
ABATEMENT FLOOR

ELEMENTARY SCHOO ABATEMENT FLOOR PLAN

PROJECT NUMBER 14457.16


HZ101

DRAWING NUMBER

KEY PLAN
SCALE: N.T.S.

PARTIAL GROUND FLOOR ABATEMENT PLAN - AREA 'A'

SCALE: 1/4" = 1'-0"

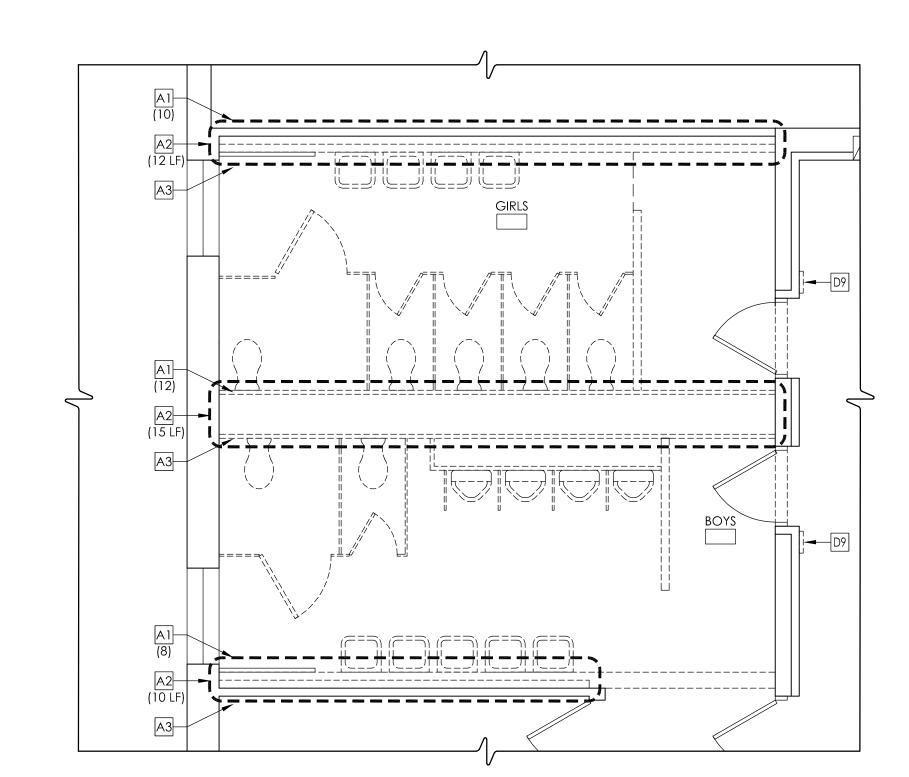

PARTIAL FIRST FLOOR ABATEMENT PLAN - AREA B

SCALE: 1/4" = 1'-0"

GENERAL ABATEMENT NOTES:


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 OWNER AND ARCHITECT.

ABATEMENT LEGEND:


REMOVE VAT FLOOR TILE, MASTIC AND RUBBER WALL BASE, IN ITS ENTIRETY. PREP SUBSTRATE FOR NEW CONSTRUCTION

ABATEMENT KEYNOTES:

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- REMOVE ASBESTOS CONTAINING PIPE INSULATION PER QUANTITY SHOWN.
- A3 REMOVE EXISTING 4" CMU CHASE WALL IN ITS ENTIRETY.

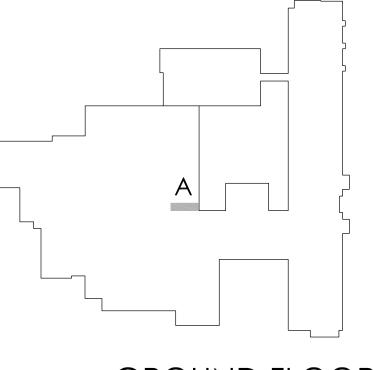



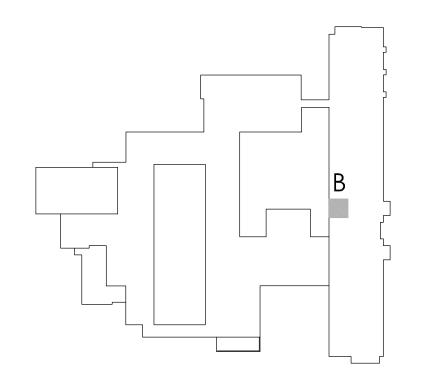


FIRST FLOOR


KEY PLAN

SCALE: N.T.S.



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CENTRAL SCHOOL DISTRICT
CAPITAL IMPROVEMENT PROJECT 2022
160 VAN WYCK RD, BLAUVELT, NY 10913
COTTAGE LANE ELEMENTARY - SED# 50-03-01-06-0-013-028
TAPPEN ZEE HIGH SCHOOL - SED# 50-03-01-06-0-003-028
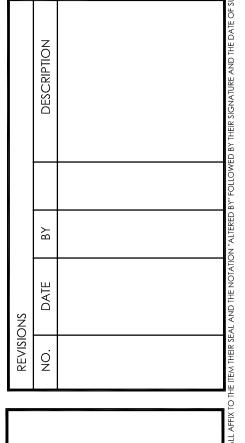
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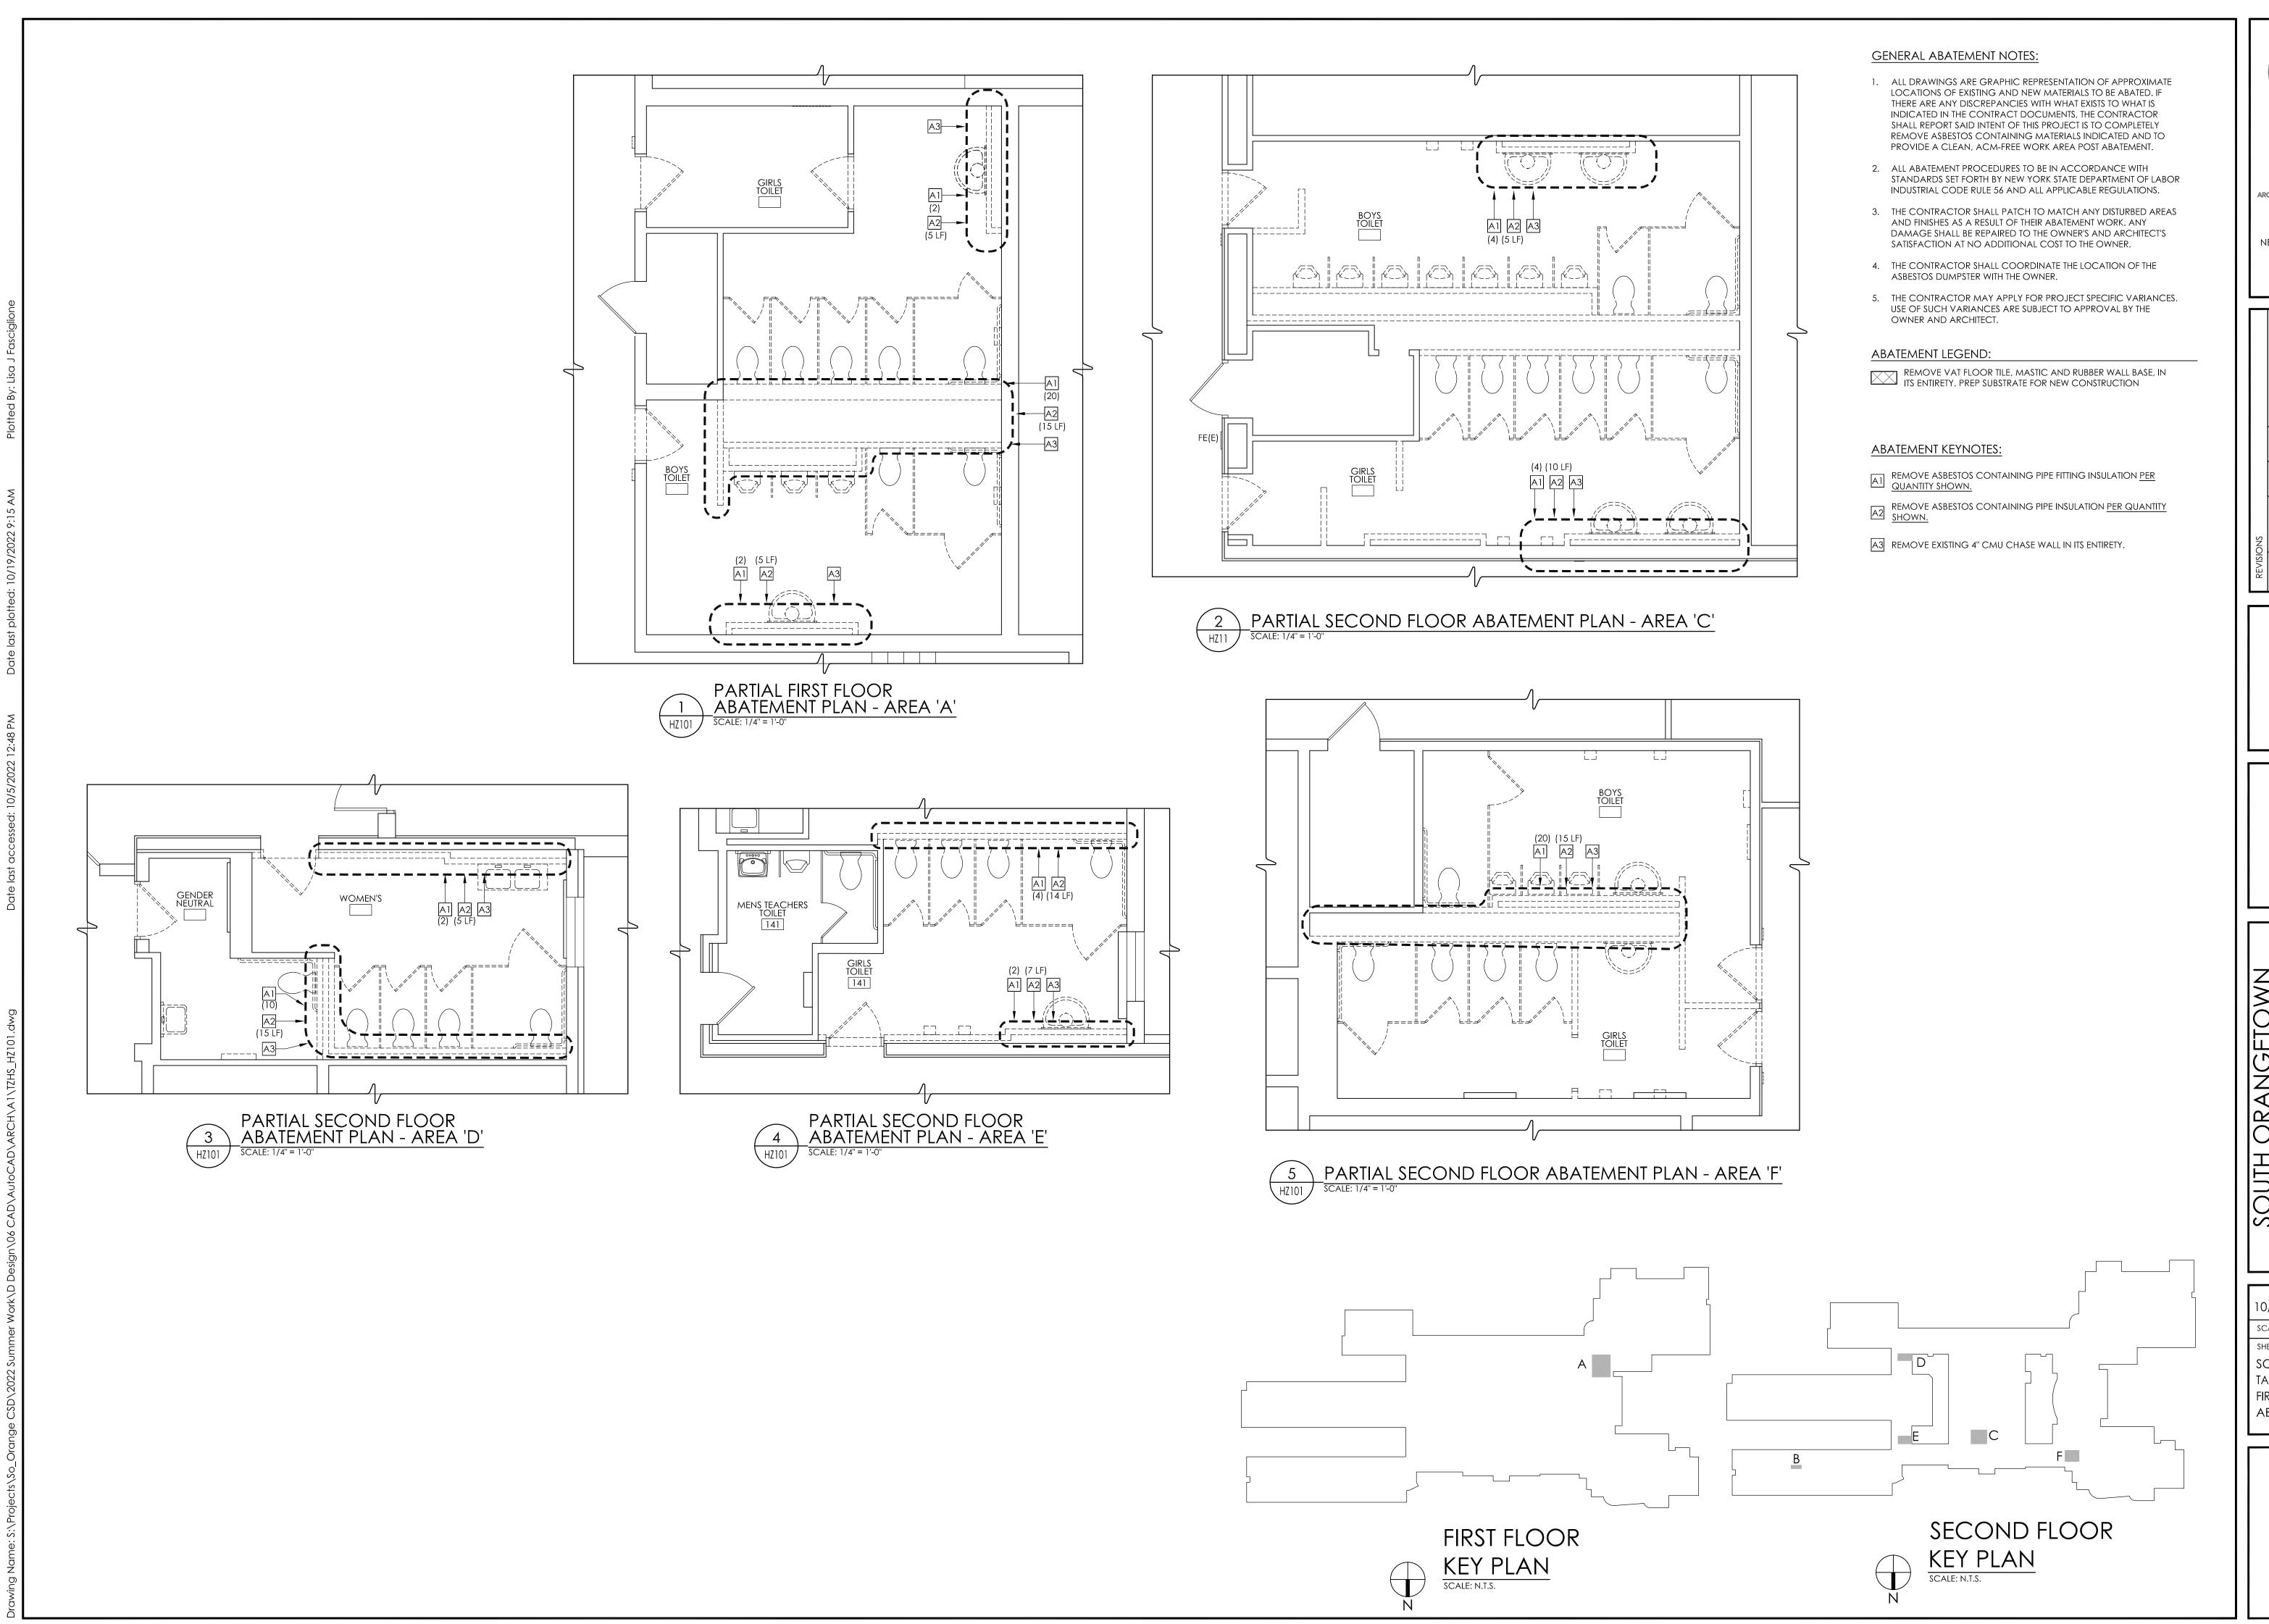
SHEET TITLE

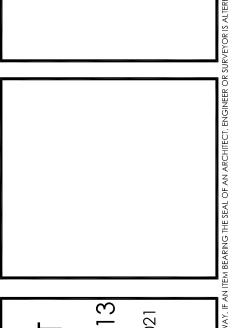SO. ORANGETOWN

SHEET TITLE
SO. ORANGETOWN
MIDDLE SCHOOL
GROUND AND FIRST FLOOR
ABATEMENT PLANS

PROJECT NUMBER 14457.16

SOMS HZ101 DRAWING NUMBER



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CENTRAL SCHOOL DISTRIC1
CAPITAL IMPROVEMENT PROJECT 2022
160 VAN WYCK RD, BLAUVELT, NY 109
COTTAGE LANE ELEMENTARY - SED# 50-03-01-06-0-010-0
S.O. MIDDLE SCHOOL - SED# 50-03-01-06-0-013-028
TAPPEN ZEE HIGH SCHOOL - SED#50-03-01-06-0-006-031

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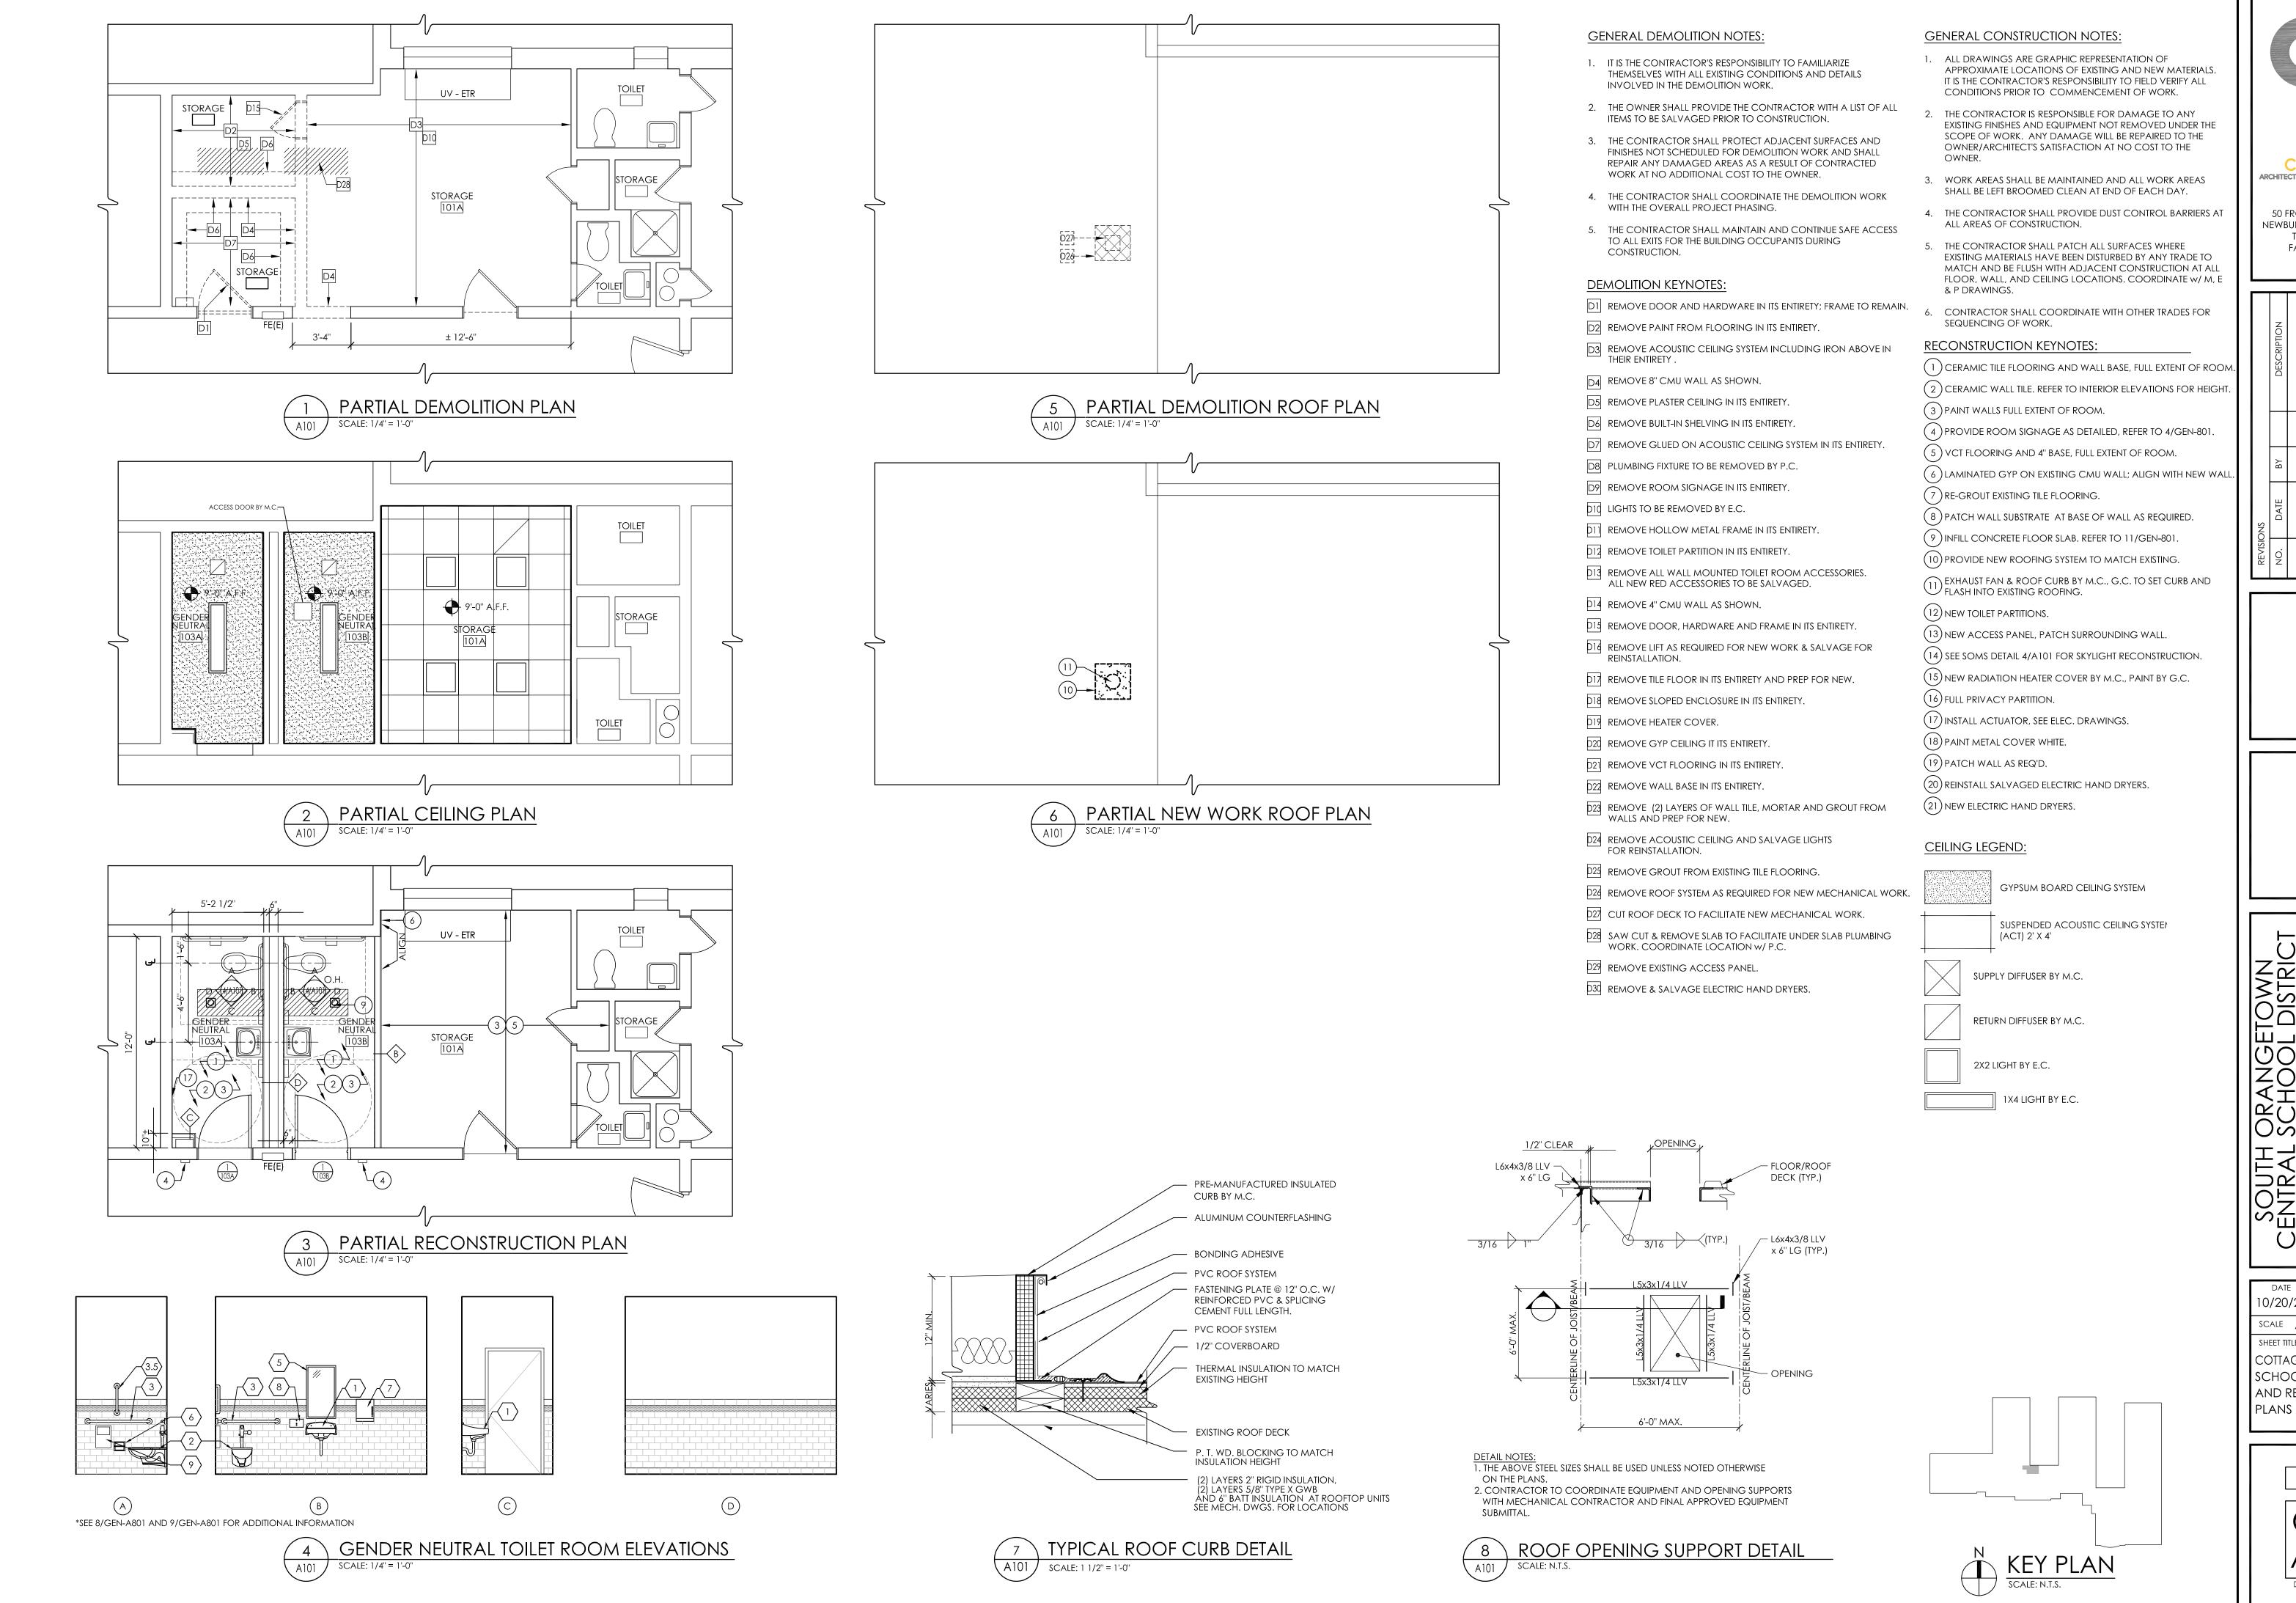
SCALE AS NOTED

SHEET TITLE

SO. ORANGETOWN
TAPPAN ZEE HIGH SCHOOL
FIRST AND SECOND FLOOR
ABATEMENT PLANS

14457.16

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REVISIONS

NO. DATE BY DESCRIPTION

CENTRAL SCHOOL DISTRICOLAND STALL SCHOOL DISTRICOLAND WYCK RD, BLAUVELT, NY 1 S.O. MIDDLE SCHOOL - SED# 50-03-01-06-0-03-01-06-0-03-01-06-0-006-03-01-06-00-006-03-01-06-00-006-03-01-06-00-006-03-01-06-00-006-03-01-06-00-006-03-

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10/20/22 TLB LT


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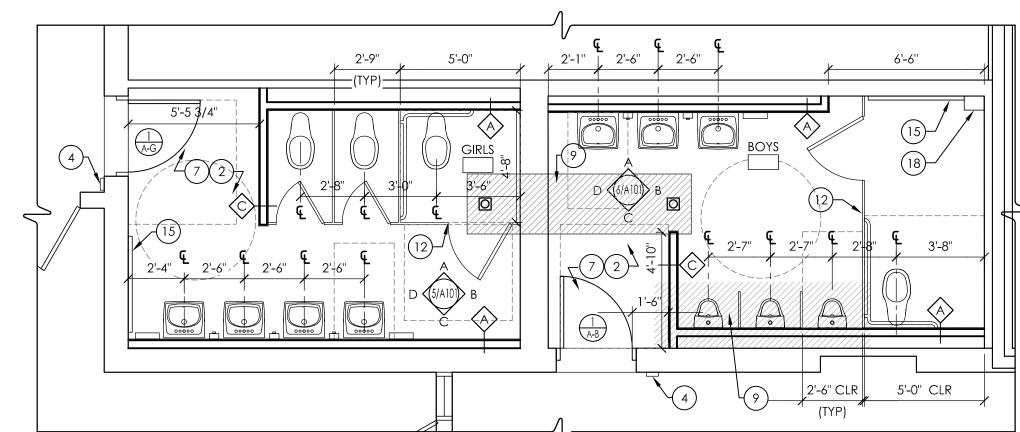
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COTTAGE LANE FLEMENTA

COTTAGE LANE ELEMENTARY
SCHOOL: DEMOLITION
AND RECONSTRUCTION
PLANS AND ELEVATIONS

PROJECT NUMBER

CLES A101 DRAWING NUMBER



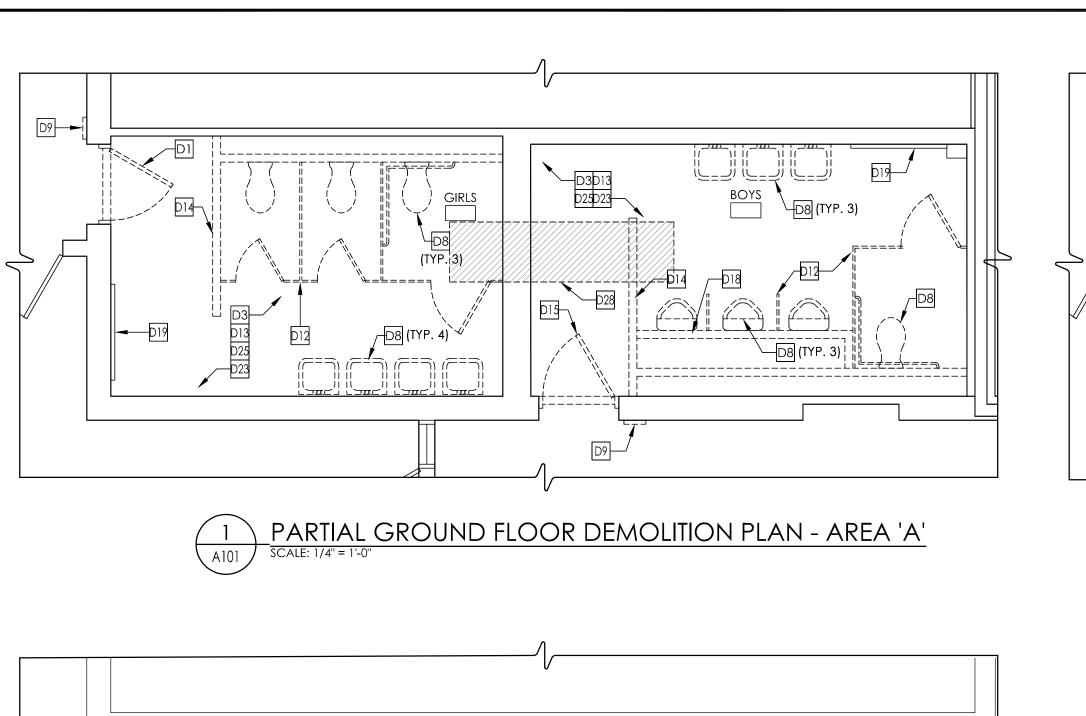

ALTERNATE #GC-1 PARTIAL GROUND FLOOR RECONSTRUCTION PLAN - AREA 'A' SCALE: 1/4" = 1'-0"

EXISTING SKYLIGHT TO —


EXISTING METAL WELL —

LINER TO REMAIN


EXISTING ROOF -


STRUCTURE TO REMAIN


REMAIN

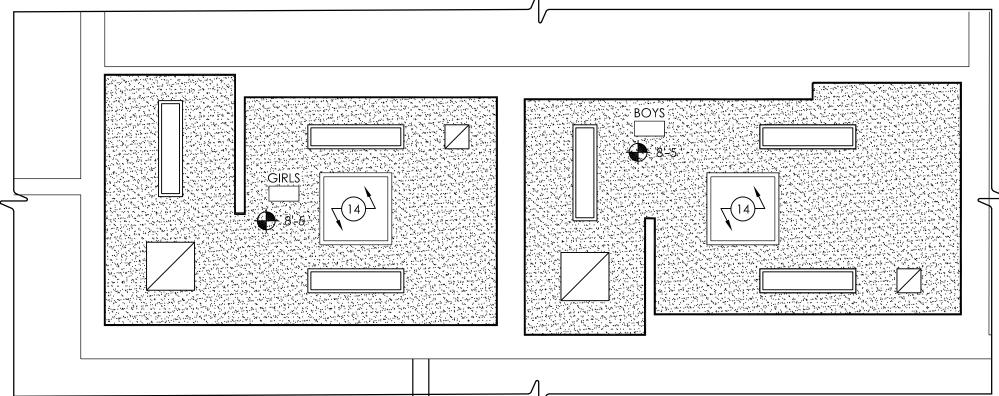




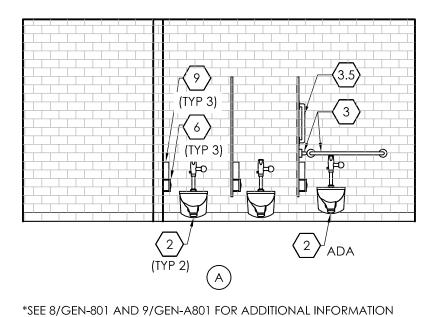

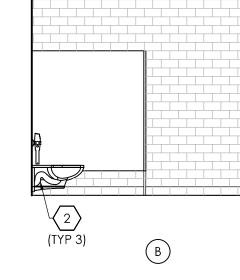

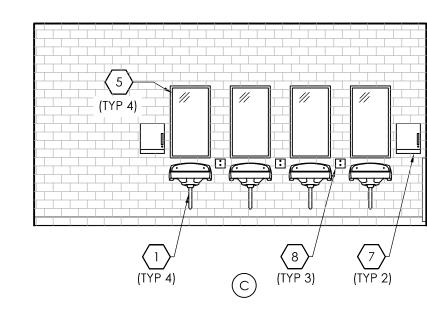

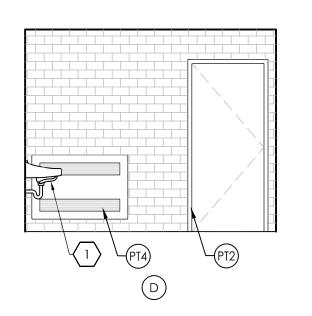



EXISTING WALL -

CONSTRUCTION TO REMAIN

NEW METAL CLIP ANGLE -

NEW TRANSLUCENT PANEL TO BE FLUSH w/ FINISHED CEILING

NEW CEILING SYSTEM AS SPECIFIED



GENERAL DEMOLITION NOTES:

- . IT IS THE CONTRACTOR'S RESPONSIBILITY TO FAMILIARIZE THEMSELVES WITH ALL EXISTING CONDITIONS AND DETAILS INVOLVED IN THE DEMOLITION WORK.
- 2. THE OWNER SHALL PROVIDE THE CONTRACTOR WITH A LIST OF ALL ITEMS TO BE SALVAGED PRIOR TO CONSTRUCTION.
- 3. THE CONTRACTOR SHALL PROTECT ADJACENT SURFACES AND FINISHES NOT SCHEDULED FOR DEMOLITION WORK AND SHALL REPAIR ANY DAMAGED AREAS AS A RESULT OF CONTRACTED WORK AT NO ADDITIONAL COST TO THE OWNER.
- 4. THE CONTRACTOR SHALL COORDINATE THE DEMOLITION WORK WITH THE OVERALL PROJECT PHASING.
- 5. THE CONTRACTOR SHALL MAINTAIN AND CONTINUE SAFE ACCESS TO ALL EXITS FOR THE BUILDING OCCUPANTS DURING CONSTRUCTION.

DEMOLITION KEYNOTES:

- D1 REMOVE DOOR AND HARDWARE IN ITS ENTIRETY; FRAME TO REMAIN.
- D2 REMOVE PAINT FROM FLOORING IN ITS ENTIRETY.
- D3 REMOVE ACOUSTIC CEILING SYSTEM INCLUDING IRON ABOVE IN THEIR ENTIRETY.
- D4 REMOVE 8" CMU WALL AS SHOWN.
- D5 REMOVE PLASTER CEILING IN ITS ENTIRETY.
- D6 REMOVE BUILT-IN SHELVING IN ITS ENTIRETY.
- D7 REMOVE GLUED ON ACOUSTIC CEILING SYSTEM IN ITS ENTIRETY
- D8 PLUMBING FIXTURE TO BE REMOVED BY P.C.
- D9 REMOVE ROOM SIGNAGE IN ITS ENTIRETY.
- DIQ LIGHTS TO BE REMOVED BY E.C.
- PII REMOVE HOLLOW METAL FRAME IN ITS ENTIRETY.
- P12 REMOVE TOILET PARTITION IN ITS ENTIRETY.
- P13 REMOVE ALL WALL MOUNTED TOILET ROOM ACCESSORIES. ALL NEW RED ACCESSORIES TO BE SALVAGED.
- P14 REMOVE 4" CMU WALL AS SHOWN.
- P15 REMOVE DOOR, HARDWARE AND FRAME IN ITS ENTIRETY.
- P10 REMOVE LIFT AS REQUIRED FOR NEW WORK & SALVAGE FOR REINSTALLATION.
- PIT REMOVE TILE FLOOR IN ITS ENTIRETY AND PREP FOR NEW.
- D18 REMOVE SLOPED ENCLOSURE IN ITS ENTIRETY.
- D19 REMOVE HEATER COVER.
- D20 REMOVE GYP CEILING IT ITS ENTIRETY.
- P21 REMOVE VCT FLOORING IN ITS ENTIRETY.
- D22 REMOVE WALL BASE IN ITS ENTIRETY.
- D23 REMOVE (2) LAYERS OF WALL TILE, MORTAR AND GROUT FROM WALLS AND PREP FOR NEW.
- P24 REMOVE ACOUSTIC CEILING AND SALVAGE LIGHTS FOR REINSTALLATION.
- p25 remove grout from existing tile flooring.
- P24 REMOVE ROOF SYSTEM AS REQUIRED FOR NEW MECHANICAL WORK.
- CUT ROOF DECK TO FACILITATE NEW MECHANICAL WORK.
- SAW CUT & REMOVE SLAB TO FACILITATE UNDER SLAB PLUMBING WORK. COORDINATE LOCATION w/ P.C.
- P29 REMOVE EXISTING ACCESS PANEL.
- P30 REMOVE & SALVAGE ELECTRIC HAND DRYERS.

GENERAL CONSTRUCTION NOTES:

OWNER.

- 1. ALL DRAWINGS ARE GRAPHIC REPRESENTATION OF APPROXIMATE LOCATIONS OF EXISTING AND NEW MATERIALS. IT IS THE CONTRACTOR'S RESPONSIBILITY TO FIELD VERIFY ALL CONDITIONS PRIOR TO COMMENCEMENT OF WORK.
- 2. THE CONTRACTOR IS RESPONSIBLE FOR DAMAGE TO ANY EXISTING FINISHES AND EQUIPMENT NOT REMOVED UNDER THE SCOPE OF WORK. ANY DAMAGE WILL BE REPAIRED TO THE OWNER/ARCHITECT'S SATISFACTION AT NO COST TO THE
- 3. WORK AREAS SHALL BE MAINTAINED AND ALL WORK AREAS SHALL BE LEFT BROOMED CLEAN AT END OF EACH DAY.
- 4. THE CONTRACTOR SHALL PROVIDE DUST CONTROL BARRIERS AT ALL AREAS OF CONSTRUCTION.
- 5. THE CONTRACTOR SHALL PATCH ALL SURFACES WHERE EXISTING MATERIALS HAVE BEEN DISTURBED BY ANY TRADE TO MATCH AND BE FLUSH WITH ADJACENT CONSTRUCTION AT ALL FLOOR, WALL, AND CEILING LOCATIONS. COORDINATE W/M, E & P DRAWINGS.
- 6. CONTRACTOR SHALL COORDINATE WITH OTHER TRADES FOR SEQUENCING OF WORK.

RECONSTRUCTION KEYNOTES:

 $\left(\
ight)$ CERAMIC TILE FLOORING AND WALL BASE, FULL EXTENT OF ROOM

 $(\; 2\;)$ CERAMIC WALL TILE. REFER TO INTERIOR ELEVATIONS FOR HEIGHT.

- (3) PAINT WALLS FULL EXTENT OF ROOM.
- $(\ 4\)$ Provide room signage as detailed, refer to 4/Gen-801.
- $(\ 5\)$ VCT FLOORING AND 4" BASE, FULL EXTENT OF ROOM.
- $(\ 6\)$ LAMINATED GYP ON EXISTING CMU WALL; ALIGN WITH NEW WALL
- (7) RE-GROUT EXISTING TILE FLOORING.
- (8) PATCH WALL SUBSTRATE AT BASE OF WALL AS REQUIRED.
- (9) INFILL CONCRETE FLOOR SLAB. REFER TO 11/GEN-801.

(10) PROVIDE NEW ROOFING SYSTEM TO MATCH EXISTING.

- EXHAUST FAN & ROOF CURB BY M.C., G.C. TO SET CURB AND FLASH INTO EXISTING ROOFING.

(12) NEW TOILET PARTITIONS.

- (13) NEW ACCESS PANEL, PATCH SURROUNDING WALL.
- (14) SEE SOMS DETAIL 4/A101 FOR SKYLIGHT RECONSTRUCTION.
- (15) NEW RADIATION HEATER COVER BY M.C., PAINT BY G.C.
- (16) FULL PRIVACY PARTITION.
- (17) INSTALL ACTUATOR, SEE ELEC. DRAWINGS.
- (18) PAINT METAL COVER WHITE.
- (19) PATCH WALL AS REQ'D.
- (20) REINSTALL SALVAGED ELECTRIC HAND DRYERS. (21) NEW ELECTRIC HAND DRYERS.

CEILING LEGEND:

GYPSUM BOARD CEILING SYSTEM

SUSPENDED ACOUSTIC CEILING SYSTE!


GROUND FLOOR KEY PLAN

SCALE: N.T.S.

(ACT) 2' X 4'

SUPPLY DIFFUSER BY M.C. RETURN DIFFUSER BY M.C.

1X4 LIGHT BY E.C.

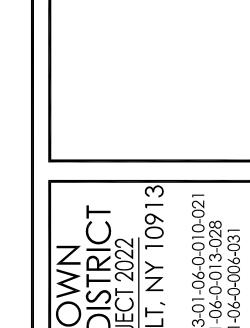

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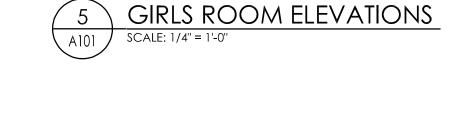
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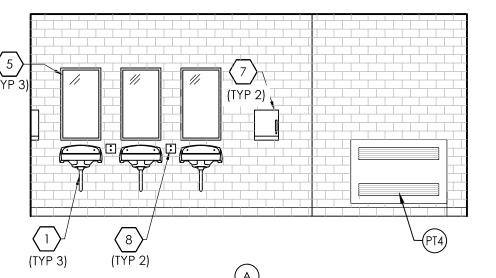
TLB 10/20/22 SCALE AS NOTED

SO. ORANGETOWN M.S GROUND FLOOR DEMOLITION AND RECONSTRUCTION PLANS AND ELEVATIONS


> PROJECT NUMBER 14457.16


SOMS A101 DRAWING NUMBER







*SEE 8/GEN-A801 AND 9/GEN-A801 FOR ADDITIONAL INFORMATION

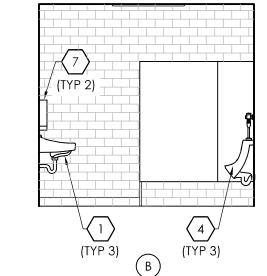

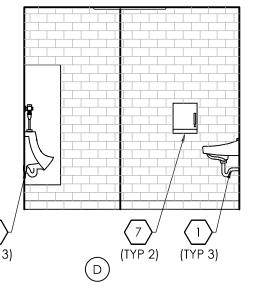


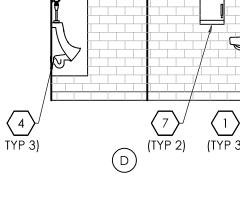





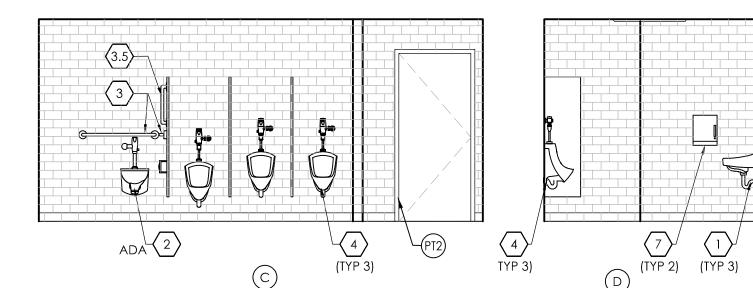




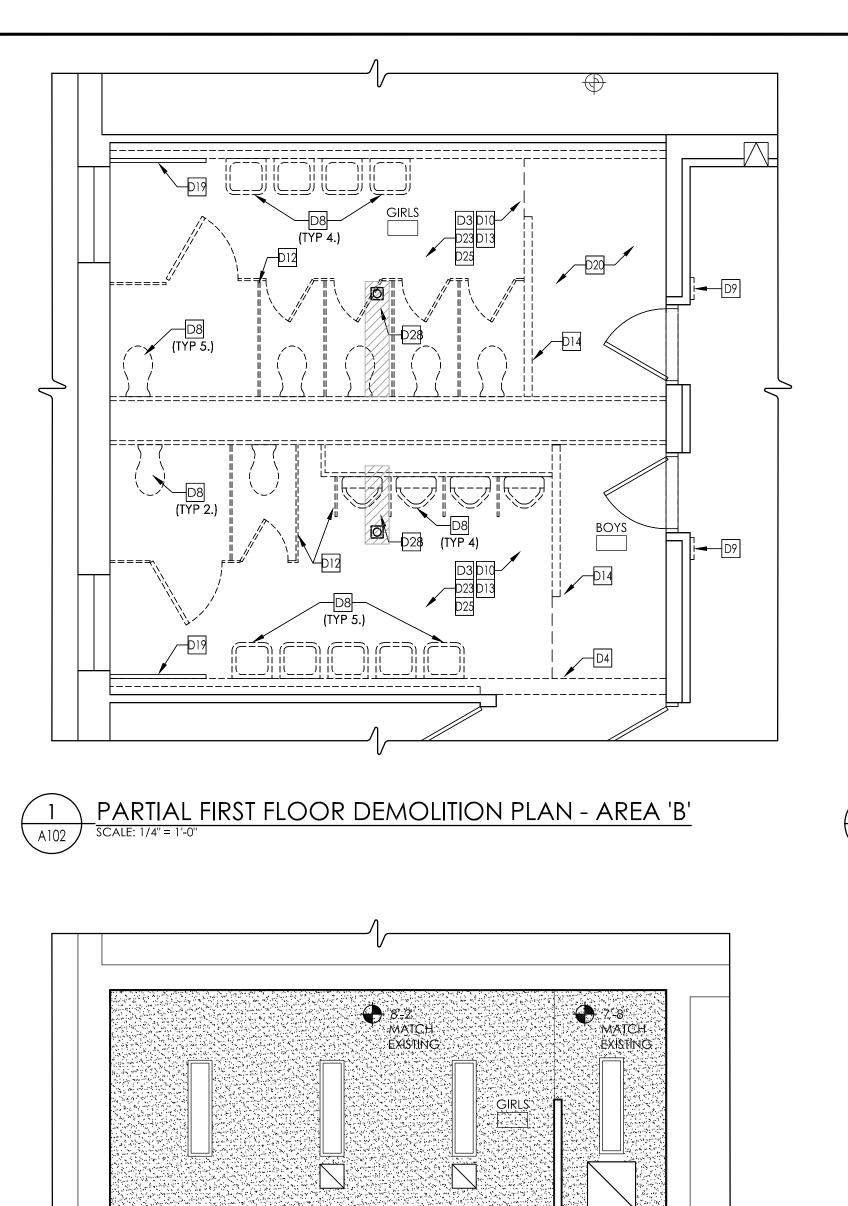


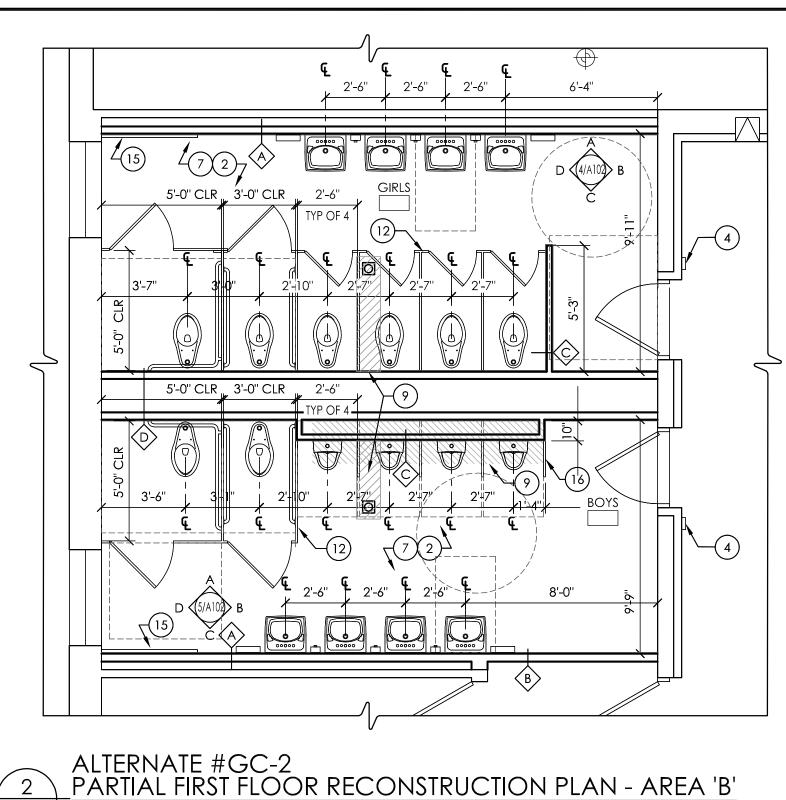


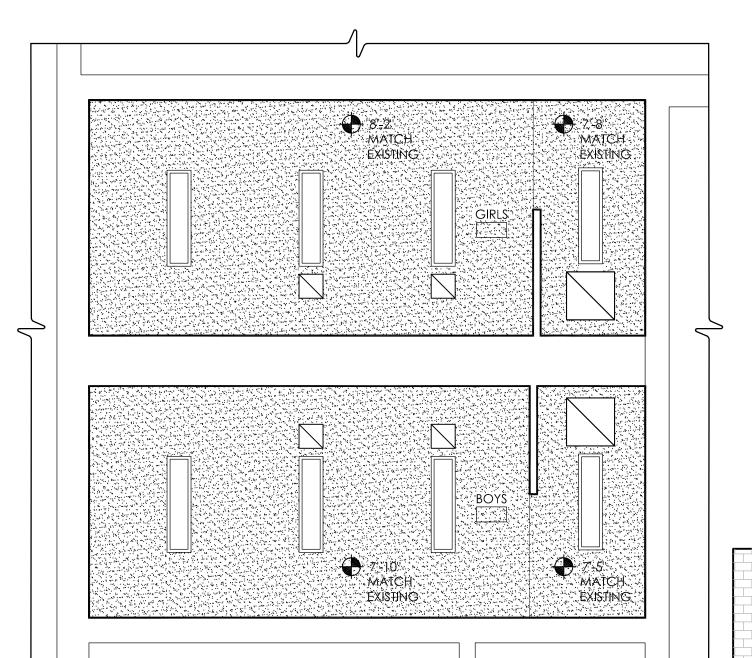


PARTIAL FIRST FLOOR CEILING PLAN - AREA 'B'

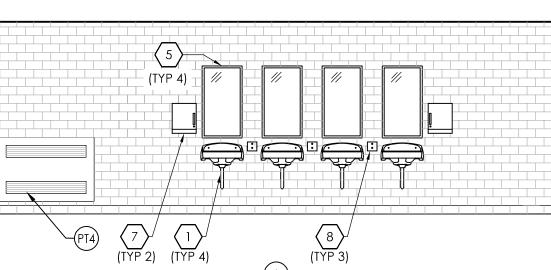

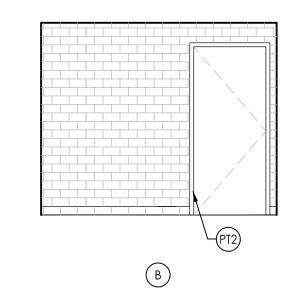

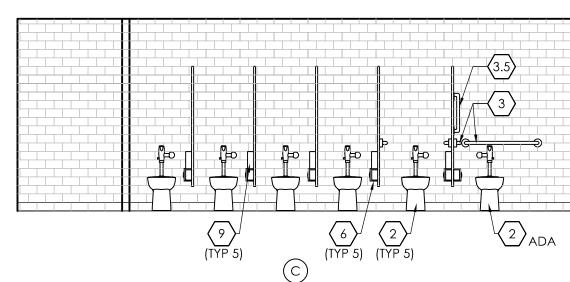

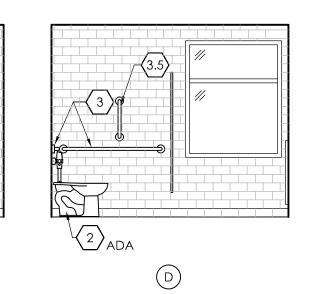

GENERAL DEMOLITION NOTES:

- 1. IT IS THE CONTRACTOR'S RESPONSIBILITY TO FAMILIARIZE THEMSELVES WITH ALL EXISTING CONDITIONS AND DETAILS INVOLVED IN THE DEMOLITION WORK.
- 2. THE OWNER SHALL PROVIDE THE CONTRACTOR WITH A LIST OF ALL ITEMS TO BE SALVAGED PRIOR TO CONSTRUCTION.
- 3. THE CONTRACTOR SHALL PROTECT ADJACENT SURFACES AND FINISHES NOT SCHEDULED FOR DEMOLITION WORK AND SHALL REPAIR ANY DAMAGED AREAS AS A RESULT OF CONTRACTED WORK AT NO ADDITIONAL COST TO THE OWNER.
- 4. THE CONTRACTOR SHALL COORDINATE THE DEMOLITION WORK WITH THE OVERALL PROJECT PHASING.
- 5. THE CONTRACTOR SHALL MAINTAIN AND CONTINUE SAFE ACCESS TO ALL EXITS FOR THE BUILDING OCCUPANTS DURING CONSTRUCTION.

DEMOLITION KEYNOTES:

- D1 REMOVE DOOR AND HARDWARE IN ITS ENTIRETY; FRAME TO REMAIN.
- D2 REMOVE PAINT FROM FLOORING IN ITS ENTIRETY.
- D3 REMOVE ACOUSTIC CEILING SYSTEM INCLUDING IRON ABOVE IN THEIR ENTIRETY.
- D4 REMOVE 8" CMU WALL AS SHOWN.
- D5 REMOVE PLASTER CEILING IN ITS ENTIRETY.
- D6 REMOVE BUILT-IN SHELVING IN ITS ENTIRETY.
- D7 REMOVE GLUED ON ACOUSTIC CEILING SYSTEM IN ITS ENTIRETY.
- D8 PLUMBING FIXTURE TO BE REMOVED BY P.C.
- D9 REMOVE ROOM SIGNAGE IN ITS ENTIRETY.
- DIQ LIGHTS TO BE REMOVED BY E.C.
- P11 REMOVE HOLLOW METAL FRAME IN ITS ENTIRETY.
- P12 REMOVE TOILET PARTITION IN ITS ENTIRETY.
- P13 REMOVE ALL WALL MOUNTED TOILET ROOM ACCESSORIES. ALL NEW RED ACCESSORIES TO BE SALVAGED.
- P14 REMOVE 4" CMU WALL AS SHOWN.
- P15 REMOVE DOOR, HARDWARE AND FRAME IN ITS ENTIRETY.
- P10 REMOVE LIFT AS REQUIRED FOR NEW WORK & SALVAGE FOR REINSTALLATION.
- PIT REMOVE TILE FLOOR IN ITS ENTIRETY AND PREP FOR NEW.
- p18 remove sloped enclosure in its entirety.
- D19 REMOVE HEATER COVER.
- D20 REMOVE GYP CEILING IT ITS ENTIRETY.
- D21 REMOVE VCT FLOORING IN ITS ENTIRETY.
- D22 REMOVE WALL BASE IN ITS ENTIRETY.
- D23 REMOVE (2) LAYERS OF WALL TILE, MORTAR AND GROUT FROM WALLS AND PREP FOR NEW.
- P24 REMOVE ACOUSTIC CEILING AND SALVAGE LIGHTS FOR REINSTALLATION.
- P25 REMOVE GROUT FROM EXISTING TILE FLOORING.
- P26 REMOVE ROOF SYSTEM AS REQUIRED FOR NEW MECHANICAL WORK.
- CUT ROOF DECK TO FACILITATE NEW MECHANICAL WORK.
- SAW CUT & REMOVE SLAB TO FACILITATE UNDER SLAB PLUMBING WORK. COORDINATE LOCATION w/ P.C.
- P29 REMOVE EXISTING ACCESS PANEL.
- p3q remove & salvage electric hand dryers.

GENERAL CONSTRUCTION NOTES:

OWNER.

- 1. ALL DRAWINGS ARE GRAPHIC REPRESENTATION OF APPROXIMATE LOCATIONS OF EXISTING AND NEW MATERIALS. IT IS THE CONTRACTOR'S RESPONSIBILITY TO FIELD VERIFY ALL CONDITIONS PRIOR TO COMMENCEMENT OF WORK.
- 2. THE CONTRACTOR IS RESPONSIBLE FOR DAMAGE TO ANY EXISTING FINISHES AND EQUIPMENT NOT REMOVED UNDER THE SCOPE OF WORK. ANY DAMAGE WILL BE REPAIRED TO THE OWNER/ARCHITECT'S SATISFACTION AT NO COST TO THE
- 3. WORK AREAS SHALL BE MAINTAINED AND ALL WORK AREAS SHALL BE LEFT BROOMED CLEAN AT END OF EACH DAY.
- 4. THE CONTRACTOR SHALL PROVIDE DUST CONTROL BARRIERS AT ALL AREAS OF CONSTRUCTION.
- 5. THE CONTRACTOR SHALL PATCH ALL SURFACES WHERE EXISTING MATERIALS HAVE BEEN DISTURBED BY ANY TRADE TO MATCH AND BE FLUSH WITH ADJACENT CONSTRUCTION AT ALL FLOOR, WALL, AND CEILING LOCATIONS. COORDINATE W/M, E & P DRAWINGS.
- 6. CONTRACTOR SHALL COORDINATE WITH OTHER TRADES FOR SEQUENCING OF WORK.

RECONSTRUCTION KEYNOTES:

- $(\ 1\)$ Ceramic tile flooring and wall base, full extent of room
- $(\; 2\;)$ CERAMIC WALL TILE. REFER TO INTERIOR ELEVATIONS FOR HEIGHT.
- (3) PAINT WALLS FULL EXTENT OF ROOM.
- $\left(egin{array}{c} 4 \end{array}
 ight)$ PROVIDE ROOM SIGNAGE AS DETAILED, REFER TO 4/GEN-801.
- $(\ 5\)$ VCT FLOORING AND 4" BASE, FULL EXTENT OF ROOM.
- $(\ 6\)$ LAMINATED GYP ON EXISTING CMU WALL; ALIGN WITH NEW WALL
- 7) RE-GROUT EXISTING TILE FLOORING.
- (8) PATCH WALL SUBSTRATE AT BASE OF WALL AS REQUIRED.
- (9) INFILL CONCRETE FLOOR SLAB. REFER TO 11/GEN-801.

(10) PROVIDE NEW ROOFING SYSTEM TO MATCH EXISTING.

- EXHAUST FAN & ROOF CURB BY M.C., G.C. TO SET CURB AND FLASH INTO EXISTING ROOFING.
- (12) NEW TOILET PARTITIONS.
- (13) NEW ACCESS PANEL, PATCH SURROUNDING WALL.
- (14) SEE SOMS DETAIL 4/A101 FOR SKYLIGHT RECONSTRUCTION.
- (15) NEW RADIATION HEATER COVER BY M.C., PAINT BY G.C.
- (16) FULL PRIVACY PARTITION.
- (17) INSTALL ACTUATOR, SEE ELEC. DRAWINGS.
- (18) PAINT METAL COVER WHITE.
- (19) PATCH WALL AS REQ'D.
- (20) REINSTALL SALVAGED ELECTRIC HAND DRYERS.
- (21) NEW ELECTRIC HAND DRYERS.

CEILING LEGEND:

- GYPSUM BOARD CEILING SYSTEM
 - SUSPENDED ACOUSTIC CEILING SYSTEM (ACT) 2' X 4'
- SUPPLY DIFFUSER BY M.C.
- RETURN DIFFUSER BY M.C.
 - 1X4 LIGHT BY E.C.

FIRST FLOOR KEY PLAN

SCALE: N.T.S.

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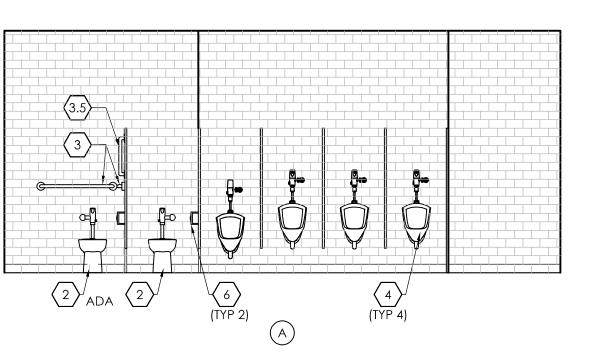
TLB 10/20/22 SCALE AS NOTED


SO. ORANGETOWN M.S FIRST FLOOR DEMOLITION AND RECONSTRUCTION PLANS AND ELEVATIONS


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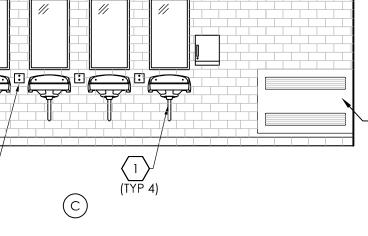
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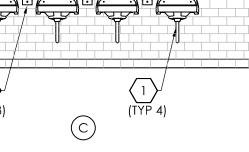
GIRLS ROOM ELEVATIONS









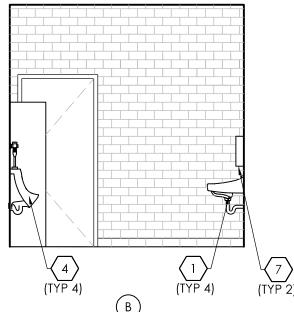


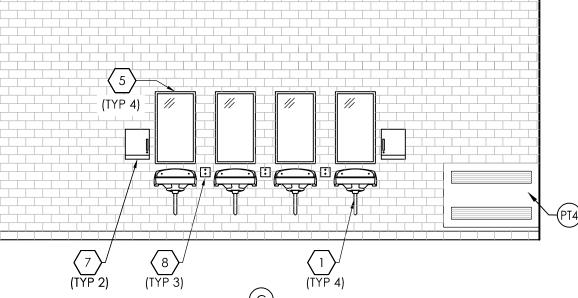




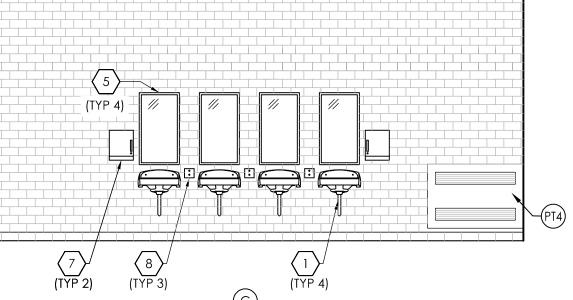

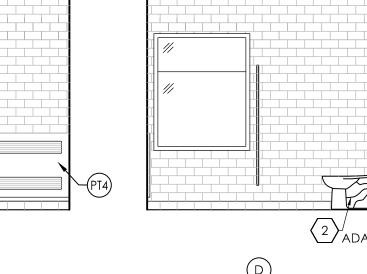

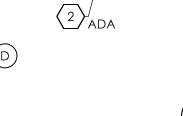

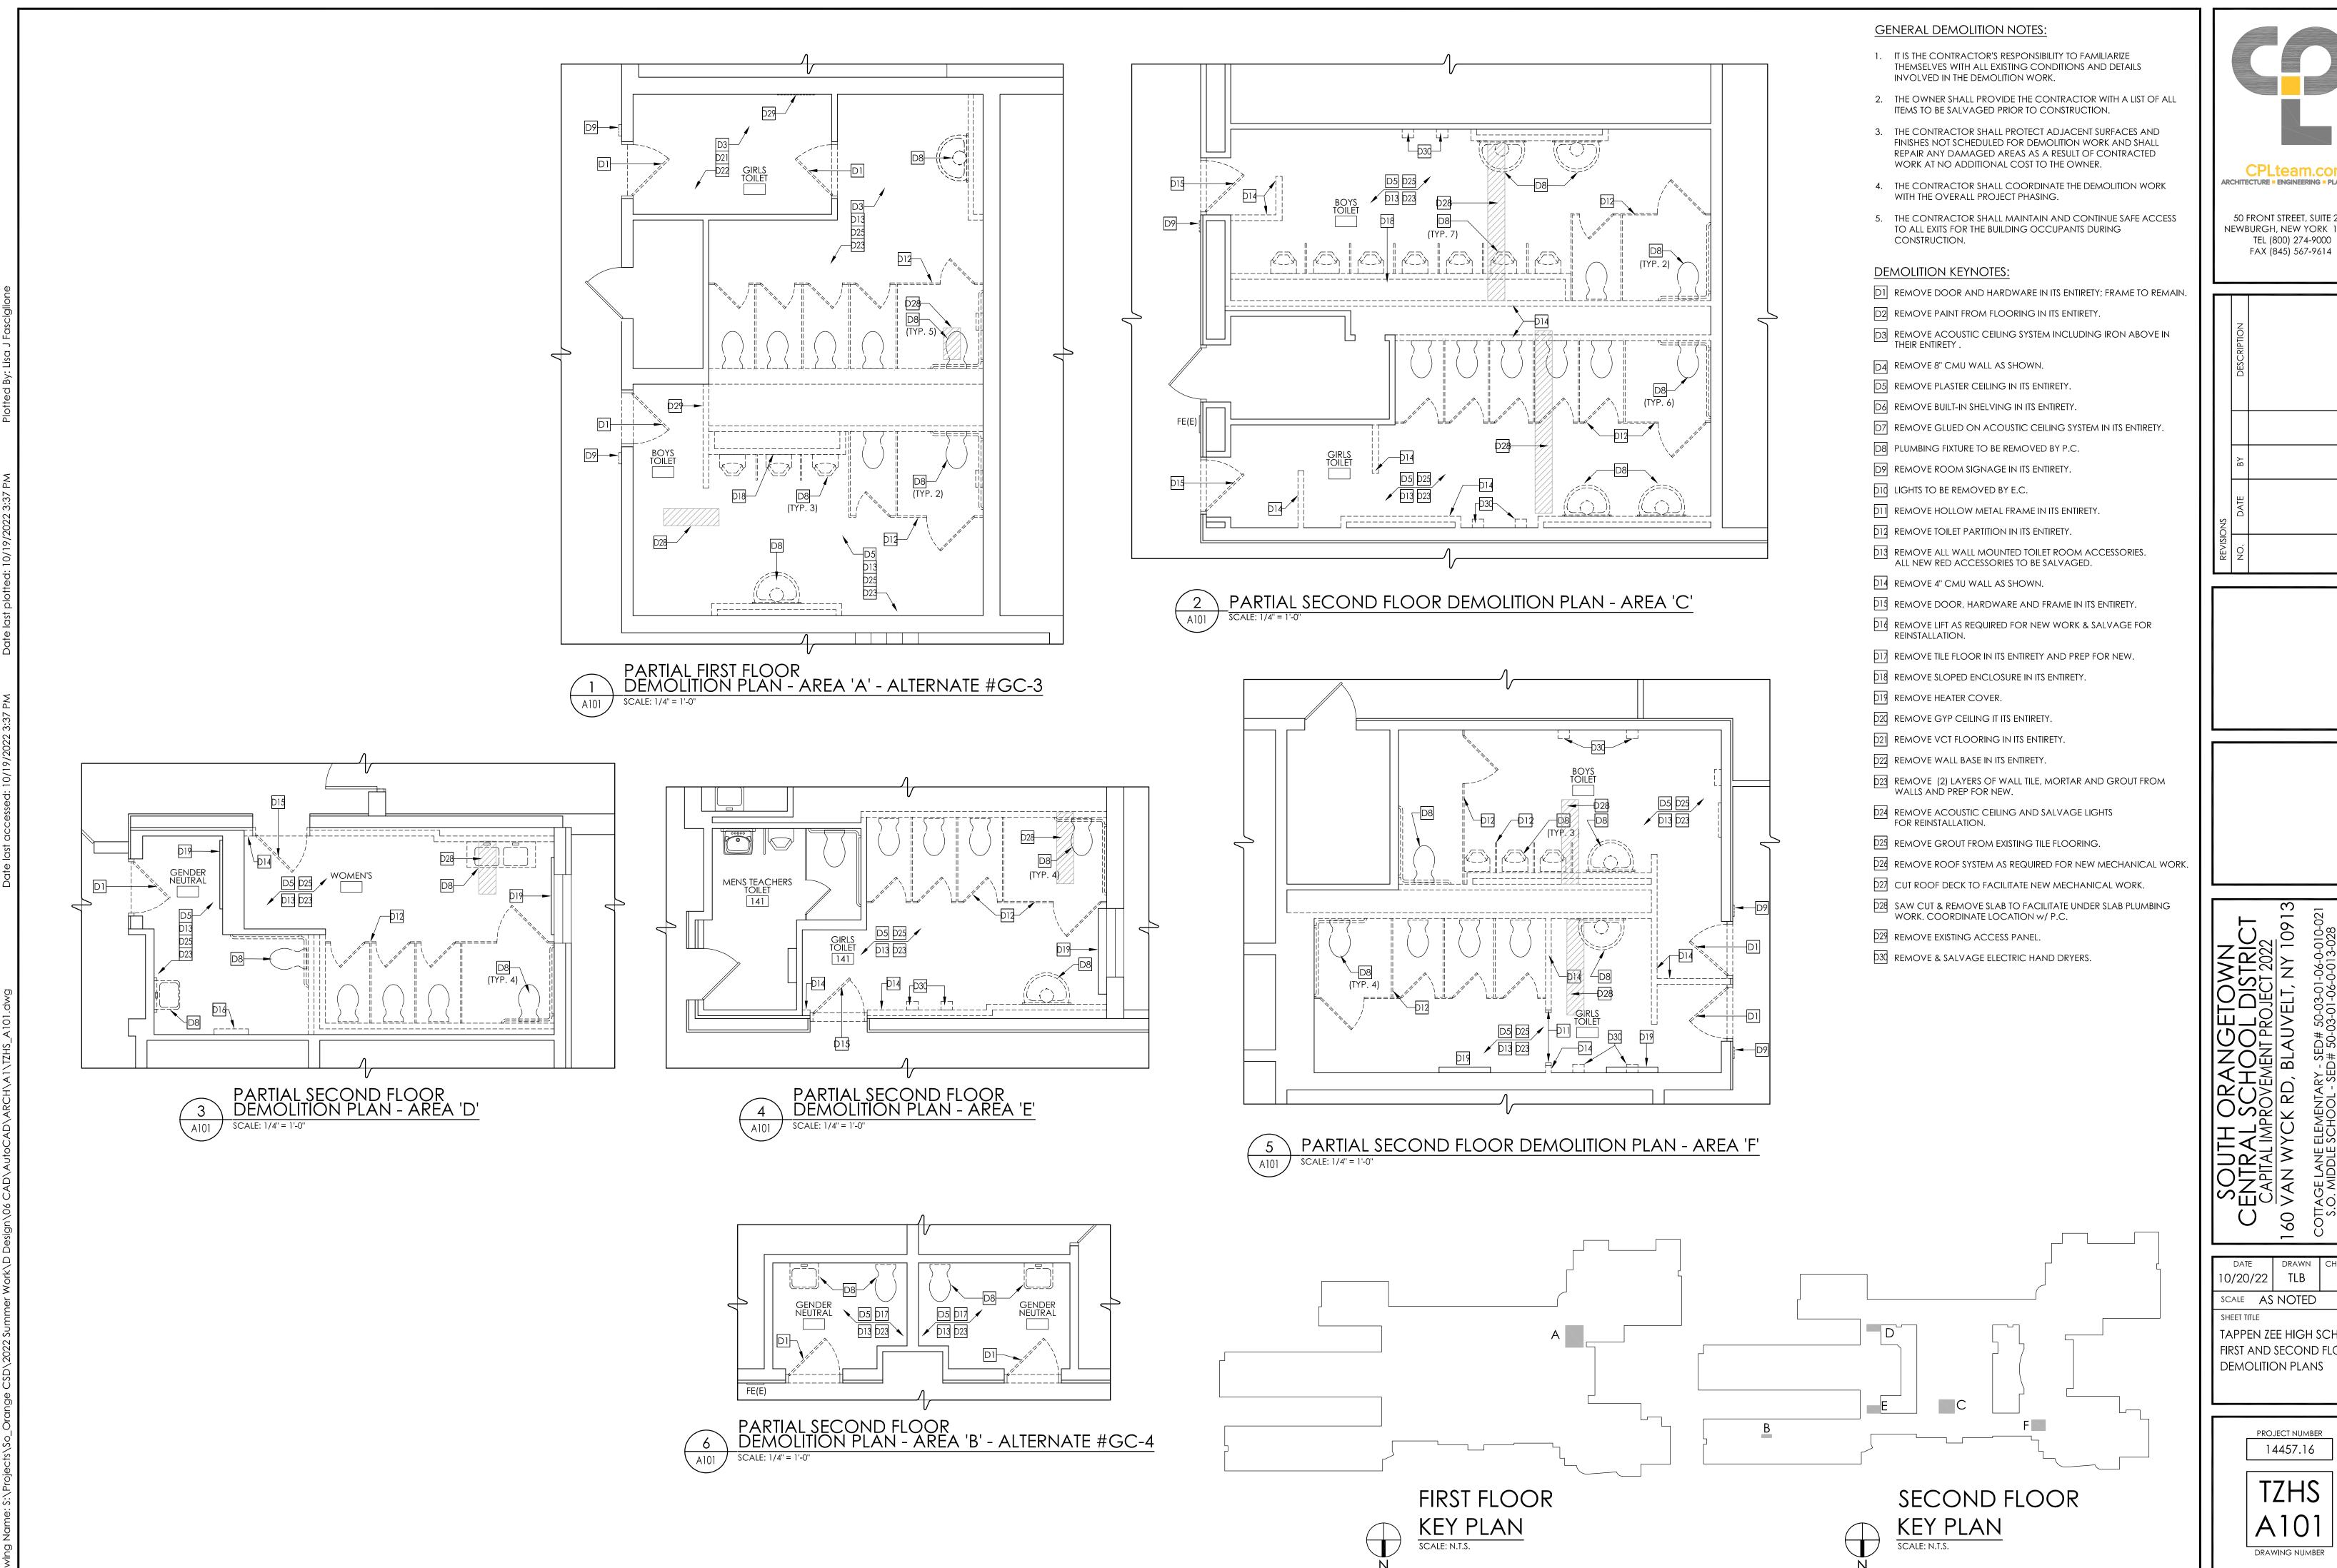


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TLB 10/20/22 SCALE AS NOTED

TAPPEN ZEE HIGH SCHOOL FIRST AND SECOND FLOOR DEMOLITION PLANS

> PROJECT NUMBER 14457.16

TZHS A101 DRAWING NUMBER

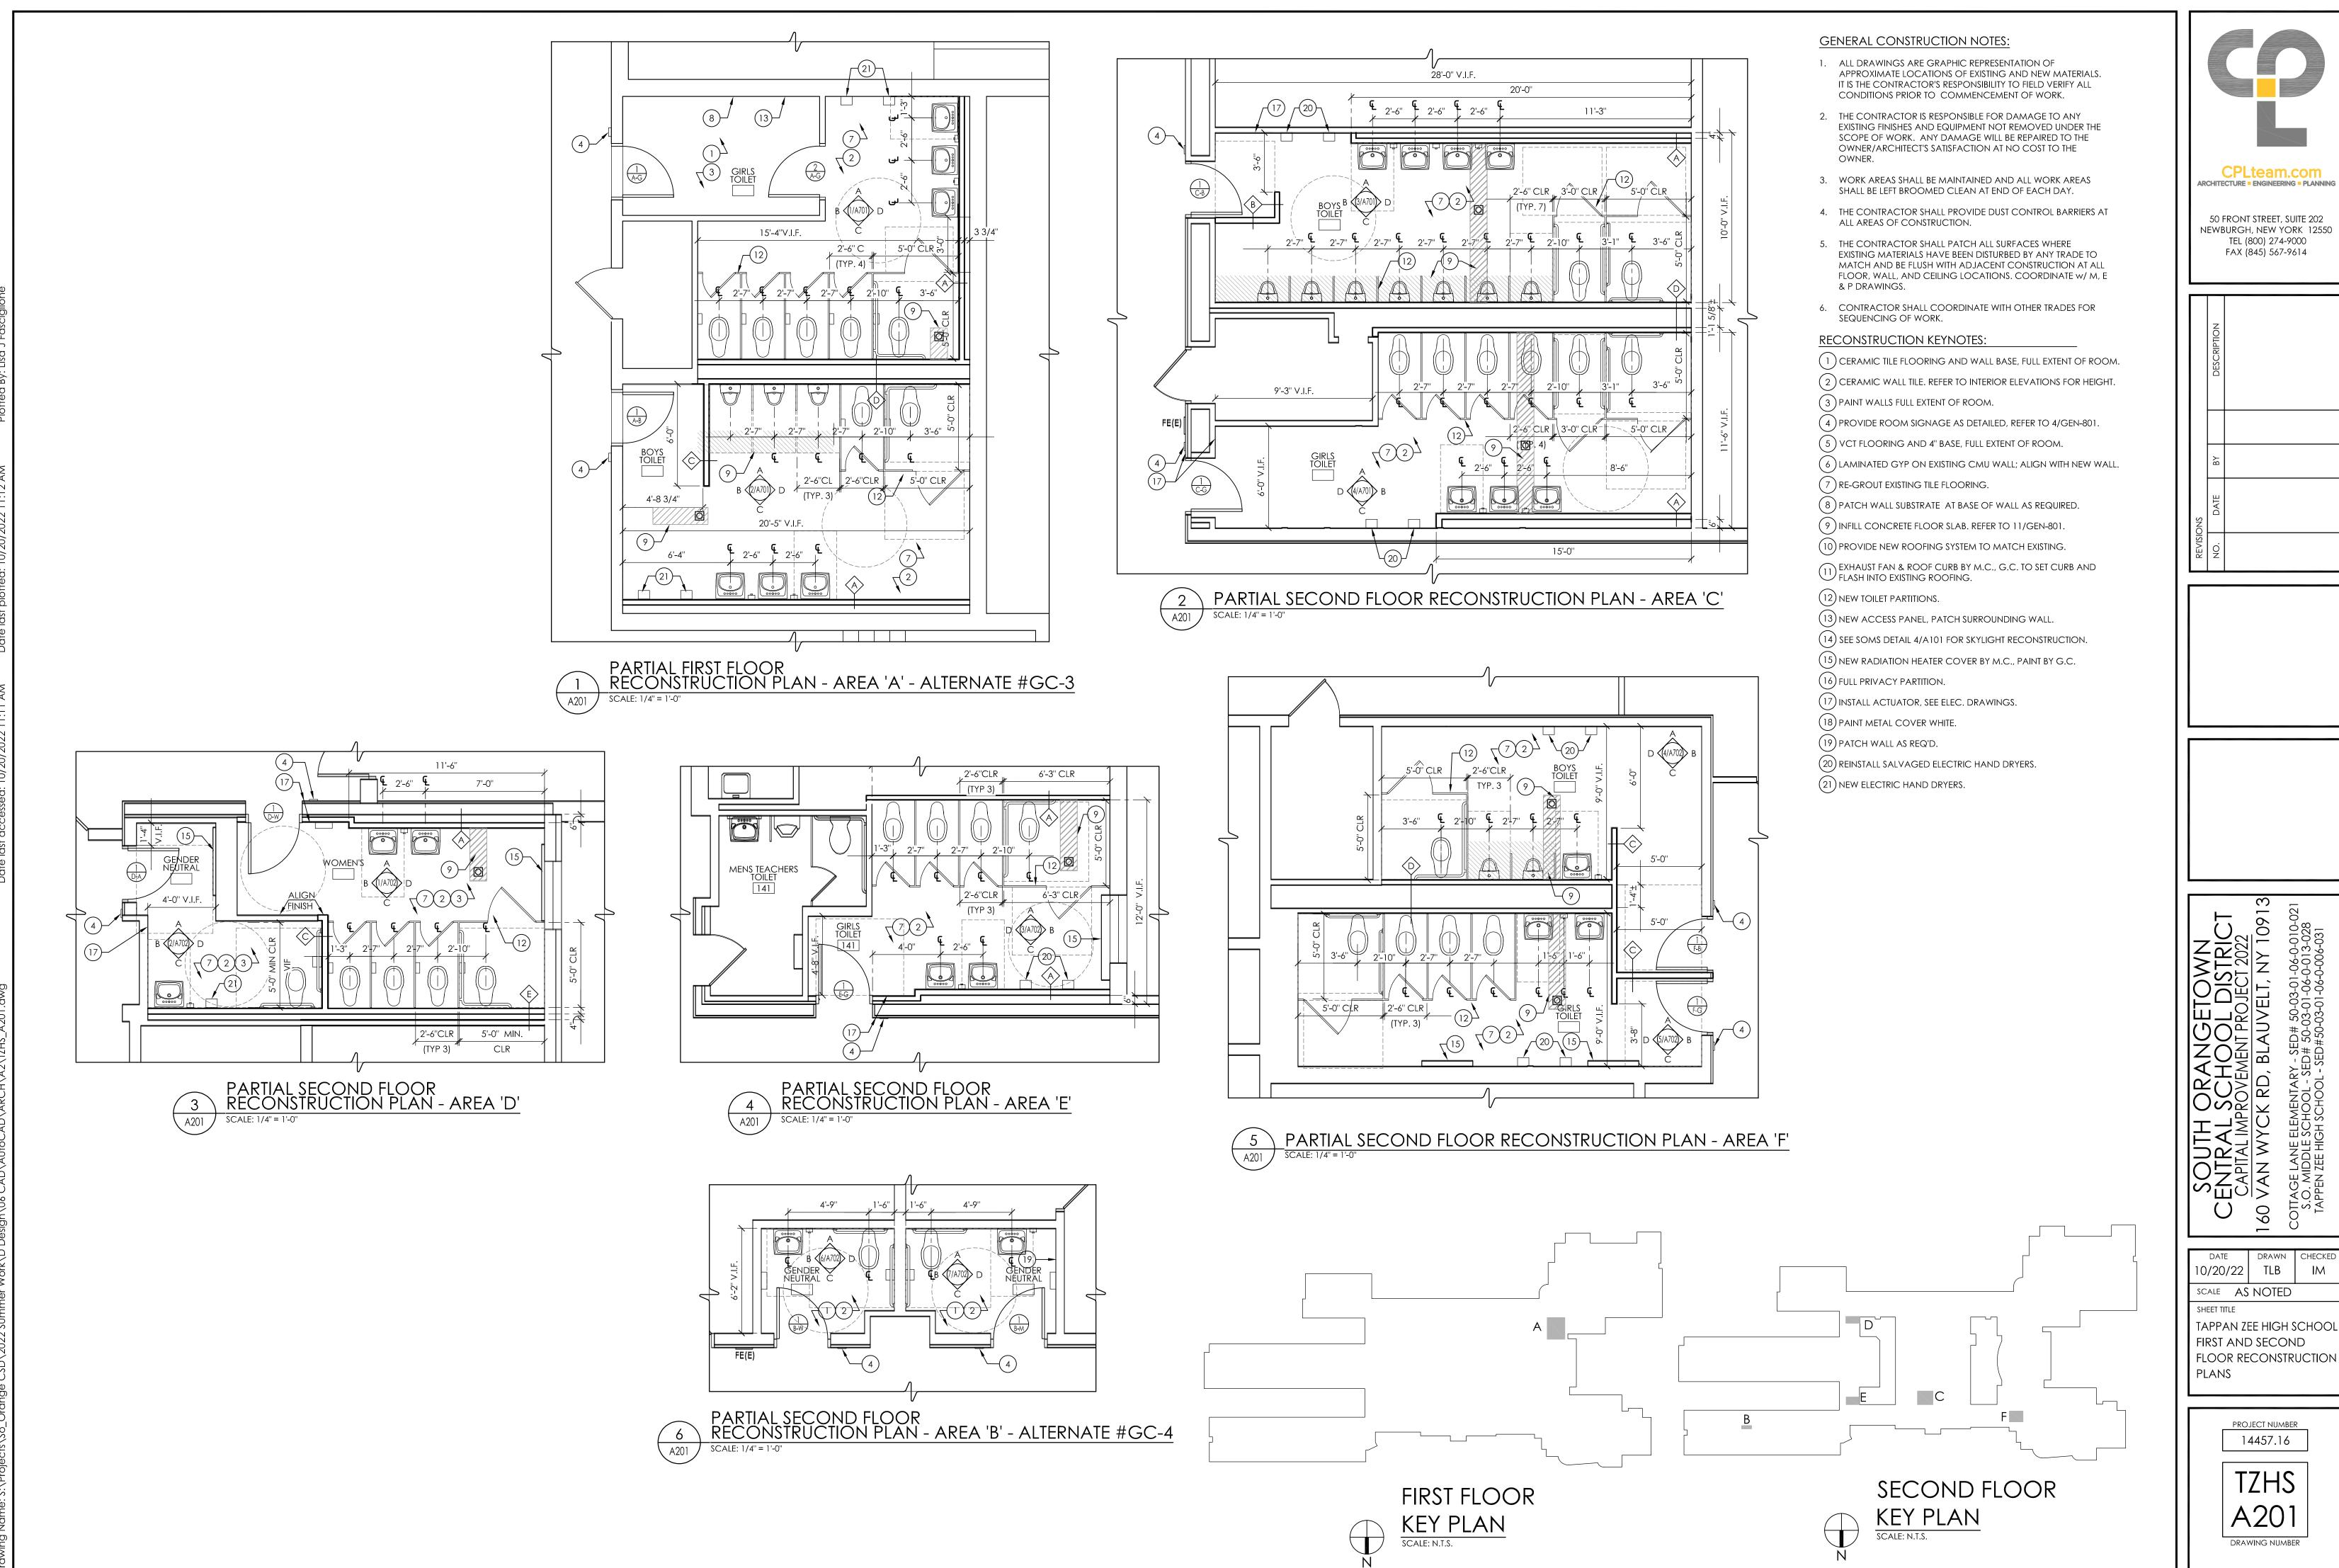

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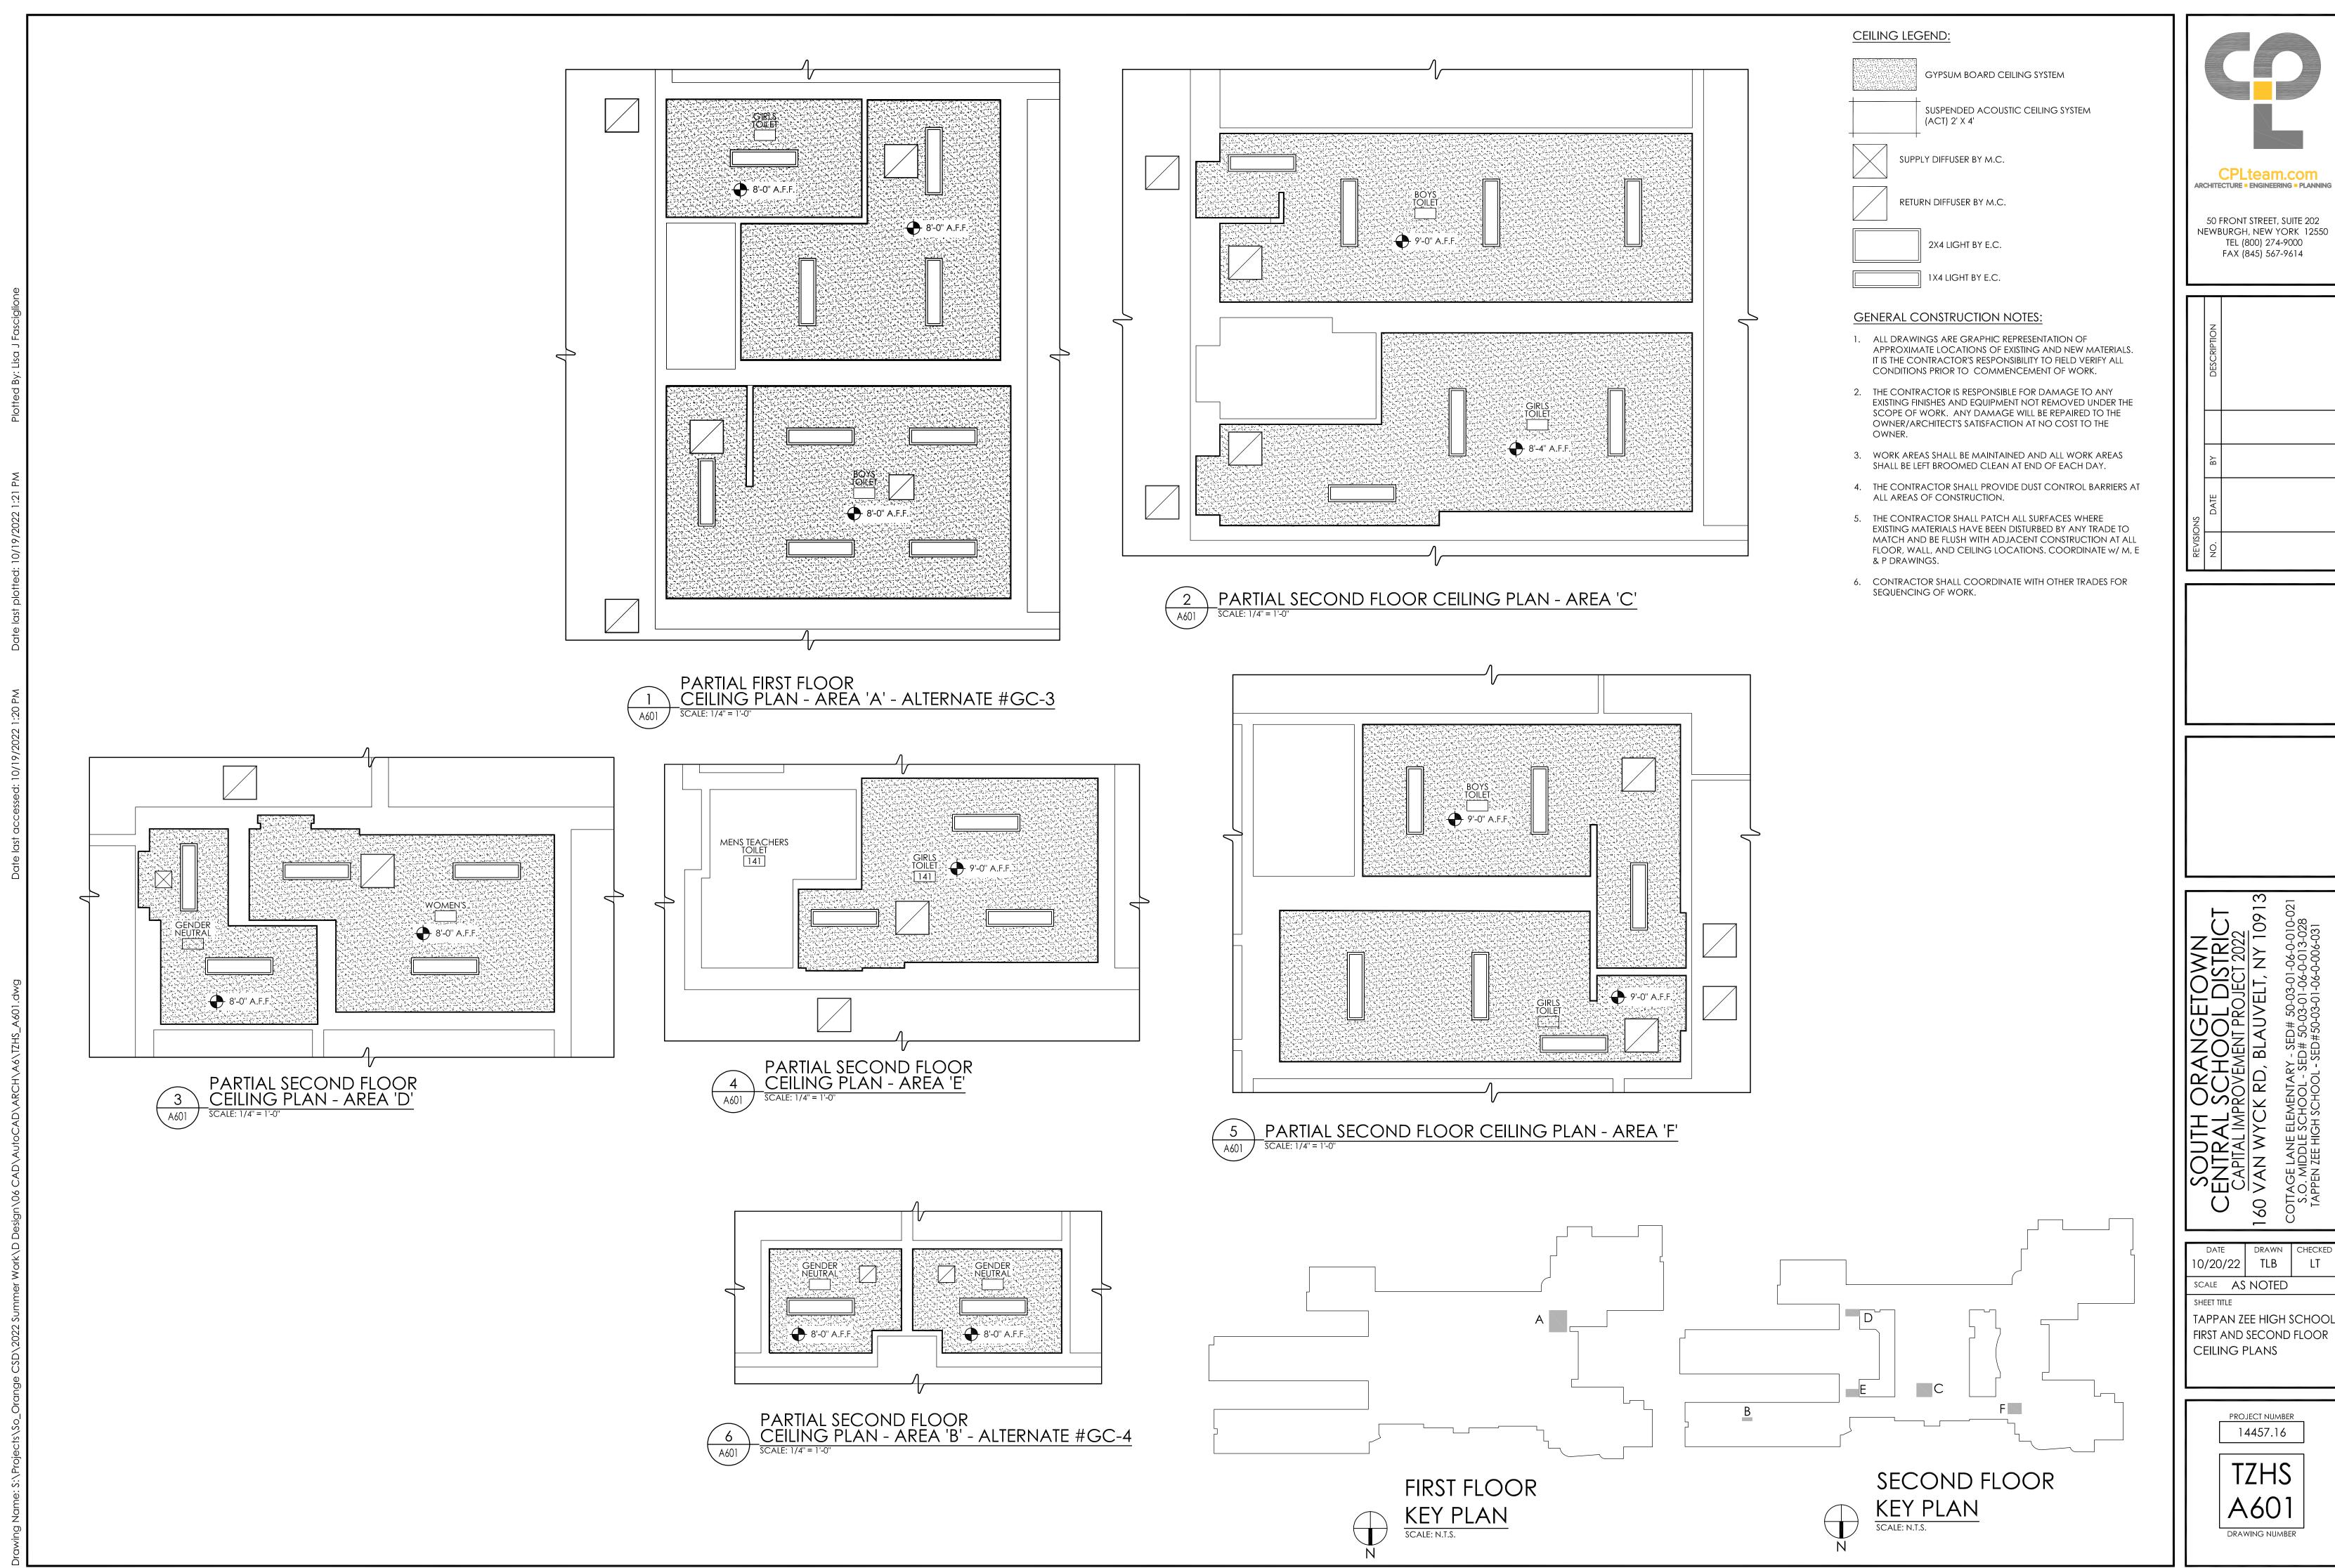
FAX (845) 567-9614

10/20/22 TLB SCALE AS NOTED

TAPPAN ZEE HIGH SCHOOL FIRST AND SECOND FLOOR RECONSTRUCTION PLANS

> PROJECT NUMBER 14457.16

TZHS A201 DRAWING NUMBER




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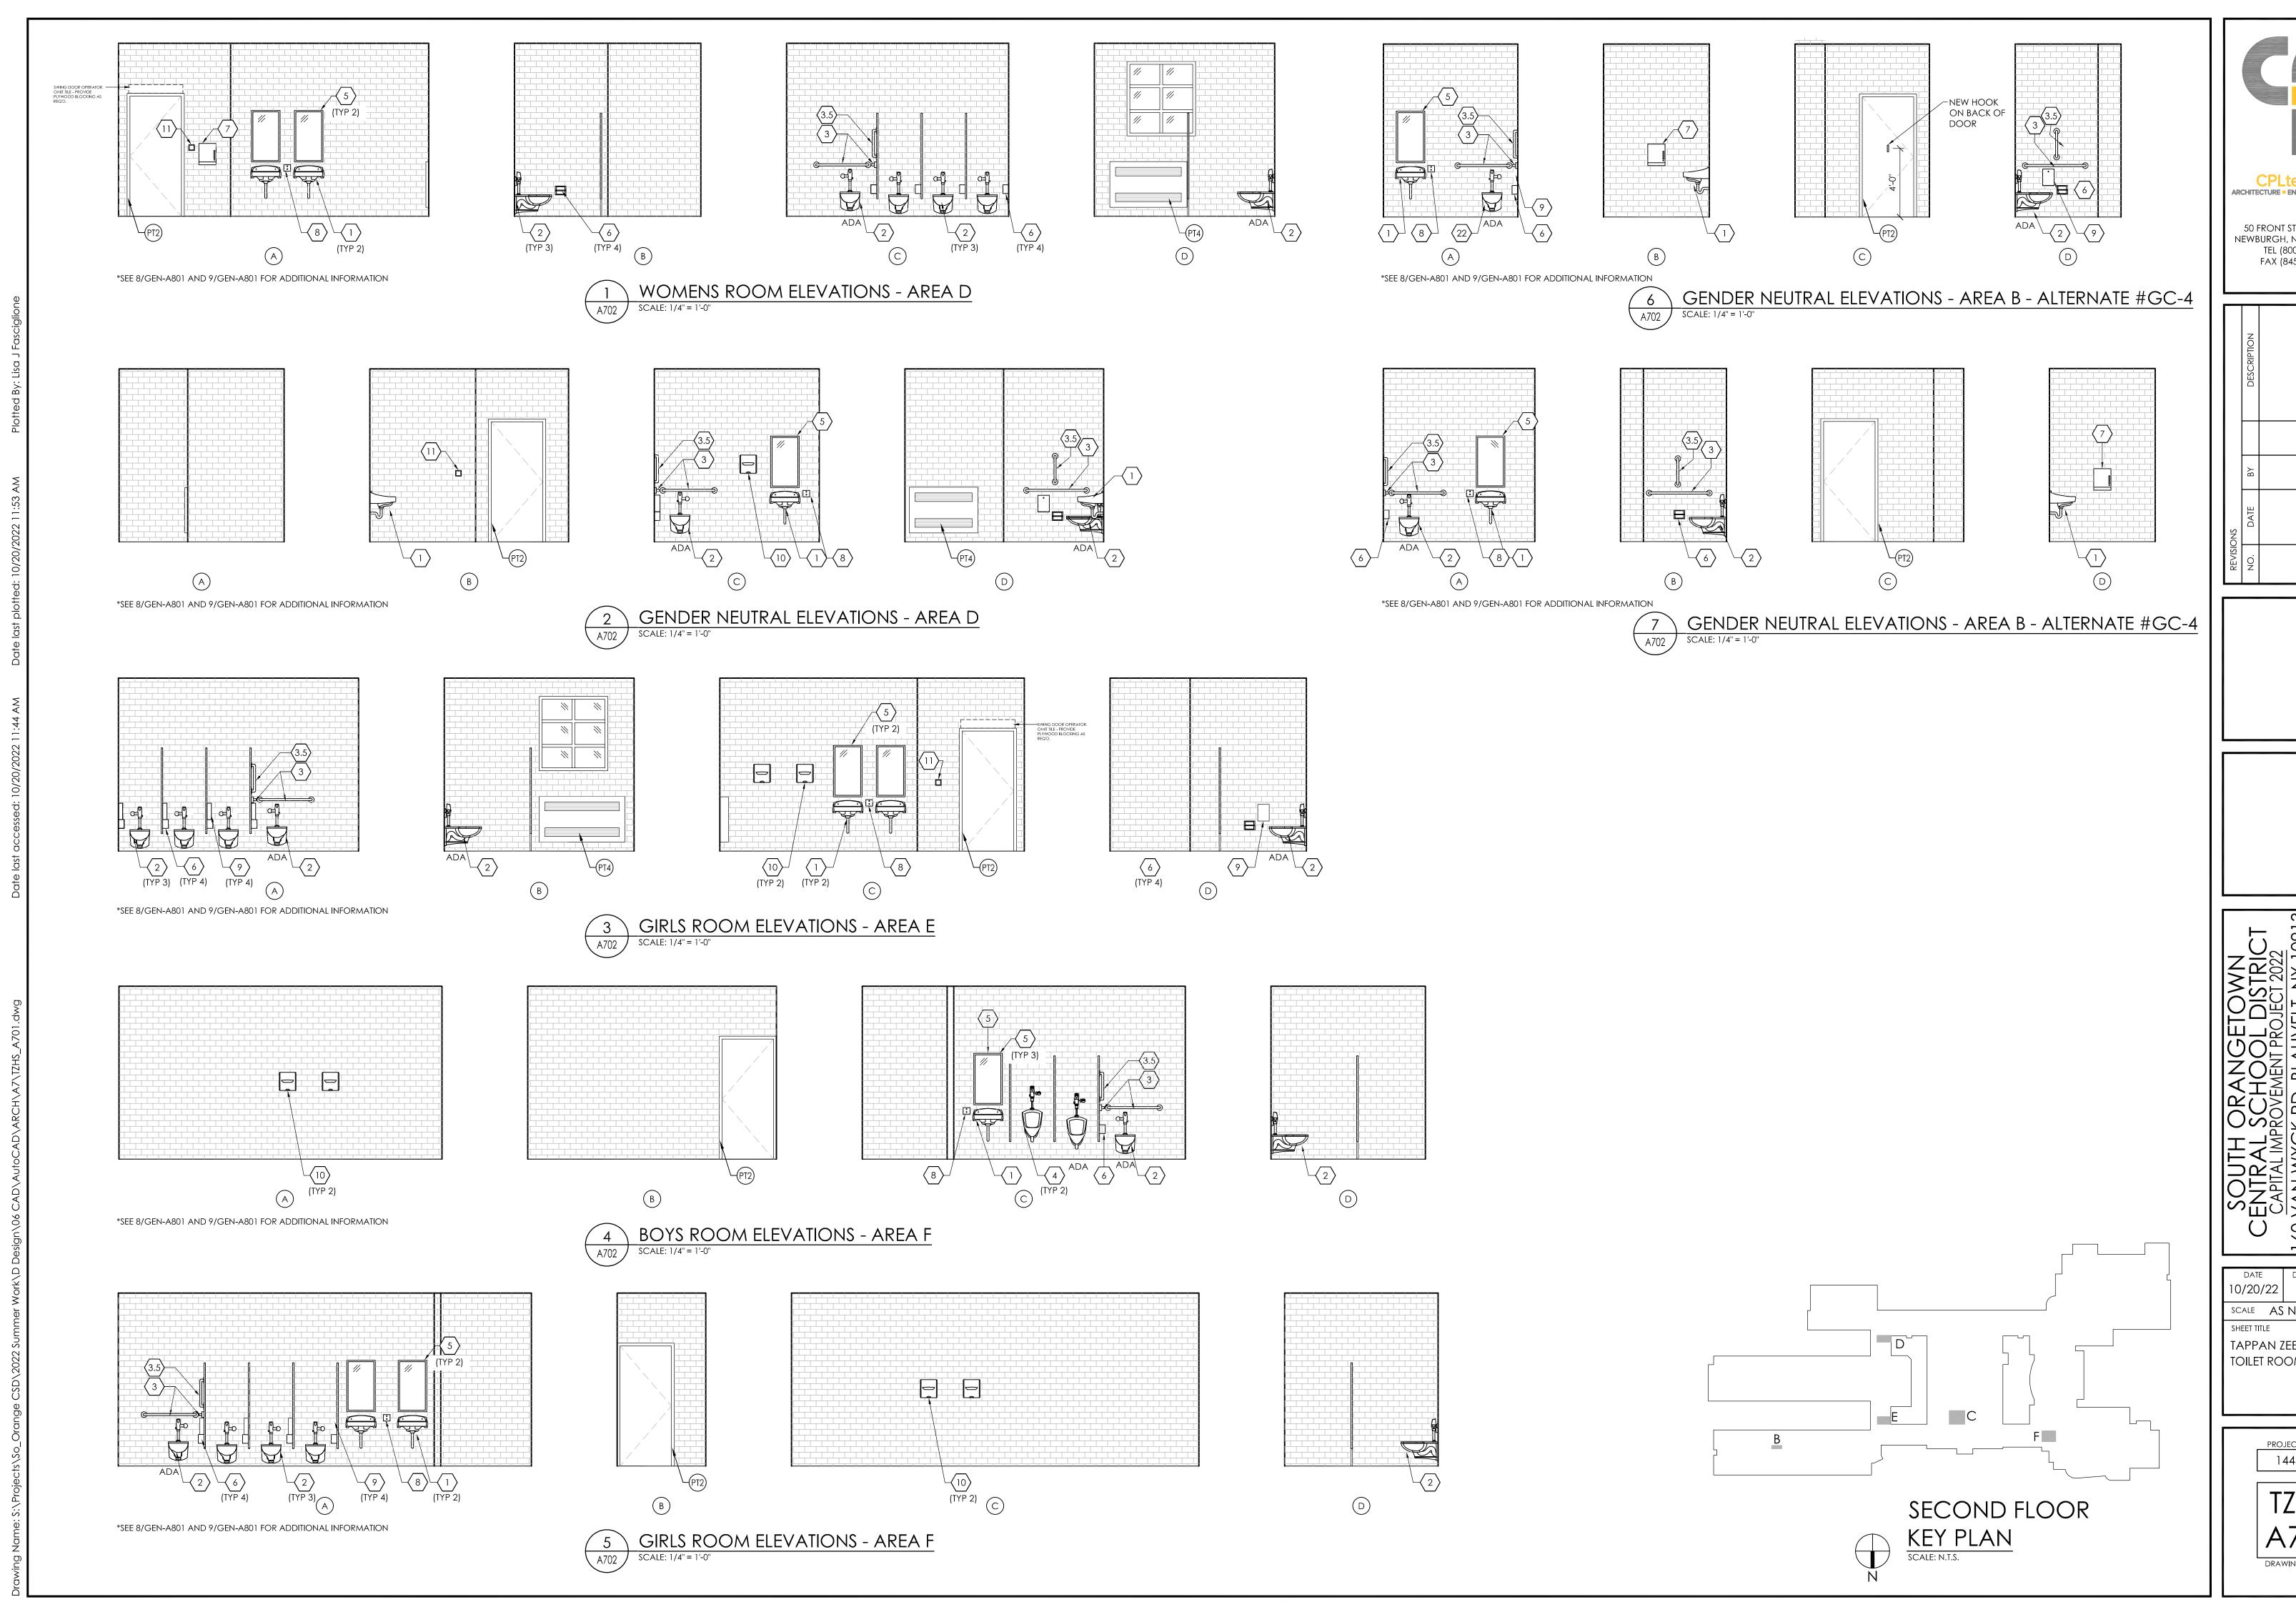
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TAPPAN ZEE HIGH SCHOOL FIRST AND SECOND FLOOR CEILING PLANS

> PROJECT NUMBER 14457.16

TZHS A601 DRAWING NUMBER



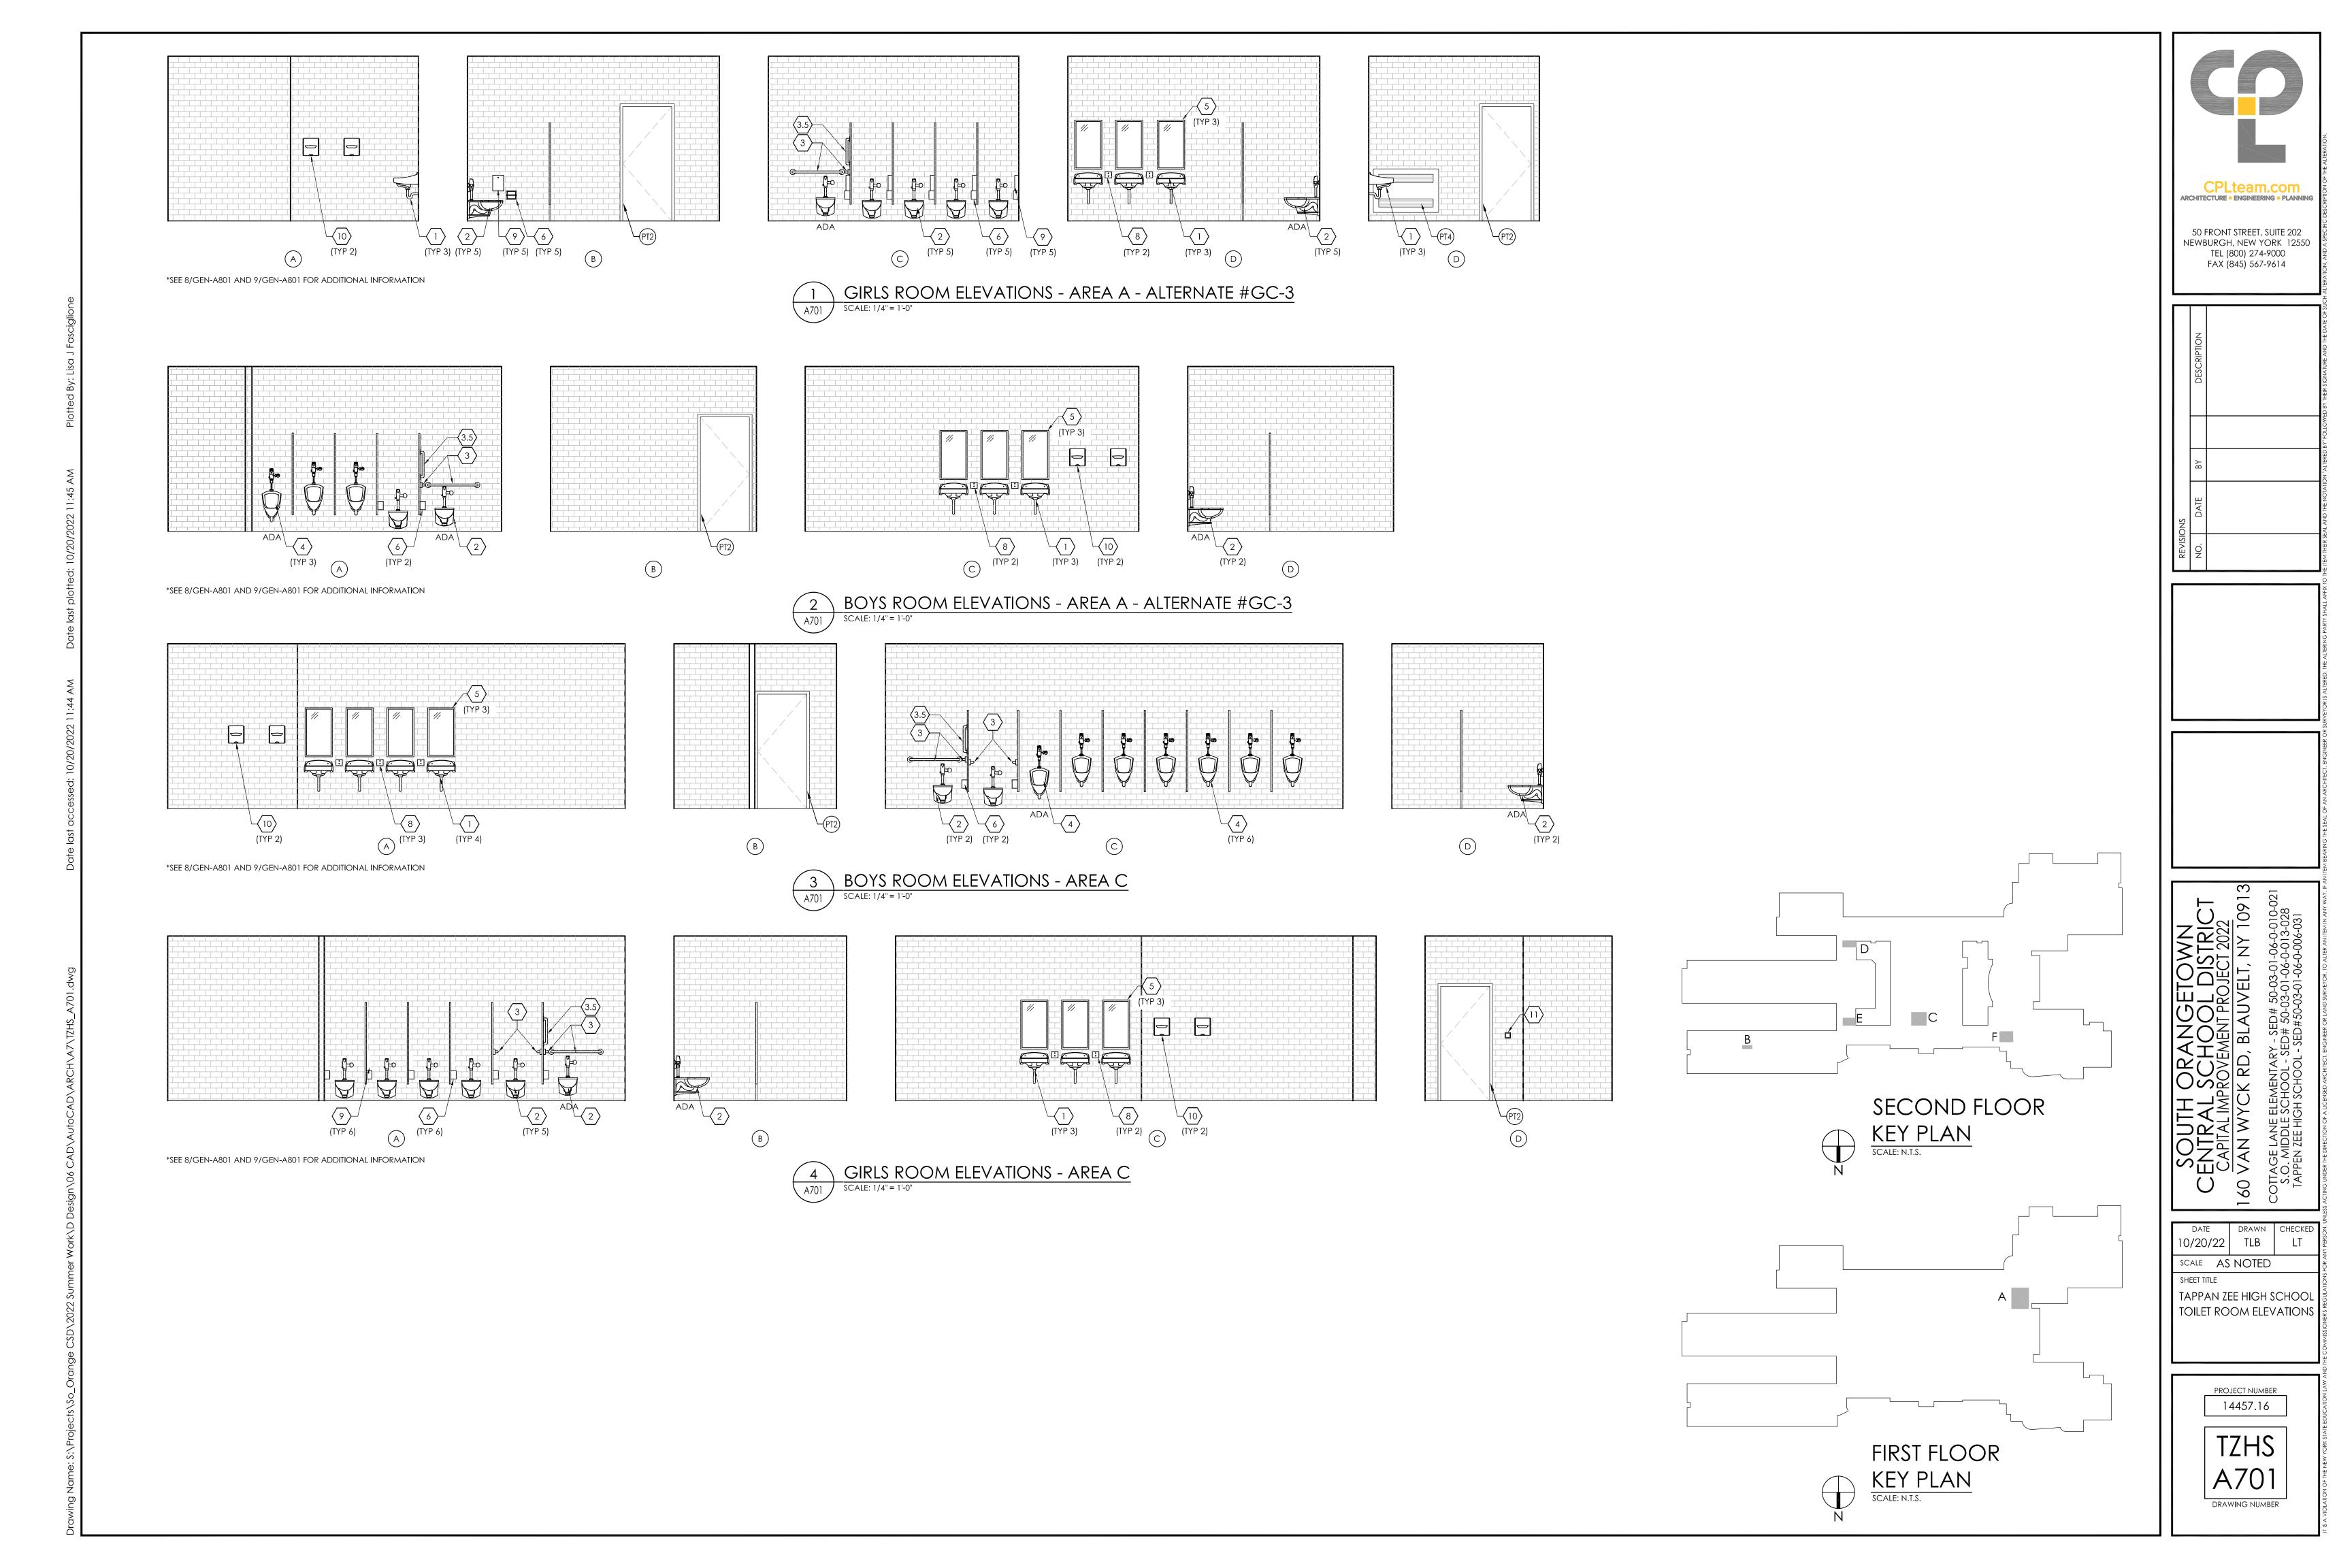

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CENTRAL SCHOOL DISTRICT
CAPITAL IMPROVEMENT PROJECT 2022
160 VAN WYCK RD, BLAUVELT, NY 10913
COTTAGE LANE ELEMENTARY - SED# 50-03-01-06-0-013-028
TAPPEN ZEE HIGH SCHOOL - SED#50-03-01-06-0-006-031


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10/20/22 TLB LT

SCALE AS NOTED

SHEET TITLE
TAPPAN ZEE HIGH SHOOL
TOILET ROOM ELEVATIONS

TZHS
A702

DRAWING NUMBER

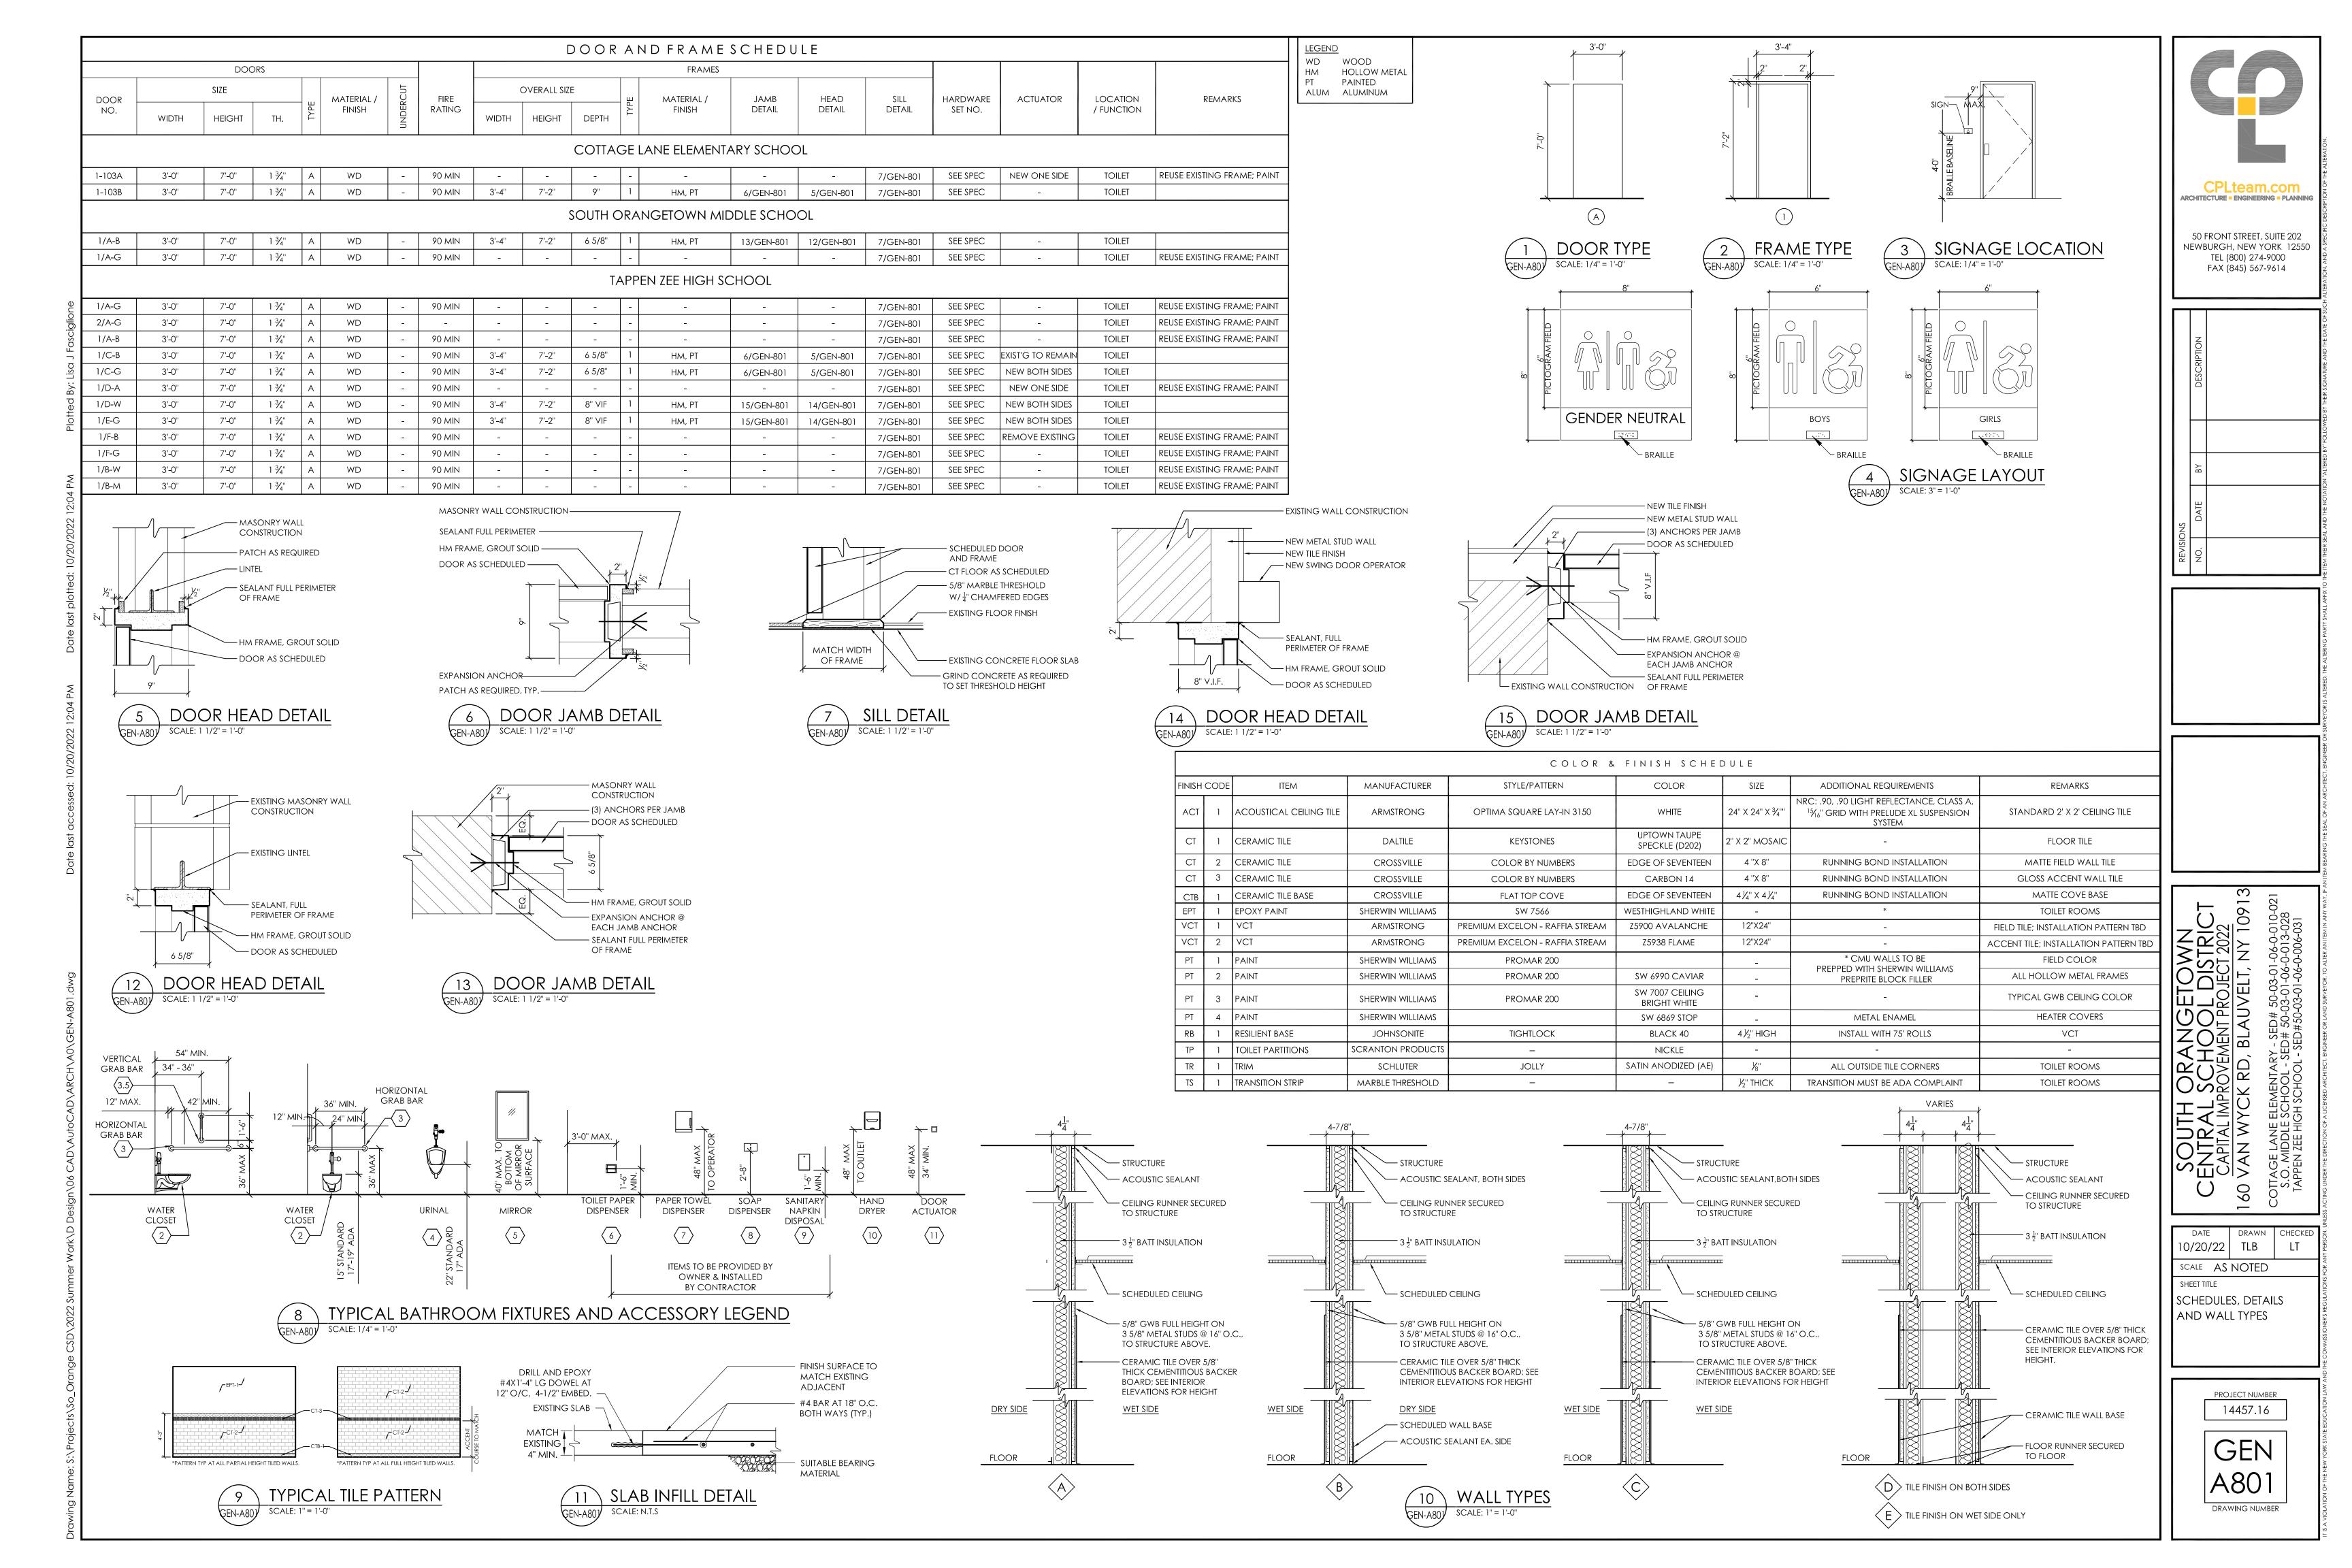

SYMBOLS GENERAL NOTES:

SYMBOL

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DESCRIPTION

CURRENT TRANSDUCER

OPEN/CLOSED

ENABLE/DISABLE

FLOW TRANSMITTER

PRESSURE TRANSMITTER

DUCT SMOKE DETECTOR

SPACE TEMPERATURE SENSOR

SPACE NATURAL GAS SENSOR

SPACE SENSOR WITH GUARD

SPACE HUMIDISTAT

WATER FLOW SENSOR

PNEUMATIC ACTUATOR

ELECTRIC ACTUATOR

COOLING COIL

HEATING COIL

GAS FURNACE

HUMIDIFIER

ALARM

STATUS

RELAY

FLOW SWITCH

PRESSURE GAUGE

ELECTRICAL INTERFACE

SPEED FEED BACK

POSITION FEEDBACK

TRAVERSE AVERAGING SENSOR

END SWITCH

PROBE SENSOR

FREEZE STAT SENSOR

FREEZE-STAT

SPACE CARBON DIOXIDE SENSOR

SPACE CARBON MONOXIDE SENSOR

VARIABLE SPEED / FREQUENCY DRIVE

DIFFERENTIAL STATIC PRESSURE SWITCH

DIGITAL INPUT (TO BUILDING MANAGEMENT SYSTEM)

DIGITAL OUTPUT (FROM BUILDING MANAGEMENT SYSTEM)

ANALOG OUTPUT (FROM BUILDING MANAGEMENT SYSTEM)

ANALOG INPUT (TO BUILDING MANAGEMENT SYSTEM)

SPACE THERMOSTAT

START/STOP

ELECTRIC/PNEUMATIC SWITCH OR RELAY

PNEUMATIC/ELECTRIC SWITCH OR RELAY

TEMPERATURE SENSOR (DUCT OR PIPE MOUNTED)

HUMIDITY SENSOR (DUCT MOUNTED)

DIFFERENTIAL PRESSURE TRANSMITTER

ELECTRIC/PNEUMATIC TRANSDUCER

ELECTRIC/ELECTRONIC TRANSDUCER

1) VALVE AND DAMPER ACTUATOR TYPES (ELECTRIC OR PNEUMATIC) WHICH ARE INDICATED IN HVAC TEMPERATURE CONTROL DRAWINGS SHALL SUPERSEDE TYPE INDICATED ON ALL OTHER HVAC DRAWINGS.

HVAC CONTRACTOR GENERAL NOTES:

- A. IT IS THE RESPONSIBILITY OF THE CONTRACTOR TO FIELD VERIFY EXISTING CONDITIONS WITHIN THE BUILDING PRIOR TO COMMENCEMENT OF ALL DEMOLITION AND NEW WORK.
- B. IT IS THE RESPONSIBILITY OF THE CONTRACTOR TO REMOVE AND REPLACE EXISTING CEILINGS, UNLESS OTHERWISE NOTED ON THE ARCHITECTURAL DRAWINGS, FOR PERFORMING DEMOLITION OR NEW WORK WITHIN THE BUILDING. THE EXISTING CEILINGS SHALL BE REMOVED IN A MANNER TO AVOID DAMAGE TO THE CEILING SYSTEMS. STORAGE OF CEILING SYSTEM COMPONENTS FOR REINSTALLATION IS THE RESPONSIBILITY OF THE CONTRACTOR. THE STORAGE OF ALL MATERIAL SHALL BE IN AREAS OR LOCATIONS APPROVED BY THE OWNER. THE OWNER WILL NOT COMPENSATE FOR ANY DAMAGED OR LOST MATERIAL WHILE IN STORAGE. AFTER COMPLETION OF ALL DEMOLITION OR NEW WORK, THE CONTRACTOR SHALL REINSTALL THE CEILING SYSTEMS TO MATCH THE ORIGINAL INSTALLATION.
- C. DEMOLITION DRAWINGS SHOW MAJOR EQUIPMENT, PIPING, AND DUCTWORK REMOVALS. THE INTENT IS NOT TO IDENTIFY ALL MISCELLANEOUS PIPING, PIPING ACCESSORIES, DUCTWORK, DUCTWORK ACCESSORIES, SUPPORTS, CONTROLS, CONTROL ACCESSORIES, CONTROL WIRING, CONDUIT, AND PNEUMATIC CONTROL TUBING TO BE DISCONNECTED AND REMOVED, BUT IS THE REQUIREMENT UNDER THIS CONTRACT. NO EQUIPMENT, PIPING, OR DUCTWORK SHALL BE ABANDONED IN PLACE, UNLESS OTHERWISE NOTED ON THE DRAWINGS.
- D. ALL EQUIPMENT INDICATED TO BE TURNED OVER TO THE OWNER SHALL BE DISCONNECTED AND REMOVED FROM THE EXISTING SYSTEMS AND DELIVERED (INCLUDING LOADING AND UNLOADING) TO A STORAGE AREA WITHIN THE BUILDING AS SELECTED BY THE OWNER. IT WILL BE THE RESPONSIBILITY OF THE CONTRACTOR TO REPAIR ANY EQUIPMENT DAMAGED DURING REMOVAL AND DELIVERY. ANY DAMAGE TO EQUIPMENT PRIOR TO DISCONNECTING SHOULD BE REPORTED TO THE OWNER'S REPRESENTATIVE. IF NOT REPORTED, THE CONTRACTOR TAKES FULL RESPONSIBILITY FOR REPAIRS TO THE EQUIPMENT.
- E. BEFORE DISCONNECTING, REMOVING, OR SERVICING ANY AIR CONDITIONING EQUIPMENT OR SYSTEMS CONTAINING REFRIGERANTS, THE EQUIPMENT OR SYSTEMS SHALL BE EVACUATED OF ALL REFRIGERANT PER THE LATEST ADOPTED RULES AND REGULATIONS BY THE UNITED STATES ENVIRONMENTAL PROTECTION AGENCY (EPA). THE CONTRACTOR OR TECHNICIAN PERFORMING THE WORK SHALL BE CERTIFIED BY AN EPA APPROVED CERTIFYING AGENCY OR ORGANIZATION.
- F. ALL DUCTWORK, PIPING, AND CONDUIT PENETRATIONS THROUGH RATED WALLS OR FLOORS SHALL BE PROVIDED WITH FIRE/SMOKE STOPPINGS PER SPECIFICATION. REFER TO CODE ANALYSIS DRAWING FOR ALL RATED WALL LOCATIONS. ALL FLOORS SHALL BE CONSIDERED RATED.
- G. UNLESS SHOWN ON THE ARCHITECTURAL DRAWINGS, IT IS THE RESPONSIBILITY OF THIS CONTRACT TO PATCH AND FINISH ALL EXISTING DUCTWORK OR PIPE PENETRATIONS THROUGH FLOORS, ROOFS, INTERIOR WALLS, AND EXTERIOR WALLS AFTER DEMOLITION WORK. IN ADDITION, ALL NEW PENETRATIONS SHALL BE PROVIDED FOR INSTALLATION OF MECHANICAL SYSTEMS INCLUDING, BUT NOT LIMITED TO, EQUIPMENT, CURBING, DUCTWORK, PIPING, CONTROLS, ETC. PATCHING AND FINISHING SHALL MATCH EXISTING CONSTRUCTION INCLUDING FIRE RATINGS. PROVIDE LINTELS PER LINTEL SCHEDULE.
- H. IT IS NOT THE INTENT OF THE DRAWINGS TO SHOW ALL AIR VENTS AND DRAINS IN THE PIPING SYSTEMS. IT IS THE RESPONSIBILITY OF THE CONTRACTOR TO PROVIDE AIR VENTS AT ALL SYSTEM HIGH POINTS AND AT AREAS WITHIN THE PIPING SYSTEMS THAT COULD ACCUMULATE OR TRAP AIR WHICH WOULD PREVENT PROPER VENTING OR OPERATION OF THE SYSTEMS. DRAINS SHALL BE PROVIDED AT ALL LOW POINTS WITHIN THE PIPING SYSTEM TO FACILITATE COMPLETE DRAINING OF THE SYSTEM.
- I. PROVIDE THERMAL EXPANSION COMPENSATORS AND THERMAL EXPANSION LOOPS IN PIPING SYSTEM PER INDUSTRY STANDARDS.



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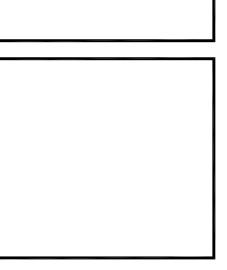
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	ВY	
SNC	DATE	
REVISIONS	NO.	



SOUTH ORANGETOWN
CENTRAL SCHOOL DISTRICT
CAPITAL IMPROVEMENT PROJECT 2022
160 VAN WYCK RD, BLAUVELT, NY 10913
COTTAGE LANE ELEMENTARY - SED# 50-03-01-06-0-010-021
S.O. MIDDLE SCHOOL - SED# 50-03-01-06-0-013-028
TAPPEN ZEE HIGH SCHOOL - SED# 50-03-01-06-0-006-031

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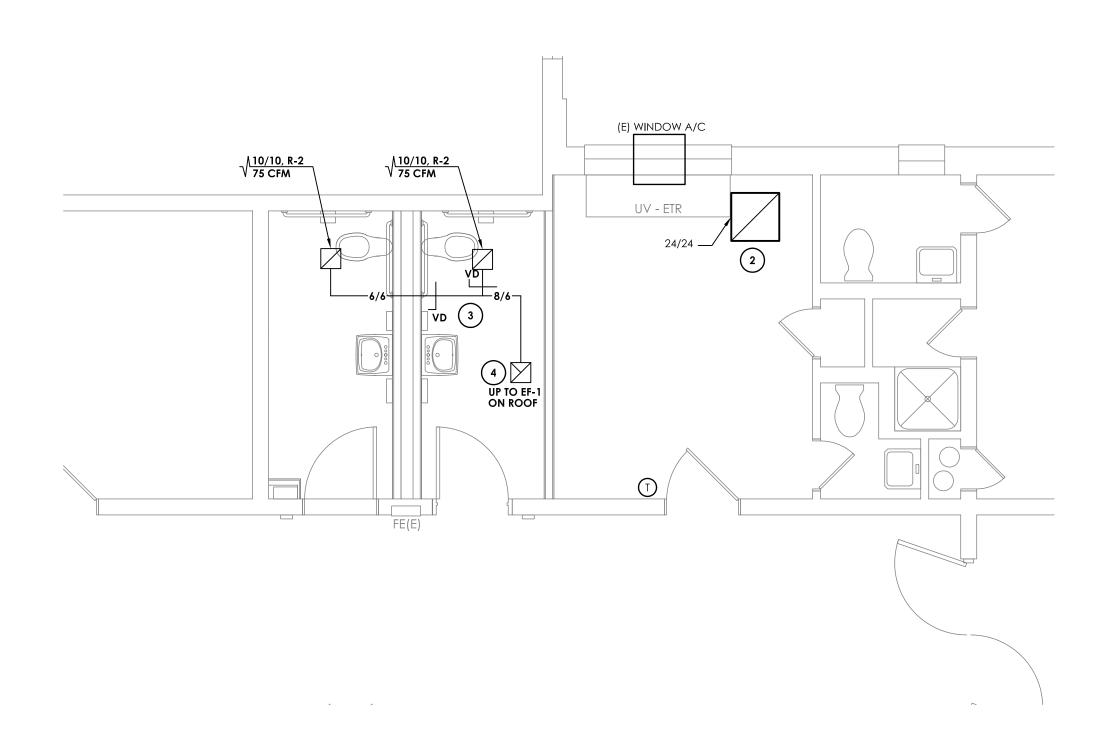
HVAC SYMBOLS LIST AND GENERAL NOTES

14457.16

GEN
H000

DRAWING NUMBER





FIRST FLOOR HVAC NEW WORK PLAN

SCALE: 1/4" = 1'-0"

GENERAL NOTES:

- A. IT IS THE RESPONSIBILITY OF THE CONTRACTOR TO FIELD VERIFY EXISTING CONDITIONS WITHIN THE BUILDING PRIOR TO COMMENCEMENT OF ALL DEMOLITION AND NEW WORK.
- B. IT IS THE RESPONSIBILITY OF THE CONTRACTOR TO REMOVE AND REPLACE EXISTING CEILINGS, UNLESS OTHERWISE NOTED ON THE ARCHITECTURAL DRAWINGS, FOR PERFORMING DEMOLITION OR NEW WORK WITHIN THE BUILDING. THE EXISTING CEILINGS SHALL BE REMOVED IN A MANNER TO AVOID DAMAGE TO THE CEILING SYSTEMS. STORAGE OF CEILING SYSTEM COMPONENTS FOR REINSTALLATION IS THE RESPONSIBILITY OF THE CONTRACTOR. THE STORAGE OF ALL MATERIAL SHALL BE IN AREAS OR LOCATIONS APPROVED BY THE OWNER. THE OWNER WILL NOT COMPENSATE FOR ANY DAMAGED OR LOST MATERIAL WHILE IN STORAGE. AFTER COMPLETION OF ALL DEMOLITION OR NEW WORK, THE CONTRACTOR SHALL REINSTALL THE CEILING SYSTEMS TO MATCH THE ORIGINAL INSTALLATION.
- C. DEMOLITION DRAWINGS SHOW MAJOR EQUIPMENT, PIPING, AND DUCTWORK REMOVALS. THE INTENT IS NOT TO IDENTIFY ALL MISCELLANEOUS PIPING, PIPING ACCESSORIES, DUCTWORK, DUCTWORK ACCESSORIES, SUPPORTS, CONTROLS, CONTROL ACCESSORIES, CONTROL WIRING, CONDUIT, AND PNEUMATIC CONTROL TUBING TO BE DISCONNECTED AND REMOVED, BUT IS THE REQUIREMENT UNDER THIS CONTRACT. NO EQUIPMENT, PIPING, OR DUCTWORK SHALL BE ABANDONED IN PLACE, UNLESS OTHERWISE NOTED ON THE DRAWINGS.
- D. ALL DUCTWORK, PIPING, AND CONDUIT PENETRATIONS
 THROUGH RATED WALLS OR FLOORS SHALL BE PROVIDED
 WITH FIRE/SMOKE STOPPINGS PER SPECIFICATION. REFER TO
 CODE ANALYSIS DRAWING FOR ALL RATED WALL
 LOCATIONS. ALL FLOORS SHALL BE CONSIDERED RATED.
- E. UNLESS SHOWN ON THE ARCHITECTURAL DRAWINGS, IT IS THE RESPONSIBILITY OF THIS CONTRACT TO PATCH AND FINISH ALL EXISTING DUCTWORK OR PIPE PENETRATIONS THROUGH FLOORS, ROOFS, INTERIOR WALLS, AND EXTERIOR WALLS AFTER DEMOLITION WORK. IN ADDITION, ALL NEW PENETRATIONS SHALL BE PROVIDED FOR INSTALLATION OF MECHANICAL SYSTEMS INCLUDING, BUT NOT LIMITED TO, EQUIPMENT, CURBING, DUCTWORK, PIPING, CONTROLS, ETC. PATCHING AND FINISHING SHALL MATCH EXISTING CONSTRUCTION INCLUDING FIRE RATINGS. PROVIDE LINTELS PER LINTEL SCHEDULE.


KEY NOTES:

- REMOVE EXISTING RETURN GRILLE. PREPARE EXISTING DUCTWORK FOR NEW LOCATION AND CONNECTION.
- 2 PROVIDE NEW RETURN GRILLE IN ACT CEILING. CONNECT TO EXISTING DUCTWORK.
- PROVIDE 12X12 ACCESS DOOR FOR DAMPER ACCESS. COORDINATE WITH G.C.
- PROVIDE 10/10 DUCT UP TO NEW EXHAUST FAN ON ROOF.



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	DESCRIPTION	
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SNC	DATE	
REVISIONS	NO.	

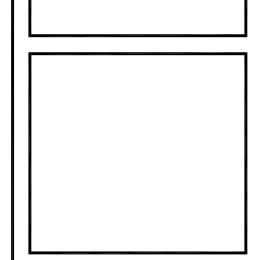

CENTRAL SCHOOL DISTRICT
CAPITAL IMPROVEMENT PROJECT 2022

160 VAN WYCK RD, BLAUVELT, NY 10913

COTTAGE LANE ELEMENTARY - SED# 50-03-01-06-0-013-028

S.O. MIDDLE SCHOOL - SED# 50-03-01-06-0-013-028

TAPPEN 7FF HIGH SCHOOL - SED# 50-03-01-06-0-013-028

DATE DRAWN CHECK
10/20/22 KCM JJM

SCALE 1/4"=1'-0"

SHEET TITLE


TOILET ROOM HVAC

SHEET TITLE
TOILET ROOM HVAC
DEMOLITION AND NEW
WORK PLAN


PROJECT NUMBER
14457.16

CLES
H101


DRAWING NUMBER

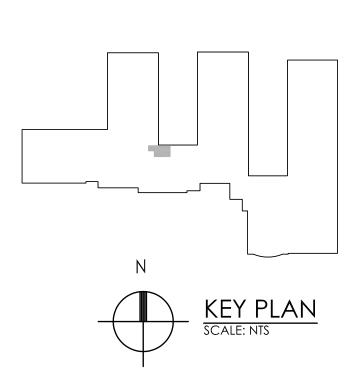

PARTIAL GROUND FLOOR DEMOLITION PLAN - AREA 'A' - ALTERNATE #MC-1

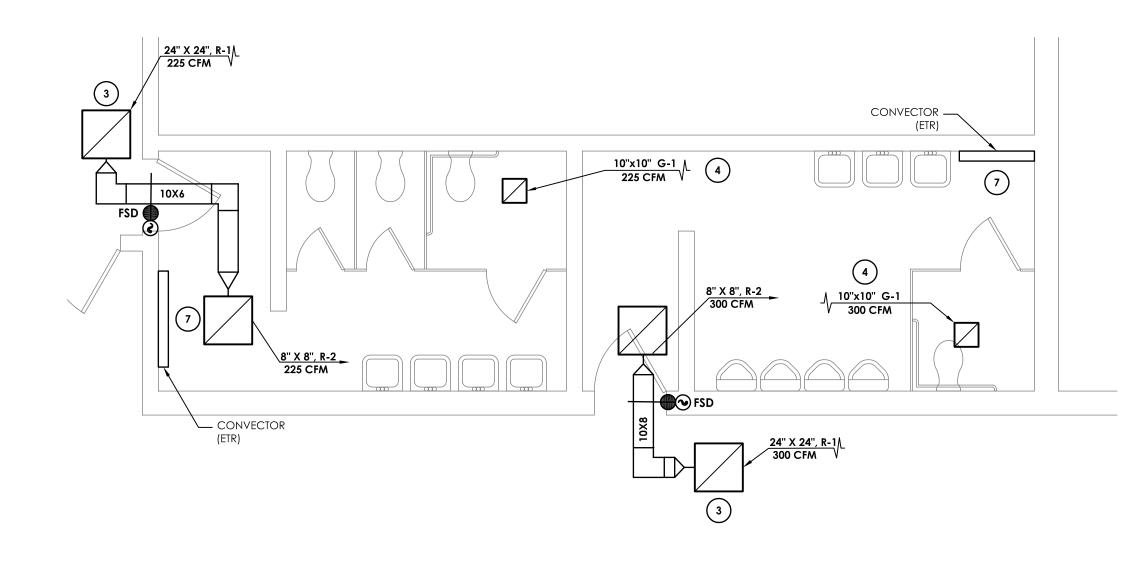


PARTIAL GROUND FLOOR
RECONSTRUCTION PLAN - AREA 'A' - ALTERNATE #MC-1

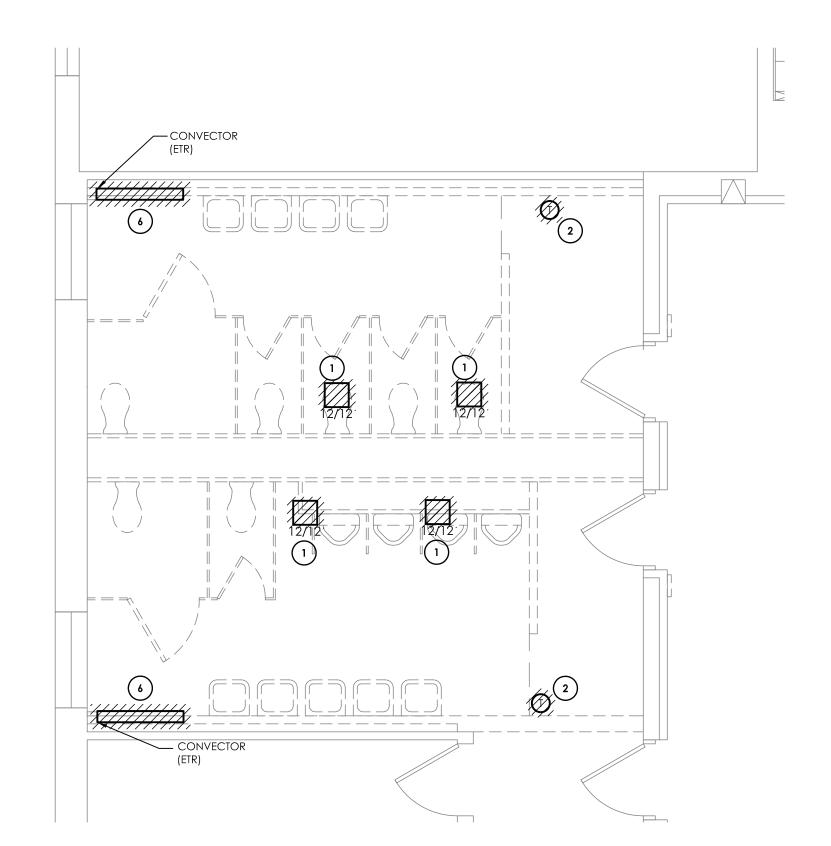

PARTIAL FIRST FLOOR
DEMOLITION PLAN - AREA 'B' - ALTERNATE #MC-2

SCALE: 1/4" = 1'-0"

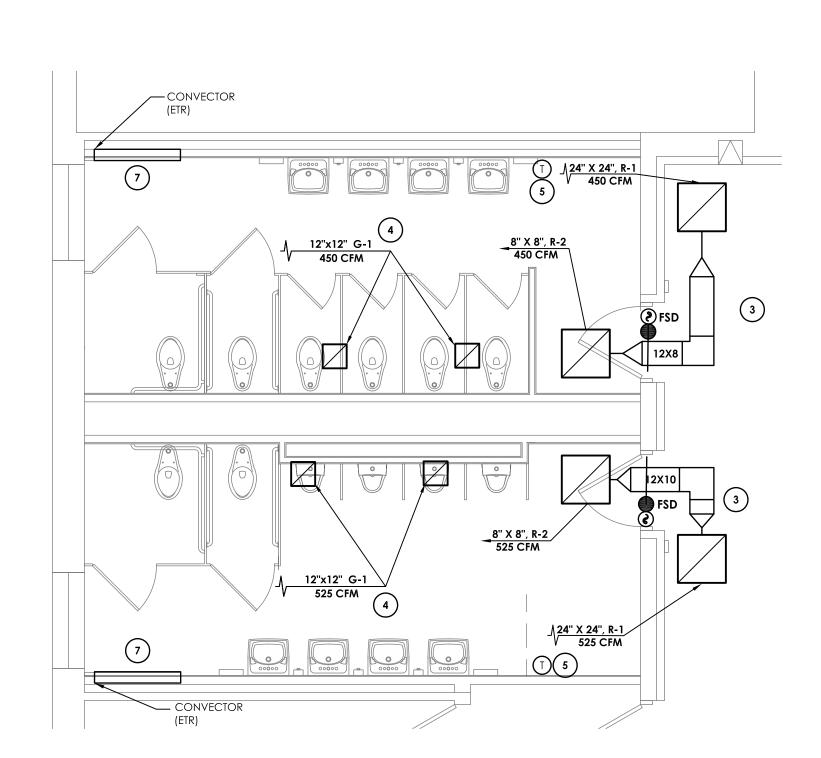

PARTIAL FIRST FLOOR RECONSTRUCTION PLAN - AREA 'B' - ALTERNATE #MC-2


| SCALE: 1/4" = 1'-0"


GENERAL NOTES:

- A. IT IS THE RESPONSIBILITY OF THE CONTRACTOR TO FIELD VERIFY EXISTING CONDITIONS WITHIN THE BUILDING PRIOR TO COMMENCEMENT OF ALL DEMOLITION AND NEW WORK.
- B. IT IS THE RESPONSIBILITY OF THE CONTRACTOR TO REMOVE AND REPLACE EXISTING CEILINGS, UNLESS OTHERWISE NOTED ON THE ARCHITECTURAL DRAWINGS, FOR PERFORMING DEMOLITION OR NEW WORK WITHIN THE BUILDING. THE EXISTING CEILINGS SHALL BE REMOVED IN A MANNER TO AVOID DAMAGE TO THE CEILING SYSTEMS. STORAGE OF CEILING SYSTEM COMPONENTS FOR REINSTALLATION IS THE RESPONSIBILITY OF THE CONTRACTOR. THE STORAGE OF ALL MATERIAL SHALL BE IN AREAS OR LOCATIONS APPROVED BY THE OWNER. THE OWNER WILL NOT COMPENSATE FOR ANY DAMAGED OR LOST MATERIAL WHILE IN STORAGE. AFTER COMPLETION OF ALL DEMOLITION OR NEW WORK, THE CONTRACTOR SHALL REINSTALL THE CEILING SYSTEMS TO MATCH THE ORIGINAL INSTALLATION.
- C. DEMOLITION DRAWINGS SHOW MAJOR EQUIPMENT, PIPING, AND DUCTWORK REMOVALS. THE INTENT IS NOT TO IDENTIFY ALL MISCELLANEOUS PIPING, PIPING ACCESSORIES, DUCTWORK, DUCTWORK ACCESSORIES, SUPPORTS, CONTROLS, CONTROL ACCESSORIES, CONTROL WIRING, CONDUIT, AND PNEUMATIC CONTROL TUBING TO BE DISCONNECTED AND REMOVED, BUT IS THE REQUIREMENT UNDER THIS CONTRACT. NO EQUIPMENT, PIPING, OR DUCTWORK SHALL BE ABANDONED IN PLACE, UNLESS OTHERWISE NOTED ON THE DRAWINGS.
- D. ALL DUCTWORK, PIPING, AND CONDUIT PENETRATIONS THROUGH RATED WALLS OR FLOORS SHALL BE PROVIDED WITH FIRE/SMOKE STOPPINGS PER SPECIFICATION. REFER TO CODE ANALYSIS DRAWING FOR ALL RATED WALL LOCATIONS. ALL FLOORS SHALL BE CONSIDERED RATED.
- E. UNLESS SHOWN ON THE ARCHITECTURAL DRAWINGS, IT IS THE RESPONSIBILITY OF THIS CONTRACT TO PATCH AND FINISH ALL EXISTING DUCTWORK OR PIPE PENETRATIONS THROUGH FLOORS, ROOFS, INTERIOR WALLS, AND EXTERIOR WALLS AFTER DEMOLITION WORK. IN ADDITION, ALL NEW PENETRATIONS SHALL BE PROVIDED FOR INSTALLATION OF MECHANICAL SYSTEMS INCLUDING, BUT NOT LIMITED TO, EQUIPMENT, CURBING, DUCTWORK, PIPING, CONTROLS, ETC. PATCHING AND FINISHING SHALL MATCH EXISTING CONSTRUCTION INCLUDING FIRE RATINGS. PROVIDE LINTELS PER LINTEL SCHEDULE.

KEY NOTES:

- 1 REMOVE EXISTING EXHAUST GRILLE. PREPARE DUCTWORK FOR NEW.
- REMOVE EXISTING ROOM TEMPERATURE CONTROLS. PREPARE FOR NEW.
- PROVIDE TRANSFER AIR DUCTWORK AND GRILLES. COORDINATE CORRIDOR TRANSFER GRILLE WITH CEILING GRID.
- 4 RECONNECT NEW GRILLE TO EXISTING DUCTWORK. COORDINATE WITH EXISTING DUCTWORK AND CEILING TYPES.
- 5 PROVIDE NEW TEMPERATURE SENSOR. CONNECT TO EXISTING
- 6 REMOVE EXISTING HEATER COVER AND PREPARE FOR REPLACEMENT.
- 7) INSTALL NEW HEATER COVER PROVIDED BY M.C.

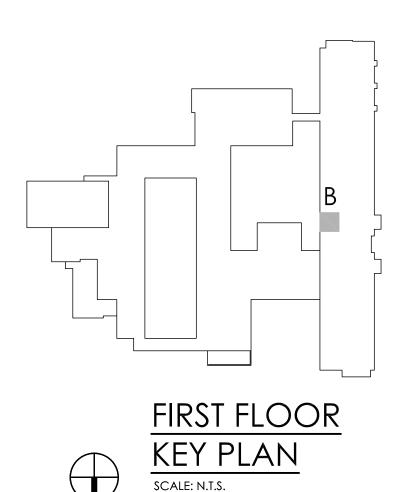

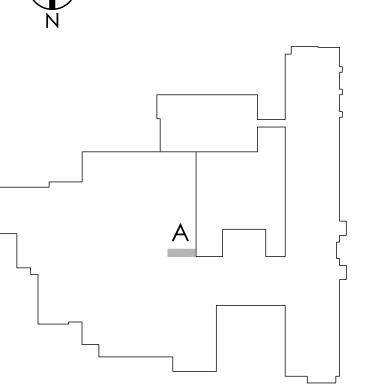






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CENTRAL SCHOOL DISTRICT CAPITAL IMPROVEMENT PROJECT 2022
60 VAN WYCK RD, BLAUVELT, NY 1091
S.O. MIDDLE SCHOOL - SED# 50-03-01-06-0-013-028
TAPPEN ZEE HIGH SCHOOL - SED#50-03-01-06-0-031

DATE DRAWN CHECKEE

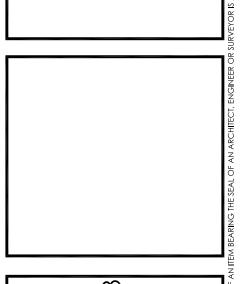10/20/22 KCM JJM

SCALE 1/4" = 1'- 0"

SHEET TITLE

TOILET ROOM HVAC

SHEET TITLE


TOILET ROOM HVAC

DEMOLITION AND NEW


WORK PLAN

PROJECT NUMBER


SOMS H101 DRAWING NUMBER

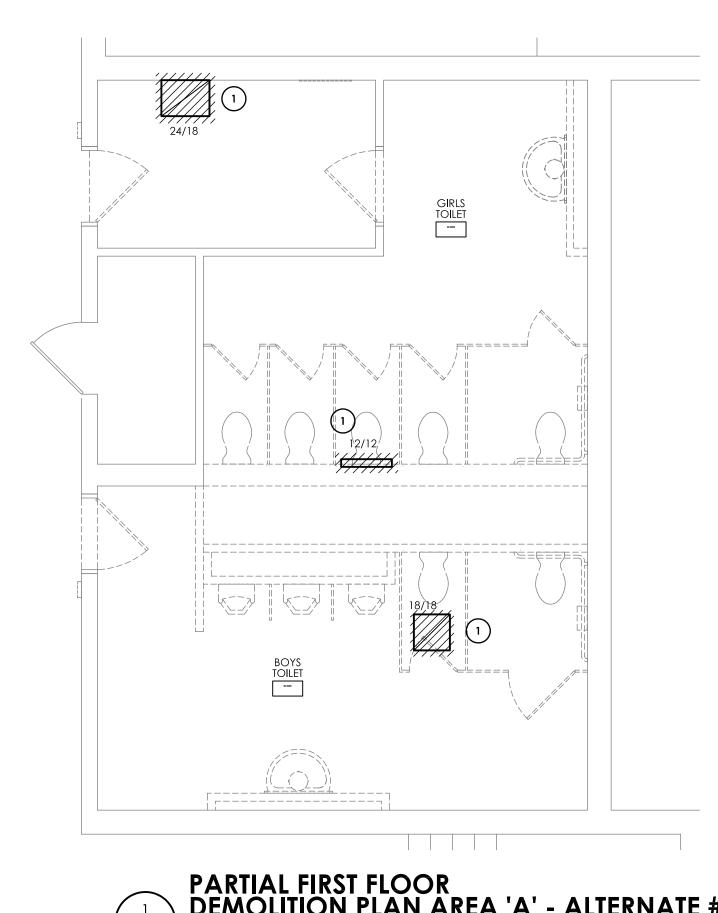




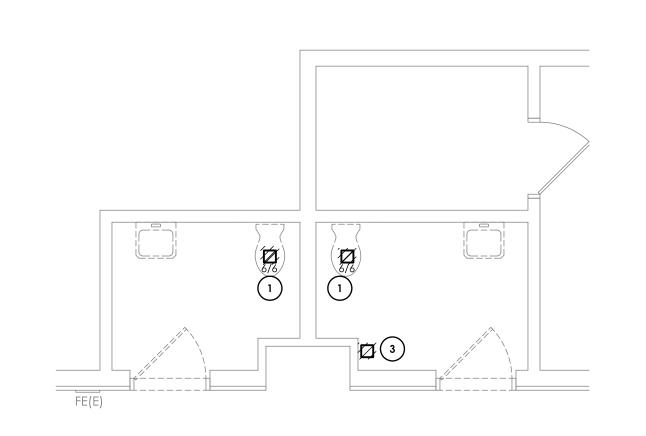


PARTIAL SECOND FLOOR DEMOLITION PLAN - AREA 'B' - ALTERNATE #MC-4

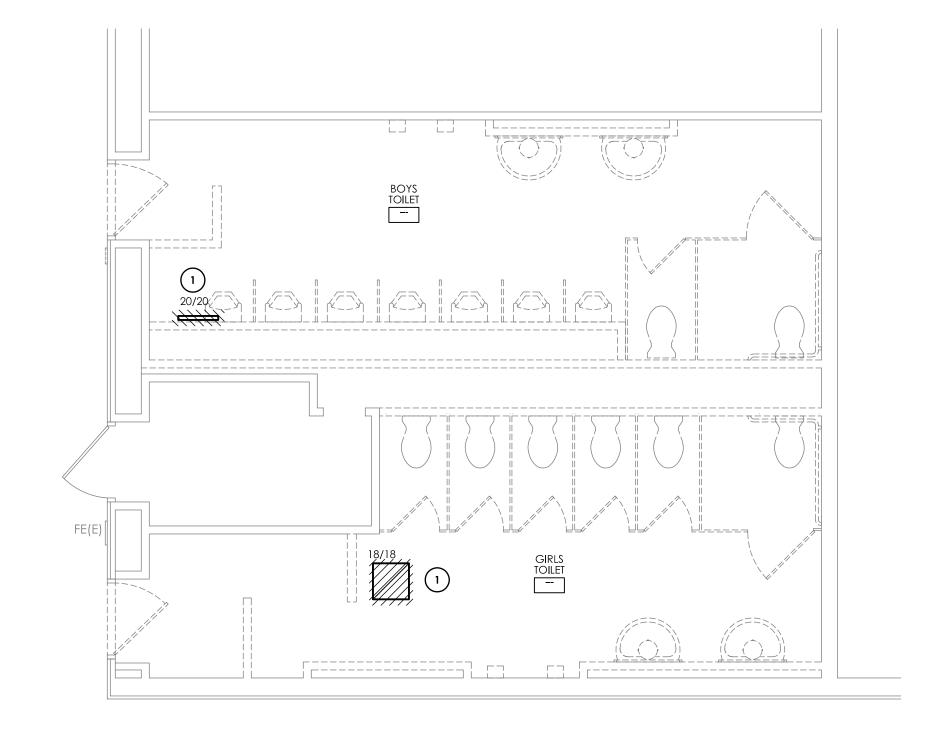

PARTIAL SECOND FLOOR DEMOLITION PLAN - AREA 'C'

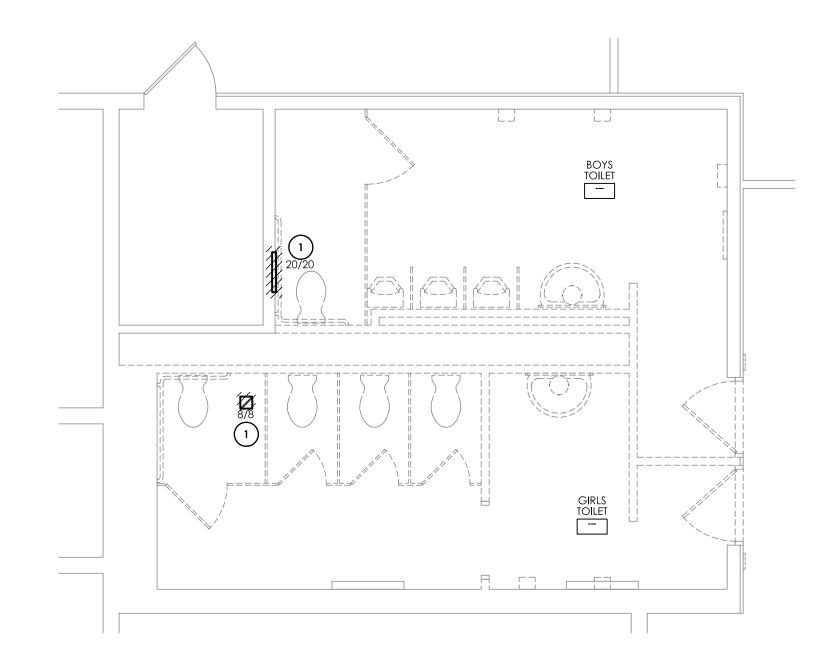

PARTIAL SECOND FLOOR DEMOLITION PLAN - AREA 'F'

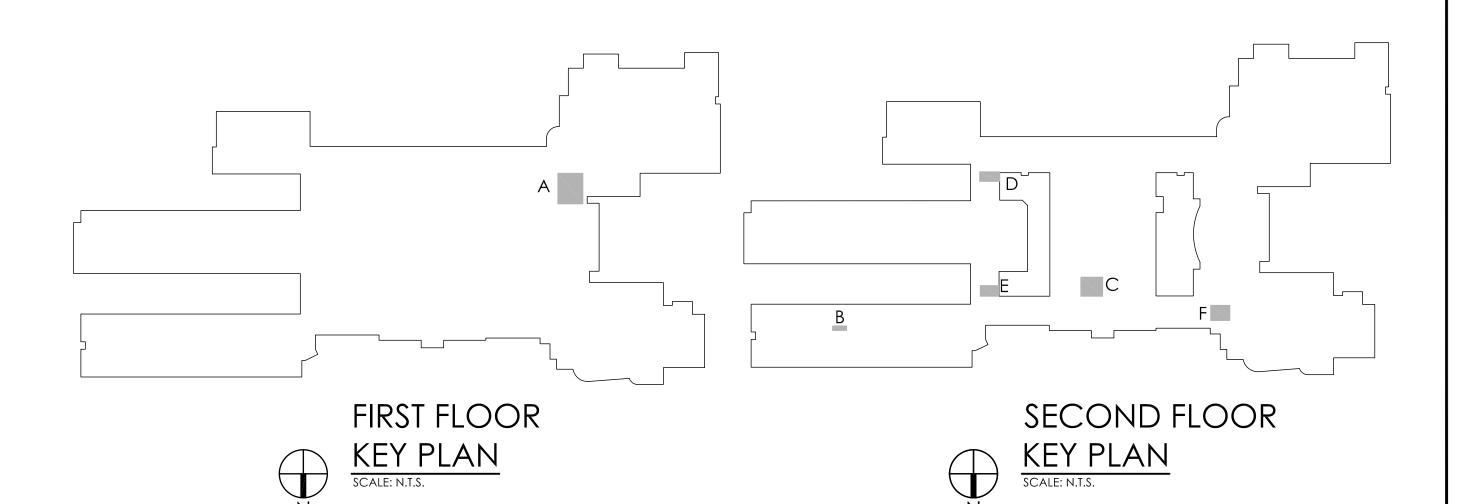



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KEY NOTES:

- 1 REMOVE EXISTING EXHAUST GRILLE. PREPARE DUCTWORK FOR NEW.
- 2 REMOVE EXISTING ROOM TEMPERATURE CONTROLS. PREPARE FOR NEW.
- 3 REMOVE FOUR (4) JOHNSON CONTROLS PNEUMATIC FAN CONTROLLERS. SAVE FOR RE-INSTALLATION. PREPARE PNEUMATIC TUBING FOR RELOCATION.
- 4 REMOVE EXISTING HEATER COVER AND PREPARE FOR REPLACEMENT.


ARCHITECTURE - ENGINEERING - PLANNING 50 FRONT STREET, SUITE 202 NEWBURGH, NEW YORK 12550 TEL (800) 274-9000 FAX (845) 567-9614


10/20/22 KCM SCALE 1/4'' = 1' - 0''

TAPPEN ZEE HIGH SCHOOL FIRST AND SECOND FLOOR DEMOLITION PLANS


PROJECT NUMBER


14457.16 TZHS H101 DRAWING NUMBER

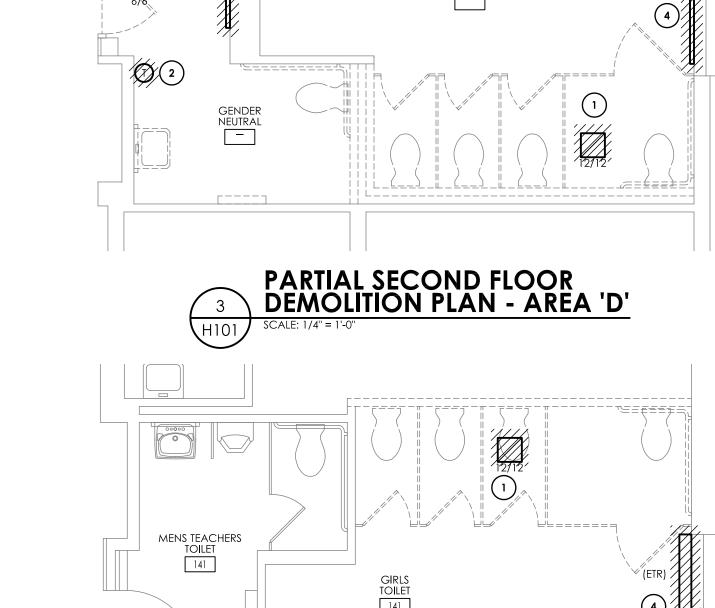

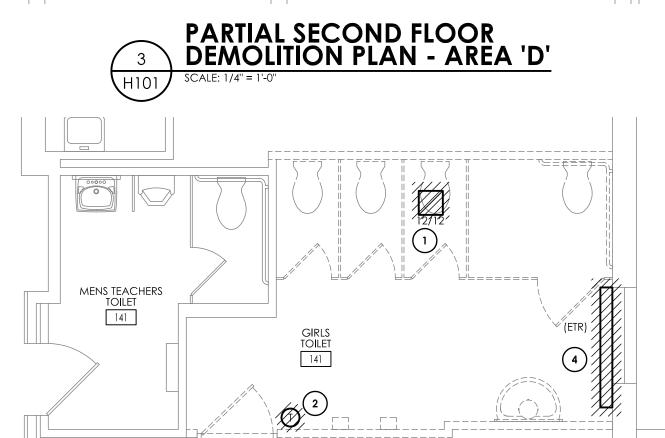



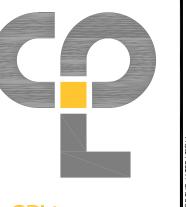

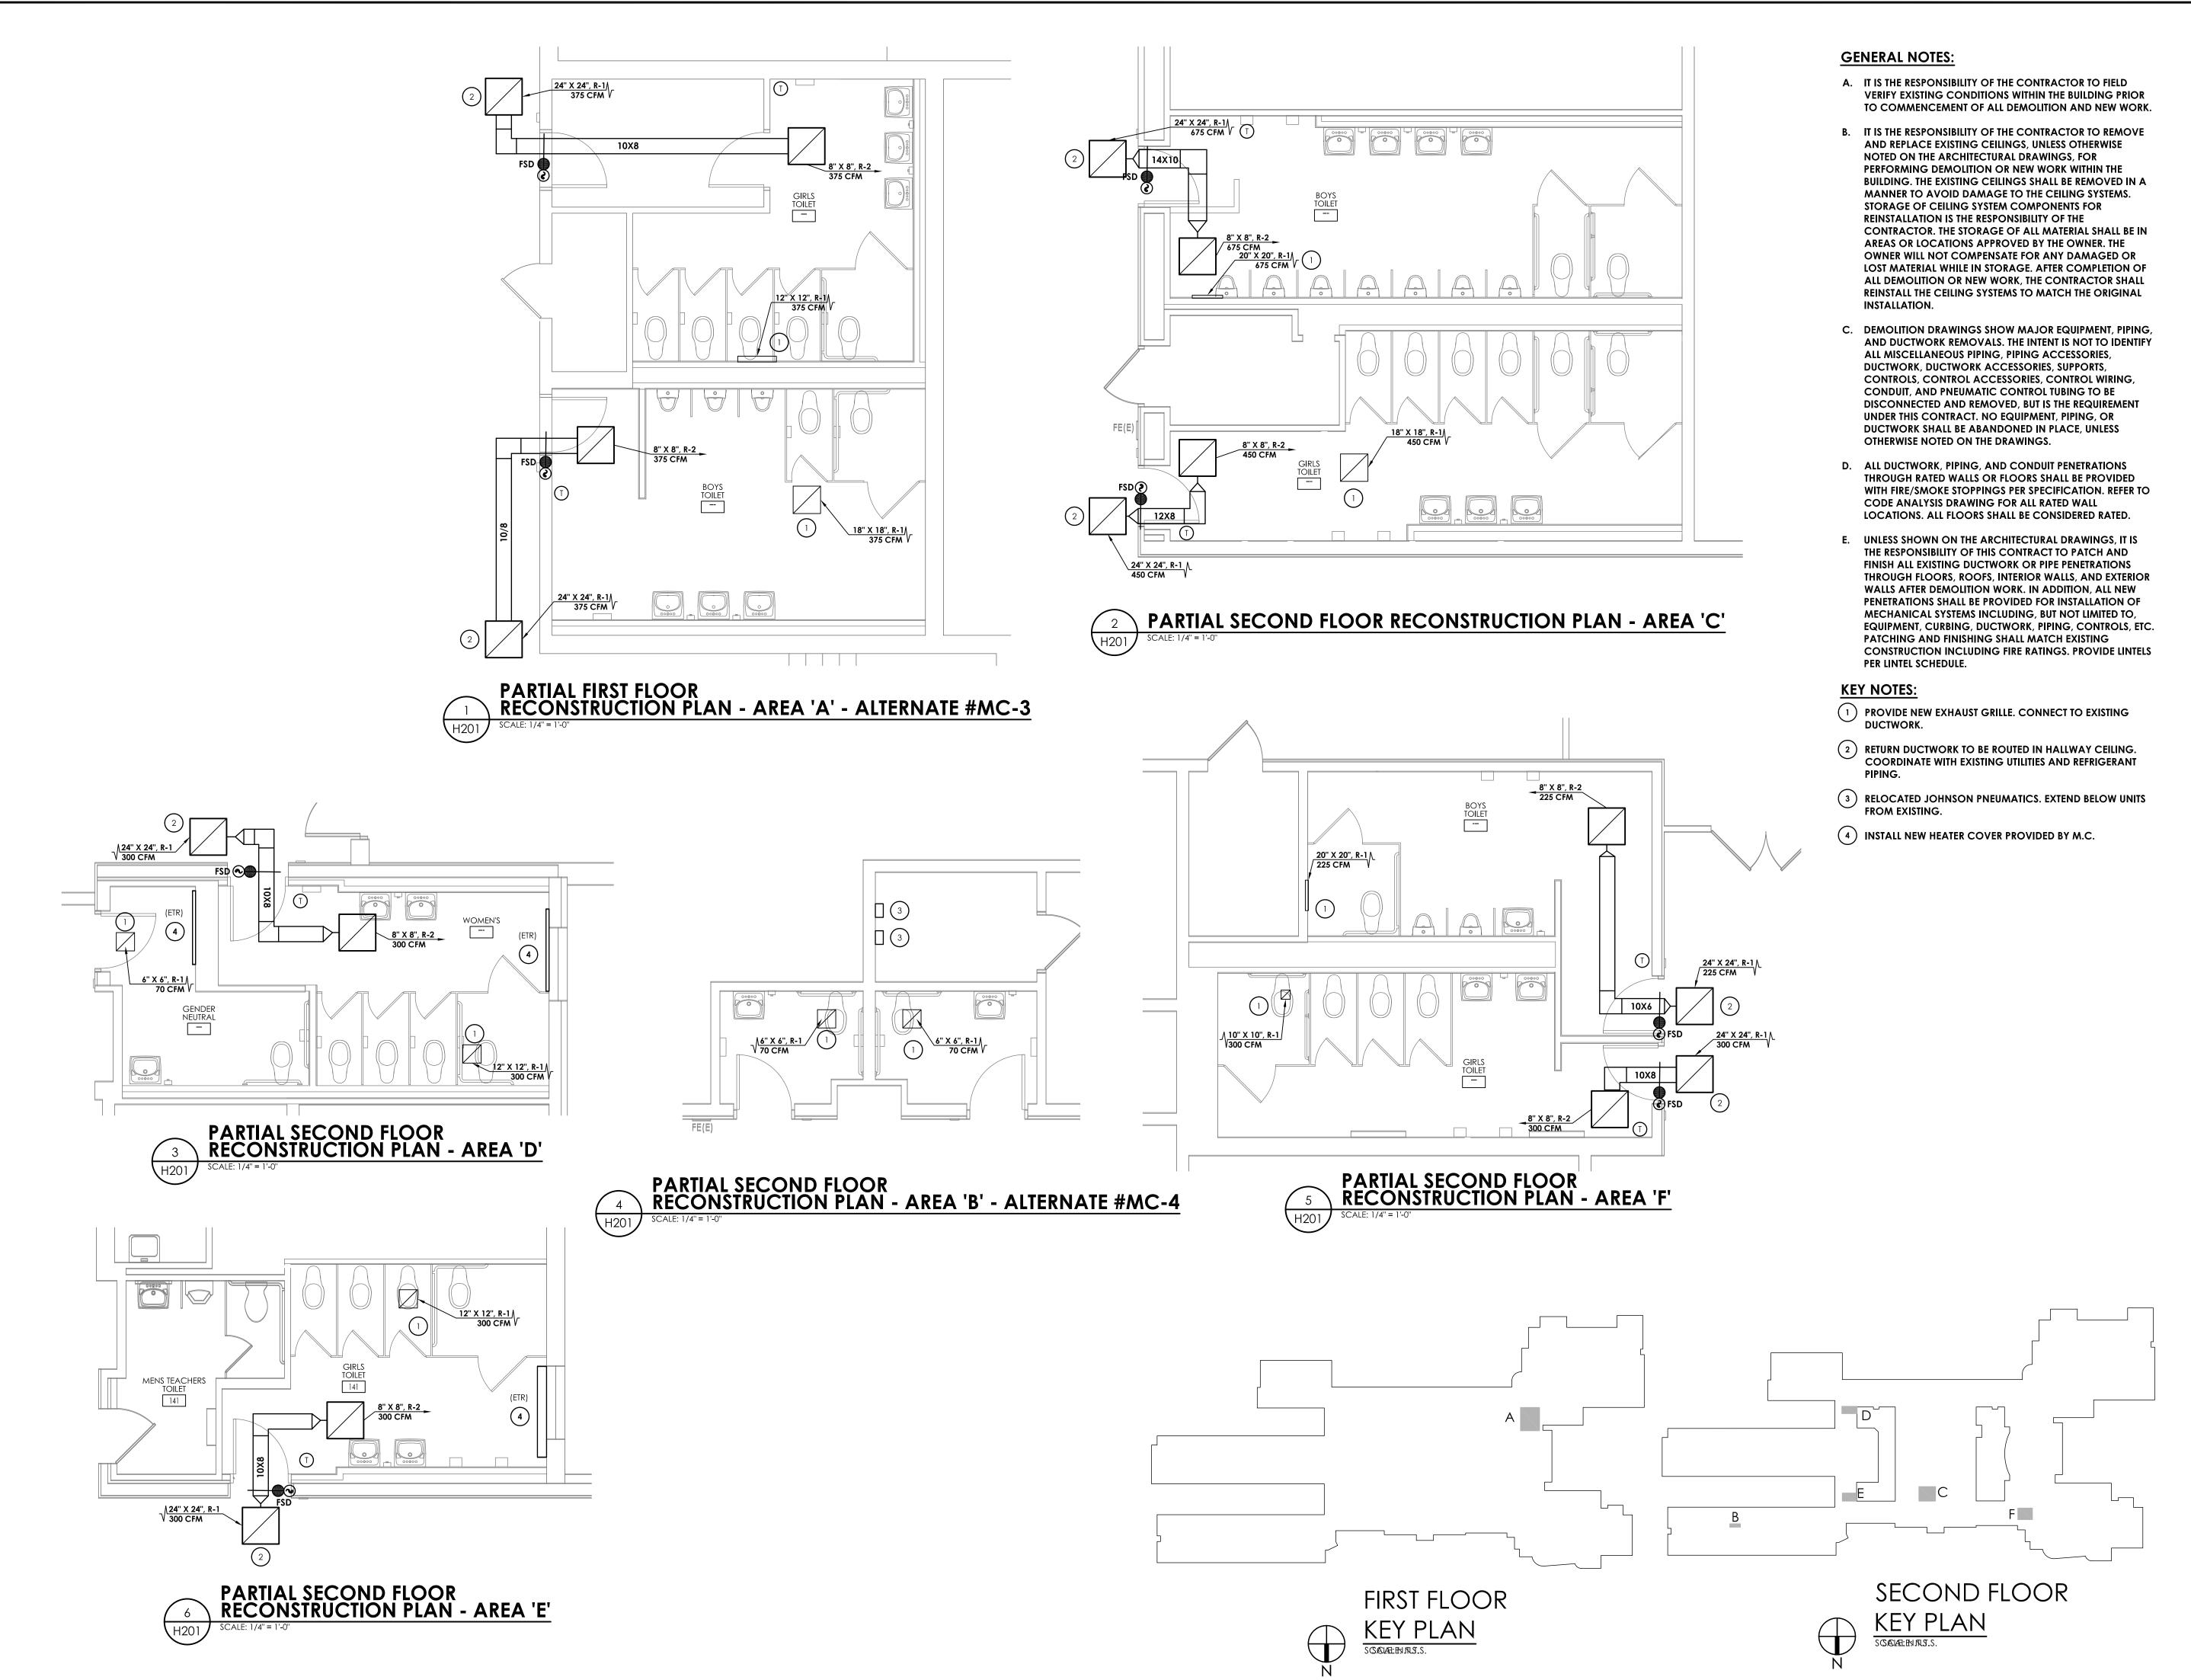

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DATE BY DESCRIPTION

CT 0-021 28 11

CENTRAL SCHOOL DISTRICT CAPITAL IMPROVEMENT PROJECT 2022

160 VAN WYCK RD, BLAUVELT, NY 109

COTTAGE LANE ELEMENTARY - SED# 50-03-01-06-0-013-028

S.O. MIDDLE SCHOOL - SED# 50-03-01-06-0-013-028

TAPPEN ZEE HIGH SCHOOL - SED#50-03-01-06-0-006-031

DATE DRAWN CHEC 10/20/22 KCM JJ SCALE 1/4" = 1'- 0"

SHEET TITLE

TAPPAN ZEE HIGH SCHOOL


FIRST AND SECOND

FLOOR RECONSTRUCTION

PLANS

PROJECT NUMBER

TZHS H201

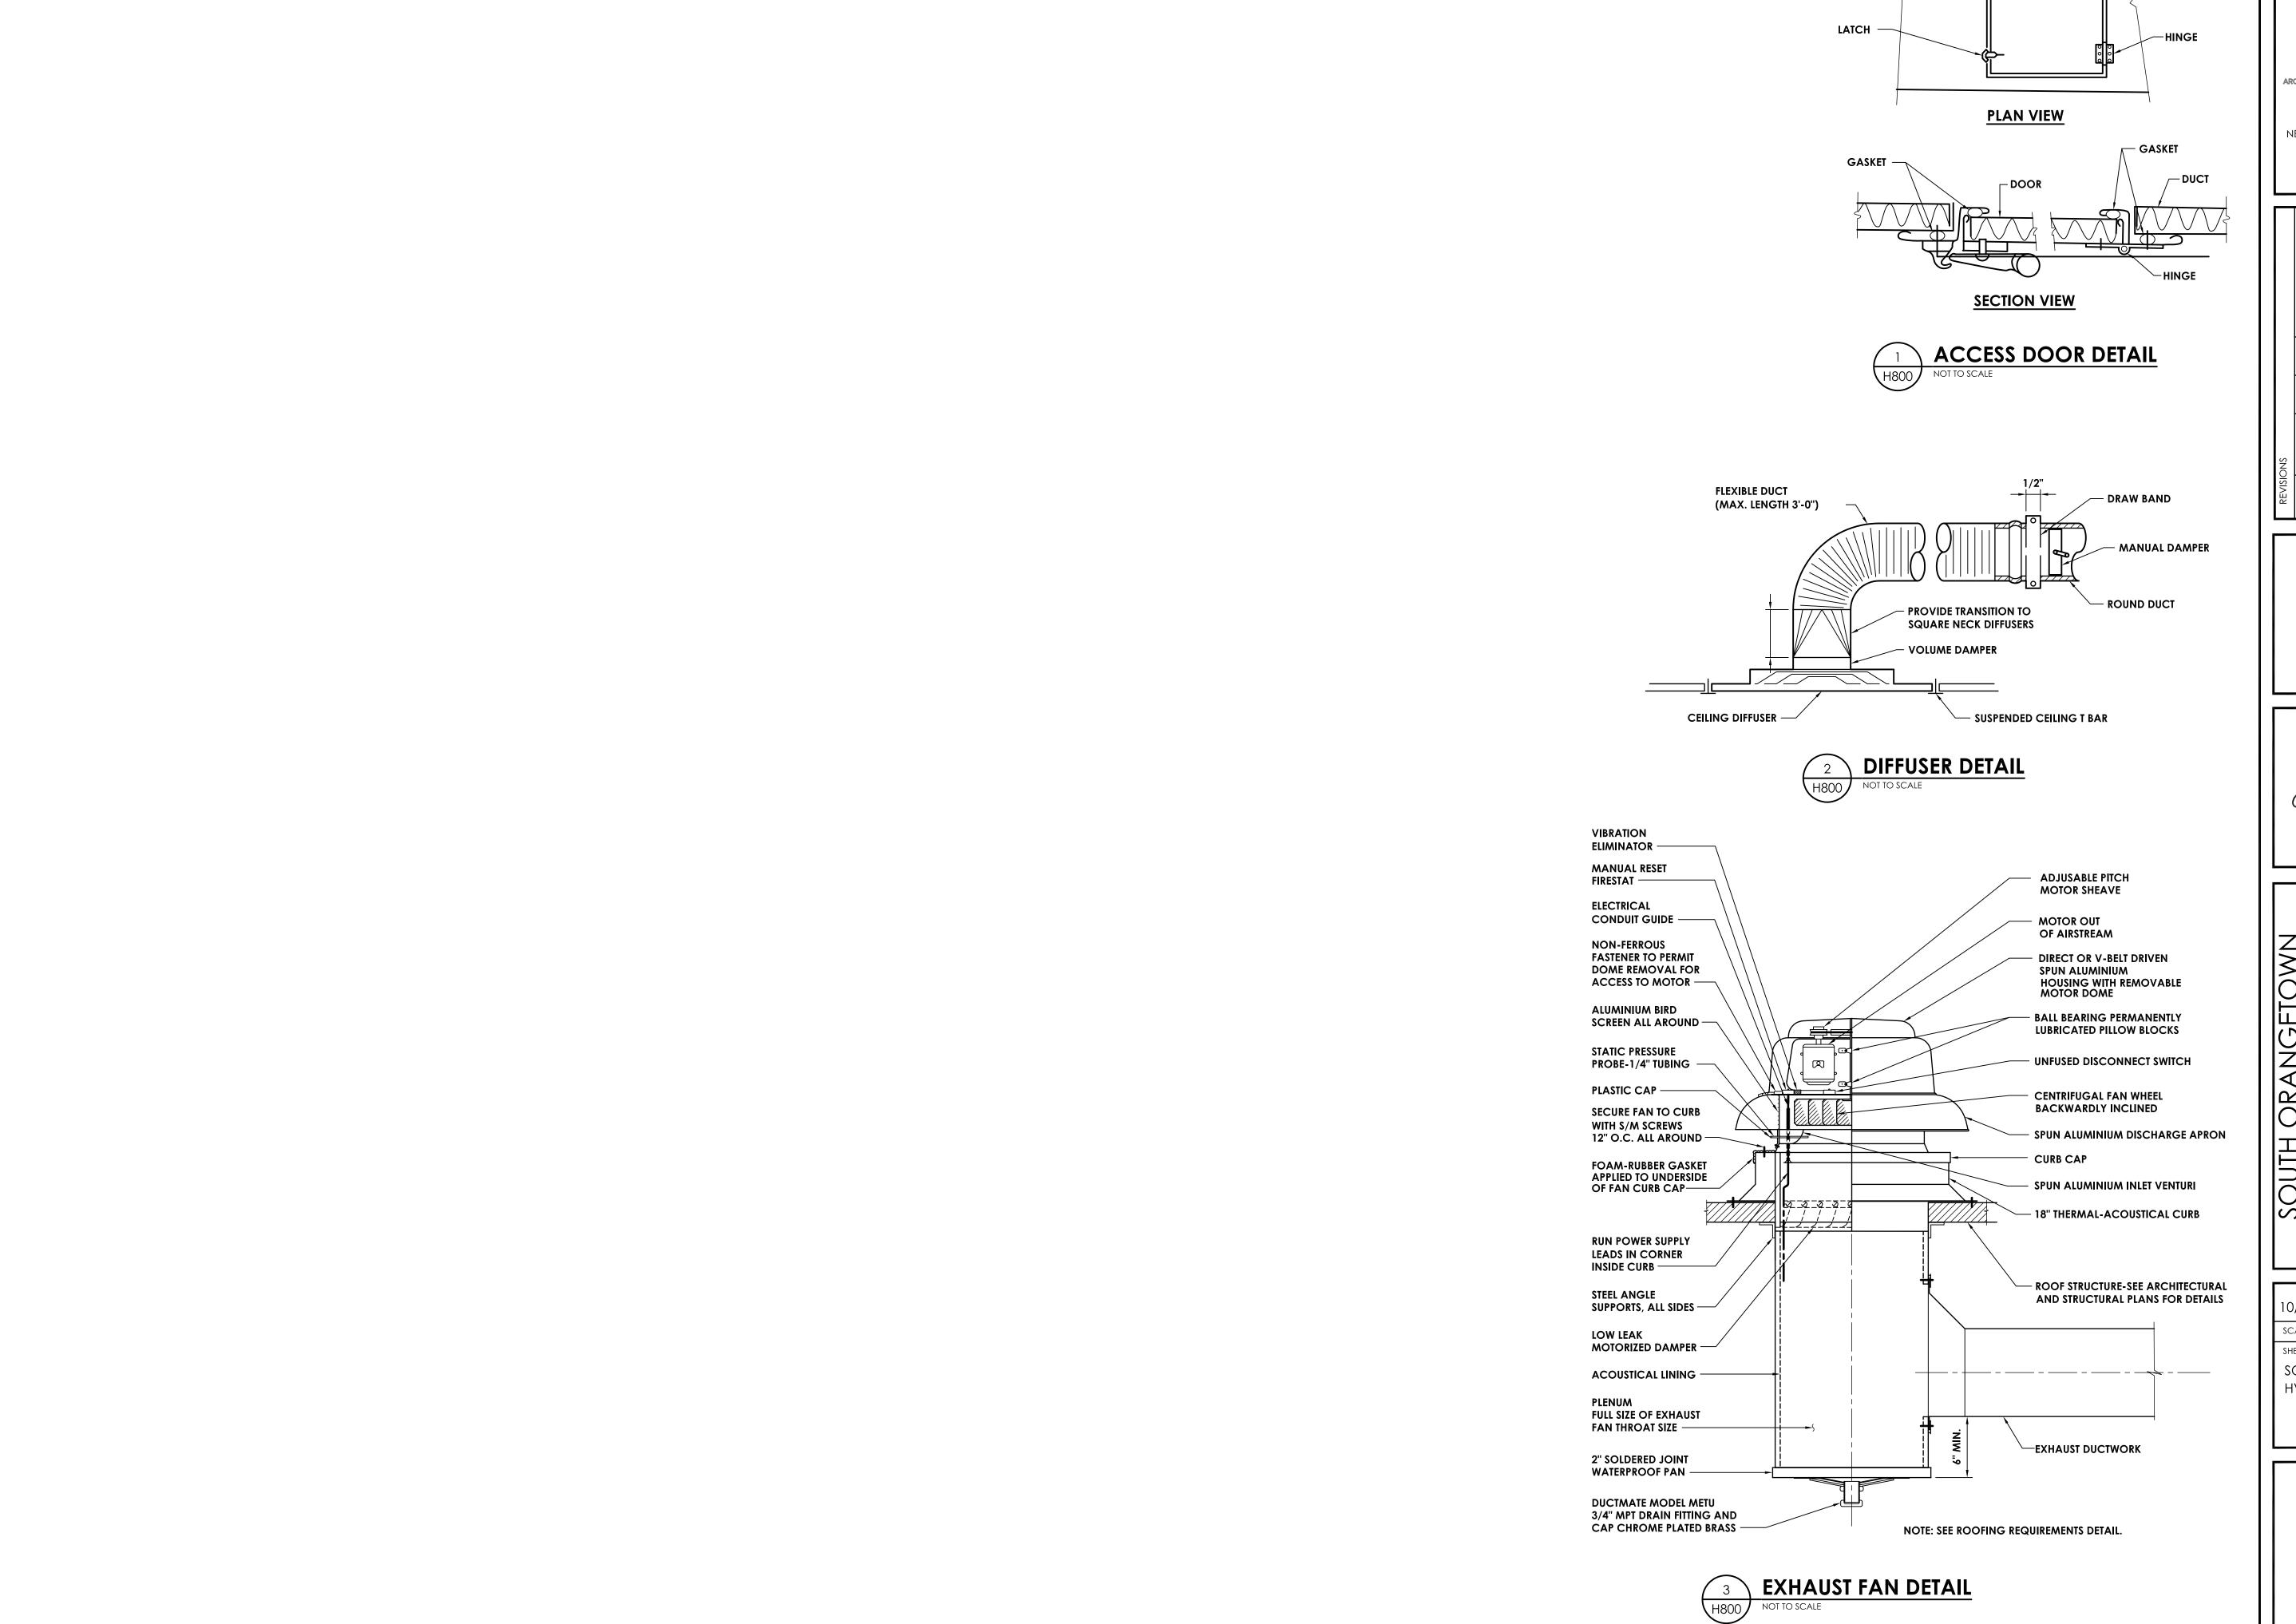


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NO. DATE BY DESCRIPTION





CENTRAL SCHOOL DISTRICT
CAPITAL IMPROVEMENT PROJECT 2022

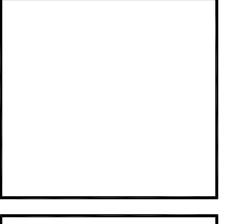160 VAN WYCK RD, BLAUVELT, NY 10913

COTTAGE LANE ELEMENTARY - SED# 50-03-01-06-0-013-028

TAPPEN ZEE HIGH SCHOOL - SED# 50-03-01-06-0-006-031

DATE DRAWN CHECKED
10/20/22 MD JJM

SCALE N.T.S

SHEET TITLE

SOUTH ORANGETOWN
HVAC DETAILS

PROJECT NUMBER

GEN H800 DRAWING NUMBER


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Date last plotted: 10/13/2022 2:55 PM	
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	FAN SCHEDULE																	
MARK	LOCATION	SERVICE	CED/ICE	OFF)//OF	CED/IICE	CED/40E	TYPE	CFM	SP DDM			SP	ELECTRICAL DATA				TYPICAL UNIT MFG	DEMARKO
WARK	LOCATION		IYPE	CFIVI	IN W.G.	RPM -	HP	VOLTS	PHASE	AMPS	& MODEL NO.	REMARKS:						
EF-1	ROOF	TOILETS	DOWNBLAST	150	0.6	1317	1/6	115	1	4.4	GREENHECK GB-097	1,2,3						
REMARKS:	REMARKS: 1. FACTORY MOUNTED AND WIRED DISCONNECT.																	

2. 14" CUBR, HINGED BASE AND BIRD SCREEN.


3. BAROMETRIC RELIEF DAMPER IN CURB.

REGISTERS, GRILLES, AND DIFFUSERS									
MARK	APPLICATION	MATERIAL	TYPE	FINISH	DESIGN EQUIP.	REMARKS			
D-1	SUPPLY	STEEL	LAY-IN	WHITE	PRICE SPD	1			
R-1	RETURN/EA	STEEL	LAY-IN	WHITE	PRICE PDR	1			
R-2	RETURN/EA	STEEL	LAY-IN	WHITE	PRICE 500	1			
REMARKS:	1. PROVIDE WITH L	INE SIZE DAMPER							

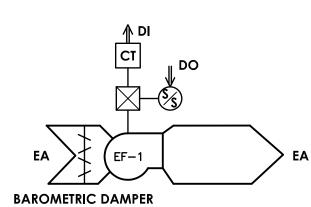



- A. <u>EXHAUST FANS:</u>
 G. OCCUPIED MODE: OPEN DAMPER AND ENABLE FAN AFTER 15-SECOND DELAY.
 B. UNOCCUPIED MODE: DISABLE FAN AND MODULATE DAMPER TO FULL CLOSED POSITION AFTER 15-SECOND DELAY.
- a. FAN FAILS TO RUN AFTER 30 SECONDS OF BEING COMMANDED ON.
 b. FAN FAILS TO STOP AFTER 30 SECONDS OF BEING COMMANDED OFF.



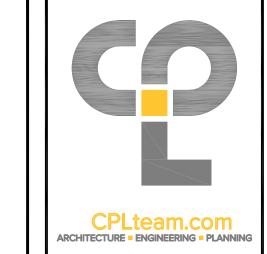

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DATE DRAWN 10/20/22 KCM JJM

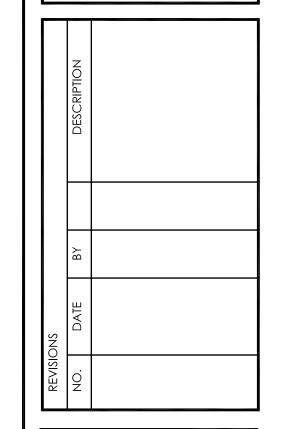SOUTH ORANGETOWN HVAC SCHEDULES & CONTROLS
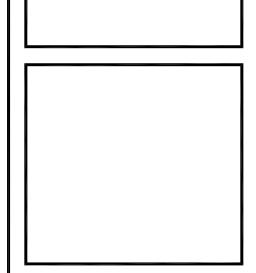
> PROJECT NUMBER 14457.16

> > GEN H900 DRAWING NUMBER

	PLUMBING EQUIPMENT & FIXTURE SCHEDULE									
MARK	FIXTURE	CW	нw	SAN	٧	DESCRIPTION	MODEL NUMBER	REMARKS		
WC-1	WATER CLOSET	1 1/2"	-	4"	2"	WALL MOUNTED WATER CLOSET, ELONGATED BOWL 1.6GPF, SENSOR OPERATED FLUSH VALVE, INSTALLED AT STANDARD HEIGHT, WITH NEW CARRIER.	AMERICAN STANDARD - AFWALL MILLENIUM 2257.660	1		
WC-2	WATER CLOSET, ACCESSIBLE	1/2"	-	4''	2"	WALL MOUNTED WATER CLOSET, ELONGATED BOWL 1.6GPF, SENSOR OPERATED FLUSH VALVE, INSTALLED AT ACCESSIBLE HEIGHT, WITH NEW CARRIER.	AMERICAN STANDARD - AFWALL MILLENIUM 2257.660	1		
LAV-1	LAVATORY, ACCESSIBLE	1/2"	1/2"	1 1/2"	1 1/2"	WALL-HUNG VITREOUS CHINA SINK, FRONT OVERFLOW, D SHAPED BOWL, SELF-DRAINING DECK AREA WITH CONTOURED BACK AND SIDE SPLASH. ACCESSIBLE HEIGHT.	AMERICAN STANDARD - LUCERNE 0355.012 TRUEBRO LAV SHEILD	1		
UR-1	urinal, accessible	3/4"	-	2"	1 1/2"	EXPOSED TOP SPUD URINAL, 2 WALL HANGERS, DIMENSIONS 14 7/6"X14 7/8"X22 8/8", 0.125GPF, SENSOR OPERATED FLUSH VALVE, ADA COMPLIANT	AMERICAN STANDARD - PINTBROOK 6002.001.020 SELECTRONIC FLUSH VALVE MODEL 6063.013.002	1		
FD-1	FLOOR DRAIN	-	-	3"	2"	CAST IRON BODY WITH CLAMP RING, FLANGE, ADJUSTABLE STRAINER FOOR DRAIN WITH FLOOR DRAIN TRAP SEAL	JOSAM COMPANY - 30000-A RECTORSEAL - SURE SEAL	-		
HB-1	HOSE BIBB	3/4"	-	-	-	KEY OPERATED, MODERARE CLIMATE CONCEALED OUTLET, FLUSH MOUNTED BOX WITH COVER INTEGRAL VACUMN BREAKER WITH HOSE CONNECTION	ZURN - Z1330	-		

REMARKS

1. ALL ACCESSIBLE EQUIPMENT/FIXTURES TO BE INSTALLED PER ADA REQUIREMENTS.

VINYLCLAD FINISH TO BE SELECTED BY ARCHITECT

GENERAL PLUMBING EQUIPMENT & FIXTURE COMMENT

PLUMBING CONTRACTOR SHALL PROVIDE ALL RISERS, CARRIERS, P-TRAPS, STOPS, STRAINERS, TAIL PIECES, DRAINS, ETC. REQUIRED TO HAVE A COMPLETE INSTALLATION.

2' DIAMETER DEPRESSION PROVIDE GRAVEL **5" RECESSED GRATE** MORTAR FILL — -ADJUST COLLAR TO MATCH FINISHED FLOOR FILL ABOVE WEEPHOLES — FLOOR DRAIN WITH SHEET VINYL FINISHED FLOOR LEVEL ADJUSTABLE COLLAR -WATERPROOFING MEMBRANE WITH BONDABLE SURFACE NOBLESEAL TS OR EQUAL— TILE MORTAR -CHIP OUT DECK FOR 2'DIA. DEPRESSION-SEAL FULL PERIMETER —4" CONCRETE DECK, TYPICAL OF FLANGE TO DECK— NOTCH DECK AS NEEDED FOR FLOOR DRAIN SCREW CASING CORE DECK 5 1/2"Ø RECESSED FLOOR DRAIN INSTALLED IN EXISTING DECK

PIPING I	<u>.EGEND</u>		FIXTURES & FITTINGS	LEGEND	
xx	PIPING BELOW GRADE	—— I OI——	TEE OUTLET - UP	co I———	CLEAN OUT
XX	EXISTING PIPING		TEE OUTLET - DOWN	FCO ⊩	FLOOR CLEAN OUT
CW 	COLD WATER		CONNECTION - TOP	wco ⊩	WALL CLEAN OUT
	HOT WATER	O I	ELBOW - TURNED UP	НВ / 	HOSE BIBB
HWR 	HOT WATER RECIRCULATING	C 	ELBOW - TURNED DOWN	NFHB /	NON FREEZE HOSE BIBB
SAN	SANITARY SEWER	E	PIPE CAP	FD O	FLOOR DRAIN
ST	STORM	——————————————————————————————————————	UNION	F5	FLOW SWITCH
LPG	PROPANE GAS	——————————————————————————————————————	FLANGE	PS AC	PRESSURE SWITCH
FOS	FUEL OIL SUPPLY	————	BALL VALVE		AQUASTAT
FOR	FUEL OIL RETURN	———⊗———	BALANCING VALVE	<u> </u>	PRESSURE GAUGE
—— FP ———	FIRE PROTECTION/SPRINKLER		CHECK VALVE	Д	THERMOMETER
v	VENT	——————————————————————————————————————	BUTTERFLY VALVE		STRAINER
/////////////////////////////////////	PLUMBING TO BE REMOVED		PLUG VALVE	~ ~ ~ ~ ~ ~ ~ ~ ~ ~ ~ ~ ~ ~ ~ ~ ~ ~ ~	INLINE PUMP
WH-A	WATER HEATER ZONE ONE	₽	PRESSURE RELIEF VALVE		WATER HAMMER ARRESTER
WH-B	WATER HEATER ZONE TWO	Å [™]	TEMPERATURE-PRESSURE RELIEF VALVE	<u></u>	
EXP	EXPANSION	—— ———————————————————————————————————	PRESSURE REDUCING VALVE	RPZ	REDUCED PRESSURE ZONE BACK FLOW PREVENTER
ETR	EXISTING TO REMAIN	── ₩──	COMBO ISOLATION, CHECK, BALANCE	DCV	DOUBLE CHECK VALVE ASSEMBLY
		——————————————————————————————————————	GAS PRESSURE REGULATOR	×	SPRINKLER HEAD

GENERAL NOTES:

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POINT OF CONNECTION

POINT OF REMOVAL



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NEWBURGH, NEW YORK 12550

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CENTRAL SCHOOL DISTRICT
CAPITAL IMPROVEMENT PROJECT 2022
160 VAN WYCK RD, BLAUVELT, NY 10913
COTTAGE LANE ELEMENTARY - SED# 50-03-01-06-0-010-021
S.O. MIDDLE SCHOOL - SED# 50-03-01-06-0-013-028
TAPPEN ZEE HIGH SCHOOL - SED#50-03-01-06-0-006-031

DATE	DRAWN	CHECKE
10/20/22	KCM	JJM
scale N.T	ſ.S.	•
SHEET TITLE		

SHEET TITLE
PLUMBING LEGENDS,
ABBREVIATIONS, NOTES,
DETAILS AND SCHEDULES

PROJECT NUMBER

GEN PO01 DRAWING NUMBER

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ARCHITECTURE = ENGINEERING = PLANNING

GENERAL NOTES:

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NO. DATE BY DESCRIPTION

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CENTRAL SCHOOL DISTRICT
CAPITAL IMPROVEMENT PROJECT 2022
SO VAN WYCK RD, BLAUVELT, NY 10913
S.O. MIDDLE SCHOOL - SED# 50-03-01-06-0-013-028
TAPPEN ZEE HIGH SCHOOL - SED# 50-03-01-06-0-031

DATE DRAWN CHECT 10/20/22 KCM JJN SCALE 1/4"=1"-0"

CLE TOILET ROOMS-PLUMBING DEMOLITION
& NEW WORK PLAN.

PROJECT NUMBER

CLES
P201

DRAWING NUMBER


1. FIELD VERIFY EXISTING LOCATIONS OF EXISTING HW, CW, SAN, AND VENT PIPING.


KEY REMOVAL NOTES:

- REMOVE EXISTING URINAL, HW, CW, SAN, AND VENT PIPING. REMOVE PIPING BACK TO POINTS INDICATED. REMOVE ADDITIONAL ABANDONED URINALS/PIPING IN CHASE.
- REMOVE EXISTING WATER CLOSET, HW, CW, SAN, AND VENT PIPING. REMOVE PIPING BACK TO POINTS INDICATED. REMOVE CARRIER AND PREPARE FOR NEW JUSTIFICATION. PREPARE PIPING FOR NEW VALVES AND CONNECTION.
- REMOVE EXISTING LAVATORY, HW, CW, SAN, AND VENT PIPING. REMOVE PIPING BACK TO POINTS INDICATED. REMOVE CARRIER AND PREPARE FOR NEW CONNECTION. PREPARE PIPING FOR NEW VALVES AND CONNECTION.



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FIRST FLOOR

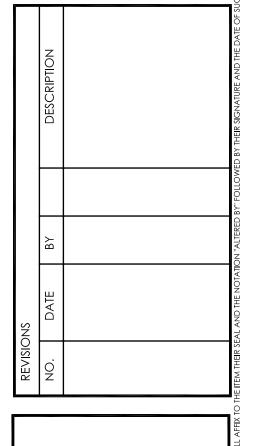GROUND FLOOR

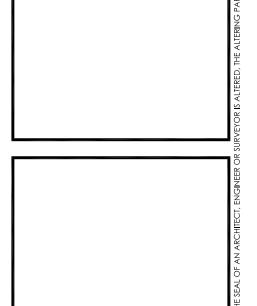KEY PLAN

KEY PLAN


SCALE: N.T.S.

10/20/22 KCM SCALE 1/4''=1'-0''


SOUTH ORANGETOWN MIDDLE SCHOOL PLUMBING DEMOLITION PLANS


PROJECT NUMBER 14457.16

SOMS DRAWING NUMBER

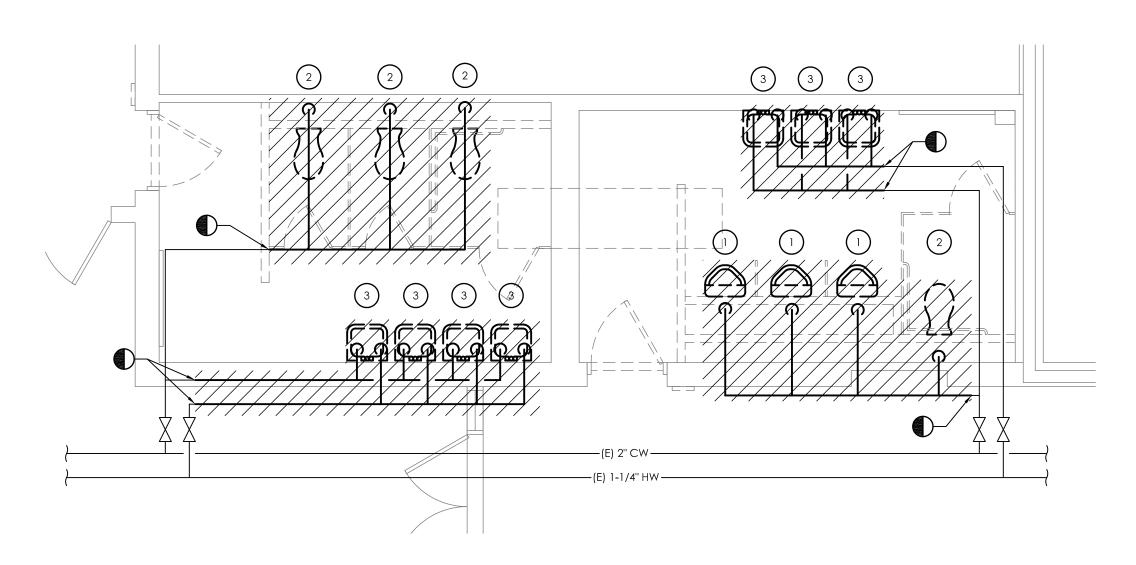


PARTIAL GROUND FLOOR
DOMESTIC DEMOLITION PLAN - AREA 'A' - ALTERNATE #PC-1

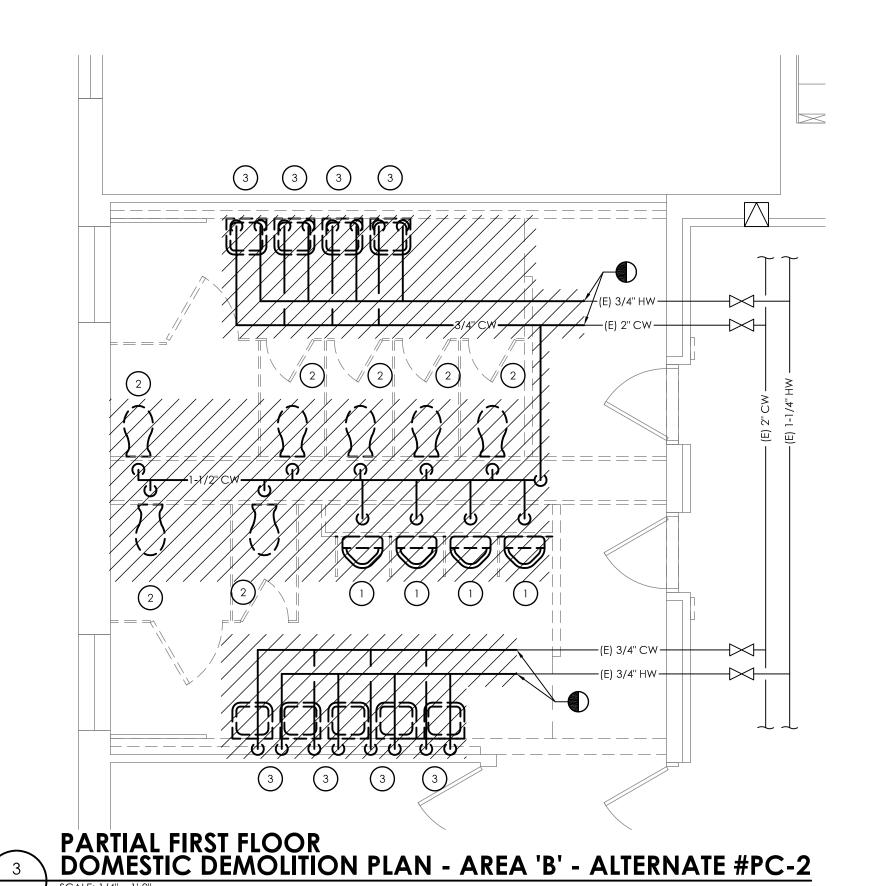

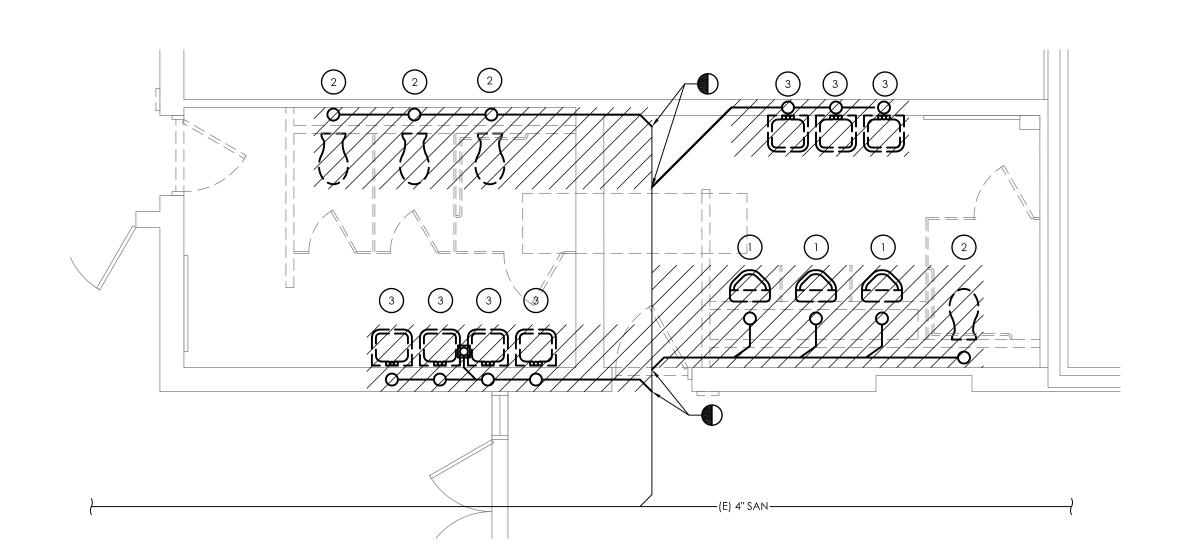

PARTIAL GROUND FLOOR
SANITARY DEMOLITION PLAN - AREA 'A' - ALTERNATE #PC-1

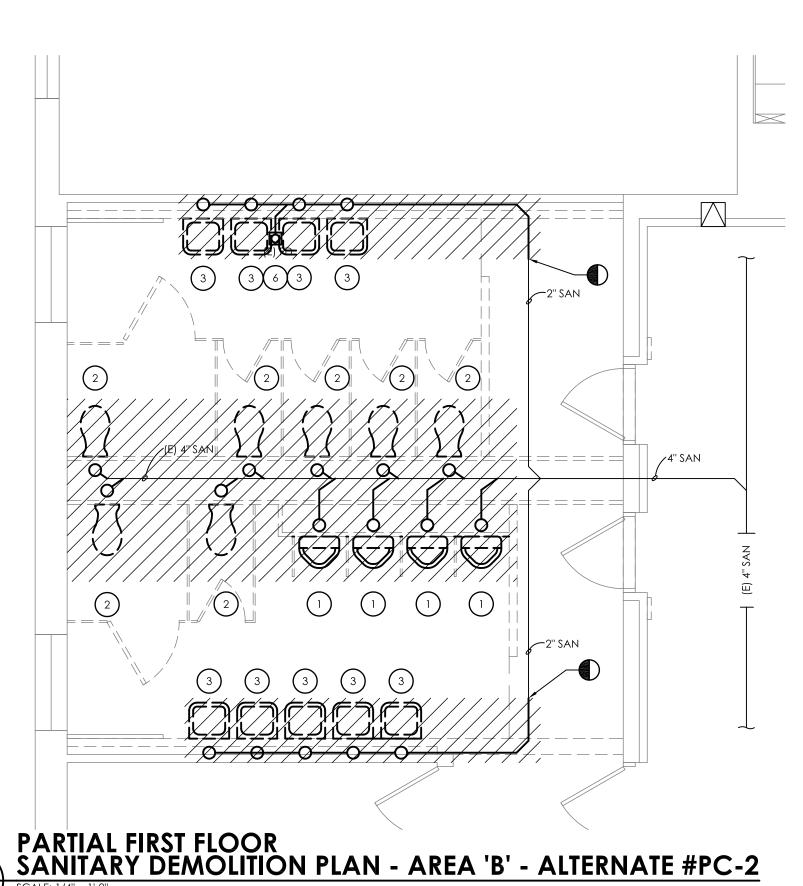



KEY NOTES:

PROVIDE NEW WATER CLOSET. CONNECT TO NEW CW PIPING.

2 PROVIDE NEW URINAL. CONNECT TO NEW CW PIPING.

3 PROVIDE NEW LAVATORY. CONNECT TO NEW HW/CW PIPING.

(4) CONNECT TO EXISTING HW/CW PIPING IN CEILING.


5 PROVIDE NEW WATER CLOSET. EXTEND EXISTING SANITARY AND VENT PIPING. SAW CUT SLAB AS NEEDED TO COMPLETE WORK. FIELD VERIFY EXISTING VENT LOCATION

PROVIDE NEW URINAL. EXTEND EXISTING SANITARY AND VENT PIPING. SAW CUT SLAB AS NEEDED TO COMPLETE WORK. FIELD VERIFY EXISTING VENT LOCATION AND SIZE.

PROVIDE NEW LAVATORY. EXTEND EXISTING SANITARY AND VENT PIPING. SAW CUT SLAB AS NEEDED TO COMPLETE WORK. FIELD VERIFY EXISTING VENT LOCATION AND SIZE.


8 FIELD VERIFY SANITARY PIPING SLOPE AND FLOW DIRECTION.

FIELD VERIFY BEST LOCATION FOR FLOOR DRAIN. LOCATE IN LOW SPOT OR LOCATION THAT FLOOR PITCHES TO. COORDINATE WITH FLOOR TILE.

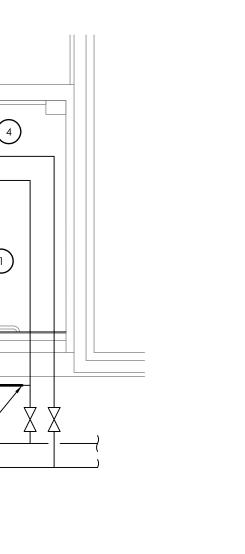


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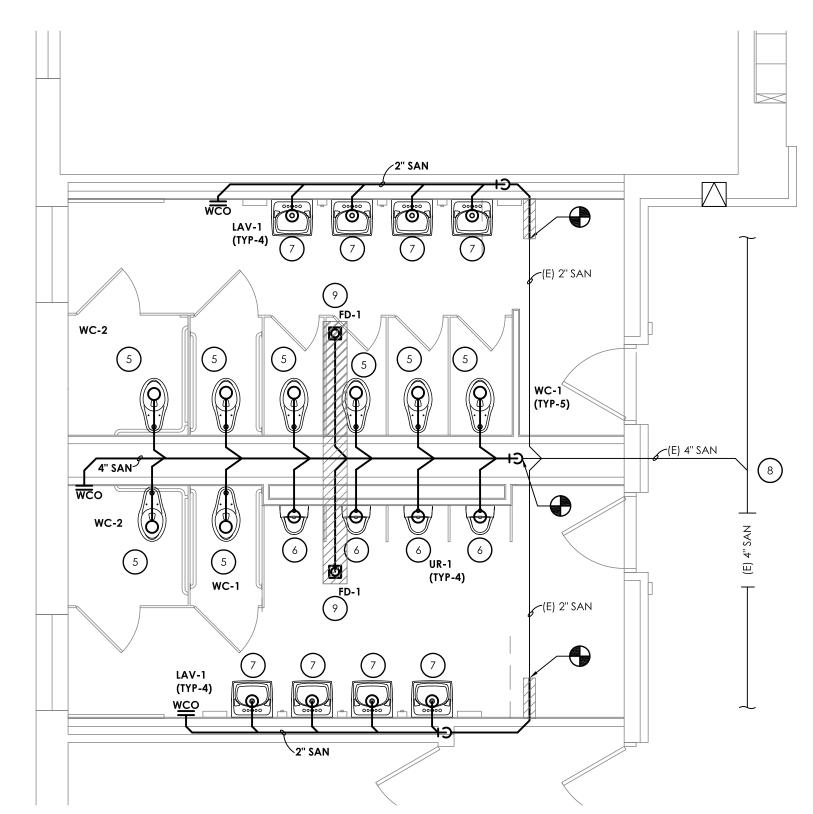
PARTIAL GROUND FLOOR DOMESTIC PLUMBING PLAN - AREA 'A' - ALTERNATE #PC-1 P201 SCALE: 1/4" = 1'-0"




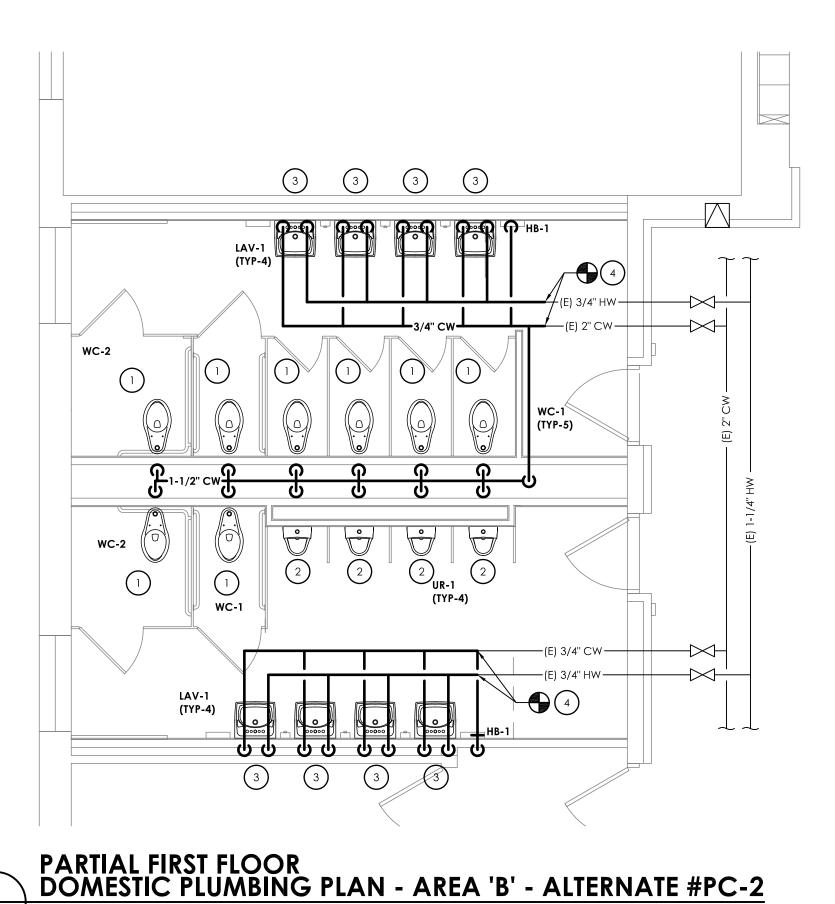

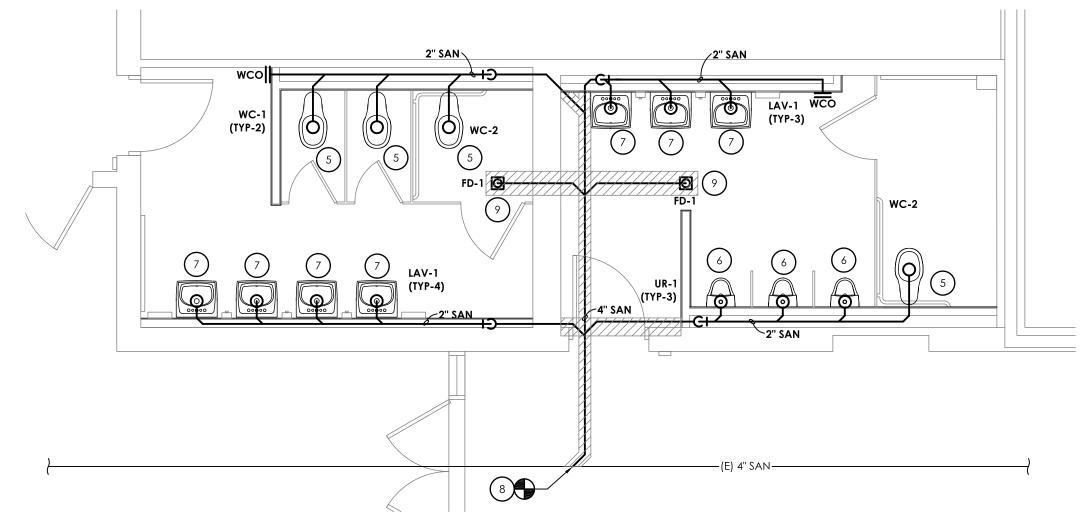


PARTIAL GROUND FLOOR SANITARY PLUMBING PLAN - AREA 'A' - ALTERNATE #PC-1




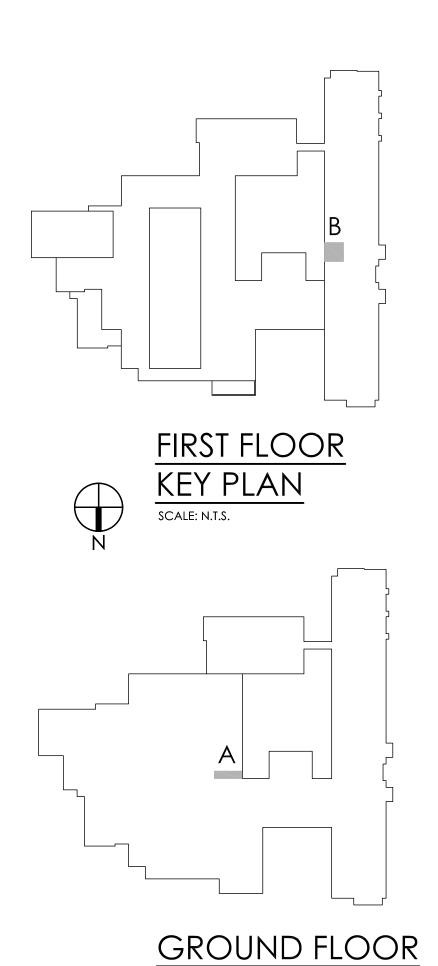


KEY PLAN

SCALE: N.T.S.

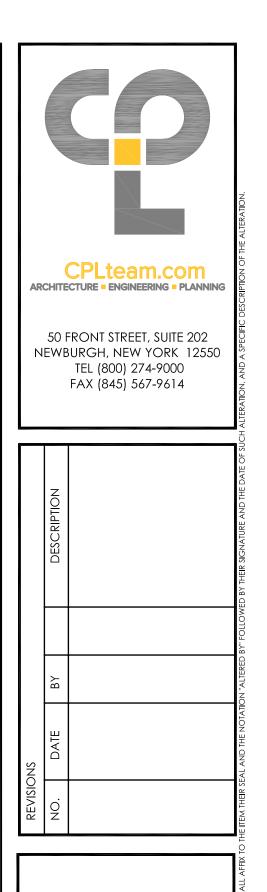


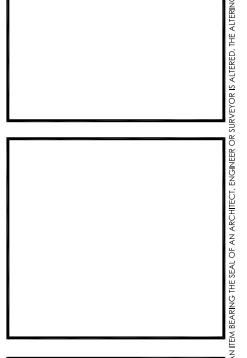




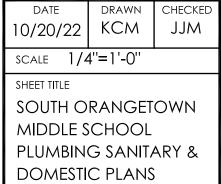

PROJECT NUMBER 14457.16

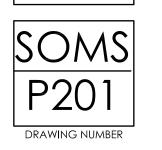

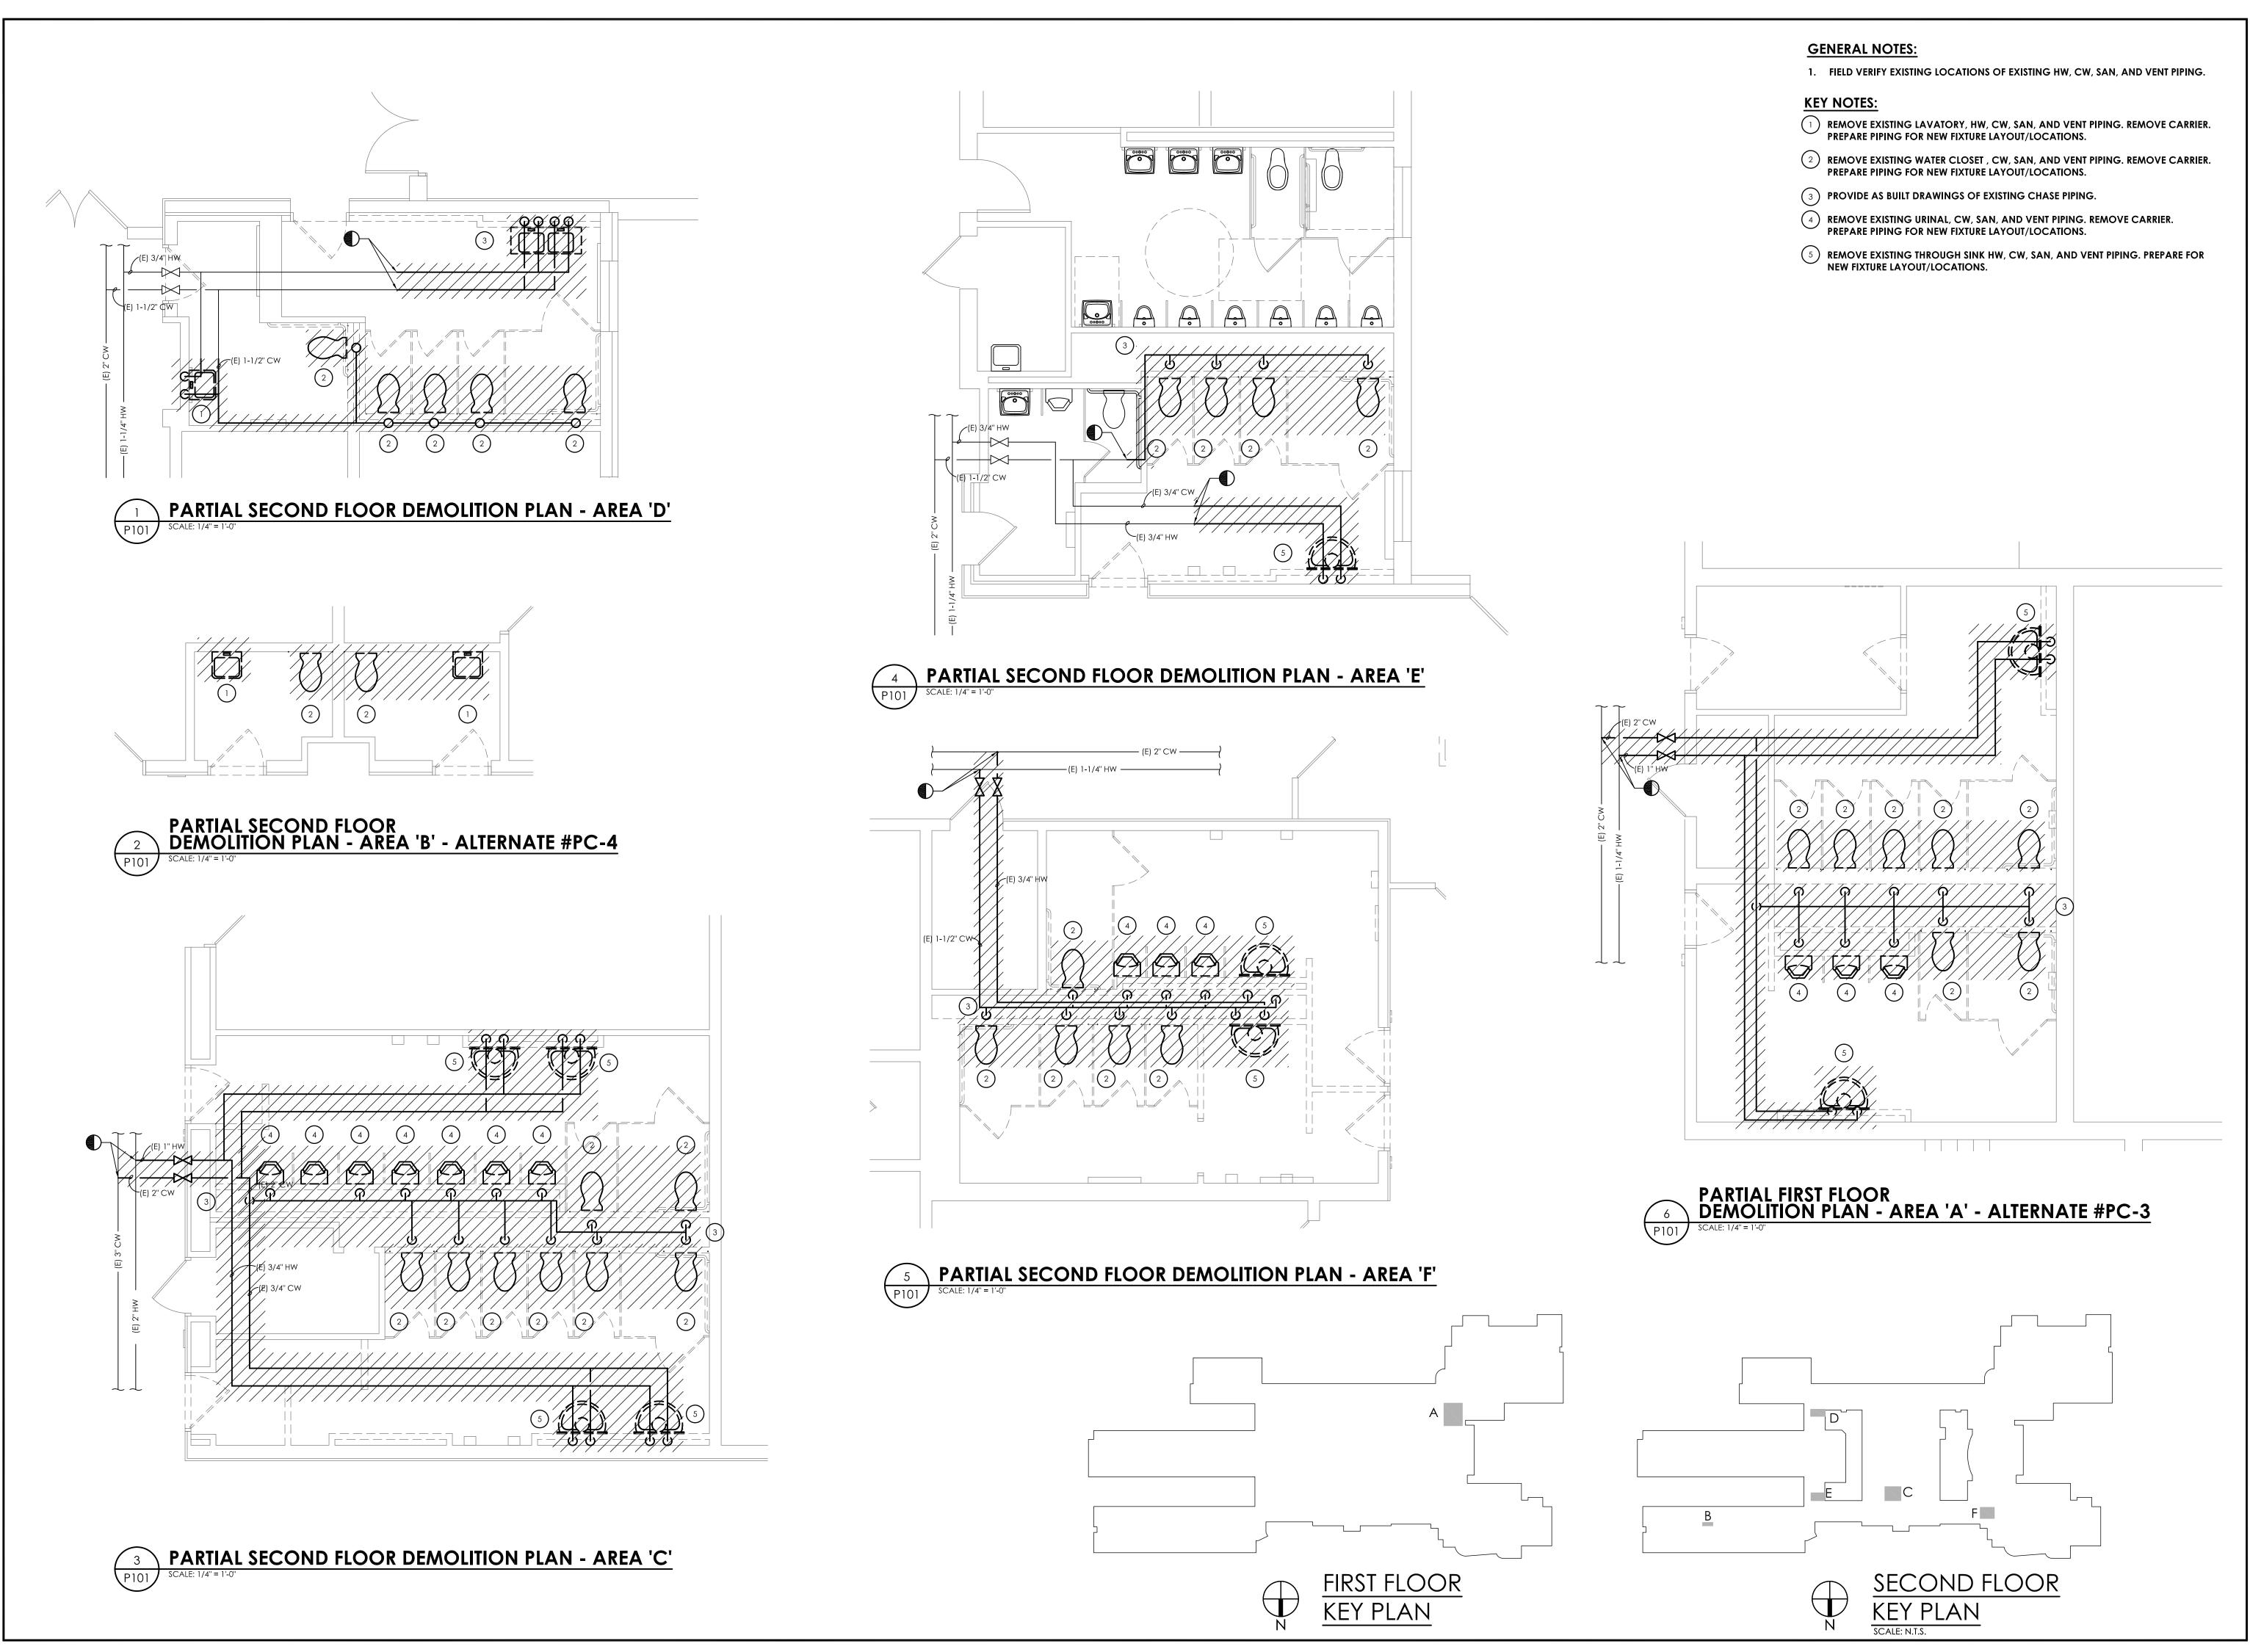

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NO. DATE BY DESCRIPTION

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CENTRAL SCHOOL DISTRICT
CAPITAL IMPROVEMENT PROJECT 2022
160 VAN WYCK RD, BLAUVELT, NY 1091
COTTAGE LANE ELEMENTARY - SED# 50-03-01-06-0-010-02
S.O. MIDDLE SCHOOL - SED# 50-03-01-06-0-013-028
TAPPEN ZEE HIGH SCHOOL - SED#50-03-01-06-0-0006-031

DATE DRAWN CHECKE
10/20/22 KCM JJM

SCALE 1/4"=1'-0"

SHEET TITLE
TZ HIGH SCHOOL

SCALE 1/4 = 1 -0

SHEET TITLE


TZ HIGH SCHOOL

PLUMBING DEMOLITION


PLAN

TZHS
P101


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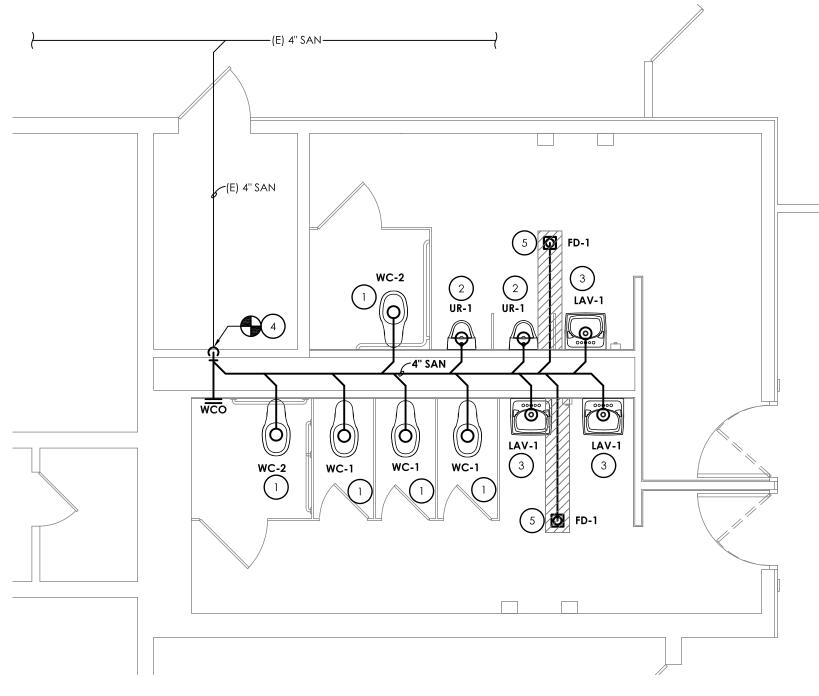


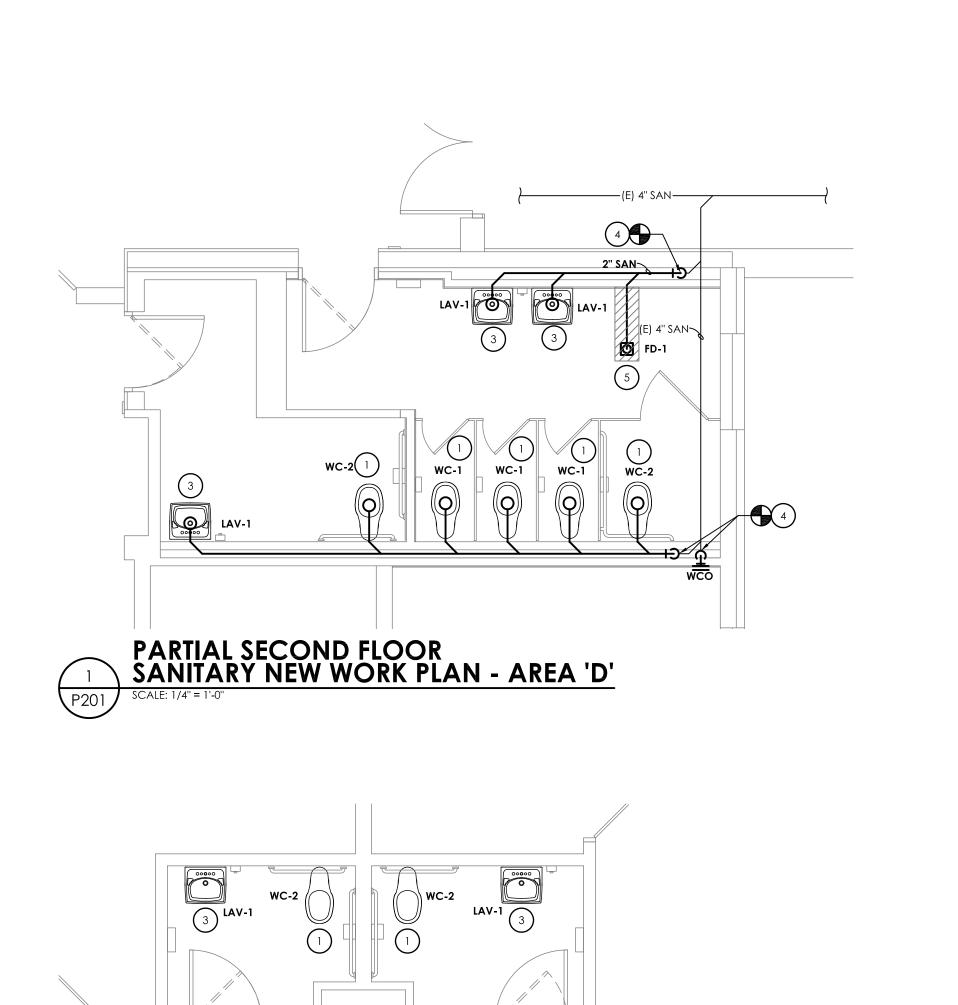


PARTIAL SECOND FLOOR
SANITARY NEW WORK PLAN - AREA 'C'

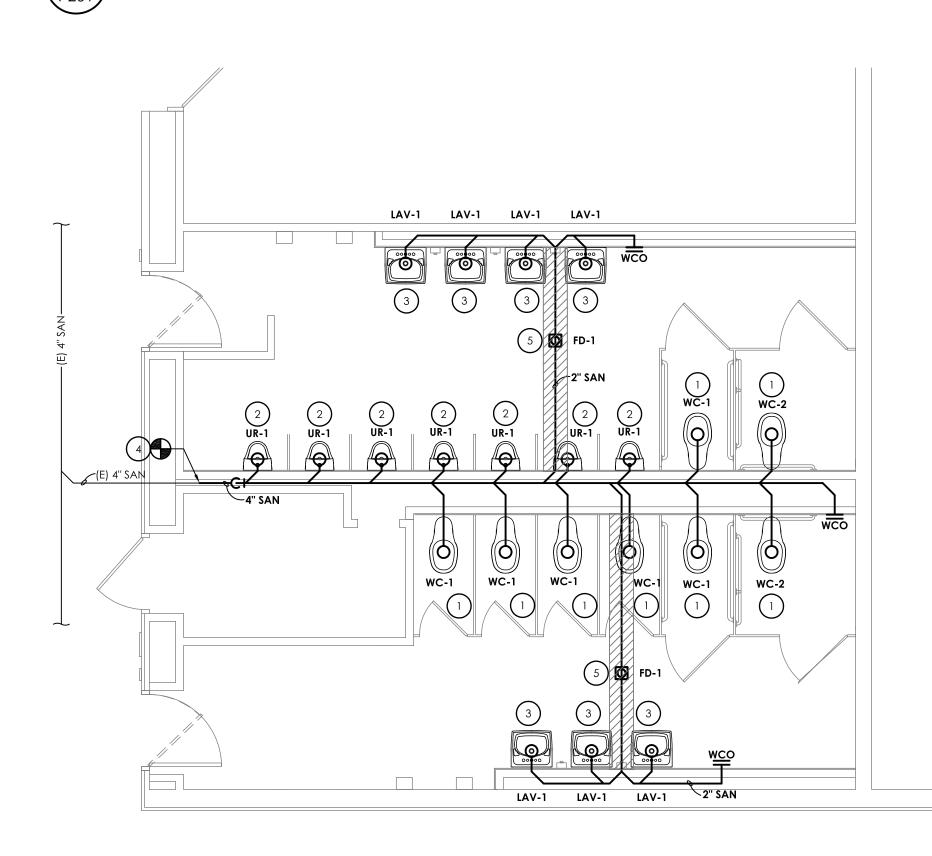

PARTIAL SECOND FLOOR
SANITARY NEW WORK PLAN - AREA 'E'

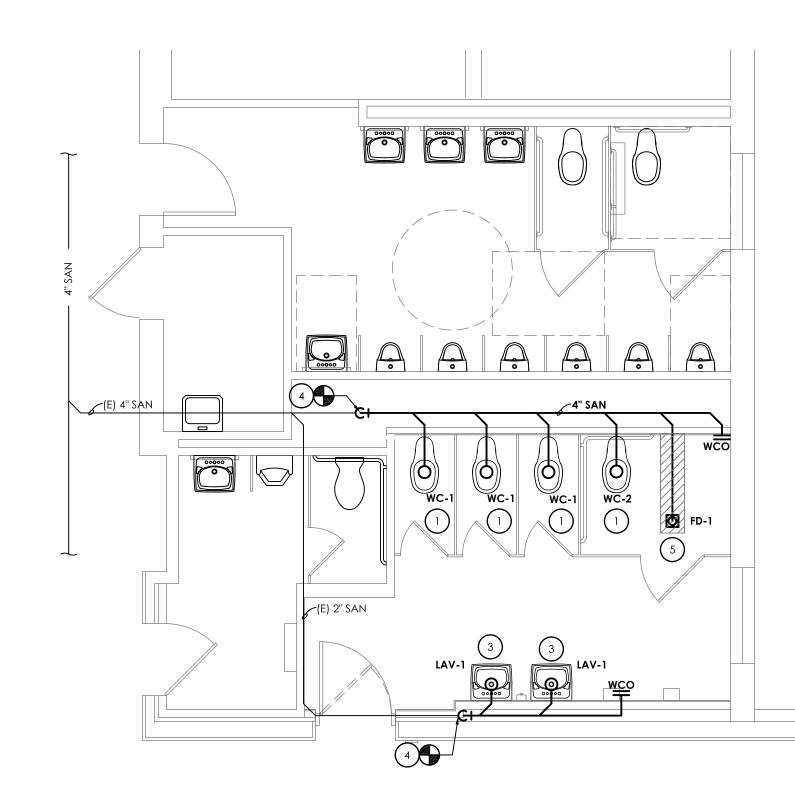

PARTIAL SECOND FLOOR
SANITARY NEW WORK PLAN - AREA 'F'

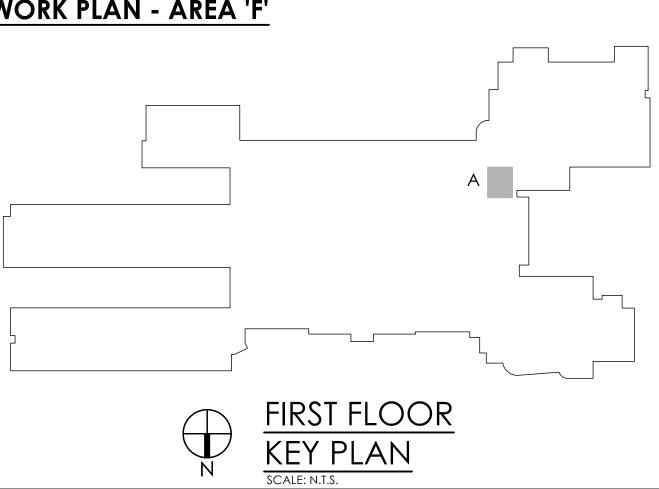

SECOND FLOOR
KEY PLAN
SCALE: N.T.S.

KEY NOTES:


PROVIDE NEW WATER CLOSET. EXTEND EXISTING SANITARY AND VENT PIPING. SAW CUT SLAB AS NEEDED TO COMPLETE WORK. FIELD VERIFY EXISTING VENT LOCATION AND SIZE.

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PROVIDE NEW LAVATORY. EXTEND EXISTING SANITARY AND VENT PIPING. SAW CUT SLAB AS NEEDED TO COMPLETE WORK. FIELD VERIFY EXISTING VENT LOCATION AND SIZE.


CONNECT TO EXISTING PIPING AND FIELD VERIFY SANITARY PIPING SLOPE AND FLOW DIRECTION.


5 FIELD VERIFY BEST LOCATION FOR FLOOR DRAIN. LOCATE IN LOW SPOT OR LOCATION THAT FLOOR PITCHES TO. COORDINATE WITH FLOOR TILE.

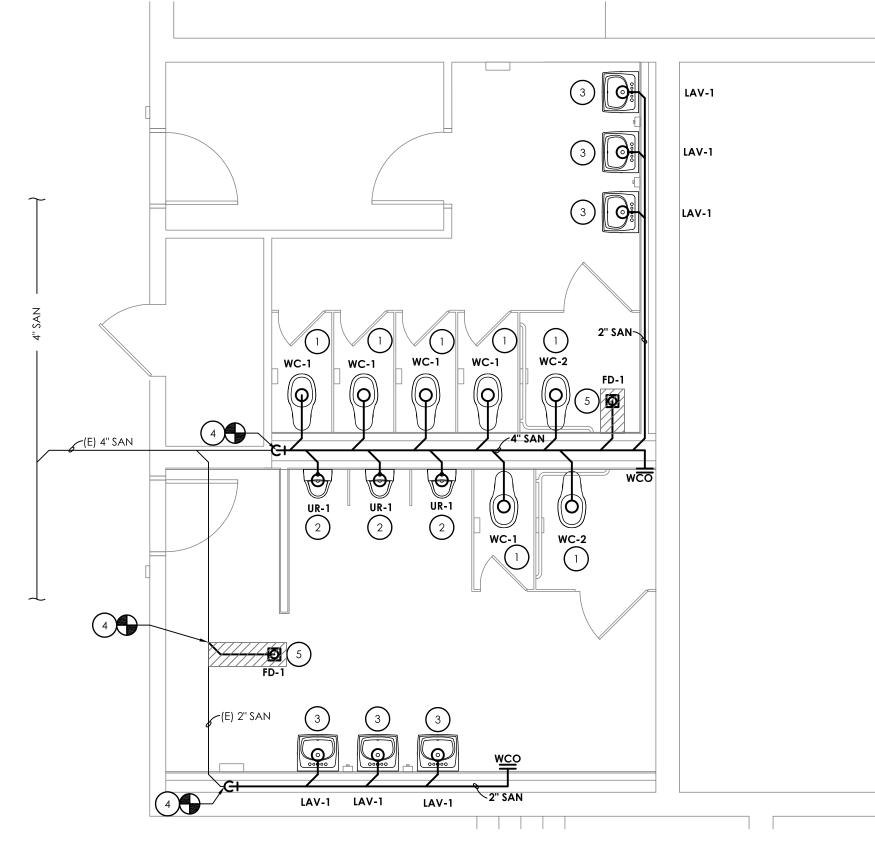

PARTIAL FIRST FLOOR SANITARY NEW WORK PLAN - AREA 'A' - ALTERNATE #PC-3 CPLteam.com
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CENTRAL SCHOOL DISTRICT
CAPITAL IMPROVEMENT PROJECT 2022
160 VAN WYCK RD, BLAUVELT, NY 10913
COTTAGE LANE ELEMENTARY - SED# 50-03-01-06-0-010-021
S.O. MIDDLE SCHOOL - SED# 50-03-01-06-0-013-028
TAPPEN ZEE HIGH SCHOOL - SED#50-03-01-06-0-006-031

DATE DRAWN CHECKED
10/20/22 KCM JJM

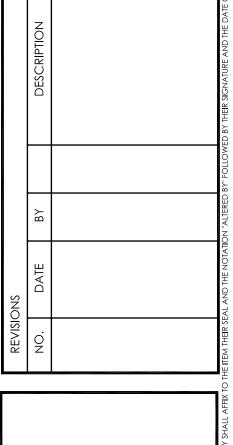SCALE 1/4"=1'-0"

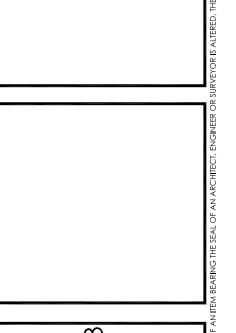SHEET TITLE


TZ HIGH SCHOOL

TZ HIGH SCHOOL
PLUMBING SANITARY &
DOMESTIC PLANS

14457.16

TZHS
P201

DRAWING NUMBER

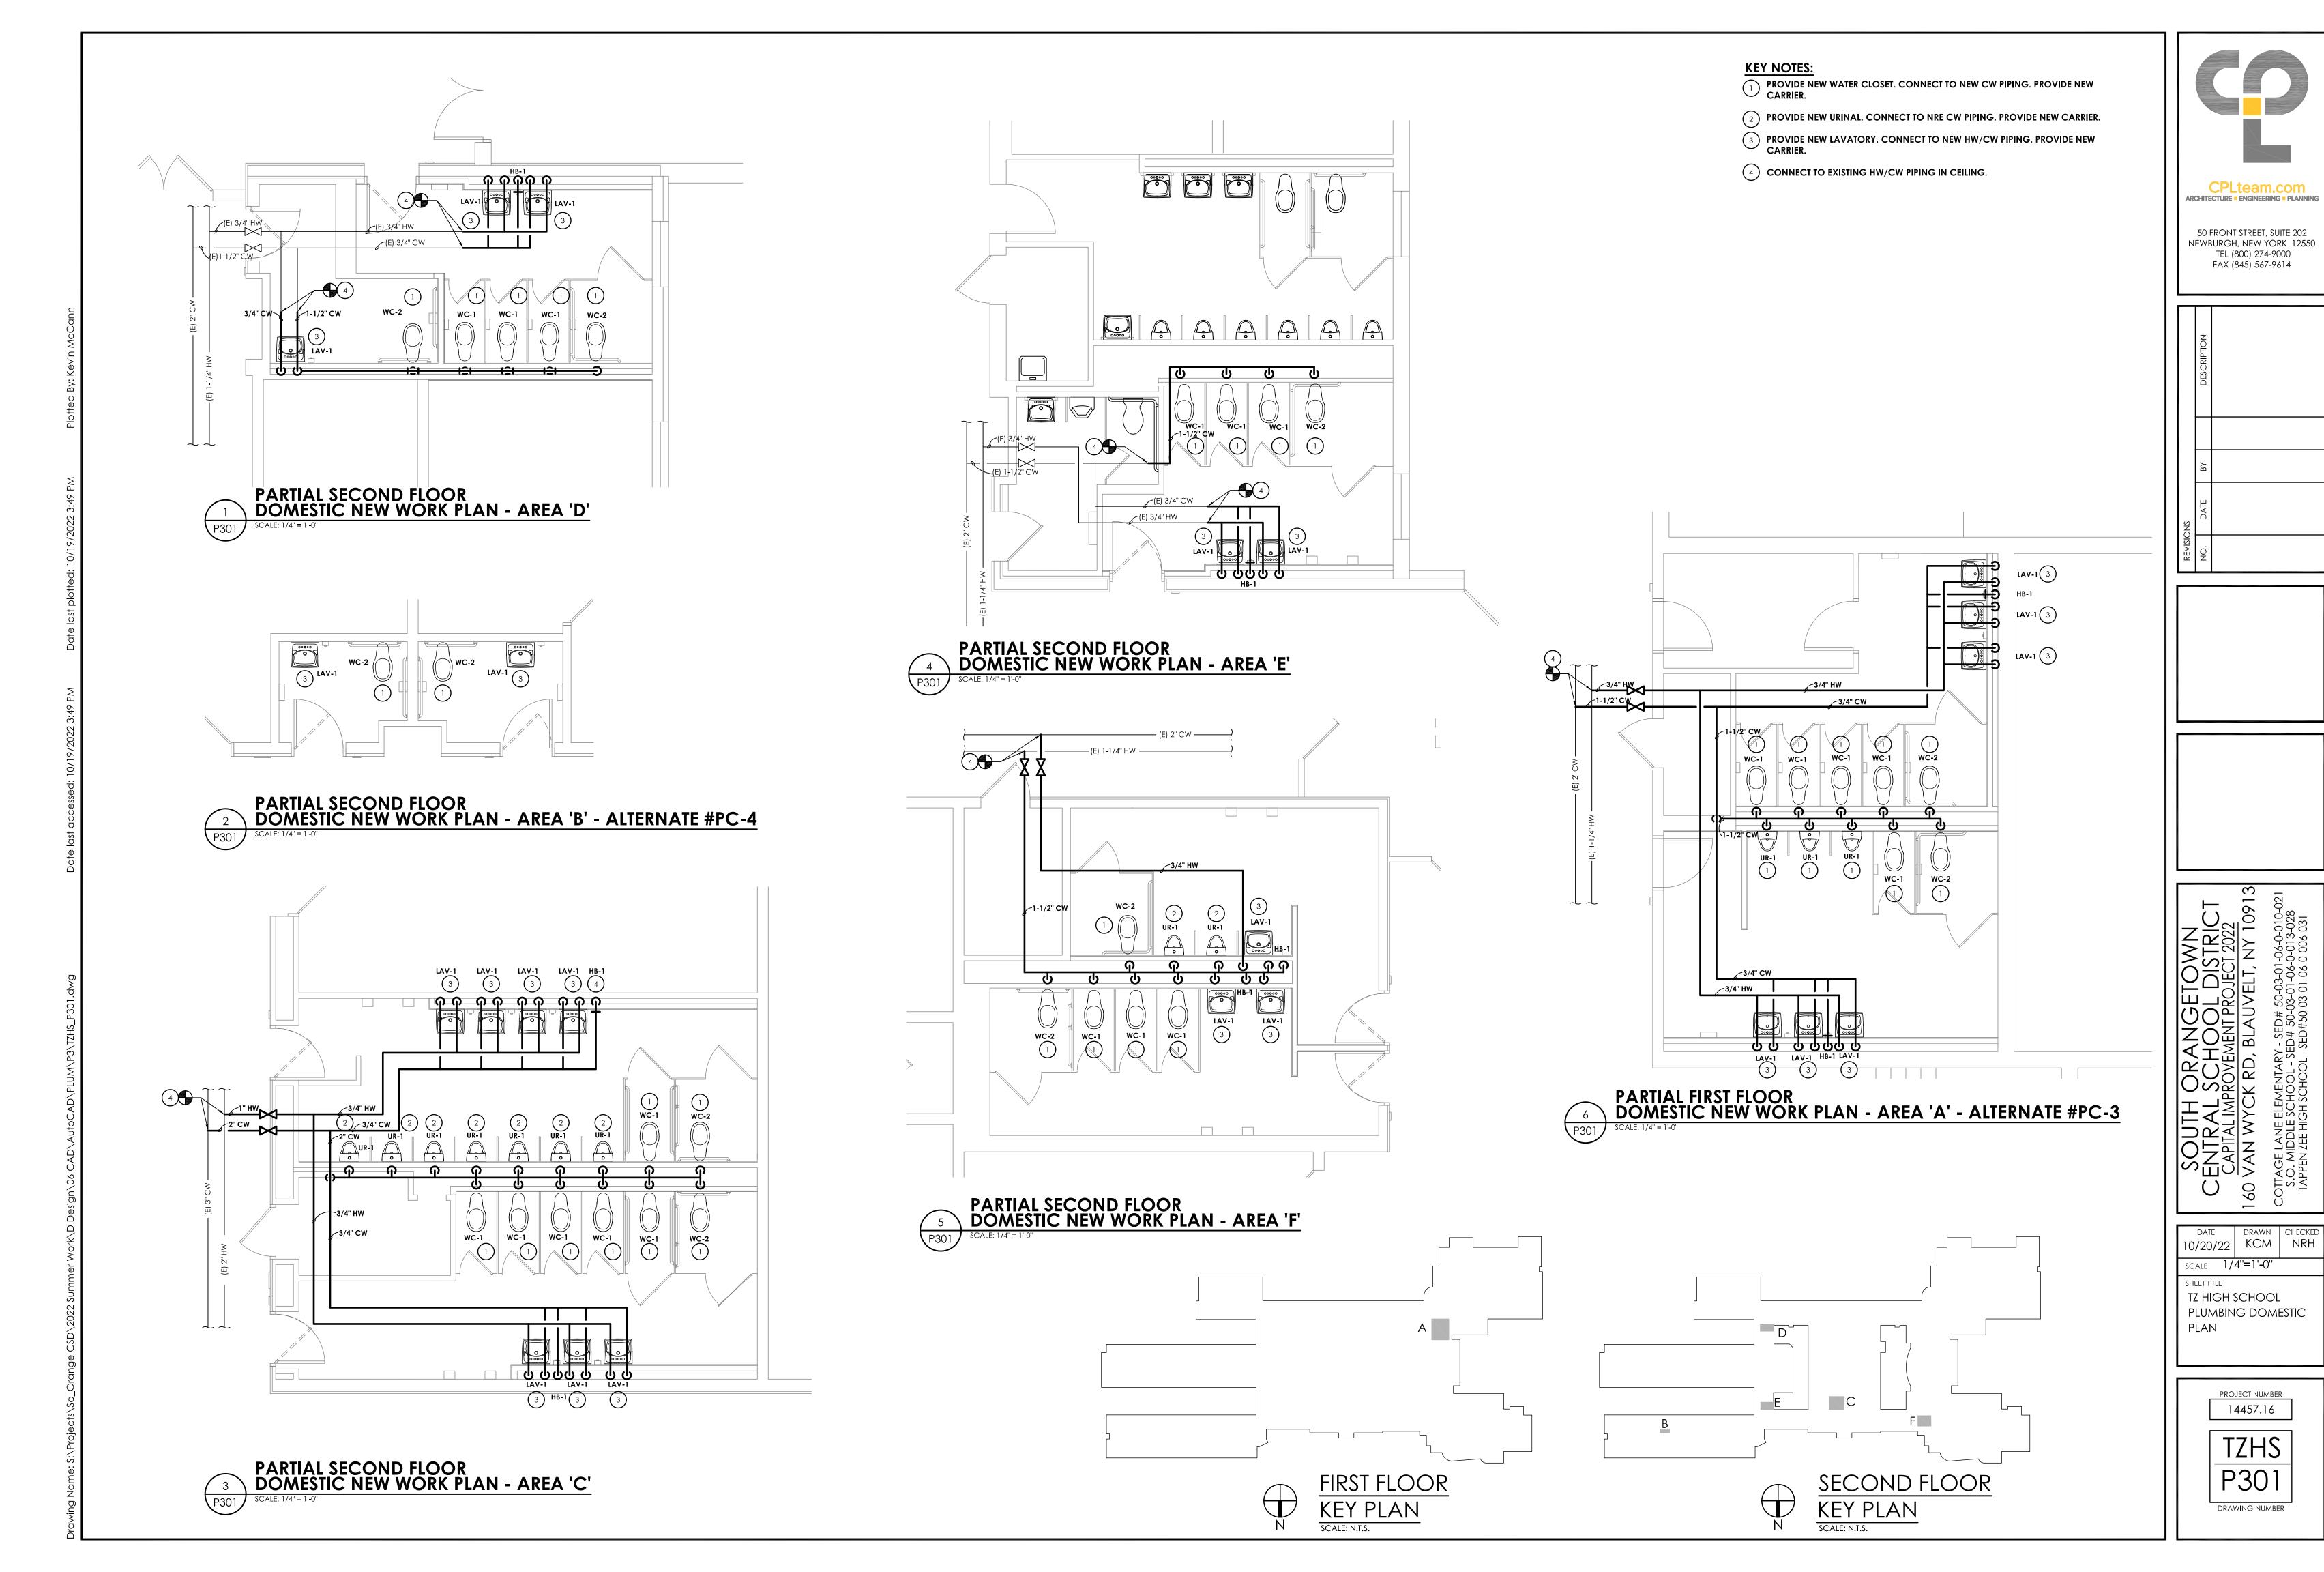

SINGLE LINE DIAGRAM LEGEND:

EARTH GROUND CHASSIS GROUND TRANSFORMER - KVA, PRIMARY AND SECONDARY 45 KVA VOLTAGE INDICATED. CONNECTIONS, K-RATING, AND SHIELD SPECIFIED 208/120V K-13 **CURRENT TRANSFORMER** POTENTIAL TRANSFORMER DISCONNECT/LOADBREAK SWITCH CIRCUIT BREAKER DRAWOUT MOUNTED (LOW VOLTAGE) AUTOMATIC TRANSFER SWITCH

(NORMAL POSITION SHOWN)

ENCLOSED CIRCUIT BREAKER

FUSED DISCONNECT SWITCH

LIGHTNING ARRESTER

METER

PANELBOARD-RATINGS AS SPECIFIED IN SINGLE LINE DIAGRAM AND ON PANELBOARD SCHEDULE

COMMUNICATIONS LEGEND:

TELEPHONE (1) CAT3 - TELEPHONE JACK & CABLE

(NONE) STANDARD MODULAR JACK FOR TELEPHONE

W WALL MOUNTED TELEPHONE MODULAR JACK P PUBLIC TELEPHONE MODULAR JACK

C COUNTER HEIGHT MODULAR JACK

TELEPHONE FLOOR OUTLET (1) CAT3 - TELEPHONE JACK & CABLE

DATA OUTLET WITH FLUSH BOX AND FACEPLATE (1) CAT5e - DATA JACK & CABLE

COMPUTER FLOOR OUTLET (1) CAT5e - DATA JACK & CABLE

COMBINATION TELEPHONE CABLE AND DATA OUTLETS IN DOUBLE GANG FLUSH MOUNTED BOX WITH FACEPLATE

WIRELESS TRANSMITTER (PROVIDED BY OWNER)

CONTRACTOR TO PROVIDE (2) CAT5e DATA JACKS & CABLING

BACK BOX FOR OWNER PROVIDED TEL/COM WIRING & DEVICES

DATA RACK

COAX CABLE (TYPE F CONNECTOR)

CEILING MOUNT LCD PROJECTOR

SPEAKER (PUBLIC ADDRESS) (NONE) CEILING MOUNTED

SPEAKER (LOCAL SOUND SYSTEM)

W WALL MOUNTED

SPEAKER HORN

MICROPHONE JACK

SPEAKER JACK

VOLUME CONTROL

CLOCK

DOUBLE FACE CLOCK

COMBINATION CLOCK AND SPEAKER

INTERCOM STATION

REMOTE PRE-AMPLIFIER AND PAGING MICROPHONE

CONSOLE JACK

HOUSE LIGHT CONTROL STATION

WALL BOX AS SPECIFIED

FLOOR BOX

SYMBOLS SHOWN ON THIS ELECTRICAL SYMBOLS LIST ARE FOR REFERENCE PURPOSES ONLY. ALL OF THESE SYMBOLS MAY NOT BE USED FOR THIS PROJECT.

FIRE/LIFE SAFETY LEGEND:

FIRE ALARM PULL STATION

FIRE ALARM BELL

FIRE ALARM HORN

FIRE ALARM HORN AND STROBE COMBINATION

FIRE ALARM HORN AND STROBE COMBINATION, WEATHER PROOF

S FIRE ALARM SPEAKER

FIRE ALARM SPEAKER - CEILING MOUNTED

FIRE ALARM SPEAKER AND STROBE COMBINATION

FIRE ALARM STROBE

FIRE ALARM STROBE - CEILING MOUNTED

SMOKE DETECTOR

SMOKE DETECTOR WITH GUARD

CARBON MONOXIDE DETECTOR

NATURAL GAS SENSOR

HEAT DETECTOR

COMBINATION SMOKE/HEAT DETECTOR

HEAT DETECTOR - 190° FIXED TEMPERATURE

HEAT DETECTOR - EXPLOSION PROOF

BEAM SMOKE DETECTOR TRANSMITTER

BEAM SMOKE DETECTOR RECEIVER

SA INDICATES INSTALLATION IN SUPPLY AIR RA INDICATES INSTALLATION IN RETURN AIR

REMOTE TEST STATION FOR DUCT DETECTOR

FIRE ALARM SHUT DOWN RELAY

FIRE DOOR HOLD OPEN

TAMPER SWITCH

FLOW SWITCH

FIRE SUPRESSION ANSUL SYSTEM CONNECTION

SMOKE DAMPER RELAY CONNECTION SD/FD SMOKE DAMPER AND FIRE DAMPER

SD SMOKE DAMPER CONTROL MODULE, ADDRESSABLE

AREA OF RESCUE CALL STATION

AREA OF RESCUE MASTER TELEPHONE STATION

SECURITY LEGEND:

SECURITY KEY PAD

VIDEO CAMERA

CCTV VIDEO MONITOR

PASSIVE INFRARED MOTION DETECTOR

PROXIMITY CARD READER

CALL SWITCH

DC DOOR CONTACT

WINDOW CONTACT

ELECTRIC STRIKE DOOR RELEASE

MAGNETIC DOOR RELEASE

NURSE CALL LEGEND:

NURSE CALL BUTTON

NURSE CALL PATIENT BED STATION

CODE CALL BUTTON

NURSE CALL STAFF ASSIST STATION NURSE CALL STAFF STATION

NURSE CALL DUTY/STAFF STATION

NURSE CALL DUTY STATION

NURSE CALL LIGHT NURSE CALL CODE LIGHT

NURSE CALL ZONE LIGHT

NURSE CALL MASTER STATION

NURSE CALL EMERGENCY PULL STATION

NURSE CALL INFRARED SENSOR

LIGHT FIXTURE LEGEND:

LIGHTING FIXTURE $\triangle \bigcirc \Diamond$ (SEE LIGHTING FIXTURE SCHEDULE FOR LETTER

DESIGNATION AND DESCRIPTION OF FIXTURES)

EMERGENCY AND/OR NIGHT LIGHTING FIXTURE EXIT LIGHTING FIXTURE UNIVERSAL MOUNT, SINGLE/DOUBLE FACE

(WHERE USED, ARROW INDICATES CHEVRON DIRECTION)

BATTERY POWERED EMERGENCY LIGHT \Box

EMERGENCY LIGHT REMOTE HEAD

TRACK LIGHTING

POLE MOUNTED LIGHTING (QUANTITY AND ORIENTATION OF HEADS AS SHOWN)

 \bigcirc S OCCUPANCY SENSOR - CEILING MOUNTED

OSW OCCUPANCY SENSOR - WALL MOUNTED

LIGHTING CONTACTOR

PHOTOCELL AMBIENT LIGHT SENSOR

SWITCH

LV LOW VOLTAGE 1-4 BUTTON STATION (CONNECT TO LIGHTING CONTROL STATION)

OS OCCUPANCY SENSOR SWITCH D DIMMER (INCANDESCENT)

D3 THREE WAY DIMMER (INCANDESCENT)

DF DIMMER (FLUORESCENT)

PANEL LEGEND:

EXISTING ELECTRICAL PANEL

NEW ELECTRICAL PANEL MDP MAIN DISTRIBUTION PANEL

LVP LOW VOLTAGE PANEL HVP HIGH VOLTAGE PANEL

LP LIGHTING CONTROL PANEL

IG ISOLATED GROUND PANEL MSB MAIN SWITCH BOARD MCC MOTOR CONTROL CENTER

TVSS TRANSIENT VOLTAGE SURGE SUPPRESSION

AUTOMATIC TRANSFER SWITCH ELECTRICAL SYSTEMS PANEL

> SACP SECURITY ALARM CONTROL PANEL FACP FIRE ALARM CONTROL PANEL

PA PUBLIC ADDRESS CONTROL PANEL FAAP FIRE ALARM ANNUNCIATOR PANEL

ELECTRICAL PANELBOARD LABELING PLACARD

LINE 1 - PANELBOARD NAME: PP1 (EXAMPLE)

LINE 2 - VOLTAGE AND PHASE: 480/277V-3PH-4W (EXAMPLE) LINE 3 - WHERE PANELBOARD IS FED FROM: FF MSB BREAKER #14 (EXAMPLE)

GENERAL ELECTRICAL NOTES:

1) HATCHED AREAS ///// DESIGNATE EXISTING EQUIPMENT TO BE REMOVED, UNLESS OTHERWISE NOTED.

2) ALL WORK TO BE DONE IN ACCORDANCE WITH THE LATES ADOPTED VERSION OF THE NATIONAL ELECTRIC CODE (NFPA 70).

3) CONTRACTOR SHALL FIELD VERIFY ALL CONDITIONS AND COORDINATE WITH EXISTING EQUIPMENT PRIOR TO BIDDING.

BUILDING:

4) INSTALLATION HEIGHT TO CENTER OF EQUIPMENT ABOVE FINISHED FLOOR UNLESS OTHERWISE NOTED TO BE:

SWITCH = 44"MODULAR JACK FOR WALL MOUNTED TELEPHONE = 52"

MODULAR TELEPHONE JACK = 18" AUDIO/VISUAL FIRE ALARM INDICATORS = 88"

FIRE ALARM PULL STATIONS = 48" TELEVISION OUTLET = 7'-0"

COMPUTER OUTLET = 18" CALL SWITCH = 44"

REMOTE TEST STATION FOR DUCT DETECTOR = 52" C = ABOVE COUNTER BACKSPLASH, COORDINATE WITH ARCHITECTURAL ELEVATIONS AND MILLWORK.

5) INSTALL DATA JACKS FOR CEILING MOUNTED WIRELESS TRANSMITTERS ABOVE CEILING IN ALL AREAS WHERE THERE IS AN ACCESSIBLE CEILING. PROVIDE FLUSH MOUNTED JACKS IN ALL HARD CEILINGS.

6) ALL CONDUIT AND WIRING TO BE CONCEALED IN WALLS, FLOOR, OR ABOVE CEILINGS UNLESS OTHERWISE NOTED OR APPROVED BY THE ARCHITECT/ENGINEER. ALL DEVICE OUTLET BOXES SHALL BE RECESSED UNLESS OTHERWISE NOTED OR APPROVED BY THE ARCHITECT/ENGINEER. WHERE APPROVED OR NOTED, SURFACE METAL RACEWAY AND DEVICE BOXES SHALL BE USED IN-LIEU

7) ALL CONDUIT ROUTES SHOWN ARE APPROXIMATE ONLY. CONTRACTOR SHALL FIELD VERIFY FINAL ROUTE.

OF CONDUIT AND CONCEALED BOXES AT NO EXTRA COST TO THE OWNER.

8) CONDUIT RUNS SHOWN ARE SCHEMATICAL AND DO NOT INDICATE THE NECESSARY FITTINGS AND JUNCTION BOXES THAT ARE INCLUDED IN THE SCOPE OF THE WORK.

GROUNDING:

9) ALL METAL RACEWAYS, INCLUDING CONDUIT, WIRE TROUGHS, WIREMOLD, ETC., SHALL BE GROUNDED. ALL CONNECTIONS IN METAL RACEWAYS SHALL BE COMPLETED IN SUCH A MANNER AS TO MAINTAIN A CONTINUOUS PATH TO GROUND THROUGHOUT THE ENTIRE LENGTH OF THE RACEWAY.

WIRING:

10) UNLESS NOTED OTHERWISE ON THE DRAWINGS OR ON THE EQUIPMENT WIRING SCHEDULE, EACH BRANCH CIRCUIT SHALL BE THREE (3) #12 AWG THHN/THWN (1 HOT, 1 NEUTRAL & 1 EQUIPMENT GROUND) IN 3/4" EMT CONDUIT. PROTECT EACH CIRCUIT WITH A 20 AMPÈRE, 1-POLE OVERCURRENT DEVICE UNLESS OTHERWISE NOTED. PROVIDE #10 AWG FOR 120V BRANCH CIRCUITS LONGER THAN 100 FEET. COMBINED NEUTRALS ARE NOT PERMITTED.



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	DESCRIPTION	
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SNC	DATE	
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	REVISIONS	ATE BY

TOWN DISTRICI DJECT 2022 TELT, NY 109

DRAWN CHECKED 10/20/22 | MAY SCALE AS NOTED ELECTRICAL SYMBOLS AND ABBREVIATIONS

> PROJECT NUMBER 14457.16

> > GEN DRAWING NUMBER

GENERAL DEMOLITION NOTES:

- A. ALL ITEMS SHOWN ARE TO BE REMOVED UNLESS LABELED AS (E) EXISTING TO REMAIN. ANY DEVICE, AS WELL AS ITS ASSOCIATED CIRCUITING, AND CONDUIT, LABELED "(E)" SHALL REMAIN, UNLESS OTHERWISE NOTED.
- B. INFORMATION ON DRAWINGS WAS OBTAINED THROUGH FIELD OBSERVATION AND AS-BUILT DOCUMENTATION. THE CONTRACTOR IS RESPONSIBLE FOR THE REMOVAL AND REPLACEMENT OF ANY DEVICES AND CABLING THAT MAY NOT BE SHOWN ON DRAWING AT NO ADDITIONAL COST TO OWNER.
- C. DRAWINGS ARE GRAPHICAL REPRESENTATIONS OF APPROXIMATE EQUIPMENT AND DEVICE LOCATIONS. CONTRACTOR SHALL VISIT THE SITE TO DETERMINE THE EXACT EXTENT OF ELECTRICAL WORK REQUIRED TO COMPLETE THE PROJECT. EXISTING CONDITIONS ARE TAKEN FROM FIELD OBSERVATION AND EXISTING BUILDING DOCUMENTS. OTHER ELECTRICAL ITEMS MAY EXIST FOR WHICH THE CONTRACTOR IS RESPONSIBLE AT NO ADDITIONAL COST.
- D. THE CONTRACTOR SHALL REMOVE THE EXISTING ELECTRIC IN AREAS OF NEW RENOVATIONS TO ACCOMMODATE NEW CONSTRUCTION. REROUTING OF EXISTING MAY BE REQUIRED AT NEW OPENINGS IN EXISTING CONSTRUCTION OR INTERFERENCE WITH OTHER NEW WORK AS NOTED IN THE FOLLOWING NOTES.
- E. DRAWINGS INDICATE SPECIFIC ITEMS TO BE REMOVED AND/OR RELOCATED IN ORDER TO INDICATE GENERAL SCOPE. ADDITIONAL ITEMS NOT INDICATED, BUT NECESSARY FOR PROJECT RENOVATIONS, SHALL BE REMOVED, RELOCATED AND/OR REROUTED. THE CONTRACTOR SHALL ASSUME WITHIN THE BASE BID A NOMINAL AMOUNT OF BRANCH CIRCUITS, FIXTURES, DEVICES, AND SYSTEMS WIRING WITHIN WALLS OR OPENINGS TO BE REMOVED OR RELOCATED AS REQUIRED TO ACCOMMODATE THE NEW CONSTRUCTION.
- F. COORDINATE DEMOLITION OF EQUIPMENT, DEVICES, ETC. WITH OTHER DISCIPLINES AS APPLICABLE. REFER TO ARCHITECTURAL DEMOLITION DRAWINGS AND NOTES FOR COORDINATION.
- G. ALL ITEMS (DEVICES, FIXTURES, ETC.) SHOWN ARE TO BE REMOVED UNLESS LABELED AS EXISTING TO REMAIN - (E). THESE ITEMS AND THEIR RELATED WIRING/CONDUIT SHALL BE REMOVED BACK TO THE SOURCE CONTROL PANEL/PANELBOARD UNLESS OTHERWISE NOTED. ON CIRCUITS WHERE OTHER DEVICES, FIXTURES, ETC. ARE FOUND THAT MUST REMAIN, MAINTAIN CIRCUIT CONTINUITY BY PROVIDING ADDITIONAL WIRING, TO FEED THROUGH TO THESE REMAINING ITEMS. relocate any circuits that remain, to avoid conflict with NEW CONSTRUCTION AS REQUIRED. PROPERLY TERMINATE ALL WIRING.
- H. CONTRACTOR SHALL PROPERLY DISPOSE OF ALL ITEMS AND/OR EQUIPMENT BEING REMOVED AS PART OF THE PROJECT. THE OWNER SHALL HAVE THE RIGHT OF RETAINING ANY ITEMS BEING REMOVED.
- I. CONTRACTOR SHALL PROVIDE NEW COVERPLATES ON ALL UNUSED FLUSH MOUNT DEVICE BOXES UPON COMPLETION OF PROJECT.
- J. FIREPROOFING AND/OR FIRE STOP MATERIALS REMOVED FROM FIRE RATED WALLS AND CEILINGS AS A RESULT OF DEMOLITION SHALL BE RE-INSTALLED USING AN APPROVED METHOD AS DESCRIBED IN ASSOCIATED PROJECT SPECIFICATIONS.

KEY NOTES:

- 1) DISCONNECT AND REMOVE EXISTING LIGHT FIXTURES. PULL ALL WIRING BACK AND TAG FOR RE-USE. SWITCHING TO BE REMOVED UNLESS NOTED OTHERWISE.
- DISCONNECT EXISTING WIRELESS TRANSMITTER AND STORE FOR RELOCATION. PULL WIRING BACK AND TAG FOR RE-USE.
- 3 DISCONNECT EXISTING WALL MOUNTED SPEAKER AND STORE FOR RELOCATION. PULL WIRING BACK AND TAG FOR RE-USE.
- disconnect existing smoke detector and store for relocation. Pull wiring back and tag for re-use.
- DISCONNECT EXISTING CLOCK AND STORE FOR RELOCATION. PULL WIRING BACK AND TAG FOR RE-USE.
- DISCONNECT AND REMOVE EXISTING DATA JACK, SURFACE RACEWAY, AND WIRING IN ITS ENTIRETY. REMOVE WIRING BACK TO
- EXISTING PANEL FEEDER JUNCTION BOX TO REMAIN. PROTECT DURING DEMOLITION.



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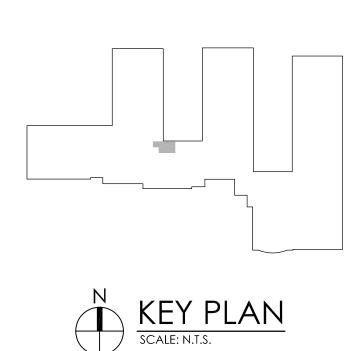
	DESCRIPTION	
	ВҮ	
SNC	DATE	
REVISIONS	NO.	

10/20/22 MAY SCALE AS NOTED

SHEET TITLE COTTAGE LANE FIRST FLOOR DEMOLITION PLAN

> PROJECT NUMBER 14457.16

> > DRAWING NUMBER



GENERAL NOTES:

- A. FIXTURE MARK INDICATED ADJACENT TO NEW LIGTHT FIXTURE. REFER TO LUMINAIRE SCHEDULE ON SHEET GEN-E900 FOR FIXTURE DESCRIPTION, NOTESAND SPECIFICATIONS.
- B. ALL NEW CIRCUIT BREAKERS TO BE OF SAME MANUFACTURER AND MINIMUM INTERRUPTING RATING OF PANEL . ALL NEW BREAKERS TO BE UL LISTED AND LABELED FOR USE IN PANEL.
- C. AT EACH SYMBOL, REFER TO DRAWING GEN-E900 FOR FURTHER INFORMATION.


KEY NOTES:

- CONNECT NEW LIGHT FIXTURES TO EXISTING LIGHTING CIRCUITRY TAGGED FOR RE-USE. REWORK/EXTEND CIRCUITRY AS NECESSARY TO ACCOMMODATE NEW LOCATIONS.
- PROVIDE NEW OCCUPANCY SENSOR SWITCHING AS NOTED.
 PROVIDE ALL LOW VOLTAGE WIRING FROM NEW SWITCHING TO NEW LIGHT FIXTURES.
- RECONNECT EXISTING RELOCATED WIRELESS TRANSMITTER TO EXISTING TAGGED WIRING. ATTACH WIRELESS TRANSMITTER TO CEILING GRID.
- RECONNECT EXISTING RELOCATED WALL MOUNTED SPEAKER TO EXISTING TAGGED WIRING. UTILIZE EXISTING MOUNTING HARDWARE. SPEAKER SHALL BE MOUNTED AT CEILING LEVEL TO TOP OF BOX.
- RECONNECT EXISTING RELOCATED CLOCK TO EXISTING TAGGED WIRING. UTILIZE EXISTING MOUNTING HARDWARE. CLOCK SHALL BE MOUNTED AT CEILING LEVEL TO TOP OF CLOCK.
- RECONNECT EXISTING RELOCATED SMOKE DETECTOR TO EXISTING TAGGED WIRING. SMOKE DETECTOR TO BE MOUNTED TO GYP CEILING.
- PROVIDE NEW ADDRESSABLE SMOKE DETECTOR AT LOCATION SHOWN. DETECTOR TO MATCH EXISTING MANUFACTURER. WIRE SMOKE DETECTOR TO EXISTING FIRE ALARM LOOP.
- AT EACH LOCATION, PROVIDE (1) CATEGORY 6 UTP PLENUM CABLE FROM DATA CLOSET INDICATED TO EACH DEVICE. PROVIDE RJ-45 CONNECTOR ON EACH ON AND 10' OF COILED CABLING AT EACH END. PROVIDE ALL TERMINATION AND TESTING. DATA CABLING FOR USE WITH DISTRICT PROVIDED VAPE SENSORS. COORDINATE WITH DISTRICT FOR EXACT PLACEMENT OF DEVICES AND CABLING.
- PROVIDE NEW FIRE ALARM STROBES AT LOCATIONS SHOWN.
 PROVIDE ALL WIRING AND TESTING FOR A COMPLETE FUNCTIONING SYSTEM.
- NEW ADA DOOR OPERATOR EQUIPMENT AND PUSH BUTTONS.
 PROVIDE 120-VOLT POWER IN CEILING TO ACCOMMODATE POWER
 TO ADA DOOR OPERATOR EQUIPMENT. PROVIDE (2) #12, (1) 12 GND
 IN 3/4"C FROM SPARE 20-AMP, 1-POLE CIRCUIT BREAKER IN PANEL
 1LNL11 TO ADA DOOR EQUIPMENT. INSTALL ADA DOOR PUSH
 BUTTONS AND ALL ASSOCIATED POWER AND CONTROL WIRING
 BETWEEN DOORS AND PUSH BUTTONS. REFER TO SPECIFICATION
 SECTION 087100 FOR FURTHER INFORMATION.



50 front street, suite 202 newburgh, new york 12550 tel (800) 274-9000 fax (845) 567-9614

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CAPITAL IMPROVEMENT PROJECT 2022

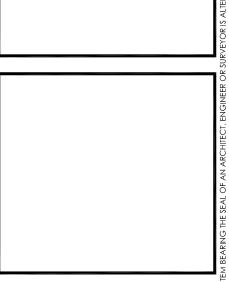O VAN WYCK RD, BLAUVELT, NY 10913

S.O. MIDDLE SCHOOL - SED# 50-03-01-06-0-013-028

TAPPEN ZEE HIGH SCHOOL - SED#50-03-01-06-0-006-031

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10/20/22 MAY JBT


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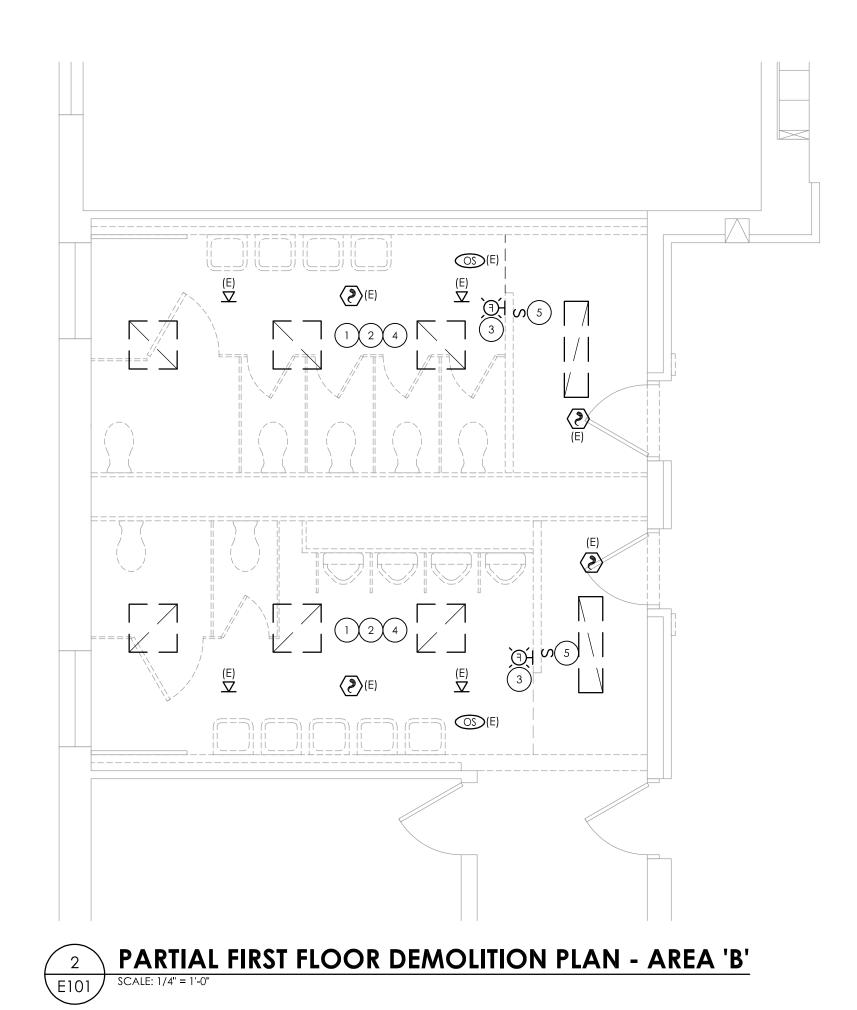
COTTAGE LANE
FIRST FLOOR
NEW WORK PLAN

PROJECT NUMBER 14457.16

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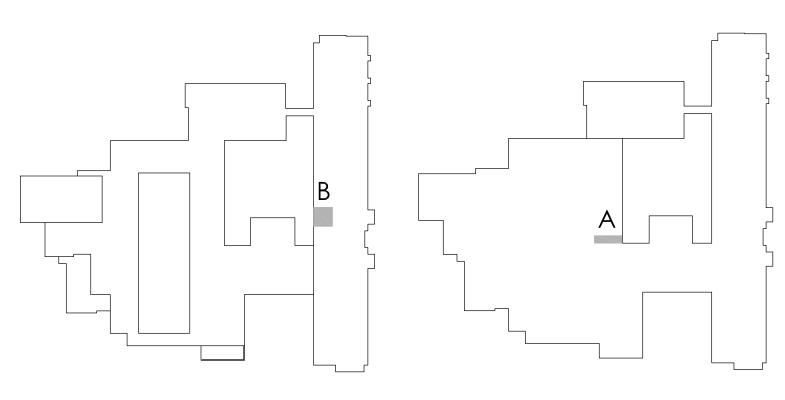
PARTIAL GROUND FLOOR DEMOLITION PLAN - AREA 'A'



- A. ALL ITEMS SHOWN ARE TO BE REMOVED UNLESS LABELED AS (E) EXISTING TO REMAIN. ANY DEVICE, AS WELL AS ITS ASSOCIATED CIRCUITING, AND CONDUIT, LABELED "(E)" SHALL REMAIN, UNLESS OTHERWISE NOTED.
- B. INFORMATION ON DRAWINGS WAS OBTAINED THROUGH FIELD
 OBSERVATION AND AS-BUILT DOCUMENTATION. THE CONTRACTOR IS
 RESPONSIBLE FOR THE REMOVAL AND REPLACEMENT OF ANY
 DEVICES AND CABLING THAT MAY NOT BE SHOWN ON DRAWING AT
 NO ADDITIONAL COST TO OWNER.
- C. DRAWINGS ARE GRAPHICAL REPRESENTATIONS OF APPROXIMATE EQUIPMENT AND DEVICE LOCATIONS. CONTRACTOR SHALL VISIT THE SITE TO DETERMINE THE EXACT EXTENT OF ELECTRICAL WORK REQUIRED TO COMPLETE THE PROJECT. EXISTING CONDITIONS ARE TAKEN FROM FIELD OBSERVATION AND EXISTING BUILDING DOCUMENTS. OTHER ELECTRICAL ITEMS MAY EXIST FOR WHICH THE CONTRACTOR IS RESPONSIBLE AT NO ADDITIONAL COST.
- D. THE CONTRACTOR SHALL REMOVE THE EXISTING ELECTRIC IN AREAS OF NEW RENOVATIONS TO ACCOMMODATE NEW CONSTRUCTION. REROUTING OF EXISTING MAY BE REQUIRED AT NEW OPENINGS IN EXISTING CONSTRUCTION OR INTERFERENCE WITH OTHER NEW WORK AS NOTED IN THE FOLLOWING NOTES.
- E. DRAWINGS INDICATE SPECIFIC ITEMS TO BE REMOVED AND/OR RELOCATED IN ORDER TO INDICATE GENERAL SCOPE. ADDITIONAL ITEMS NOT INDICATED, BUT NECESSARY FOR PROJECT RENOVATIONS, SHALL BE REMOVED, RELOCATED AND/OR REROUTED. THE CONTRACTOR SHALL ASSUME WITHIN THE BASE BID A NOMINAL AMOUNT OF BRANCH CIRCUITS, FIXTURES, DEVICES, AND SYSTEMS WIRING WITHIN WALLS OR OPENINGS TO BE REMOVED OR RELOCATED AS REQUIRED TO ACCOMMODATE THE NEW CONSTRUCTION.
- F. COORDINATE DEMOLITION OF EQUIPMENT, DEVICES, ETC. WITH OTHER DISCIPLINES AS APPLICABLE. REFER TO ARCHITECTURAL DEMOLITION DRAWINGS AND NOTES FOR COORDINATION.
- G. ALL ITEMS (DEVICES, FIXTURES, ETC.) SHOWN ARE TO BE REMOVED UNLESS LABELED AS EXISTING TO REMAIN (E). THESE ITEMS AND THEIR RELATED WIRING/CONDUIT SHALL BE REMOVED BACK TO THE SOURCE CONTROL PANEL/PANELBOARD UNLESS OTHERWISE NOTED. ON CIRCUITS WHERE OTHER DEVICES, FIXTURES, ETC. ARE FOUND THAT MUST REMAIN, MAINTAIN CIRCUIT CONTINUITY BY PROVIDING ADDITIONAL WIRING, TO FEED THROUGH TO THESE REMAINING ITEMS. RELOCATE ANY CIRCUITS THAT REMAIN, TO AVOID CONFLICT WITH NEW CONSTRUCTION AS REQUIRED. PROPERLY TERMINATE ALL WIRING.
- H. CONTRACTOR SHALL PROPERLY DISPOSE OF ALL ITEMS AND/OR EQUIPMENT BEING REMOVED AS PART OF THE PROJECT. THE OWNER SHALL HAVE THE RIGHT OF RETAINING ANY ITEMS BEING REMOVED.
- I. CONTRACTOR SHALL PROVIDE NEW COVERPLATES ON ALL UNUSED FLUSH MOUNT DEVICE BOXES UPON COMPLETION OF PROJECT.
- J. FIREPROOFING AND/OR FIRE STOP MATERIALS REMOVED FROM FIRE RATED WALLS AND CEILINGS AS A RESULT OF DEMOLITION SHALL BE RE-INSTALLED USING AN APPROVED METHOD AS DESCRIBED IN ASSOCIATED PROJECT SPECIFICATIONS.

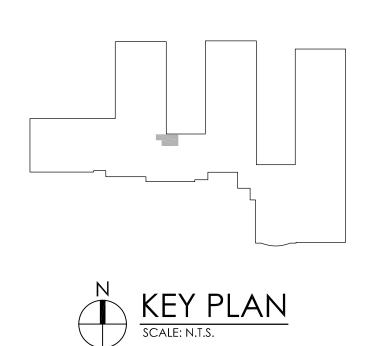KEY NOTES:

- DISCONNECT AND REMOVE EXISTING LIGHTING. PULL WIRING BACK AND TAG FOR RE-USE.
- DISCONNECT ALL EXISTING CEILING DEVICES, IE., SMOKE DETECTORS, OCCUPANCY SENSORS, AND VAPE SENSORS, AND STORE FOR RELOCATION. PULL WIRING BACK AND TAG FOR RE-USE.
- 3 DISCONNECT EXISTING FIRE ALARM DEVICES AND STORE FOR RELOCATION. PULL WIRING BACK AND TAG FOR RE-USE.
- ALL EXISTING DEVICES WITHIN THESE SPACES ARE EXISTING TO REMAIN.
 ANY DEVICES ON DEMOLISHED FINISHES SHALL BE DISCONNECTED TO
 ACCOMMODATE WORK AND THEN RECONNECTED ONCE NEW
 FINISHES ARE INSTALLED.
- DISCONNECT EXISTING LIGHT SWITCH AND STORE FOR RE-USE. PULL CONDUIT AND WIRING BACK AND TAG FOR RE-USE.









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CENTRAL SCHOOL DISTRIC
CAPITAL IMPROVEMENT PROJECT 2022

160 VAN WYCK RD, BLAUVELT, NY 109

COTTAGE LANE ELEMENTARY - SED# 50-03-01-06-0-013-028

3.O. MIDDLE SCHOOL - SED# 50-03-01-06-0-013-028

TAPPEN ZEF HIGH SCHOOL - SED# 50-03-01-06-0-013-028

DATE DRAWN CHECKED
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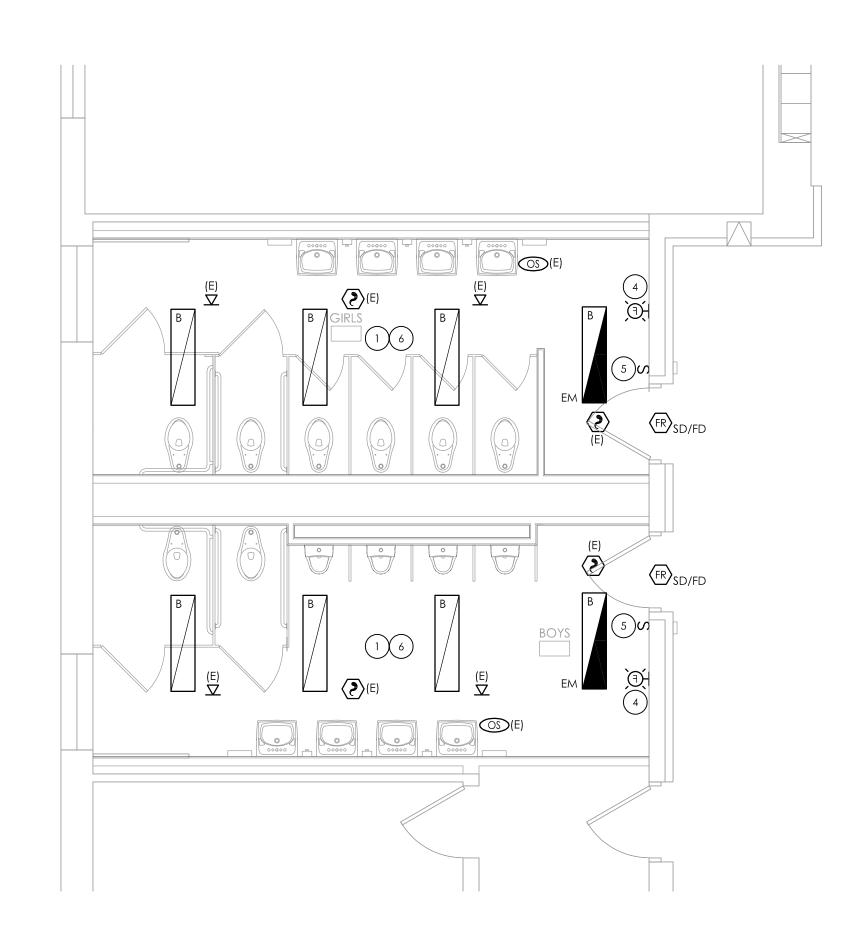
SHEET TITLE

S.O. MIDDLE SCHOOL

S.O. MIDDLE SCHOOL GROUND AND FIRST FLOOR DEMOLITION PLANS

PROJECT NUMBER 14457.16

SOMS E101 DRAWING NUMBER PARTIAL GROUND FLOOR NEW WORK PLAN - AREA 'A' - ALTERNATE #EC-1



PARTIAL FIRST FLOOR NEW WORK PLAN - AREA 'B' - ALTERNATE #EC-3

SCALE: 1/4" = 1'-0"

KEY NOTES:

- 1 CONNECT NEW LIGHT FIXTURES TO EXISTING LIGHTING CIRCUITRY TAGGED FOR RE-USE. REWORK/EXTEND CIRCUITRY AS NECESSARY TO ACCOMMODATE NEW LOCATIONS. REFER TO LUMINAIRE SCHEDULE ON DRAWING GEN-E900 FOR LIGHTING SPECIFICATIONS AND NOTES.
- PROVIDE NEW CEILING MOUNTED OCCUPANCY SENSORS AS NOTED. PROVIDE ALL LOW VOLTAGE WIRING FROM NEW OCCUPANCY SENSORS TO NEW LIGHT FIXTURES.
- RECONNECT EXISTING RELOCATED SMOKE DETECTOR TO EXISTING TAGGED WIRING. SMOKE DETECTOR TO BE MOUNTED TO GYP
- 4 RECONNECT EXISTING RELOCATED FIRE ALARM STROBE TO EXISTING TAGGED WIRING. FIRE ALARM STROBE TO BE WALL MOUNTED AT PREVIOUS HEIGHT.
- 5 RECONNECT EXISTING RELOCATED SWITCHES TO EXISTING TAGGED WIRING. UTILIZE EXISTING CONDUIT AND BACKBOXES AS NECESSARY. SWITCHES TO BE MOUNTED AT PREVIOUS HEIGHTS.
- (6) RECONNECT ALL EXISTING RELOCATED CEILING DEVICES, IE., SMOKE DETECTORS, OCCUPANCY SENSORS, AND VAPE SENSORS, TO EXISTING TAGGED WIRING. DEVICES TO BE MOUNTED TO GYP CEILING.



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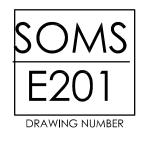
FAX (845) 567-9614


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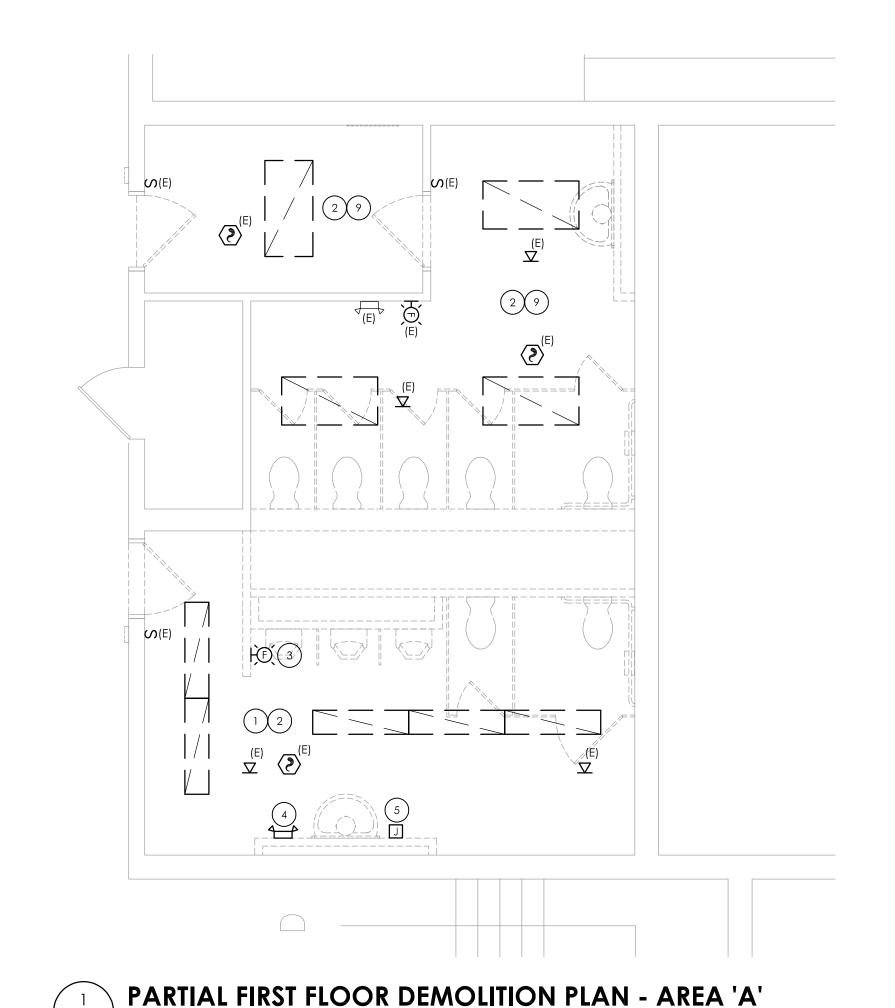
S.O. MIDDLE SCHOOL GROUND AND FIRST FLOOR NEW WORK PLANS

> PROJECT NUMBER 14457.16







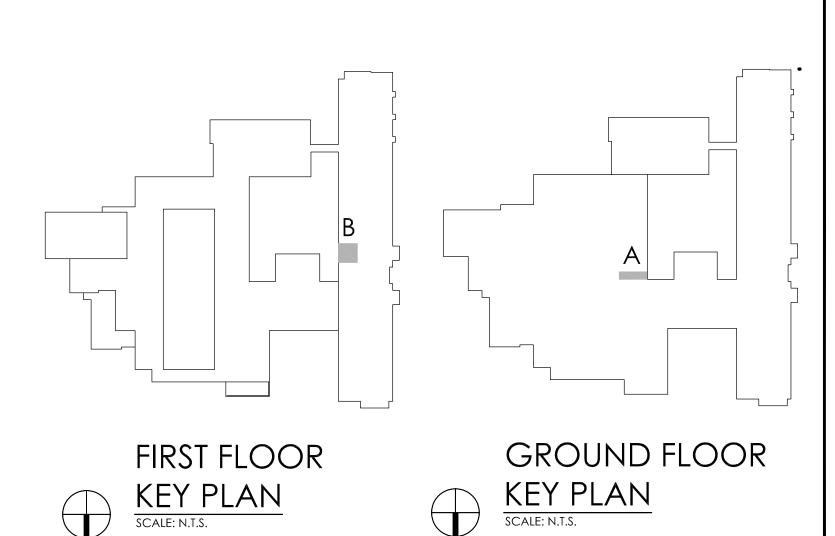


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GENERAL DEMOLITION NOTES:

- A. ALL ITEMS SHOWN ARE TO BE REMOVED UNLESS LABELED AS (E) EXISTING TO REMAIN. ANY DEVICE, AS WELL AS ITS ASSOCIATED CIRCUITING, AND CONDUIT, LABELED "(E)" SHALL REMAIN, UNLESS OTHERWISE NOTED.
- B. INFORMATION ON DRAWINGS WAS OBTAINED THROUGH FIELD OBSERVATION AND AS-BUILT DOCUMENTATION. THE CONTRACTOR IS RESPONSIBLE FOR THE REMOVAL AND REPLACEMENT OF ANY DEVICES AND CABLING THAT MAY NOT BE SHOWN ON DRAWING AT NO ADDITIONAL COST TO OWNER.
- C. DRAWINGS ARE GRAPHICAL REPRESENTATIONS OF APPROXIMATE EQUIPMENT AND DEVICE LOCATIONS. CONTRACTOR SHALL VISIT THE SITE TO DETERMINE THE EXACT EXTENT OF ELECTRICAL WORK REQUIRED TO COMPLETE THE PROJECT. EXISTING CONDITIONS ARE TAKEN FROM FIELD OBSERVATION AND EXISTING BUILDING DOCUMENTS. OTHER ELECTRICAL ITEMS MAY EXIST FOR WHICH THE CONTRACTOR IS RESPONSIBLE AT NO ADDITIONAL COST.
- D. THE CONTRACTOR SHALL REMOVE THE EXISTING ELECTRIC IN AREAS OF NEW RENOVATIONS TO ACCOMMODATE NEW CONSTRUCTION. REROUTING OF EXISTING MAY BE REQUIRED AT NEW OPENINGS IN EXISTING CONSTRUCTION OR INTERFERENCE WITH OTHER NEW WORK AS NOTED IN THE FOLLOWING NOTES.
- E. DRAWINGS INDICATE SPECIFIC ITEMS TO BE REMOVED AND/OR RELOCATED IN ORDER TO INDICATE GENERAL SCOPE. ADDITIONAL ITEMS NOT INDICATED, BUT NECESSARY FOR PROJECT RENOVATIONS, SHALL BE REMOVED, RELOCATED AND/OR REROUTED. THE CONTRACTOR SHALL ASSUME WITHIN THE BASE BID A NOMINAL AMOUNT OF BRANCH CIRCUITS, FIXTURES, DEVICES, AND SYSTEMS WIRING WITHIN WALLS OR OPENINGS TO BE REMOVED OR RELOCATED AS REQUIRED TO ACCOMMODATE THE NEW CONSTRUCTION.
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- G. ALL ITEMS (DEVICES, FIXTURES, ETC.) SHOWN ARE TO BE REMOVED UNLESS LABELED AS EXISTING TO REMAIN - (E). THESE ITEMS AND THEIR RELATED WIRING/CONDUIT SHALL BE REMOVED BACK TO THE SOURCE CONTROL PANEL/PANELBOARD UNLESS OTHERWISE NOTED. ON CIRCUITS WHERE OTHER DEVICES, FIXTURES, ETC. ARE FOUND THAT MUST REMAIN, MAINTAIN CIRCUIT CONTINUITY BY PROVIDING ADDITIONAL WIRING, TO FEED THROUGH TO THESE REMAINING ITEMS. RELOCATE ANY CIRCUITS THAT REMAIN, TO AVOID CONFLICT WITH NEW CONSTRUCTION AS REQUIRED. PROPERLY TERMINATE ALL WIRING.
- H. CONTRACTOR SHALL PROPERLY DISPOSE OF ALL ITEMS AND/OR EQUIPMENT BEING REMOVED AS PART OF THE PROJECT. THE OWNER SHALL HAVE THE RIGHT OF RETAINING ANY ITEMS BEING REMOVED.
- I. CONTRACTOR SHALL PROVIDE NEW COVERPLATES ON ALL UNUSED FLUSH MOUNT DEVICE BOXES UPON COMPLETION OF PROJECT.
- J. FIREPROOFING AND/OR FIRE STOP MATERIALS REMOVED FROM FIRE RATED WALLS AND CEILINGS AS A RESULT OF DEMOLITION SHALL BE RE-INSTALLED USING AN APPROVED METHOD AS DESCRIBED IN ASSOCIATED PROJECT SPECIFICATIONS.

KEY NOTES:

- 1) DISCONNECT AND REMOVE EXISTING LIGHTING. PULL WIRING BACK
- DISCONNECT ALL EXISTING CEILING DEVICES, IE., SMOKE DETECTORS, OCCUPANCY SENSORS, AND VAPE SENSORS, AND STORE FOR RELOCATION. PULL WIRING BACK AND TAG FOR RE-USE.
- 3) DISCONNECT EXISTING FIRE ALARM DEVICES AND STORE FOR RELOCATION. PULL WIRING BACK AND TAG FOR RE-USE.
- (4) DISCONNECT EXISTING EMERGENCY LIGHTING FIXTURE AND STORE FOR RELOCATION. PULL WIRING BACK AND TAG FOR RE-USE.
- (5) DISCONNECT AND REMOVE EXISTING JUNCTION BOX AND SURFACE RACEWAY TO SINK SENSORS. DISCONNECT AND REMOVE ALL WIRING BACK TO SOURCE.
- (6) DISCONNECT EXISTING ADA DOOR OPENER AND STORE FOR RELOCATION. PULL WIRING BACK AND TAG FOR RE-USE.
- (7) ALL EXISTING DEVICES WITHIN THESE SPACES ARE EXISTING TO REMAI ANY DEVICES ON DEMOLISHED FINISHES SHALL BE DISCONNECTED TO ACCOMMODATE WORK AND THEN RECONNECTED ONCE NEW FINISHES ARE INSTALLED.
- B DISCONNECT EXISTING HAND DRYER CONDUIT AND WIRING AND PULL BACK TO ABOVE CEILING SPACE. TAG ALL WIRING FOR RE-USE. REMOVE ALL SURFACE RACEWAY.
- (9) DISCONNECT AND REMOVE EXISTING LIGHT FIXTURES. PROTECT FROM DAMAGE AND TURN OVER TO OWNER. PULL WIRING BACK AND TAG FOR RE-USE.

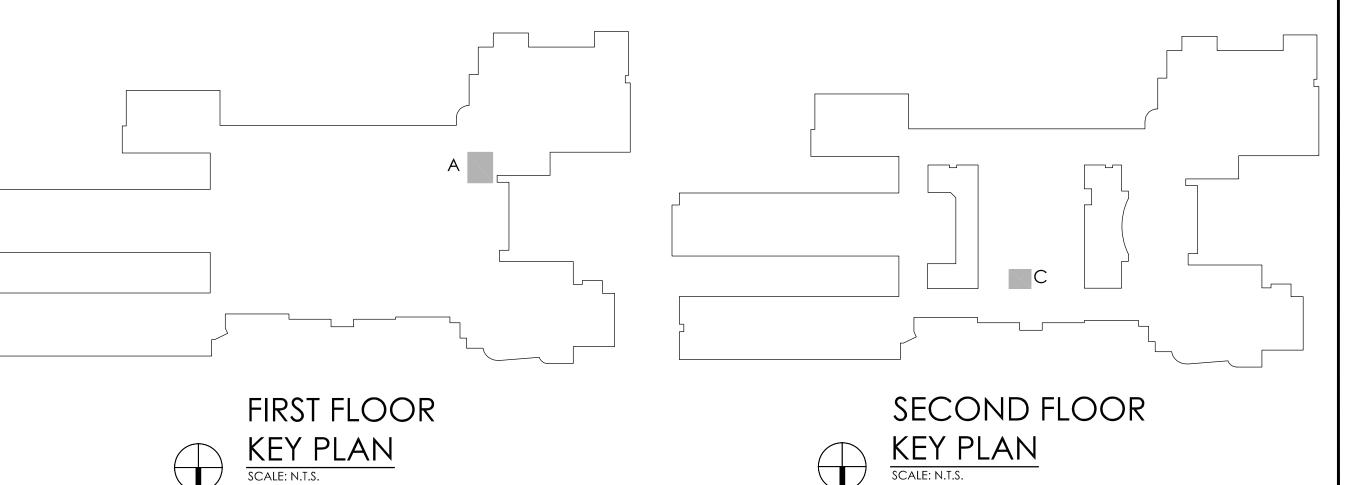

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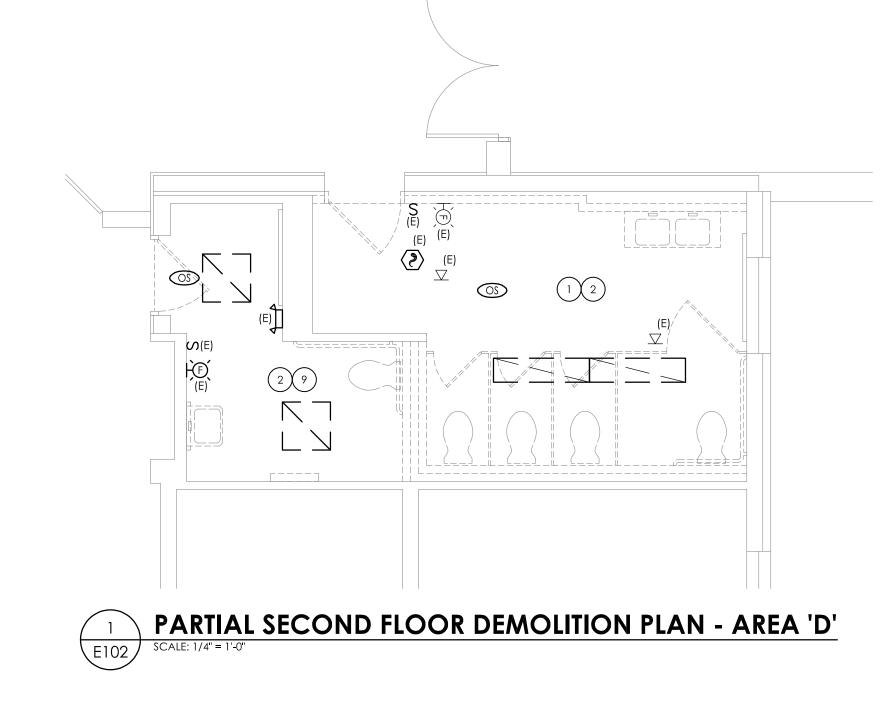
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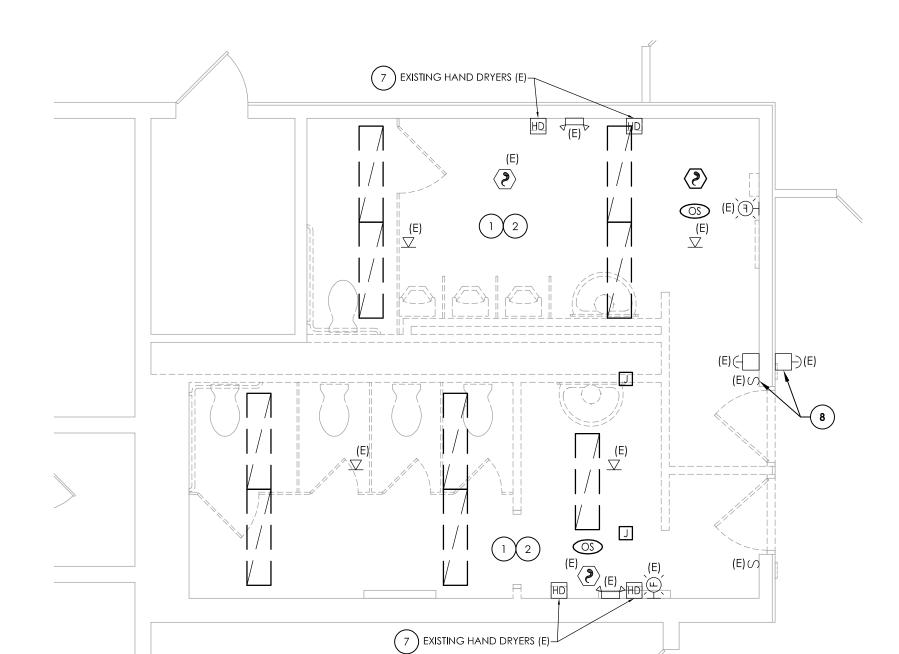
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TAPPAN ZEE HS FIRST AND SECOND FLOOR DEMOLITION PLANS


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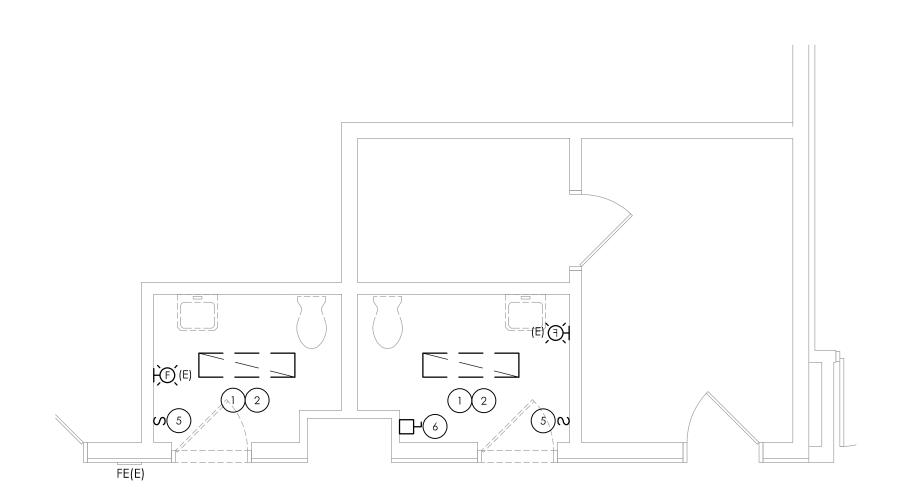






PARTIAL SECOND FLOOR DEMOLITION PLAN - AREA 'E'

SCALE: 1/4" = 1'-0"

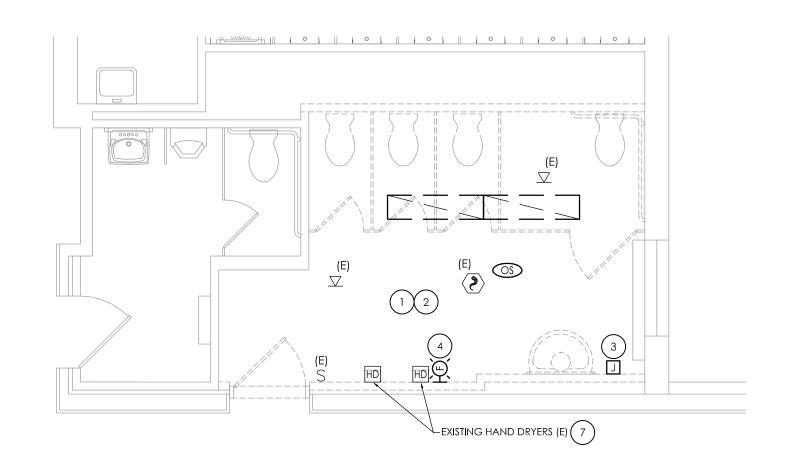

PARTIAL SECOND FLOOR DEMOLITION PLAN - AREA 'B'


SCALE: 1/4" = 1'-0"

GENERAL DEMOLITION NOTES:

- A. ALL ITEMS SHOWN ARE TO BE REMOVED UNLESS LABELED AS (E) EXISTING TO REMAIN. ANY DEVICE, AS WELL AS ITS ASSOCIATED CIRCUITING, AND CONDUIT, LABELED "(E)" SHALL REMAIN, UNLESS OTHERWISE NOTED.
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- D. THE CONTRACTOR SHALL REMOVE THE EXISTING ELECTRIC IN AREAS OF NEW RENOVATIONS TO ACCOMMODATE NEW CONSTRUCTION. REROUTING OF EXISTING MAY BE REQUIRED AT NEW OPENINGS IN EXISTING CONSTRUCTION OR INTERFERENCE WITH OTHER NEW WORK AS NOTED IN THE FOLLOWING NOTES.
- E. DRAWINGS INDICATE SPECIFIC ITEMS TO BE REMOVED AND/OR RELOCATED IN ORDER TO INDICATE GENERAL SCOPE. ADDITIONAL ITEMS NOT INDICATED, BUT NECESSARY FOR PROJECT RENOVATIONS, SHALL BE REMOVED, RELOCATED AND/OR REROUTED. THE CONTRACTOR SHALL ASSUME WITHIN THE BASE BID A NOMINAL AMOUNT OF BRANCH CIRCUITS, FIXTURES, DEVICES, AND SYSTEMS WIRING WITHIN WALLS OR OPENINGS TO BE REMOVED OR RELOCATED AS REQUIRED TO ACCOMMODATE THE NEW CONSTRUCTION.
- F. COORDINATE DEMOLITION OF EQUIPMENT, DEVICES, ETC. WITH OTHER DISCIPLINES AS APPLICABLE. REFER TO ARCHITECTURAL DEMOLITION DRAWINGS AND NOTES FOR COORDINATION.
- G. ALL ITEMS (DEVICES, FIXTURES, ETC.) SHOWN ARE TO BE REMOVED UNLESS LABELED AS EXISTING TO REMAIN (E). THESE ITEMS AND THEIR RELATED WIRING/CONDUIT SHALL BE REMOVED BACK TO THE SOURCE CONTROL PANEL/PANELBOARD UNLESS OTHERWISE NOTED. ON CIRCUITS WHERE OTHER DEVICES, FIXTURES, ETC. ARE FOUND THAT MUST REMAIN, MAINTAIN CIRCUIT CONTINUITY BY PROVIDING ADDITIONAL WIRING, TO FEED THROUGH TO THESE REMAINING ITEMS. RELOCATE ANY CIRCUITS THAT REMAIN, TO AVOID CONFLICT WITH NEW CONSTRUCTION AS REQUIRED. PROPERLY TERMINATE ALL WIRING.
- H. CONTRACTOR SHALL PROPERLY DISPOSE OF ALL ITEMS AND/OR EQUIPMENT BEING REMOVED AS PART OF THE PROJECT. THE OWNER SHALL HAVE THE RIGHT OF RETAINING ANY ITEMS BEING REMOVED.
- I. CONTRACTOR SHALL PROVIDE NEW COVERPLATES ON ALL UNUSED FLUSH MOUNT DEVICE BOXES UPON COMPLETION OF PROJECT.
- J. FIREPROOFING AND/OR FIRE STOP MATERIALS REMOVED FROM FIRE RATED WALLS AND CEILINGS AS A RESULT OF DEMOLITION SHALL BE RE-INSTALLED USING AN APPROVED METHOD AS DESCRIBED IN ASSOCIATED PROJECT SPECIFICATIONS.

KEY NOTES:

- DISCONNECT AND REMOVE EXISTING LIGHTING. PULL WIRING BACK AND TAG FOR RE-USE.
- DISCONNECT ALL EXISTING CEILING DEVICES, IE., SMOKE DETECTORS, OCCUPANCY SENSORS, AND VAPE SENSORS, AND STORE FOR RELOCATION. PULL WIRING BACK AND TAG FOR RE-USE.
- DISCONNECT AND REMOVE EXISTING JUNCTION BOX AND SURFACE RACEWAY TO SINK SENSORS. DISCONNECT AND REMOVE ALL WIRING BACK TO SOURCE.
- DISCONNECT EXISTING FIRE ALARM DEVICES AND STORE FOR RELOCATION. PULL WIRING BACK AND TAG FOR RE-USE.
- DISCONNECT AND REMOVE EXISTING SWITCH AND SWITCH LEG. EXISTING BACKBOX AND CONDUIT TO REMAIN FOR RE-USE.
- DISCONNECT AND REMOVE EXISTING WALL MOUNTED CIRCUIT BREAKERS AT LOCATION SHOWN. STORE FOR RELOCATION. PULL ALL CONDUIT AND WIRING BACK TO ABOVE CEILING. PROVIDE A JUNCTION BOX ABOVE CEILING TO TERMINATE ALL CONDUIT AND WIRE. TAG FOR RE-USE.
- DISCONNECT EXISTING HAND DRYER CONDUIT AND WIRING AND PULL BACK TO ABOVE CEILING SPACE. TAG ALL WIRING FOR RE-USE. REMOVE ALL SURFACE RACEWAY.
- 8 DISCONNECT AND REMOVE EXISTING DOOR OPERATORS. REMOVE ALL CONDUIT AND WIRING BACK TO SOURCE.
- 9 DISCONNECT AND REMOVE EXISTING LIGHT FIXTURES. PROTECT FROM DAMAGE AND TURN OVER TO OWNER. PULL WIRING BACK AND TAG FOR RE-USE.

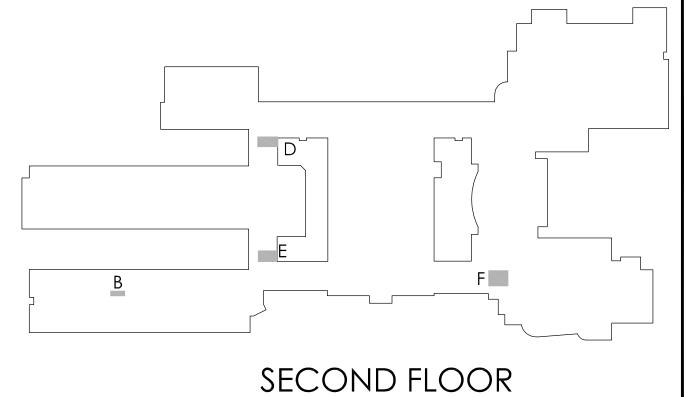





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CAPITAL IMPROVEMENT PROJECT 2022

VAN WYCK RD, BLAUVELT, NY 10913

AGE LANE ELEMENTARY - SED# 50-03-01-06-0-010-021

D. MIDDLE SCHOOL - SED# 50-03-01-06-0-013-028

PEN ZEE HIGH SCHOOL - SED# 50-03-01-06-0-006-031

DATE DRAWN CHECKED
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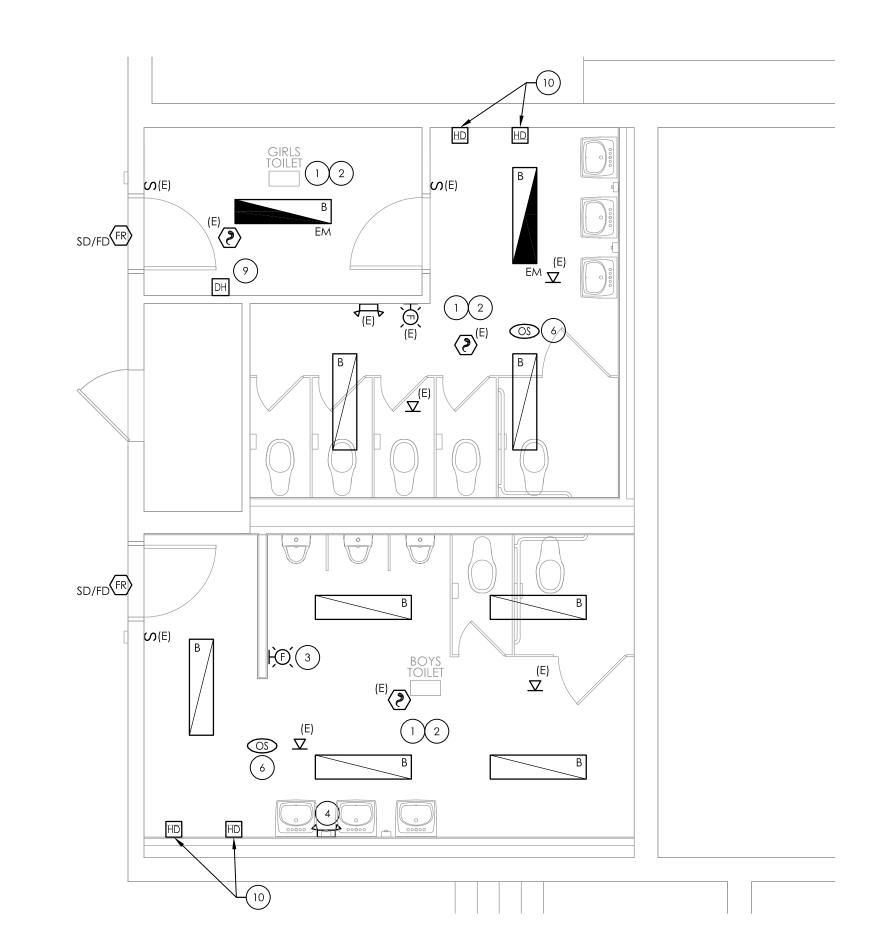
SHEET TITLE

TAPPAN ZEE HS
SECOND FLOOR
DEMOLITION PLANS

PROJECT NUMBER







PARTIAL FIRST FLOOR NEW WORK - AREA 'A' - ALTERNATE #EC-3

KEY NOTES:

- (1) CONNECT NEW LIGHT FIXTURES TO EXISTING LIGHTING CIRCUITRY TAGGED FOR RE-USE. REWORK/EXTEND CIRCUITRY AS NECESSARY TO ACCOMMODATE NEW LOCATIONS. REFER TO LUMINAIRE SCHEDULE ON DRAWING GEN-E900 FOR LIGHTING SPECIFICATIONS AND NOTES.
- RECONNECT ALL EXISTING RELOCATED CEILING DEVICES, IE., SMOKE DETECTORS, OCCUPANCY SENSORS, AND VAPE SENSORS, TO EXISTING TAGGED WIRING. DEVICES TO BE MOUNTED TO GYP CEILING.
- 3 RECONNECT EXISTING RELOCATED FIRE ALARM DEVICE TO EXISTING TAGGED WIRING. FIRE ALARM DEVICE TO BE WALL MOUNTED AT PREVIOUS HEIGHT.
- 4 RECONNECT EXISTING RELOCATED EMERGENCY LIGHTING FIXTURE TO EXISTING TAGGED WIRING. EMERGENCY LIGHTING FIXTURE TO BE WALL MOUNTED AT PREVIOUS HEIGHT.
- 5 RECONNECT EXISTING ADA DOOR OPENER TO EXISTING TAGGED WIRING. ADA DOOR OPENER TO BE WALL MOUNTED AT PREVIOUS
- 6 PROVIDE NEW CEILING MOUNTED OCCUPANCY SENSORS AS NOTED. PROVIDE ALL LOW VOLTAGE WIRING FROM NEW OCCUPANCY SENSORS TO NEW LIGHT FIXTURES.
- 7) NEW ADA DOOR OPERATOR EQUIPMENT AND PUSH BUTTONS. PROVIDE 120-VOLT POWER IN CEILING TO ACCOMMODATE POWER TO ADA DOOR OPERATOR EQUIPMENT. PROVIDE (2) #12, (1) 12 GND IN 3/4"C FROM SPARE 20-AMP, 1-POLE CIRCUIT BREAKER IN PANEL LPB-CP TO ADA DOOR EQUIPMENT. INSTALL ADA DOOR PUSH BUTTONS AND ALL ASSOCIATED POWER AND CONTROL WIRING BETWEEN DOORS AND PUSH BUTTONS. REFER TO SPECIFICATION SECTION 087100 FOR FURTHER INFORMATION.
- 8 NEW LOCATION OF EXISTING HAND DRYERS. CONNECT TO EXISTING CIRCUITRY TAGGED FOR RE-USE. REWORK/EXTEND CIRCUITRY AS NECESSARY TO ACCOMMODATE NEW LOCATIONS.
- PROVIDE DOOR HOLD OPEN AT LOCATION INDICATED. PROVIDE ALL WIRING AND TERMINATIONS TO CONNECT HOLD OPEN TO FIRE ALARM SYSTEM.
- PROVIDE (2) #12, (1) #12 GND IN 3/4" CONDUIT FROM EACH HAND DRYER TO PANEL LPC-GA IN CORRIDOR. PROVIDE (1) 20-AMP, 1-POLE CIRCUIT BREAKER IN PANEL TO ACCOMMODATE EACH NEW HAND DRYER, FOR A TOTAL OF (4) NEW BREAKERS. LABEL ACCORDINGLY.

ARCHITECTURE - ENGINEERING - PLANNING

50 FRONT STREET, SUITE 202


NEWBURGH, NEW YORK 12550 TEL (800) 274-9000 FAX (845) 567-9614

10/20/22 MAY SCALE AS NOTED


TAPPAN ZEE HS FIRST AND SECOND FLOOR NEW WORK


> PROJECT NUMBER 14457.16

> > DRAWING NUMBER

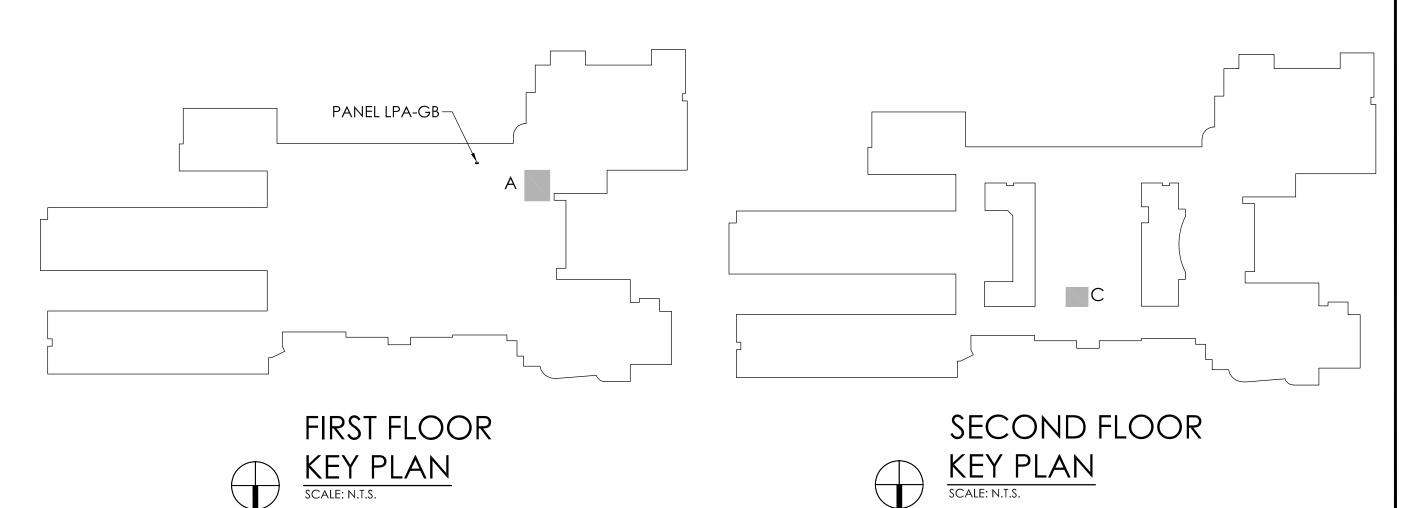




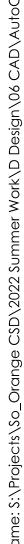


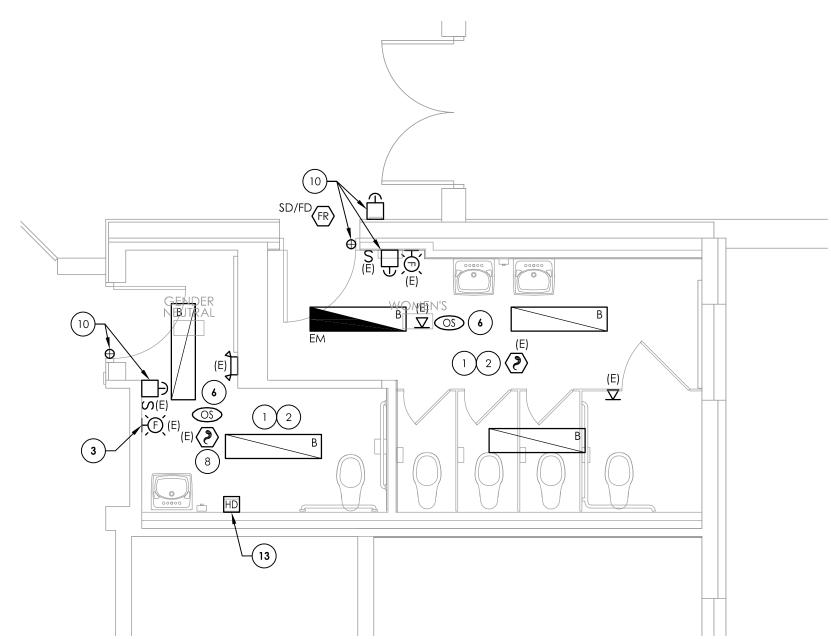



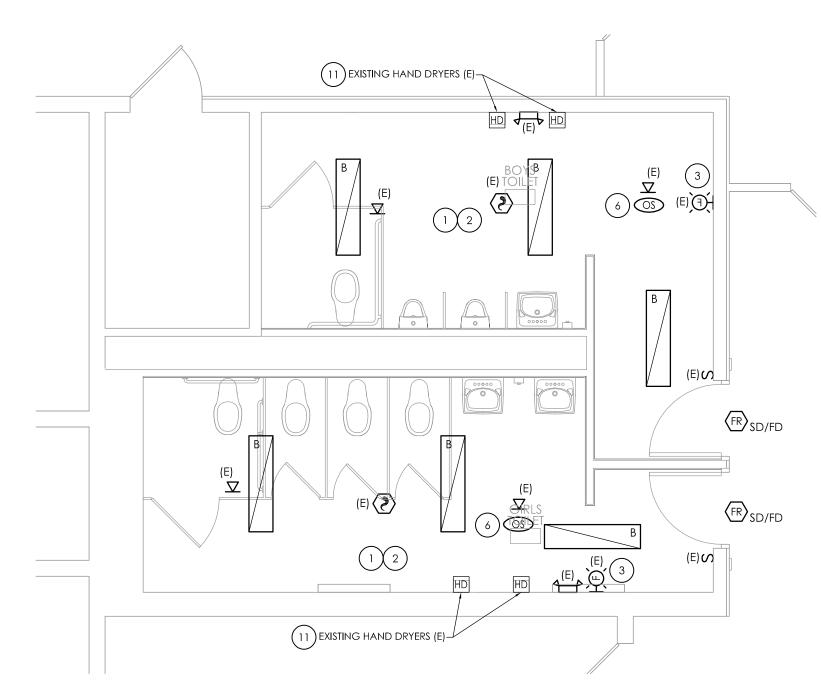


3 PARTIAL SECOND FLOOR NEW WORK - AREA 'F'

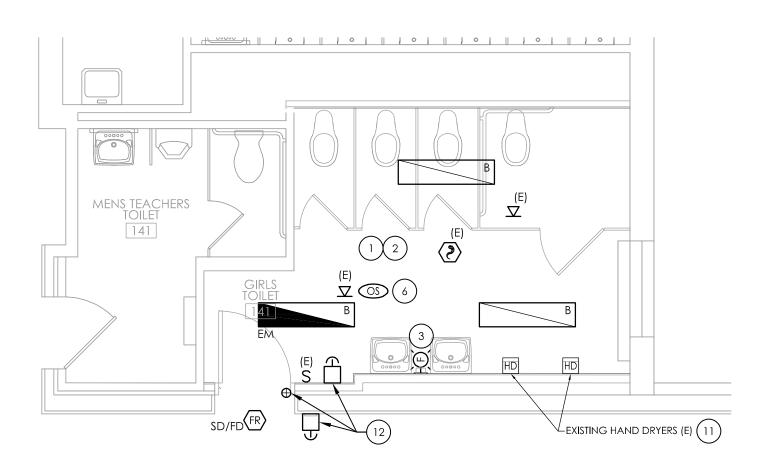

PARTIAL SECOND FLOOR NEW WORK - AREA 'E'

SCALE: 1/4" = 1'-0"

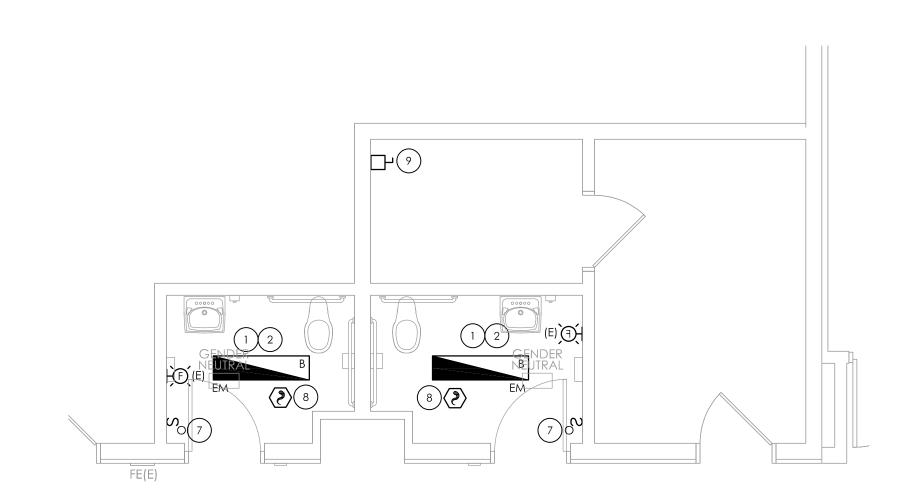

PARTIAL SECOND FLOOR NEW WORK - AREA 'B' - ALTERNATE #EC-4

KEY NOTES:

- 1 CONNECT NEW LIGHT FIXTURES TO EXISTING LIGHTING CIRCUITRY TAGGED FOR RE-USE. REWORK/EXTEND CIRCUITRY AS NECESSARY TO ACCOMMODATE NEW LOCATIONS. REFER TO LUMINAIRE SCHEDULE ON DRAWING GEN-E900 FOR LIGHTING SPECIFICATIONS AND NOTES.
- RECONNECT ALL EXISTING RELOCATED CEILING DEVICES, IE., SMOKE DETECTORS, OCCUPANCY SENSORS, AND VAPE SENSORS, TO EXISTING TAGGED WIRING. DEVICES TO BE MOUNTED TO GYP CEILING.
- RECONNECT EXISTING RELOCATED FIRE ALARM DEVICE TO EXISTING TAGGED WIRING. FIRE ALARM DEVICE TO BE WALL MOUNTED AT PREVIOUS HEIGHT.
- RECONNECT EXISTING RELOCATED EMERGENCY LIGHTING FIXTURE TO EXISTING TAGGED WIRING. EMERGENCY LIGHTING FIXTURE TO BE WALL MOUNTED AT PREVIOUS HEIGHT.
- FECONNECT EXISTING ADA DOOR OPENER TO EXISTING TAGGED WIRING. ADA DOOR OPENER TO BE WALL MOUNTED AT PREVIOUS HEIGHT.
- PROVIDE NEW CEILING MOUNTED OCCUPANCY SENSORS AS NOTED.
 PROVIDE ALL LOW VOLTAGE WIRING FROM NEW OCCUPANCY
 SENSORS TO NEW LIGHT FIXTURES.
- PROVIDE NEW OCCUPANCY SENSOR SWITCHING AS NOTED, IN EXISTING BACKBOX. PROVIDE ALL LOW VOLTAGE WIRING FROM NEW SWITCHING TO NEW LIGHT FIXTURES.
- PROVIDE NEW ADDRESSABLE SMOKE DETECTOR AT LOCATION SHOWN. DETECTOR TO MATCH EXISTING MANUFACTURER. WIRE SMOKE DETECTOR TO EXISTING FIRE ALARM LOOP.
- PROVIDE NEW CONDUIT AND WIRING TO MATCH EXISTING SIZE OF TAGGED WIRING FROM ABOVE CEILING JUNCTION BOX TO NEW LOCATION. PROVIDE ALL CONDUIT AND WIRING TO NEW LOCATION.
- NEW ADA DOOR OPERATOR EQUIPMENT AND PUSH BUTTONS.
 PROVIDE 120-VOLT POWER IN CEILING TO ACCOMMODATE POWER
 TO ADA DOOR OPERATOR EQUIPMENT. PROVIDE (2) #12, (1) 12 GND
 IN 3/4"C FROM PANEL LPA-1B TO ADA DOOR EQUIPMENT. PROVIDE
 (1) 20-AMP, 1-POLE CIRCUIT BREAKER IN PANEL TO ACCOMMODATE
 NEW DOOR OPERATORS. INSTALL ADA DOOR PUSH BUTTONS AND ALL
 ASSOCIATED POWER AND CONTROL WIRING BETWEEN DOORS AND
 PUSH BUTTONS. REFER TO SPECIFICATION SECTION 087100 FOR
 FURTHER INFORMATION.
- NEW LOCATION OF EXISTING HAND DRYERS. CONNECT TO EXISTING CIRCUITRY TAGGED FOR RE-USE. REWORK/EXTEND CIRCUITRY AS NECESSARY TO ACCOMMODATE NEW LOCATIONS.
- NEW ADA DOOR OPERATOR EQUIPMENT AND PUSH BUTTONS.
 PROVIDE 120-VOLT POWER IN CEILING TO ACCOMMODATE POWER
 TO ADA DOOR OPERATOR EQUIPMENT. PROVIDE (2) #12, (1) 12 GND
 IN 3/4"C FROM SPARE 20-AMP, 1-POLE CIRCUIT BREAKER IN PANEL
 LPA-1C TO ADA DOOR EQUIPMENT. INSTALL ADA DOOR PUSH
 BUTTONS AND ALL ASSOCIATED POWER AND CONTROL WIRING
 BETWEEN DOORS AND PUSH BUTTONS. REFER TO SPECIFICATION
 SECTION 087100 FOR FURTHER INFORMATION.
- PROVIDE (2) #12, (1) #12 GND IN 3/4" CONDUIT FROM HAND DRYER TO PANEL LPA-1B. PROVIDE (1) 20-AMP, 1-POLE CIRCUIT BREAKER IN PANEL TO ACCOMMODATE NEW HAND DRYER, LABEL ACCORDINGLY.




SCALE AS NOTED

14457.16

E202

DRAWING NUMBER

TAPPAN ZEE HS SECOND FLOOR NEW WORK PLANS

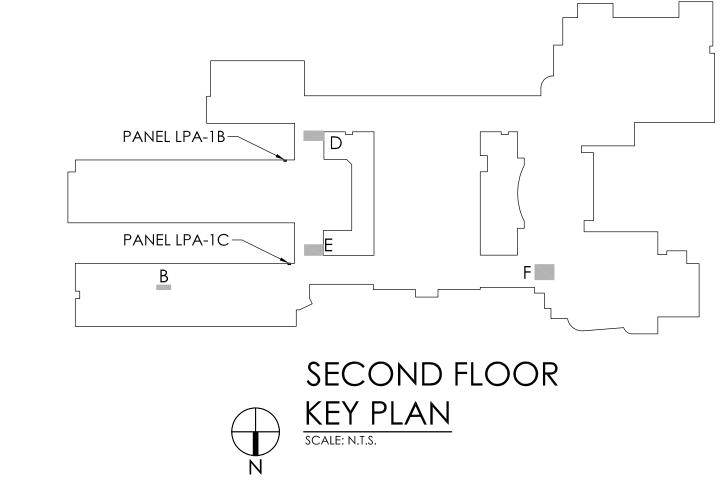



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LUMIN	AIRE SCHEDULE							
MARK	DESCRIPTION	DESIGN MAKE	MODEL #	VOLTS	QTY	L. WATTS	AMP MODEL #	REMARKS
А	2x4 RECESSED TROFFER	COLUMBIA	LCAT-9-35-MWHE-G-ED-U	VNV	-	30	3500K	-
A/EM	2x4 RECESSED TROFFER WITH EMERGENCY BATTERY BACKUP	COLUMBIA	LCAT-9-35-MWHE-G-ED-U-ELL14	UNV	-	30	3500К	2,3
В	1x4 RECESSED FLAT PANEL LED FIXTURE	COLUMBIA	CFP14-55/41/3435	UNV	-	39	3500K	1
В/ЕМ	1x4 RECESSED FLAT PANEL LED FIXTURE WITH EMERGENCY BATTERY BACKUP	COLUMBIA	CFP14-55/41/3435-PLD10M	UNV	-	53	3500K	1,2,3
С	2X2 RECESSED FLAT PANEL LED FIXTURE	COLUMBIA	CFP22-40/33/2835	UNV	-	40	3500K	1
C/EM	2X2 RECESSED FLAT PANEL LED FIXTURE WITH EMERGENCY BATTERY BACKUP	COLUMBIA	CFP22-40/33/2835-PLD10M	UNV	-	40	3500К	1,2,3

REMARKS:

- 1. FIXTURES TO BE RECESSED MOUNTED INTO DRYWALL CEILING. PROVIDE DRYWALL FRAME KIT FK14 FOR ALL FIXTURES.
- 2. ALL FIXTURES SHOWN WITH AN "EM" DESIGNATION SHALL HAVE 90-MINUTE BATTERY CAPACITY.

 3. ALL FIXTURES SHOWN WITH AN "EM" DESIGNATION INDICATES EMERGENCY LIGHTING FIXTURE. PROVIDE EMERGENCY BATTERY BACKUP FOR EACH FIXTURE INDICATED.

ELECTRICAL EQUIPMENT WIRING SCHEDULE									
ITEM NUMBER	EQUIPMENT	HP/ FLA	VOLTS	PHASE	AMPS	BREAKER SIZE/ FUSE SIZE	WIRE/CONDUIT SIZE	PANEL/CCT	REMARKS
1	EF-1	1/6 HP	120	1	4A	-	(2) #12, (1) #12GND IN 3/4"C	-	1,2


REMARKS:

- 1. ELECTRICAL CONTRACTOR IS RESPONSIBLE FOR THE MOUNTING, AND LINE/LOAD SIDE CONNECTIONS OF DISCONNECT AND/OR STARTER DEVICE ASSOCIATED WITH UNIT. MEANS OF DISCONNECT AND/OR STARTER ASSOCIATED WITH UNIT PROVIDED BY MECHANICAL CONTRACTOR. ELECTRICAL CONTRACTOR IS RESPONSIBLE FOR ALL FINAL CONNECTIONS TO EQUIPMENT.
- 2. EXHAUST FAN TO BE WIRED TO EXISTING LIGHTING CIRCUIT FEEDING THE SPACE. TIE EXHAUST FAN INTO OCCUPANCY SENSORS FOR ON/OFF CONTROL. PROVIDE ALL WIRING TO ACCOMMODATE.



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REVISIONS	O	
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CENTRAL SCHOOL DISTRICT
CAPITAL IMPROVEMENT PROJECT 2022
60 VAN WYCK RD, BLAUVELT, NY 10913
S.O. MIDDLE SCHOOL - SED# 50-03-01-06-0-013-028
TAPPEN ZEE HIGH SCHOOL - SED#50-03-01-06-0-006-031

DATE DRAWN CHECKED
10/20/22 MAY JBT

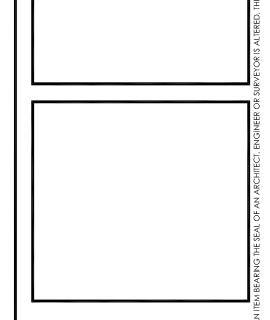SCALE AS NOTED

SHEET TITLE

SCHEDULES

PROJECT NUMBER

