

ABBREVIATIONS

AD	AREA DRAIN
BFP	BACKFLOW PREVENTOR
BT	BATHTUB
CI	CAST IRON
CL	CENTER LINE
CLG	CEILING
CO	CLEANOUT
CODP	CLEANOUT DECK PLATE
COWP	CLEAN OUT WALL PLATE
COL	COLUMN
CP	CONTROL PANEL
CW	COLD WATER
DCV	DOUBLE CHECK VALVE
DDDA	DOUBLE CHECK DETECTOR ASSEMBLY
DF	DRINKING FOUNTAIN
DFU	DRAINAGE FIXTURE UNIT
DIA	DIAMETER
DN	PIPE DOWN THRU FLOOR
DR	DRAIN
DW	DISH WASHER
DWG	DRAWING
EL	ELEVATION
ELEC	ELECTRIC
ETBR	EXISTING TO BE REMOVED
ETR	EXISTING TO REMAIN
EW	ELECTRIC WATER COOLER
EWV	ELECTRIC WATER HEATER
EXIST	EXISTING
F	FIRE SERVICE
FAI	FRESH AIR INTAKE
FD	FLOOR DRAIN
FFD	FUNNEL FLOOR DRAIN
FL	FLOOR
FU	FIXTURE UNIT
FS	FLOOR SINK
G	GAS
GAL	GALLON
GC	GENERAL CONTRACTOR
GI	GREASE INTERCEPTOR
GM	GAS METER
GV	GATE VALVE
GW	GRAY WASTE
HB	HOSE BIB
HC	HANDICAPPED
HVAC	HEATING, VENTILATION & AIR CONDITIONING
HW	HOT WATER
HWH	HOT WATER HEATER
HWR	HOT WATER RETURN
IG	IRRIGATION PIPING
IE	INVERT ELEVATION
IW	INDIRECT WASTE
JS	JANITOR SINK

KS	KITCHEN SINK
L	LEADER
LAV	LAVATORY
LP	LOW PRESSURE
MAX	MAXIMUM
MIN	MINIMUM
MGCV	MASTER GAS CONTROL VALVE
MICV	METER INLET CONTROL VALVE
MS	MOP SINK
NFWH	NON-FREEZE WALL HYDRANT
NIC	NOT IN CONTRACT
NTS	NOT TO SCALE
OD	OVERFLOW DRAIN
OS&Y	OUTSIDE SCREW & YOKE
PG	PRESSURE GAUGE
PLMB	PLUMBING
PO	PLUGGED OUTLET
POE	POINT OF ENTRY
PS	PANTRY SINK
RD	ROOF DRAIN
REF	REFRIGERATOR
RPZ	REDUCED PRESSURE ZONE
RM	ROOM
S	SOIL
SA	SHOCK OBSORBER
SS, SAN	SANITARY
ST	STORM DRAIN
SE	SEWAGE EJECTOR
SP	SUMP PUMP
SH	SHOWER
SPEC	SPECIFICATIONS
SQ. FT.	SQUARE FEET
TD	TRENCH DRAIN
TMV	THERMOSTATIC MIXING VALVE
TR	TRAP
TYP	TYPICAL
UR	URINAL
V	VENT
VTR	VENT THROUGH ROOF
VB	VACUUM BREAKER
W	WASTE
WC	WATER CLOSET
WH	WALL HUNG
WHA	WATER HAMMER ARRESTER
WSFU	WATER SUPPLY FIXTURE UNIT

PLUMBING SYMBOLS

SYMBOL	DESCRIPTION
	PROPOSED SANITARY PIPING BELOW GRADE
	EXISTING SANITARY PIPING BELOW GRADE
	PROPOSED SANITARY WASTE (S OR W)
	EXISTING SANITARY WASTE (S OR W)
	PROPOSED STORM DRAINAGE (ST)
	EXISTING STORM DRAINAGE (ST)
	PROPOSED OVERFLOW STORM DRAINAGE
	EXISTING OVERFLOW STORM DRAINAGE
	PROPOSED VENT
	EXISTING VENT
	PROPOSED DOMESTIC COLD WATER
	EXISTING DOMESTIC COLD WATER
	PROPOSED DOMESTIC HOT WATER
	EXISTING DOMESTIC HOT WATER
	PROPOSED DOMESTIC HOT WATER RETURN
	EXISTING DOMESTIC HOT WATER RETURN
	PROPOSED NATURAL GAS
	EXISTING NATURAL GAS
	RAINWATER REUSE
	SEWAGE EJECTOR DISCHARGE
	PUMP DISCHARGE PIPING
	GRAY WATER (LA ONLY)
	GREASE WASTE
	SOFTENED WATER
	PURIFIED WATER
	COMPRESSED AIR
	OXYGEN
	NITROGEN
	LAB VACUUM
	LAB AIR
	LAB GAS
	TEPID WATER
	REMOVE EXISTING PIPING
	PIPING WITH ELECTRIC TRACE HEATING
	PIPING INTERRUPTED OR TO BE CONTINUED
	CAP OR END OF PIPE
	SECTION SHEET No. SECTION NUMBER
	SYSTEM DESCRIPTION RISER NUMBER PLUMBING RISER
	SYSTEM DESCRIPTION RISER NUMBER STORM RISER
	SYSTEM DESCRIPTION RISER NUMBER GAS RISER
	EQUIPMENT DESCRIPTION EQUIPMENT NUMBER EQUIPMENT REFERENCE
	POINT OF DISCONNECT
	CONNECT NEW TO EXISTING
	HOT WATER BALANCING ASSEMBLY
	CLEANOUT
	CLEANOUT DECK PLATE
	DRAIN
	HOUSE TRAP
	P-TRAP
	SHOCK ABSORBER
	TRAP PRIMER
	ARROW INDICATES DIRECTION OF FLOW
	ELBOW UP OR RISE
	ELBOW DN OR DROP

PLUMBING SYMBOLS

SYMBOL	DESCRIPTION
	BOTTOM CONNECTION
	TOP CONNECTION
	UNION SCREWED
	PIPE SLEEVE
	WATERPROOF PIPE SLEEVE
	NON FREEZE WALL HYDRANT
	VALVE ON PIPE RISE
	BACK FLOW PREVENTER
	DOUBLE CHECK DETECTOR ASSEMBLY (FIRE PROTECTION)
	REDUCED PRESSURE ZONE VALVE ASSEMBLY (FIRE PROTECTION)
	DOUBLE CHECK ASSEMBLY (FIRE PROTECTION)
	CHECK VALVE
	GATE VALVE
	BALL VALVE
	GAS VALVE
	GLOBE VALVE
	PRESSURE REDUCING VALVE
	TEMPERATURE & PRESSURE RELIEF VALVE
	PRESSURE REGULATING VALVE
	THERMOSTATIC MIXING VALVE
	VALVED CAPPED OUTLET
	CURB VALVE
	SOLENOID VALVE
	OUTSIDE STEM AND YOKE VALVE
	OUTSIDE STEM AND YOKE VALVE W/ TAMPER SWITCH
	STRAINER
	PRESSURE GAUGE
	HOSE BIB
	VACUUM BREAKER
	THERMOMETER
	PUMP
	CIRCULATOR PUMP
	SCHEMATIC PUMP
	FLOOR SINK
	VENT THRU ROOF
	METER
	FILTER
	FAI
	VENT INCREASER

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Key Plan

Description	Date
Filing Set	06/17/22

Project

Storm King Art Center

C.F.M. Building

Seal

NOT FOR CONSTRUCTION

Drawing Title

Abbreviations, Symbols & Legends

Date	06/17/22
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PLUMBING NOTES:

1. CONTRACTOR SHALL VERIFY ALL DIMENSIONS AND JOB CONDITIONS AND SHALL REPORT TO ENGINEER ANY DISCREPANCIES OR OMISSIONS THAT WOULD INTERFERE WITH SATISFACTORY COMPLETION OF THE WORK.
2. CONTRACTOR SHALL VISIT THE JOB SITE AND THOROUGHLY FAMILIARIZE THEMSELVES WITH ALL EXISTING CONDITIONS PRIOR TO THE BEGINNING OF CONSTRUCTION.
3. ALL WORK SHALL BE PERFORMED BY A LICENSED PLUMBING CONTRACTOR IN A FIRST CLASS WORKPERSON LIKE MANNER. THE COMPLETED SYSTEM SHALL BE FULLY OPERATIVE AND FUNCTIONAL.
4. NOTIFY BUILDING MANAGER AT LEAST 48 HOURS BEFORE NEW WORK OR BEFORE SHUT DOWN OF EXISTING SERVICES. RISER SHUT DOWNS SHALL BE PERFORMED AT TENANT'S COST, AT DESIGNATED TIMES UNDER BUILDING MANAGER'S SUPERVISION AND ONLY WITH THEIR APPROVAL.
5. CONTRACTOR SHALL BE RESPONSIBLE FOR ARRANGING WITH BUILDING MANAGEMENT FOR HANDLING MATERIALS, AS WELL AS FOR ALLOWABLE WORKING HOURS AND DELIVERIES.
6. PLUMBING CONTRACTOR SHALL COORDINATE ALL WORK WITH RESPECT TO ALL OTHER TRADES, INCLUDING STRUCTURE AND CEILING HEIGHTS. CONTRACTOR SHALL COORDINATE ALL WORK WITH ARCHITECTURAL LAYOUTS, INCLUDING CEILING HEIGHTS.
7. CONTRACTOR SHALL SUBMIT ALL SHOP DRAWINGS AND MANUFACTURERS' CUTS AND SAMPLES TO ARCHITECT PRIOR TO COMMENCEMENT OF SUCH WORK.
8. CONTRACT DRAWINGS ARE NOT TO BE SCALED.
9. CONTRACTOR SHALL COMPLY WITH ALL NEW YORK STATE AND LOCAL BUILDING DEPARTMENT AND REGULATORY AGENCIES AND CODE REQUIREMENTS. BE RESPONSIBLE FOR SECURING ALL NECESSARY PERMITS AND APPROVALS OF ALL TRADES.
10. CONTRACTOR SHALL CARRY AND DOCUMENT LIABILITY, ACCIDENT AND PROPERTY DAMAGE INSURANCE AS REQUIRED BY COOPERATIVE CORPORATION AND OBSERVE THEIR PERMITTED HOURS FOR WORK.
11. CONTRACTOR SHALL EXERCISE EXTREME CARE IN PROTECTING AREAS ADJACENT TO CONSTRUCTION AREAS, SHALL FULLY PROTECT THEM FROM ANY DAMAGE RESULTING FROM CONTRACTOR'S WORKPERSONS, SUBCONTRACTORS OR AGENTS, AND SHALL BE RESPONSIBLE FOR REPAIRING, CLEANING OR REPLACING ANY SUCH DAMAGE.
12. ALL DIMENSIONS GIVEN ARE FINISH DIMENSIONS UNLESS OTHERWISE STATED.
13. REFER TO ARCHITECTURAL DRAWINGS FOR DIMENSIONS UNLESS SPECIFICALLY STATED OTHERWISE. CONTRACTOR SHALL FURNISH ALL LABOR, MATERIALS, APPURTENANCES, EQUIPMENT AND SERVICES TO COMPLETE ALL WORK AS INDICATED ON DRAWINGS AND/OR SPECIFIED ON NOTES.
14. UNLESS SPECIFICALLY STATED OTHERWISE, CONTRACTOR SHALL FOLLOW MANUFACTURERS' DIRECTIONS WITH APPLICABLE CODES, INSTRUCTIONS AND RECOMMENDATIONS FOR ALL MATERIALS AND PROCESSES USED IN THIS CONTRACT. PROVIDE ALL FITTINGS, TRANSITIONS, VALVES, AND OTHER DEVICES REQUIRED FOR A COMPLETE WORKABLE INSTALLATION.
15. UPON COMPLETION OF THE WORK, COMPLETELY CLEAN THE CONSTRUCTION AREA SUITABLE FOR THE OWNER'S USE, INCLUDING REMOVAL OF ALL LABELS (AFTER ARCHITECT'S INSPECTION), CLEANING OF ALL THE EQUIPMENT, CONSTRUCTION WORK, WINDOWS AND OTHER WORK, NEW AND OLD, IN THAT CONSTRUCTION AREA. MAINTENANCE MANUAL SHALL BE PROVIDED TO THE OWNER.
16. BUILDING DEPARTMENT APPROVED PLANS SHALL BE TURNED OVER TO OWNER AT THE COMPLETION OF THE JOB.
17. AT THE FINAL COMPLETION OF THE JOB, CONTRACTOR SHALL SUBMIT TO THE OWNER AND TO ENGINEER A NOTARIZED AFFIDAVIT STATING COMPLIANCE WITH ALL PROVISIONS OF THIS CONTRACT, INCLUDING ALL NOTES, EXCEPT FOR THOSE CHANGES SPECIFICALLY APPROVED IN WRITING BY THE ARCHITECT.
18. VACUUM BREAKER AND RELATED PIPING SHALL BE INSTALLED BEHIND WALL; PROVIDE AN ACCESS PANEL TO THE VACUUM BREAKER. ALL EXPOSED PIPING AT THE PANTRY SHALL BE STEEL WITH CHROME PLATED FINISH.
19. CONTRACTOR SHALL GUARANTEE ALL WORK PERFORMED UNDER THIS CONTRACT FOR ONE YEAR, STARTING FROM DATE OF FINAL COMPLETION OF ALL WORK.
20. PROVIDE CLEANOUTS FOR CHANGES IN DIRECTION FOR ALL SANITARY PIPING.
21. CONTRACTOR SHALL COORDINATE ALL FLOOR CORING SLEEVES AND FLOOR OPENINGS WITH STRUCTURAL DRAWINGS.
22. ALL PIPING PENETRATIONS THROUGH WALLS OR CEILINGS SHALL BE PROVIDED WITH APPROPRIATE FIRE RETARDANT SEALANT AND ESCUTCHEONS.
23. PLUMBING CONTRACTOR SHALL OBTAIN THE BUILDINGS RULES AND REGULATIONS PRIOR TO BID AND SHALL MEET ALL REQUIREMENTS. NO EXTRA MONEY WILL BE AWARDED FOR ANY WORK PERFORMED AND MATERIAL PURCHASED THAT DOES NOT MEET THE REQUIREMENTS.
24. ALL FIXTURES MUST BE PROVIDED WITH READILY ACCESSIBLE STOPS AND APPROPRIATELY MARKED ACCESS PANELS. COORDINATE LOCATIONS WITH GENERAL CONTRACTOR PRIOR TO INSTALLATION.
25. PLATFORMS, CURBS, AND FLASHINGS FOR PLUMBING EQUIPMENT SHALL BE AS INDICATED ON THE STRUCTURAL AND ARCHITECTURAL PLANS, UNLESS NOTED OTHERWISE. COORDINATE EXACT SIZES OF REQUIRED OPENINGS AND SUPPORTS FOR FURNISHED EQUIPMENT.
26. PROVIDE DRAIN DRIP PANS UNDER ALL PLUMBING DRAINAGE PIPING TO BE INSTALLED WITHIN THE ELECTRICAL AND TELEPHONE EQUIPMENT, KITCHEN, PANTRY OR FOOD PREPARATION AND DINING ROOM CEILINGS. PROVIDE TELLTALE DRAINAGE PIPE AND SPILL OVER CLOSET FLOOR DRAIN OR SERVICE SINK.
27. PROVIDE ACCESS DOORS FOR SHUTOFF VALVES, SHOCK ABSORBERS, HOT WATER RETURN BALANCING RIGS, TRAP PRIMERS AND CLEANOUTS.
28. CONTRACTOR TO VERIFY SYSTEM WORKING PRESSURE AND PROVIDE PRESSURE REDUCING VALVES WHERE APPLICABLE.
29. CONTRACTOR TO PROVIDE SHOCK ABSORBERS PRIOR TO ALL QUICK CLOSING VALVES.

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Key Plan

Description	Date
Filing Set	06/17/22

Project

Storm King Art Center C.F.M. Building


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Drawing Title

General Notes

Date	06/17/22
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Key Plan



Description	Date
Filing Set	06/17/22

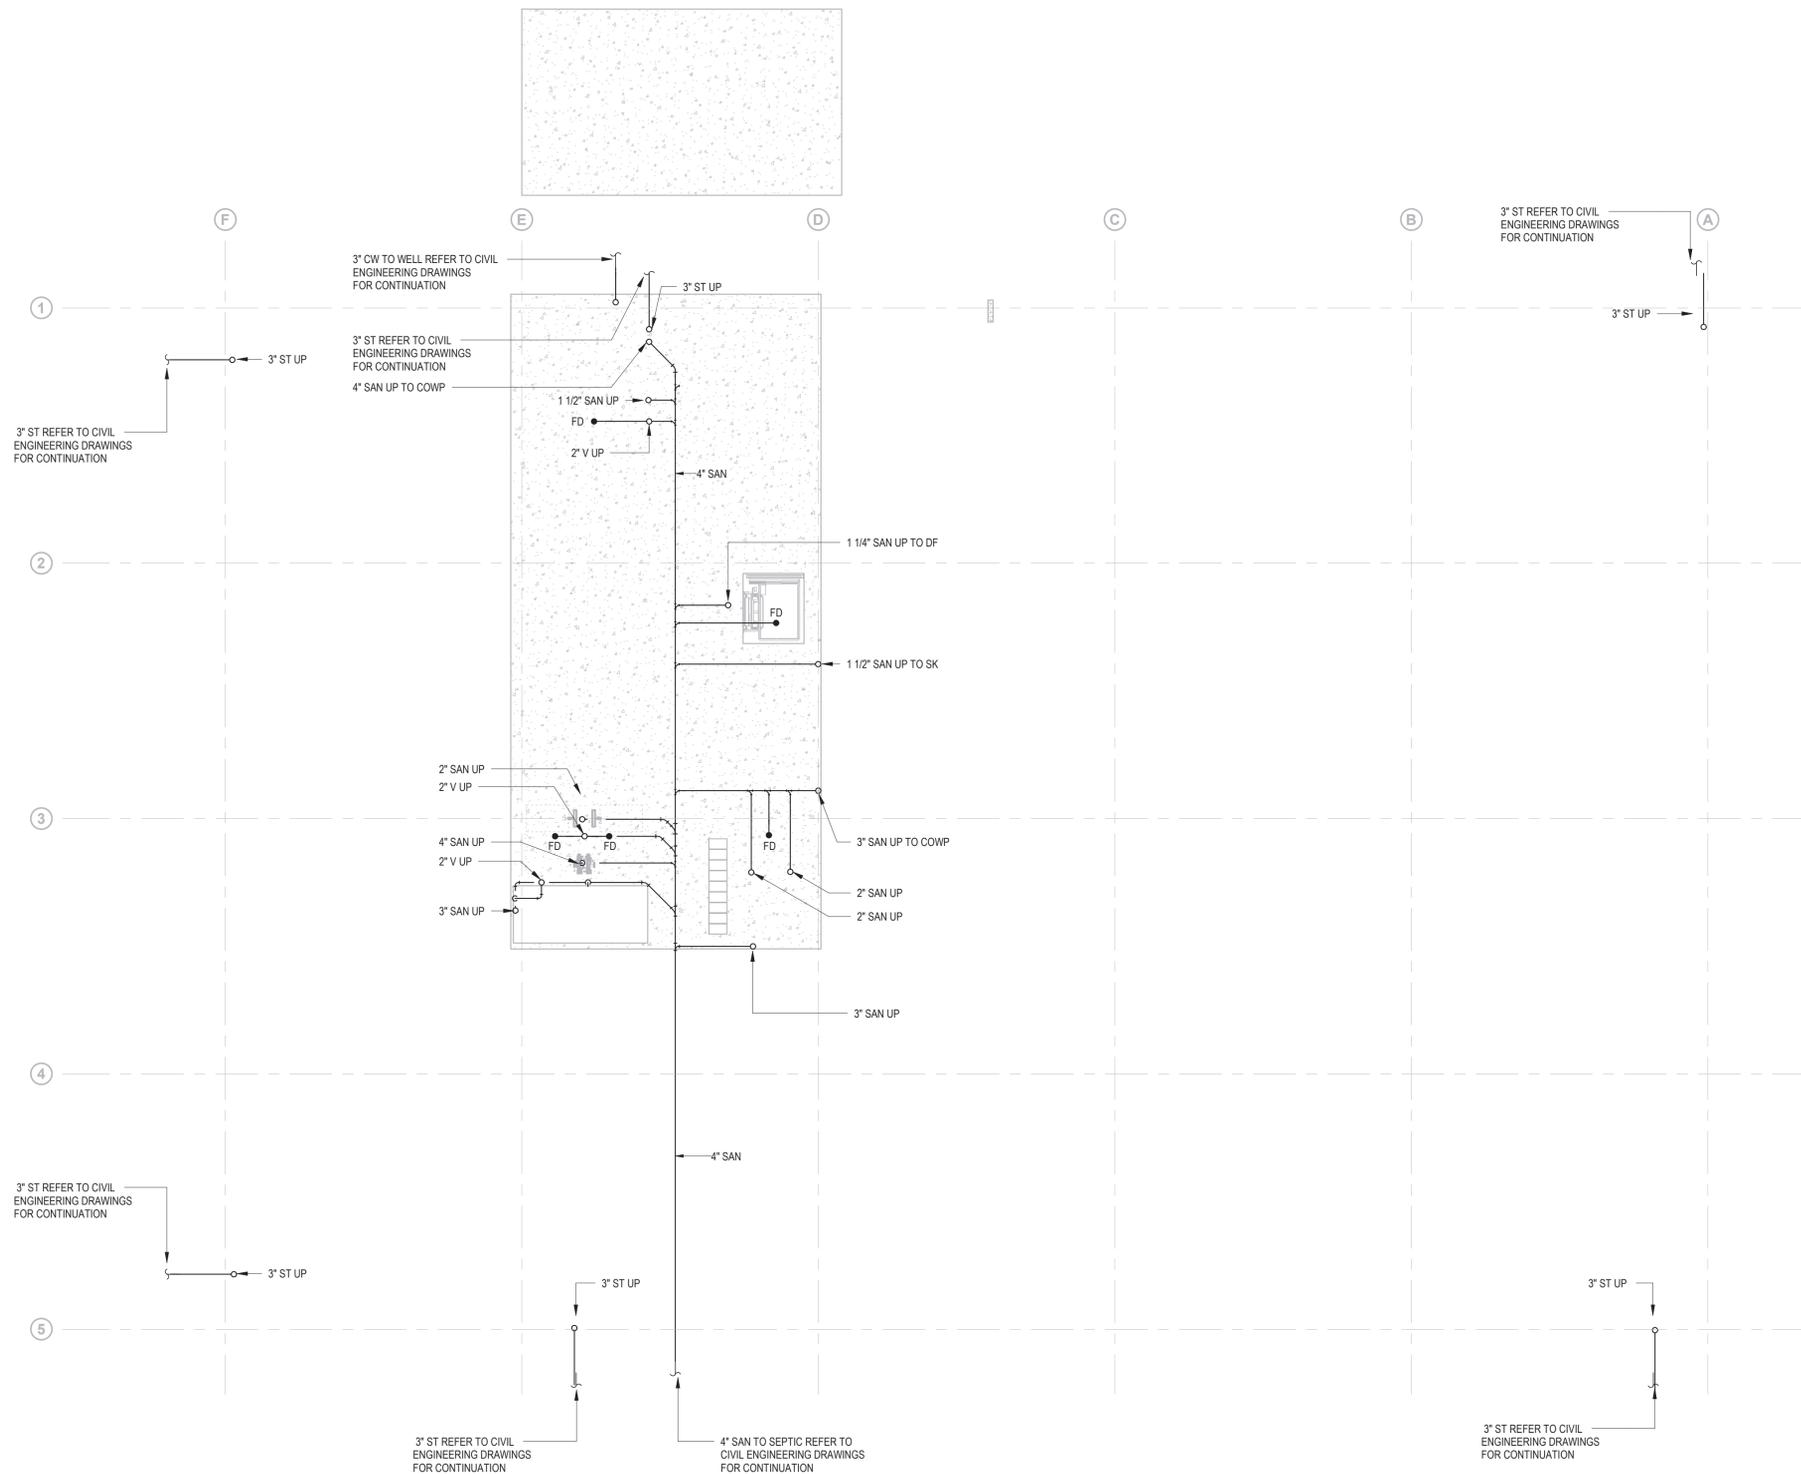Project


**Storm King
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 C.F.M.
 Building**

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Drawing Title
**Piping Plan -
 Underslab**

Date	06/17/22
Scale	1/8" = 1'-0"
Drawing Number	P-C-100
Sheet Size	ARCH D



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Key Plan

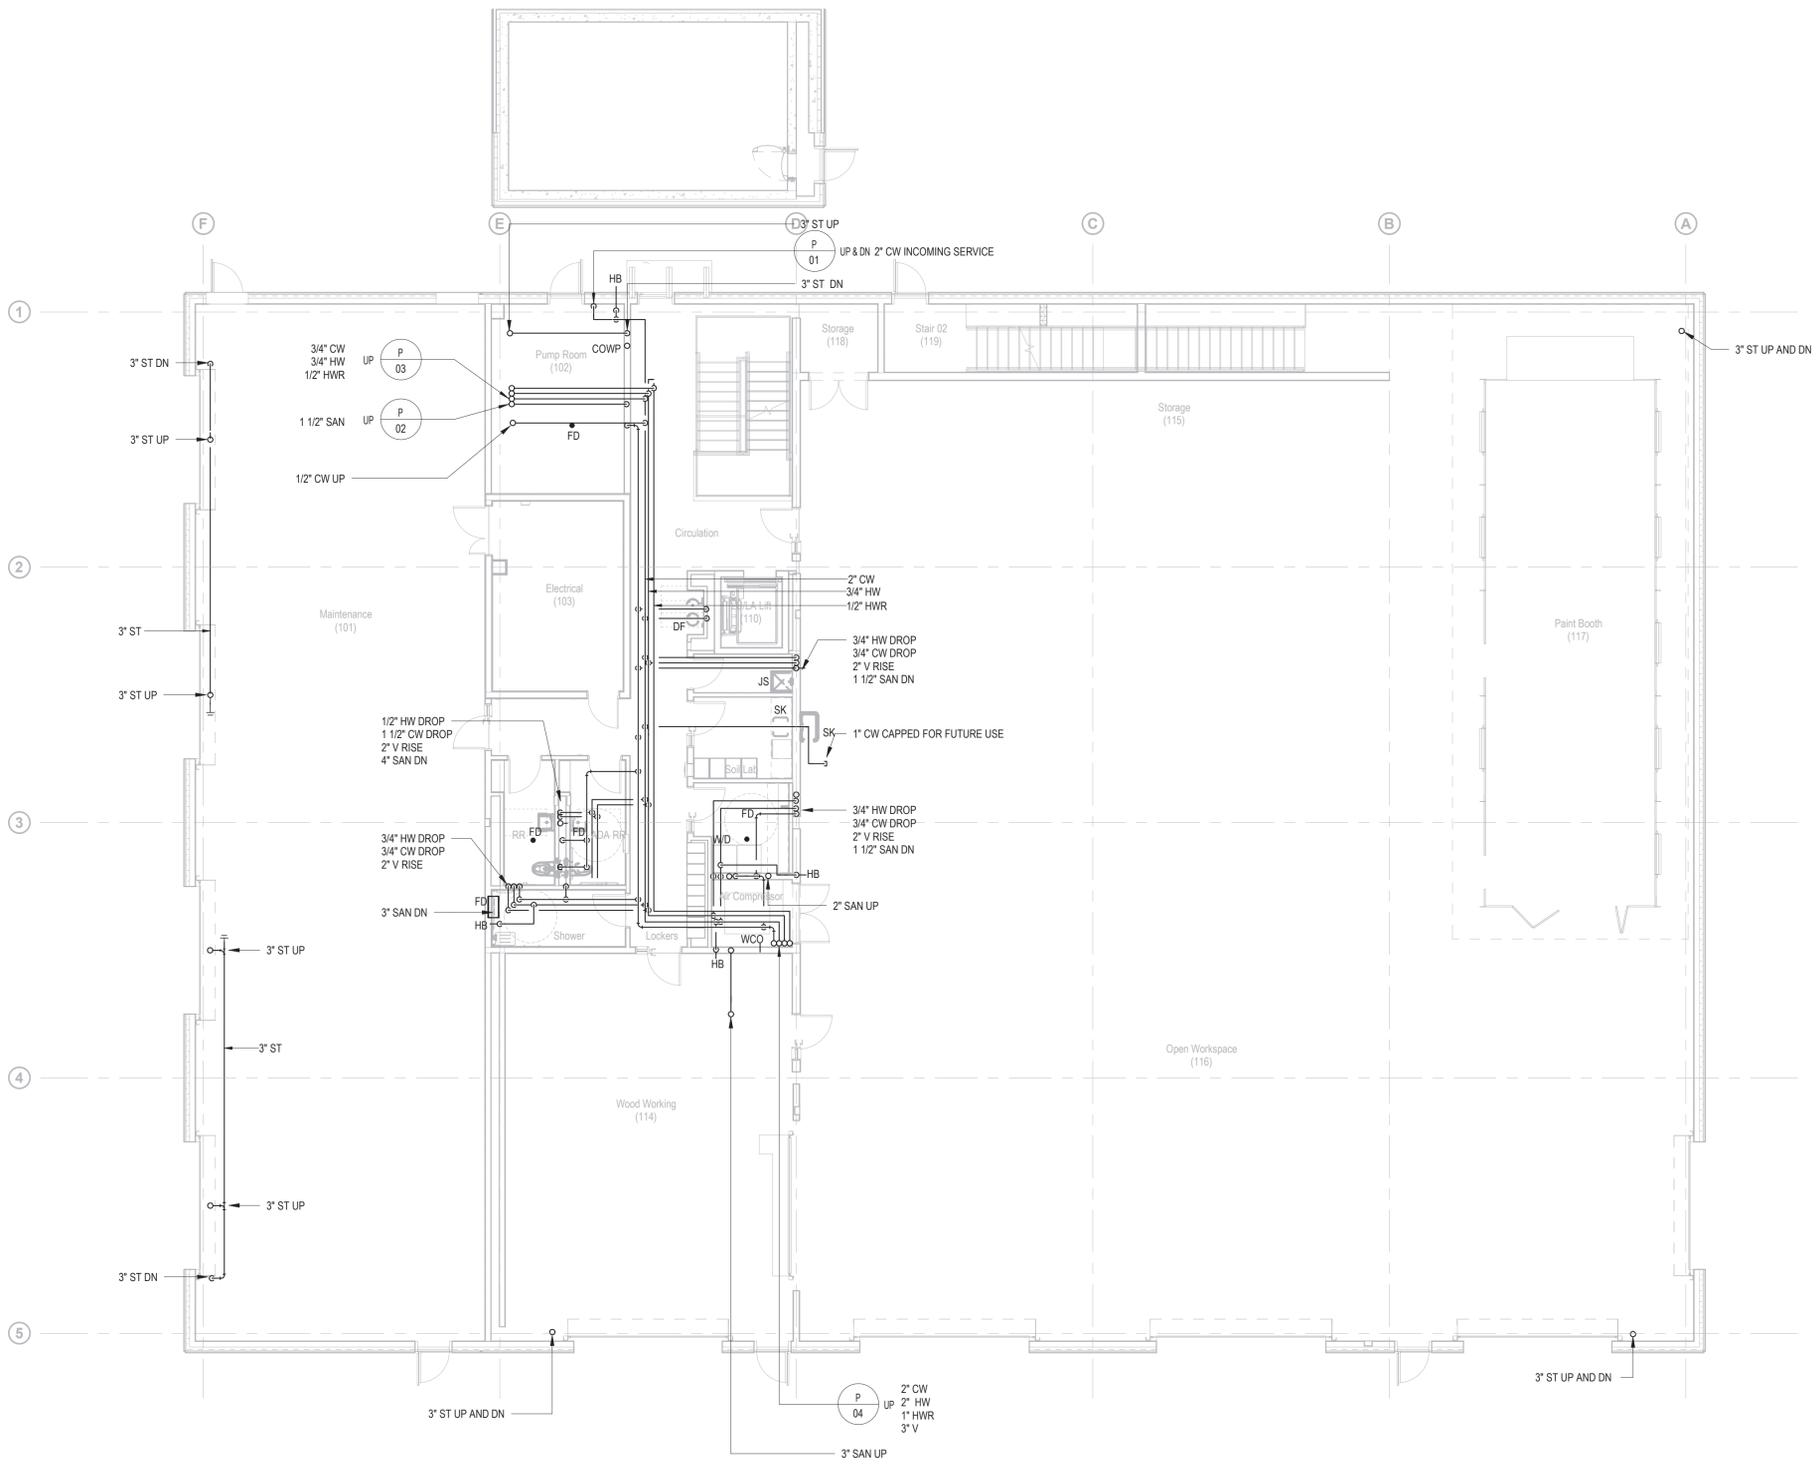

Description	Date
Filing Set	06/17/22

Project
 Storm King
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 Building

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 Drawing Title
 Piping Plan - Ground
 Level

Date	06/17/22
Scale	1/8" = 1'-0"
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Key Plan



Description	Date
Filing Set	06/17/22

Project

Storm King Art Center C.F.M. Building

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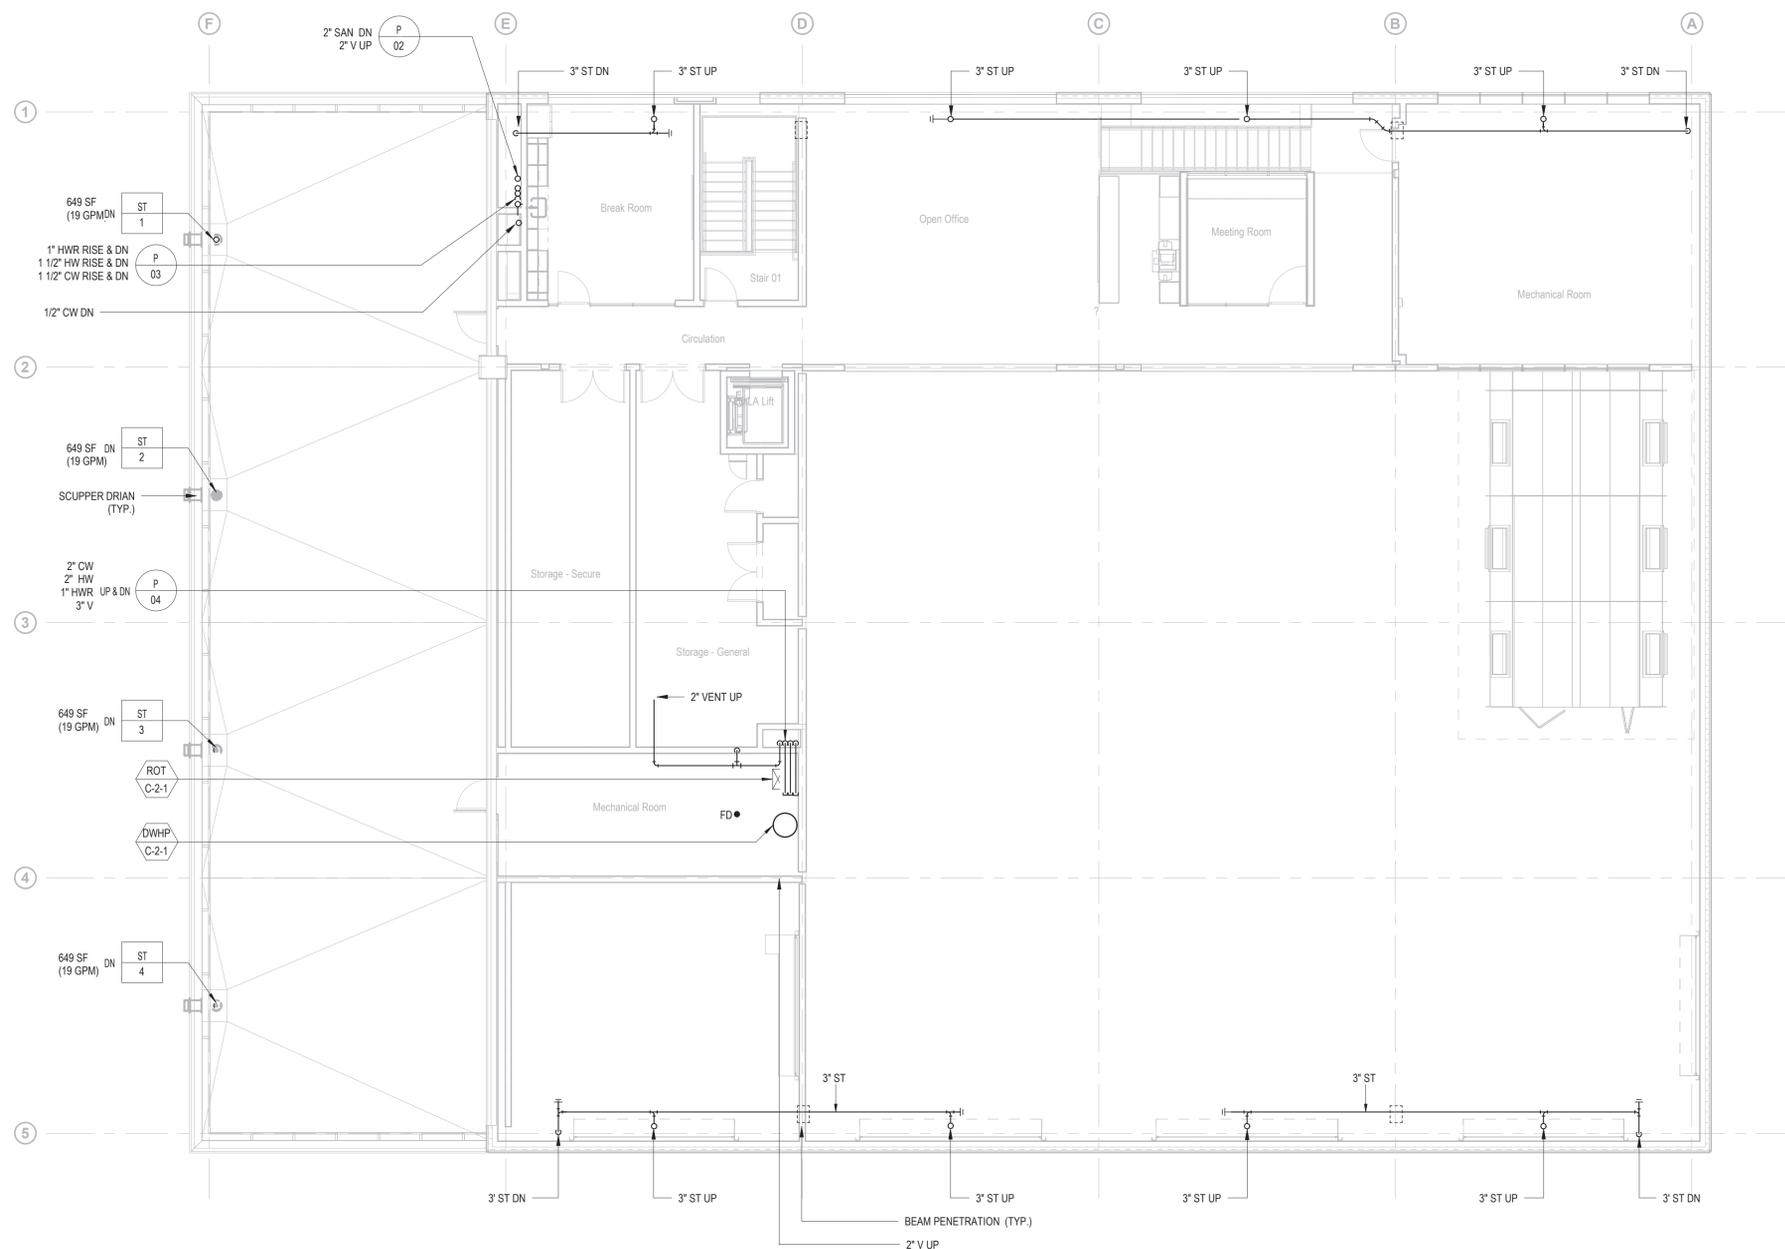
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**Piping Plan - Second
 Level**

Date 06/17/22

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Drawing Number **P-C-102**

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Key Plan


	
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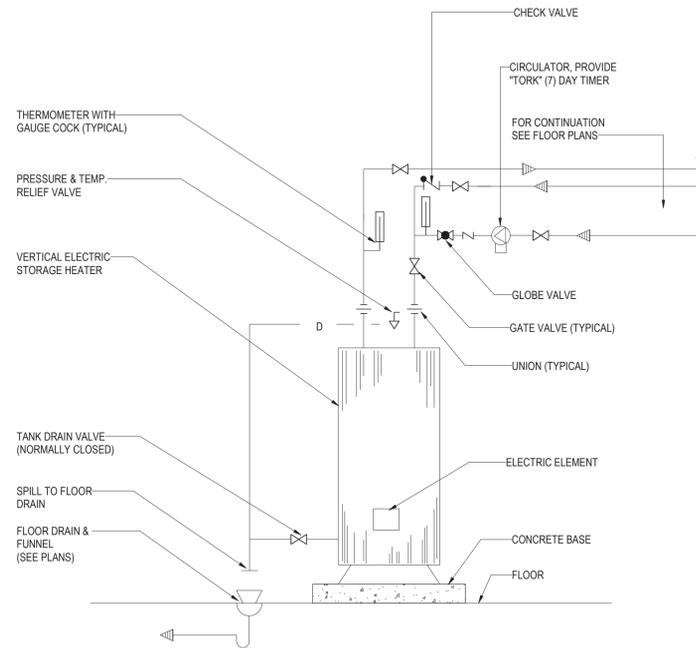
Project
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**C.F.M.
 Building**

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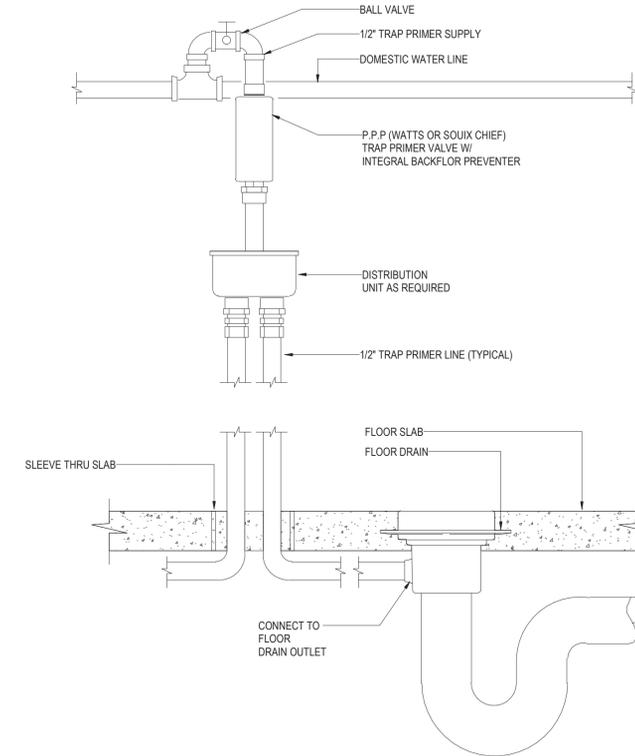
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 Drawing Title
 Piping Plan - Roof
 Level

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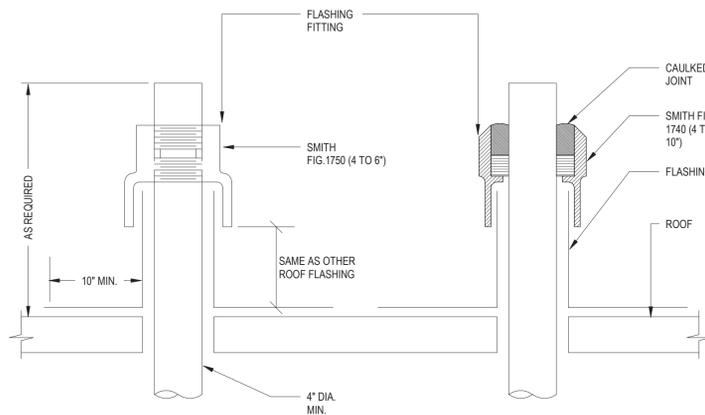





2 ELECTRIC DOMESTIC WATER HEATER W/CIRCULATION
NOT TO SCALE

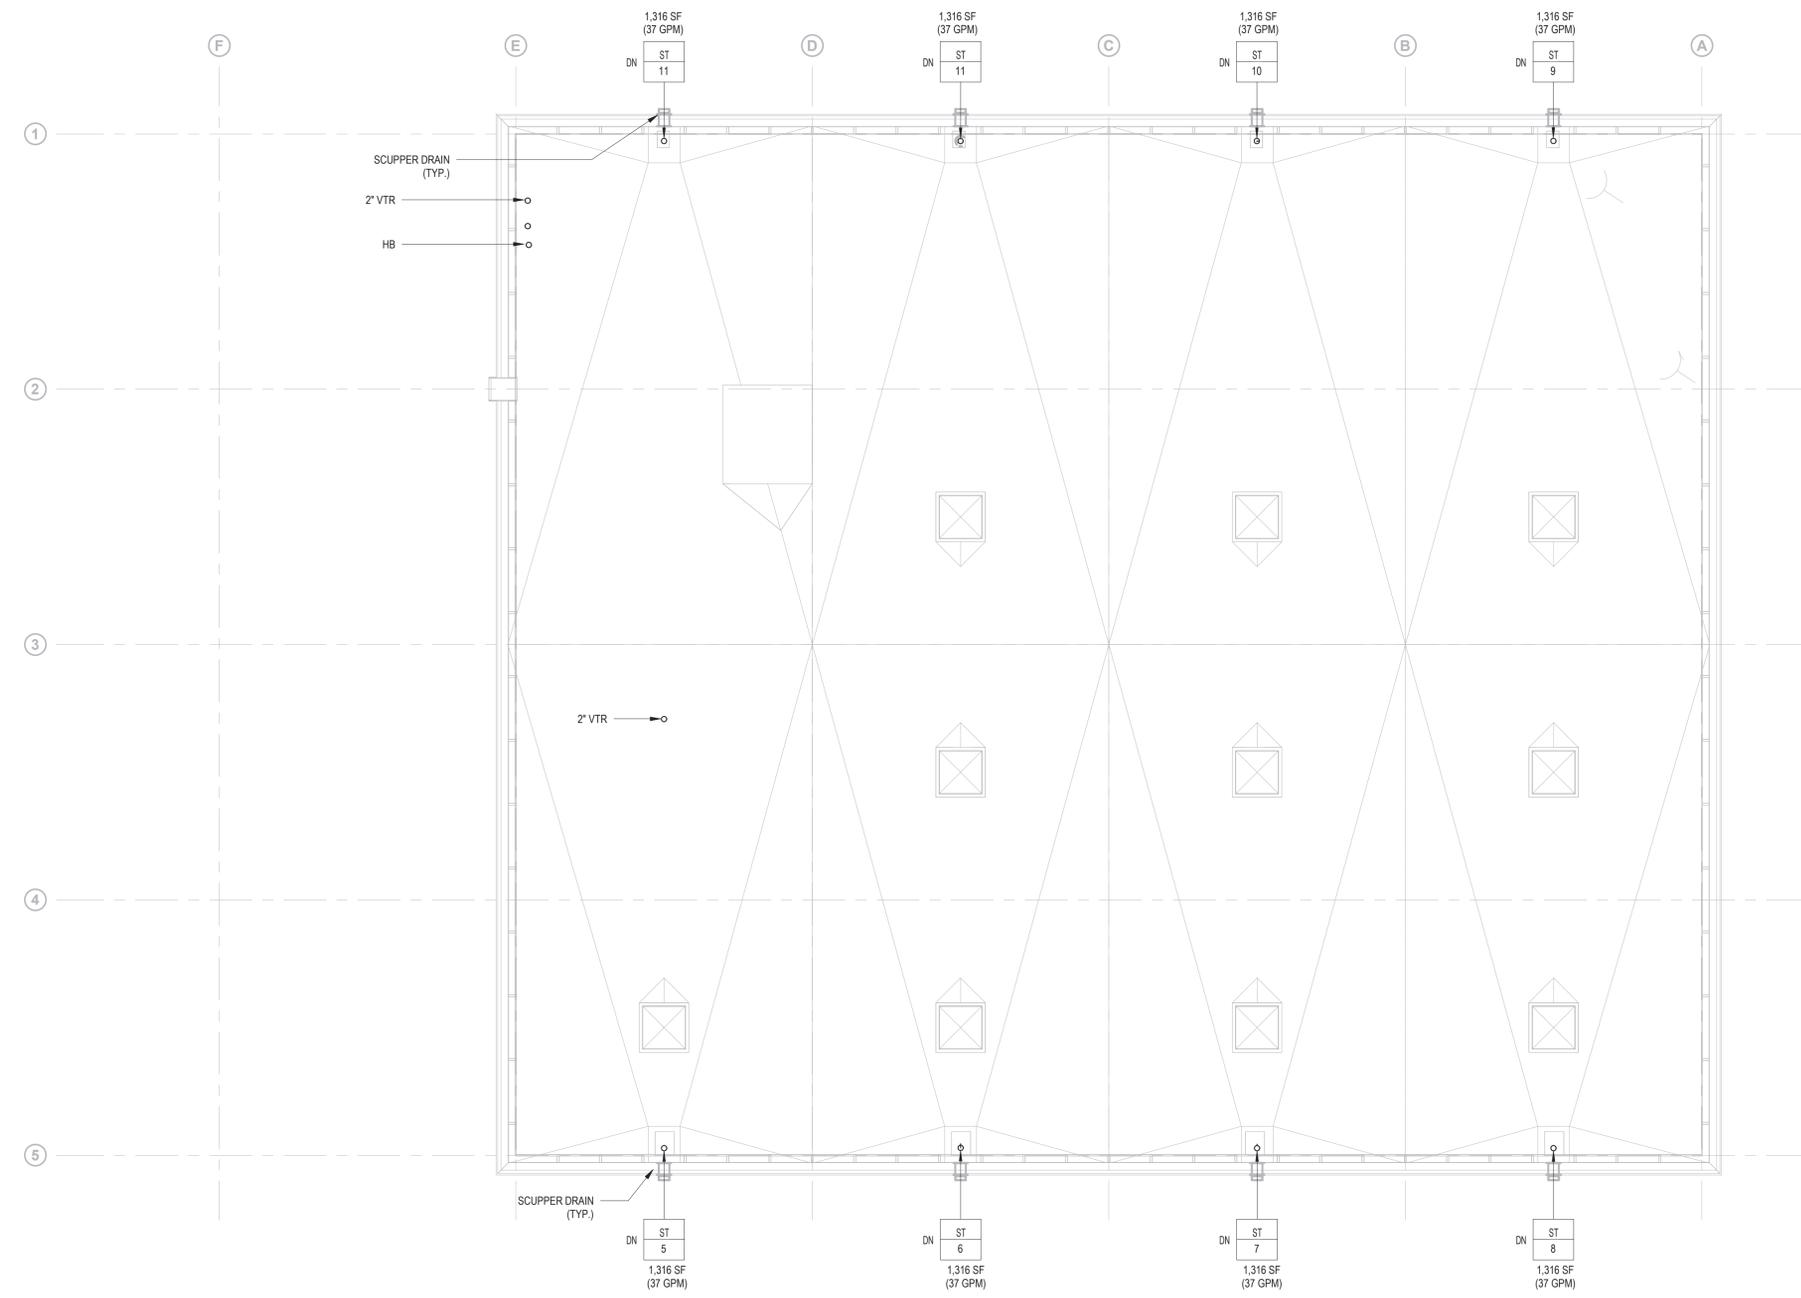

3 TRAP PRIMER FOR MECHANICAL ROOM DRAINS
NOT TO SCALE




4 FLASHINGS FOR VENT TERMINALS ABOVE ROOF
NOT TO SCALE

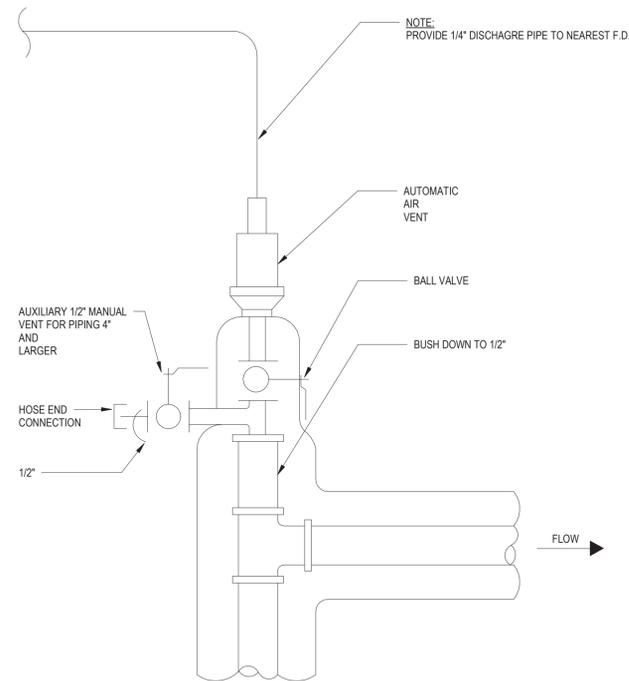

NOTE:
1. DETAIL TO BE USED AT ALL AUTOMATIC AIR VENT LOCATIONS, INCLUDING AT THE TOP OF ALL PIPE RISERS CONNECTING TO TWO OR MORE FLOORS.
2. AAV. TO BE INSTALLED AT

5 AUTOMATIC AIR VENT
NOT TO SCALE

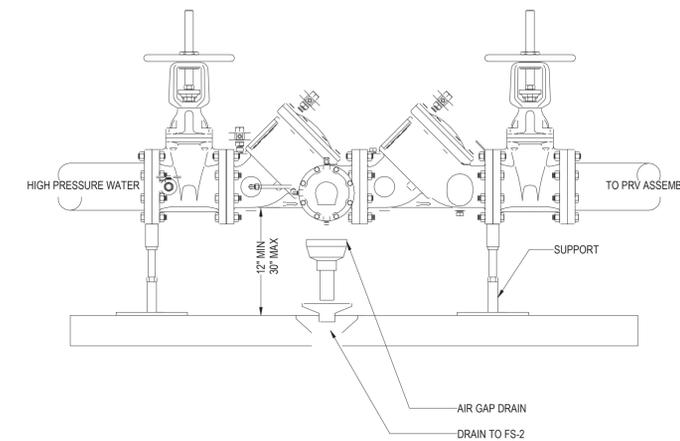

NOTE:
1. BACKFLOW PREVENTOR TO BE PAINTED HUNTER GREEN 4372 OR HUNTER GREEN 085F.
2. TO BE INSTALLED PER WATER SERVICE STANDARD SPECIFICATION W-221A.
3. PROPER SCREENING OF BACKFLOW PREVENTION DEVICE SHALL COMPLY WITH WATER SERVICE STANDARD SPECIFICATION SECTION 4-10.
4. BACKFLOW PREVENTION DEVICE SHOULD BE LEAD FREE.

6 BACKFLOW PREVENTER
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Building**

Seal


NOT FOR CONSTRUCTION
Drawing Title
Plumbing Details

Date 06/17/22

Scale Not to Scale


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Sheet Size ARCH D

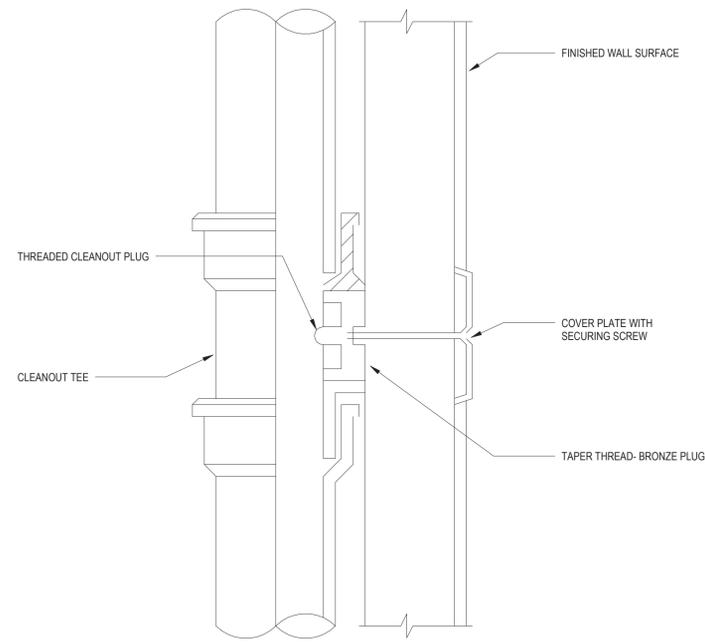


NOTE:
ACCESS PANELS SHALL BE PROVIDED ON ALL VERTICAL FOUL DRAINAGE STACKS AT 4' (1200MM) ABOVE EACH FINISHED FLOOR LEVEL, TO THE CENTERLINE OF THE CLEANOUT.

1 CLEANOUT CONCEALED
NOT TO SCALE

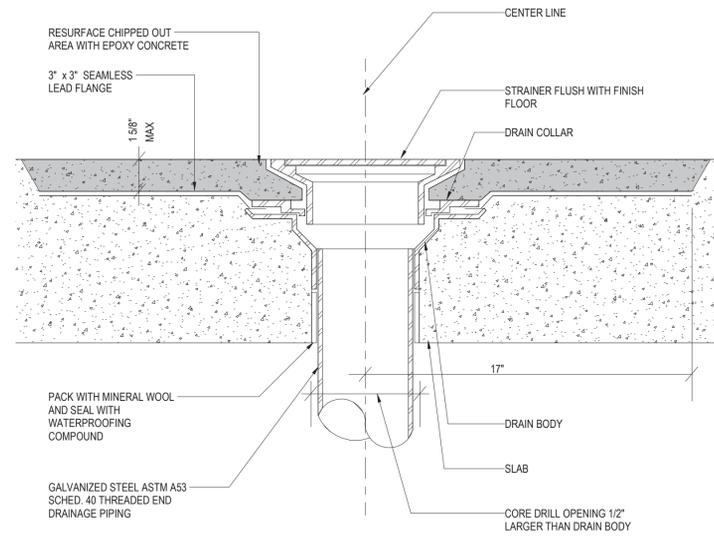


NOTES:
1. WATERPROOF EXISTING FLOOR OF ROOM WHERE FLOOR DRAIN IS TO BE LOCATED USING THOROSEAL SEALANT OR APPROVED EQUAL.


2 TYPICAL FLOOR DRAIN INSTALLATION
NOT TO SCALE

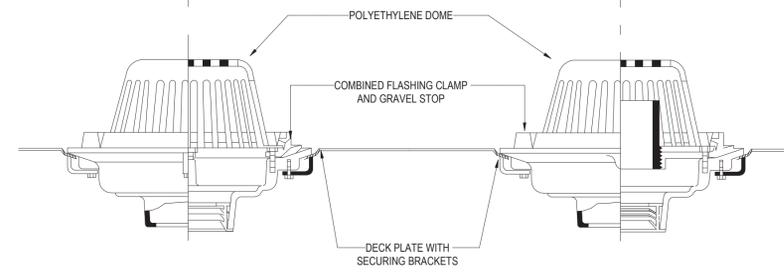


3 ROOF DRAIN AND OVERFLOW DRAIN
NOT TO SCALE

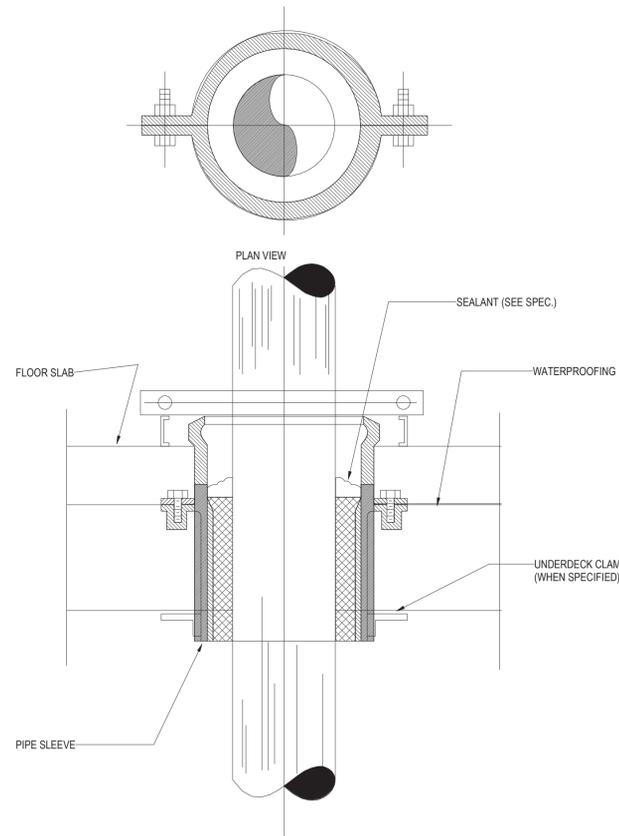

4 PIPE SLEEVE THRU WATERPROOF FLOOR SLAB
NOT TO SCALE

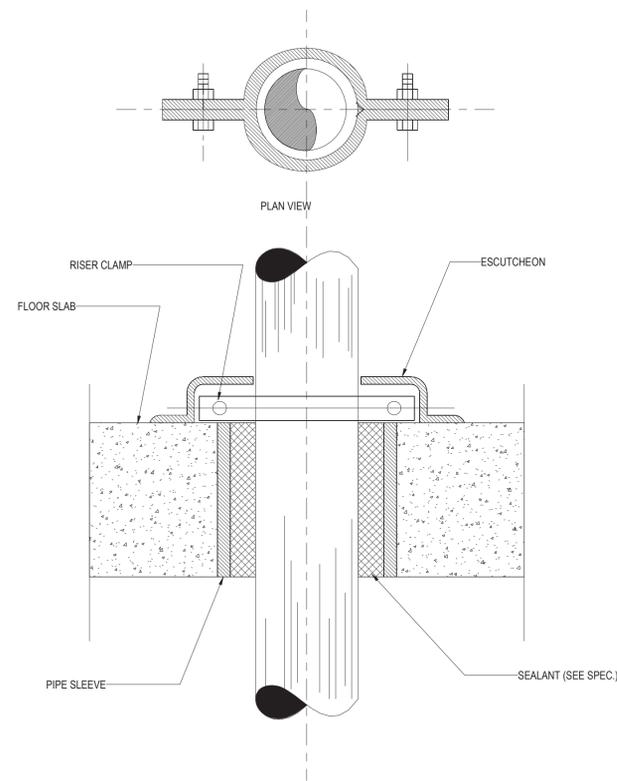

5 PIPE SLEEVE THRU EXPOSED FLOOR SLAB
NOT TO SCALE

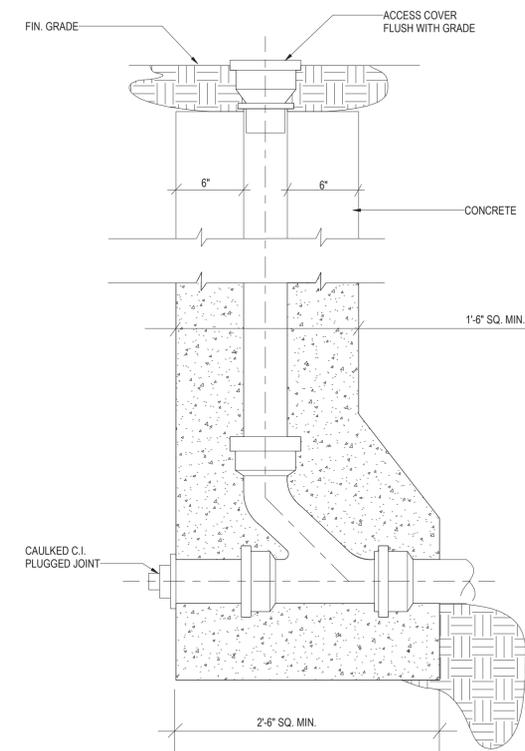

6 OUTSIDE BUILDING GRADE CLEANOUT
NOT TO SCALE

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Key Plan

Description	Date
Filing Set	06/17/22


Project
Storm King
Art Center
C.F.M.
Building

Seal

NOT FOR CONSTRUCTION
Drawing Title
Plumbing Details


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Drawing Number	P-C-502
Sheet Size	ARCH D

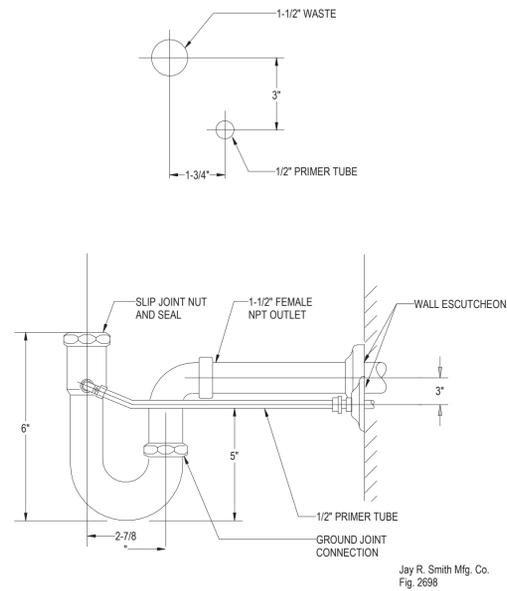

Jay R. Smith Mfg. Co.
Fig. 2698


1 PRIM-EZE WATER SAVER
NOT TO SCALE

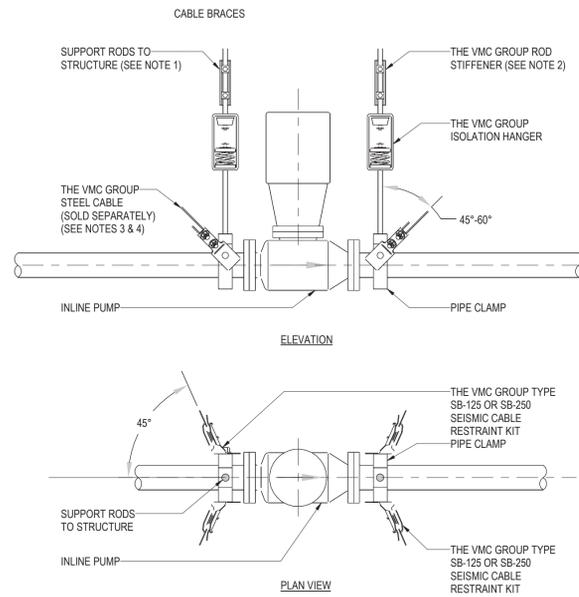

NOTES:

- DOUBLE-SIDED BEAM CLAMP ATTACHMENTS AT SEISMIC RESTRAINT LOCATIONS.
- FOR APPLICABILITY OF THE VMC GROUP SRBC (SEISMIC ROD BRACING CLAMP REFER TO SGMCEC-190).
- SLACK CABLE 1/2" IN CENTER IF DUCT IS ISOLATED.
- FOR DETAILS OF CONNECTION, REFER TO SGMCEC-191 OR -193
- APPLICATION USED WITH 1/8" & 1/4" CABLE ONLY.


2 INLINE PUMPS
NOT TO SCALE

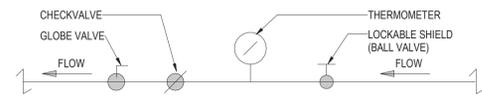


PROCEDURE FOR BALANCING HOT WATER RETURN PIPING

- IN ORDER TO BALANCE HOT WATER RETURN TEMPERATURES IN THE RETURN PIPING THIS IS THE PROCEDURE TO BE FOLLOWED:
BEFORE A RETURN CIRCULATION SYSTEM IS PUT INTO SERVICE, IT SHOULD BE ADJUSTED FOR RETURN LINE TEMPERATURE BALANCE UNDER CONDITIONS WHEREBY NO WATER IS DRAWN AT FIXTURE OUTLETS. THE ADJUSTMENT PROCEDURE IS SIMPLE AND MAY BE ACCURATELY DONE USING THERMOMETERS. FIRST, CLOSE ALL BALANCING VALVES SO THAT ALL CIRCULATION GOES THROUGH BRANCH 1. THEN, OPEN THE BALANCING VALVE ON BRANCH 2 TO THE DEGREE NECESSARY SO THAT IT RETURNS WATER CONSTANTLY AT THE SAME TEMPERATURE AS BRANCH 1. SIMILARLY, ADJUSTMENT MAY BE MADE WITH BALANCING VALVE ON ANY OTHER RISERS OR BRANCHES SO THAT ALL RETURN WATER IS AT THE SAME TEMPERATURE.
- CONTRACTOR, AT THE END OF THE PROJECT, TO SUBMIT A REPORT FOR RECORD TO THE ENGINEER THAT THE HOT WATER RETURN CIRCULATION SYSTEM HAS BEEN BALANCED PROPERLY.


PIPE DIAMETER	ROD DIAMETER
UP TO 2IN.	3/8 IN.
2-1/2" - 4IN.	1/2 IN.
5 AND 6IN.	5/8 IN.

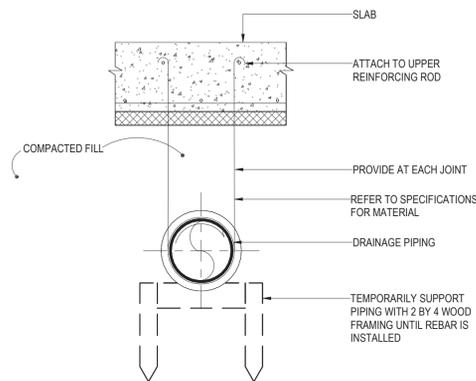

5 UNDERGROUND BELOW SLAB
NOT TO SCALE

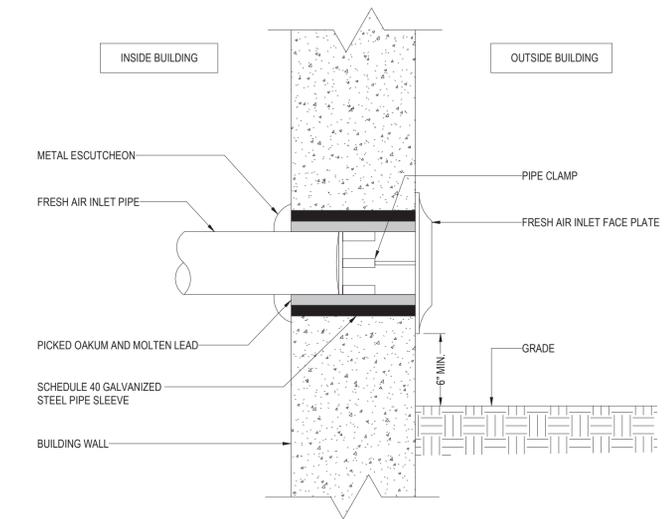

3 FAI
NOT TO SCALE

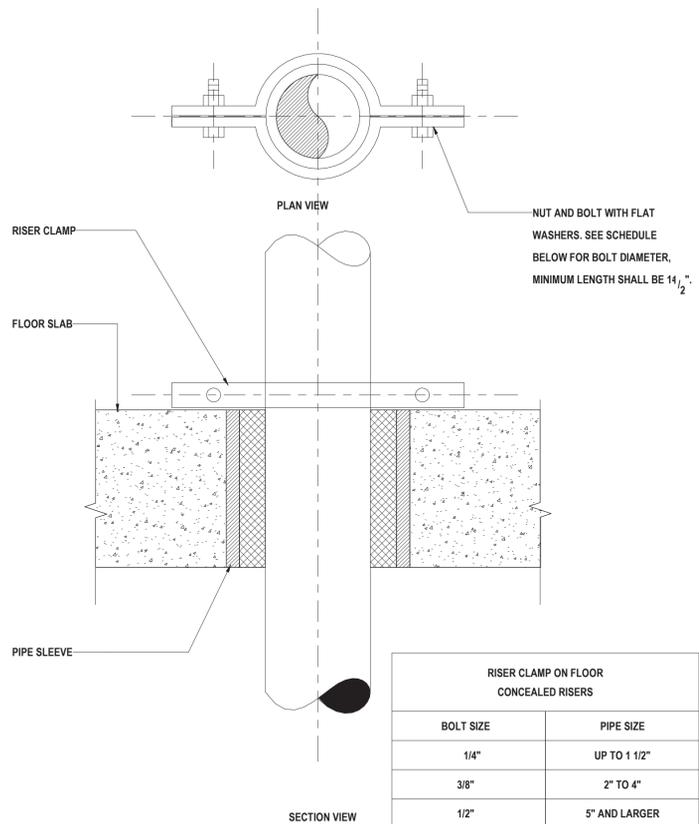

RISER CLAMP ON FLOOR CONCEALED RISERS	
BOLT SIZE	PIPE SIZE
1/4"	UP TO 1 1/2"
3/8"	2" TO 4"
1/2"	5" AND LARGER

6 RISER SUPPORT DETAIL
NOT TO SCALE

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Key Plan

Description: Filing Set
Date: 06/17/22

Project
Storm King Art Center
C.F.M. Building

Seal


NOT FOR CONSTRUCTION
Drawing Title
Plumbing Details

Date: 06/17/22
Scale: Not to Scale


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Sheet Size: ARCH D


4 HW BALANCING VALVE
NOT TO SCALE

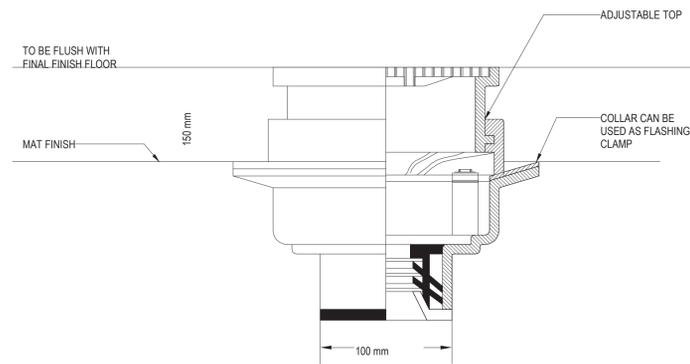

1 FLOOR DRAIN WITH ADJUSTABLE TOP
NOT TO SCALE

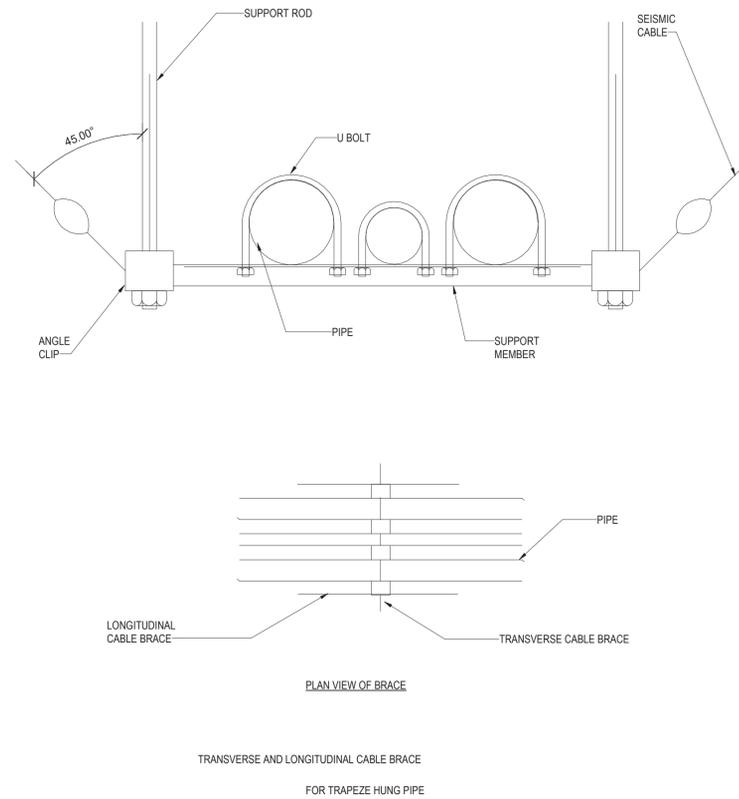

2 TRANSVERSE AND LONGIT CBL BRACE FOR TRAPEZE HUNG PIPE
NOT TO SCALE

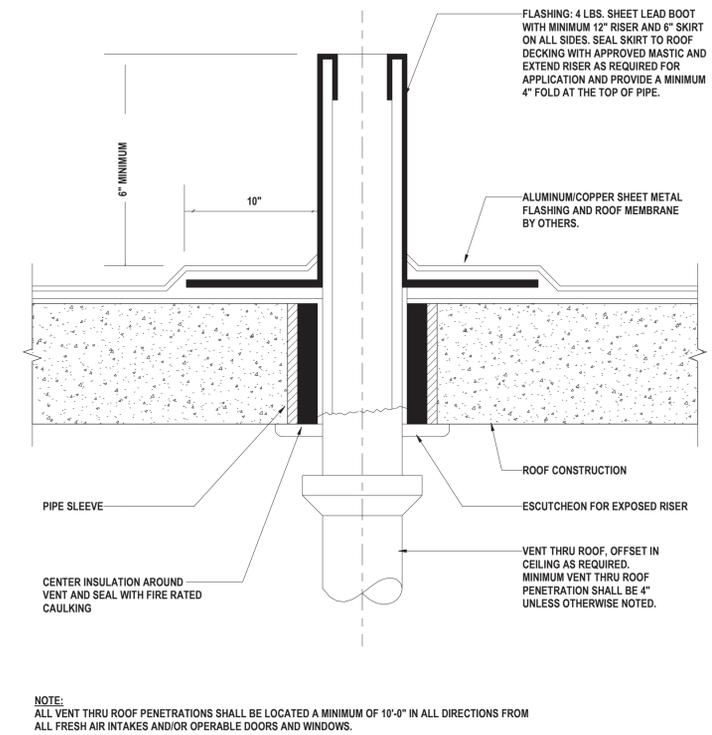

3 VENT THRU ROOF DETAIL
NOT TO SCALE

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Key Plan

Description	Date
Filing Set	06/17/22

Project

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Art Center
C.F.M.
Building

Seal

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Drawing Title
Plumbing Details

Date	06/17/22
Scale	Not to Scale
Drawing Number	P-C-504
Sheet Size	ARCH D

P - ELECTRIC HEAT PUMP WATER HEATER SCHEDULE

DESIGNATION	LOCATION	VOLUME (GAL)	DIMENSIONS		ELECTRICAL			WEIGHT (LB)	MODEL NUMBER	MANUFACTURER	REMARKS
			DIAMETER	HEIGHT	VOLTAGE	FREQUENCY	PHASE				
DWHP - C-2-1	LEVEL 02	80	2.3"	5.9"	208 V	60 Hz	1	307	HPTU-80N	AO SMITH	

P - REVERSE OSMOSIS TREATMENT PACKAGE SCHEDULE

DESIGNATION	LOCATION	MANUFACTURER	MODEL NUMBER	SERVICE	QUANTITY	DEMAND (GPM)	ELECTRICAL				SYSTEM WEIGHT (LBS)	REMARKS	
							FLA	FREQUENCY	KW	PHASE			
ROT - C-2-1	LEVEL 02	US WATER SYSTEMS	AR-5-2000	DOMESTIC WATER	1	6	6 A	60 Hz	0.6	1	220 V	115	

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Key Plan

Description	Date
Filing Set	06/17/22

Project

Storm King
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C.F.M.
Building

Seal

NOT FOR CONSTRUCTION

Drawing Title
Plumbing Schedules

Date	06/17/22
Scale	Not to Scale
Drawing Number	P-C-601
Sheet Size	ARCH D

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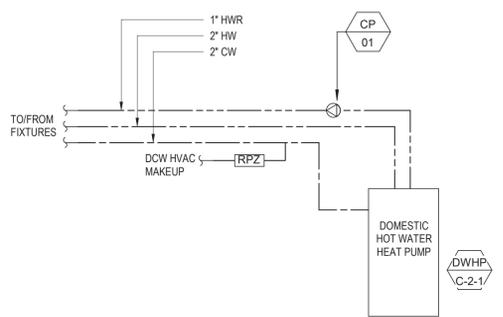
Description	Date
Filing Set	06/17/22

Project
 Storm King
 Art Center
**C.F.M.
 Building**


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NOT FOR CONSTRUCTION
 Drawing Title
 Domestic Water Riser

Date	06/17/22
Scale	Not to Scale
Drawing Number	P-C-701
Sheet Size	ARCH D



2 PLUMBING EQUIPMENT ROOM RISER DIAGRAM
 NOT TO SCALE

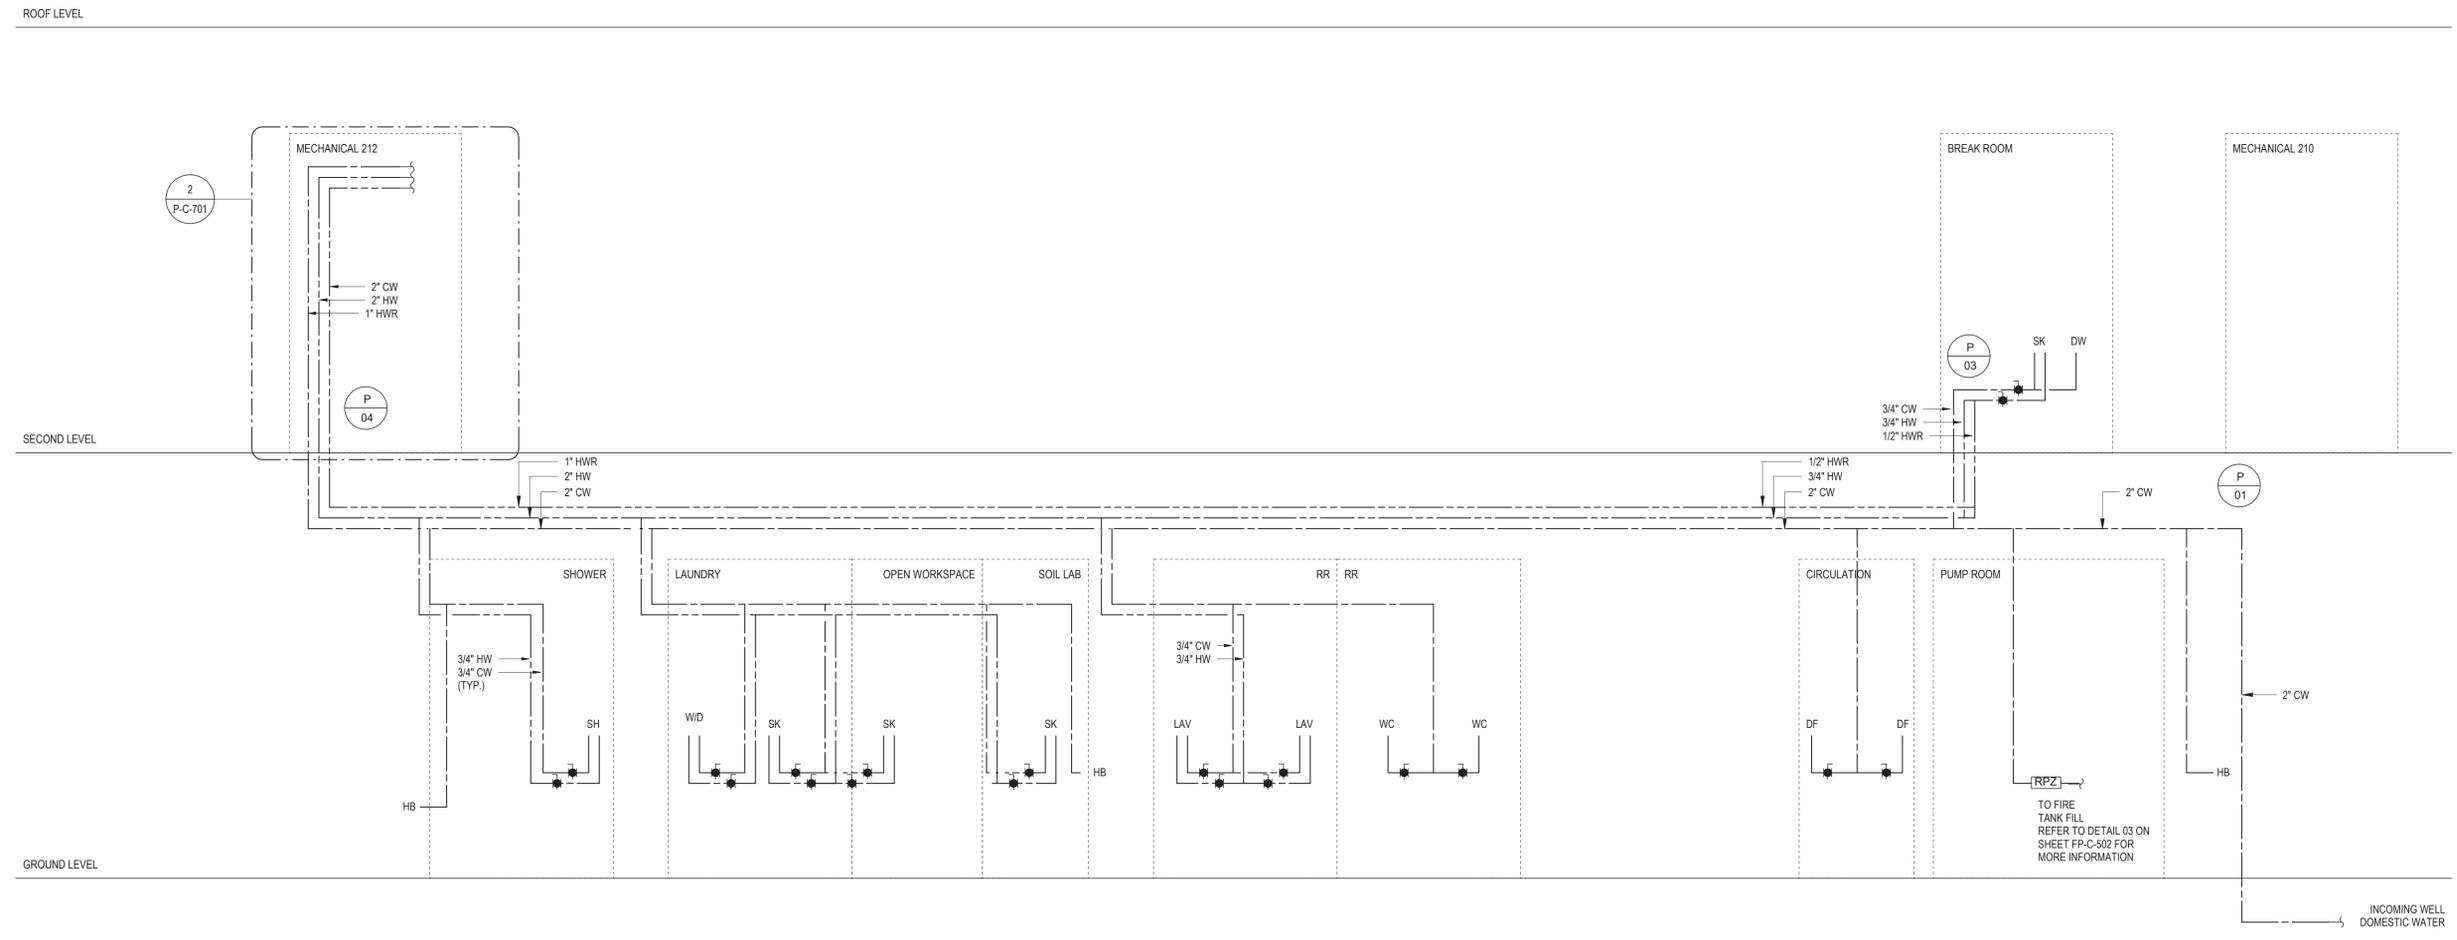

1 PLUMBING DOMESTIC WATER RISER DIAGRAM
 NOT TO SCALE

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Key Plan

Description	Date
Filing Set	06/17/22

Project

Storm King Art Center C.F.M. Building

Seal

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Drawing Title
 Drain & Vent Riser

Date 06/17/22

Scale Not to Scale

Drawing Number **P-C-702**

Sheet Size ARCH D

