TOWN/VILLAGE OF MOUNT KISCO WATER DEPARTMENT BUILDING ADDITION

43 COLUMBUS AVENUE MOUNT KISCO NY 10549

CONSTRUCTION DOCUMENTS


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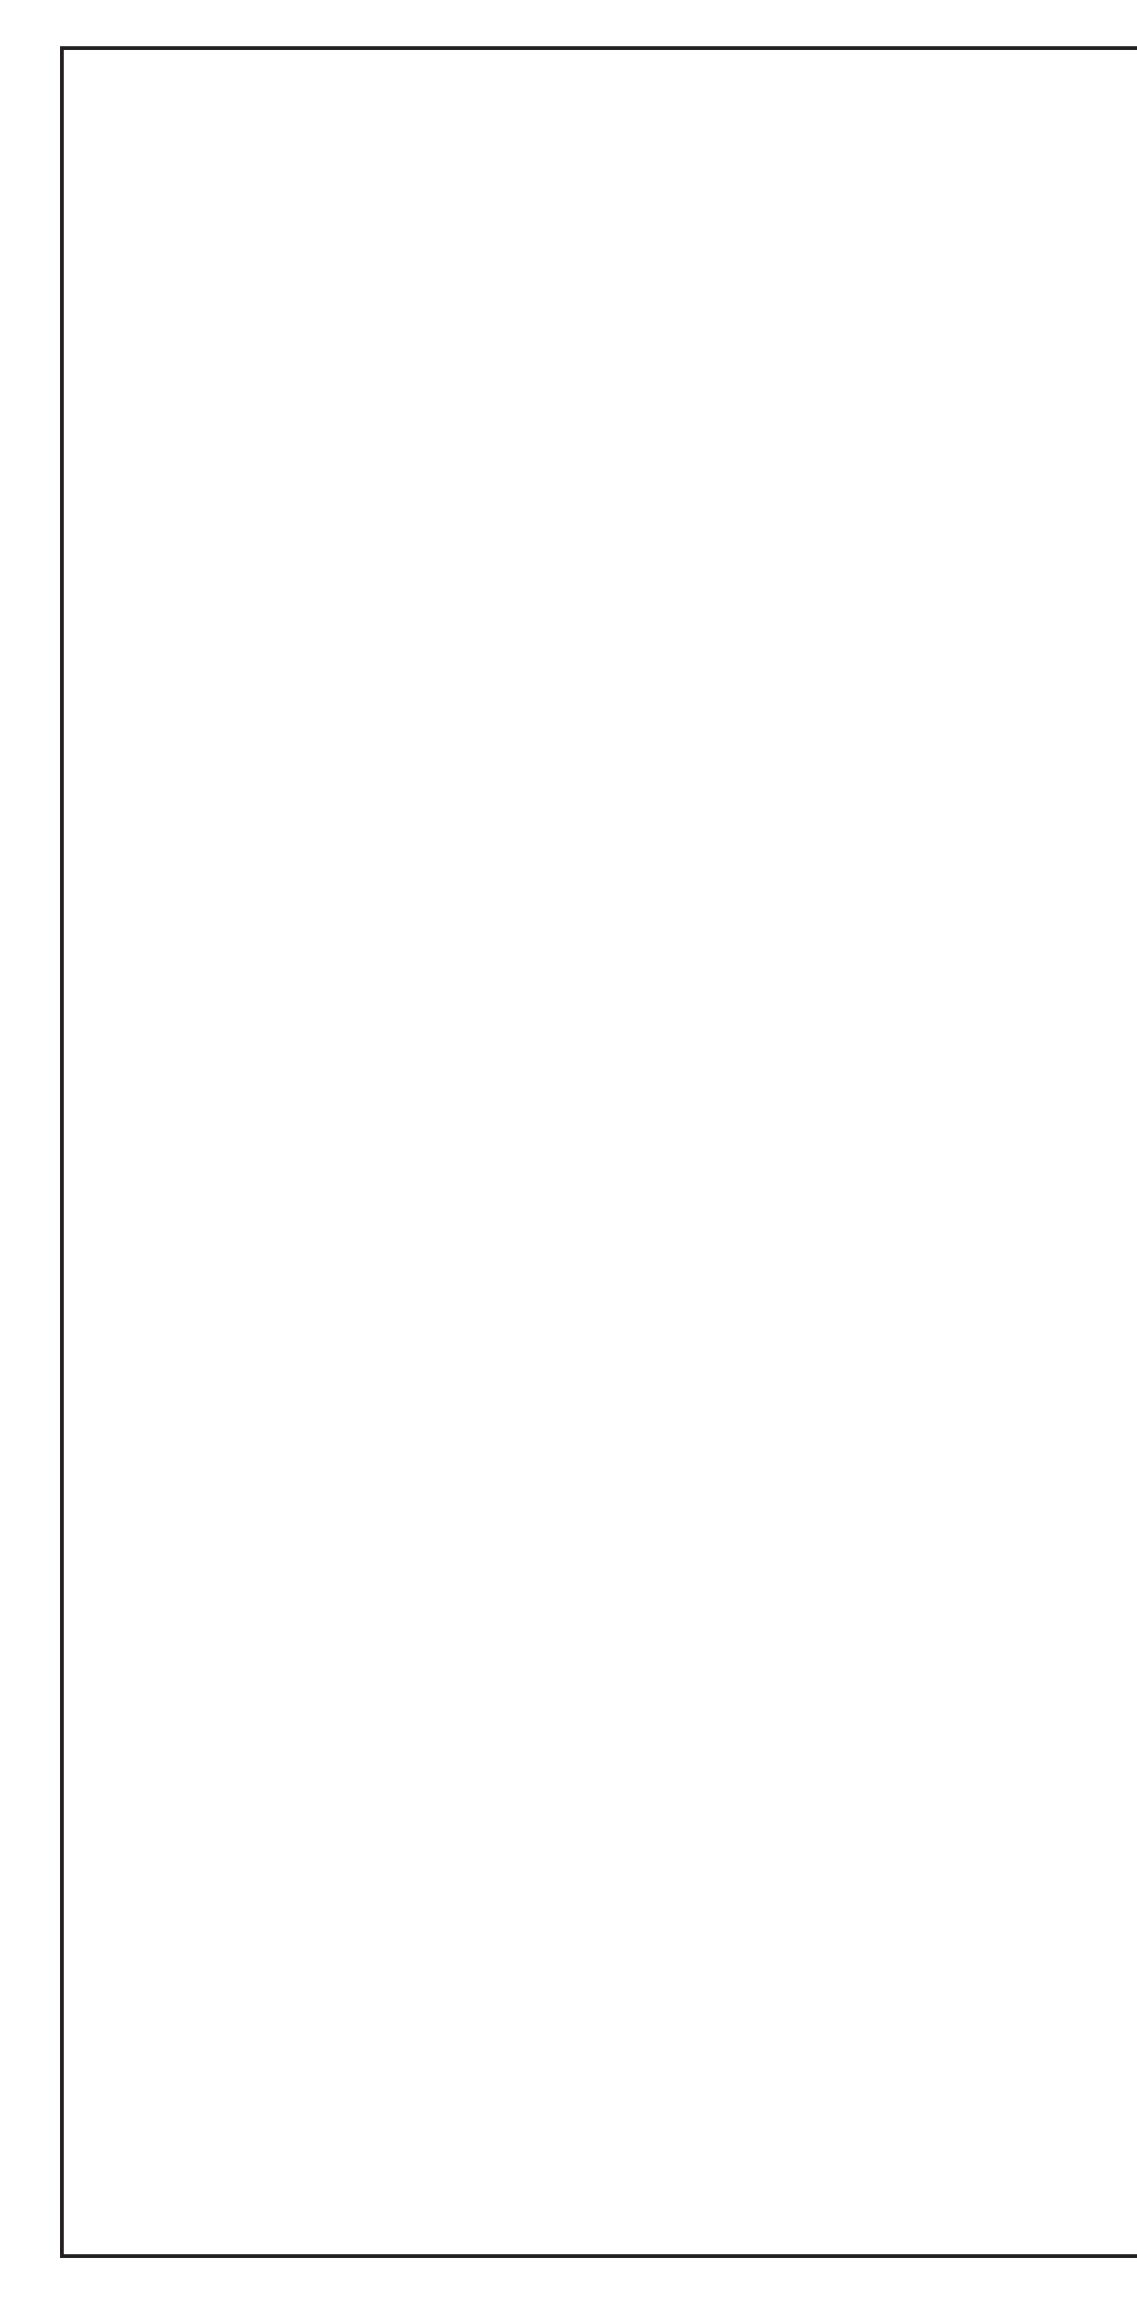




THE DESIGN OF THIS PROJECT CONFORMS TO APPLICABLE PROVISIONS OF THE 2020 NEW YORK STATE UNIFORM FIRE PREVENTION AND BUILDING CODE, AND THE NEW YORK STATE ENERGY CONSERVATION CONSTRUCTION CODE



G001	GENERAL NOTES, LEGENDS, AND SITE PLAN
D100	DEMOLITION PLANS
ASB-100	ASBESTOS ABATEMENT DRAWING
S001	DESIGN DATA AND GENERAL NOTES
S002	GENERAL NOTES
S100	FOUNDATION PLAN
S200	SECOND FLOOR FRAMING PLAN
S201	ROOF FRAMING PLAN
S300	FOUNDATION DETAILS
S400	MASONRY DETAILS
S500	STRUCTURAL DETAILS
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A200	ROOF PLAN
A101	SECOND FLOOR CONSTRUCTION PLAN
A300	EXTERIOR ELEVATIONS
A301	SECTIONS AND DETAILS
A450	ROOF DETAILS
A451	MASONRY DETAILS
A500	STAIR DETAILS
A600	WALL TYPES AND SCHEDULES
A900	DOOR AND WINDOW DETAILS
M-1	MECHANICAL DEMOLITION PLANS
M-2	MECHANICAL PLANS
M-3	MECHANICAL ROOF PLAN
P-1	PLUMBING DEMOLITION PLAN
P-2	PLUMBING PLANS
P-3	ROOF PLUMBING PLAN
E-1	ELECTRICAL DEMOLITION PLANS
E-2	ELECTRICAL PLANS

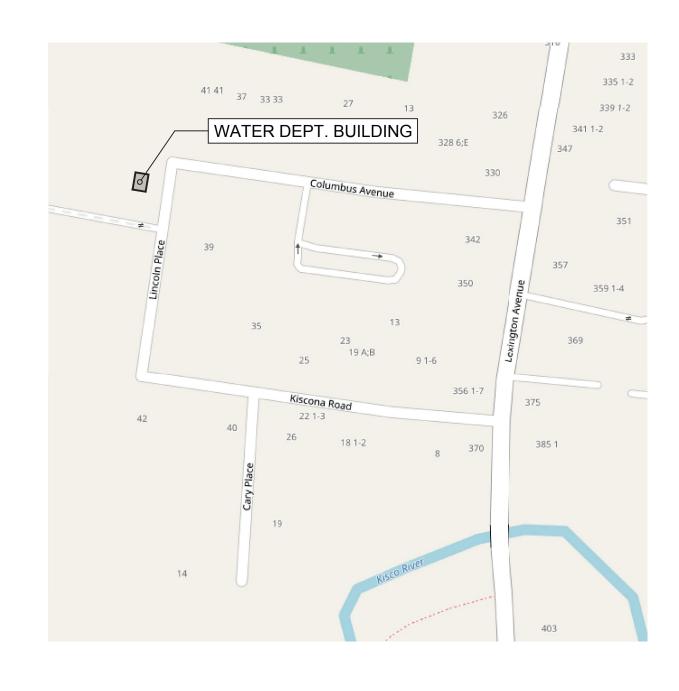

FINISH SCHEDULE

- TF TRANSPARENT FINISH
- RB RUBBER BASE WD WOOD
- SAC- SUSPENDED ACOUSTIC CEILING
- TB TILE BACKER EWF ENGINEERED WOOD FLOORING
- QT QUARRY TILE
- CPT- CARPET TILE
- LIN LINOLEU VIN VINYL
- CFT- CERAMIC FLOOR TILE LIN LINOLEUM
- VCT VINYL COMPOSITE TIL CWT- CERAMIC WALL TILE
- PNT PAINT VCT VINYL COMPOSITE TILE
- CONC CONCRETE/CONCRETE MASONRY UNIT GWB GYPSUM WALLBOARD
- ABBREVIATIONS

ßER			FLOOR		BASE			N	IORTH WALL			EAST WALL		S	OUTH WALL			WEST WALL		CEILING		
NUMB	ROOM NAME	SUBSTRATE	FINISH	COLOR CODE	SUBSTRATE	FINISH	COLOR CODE	SUBSTRATE	FINISH	COLOR CODE	SUBSTRATE	FINISH	COLOR CODE	SUBSTRATE	FINISH	COLOR CODE	SUBSTRATE	FINISH	COLOR CODE	MATERIAL	TYPE	COLOR CODE
101	BAY 1	CONC	EPOXY	TBD	INTEG	INTEGRAL EPOXY BASE			PNT	TBD	CONC	PNT	TBD	CONC	PNT	TBD	CONC	PNT	TBD	CONC	PNT	TBD
102	BAY 2	CONC	EPOXY	TBD	INTEGRAL EPOXY BASE			CONC	PNT	TBD	CONC	PNT	TBD	CONC	PNT	TBD	CONC	PNT	TBD	CONC	PNT	TBD
103	BAY 3	CONC	EPOXY	TBD	INTEGRAL EPOXY BASE			CONC	PNT	TBD	CONC	PNT	TBD	CONC	PNT	TBD	CONC	PNT	TBD	CONC	PNT	TBD
104	CORRIDOR	CONC	EPOXY	TBD	INTEGRAL EPOXY BASE			-	-	-	-	-	-	CONC	PNT	TBD	CONC	PNT	TBD	CONC	PNT	TBD
105	STORAGE	CONC	EPOXY	TBD	INTEG	INTEGRAL EPOXY BASE			PNT	TBD	CONC	PNT	TBD	CONC	PNT	TBD	CONC	PNT	TBD	CONC	PNT	TBD
106	LOCKER	CONC	EPOXY	TBD	INTEG	INTEGRAL EPOXY BASE			PNT	TBD	CONC	PNT	TBD	-	-	-	CONC	PNT	TBD	CONC	PNT	TBD
107	SHOWER	CONC	EPOXY	TBD	INTEG	GRAL EPOXY BA	\SE	CONC	PNT	TBD	CONC	PNT	TBD	-	-	-	CONC	PNT	TBD	CONC	PNT	TBD
108	LAUNDRY	CONC	EPOXY	TBD	INTEG	GRAL EPOXY BA	SE	CONC	PNT	TBD	CONC	PNT	TBD	-	-	-	CONC	PNT	TBD	CONC	PNT	TBD
109	TOILET	CONC	EPOXY	TBD	INTEG	GRAL EPOXY BA	SE	CONC	PNT	TBD	CONC	PNT	TBD	CONC	PNT	TBD	CONC	PNT	TBD	CONC	PNT	TBD
110	MECHANICAL	CONC	EPOXY	TBD	INTEG	GRAL EPOXY BA	SE	CONC	PNT	TBD	CONC	PNT	TBD	CONC	PNT	TBD	CONC	PNT	TBD	CONC	PNT	TBD
111	STORAGE	CONC	EPOXY	TBD	INTEG	GRAL EPOXY BA	SE	CONC	PNT	TBD	CONC	PNT	TBD	CONC	PNT	TBD	CONC	PNT	TBD	CONC	PNT	TBD
112	CORRIDOR/STAIR	CONC	EPOXY	TBD	INTEG	INTEGRAL EPOXY BASE			PNT	TBD	CONC	PNT	TBD	CONC	PNT	TBD	CONC	PNT	TBD	CONC	PNT	TBD
201	MEZZANINE	CONC	-	-	CONC	RB	TBD	CONC	PNT	TBD	CONC	PNT	TBD				CONC	PNT	TBD	CONC	PNT	TBD
202	OFFICE	CONC	VIN	TBD	CONC	RB	TBD	CONC	PNT	TBD	CONC	PNT	TBD	CONC	PNT	TBD	CONC	PNT	TBD	CONC	PNT	TBD
203	STORAGE	CONC	-	-	CONC	RB	TBD	CONC	PNT	TBD	CONC	PNT	TBD	CONC	PNT	TBD	CONC	PNT	TBD	CONC	PNT	TBD


DOOR SCHEDULE


FF	FACTORY FINISH
PNT	PAINT

- HM HOLLOW METAL
- STL STEEL
- ALU ALUNIMUM WD WOOD
- ABBREVIATIONS

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BE		LOCA		DOOR							FRAME										BE		
DOORNUM	FROM		ТО		QUANTITY	WIDTH	HEIGHT	THICKNESS	ТҮРЕ	MATERIAL	FINISH	ТҮРЕ	MATERIAL	FINISH	HEAD DETAIL	JAMB DETAIL	ETA	MAG. HOLE OPEN	ACCESS CONTROL	REMARKS	DOORNUM		
103.1	EXT	EXTERIOR	103	BAY 3	1	3'-0"	7'-0"	1-3/4"	F	HM	PNT	HM1	HM	PNT	2/A900	2/A900			03	N	N		103.1
104.1	EXT	EXTERIOR	104	CORRIDOR	1	3'-0"	7'-0"	1-3/4"	F	HM	PNT	HM1	НM	PNT	2/A900	2/A900			03	N	N		104.1
105.1	104	CORRIDOR	105	STORAGE	1	3'-0"	7'-0"	1-3/4"	F	HM	PNT	HM1	HM	PNT	2/A900	2/A900			02	N	N		105.1
109.1	104	CORRIDOR	109	TOILET	1	3'-0"	7'-0"	1-3/4"	F	HM	PNT	HM2	HM	PNT	2/A900	2/A900			04	N	N		109.1
110.1	104	CORRIDOR	110	MECHANICAL	1	3'-0"	7'-0"	1-3/4"	L	HM	PNT	HM2	HM	PNT	2/A900	2/A900		45	02A	N	N		110.1
111.1	101	BAY	111	STORAGE	1	3'-0"	7'-0"	1-3/4"	F	HM	PNT	HM1	HM	PNT	2/A900	2/A900			02B	N	N		111.1
102.1	102	BAY	112	CORRIDOR	1	2'-8"	7'-0"	1-3/4"	F	HM	PNT	HM1	HM	PNT	2/A900	2/A900		45	02C	N	N		102.1
202.1	-	STAIR	202	OFFICE	1	2'-8"	7'-0"	1-3/4"	F	HM	PNT	HM1	HM	PNT	2/A900	2/A900			01	N	N		202.1
202.2	202	OFFICE	203	STORAGE	1	2'-8"	7'-0"	1-3/4"	F	HM	PNT	HM1	HM	PNT	2/A900	2/A900			01	N	N	Alternate	202.2

1) PARTITION TYPES SCALE: N.T.S.

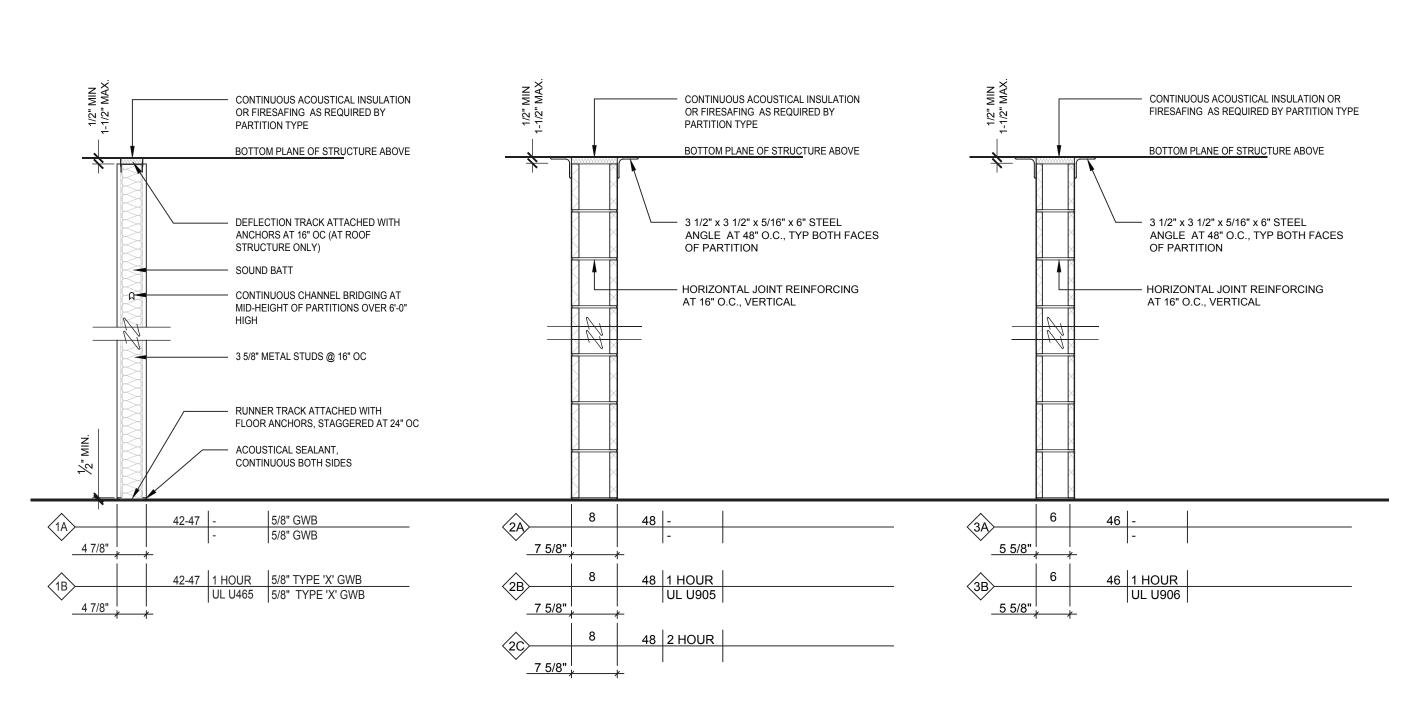

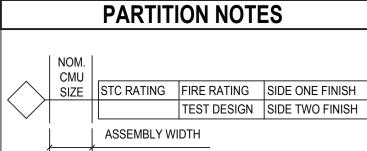



- 1. PROVIDE FIRE RATED JOINT SYSTEMS AT ALL INTERSECTIONS OF FIRE RATED PARTITION ASSEMBLIES AND FIRE RATED FLOOR /ROOF ASSEMBLIES. THE FIRE RATED JOINT SYSTEM SHALL HAVE A MINIMUM FIRE RESISTANCE RATING GREATER THAN OR EQUAL TO THE PARTITION IN WHICH IT IS BEING USED. THIS JOINT SYSTEM MUST BE AN APPROVED ASSEMBLY TESTED BY A NATIONALLY RECOGNIZED TESTING AGENCY.
- 2. PROVIDE THROUGH-PENETRATION FIRE STOP SYSTEM AT ALL PENETRATIONS THROUGH FIRE RATED PARTITION, FLOOR AND ROOF ASSEMBLIES. THE THROUGH-PENETRATION FIRE STOP SYSTEM SHALL HAVE A MINIMUM FIRE RESISTANCE RATING GREATER THAN OR EQUAL TO THE ASSEMBLY THAT IT IS BEING USED IN. THIS FIRE STOP SYSTEM MUST BE AN APPROVED ASSEMBLY TESTED BY A NATIONALLY RECOGNIZED TESTING AGENCY.
- 3. CONCEALED VERTICAL SPACES IN PARTITIONS SHALL BE FILLED WITH NON COMBUSTIBLE MATERIAL, OR FIRE-STOPPED AT EACH FLOOR LEVEL AND AT THE CEILING OF THE UPPERMOST STORY, SO THAT SUCH SPACES WILL NOT BE CONTINUOUS FOR MORE THAN ONE STORY, OR COMMUNICATE WITH CONCEALED HORIZONTAL SPACES IN THE FLOOR OR ROOF CONSTRUCTION.
- 4. ALL PARTITION TYPE DIAGRAMS ARE GRAPHICAL IN NATURE. IN THE CASE WHERE A DIAGRAM DOES NOT SHOW ALL MATERIALS REQUIRED BY A FIRE-RATED PARTITION, THE PARTITION TYPE DESCRIPTION GOVERNS.

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Sheet No.

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