

DETAIL NOTES:


SUPPORT PIPING FROM BUILDING STRUCTURE. DO NOT HANG PIPING FROM OVERHEAD DOOR SUPPORTS OR TRACK.


B. COORDINATE INSTALLATION WITH MOVING PARTS OF DOOR ASSEMBLY

SPRINKLER BELOW OVERHEAD DOOR


NOT TO SCALE

STORZ FIRE DEPARTMENT CONNECTIONS: PROVIDE 22-1/2^ ELBOW FOR EASE OF TENSION ON FIRE HOSE CONNECTION IF INSTALLED GREATER THAN 2'-6" ABOVE FINISHED GRADE. FIRE DEPARTMENT CONNECTION DETAIL NOT TO SCALE

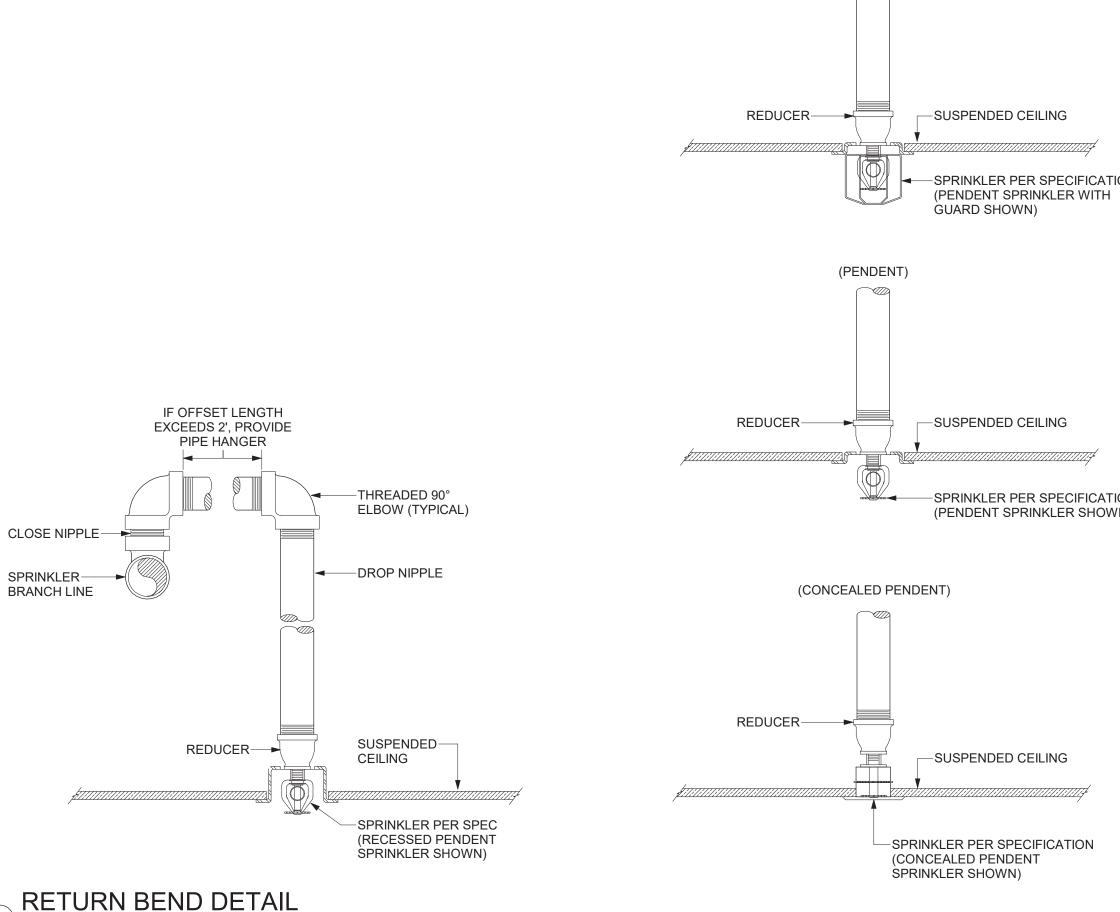

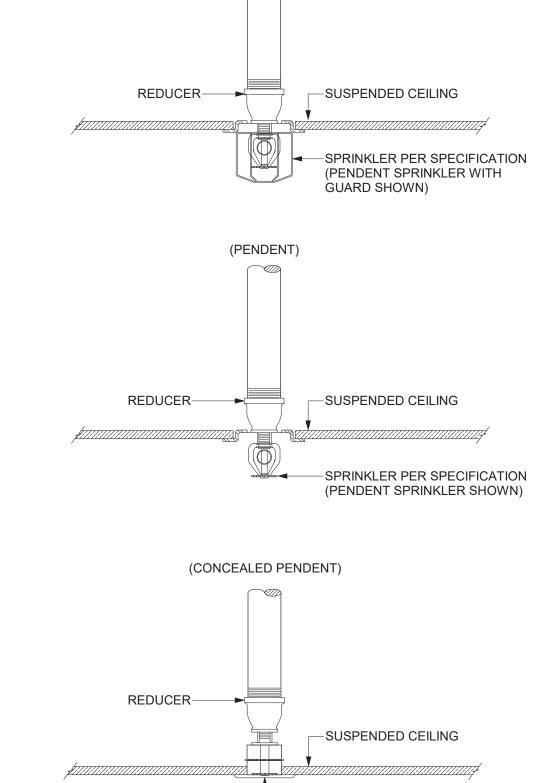


(PENEDENT WITH GUARD)

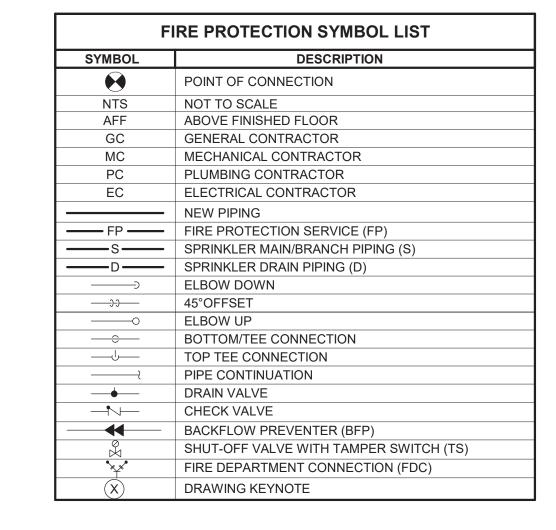

FIRE PROTECTION GENERAL NOTES:

- THE WORK COVERED CONSISTS OF FURNISHING ALL LABOR AND MATERIAL NECESSARY TO INSTALL, COMPLETE AND READY FOR CONTINIOUS OPERATION, THE FIRE PROTECTION SYSTEM(S), APPARATUS AND EQUIPMENT FOR THIS PROJECT, AS SHOWN ON DRAWINGS, DESCRIBED IN SPECIFICATIONS, AS REQUIRED BY NFPA 13 2016 ED. AND THE AUTHORITY HAVING JURISDICTION.
- THIS PROJECT IS "DESIGN BUILD". THESE DRAWINGS AND SPECIFICATIONS ARE INTENDED TO INDICATE MINIMUM WORK AND MINIMUM STANDARDS FOR EQUIPMENT, MATERIALS
- ANY AND ALL PERMITS REQUIRED FOR INSTALLATION OF ANY MATERIAL SHALL BE OBTAINED BY THE SPRINKLER CONTRACTOR AS PART OF THE WORK, INCLUDING ALL
- FEES OR EXPENSES INCURRED. ROUTING OF SPRINKLER MAINS, BRANCHES, AND SPRINKLERS SHALL BE THOROUGHLY COORDINATED BY THE SPRINKLER CONTRACTOR WITH OTHER TRADES AND BUILDING STRTUCTURE PRIOR TO SUBMISSION OF COORDINATED SHOP DRAWINGS, ORDERING OF FABRICATED PIPING AND INSTALLATION.
- THE SPRINKLER CONTRACTOR SHALL PERFORM A NEW HYDRANT FLOW TEST AND SHALL BASE THE HYDRAULIC CALCULATIONS ON THESE RESULTS.
- PRESSURE TEST ALL NEW PIPING AND ALARMS PER NFPA 13 2016 ED. COMPLETE AND FILE
- ALL REPORTS AND CERTIFICATIONS REQUIRED. SUBMIT TO OWNER COPIES OF ALL
- REPORTS AND CERTIFICATIONS, TOGETHER WITH A COPY OF NFPA 25 2016 ED. ALL SPRINKLER SYSTEM PIPING IN FINISHED AREAS SHALL BE CONCEALED ABOVE CEILINGS UNLESS OTHERWISE NOTED.
- SPRINKLERS INSTALLED IN AREAS WITH NO FINISH CEILING SHALL BE LOCATED AS HIGH AS POSSIBLE. SPRINKLERS SUBJECT TO PHYSICAL DAMAGE, OR WITH A DEFLECTOR ELEVATION 7'-6" OR LESS, SHALL BE INSTALLED WITH APPROVED AND LISTED SPRINKLER
- WHERE SPRINKLER PIPING IS LEFT EXPOSED, THE SPRINKLER CONTRACTOR SHALL CLEAN PIPING AND COORDINATE PAINTING WITH ARCHITECT.
- THE SPRINKLER CONTRACTOR SHALL PROVIDE SPRINKLER PROTECTION UNDER ALL
- EXPOSED STRUCTURE AREAS, IN ACCORDANCE WITH NFPA 13 2013 ED. ALL PIPING THROUGH CONCRETE FLOORS AND FIRE RATED WALLS OR PARTITIONS SHALL BE PROVIDED WITH SLEEVES AND FIRE STOPPED WITH UL RATED ASSEMBLIES OF EQUAL
- FIRE RATING. THE FIRE SPRINKLER CONTRACTOR SHALL BE RESPONSIBLE FOR THE REMOVAL STORAGE AND CUTTING OF ANY CEILING TILES TO ACCOMMODATE SPRINKLERS AND PIPING. THE SPRINKLER CONTRACTOR SHALL ALSO REINSTALL THE CEILING TILES UPON
- COMPLETION OF THE WORK AND REPLACE ANY DAMAGED TILES. THE SPRINKLER CONTRACTOR SHALL DELIVER MATERIAL TO THE JOB, UNLOAD AND STORE MATERIALS IN A LOCATION AS DETERMINED BY THE OWNER'S REPRESENTATIVE.
- THE SPRINKLER CONTRACTOR SHALL MAINTAIN THE WORK PREMISES FREE FROM ACUMMALATION OF WASTE MATERIAL OR REFUSE COVERED BY THIS WORK. AT THE COMPLETION OF THE WORK, REMOVE ALL SURPLUS MATERIALS, TOOLS, ETC. AND LEAVE
- THE PRMESES CLEAN. THE SPRINKLER CONTRACTOR SHALL PROVIDE PROPER SIESMIC RESTRAINTS FOR ALL
- NEW PIPING IN ACCORDANCE WITH NFPA 13 2016 ED. AND AS REQUIRED BY ASCE 7 THESE SPRINKLER DRAWINGS ARE DIAGRAMMATIC AND SHOWN AS A REPRESENTATIVE DESIGN ONLY. THE CONTRACTOR SHALL VISIT THE SITE, READ ALL DRAWINGS, AND MAKE DETAILED NOTES OF NECESSARY OFFSETS REQUIRED FOR INSTALLATION OF THE WORK.

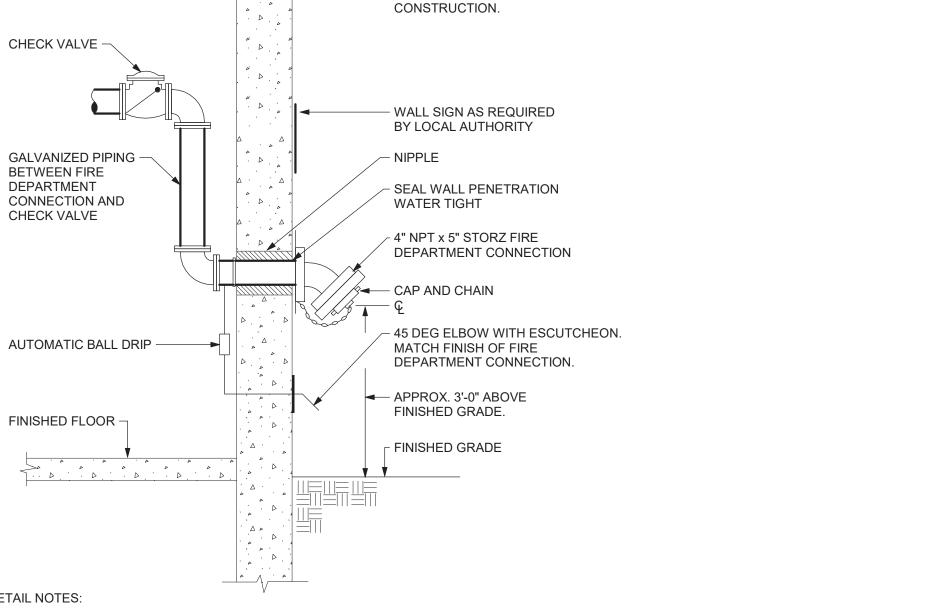


EXTERIOR WALL SEE

ARCHITECTURAL PLANS FOR

DETAIL NOTES: A. FIRE DEPARTMENT CONNECTION SHALL MATCH LOCAL FIRE DEPARTMENT TYPE, THREAD

- B. FIRE DEPARTMENT CONNECTION SHALL NOT BE OBSCURED OR BLOCKED BY PLANTINGS.

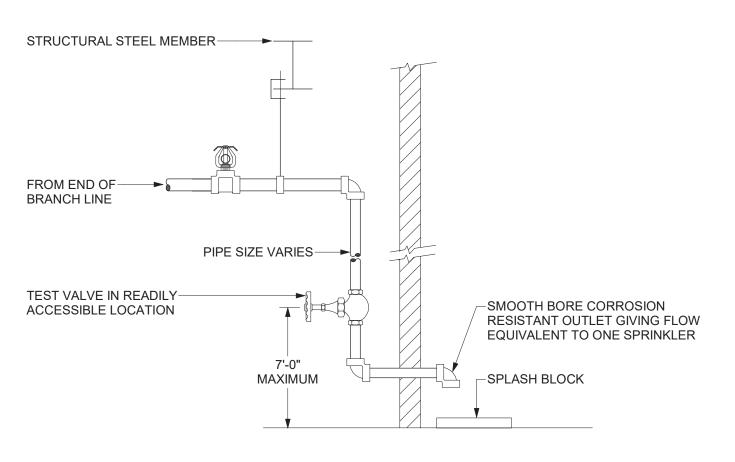

DETAIL NOTE:

A. NOT LESS THAN 4' OF EXPOSED TEST PIPE IN WARM ROOM BEYOND VALVE WHEN PIPE EXTENDS THRU WALL TO OUTSIDE

INSPECTOR'S TEST CONNECTION DETAIL (WET SYSTEM)

VILLAGE OF ARDSLEY, NY **NEW PUBLIC WORKS FACILITY** 220 HEATHERDELL ROAD, VILLAGE OF ARDSLEY. NEW YORK 10502

> WESTON & SAMPSON, PE, LS, LA, PC 1 Winners Circle Suite 130 Albany, NY 12205 (508) 698-3034 (800) SAMPSON www.westonandsampson.com


Consultants:



ME ENGINEERING Mechanical/Electrical Engineering Consultants

Capital District | Rochester | Buffalo | Syracuse



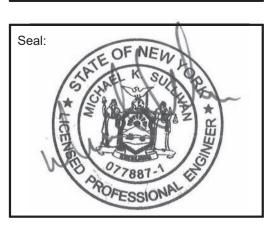

Revisions: Rev Date Description

BID

PROJECT TRUE

Issued For:

SCALE: AS NOTED

APRIL 7, 2022 CES

Drawn By:

Reviewed By:

Approved By: BAB W&S Project No: N2190088


Drawing Title:

FIRE PROTECTION SCHEDULES, **GENERAL NOTES**

& SYMBOLS LIST

Sheet Number:

WESTON & SAMPSON COPYRIGHT 2019

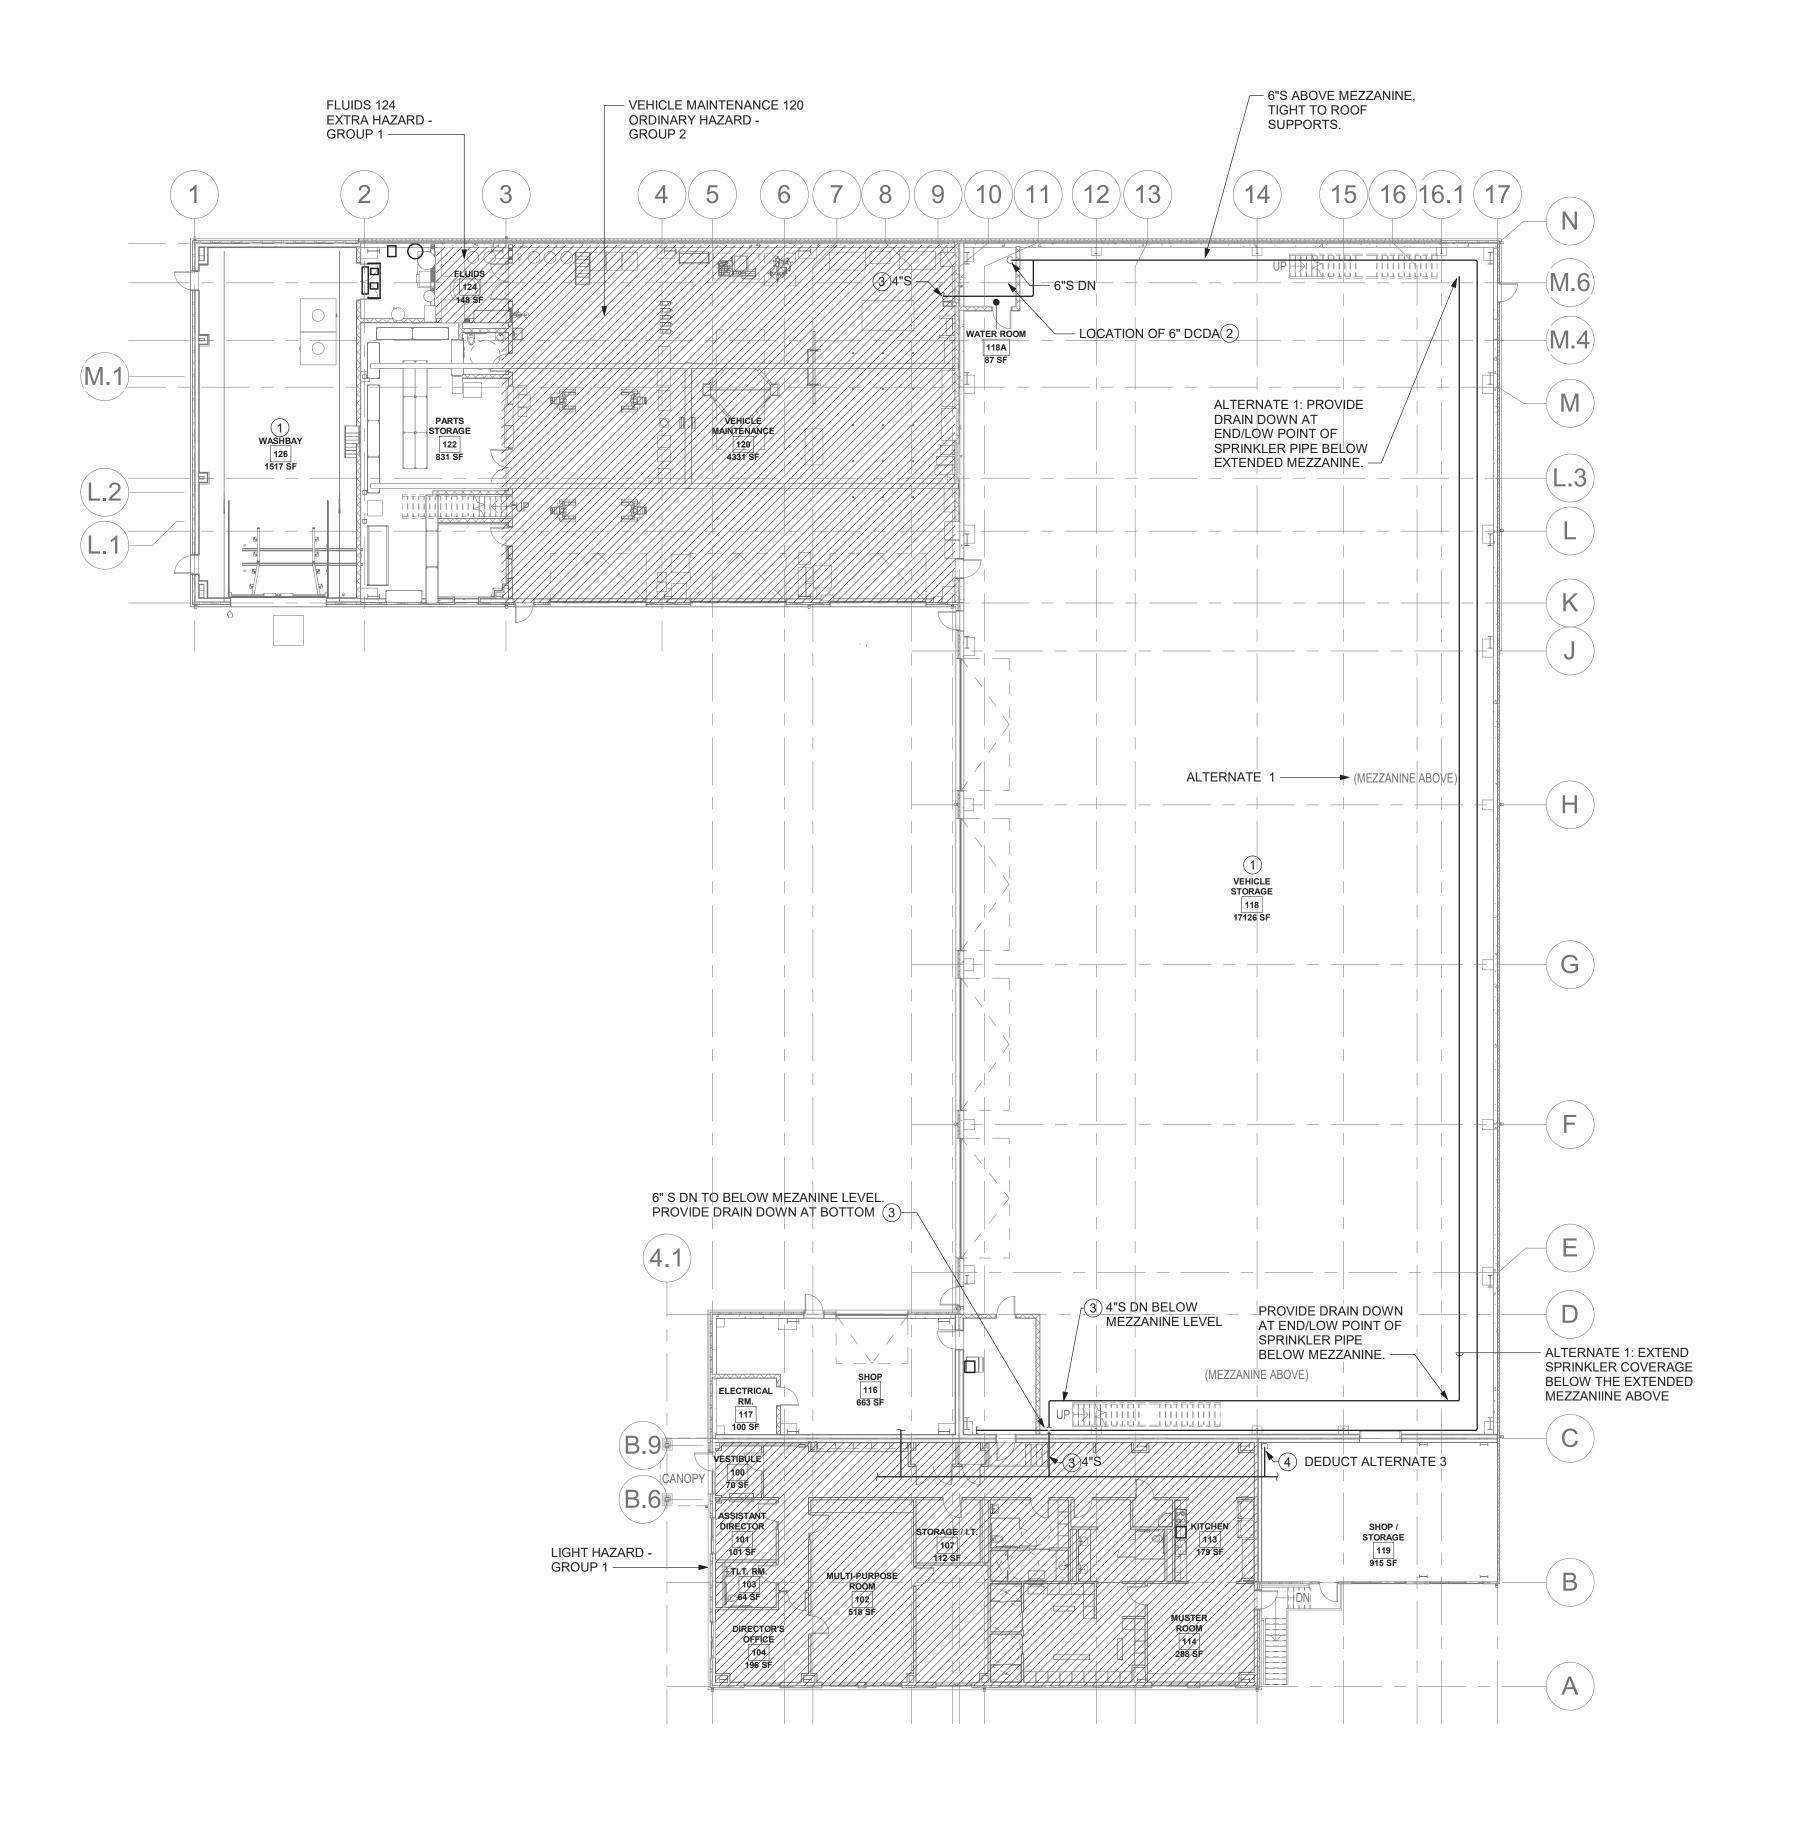

FP101 DRAWING NOTES

- 1 FIRE HAZARD CLASSIFICATION SHALL BE ORDINARY HAZARD GROUP 1 UNLESS OTHERWISE NOTED.
- 2 FIRE SERVICE BACK FLOW PREVENTOR PROVIDED BY THE PLUMBING CONTRACTOR. COORDINATE SIZE AND CLEARANCE REQUIRMENTS WITH THE PC BASED ON THE RESULTS OF THE HYDRAULIC CALCULATIONS. REFER TO THE PLUMBING DRAWINGS FOR
- 3 SPRINKLER MAIN SIZES INDICATED ARE FOR SUGGESTED ROUTING REFERENCE ONLY. THIS CONTRACTOR SHALL HYDRAULICALLY CALULATE AND CONFIRM ALL MAINS AND
- 4 DEDUCT ALTERNATE No. 3: 2"S DN TO BASEMENT LEVEL. PROVIDE DRAIN DOWN AT

ROOM LAYOUT.

BOTTOM.

NEW PUBLIC WORKS **FACILITY**

VILLAGE OF ARDSLEY, NY

220 HEATHERDELL ROAD, VILLAGE OF ARDSLEY, NEW YORK 10502

WESTON & SAMPSON, PE, LS, LA, PC 1 Winners Circle Suite 130 Albany, NY 12205 (508) 698-3034 (800) SAMPSON www.westonandsampson.com


Consultants:









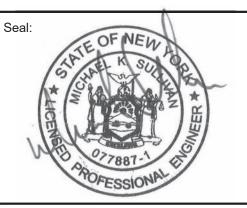

Revisions: Rev Date Description

Issued For:





CES

SCALE: AS NOTED

APRIL 7, 2022

Reviewed By:

Drawn By:

Approved By: BAB

W&S Project No: N2190088

Drawing Title:

OVERALL FIRE PROTECTION FLOOR PLAN

Sheet Number:

OVERALL FIRST FLOOR FIRE PROTECTION PLAN

1/16" = 1'-0"