GENERAL NOTES:

- A. ALL WORK AND MATERIALS SHALL BE IN ACCORDANCE WITH CURRENT LOCAL CODES AND PROJECT SPECIFICATIONS.
- THE PLUMBING CONTRACTOR SHALL COORDINATE ALL PIPING WITH MECHANICAL, ELECTRICAL, ARCHITECTURAL, AND STRUCTURAL TRADES PRIOR TO CONSTRUCTION TO AVOID ITERFERENCE.
- C. PROVIDE ACCESS PANELS FOR ALL CONCEALED VALVES, WATER HAMMER ARRESTORS, TRAPS, ETC. PROVIDE TRAP GUARDS FOR ALL P-TRAPS FOR FLOOR DRAINS LOCATED IN MECHANICAL ROOMS, PUBLIC RESTROOMS AND OTHER
- AREAS WHERE TRAP EVAPORATION MAY OCCUR. PLUMBING CONTRACTOR SHALL CONNECT ALL ITEMS OF EQUIPMENT FURNISHED BY OTHERS AND UNDER OTHER SECTIONS OF THE SPECIFICATIONS. CONTRACTOR SHALL PROVIDE ALL ITEMS NECESSARY TO COMPLETE THE PLUMBING INSTALLATION.
- REFER TO ARCHITECTURAL DRAWING FOR ROUGHING DIMENSIONS OF PLUMBING FIXTURE MOUNTINGS HEIGHTS. G. PROVIDE UNIONS FOR ALL PIPING CONNECTIONS TO EQUIPMENT.
- ALL PLUMBING FIXTURES AND EQUIPMENT SHALL BE IN COMPLIANCE WITH CURRENT APPLICABLE ENERGY CONSERVATION CODES. ALL PIPING AND EQUIPMENT IS SHOWN DIAGRAMMATICALLY ONLY. GENERAL ORIENTATION SHOWN IN PLAN AND SECTIONAL DRAWINGS. EXACT LOCATION SHALL BE DETERMINED IN FIELD. MAINTAIN HEAD ROOM AND SPACE CONDITIONS AT ALL TIMES. ALL WORK SHALL BE COORDINATED WITH ALL TRADES BEFORE PROCEEDING WITH INSTALLATION. PRIOR TO CONSTRUCTION, CONTRACTOR SHALL NOTIFY ARCHITECT OF ANY DISCREPANCIES. PRIOR TO EQUIPMENT SUBMITTALS, CONTRACTOR SHALL VERIFY EXISTING AND PROPOSED CONDITIONS SUCH AS CORRIDORS, PASSAGE-WAY ROOM SIZES, ETC. TO ENSURE SPECIFIED EQUIPMENT CAN BE PROPERLY INSTALLED.
- J. FABRICATE AND INSTALL ALL PIPING IN ACCORDANCE WITH THE STATE PLUMBING CODE, LOCAL PLUMBING CODE, AND APPLICABLE SECTIONS OF THE BUILDING CODES.
- K. INSTALL PIPING CLOSE TO WALLS, PARTITIONS, CEILINGS, ETC. OFFSET ONLY WHERE NECESSARY TO FOLLOW WALLS, AS INDICATED.
- PROVIDE ALL NECESSARY FITTINGS, OFFSETS, VALVES AND OTHER DEVICES REQUIRED FOR A COMPLETE INSTALLATION. INSTALL PIPING IN A CONCEALED MANNER, STRAIGHT, PLUMB AND AS DIRECT AS POSSIBLE. FORM RIGHT ANGLES PARALLEL WITH BUILDING WALLS. LOCATE GROUPS OF PIPES PARALLEL TO EACH OTHER. PIPE SHALL BE LOCATED TO PERMIT ACCESS FOR SERVICE
- M. CONCRETE PADS, PITS, AND FLASHING FOR PLUMBING EQUIPMENT SHALL BE AS INDICATED ON THE STRUCTURAL AND ARCHITECTURAL PLANS, UNLESS NOTED OTHERWISE. COORDINATE EXACT SIZES OF REQUIRED OPENINGS AND SUPPORTS FOR FURNISHED EQUIPMENT.
- N. ALL PIPING SHALL BE REAMED TO BE FREE OF BURRS. KEEP PIPING FREE FROM SCALE AND DIRT. PROTECT OPEN PIPE ENDS WHENEVER WORK IS SUSPENDED DURING CONSTRUCTION TO PREVENT FOREIGN MATERIAL FROM ENTERING, AND CAP ALL OPEN ENDS DURING CONSTRUCTION WITH APPROVED TEMPORALLY CAPS OR MATERIALS.
- O. ALL GAS PIPING AND OTHER PLUMBING SYSTEMS SHALL BE SEISMICALLY BRACED IN ACCORDANCE WITH THE APPLICABLE SECTIONS OF THE STATE BUILDING CODE AND THE NATIONAL FIRE PROTECTION ASSOCIATION (NFPA). SEAL ALL WALL AND FLOOR PENETRATIONS AROUND NEW PIPES WITH FIRE PROOF CAULKING.
- P. MAINTENANCE LABELS SHALL BE AFFIXED TO ALL PLUMBING EQUIPMENT AND MAINTENANCE AND OPERATION MANUALS SHALL BE PROVIDED TO OWNER.
- Q. INSTALL WELDED OR THREADED PIPE IN AREAS WHERE SPACE IS CRITICAL BETWEEN FINISHED CEILING AND STRUCTURAL SURFACE. INSTALL ALL VENTS THRU ROOF 10'-0" MINIMUM FROM EDGE OF ROOF AND 25'-0" FROM FRESH AIR INTAKES.
- R. SUBMIT ALL REQUIRED PLUMBING DOCUMENTS TO LOCAL PLUMBING OFFICIAL FOR APPROVAL. THE ENTIRE PLUMBING SYSTEM SHALL BE INSTALLED IN COMPLIANCE WITH ALL APPLICABLE BUILDING CODES, REGULATIONS, AND LOCAL REQUIREMENTS.
- SUBMIT APPROVED PRESSURE REDUCING VALVES & BACKFLOW PREVENTION DEVICES TO WATER AUTHORITY. CONTRACTOR SHALL PROVIDE ALL NECESSARY DEVICES PER WATER AUTHORITY REQUIREMENTS AND MANUFACTURER RECOMMENDATIONS. ALL WALL, CEILING AND FLOOR PENETRATIONS CONVEYING PLUMBING AND DRAINS SHALL BE FULLY SEALED AND CAULKED AROUND THE PENETRATING FEATURE TO RESTORE THE REQUIRED FIRE OR SMOKE BARRIER RATING OF THE WALL, CEILING OR FLOOR PENETRATED. AT A MINIMUM, AT ALL LOCATIONS A TWENTY (20) MINUTE FIRE/SMOKE RESISTANCE SHALL BE MAINTAINED. WHERE REQUIRED BY CODE, THE PENETRATING FEATURES SHALL ALSO BE SUPPLIED AND INSTALLED WITH A MECHANISM OR MATERIAL WHICH
- WILL MAINTAIN THE WALL, CEILING OR FLOOR RATING IN THE EVENT OF A FIRE. U. PLUMBING OR SPRINKLER RELATED PIPE SHALL NOT PENETRATE INTO OR PASS THROUGH STAIRWAYS UNLESS IT IS REQUIRED FOR SERVICING THE STAIRWAY OR IT IS SEGREGATED FROM THE STAIRWAY PASSAGEWAY BY AN ENCLOSURE SYSTEM RATED EQUAL TO OR GREATER THAN THE REQUIRED STAIRWAY RATING.
- V. PROVIDE FLUSH TYPE ACCESS DOORS OR PANELS NO SMALLER THAN 12"x12" AND NO LARGER THAN 30"x30" FOR ALL VALVES OR APPARATUS LOCATED IN CHASES, WALLS, AND NON ACCESSIBLE CEILINGS, OR FLOORS.
- W. INSTALL WATER HAMMER ARRESTORS IN COMPLIANCE WITH ALL APPLICABLE CODES. SIZE OF WATER HAMMER ARRESTORS SHALL BE ACCORDING TO THE WATER HAMMER SCHEDULE AND MANUFACTURER'S RECOMMENDATIONS FOR THAT BRANCH LINE.
- X. CLEANOUTS SHALL BE PROVIDED AS INDICATED ON PLANS AND AS REQUIRED BY THE LOCAL CODES. Y. PRIOR TO INSTALLING ANY PIPING, VERIFY EXISTING OR NEW INVERT ELEVATIONS, LOCATIONS AND PIPE SIZES. INSTALL ALL SANITARY
- AND WASTE BEGINNING AT LOW POINT OF EACH SYSTEM AND CONTINUE WITH UNBROKEN CONTINUITY OF INVERT. LOW POINT OF EACH SYSTEM SHALL BE COORDINATED WITH SITE UTILITIES CONTRACTOR. REFER TO SITE UTILITY PLANS FOR REFERENCE.
- AA. DRAIN VALVES SHALL BE PROVIDED ON LOWEST POINT OF ALL DOMESTIC WATER RISERS AS FOLLOWS: 1-1/2" OR LESS-PROVIDE 1/2" DRAIN VALVE. 2" OR LARGER-PROVIDE 3/4" DRAIN VALVE. BB. PROVIDE ISOLATION VALVES AT ALL FIXTURES AND EQUIPMENT.
- CC. PLUMBING CONTRACTOR SHALL INSTALL GAS VENTS FOR ALL GAS MANIFOLD/TRAIN SYSTEMS LOCATED AT BOILERS OR WATER HEATERS. PRIOR TO CONSTRUTION, CONTRACTOR SHALL REVIEW THE EXISTING CONDITIONS TO DETERMINE MOST ECONOMICAL ROUTE FOR MANIFOLD VENTS BEGINNING AT EQUIPMENT AND EXTENDING THROUGH ROOF.

	PLUMBING SYMBOL LIST
SYMBOL	DESCRIPTION
lacktriangle	POINT OF CONNECTION
NTS	NOT TO SCALE
AFF	ABOVE FINISHED FLOOR
BFF	BELOW FINISHED FLOOR
VTR	VENT THRU ROOF
GC	GENERAL CONTRACTOR
MC	MECHANICAL CONTRACTOR
PC	PLUMBING CONTRACTOR
EC	ELECTRICAL CONTRACTOR
	NEW PIPING LOCATED ABOVE FLOOR/SLAB
	NEW PIPING LOCATED BELOW FLOOR/SLAB
•	COLD WATER PIPING (CW)
• •	HOT WATER PIPING (HW)
	HOT WATER RECIRCULATING PIPING (HWR)
W	WATER SERVICE - EXTERIOR
—— SAN——	SANITARY SEWER PIPING
v	VENT PIPING (V)
——G——	NATURAL GAS PIPING (G)
OW	OIL/WATER WASTE PIPING (OW)
——CA——	COMPRESSED AIR PIPING (CA)
	ELBOW DOWN
	45°OFFSET
	ELBOW UP
	BOTTOM/TEE CONNECTION
————	TOP TEE CONNECTION
	"P" TRAP
	PIPE CONTINUATION
	CAP OR PLUG
——ф	DECK PLATE CLEANOUT (DPCO)
—— C	WALL PLATE CLEANOUT (WPCO)
	CLEANOUT (CO)
	FLOOR DRAIN (FD) / FLOOR SINK (FS)
	WALL HYDRANT (WH) / HOSE BIBB (HB)
$\overline{}$	STRAINER
М	WATER METER
	SHUT OFF VALVE
——⊗—	BALANCING VALVE
→ \	CHECK VALVE
	SOLENOID VALVE
—	PRESSURE REDUCING VALVE
<u></u> ₹	RELIEF VALVE
	UNION
	BACKFLOW PREVENTER (BFP)
> —	SHOWER HEAD
	SHOCK ABSORBER (SA)
Ø	RECIRCULATION PUMP
	THERMOMETER
<u>-</u>	PRESSURE GAUGE
X	DRAWING KEYNOTE
_	

FIXTURE AN	ID EQUIPMENT CONNECTION S	SCHEDL	JLE			
DESIGNATION	DESCRIPTION	COLD WATER	HOT WATER	WASTE OR SANITARY	VENT	REMARKS
WC-A	WATER CLOSET - PUBLIC - FLUSH VALVE	1"	-	3"	2"	ADA HEIGHT, WALL HUNG, ELONGATED, 1.28 GPF: AMERICAN STANDARD AFWALL. OPEN FRONT TOILET SEAT.
UR-A	URINAL -PUBLIC - FLUSH VALVE	3/4"	-	2"	1-1/2"	WALL MOUNTED, ELONGATED FLUSHING RIM, TOP SPUD, SLOAN G2 OPTIMA PLUS SENSOR BATTERY POWERED, 0.5 GPF: AMERICAN STANDARD WASHBROOK.
LAV-A	LAVATORY - ADA	1/2"	1/2"	1-1/2"	1-1/2"	AMERICAN STANDARD LUCERNE, WALL-HUNG, LAV GUARD
LAV-B	LAVATORY - PUBLIC - ADA	1/2"	1/2"	1-1/2"	1-1/2"	AMERICAN STANDARD, LAV GUARD
SK-A	KITCHEN SINK	1/2"	1/2"	1-1/2"	1-1/2"	ELKAY LUSTERTONE, ADA, STRAINER
SH-A	SHOWER - ADA	1/2"	1/2"	1-1/2"	1-1/2"	AQUATIC ADVANTAGE 16030BFSC, CENTER BRASS DRAIN, SLIP RESISTANT TEXTURED BOTTOM, VINYL FLEXIBLE DAM, REINFORCED FOR FOLDING SEAT AND GRAB BARS, CURTAIN ROD, SOAP DISH. MOEN 8346EP15 POSI-TEMP TRIM KIT, CHROME FINISH, HAND-HELD SHOWER WITH 30" SLIDE BAR, DROP ELL, 69" METAL HOSE, CHROME FINISH, 1.5 GPM.
FD-A	FLOOR DRAIN - STANDARD	-	-	2"	1-1/2"	JAY R SMITH FIGURE 2010,7" ADJUSTABLE STRAINER, TRAP GUARD
FD-B	FLOOR DRAIN - WITH RECESS	-	-	3"	1-1/2"	JAY R SMITH FIGURE 2010, 7" ADJUSTABLE STRAINER, TRAP GUARD, WITH RECESSED, ANTI-FLOOD RIM.
FD-C	FLOOR DRAIN - HEAVY DUTY	-	-	4",6"	-	JAY R SMITH FIGURE 21243C, 12" NICKEL BRONZE HINGED GRATE, SEDIMENT BUCKET, QUAD CLOSE TRAP SEAL,
TD-A	TRENCH DRAIN SYSTEM WITH CATCH BASIN	-	-	4",6"	-	ZURN Z882-HDG, GALVANIZED PRE-SLOPED TRENCH DRAIN SYSTEM, HIGH DENSITY POLYETHYLENE, EXTRA HEAVY DUTY 12" WIDE GRATE, EN1433 CLASSIFICATION 'E', GALVANIZED CATH BASIN WITH SEDIMENT BASKET.
EWC-A	WATER COOLER - ADA	1/2"	-	1-1/2"		ELKAY EZSTL8LC, BI-LEVEL NON-FILTERING, 8 GPH.
MB-A	MOP BASIN	3/4"	3/4"	2"		FIAT MODEL MSB
SS-A	SERVICE SINK	1/2"	1/2"	2'	1-1/2"	AMERICAN STANDARD AKRON

BACKFLOW PREVENTER SCHEDULE										
NO.	AREA SERVED	USAGE	TYPE	ORIENTATION	INLET/ OUTLET SIZE (IN.)	INLET/ OUTLET SHUTOFF VALVE TYPE	MAX. WORKING PRESSURE (PSI)	FLOW AT 7.5 FPS (GPM)	PRESSURE DROP AT 7.5 FPS (PSI)	DESIGN MAKE
DCDA-1	DPW BLDG	FIRE WATER	DCDA	HORIZONTAL	6"	OSY	175	680	7.0	WATTS 709 DCDA
RPZ-1	DPW BLDG	DOMESTIC WATER	RPZ	HORIZONTAL	3"	OSY	175	170	12.0	WATTS LF909 RPZ
RPZ-2	WASHBAY	WASHBAY EQUIPMENT	RPZ	HORIZONTAL	1"	QUARTER TURN BALL	175	20	10.0	WATTS 009M2-QT-S

NO LOCATION SERVICE ACEM MAX. PRESSURE MOTOR	R			
NO. LOCATION SERVICE ACFM (PSIG) HP	VOLTAGE	PHASE	TYPE	DESIGN MAKE
COMP-1 COMPRESSOR ROOM TRUCK BAYS 92.4 175 15	480	3	DUPLEX RECIPROCATING	CHAMPION MODEL HR15-12

- INCLUDE 120 GALLON RECEIVER INCLUDE REFRIGERANT DRYER
- INCLUDE 400 GALLON DRY STORAGE TANK

WATER HE	WATER HEATER SCHEDULE									
NO.	SERVICE	STORAGE VOLUME (GAL.)	BTUH INPUT	GALLONS/ HOUR	TEMP RISE DEG F	FUEL TYPE	VENT IN INCHES	ELECTRIC	EFFICIENCY	DESIGN MAKE
WH-1	ADMIN	60	1200000	138	100	NAT GAS	3"	120V / 5A	95%	A.O. SMITH CYCLONE MXI BTH 120(A)
WH-2	VEHICLE MAINT.	60	1200000	138	100	NAT GAS	3"	120V / 5A	95%	A.O. SMITH CYCLONE MXI BTH 120(A)

MASTER	R MIXING VA	LVE SCHE	DULE						
TAG NO.	SERVICE	TYPE	DESIGN RANGE (GPM)	PEAK FLOW (GPM)	MAX. PRESSURE DROP AT PEAK FLOW (PSI)	HW INLET	CONNECT CW INLET	IONS MIXED OUTLET	DESIGN MAKE
MMV-1	WH-1,WH-2	HIGH/LOW	0.5 - 159	60.0	10	1-1/4"	1-1/4"	1-1/2"	POWERS LFSH1434

PUMP SCHEDULE										
NO.	LOCATION	SERVICE	GPM	HEAD FT WATER	MOTOR HP	VOLTAGE	PHASE	RPM	TYPE	DESIGN MAKE
RP-1	MEZZANINE	ADMIN HWR	1.2	13.1	0.5	208	1	2225	INLINE	BELL & GOSSETT ECOCIRC XL 55-45

EXPANSION TANK SCHEDULE								
NO.	LOCATION	SERVICE	RELIEF PRESSURE	TANK VOLUME (GALLONS)	MAX. ACCEPT FACTOR	DESIGN EQUIPMENT		
ET-1	WH-1, WH-2	DOM. WATER	125 PSI	10	1.0	AMTROL ST-35-CL		

SHOCK	ABSORBE	R SCHEDU	JLE
NO.	FIXTURE UNIT RATING	SIZE IN INCHES	PDI SYMBOL
SA-A	1 - 11	1/2"	А
SA-B	12 - 32	3/4"	В
SA-C	33 - 60	1"	С
SA-D	61 - 113	1 1/4"	D
SA-E	114 - 154	1 1/2"	E
SA-F	155 - 330	2"	F

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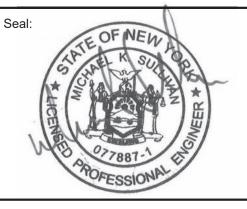
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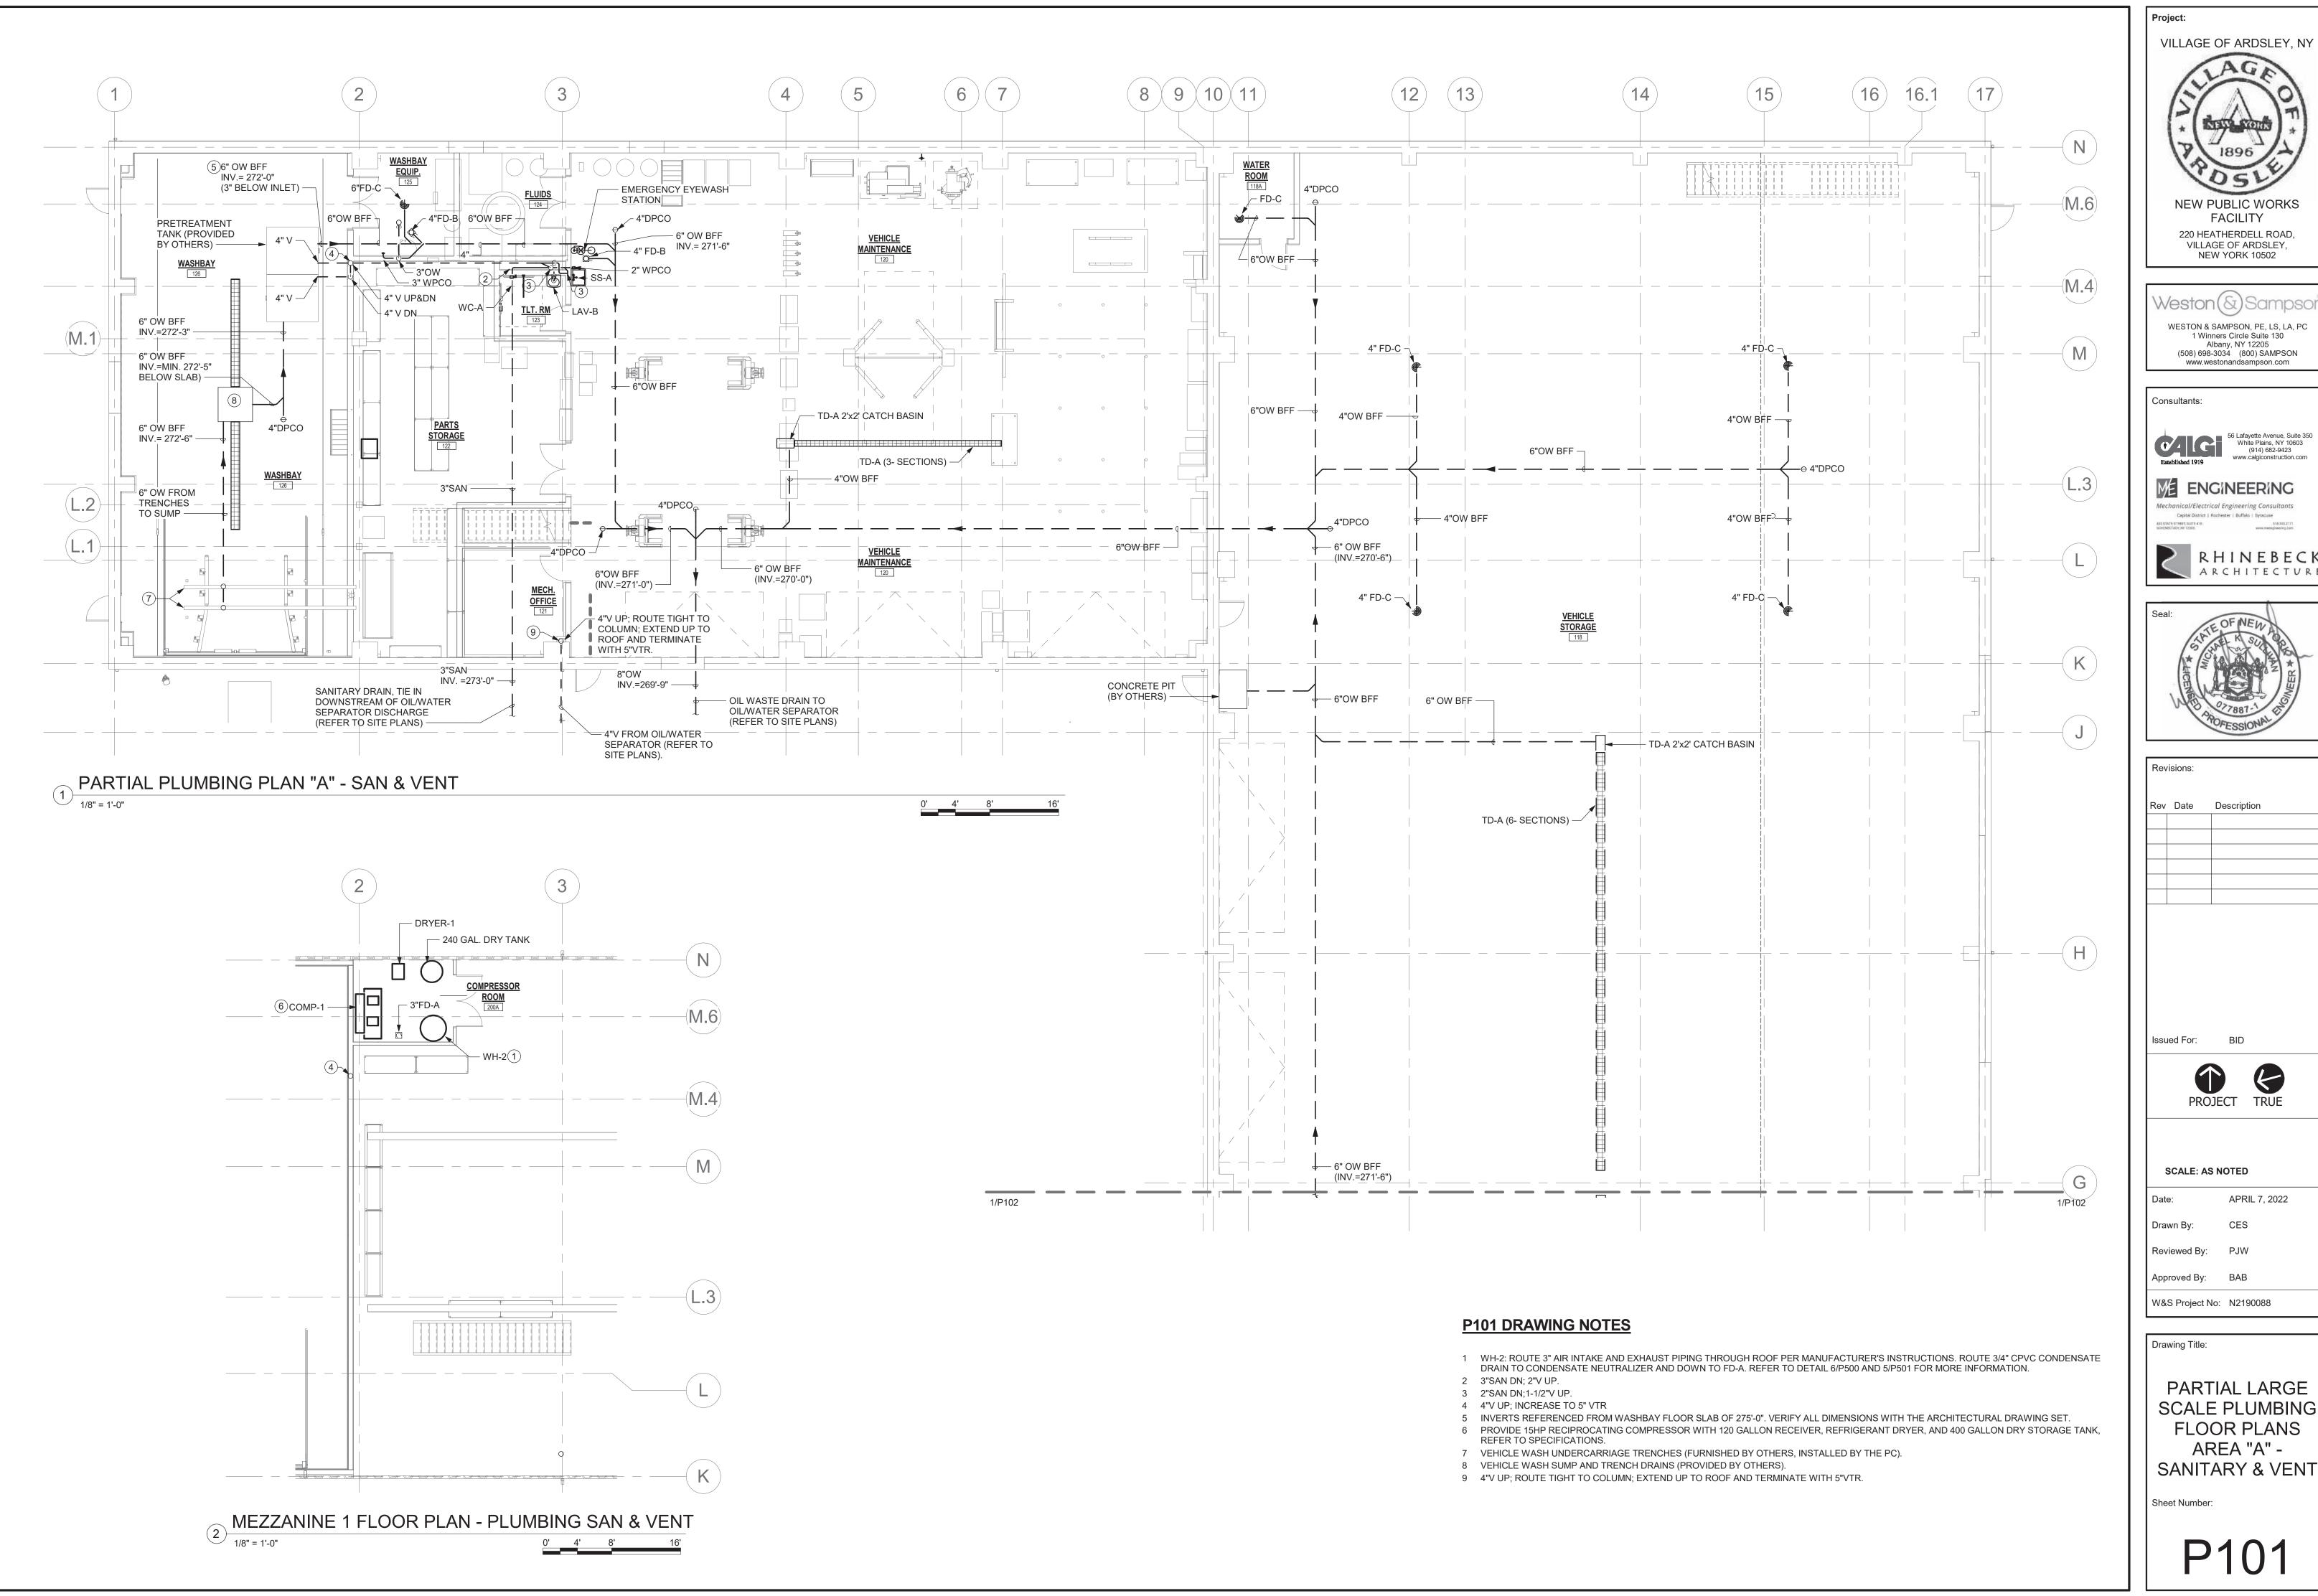
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Drawing Title:

GENERAL NOTES, SCHEDULES & SYMBOL LIST

Sheet Number:



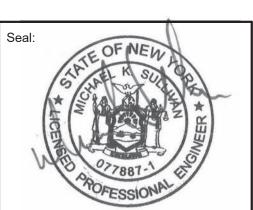
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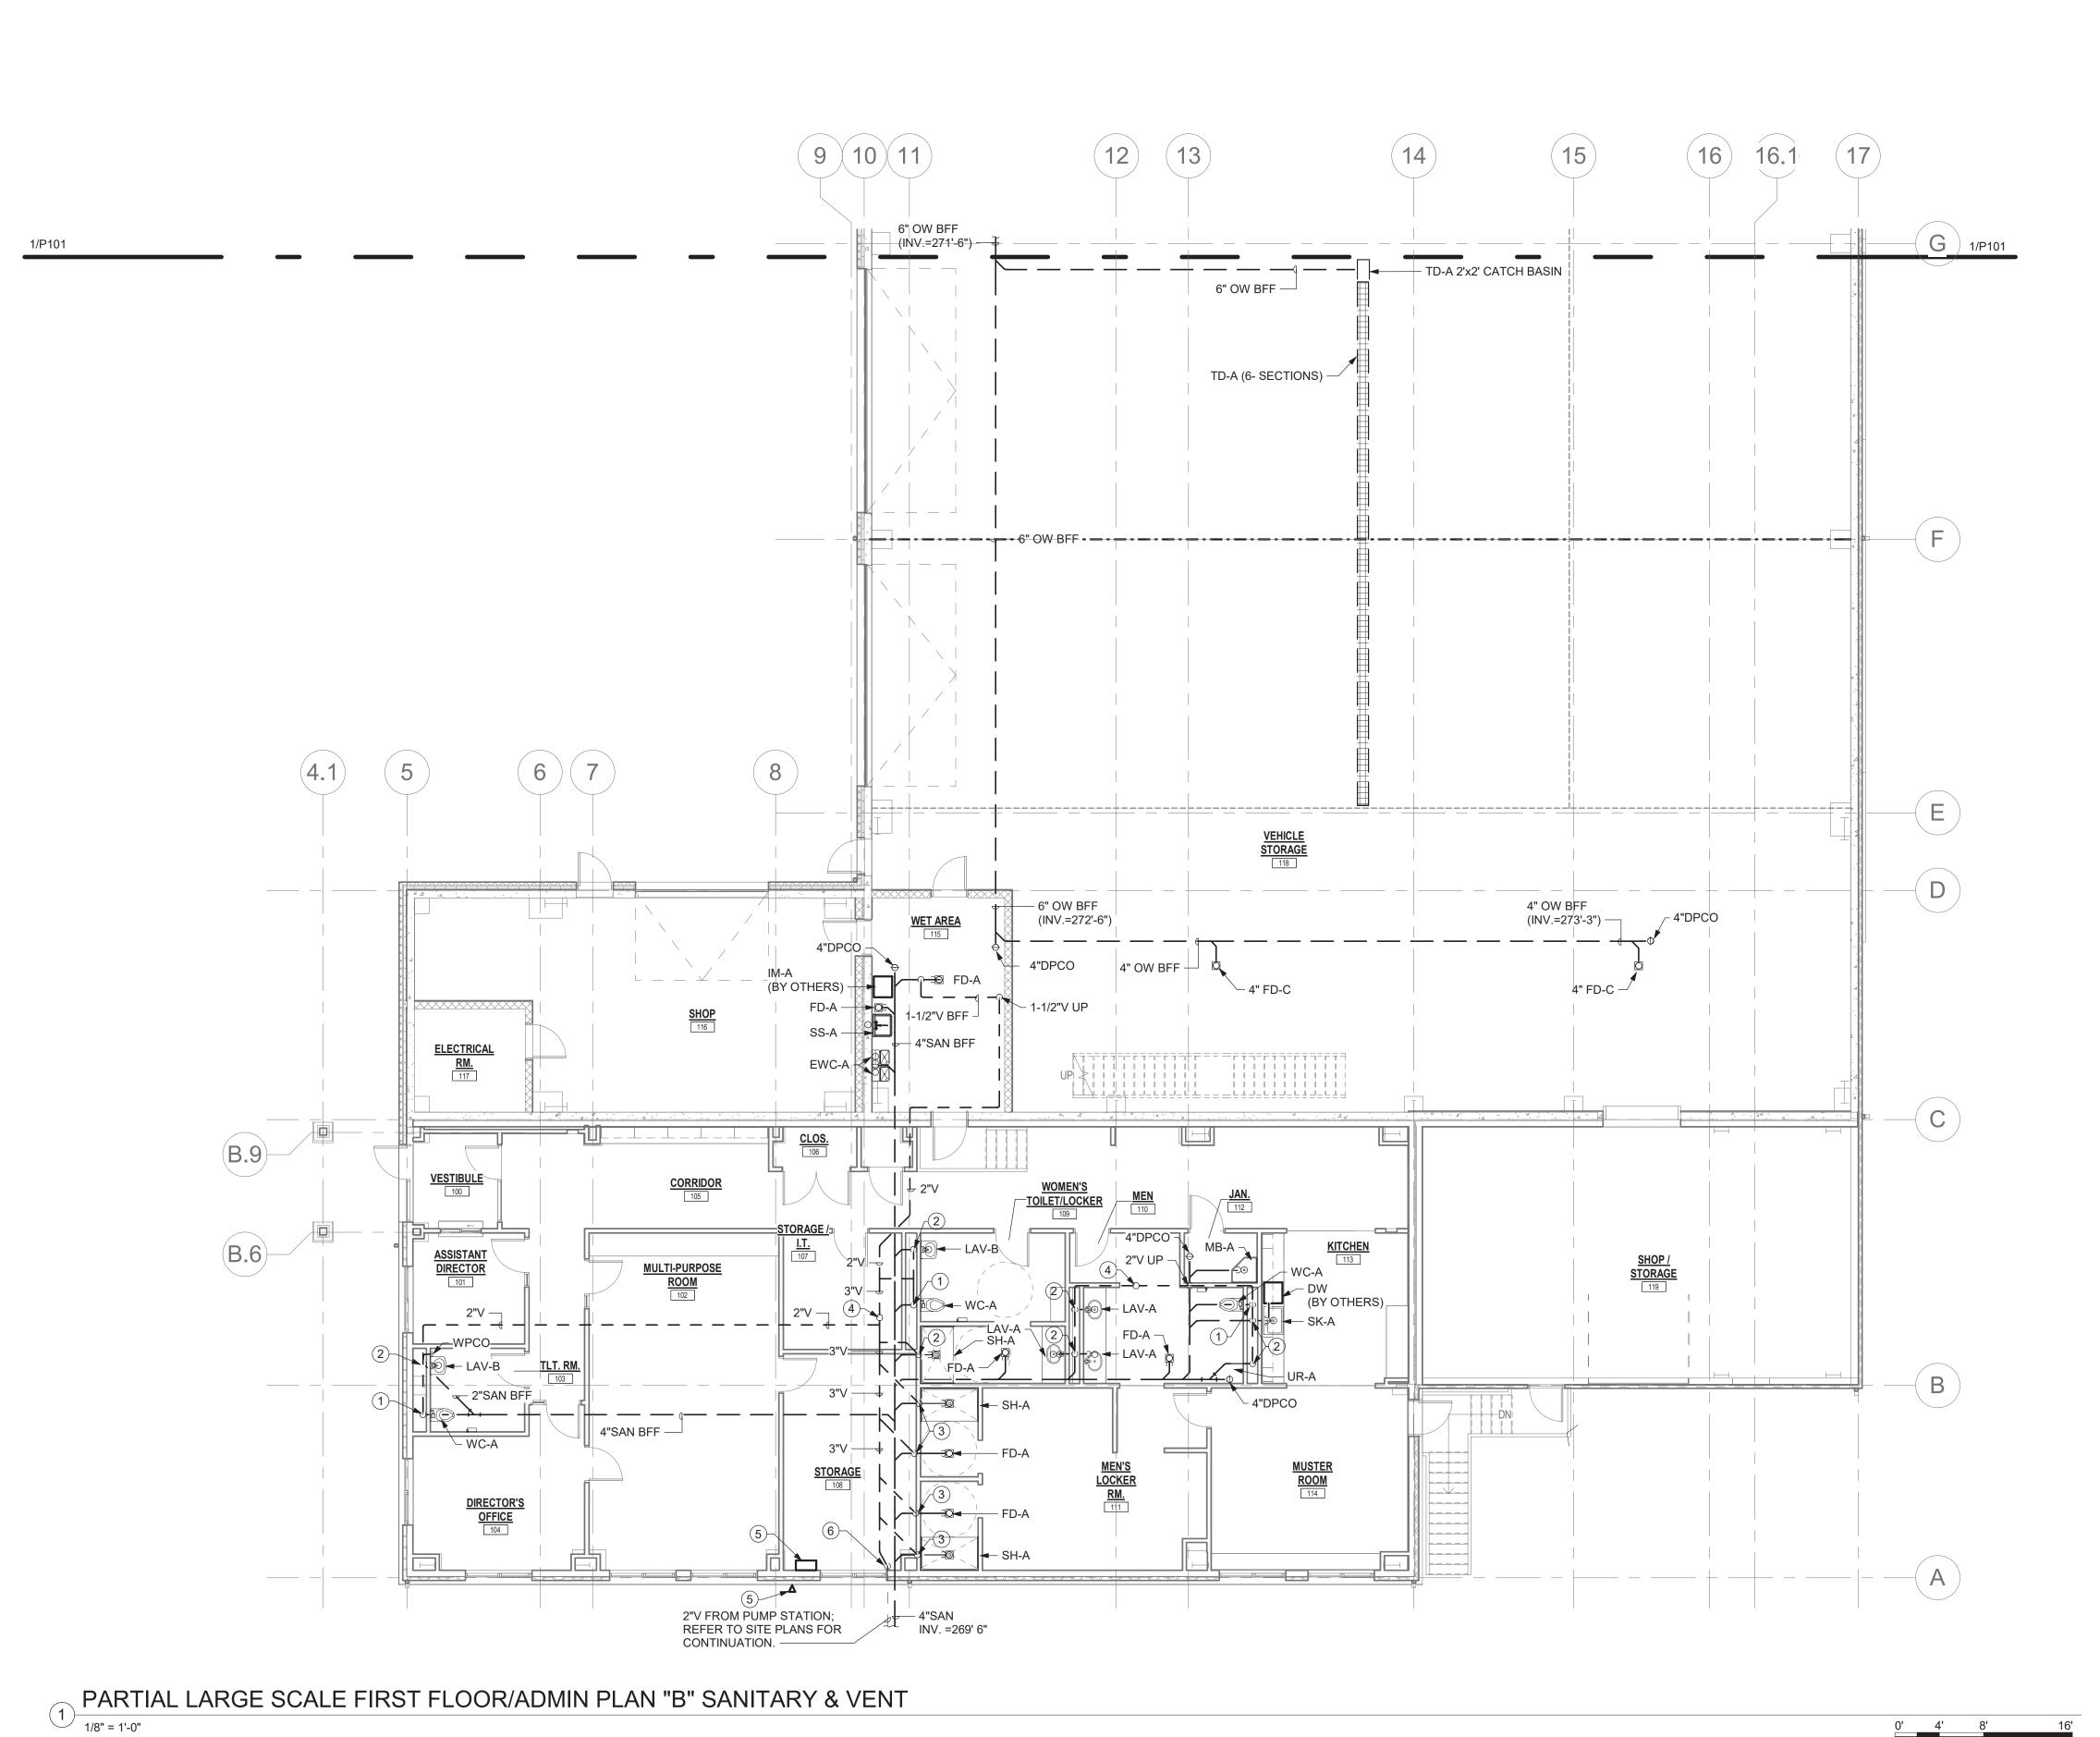
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Drawing Title:

PARTIAL LARGE SCALE PLUMBING **FLOOR PLANS** AREA "A" -SANITARY & VENT

Sheet Number:



P102 DRAWING NOTES

- 1 3"SAN DN; 2"V UP.
- 2 2"SAN DN; 1-1/2"V UP.
- 3 1-1/2"V UP.
- 4 3"V UP; 4"VTR.
- 5 PUMP STATION CONTROL PANEL AND EXTERNAL ALARM MODULE FURNISHED BY OTHERS. REFER TO THE CIVIL ENGINEERS CONTRACT DOCUMENTS AND DRAWINGS.
- 6 2"VENT FROM PUMP STATION. ROUTE TIGHT TO COLUMN UP. CONNECT TO BUILDING'S SANITARY VENT ABOVE CEILING.



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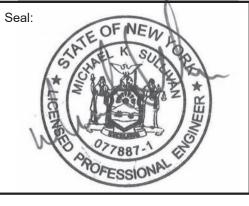
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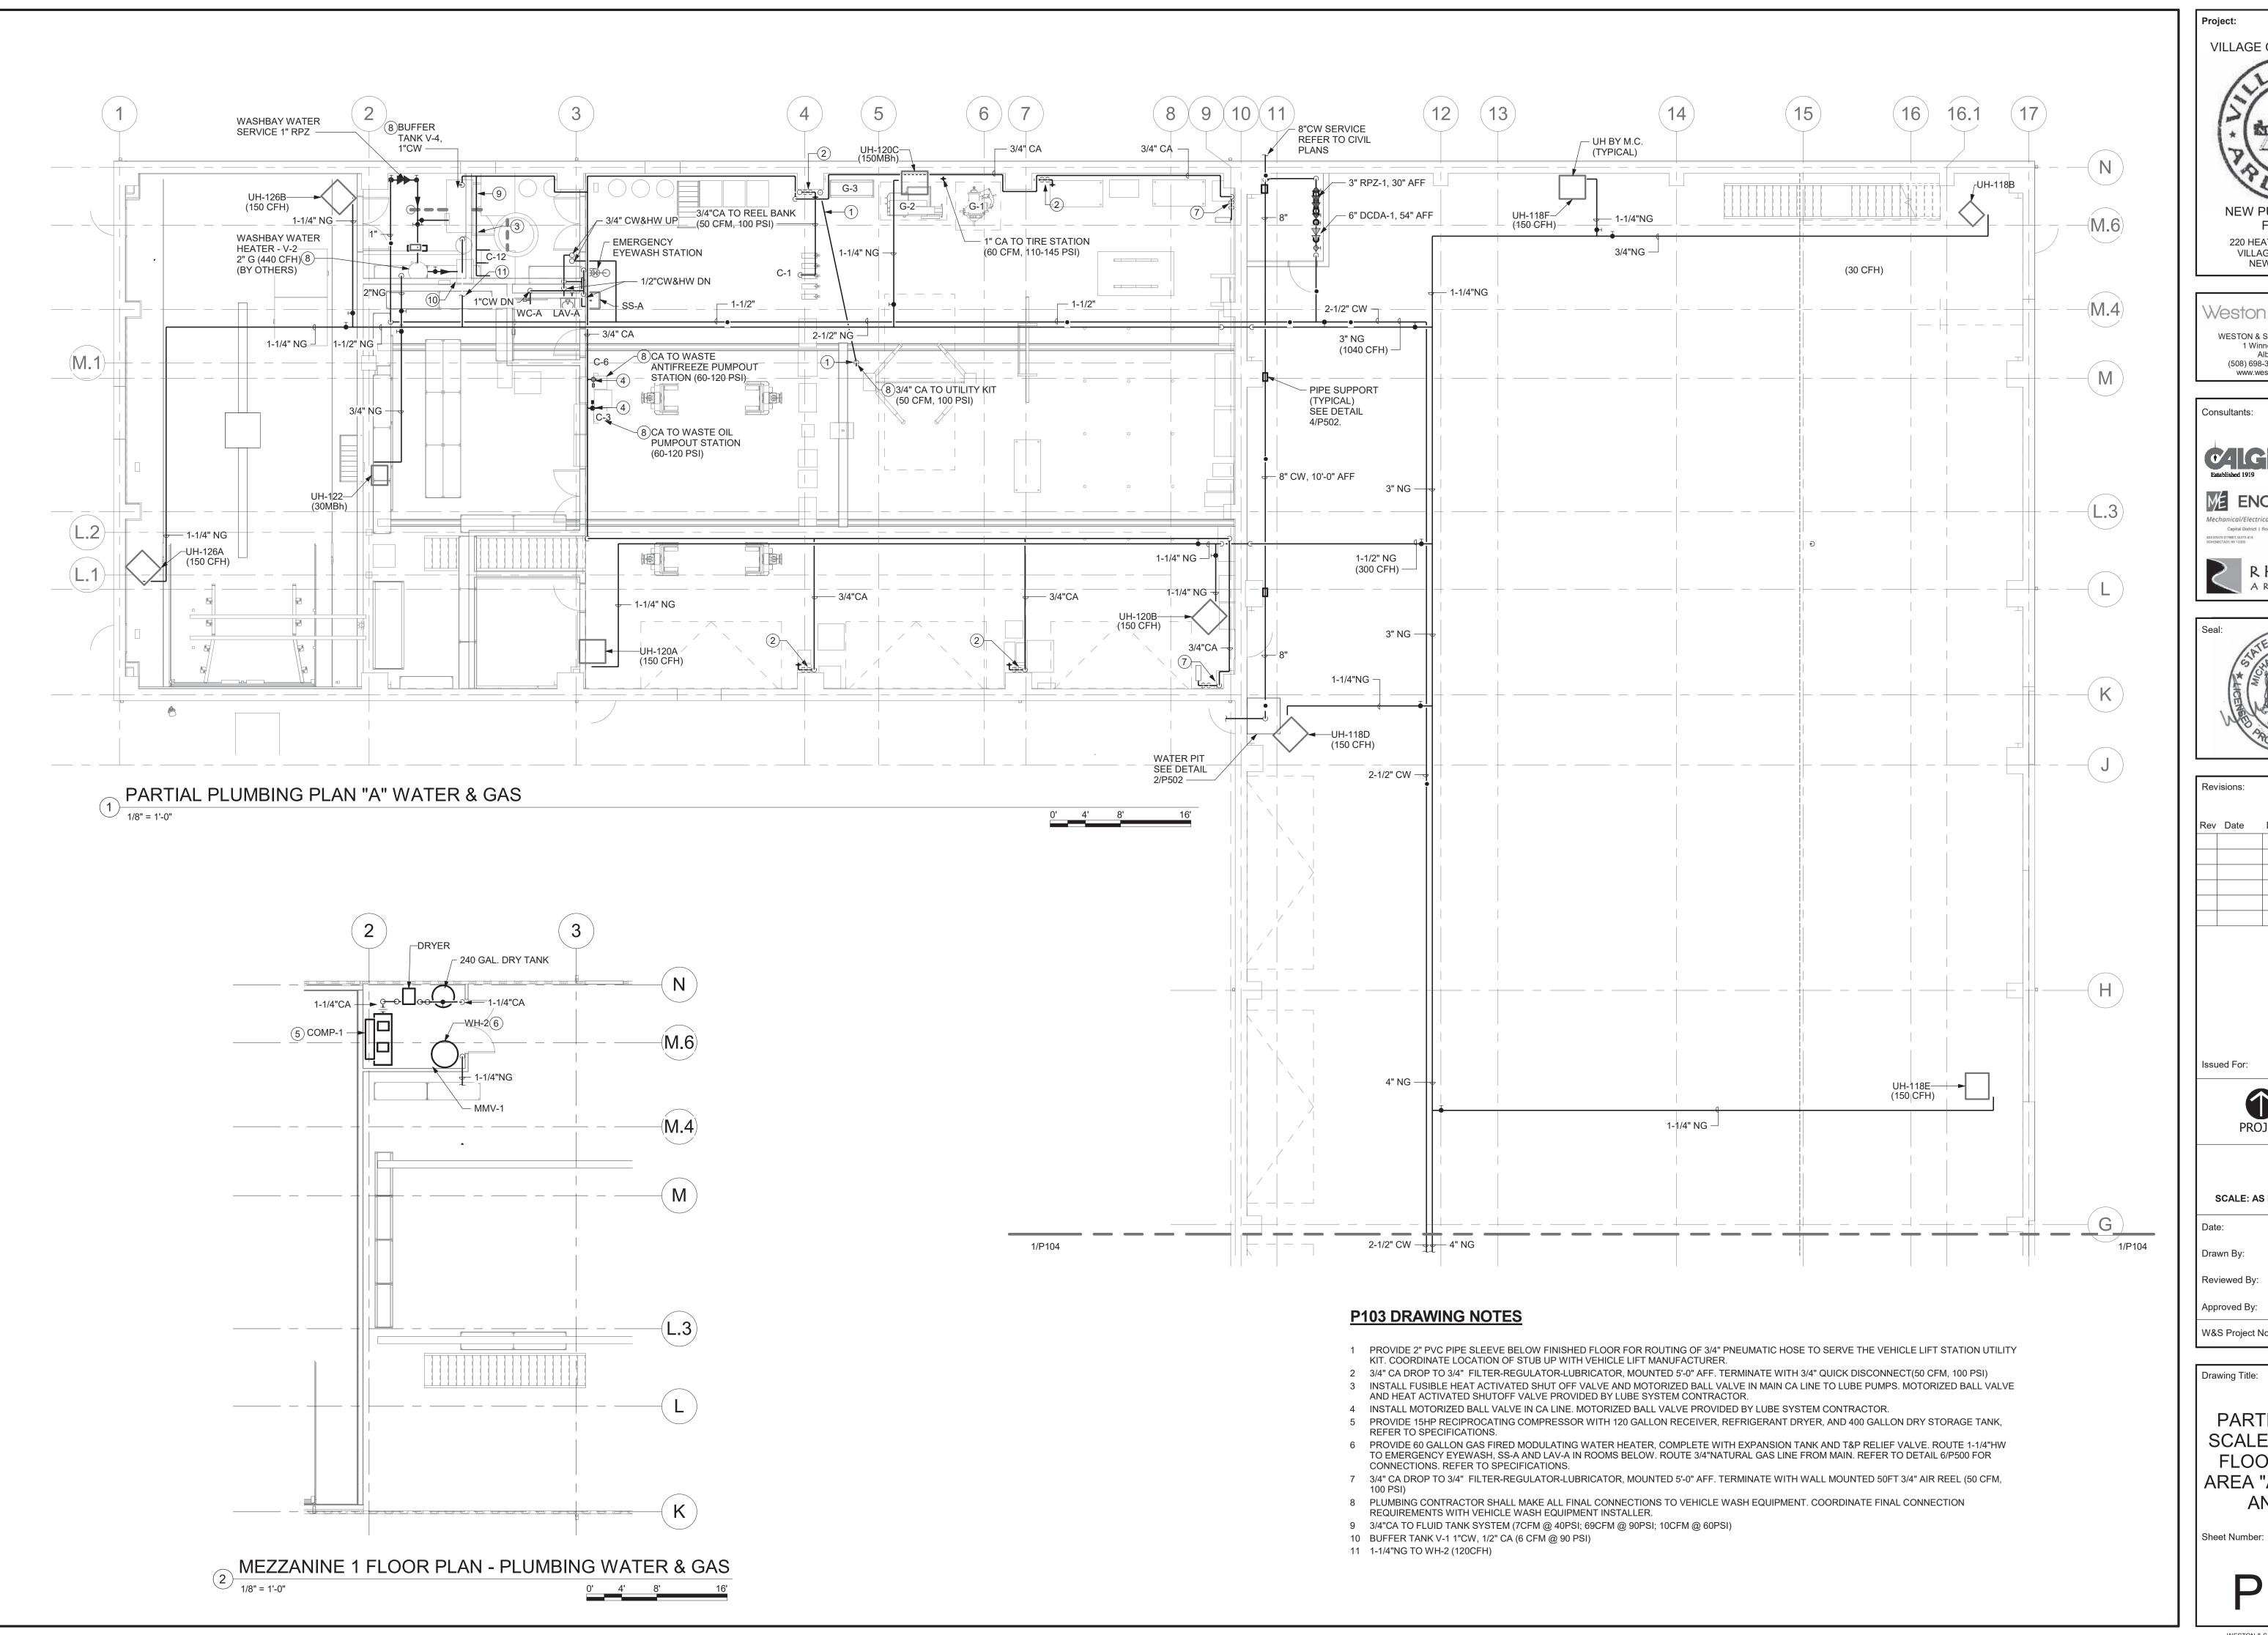
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Drawing Title:

PARTIAL LARGE SCALE PLUMBING FLOOR PLANS -AREA "B" -SANITARY & VENT

Sheet Number:



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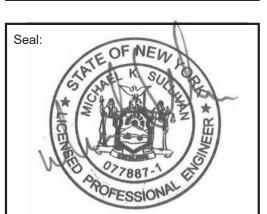
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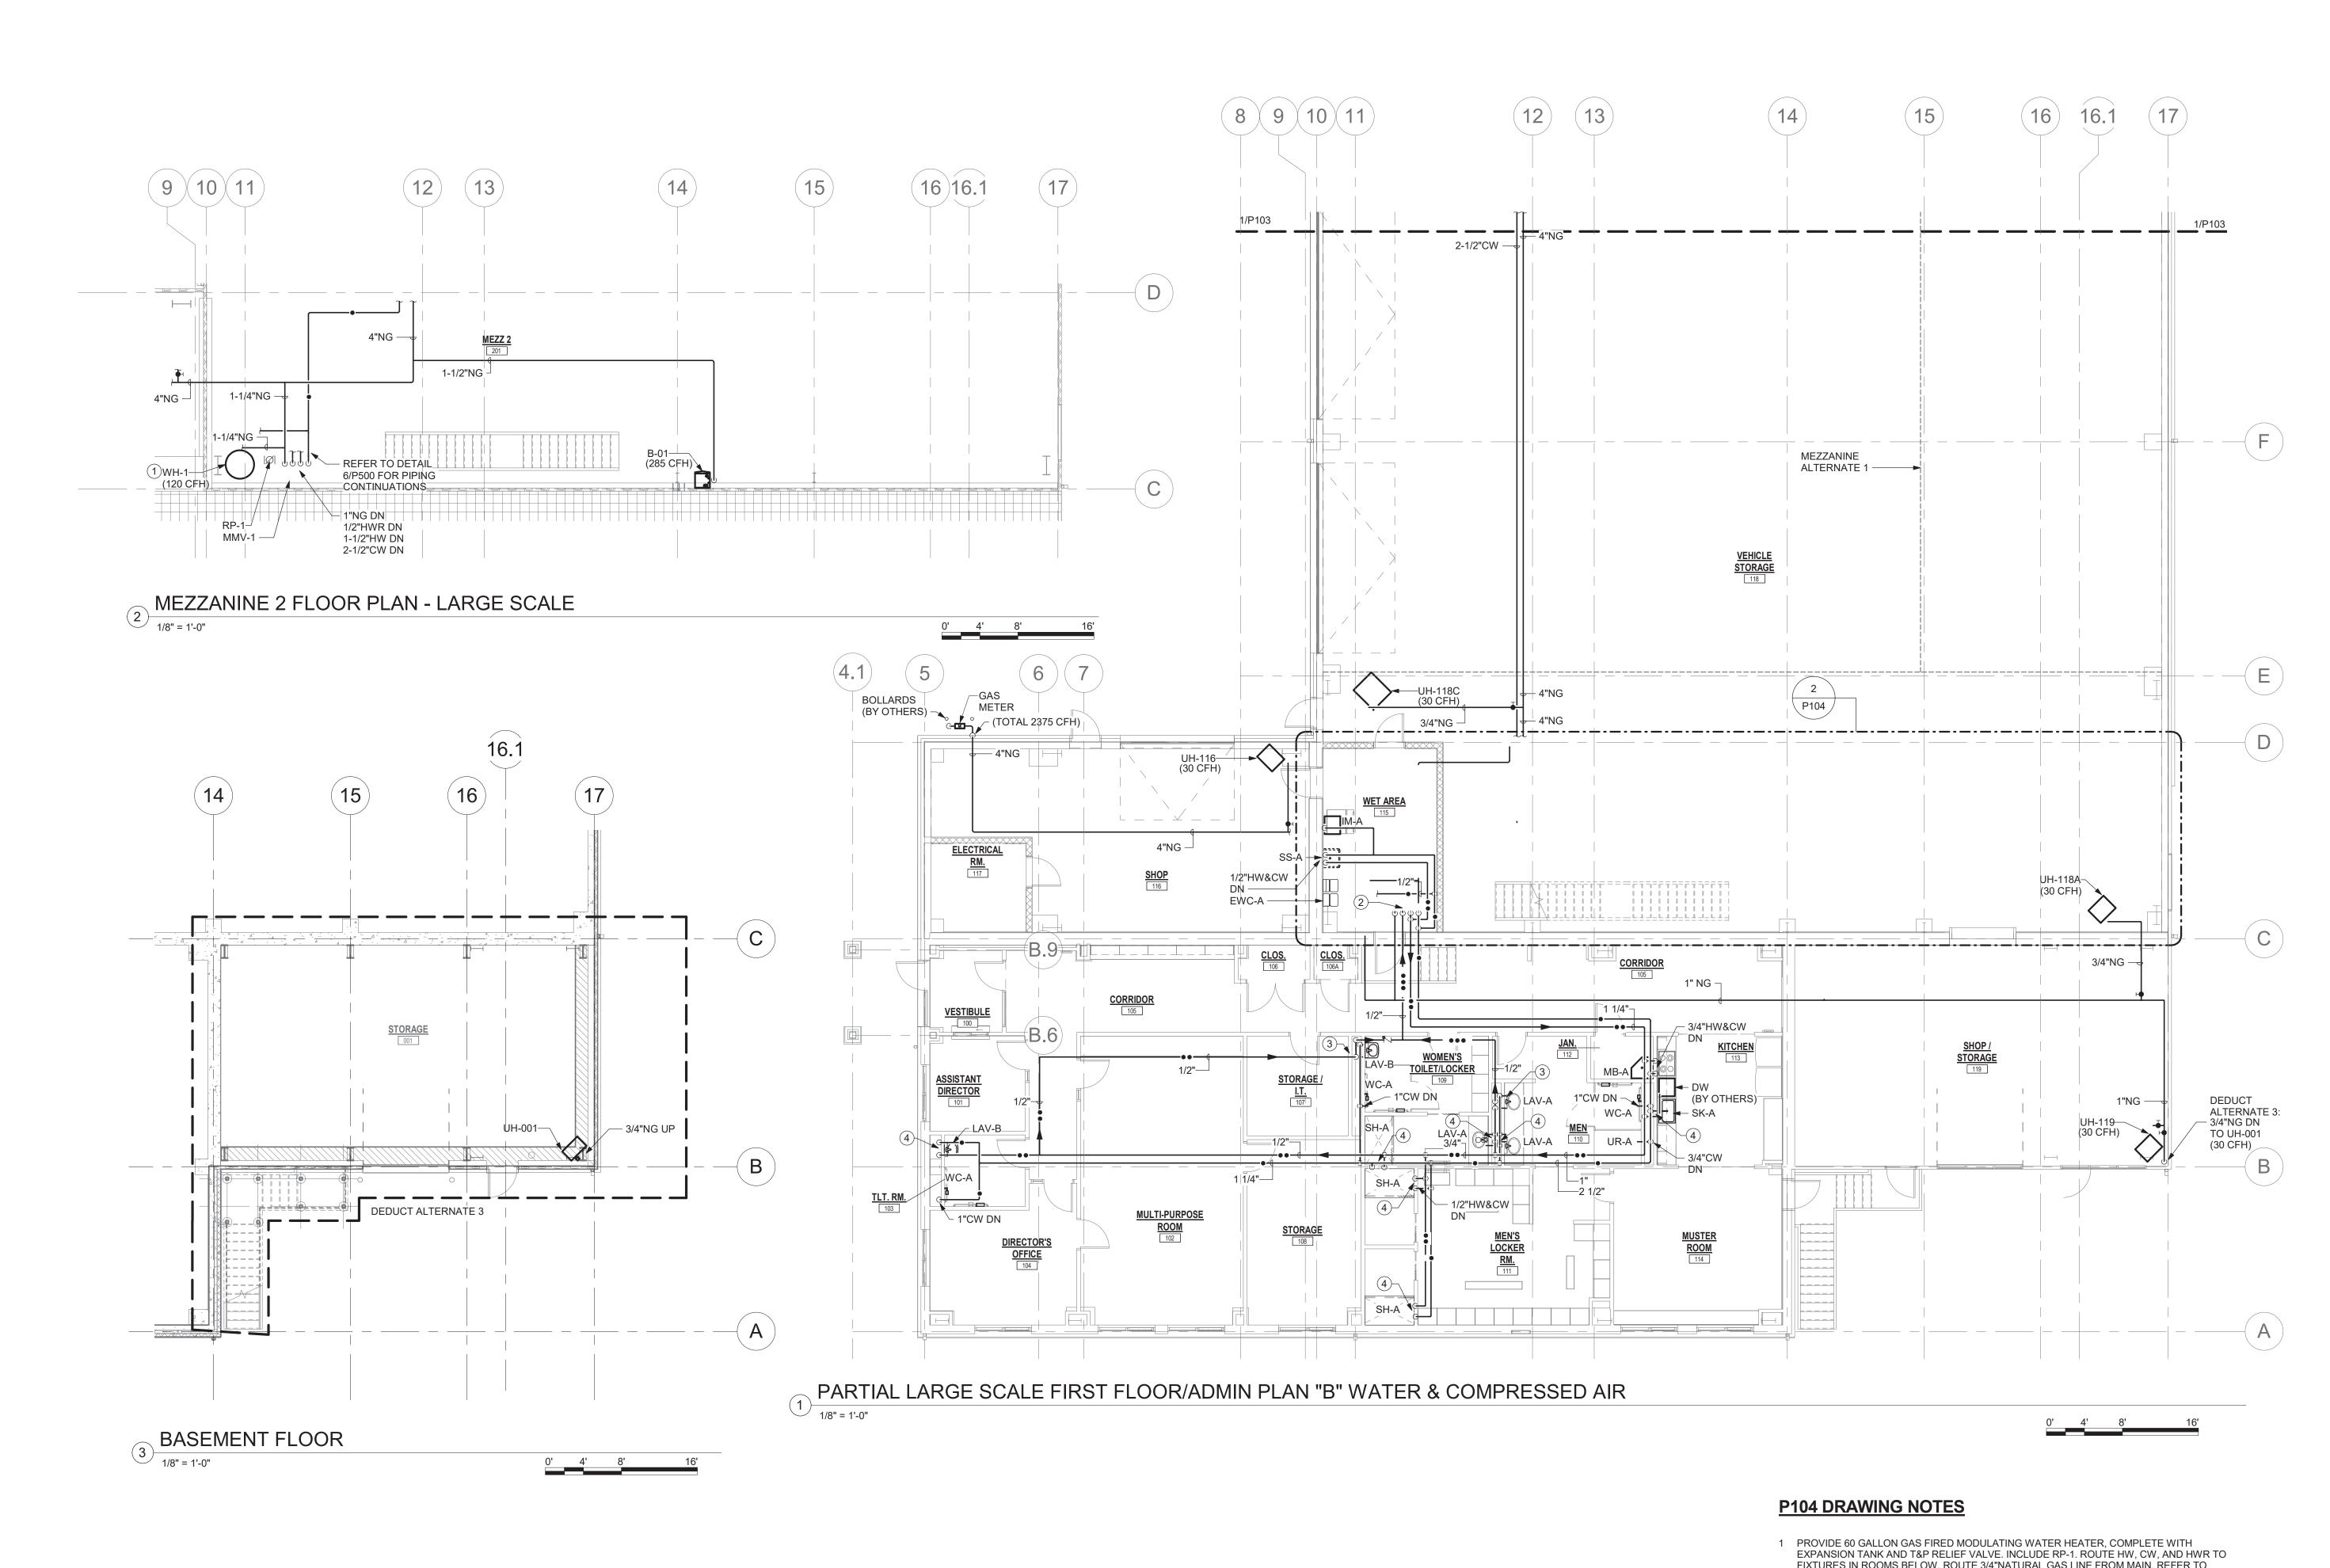
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Drawing Title:

PARTIAL LARGE SCALE PLUMBING FLOOR PLANS -AREA "A" - WATER

AND GAS

Sheet Number:



- FIXTURES IN ROOMS BELOW. ROUTE 3/4"NATURAL GAS LINE FROM MAIN. REFER TO DETAIL 6/P500 FOR CONNECTIONS. REFER TO SPECIFICATIONS.
- 2 1"NG UP; 1/2"HWR UP; 1-1/2"HW UP; 2-1/2"CW UP
- 3 1/2"HW, CW&HWR DN
- 4 1/2"HW&CW DN

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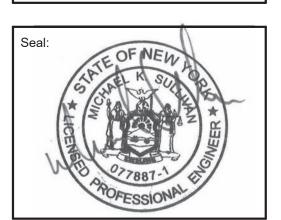
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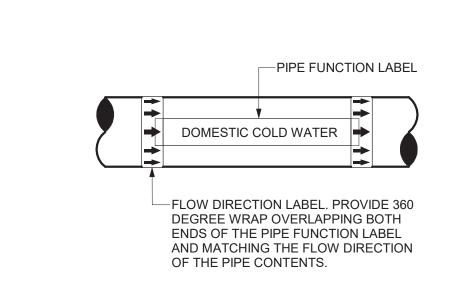
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PARTIAL LARGE SCALE PLUMBING FLOOR PLANS -AREA "B" - WATER & GAS

Sheet Number:

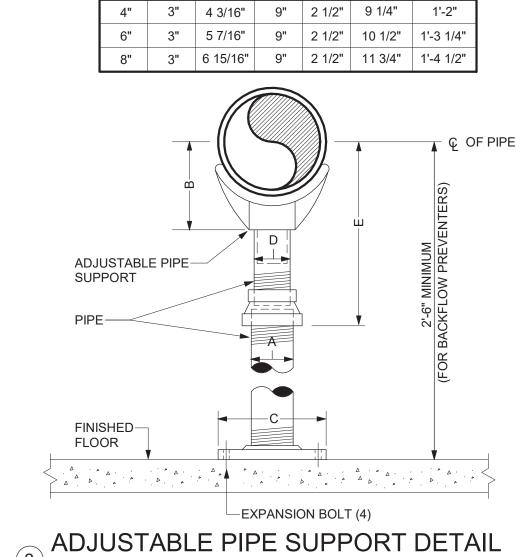


DETAIL NOTES:

- A. PROVIDE A PIPE LABEL FOR EACH PIPE FUNCTION.
- PROVIDE AT LEAST ONE LABEL ON EACH PIPE FOR EVERY ROOM THE PIPE PASSES THROUGH.
- PROVIDE LABELS IN LARGE SPACES ON MAXIMUM 20' CENTERS FOR EVERY PIPE UNLESS OTHERWISE NOTED IN THE SPECIFICATIONS.
- LABELS TO BE LOCATED IN AN EASILY VISIBLE LOCATION AS THEY WOULD NORMALLY BE SEEN. IE. ON THE BOTTOM HALF OF PIPES
- IN THE AIR AND ON THE TOP HALF OR SIDES OF PIPES MOUNTED LOW. E. LABELS SHALL BE, COLOR CODED, PRE-PRINTED, SELF ADHESIVE VINYL.
- F. SEE SPECIFICATION FOR OTHER REQUIREMENTS AND LIST OF PIPE FUNCTIONS.

PIPING IDENTIFICATION LABEL DETAIL


NOT TO SCALE



NOT TO SCALE

DIMENSION E

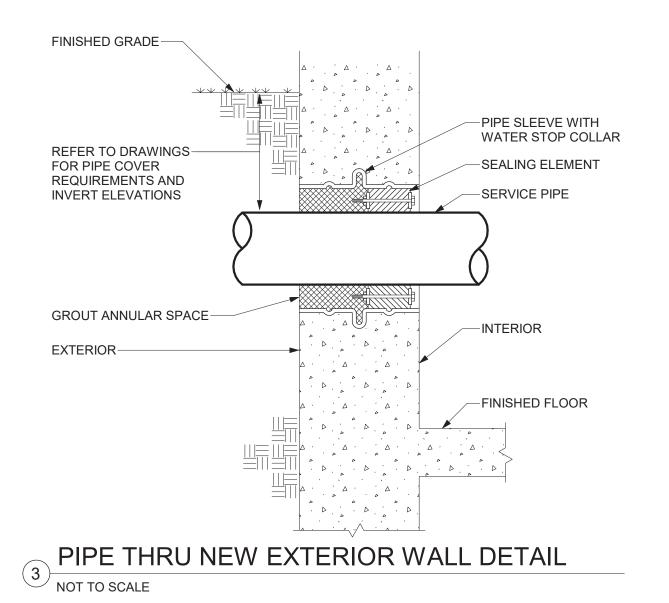B C D MINIMUM MAXIMUM



SILENT CHECK -

♣ BV-3 —

(1.2 GPM)

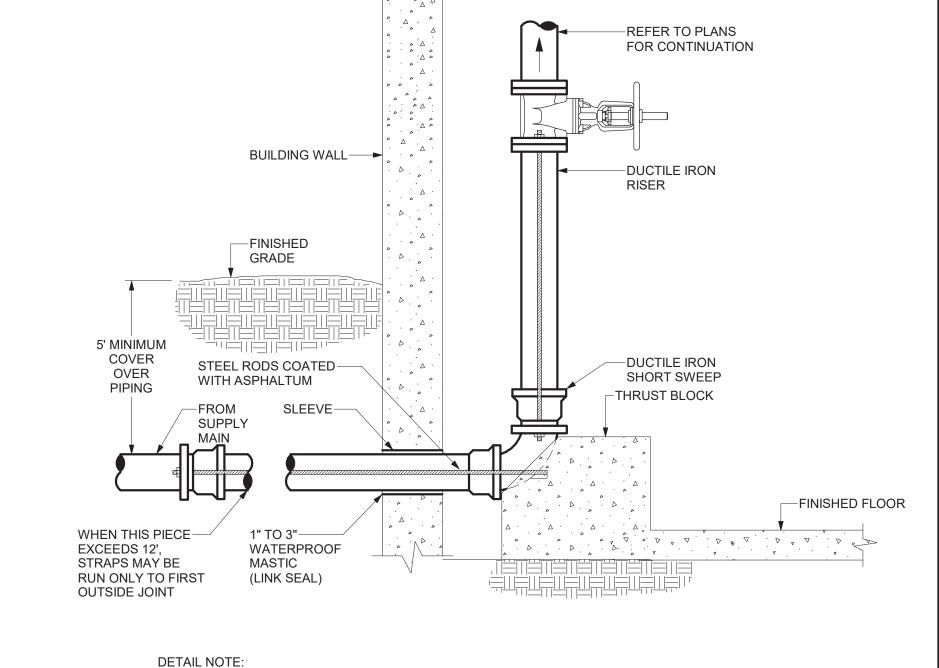
<u></u> 1-1/2"

VALVE

(TYPICAL)

___ BV-1

1-1/2"



A. ROD IN COMPLIANCE WITH AMERICA WATER WORKS ASSOCIATION STANDARDS. WATER SERVICE DETAIL

NOT TO SCALE

EXHAUST AND INTAKE

DIVISION 22/SECTION

FLUE PIPES BY

15B (TYPICAL)

- UNION (TYPICAL)

DIRT LEG (TYPICAL)

TEMPERATURE AND

PRESSURE RELIEF

VALVE (TYPICAL)

3/4" VALVE WITH

(TYPICAL)

EDGES

VACUUM BREAKER

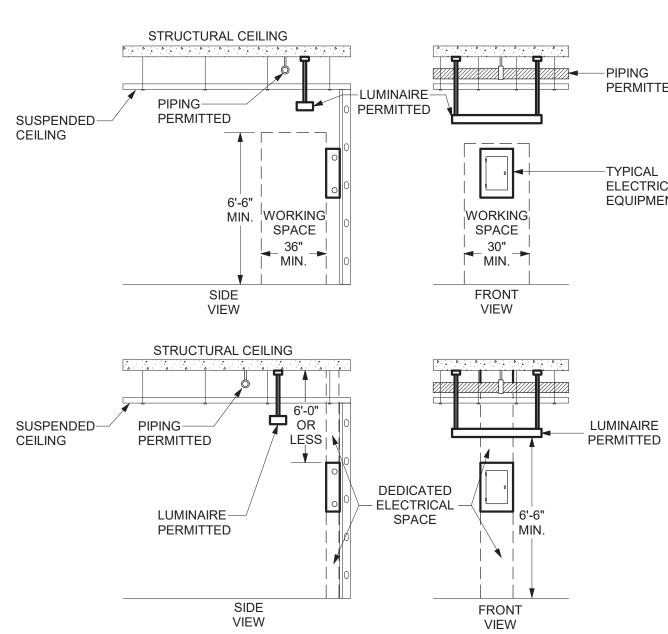
- GAS-FIRED WATER

HEATER (TYPICAL)

∠ 6" HIGH CONCRETE

PAD WITH FINISHED

DUCT-DEDICATED -SPRINKLER ALLOWED ELECTRICAL SPACE 6'-0" WORKING SPACE




DETAIL NOTES:

- A. ELECTRICAL EQUIPMENT INCLUDES PANELS, TRANSFORMERS, DISCONNECTS. STARTERS, MOTOR CONTROL CENTERS, SWITCHGEAR, ADJUSTABLE SPEED DRIVES, AND FUSED SWITCHES (THIS ALSO APPLIES TO ELECTRICAL GEAR MOUNTED DIRECTLY ON MECHANICAL EQUIPMENT).
- B. DEDICATED ELECTRICAL SPACE IS DEFINED BY NEC 110.
- C. NO PIPING OR DUCTWORK MAY BE INSTALLED IN DEDICATED ELECTRICAL SPACE OR WORKING SPACE.

PIPING OVER ELECTRICAL EQUIPMENT DETAIL

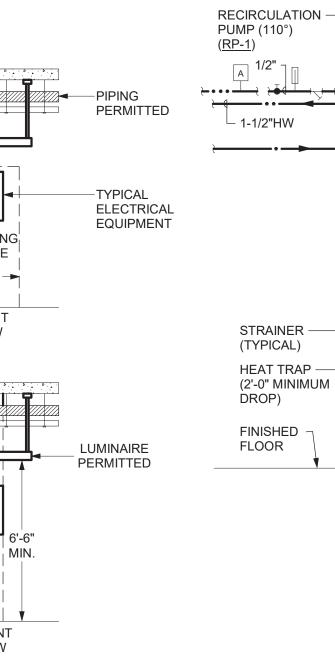NOT TO SCALE



DETAIL NOTES:

EXPANSION -

TANK (ET-1)

BUILDING -MIXING

VALVE

(MMV-1)

PRESSURE GAUGE -

(TYPICAL)

- A. INSTALL PIPING TO ALLOW FOR FUTURE REMOVAL OF WATER HEATERS.
- B. RELIEF VALVE DISCHARGE PIPE SIZE SHALL MATCH VALVE OUTLET SIZE TERMINATE ABOVE FLOOR DRAIN WITH CODE REQUIRED AIR GAP.

CONDENSATE -

NEUTRALIZER

(TYPICAL)

BALANCING VALVE

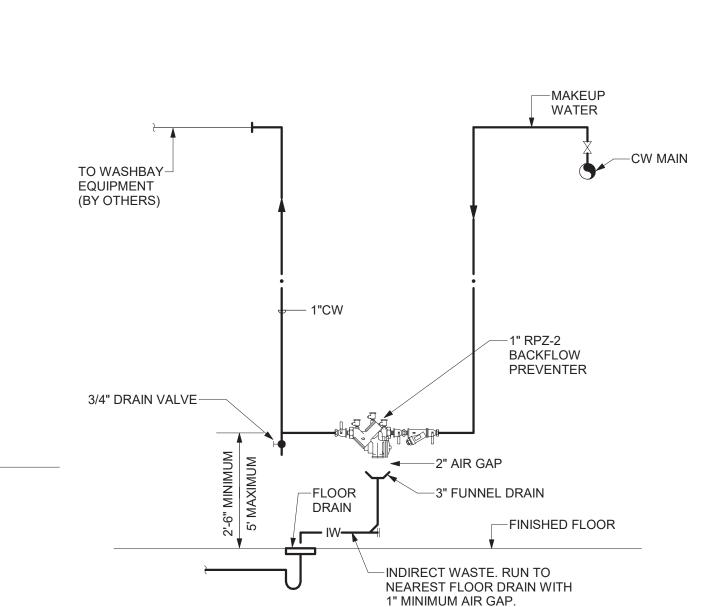
GAS VALVE -

(TYPICAL)

(TYPICAL)

- C. REFER TO EXPANSION TANK DETAIL 1/P501.
- D. PROVIDE AQUASTAT WITH DOMESTIC HOT WATER DISTRIBUTION SYSTEM, AND PROVIDE NECESSARY WIRING TO INTERLOCK WITH HEATER CONTROLS.
- E. PIPING CONFIGURATION BASED ON CONDENSING WATER HEATER.
- PROVIDE WITH CONDENSATE NEUTRALIZER. CONNECT 3/4" CPVC PIPING TO WATER
- HEATER AND NEUTRALIZER. TERMINATE CONDENSATE DRAIN ABOVE FLOOR DRAIN WITH CODE REQUIRED AIR GAP.
- G. WATER HEATER DETAILS SIMILAR FOR WH-2 EXCEPT WITHOUT HWR RECIRCULATION

WATER HEATER COMMERCIAL GAS TANK CONDENSING TYPE DETAIL $\overset{\smile}{\smile}$ NOT TO SCALE



DETAIL NOTES:

- A. BACKFLOW PREVENTER SHALL BE LOCATED UPSTREAM OF ALL CONNECTIONS TO HVAC EQUIPMENT.
- B. PROVIDE PROPER SUPPORTS FOR BACKFLOW PREVENTER AND
- PIPING. C. PROVIDE 8" CLEARANCE BEHIND BACKFLOW PREVENTER, 1'

ABOVE AND 2'-6" CLEARANCE IN FRONT OF DEVICE.

- D. THE INSTALLATION OF A FIXED AIR GAP FITTING IS NOT ACCEPTABLE
- FOR USE ON DRAIN LINE. PROVIDE FUNNEL DRAIN AS INDICATED.
- E. PAINT SUPPORTS WITH ONE (1) PRIMER AND TWO (2) FINISH COATS

OF COLOR AS SPECIFIED. 7 MAKE-UP WATER BACKFLOW PREVENTER DETAIL NOT TO SCALE VILLAGE OF ARDSLEY, NY **NEW PUBLIC WORKS FACILITY** 220 HEATHERDELL ROAD, VILLAGE OF ARDSLEY,


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Revisions: Rev Date Description Issued For: BID PROJECT TRUE SCALE: AS NOTED APRIL 7, 2022

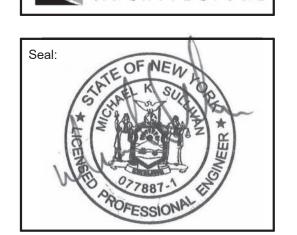Drawing Title:

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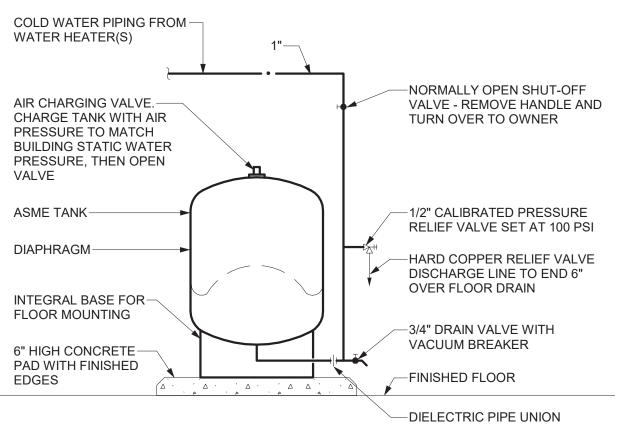
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Reviewed By:

DETAILS


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THERMAL EXPANSION TANK DETAIL


1 NOT TO SCALE



DETAIL NOTES:

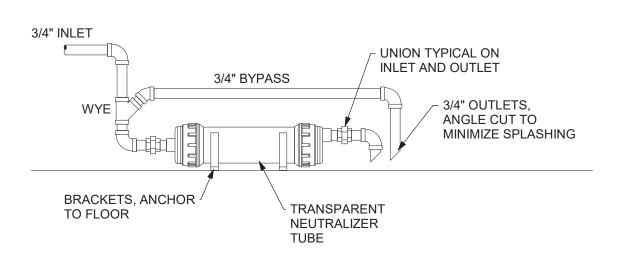- A. NEUTRALIZER AND PIPING SHALL NOT OBSTRUCT ANY SERVICE SPACES OR ACCESS DOORS ON EQUIPMENT
- B. PIPING SIZE SHALL BE 3/4" MINIMUM, DO NOT USE 1/2" VINYL TUBE
- MOUNT NEUTRALIZER LEVEL, AND HORIZONTAL, WITH OUTLET HIGHER THAN INLET. VERTICAL MOUNTING SHALL NOT BE ACCEPTED DUE TO POSSIBLE BLOCKAGE OF INLET BY NEUTRALIZING MEDIA.
- D. ALL PIPING SHALL BE LOWER THAN APPLIANCE CONDENSATE OUTLETS
- E. TOTAL CONNECTED EQUIPMENT SHALL BE 300,000 BTUH OR LESS
- F. DESIGN BASIS: AXIOM NC-1


CONDENSATE NEUTRALIZER DETAIL

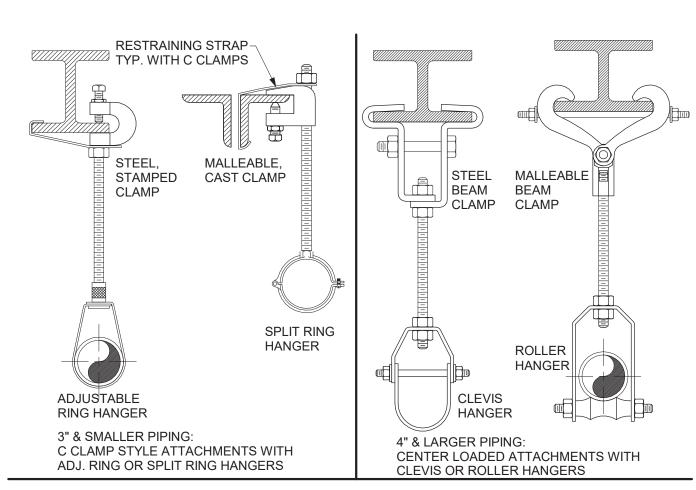


SUPPORT	SCHEDULE				
	PIPE MA	ATERIAL &	SUPPORT	SPACING	
PIPE SIZE	STEEL	COPPER	PLASTIC	CAST IRON	ROD SIZE
3/4" TO 1"	8 FT.	6 FT.	3 FT.	EACH	3/8 IN.
1 1/4" TO 2"	10 FT.	6 FT.	3 FT.	HORIZONTAL	3/8 IN.
2 1/2" TO 4"	12 FT.	10 FT.	4 FT.	JT., 5 FT. MAXIMUM	1/2 IN.
5" TO 6"	12 FT.	10 FT.	4 FT.	SPACING	5/8 IN.
8"	12 FT.	10 FT.	4 FT.		3/4 IN.
OVER 8"	TO SUIT L	OADING CO	ONDITIONS		

DETAIL NOTES:

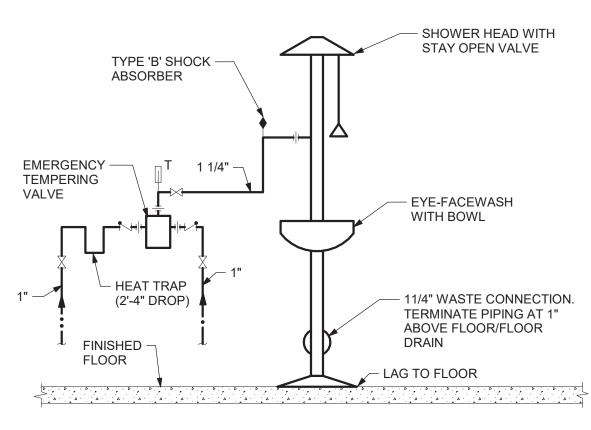- HORIZONTAL PIPING
- SUPPORT WITHIN 18 INCHES OF EACH COUPLING JOINT FOR 10 FT. PIPE LENGTHS
- SUPPORT AT 5 FT. INTERVALS FOR 5 FT. PIPE LENGTHS 4 INCH AND LARGER PIPE - BRACE AT CHANGES IN DIRECTION TO PREVENT
- HORIZONTAL MOVEMENT INSTALLATIONS REQUIRING MULTIPLE JOINTS WITHIN A FOUR FOOT DEVELOPED LENGTH SHALL BE SUPPORTED AT EVERY OTHER OR ALTERNATING COUPLINGS. **FINISHES**
- TYPICAL ELECTROPLATED ZINC OR CADMIUM FINISH
- COPPER PIPING, UNINSULATED COPPER PLATED OR PVC COATED EXTERIOR & WET LOCATIONS, HOT DIPPED GALVANIZED HARDWARE & HANGERS
- 8 PIPE HANGER AND SPACING DETAILS STEEL STRUCTURE
 NOT TO SCALE




EMERGENCY SHOWER/EYEWASH DETAIL

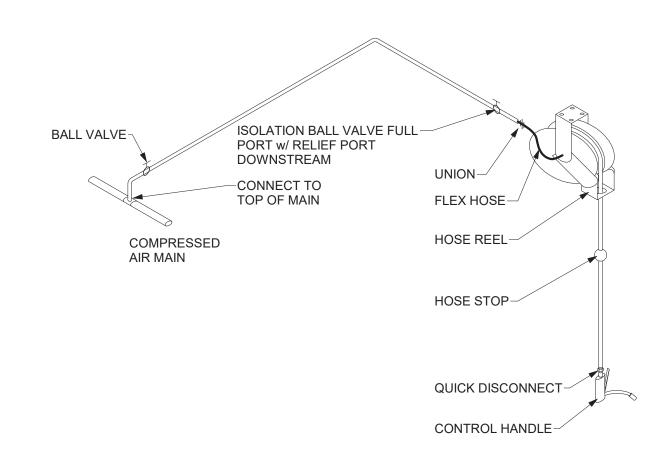

GENERAL NOTES:

- ADJUST HOSE STOPS AND REEL TENSION. CONTROL HANDLE TO HANG AT 4'-6" AFF UNLESS OTHERWISE REQUESTED BY OWNER.
- QUICK DISCONNECT TO MATCH OWNER'S MODEL FOR RENOVATIONS
- COLOR CODE EXPOSED PIPING IN SERVICE BAYS. PAINT 12" BAND ON PIPING ON 20 FOOT CENTERS WITH UNIQUE COLOR FOR EACH PIPE CONTENTS. PROVIDE CHART WITH KEY TO COLORS TO OWNER.

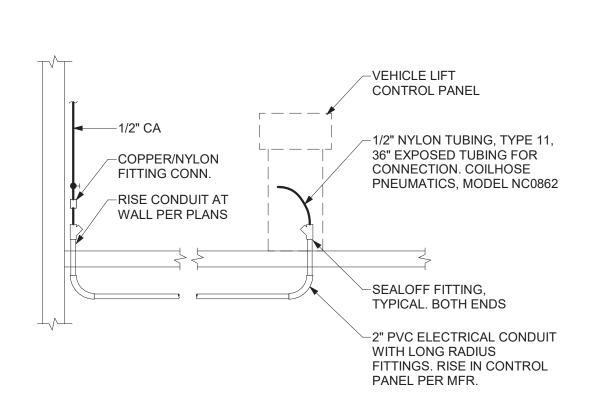
COMPRESSED AIR - HOSE REEL DETAIL



DRAWING NOTES:

- A. PROVIDE ONE DEDICATED CONDUIT PER VEHICLE LIFT CONTROL PANEL
- B. PROVIDE 1/2" COMPRESSED AIR CONNECTION TO CONDUIT RISER AT WALL
- C. PROVIDE PERMANENT LABEL AT VALVE "VEHICLE LIFT COMPRESSED AIR"
- STUB UP ABOVE FINISHED FLOOR PER LIFT MFR. COORDINATE CONDUIT ROUTE AND RISE LOCATIONS AT LIFT CONTROL CABINET WITH E.C. PROVIDE SEALOFF AT BOTH ENDS OF CONDUIT PER LIFT MANUFACTURER. PROVIDE 1/2", NYLON, TYPE 11, TUBING IN CONDUIT WITH 36" MIN. EXPOSED TUBING AT BOTH ENDS.
- VEHICLE LIFT COMPRESSED AIR DETAIL

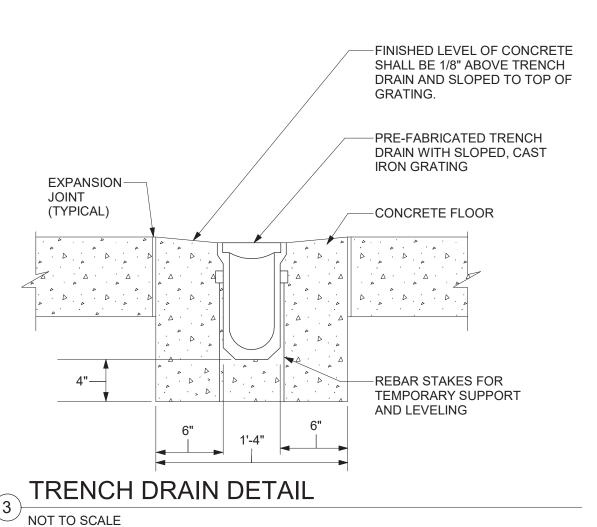NOT TO SCALE




- BUILDING STRUCTURE PIPE SIZE -PER PLANS $_{\sqcap}$ GAS FIRED EQUIPMENT; WTR. HTR., FURNACE, **BOILER OR GENERATOR** GAS SHUT-OFF VALVE, LOCKABLE UNION FINISHED **FLOOR** DIRT LEG. **FULL SIZE** WITH CAP

DETAIL NOTES:

- A. PROVIDE SHUT-OFF VALVE, DIRT LEG AND UNION AT EACH GAS CONNECTION ON EACH PIECE OF EQUIPMENT.
- B. VERIFY CONNECTION SIZES, QUANTITIES AND LOCATIONS WITH M.C.
- PROVIDE PIPE NIPPLE THROUGH EQUIPMENT CASE. CSST & FLEX LINES SHALL NOT PENETRATE CASING PER CODE.

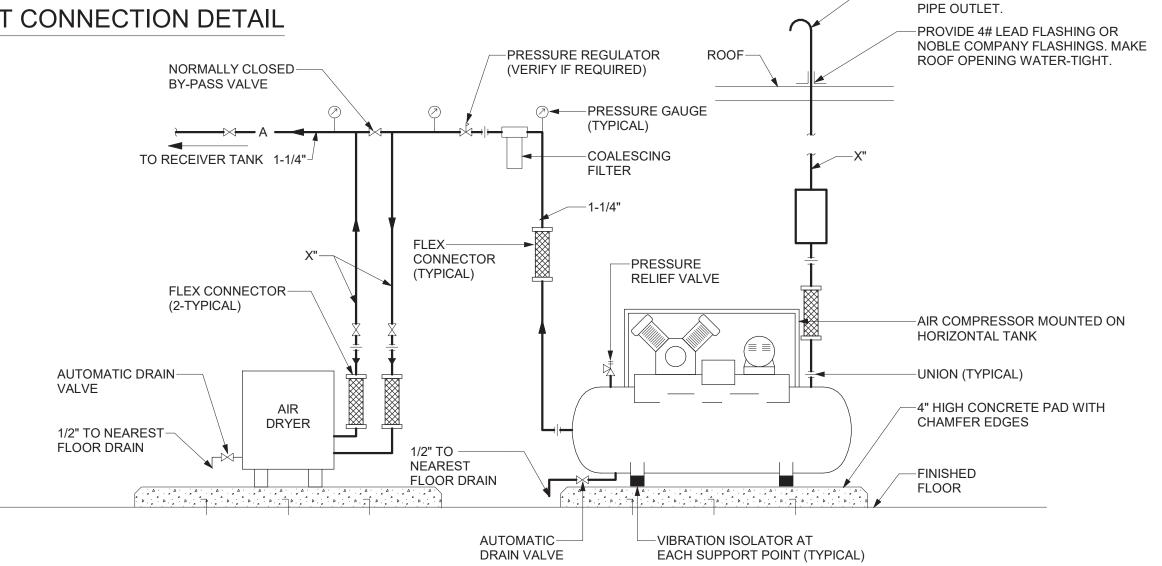GAS EQUIPMENT CONNECTION DETAIL



DETAIL NOTES:

- PIPE SIZES AND COMPRESSOR LOCATION AS INDICATED ON DRAWINGS.
- COORDINATE EQUIPMENT ELECTRICAL CONNECTION REQUIREMENTS WITH SECTION 16/DIVISION 26.
- ALL DRAIN PIPING SHALL TERMINATE AT 1" ABOVE NEAREST FLOOR DRAIN.
- PAINT EXPOSED PIPING ABOVE ROOF WITH ONE(1) PRIMER AND TWO(2) FINISH COATS AS SPECIFIED.

AIR COMPRESSOR DETAIL

VILLAGE OF ARDSLEY, NY **NEW PUBLIC WORKS FACILITY** 220 HEATHERDELL ROAD, VILLAGE OF ARDSLEY,

EXHAUST

∼ GAS VALVE

─ UNION

- FLEX CONNECTION

- 3/4" CONDENSATE DRAIN

EXTEND TO FLOOR DRAIN

WITH NEUTRALIZER,

UNIT HEATER GAS PIPING DETAIL - CONDENSING TYPE

- DIRT LEG, LINE SIZE x 6" LONG

CONDENSATE

NEUTRALIZER

➤ 3/4", EXTEND TO

FLOOR DRAIN

-INSTALL AIR INTAKE AT 3' ABOVE

STAINLESS STEEL BIRDSCREEN ON

ROOF WITH GOOSENECK AND

AIR INTAKE

SEE MFRS. REQUIREMENTS

FOR TRAP DEPTHS AND

PIPING ARRANGEMENTS

SIDE VIEW - PIPING SCHEMATIC

UNIT HEATER EXHAUST & INTAKE BY OTHERS

DETAIL NOTES:

NOT TO SCALE

A. DESIGN BASIS: REZNOR MODEL UEAS

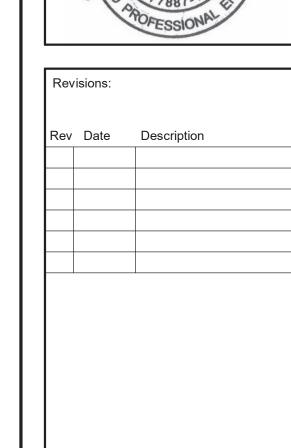
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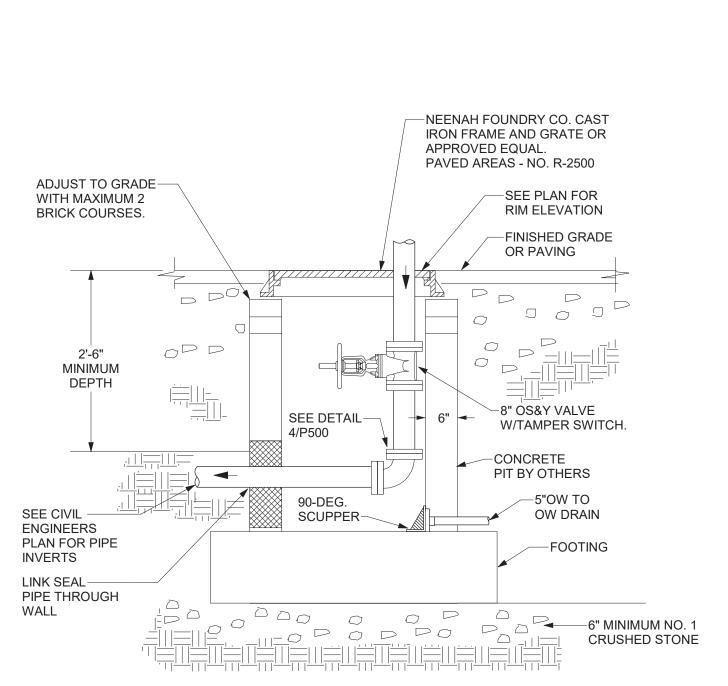
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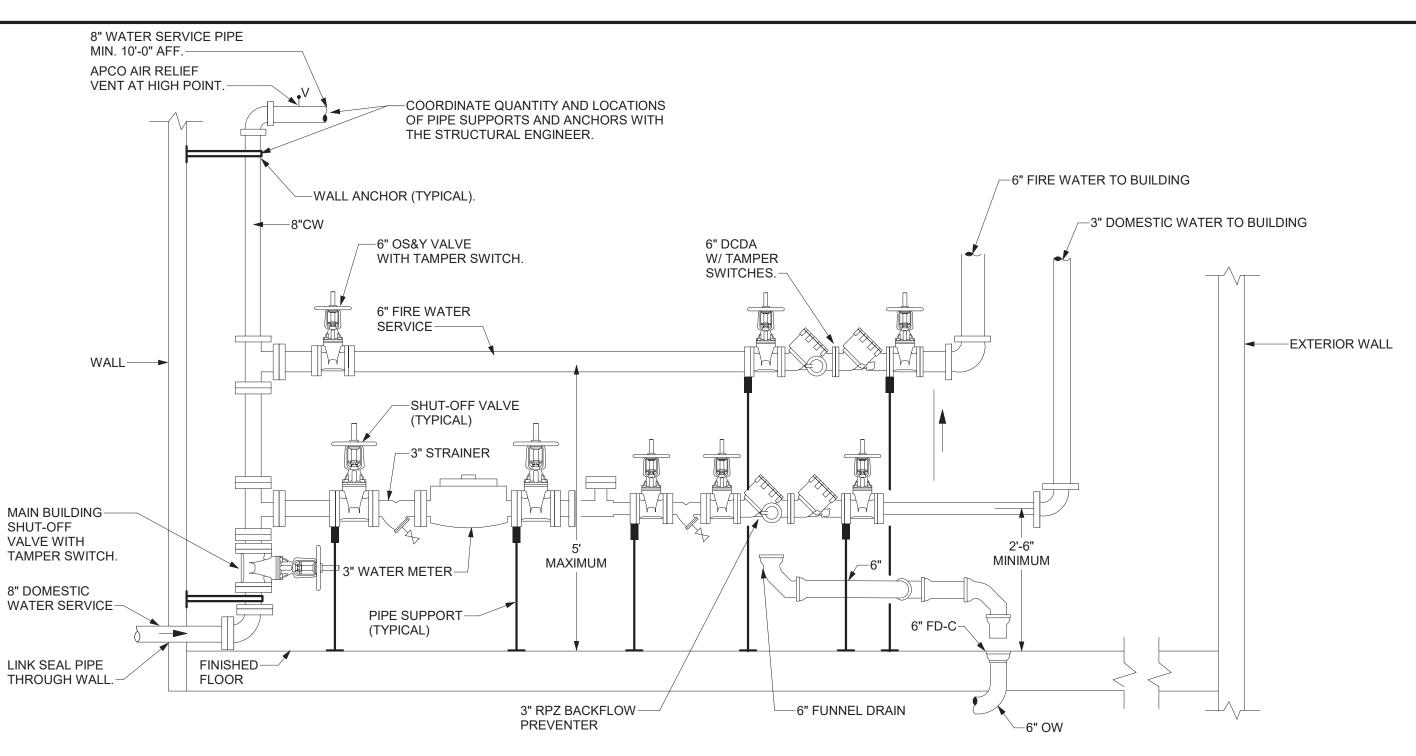
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DETAIL NOTES:

- A. COAT INTERIOR WITH TWO (2) APPLICATIONS OF SIKA GUARD 664/9 HI-BILD EPOXY COATING OR APPROVED EQUAL.
- B. COAT EXTERIOR WITH TWO (2) APPLICATIONS OF KOPPER SUPER SERVICE BLACK, BITUMASTIC COATING OR APPROVED EQUAL.
- C. SCUPPER DRAIN SHALL BE JOSAM 24700 90-DEGREE SCUPPER DRAIN OR



DETAIL NOTES:

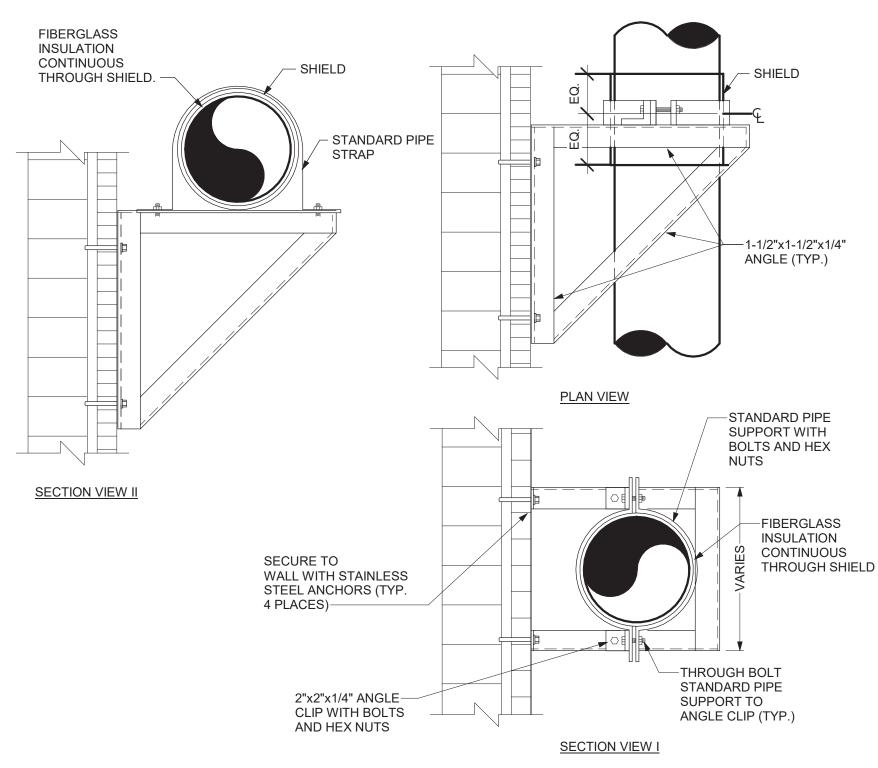
- A. PROVIDE PROPER SUPPORTS FOR BACKFLOW PREVENTERS, WATER METER AND PIPING.
- PROVIDE 8" CLEARANCE BEHIND BACKFLOW PREVENTERS, 1'-0" ABOVE AND 2'-6" CLEARANCE IN FRONT OF DEVICES.
- C. THE INSTALLATION OF FIXED AIR GAP FITTINGS ARE NOT ACCEPTABLE FOR USE ON
- DRAIN LINES. PROVIDE FUNNEL DRAINS AS INDICATED.
- D. PAINT SUPPORTS WITH ONE (1) PRIMER AND TWO (2) FINISH COATS OF COLOR AS SPECIFIED.
- PROVIDE FIXED PLATFORM SHOULD THE UPPER BACKFLOW PREVENTER BE INSTALLED HIGHER THAN 5'-0" ABOVE FINISHED FLOOR. HEIGHT OF UPPER BACKFLOW PREVENTER FROM TOP OF PLATFORM SHALL NOT EXCEED 5'-0".
- HEAT AND LIGHT ARE PROVIDED IN THE AREA OF THE BACKFLOW PREVENTERS.
- PROVIDE SPOOL PIECES AT INLET AND OUTLET OF METER AS RECOMMENDED BY

FINISHED-

METER MANUFACTURER.

COMBINED WATER SERVICE ENTRANCE DETAIL

NOT TO SCALE




DETAIL NOTES: A. ALL FASTENERS AND APPURTENANCES TO BE 316 STAINLESS STEEL.

- B. PAINT ANGLE IRON WITH TWO COATS OF RUST INHIBITIVE PRIMER AND ONE FINISH COAT.
- C. COORDINATE QUANTITY AND LOCATION OF PIPE SUPPORTS WITH THE STRUCTURAL ENGINEER.

VERTICAL AND HORIZONTAL PIPESUPPORT DETAIL - WALL-MOUNTED

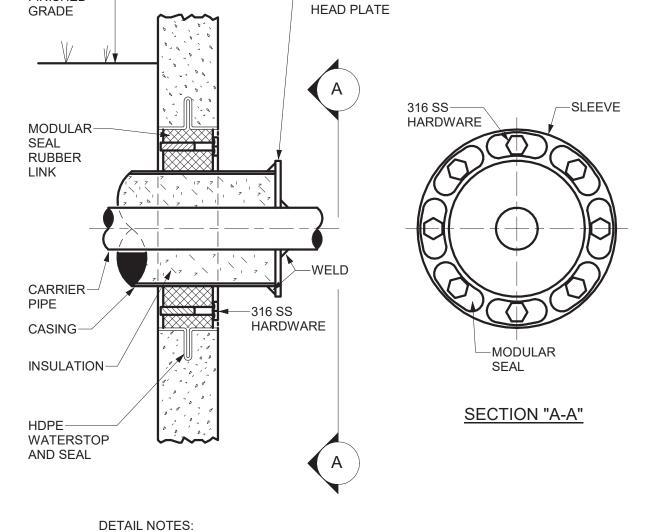NOT TO SCALE



___1/4" THICK

A. COORDINATE SLEEVE LOCATION AT TIME OF CONCRETE POUR.

BELOW GRADE WALL PENETRATION DETAIL - NEW CONSTRUCTION NOT TO SCALE

VILLAGE OF ARDSLEY, NY **NEW PUBLIC WORKS FACILITY** 220 HEATHERDELL ROAD, VILLAGE OF ARDSLEY, NEW YORK 10502

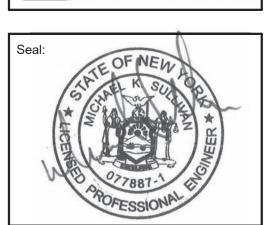
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