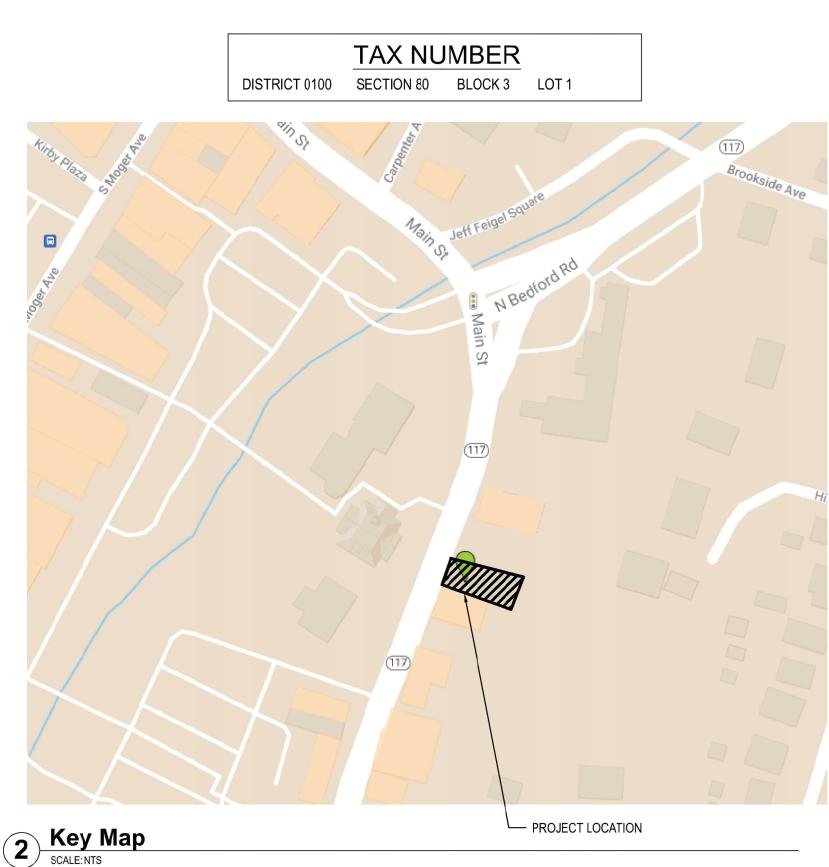


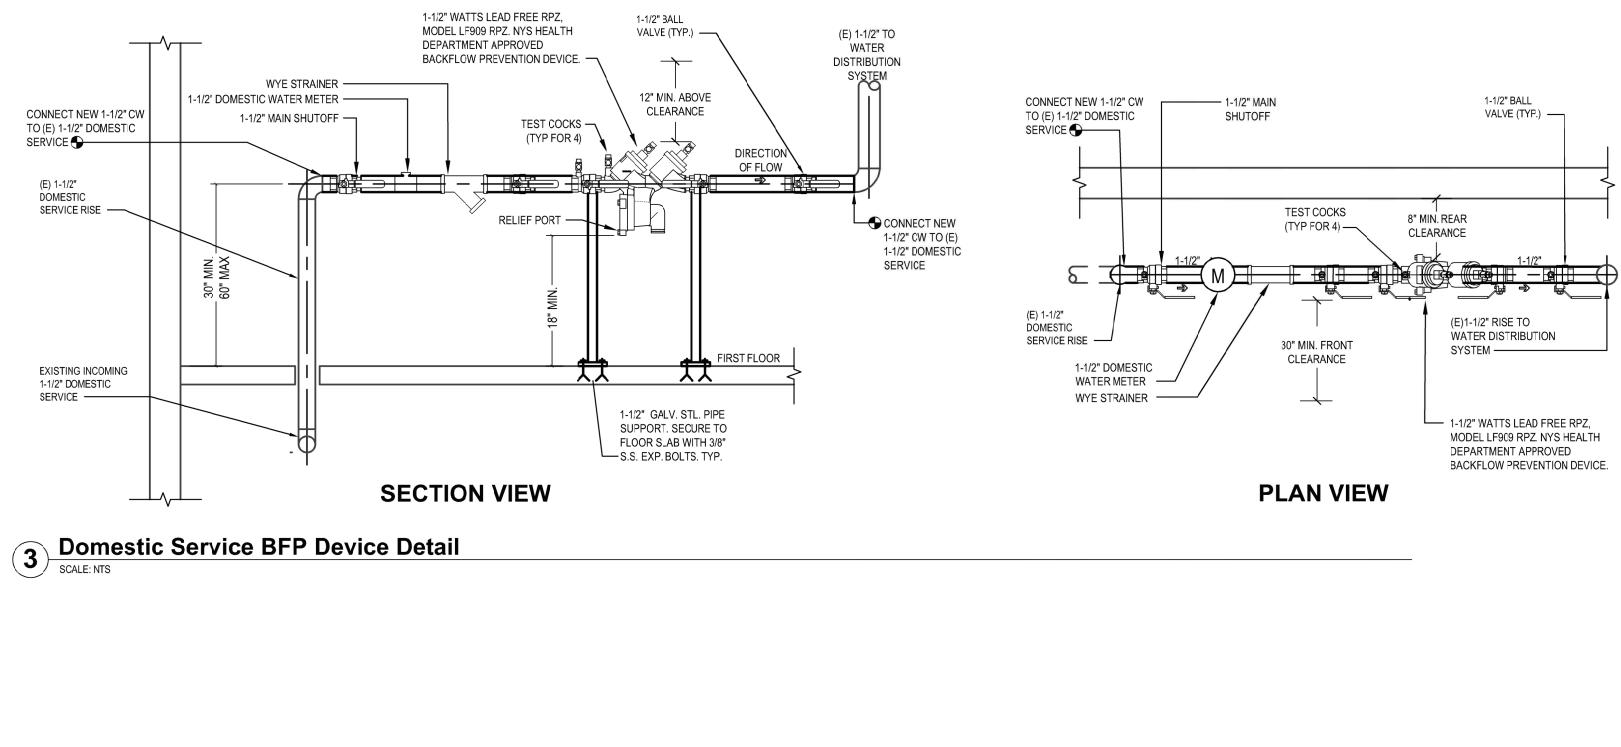
DOMESTIC WATER SERVICE BACKFLOW PREVENTION DEVICE GENERAL NOTES:

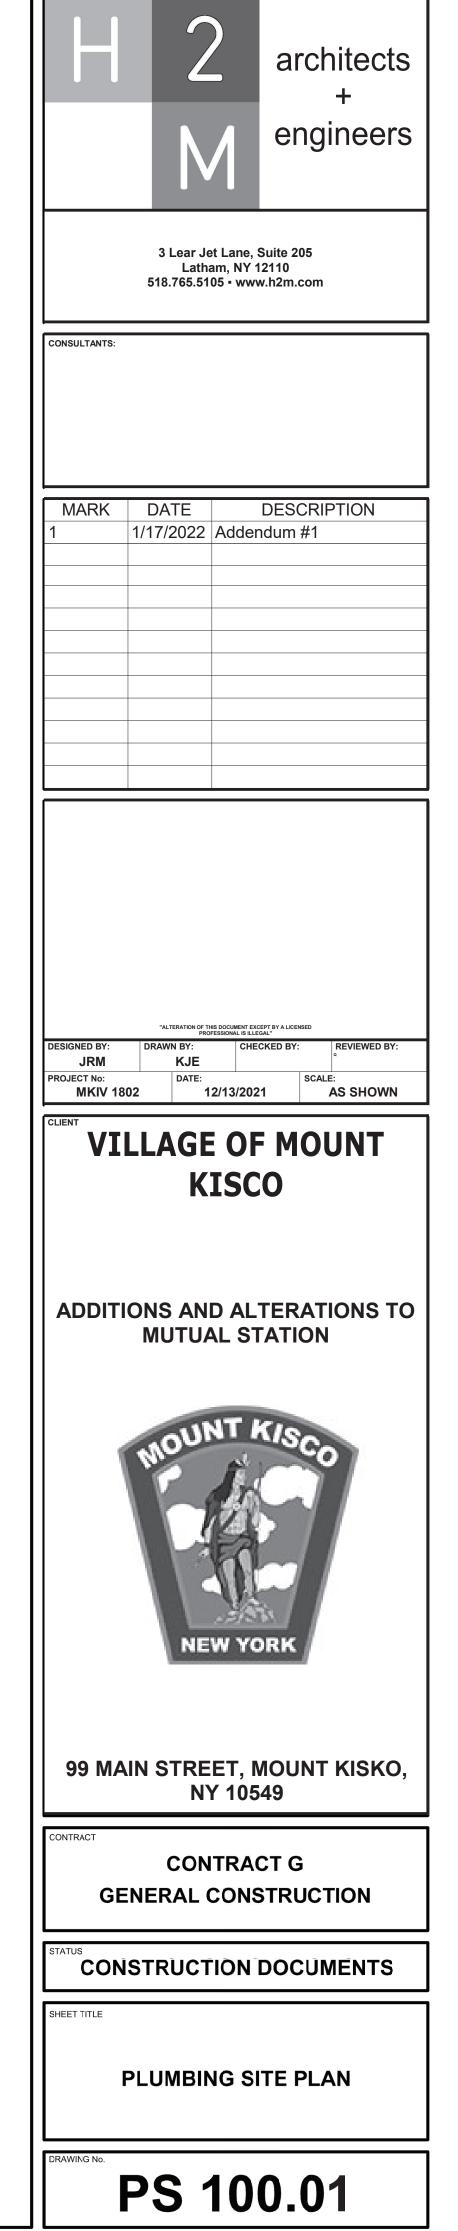
- 1. INSTALLATION SHALL BE IN ACCORDANCE WITH ALL APPLICABLE COUNTY DEPARTMENT OF HEALTH SERVICES, NEW YORK STATE HEALTH DEPARTMENT REGULATIONS, AND VILLAGE OF MT. KISCO WATER DEPARTMENT REGULATIONS.
- 2. ALL CONNECTIONS ON THE WATER SERVICE SHALL BE DOWNSTREAM FROM THE BACKFLOW PREVENTION DEVICE. BYPASSING OF A BACKFLOW PREVENTION DEVICE IS A VIOLATION OF NEW YORK STATE HEALTH DEPARTMENT RULES AND REGULATIONS.
- 3. THE CONTRACTOR SHALL ENGAGE A CERTIFIED BACKFLOW PREVENTION DEVICE TESTER TO TEST THE BACKFLOW PREVENTION DEVICE AFTER INSTALLATION. IT IS THE OWNER'S RESPONSIBILITY TO HAVE EACH DEVICE CERTIFIED AT LEAST ANNUALLY WITH RESULTS REPORTED TO MT. KISCO AND TO THE COUNTY DEPARTMENT OF HEALTH ON NY STATE FORM GEN 215. CONTRACTOR SHALL BE RESPONSIBLE FOR ALL RELATED TESTING AND APPLICATION FEES.
- 4. SHUT-OFF VALVES ON DOMESTIC WATER SERVICE BFP DEVICE SHALL BE BALL VALVES AND SHALL BE SAME MANUFACTURER AS BFP DEVICE.
- 5. TEST COCKS ON THE BFP DEVICE SHALL BE POSITIONED TO FACILITATE TESTING WITH 30" MINIMUM CLEARANCE.
- 6. BACKFLOW DEVICES MAY NOT BE MODIFIED IN ANY WAY DURING INSTALLATION
- 7. PIPING SHALL BE UN-BRANCHED AND UNRESTRICTED FROM THE SUPPLY MAIN TO THE DEVICE, EXCEPT FOR THE METER ON THE DOMESTIC SERVICE.
- 8. CONTRACTOR SHALL PROVIDE APPROPRIATE FLOOR/WALL SUPPORTS FOR ALL DEVICES AND PIPING. ALL SUPPORTS/HANGERS/CLAMPS SHALL BE GALVANIZED STEEL.
- 9. BACKFLOW DEVICES SHALL BE APPROVED BY THE UNIVERSITY OF SOUTHERN CALIFORNIA FOUNDATION FOR CROSS CONNECTION CONTROL AND HYDRAULIC RESEARCH.
- 10. THE ROOM WHERE THE DEVICES ARE LOCATED SHALL BE HEATED AND SHALL HAVE LIGHTING.
- 11. WHERE THE DISTANCE BETWEEN THE WATER METER AND DEVICE IS GREATER THAN 10'-0", ALL EXPOSED PIPING MUST BE LABELED EVERY 5'-0" DISPLAYING THE WORDS "FEED TO BACKFLOW PREVENTER, DO NOT TAP."
- 12. DEVICE MAY NOT BE INSTALLED HIGHER THAN 5'-0" ABOVE THE FLOOR OR A FIXED PLATFORM IS REQUIRED.

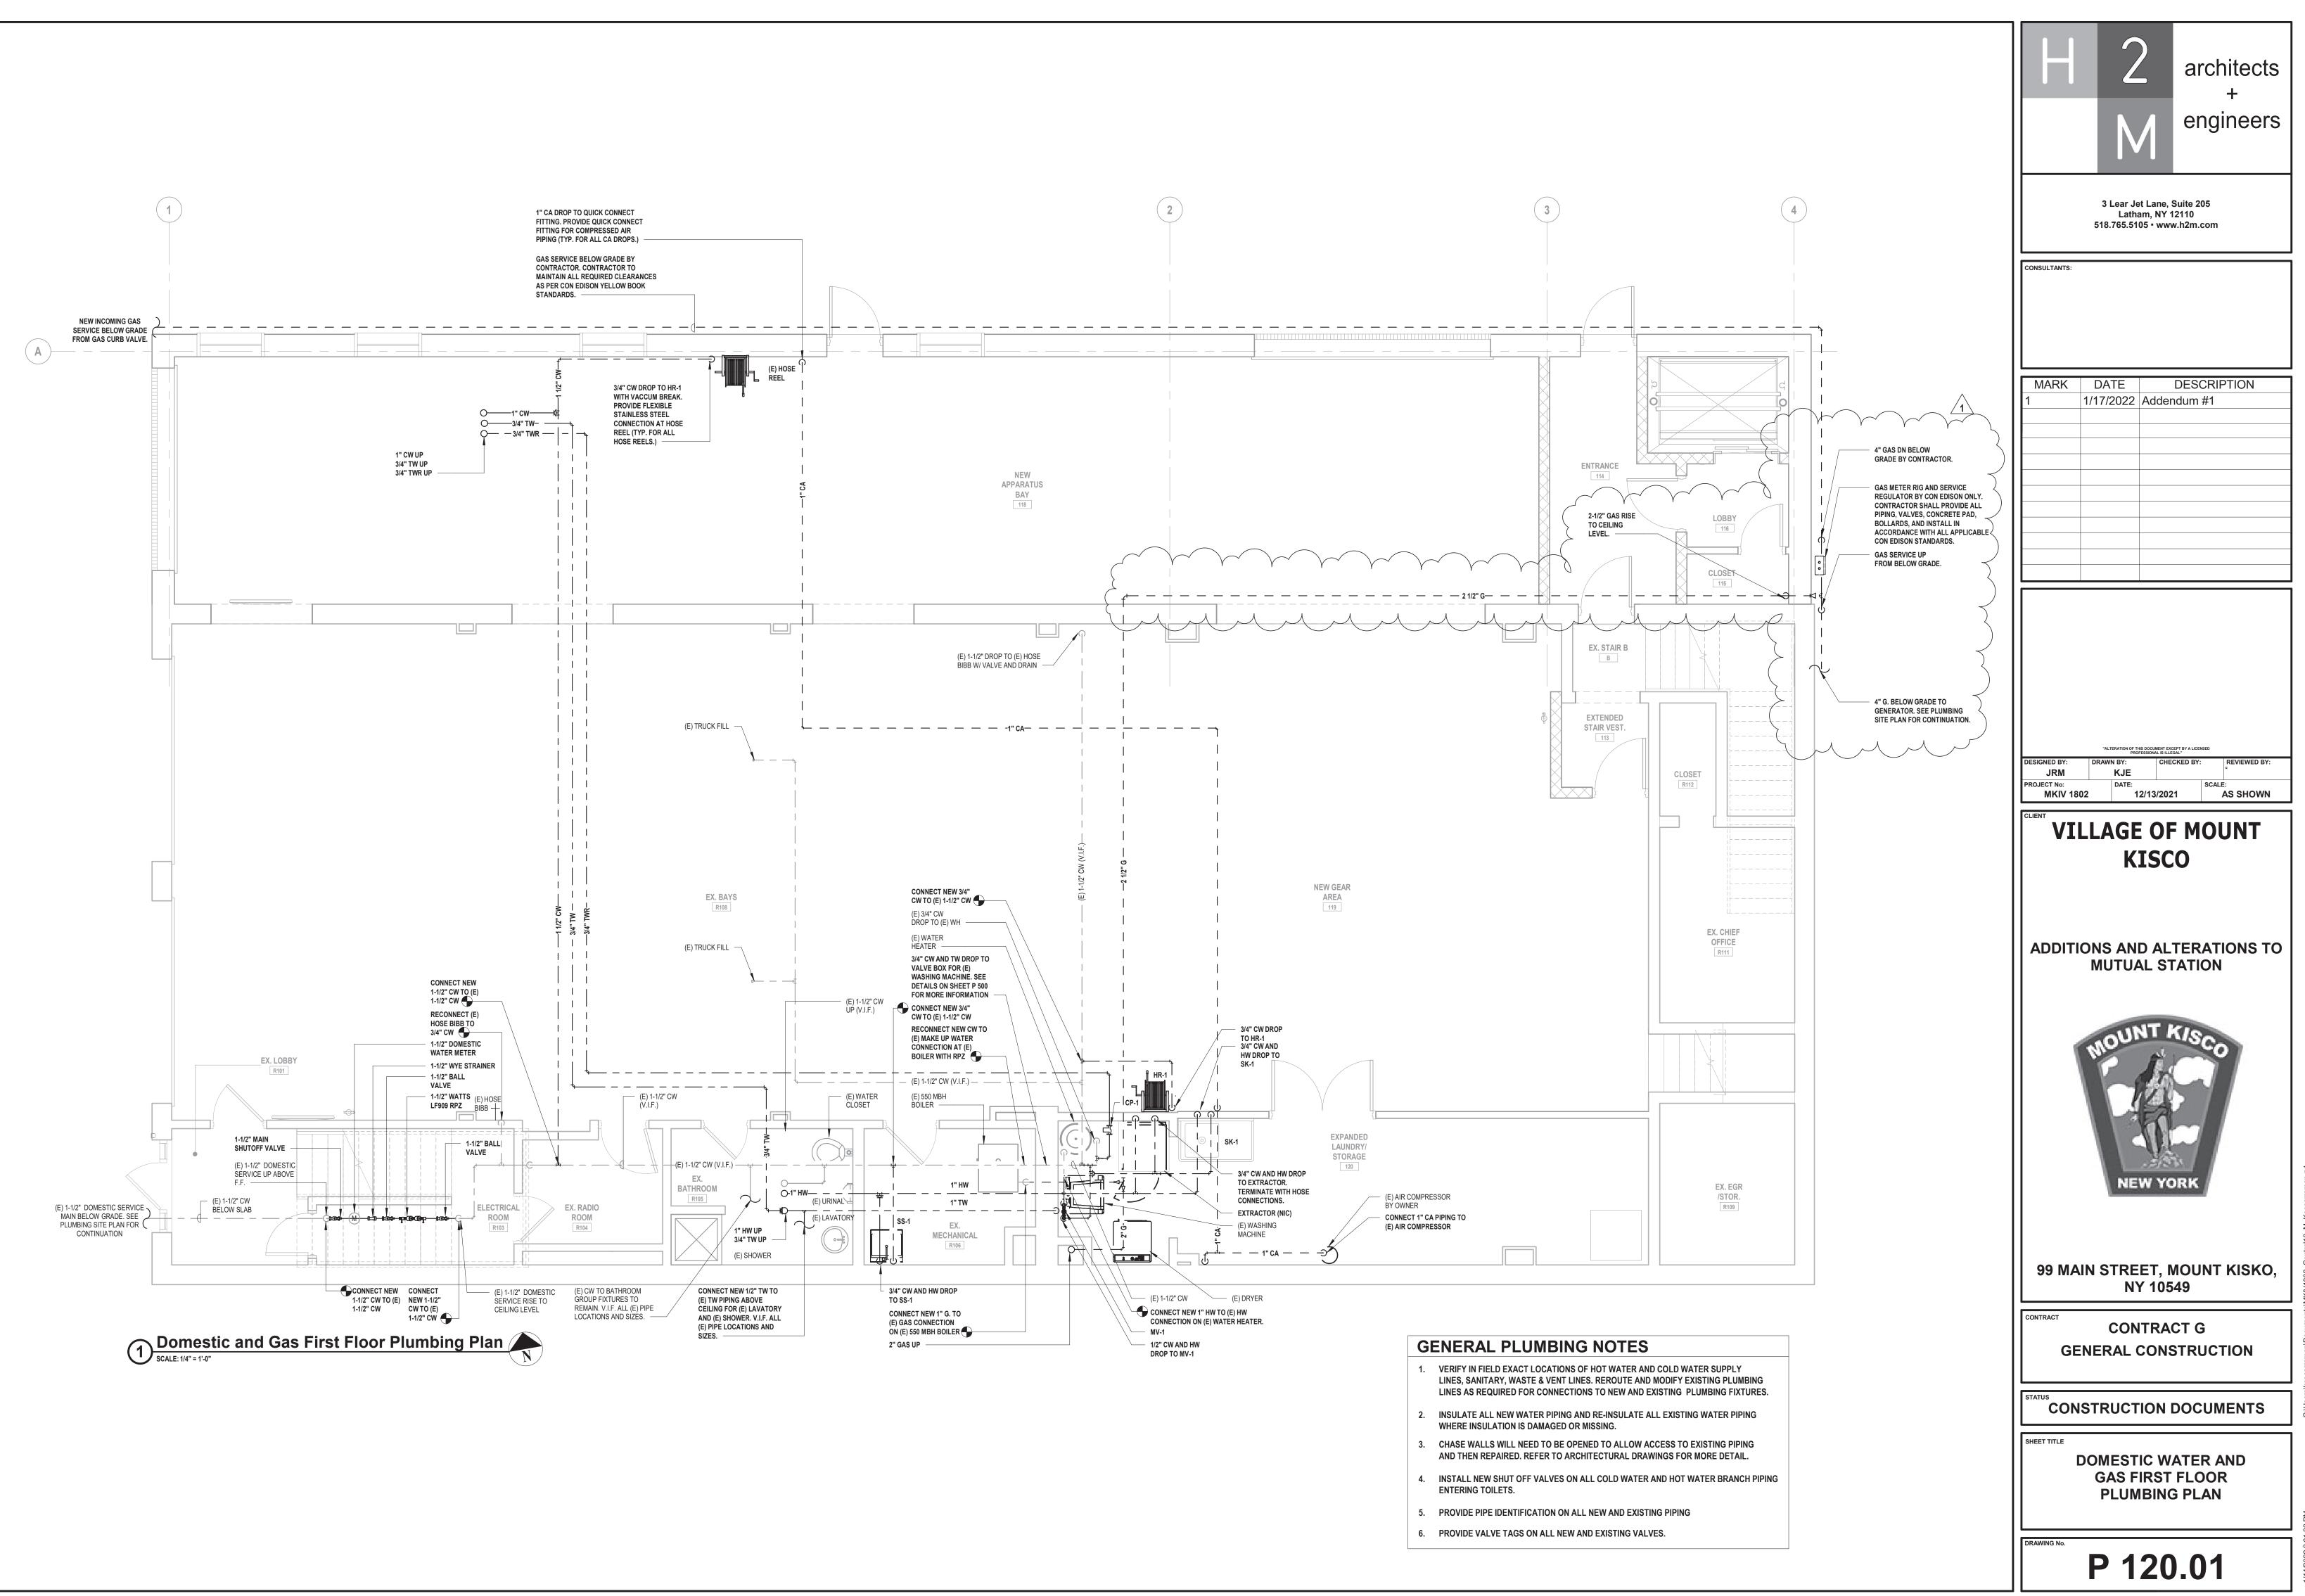
SERVICE FEE NOTE:

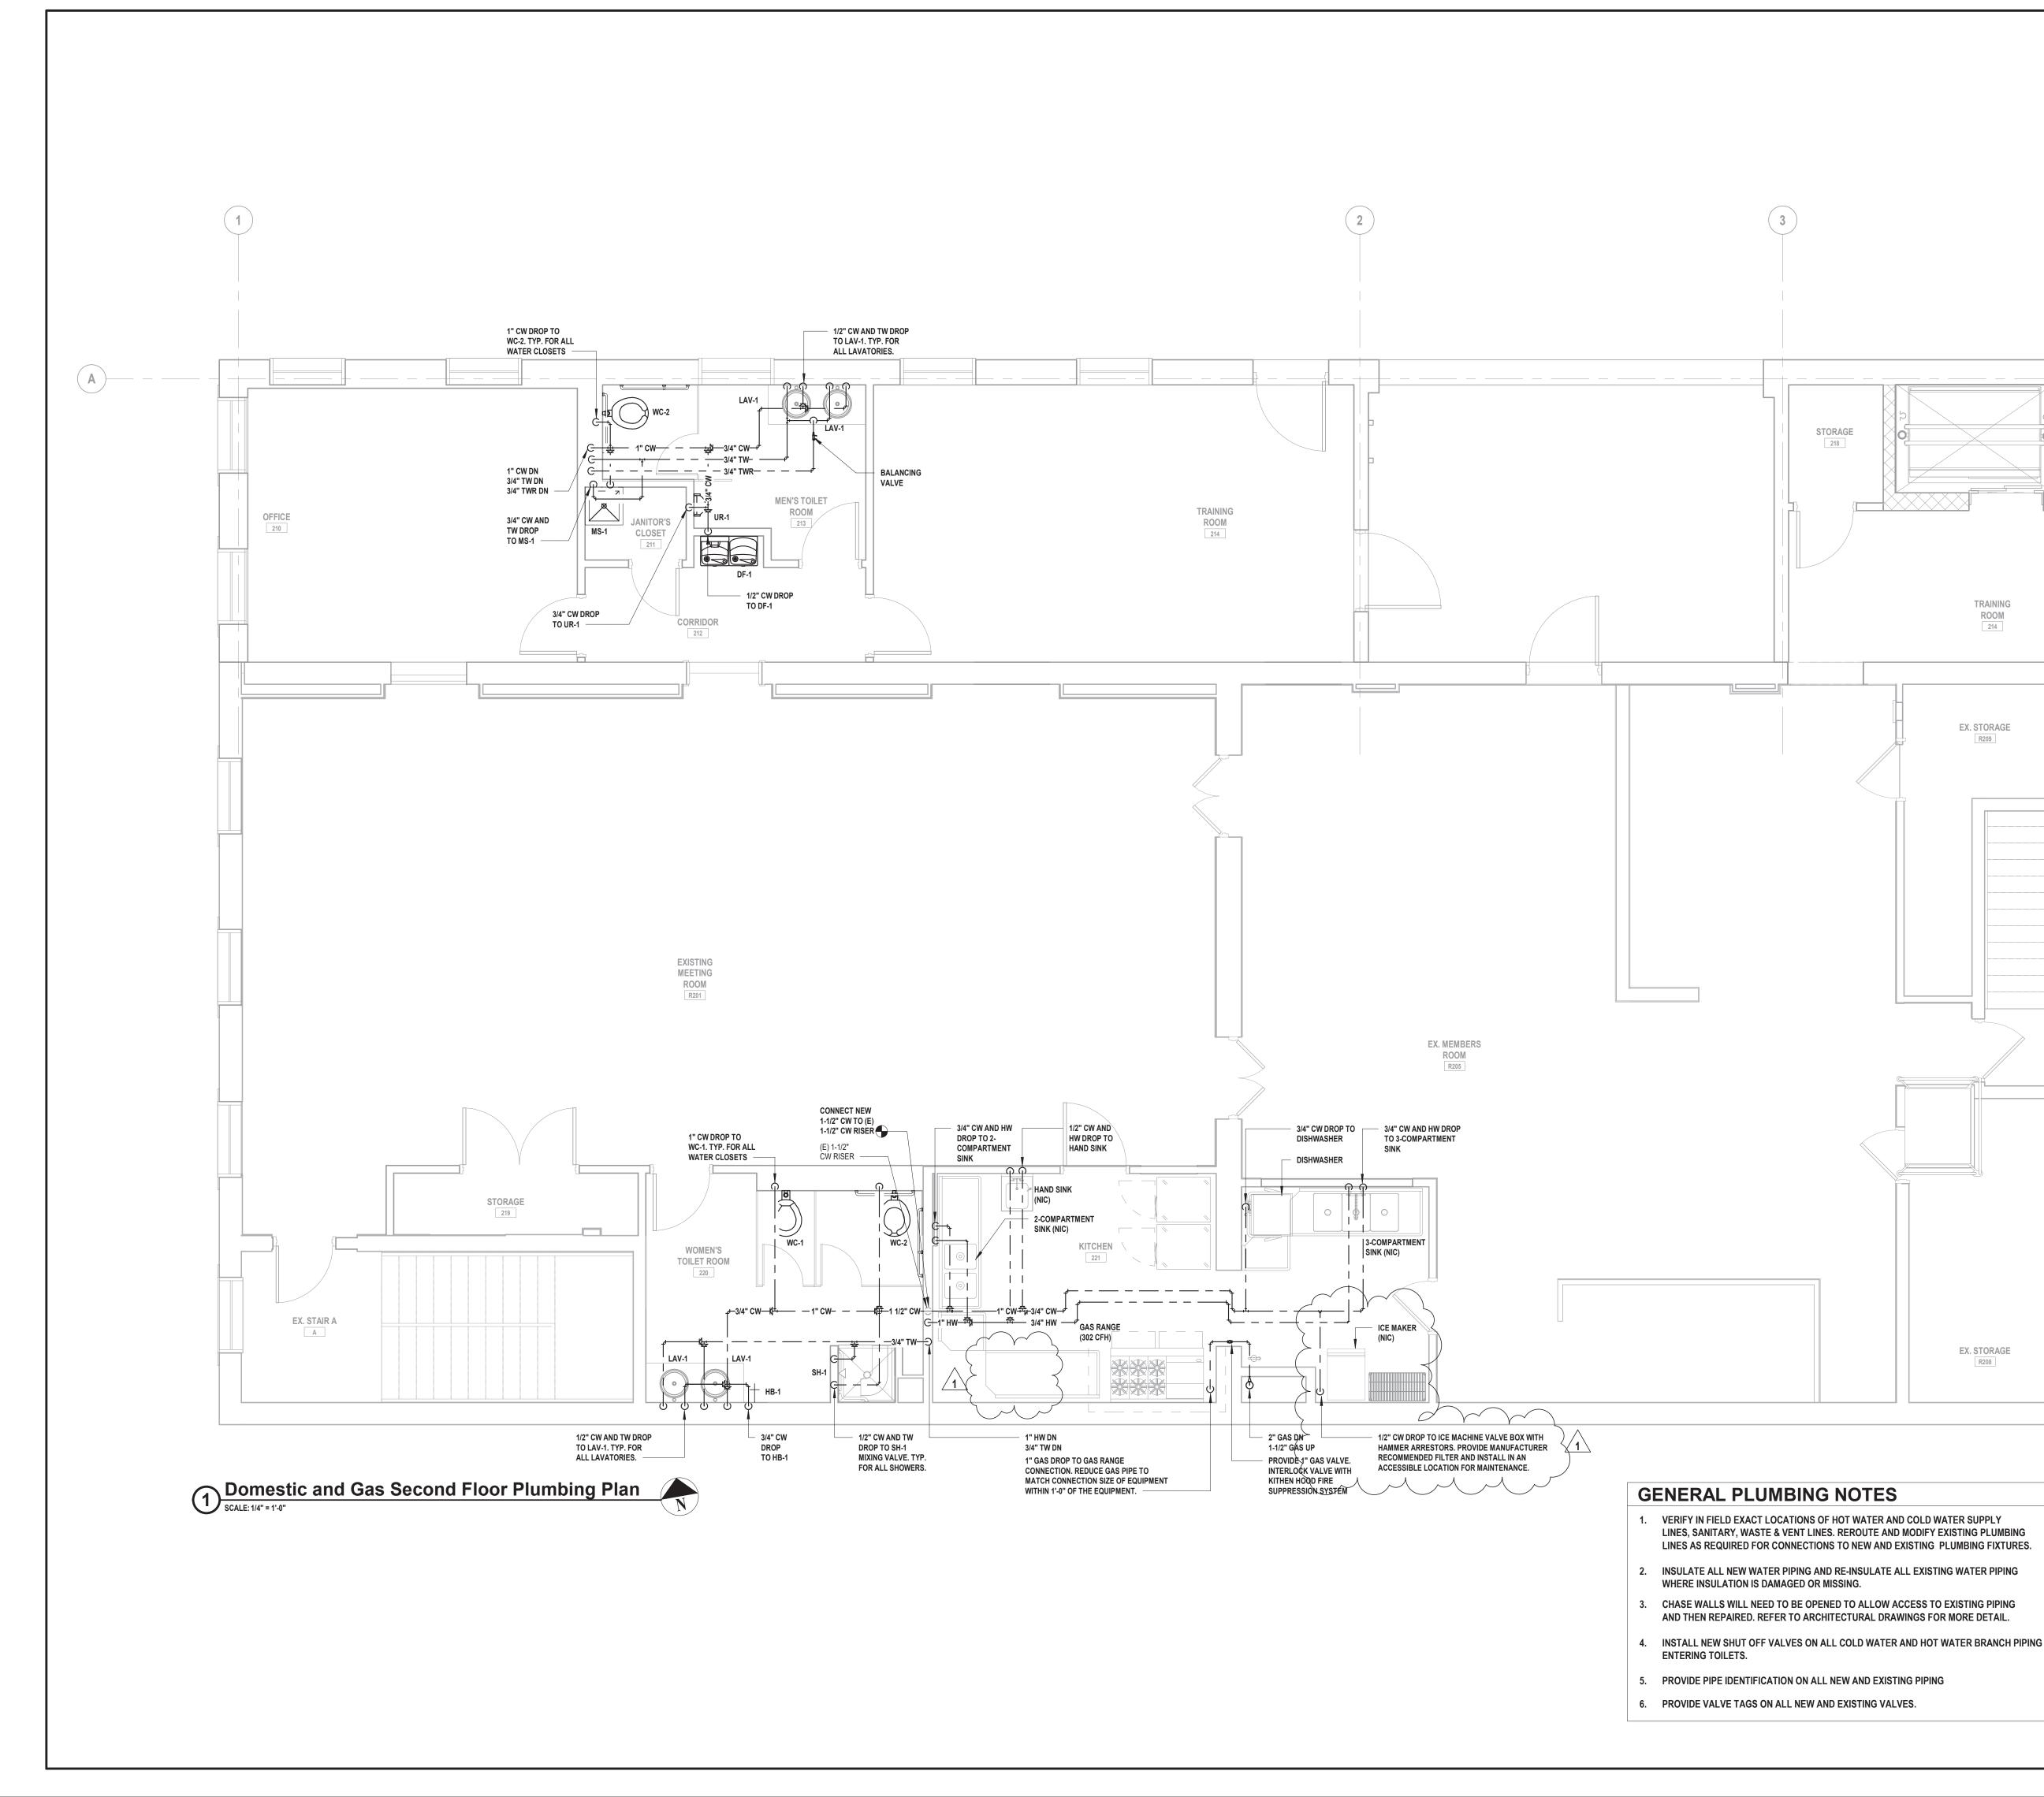
CONTRACTOR SHALL BE RESPONSIBLE FOR ALL ASSOCIATED TAP. PERMIT AND METER FEES FOR WATER SERVICES.

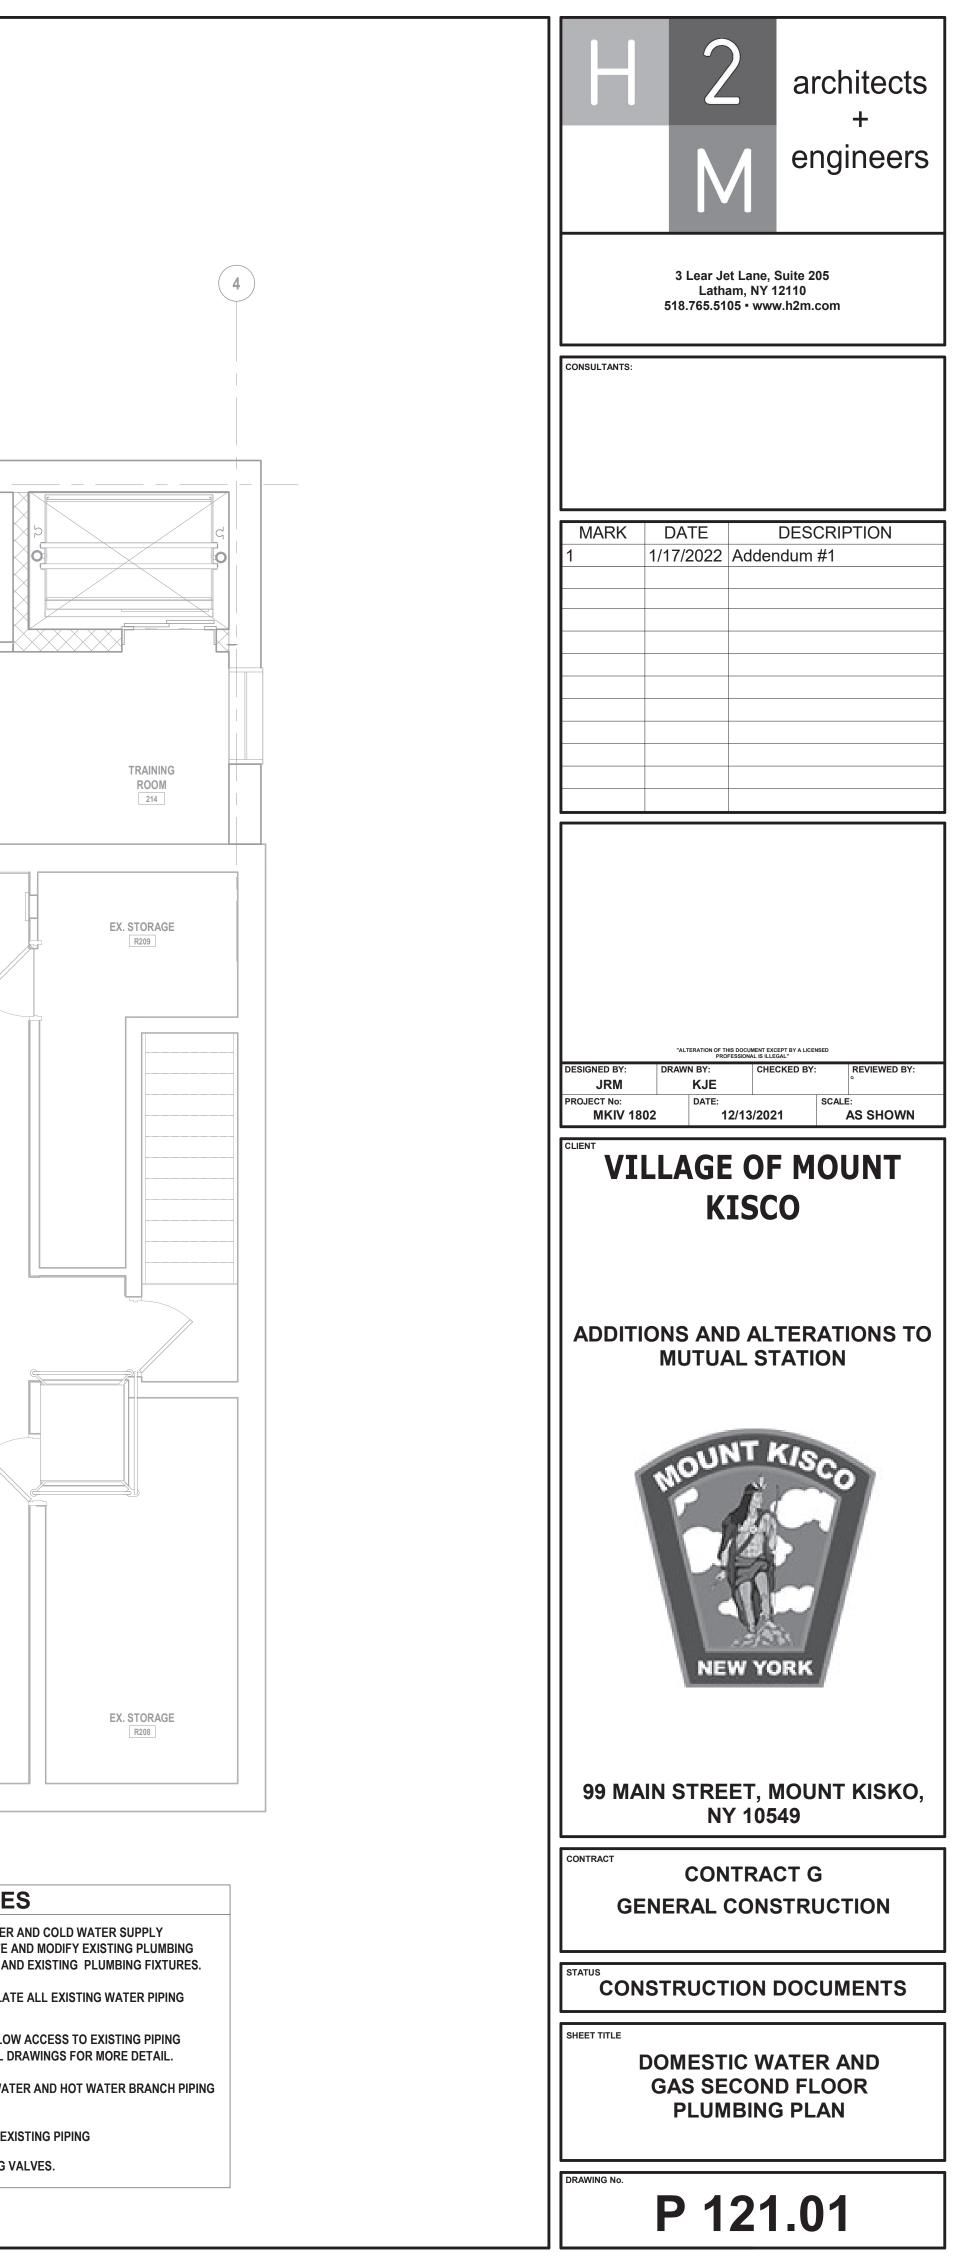




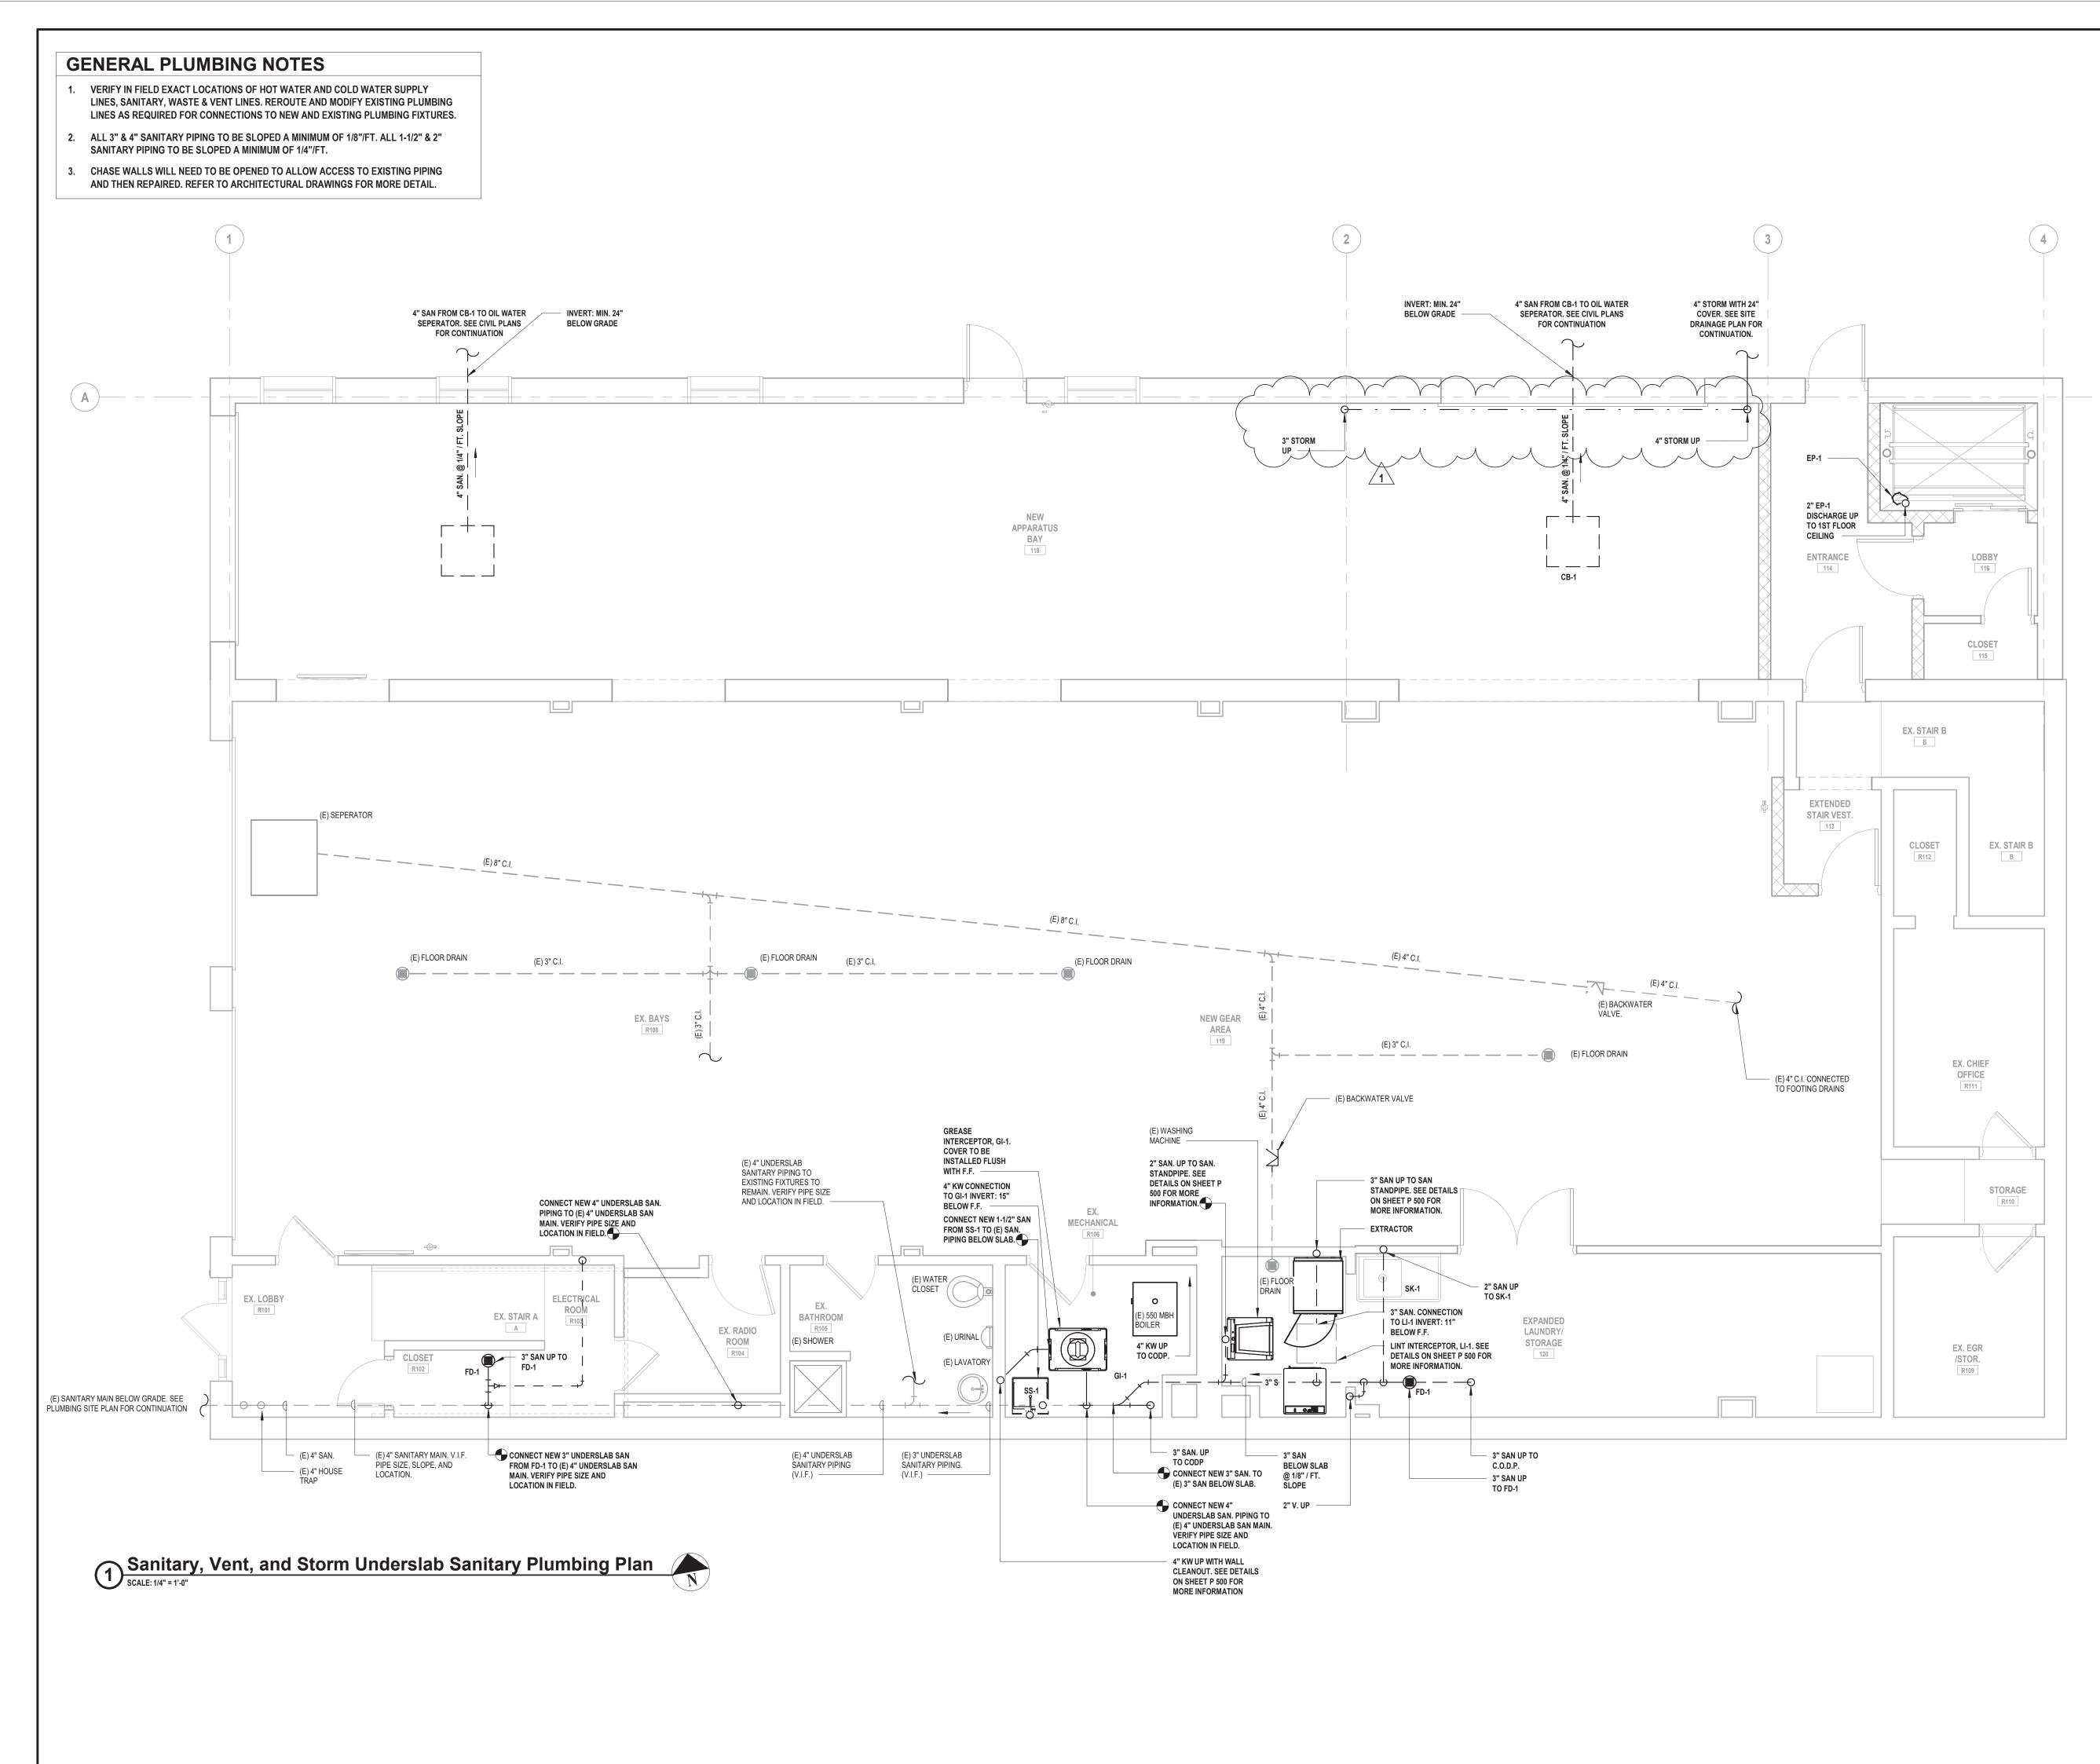


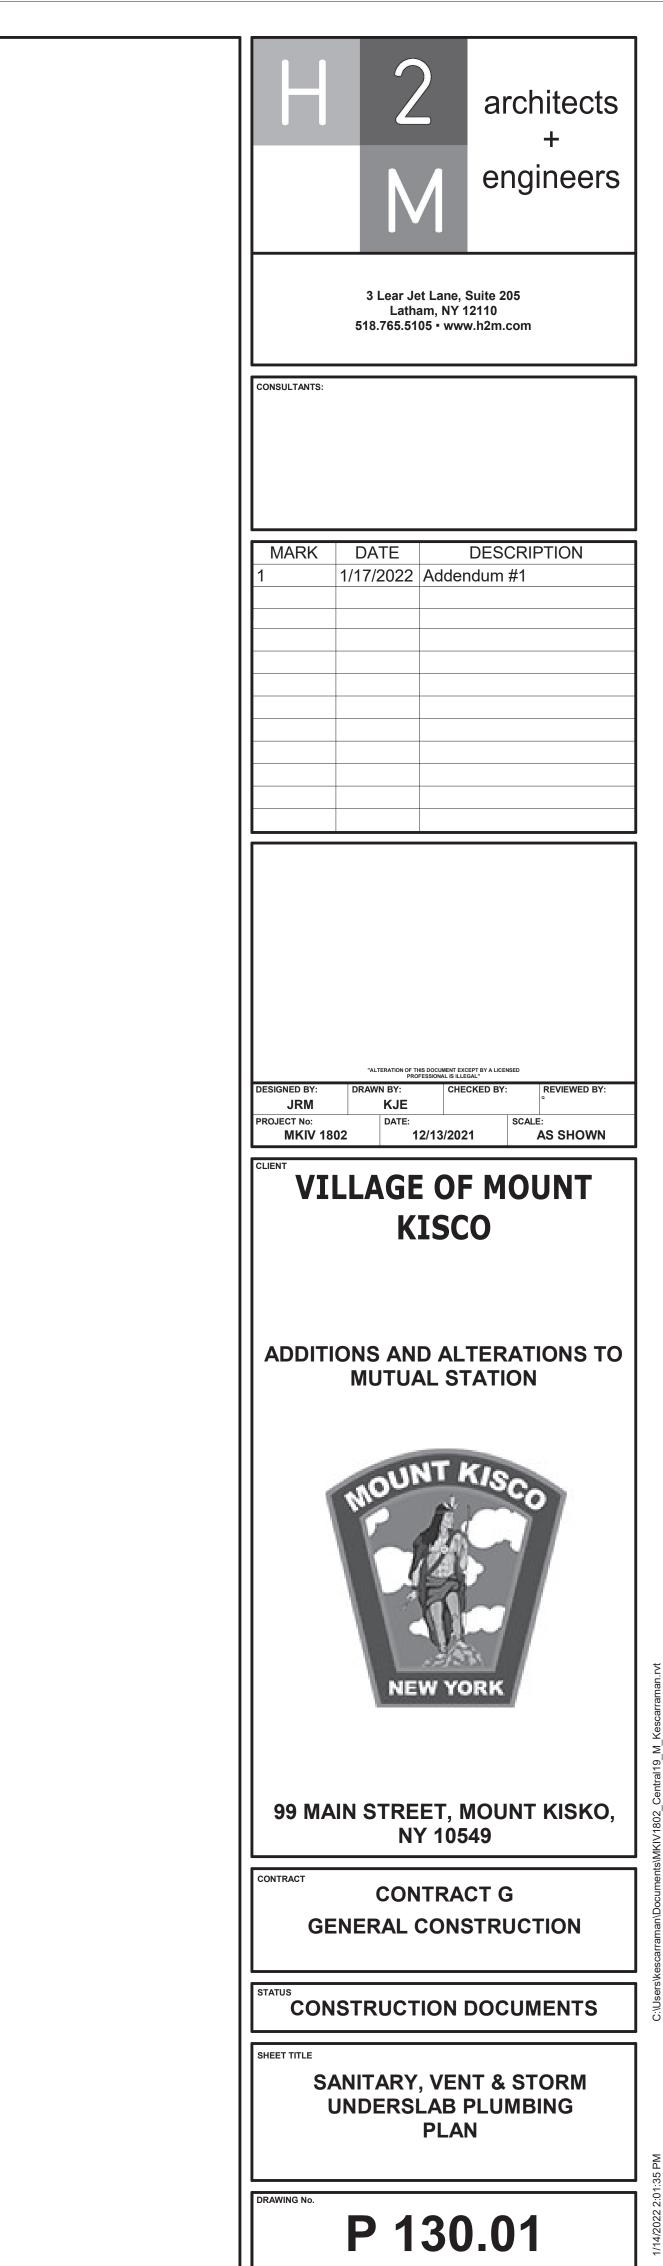


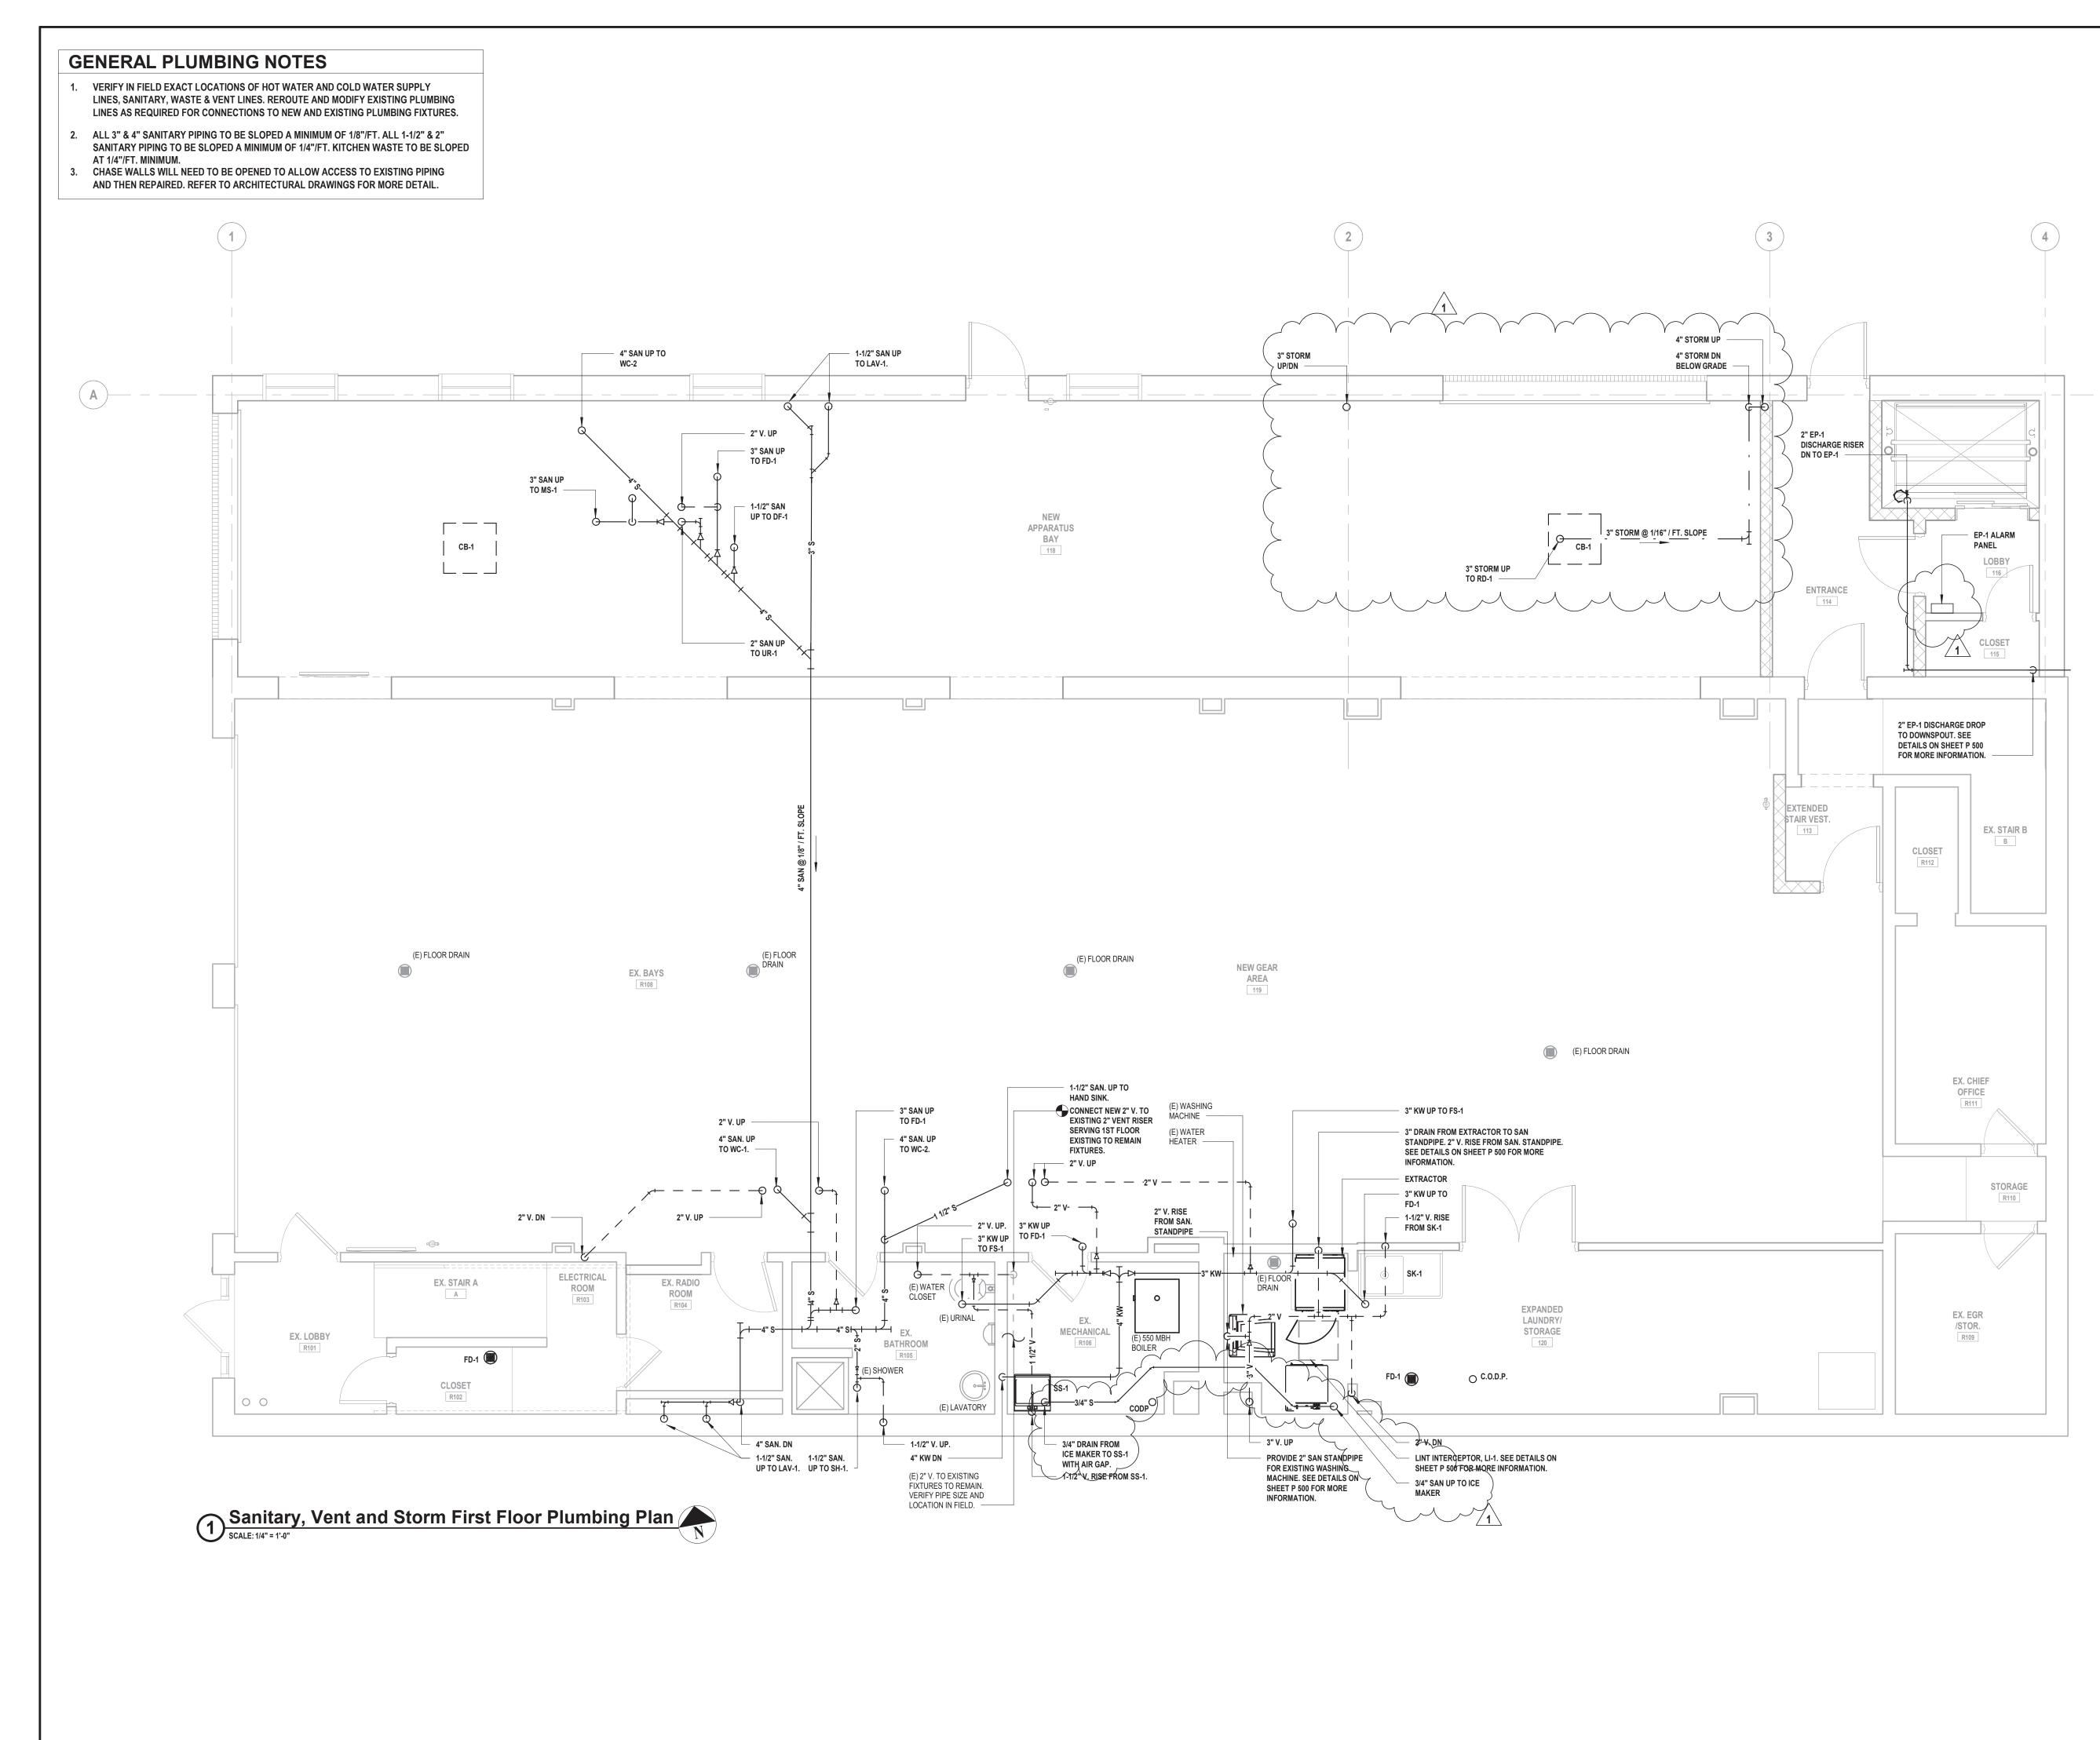


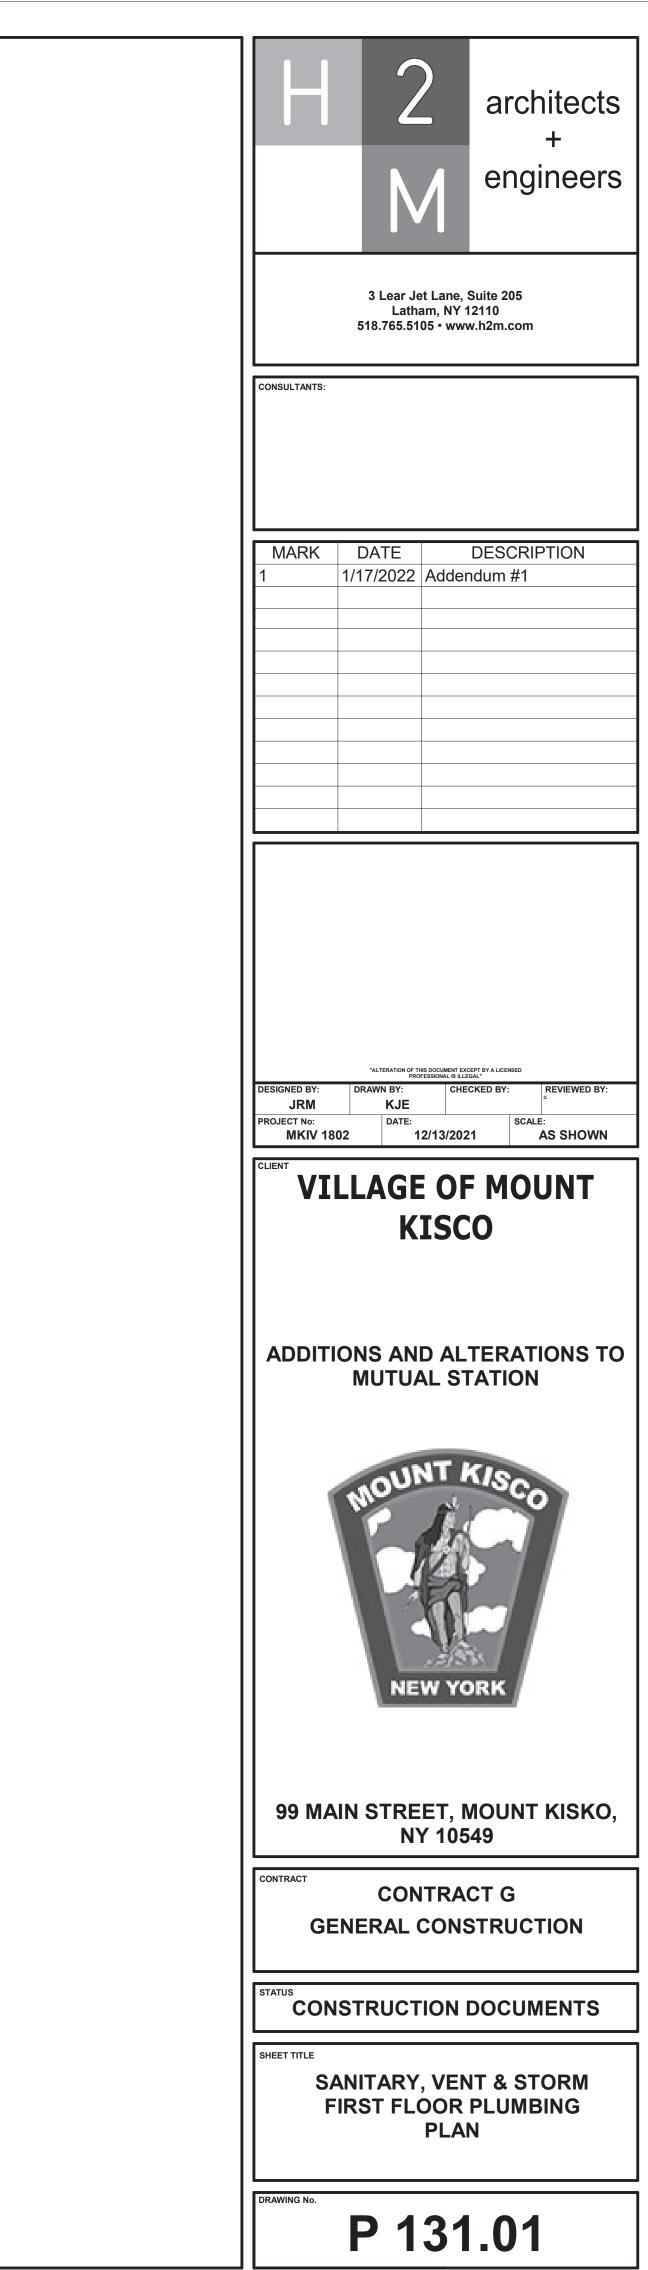


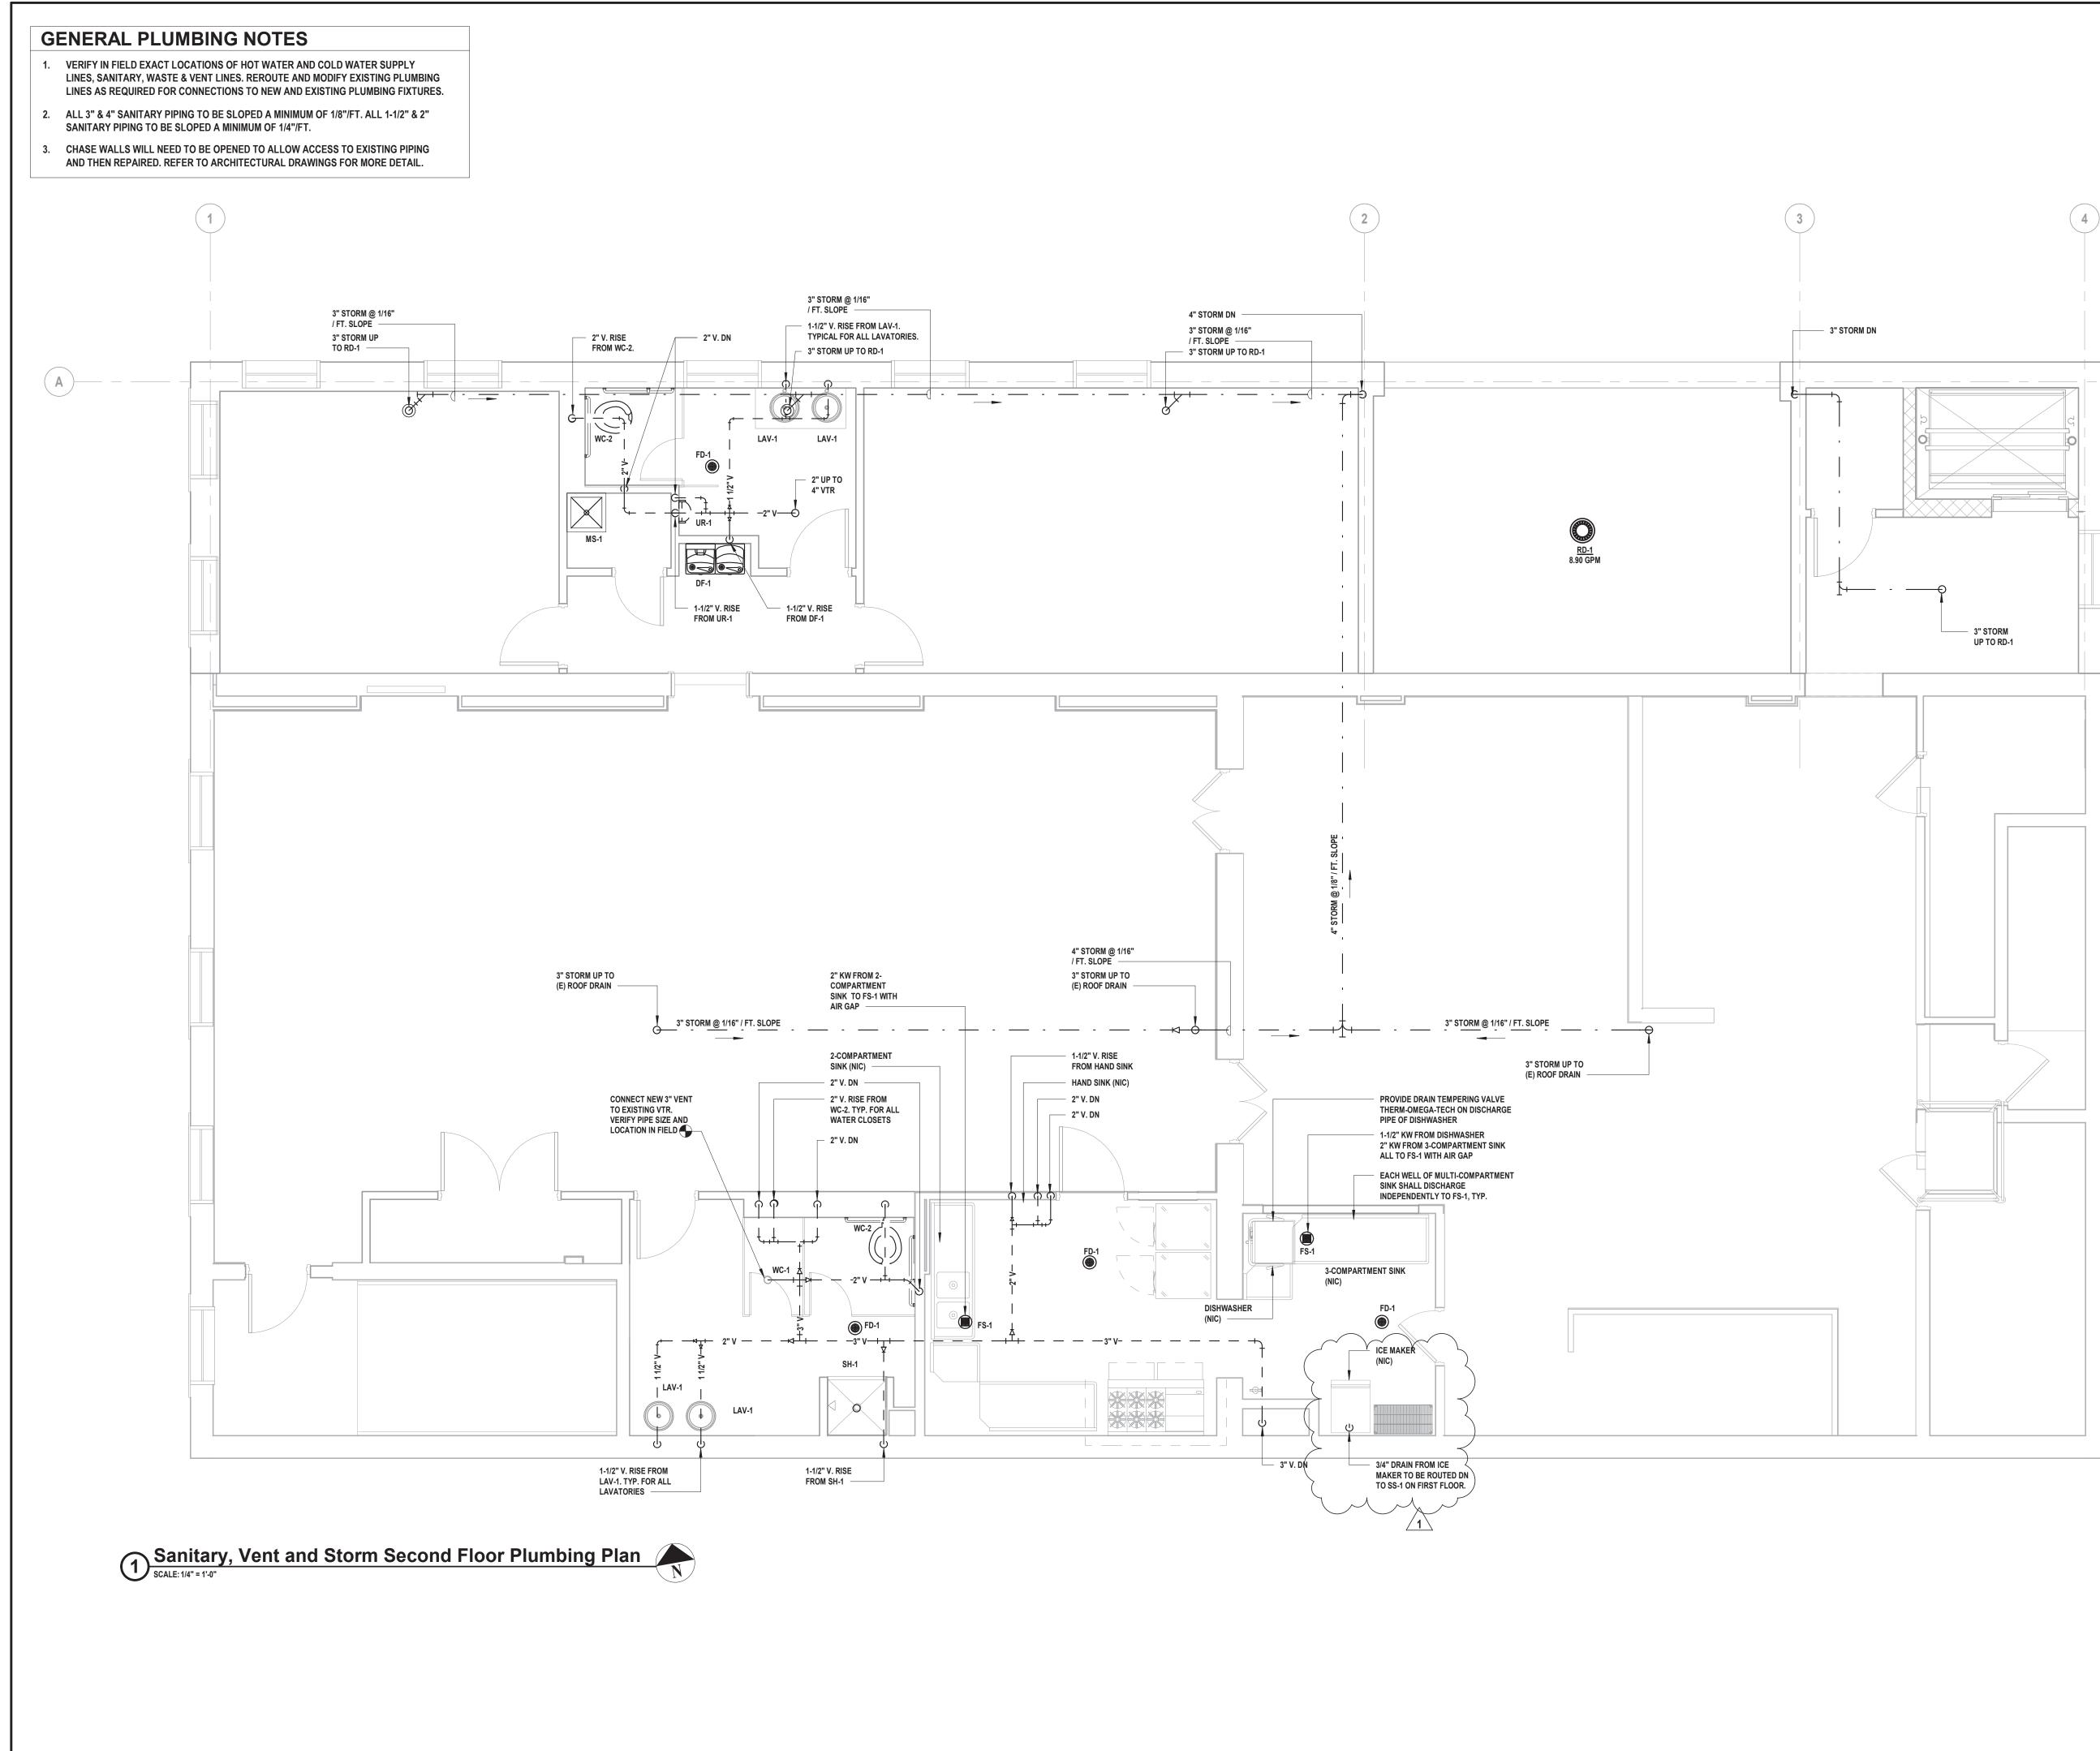
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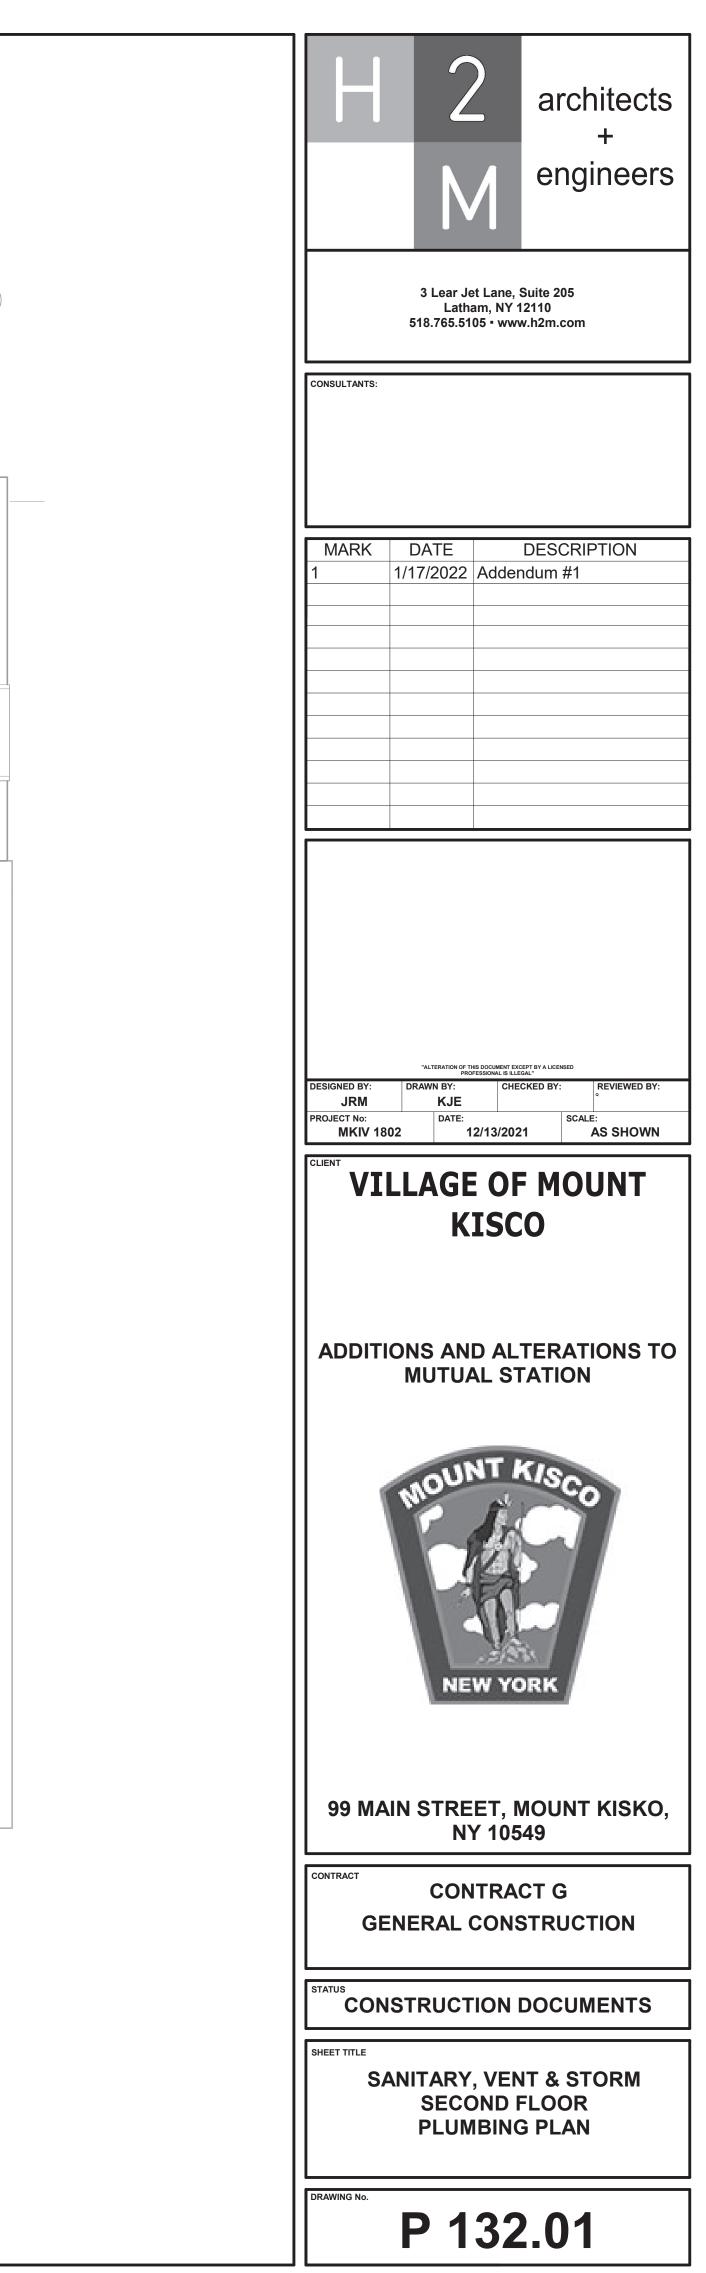








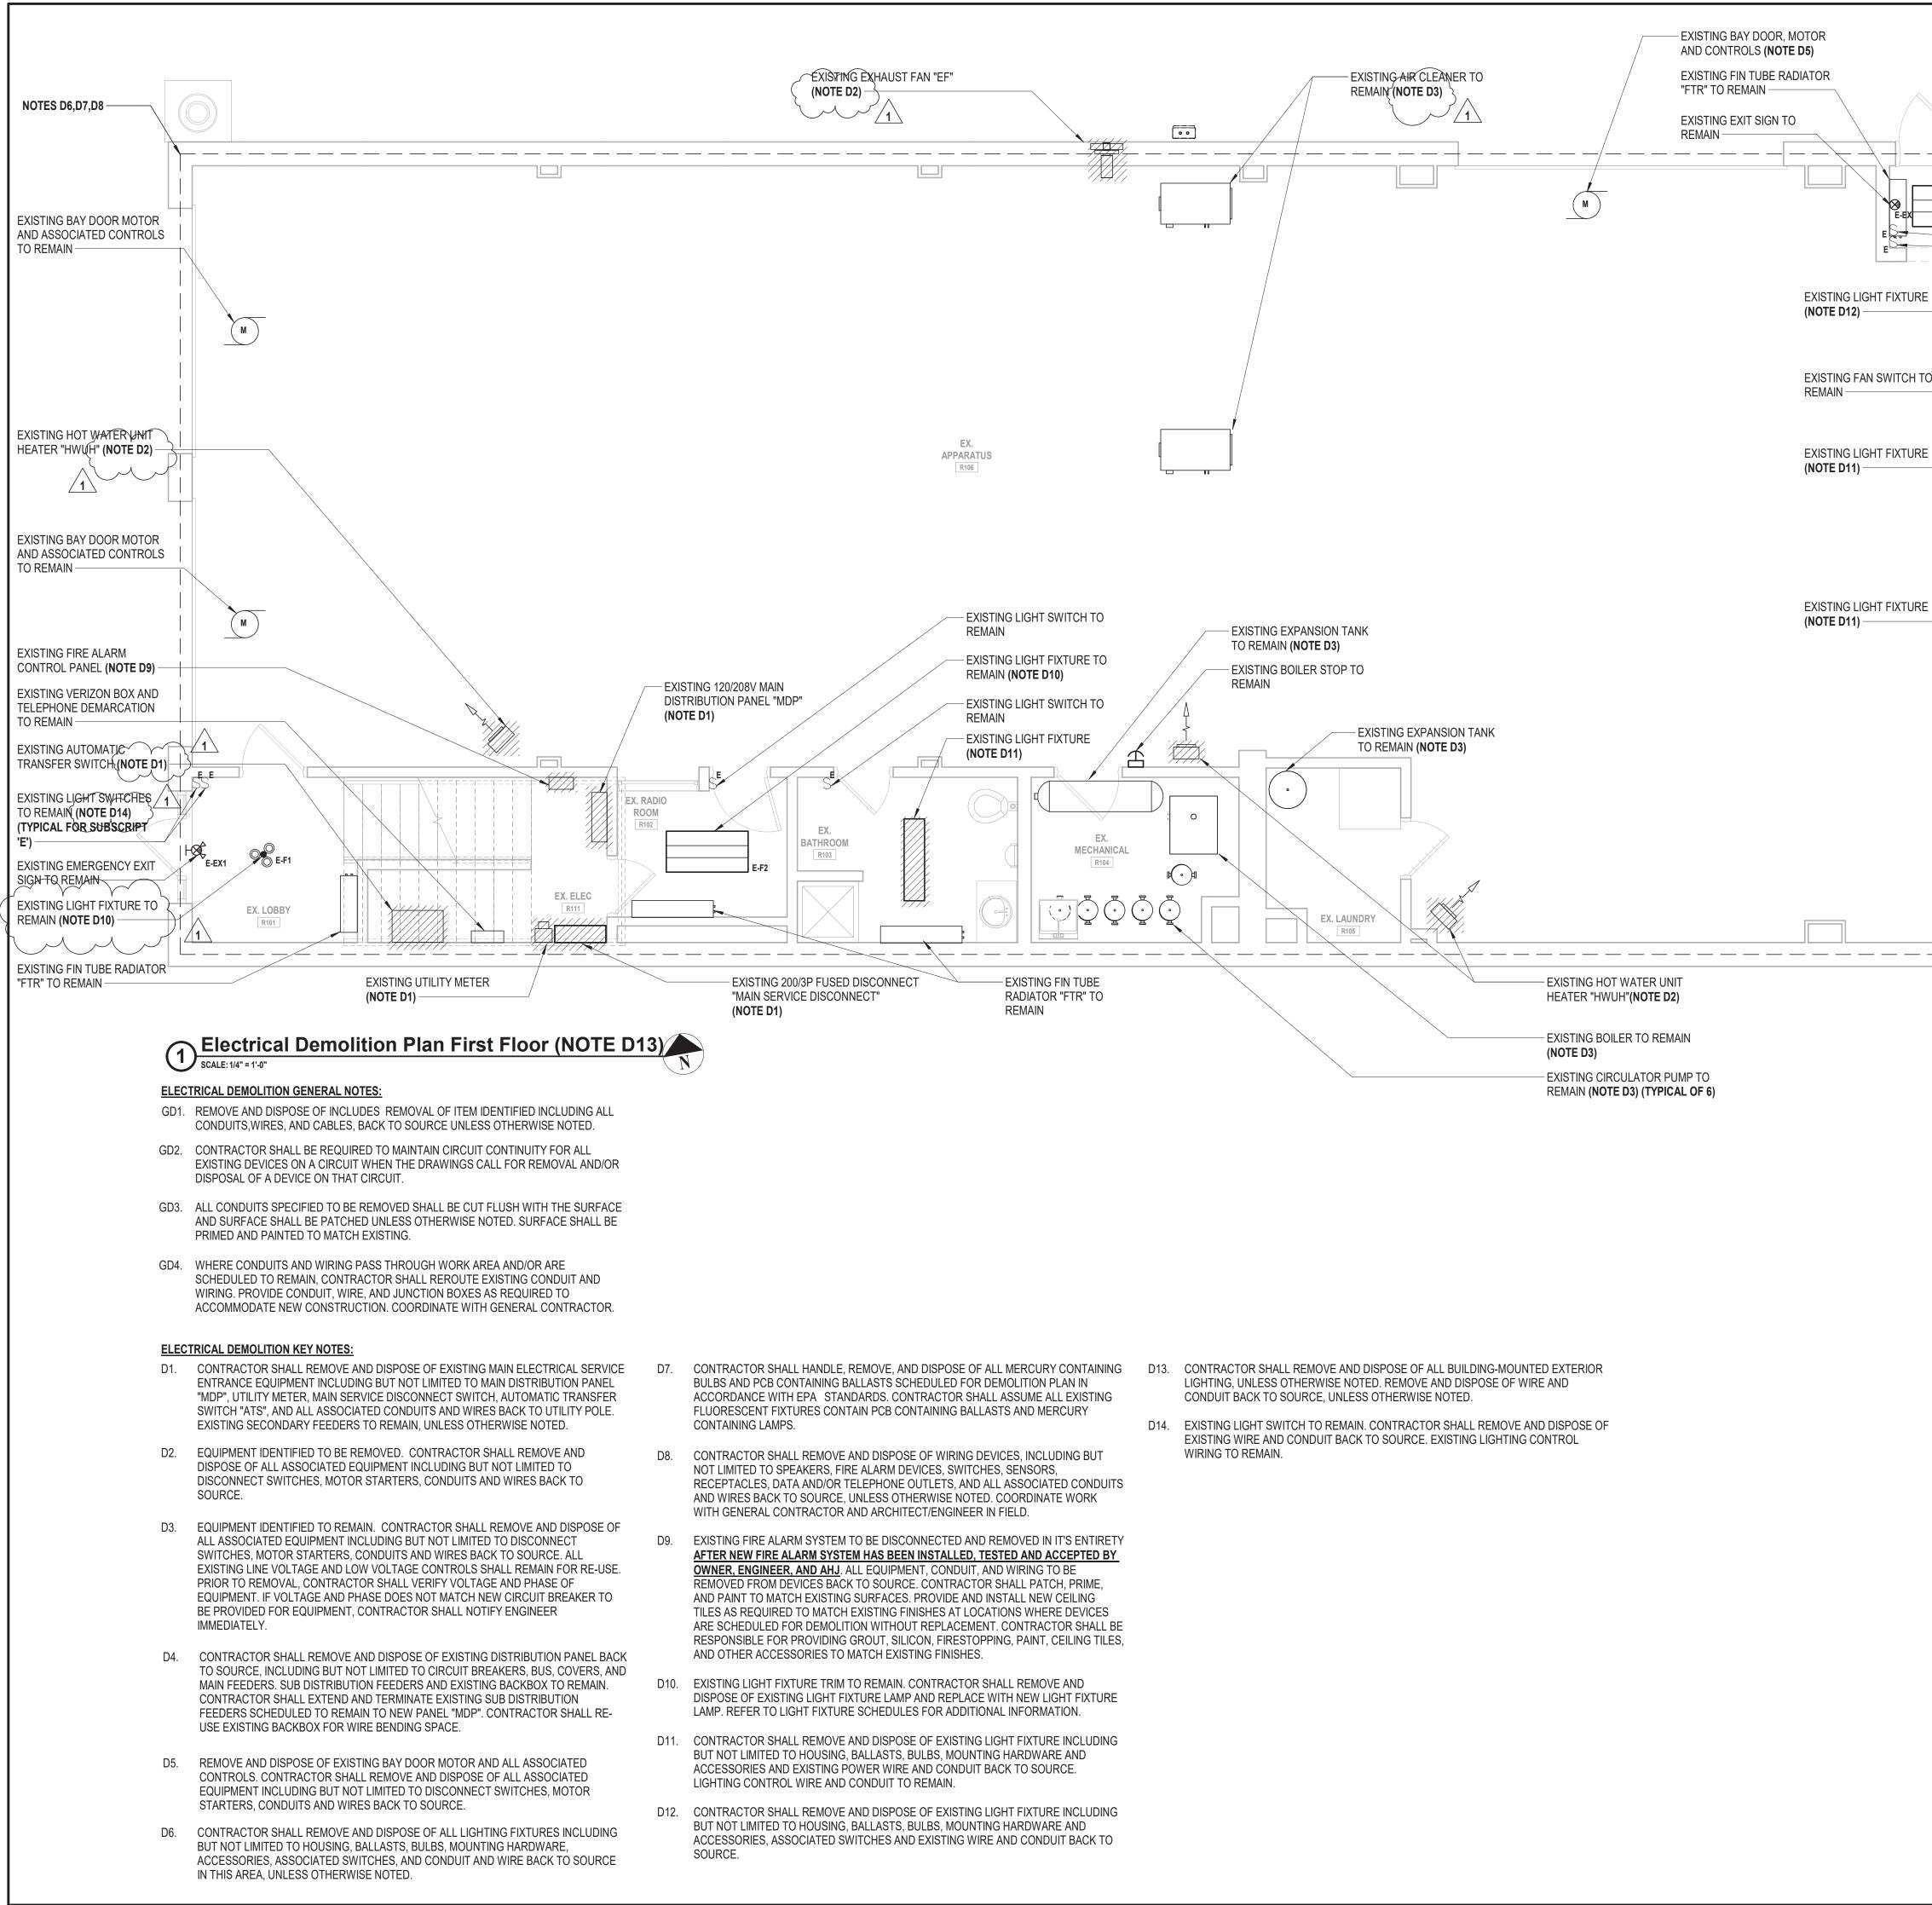


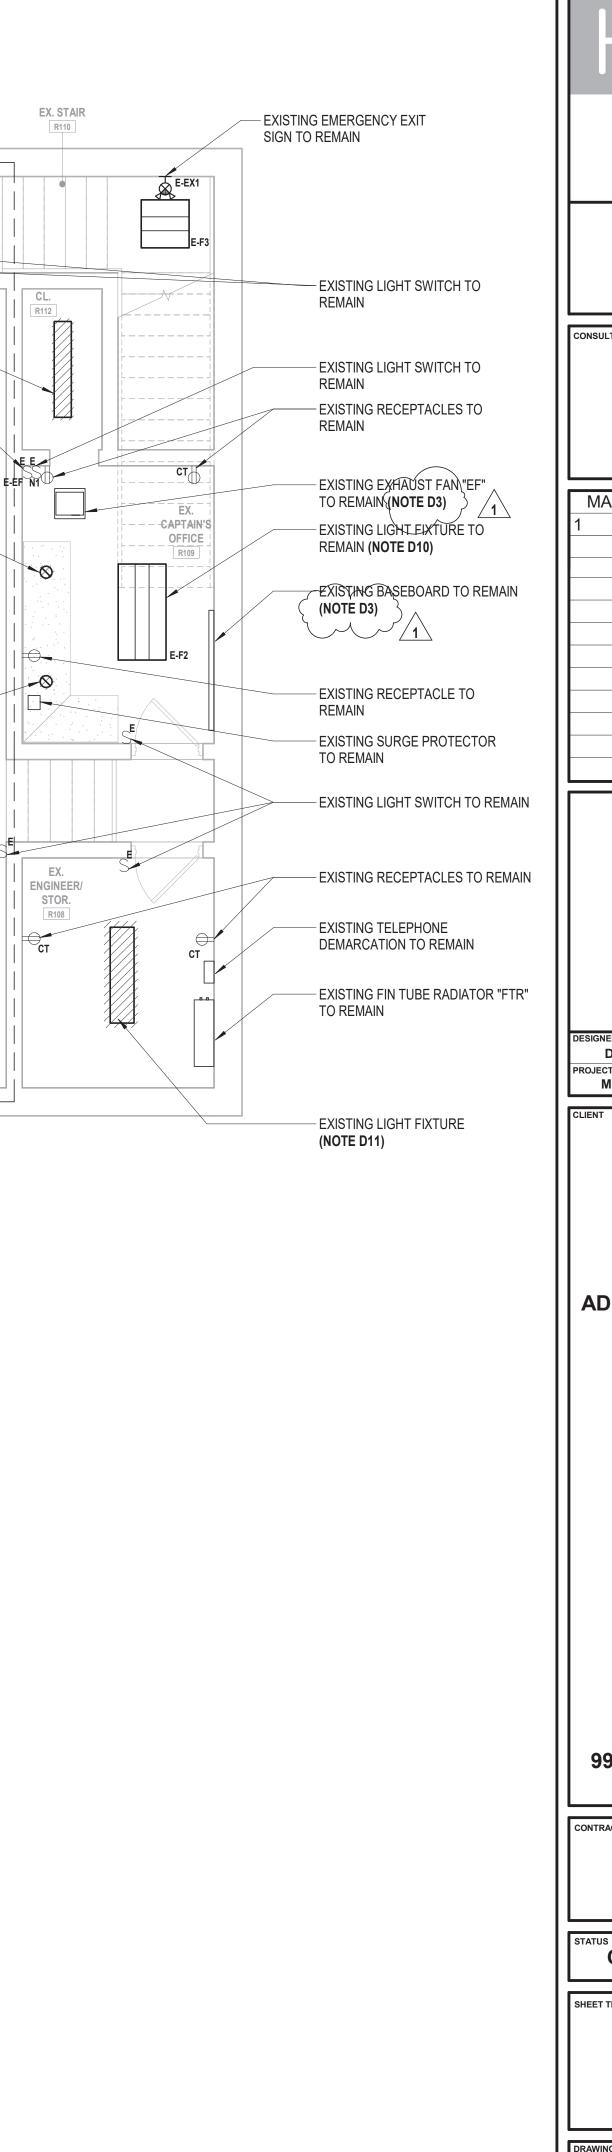


SYMBOL	DESCRIPTION	COMMENTS	ABBREVI
S ₃	THREE - WAY SWITCH	46" AFF TO CL UON	AFF
S ₄	FOUR - WAY SWITCH	46" AFF TO CL UON	AFC
S _I	ILLUMINATED SWITCH	46" AFF TO CL UON	AFG
SA	SINGLE POLE SWITCH; "A" INDICATES SWITCH CONTROL	46" AFF TO CL UON	AMP,
S _D	SINGLE POLE DIMMER SWITCH	46" AFF TO CL UON	ATS
S _{3D}	THREE - WAY DIMMER SWITCH	46" AFF TO CL UON	AW
S _K	SINGLE POLE KEYED SWITCH	46" AFF TO CL UON	BFC
S _{K3}	KEYED THREE - WAY SWITCH	46" AFF TO CL UON	CL
S _{K4}	KEYED FOUR - WAY SWITCH	46" AFF TO CL UON	СТ
S _M	HORSEPOWER RATED SWITCH, WITH INDICATOR (CONTRACTOR SHALL COORDINATE VOLTAGE AND PHASE WITH	46" AFF	EC
	EQUIPMENT)	40 AT	GFC
S _P	SWITCH AND PILOT LIGHT		GF
ST	SWITCH WITH THERMAL OVERLOAD PROTECTION (CONTRACTOR SHALL COORDINATE VOLTAGE AND PHASE WITH EQUIPMENT)		CON
S _{os}	OCCUPANCY SENSOR WITH MANUAL OVERRIDE, WALL MOUNT		МС
TC	TIME CLOCK		ML
PC	PHOTOCELL		NTS
PB	PUSH BUTTON		UO
	EMERGENCY SHUT OFF SWITCH; 'E' INDICATES ELECTRICAL; 'G' INDICATES GAS		UC
	OCCUPANCY SENSOR, CEILING MOUNT		v
			VA
	OCCUPANCY SENSOR POWER PACK, MOUNTED ABOVE CEILING 2 #12 AWG + #12 AWG GND IN 3/4" E.C. CONCEALED IN WALL OR CEILING		VD
	2 #12 AWG + #12 AWG GND IN 3/4" E.C. CONCEALED IN WALL OR CEILING 5 #12 AWG + #12 AWG GND IN 3/4" E.C. CONCEALED IN WALL OR CEILING		X-FN
	3 #12 AWG + #12 AWG GND IN 3/4" E.C. CONCEALED IN OR BELOW SLAB		WF
	DEDICATED HOME RUN TO PANEL LP1 FOR CIRCUIT No. 35 ONLY. 2 #12 AWG + #12 AWG GND IN 3/4" E.C. CONCEALED		
LP1-35	IN WALL OR CEILING		
θ-	SIMPLEX RECEPTACLE: 120V, 20A. COORDINATE MOUNTING HEIGHT WITH MECHANICAL CONTRACTOR TO CLEAR	FLUSH	
Œ	DUPLEX RECEPTACLE: 120V, 20A. COORDINATE MOUNTING HEIGHT WITH MECHANICAL CONTRACTOR TO CLEAR BASEBOARDS.	FLUSH	
—	QUAD RECEPTACLE, DOUBLE DUPLEX RECEPTACLE: 120V, 20A. COORDINATE MOUNTING HEIGHT WITH MECHANICAL	FLUSH	
	CONTRACTOR TO CLEAR BASEBOARDS.	FLUSH	
c	DUPLEX RECEPTACLE: 120V, 20A; SUBSCRIPT "C" INDICATES CEILING MOUNT.	FLUSH	
	DUPLEX RECEPTACLE: 120V, 20A; FLOOR MOUNTED.	FLUSH	
G→IG	ISOLATED GROUND DUPLEX RECEPTACLE. COORDINATE MOUNTING HEIGHT WITH MECHANICAL CONTRACTOR TO CLEAR BASEBOARDS.	FLUSH	
GEI GEI	DUPLEX RECEPTACLE: 120V, 20A; WITH GROUND FAULT INDICATOR. COORDINATE MOUNTING HEIGHT WITH	FLUQU	
	MECHANICAL CONTRACTOR TO CLEAR BASEBOARDS.	FLUSH	
	DUPLEX RECEPTACLE: 120V, 20A; SUBSCRIPT "UC" INDICATES UNDER COUNTER	AS PER ENGINEER	
CT CT	DUPLEX RECEPTACLE: 120V, 20A; SUBSCRIPT "CT" INDICATES COUNTER TOP.	AS PER ENGINEER	
₩P ₩P	DUPLEX RECEPTACLE: 120V, 20A; SUBSCRIPT "WP" INDICATED WEATHER PROOF	AS PER ENGINEER	
₩ ⁴⁰ 240	SPECIAL PURPOSE OUTLET: 240V, 40A. VERIFY NEMA CONFIGURATION WITH EQUIPMENT MANUFACTURER.	AS PER ENGINEER	
●_ ^{TL}	TWISTED LOCK RECEPTACLE: 125V, 20A, 3 WIRE; UNLESS OTHERWISE NOTED.	AS PER ENGINEER	
	SURFACE RACEWAY WITH 2 GROUNDED AND ISOLATED TYPE DUPLEX RECEPTACLES AND 1 DATA OUTLET PER POSITION, 18" AFF UNLESS OTHERWISE NOTED.		
Ø	TELEPHONE/POWER POLE		
 ⊠' _{\$1}	MAGNETIC STARTER "S1"; SEE STARTER SCHEDULE		
□ <u>S1</u> □ □ <u>DS1</u>			
	DISCONNECTION SWITCH "DS1"; SEE DISCONNECT SWITCH SCHEDULE. JUNCTION BOX		
	NEMA 4X STAINLESS STEEL JUNCTION BOX WITH GASKET COVER.		
(J _{4X}			
J _s	JUNCTION BOX RECESSED IN WALL WITH BLANK COVER, PROVIDE 3/4" E.C. AND DRAG LINE TO ABOVE FINISHED CEILING. MOUNT 18" AFF, UNLESS OTHERWISE NOTED.		
J _M	FOR MONITOR, JUNCTION BOX RECESSED IN WALL WITH BLANK COVER. PROVIDE 3/4" E.C. AND DRAG LINE TO		
	ABOVE FINISHED CEILING.		
	TRANSFORMER "T1"; SEE TRANSFORMER SCHEDULE.		
	ELECTRICAL PANEL "P1", RECESSED; SEE PANEL SCHEDULE.		
P1	ELECTRICAL PANEL "P1", SURFACE MOUNT; SEE PANEL SCHEDULE.		
<u>C</u>	CONDUIT GOING UP.		
	CONDUIT GOING DOWN.		
0	PULLBOX		
Ť	TELEPHONE. PROVIDE CAT 6 CABLE IN 3/4" E.C. TO PATCH PANEL IN EXISTING OFFICE R204. COORDINATE RACK AND PUNCH DOWN LOCATION WITH OWNER. AT PATCH PANEL, LABEL CABLE WITH ROOM NUMBER/NAME. AT DATA DROP, LABEL CABLE WITH IDF RACK NUMBER, PATCH PANEL NUMBER, AND PORT NUMBER. PROVIDE BOX RECESSED IN WALL WITH RJ-11 COVER.	46" AFF	
Â	CEILING MOUNTED DATA DROP FOR WIRELESS ACCESS POINT (PROVIDED BY OWNER). PROVIDE CAT 6 CABLE IN 3/4" E.C. TO PATCH PANEL IN EXISTING OFFICE R204. COORDINATE RACK AND PUNCHDOWN LOCATION WITH OWNER. AT PATCH PANEL, PATCH PANEL NUMBER, AND PORT NUMBER. DATA DROP SHALL BE MOUNTED FLUSH WITH CEILING.	FLUSH	
D	DATA. PROVIDE CAT 6 CABLE IN 3/4" E.C. TO PATCH PANEL IN EXISTING OFFICE R204. COORDINATE RACK AND PUNCH DOWN LOCATION WITH OWNER. AT PATCH PANEL, LABEL CABLE WITH ROOM NUMBER/NAME. AT DATA DROP, LABEL CABLE WITH IDF RACK NUMBER, PATCH PANEL NUMBER, AND PORT NUMBER. PROVIDE BOX RECESSED IN WALL WITH RJ-45 COVER.	18" AFF	
2D	DOUBLE DATA. PROVIDE TWO (2) CAT 6 CABLE IN 3/4" E.C. TO PATCH PANEL IN EXISTING OFFICE R204. COORDINATE RACK AND PUNCH DOWN LOCATION WITH OWNER. AT PATCH PANEL, LABEL CABLE WITH ROOM NUMBER/NAME. AT DATA DROP, LABEL CABLE WITH IDF RACK NUMBER, PATCH PANEL NUMBER, AND PORT NUMBER. PROVIDE BOX RECESSED IN WALL WITH (2) TWO PORT RJ-45 COVER.	18" AFF	

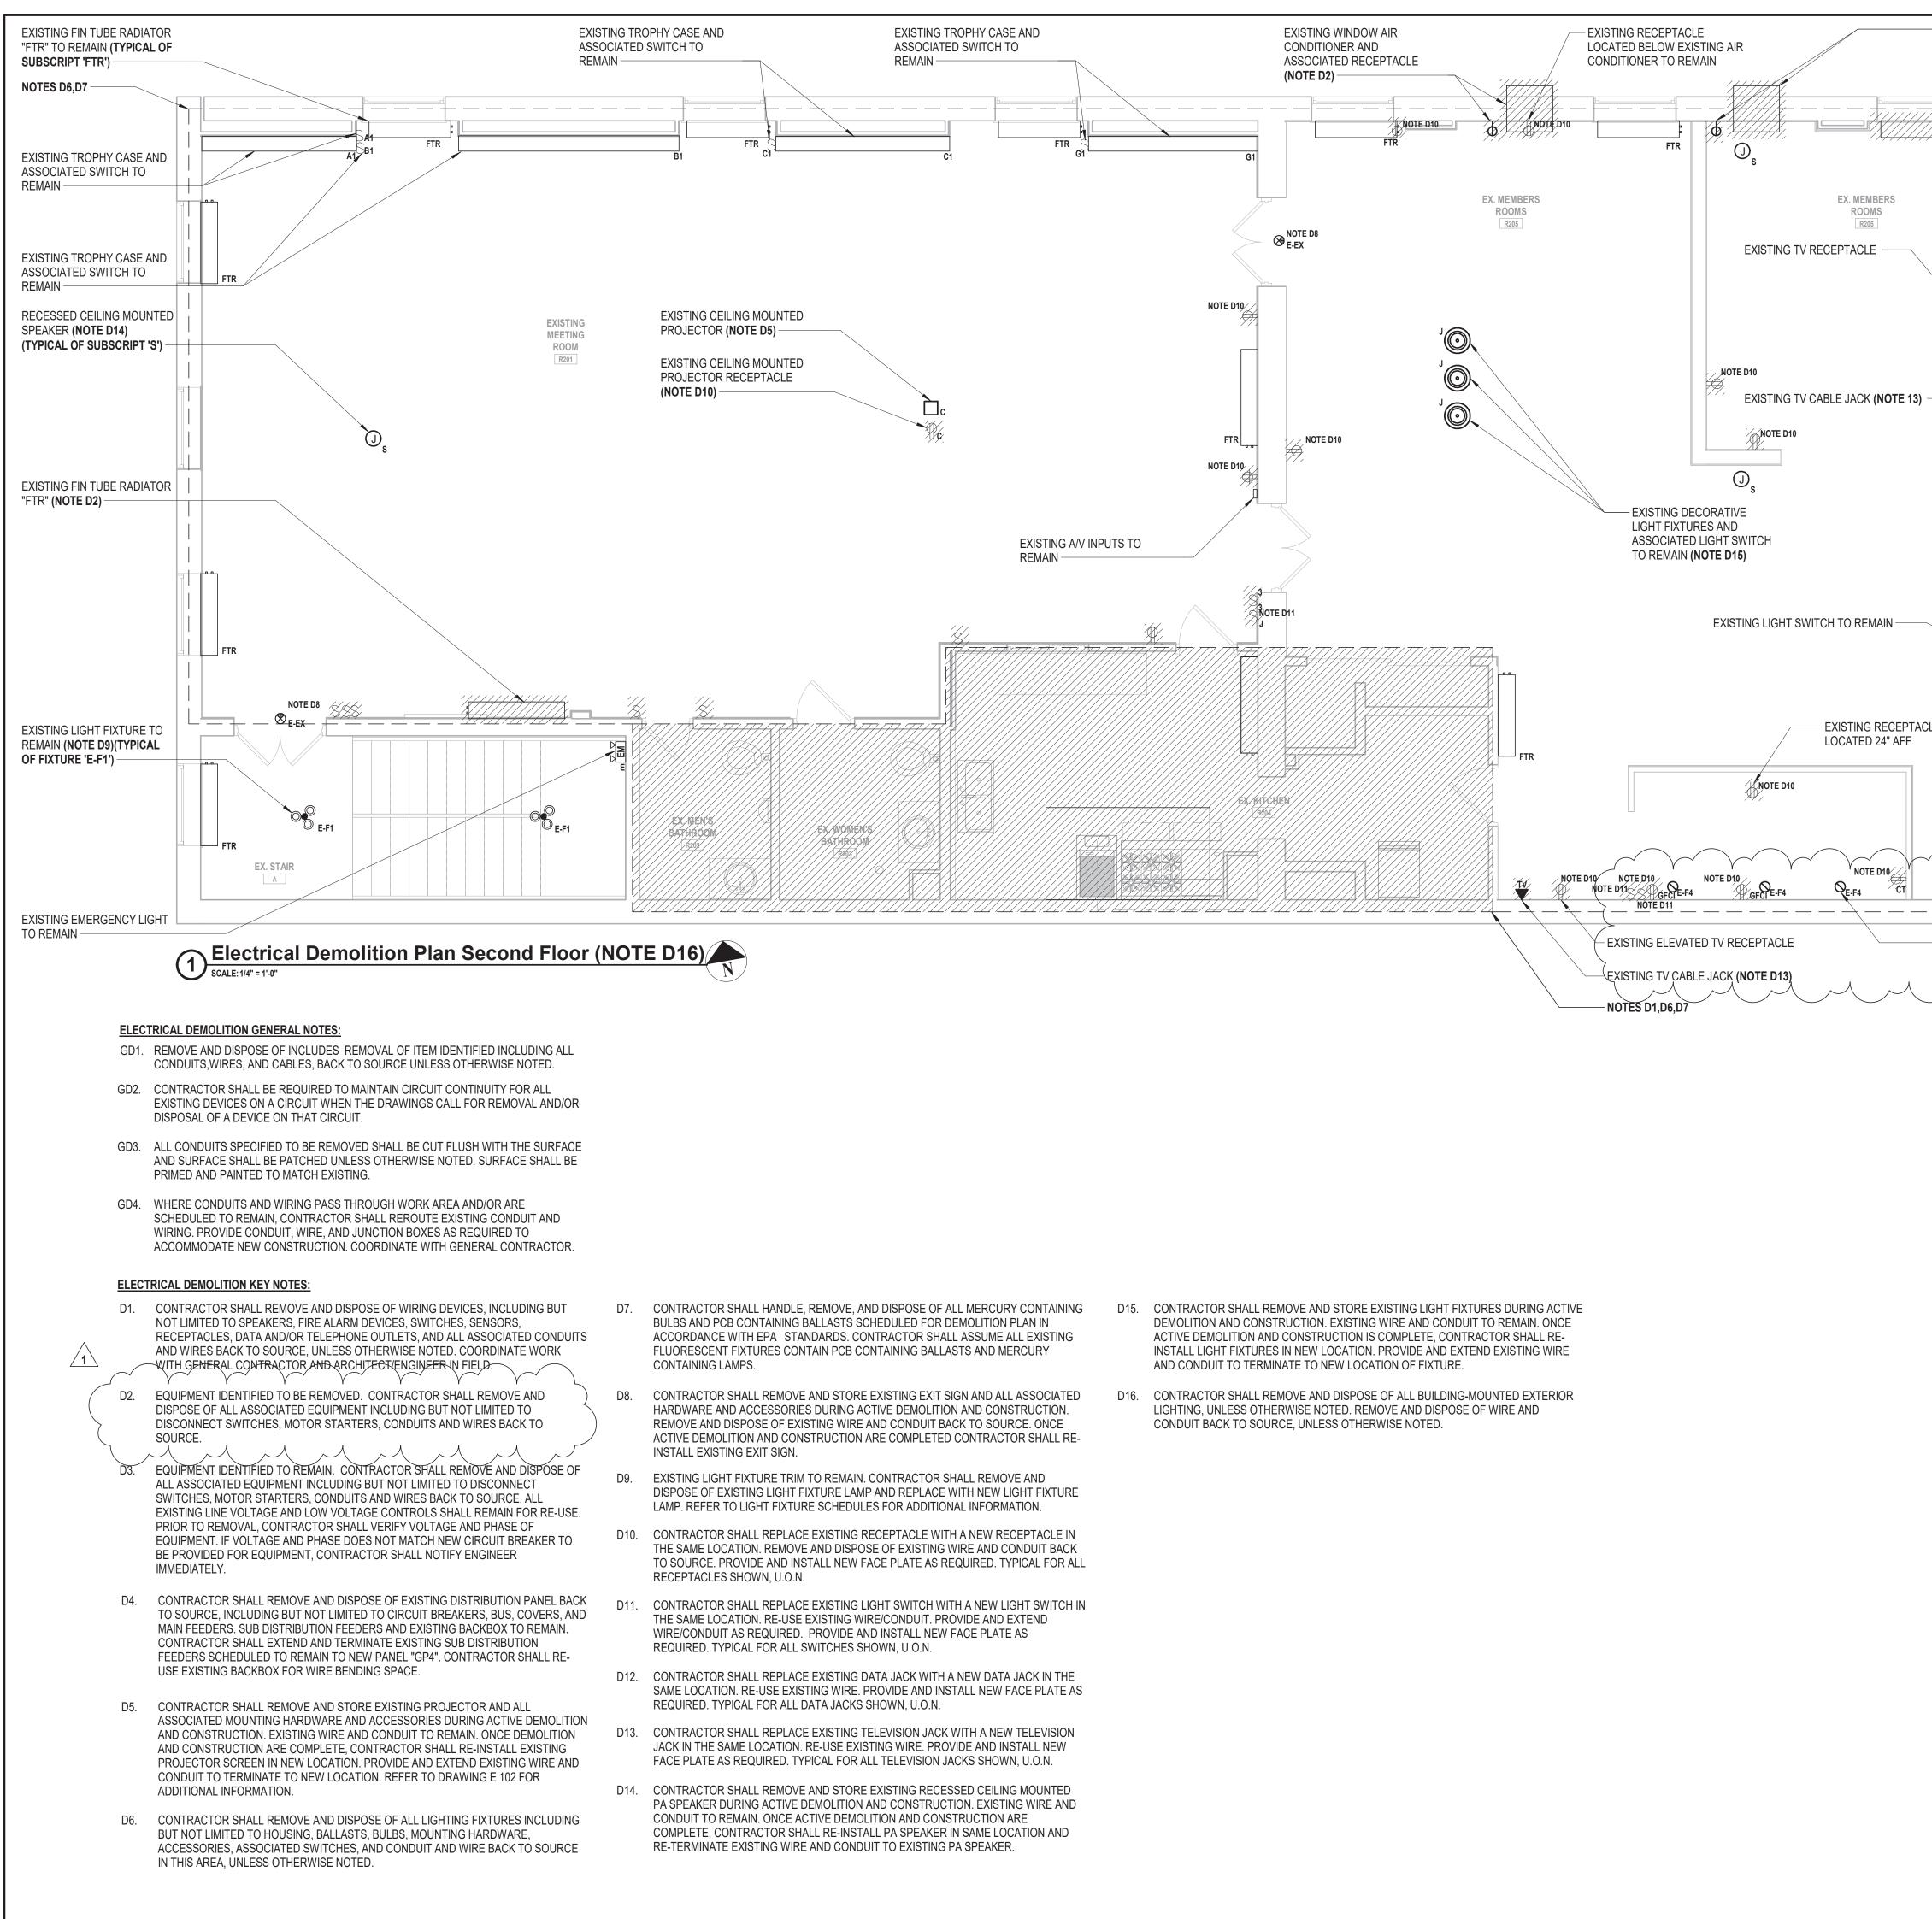
			ELECTRICAL SHEET LIST				
DESCRIPTION	SYMBOL	DESCRIPTION	COMMENTS	Sheet Number	Sheet Name		architects
ABOVE FINISH FLOOR	T	LINE VOLTAGE THERMOSTAT, 120V, 10A.		E 001	ELECTRICAL GENERAL NOTES AND LEGENDS		+
ABOVE FINISH CEILING		CIRCUIT BREAKER WITH TRIP AND POLES AS NOTED.		ED 111 ED 112	ELECTRICAL DEMOLITION PLAN FIRST FLOOR ELECTRICAL DEMOLITION PLAN SECOND FLOOR		engineers
ABOVE FINISH GRADE	• •			ED 113	ELECTRICAL DEMOLITION PLAN ROOF		, , , , , , , , , , , , , , , , , , ,
AMPERE AUTOMATIC TRANSFER SWITCH; SEE TRANSFER SWITCH SCHEDULE	TS1	TRANSFER SWITCH TS1; SEE TRANSFER SWITCH SCHEDULE.			ELECTRICAL SITE PLAN ELECTRICAL POWER PLAN FIRST FLOOR		
AMERICAN WIRE GAUGE) M.C.B 9/30A/2P			E 102	ELECTRICAL POWER PLAN SECOND FLOOR		
BELOW FINISHED CEILING	PANEL "P1"	DISTRIBUTION PANEL P1 WITH 30A, 2 POLE M.C.B.; SEE DISTRIBUTION PANEL SCHEDULE.		E 111 E 112	ELECTRICAL HVAC POWER PLAN FIRST FLOOR ELECTRICAL HVAC POWER PLAN SECOND FLOOR	3 Lear Jet Lane Latham, NY	12110
CENTERLINE					ELECTRICAL HVAC POWER PLAN ROOF	518.765.5105 • wv	w.h2m.com
	•	DISCONNECT SWITCH DS1, 100A, 3 POLES; SEE DISCONNECT SWITCH SCHEDULE.		E 121 E 122	ELECTRICAL LIGHTING PLAN FIRST FLOOR ELECTRICAL LIGHTING PLAN SECOND FLOOR		
ELECTRICAL CONDUIT GROUND FAULT CIRCUIT INTERRUPTER	DS3 100A/3P	FUSED DISCONNECT SWITCH DS2, FUSED AT 40A, 3 POLES; SEE DISCONNECT SWITCH SCHEDULE		E 140 E 500	ELECTRICAL GENERATOR PLAN ELECTRICAL DETAILS	CONSULTANTS:	
GROUND FAULT INDICATOR		TOSED DISCONNECT SWITCH DS2, TOSED AT 40A, 3 FOLES, SEE DISCONNECT SWITCH SCHEDOL		E 501	ELECTRICAL DETAILS		
CON EDISON (LOCAL ELECTRIC UTILITY)	•			E 540 E 600	ELECTRICAL GENERATOR DETAILS ELECTRICAL SCHEDULES		
	(G1)	GENERATOR SET G1		E 601	ELECTRICAL PANEL SCHEDULES		
MAIN LUGS ONLY NOT TO SCALE	M	ELECTRIC METER AND METER PAN AS PER PSEG REQUIREMENTS.		E 610	ELECTRICAL SINGLE LINE DIAGRAM		
UNLESS OTHERWISE NOTED	5	MOTOR, NUMBER INDICATED HORSEPOWER.				MARK DATE 1 1/19/2022 Adde	DESCRIPTION ndum #1
UNDERCOUNTER							
VOLTS							
		VOLTAGE TRANSFORMER.					
VOLT DIRECT CURRENT TRANSFORMER		TRANSFORMER WITH SIZE, PRIMARY AND SECONDARY VOLTAGES AS NOTED.					
WEATHERPROOF	RVRM						
	10	REDUCED VOLTAGE SOLID STATE RAMPING MODULE, SIZED FOR 10 H.P.					
	RVSS 150	REDUCED VOLTAGE SOLID STATE STARTER, SIZED FOR 150 H.P.					
	VFD 25	VARIABLE FREQUENCY DRIVE, RATED FOR 25 H.P.					
		FULL VOLTAGE NON-REVERSING STARTER, NEMA SIZE 6					
	FVR	FULL VOLTAGE REVERSING STARTER, NEMA SIZE 5					
	JJS	FAST ACTING SOLID STATE FUSES AS PER MANUFACTURER.					
		MULTIPLE BRANCH CIRCUITS AS REQUIRED.					
		CONTROL CIRCUIT; MIN 2 #12 AWG IN 3/4" E.C.					
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	CAT6 CA LOCATIO C CAMERA PROGRA	MOUNTED IP ENABLED CAMERA SHALL BE PROVIDED AND INSTALLED BY DISTRICT. PROVIDE ABLE TO PATCH PANEL IN SECOND FLOOR OFFICE. COORDINATE RACK AND PUNCH DOWN ON WITH I.T. DEPARTMENT. AT PATCH PANEL, LABEL CABLE WITH ROOM NUMBER/NAME. AT A, LABEL CABLE WITH IDF RACK NUMBER, PATCH PANEL NUMBER, AND PORT NUMBER. ALL AMMING AND LICENSING OF CAMERAS TO BE BY DISTRICT. COORDINATE EXACT MOUNTING , LOCATION, AND AIMING ANGLE WITH DISTRICT.	FLUSH			ADDITIONS AND AI	
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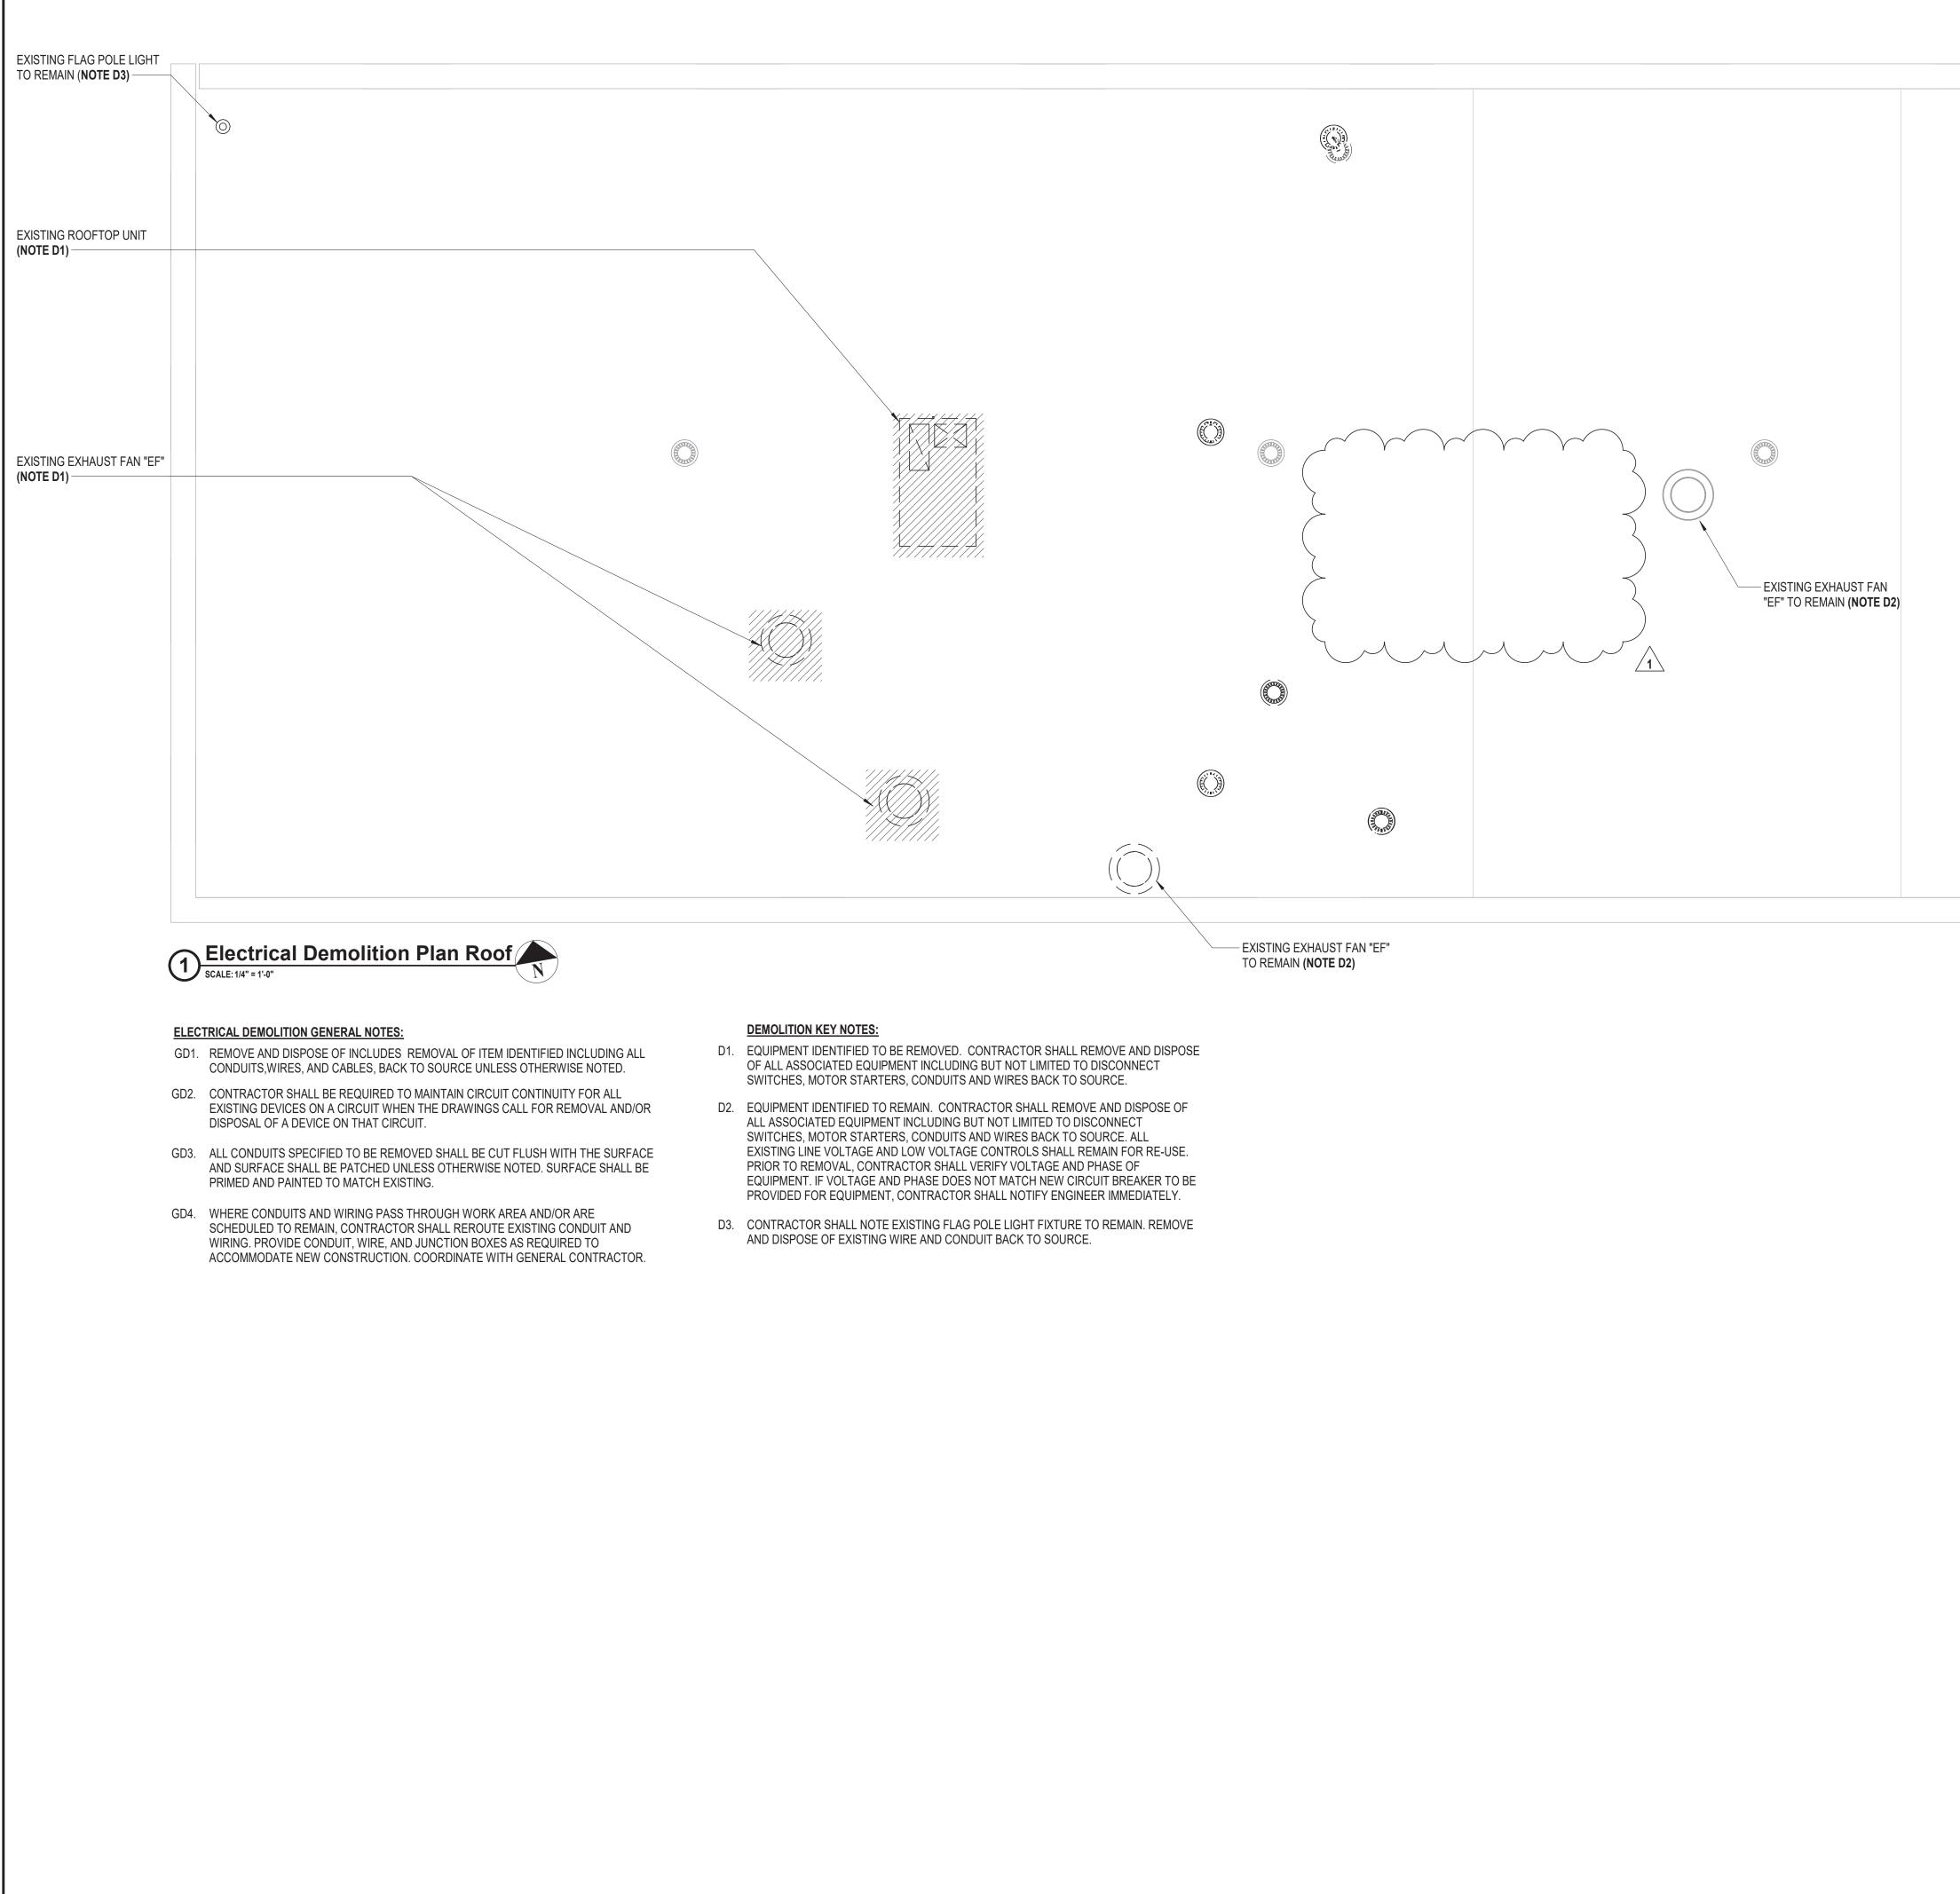




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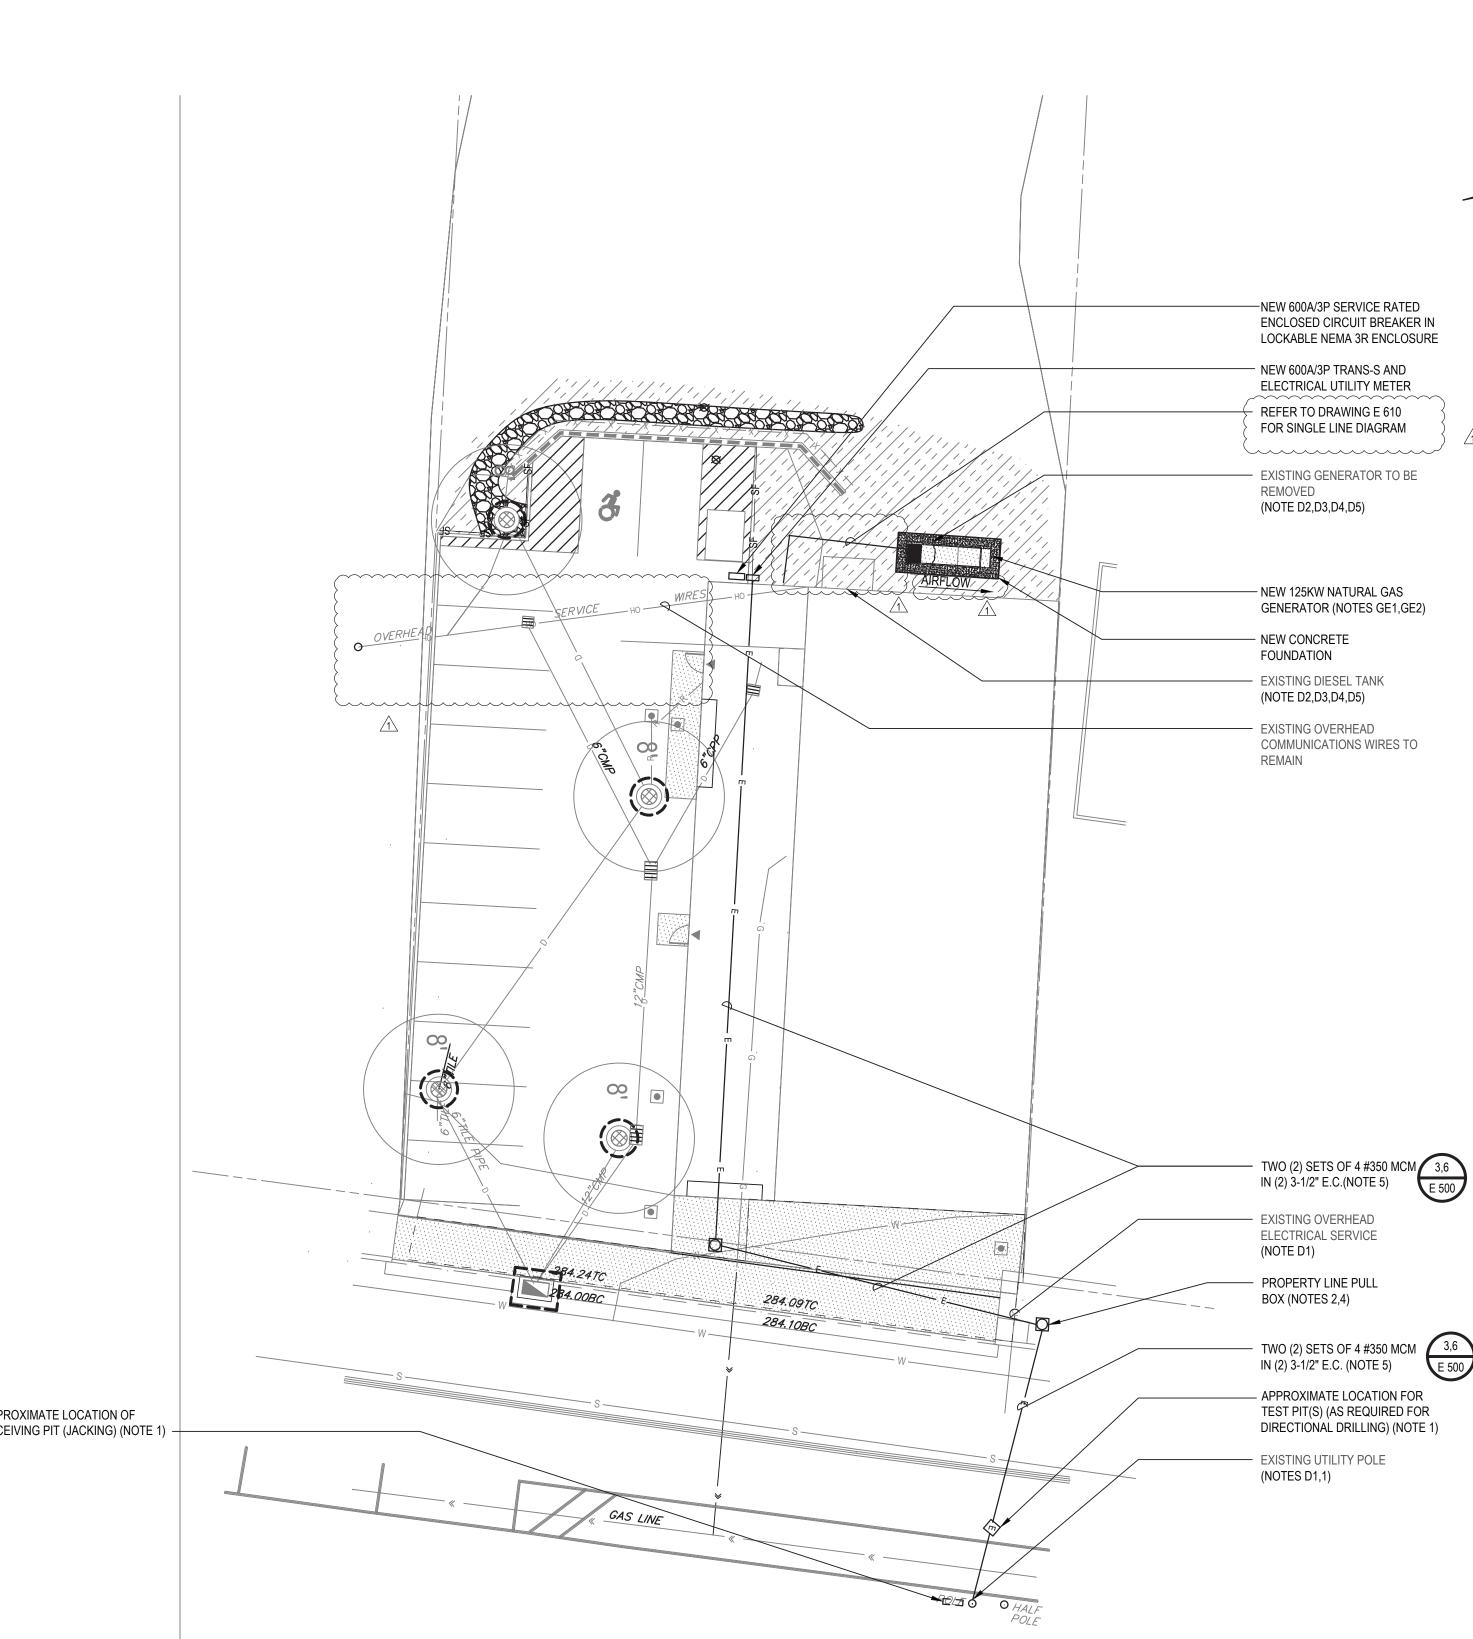


EXISTING WINDOW AIR CONDITIONER AND ASSOCIATED RÉCEPTACLÉ (NOTE D2) EXISTING FIN TUBE RADIATOR "FTR" (NOTE D2)	H 2 architects
EXISTING LIGHT SWITCH TO REMAIN EXISTING LIGHT.FIXTURE TO REMAIN (NOTE D9)	M engineers
D _s NOTE D10	3 Lear Jet Lane, Suite 205 Latham, NY 12110 518.765.5105 • www.h2m.com
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E-EX E-EX EXISTING 40A/3P SUB PANEL "LPL" (NOTE D4) EXISTING 100A/3P PANEL "P1" (NOTE D4)	
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APPROXIMATE LOCATION OF RECEIVING PIT (JACKING) (NOTE 1)





ELECTRICAL SITE PLAN GENERAL NOTES:

- G1. CONTRACTOR SHALL INSPECT CONSTRUCTION SITE PRIOR TO SUBMISSION OF BIDS AND SHALL MAKE NO ADDITIONAL CLAIMS REGARDING SITE CONDITIONS THEREAFTER.
- G2. LOCATION OF ALL UNDERGROUND UTILITIES BOTH PUBLIC AND CUSTOMER OWNED, WERE OBTAINED FROM EITHER MAPS, SURVEYS, DRAWINGS AND RECORDS SUPPLIED BY OTHERS. THE OWNER AND ENGINEER DO NOT GUARANTEE OR ACCEPT RESPONSIBILITY FOR ANY DAMAGE TO SUCH FACILITIES DUE TO DISCREPANCIES IN LOCATION AND SIZE SHOWN ON THE PLANS OR THOSE UTILITIES NOT SHOWN. THE CONTRACTOR IS RESPONSIBLE FOR OBTAINING A PRIVATE MARKOUT COMPANY FOR DETERMINING THE LOCATION OF ALL UNDERGROUND UTILITIES PRIOR TO BEGINNING WORK. CONTRACTOR SHALL LOCATE ALL UTILITIES WITHIN PROXIMITY OF CONSTRUCTION LIMITS.
- G3. CONTRACTOR SHALL COMPLETELY RESTORE ALL AREAS DISTURBED DURING CONSTRUCTION, INCLUDING BUT NOT LIMITED TO GRASS AREAS, LANDSCAPING, PAVEMENTS, SIDEWALKS, CURBING AND IN-GROUND SPRINKLER SYSTEMS.
- G4. THE CONTRACTOR SHALL PERFORM DAILY CLEAN-UP OPERATIONS WHICH INCLUDE REMOVAL OF DEBRIS AND EXCESS CONSTRUCTION MATERIAL TO THE SATISFACTION OF THE OWNER AND THE ENGINEER.
- G5. DURING ALL NON-WORKING HOURS, THE CONTRACTOR WILL BE REQUIRED TO STORE ALL EQUIPMENT AND MATERIALS WITHIN THE AREA DESIGNATED BY THE ENGINEER AT THE PROJECT SITE.
- G6. PROVIDE TEMPORARY FENCING TO PROTECT WORK AREAS.
- G7. CONTRACTOR SHALL MINIMIZE REMOVAL OF EXISTING TREES. CONTRACTOR SHALL BE RESPONSIBLE FOR SITE LAYOUT, TAGGING AND REMOVAL OF TREES REQUIRED TO COMPLETE ALL WORK. OWNER SHALL APPROVE TREES TO BE REMOVED PRIOR TO ACTUAL REMOVALS. REMOVALS SHALL INCLUDE REMOVAL OF COMPLETE STUMP AND ROOT SYSTEM. CONTRACTOR NOT PERMITTED TO GRIND STUMPS.
- G8. CONCRETE SIDEWALKS SHALL BE SAWCUT BACK TO EXPANSION/ CONTROL JOINTS.

DEMOLITION SITE PLAN NOTES:

- D1. CON EDISON SHALL REMOVE AND DISPOSE OF EXISTING SERVICE AND SERVICE RISER ONCE NEW SERVICE IS INSTALLED. CONTRACTOR SHALL REMOVE AND DISPOSE OF EXISTING SECONDARY SERVICE CONDUCTORS AND ALL ASSOCIATED CONDUIT. CONTRACTOR SHALL REPAIR SURFACES TO MATCH EXISTING. CONTRACTOR SHALL COORDINATE REMOVAL OF EXISTING POLE MOUNTED UTILITY TRANSFORMERS WITH CON EDISON.
- D2. CONTRACTOR SHALL REMOVE AND DISPOSE OF EXISTING GENERATOR, DIESEL FUEL TANK AND CONCRETE CONTAINMENT STRUCTURE IN ACCORDANCE WITH EPA STANDARDS. UNREGISTER TANK AS REQUIRED. REMOVE AND DISPOSE OF INCLUDES ALL
- FUEL PIPING, ELECTRICAL WIRING, AND CONDUIT BACK TO SOURCE D3. CONTRACTOR SHALL REMOVE ANY REMAINING STORED PRODUCT AND ACCUMULATED SLUDGE/SOLIDS REMAINING IN TANKS TO THE SATISFACTION OF THE NEW YORK STATE D.E.C.
- D4. REMOVAL AND DISPOSAL OF THE DIESEL STORAGE TANK WILL INCLUDE THE CONTRACTOR'S RESPONSIBILITY TO CONTACT AND COORDINATE WITH N.Y.S. DEC AND COMPLY WITH THE REQUIREMENTS FOR INSPECTION AND RECORDS KEEPING.
- D5. REMOVAL OF THE DIESEL STORAGE TANK WILL INCLUDE THE STEEL TANK, CONCRETE SLAB, FILL BOXES, VENTS, PRODUCT PIPING AND TANK MONITORING.

SITE PLAN NOTES:

- 1. NEW ELECTRIC SERVICE RISER AS PER UTILITY REQUIREMENTS. CONTRACTOR SHALL COORDINATE WITH CON EDISON.
- 2. NEW PROPERTY LINE PULL BOX SHALL BE AS PER UTILITY REQUIREMENTS.
- 3. CONTRACTOR SHALL OBTAIN THE SERVICES OF A DIRECTIONAL DRILLING SUB-CONTRACTOR FOR EXACT LOCATIONS OF DRILLING EQUIPMENT TEST PITS. SUB-CONTRACTOR TO DIRECTIONAL DRILL CONDUITS UNDER ROAD TO NEW UTILITY POLE. SUB-CONTRACTOR SHALL PROVIDE ALL TEST PITS AS REQUIRED. CONTRACTOR SHALL OBTAIN AND PAY FOR ALL ASSOCIATED DIRECTIONAL DRILLING SUB-CONTRACTOR COSTS AND PERMITS.
- 4. CONTRACTOR SHALL PROVIDE AND INSTALL NEW PULLBOX. SITE PLAN SHOWS MINIMUM REQUIRED PULL BOXES. PROVIDE ADDITIONAL PULL BOXES AS REQUIRED BY NEC AND UTILITY SERVICE REQUIREMENTS.
- 5. SAW-CUT EXISTING PAVEMENT/SIDEWALK/CURBING FOR INSTALLATION OF NEW CONDUITS. REMOVE AND DISPOSE OF ALL DEBRIS.

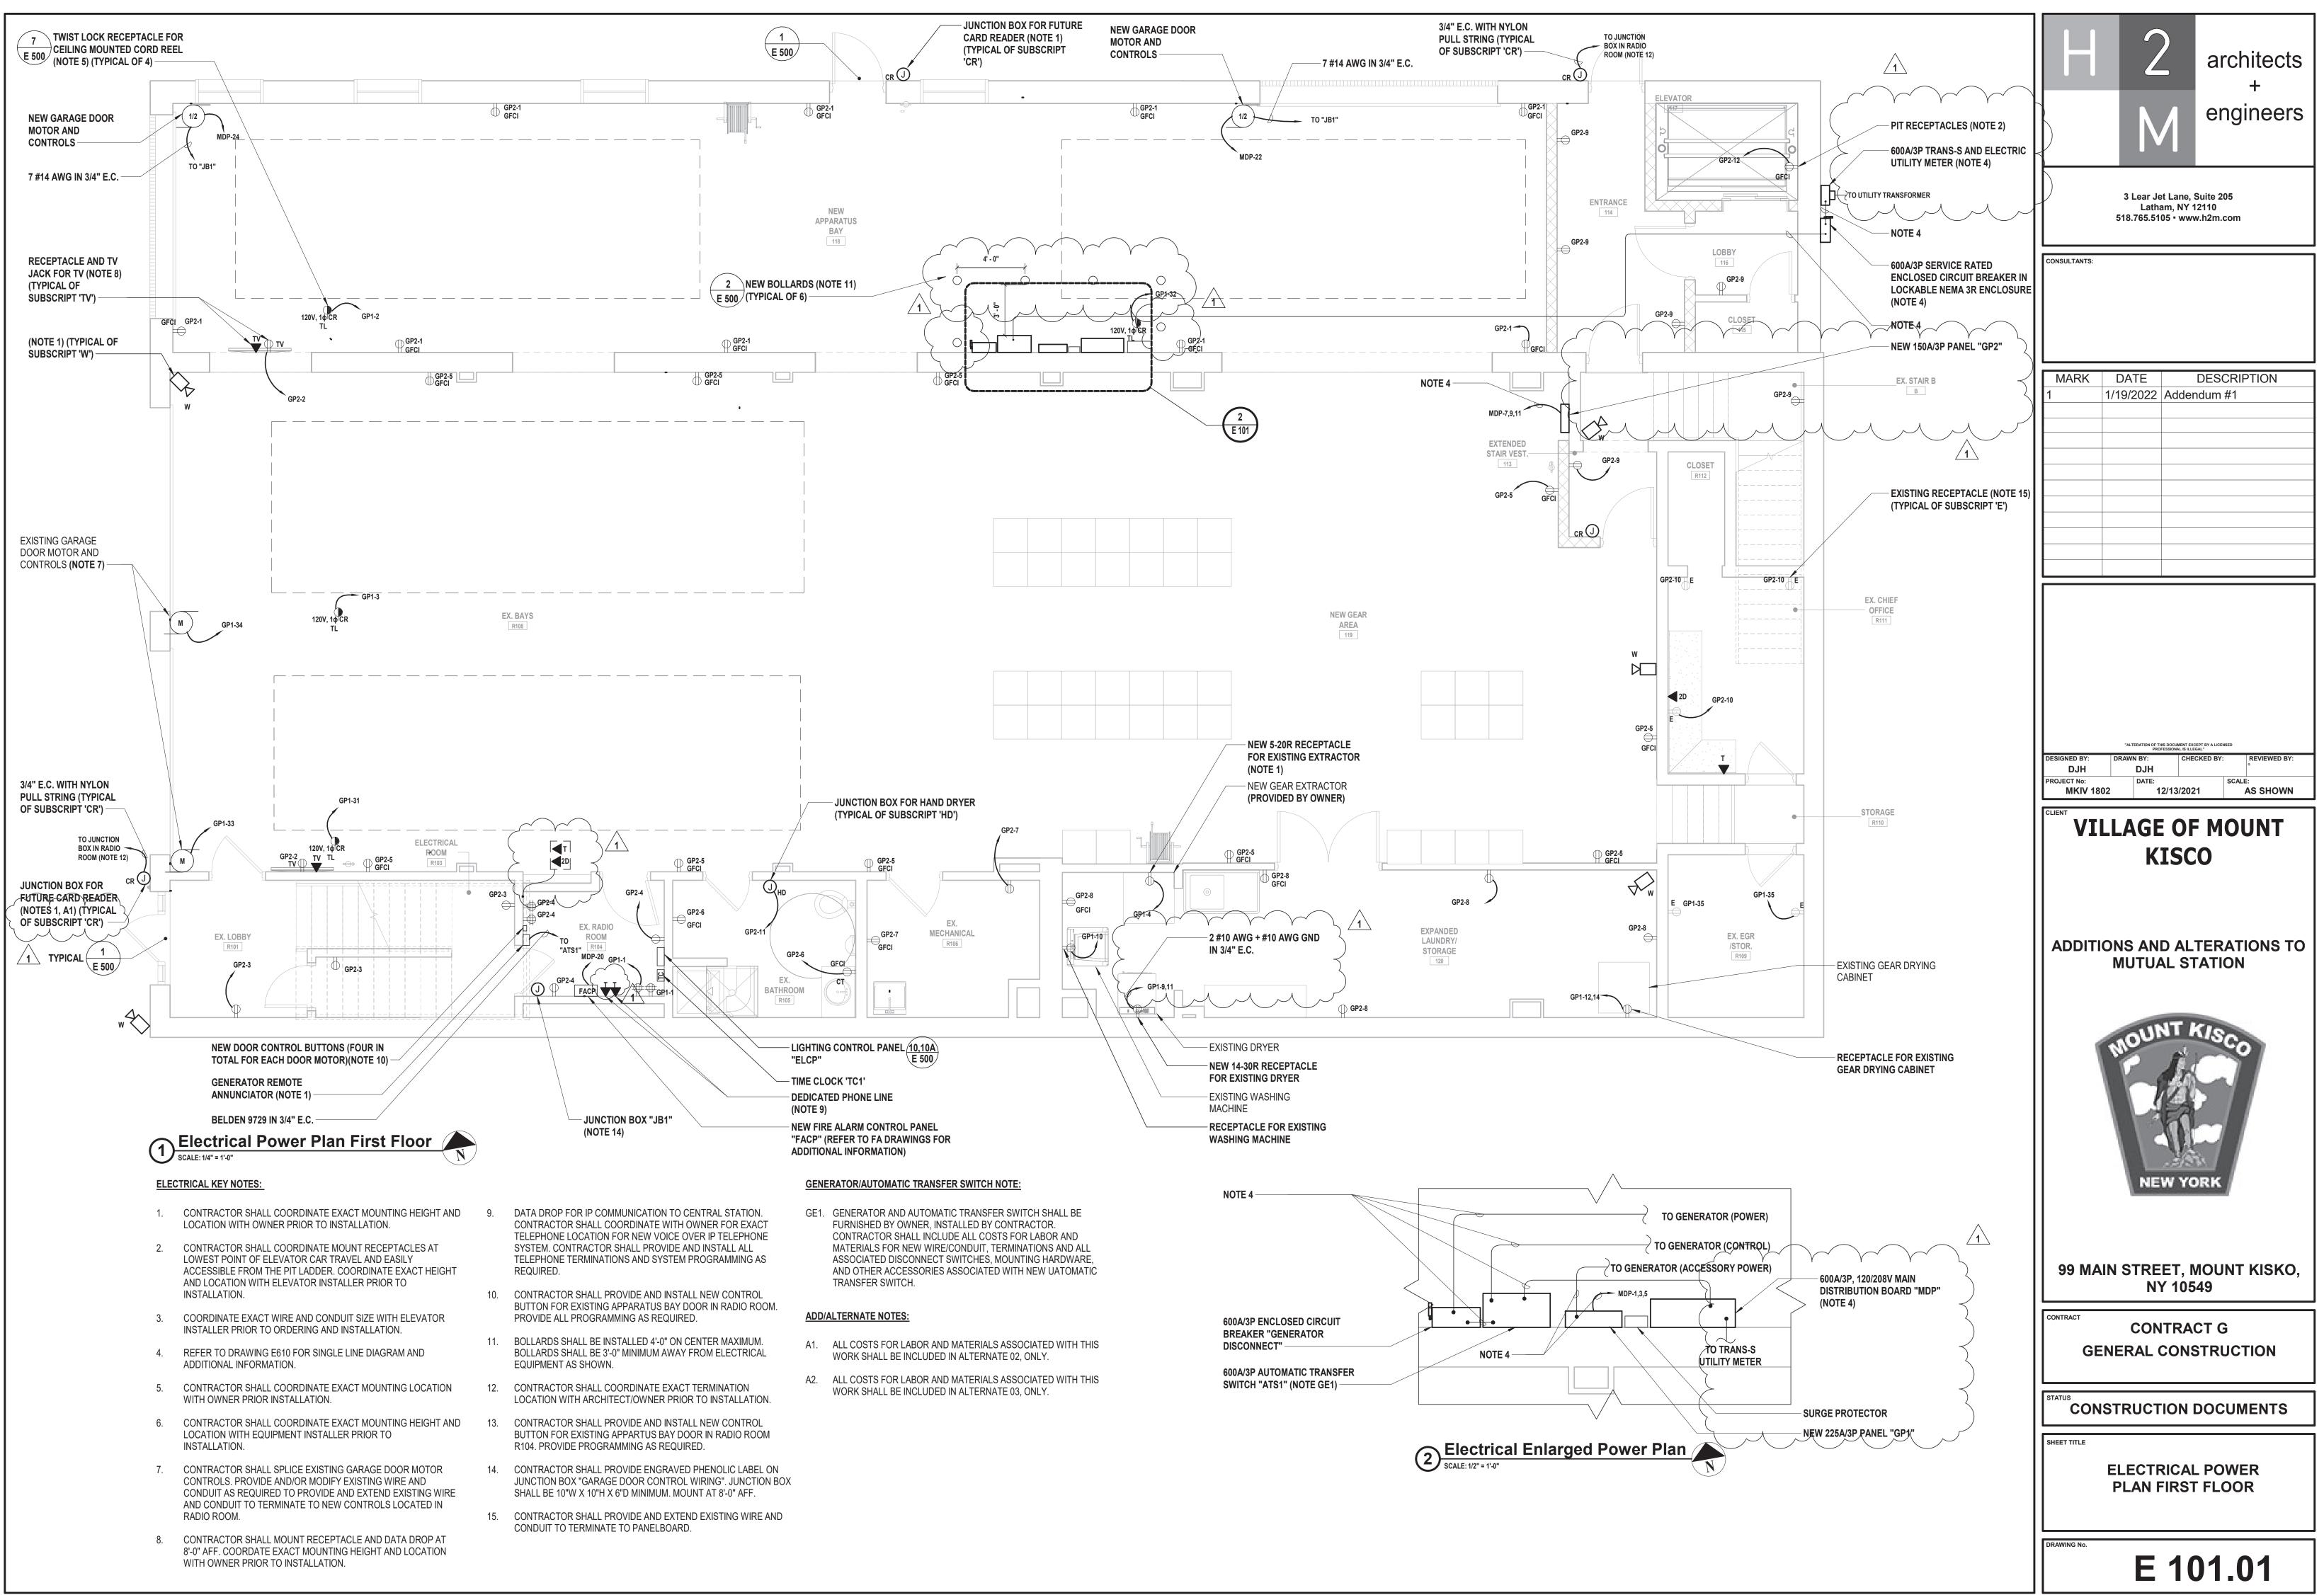
GENERATOR NOTE:

- GE1. NEW GENERATOR AND CONCRETE FOUNDATION. GENERATOR SHALL BE PROVIDED BY DISTRICT AND INSTALLED BY CONTRACTOR. EXACT INSTALLATION LOCATION OF GENERATOR AND CONCRETE FOUNDATION SHALL BE COORDINATED WITH DISTRICT AND ENGINEER. FINAL LOCATION SHALL BE STAKED OUT AND APPROVED PRIOR TO INSTALLATION.
- GE2. CONTRACTOR SHALL PROVIDE ALL RIGGING OF GENSET INTO FINAL LOCATION. CONTRACTOR SHALL COORDINATE ALL CONDUIT AND GAS PIPING STUB UP LOCATIONS WITH OWNER PROVIDED GENSET AND CONCRETE PAD PRIOR TO CONSTRUCTION.

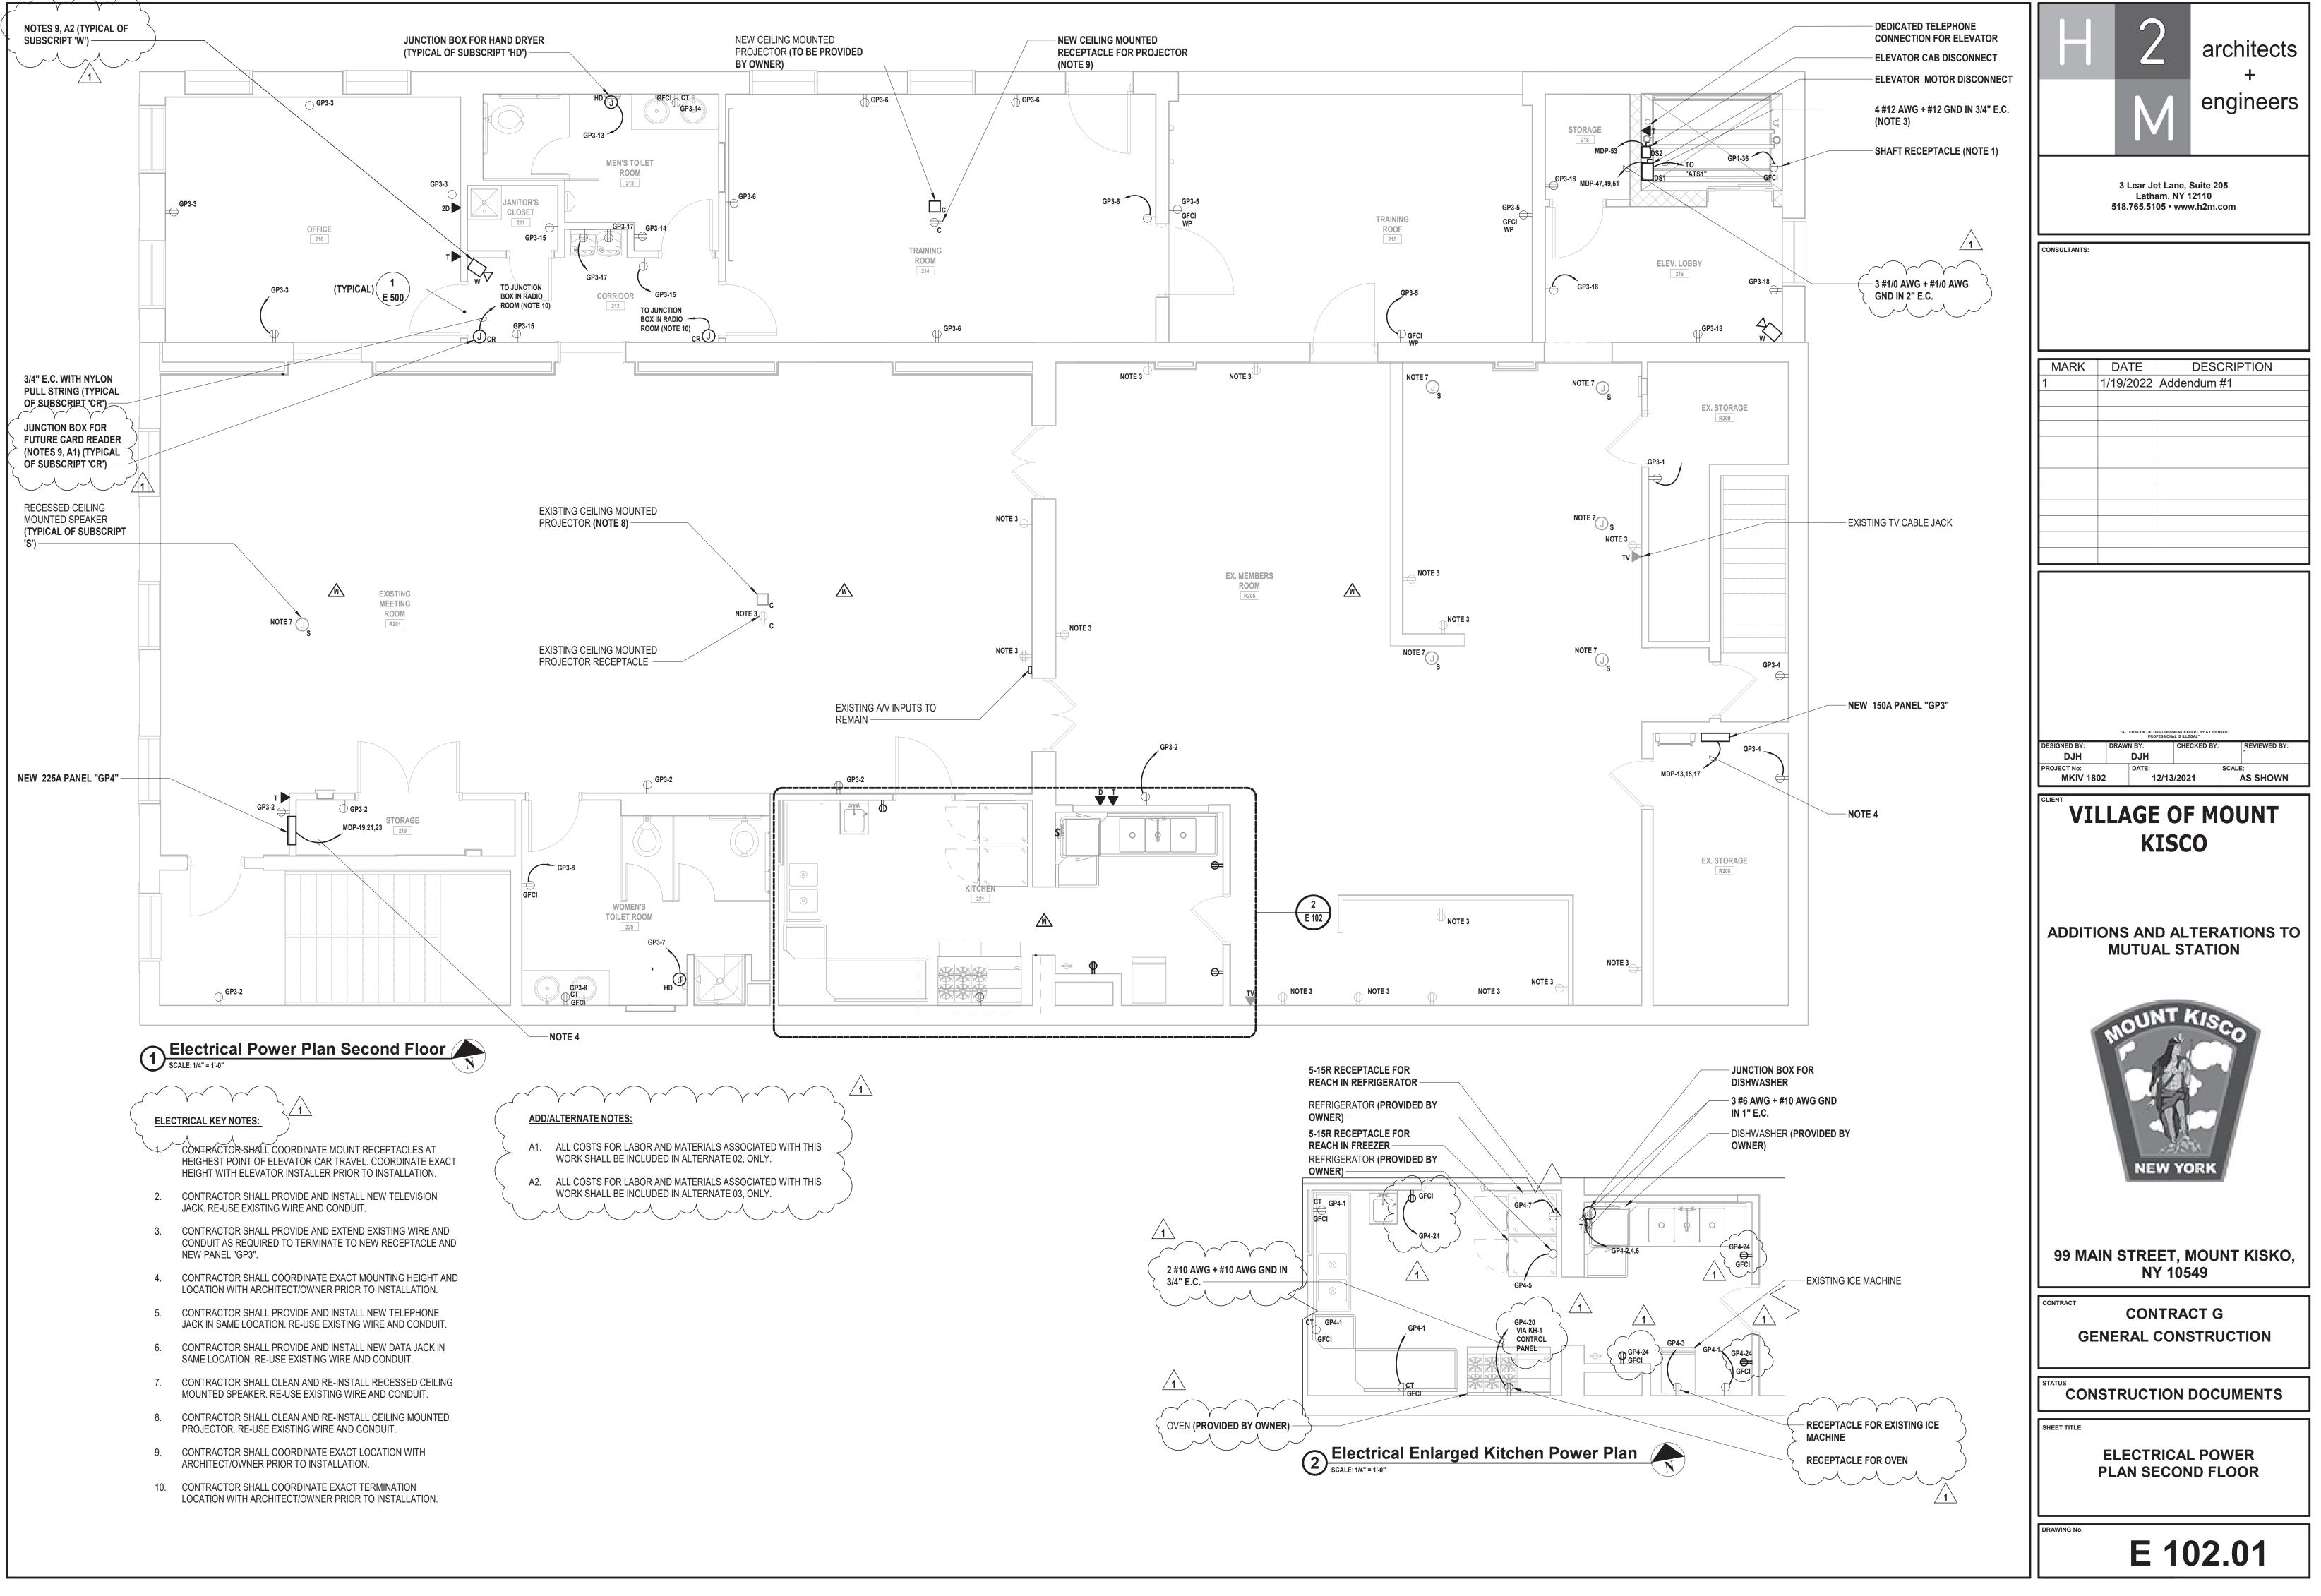
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3 Lear Jet Lane, Suite 205 Latham, NY 12110 518.765.5105 • www.h2m.com						
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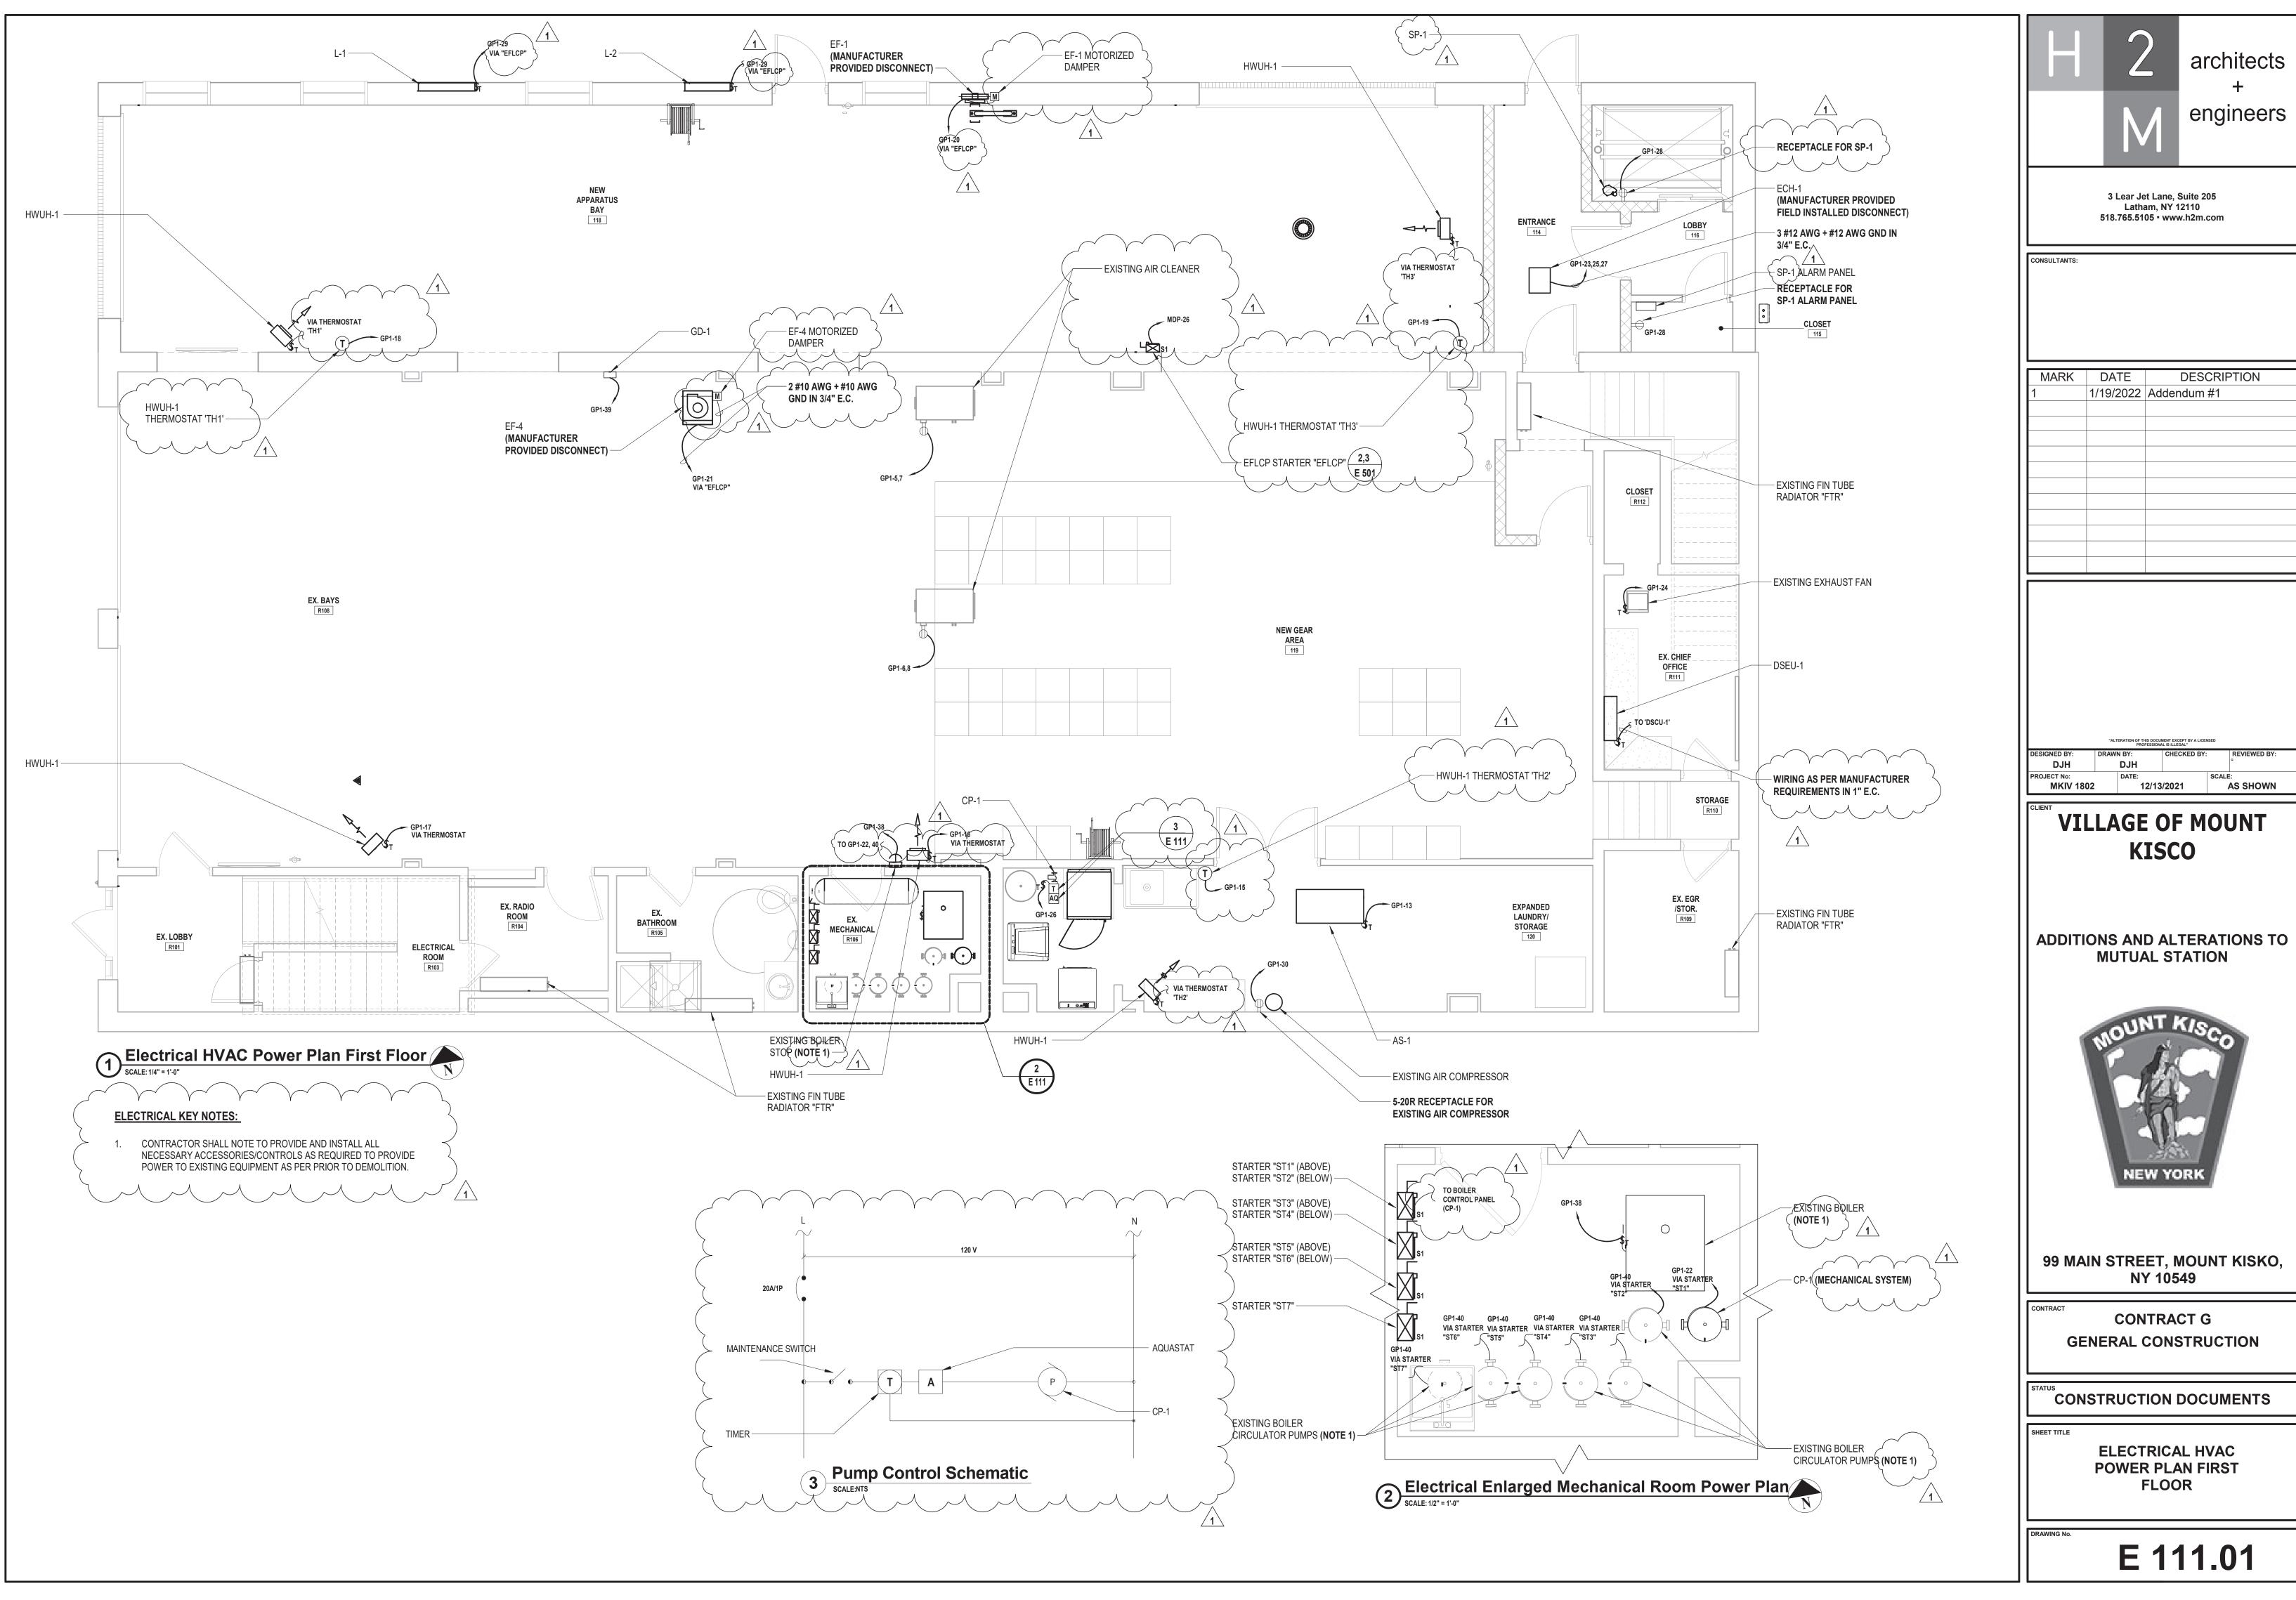
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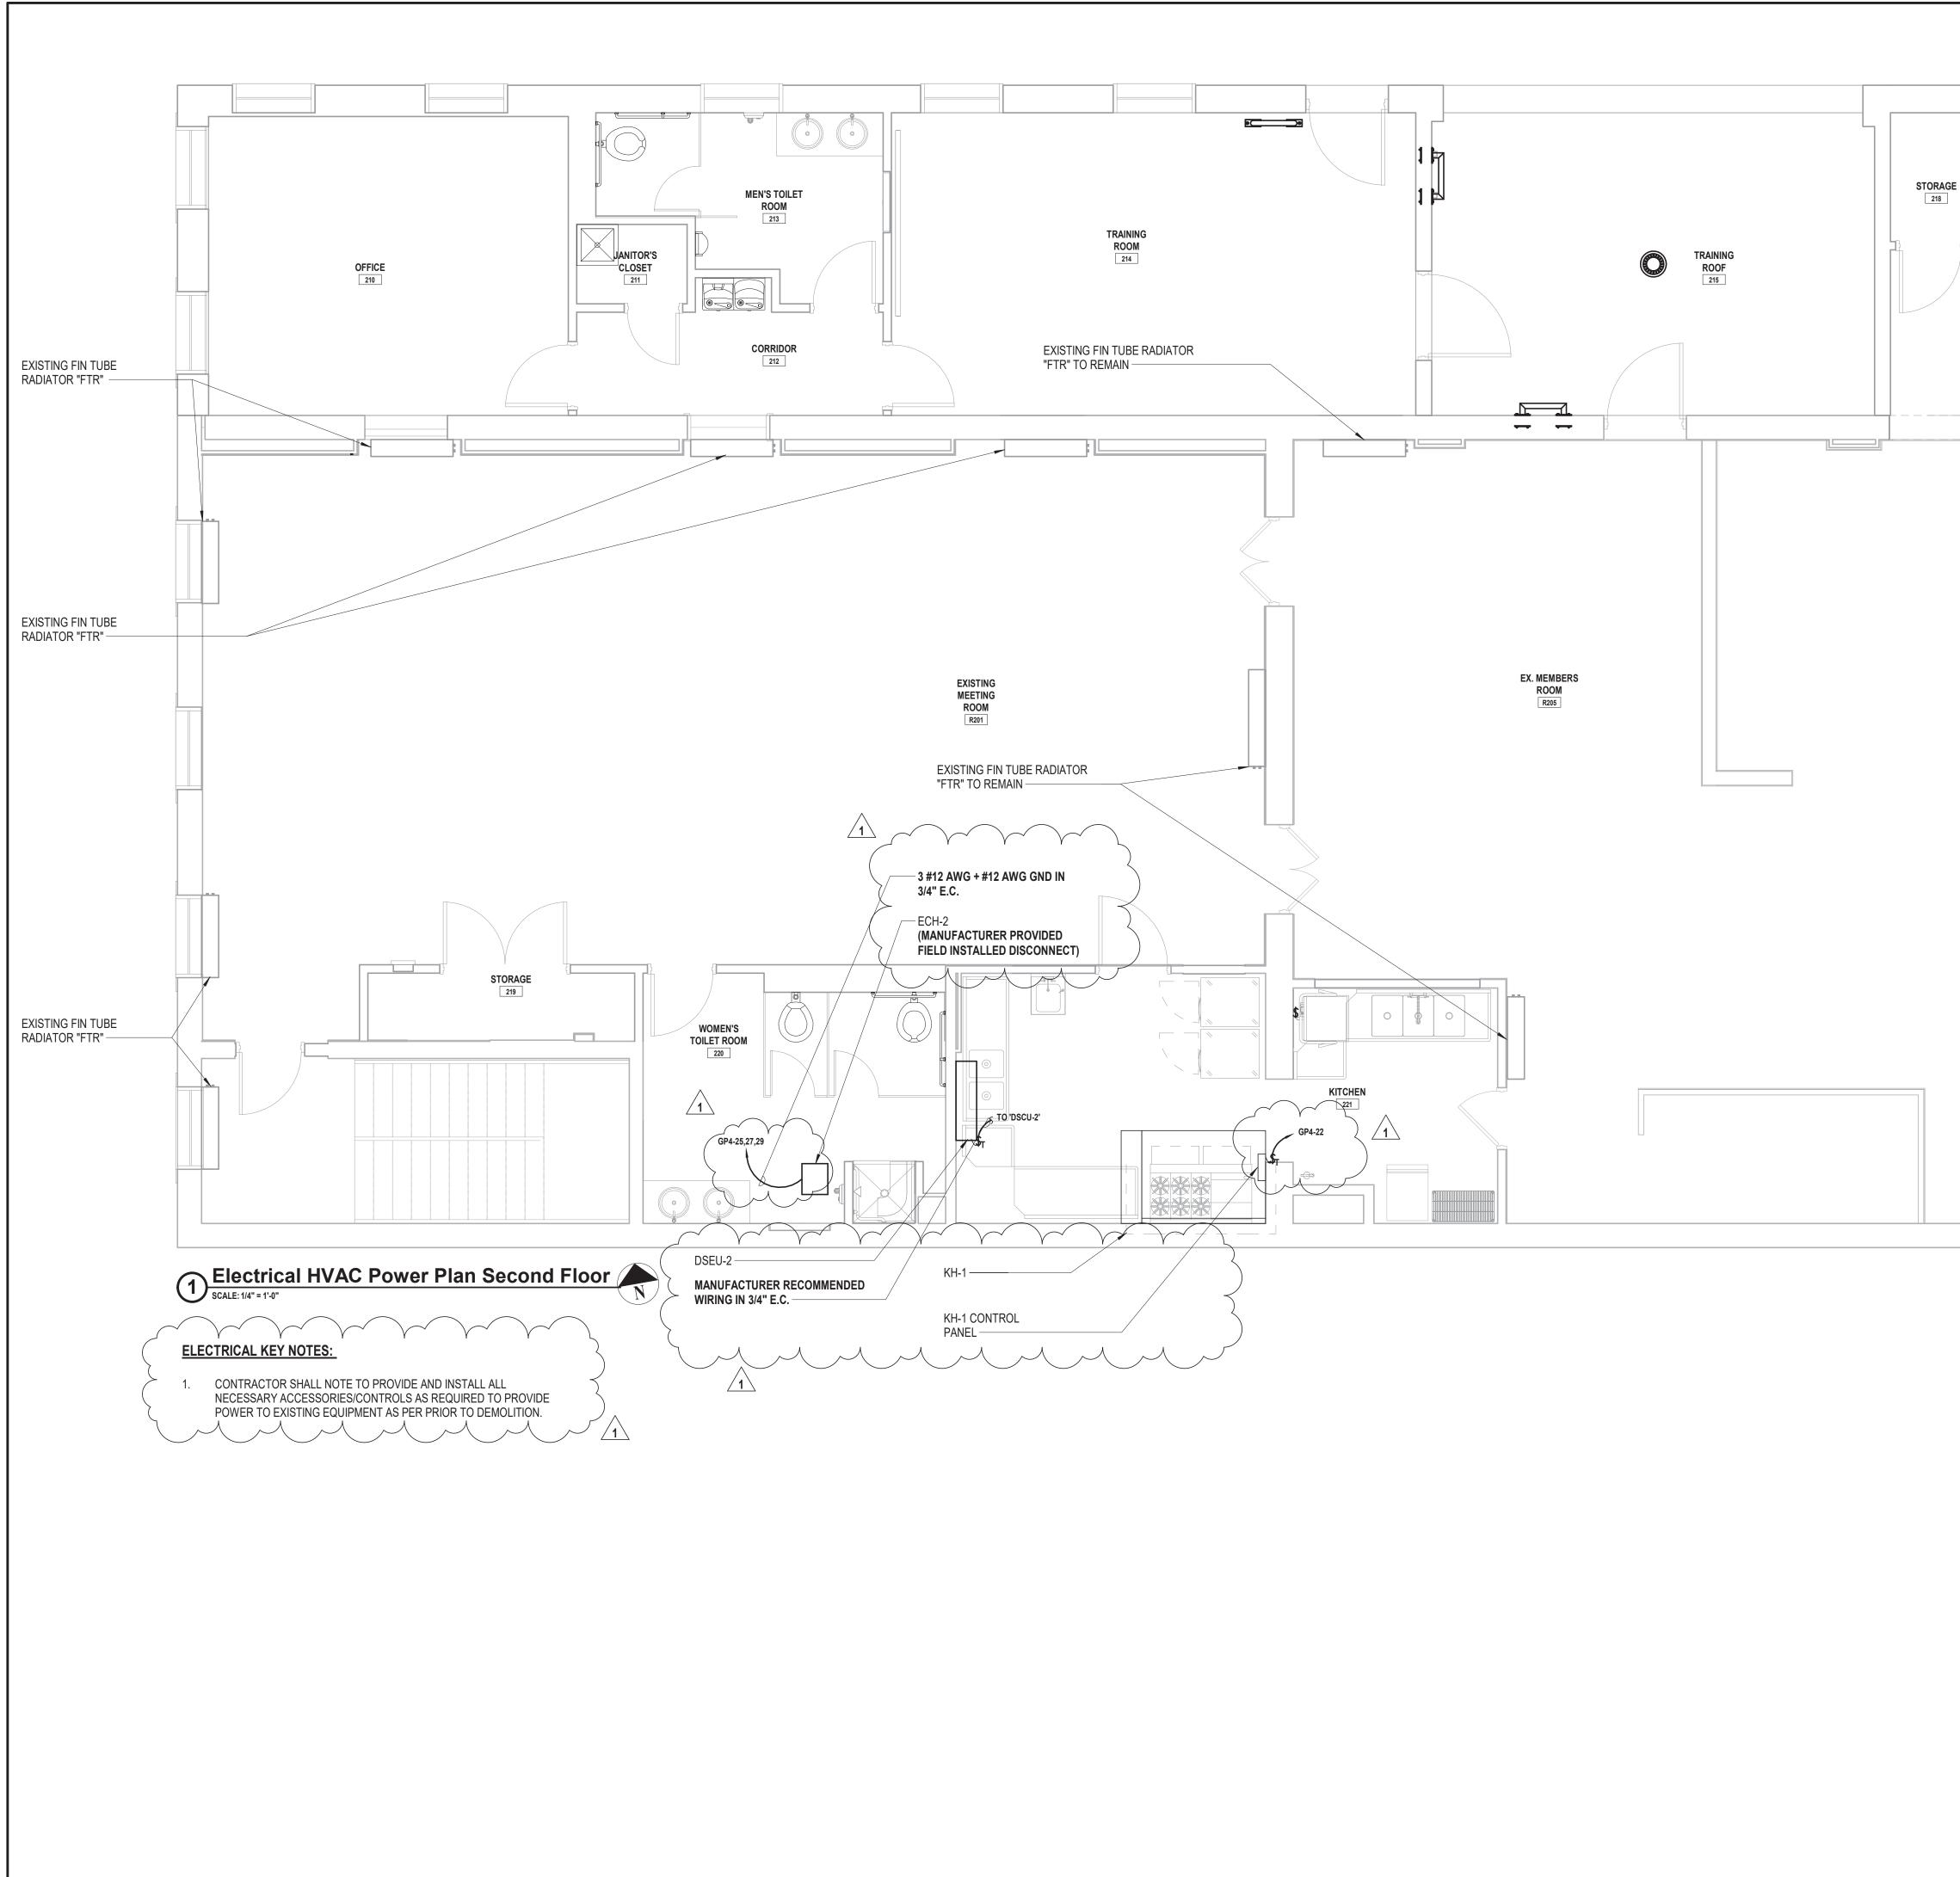
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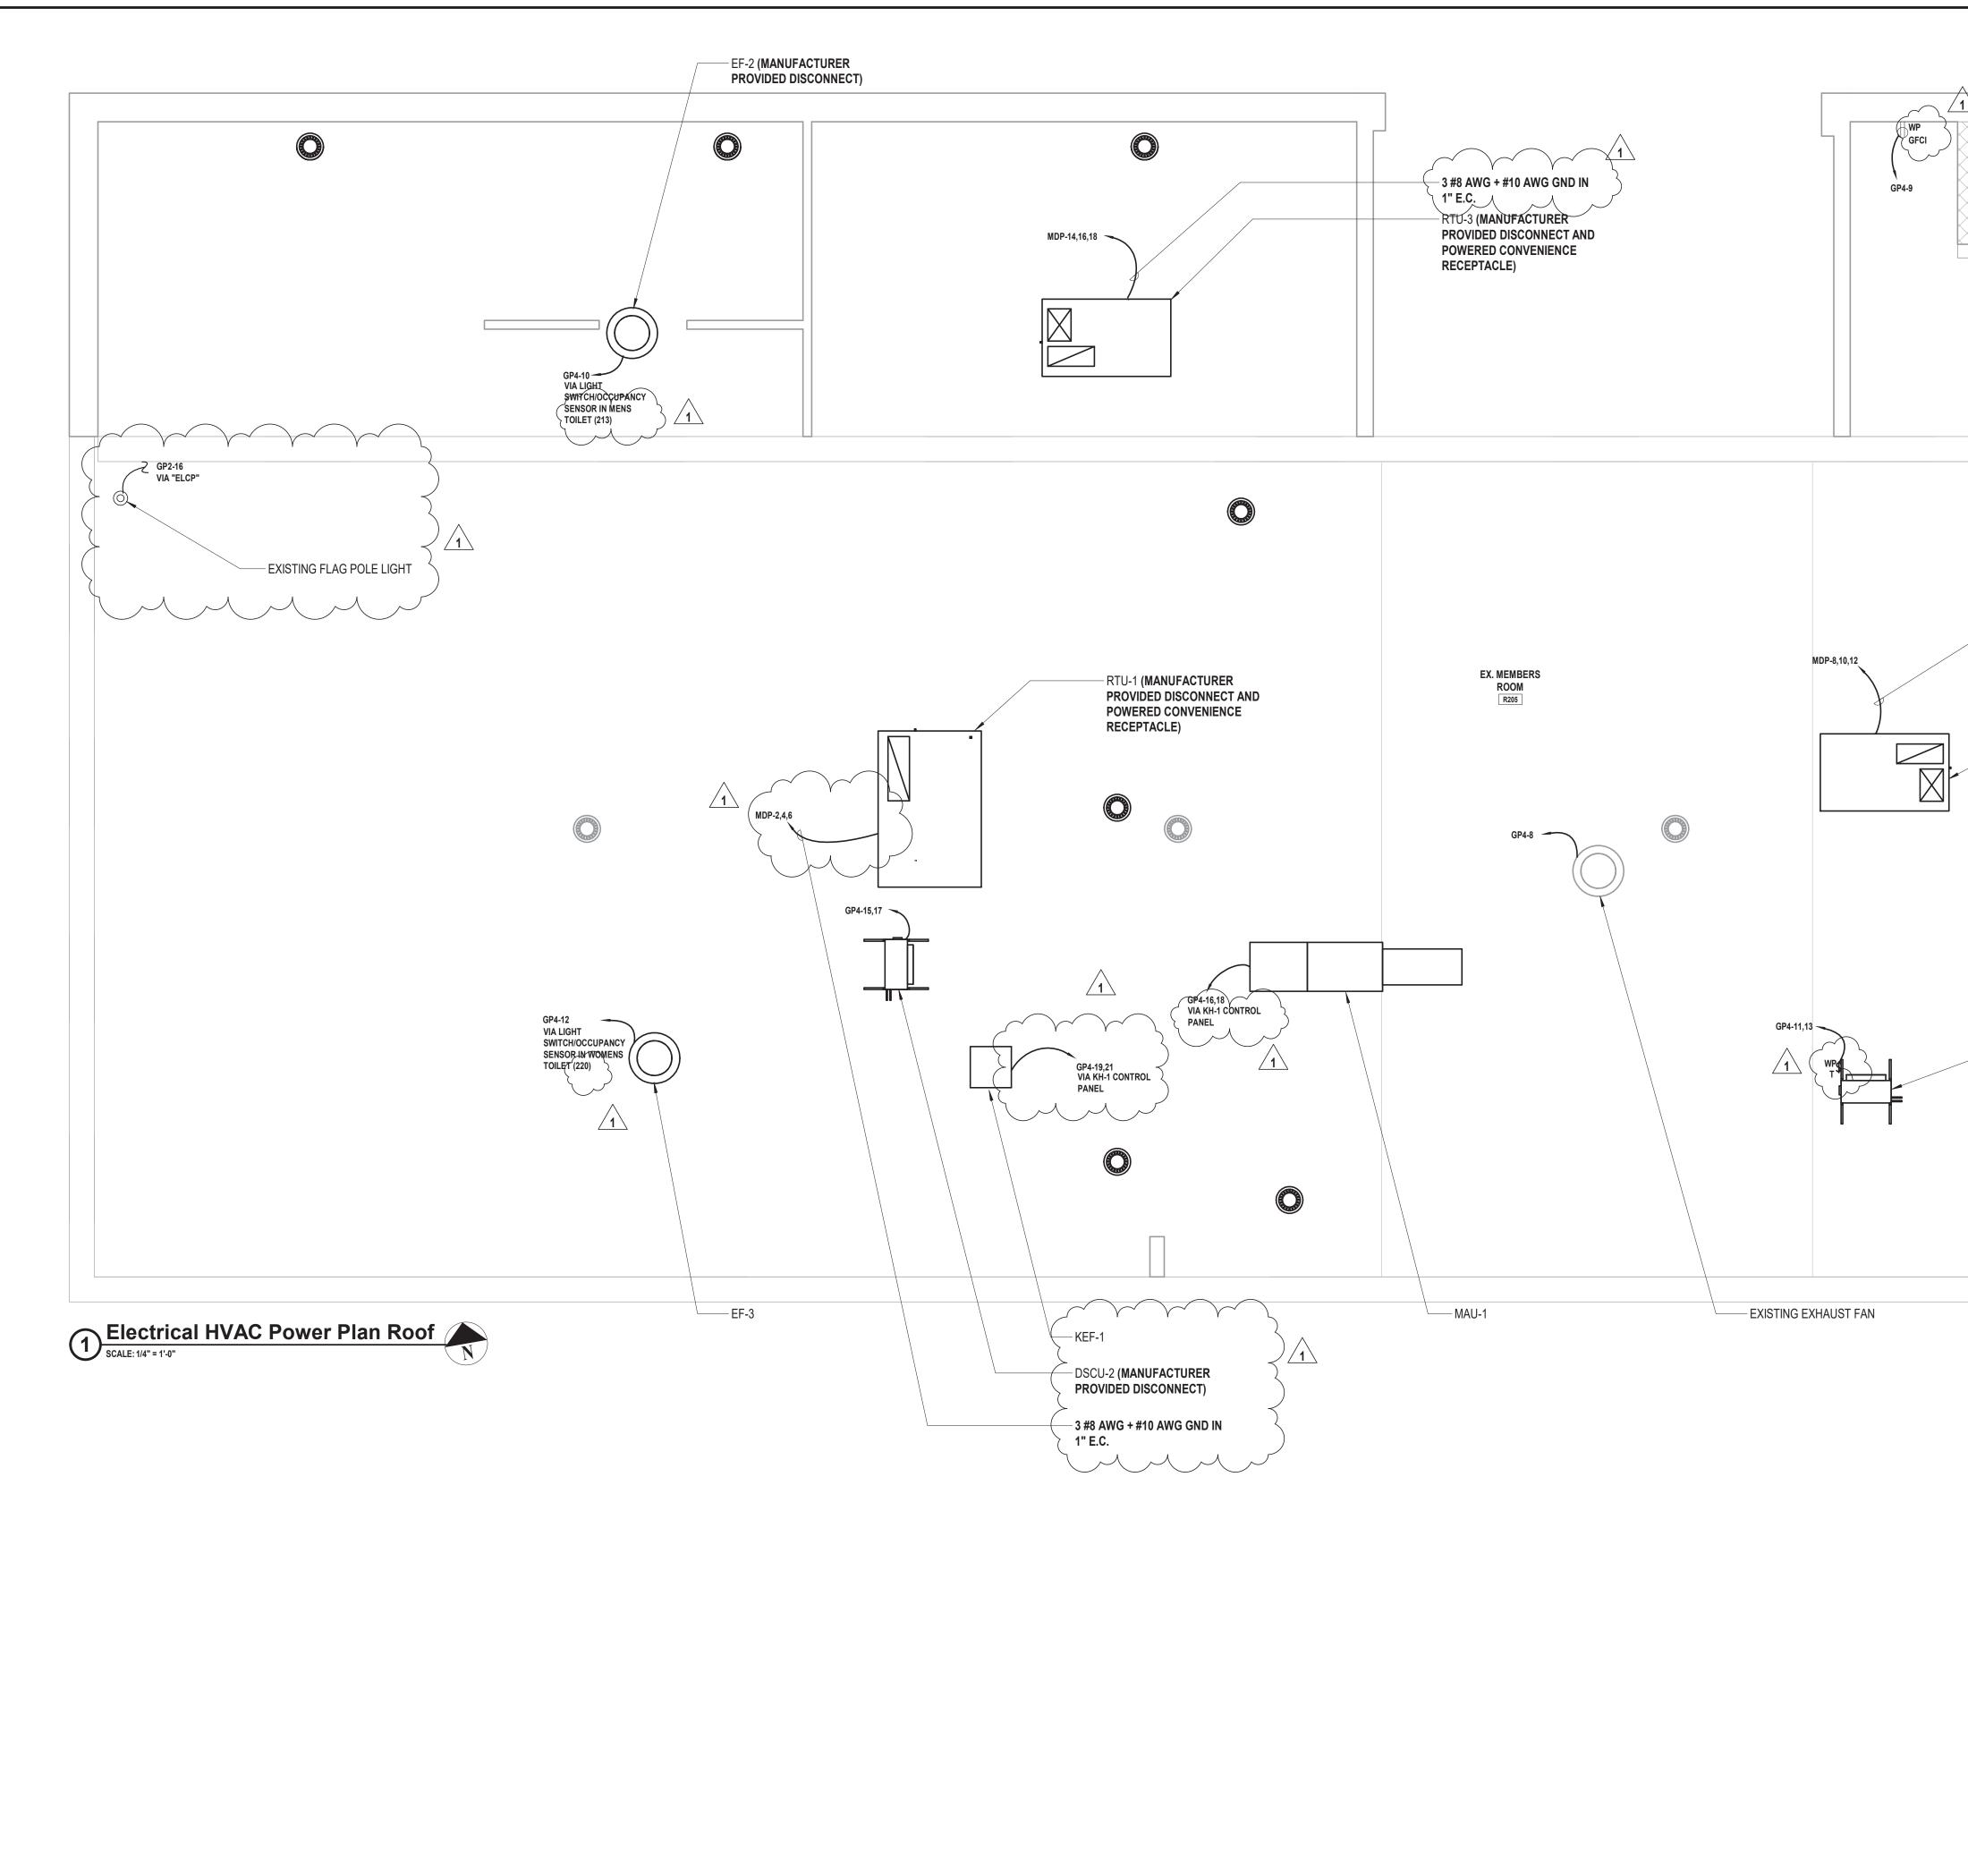
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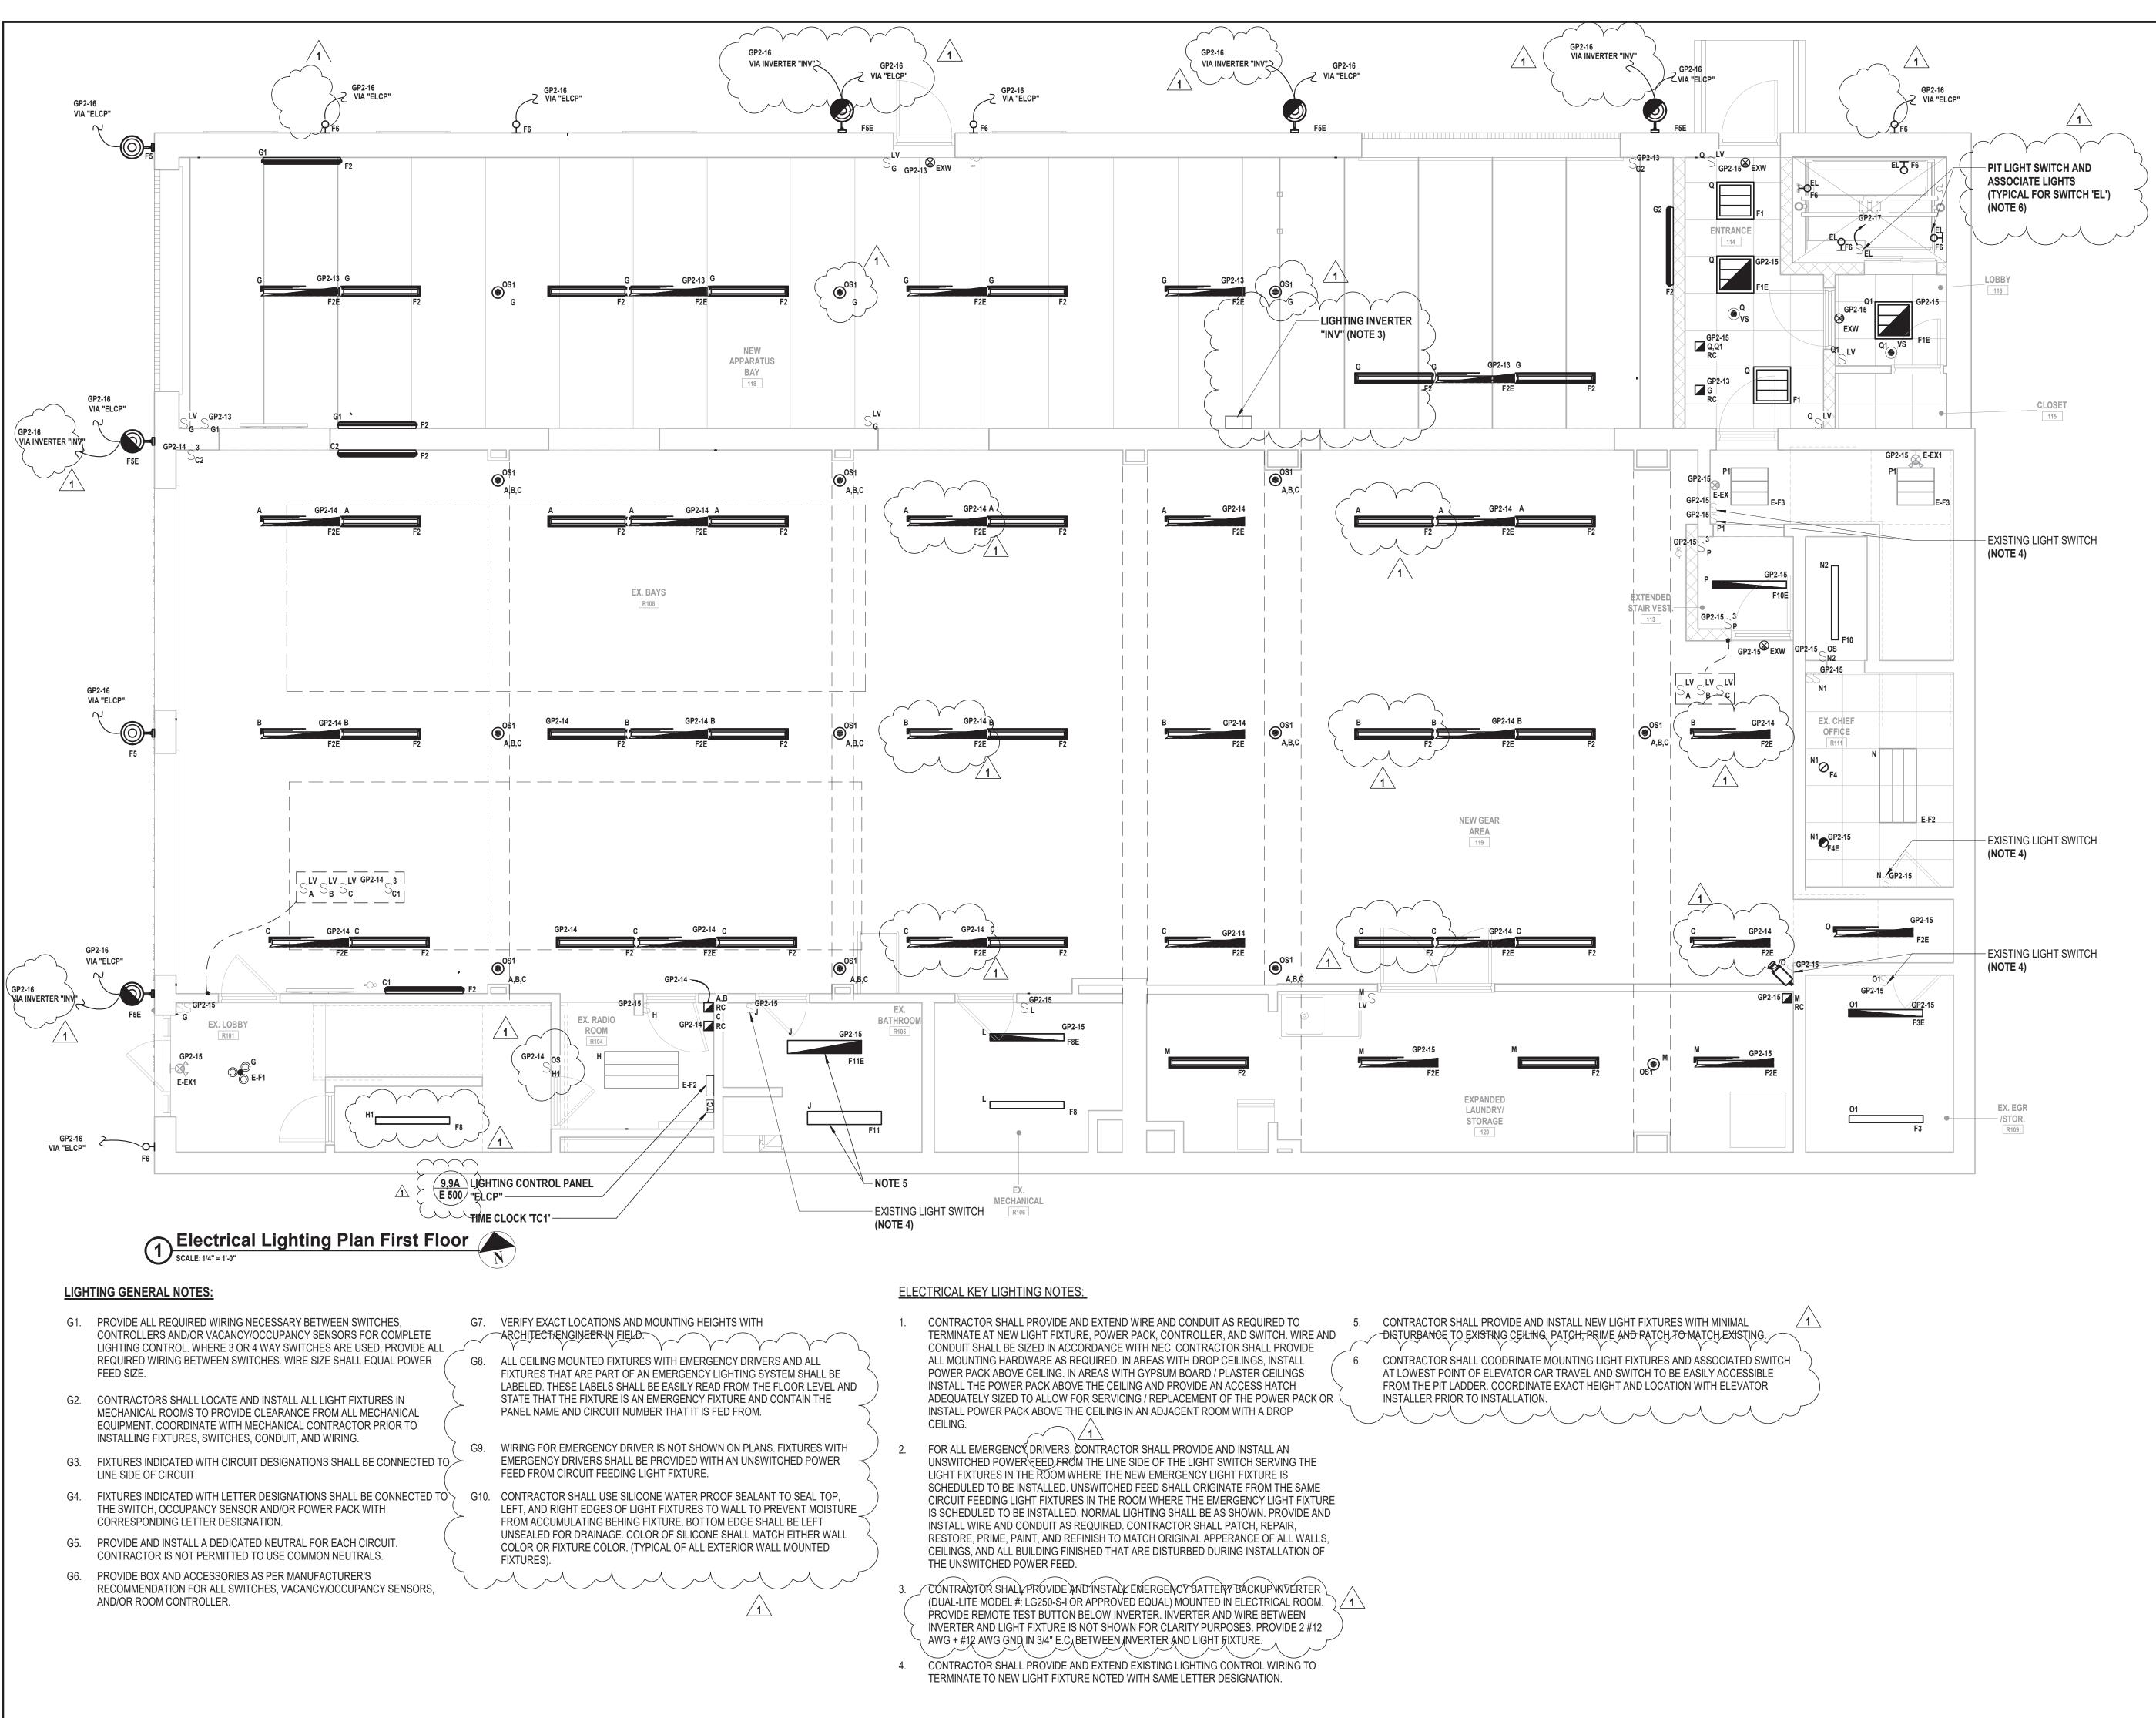




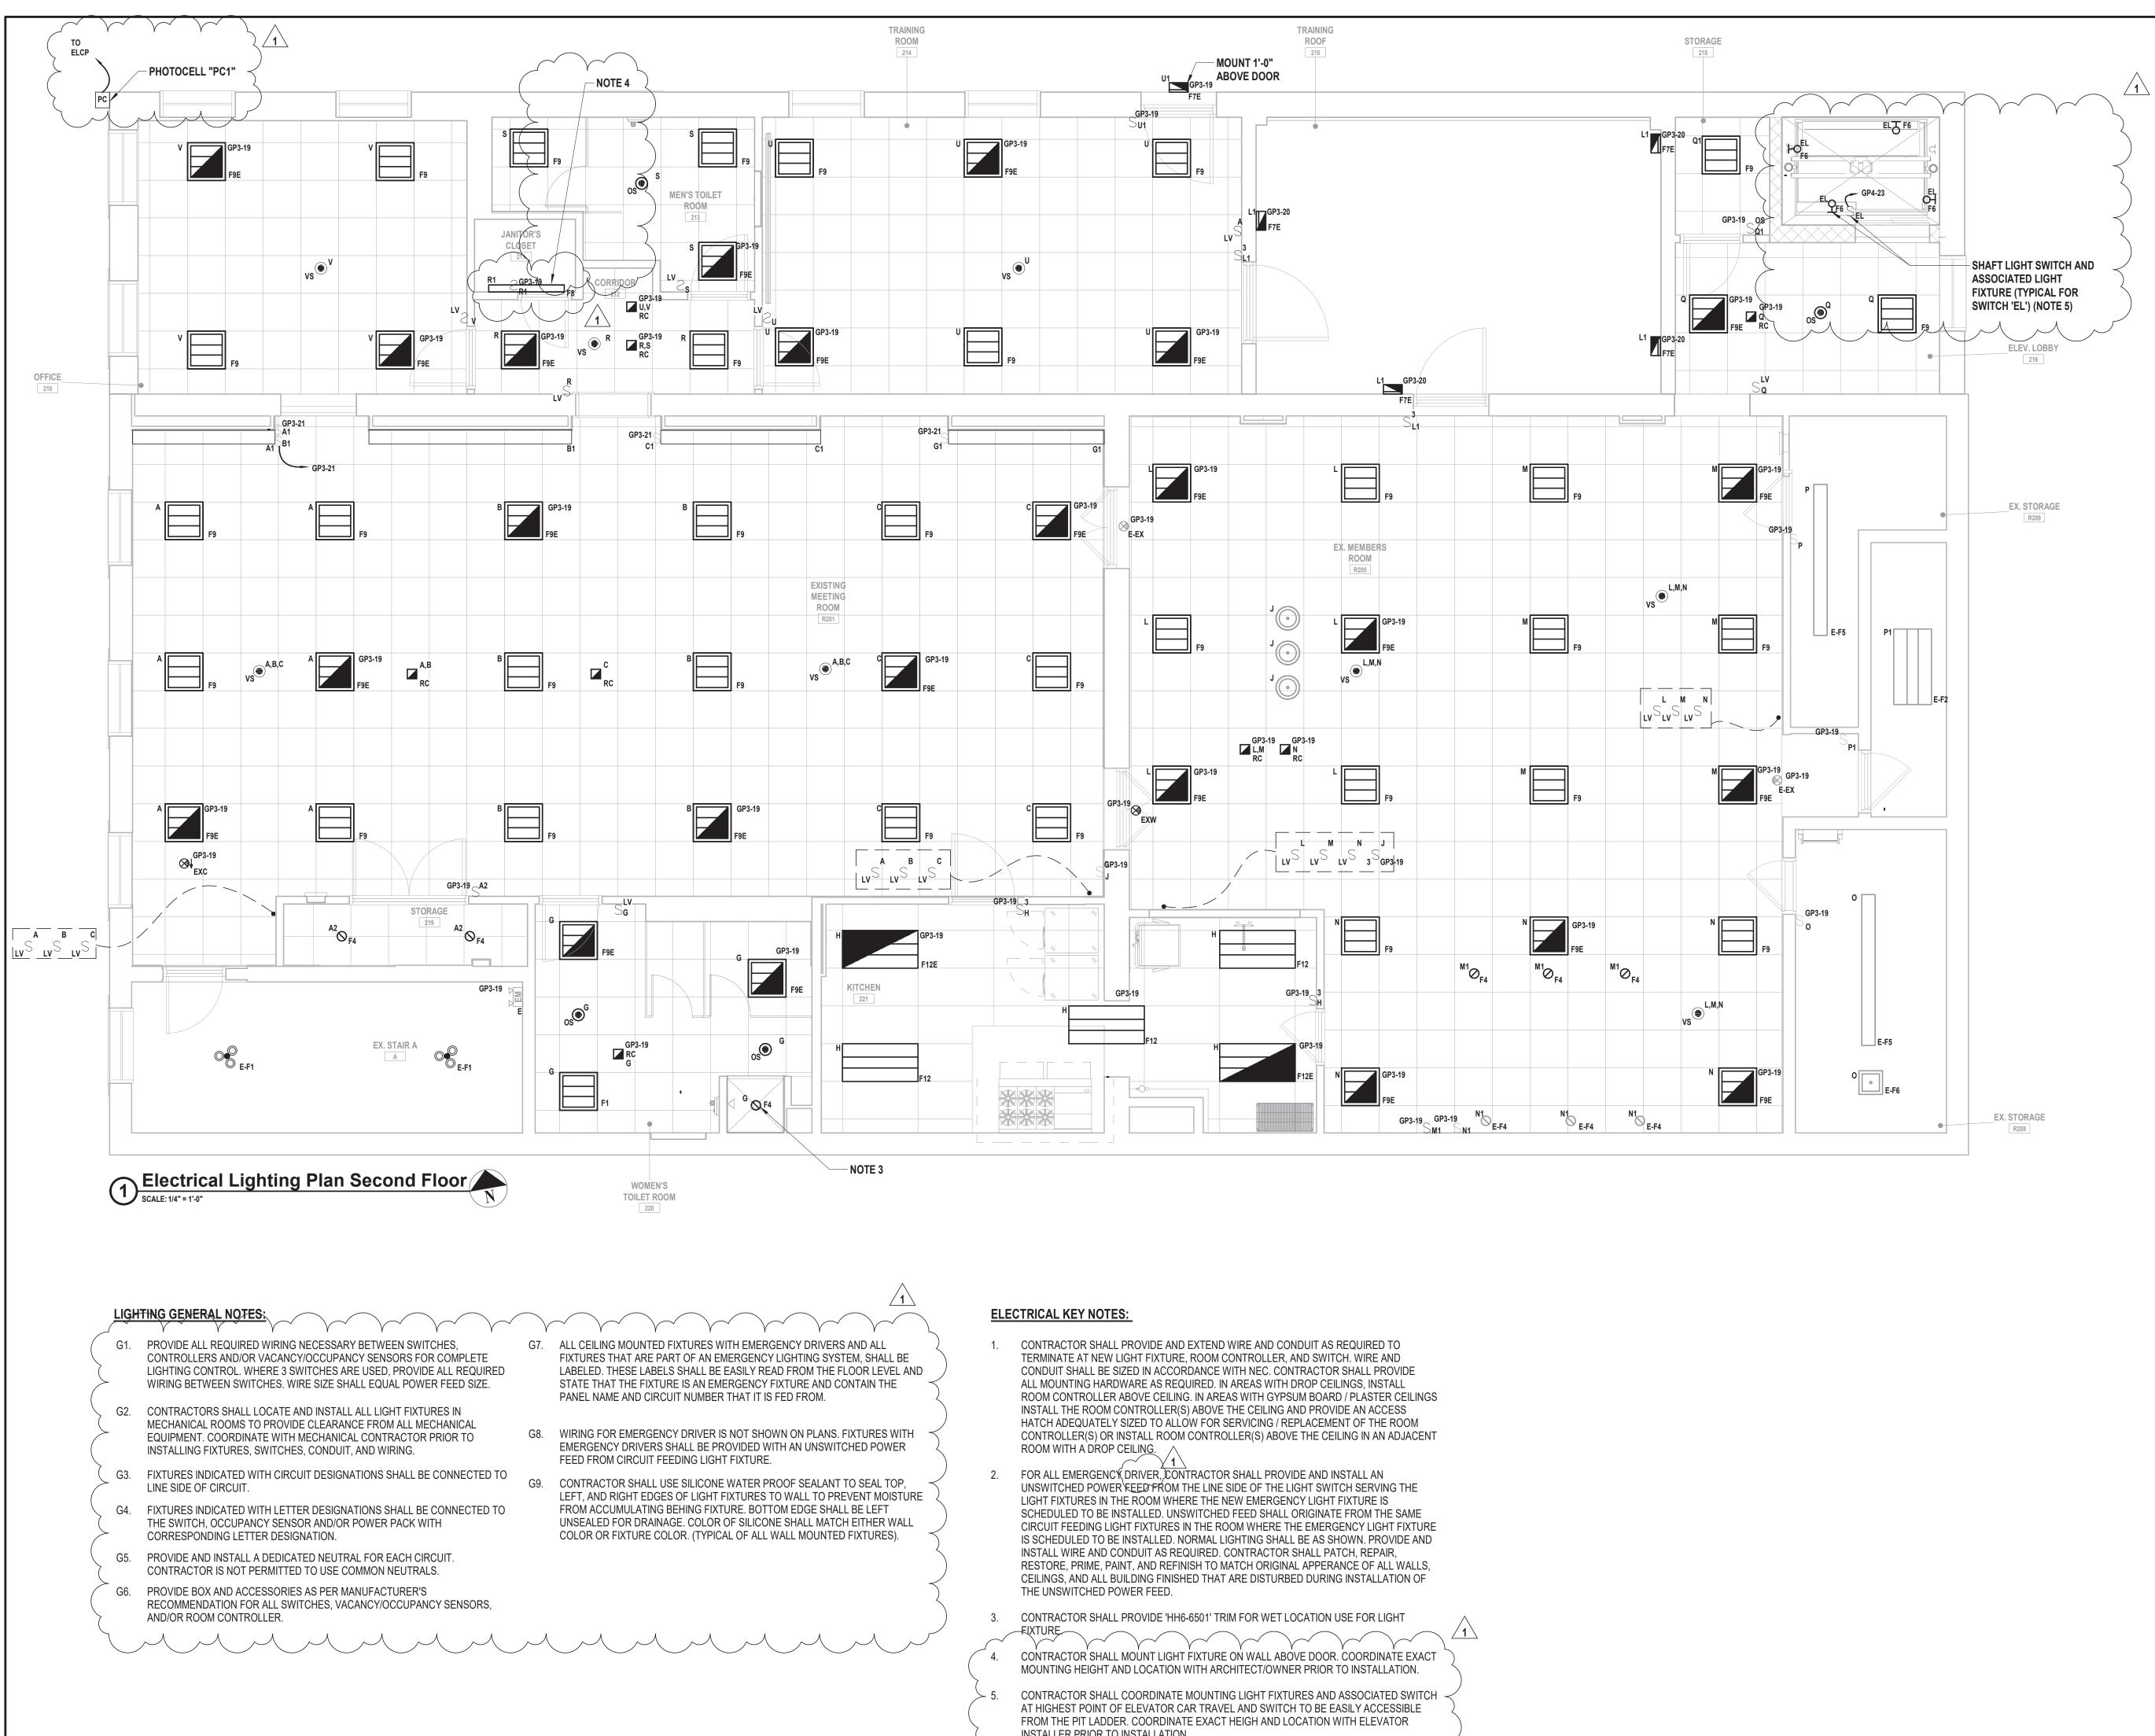
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EX. STORAGE R209	MARK DATE DESCRIPTION 1 1/19/2022 Addendum #1
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EX. STORAGE R208	VILLAGE OF MOUNT KISCO
	VILLAGE OF MOUNT KISCO
EXISTING FIN TUBE RADIATOR "FTR"	ADDITIONS AND ALTERATIONS TO
EXISTING FIN TUBE RADIATOR "FTR"	VILLAGE OF MOUNT KISCO ADDITIONS AND ALTERATIONS TO MUTUAL STATION NUTUAL STATION 99 MAIN STREET, MOUNT KISKO, NY 10549
EXISTING FIN TUBE RADIATOR "FTR"	VILLAGE OF MOUNT KISCO ADDITIONS AND ALTERATIONS TO MUTUAL STATION NOUNT KISCO NEW YORK 99 MAIN STREET, MOUNT KISKO,
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 $(\cap$ EF-5 (MANUFACTURER PROVIDED DISCONNECT) architects / 1 \ engineers TO TEMP CONTROL 3 Lear Jet Lane, Suite 205 Latham, NY 12110 518.765.5105 • www.h2m.com GP4-14 - WIRING AS PER MANUFACTURER CONSULTANTS: **REQUIREMENTS IN 1" E.C.** \bigcirc DESCRIPTION MARK DATE 1/19/2022 Addendum #1 - 3 #8 AWG + #10 AWG GND IN 1" E.C. - RTU-2 (MANUFACTURER PROVIDED DISCONNECT AND POWERED CONVENIENCE RECEPTACLE) "ALTERATION OF THIS DOCUMENT EXCEPT BY A LICENSED PROFESSIONAL IS ILLEGAL" CHECKED BY: REVIEWED BY: DESIGNED BY: DRAWN BY: DJH DJH ROJECT No: DATE: SCALE: AS SHOWN MKIV 1802 12/13/2021 -DSCU-1 VILLAGE OF MOUNT **KISCO** ADDITIONS AND ALTERATIONS TO **MUTUAL STATION** NEW YORK 99 MAIN STREET, MOUNT KISKO, NY 10549 CONTRACT CONTRACT G **GENERAL CONSTRUCTION** CONSTRUCTION DOCUMENTS SHEET TITLE ELECTRICAL HVAC POWER PLAN ROOF E 113.01

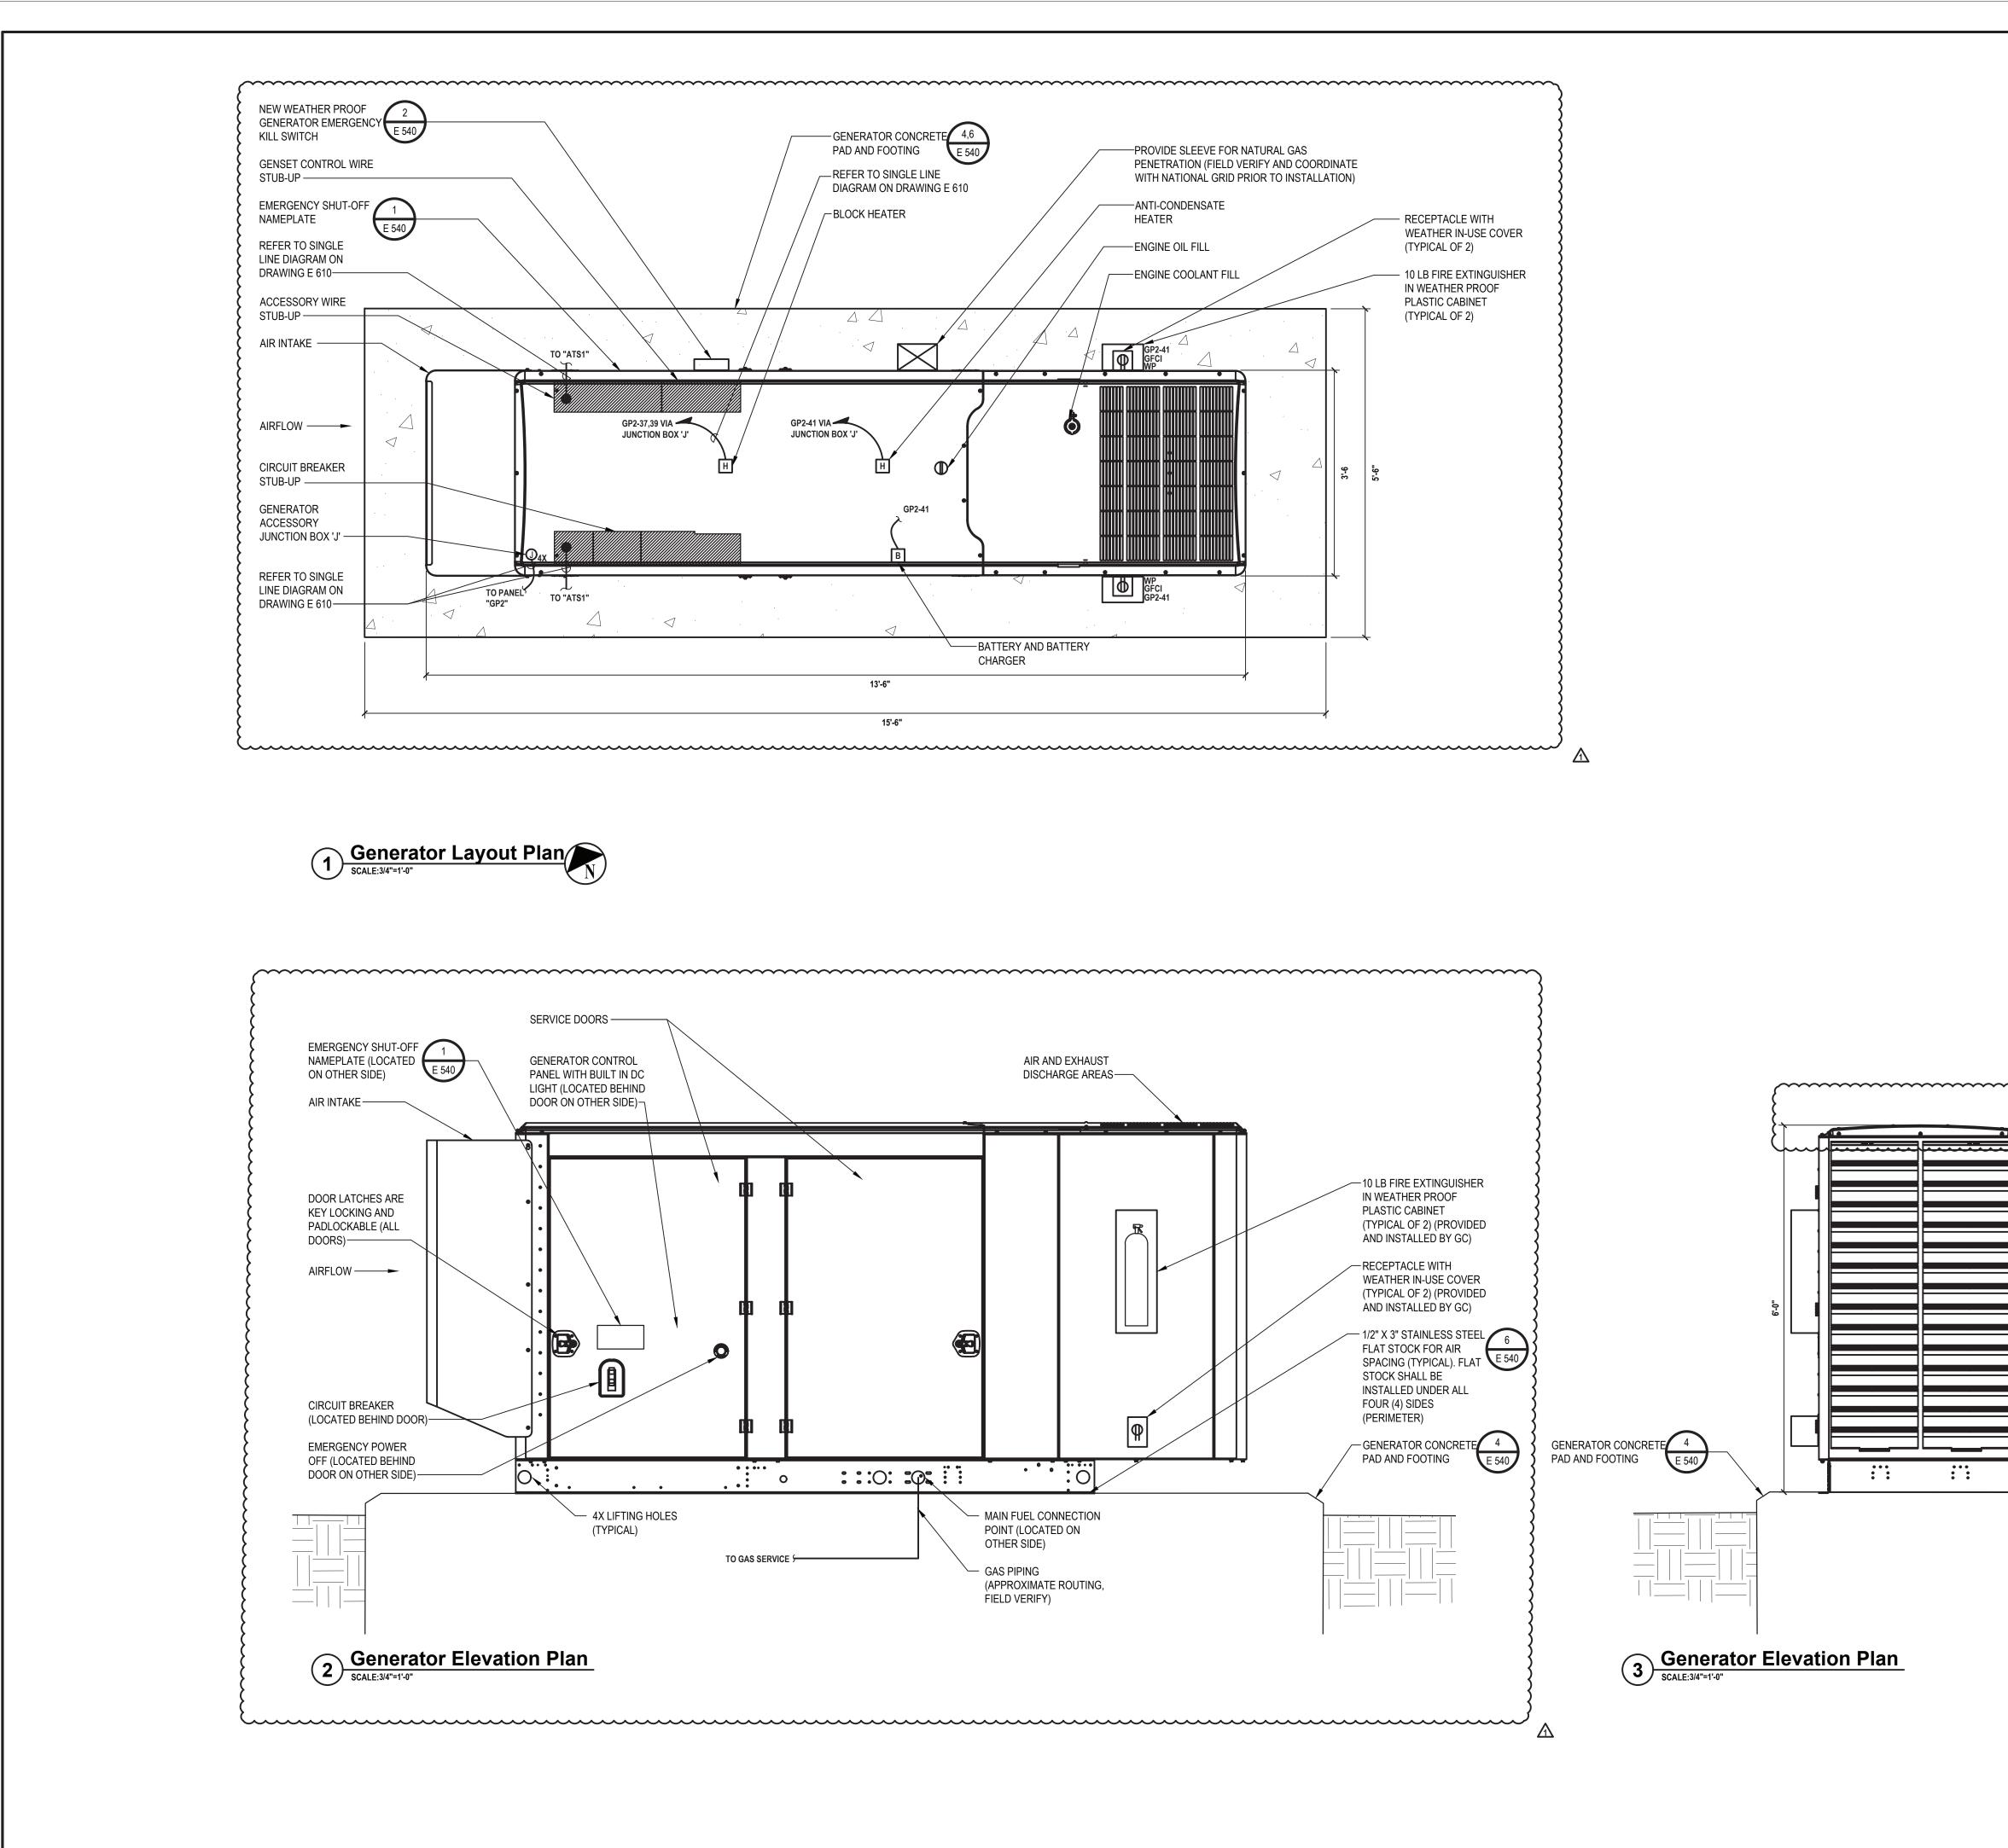


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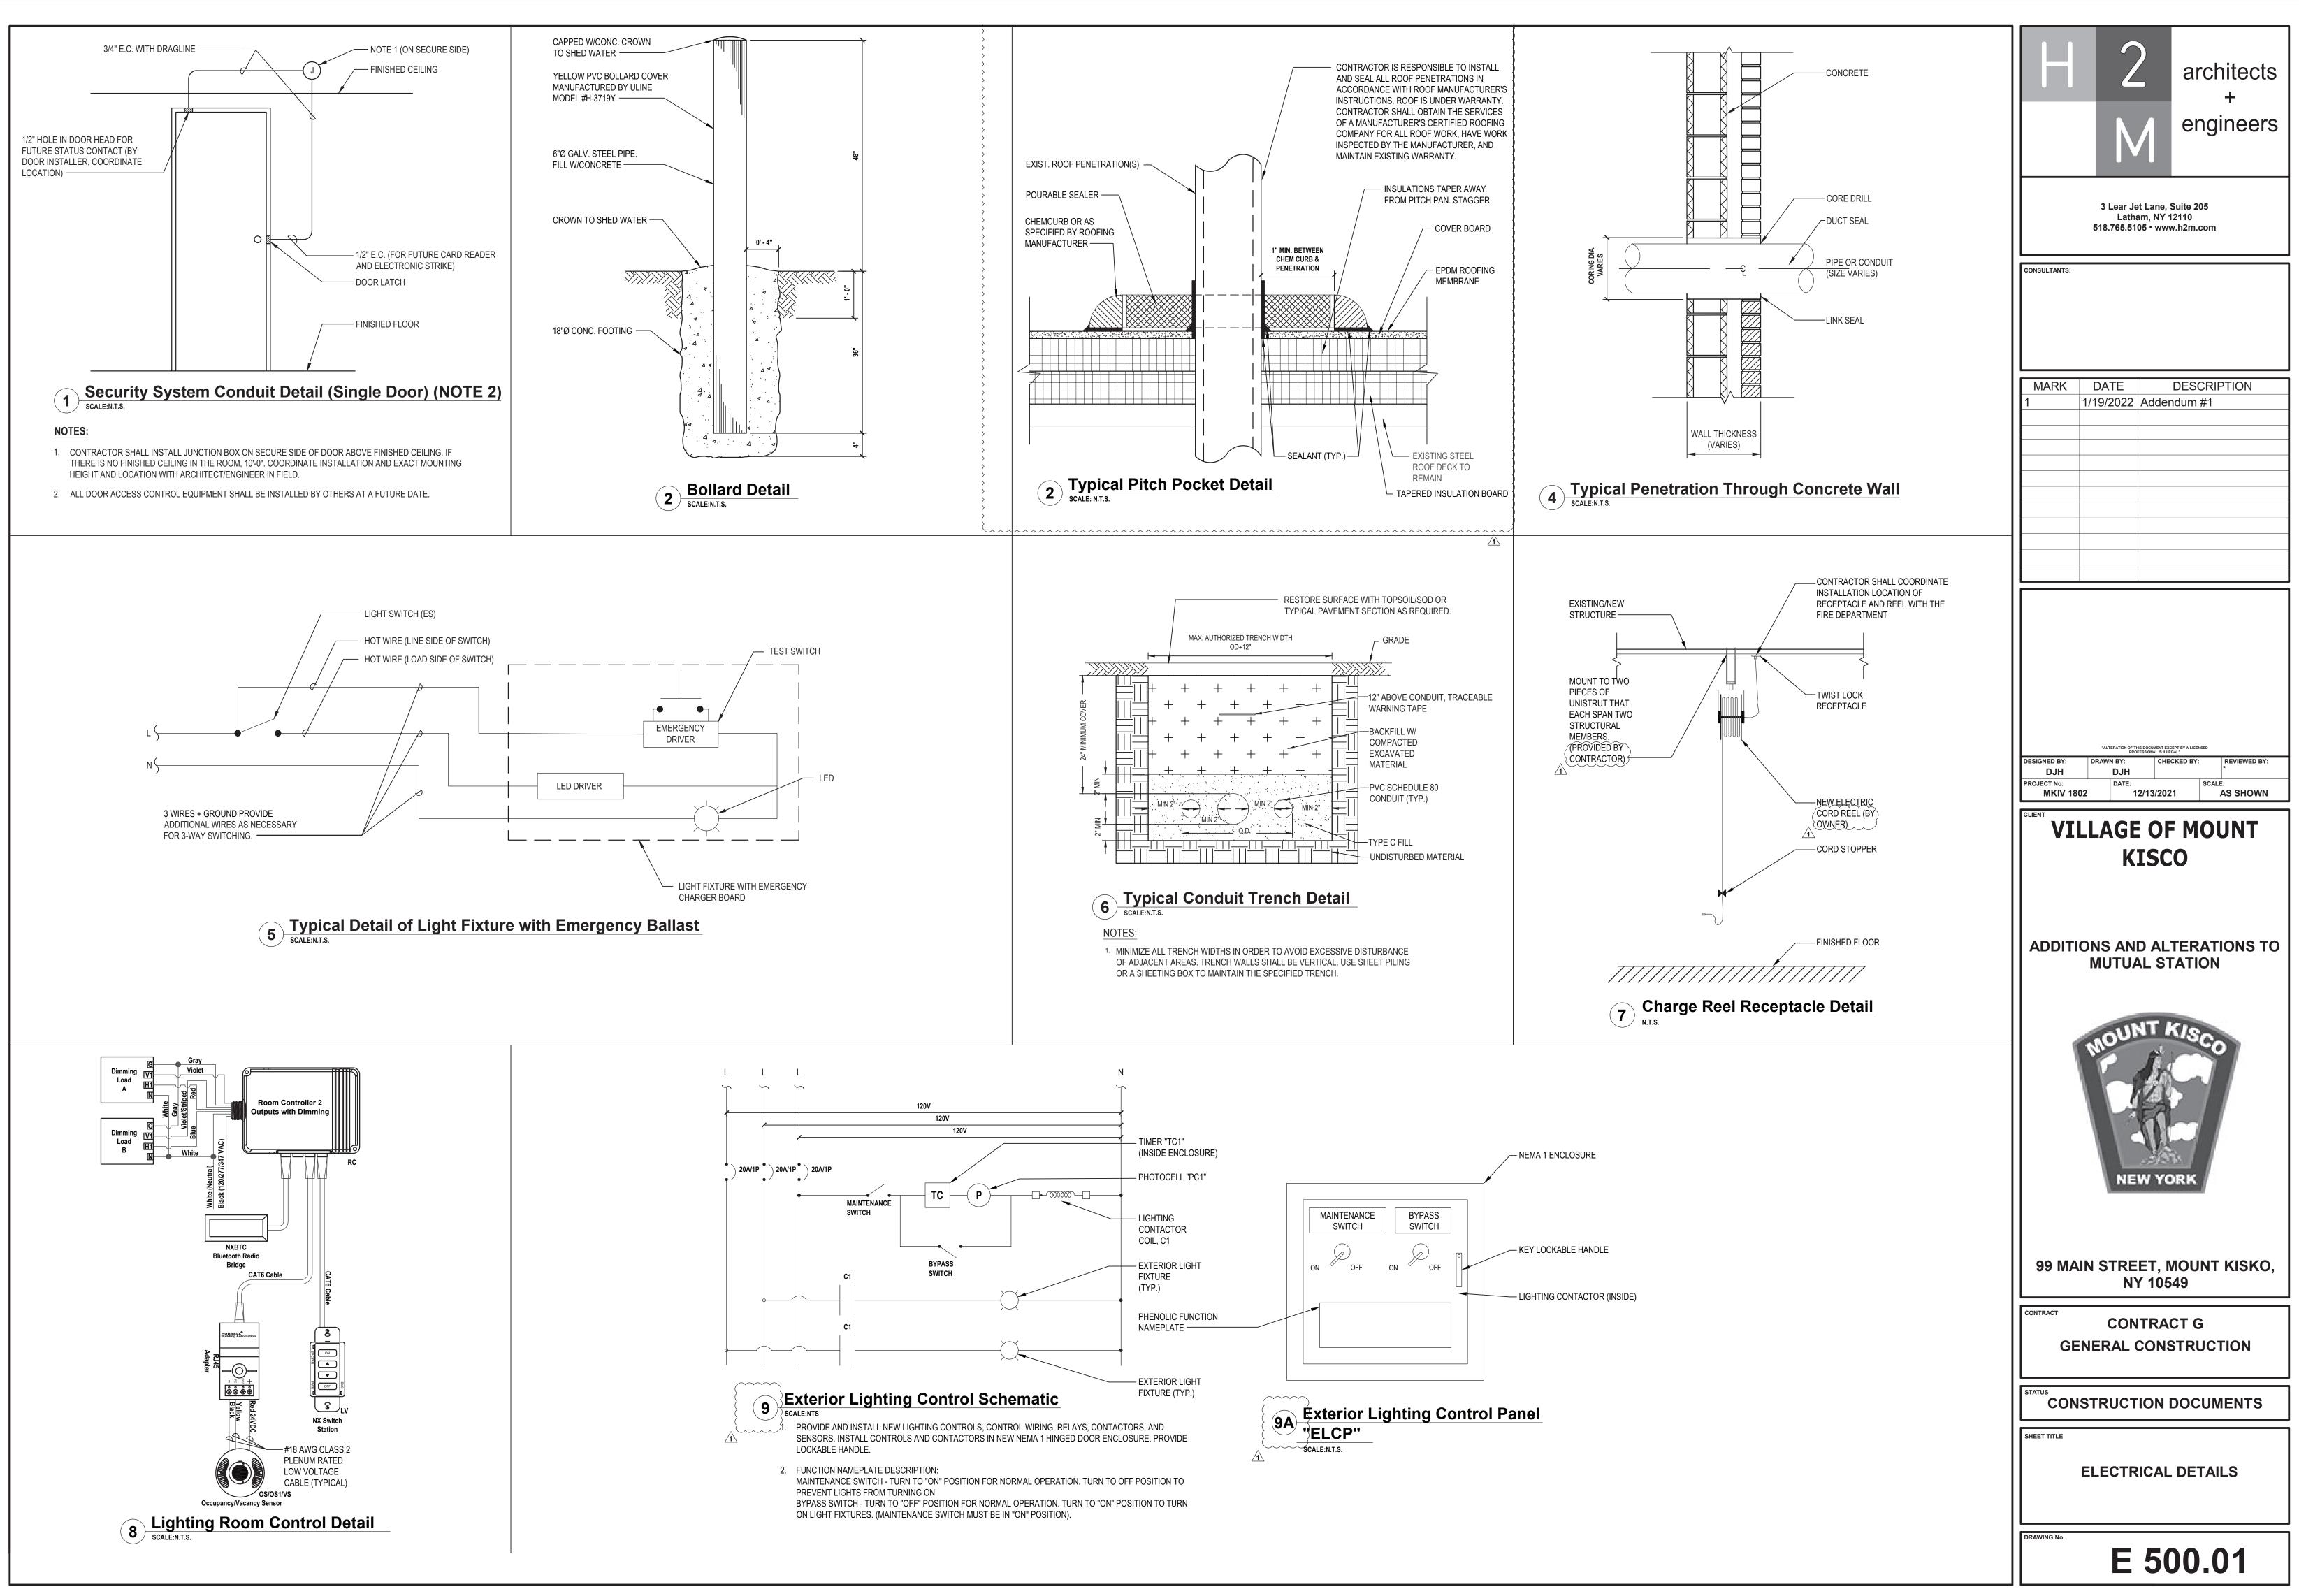
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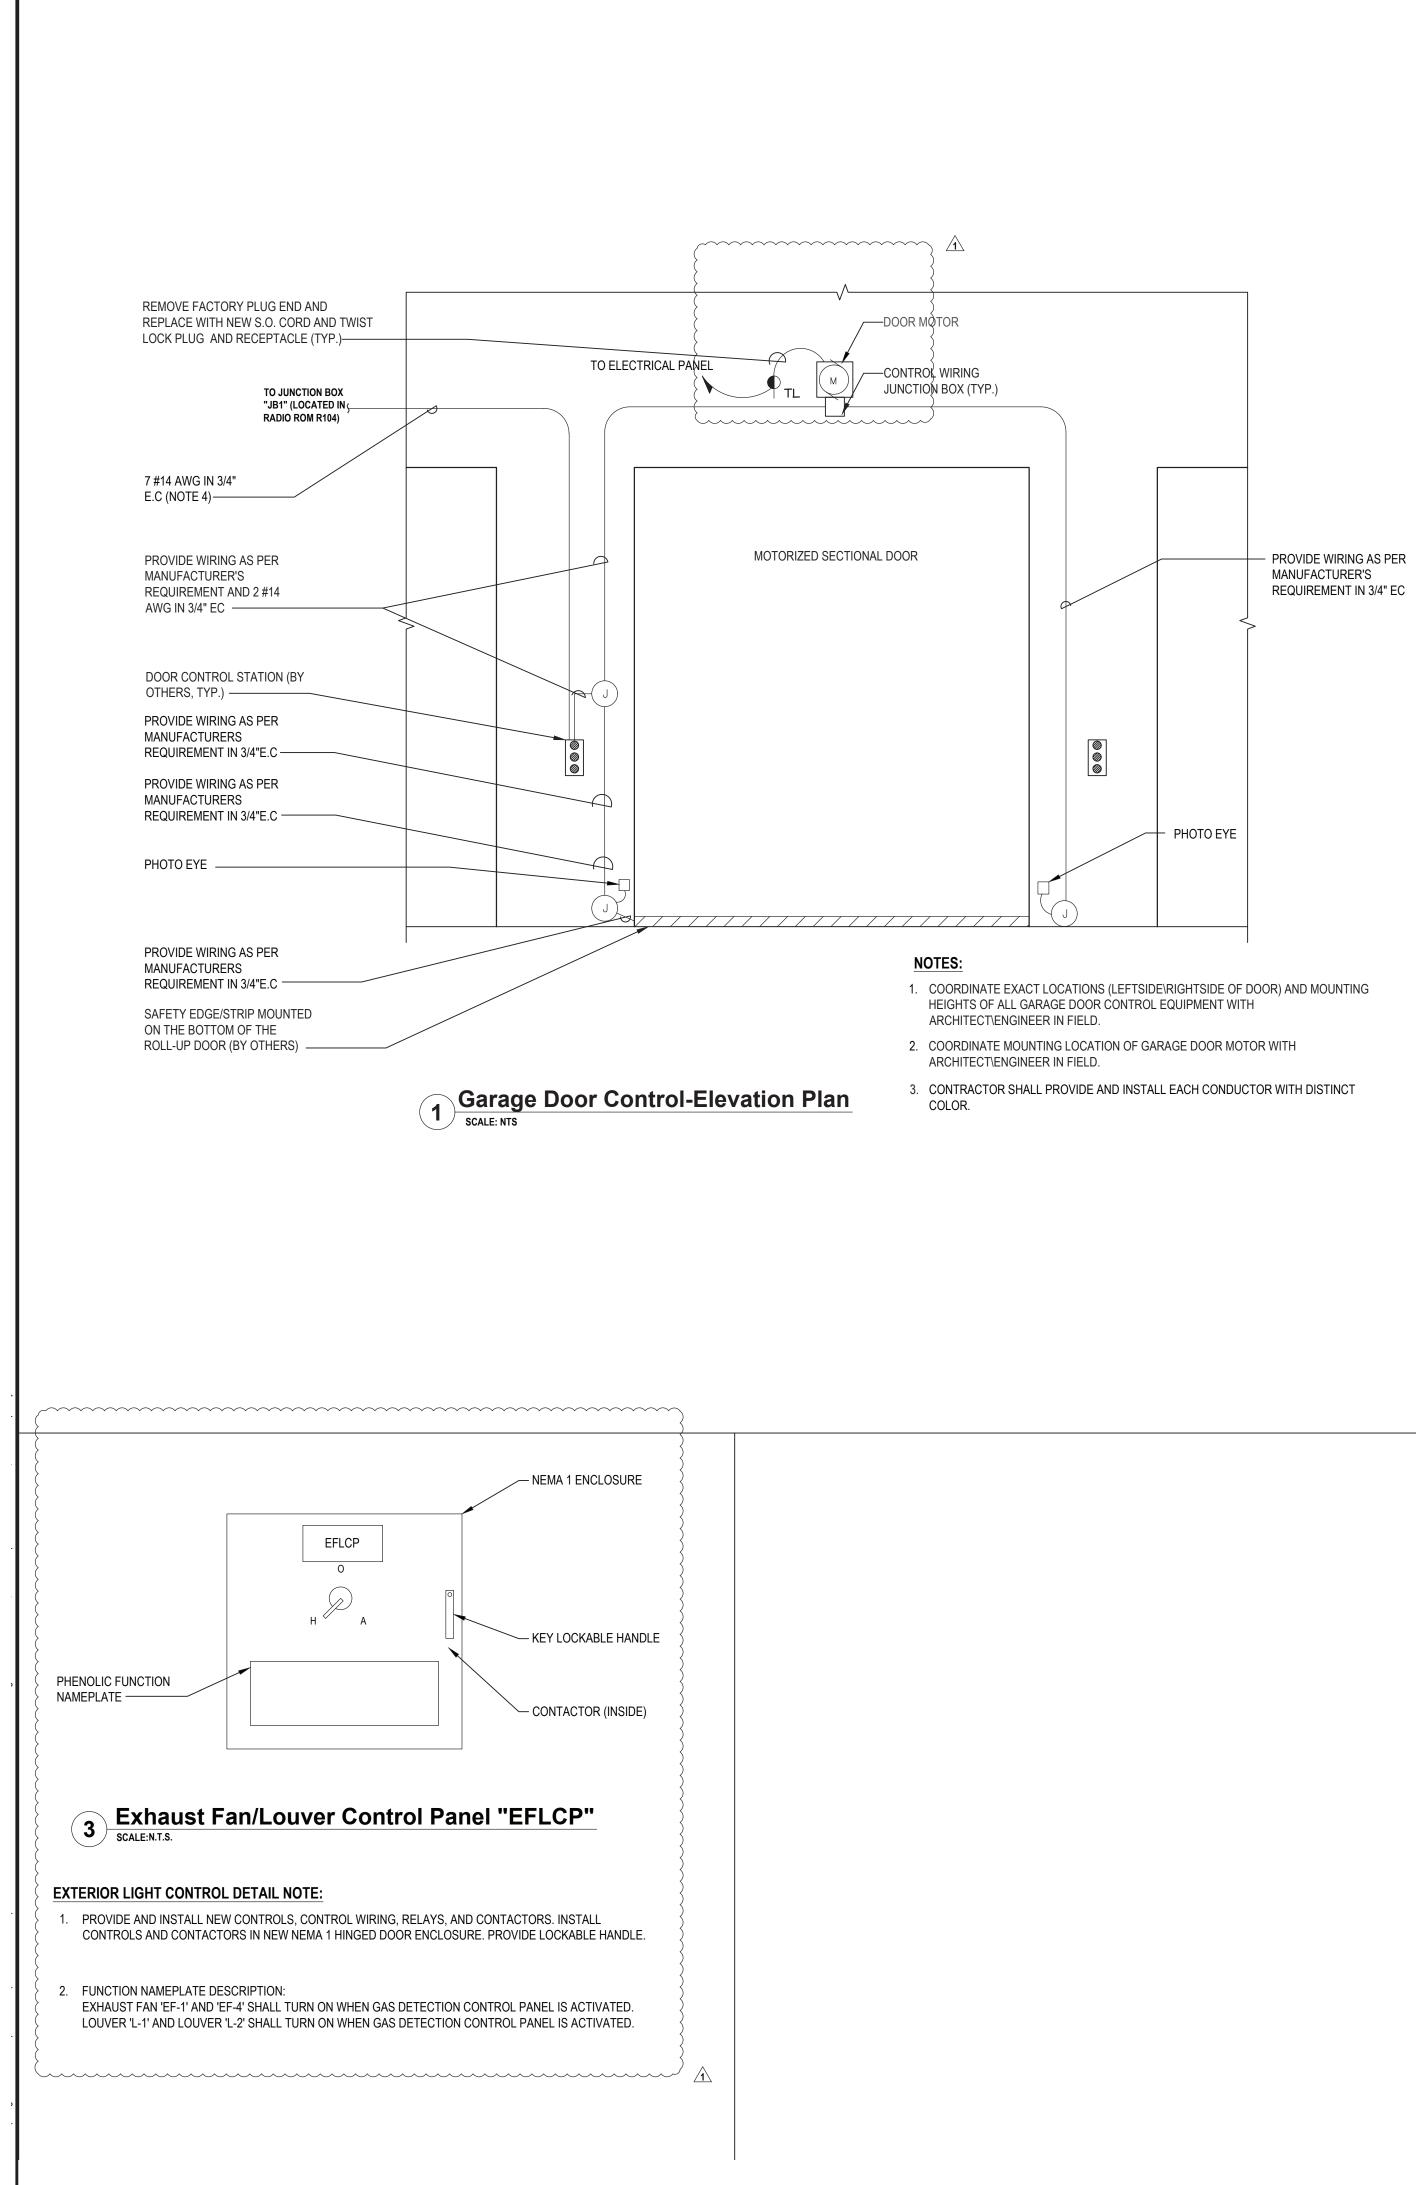


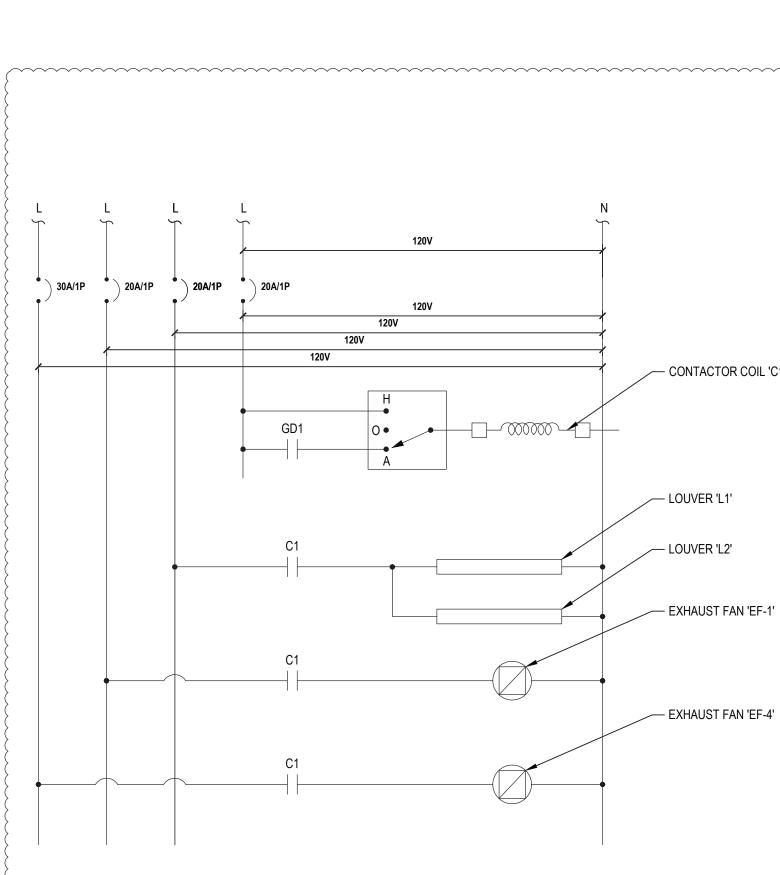


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10 LB FIRE EXTINGUISHER IN WEATHER PROOF PLASTIC CABINET (TYPICAL OF 2) (PROVIDED AND INSTALLED BY GC) RECEPTACLE WITH WEATHER IN-USE COVER (TYPICAL OF 2) (PROVIDED AND INSTALLED BY GC) 1/2" X 3" STAINLESS STEEL FLAT STOCK FOR AIR SPACING (TYPICAL). FLAT STOCK SHALL BE INSTALLED UNDER ALL FOUR (4) SIDES		ADDIT	MUTUA	D ALTERAL STATI	Co
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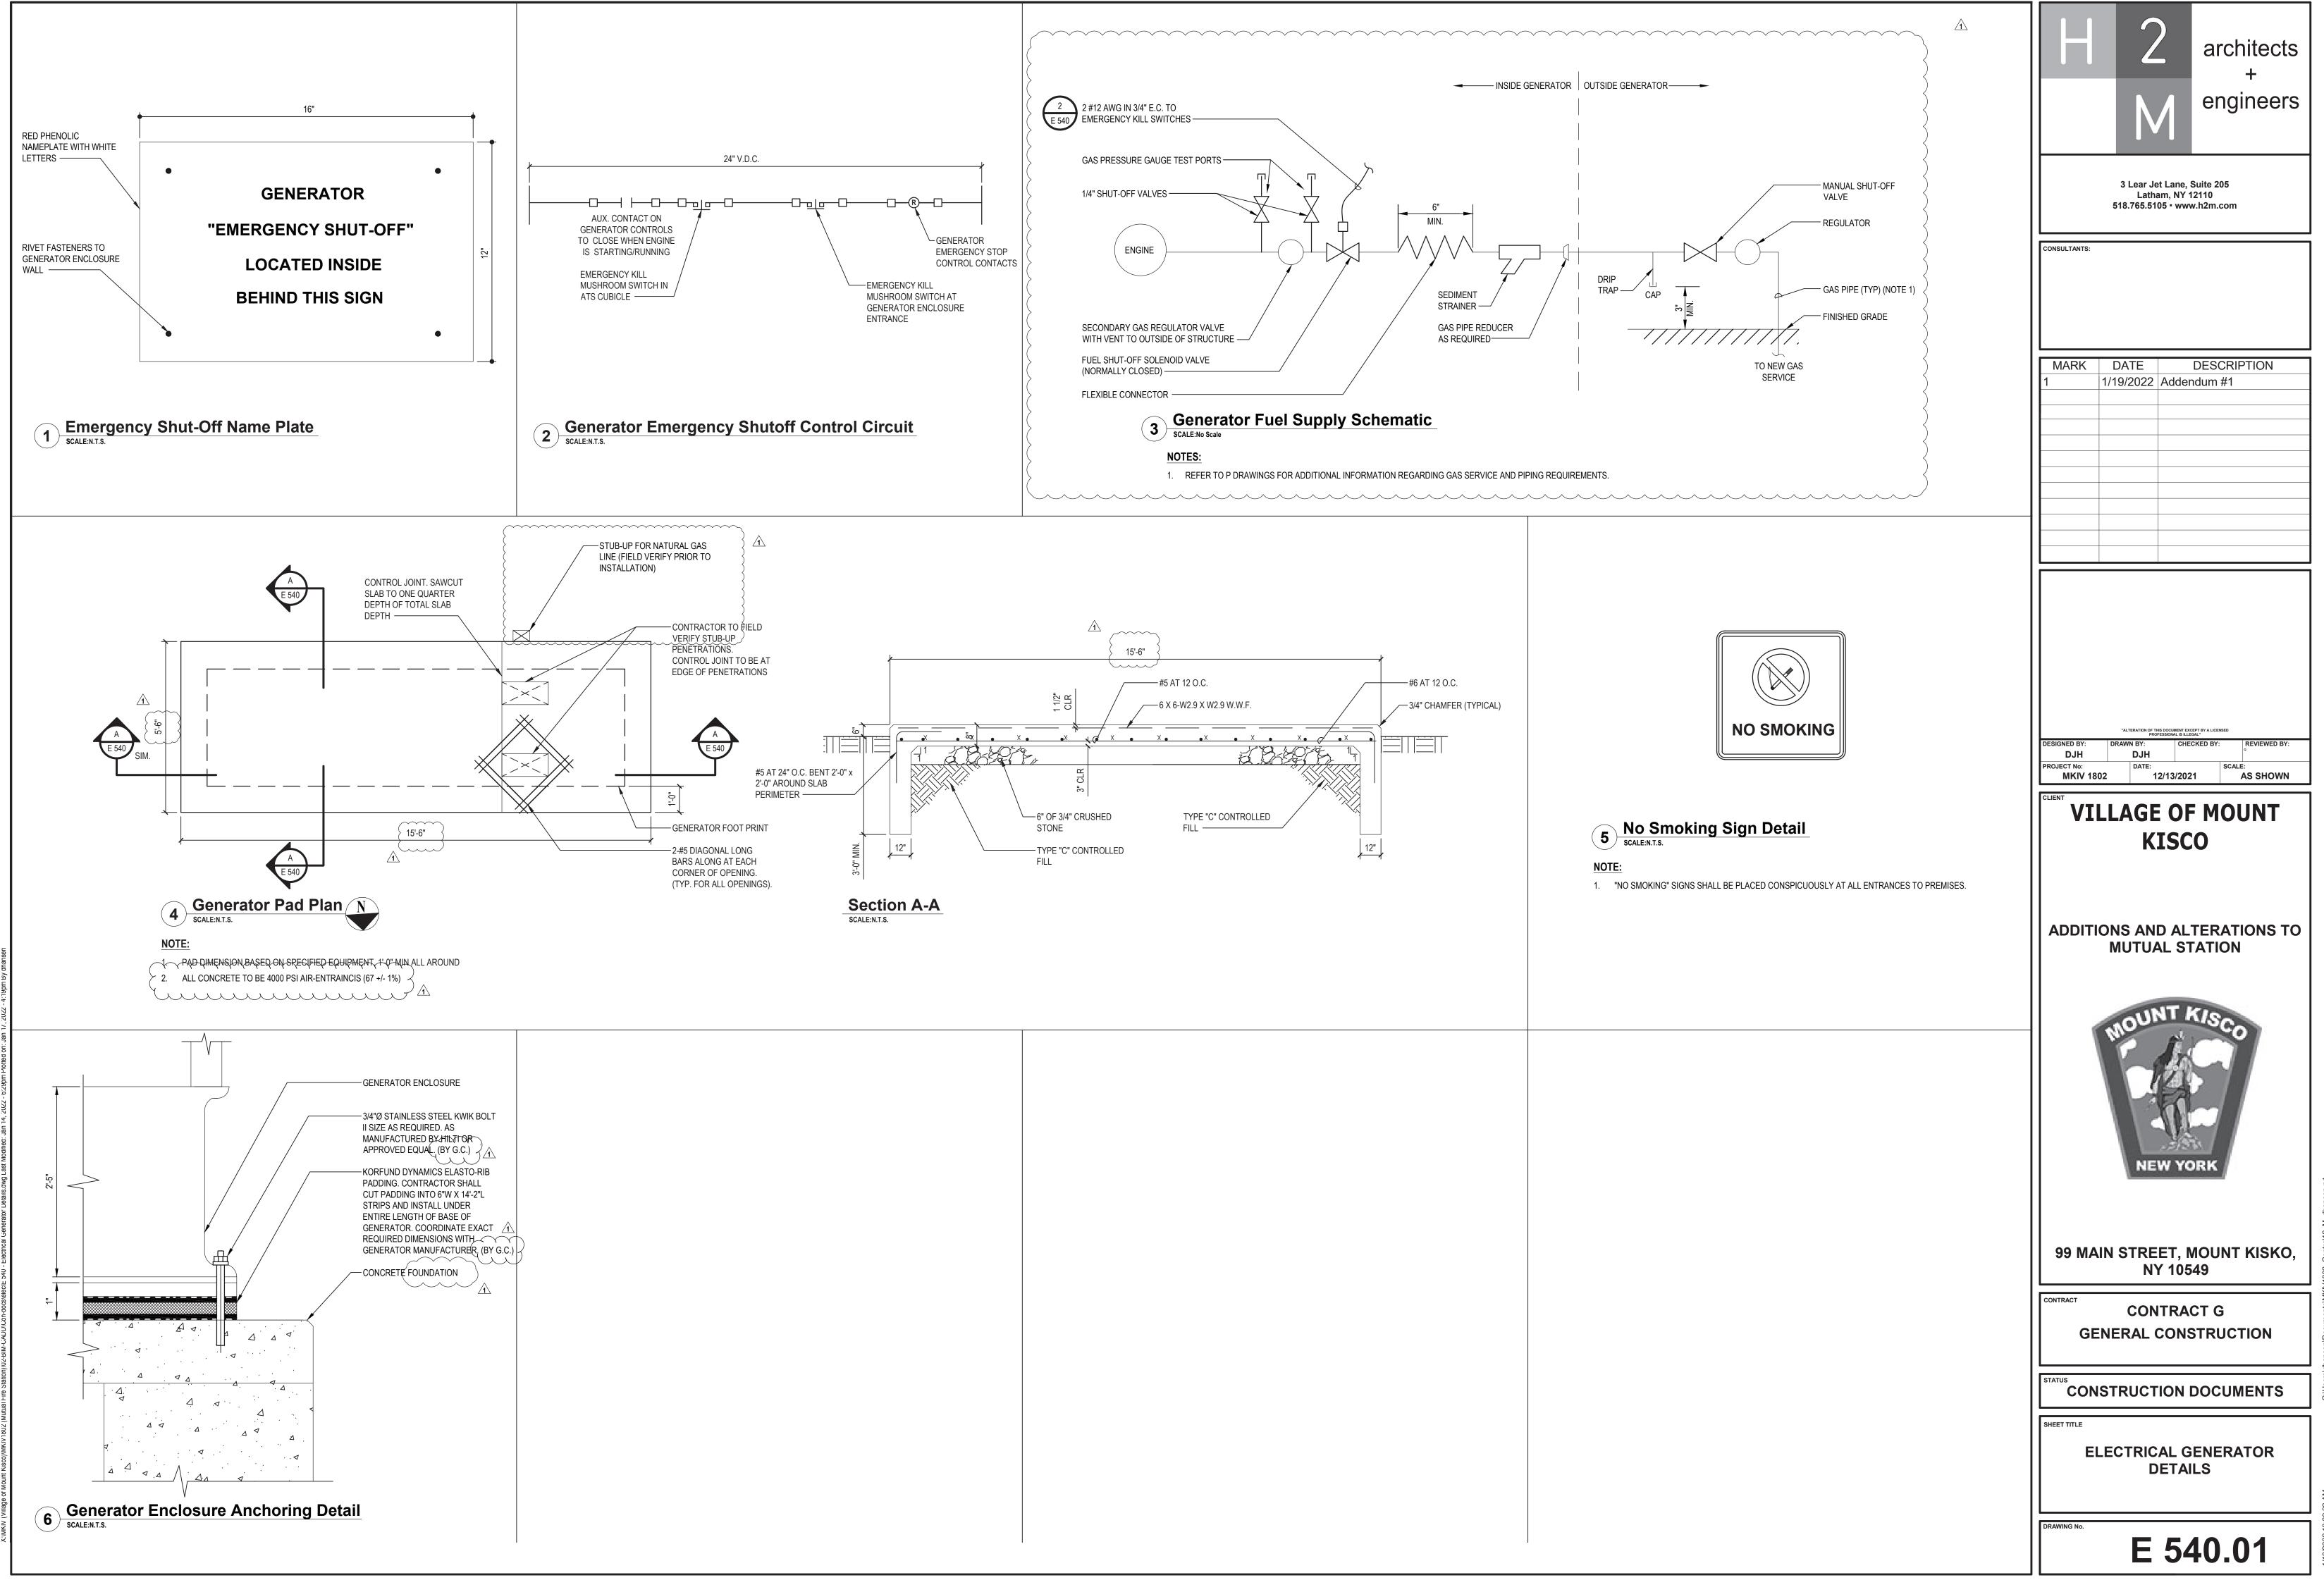






2 Exhaust Fan/Louver Control Panel "EFLCP" Wiring Schematic SCALE: NTS

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'C1' GAS DETECTOR RELAY 'GD1'	MARK DATE DESCRIPTION 1 1/19/2022 Addendum #1
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	99 MAIN STREET, MOUNT KISKO, NY 10549
	GENERAL CONSTRUCTION STATUS CONSTRUCTION DOCUMENTS
	SHEET TITLE ELECTRICAL DETAILS
	DRAWING No. E 501.01



SIGNATION	SYMBOL	MANUFACTURER	MODEL NUMBER	TYPE	WATTS	COLOR TEMP	VOLT	LUMENS	MOUNTING	REMARKS	MOUNTING HEIGHT	DET
F1		COLUMBIA LIGHTING	LCAT22-40MWG-G-EDU	LED	22	4000K	UNV	3380	RECESSED	-	CEILING	-
F1E		COLUMBIA LIGHTING	LCAT22-40MW-G-EDU-ELL14	LED	22	4000K	UNV	3380	RECESSED	EMERGENCY BATTERY BACKUP WITH 90 MINUTES OF BACK-UP CAPACITY	CEILING	5 E 50
F2		COLUMBIA LIGHTING	LXEM4-40ML-RA-EDU	LED	42	4000K	UNV	5168	SURFACE	-	CEILING	-
F2E		COLUMBIA LIGHTING	LXEM4-40ML-RA-EDU-ELL14	LED	42	4000K	UNV	5168	SURFACE	EMERGENCY BATTERY BACKUP WITH 90 MINUTES OF BACK-UP CAPACITY	CEILING	5 E 5
F3		MERCURY LIGHTING	LW4-4-3800-40K-HTA-A40- UNI+SR	LED	39	4000K	UNV	3671	SURFACE	-	CEILING	-
F3E		MERCURY LIGHTING	LW4-4-3800-40K-HTA-A40- UNI+SR+EM12	LED	39	4000K	UNV	3671	SURFACE	EMERGENCY BATTERY BACKUP WITH 90 MINUTES OF BACK-UP CAPACITY	CEILING	E 5
F4	\oslash	LITEFRAME	HH6IC-LED-900L-DIM10-120- WD-40K-90-CL-WH	1 LED	12	4000K	UNV	900	RECESSED	-	CEILING	-
F5		HUBBELL	UCS-BEL/VSL-BEL-12LED- NW-DB-WCV	LED	70	4000K	UNV	7920	SURFACE	-	8'-0" AFG, UON	
F5E		HUBBELL	UCS-BEL/VSL-BEL-12LED- NW- DB-WCV	LED	70	4000K	UNV	7920	SURFACE	EMERGENCY BATTERY BACKUP WITH 90 MINUTES OF BACK-UP CAPACITY	8'-0" AFG, UON	E 5
F6	9	HUBBELL	VWGL-1	LED	11	4000K	UNV		SURFACE	-		-
F7E		HUBBELL	TRP2-24L-70-4K8-3-UNV-BLT- PC-EH	LED	70	4000K	UNV	7920	SURFACE	EMERGENCY BATTERY BACKUP WITH 90 MINUTES OF BACK-UP CAPACITY	8'-0" AFF, UON	E 5
F8		MERCURY LIGHTING	LW4-4-3800-40K-HTA-A40- UNI+SR	LED	39	4000K	UNV	3671	PENDANT	-	8'-0" AFF	
F8E		MERCURY LIGHTING	LW4-4-3800-40K-HTA-A40- UNI+SR+EM12	LED	39	4000K	UNV	3671	PENDANT	EMERGENCY BATTERY BACKUP WITH 90 MINUTES OF BACK-UP CAPACITY	8'-0" AFF	E
F9		COLUMBIA LIGHTING	LCAT22-40LWG-G-EDU	LED	22	4000K	UNV	3380	RECESSED	-	CEILING	
F9E		COLUMBIA LIGHTING	LCAT22-40LW-G-EDU-ELL14	LED	22	4000K	UNV	2811	RECESSED	EMERGENCY BATTERY BACKUP WITH 90 MINUTES OF BACK-UP CAPACITY	CEILING	E
F10		MERCURY LIGHTING	LW4-4-2100-40K-HTA-A40- UNI+SR	LED	18	4000K	UNV	2036	SURFACE	-	CEILING	
F10E		MERCURY LIGHTING	LW4-4-2100-40K-HTA-A40- UNI+SR+EM12	LED	18	4000K	UNV	2036	SURFACE	EMERGENCY BATTERY BACKUP WITH 90 MINUTES OF BACK-UP CAPACITY	CEILING	E
F11			6L-S-D-4-04-BAT-C1-40K-D055- D01-1C-UNV	LED	19	4000K	UNV	2200	SURFACE	-	CEILING	
F11E		LITECONTROL	6L-S-D-4-04-BAT-C1-40K-D055- D01-1C-UNV-EF	LED	19	4000K	UNV	2200	SURFACE	EMERGENCY BATTERY BACKUP WITH 90 MINUTES OF BACK-UP CAPACITY	CEILING	E
F12		COLUMBIA LIGHTING	LCAT22-40VWG-G-EDU	LED	24	4000K	UNV	3339	RECESSED	-	CEILING	
F12E		COLUMBIA LIGHTING	LCAT22-40VWG-G-EDU-ELL14	LED	24	4000K	UNV	3339	RECESSED	EMERGENCY BATTERY BACKUP WITH 90 MINUTES OF BACK-UP CAPACITY	CEILING	E
E-F1		GREEN CREATIVE	15A21DIM/840	LED	15	4000K	120V-277V	1700	LAMP	PROVIDE ALL DRIVERS AND ACCESSORIES AS REQUIRED FOR INSTALLATION.	EXISTING	
E-F2		GREEN CREATIVE	10.5T8/4F/840/DIR/RD	LED	10	4000K	120V-277V	1700	LAMP	PROVIDE ALL DRIVERS AND ACCESSORIES AS REQUIRED FOR INSTALLATION.	EXISTING	
E-F3		GREEN CREATIVE	8T8/2F/840/DIR/RC	LED	8	4000K	120V-277V	1300	LAMP	PROVIDE ALL DRIVERS AND ACCESSORIES AS REQUIRED FOR INSTALLATION.	EXISTING	
E-F4		1 GREEN CREATIVE	1 15A21DIM/840	LED	15	4000K	120V-277V	1700	LAMP	PROVIDE ALL DRIVERS AND ACCESSORIES AS REQUIRED FOR INSTALLATION.	EXISTING	
E-F5		GREEN CREATIVE	43T8/8F/840/DEB/-	LED	43	4000K	120V-277V	5500	LAMP	PROVIDE ALL DRIVERS AND ACCESSORIES AS REQUIRED FOR INSTALLATION. REPLACE '-' WITH PIN CONNECTION. COORDINATE PIN CONNECTION WITH EXISTING FIXTURE.	EXISTING	
E-F6	•	GREEN CREATIVE	15A21DIM/840	LED	15	4000K	120V-277V	1700	LAMP	PROVIDE ALL DRIVERS AND ACCESSORIES AS REQUIRED FOR INSTALLATION.	EXISTING	
EXW	\bigotimes	COMPASS	APX6G	LED	2	-	UNV	-	SURFACE	NOTE LF1, EMERGENCY BATTERY BACKUP WITH 90 MINUTES OF BACK-UP CAPACITY	1'-0" ABOVE DOOR	E
EXC	\bigotimes	COMPASS	APX6G	LED	2	-	UNV	-	SURFACE	NOTE LF1, EMERGENCY BATTERY BACKUP WITH 90 MINUTES OF BACK-UP CAPACITY	CEILING	E
EM	4	DUAL LITE	EV2	LED	1	_	UNV	_	SURFACE	EMERGENCY BATTERY BACKUP WITH 90 MINUTES OF BACK-UP CAPACITY	8'-0" AFF	E

DISCONNECT SWITCH SCHEDULE

DISCONNECT SWITCH IDENTIFICATION	
DS1 (NOTES S1, S2)	
DS2 (NOTE S3)	

ENCLOSURE TYPE FUSED NEMA 3R FUSED NEMA 3R

VOLTS 240 240

DISCONNECT SWITCH SCHEDULE NOTES:

S1. CONTRACTOR SHALL PROVIDE AND INSTALL COOPER BUSSMAN DISCONNECT SWITCH OR APPROVED EQUAL. REFER TO SPECIFICATION 262816 FOR ADDITIONAL INFORMATION.

S2. COORDINATE EXACT FUSE SIZE WITH ELEVATOR INSTALLER.

S3. DISCONNECT SWITCH SHALL BE CAPABLE OF BEING LOCKED IN THE OPEN POSITION PER NEC REQUIREMENTS.

MOTOR STA	RTER SCHE	DULE			
IDENTIFICATION	NEMA SIZE	VOLTS / PHASE	ENCLOSURE TYPE	DISCONNECT AMPS / POLE	ACCESSORIES
\$1*		120/10	NÈMA 1/	20 / 1	H-O-A SWITCH, RUN AND OVERLOAD LIGHT
* MOTOR STARTER SH	IALL BE FRANKLIN ELECT	RIC MODEL NUMBER "BAS"	OR APPROVED EQUAL		

LIGHTING		OL SCHEDU	LE					
DESIGNATION	SYMBOL	MANUFACTURER	MODEL NUMBER	VOLT	MOUNTING	REMARKS	MOUNTING HEIGHT	DETAIL
LV	S	HUBBELL	NXSW-ORLO-WH	24VDC	RECESSED	WALL MOUNTED LOW VOLTAGE	AFC	8 E 500
OS	S	HUBBELL	LHMTS-1-G-WH	24VDC	RECESSED	WALL MOUNTED OCCUPANCY SENSOR	-	
RC		HUBBELL	NXRCFX-2RD-UNV	UNV	SURFACE	ROOM CONTROLLER	AFC, UON	8 E 500
OS/VS	0	HUBBELL	OMNI-DT-2000	24VDC	SURFACE	CEILING MOUNTED OCCUPANCY SENSOR/VACANCY SENSOR	CEILING, UON	8 E 500
OS1	\odot	HUBBELL	WSP-SF-24V LENS: WSP-L360-WH	24VDC	SURFACE	HI-BAY CEILING MOUNTED OCCUPANCY SENSOR	CEILING, UON	8 E 500
PC	PC	INTERMATIC	K4121C	UNV	K42-SW-A (SURFACE)	SWIVEL MOUNT AND 25 AMP RATED PHOTOCELL	AT ROOF LINE	
тс	TC	TORK	1100	UNV	SURFACE	TIME CLOCK	IN "ELCP"	9 E 500

LIGHT FIXTURE SCHEDULE NOTE:

LF1. SHADED AREA SHOWN ON DRAWINGS IS TO SHOW THE EXIT SIGN FACE.

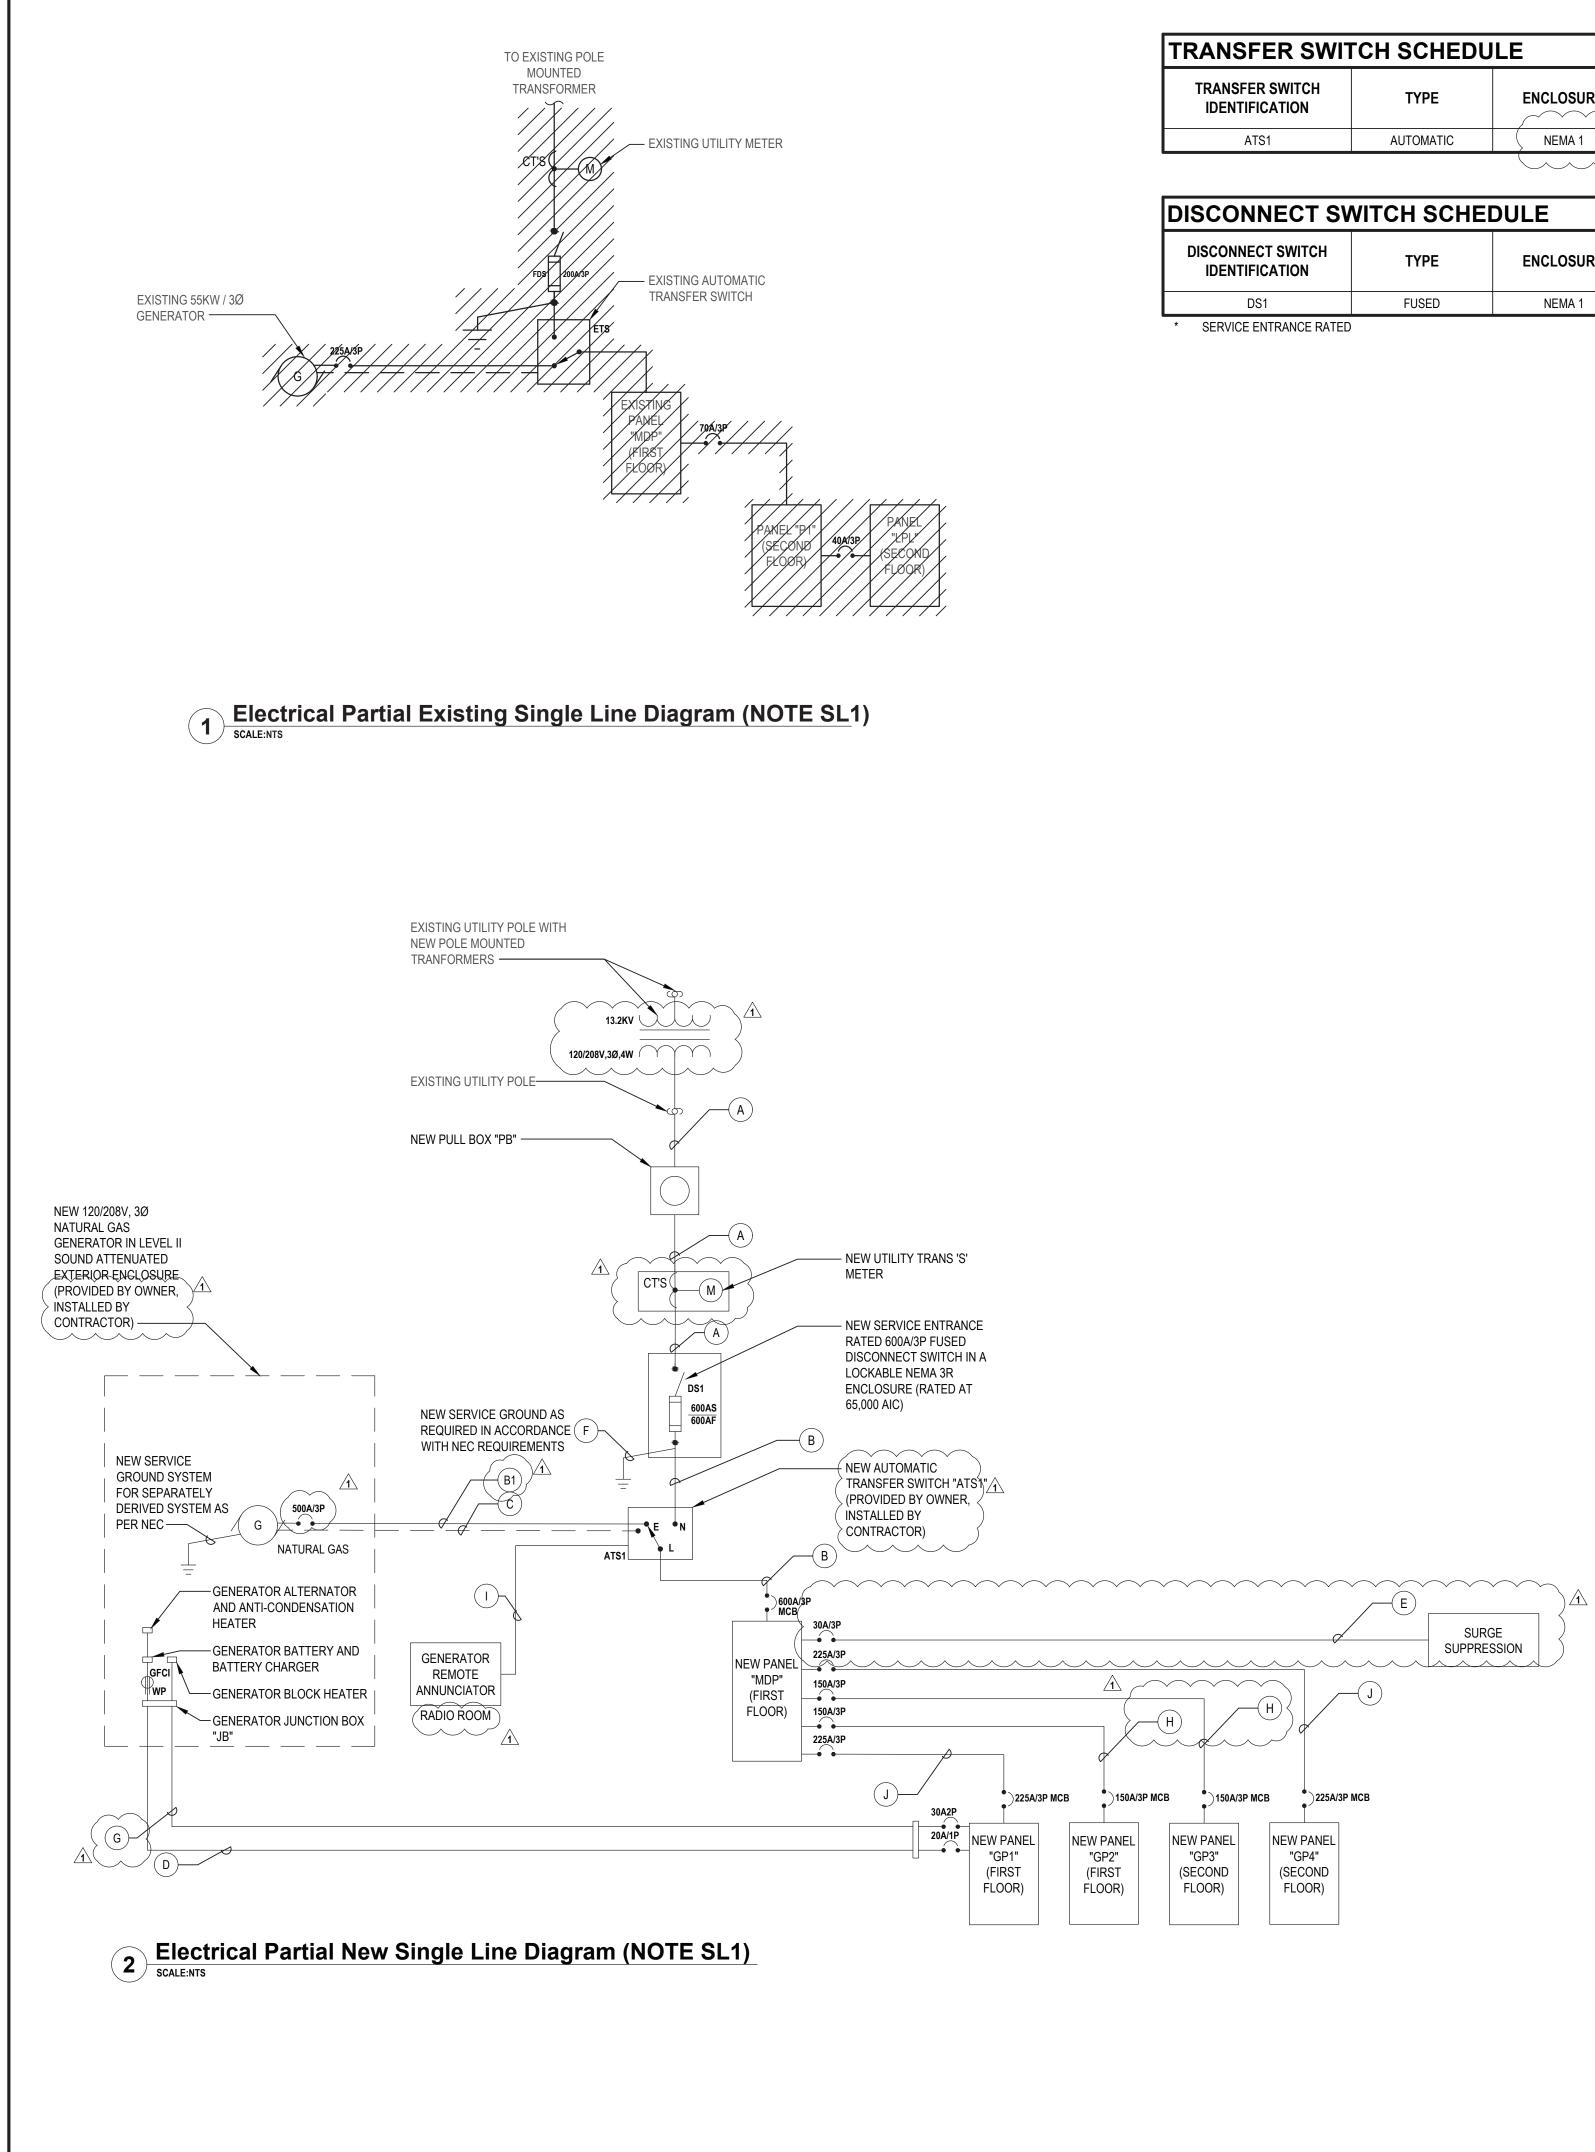
POLES	FRAME SIZE AMPS	FUSE RATING
3	200 A	150 A
1	30 A	20 A

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	N		engineers
	Lath	am, NY 1	Suite 205 2110 v.h2m.com
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anelboard:	MDP	Voltage:	208Y/120	Phase:		3	_Wire	4 A.I.C. Ra	ating:	65,000	_	Panelboard:	GP2	Voltage	e:208Y	7/120 Phase:	;	3	Wire	4 A.I.C. Rati	ng: 42,000
anufacturer:	SIEMENS	Mains:	600 A MCB	Mains Ratir	ting: 0	600 A	Notes					Manufacturer:	SIEMENS P2	Mains:		MCB Mains R	-	0 A	Notes		
anel Type:	P21	Mounting:	SURFACE	Options:			_Notes:				-	Panel Type: NEMA Type Enclosure	P2 1	Mounti	ng: SURF	ACE Options			Notes:		
Load Description	Breaker Option Trip Poles Circ No.	A B	с	A B	вС	Circ No.	oles Trip	Breaker Option	Load	Description	-	Load Description	Breaker Option Trip F	Poles Circ A	вС	A	вС	Circ No.	oles Trip	Breaker Option	Load Description
		13196 VA		5520 VA		2		•				APPARTUS BAY 118 RECEPT.		1 1 1620 VA		360 VA		2 1	1 20 A		TV RECEPT.
GP1	225 A 3 3 5	13254 VA	9150 VA		20 VA 5520 V	VA 6	3 50 A	HACR		RTU-1		LOBBY RECEPT. APPARTUS BAY R108 RECEPT.	20 A 20 A	1 5	540 VA 1800	VA	080 VA 360 VA	6 1			RADIO RM RECEPT.
GP2	150 A 3 9	5342 VA 4394 VA		4200 VA 4200		8 10 VA 12	3 45 A	HACR		RTU-2		MECH RM RECEPT. CORRIDOR RECEPT. 1ST FLR BTHRM HAND DRYER	20 A 20 A 20 A	1 7 360 VA 1 9 1 11	1080 VA 1000		40 VA		1 20 A 1 20 A 1 20 A		LAUNDRY RM RECEPT. EXISTING CHIEFS RECEPT. ELEVATOR PIT RECEPT.
GP3		5910 VA 4520 VA		3480 VA	4200 V 30 VA	12 14 16	3 40 A	MACR	\frown	RTU-3		NEW APPARTUS BAY LTG FIRST FLOOR BACK AREA LTG	20 A 20 A 20 A	1 11 1 13 548 VA 1 15	878 VA	1554 VA	277 VA	14 1	1 20 A 1 20 A 1 20 A		ELEVATOR PIT RECEPT. EXISTING APPARTUS BAY LTG EXTERIOR LTG.
610	17	8600 VA	4680 VA	1000 VA	3480 V		1 20 A		\sim γ			ELEVATOR PIT LTG. SPARE	20 A 20 A 20 A	1 17 1 19 0 VA	44 \		0 VA	18 1	1 20 A 1 20 A 1 20 A	-	SPARE SPARE
GP4	225 A 3 21 23	10632 VA		1176	76 VA	22 VA 24	1 20 A 1 20 A		NEW BAC	K DOOR MOTOR		SPARE SPARE	20 A 20 A	1 21 1 23	AV 0		0 VA 0 VA		1 20 A 1 20 A		SPARE SPARE
SURGE SUPRESSION	30 A 3 25	20 VA 0 VA		180 VA 0 V	VA	26 28	1 20 A		\sim	EFLCP SPACE		SPARE SPACE	20 A 	1 25 0 VA 27	0 VA	0 VA	0 VA				SPACE SPACE
SPACE	29	0 VA	0 VA	0 VA	0 VA					SPACE SPACE		SPACE SPACE		29 31 0 VA	0 V	0 VA	0 VA	32 -	 		SPACE SPACE
SPACE SPACE	33 35	0 VA	0 VA		VA 0 VA	A 36				SPACE SPACE		SPACE SPACE		- 33 35	0 VA 0 V	A	0 VA 0 VA	36 -			SPACE SPACE
SPACE SPACE	39	0 VA 0 VA		0 VA 0 V	VA	40				SPACE SPACE	_	GENERATOR BLOCK HEATER	30 A	2 37 2 0 VA 39 1 41	0 VA		0 VA	40 -			SPACE SPACE
SPACE SPACE SPACE	41 43 45	0 VA 0 VA	0 VA	0 VA 0 V	0 VA	44	 			SPACE SPACE SPACE		GENERATOR ACCESSORIES			0 V.		0 VA				SPACE
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												Panel Type:	P2	Mounti					Notes:		
Name												NEMA Type Enclosure	1								
Panelboard:	GP1 SIEMENS	Voltage:	208Y/120 225 A MCB	Phase:		3 225 A	Wire 4	4 A.I.C. Ra	ating:	42,000	-		Breaker Option Trip F	Poles Circ A	вС		в 1 С	Circ	oles Trip	Breaker	Load Description
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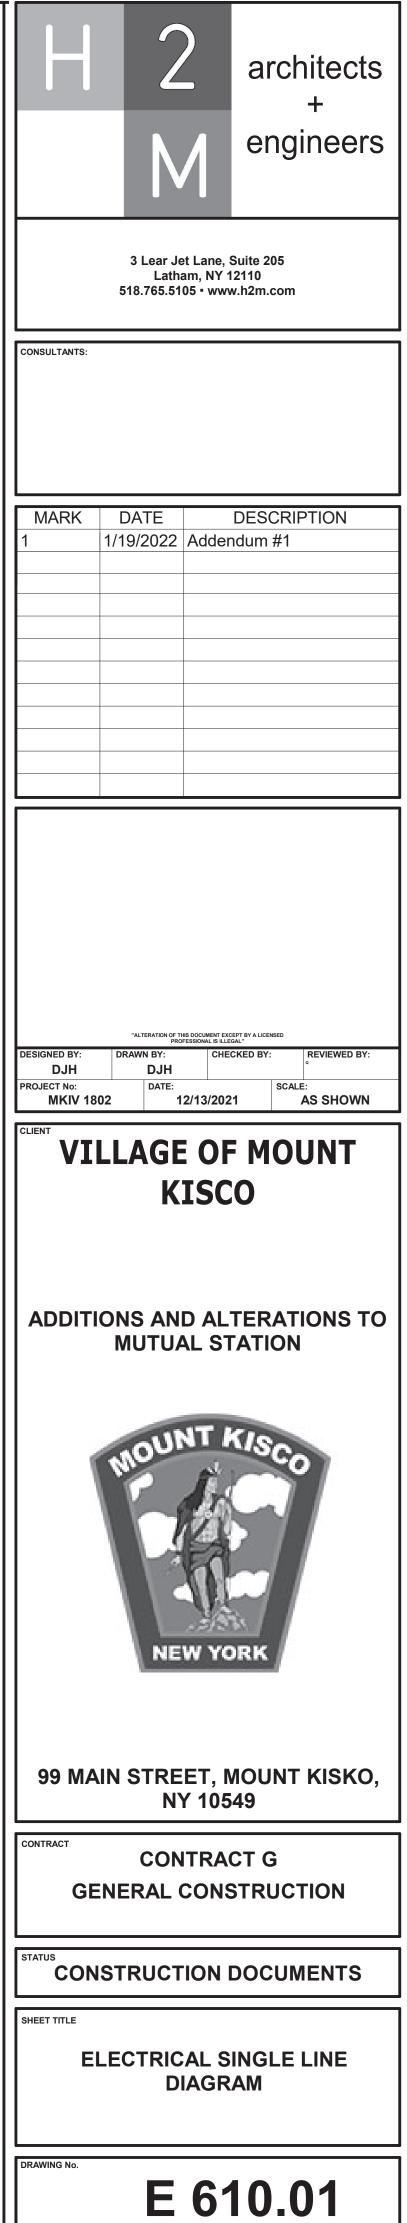


TRANSFER SWITCH IDENTIFICATION	TYPE	ENCLOSURE	VOLTS	PHASE	POLES	AMPS
ATS1	AUTOMATIC	NEMA 1	208	3Ø	4	600A
ISCONNECT SW						
ISCONNECT SW	ITCH SCHE					
ISCONNECT SW DISCONNECT SWITCH IDENTIFICATION	TYPE		VOLTS	POLES	FRAME SIZE AMPS	FUSE RATING

SINGLE	LINE DIAGRAM FEEDER SCHEDULE	
FEEDER	CONDUCTOR AND CONDUITS FEEDER SCHEDULE	
A	2 SETS OF 4-350 MCM IN (2) 3-1/2" E.C. (PVC SCHEDULE 80)(EXTERIOR)	
B	2 SETS OF 4-350 MCM + #1 AWG GND IN (2) 4" E.C.	
(B1)	2 SETS OF 4-250 MCM + #4 AWG GND IN (2) 3" E.C.	
C	187#147AWG + BELDEN-'9279' CABLE 1" E.C.(PVC SCHEDULE-80) (EXTERIOR) AND 1" EMT (INTERIOR)	
D	2 #12 AWG + #12 AWG GND IN 3/4" E.C. (FOR BATTERY CHARGER, ANTI-CONDENSATION HEATER AND RECERTACLES) PVC SCHEDULE 80 (EXTERIOR) AND EMT (INTERIOR)	
E	4 #10 AWG + #10 AWG GND IN 3/4" E.C.	
~ Fr	NÈW ŜERVICE GROUND FOR SEPARATELY DERIVED SYSTEM AS PER NEC.	
G	2 #10 AWG + #10 AWG GND IN 3/4" PVC SCHEDULE 80 (EXTERIOR) AND EMT (INTERIOR)	
H	4 #1/0 AWG + #6 AWG GND IN 2" E.C.	\sum
	BELDEN '9279' CABLE IN 3/4" E.C. (RUN CONTINUOUS FROM GENERATOR)	}
J	4 #4/0 AWG + #4 AWG GND IN 3" E.C.	

SINGLE LINE DIAGRAM NOTES:

SL1. CONTRACTOR SHALL COORDINATE ALL ELECTRICAL SHUTDOWN WITH CON EDISON AND THE CLIENT AS REQUIRED. CONTRACTOR SHALL COMPLETE ALL APPLICATIONS AND PAY RELATED FEES REQUIRED FOR SHUTDOWN.



	FIRE ALARM SHEET LI	ST
Sheet	_	
Number	Sheet Name	
A 001	FIRE ALARM LEGENDS AND RISER DIAGR	
A 101 A 102	FIRE ALARM PLAN FIRST FLOOR	1 \
A 102	FIRE ALARM PLAN ROOF)
	FIRE ALARM LEGEND	
SYMBOL	DESCRIPTION	COMMENTS
FACP	FIRE ALARM CONTROL PANEL.	
RA	REMOTE ANNUNCIATOR WITH BACKBOX.	
<u>(s)</u>	SMOKE DETECTOR.	
(S) _{CO}	SMOKE DETECTOR WITH CARBON MONOXIDE AND LOCAL TEMPORAL '4' SOUNDER BASE.	
(S) CO/SB	SUUNDER BASE. SMOKE DETECTOR WITH CARBON MONOXIDE AND INTEGRAL SOUNDER BASE.	
 ©	CARBON MONOXIDE DETECTOR.	
RAL	ABOVE CEILING SMOKE DETECTOR WITH REMOTE ALARM LAMP.	
S R1	DUCT DETECTOR WITH REMOTE ALARM LAMP; "S" DENOTES SUPPLY, "R" DENOTES RETURN.	
٨	HEAT DETECTOR.	
(H1)	HEAT DETECTOR 200°.	
ă	HORN/STROBE COMBO.	
Мир	WEATHER PROOF HORN/STROBE COMBO WITH BACKBOX.	
AM	ADAPTER MODULE WITH MOUNTING PLATE.	
SH	SMOKE HATCH (F.B.O.).	
X	STROBE.	
DH	MAGNETIC DOOR HOLDER.	
DR	DOOR RELEASE RELAY.	
F	MANUAL PULL STATION WITH BACKBOX.	
R	RELAY.	
IAM	INDIVIDUAL ADDRESSABLE MODULE.	
СМ	CONTROL MODULE.	
AES	AUTOMATIC EXTINGUISHING SYSTEM.	
\boxtimes	MOTOR STARTER.	
m.	END OF LINE RESISTOR.	
BT	BEAM DETECTOR TRANSMITTER.	
BR	BEAM DETECTOR RECEIVER.	
SP	SURGE PROTECTOR.	
<u> </u>	BELL/STROBE.	
s ^E	SMOKE DETECTOR FOR ELEVATOR RECALL.	
SRP	SUPPRESSION RELEASING PANEL.	
MS	MAINTENANCE SWITCH.	
[SOL]	SOLENOID (F.B.O.).	
PS	PRESSURE SWITCH.	
TS	TAMPER SWITCH.	
FS	FLOW SWITCH.	
CS	COIL SUPERVISORY (F.B.O.).	
CL	AIR COMPRESSOR, LOW PRESSURE (F.B.O.).	
СН	AIR COMPRESSOR, HIGH PRESSURE (F.B.O.).	
и В В		_

NOTES: 1. ALL WIRING TO BE INSTALLED ACCORDING TO THE LATEST REVISION OF THE NATIONAL ELECTRIC CODE OR AS DICTATED BY CONTRACT SPECIFICATIONS, AND THE 2013 EDITION OF N.F.P.A 72 OR AS REQUIRED BY LOCAL ORDINANCE.

2. ALL CONDUCTORS MUST BE TEST FREE OF OPENS, SHORTS AND GROUNDS.

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3. GROUNDING MUST COMPLY WITH THE NATIONAL ELECTRIC CODE. GROUNDING MUST BE NO. 12 A.W.G.

4. ALL PANEL TERMINATIONS TO BE SUPERVISED BY A FACTORY AUTHORIZED TECHNICIAN PRIOR TO POWERING EQUIPMENT.

5. FOR COMPONENT WIRING AND INSTALLATION INFORMATION REFER TO MANUFACTURERS REQUIREMENTS.

6. REFER TO CONTRACT DRAWINGS FOR APPROXIMATE DEVICE LOCATIONS. DRAWINGS REPRESENT DEVICE QUANTITIES. SHOP DRAWINGS SHALL BE SUBMITTED SHOWING SCALED LOCATIONS. CONTRACTOR TO SUBMIT PLANS STAMPED BY LICENSED NEW YORK PROFESSIONAL ENGINEER ONLY. SHOP DRAWINGS WITHOUT P.E STAMP WILL BE AUTOMATICALLY REJECTED.

7. EXISTING FIRE ALARM SYSTEM INCLUDING ALL DEVICES TO BE DISCONNECTED AND REMOVED IN ITS ENTIRETY AFTER NEW FIRE ALARM HAS BEEN TESTED AND ACCEPTED BY LOCAL FIRE MARSHALL, OWNER AND ENGINEER ALL EQUIPMENT, CONDUIT AND WIRING TO BE REMOVED FROM DEVICE BACK TO THEIR ORIGINAL SOURCE.

8. CONTRACTOR RESPONSIBLE TO PATCH & PAINT ALL OPENINGS AS A RESULT OF REMOVAL OF EXISTING EQUIPMENT.

9. INSTALL DETECTORS A MINIMUM OF 3'-0" FROM ANY SUPPLY OR RETURN AIR REGISTERS. COORDINATE EXACT LOCATIONS OF SUPPLY/RETURNS REGISTERS WITH MECHANICAL CONTRACTOR.

10. WHEN INSTALLING SHIELDED CABLE THE FOLLOWING MUST BE OBSERVED: A. METALLIC CONTINUITY MUST BE MAINTAINED THROUGHOUT THE CABLE RUN. B. THE CABLE SHIELD MUST BE ISOLATED FROM GROUND AND TERMINATED ONLY IN THE ASSOCIATED CONTROL PANEL AT THE TERMINAL INDICATED ON THE CONTROL PANEL DRAWINGS. THE REMOTE END OF THE SHIELD (AT LAST DEVICE) MUST BE TAPED AND ISOLATED FROM GROUND.

11. ALL STROBE APPLIANCES SHALL BE SYNCHRONIZED. ALL ALARM INDICATING APPLIANCES SHALL SOUND A 'TEMPORAL 3' CODE PATTERN.

12. AFTER ALARM INDICATION, ALL FANS SHALL BE MANUALLY RESET INDEPENDENT FROM F.A.C.P. SYSTEM RESET. PROVIDE ALL REQUIRED HARDWARE ACCESSORIES, MOTOR STARTERS, CONTROLS, POWER AND CONTROL WIRING AND CONDUITS TO PROVIDE INDEPENDENT RESET OF ALL FANS AFTER ALARM INDICATION.

A. MANUAL PULL STATIONS 48" O.C. **B. ALARM INDICATING APPLIANCE 80" A.F.F.**

C. VERIFY WITH CONTRACT SPECIFICATIONS FOR ANY DEVIATIONS.

15. PROVIDE AND INSTALL ALL NECESSARY CONTROL MODULES, SYNCHRONIZATION MODULES AND MONITOR MODULES AS REQUIRED BY MANUFACTURER.

16. ALL EQUIPMENT TO BE RECESSED MOUNTED AND ALL WIRING AND CONDUIT TO BE RUN CONCEALED.

17. PROVIDE AND INSTALL ALL REQUIRED RELAYS TO RELEASE ELECTRIC DOOR LATCHES.

18. COORDINATE EXACT LOCATION OF REMOTE ANNUNCIATOR AND F.A.C.P. WITH LOCAL FIRE MARSHALL AND OWNER.

19. PROVIDE ALL REQUIRED DUCT SMOKE DETECTORS. CONTRACTOR TO INSTALL DUCT SMOKE DETECTORS. CONTRACTOR TO INTERFACE ALL DUCT DETECTORS WITH FACP.

20. CONTRACTOR TO INSTALL NECESSARY COMPONENTS FOR ELEVATOR RECALL AS PER AHJ. EACH LOBBY, SHAFT, AND PIT TO HAVE SMOKE DETECTION. WHERE APPLICABLE CONTRACTOR TO COORDINATE AND INSTALL NECESSARY COMPONENTS TO INTERFACE FIRE ALARM SYSTEM, ELEVATOR, AND SMOKE DETECTION LOCATED IN THE ELEVATOR SHAFT AND ELEVATOR LOBBIES.

21. CONTRACTOR SHALL PROVIDE ALL COMMUNICATION WIRING FOR FACP. PROVIDE ALL REQUIRED WIRING/CONDUIT TO LOCATE COMMUNICATIONS IN FACP. PROVIDE CAT6 CABLE AND DATA JACKS AS REQUIRED.

22. FIRE ALARM RISER DIAGRAM IS SCHEMATIC. REFER TO FLOOR PLANS FOR DEVICE TYPES AND QUANTITIES.

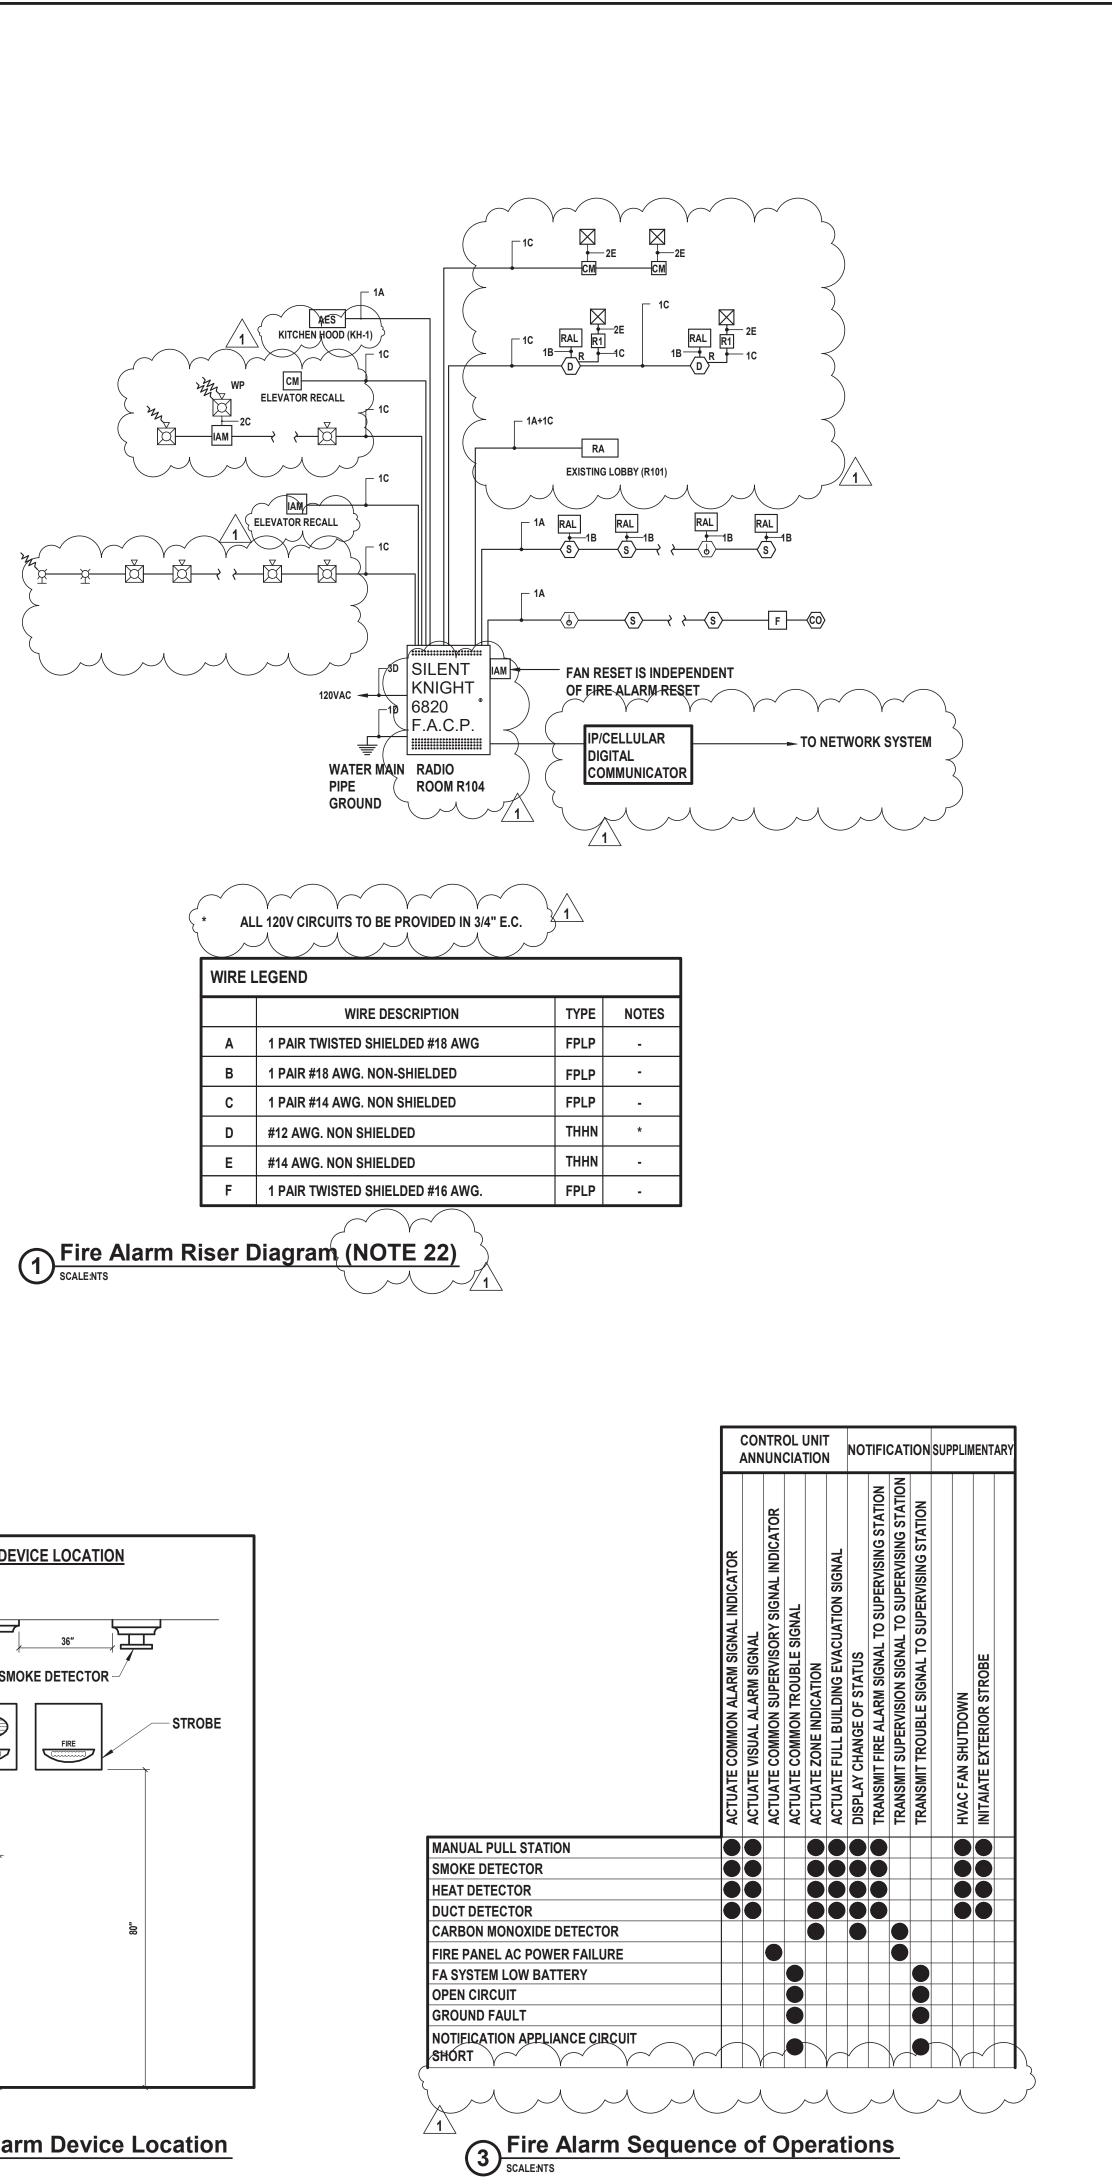
23. ALL HVAC EQUIPMENT WITH A CFM RATING OF 1000 CFM OR GREATER SHALL BE INTERCONNECTED TO THE FIRE ALARM SYSTEM AND SHUT DOWN UPON FIRE ALARM SYSTEM ALARM ACTIVATION. CONTRACTOR SHALL ALSO PROVIDE AND INSTALL RETURN DUCT SMOKE DETECTORS WITH REMOTE LED'S FOR ALL HVAC UNITS WITH A CFM RATING OF 2000 CFM OR GREATER. CONTRACTOR SHALL CONDUCT A SURVEY OF ALL HVAC EQUIPMENT.

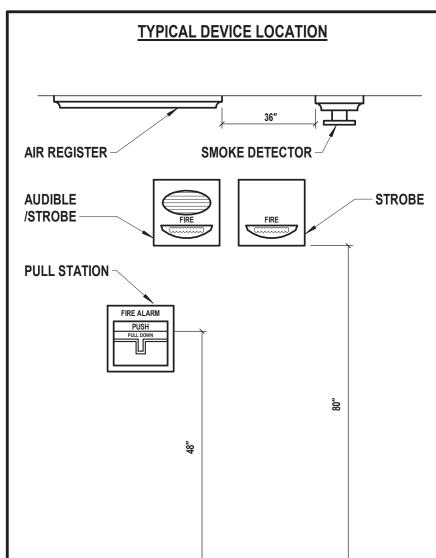
24. IN ADDITION TO DEVICES SHOWN ON THE DRAWINGS CONTRACTOR TO PROVIDE FIVE (5) SMOKE DETECTORS, THREE (3) HEAT DETECTORS, THREE (3) MULTI-CRITERIA DETECTORS WITH CARBON MONOXIDE SOUNDER BASE, THREE (3) PULL STATIONS, THREE (3) HORN STROBES, AND THREE (3) STROBES. EACH DEVICE SHALL BE INCLUDED WITH 100' OF WIRING AND/OR CONDUIT.

25. PLENUM WIRING TO BE USED IN ALL AREAS ABOVE DROP CEILINGS. CONDUIT MUST BE USED IN ALL TRUCK BAYS, MECHANICALROOMS, AND ELECTRIÇAL ROOMS, CONDUIT MUST ALSO BE USED IN ALL AREAS WITH OPEN CEILINGS.

13. INSTALL ALL DEVICES IN ACCORDANCE WITH A.D.A REQUIREMENTS. ALL DEVICES SHALL BE MOUNTED AS FOLLOWS:

14. STROBES SHALL BE WIRED TO REMAIN ACTIVE AFTER SILENCE FUNCTION IS PERFORMED.

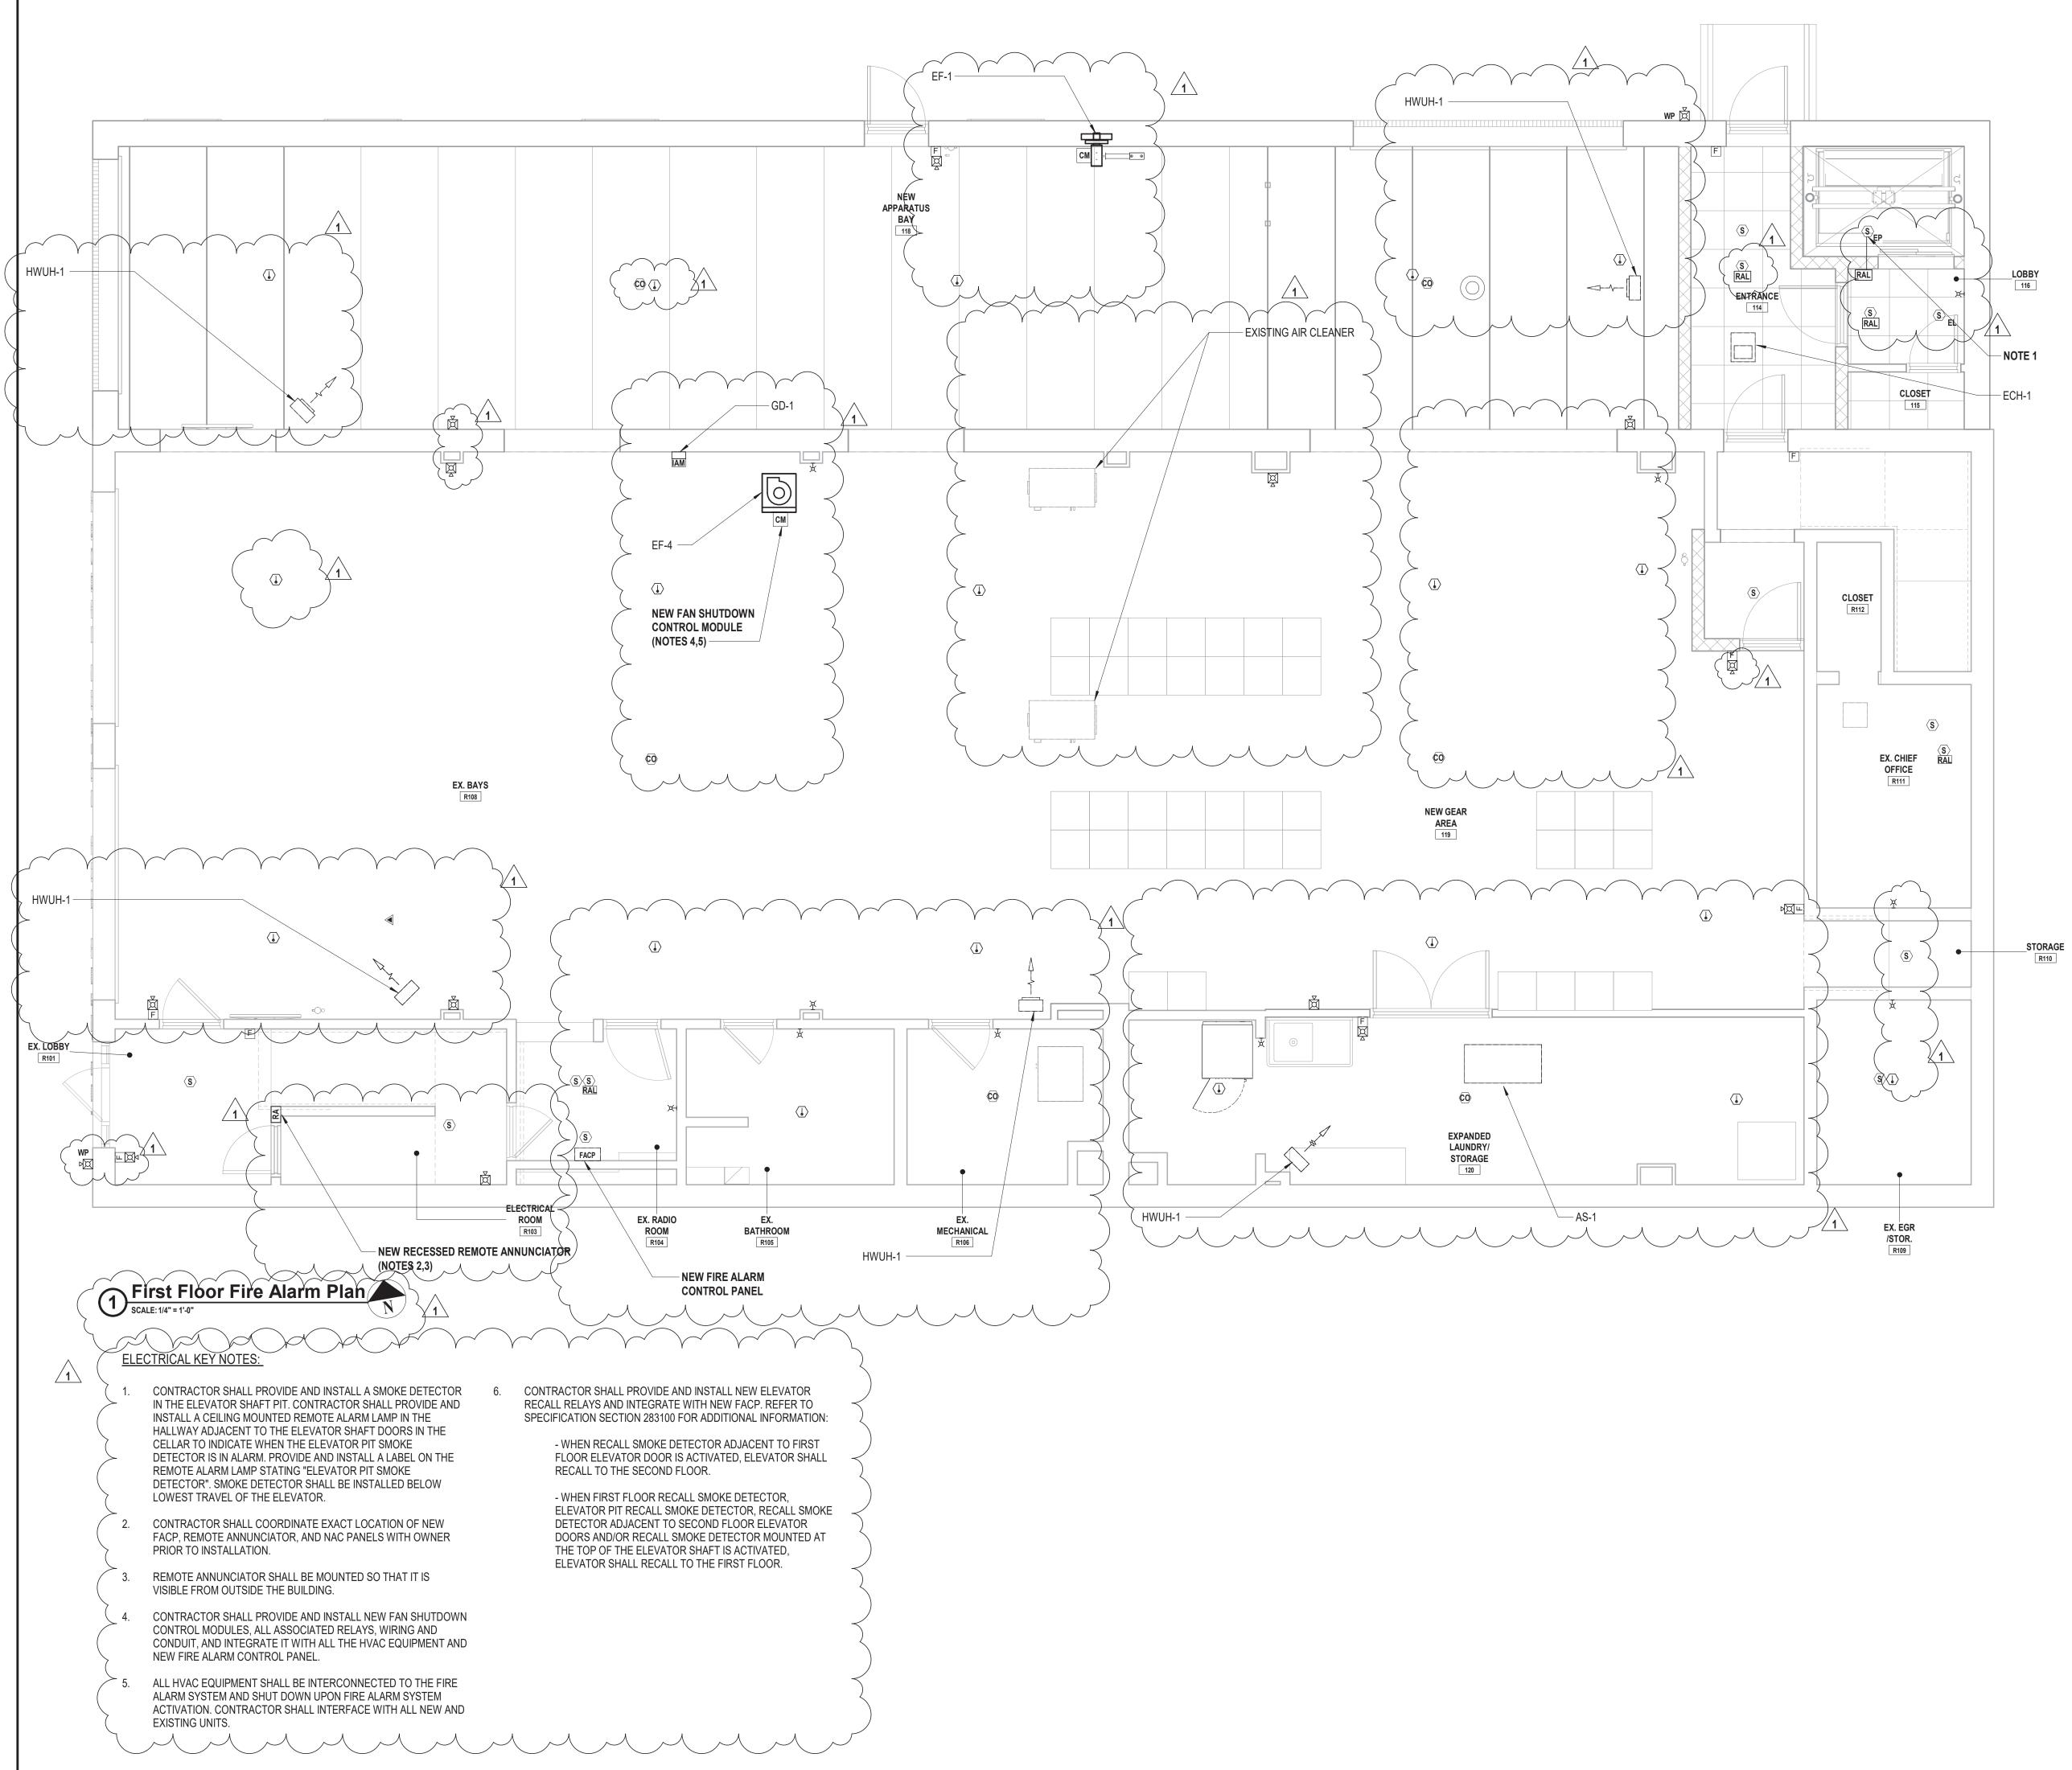




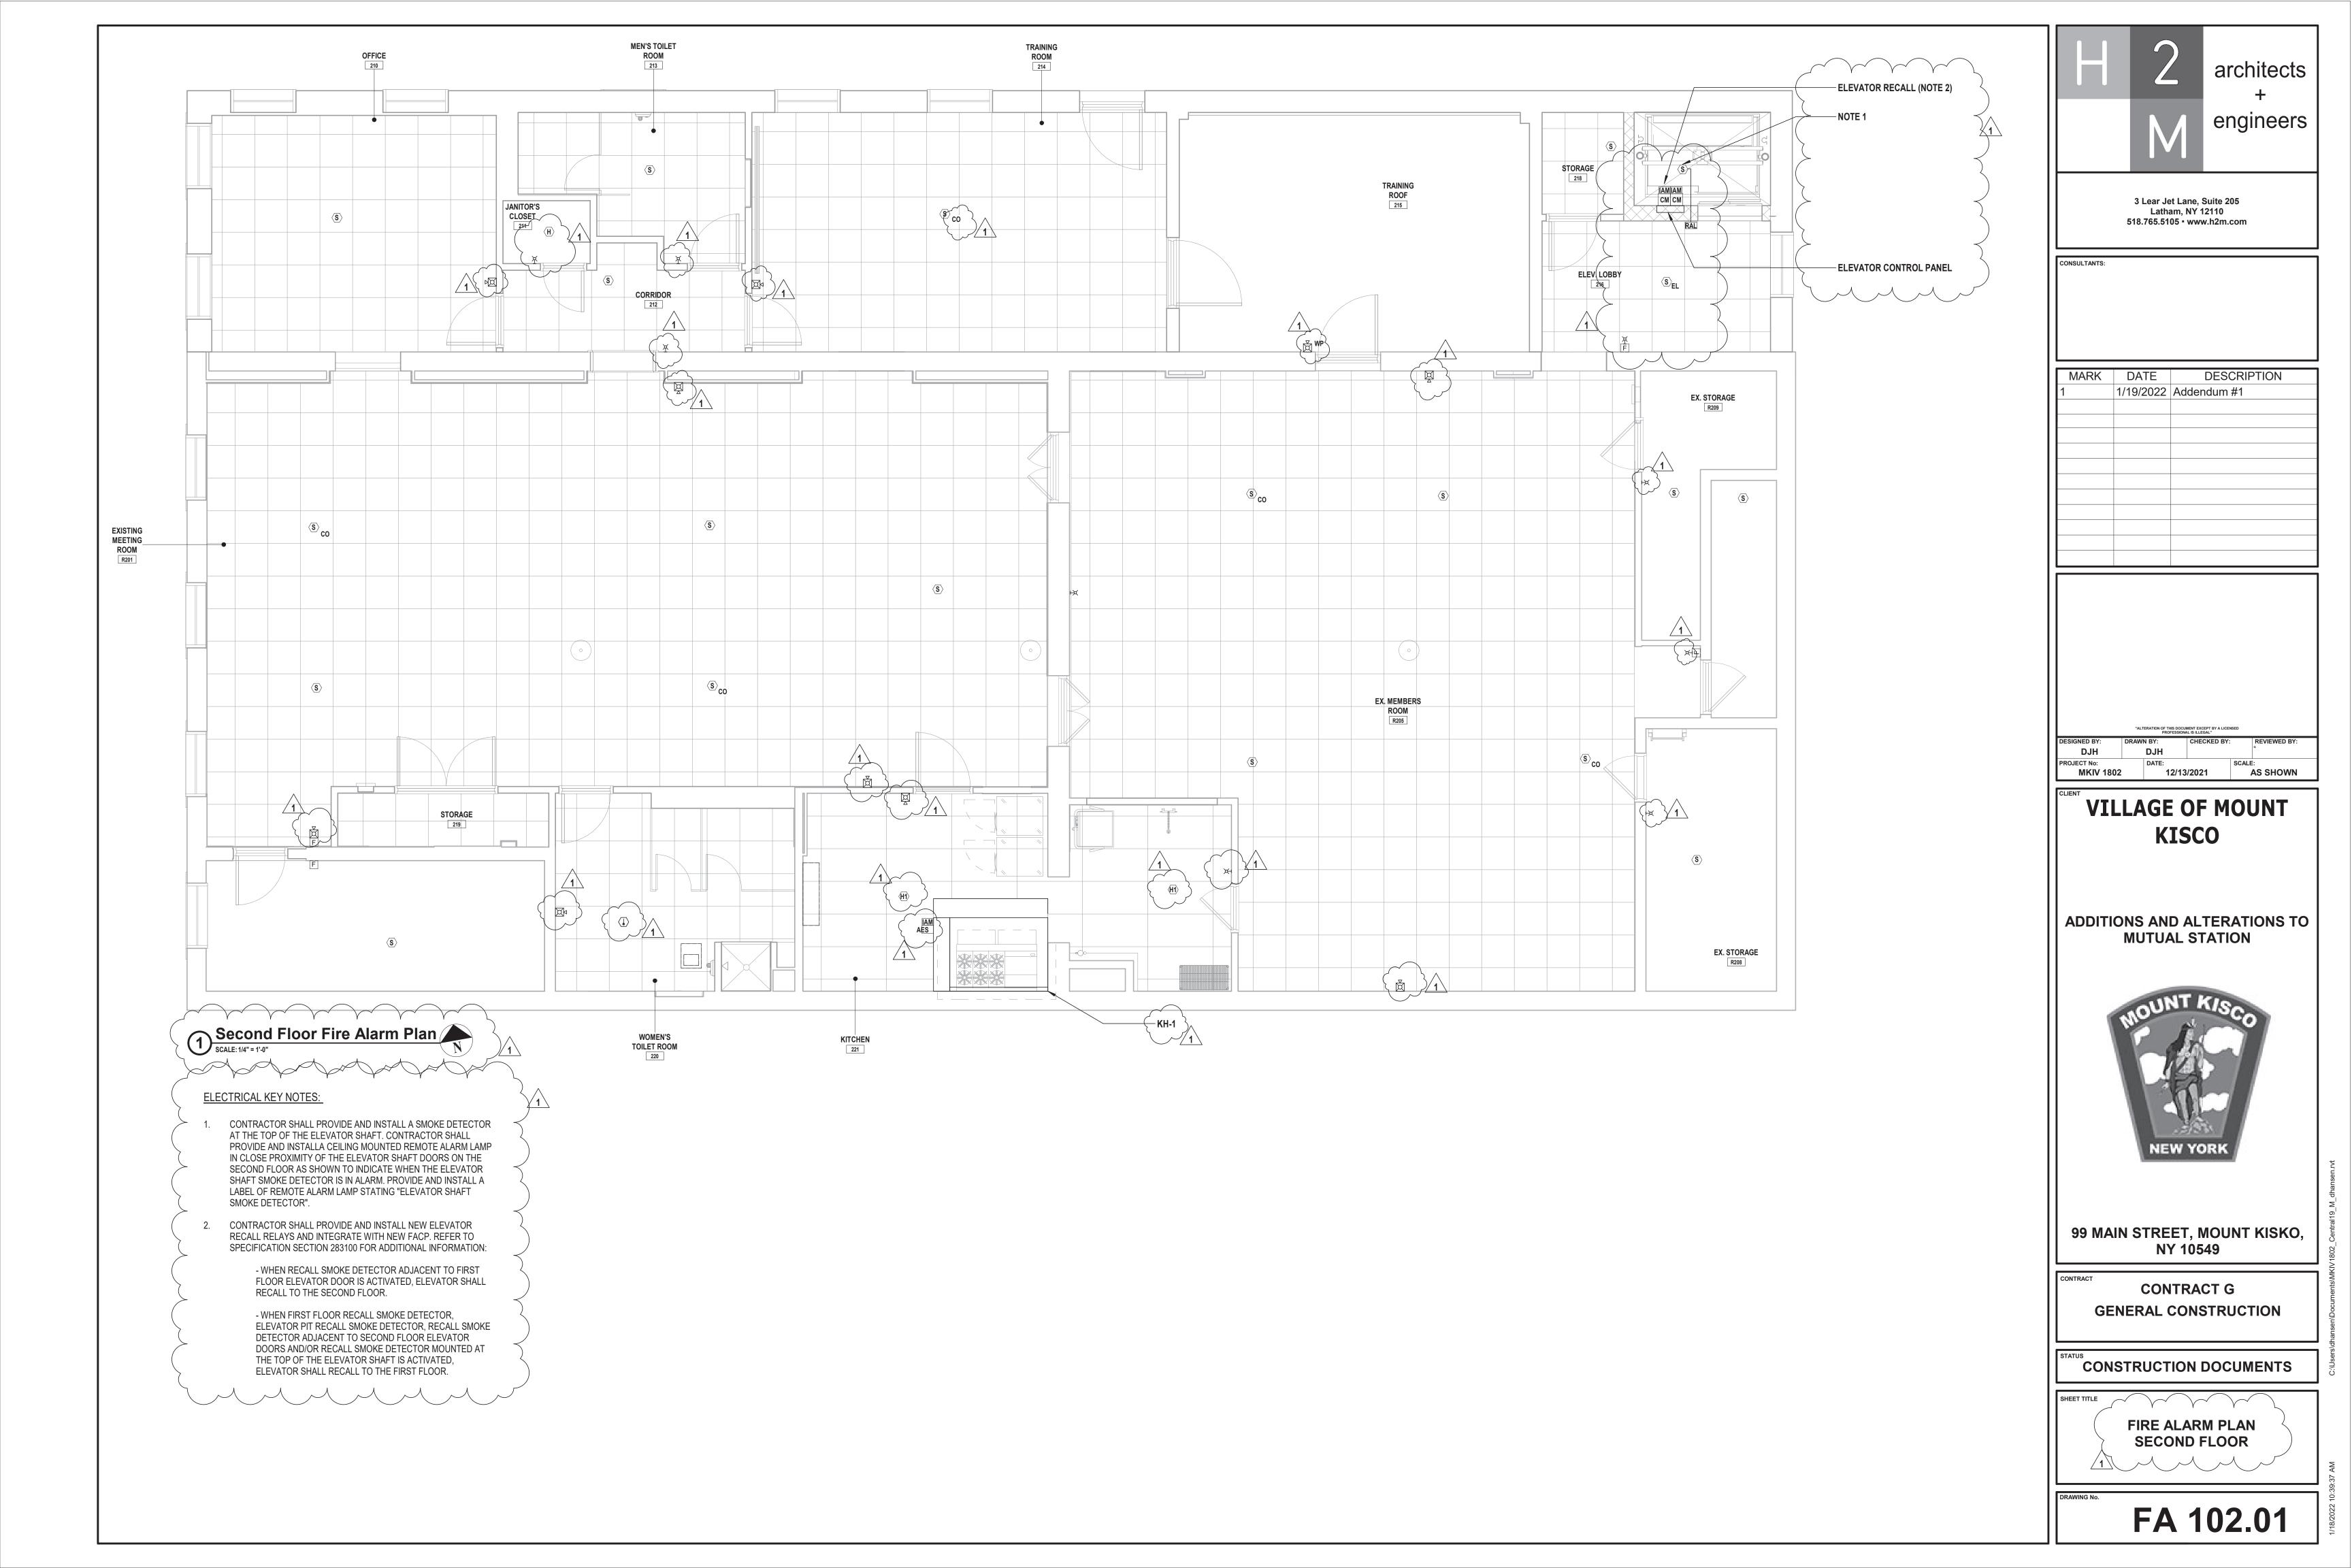
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HEAT DETECTOR
DUCT DETECTOR
CARBON MONOXIDE DETECT
FIRE PANEL AC POWER FAIL
FA SYSTEM LOW BATTERY
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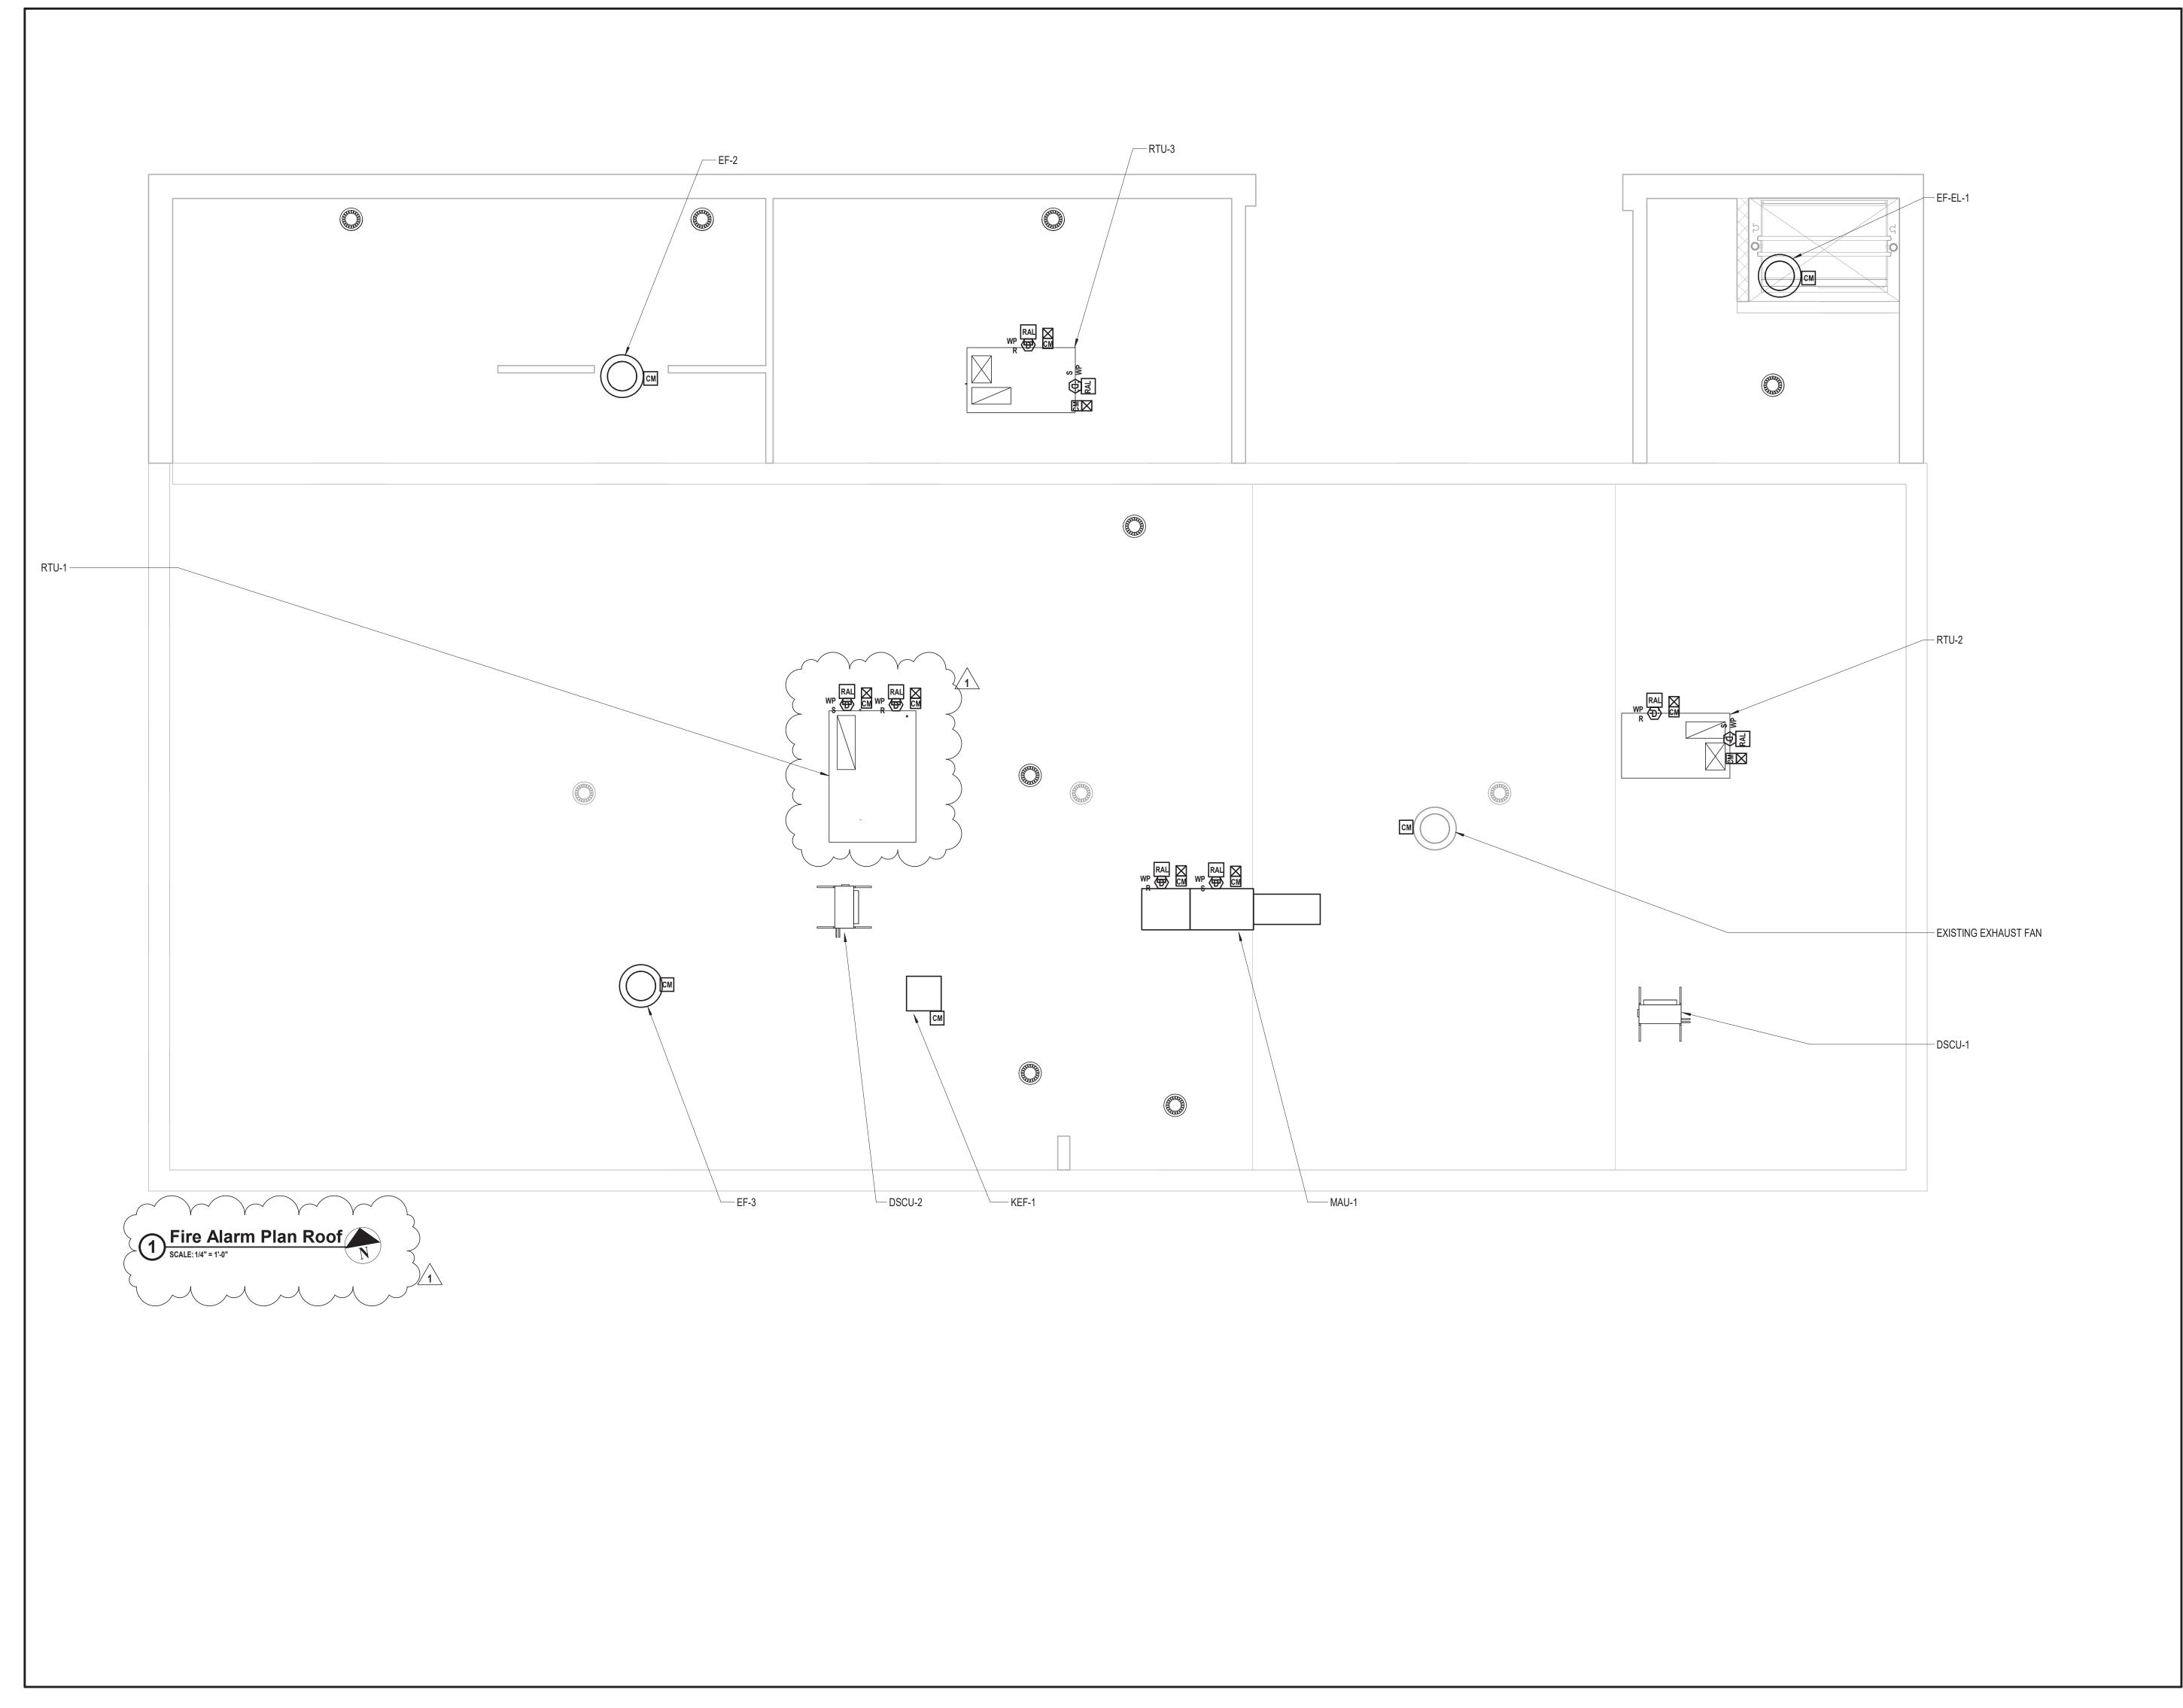
2 Typical Fire Alarm Device Location

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